UTILITIES Electric Service Evergy Nathan Michael 913-347-4310 Nathan.michael@evergy.com

Gas Service Spire **Bobbie Saulsberry** 816-969-2266 bobbie.saulsberry@spireenergy.com

Water/Sanitary Sewer Water Utilities Department 1200 SE Hamblen Road Lee's Summit, Mo 64081 Jeff Thorn 816-969-1900 jeff.thorn@cityofls.net

Street and Storm City of Lee's Summit Public Works Dept 220 SE Green Lee's Summit, MO 64063 816-969-1800

Communication Service AT&T Carrie Cilke 816-703-4386 cc3527@att.com

Time Warner Cable Steve Baxter 913-643-1928 steve.baxter@charter.com

Comcast Ryan Alkire 816-795-2218 ryan.alkire@cable.comcast.com

Google Fiber **Becky Davis** 913-725-8745 rebeccadavis@google.com

SURVEYOR AT THE TIME OF SURVEY. THE SURVEYOR MAKES NO GUARANTEE THAT THE

UNDERGROUND UTILITIES SHOWN COMPRISE ALL SUCH UTILITIES IN THE AREA, EITHER IN SERVICE

OR ABANDONED. FURTHERMORE, THE SURVEYOR DOES NOT WARRANT THAT THE UNDERGROUND

ARE LOCATED AS ACCURATELY AS POSSIBLE FROM INFORMATION AVAILABLE. THE SURVEYOR HAS

NOT PHYSICALLY LOCATED THE UNDERGROUND UTILITIES BY EXCAVATION UNLESS OTHERWISE

UTILITIES SHOWN ARE IN THE EXACT LOCATION INDICATED ALTHOUGH HE DOES CERTIFY THAT THEY

IN ACCORDANCE WITH GENERALLY ACCEPTED CONSTRUCTION PRACTICE, THE CONTRACTOR WILL BE

SOLELY AND COMPLETELY RESPONSIBLE FOR CONDITIONS OF THE JOB SITE, INCLUDING SAFETY OF

THE DESIGNS REPRESENTED IN THESE PLANS ARE IN ACCORDANCE WITH ESTABLISHED PRACTICES OF CIVIL ENGINEERING FOR THE DESIGN FUNCTIONS AND USES INTENEDED BY THE OWNER AT THIS

WARRANTY THESE DESIGNS OR PLANS AS CONSTRUCTED, EXCEPT IN THE SPECIFIC CASES WHERE

THE CONTRACTOR IS SPECIFICALLY CAUTIONED THAT THE LOCATION AND/OR ELEVATION OF EXISTING

RELIED ON AS BEING EXACT OR COMPLETE. THE CONTRACTOR MUST CALL THE APPROPRIATE UTILITY

UTILITIES. IT SHALL BE THE RESPONSIBILITY OF THE CONTRACTOR TO RELOCATE ALL EXISTING UTILITIES

UTILITIES AS SHOWN ON THESE PLANS IS BASED ON RECORDS OF THE VARIOUS UTILITY COMPANIES

COMPANY AT LEAST 72 HOURS BEFORE ANY EXCAVATION TO REQUEST EXACT FIELD LOCATION OF

AND, WHERE POSSIBLE, MEASUREMENTS TAKEN IN THE FIELD. THE INFORMATION IS NOT TO BE

WHICH CONFLICT WITH PROPOSED IMPROVEMENTS SHOWN ON THE PLANS. THE CONTRACTOR

SHALL EXPOSE EXISTING UTILITIES AT LOCATIONS OF POSSIBLE CONFLICTS PRIOR TO ANY

SM ENGINEERING PERSONNEL INSPECT AND CONTROL THE PHYSICAL CONSTRUCTION ON

ALL PERSONS AND PROPERTY DURING PERFORMANCE OF THE WORK. THIS REQUIREMENT WILL

APPLY CONTINUOUSLY AND NOT BE LIMITED TO NORMAL WORKING HOURS.

TIME. HOWEVER, NEITHER SM ENGINEERING NOR ITS PERSONNEL CAN OR DO

UTILITY STATEMENT:

NOTED ON THIS SURVEY.

WARRANTY/DISCLAIMER

CONSTRUCTION.

SAFETY NOTICE TO CONTRACTOR

A CONTEMPORARY BASIS AT THE SITE.

CAUTION- NOTICE TO CONTRACTOR

ARBORIDGE DRIVE PUBLIC STREET AND STORM PLANS ARBOR WALK WEST

LEE'S SUMMIT



AS-BUILTS 4-14-25

RECORD DRAWING

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Date: 4-1-25 Certified by: Samuel D. Malinowsky Title: Owner

Firm: SM Engineering

FLOODPLAIN NOTE:

SUBJECT PROPERTY IS SHOWN TO BE LOCATED IN "OTHER AREAS ZONE X" ON THE FLOOD INSURANCE RATE MAP FOR JACKSON COUNTY, MISSOURI AND INCORPORATED AREAS. COMMUNITY PANEL NO. 29095C0531G, REVISED JANUARY 20, 2017. "OTHER AREAS ZONE X" IS DEFINED AS "AREAS DETERMINED TO BE OUTSIDE THE 0.2% ANNUL CHANCE FLOODPLAIN". LOCATION DETERMINED BY A SCALED GRAPHICAL PLOT OF THE FLOOD INSURANCE RATE MAP.

LOCATION MAP

INDEX OF SHEETS

- C-1 COVER SHEET
- C-2 EXISTING CONDITIONS C-3 EXISTING CONDITIONS
- C-4 DEMOLITION PLAN
- C-5 LAYOUT PLAN
- C-6 GRADING PLAN
- C-7 STORM LINE A PLAN AND PROFILE
- C-8 STORM LINE B PLAN AND PROFILE
- C-9 EROSION CONTROL PLAN C-10 EROSION CONTROL DETAILS
- C-11 DETAILS
- C-12 DETAILS
- C-13 DETAILS
- C-14 TRAFFIC CONTROL
- C-15 TRAFFIC CONTROL DETAILS

DEVELOPER

CHRISTIE DEVELOPMENT ASSOCIATES LLC 7217 W 110TH STREET OVERLAND PARK, KS 66210 CONTACT: GARRETT FUGATE PHONE: 913.649.4500 EMAIL: GARRET@CHRISTIEDEV.COM

ENGINEER

SM ENGINEERING SAM MALINOWSKY 5507 HIGH MEADOW CIRCLE MANHATTAN KANSAS, 66503 SMCIVILENGR@GMAIL.COM 785.341.9747

SURVEYOR

SCHMIDT, BECK & BOYD ENGINEERING, LLC 1415 SW TOPEKA BOULEVARD TOPEKA, KANSAS 66612 PH: (785) 215-8630 / WWW.SBBENG.COM



SAMUEL D. MALINOWSKY PROFESSIONAL ENGINEEER Manhattan Kansas, 66503 smcivilengr@gmail.con 785.341.9747

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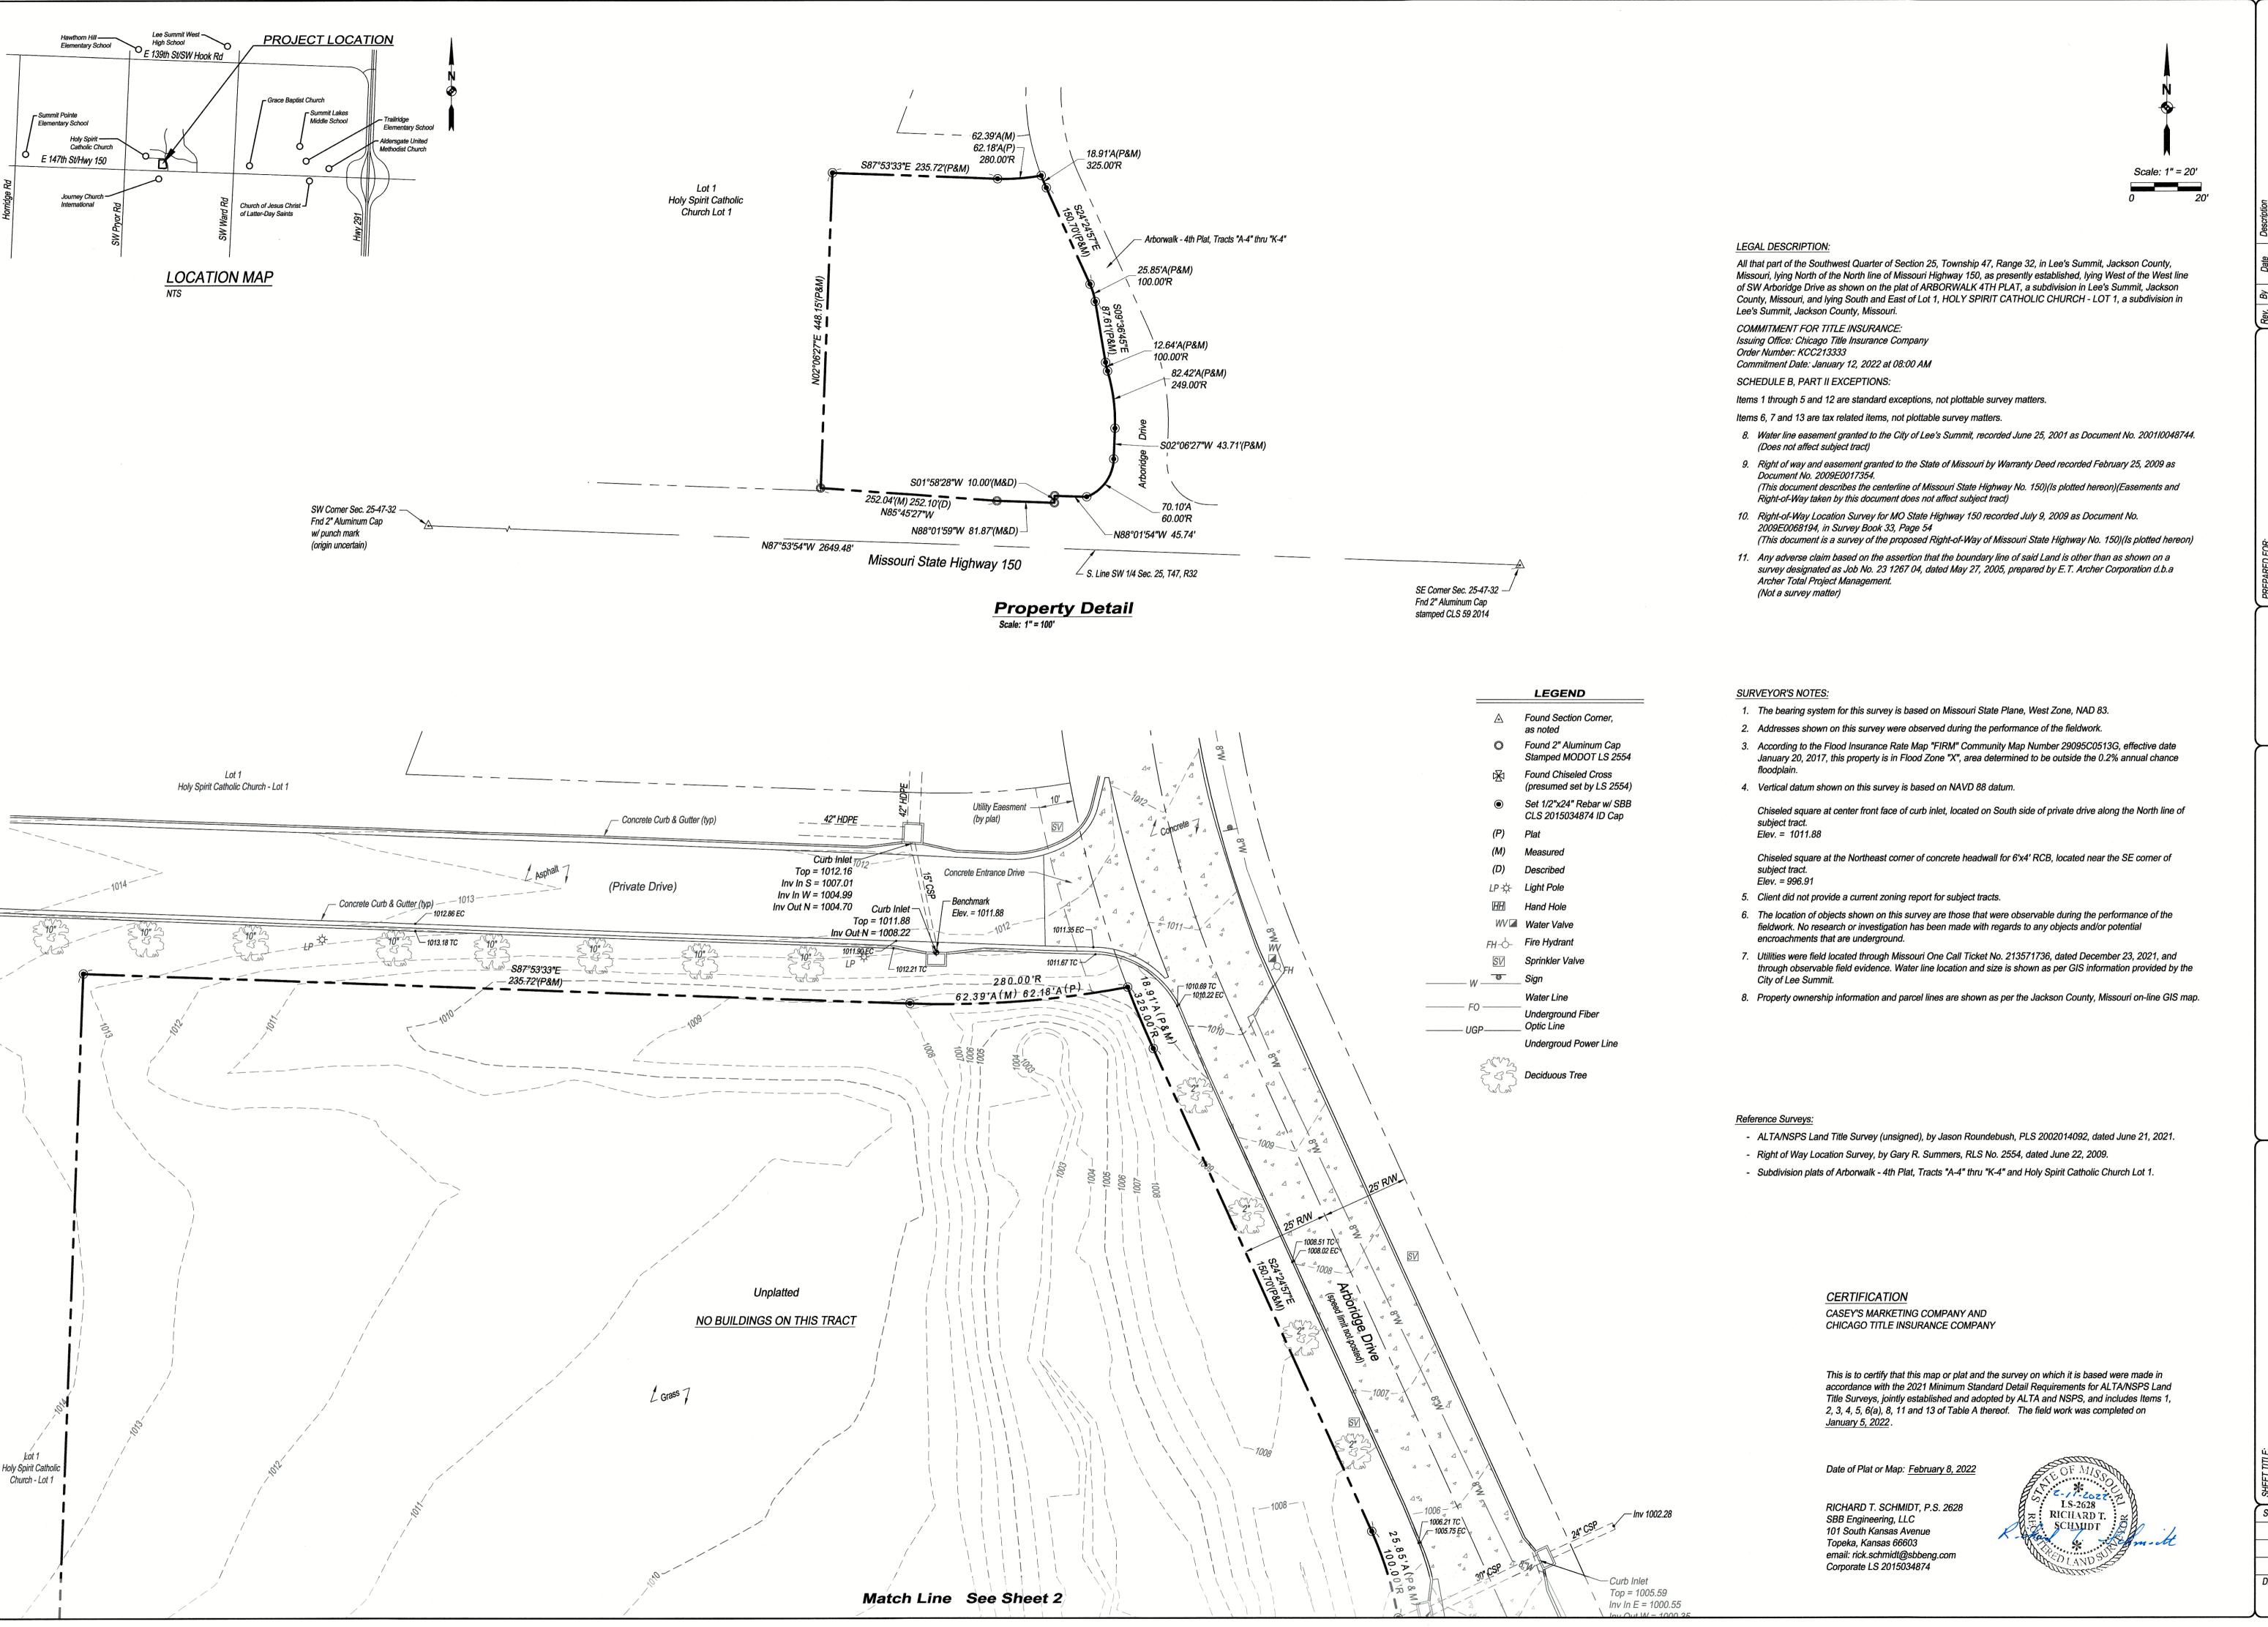
4-14-25 AS BUILTS

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sheet

COVER SHEET permit

18 JULY 2023



Key. Dy Date Description

Casey's Marketing Company One SE Convenience Boulevard Ankeny, Iowa 50021

SBB Engineering, LLC transportation site development surveying 101 South Kansas Avenue Topeka, Kansas 66603

SBB 101 ENGINEERING PI: (785) 2

LAND TITLE SURVEY

Northwest Corner Of And Arboridge

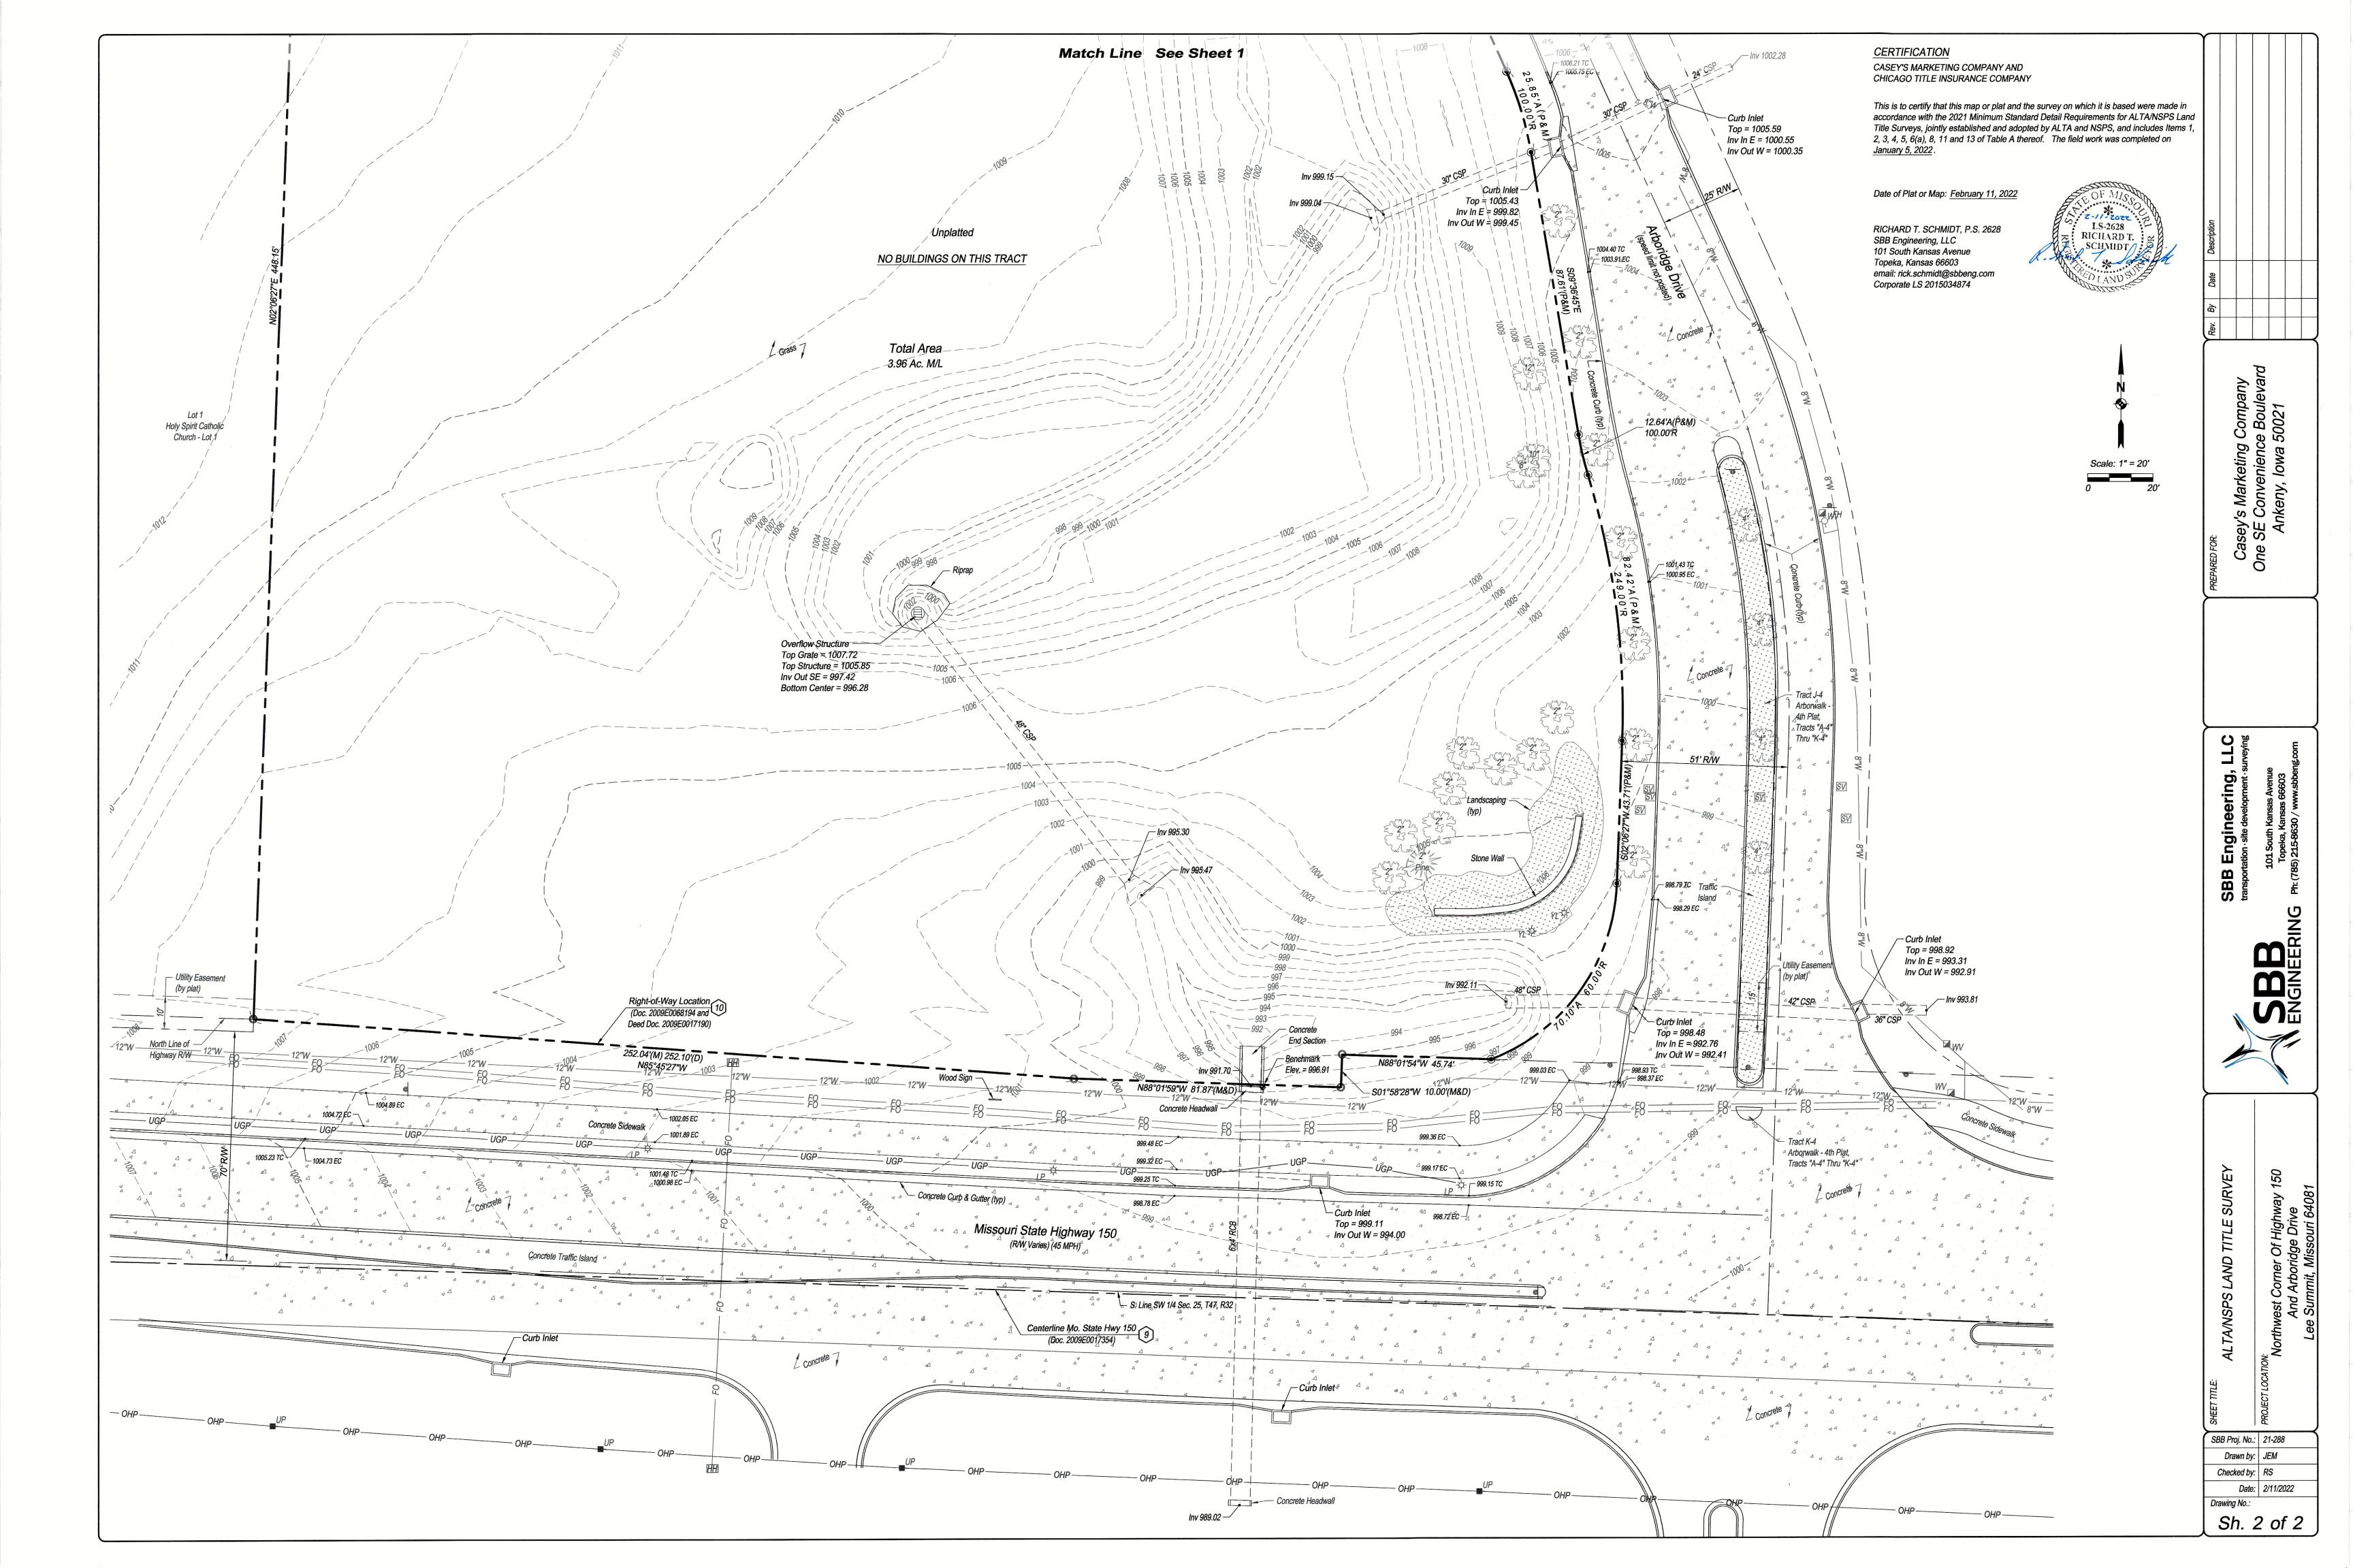
SBB Proj. No.: 21-288
Drawn by: JEM

Drawn by: JEM

Checked by: RS

Date: 2/11/2022

Sh. 1 of 2



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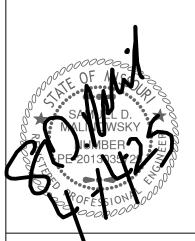
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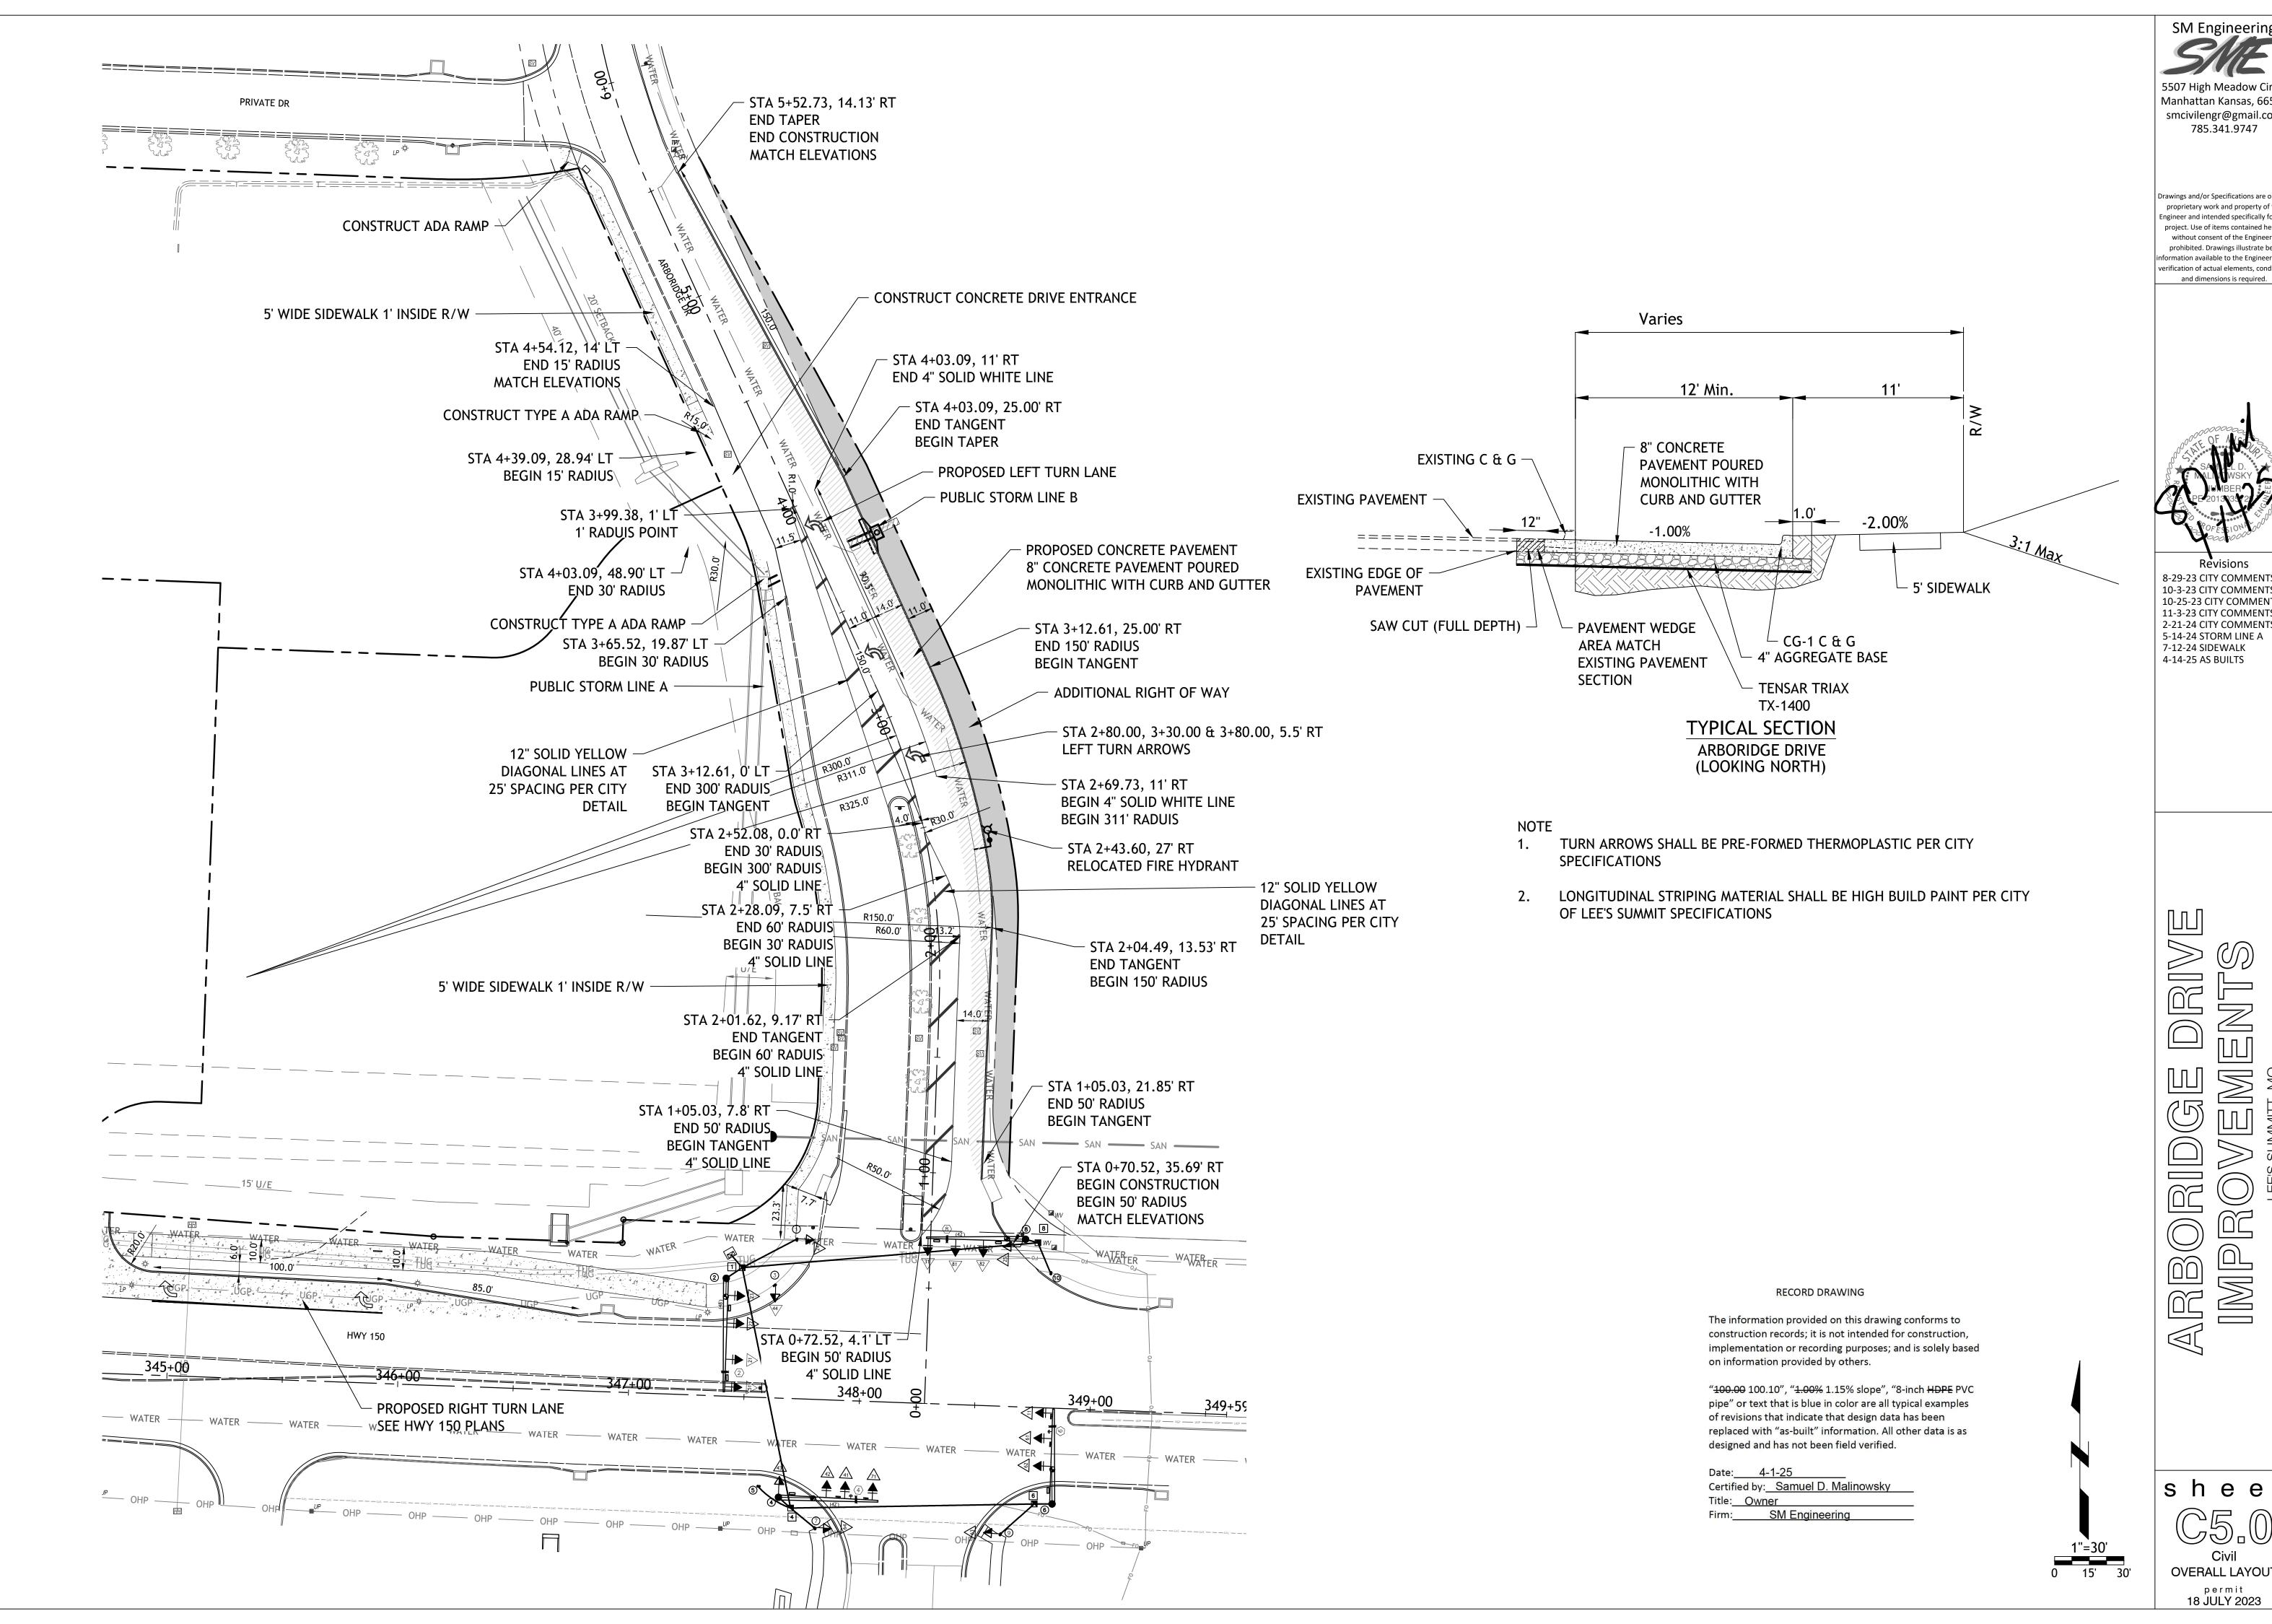
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sheet **DEMOLITION PLAN** permit 18 JULY 2023

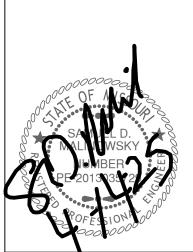
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OVERALL LAYOUT

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GRADING

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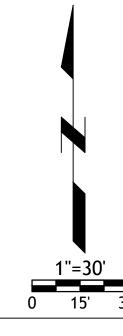
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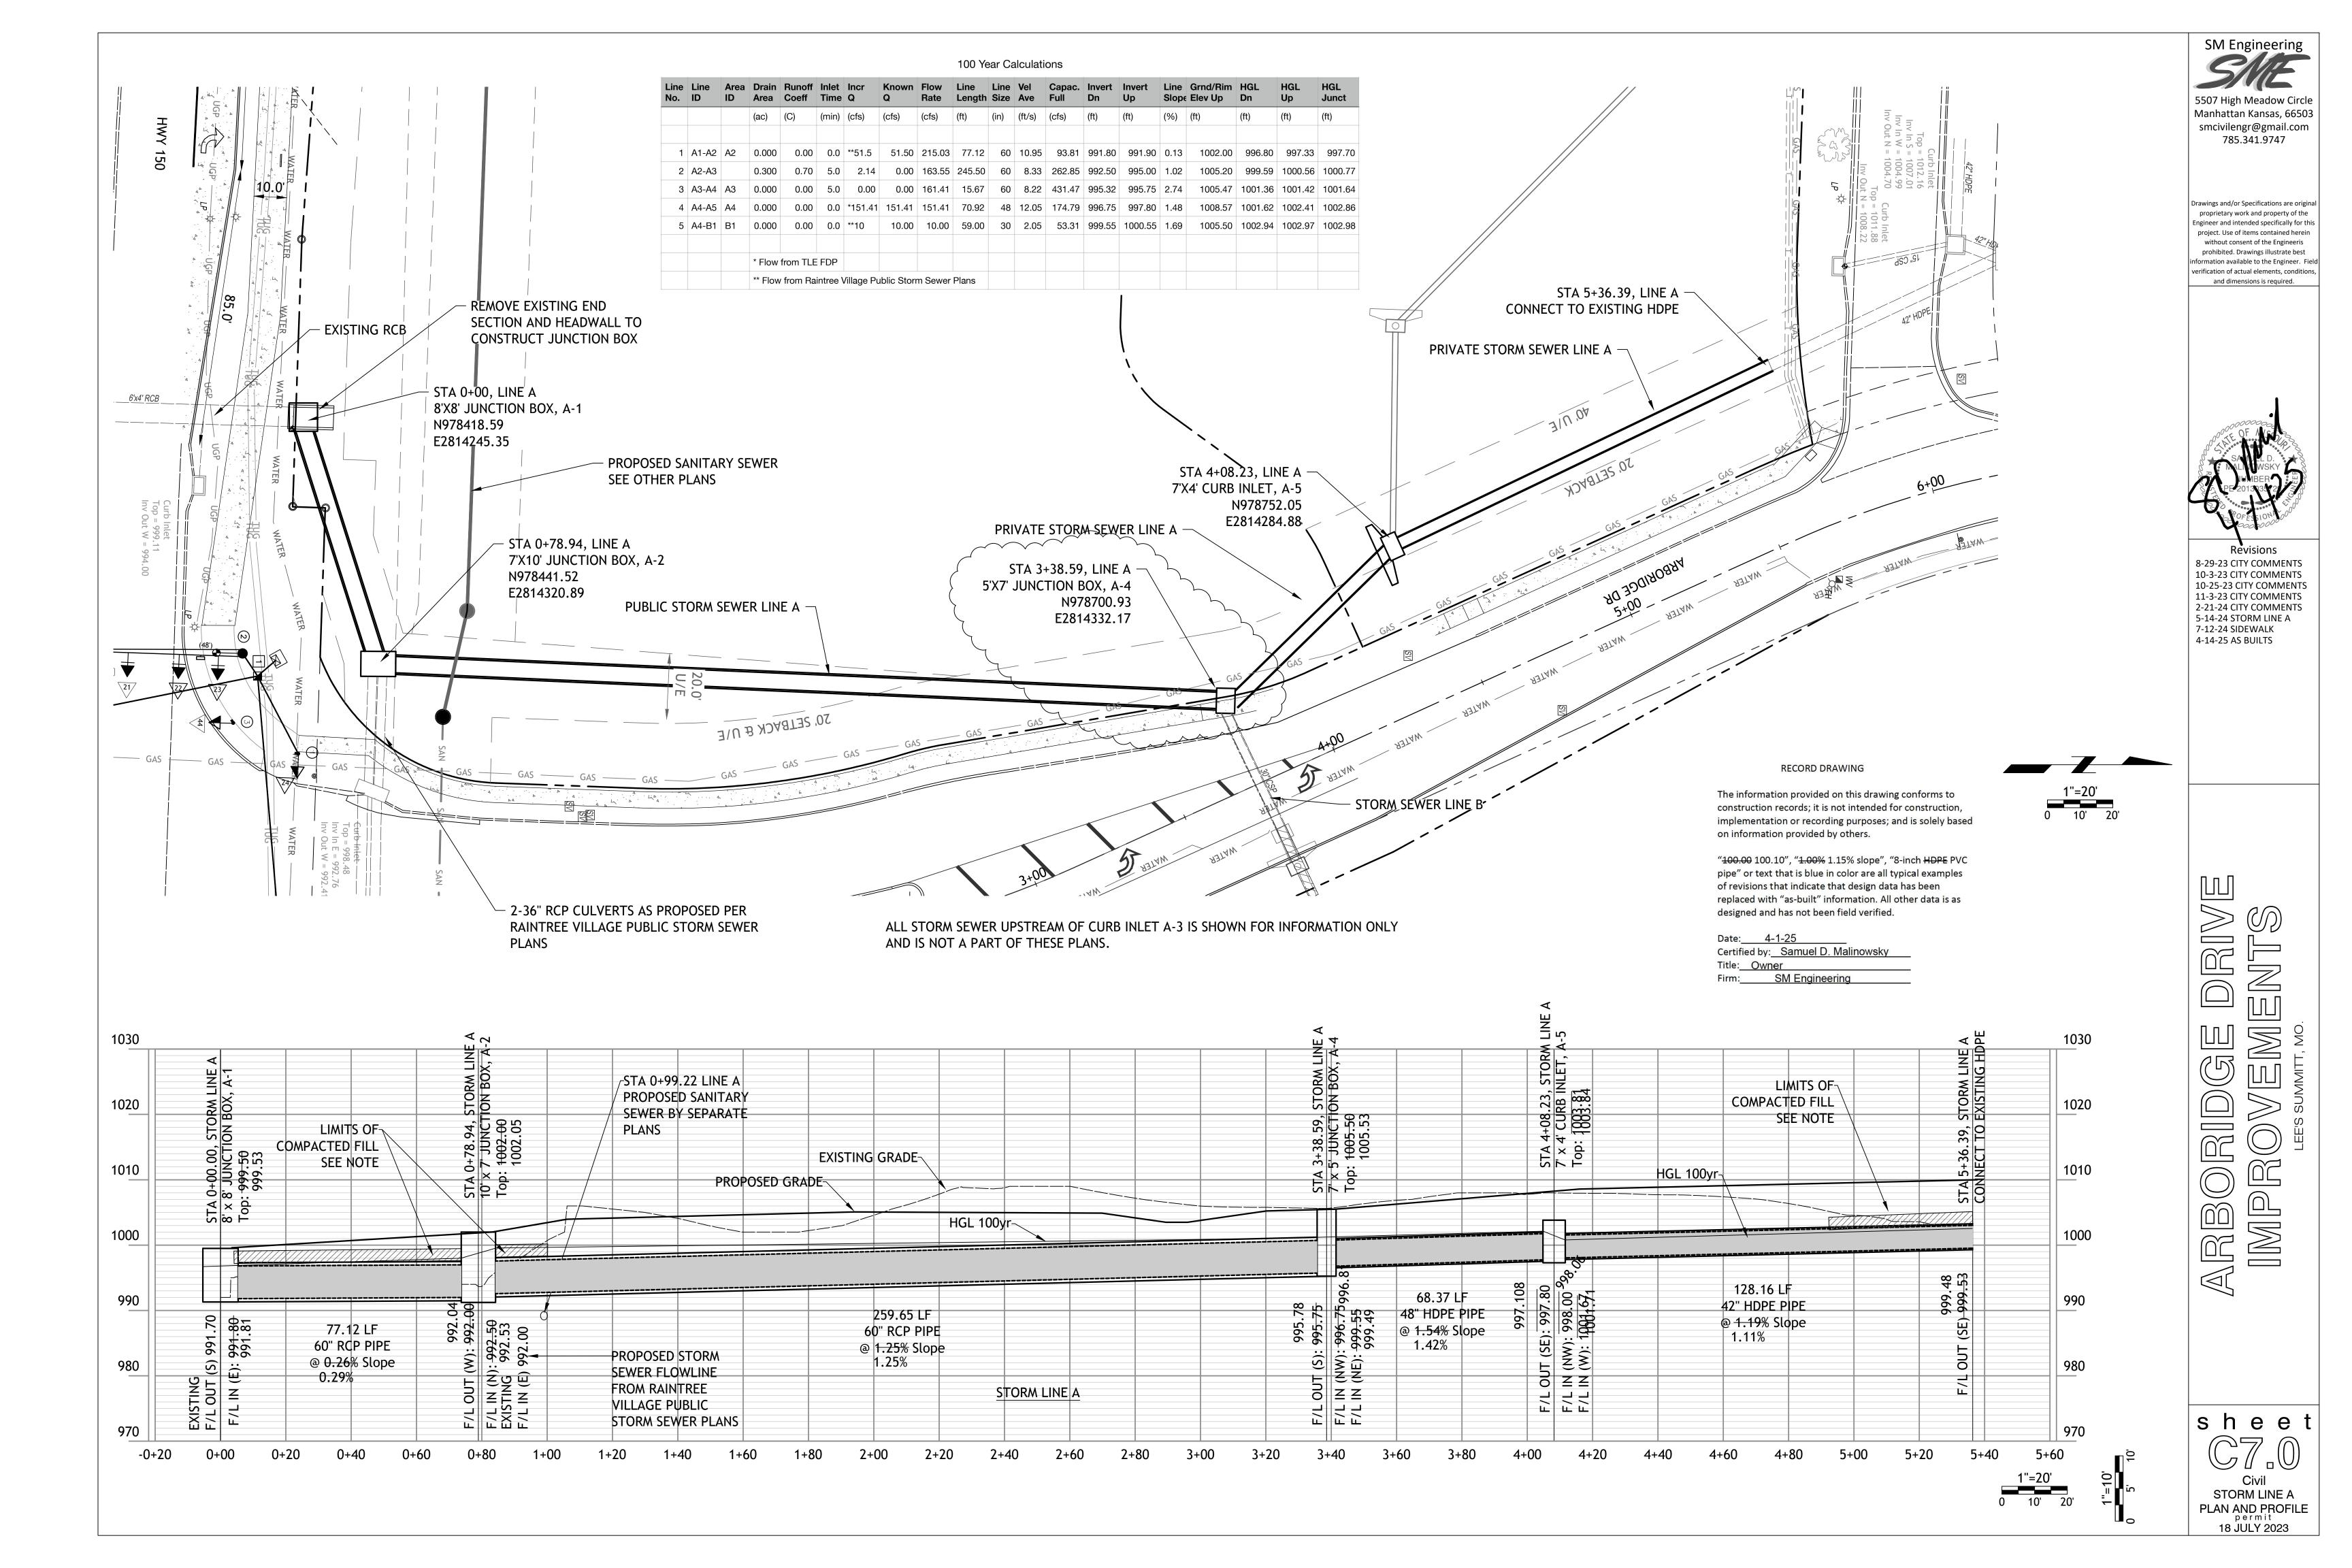
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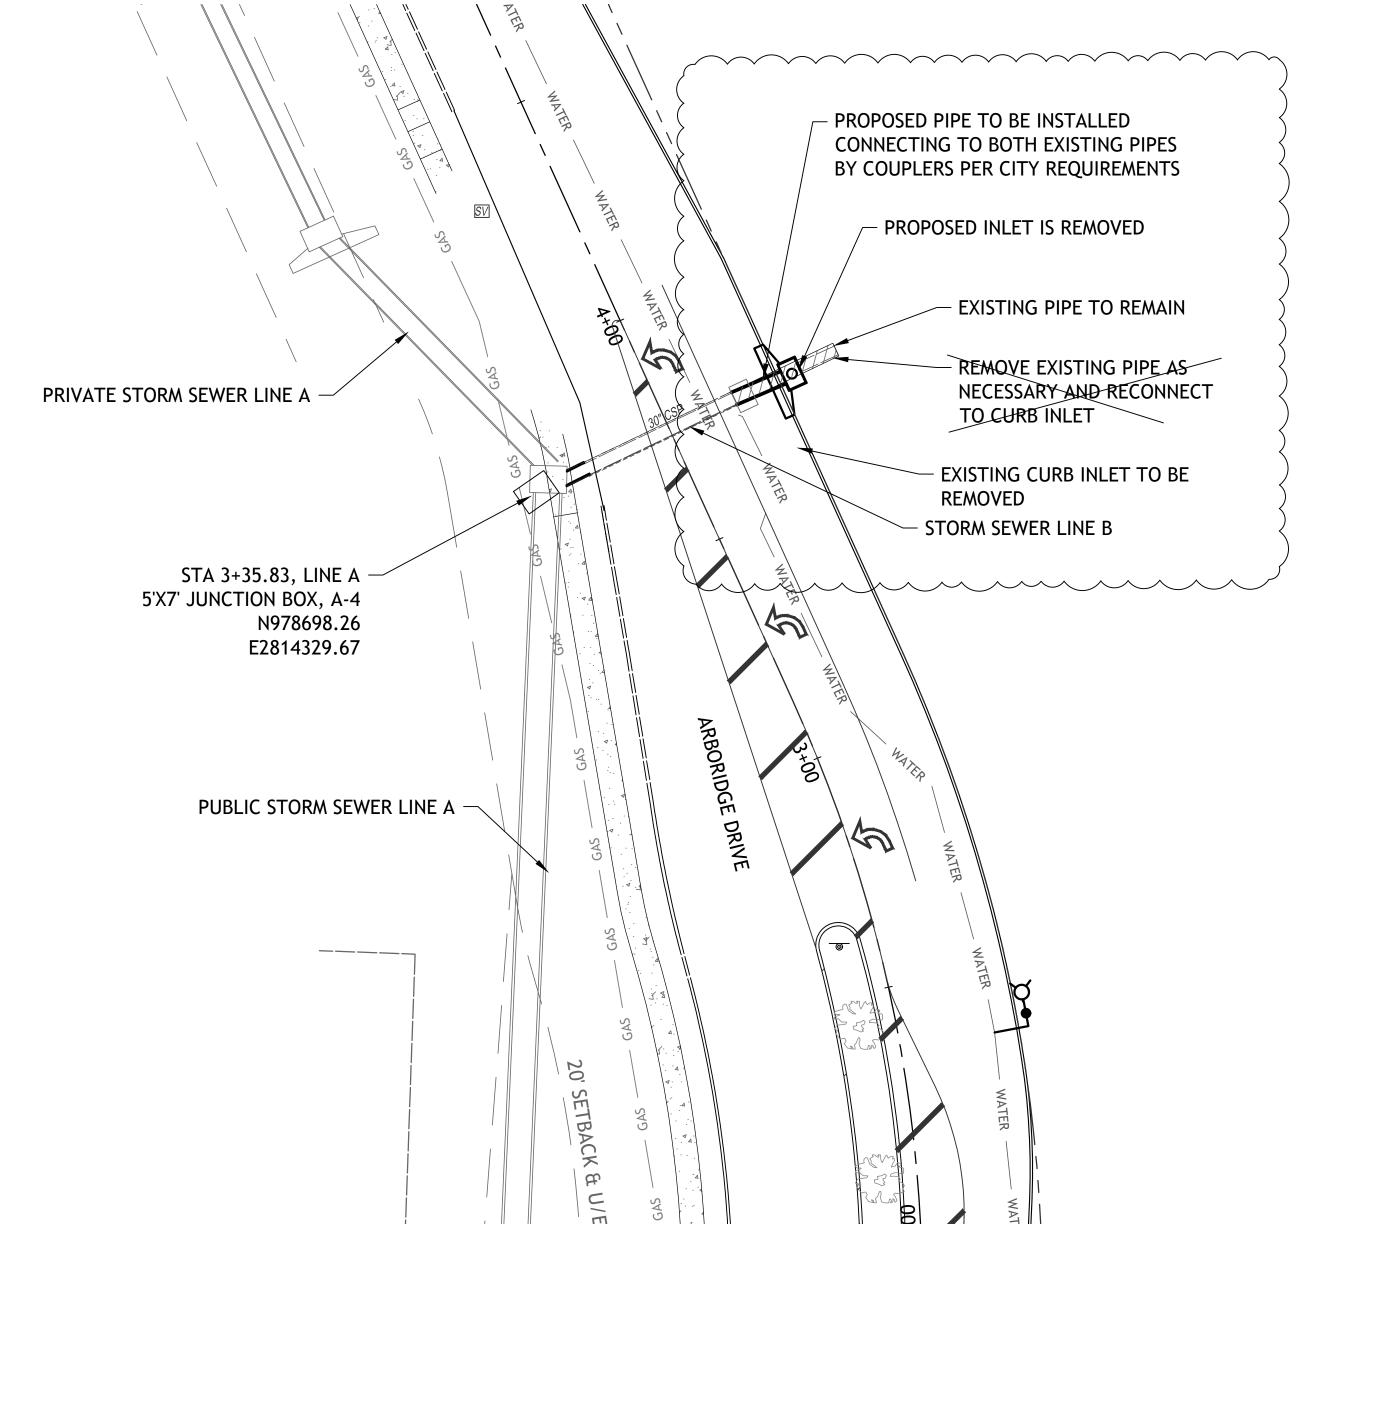
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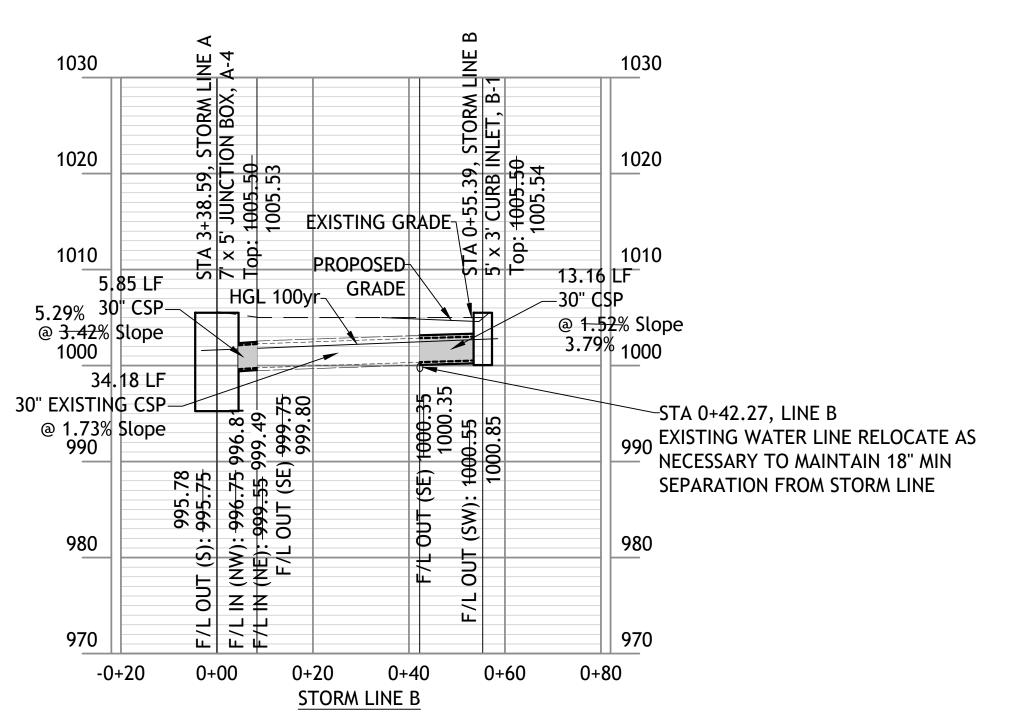
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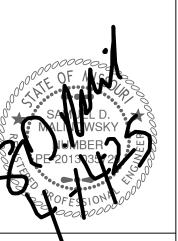




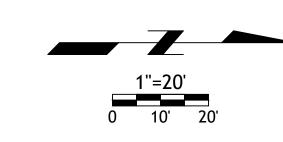


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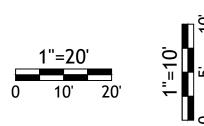
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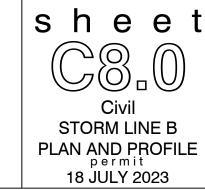
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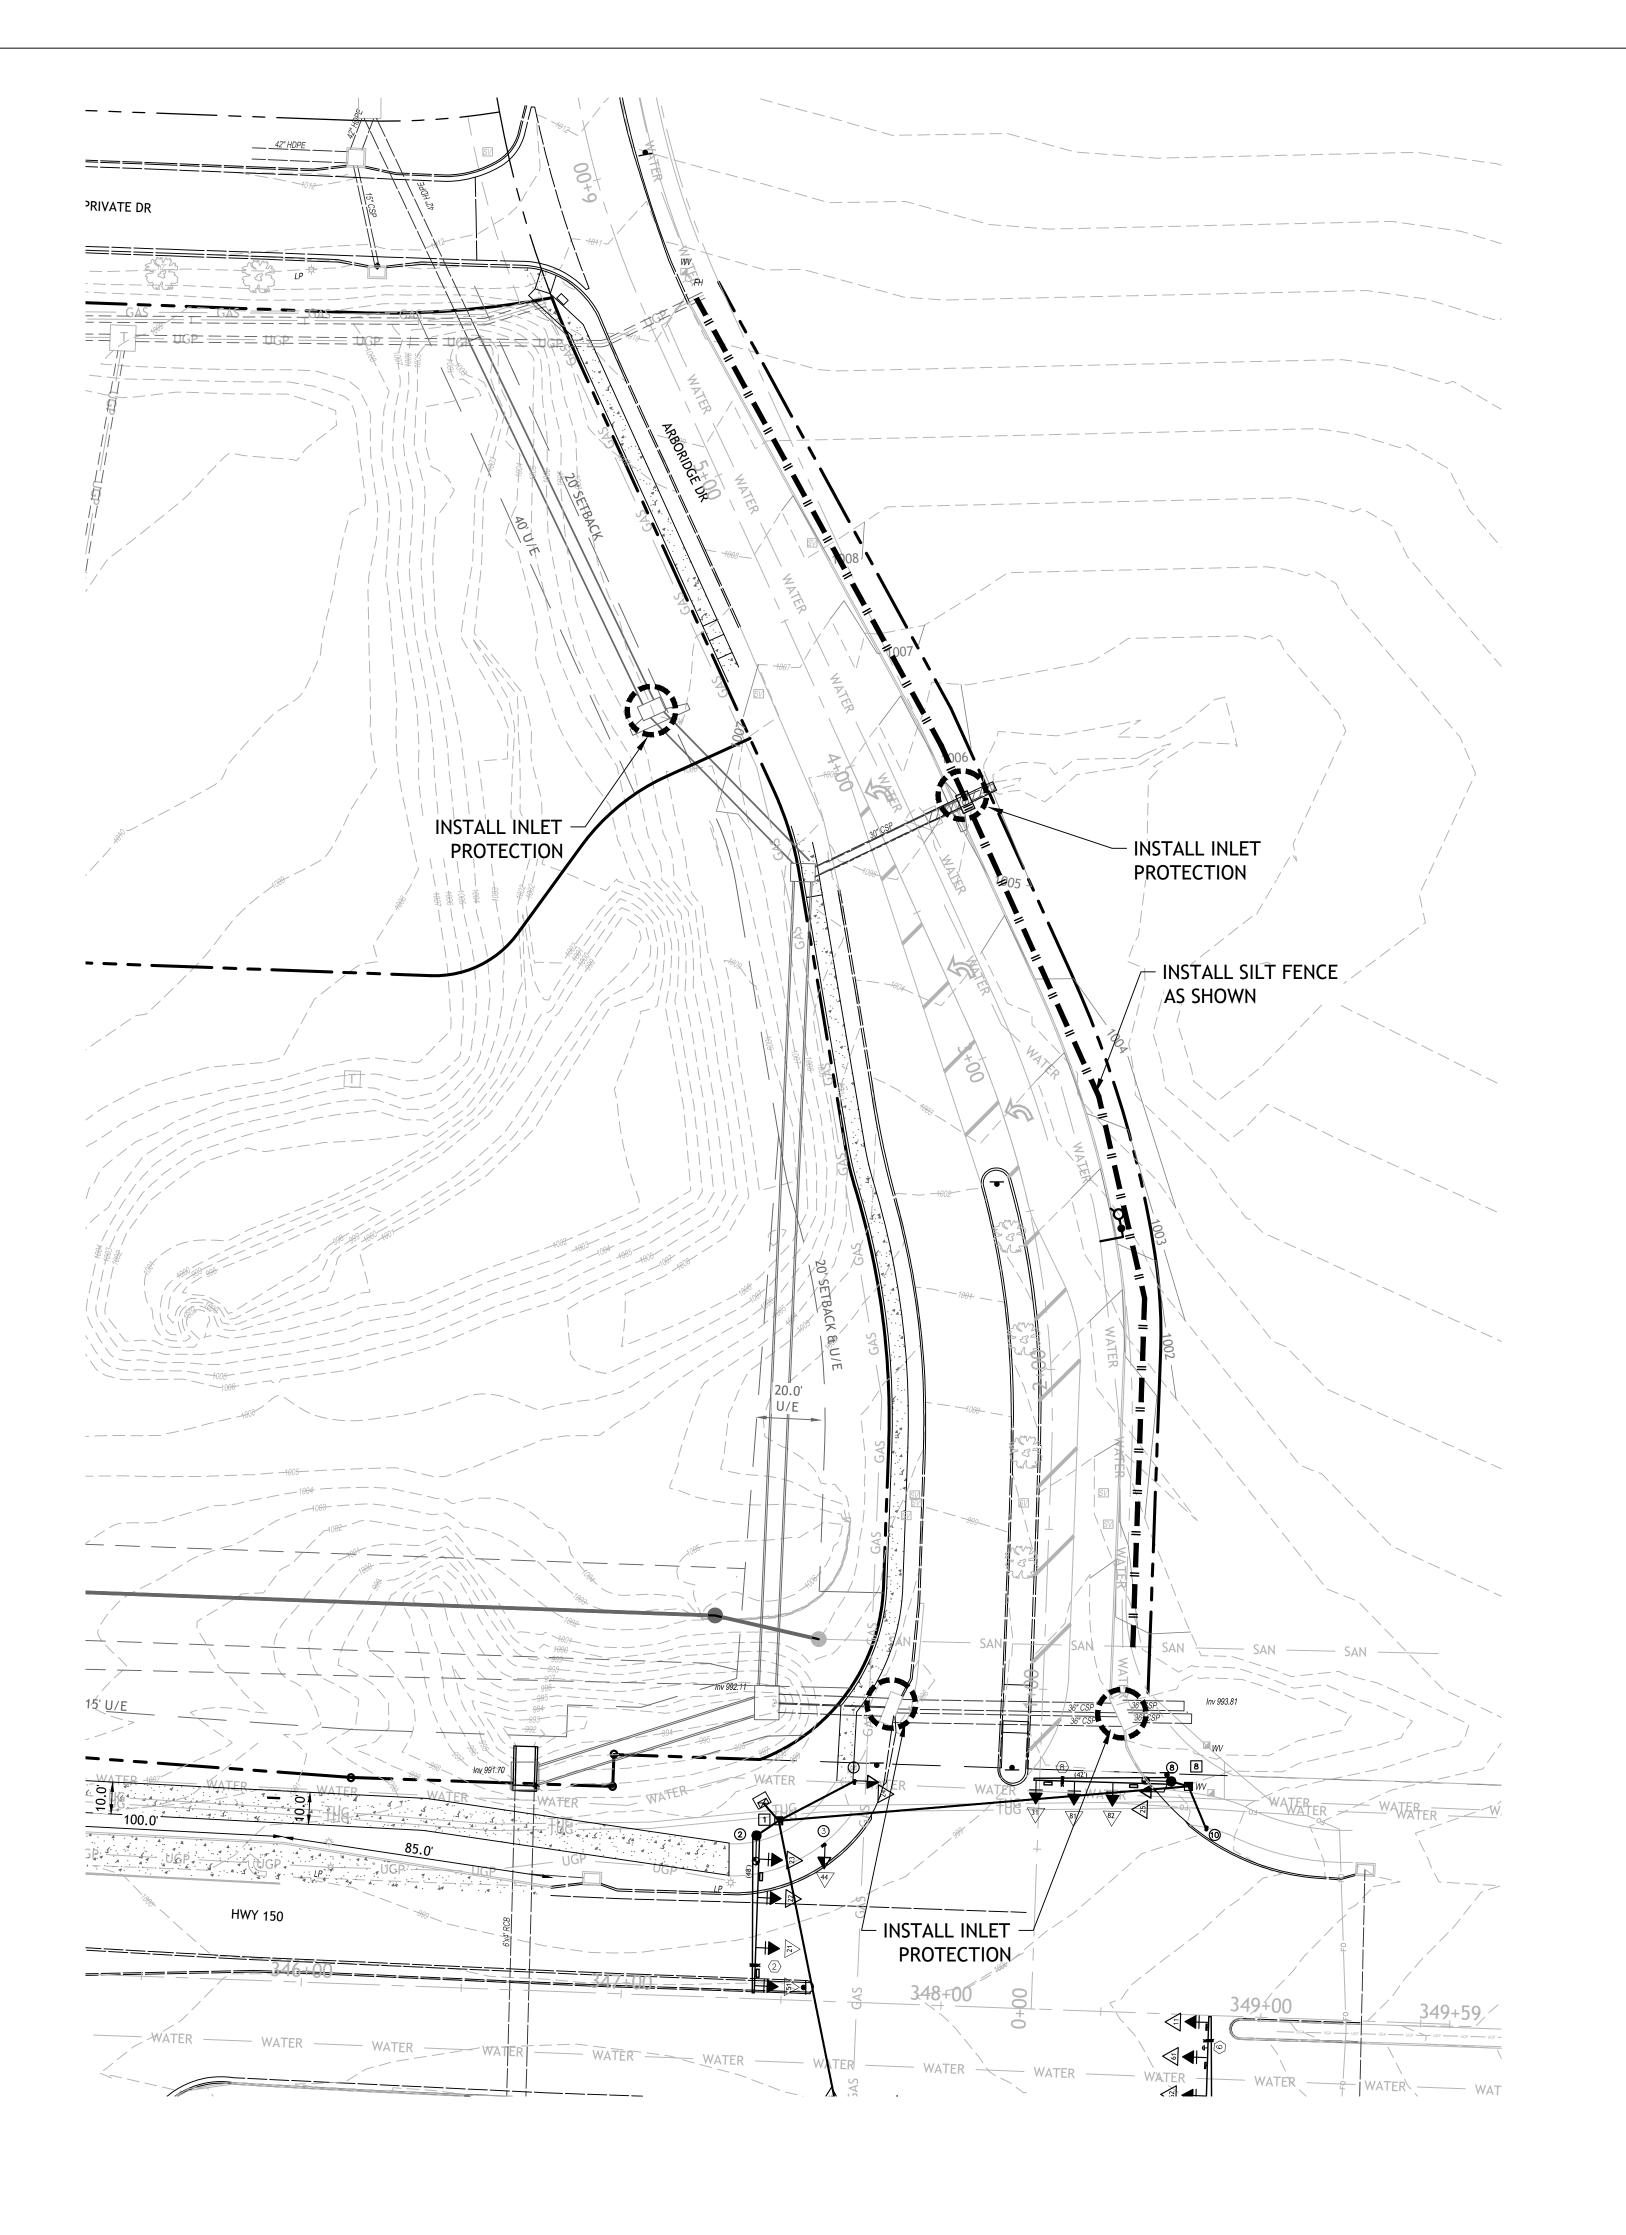
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NOT

Prior to Land Disturbance activities, the following shall occur:

 a) Identify the limits of constructjan on the ground with easily recognizable indications such as construction staking, construction fencing and placement of physical barriers or other means acceptable to the City inspector and in conformance with the erosion and pollution control plan;
 b) Construct a stabilized entrance/parking/staging area;

c) Install perimeter controls and protect any existing stormwater inlets;
d) Request an initial inspection of the installed Phase I

d) Request an initial inspection of the installed Phase pollution control measures designated on the approved erosion and pollution control plan. Land disturbance work shall not proceed until there is a passed inspection

2. The site shall comply with all requirements of the

MoDNR general requirements

a) Immediate initiation of temporary stabilization BMPs on disturbed areas where construction activities have temporarily ceased on that portion of the project site if construction activities will not resume for a period exceeding 14 calendar days.

Temporary stabilization may include establishment of vegetation, geotextiles, mulches or other techniques to reduce or eliminate erosion until either final stabilization con be achieved or until further construction activities take place to re-disturb the area. This stabilization must be completed within 14 calendar days;

b) Inspection of erosion and sediment control measures shall be performed to meet or exceed the minimum inspection frequency in the MoDNR General Permit. At a minimum, inspections shall be performed during all phases of construction at least once every 14 days and within 24 hours of each precipitation

c) An inspection log shall be maintained and shall be available for review by the regulatory authority;
d) The erosion and pollution control plan shall be routinely updated to show all modifications and amendments to the original plan. A copy of the erosion and pollution control plan shall be kept on site and made available for review by the regulatory authority.

3. Temporary seeding shall only be used for periods not to exceed 12 months. For final stabilization. temporary seeding shall only be used to establish vegetation outside the permanent seeding or sodding dates as specified in the Standard Specifications. Final stabilization requires a uniform perennial vegetative cover with a density of 70% over 100% of disturbed area.

4. Erosion and pollution control shall be provided for the duration of a project. All installed erosion and pollution control BMPs shall be maintained in a manner that preserves their effectiveness. If the City determines that the BMPs in place do not provide adequate erosion and pollution control at any time during the project, additional or alternate measures that provide effective control shall be required.

5. Concrete wash or rinse water from concrete mixing equipment. Tools and/or ready-mix trucks. etc. may not be discharged into or be allowed to run to any existing water body or portion of the storm water system. One or more locations for concrete washout will be designated on site, such that discharges during concrete washout will be contained in a small area where waste concrete can solidify in place. Proper signage will be installed to direct users to the concrete washout. Concrete washouts must be handled prior to pouring any concrete.

6. Silt fences and sediment control BMPs which are shown along the back of curb must be installed within two weeks of curb backfill and prior to placement of base asphalt. Exact locations of these erosion control methods may be field adjusted to minimize conflicts with utility construction. However, anticipated disturbance by utility construction shall not delay installation.

7. Required sediment basins and traps shall be installed as early as possible during mass grading. Sediment basins and traps shall be cleaned out when the sediment capacity has been reduced by 20% of its original design volume.

8. All manufactured BMPs such as erosion control blankets, TRMs, biodegradable logs, filter socks, synthetic sediment barriers and hydraulic erasion control shall be installed as directed by the manufacturer.

9. The above requirements are the responsibility of the permittee for the site. Responsibility may be transferred to another party by the permittee, but the permittee shall remain liable by the City of Lee's Summit if any of the above conditions are not met.

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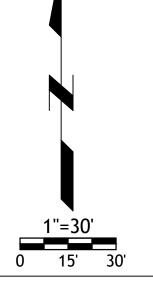
EROSION CONTROL NOTES

- 1. PROTECT ALL STORM INLETS AND DRAINAGE CONVEYANCE FROM CONSTRUCTION DEBRIS AND SEDIMENT
- 2. DO NOT WASH CONCRETE TRUCKS INTO THE STORM SYSTEM.
- 3. DO NOT ALLOW SEDIMENT TO LEAVE CONSTRUCTION SITE.
- 4. KEEP ALL ROADS FREE FROM CONSTRUCTION DEBRIS AND SEDIMENT.

LEGEND

SILT FENCE

ET PROTECTION



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ARBORIDGE DRIVE IMPROVEMENTS

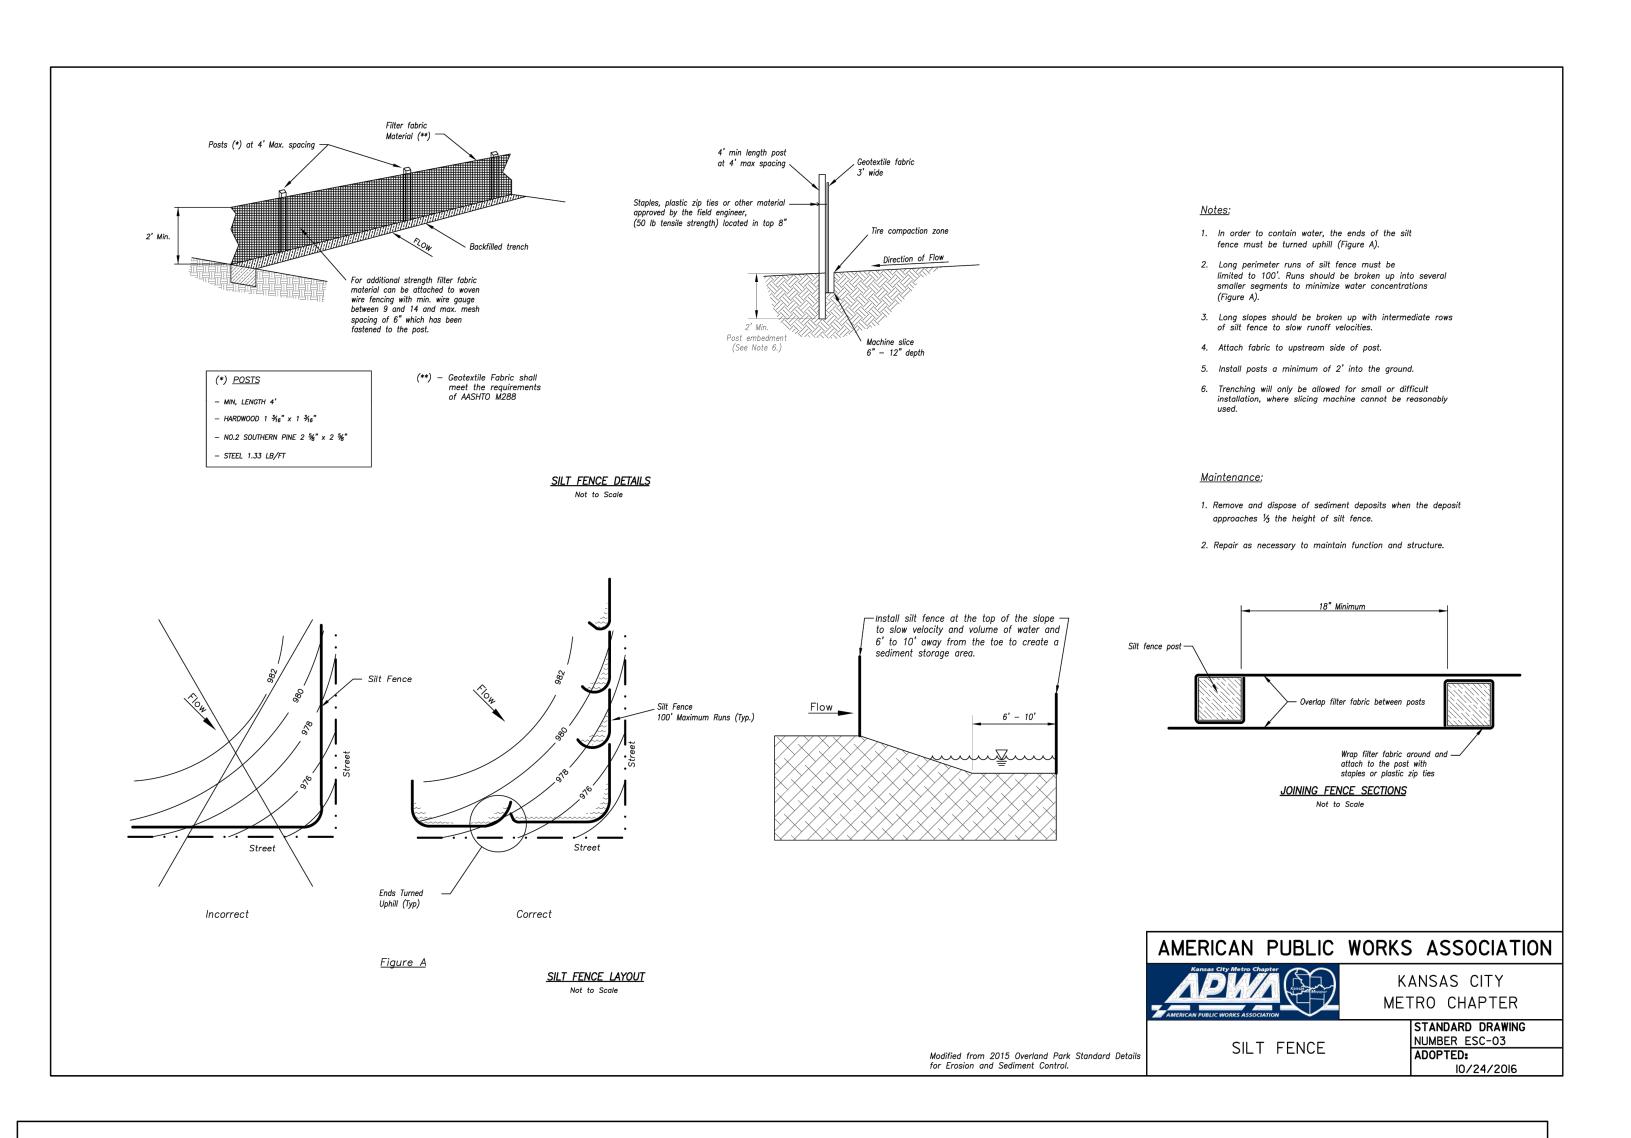
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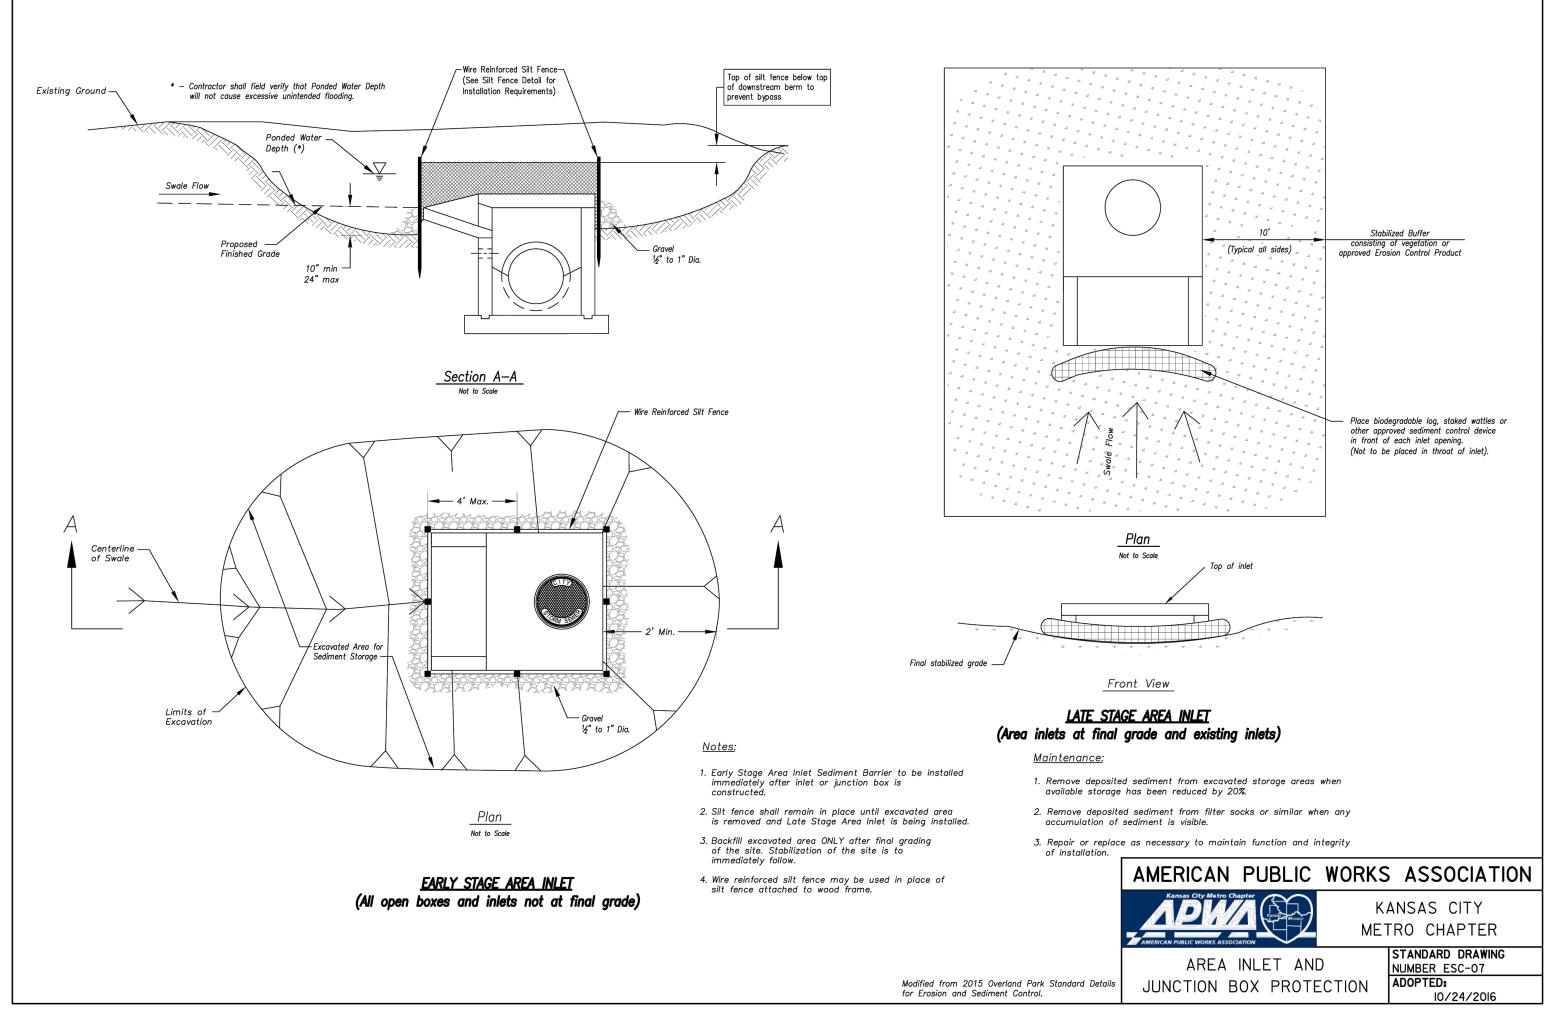
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EROSION CONTROL

permit

18 JULY 2023

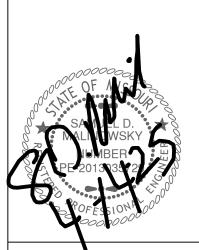




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ARBORIDGE DRIVE IMPROVEMENTS

RECORD DRAWING

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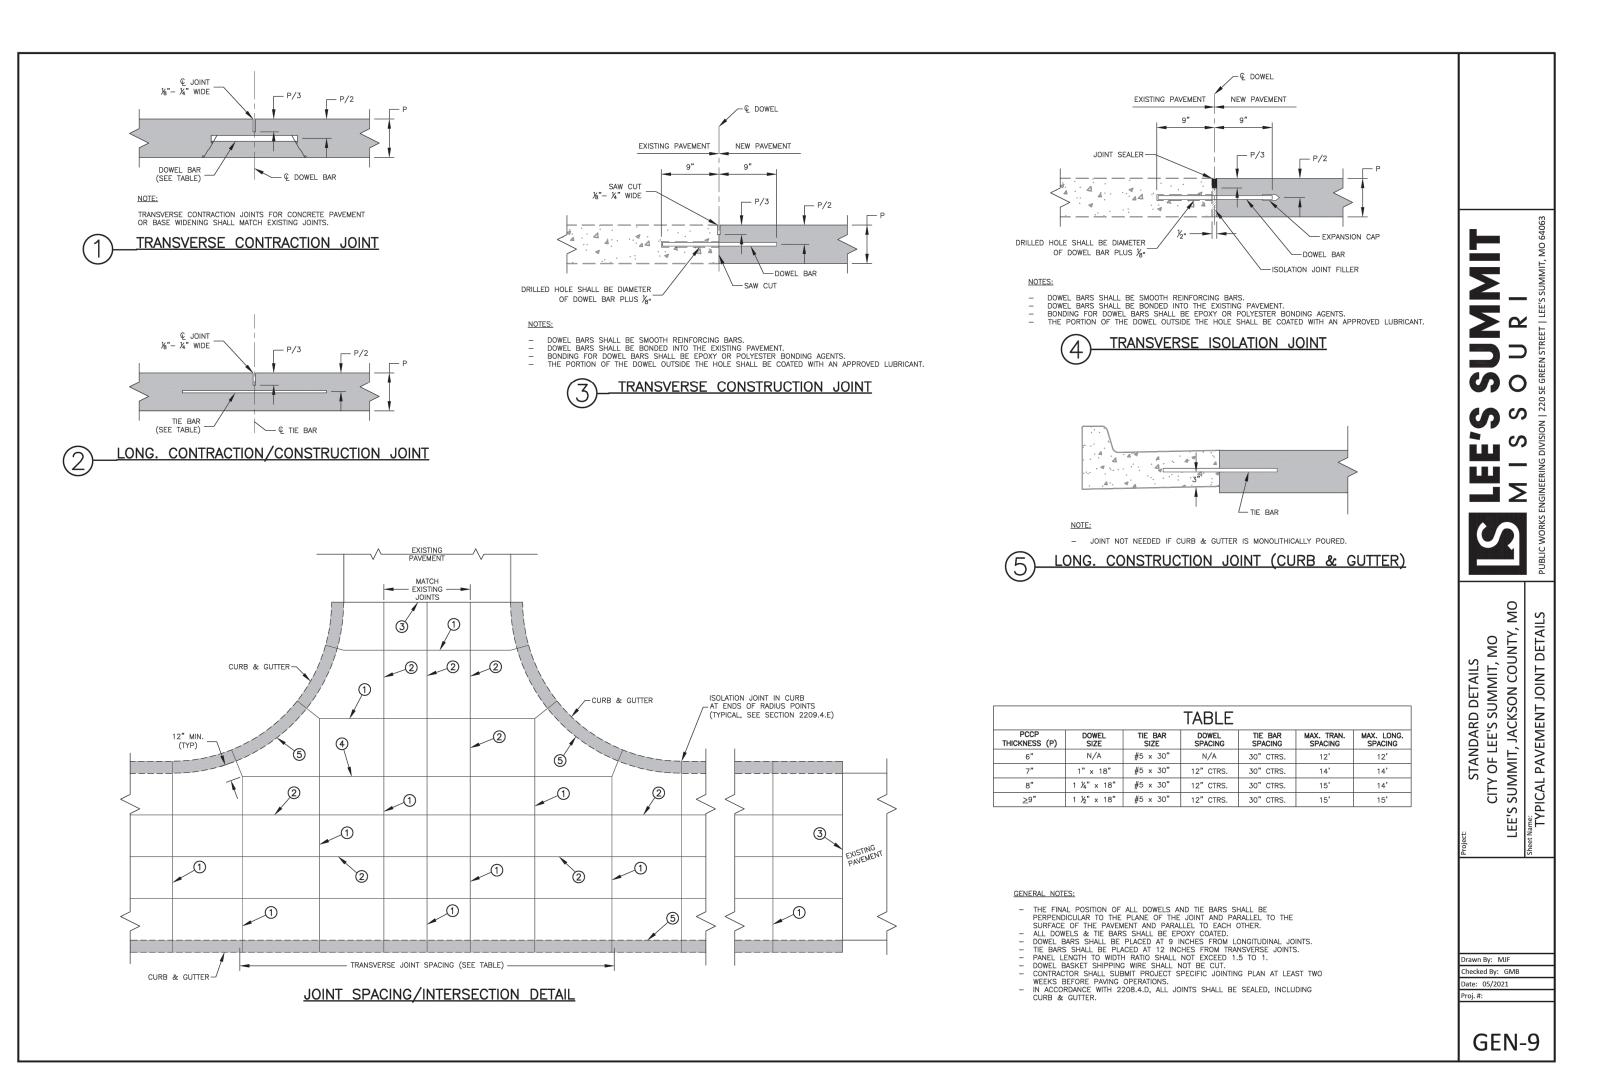
replaced with "as-built" information. All other data is as

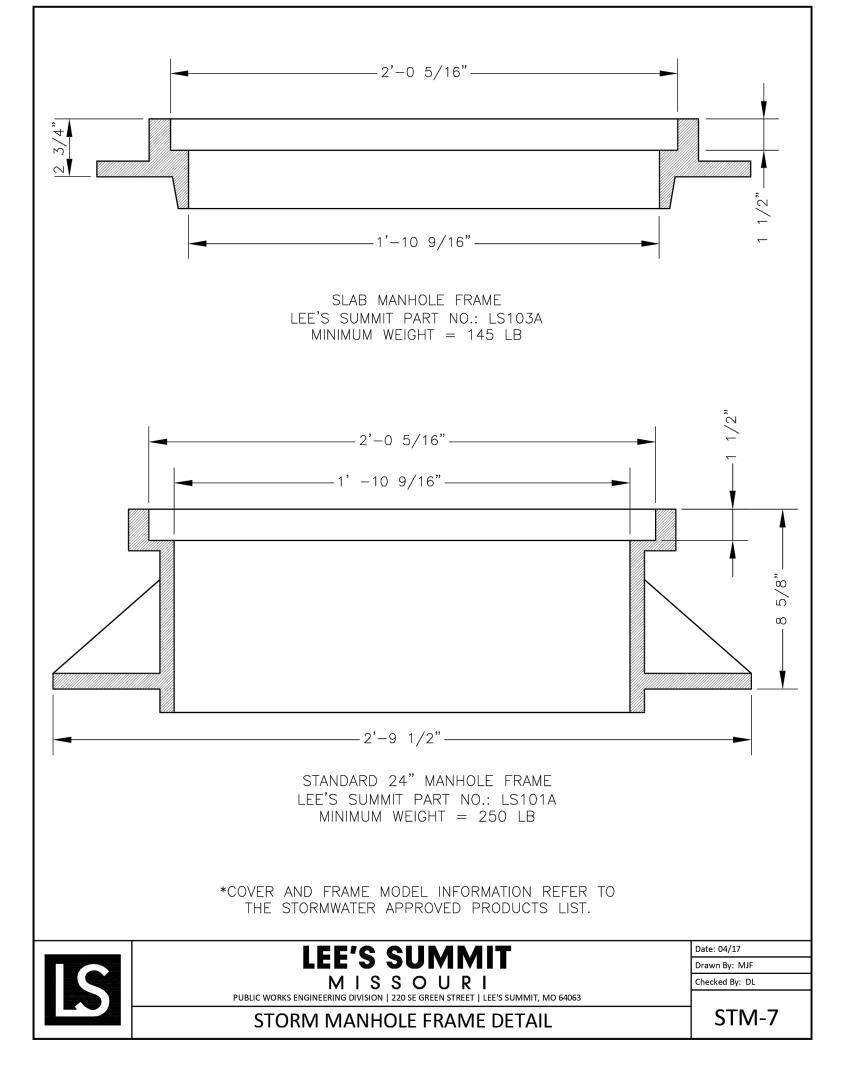
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Civil EROSION DETAILS

18 JULY 2023





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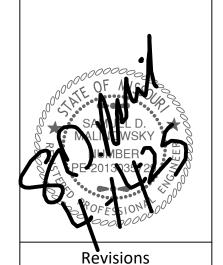
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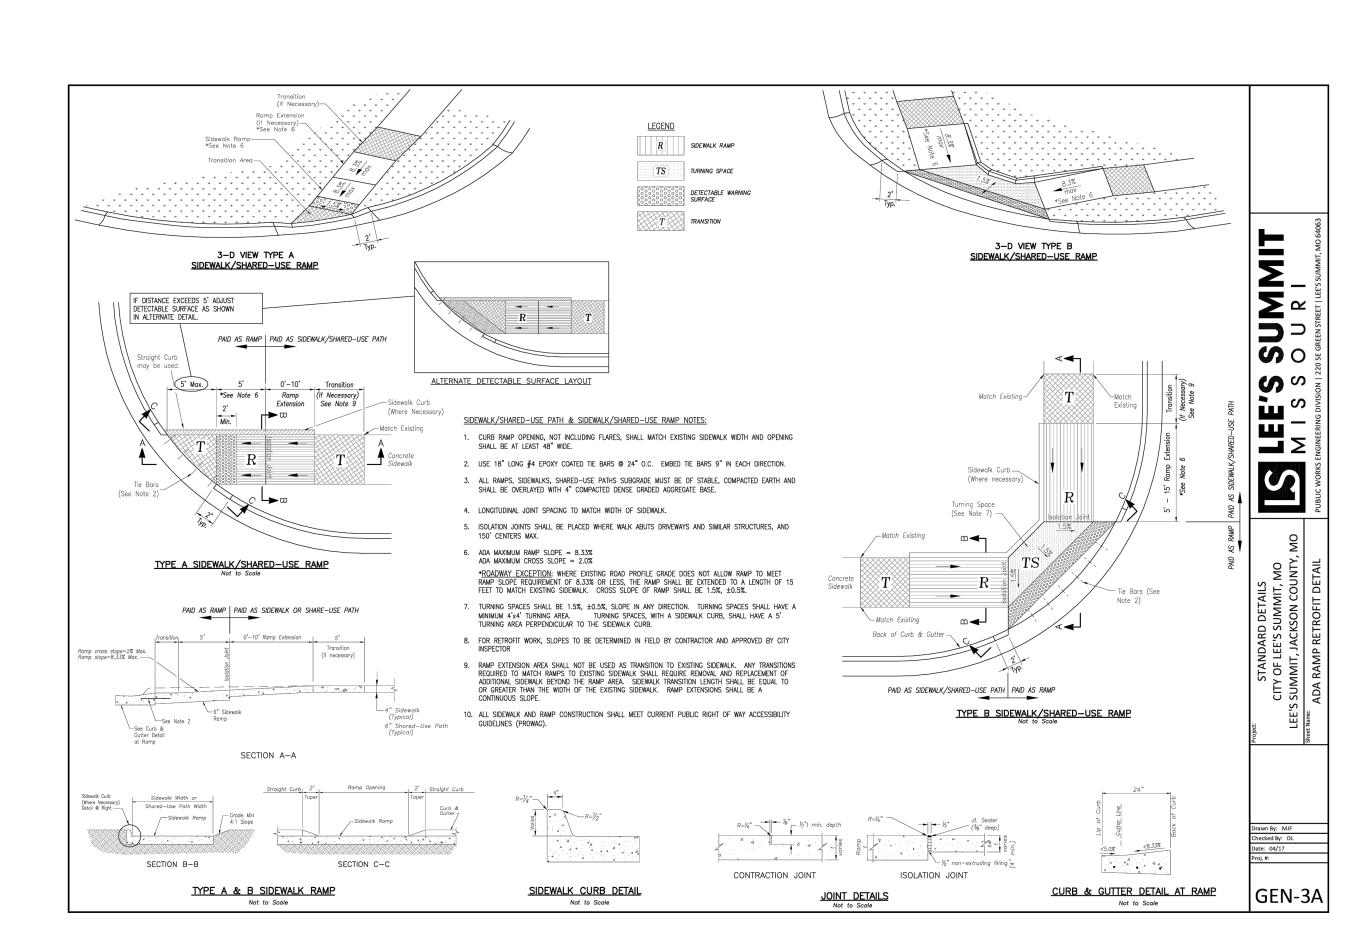
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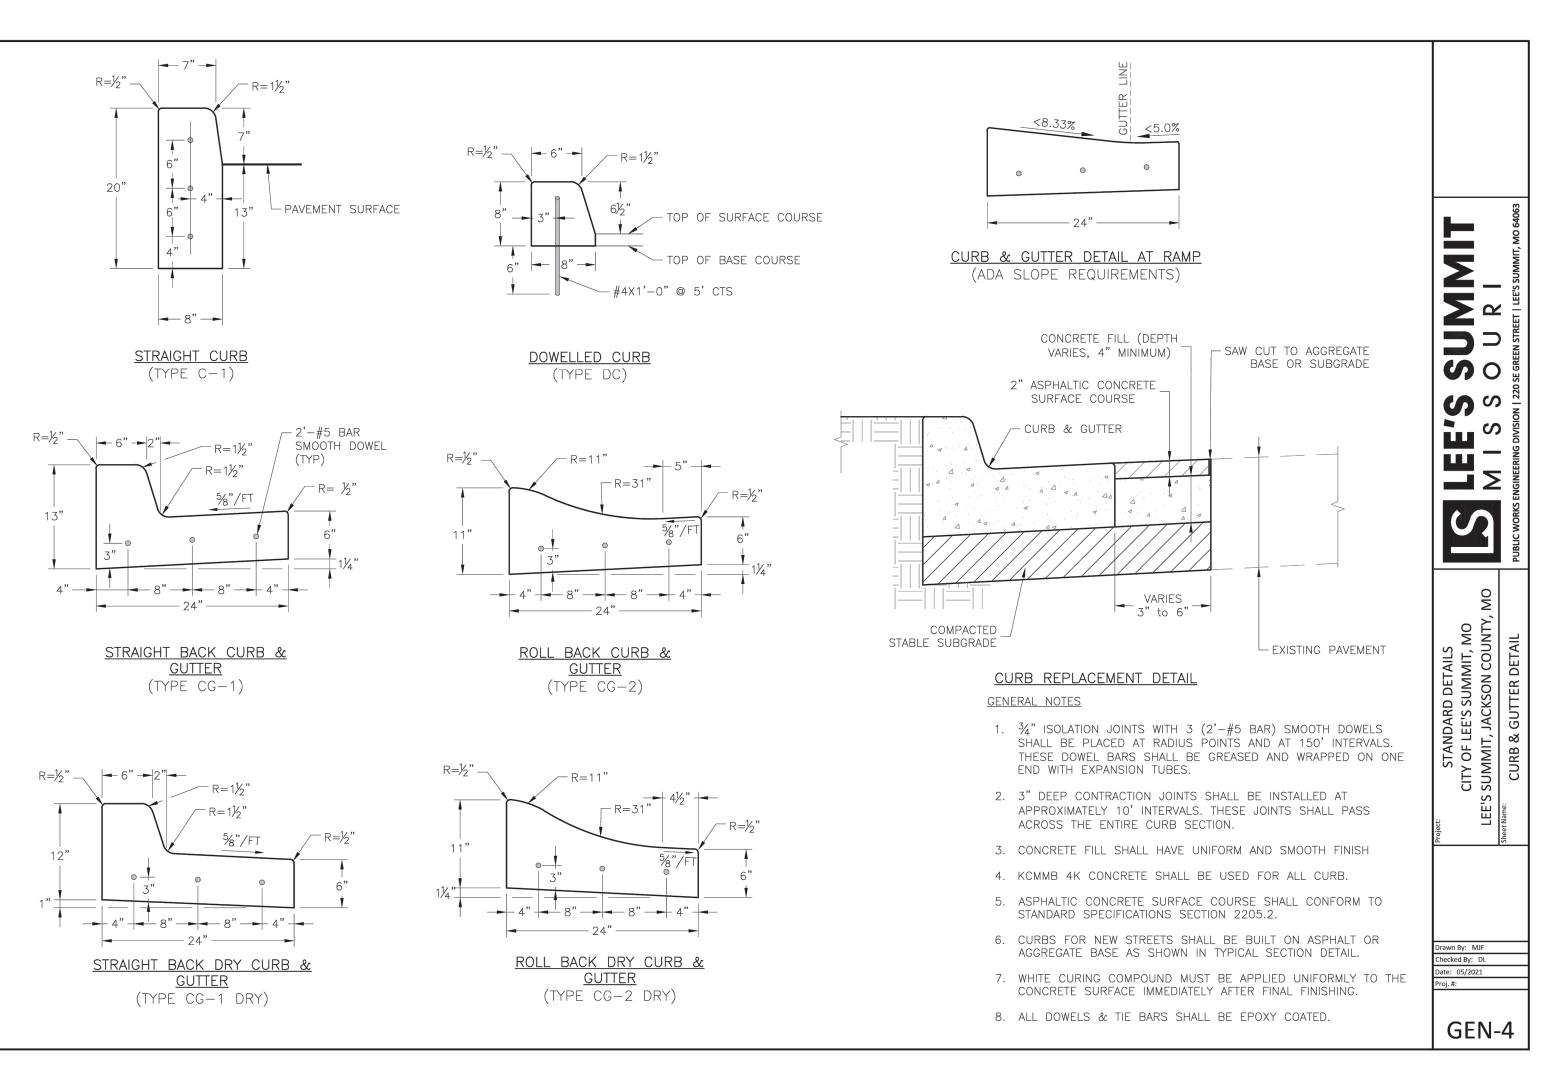
smcivilengr@gmail.com

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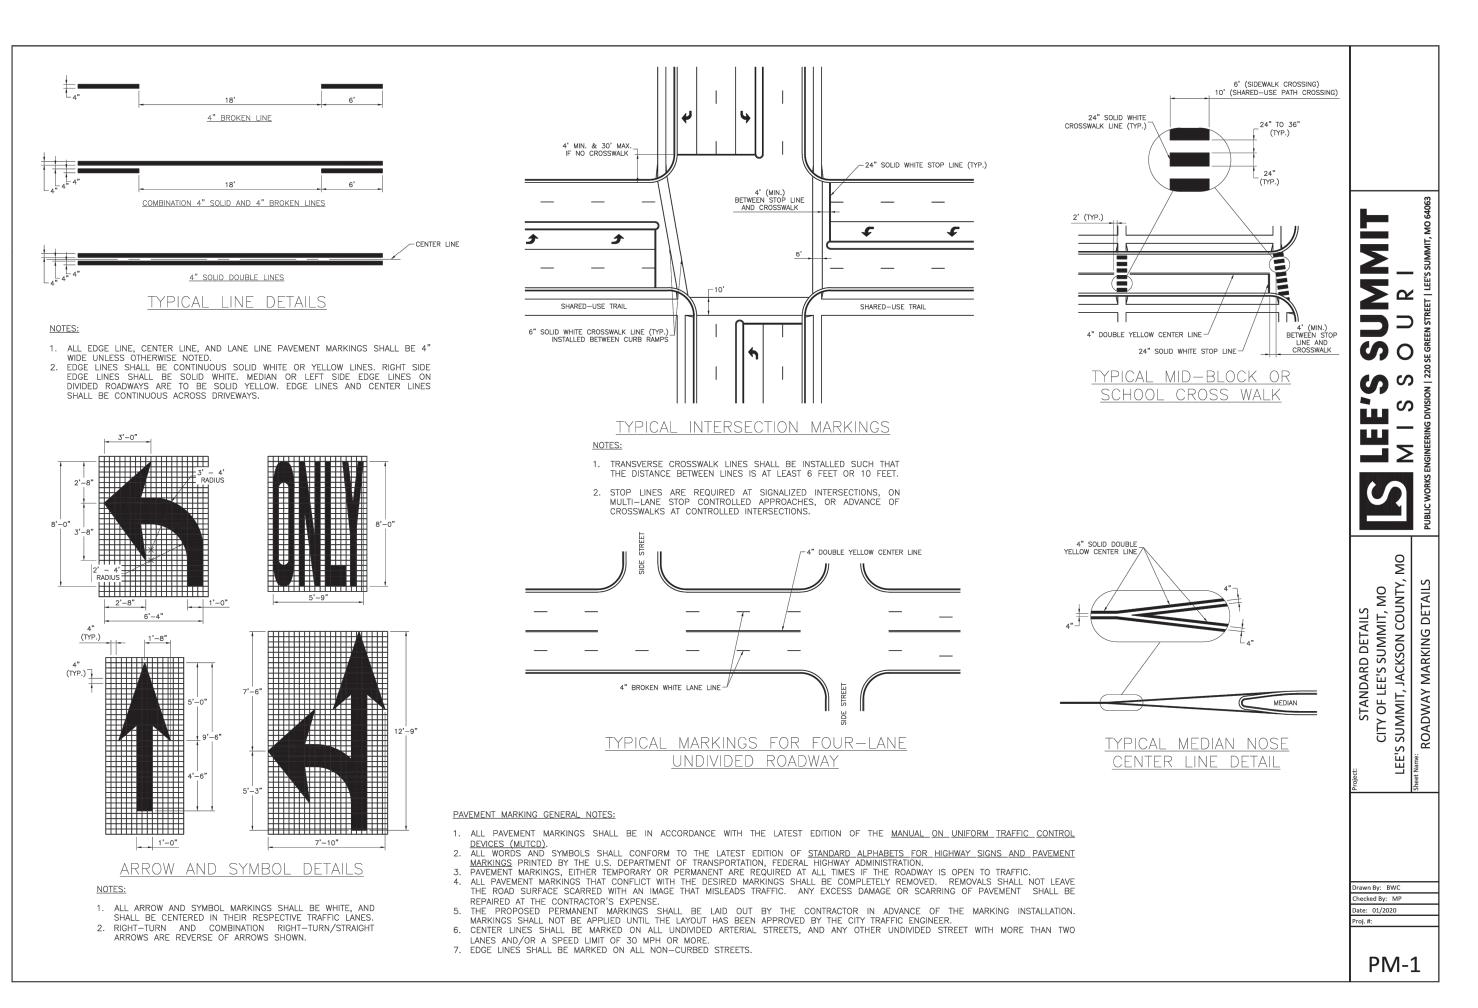


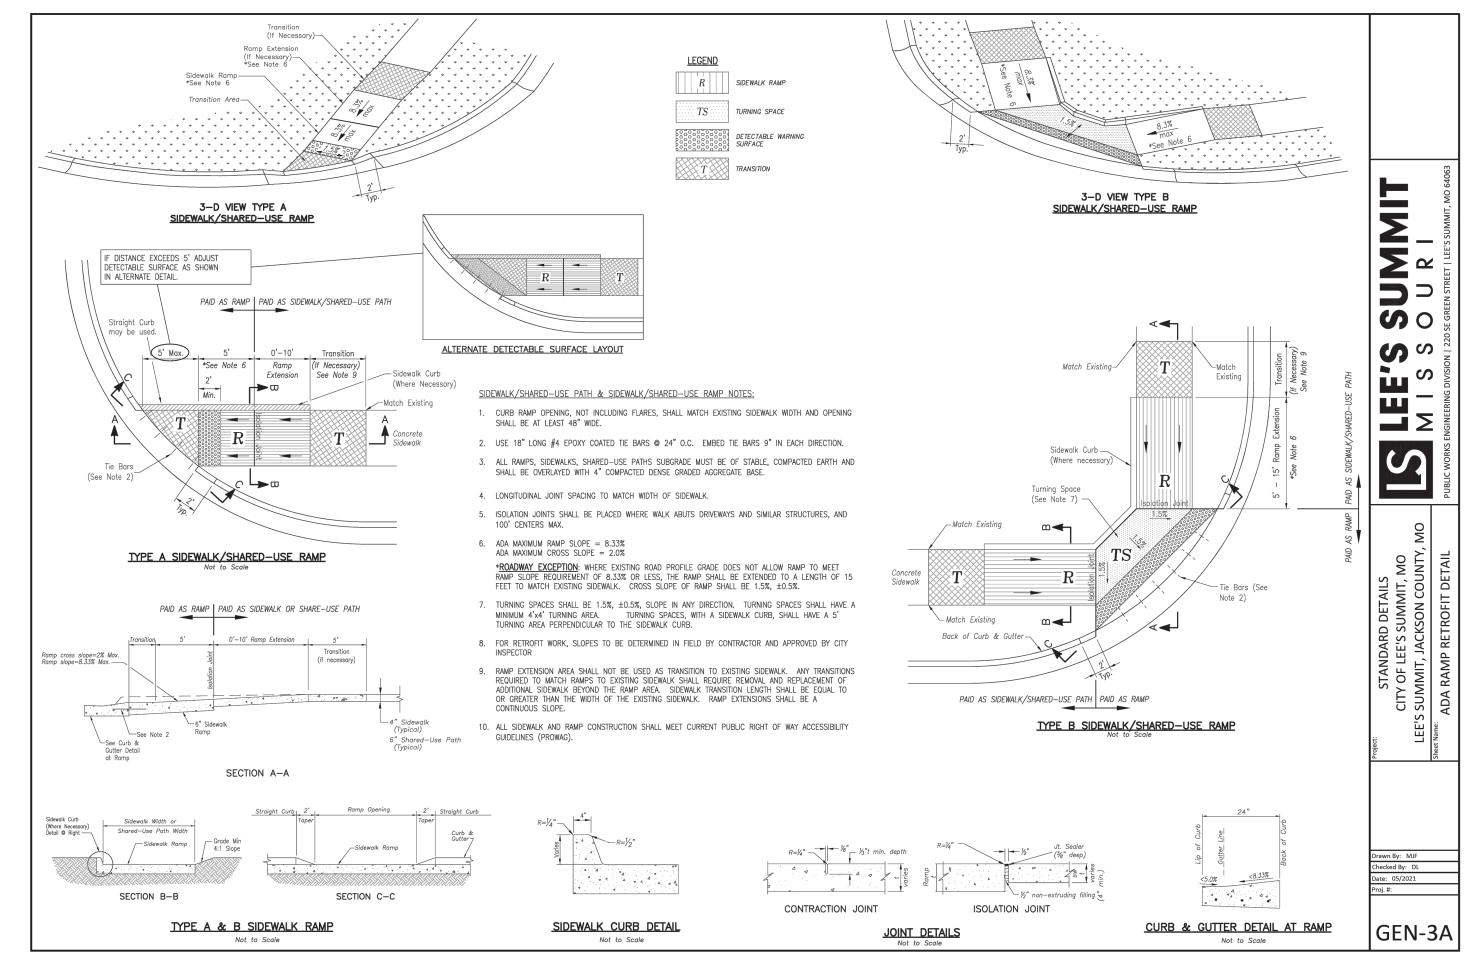


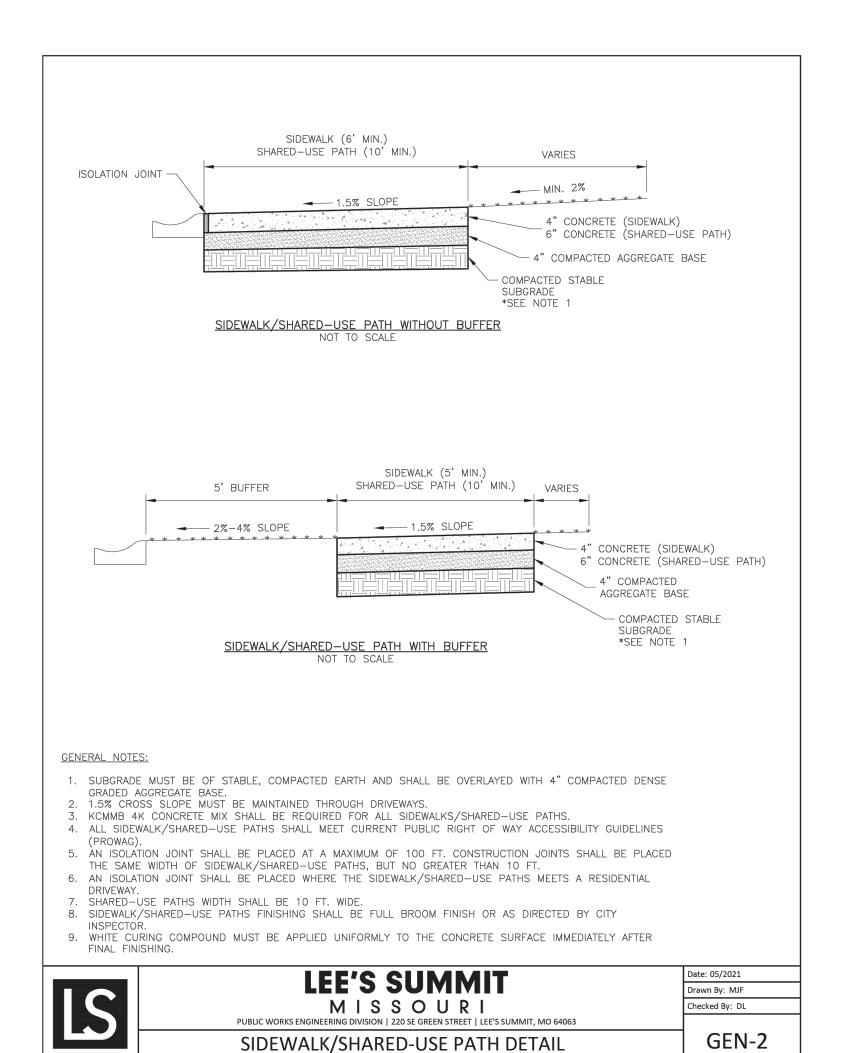
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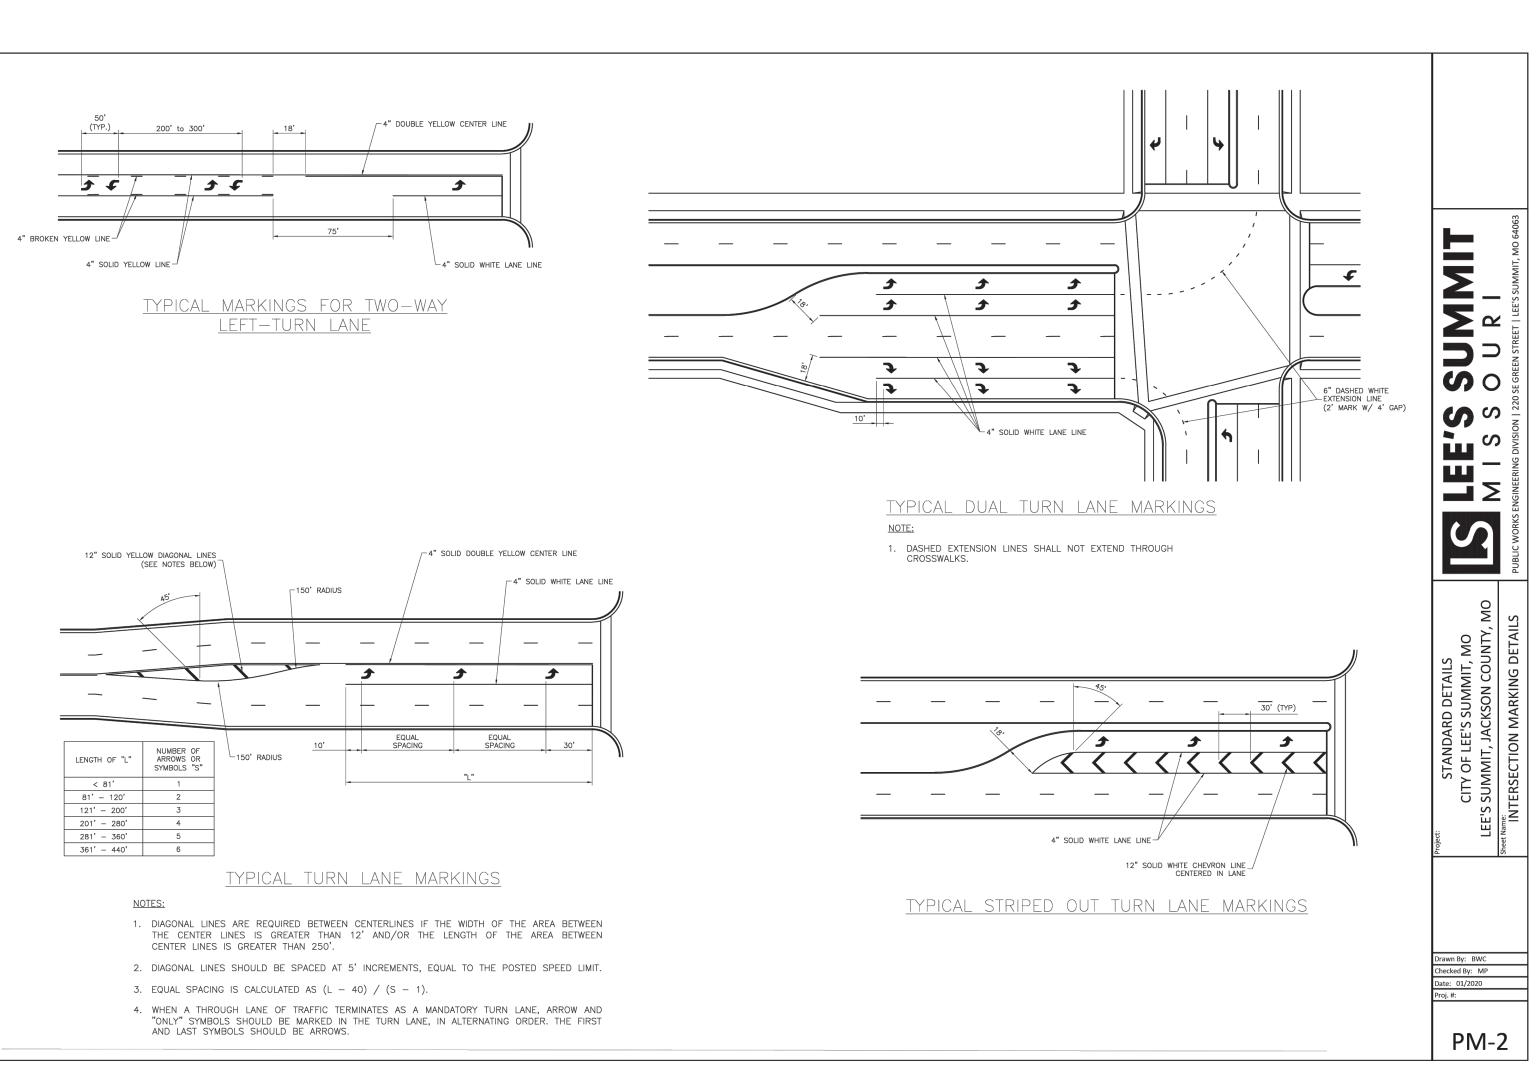
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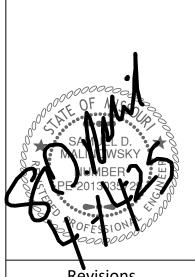
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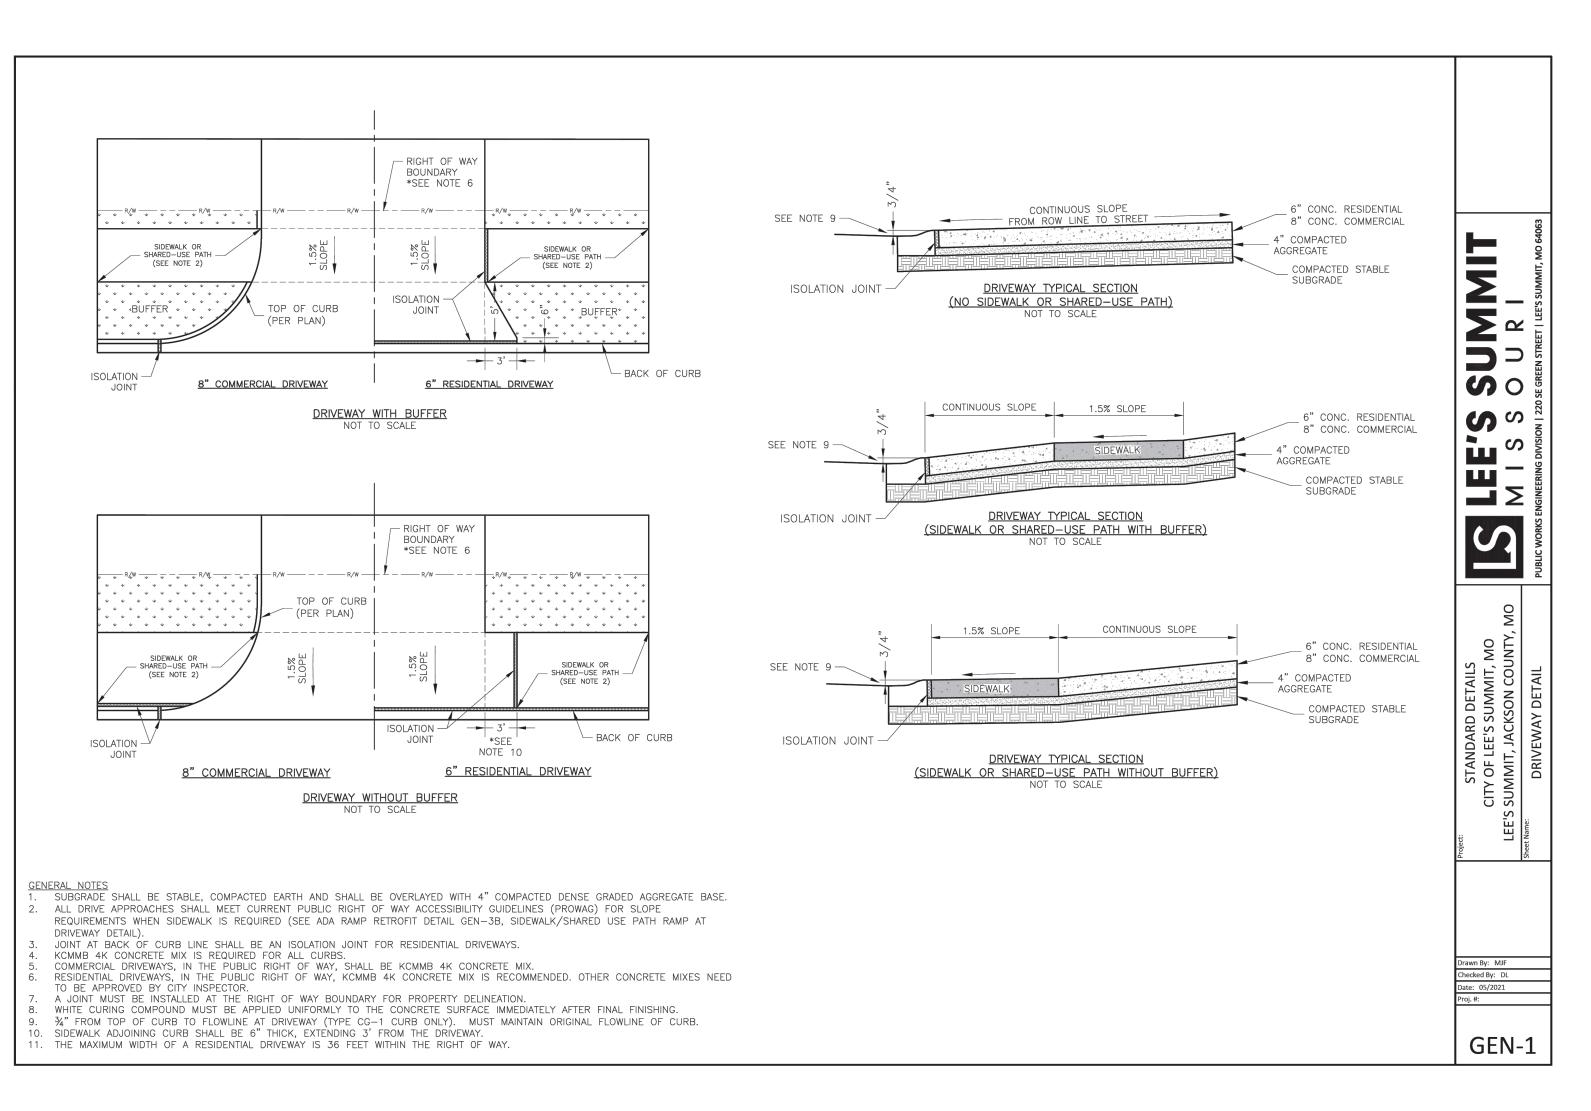


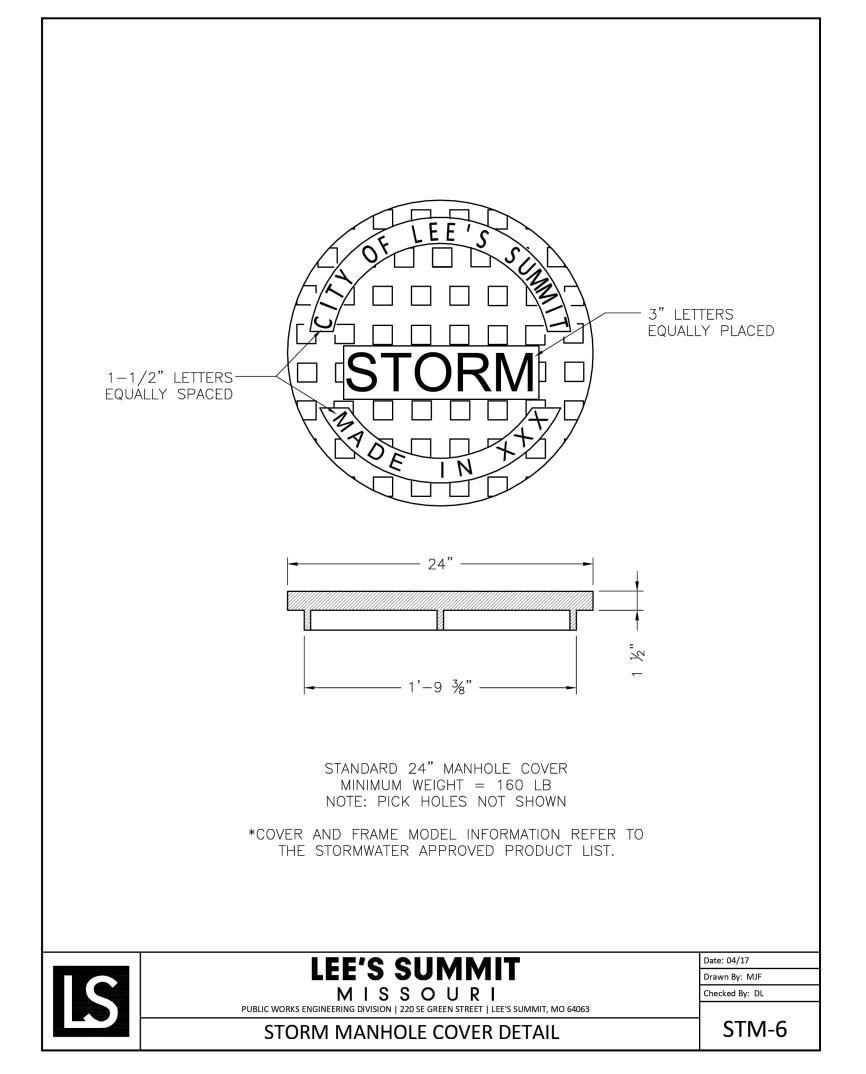
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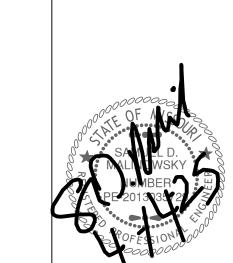
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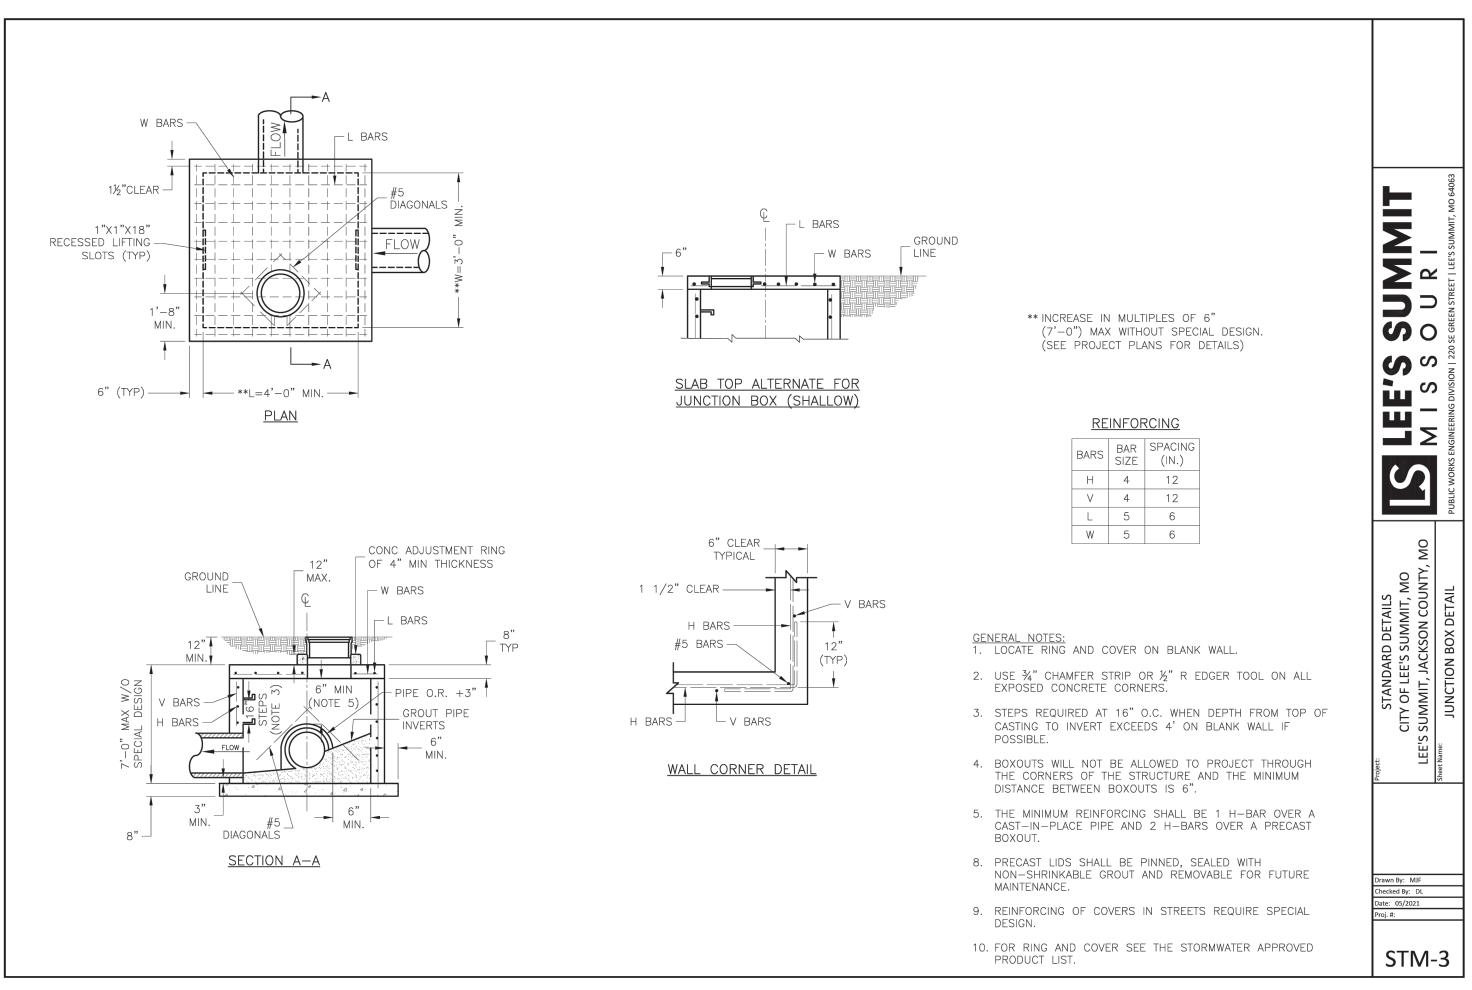
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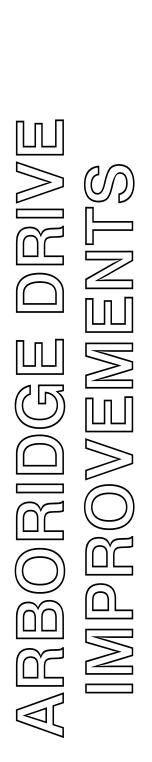
and dimensions is required.

Revisions
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ELEVATIONS SHOWN ON CONSTRUCTION STEEL INLET FRAME 10" THROAT -- PLANS ARE TOP OF INLET THIS SIDE OF STRUCTURE CURB & GUTTER -OUTSIDE EDGE OF _#4 BARS @ 6" O.C.E.W. CONCRETE FOOTING 1" X 1" X 18" RECESSED → SLOPE = 2% LIFTING SLOT (TYP) FZ SLOPE SAME AS CURB-2" CLEAR (TYP) #4 BARS PLACED AT 45° ANGLE - STEP PLACE 15" OF CLEAN -- INSIDE WALL AGGREGATE ALL DIRECTIONS - STEEL INLET FRAME (10" THROAT) EXPANSION JOINT 4" GALVANIZED HARDWARE CLOTH SHALL BE PLACED IN FRONT OF 4" DRAIN PIPES CURB AND GUTTER (2 EA). LOCATING POINT CONTRACTION - (INSIDE FACE OF FRONT WALL & OF BOX) #4 BARS AT 12" CONCRETE 3" CLEAR FOOTING (TYP) O.C.E.W. (TYP) XPANSION _#4 BARS AT 6" 5' TRANSITION A DOWNSTREAM SIDE GROUT PIPE INVERT 10' TRANSITION UPSTREAM SIDE -*SEE NOTE 3 10' TRANSITION BOTH SIDES FOR SUMP INLET SECTION A-A PLAN VIEW - VARIABLE L /4" STEEL 7 6" FOR CAST-IN-PLACE OR PRECAST WALL 1½" CLEAR — H BARS-B╼┘ 1'-3¹/_{16"} #5 BARS — - STIFFENERS AT 3'-0" CTR. MAX ¾"ø SMOOTH ROUND BAR -4¹1/₁₆" $_{\rm L}=1\frac{1}{2}$ " X $1\frac{1}{2}$ " X $\frac{1}{4}$ " X 2" TYPICAL OF STIFFENERS FRONT ELEVATION └ V BARS L= $1\frac{1}{2}$ " X $1\frac{1}{2}$ " X $\frac{1}{4}$ " X 2" TYPICAL OF STIFFENERS 1'-1'16" H BARS CONCRETE CURB DOWELS (#4 BARS) SHALL BE CENTERED VERTICALLY AND HORIZONTALLY SECTION B-B WALL CORNER DETAIL CONCRETE TOP SLAB (#4 BARS) AT 1'-0" CENTERS MAX 1. THE FIRST DIMENSION LISTED IN THE CONSTRUCTION NOTES IS THE "L" DIMENSION. THE SECOND DIMENSION IS THE "W" DIMENSION. . FLOW LINES LISTED ON THE PROJECT PLANS ARE LISTED AT THE INSIDE FACE OF THE WALL. FLOOR OF INLET GROUTED AND SHAPED TO MATCH PIPE INVERT TO PROVIDE SMOOTH FLOW. <u>PLAN VIEW</u> . LOCATE MH RING AND COVER ON BLANK WALL IF POSSIBLE. STEEL FRAME NOTES:

1. ALL WELDS SHALL BE PERFORMED IN ACCORDANCE WITH APPROPRIATE AWS SPECIFICATIONS AND . STEPS SHALL BE SPACED AT 1'-4" O.C. VERTICALLY ON BLANK WALL IF POSSIBLE 6. BEVEL ALL EXPOSED EDGES WITH ¾"CHAMFER OR ½" TOOLED EDGE.
7. ON-GRADE INLETS SHALL CONFORM TO THE STREET GRADE AND SUMP INLETS SHALL BE LEVEL.
8. PRECAST LIDS SHALL BE PINNED, SEALED WITH NON-SHRINKABLE GROUT AND REMOVABLE FOR PROCEDURES. 2. ALL WELDS ON EXPOSED SURFACES SHALL BE DRESSED SO AS TO PROVIDE A PLEASING FINISHED APPEARANCE. FUTURE MAINTENANCE. 3. THE ENTIRE FRAME SHALL BE PAINTED A SINGLE COAT OF CHEM-PRIME #37H-78 PRIMER (GRAY) OR 9. LIFTING RINGS SHALL BE REMOVED AND SEALED WITH NON-SHRINKABLE GROUT 10. FOR RING AND COVER SEE THE STORMWATER APPROVED PRODUCT LIST.





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DETAILS

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SM Engineering Manhattan Kansas, 66503

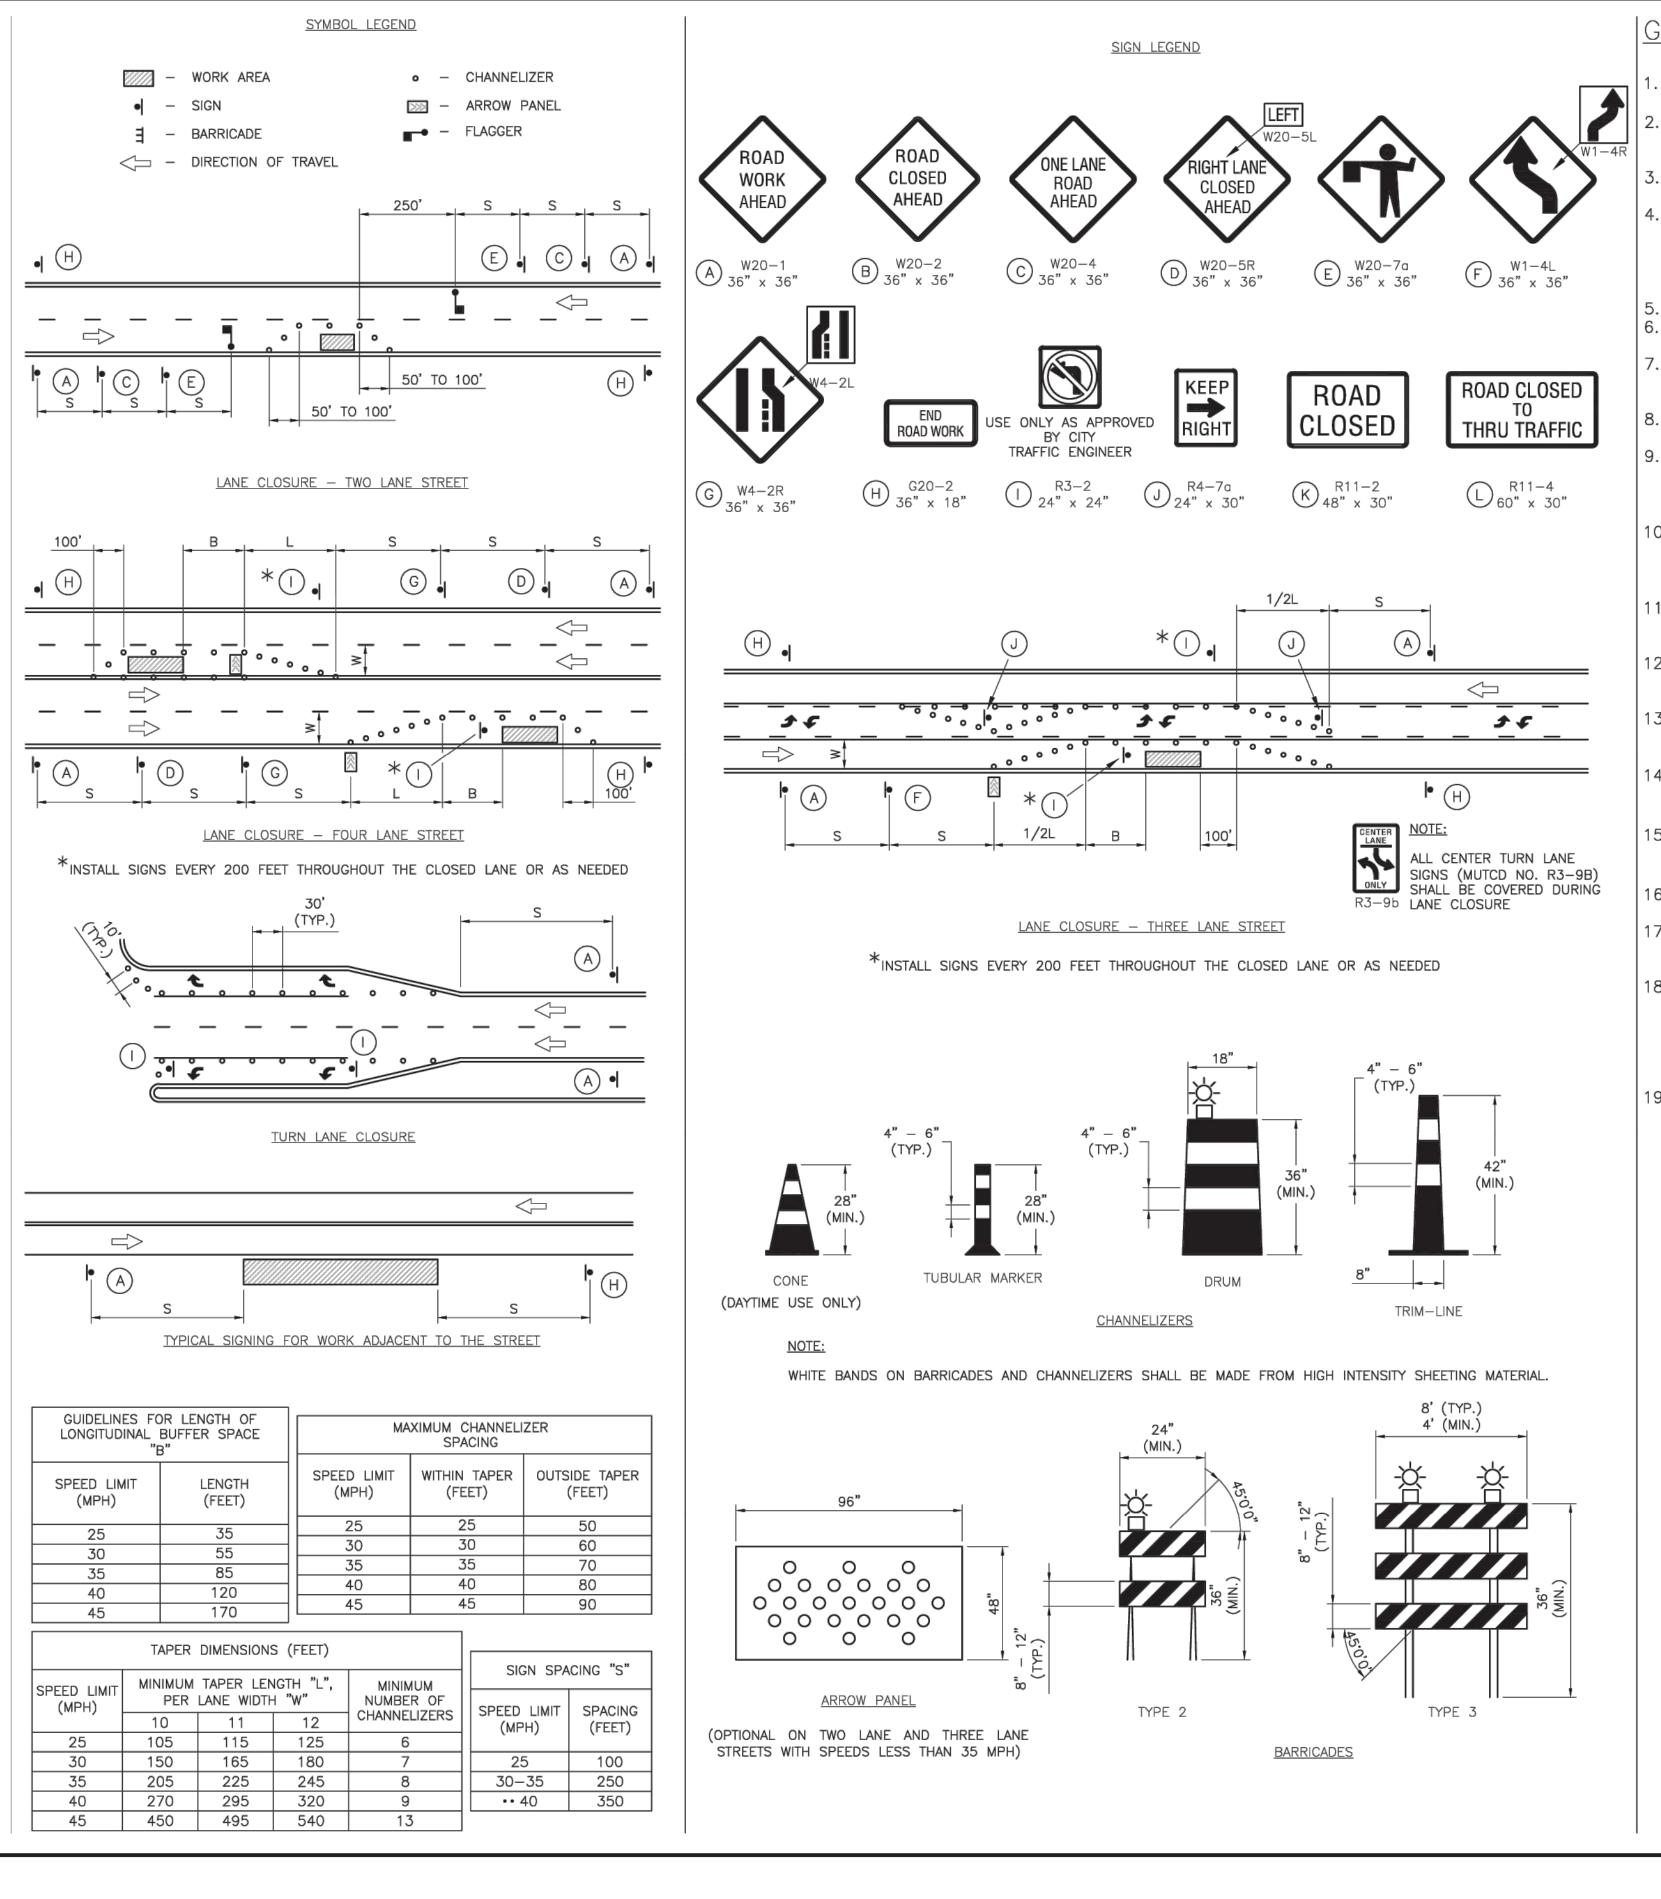
smcivilengr@gmail.com 785.341.9747

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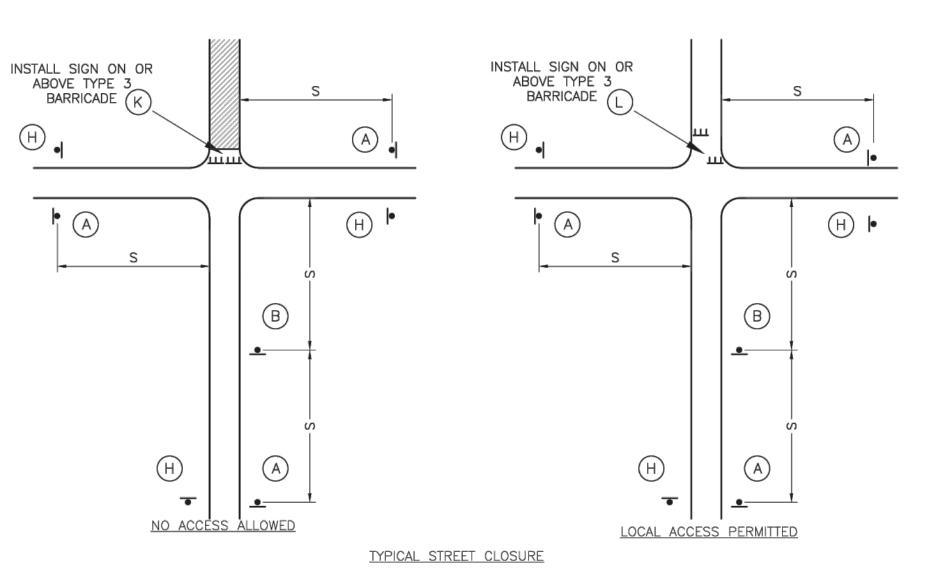
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sheet 1"=30' 0 15' 30' TRAFFIC CONTROL



GENERAL NOTES:

- ALL SIGNS, BARRICADES, CHANNELIZERS, MARKINGS AND OTHER TRAFFIC CONTROL DEVICES SHALL CONFORM TO THE LATEST EDITION OF THE MANUAL ON UNIFORM TRAFFIC CONTROL DEVICES (MUTCD
- ALL TRAFFIC CONTROL DEVICES SHALL BE STANDARD IN SIZE, SHAPE, COLOR, AND MESSAGE, IN GOOD CONDITION, AND RETRO-REFLECTORIZED. ALL SIGNS SHALL BE SECURELY MOUNTED WITH HEIGHT AND LATERAL LOCATION AS DESCRIBED IN THE MUTCD.
- WARNING LIGHTS SHALL BE USED ON BARRICADES IN PLACE AT NIGHT AND ON WARNING SIGNS WHICH ALERT DRIVERS ABOUT A CHANGE IN ALIGNMENT, TRAFFIC CONTROL, LANE CLOSURE, OR ROAD CLOSURE.
- FLAGGERS SHALL BE USED WHERE INDICATED ON THE PLANS, WHERE CONSTRUCTION VEHICLES INTERACT WITH NORMAL TRAFFIC, OR WHERE CONSTRUCTION ACTIVITIES IMPOSE A RESTRICTION ON TRAFFIC, AS DIRECTED BY THE CITY TRAFFIC ENGINEER. WHERE FLAGGERS ARE USED, ADVANCE SIGNING SHALL BE ERECTED AS SHOWN IN THE DETAILS OR AS SPECIFIED IN THE MUTCD. FLAGGERS SHALL MEET THE REQUIREMENTS IN THE MUTCO IN REGARD TO CHARACTER, TRAINING, ATTIRE, AND BEHAVIOR
- TRIM-LINES ARE THE CITY'S PREFERRED CHANNELIZING DEVICE. CONES MAY NOT BE USED AT NIGHTTIME TRAFFIC CONTROL DEVICES NOT IN USE OR NOT APPLICABLE SHALL BE EITHER COVERED OR REMOVED FROM THE WORK AREA.
- THE CONTRACTOR SHALL USE BARRICADES, STREET PLATES, OR FENCING AS NEEDED TO EFFECTIVELY SHIELD PEDESTRIAN AND VEHICULAR TRAFFIC FROM EXPOSED OBJECTS, EXCAVATIONS, AND CONSTRUCTION
- ACCESS SHALL BE MAINTAINED TO ALL DRIVEWAYS AND SIDE STREETS UNLESS NOTED OTHERWISE ON THE PLANS.
- NO STREET SHALL BE CLOSED WITHOUT THE APPROVAL OF THE CITY TRAFFIC ENGINEER. THE CONTRACTOR SHALL NOTIFY THE CITY TRAFFIC ENGINEER AT LEAST 7 DAYS IN ADVANCE OF ANY STREET CLOSURE. IF A DETOUR ROUTE AROUND THE CLOSURE IS TO BE PROVIDED, ALL DETOUR SIGNING SHALL BE AS SHOWN ON A PLAN APPROVED BY THE CITY TRAFFIC ENGINEER.
- 10. CONSTRUCTION VEHICLES PARKED ALONG STREETS SHALL BE LOCATED WITHIN THE WORK AREA (TRAFFIC CONTROL) OR WHERE OTHERWISE NORMALLY PERMITTED. CONSTRUCTION MATERIALS, INCLUDING TRAFFIC CONTROL AND VEHICLES SHALL NOT RESTRICT SIGHT DISTANCE FOR VEHICLES EXITING AT STREETS OR
- 11. CONSTRUCTION MATERIALS SHALL BE KEPT OFF OF SIDEWALKS, CONSOLIDATED IN ONE LOCATION WITHIN CITY RIGHT-OF-WAY, AND REMOVED DAILY UNLESS OTHERWISE APPROVED BY THE INSPECTOR, DIRT, MUD. AND OTHER CONSTRUCTION DEBRIS ON STREETS AND SIDEWALKS SHALL BE REMOVED IMMEDIATELY.
- 12. THE CONTRACTOR SHALL NOT PERFORM ANY WORK THAT WILL RESTRICT VEHICULAR TRAFFIC IN ANY WAY BETWEEN THE HOURS OF 7:00 A.M. AND 9:00 A.M. OR 4:00 P.M. AND 6:00 P.M. MONDAY THROUGH FRIDAY UNLESS OTHERWISE INDICATED IN THE SPECIFICATIONS
- 13. ALL TRAVEL LANES SHOULD BE AT LEAST 11 FEET WIDE UNLESS OTHERWISE AUTHORIZED BY THE CITY TRAFFIC ENGINEER. A "NARROW LANES" SIGN SHALL BE INSTALLED IN ADVANCE OF A LANE WIDTH
- REDUCTION TO LESS THAN 11 FEET. ALL EDGE DROP-OFFS OF MORE THAN 2 INCHES AND LESS THAN 4 INCHES SHOULD BE PROTECTED BY A WEDGE OR BARRIER AND ALL EDGE DROP-OFFS GREATER THAN 4 INCHES SHALL HAVE EDGE PROTECTION
- (SEE TRAFFIC CONTROL SPECIFICATIONS FOR EDGE TREATMENT REQUIREMENTS) 15. THE "WORKERS" SYMBOLIC SIGN (MUTCD NO. W21-1A) MAY BE USED INSTEAD OF THE "ROAD WORK AHEAD" SIGN FOR WORK WITH A DURATION OF 12 HOURS OR LESS. THE "END ROAD WORK" SIGN IS NOT REQUIRED TO BE INSTALLED AFTER THE "WORKERS" SIGN.
- 16. NO TRAFFIC SIGNAL SHALL BE ALTERED OR MODIFIED IN ANY WAY WITHOUT A PLAN APPROVED BY THE CITY TRAFFIC ENGINEER.
- 17. THE CONTRACTOR SHALL BE RESPONSIBLE FOR MAINTAINING ALL TRAFFIC CONTROL DEVICES ON AN AROUND-THE-CLOCK BASIS, WHETHER OR NOT WORK IS ACTIVELY BEING PURSUED AND ANY DEFICIENCIES NOTED SHALL BE CORRECTED IMMEDIATELY
- 18. THE TRAFFIC CONTROL REQUIREMENTS SHOWN ON THESE PLANS ARE MINIMUM REQUIREMENTS ONLY AND DO NOT ATTEMPT TO ADDRESS IN DEPTH THE VARIETY OF SITUATIONS THAT MAY OCCUR ONCE CONSTRUCTION HAS STARTED. IN NO WAY DO THE REQUIREMENTS SHOWN ON THESE PLANS RELIEVE THE CONTRACTOR OF HIS RESPONSIBILITY FOR SELECTING THE PROPER TRAFFIC CONTROL DEVICES AND IMPLEMENTATION PROCEDURES THAT WILL ASSURE THE SAFETY OF DRIVERS. PEDESTRIANS. AND WORKERS AT ALL TIMES.
- 19. SHOULD THE CONTRACTOR FAIL TO ENFORCE THE TRAFFIC CONTROL PLAN OR FAIL TO CLEAN, REPLACE OR OTHERWISE MAINTAIN THE TRAFFIC CONTROL DEVICES WHEN DIRECTED TO DO SO BY THE CITY TRAFFIC ENGINEER OR REPRESENTATIVE, THE CITY MAY TAKE ONE OR MORE OF THE FOLLOWING ACTIONS:
- A. EMPLOY ANOTHER AGENCY TO CORRECT DEFICIENCIES IN TRAFFIC CONTROL DEVICES AND DEDUCT THE COST FROM THE CONTRACTOR'S PAY ESTIMATE.
- STOP THE WORK UNTIL DEFICIENCIES ARE CORRECTED.
- C. SUSPEND ALL PAY ESTIMATES UNTIL DEFICIENCIES ARE CORRECTED, OR
- D. PLACE THE CONTRACTOR IN DEFAULT.



MO POLE AND LUMINAIRE DE CITY OF LEE'S SUMMIT, SUMMIT, JACKSON COL DET CONTROL TRAFFIC S E Drawn By: BWC Checked By: MP Date: 01/2020 Proj. #:

RECORD DRAWING

The information provided on this drawing conforms to construction records; it is not intended for construction, implementation or recording purposes; and is solely based on information provided by others.

"100.00 100.10", "1.00% 1.15% slope", "8-inch HDPE PVC pipe" or text that is blue in color are all typical examples of revisions that indicate that design data has been replaced with "as-built" information. All other data is as designed and has not been field verified.

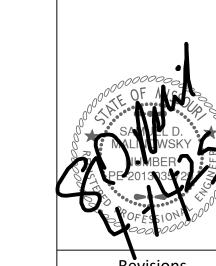
Date: 4-1-25 Certified by: Samuel D. Malinowsky

Title: Owner Firm: SM Engineering

5507 High Meadow Circle Manhattan Kansas, 66503 smcivilengr@gmail.com 785.341.9747

SM Engineering

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