



HCA - LEE’S SUMMIT MEDICAL CENTER ADMINISTRATION RELOCATION

2000 SE BLUE PKWY
LEE’S SUMMIT, MO 64063

DGL PROJECT NO	6406.24.0001	DATE:
HCA PROJECT NO.	0972400009	05/29/2025

HCA DESIGN MANAGER: MIKAL MALIK
HCA CONSTRUCTION MANAGER: ERIC SJODIN

CITY AND STATE - 2ND REVIEW



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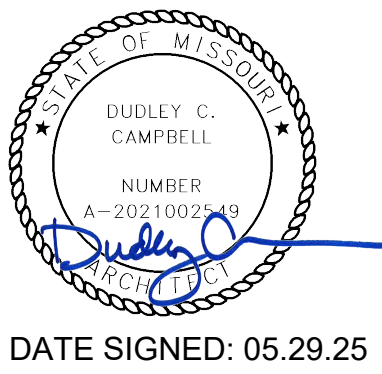
www.devenneygroup.com

HCA VENDOR INFORMATION

REMAR (TV) DARRELL LEFTWICH, DLEFTWICH@REMARINC.COM
STORAGE SYSTEMS UNLIMITED (STORAGE) LANCE MCCORMICK, LMCCORMICK@STORAGESYSTEMSUL.COM

DEVENNEY GROUP, LTD.
ARCHITECTS
ARCHITECTS

6900 E CAMELBACK RD, SUITE #500
SCOTTSDALE, AZ 85251
PROJECT MANAGER: KEVIN COOK 602.541.7287



WSP
MECHANICAL, PLUMBING & ELECTRICAL ENGINEERS
300 WYANDOTTE, SUITE 200
KANSAS CITY, MO 64105
PROJECT MANAGER: MINDY WHISLER 816.702.4247

INNER DESIGN STUDIO
INTERIOR DESIGNER
7103 BAKER’S BRIDGE AVE, SUITE 106
BRENTWOOD, TN 37027
PROJECT MANAGER: BEVERLY PHILLEY 615.321.0696


NABHOLZ
GENERAL CONTRACTOR

6640 CAROTHERS PARKWAY, STE 150
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AUTHORITY HAVING JURISDICTION:
CITY OF LEE'S SUMMIT BUILDING DEPT.
MISSOURI DHSS

FACILITY NUMBER:
0972400009

AGENCY APPROVALS:
AGENCY

REVISIONS		
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DATE: 04/18/2025
SCALE: JV
DRAWN: MM/DP
REVIEWED: 6406.24
JOB NUMBER:

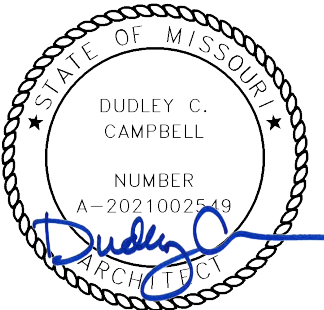SHEET INDEX

GI001

SHEET INDEX

R = REVISED SHEET
F = FOR REFERENCE ONLY
D = DELETED SHEET

SHEET NUMBER SHEET NAME

GENERAL INFORMATION

GI000	COVER SHEET	X	R
GI001	SHEET INDEX	X	R
GI101	PROJECT INFORMATION, AREA MAPS, SYMBOLS	X	R

ARCHITECTURAL SITE

AS001	ARCHITECTURAL SITE PLAN	X	R
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ARCHITECTURAL LIFESAFETY

AC101	LIFE SAFETY FLOOR PLAN – LEVEL 1	X	R
AC501	PARTITION TYPES & DETAILS	X	R
AC521	TYPICAL MOUNTING HEIGHTS	X	R

ARCHITECTURAL DEMOLITION

AD101	DEMOLITION PLAN - LEVEL 1	X	R
AD171	DEMOLITION RCP - LEVEL 1	X	R

ARCHITECTURAL

AE111	DIMENSION FLOOR PLAN - LEVEL 1 - ADMIN	X	R
AE131	ANNOTATION FLOOR PLAN - LEVEL 1 - ADMIN	X	R
AE181	REFLECTED CEILING PLAN - LEVEL 1 - ADMIN	X	R
AE601	DOOR SCHEDULES - LEVEL 1 ADMIN	X	R
AE701	INTERIOR DETAILS	X	R
AE720	CEILING DETAILS	X	R
AE740	CASEWORK DETAILS & LEGEND	X	R
AE741	MILLWORK DETAILS	X	R

INTERIORS

AF001	GENERAL FINISH SPECIFICATIONS AND NOTES	X	R
AF002	GENERAL FINISH SPECIFICATIONS AND NOTES	X	R
AF101	FINISH FLOOR PLAN - LEVEL 1	X	R
AF103	FLOOR PATTERN PLAN - LEVEL 1	X	R
AF104	FURNITURE PLAN - LEVEL 1	X	R
AF105	SIGNAGE PLAN - LEVEL 1	X	R
AF106	SIGNAGE KEY	X	R
AF107	SIGNAGE KEY	X	R

PLUMBING

PD0-00	GENERAL INFORMATION - PLUMBING	X	R
PD02-00	UNDERFLOOR DEMOLITION PLAN - PLUMBING	X	R
PD02-01	DEMOLITION PLAN - LEVEL 01 - PLUMBING	X	R
PD2-00	UNDERFLOOR PLAN - PLUMBING	X	R
PD2-01	FLOOR PLAN - LEVEL 01 - PLUMBING	X	R
PD7-01	DETAILS - PLUMBING	X	R
PD8-01	SCHEDULES - PLUMBING	X	R

MECHANICAL

MD0-00	GENERAL INFORMATION - MECHANICAL	X	R
MD1-01	CONTROLS - MECHANICAL	X	R
MD02-01	DEMOLITION PLAN - LEVEL 01 - HVAC	X	R
MD03-01	DEMOLITION PLAN - LEVEL 01 - HVAC PIPING	X	R
MD2-01	FLOOR PLAN - LEVEL 01 - HVAC	X	R
MD3-01	FLOOR PLAN - LEVEL 01 - HVAC PIPING	X	R
MD6-01	RISER DIAGRAM - MECHANICAL	X	R
MD7-01	DETAILS - MECHANICAL	X	R
MD7-02	DETAILS - MECHANICAL	X	R
MD8-01	SCHEDULES - MECHANICAL	X	R
MDP02-03	ATTACHED MOB ROOF PLAN - MEP	X	R

ELECTRICAL

ED0-00	GENERAL INFORMATION - ELECTRICAL	X	R
ED02-01	DEMOLITION PLAN - LEVEL 01 ELECTRICAL	X	R
ED2-01	FLOOR PLAN - LEVEL 01 - POWER	X	R
ED3-01	FLOOR PLAN - LEVEL 01 - LIGHTING	X	R
ED4-01	FLOOR PLAN - LEVEL 01 - SPECIAL SYSTEMS	X	R
ED6-01	ONE LINE DIAGRAM - ELECTRICAL	X	R
ED7-01	DETAILS - ELECTRICAL	X	R
ED8-01	SCHEDULES - ELECTRICAL	X	R

TECHNOLOGIES

TD0-00	GENERAL INFORMATION - TECHNOLOGY	X	R
TD03-01	DEMOLITION PLAN - LEVEL 01 - COMMUNICATIONS	X	R
TD2-01	FLOOR PLAN - LEVEL 01 - COMMUNICATIONS	X	R
TD3-01	FLOOR PLAN - LEVEL 01 - LOW VOLTAGE	X	R
TD4-01	FLOOR PLAN - LEVEL 01 - SECURITY	X	R
TD5-01	ENLARGED PLAN - TECHNOLOGY	X	R
TD6-01	RISER DIAGRAM - TECHNOLOGY	X	R
TD7-01	DETAILS - TECHNOLOGY	X	R
TD7-02	DETAILS - TECHNOLOGY	X	R
TD7-03	DETAILS - TECHNOLOGY	X	R
TD8-01	SCHEDULES - TECHNOLOGY	X	R

STORAGE SYSTEMS (VENDOR)

SS-1	STORAGE SYSTEMS LAYOUT	F	R
SS-2	EQUIPMENT ELEVATIONS	F	R

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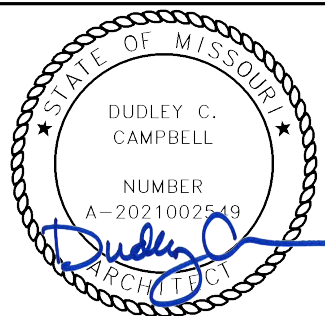
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PROJECT INFORMATION,
AREA MAPS, SYMBOLS

G1101

PROJECT SYMBOLS

DIMENSION LINE

12'-0"

TO FACE OF FRAMING OR
CENTERLINE OF STRUCTURE

NORTH ARROW

TRUE NORTH

REFERENCE NORTH

BUILDING SECTION

SECTION DESIGNATION

SHEET NUMBER

WALL SECTION

SECTION DESIGNATION

SHEET NUMBER

DETAIL

DETAIL NUMBER

SHEET NUMBER

EXTERIOR ELEVATION

ELEVATION DESIGNATION

SHEET NUMBER

INTERIOR ELEVATION

ELEVATION DESIGNATION

SHEET NUMBER

PARTITION TYPE

DOOR #

NEW

EXIST.

DOOR IDENTIFICATION

NEW

EXIST.

WINDOW IDENTIFICATION

54123

ROOM NAME

EQUIPMENT IDENTIFICATION

105

ROOM NUMBER

ROOM NAME AND NUMBER

LOBBY

105

ROOM NUMBER

CEILING ELEVATION REFERENCE

6'-0"

KEYNOTE REFERENCE

XX

ELEVATION/DATUM REFERENCE

FINISH FLOOR

100'-0"

ELEVATION CHANGE REFERENCE

1'-0"

REVISION

STANDARD

PRE-PERMIT
REVISION

1/AE203

SHEET NUMBER-SIDE
MATCHED TO

MATCH LINE

D

2

COLUMN OR GRID LINE

1

2

KEY FOR ENLARGED PLAN

1

2

- PROJECT GENERAL NOTES
1. GENERAL NOTES APPLY TO ALL DRAWINGS.

2. LABOR, MATERIALS, CONSTRUCTION METHODS AND WORK TO CONFORM TO THE LATEST GOVERNING CODES, RULES AND REGULATIONS FOR THIS PROJECT AND JURISDICTION. THE MOST STRINGENT SHALL PREVAIL.

3. WHEN REQUIRED BY CODE, RULES OR REGULATIONS, WORK MUST BE INSPECTED AND APPROVED BY AUTHORITY HAVING JURISDICTION.

4. VERIFY EXISTING SITE CONDITIONS PRIOR TO STARTING WORK AND NOTIFY ARCHITECT OF ANY DISCREPANCIES.

5. VERIFY EXISTING CONDITIONS AND DIMENSIONS PRIOR TO FABRICATION AND/OR CONSTRUCTION; NOTIFY ARCHITECT OF ANY DISCREPANCIES BETWEEN EXISTING CONDITIONS AND THESE DRAWINGS WHICH AFFECT THE SCOPE AND INTENT OF THE WORK DESCRIBED IN THE CONSTRUCTION DOCUMENTS.

6. DO NOT MEASURE DRAWINGS. DIMENSIONS TO BE FIELD MEASURED AND VERIFIED. NOTIFY ARCHITECT OF ANY DISCREPANCIES.

7. FIELD VERIFY DIMENSIONS OF OPENINGS FOR DOORS AND WINDOWS PRIOR TO FABRICATION.

8. FIELD VERIFY SPACES REQUIRING CABINETS, COUNTERS, CASEWORK, ETC. PRIOR TO FABRICATION.

9. COORDINATE MECHANICAL, PLUMBING AND ELECTRICAL CHASE SIZES AND LOCATIONS.

10. GYPSUM BOARD TO BE 5/8" TYPE "X" FIRE RATED UNLESS NOTED OTHERWISE.

11. GYPSUM BOARD AT NON-RATED INTERIOR PARTITIONS TERMINATES 6" (MINIMUM) ABOVE THE HIGHEST ADJACENT CEILING UNLESS NOTED OTHERWISE.

12. SCRIBE GYPSUM BOARD TO IRREGULARITIES OF ADJACENT SURFACES; SEAL TIGHT AROUND PENETRATIONS.

13. SEAL PENETRATIONS THROUGH FIRE RATED ASSEMBLIES WITH APPROVED MATERIALS AND METHODS MEETING REQUIREMENTS OF AGENCY HAVING JURISDICTION.

14. NEW WORK TO ALIGN WITH AND MATCH EXISTING EXCEPT WHERE OTHERWISE DIMENSIONED OR DETAILED.

15. WHEN EXISTING EQUIPMENT, FIXTURES, PIPING, DUCTS, ETC. ARE REMOVED SUCH REMOVAL SHALL INCLUDE ANCHORS, HANGERS, BASE, ETC., AFTER REMOVAL, PATCH FLOORS, WALLS AND CEILINGS TO MATCH ADJACENT SURFACES IN MATERIAL, TEXTURE AND COLOR.

16. PATCH EXISTING PARTITIONS AND WALLS WITHIN THE SCOPE OF THE PROJECT THAT ARE DENTED OR DAMAGED AND FILL ALL NAIL HOLES, ETC. TO PREPARE FOR FINISH AS PER NEW FINISHES REQUIREMENTS.

17. PATCH AND REPAIR PARTITIONS, WALLS AND FLOORS CUT OUT FOR MECHANICAL, PLUMBING OR ELECTRICAL WORK.

18. PROVIDE GYPSUM BOARD BARRIER (FIRE RATED ASSEMBLIES WHERE REQUIRED) WITH ACCESS BETWEEN CONSTRUCTION AREA AND EXISTING AREA TO REMAIN. NO FUMES, DUST OR DEBRIS IS PERMITTED OUTSIDE OF THE CONSTRUCTION BARRIER.

DISCLAIMER


THESE COMPOSITION PLANS WERE DEVELOPED USING THE RECORD CONSTRUCTION PLANS PROVIDED BY THE CLIENT. RECORD DRAWINGS WERE UTILIZED TO GENERATE THE COMPOSITE PLANS. VERIFICATIONS WERE MADE FOR MINOR ALTERATION AND DEVIATIONS FROM THE ORIGINAL CONSTRUCTION PLANS. EXTENSIVE AS-BUILT VERIFICATION WAS NOT PERFORMED FOR THE COMPOSITE PLANS. THE COMPOSITE PLANS WERE UTILIZED FOR THE BASE PLANS FOR THE DEVELOPMENT OF THE MECHANICAL AND ELECTRICAL COMPOSITE PLANS. LIMITED FIELD VERIFICATION OF MECHANICAL AND ELECTRICAL SYSTEMS WERE PERFORMED TO DETERMINE LOCATIONS OF MAJOR COMPONENTS, FIRE PROTECTION AND LIFE SAFETY SYSTEMS

DEFERRED SUBMITTALS

- FIRE/SMOKE ALARM DESIGN AND ENGINEERING
- FIRE SUPPRESSION DESIGN AND ENGINEERING
- SPRAY APPLIED FIRE PROOFING DESIGN AND ENGINEERING
- FIRE RESISTANT JOINT SYSTEM DESIGN AND ENGINEERING
- INTERIOR SIGNAGE DESIGN AND ENGINEERING
- LIGHT GAGE METAL STUD FRAMING DESIGN AND ENGINEERING


LEVEL 1 PLUMBING FIXTURE REQUIREMENTS										
CLASSIFICATION	OCCUPANCY	DESCRIPTION	WATER CLOSETS		LAVATORIES		BATHTUBS OR SHOWERS	DRINKING FOUNTAINS	OTHER	
			MALE	FEMALE	MALE	FEMALE				
BUSINESS	B	BUSINESS OPERATIONS (B OCCUPANCY)	1 PER 25 FOR FIRST 50 & 1 PER 50 FOR REMAINING	1 PER 25 FOR FIRST 50 & 1 PER 50 FOR REMAINING	1 PER 40 FOR FIRST 80 & 1 PER 80 FOR REMAINING	1 PER 40 FOR FIRST 80 & 1 PER 80 FOR REMAINING	N/A	1 PER 100	1 SERVICE SINK	
		REQUIRED	2	2	1	1				
		PROVIDED	6		6			-		2

NOTES:
*TOTAL OCCUPANTS FOR LEVEL 1 TENANT IMPROVEMENT IS 72 OCCUPANTS. REFER TO SHEET AC101 FOR ADDITIONAL INFORMATION ON OCCUPANT LOAD CALCULATIONS.
1. TOILET FACILITIES FOR EMPLOYEES SHALL BE SEPARATE FROM FACILITIES FOR INMATES OR CARE RECIPIENTS
2. THE OCCUPANT LOAD FOR SEASONAL OUTDOOR SEATING AND ENTERTAINMENT AREAS SHALL BE INCLUDED WHEN DETERMINING THE MINIMUM NUMBER OF FACILITIES REQUIRED

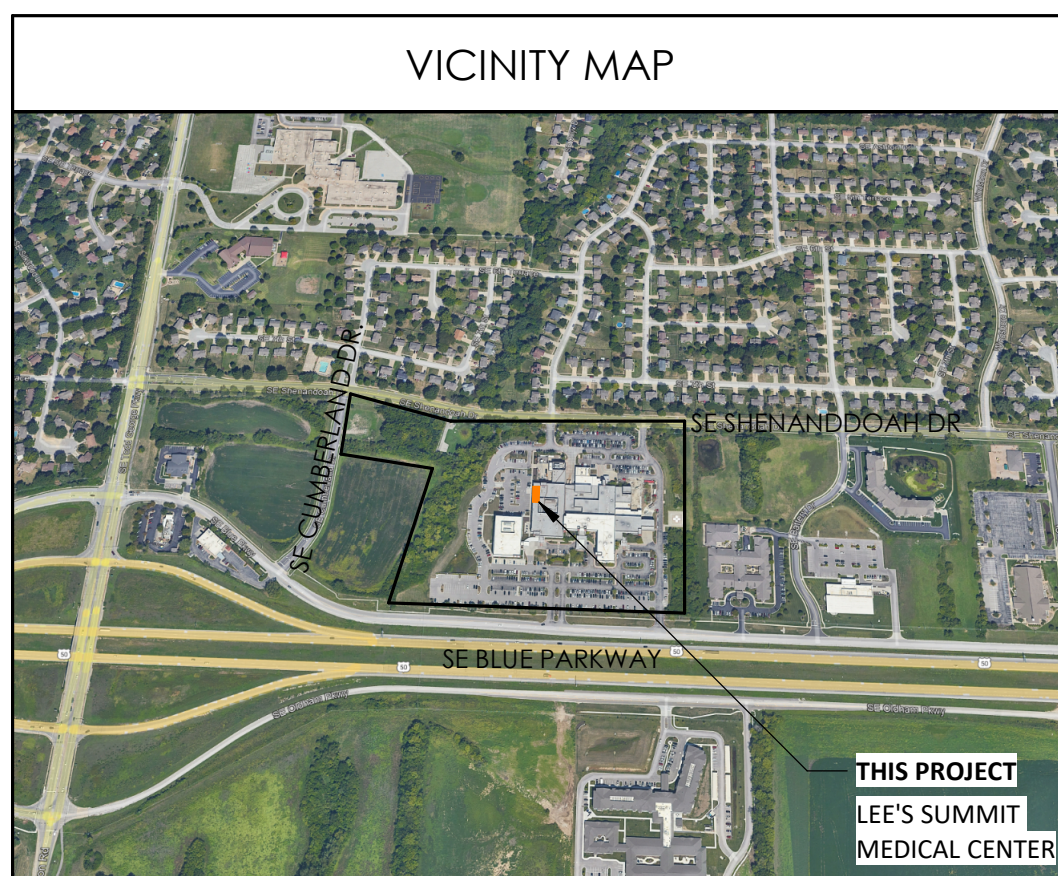

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NO CHANGE IN OCCUPANTS,
THEREFORE NO CHANGE IN
PARKING CALCS.

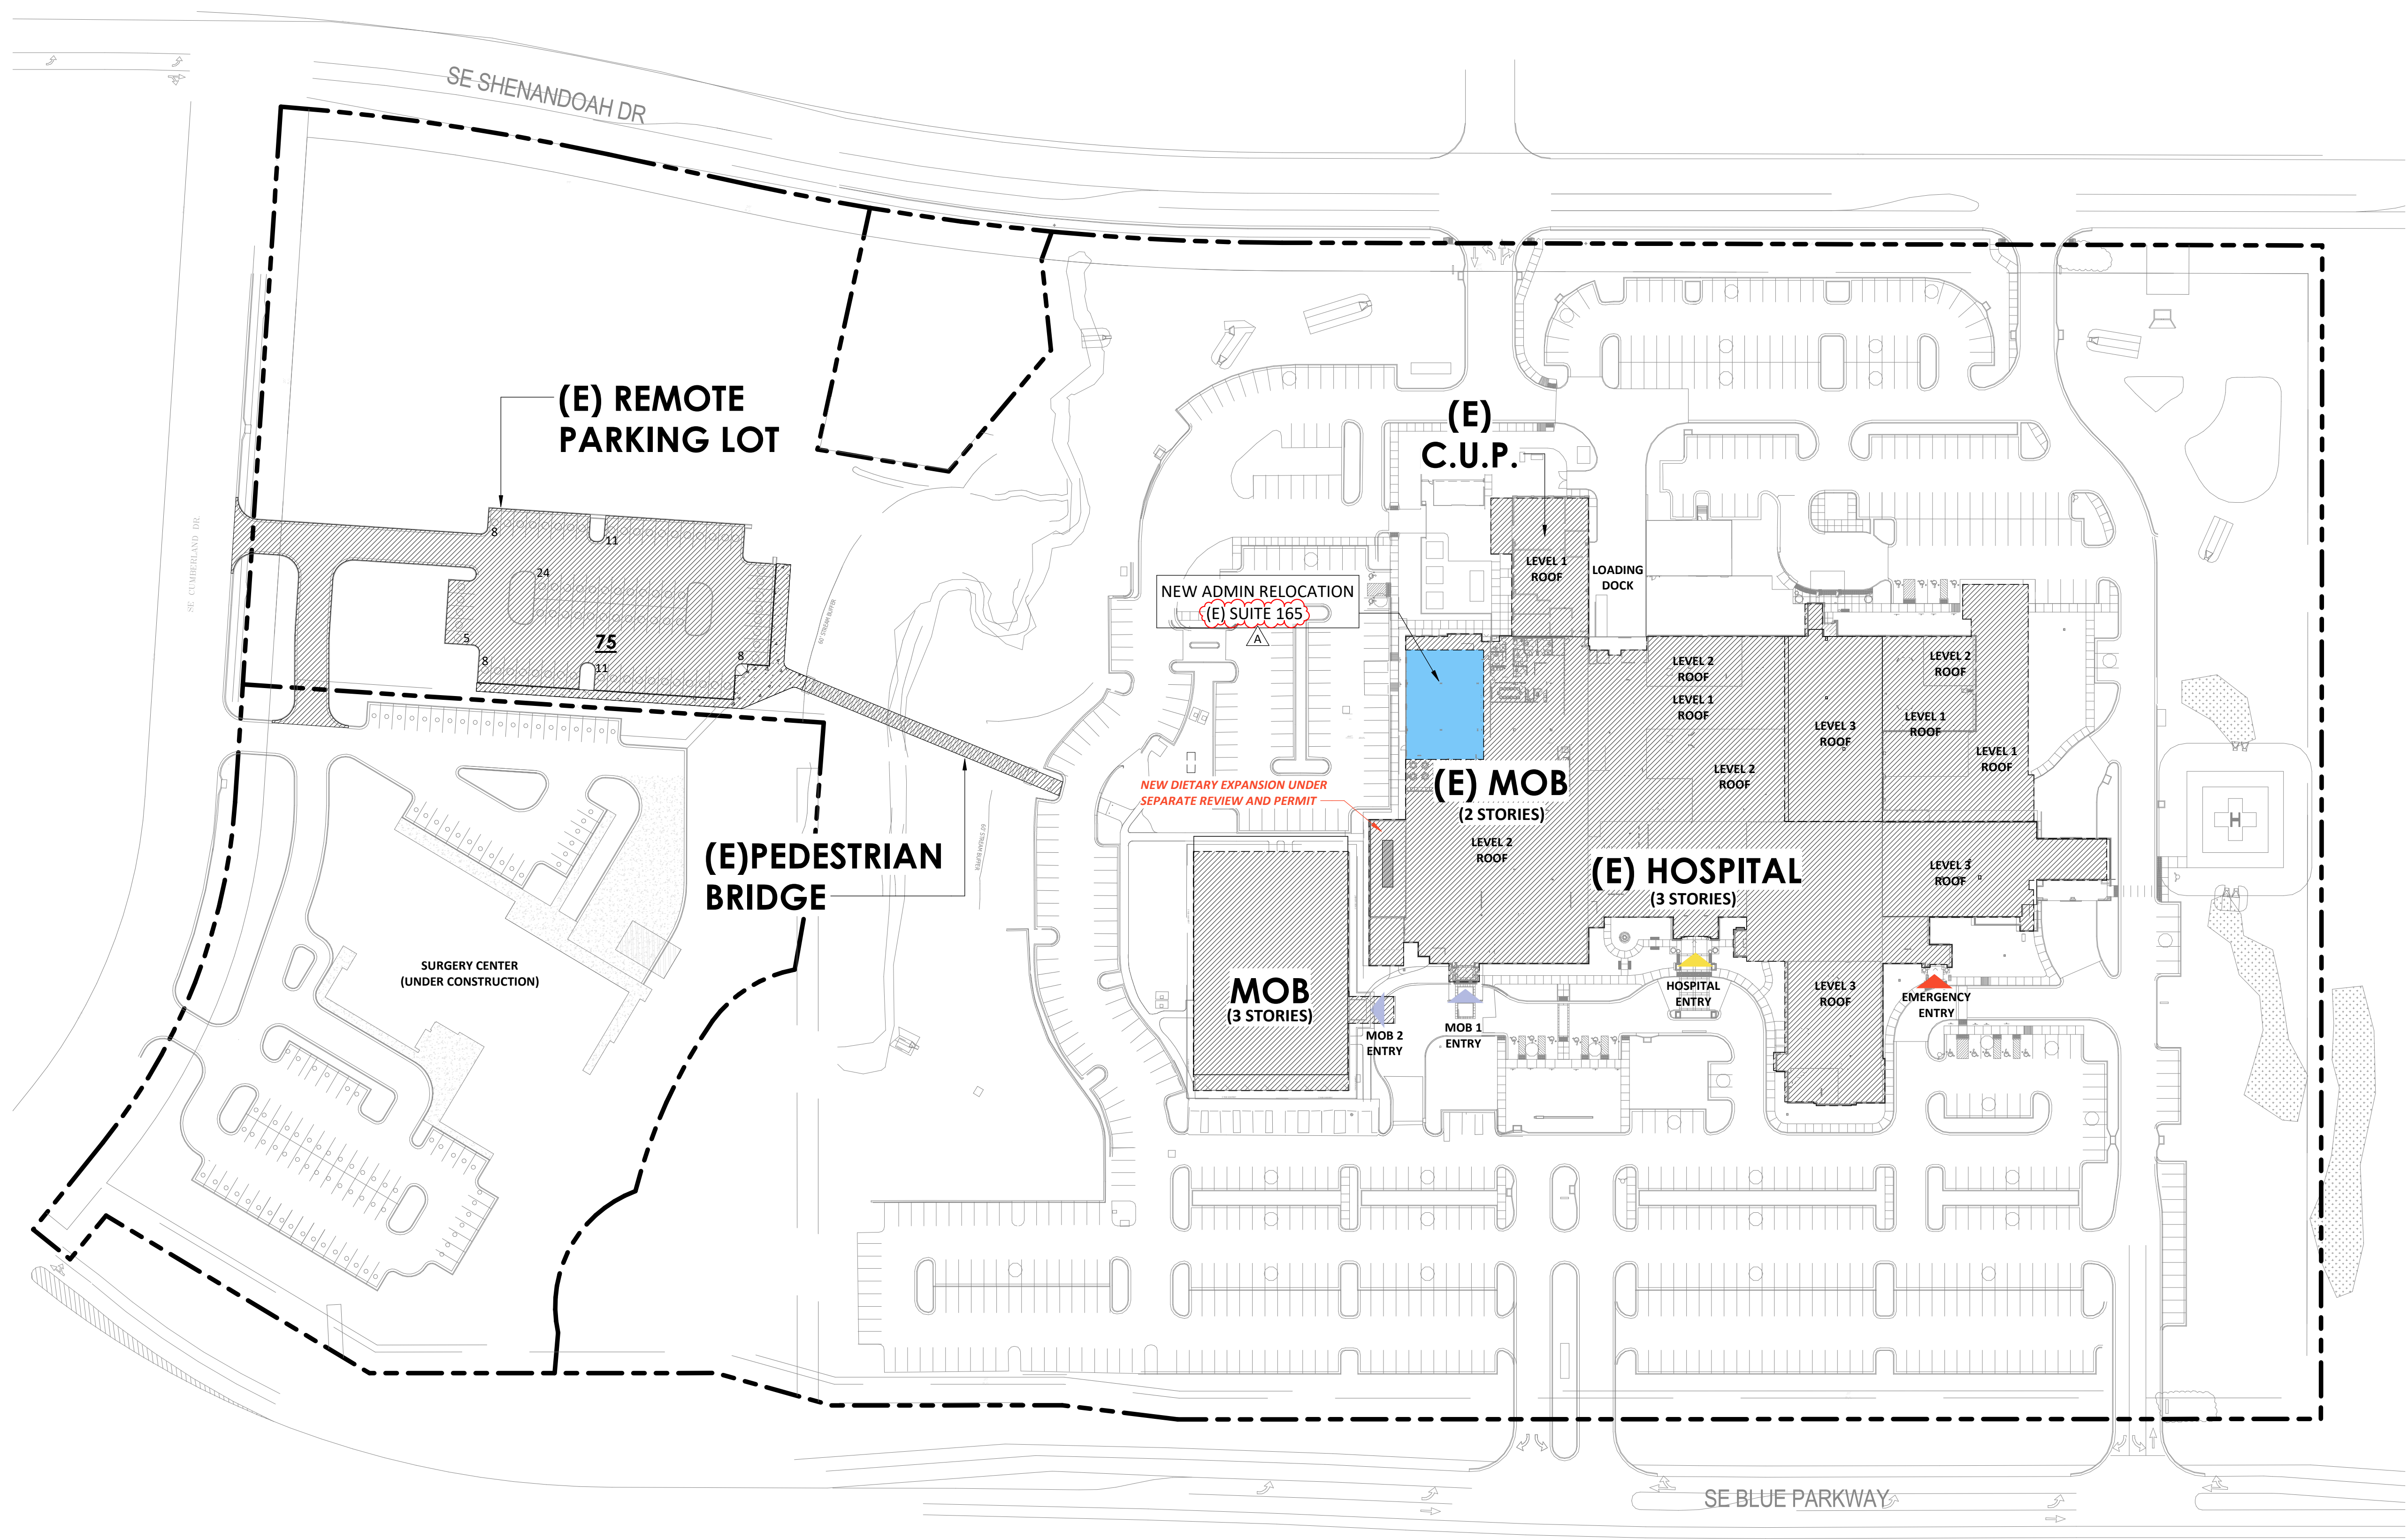


1 ARCHITECTURAL SITE PLAN
1/64" = 1'-0"



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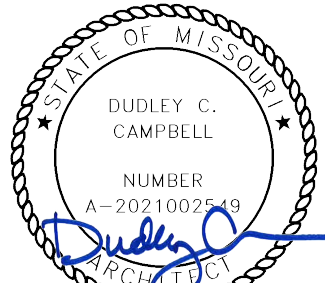
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ARCHITECTURAL SITE PLAN

AS001
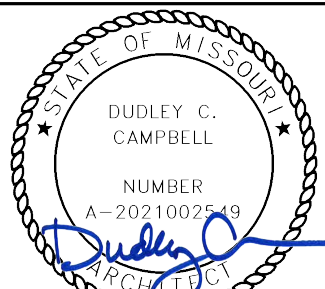
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LIFE SAFETY FLOOR PLAN - LEVEL 1


AC101

MAXIMUM FLOOR AREA ALLOWANCES PER OCCUPANT			
FUNCTION OF SPACE	ID	LOAD FACTOR	COMMENT
ACCESSORY STORAGE AREAS	S	300 SF	GROSS
ASSEMBLY W/O FIXED SEATS - CHAIRS ONLY	AC	7 SF	NET
ASSEMBLY W/O FIXED SEATS - TABLES & CHAIRS (WAITING)	AT	15 SF	NET
BUSINESS AREA (OFFICE)	B	150 SF	GROSS
INSTITUTIONAL - INPATIENT TREATMENT AREA	II	240 SF	GROSS
INSTITUTIONAL - OUTPATIENT AREA	IO	100 SF	GROSS
INSTITUTIONAL - SLEEPING AREA	IS	120 SF	GROSS

ROOM OCCUPANCY - LEVEL 1					
NUMBER	NAME	AREA	OCC ID	LOAD FACTOR	OCC LOAD
1-1335	(E) VESTIBULE	78 SF			
2-2000	WAITING	102 SF	AT	15 SF	7
2-2001	RECEPTION	139 SF	B	150 SF	1
2-2002	CEO OFFICE	198 SF	B	150 SF	2
2-2003	CNO OFFICE	139 SF	B	150 SF	1
2-2004	COO OFFICE	139 SF	B	150 SF	1
2-2005	CFO OFFICE	137 SF	B	150 SF	1
2-2006	CMO OFFICE	132 SF	B	150 SF	1
2-2007	PHYSICIAN PROVIDER RELATIONSHIP OFFICE	106 SF	B	150 SF	1
2-2008	MARKETING OFFICE	106 SF	B	150 SF	1
2-2009	SHARED OFFICE	143 SF	B	150 SF	1
2-2010	CONFERENCE	213 SF	AT	15 SF	15
2-2011	BOARD ROOM	552 SF	AT	15 SF	37
2-2012	COPY/WORK	124 SF	B	150 SF	1
2-2013	STORAGE	46 SF	S	300 SF	1
2-2014	STORAGE	45 SF	S	300 SF	1
2-2015	BREAK/NOURISH	114 SF	B	150 SF	1
2-2016	COMM	75 SF	S	300 SF	1
2-2017	STORAGE	56 SF	S	300 SF	1
2-2018	TLT	51 SF	B	150 SF	1
2-2019	TLT	54 SF	B	150 SF	1
77					

LEVEL 1 EXISTING OCCUPANT LOAD AT B OCCUPANCY = 197 OCCUPANTS
LEVEL 1 ADMINISTRATION OCCUPANT LOAD AT B OCCUPANCY = 77 OCCUPANTS
274 OCCUPANTS / 4 EXITS = 69 OCCUPANTS PER EXIT

LIFE SAFETY LEGEND

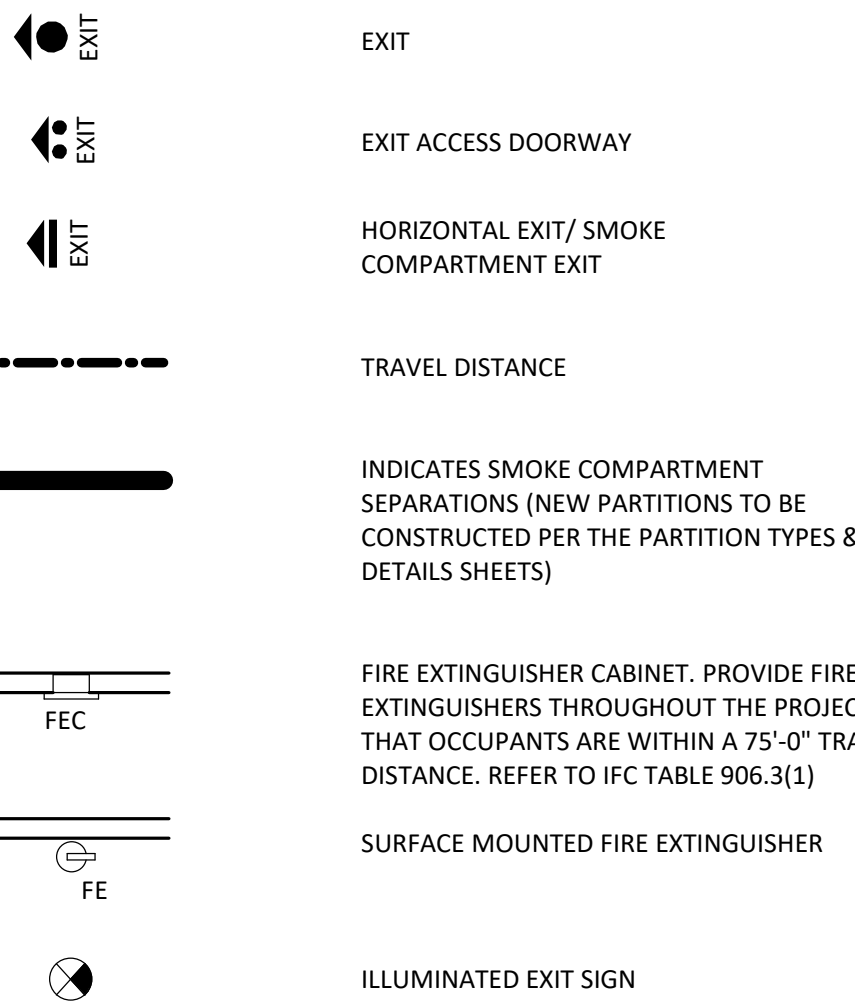

MEANS OF EGRESS GENERAL NOTES

THE FOLLOWING MINIMUM CLEAR WIDTHS OF EGRESS COMPONENTS SHALL BE MET OR EXCEEDED.	
COMPONENT	MINIMUM CLEAR WIDTH
DOORS:	
MEANS OF EGRESS	32 INCHES
MEANS OF EGRESS IN 1-2 OCCUPANCY USED FOR MOVEMENT OF BEDS	41 1/2 INCHES
STAIRWAYS:	
GENERAL	44 INCHES
AISES:	
GENERAL	36 INCHES
CORRIDORS, RAMPS, AND EXIT PASSAGEWAYS:	
50 OCCUPANTS OR GREATER	44 INCHES
LESS THAN 50 OCCUPANTS	36 INCHES
WHERE REQUIRED FOR BED MOVEMENT	96 INCHES
OUTPATIENT GURNEY TRAFFIC	72 INCHES

PARTITION LEGEND



EXIT ACCESS TRAVEL DISTANCE - LEVEL 1

PER IBC 1016.1 THE MAX LENGTH OF EXIT ACCESS TRAVEL SHALL NOT EXCEED 300FT (B OCCUPANCY)



PATH NAME		DISTANCE
LEVEL 1		
A PATH		102'-3"
B PATH		263'-7"

EXIT DOOR SCHEDULE


MINIMUM EGRESS WIDTH REQUIRED IS THE GREATER WIDTH CALCULATED PER IBC SECTION 1005.3 AND 1010.1.1. AND MINIMUM EGRESS WIDTH PROVIDED ASSUMES LEAF THICKNESS OF 2", INCLUDING HINGES

DOOR #	DESCRIPTION	OCC. LOAD	WIDTH REQUIRED	WIDTH PROVIDED
LEVEL 1				
DOOR #2	@ MOB. ENT.	76	31 3/4"	36"
DOOR #5	@ REAR	76	31 3/4"	60"

SMOKE COMPARTMENT PLAN

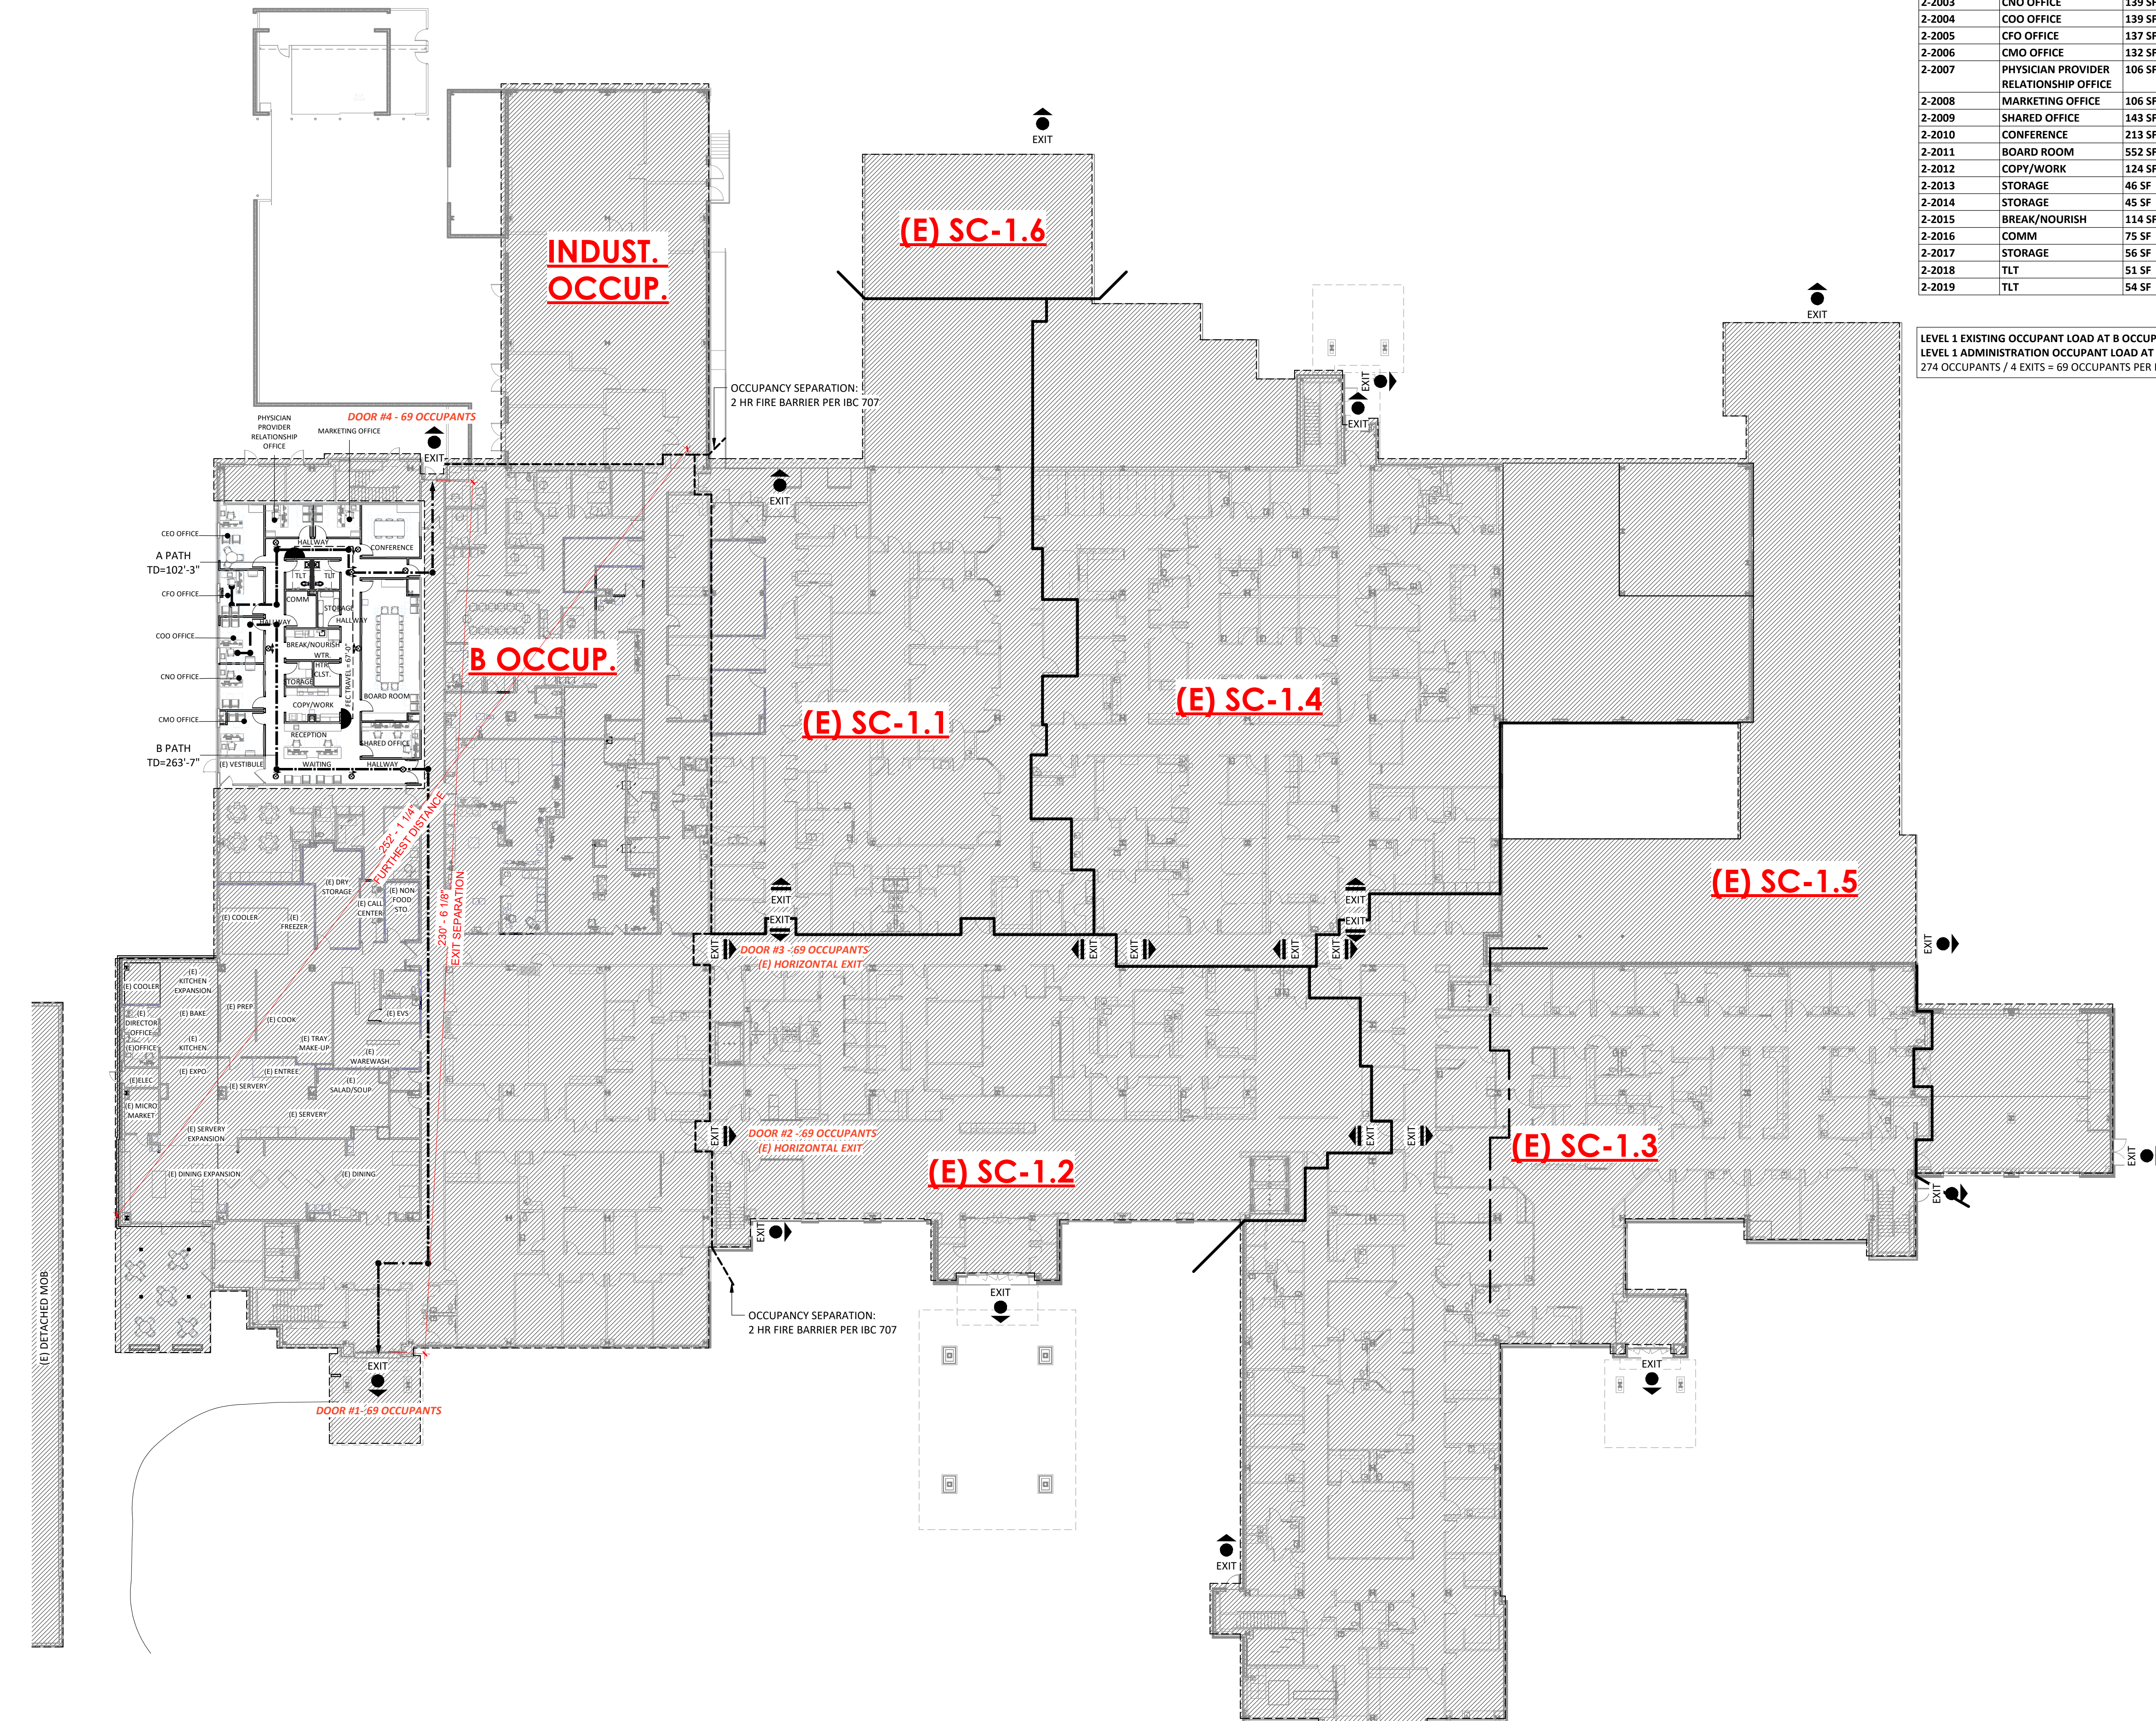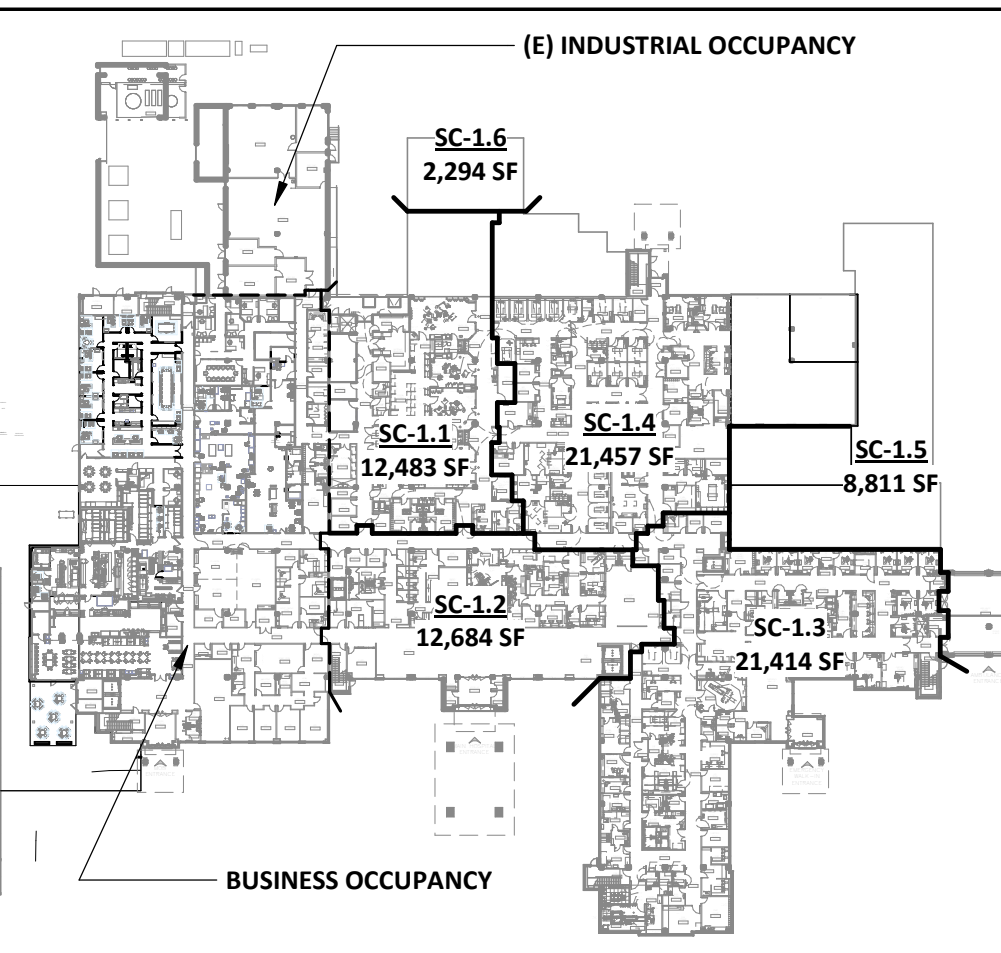

SUMMARY OF REQUIRED FIRE PROTECTION ASSEMBLIES							
CATEGORY	FUNCTION	DESCRIPTION	REQUIRED RATING	TYPE OF PROTECTION	BASIS OF DESIGN PRODUCT	LISTED DETAIL	NOTES
PARTITIONS	SEPARATION OF ACCESSORY USE AREAS PER NFPA	RATED PARTITIONS	1-HOUR	GYPSUM BOARD / STEEL STUD ASSEMBLY	US GYPSUM PRODUCTS	UL DESIGN U419	SEE "LISTED DETAILS" SHEETS FOR FULL DETAIL DESCRIPTION
JOINTS	INTERIOR STUD PARTITION BASE & HEAD TERMINATION @ RATED DECK	RATED WALL JOINT	1-HOUR & 2-HOUR	FIRE RESISTIVE JOINT MATERIAL ASSEMBLY FOR STUD ASSEMBLIES	US GYPSUM PRODUCTS	BW-S-0002 BW-S-0013 BW-S-0020 BW-S-0023 BW-S-0039 HW-D-0181 HW-D-0294 HW-D-0440 HW-D-0259 HW-D-0264 HW-D-0324 HW-D-0388 HW-D-0303 HW-D-0538 HW-D-0541 HW-D-0570 HW-D-0571 HW-D-0572 HW-D-0579 HW-D-0646 HW-D-0871 HW-D-0872	SEE "LISTED DETAILS" SHEETS FOR FULL DETAIL DESCRIPTION
	INTERIOR SHAFT STUD WALL HEAD / SILL TERMINATION	RATED WALL JOINT	1-HOUR & 2-HOUR	FIRE RESISTIVE JOINT MATERIAL ASSEMBLY FOR STUD ASSEMBLIES	US GYPSUM PRODUCTS	BW-S-023, HW-D-0646	SEE "LISTED DETAILS" SHEETS FOR FULL DETAIL DESCRIPTION
	PENETRATION OF RATED STUD PARTITIONS BY STRUCTURAL FRAMING MEMBERS	RATED PENETRATION JOINT	1-HOUR & 2-HOUR	FIRE RESISTIVE JOINT MATERIALS FOR STUD ASSEMBLIES	VARIES - SEE UL DETAIL	HW-D-0218	SEE "LISTED DETAILS" SHEETS FOR FULL DETAIL DESCRIPTION
	EDGE OF 2ND FLOOR SLAB AT CURTAIN WALLS	RATED SLAB EDGE JOINT	1-HOUR	FIRE RESISTIVE JOINT MATERIAL ASSEMBLY FOR DISSIMILAR MATERIALS	VARIES - SEE UL DETAIL	CEJ 421 P CW-D-1003	SEE "LISTED DETAILS" SHEETS FOR FULL DETAIL DESCRIPTION
	INTERIOR RATED EXPANSION JOINT AT SMOKE BARRIER WALLS	RATED EXPANSION JOINT	1-HOUR	FIRE RESISTIVE JOINT MATERIAL ASSEMBLY FOR GYPSUM BOARD	FIRELINE 520	CSI/EICA-120-01 CSI/EICA-120-02 UL FF-D-3006 UL WW-D-3007 UL FF-D-4002	SEE "LISTED DETAILS" SHEETS FOR FULL DETAIL DESCRIPTION
PENETRATIONS	RATED PARTITION PENETRATIONS FOR MECHANICAL, PLUMBING, OR ELECTRICAL ITEMS	VARIOUS PENETRATIONS THROUGH RATED PARTITIONS AS REQUIRED	1-HOUR & 2-HOUR	FIRE RESISTIVE JOINT MATERIAL / ASSEMBLY	VARIES	W-L-1001 W-L-1146 W-L-1166 W-L-1054 W-L-1206 W-L-1462 W-L-3161 W-L-3334 W-L-3414 W-L-5001 W-L-7130 W-L-7154 W-L-7155 W-L-8023	SEE "LISTED DETAILS" SHEETS FOR FULL DETAIL DESCRIPTION
	RATED DECK PENETRATIONS FOR MECHANICAL, PLUMBING, OR ELECTRICAL ITEMS	VARIOUS PENETRATIONS THROUGH RATED DECKING AS REQUIRED	1-HOUR	FIRE RESISTIVE JOINT MATERIAL / ASSEMBLY	VARIES	UL DESIGN C-AJ-5156	SEE "LISTED DETAILS" SHEETS FOR FULL DETAIL DESCRIPTION

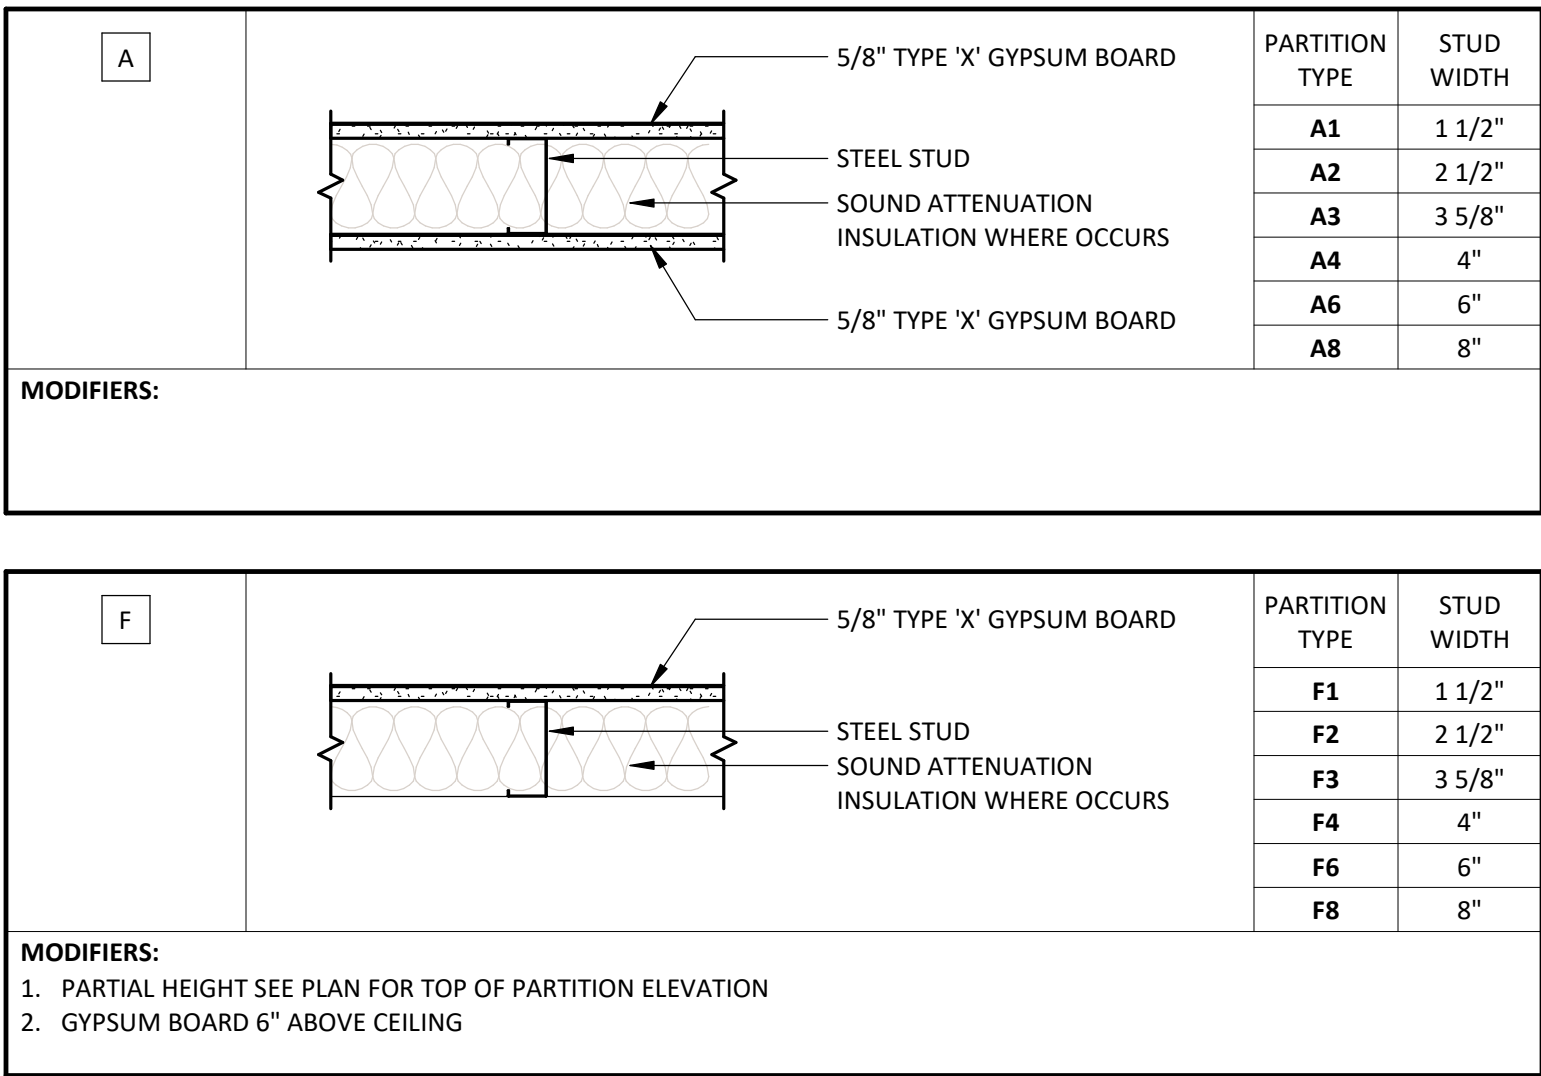

PARTITIONS GENERAL NOTES

1. ALL PARTITIONS TO EXTEND TO DECK ABOVE UNLESS NOTED OTHERWISE.

2. BRACE PARTITION TO STRUCTURE ABOVE.

3. PROVIDE MOISTURE RESISTANT GYPSUM BOARD (OR CEMENT BOARD) AT WALL TILE LOCATIONS IN LIEU OF STANDARD GYPSUM BOARD.

4. PROVIDE STEEL STUD SILL AND HEADER AT ALL INTERIOR PARTITION PENETRATIONS FOR CONDUIT AND CABLE TRAYS AS REQUIRED.

5. PROVIDE FIRE BATTS AND FIRE SAFING AND SEALANT ASSEMBLIES AT ALL PENETRATIONS THROUGH RATED PARTITIONS AS REQUIRED.

6. FOR STC RATINGS SEE DIMENSION PLANS. PROVIDE CONTINUOUS ACOUSTICAL SEALANT AT THE BOTTOM TRACK AND AT TOP TRACK WHERE PARTITION EXTENDS TO DECK.

7. STUD DEPTHS, HEIGHTS AND LIMITS TO BE ENGINEERED BY THE STUD DESIGN ENGINEER.

PARTITIONS LEGEND

A4

#

INDICATES PARTITION TYPE

INDICATES MODIFIER

Devenney GROUP

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ADMINISTRATION
RELOCATION

HCA - LEE'S SUMMIT
MEDICAL CENTER

A

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AUTHORITY HAVING JURISDICTION:
CITY OF LEE'S SUMMIT BUILDING DEPT.
MISSOURI DHSS

FACILITY NUMBER:
0972400009

AGENCY APPROVALS:
AGENCY

REVISIONS		
REV #	DESCRIPTION	DATE
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DATE: 04/18/2025

SCALE: 1 1/2" = 1'-0"

DRAWN: JV

REVIEWED: MM/DP

JOB NUMBER: 6406.24

PARTITION TYPES & DETAILS


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6/3/2025 2:17:14 PM Autodesk Docs://6406.24 - HCA - Lee's Summit Medical Center (LSMC) - r123/6406.24.0001 LCA - LSMC Admin Relocation.rvt



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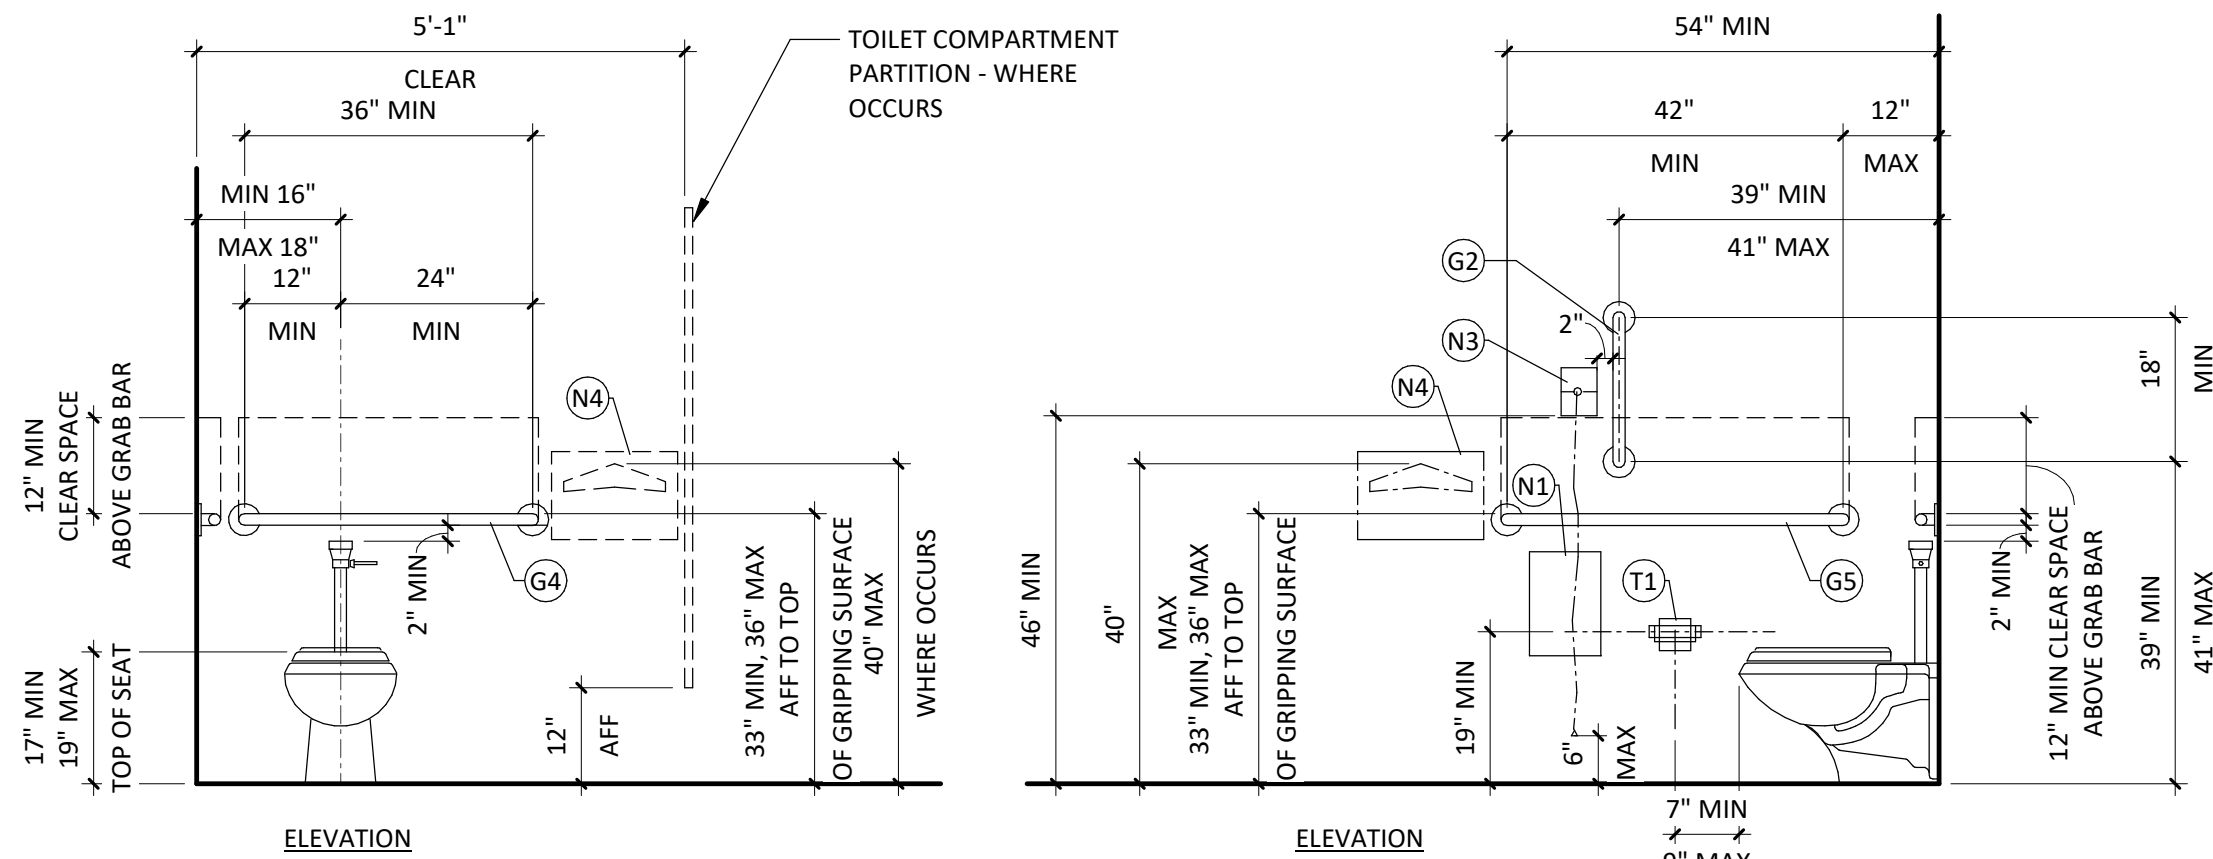
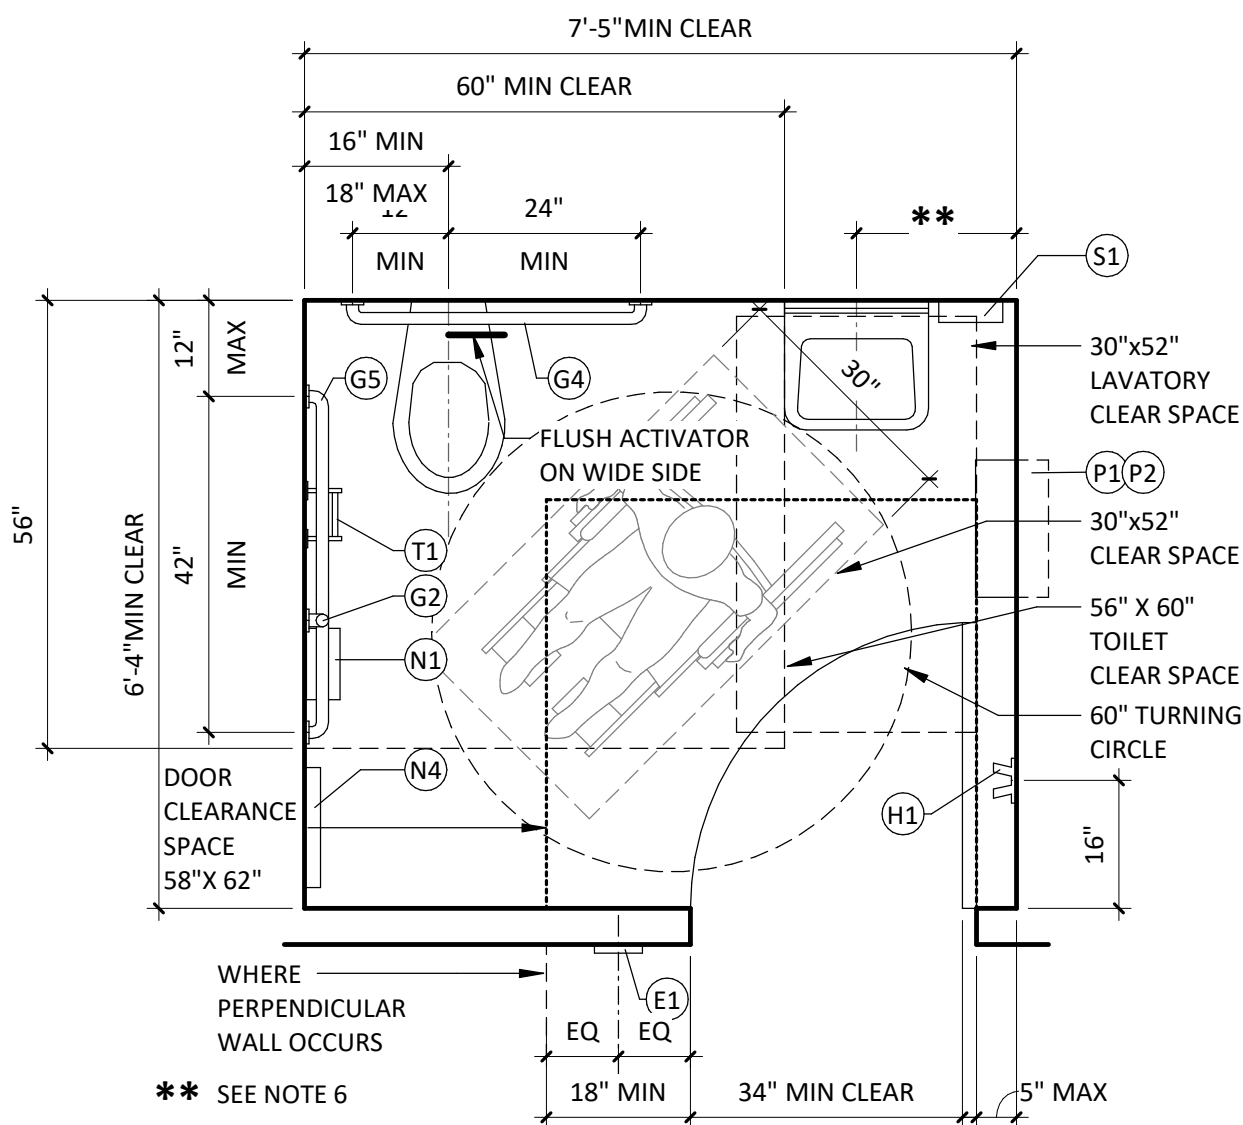
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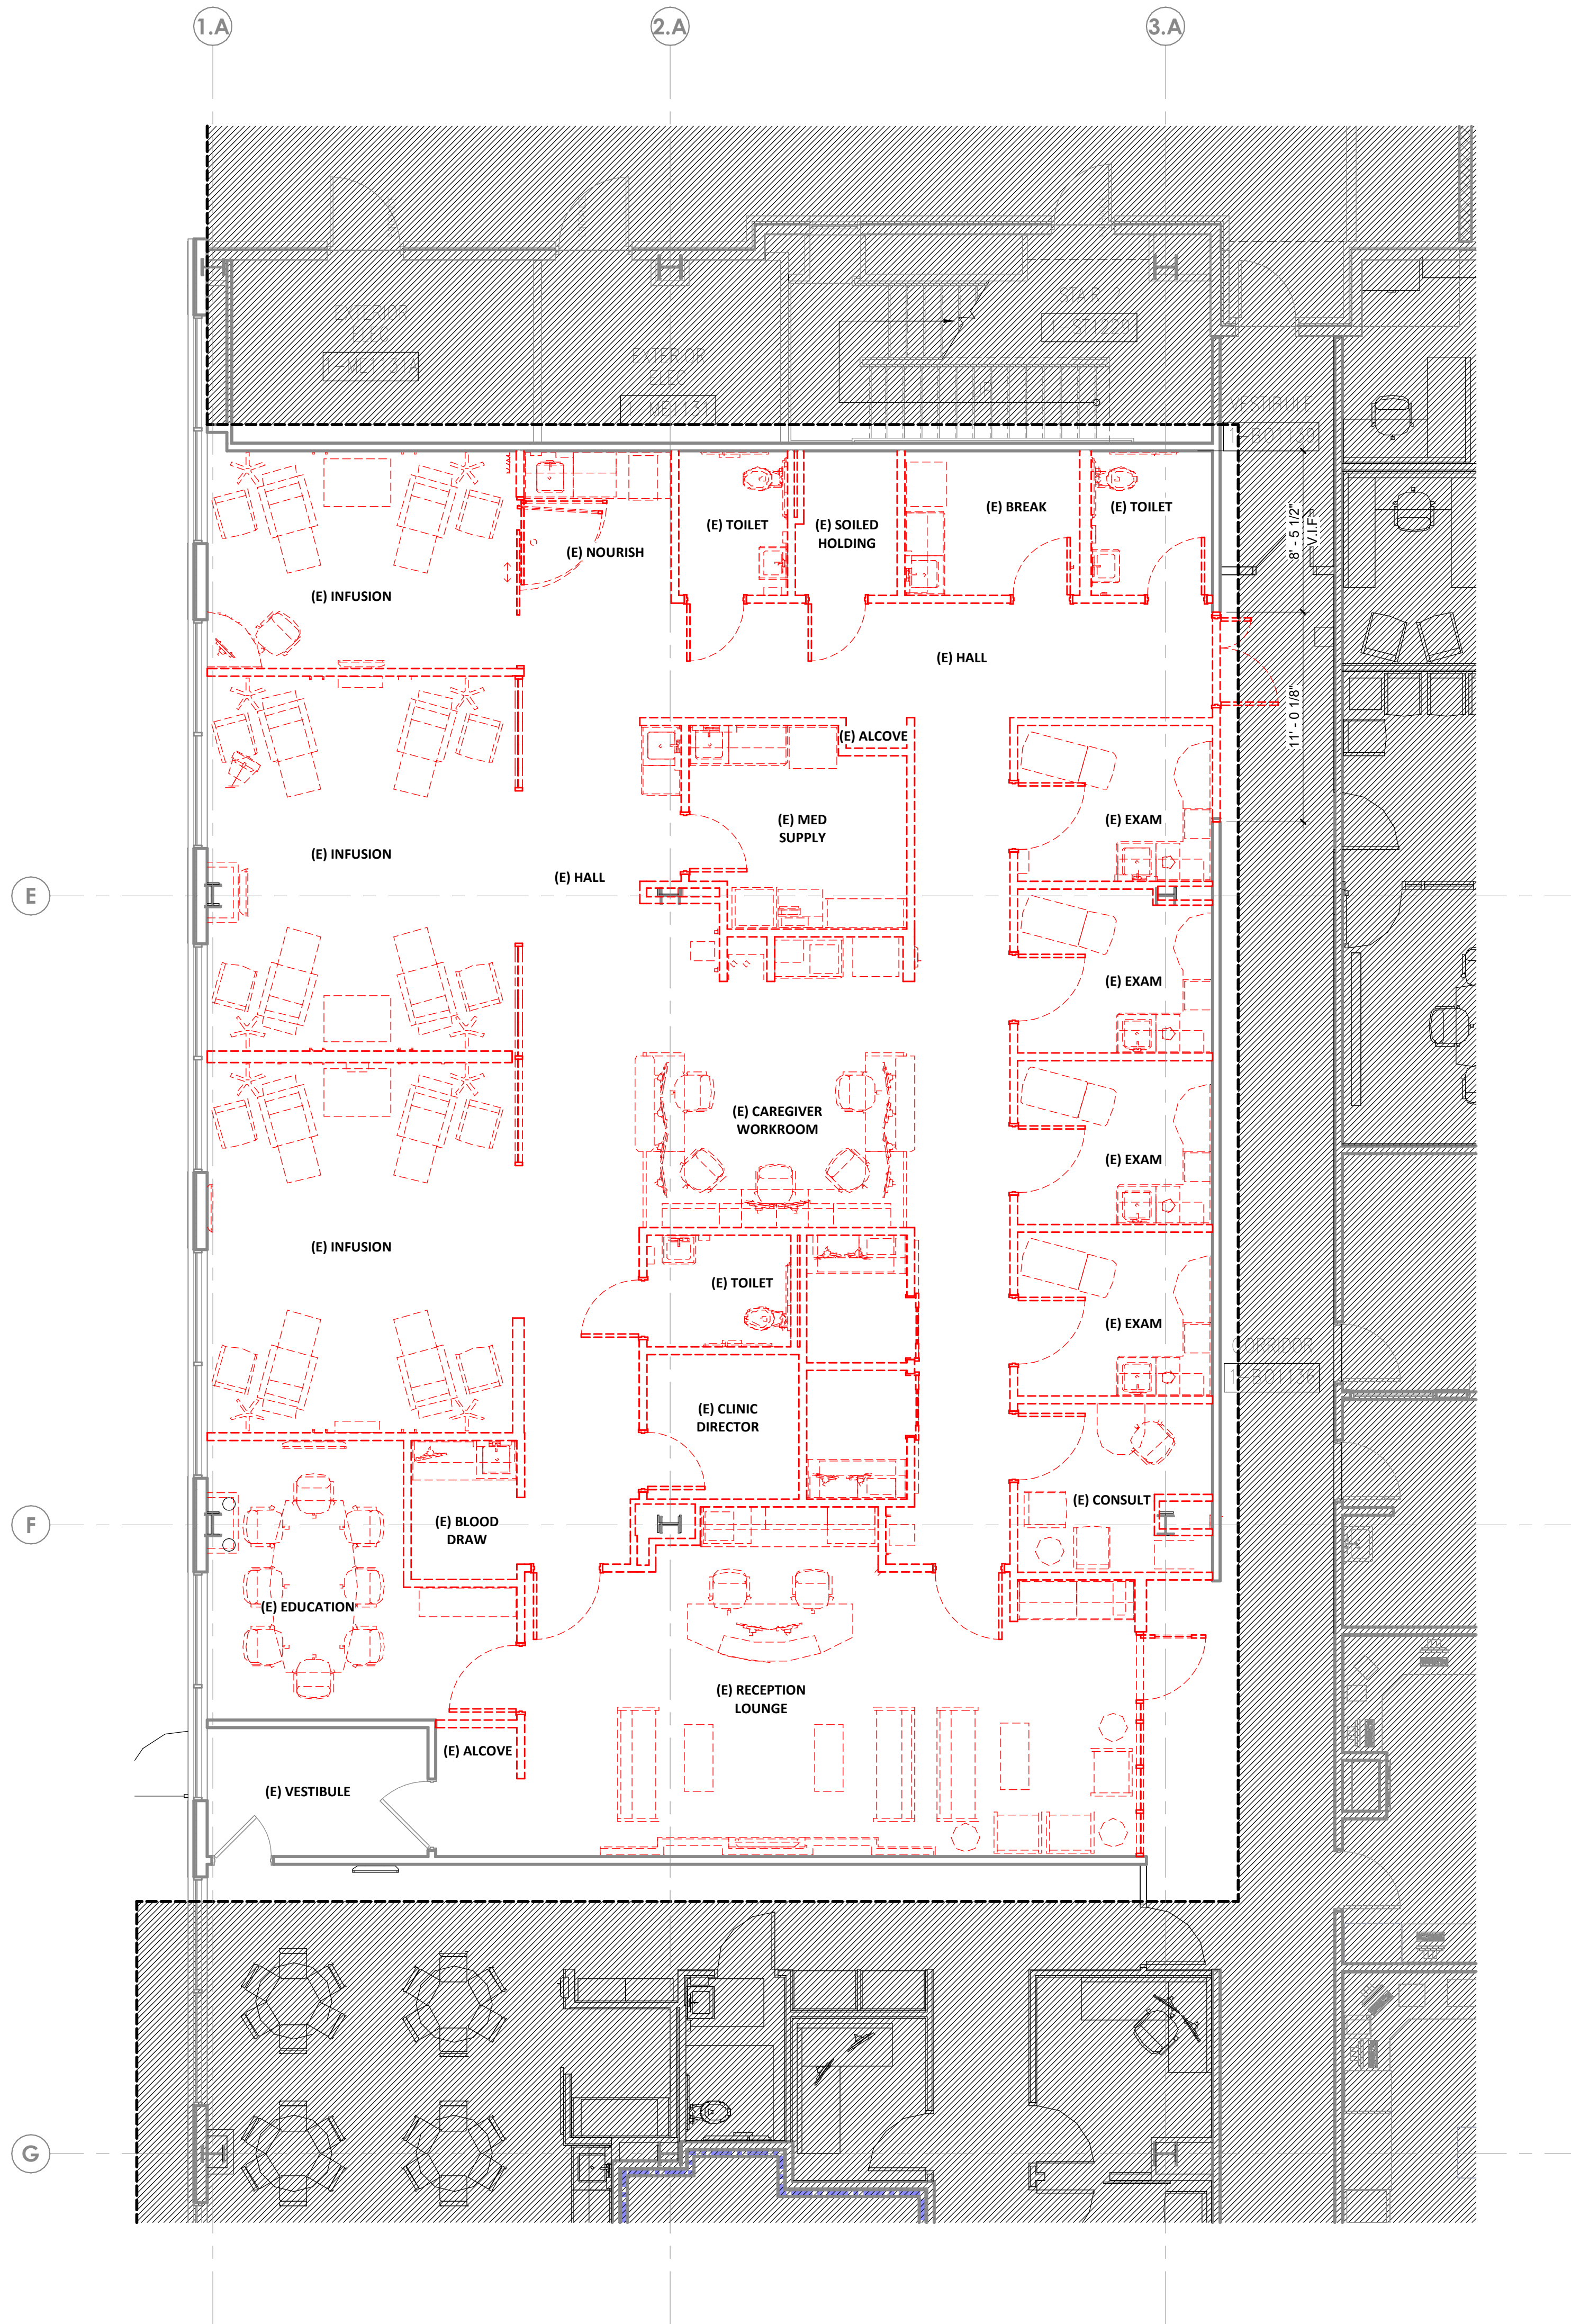
TYPICAL MOUNTING HEIGHTS

1. IT IS THE INTENT OF THE DESIGN THAT ALL ITEMS SHOWN MOUNTED AT TYPICAL HEIGHTS BE ACCESSIBLE TO PERSONS WITH DISABILITIES. ITEMS INDICATED AS NON-ACCESSIBLE ARE INTENDED FOR AUTHORIZED STAFF & SHALL BE COORDINATED WITH THE OWNER AND/OR ARCHITECT'S REQUIREMENTS.
2. THE PURPOSE OF THIS SHEET IS TO ILLUSTRATE TYPICAL MOUNTING HEIGHTS AND WHERE APPLICABLE - TYPICAL MINIMUM OR MAXIMUM CLEARANCES AND/OR DIMENSIONS. DIMENSIONS CANNOT BE GUARANTEED AS THEY MAY OCCUR AS PART OF THIS PROJECT. REFER TO THE PLANS, ELEVATIONS, SECTIONS, DETAILS, AND SCHEDULES TO DETERMINE WHICH ITEMS AND CONFIGURATIONS APPLY TO THE WORK OF THIS PROJECT.
3. TYPE DIMENSIONS SHOWN ON THIS SHEET TAKE PRECEDENCE OVER TYPICAL DIMENSIONS SHOWN ON THE ELECTRICAL OR MECHANICAL DRAWINGS FOR THE MOUNTING OF ITEMS INSTALLED BY THE ELECTRICAL OR MECHANICAL TRADES. WHERE DISCREPANCIES OCCUR ARCHITECT SHALL BE NOTIFIED IN WRITING. MODIFYING HEIGHTS, CLEARANCES, AND ACCESS REQUIREMENTS FOR ACCESSIBLE TOILET ACCESSORIES SHOWN ON THIS SHEET ARE GENERIC. SPECIFIC MANUFACTURERS AND MODELS AS INDICATED IN THE PROJECT MANUAL MOUNTING HEIGHTS, DIMENSIONS, CLEARANCES, AND ACCESS REQUIREMENTS OF THE SIMILAR MANUFACTURED ITEMS VARY. WHEN SUCH INFORMATION IS PROVIDED, THESE ITEMS ARE UTILIZED, THE CONTRACTOR SHALL BE RESPONSIBLE FOR ALL COORDINATION REQUIRED TO ACHIEVE THE SAME AESTHETIC, FUNCTIONAL, AND ACCESSIBLE DESIGN INTENT ILLUSTRATED BY THE CONFIGURATION SHOWN ON THE DRAWINGS.
4. THE MINIMUM CLEARANCE FROM THE TOP OF THE LAVATORY BASIN TO THE BOTTOM OF THE LAVATORY BASIN AREA NOT LESS THAN 34 SQ. INCHES WITH A MINIMUM "R" WIDTH OR LENGTH. THE WATER DISCHARGE POINT OF THE GOOSENECK FAUCET SHALL BE A MINIMUM 10" ABOVE THE BOTTOM OF THE LAVATORY BASIN. PER FG GUIDELINES, THE MINIMUM R AND L SHALL BE 18". THE MINIMUM CLEARANCE FROM THE TOP OF THE WASHSTAND AN APPLIED VERTICAL LOAD NOT LESS THAN 25 POUNDS ON THE FIXTURE & MILLWORK FRONT.
6. 18" MIN WHEN USING [P3] WASTE RECYCLE BIN SHALL NOT ENCRONCH ON FUTURE CLEANING SPACE. COORDINATE WITH OWNER & ARCHITECT WHEN USING A [P3] COMBINATION UNIT.

X1	SURFACE MOUNTED FOLDING SHOWER SEAT- 'L' SHAPE
Y2	SURFACE MOUNTED FOLDING SHOWER SEAT- RECTANGULAR
X1	SHOWER CURTAIN ROD
X2	TRENCH DRAIN @TOE OF COVE
M1	HAND HELD FLEXIBLE SHOWER SPRAY & HOSE 59" LONG MIN.
T1	SURFACE MOUNTED OR RECESSED TOILET PAPER DISPENSER
S1	SOAP DISPENSER (ADULT)
S2	SOAP DISPENSER (CHILD)
S3	SOAP DISH
S4	COUNTER MOUNTED SOAP DISPENSER
P1	SURFACE MOUNTED OR RECESSED PAPER TOWEL DISPENSER (BOBBICK B-262/B-359)
P2	PAPER TOWEL DISPENSER (CHILD)
P3	SEMI RECESSED PAPER TOWEL DISPENSER & WASTE RECEPTACLE (BOBBICK B-3944)
N3	NURSE CALL PULL CORD
N4	TOILET SEAT COVER DISPENSER
N5	BEDPAN WASH
N1	SURFACE MOUNTED SANITARY NAPKIN DISPOSAL AT FEMALE AND UNISEX TOILET ONLY
N2	RECESSED SANITARY NAPKIN DISPOSAL AT FEMALE AND UNISEX TOILET ONLY
M1	24"x36"x3/4" SURFACE MOUNTED MIRROR
M6	18"x24"x3/4" SURFACE MOUNTED MIRROR
H1	SURFACE MOUNTED COAT HOOK
G1	12" LENGTH GRAB BAR
G2	18" LENGTH GRAB BAR
G3	24" LENGTH GRAB BAR
G4	36" LENGTH GRAB BAR
G5	42" LENGTH GRAB BAR
E1	TACTILE ROOM SIGN - WHERE OCCURS

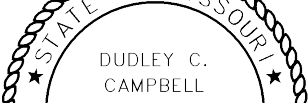
$$2) \quad 1/2'' = 1'-0''$$


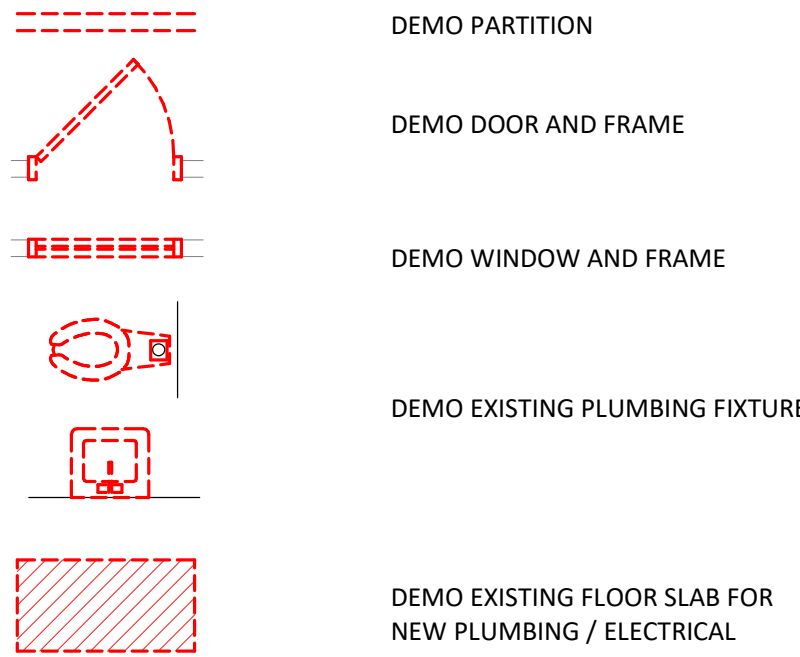
① $\frac{ROO}{1/2'' = 1'-0''}$




DEMOLITION GENERAL NOTES

1. DELIVER SALVAGED ITEMS TO THE OWNER AS DESIGNATED BY THE OWNER'S REPRESENTATIVE. THIS MAY INCLUDE BUT IS NOT LIMITED TO CASEWORK, FURNITURE, DOORS, DOOR HARDWARE, DISPENSERS, MARKERBOARDS, MEDICAL EQUIPMENT, MEDICAL GAS ITEMS, PLUMBING FIXTURES, LIGHT FIXTURES, AND MECHANICAL EQUIPMENT. ALL OTHER ITEMS SHALL BE DISPOSED OF BY CONTRACTOR.
2. PATCH AND REPAIR FLOOR, WALL, AND CEILING PENETRATIONS WHERE ITEMS HAVE BEEN REMOVED TO MATCH EXISTING FINISH. SEAL RATED ASSEMBLIES WITH APPROVED U.L. RATED MATERIALS.
3. PROTECT ADJACENT ITEMS THAT ARE TO REMAIN INCLUDING, BUT NOT LIMITED TO, FINISHES, CASEWORK, FURNITURE, DOORS, PLUMBING FIXTURES, CEILING ASSEMBLIES, AND MECHANICAL EQUIPMENT.
4. PROTECT STRUCTURAL COLUMNS, BEAMS, AND FRAMING. MAINTAIN SPRAYED ON FIREPROOFING RATING AT STRUCTURAL MEMBERS. DAMAGE TO FIREPROOFING SHALL BE PATCHED AND/OR REPLACED TO BRING TO ORIGINAL AND/OR REQUIRED PROTECTION RATING.
5. REMOVE EXISTING FLOOR FINISHES AND PREPARE EXISTING SLAB FOR NEW FINISH INSTALLATION, U.N.O.

DEMOLITION LEGEND



PARTITION LEGEND

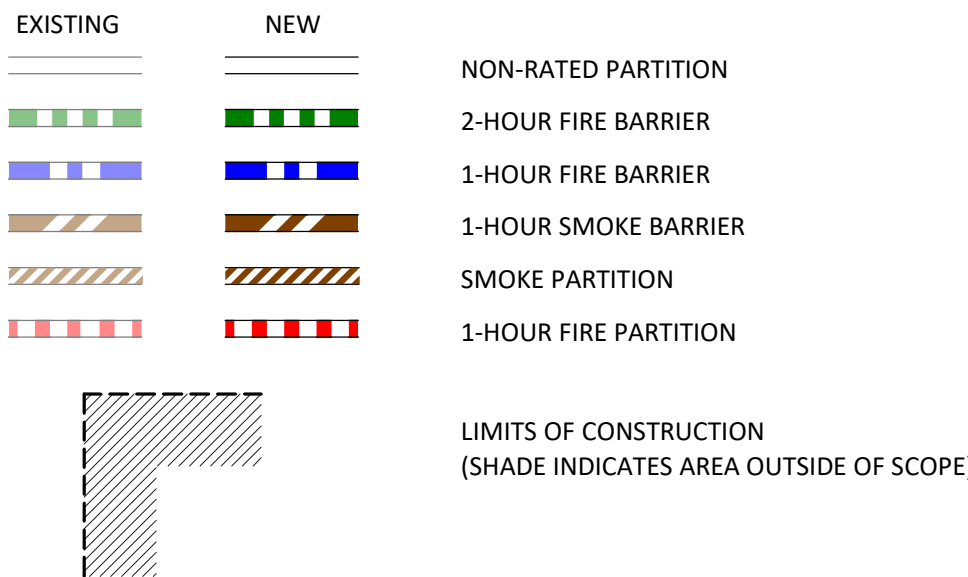


KEYNOTE LEGEND

KEY	NOTE
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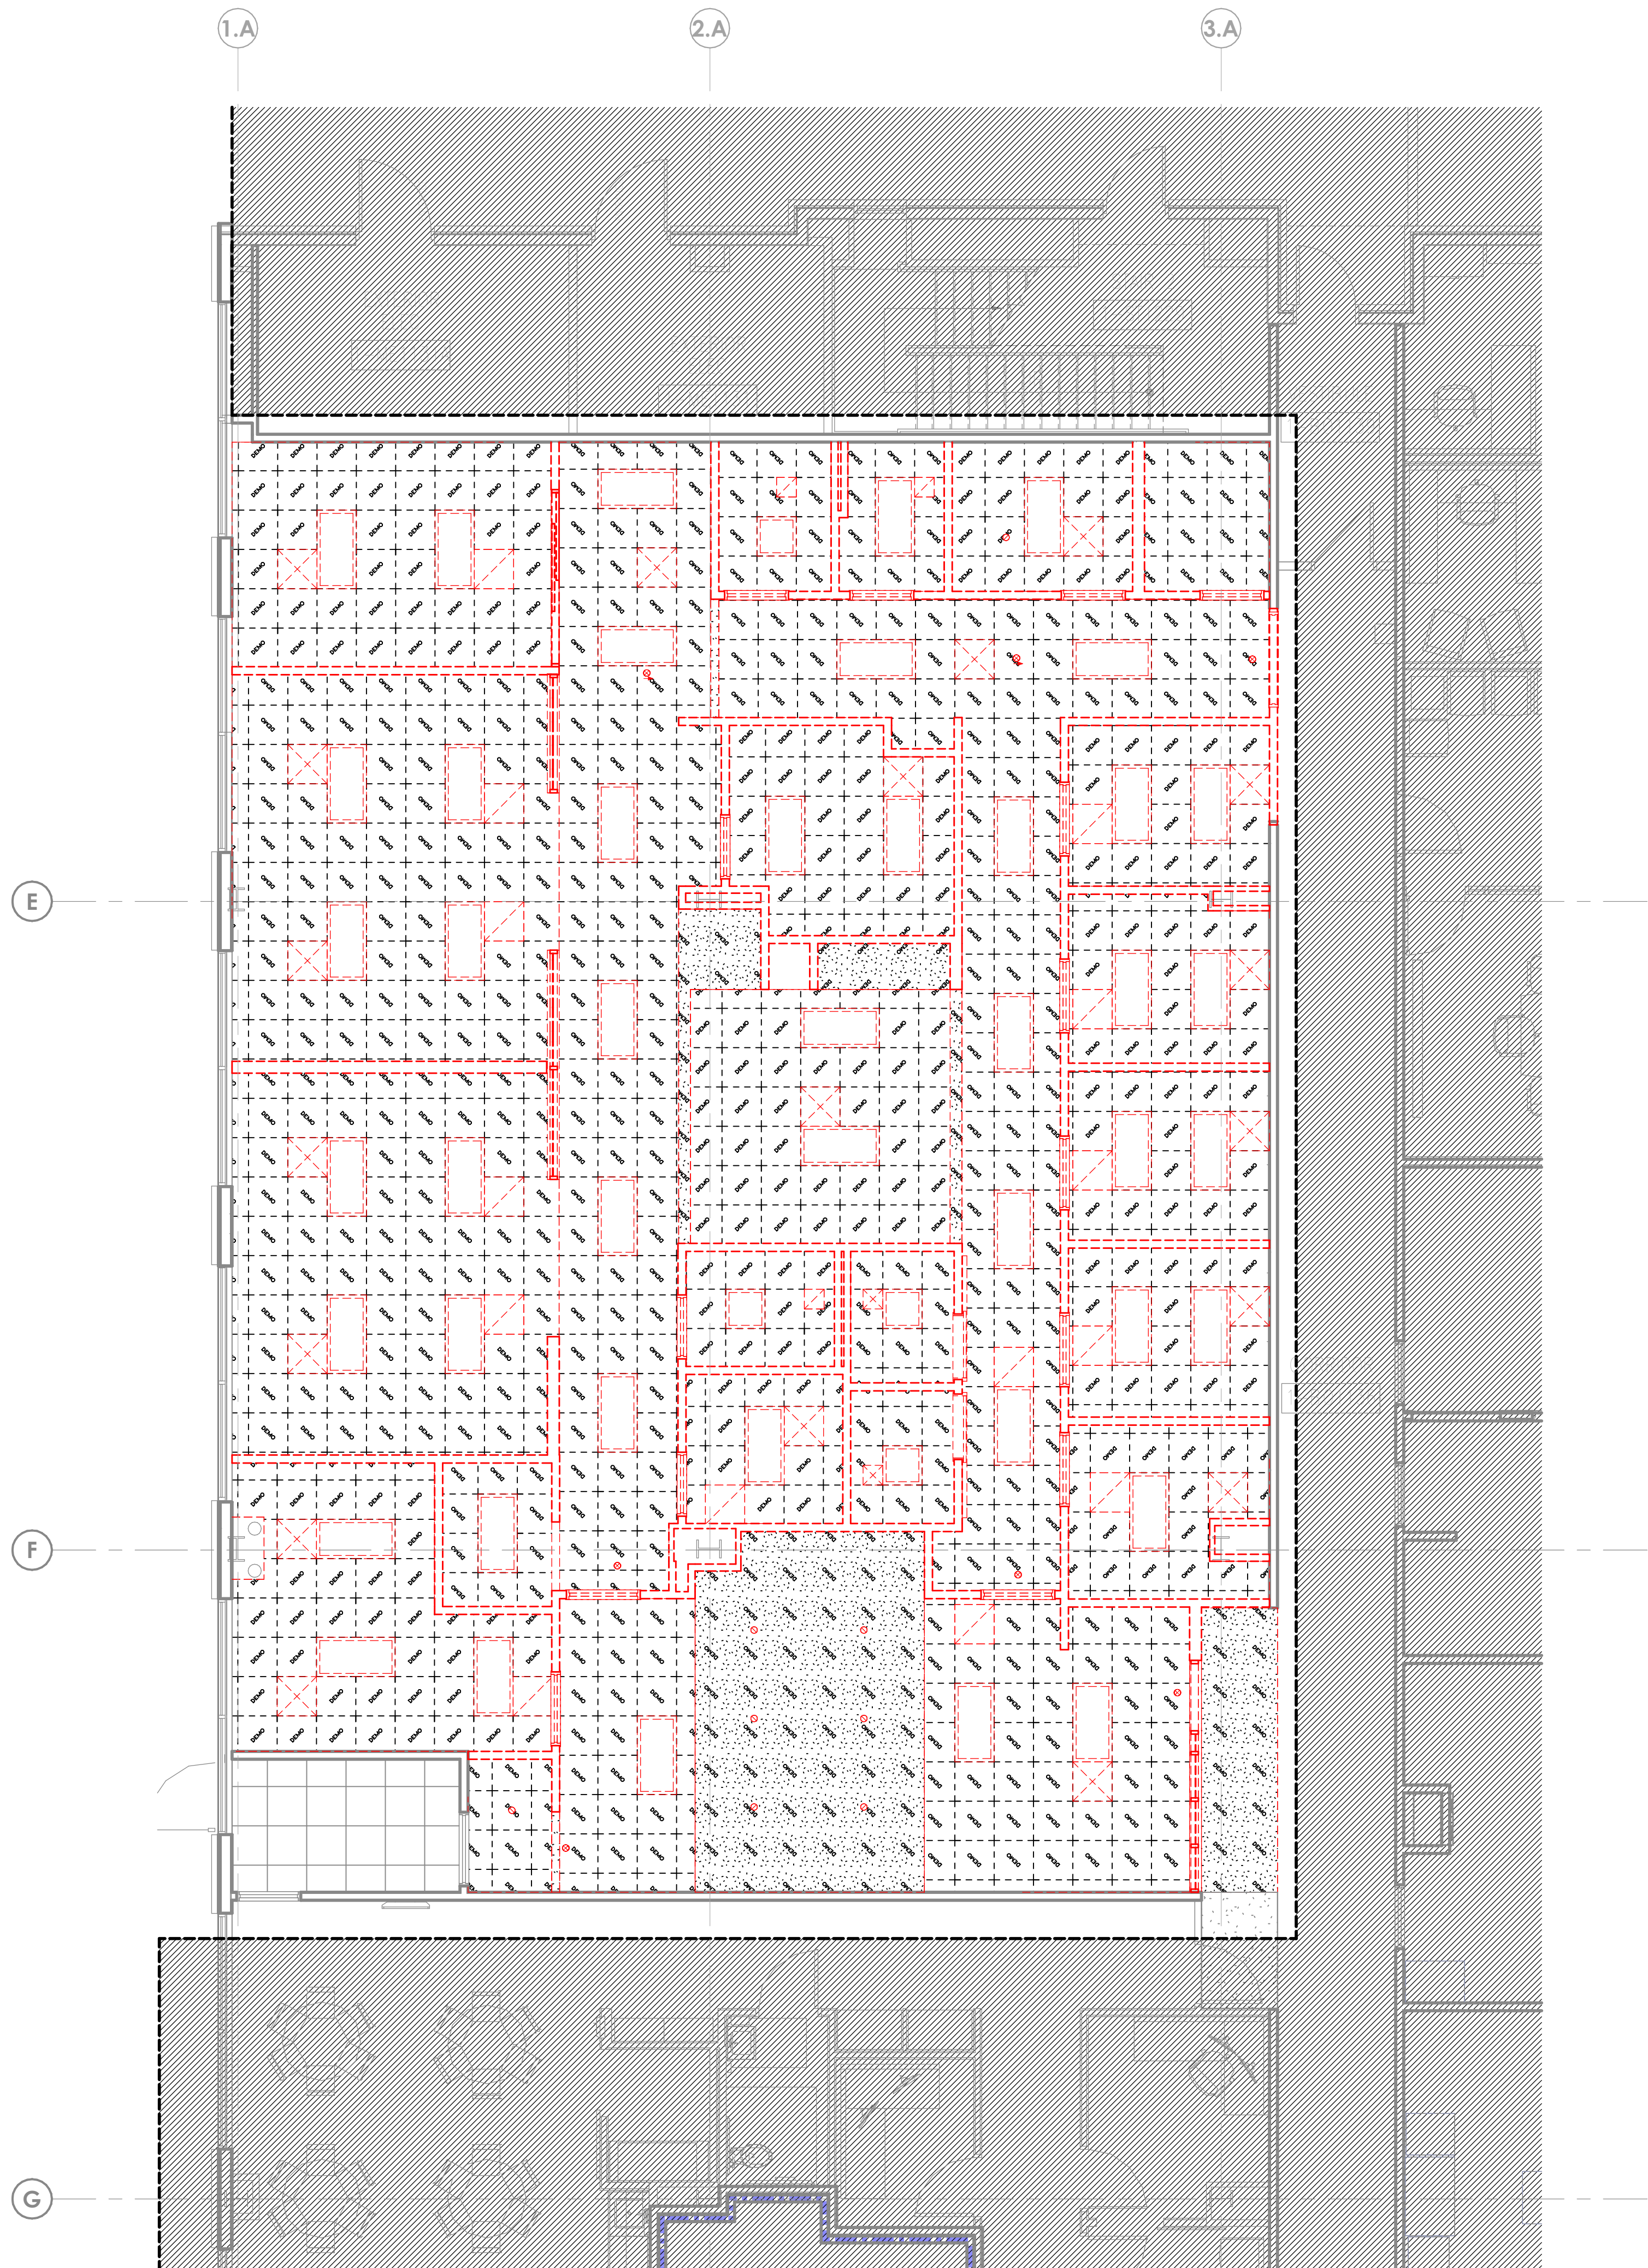
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DEMOLITION PLAN - LEVEL 1

AD101



DEMOLITION GENERAL NOTES
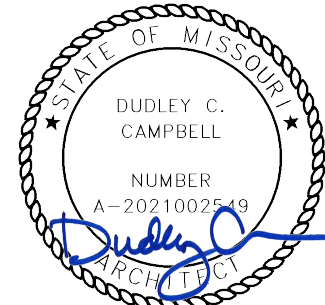
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5. REMOVE EXISTING FLOOR FINISHES AND PREPARE EXISTING SLAB FOR NEW FINISH INSTALLATION, U.N.O.

REFLECTED CEILING LEGEND

EXISTING	DEMO	
		2 X 2 ACOUSTICAL CEILING GRID SYSTEM
		2 X 4 ACOUSTICAL CEILING GRID SYSTEM
		GYPSUM BOARD
		RECESSED FLUORESCENT / LED FIXTURE
		SURFACE MOUNT FLUORESCENT / LED FIXTURE
		FLUORESCENT / LED STRIP LIGHT
		LINEAR PENDENT STRIP LIGHT
		LINEAR PENDENT LIGHT
		PENDENT LIGHT
		RECESSED DOWNLIGHT
		EMERGENCY EXIT SIGN
		SPEAKER
		SMOKE DETECTOR
		SPRINKLER
		UNDER CABINET LIGHT
		LINEAR WALL LIGHT
		WALL SCONCE
		ACCESS PANEL (DIMENSIONED ON PLAN)
		RETURN AIR GRILLE
		EXHAUST GRILLE

PARTITION LEGEND

EXISTING	NEW	
		NON-RATED PARTITION
		2-HOUR FIRE BARRIER
		1-HOUR FIRE BARRIER
		1-HOUR SMOKE BARRIER
		SMOKE PARTITION
		1-HOUR FIRE PARTITION
		LIMITS OF CONSTRUCTION (SHADE INDICATES AREA OUTSIDE OF SCOPE)


KEYNOTE LEGEND

KEY	NOTE
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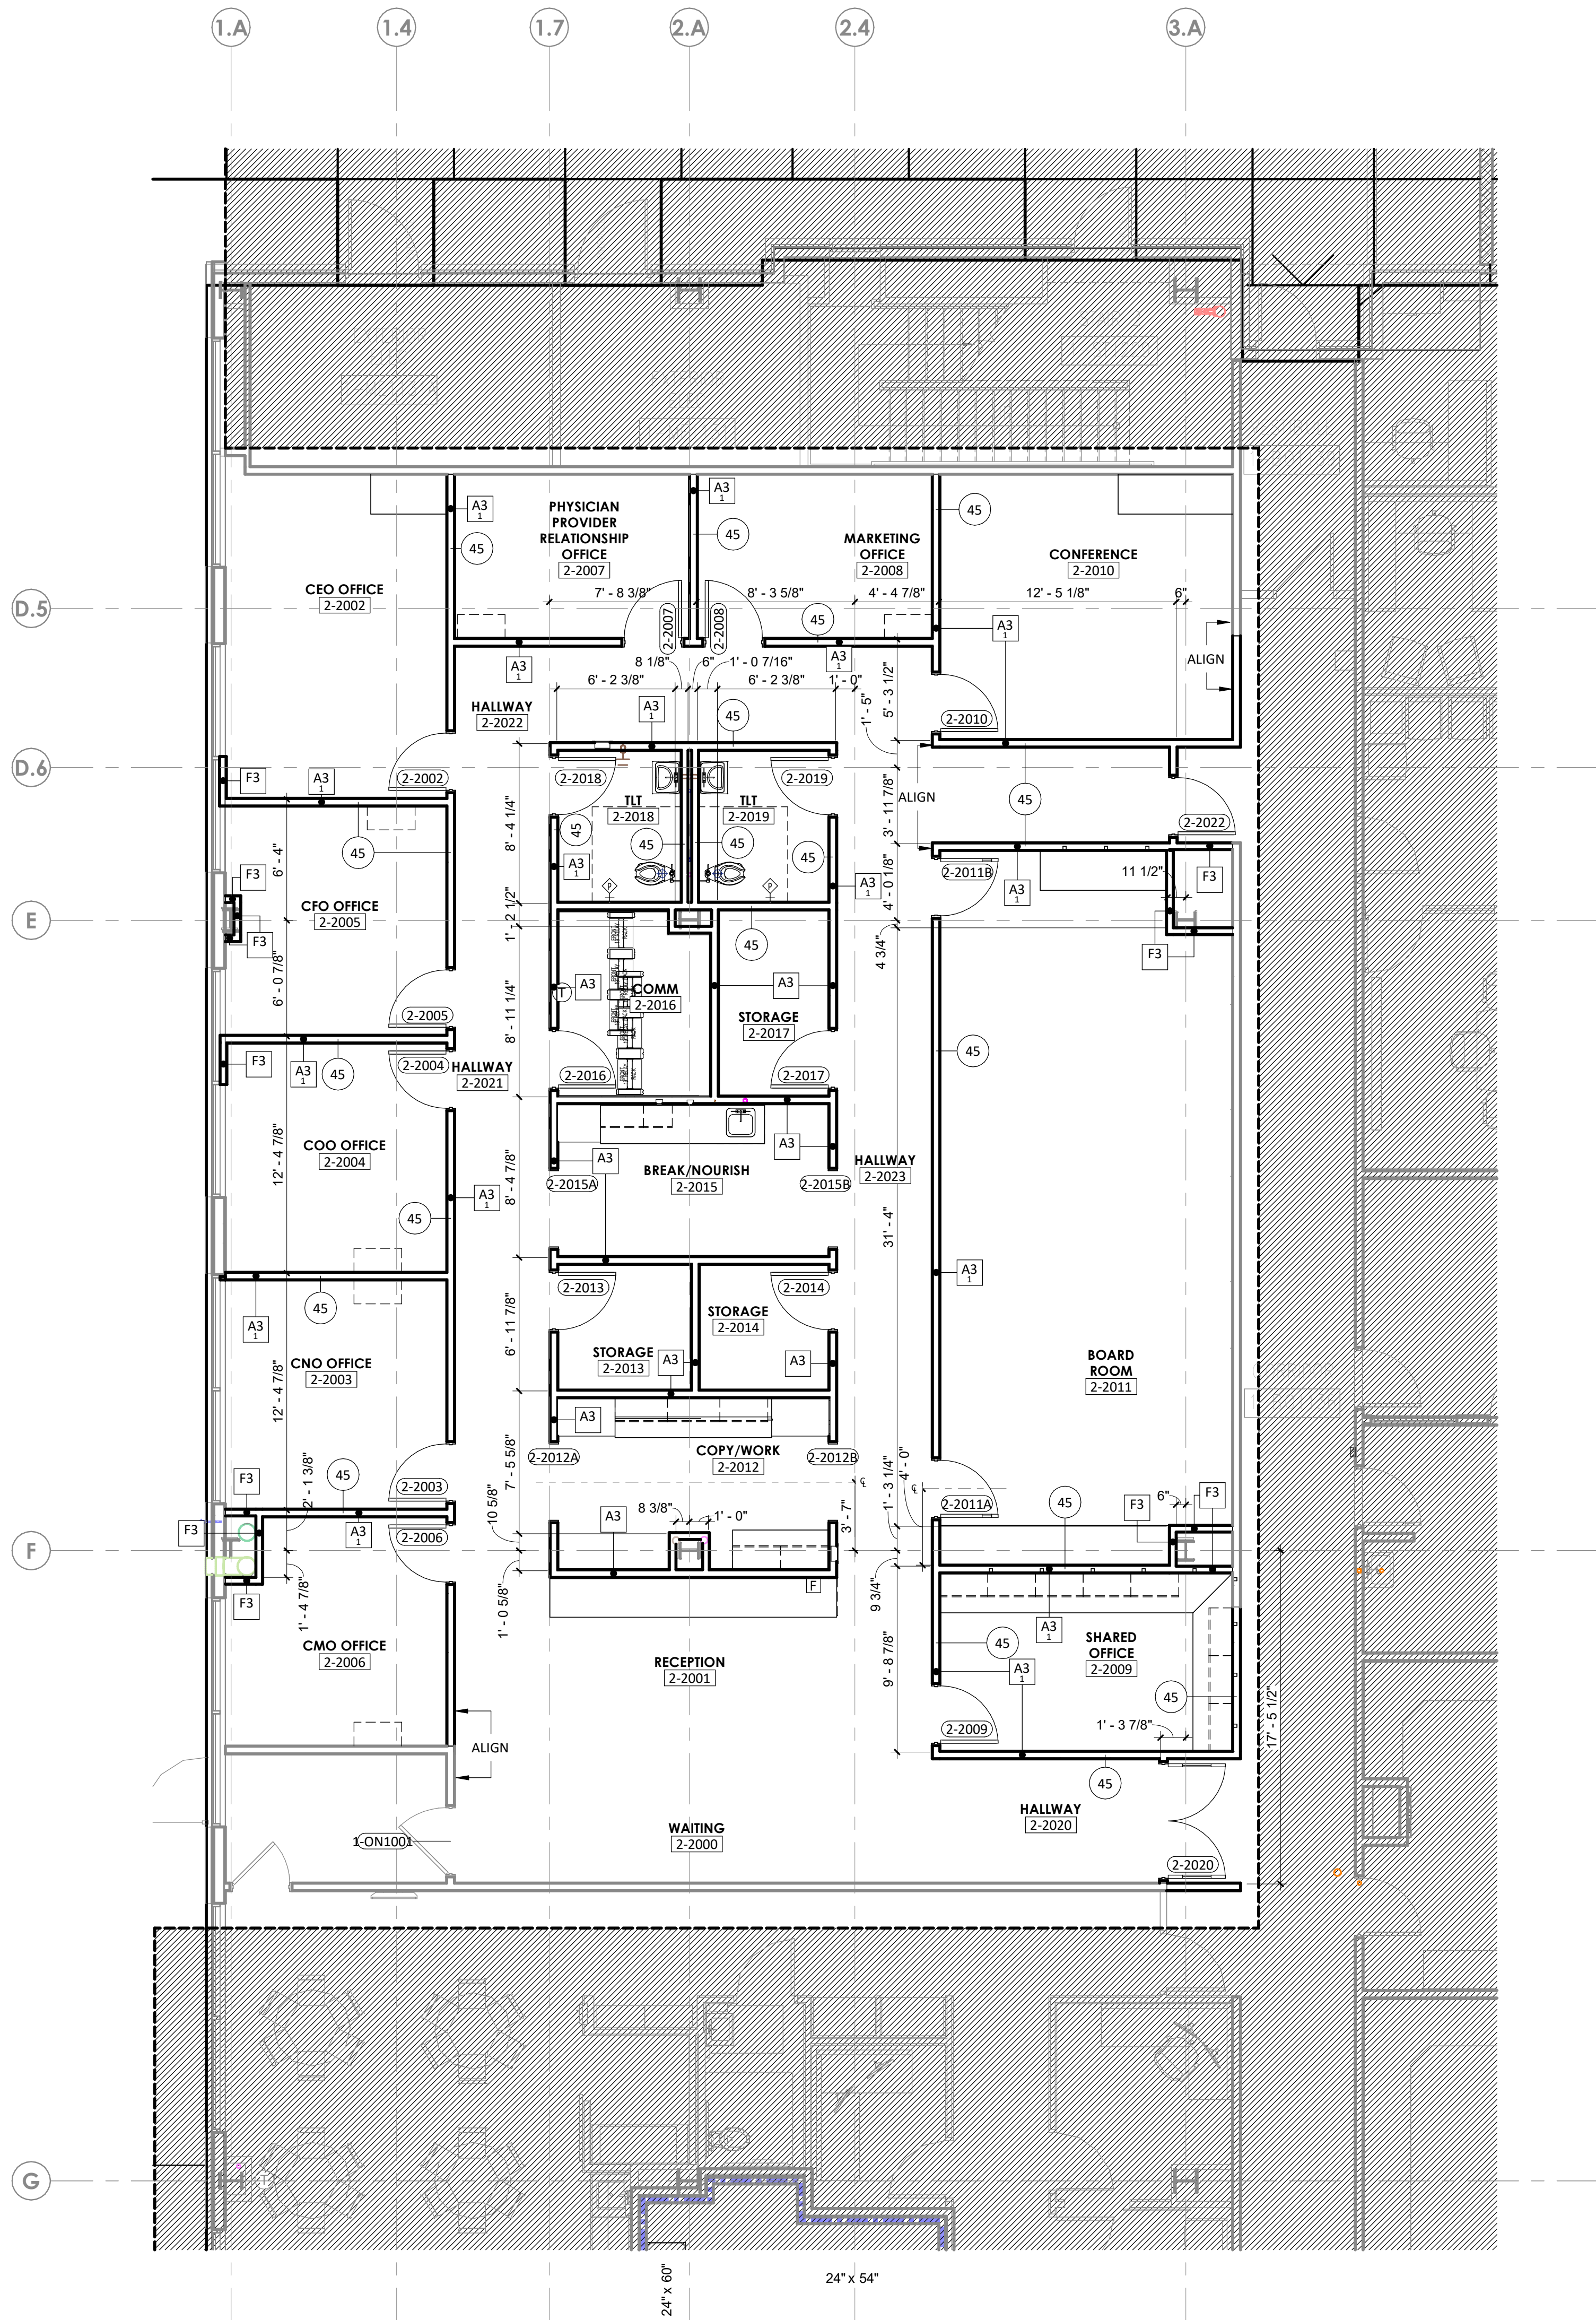
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DEMOLITION RCP - LEVEL 1

AD171



DIMENSION PLANS GENERAL NOTES

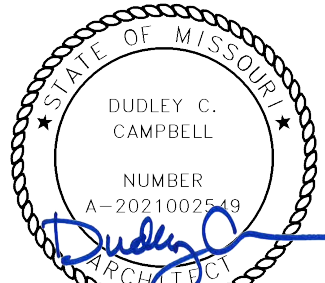1. THE WORD "CLEAR" INDICATES CRITICAL DIMENSIONS FOR ACCESSIBLE EQUIPMENT OR FUNCTIONAL CLEARANCES FROM FACE OF FINISH TO FACE OF FINISH.

2. DIMENSIONS MEASURE FROM THE EXPOSED SURFACE OF EXISTING WALLS, PARTITIONS, COLUMNS, ETC.; NEW PARTITIONS ARE DIMENSIONED TO THE FACE OF THE FRAMING, MEASURE AND VERIFY DIMENSIONS IN FIELD.

3. ALL INFORMATION GRAYED-OUT INDICATES EXISTING OR SCOPE PROVIDED BY OTHERS.

4. WHERE NEW PARTITIONS ABUT EXISTING PARTITIONS, BUILD NEW PARTITION TIGHT TO FACE OF EXISTING PARTITION U.N.O.

PARTITION LEGEND

EXISTING

NEW

NON-RATED PARTITION

2-HOUR FIRE BARRIER

1-HOUR FIRE BARRIER

1-HOUR SMOKE BARRIER

SMOKE PARTITION

1-HOUR FIRE PARTITION

LIMITS OF CONSTRUCTION
(SHADE INDICATES AREA OUTSIDE OF SCOPE)

KEYNOTE LEGEND

KEY

NOTE

STC PARTITION RATINGS ##

DESIGN CRITERIA FOR MIN. SOUND ISOLATION PERFORMANCE BETWEEN ENCLOSED ROOMS¹

TOILET ROOM	PUBLIC SPACE	45
OFFICE	ADJACENT ROOM	45

NOTES:

REFER TO SPECIFICATIONS FOR GYP BD REQUIREMENTS AT STC >40 CONDITIONS.

1. THE STC VALUES STATED ASSUME THE NEED FOR NORMAL SPEECH PRIVACY AS PER FGI 2018 TABLE 1.2.7 - EXCEPT AT CORRIDOR WALLS WITH DOORS - ASSUMING A BACKGROUND SOUND LEVEL OF AT LEAST 30DBA. WHEN SELECTING ASSEMBLIES BASED ON THEIR TESTED OR PUBLISHED STC RATINGS, IT SHOULD BE NOTED THAT LABORATORY STC TEST REPORTS CAN, IN GENERAL, BE CONSIDERED ACCURATE TO +/- 2 STC POINTS. CONSEQUENTLY, AN ASSEMBLY WITH A TESTED OR PUBLISHED STC RATING AS LOW AS 2 POINTS BELOW THE STATED MINIMUM MAY BE CONSIDERED ACCEPTABLE.

2. STC 45 RATING AT OFFICE PROVIDED FOR CONVENIENCE, NOT CODE REQUIRED.

3. THIS IS THE PERFORMANCE REQUIRED FOR THE WALL AROUND THE DOOR. NOTE THAT SOUND ISOLATION IN THESE INSTANCES WILL BE LIMITED BY THE DOORS PERFORMANCE (E.G., STC 20 FOR A CLOSE-FITTED 5-PST DOOR). IT IS UP TO THE FACILITY TO DETERMINE IF DOORS REQUIRE A HIGHER ACOUSTIC PERFORMANCE OR IF FULL PERIMETER GASKETING AND BOTTOM SEALS SHOULD BE REQUIRED. DOORS ARE NOT REQUIRED TO BE SOUND SEALED TO MAINTAIN THE STC RATING, ALTHOUGH A FACILITY MAY CHOOSE TO DO SO FOR SPECIALTY PATIENT ENVIRONMENTS SUCH AS BEREAVEMENT ROOMS, CONSULTATION ROOMS, SLEEP THERAPY ROOMS, ETC.

4. RELAXATION OF STC 60 RATINGS SHALL BE PERMITTED IF COMPLIANCE WITH ROOM NOISE REQUIREMENTS IS ACHIEVED WITH LOWER PERFORMANCE CONSTRUCTIONS SEE FGI 2018 TABLE 1.2.5

5. ELECTRONIC MASKING SHALL PROVIDE A MAXIMUM BACKGROUND LEVEL OF 48 DBA.

STC GENERAL NOTES

1. NOT ALL ADJANCIES LISTED IN STC PARTITION RATINGS LEGEND MAY OCCUR IN THIS PROJECT.

2. IN PARTITIONS WITH AND STC RATING OF 44 OR GREATER PROVIDE ACOUSTICAL PUTTY PADS AT ELECTRICAL ROUGH-IN BOXES THAT ARE BACK-TO-BACK CONFIGURATOIN OR WHERE ELECTRICAL BOX SEPARATION DISTANCES IS LESS THAN 24"

3. PENETRATIONS THROUGH FULL HEIGHT STC PARTITIONS SHOULD BE CENTERED IN OPENING AND SEALED AIRTIGHT.

4. CALBE TRAY PENETRATIONS IN STC PARTITIONS SHOULD BE PACKED TIGHTLY WITH HEAVY DENSITY PUTTY.

KEY PLAN

LEVEL 1 - KEYPLAN

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STATE OF MISSOURI

DOBBY C. CAMPBELL

NUMBER: A-2001007

DATE SIGNED: 05/29/25

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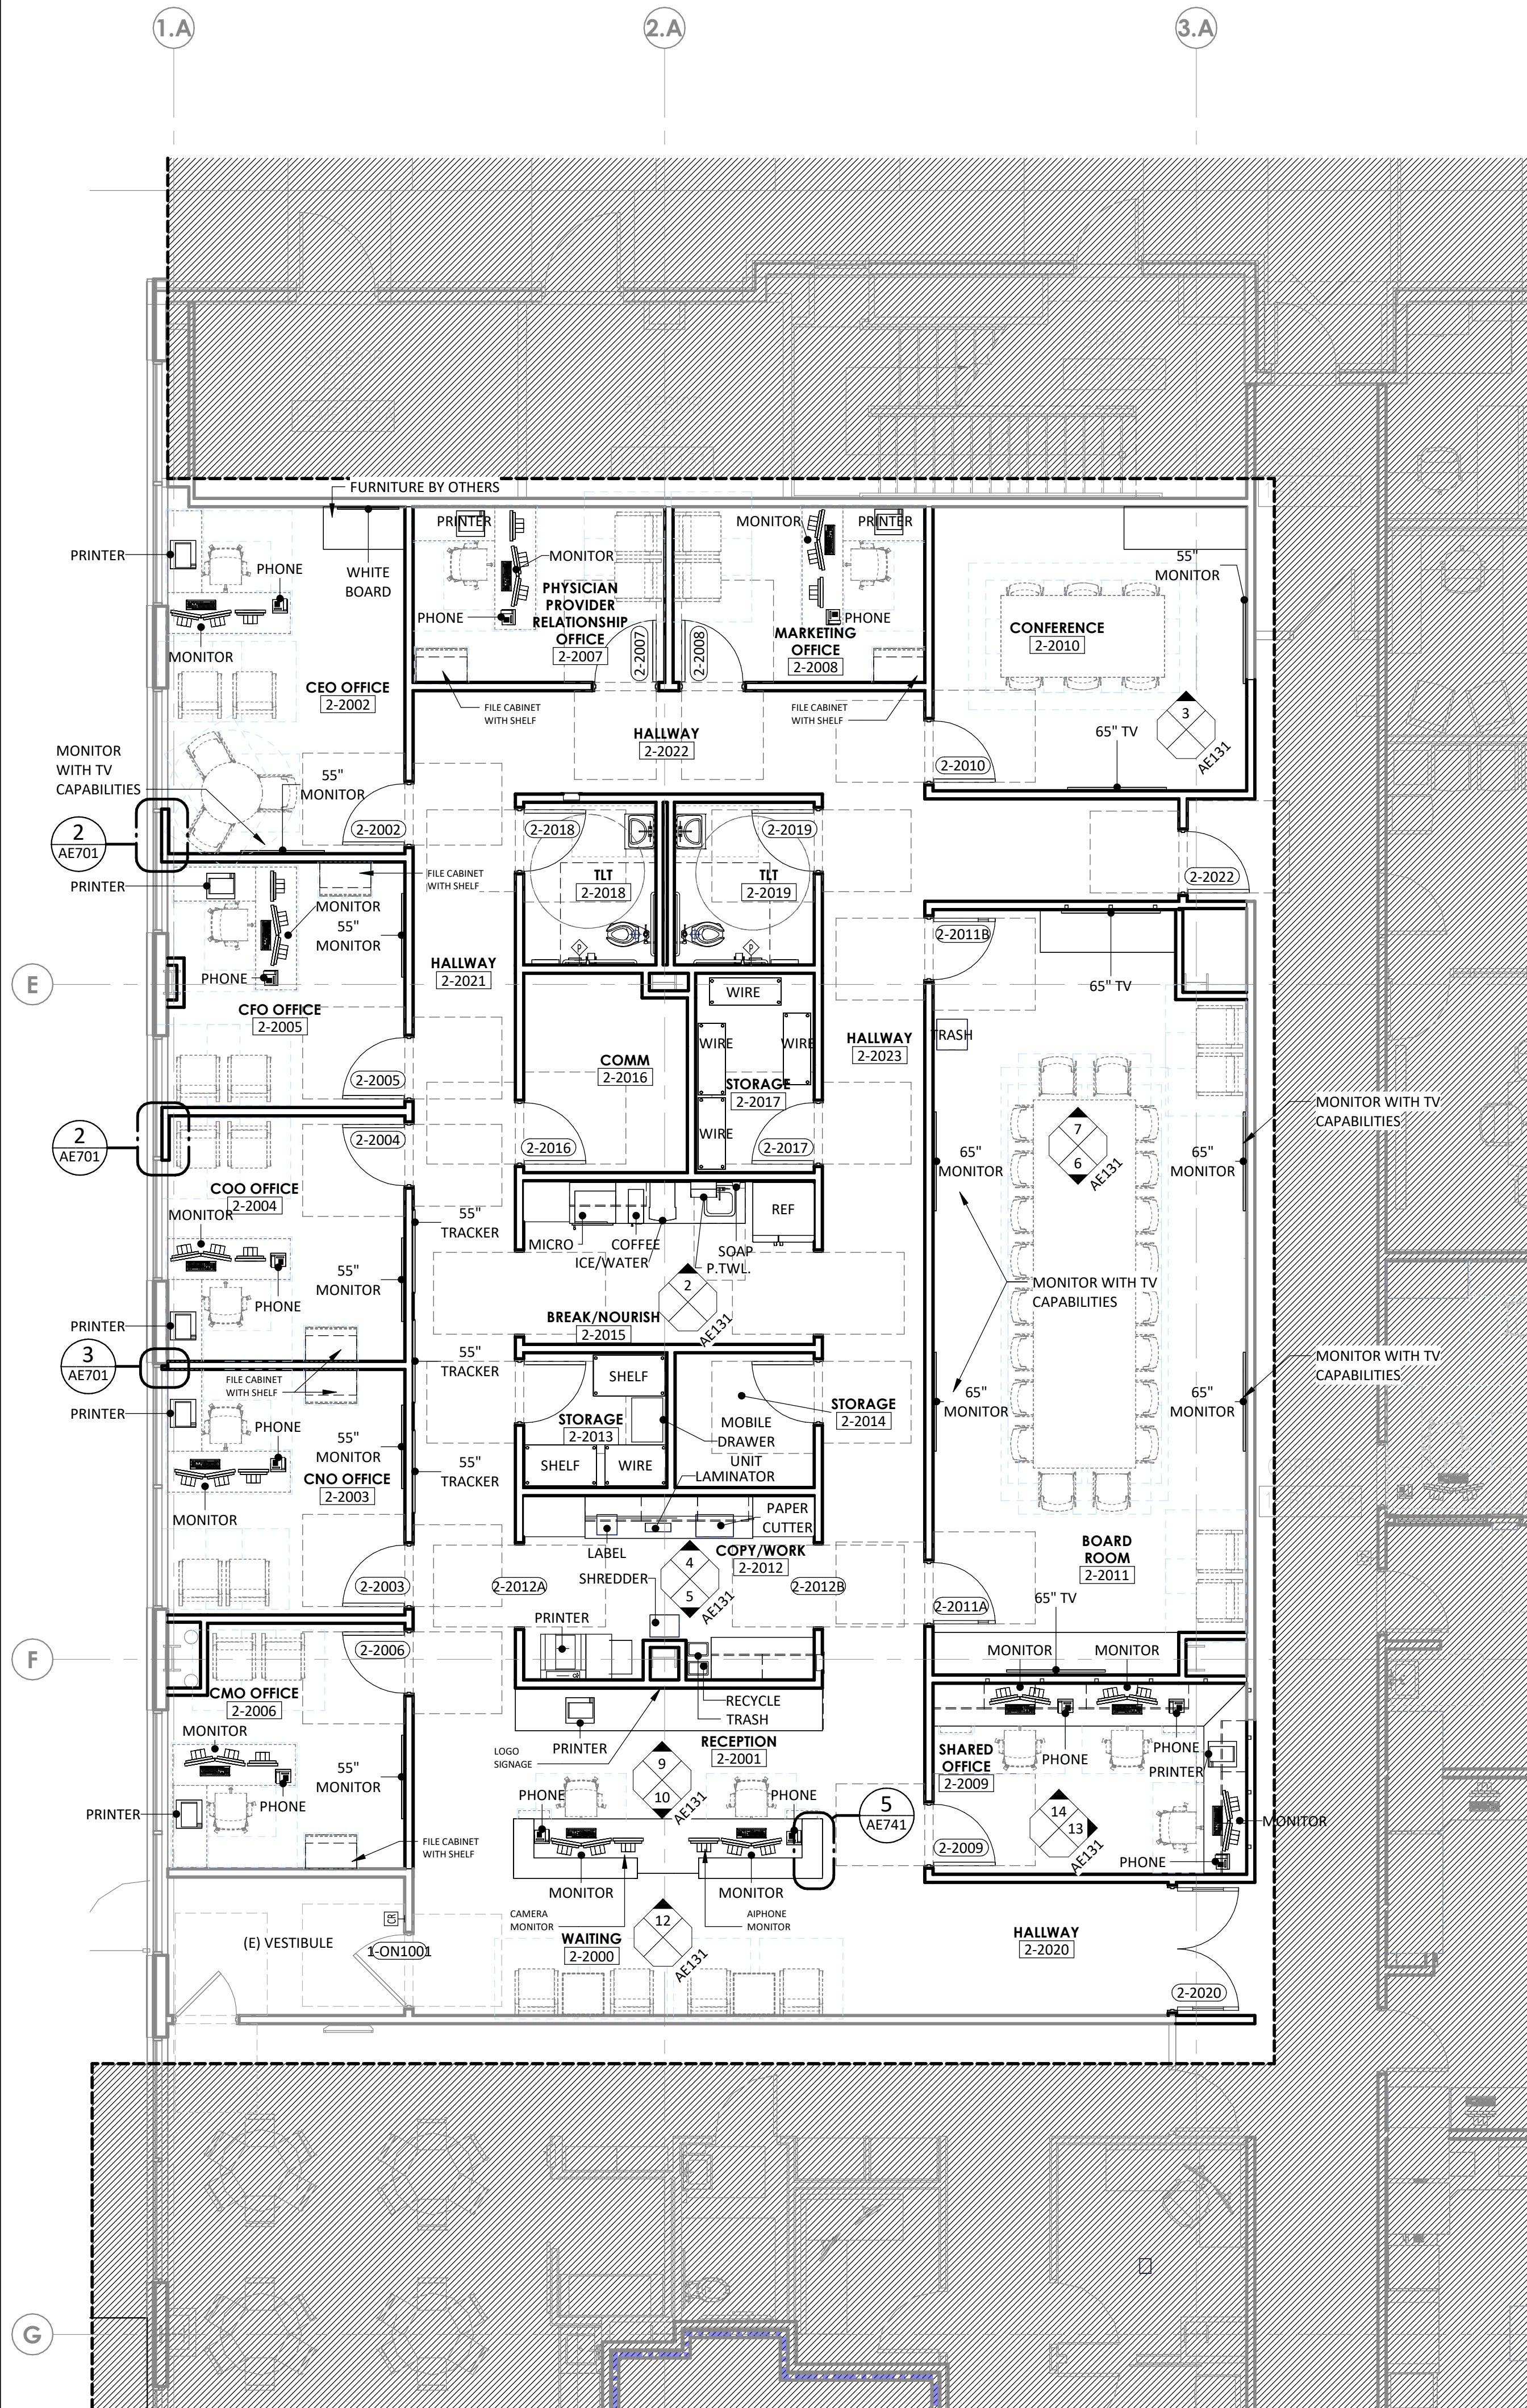
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A	CITY - 2ND REVIEW	2025/05/29

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REVIEWED: MM/DP
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DIMENSION FLOOR PLAN -
LEVEL 1 - ADMIN

AE111

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1 ANNOTATION PLAN - ENLARGED - LEVEL 1 - ADMIN
3/16" = 1'-0"

2 BREAK/NOURISH
1/4" = 1'-0"

4 COPY/WORK A
1/4" = 1'-0"

6 BOARD ROOM A
1/4" = 1'-0"

9 ADMIN - RECEPTION - A
1/4" = 1'-0"

12 ADMIN - RECEPTION A1
1/4" = 1'-0"

13 ADMIN - SHARED OFFICE B
1/4" = 1'-0"

14 ADMIN - SHARED OFFICE A
1/4" = 1'-0"

3 CONFERENCE A
1/4" = 1'-0"

5 COPY/WORK C
1/4" = 1'-0"

7 BOARD ROOM B
1/4" = 1'-0"

10 ADMIN - RECEPTION C
1/4" = 1'-0"

ANNOTATION PLAN GENERAL NOTES

- THE WORD "CLEAR" INDICATES CRITICAL DIMENSIONS FOR ACCESSIBLE EQUIPMENT OR FUNCTIONAL CLEARANCES FROM FACE OF FINISH TO FACE OF FINISH.
- DIMENSIONS MEASURED FROM THE EXPOSED SURFACE OF EXISTING WALLS, PARTITIONS, COLUMNS, ETC.; NEW PARTITIONS ARE DIMENSIONED TO THE FACE OF THE FRAMING, MEASURE AND VERIFY DIMENSIONS IN FIELD.
- ALL INFORMATION GRAYED-OUT INDICATES EXISTING.
- GRAY DASHED INDICATES OWNER FURNISHED/OWNER INSTALLED FURNITURE/EQUIPMENT.

INTERIOR ELEVATIONS GENERAL NOTES

- PROVIDE CONTINUOUS BACKING FOR SURFACE MOUNTED EQUIPMENT, MILLWORK, AND ACCESSORIES.
- LOCATE MILLWORK GROMMETS IN FIELD PER OWNER.
- EXPOSED MILLWORK SURFACES SHALL BE FINISHED.
- MOUNT EQUIPMENT, FIXTURES, AND ACCESSORIES ACCORDING TO THE TYPICAL MOUNTING HEIGHTS SHEET, UNLESS NOTED OTHERWISE.
- PROVIDE WATER RESISTANT GYPSUM BOARD AT WET WALL CONDITIONS.
- PROVIDE COUNTERTOP SUPPORTS AT OPEN KNEESPACE LOCATION. INSTALL AT 32" ON CENTER MAXIMUM.

PARTITION LEGEND

EXISTING	NEW	NON-RATED PARTITION
[Symbol]	[Symbol]	2-HOUR FIRE BARRIER
[Symbol]	[Symbol]	1-HOUR FIRE BARRIER
[Symbol]	[Symbol]	1-HOUR SMOKE BARRIER
[Symbol]	[Symbol]	SMOKE PARTITION
[Symbol]	[Symbol]	1-HOUR FIRE PARTITION

LIMITS OF CONSTRUCTION
(SHADE INDICATES AREA OUTSIDE OF SCOPE)

KEY PLAN

LEVEL 1 - KEYPLAN

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ADMINISTRATION RELOCATION

HCA - LEE'S SUMMIT MEDICAL CENTER
2000 SE BLUE PKWY
LEE'S SUMMIT, MO 64063

AUTHORITY HAVING JURISDICTION:
CITY OF LEE'S SUMMIT BUILDING DEPT.
MISSOURI DHSS

FACILITY NUMBER:
0972400009

AGENCY APPROVALS:
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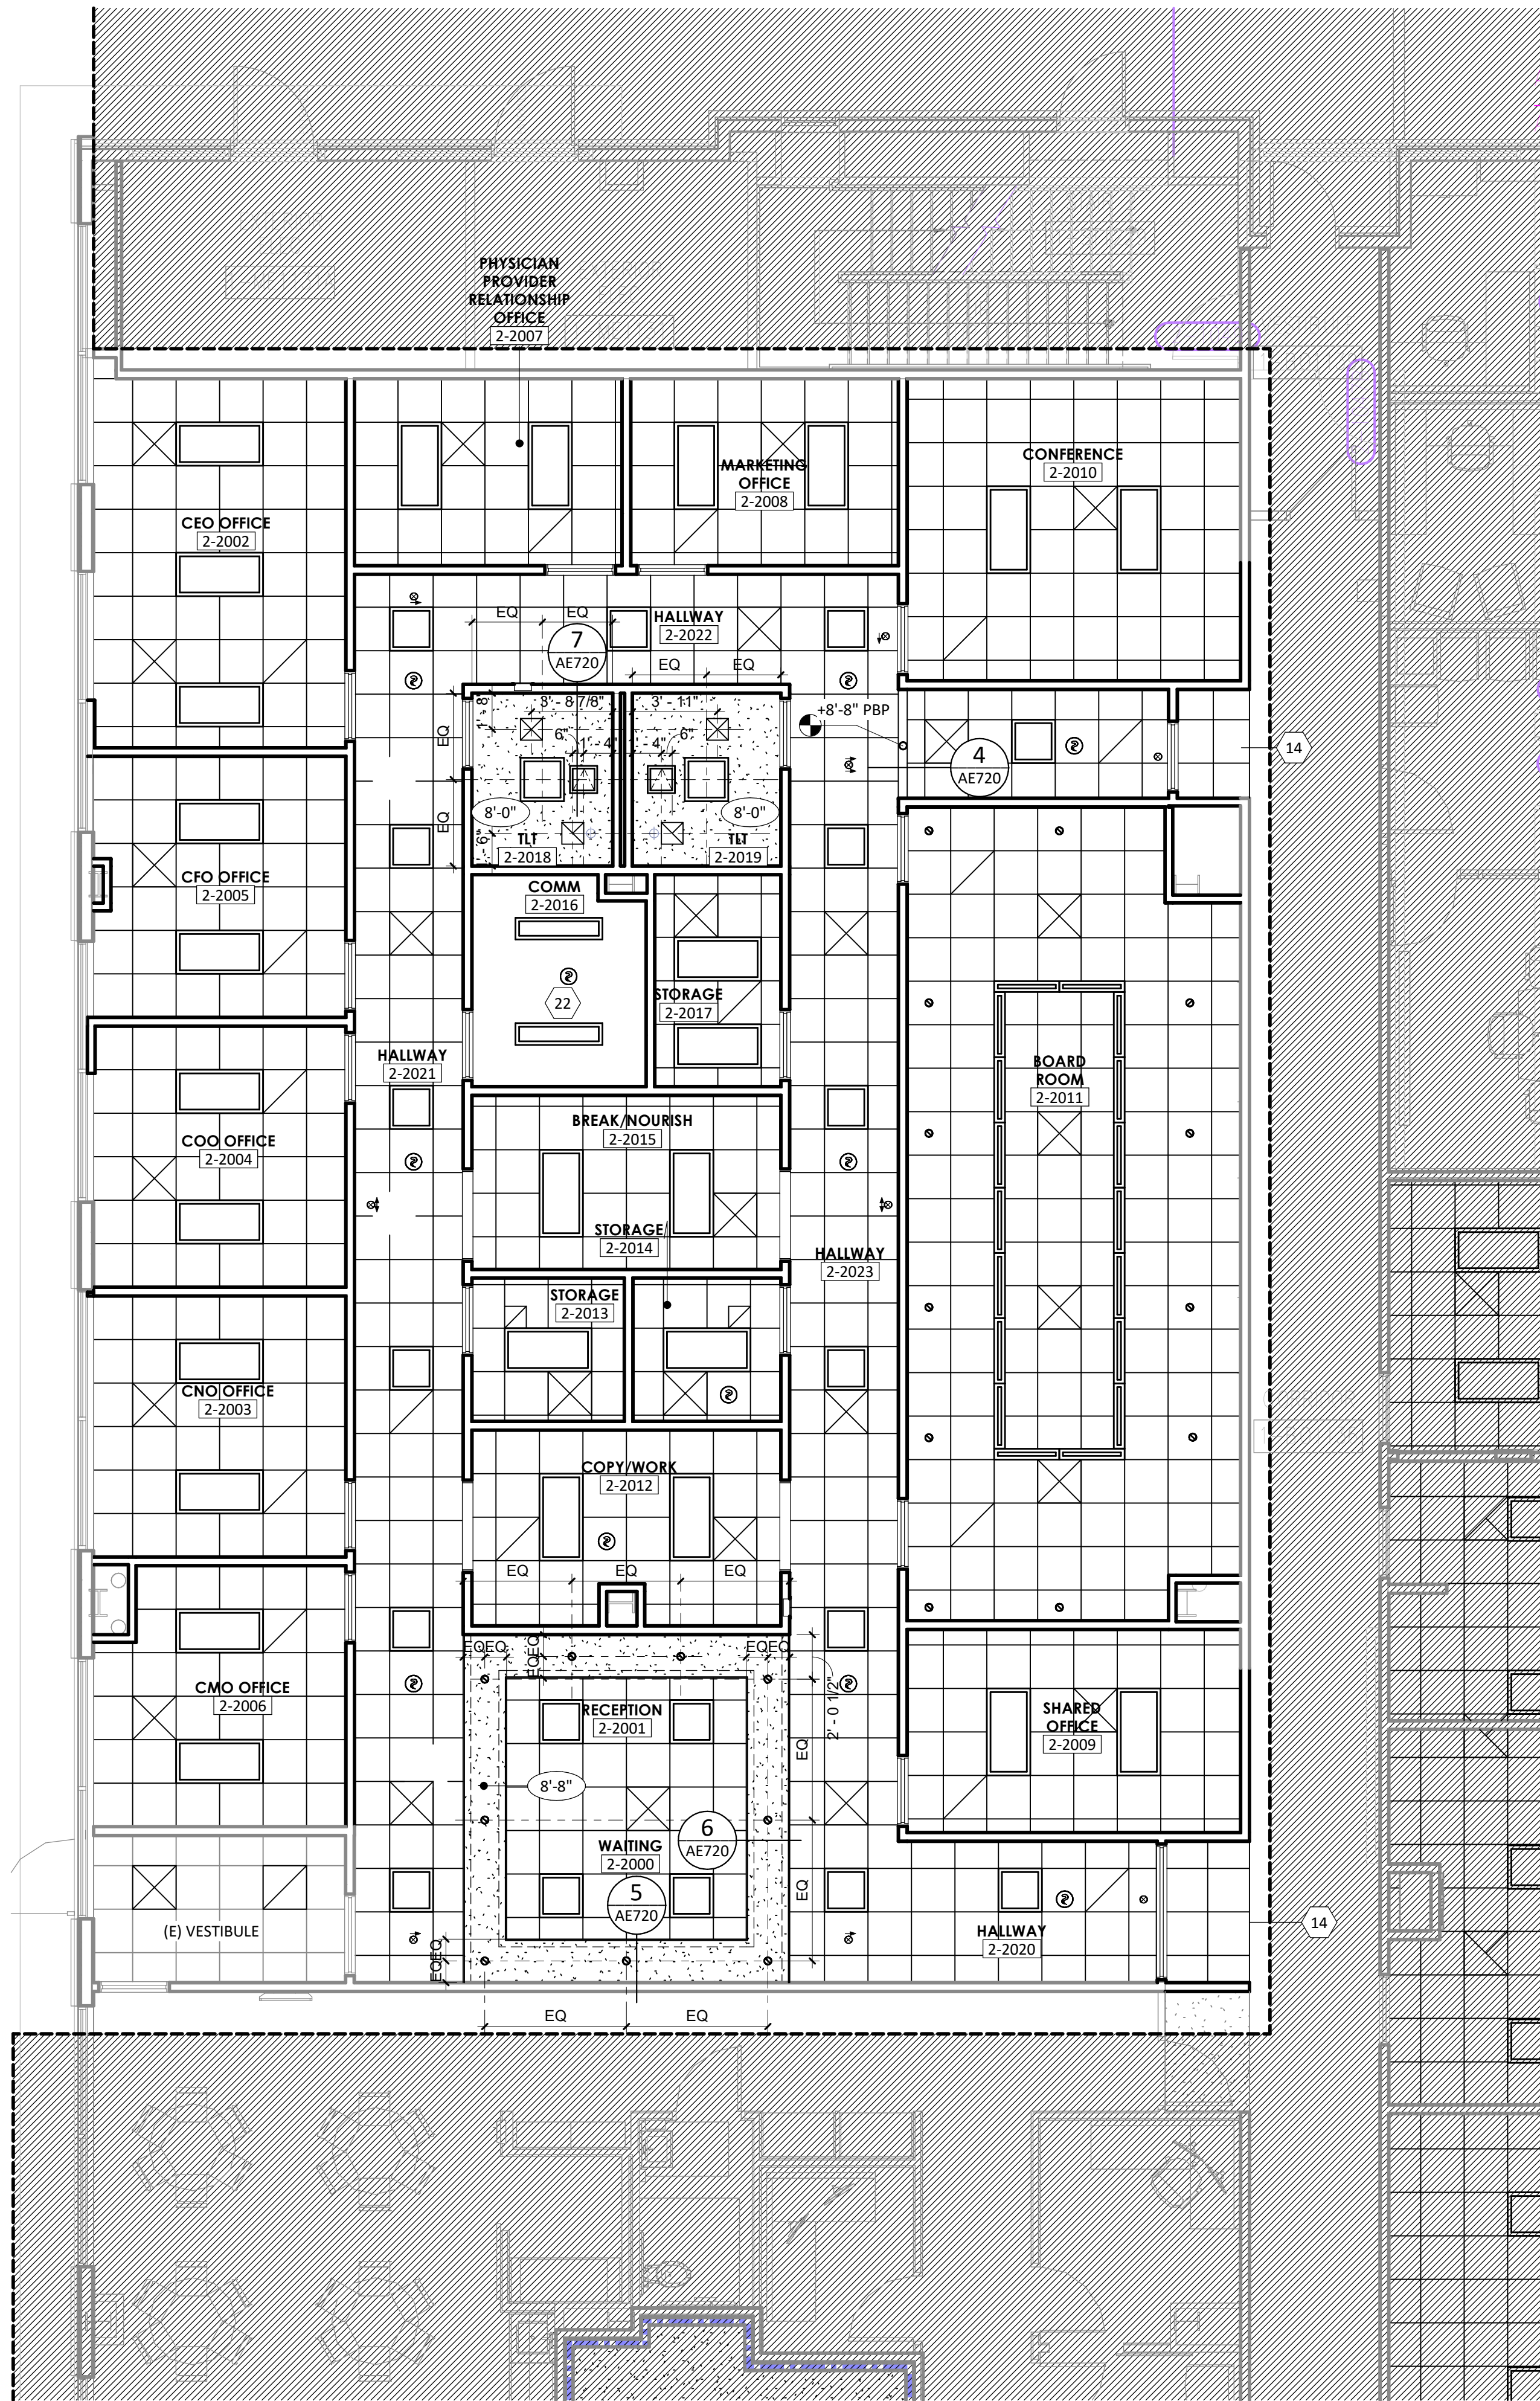
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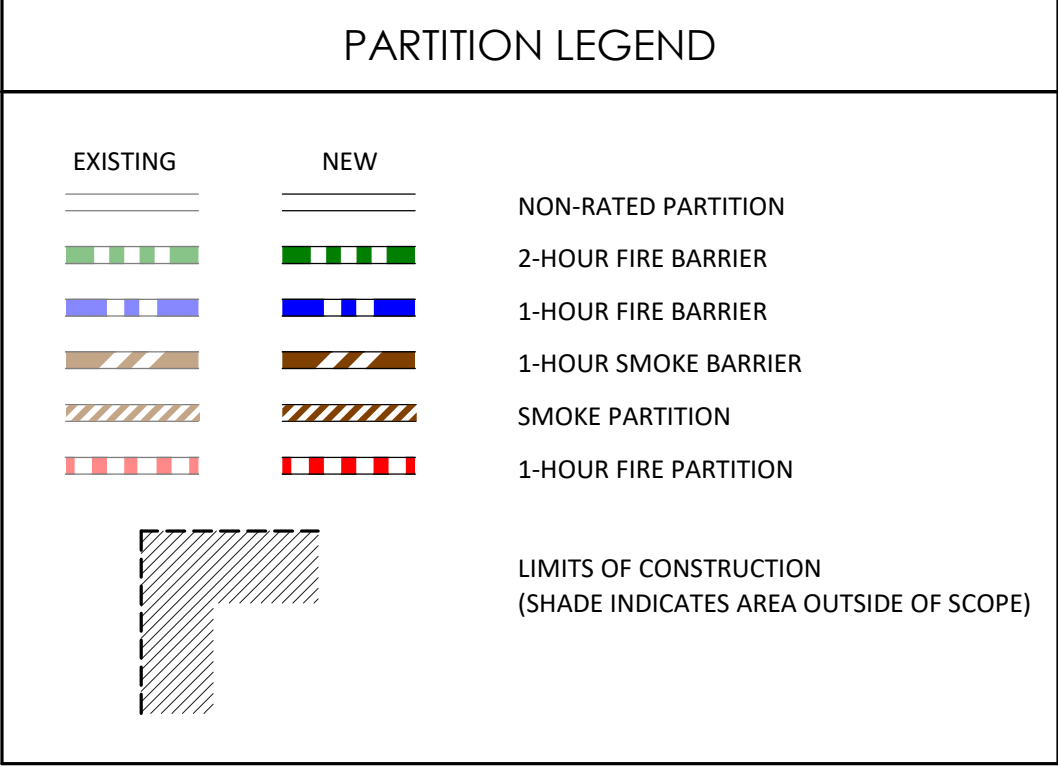
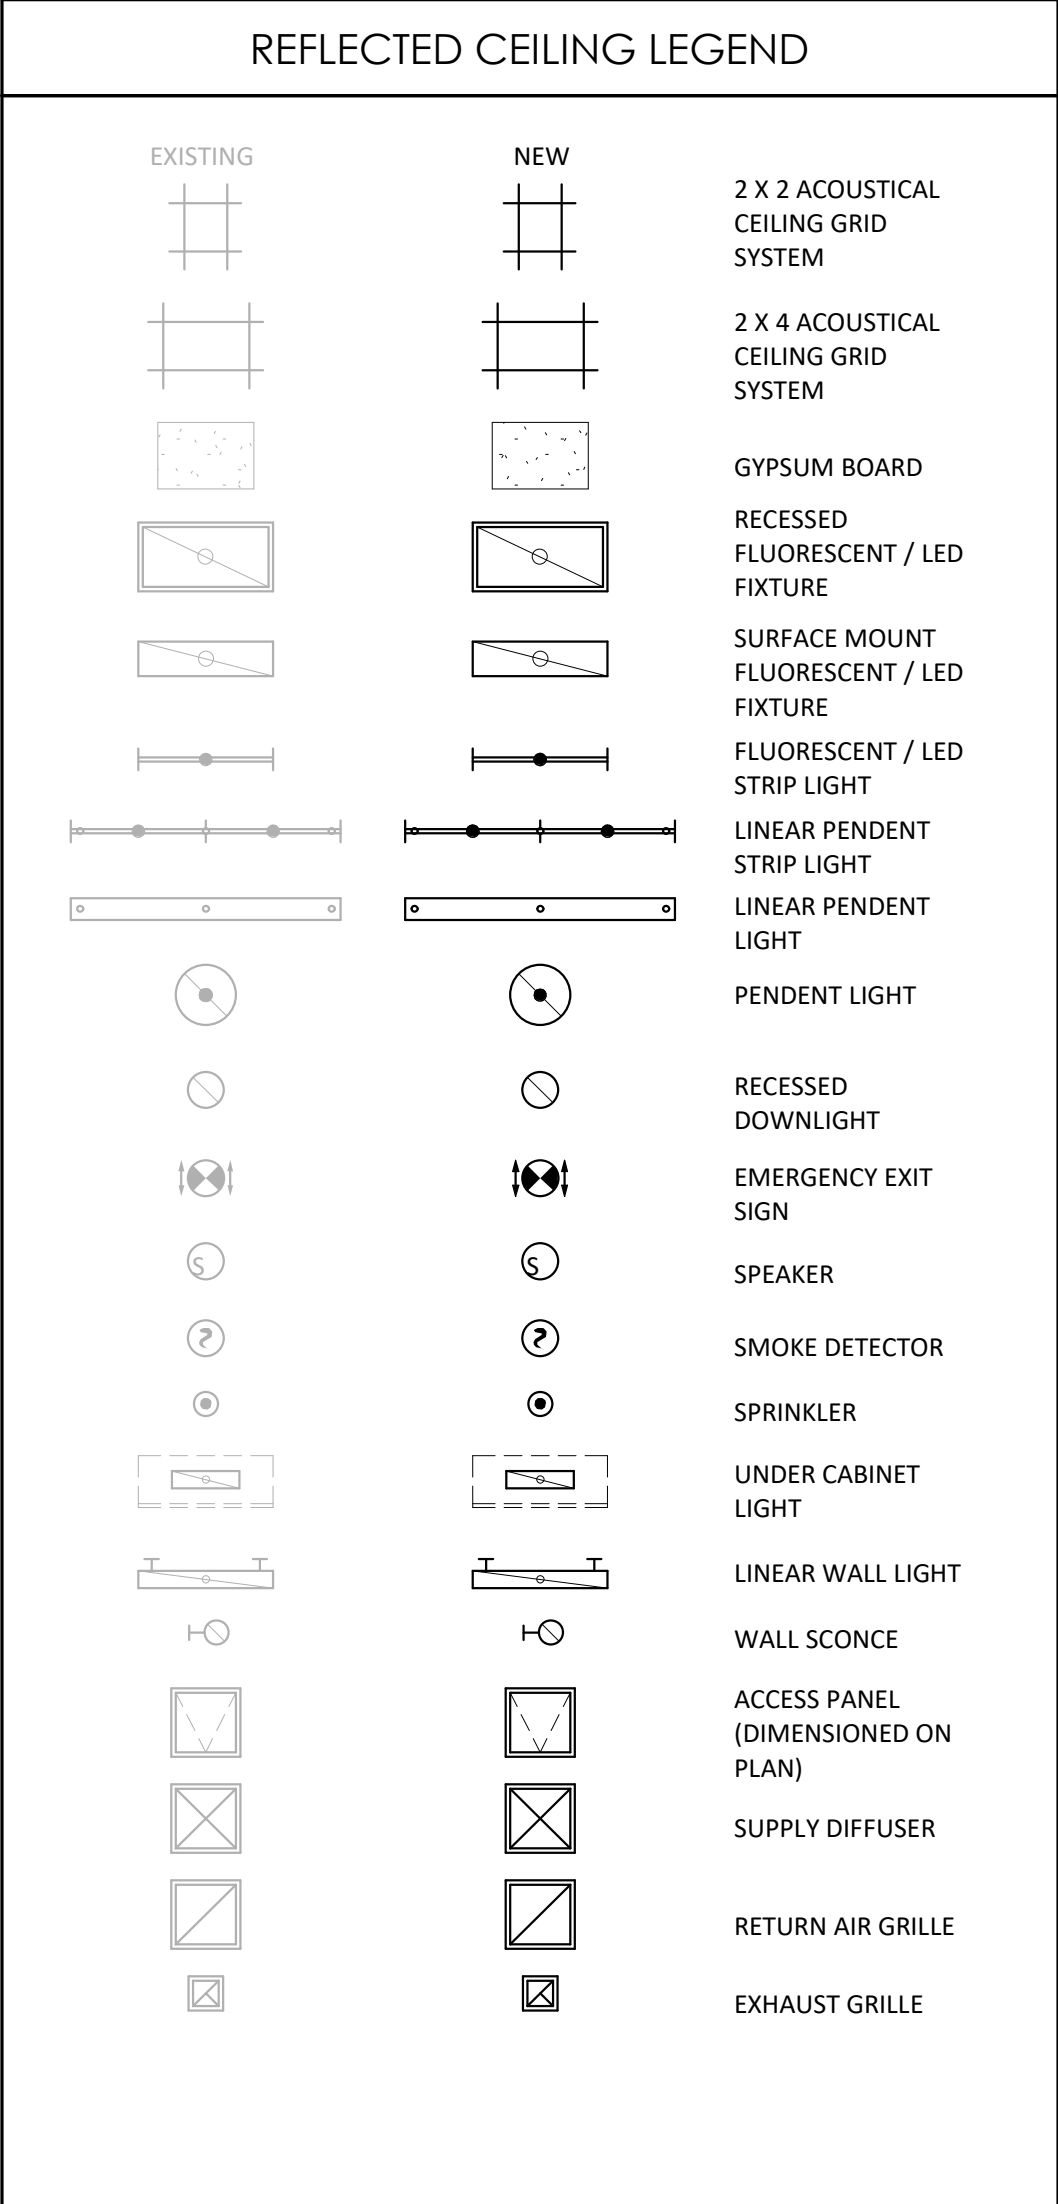
ANNOTATION FLOOR PLAN - LEVEL 1 - ADMIN

AE131

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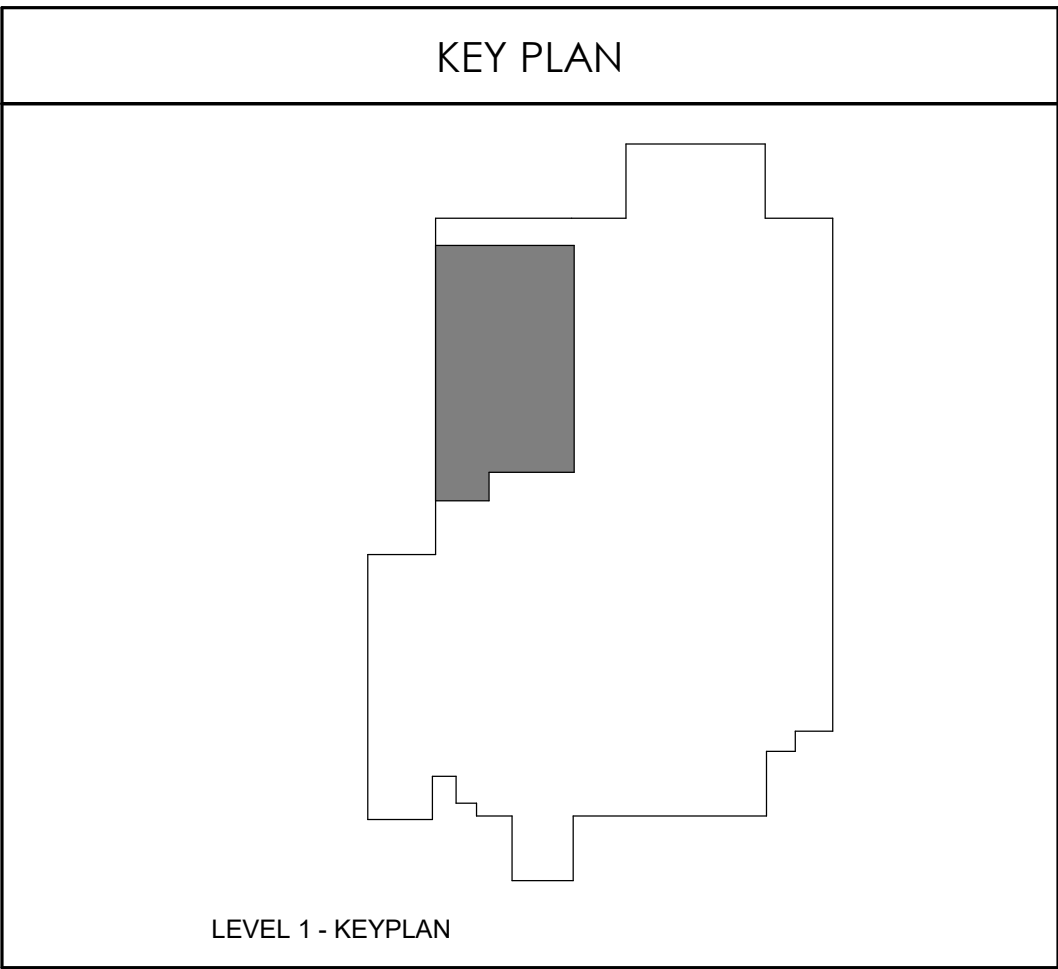


- REFLECTED CEILING GENERAL NOTES
1. CEILING HEIGHTS 9'-0" AFF UNLESS NOTED OTHERWISE. ALL SOFFIT HEIGHTS 8'-0" AFF UNLESS NOTED OTHERWISE.
 2. CENTER CEILING SYSTEMS IN ROOMS UNLESS NOTED OTHERWISE.
 3. CENTER SPRINKLER HEADS, SPEAKERS, RECESSED LIGHTS, AND SMOKE OR THERMAL DETECTORS IN CEILING TILE UNLESS NOTED OTHERWISE.
 4. EXTEND SOFFIT GYPSUM BOARD TO 6" ABOVE FINISHED CEILING.
 5. IF SPECIFIED HEIGHT OF FINISHED CEILING NEEDS TO BE LOWERED DUE TO CONDITIONS FOUND DURING CONSTRUCTION OR DEMOLITION, CONTACT ARCHITECT IMMEDIATELY.
 6. PROVIDE ACCESS PANELS AS NECESSARY FOR VALVES AND DAMPERS IN GYPSUM BOARD CEILINGS.
 7. ALL SOFFIT FACES SHALL RECIEVE SAME PAINT COLOR. SEE PLAN FOR COLOR ASSIGNMENTS



KEYNOTE LEGEND

KEY	NOTE
14	EXTEND EXISTING HALLWAY CEILING INTO NEW ALCOVE ENTRANCE - MATCH EXISTING CONDITIONS
22	NO FINISH CEILING SYSTEM IN THIS ROOM.



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REFLECTED CEILING PLAN -
LEVEL 1 - ADMIN

AE181

DOOR SCHEDULE													
DOOR MATERIAL		DOOR GLAZING		FRAME MATERIAL		FRAME GLAZING		REMARKS					
WD	- SOLID CORE WOOD	T	- TEMPERED	HM	- HOLLOW METAL	T	- TEMPERED	1	- CARD READER				
WDPL	- PLASTIC LAMINATE WOOD	L	- LAMINATED	AL	- ALUMINUM	L	- LAMINATED						
WDIR	- IMPACT RESISTANT WOOD	FR	- FIRE RESISTIVE	STL	- STEEL	FR	- FIRE RESISTIVE						
HM	- HOLLOW METAL	FP	- FIRE PROTECTIVE	EX	- EXISTING	FP	- FIRE PROTECTIVE						
AL	- ALUMINUM	SP	- SPANDREL			SP	- SPANDREL						
STL	- STEEL	IGU	- INSULATED GLASS UNIT			IGU	- INSULATED GLASS UNIT						
EX	- EXISTING	B	- BALLISTIC			B	- BALLISTIC						

DOOR SCHEDULE																			
ID	WIDTH	HEIGHT	DOOR PANEL			FRAME			SIDELITE		DETAILS					RATING FIRE	HARDWARE	REMARKS	CURRENT REVISION
			MATERIAL	ELEV.	GLAZING	MATERIAL	ELEV.	GLAZING	WIDTH	SILL HEIGHT	HEAD	JAMB	SILL	SIDELITE					
LEVEL 1																			
1-ON1001	3'-6"	7'-0"		A			1										009A-EX	1	
2-2002	3'-0"	7'-0"	WDPL	A		HM	1				1/AE601	2/AE601					003A		
2-2003	3'-0"	7'-0"	WDPL	A		HM	1				1/AE601	2/AE601					003A		
2-2004	3'-0"	7'-0"	WDPL	A		HM	1				1/AE601	2/AE601					003A		
2-2005	3'-0"	7'-0"	WDPL	A		HM	1				1/AE601	2/AE601					003A		
2-2006	3'-0"	7'-0"	WDPL	A		HM	1				1/AE601	2/AE601					003A		
2-2007	3'-0"	7'-0"	WDPL	A		HM	1				1/AE601	2/AE601					003A		
2-2008	3'-0"	7'-0"	WDPL	A		HM	1				1/AE601	2/AE601					003A		
2-2009	3'-0"	7'-0"	WDPL	A		HM	1				1/AE601	2/AE601					004A		
2-2010	3'-0"	7'-0"	WDPL	A		HM	1				1/AE601	2/AE601					004A		
2-2011A	3'-0"	7'-0"	WDPL/GL	C	T	HM	1				1/AE601	2/AE601					004A		
2-2011B	3'-0"	7'-0"	WDPL/GL	C	T	HM	1				1/AE601	2/AE601					004A		
2-2012A	4'-0"	7'-0"	-	-		HM	1											CASED OPENING	
2-2012B	4'-0"	7'-0"	-	-		HM	1											CASED OPENING	
2-2013	3'-0"	7'-0"	WDPL	A		HM	1				1/AE601	2/AE601					007C		
2-2014	3'-0"	7'-0"	WDPL	A		HM	1				1/AE601	2/AE601					007C		
2-2015A	4'-0"	7'-0"	-	-		HM	1											CASED OPENING	
2-2015B	4'-0"	7'-0"	-	-		HM	1											CASED OPENING	
2-2016	3'-0"	7'-0"	WDPL	A		HM	1				1/AE601	2/AE601					009A	1	
2-2017	3'-0"	7'-0"	WDPL	A		HM	1				1/AE601	2/AE601					007C		
2-2018	3'-0"	7'-0"	WDPL	A		HM	1				1/AE601	2/AE601					005A		
2-2019	3'-0"	7'-0"	WDPL	A		HM	1				1/AE601	2/AE601					005A		
2-2020	6'-0"	7'-0"	WDPL/GL	CC	T	HM	1		0"	0"	1/AE601	2/AE601					009E	1	
2-2022	3'-0"	7'-0"	WDPL	A		HM	1				1/AE601	2/AE601					009A	1	

- DOOR GENERAL NOTES
1. THE PURPOSE OF THIS SHEET IS TO DESCRIBE AND ILLUSTRATE DOOR TYPES. NOT ALL DOOR TYPES SHOWN ARE NECESSARILY USED. SEE DOOR MARK SCHEDULE FOR DOOR TYPES USED.

2. FIRE DOORS AND FRAMES SHALL HAVE AN APPROVED LABEL OR LISTING MARK INDICATING THE FIRE PROTECTION RATING WHICH IS PERMANENTLY AFFIXED AT THE FACTORY WHERE FABRICATION AND ASSEMBLY ARE DONE.

3. SMOKE BARRIER DOORS INSTALLED ACROSS THE CORRIDORS AND EXIT ACCESS DOORS LOCATED AT ZONE BOUNDARIES SHALL BE EQUIPPED WITH APPROVED VISION PANELS.

4. ALL SMOKE BARRIER DOORS LOCATED ON THE FLOOR OR IN THE AFFECTED ZONE SHALL COMPLY WITH CURRENT APPLICABLE CODES AND SHALL BE AUTOMATIC CLOSING UPON ACTIVATION OF THE FIRE ALARM OR FIRE SPRINKLER SYSTEM.

5. ALL DOORS IN SMOKE BARRIERS AND OPENING INTO RATED EXIT WAYS SHALL BEAR AN APPROVED LABEL DISPLAYING THE LETTER "S" PER CURRENT APPLICABLE CODES.

6. FIRE ASSEMBLIES REQUIRED TO HAVE 1 ½ HOURS, 1 HOUR OR ¾ HOUR FIRE PROTECTION RATING SHALL BE EITHER AUTOMATIC OR SELF CLOSING FIRE ASSEMBLIES. AUTOMATIC CLOSING FIRE ASSEMBLIES TO BE ACTIVATED BY AN INCREASE IN TEMPERATURE SHALL HAVE HEAT-ACTUATING DEVICES INSTALLED ON EACH SIDE OF THE WALL AT THE CEILING HEIGHT WHERE THE CEILING IS MORE THAN 3 FEET ABOVE THE TOP OF THE OPENING OR BY A SINGLE FUSIBLE LINK IN THE OPENING INCORPORATED IN THE CLOSING DEVICE.

7. GLASS:

A. INTERIOR DOORS:

1. NON-RATED DOORS SHALL HAVE ¼" CLEAR TEMPERED GLASS.

2. ALL RATED DOORS – SEE SPECIFICATIONS.

3. LEAD LINED DOORS SHALL HAVE LEAD GLASS.

8. GLAZING IN THE FOLLOWING LISTED AREAS SHALL BE DEEMED TO BE LOCATED IN HAZARDOUS LOCATIONS AND SUBJECT TO HUMAN IMPACT:

1. INGRESS AND EGRESS DOORS.

2. FIXED PANELS IN SWINGING DOORS.

3. ALL GLAZING WITHIN 18" OF THE FLOOR AND WITHIN 12" OF A DOOR SHALL BE TEMPERED.

9. EACH LITE OF THE GLAZING SHALL BEAR THE MANUFACTURER'S LABEL DESIGNATING THE TYPE AND THICKNESS OF GLASS. WHEN APPROVED BY THE AGENCY, LABELS MAY BE OMITTED FROM OTHER THAN GLAZING MATERIALS, PROVIDED AN AFFIDAVIT IS FURNISHED BY THE GLAZING CONTRACTOR CERTIFYING THAT EACH LITE IS GLAZED IN ACCORDANCE WITH APPROVED PLANS AND SPECIFICATIONS. IDENTIFICATION OF GLAZING IN HAZARDOUS LOCATIONS AND SUBJECT TO HUMAN IMPACT SHALL BE ETCHED OR CERAMIC FIRED ON THE GLASS AND READABLE FROM THE INSIDE OF THE BUILDING AFTER INSTALLATION.

10. EXIT DOORS SHALL BE OPERABLE FROM THE INSIDE WITHOUT THE USE OF A KEY OR ANY SPECIAL KNOWLEDGE OR EFFORT.

11. PANIC HARDWARE SHALL COMPLY WITH THE REQUIREMENTS OF CURRENT APPLICABLE CODES. THE ACTIVATING MEMBER SHALL BE MOUNTED AT A HEIGHT OF NOT LESS THAN 30 INCHES NOR MORE THAN 44 INCHES ABOVE THE FLOOR. THE UNLATCHING FORCE SHALL NOT EXCEED 15 POUNDS WHEN APPLIED IN THE DIRECTION OF TRAVEL.

12. DOOR ASSEMBLIES, APPROACHES AND FINISH HARDWARE SHALL BE IN COMPLIANCE WITH ACCESSIBILITY STANDARDS.

13. THE MAXIMUM EFFORT TO OPERATE DOORS SHALL NOT EXCEED THE FOLLOWING:

A. EXTERIOR DOORS 5.0 POUNDS

B. INTERIOR DOORS 5.0 POUNDS

C. FIRE DOORS 15.0 POUNDS

14. WATER CLOSET ROOMS SHALL BE SEPARATED FROM FOOD PREPARATION AND STORAGE AREAS WITH TIGHT FITTING DOORS.

15. DOOR OPENING LOCATIONS:

A. IMMEDIATELY (5") ADJACENT TO A FLANKING WALL UNLESS NOTED OTHERWISE

B. AT THE CENTERLINE OF THE ROOM, UNLESS NOTED OTHERWISE

C. CENTERED ON A GRID DOOR OPENINGS IN OTHER LOCATIONS ARE LOCATED BY DIMENSIONS

16. SEE SPECIFICATIONS FOR HARDWARE SCHEDULE

17. ALL DOOR FRAMES ARE WELDED FRAMES, UNLESS NOTED OTHERWISE.

18. FINISH FLOOR TRANSITIONS OCCUR AT CENTERLINE OF DOORS, UNLESS NOTED OTHERWISE

19. ALL INTERIOR DOORS WITH FIRE RATINGS GREATER THAN 20 MINUTE SHALL HAVE A NON-COMBUSTIBLE SILL WITH AN UNDERCUT OF 3/8" MAXIMUM ABOVE THE SILL.

20. WEIGHT OF LEAD-LINED DOORS, LEAD STRIPS IN DOOR FRAMES AND LEAD GLAZING WHERE OCCURS SHALL MATCH WEIGHT OF LEAD IN ADJACENT PARTITION, UNLESS NOTED OTHERWISE. LEAD LINING SHALL BE INSTALLED SUCH THAT SHIELDING IS CONTINUOUS IN INSTALLED DOORWAY.


21. ALL EXTERIOR DOORS SHALL HAVE METAL THRESHOLDS. SEE HARDWARE SCHEDULE.

22. WHERE DOOR HOLD-OPEN DEVICES OR DOOR STOPS OCCUR AT WALLS, PROVIDE BACKING PLATE PER BACKING PLATE SCHEDULE.


23. ALL SOLID CORE WOOD DOORS TO BE STAIN GRADE, UNLESS NOTED OTHERWISE (SEE DOOR SCHEDULE).

24. DOORS WITH AUTO DOOR OPENINGS SHALL MEET REQUIREMENTS IN CURRENT APPLICABLE CODES.


25. THRESHOLDS AT DOORWAYS AND TRANSITION STRIPS SHALL NOT EXCEED 1/2" IN HEIGHT. RAISED THRESHOLDS AND FLOOR LEVEL CHANGES AT ACCESSIBLE DOORWAYS SHALL BE BEVELED WITH A SLOPE NO GREATER THAN 1:2.

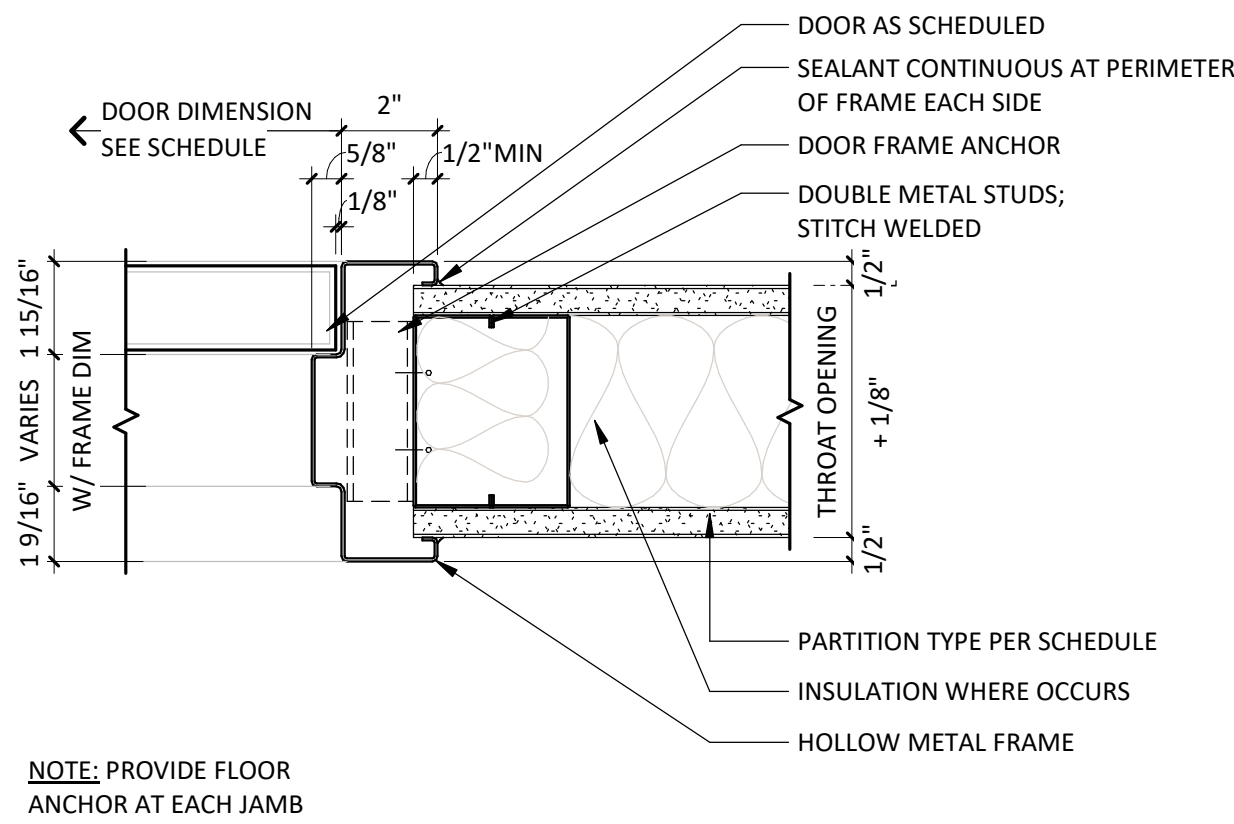


JAMB AT HOLLOW METAL FRAME

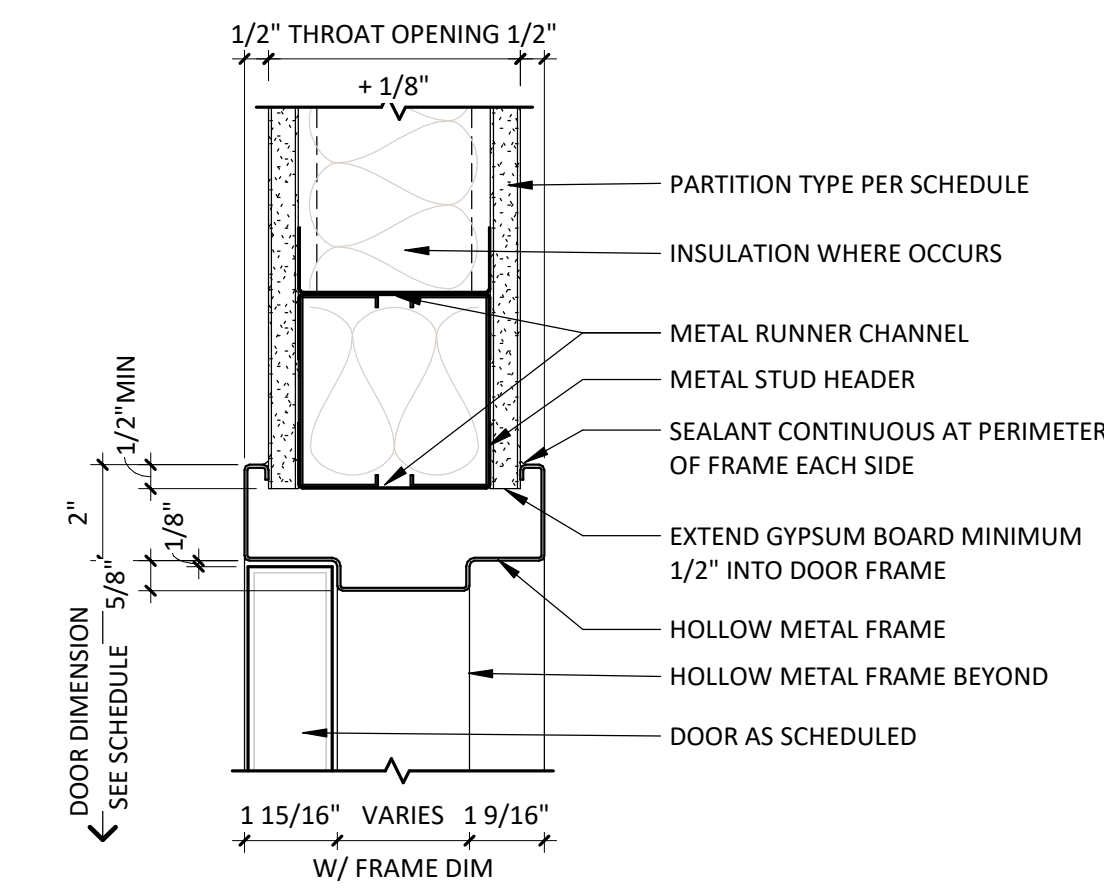

HEAD AT HOLLOW METAL FRAME

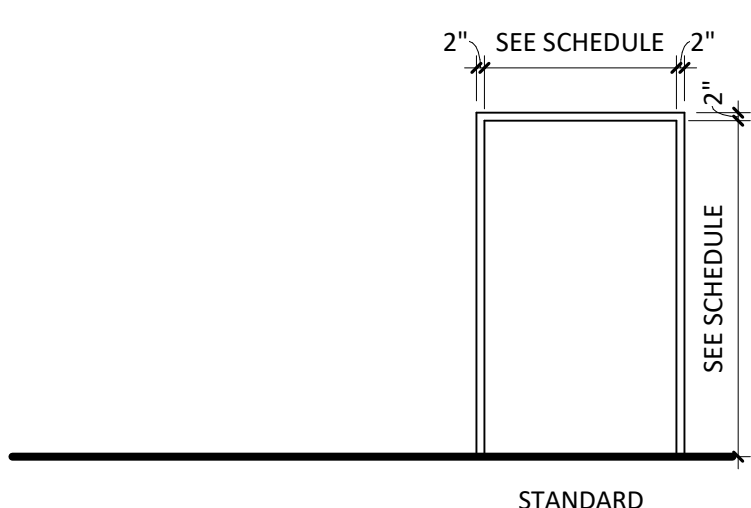

FRAME ELEVATIONS

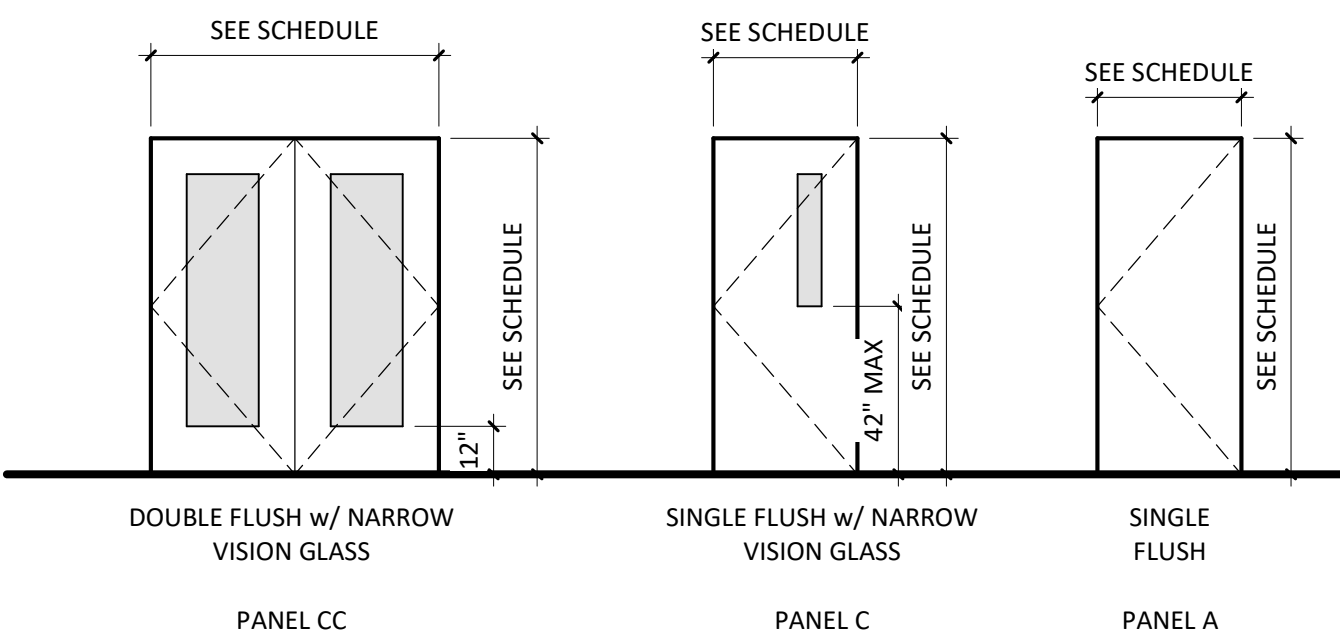


DOOR PANEL ELEVATIONS



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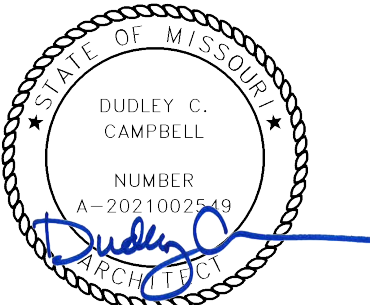
DOOR SCHEDULES - LEVEL 1 ADMIN

AE601

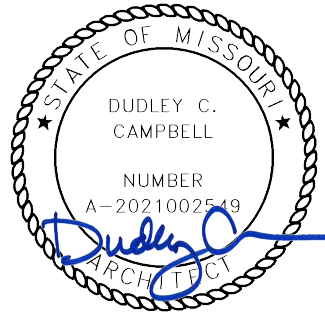

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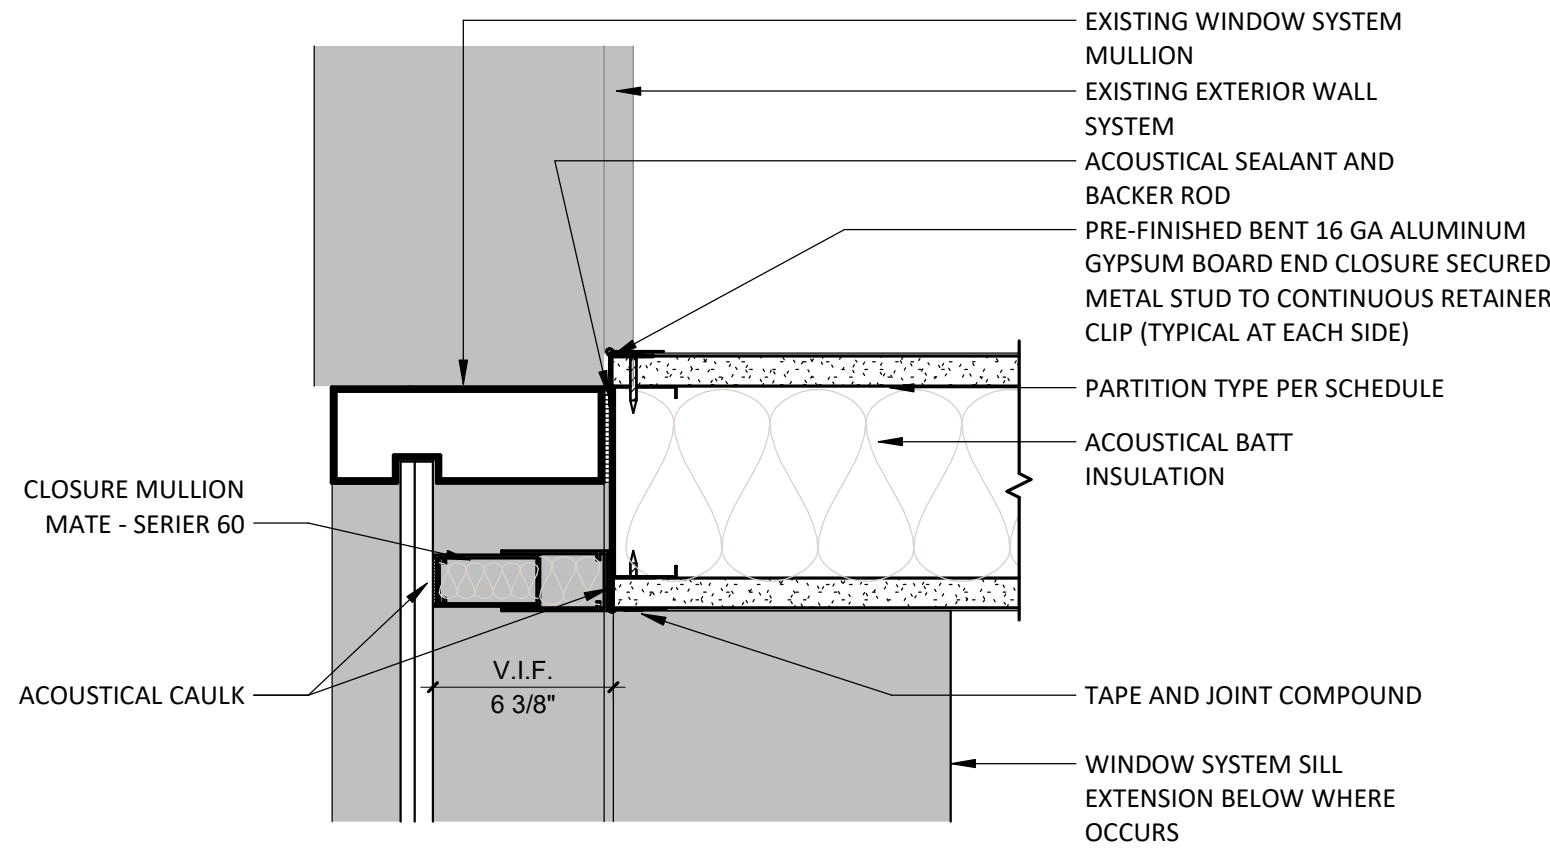
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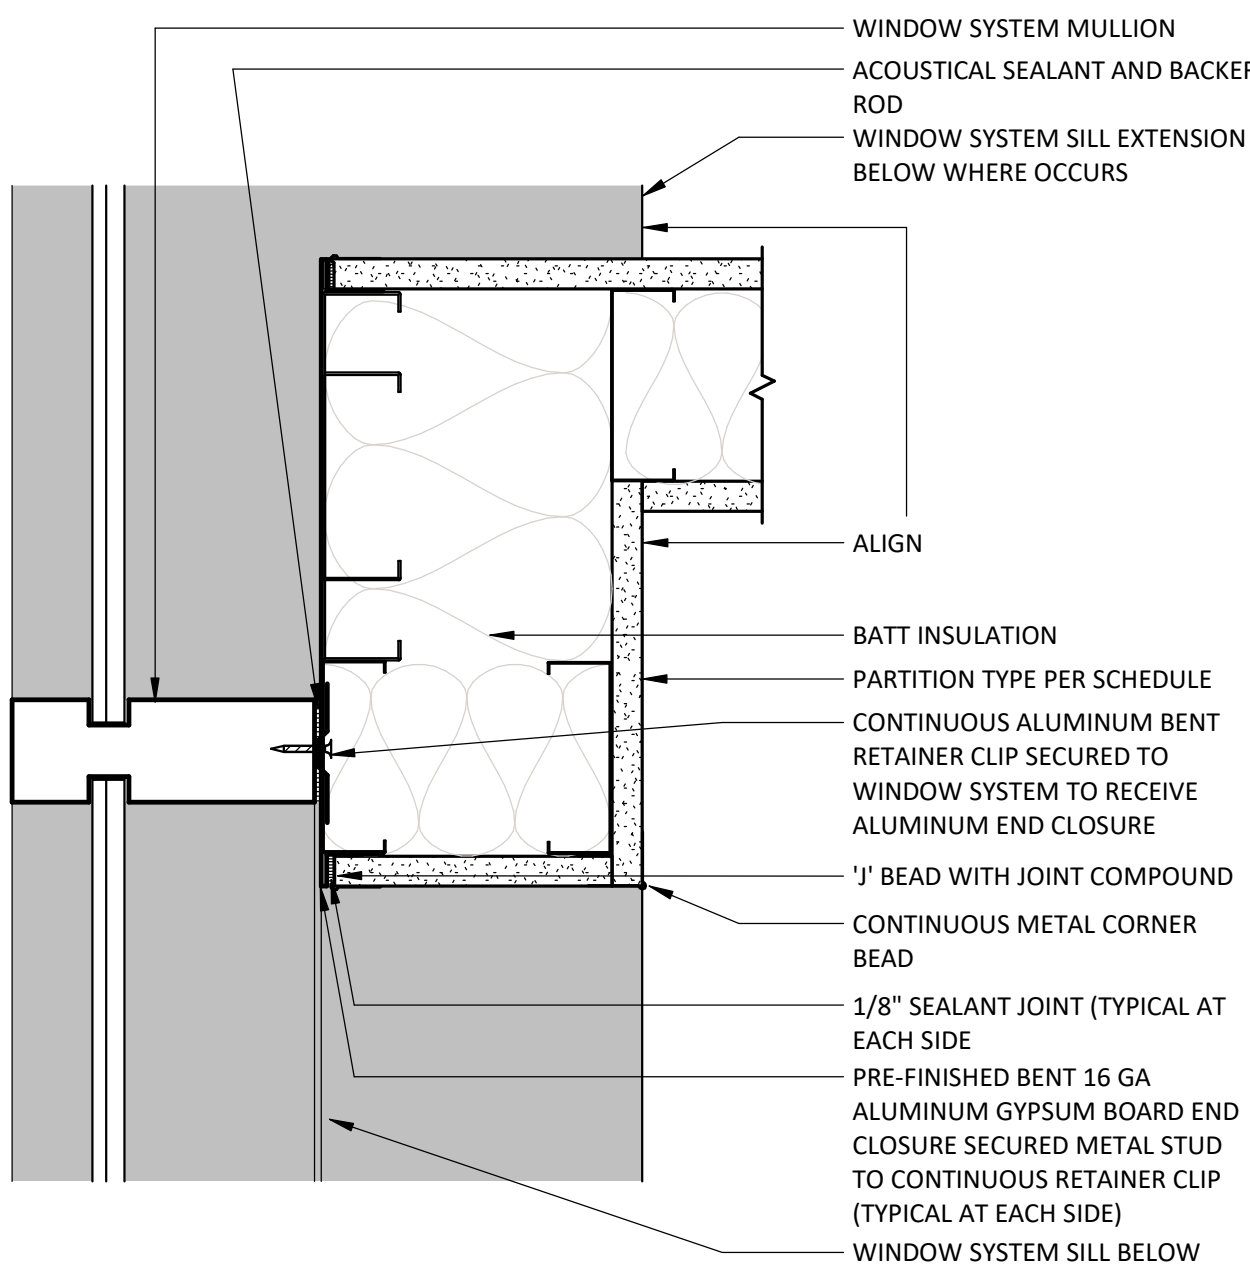
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INTERIOR DETAILS


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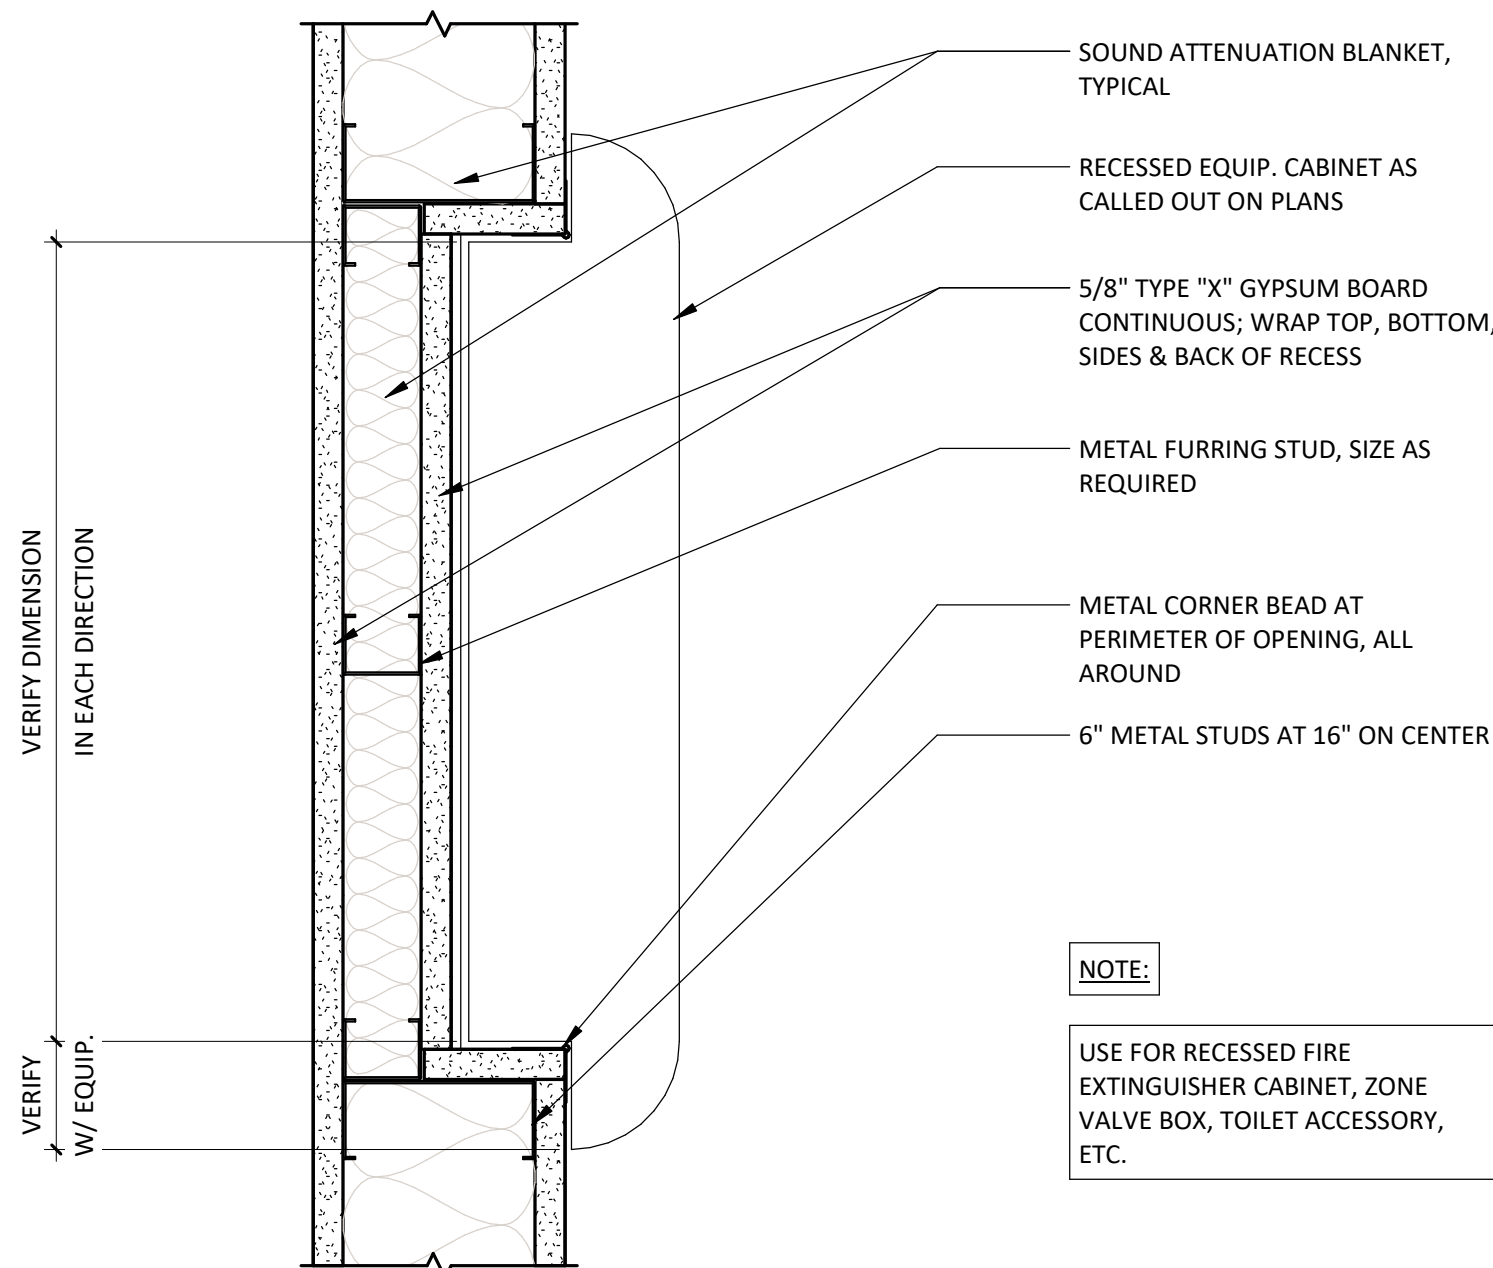
OFFSET PARTITION TERMINATION AT MULLION



OFFSET PARTITION TERMINATION AT MULLION



PARTITION OPENING INFILL NON-RATED

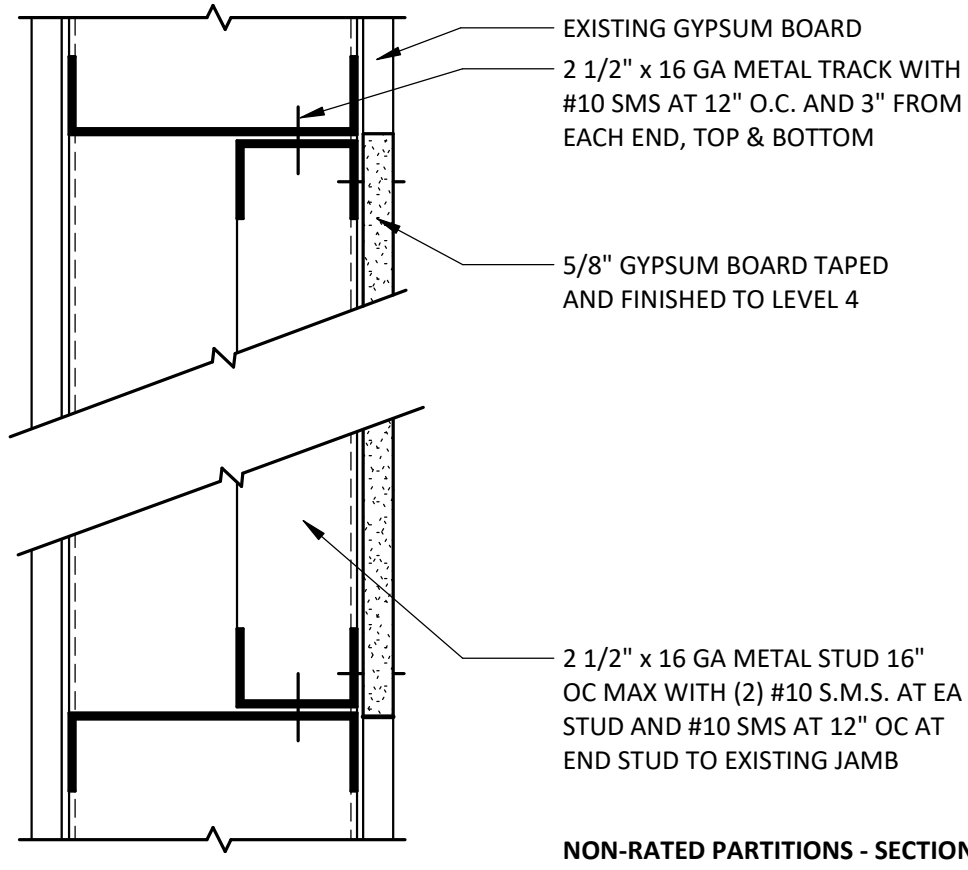


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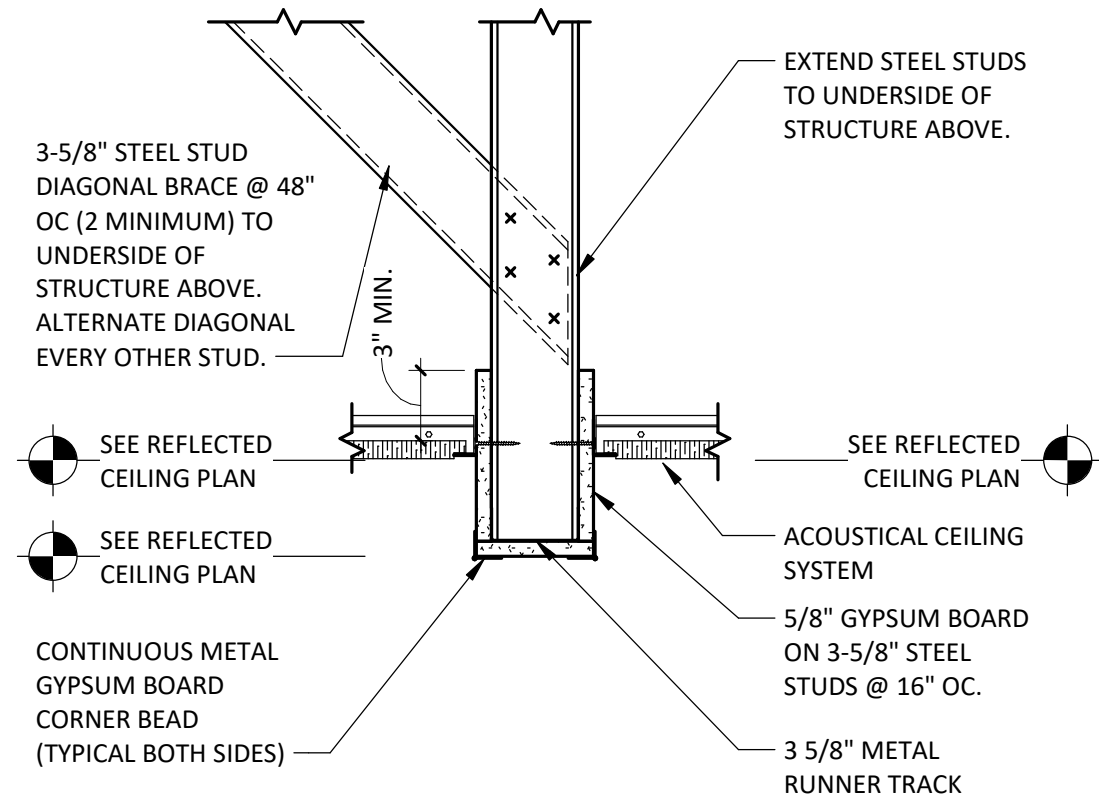
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REV #	DESCRIPTION	DATE
A	CITY - 2ND REVIEW	2025/05/29


DATE: 04/18/2025
SCALE: As indicated
DRAWN: JV
REVIEWED: MM/DP
JOB NUMBER: 6406.24

CEILING DETAILS


AE720

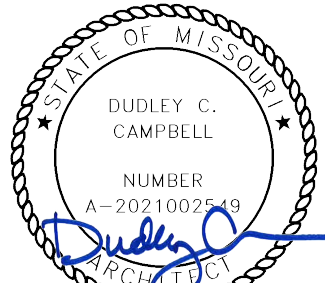

4 NARROW BULKHEAD 1 1/2" = 1'-0"

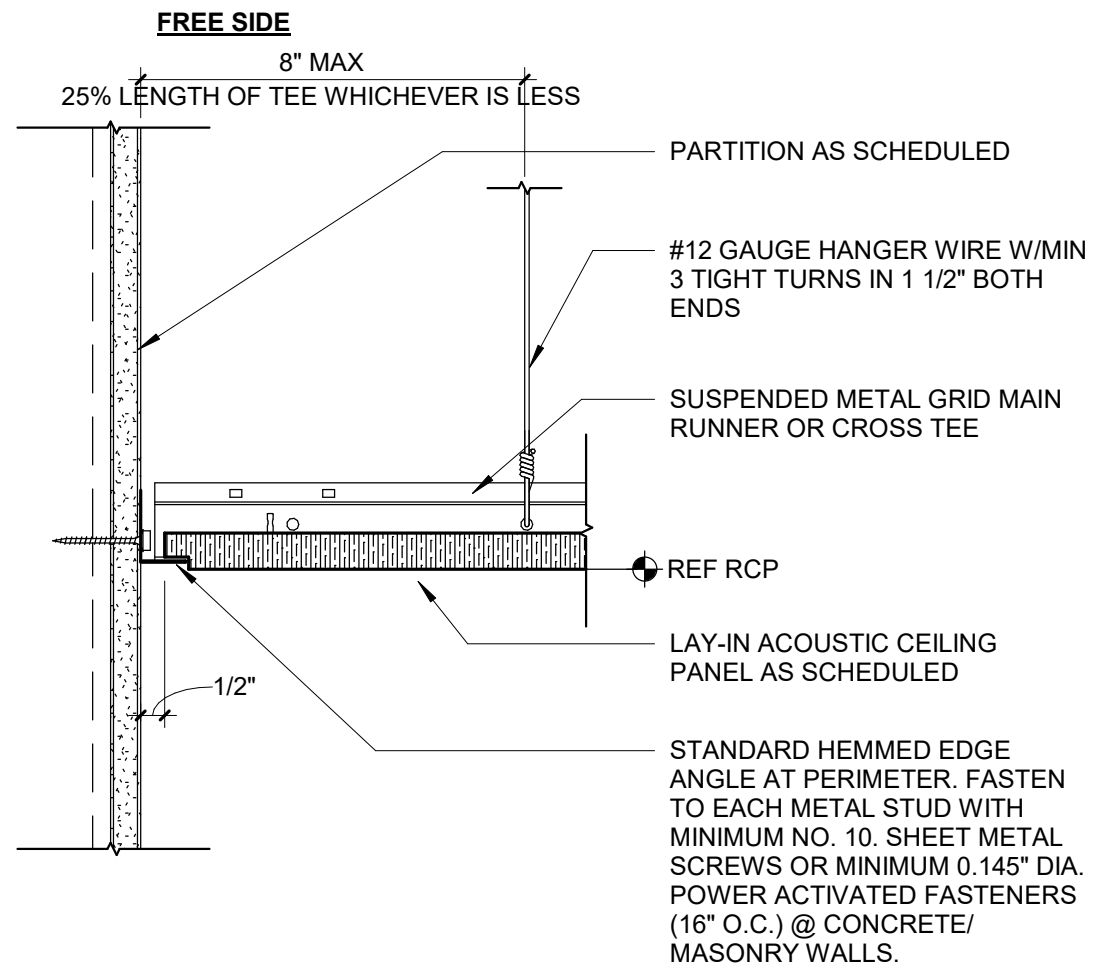


3 SUSPENDED LAY-IN CEILING FREE EDGE CONDITION C1070

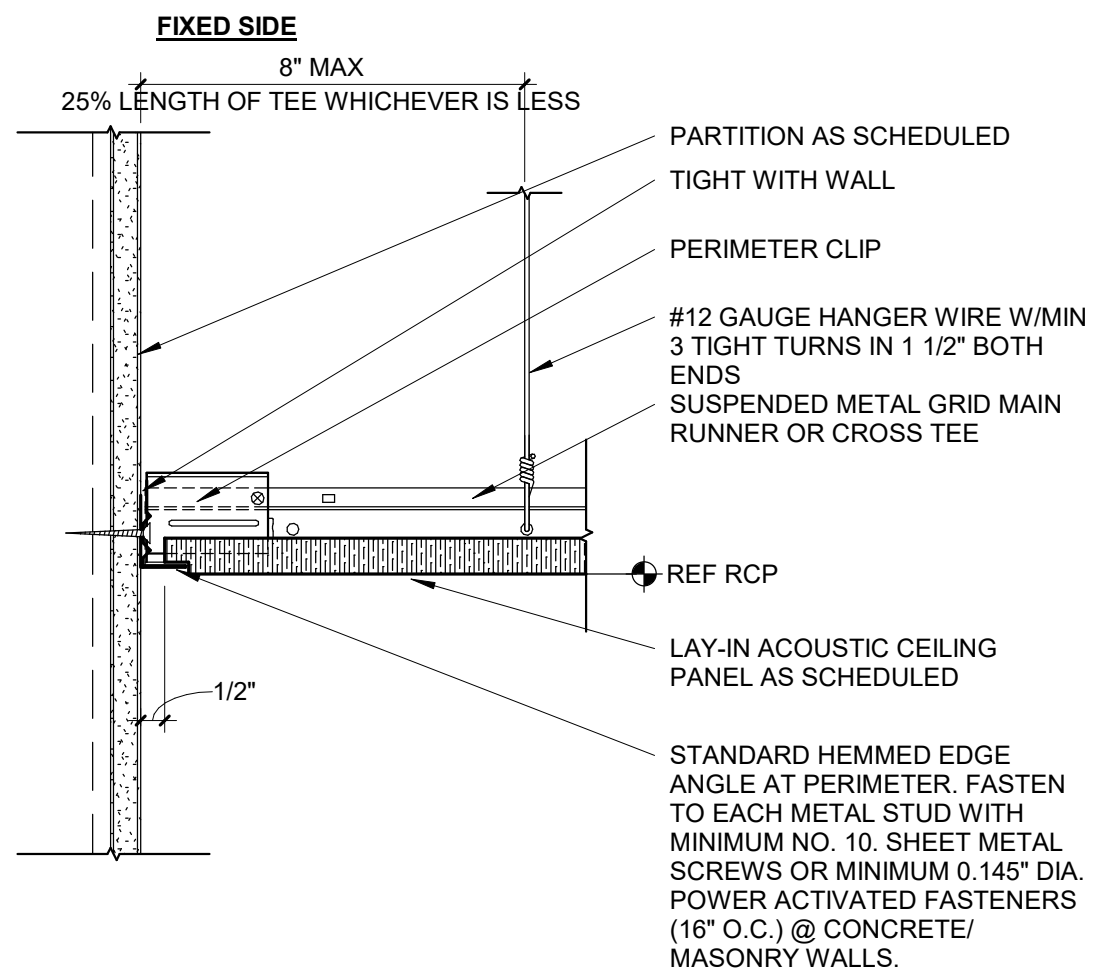


2 SUSPENDED LAY-IN CEILING EDGE CONDITION C1070

CONTINUOUS PERIMETER ANGLE OR KNURLED CHANNEL MOLDING FASTENED TO EACH METAL STUD WITH MINIMUM #10 SHEET METAL SCREWS OR MINIMUM 0.145" DIAMETER ACTUATED FASTENERS AT 16" ON CENTER AT CONCRETE/MASONRY WALLS (MINIMUM 1-1/4" EMBED)


NOTES:
1. STRUCTURAL CLASSIFICATION OF CEILING GRID MEMBERS:
MAIN RUNNERS: HEAVY DUTY CROSS-RUNNERS: HEAVY DUTY
2. ALL CEILING SYSTEMS ARE TO BE CENTERED IN DESIGNATED ROOMS UNLESS NOTED OTHERWISE

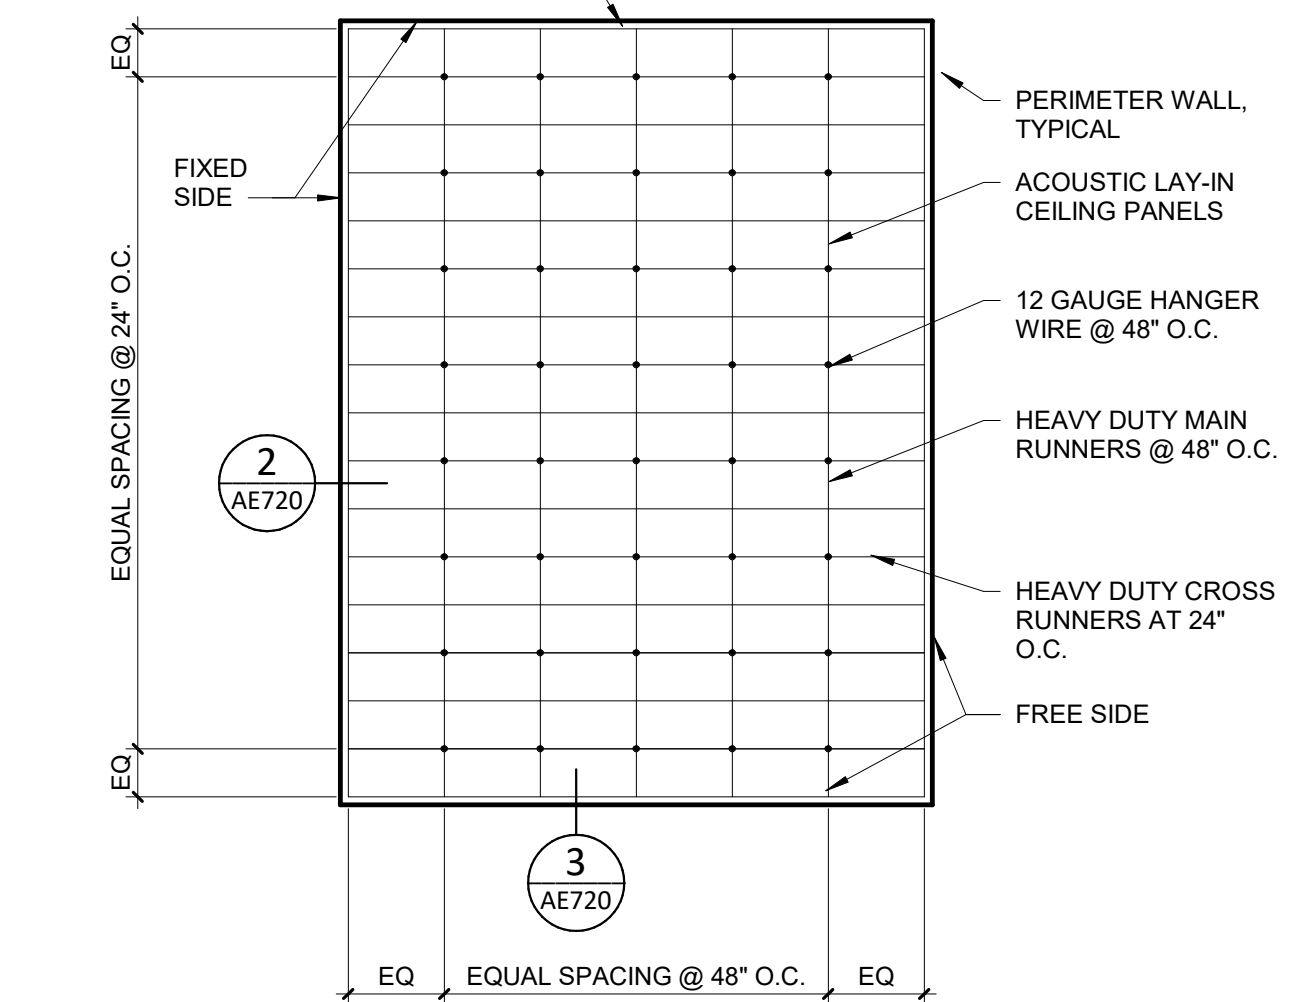


1 APC-SUSPENDED CEILING 1/8" = 1'-0"

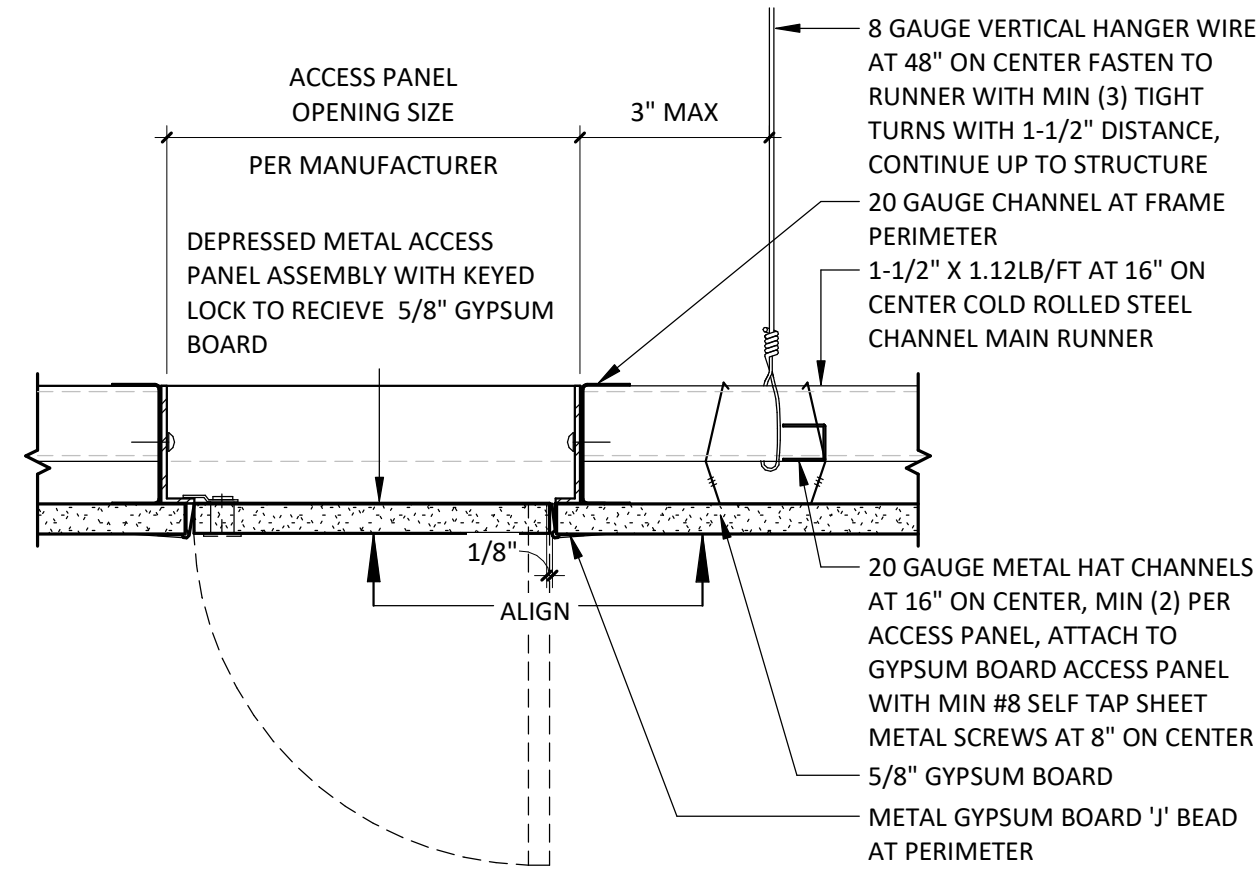

7 RECESSED GYPSUM BOARD ACCESS PANEL DETAIL 3" = 1'-0"

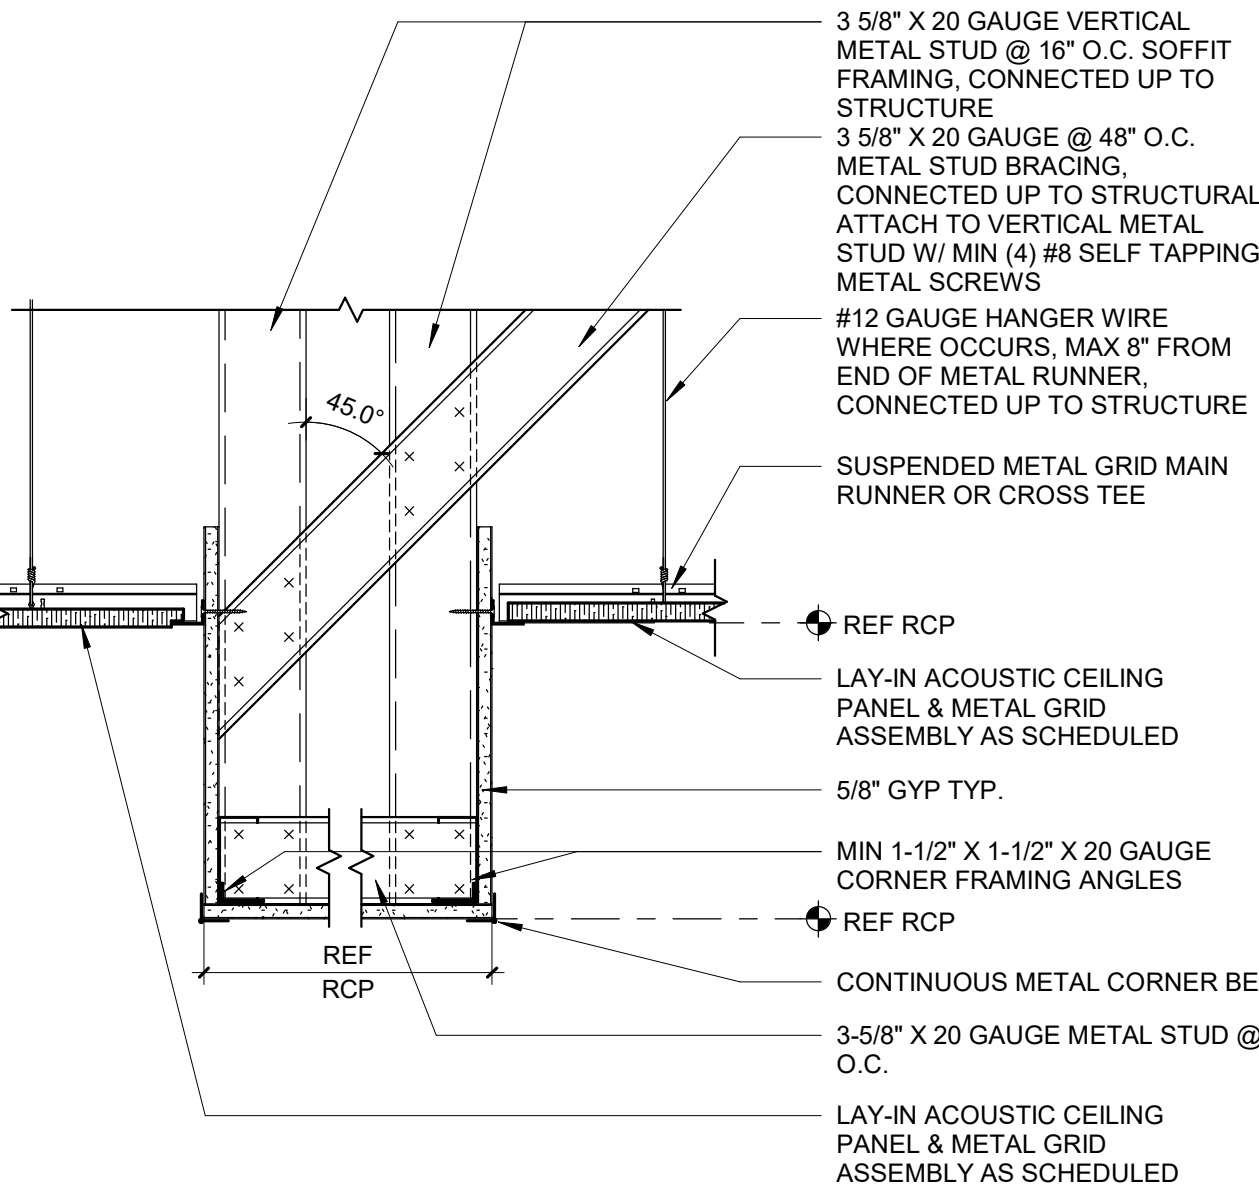


6 GYP BD SOFFIT TO APC 1 1/2" = 1'-0"

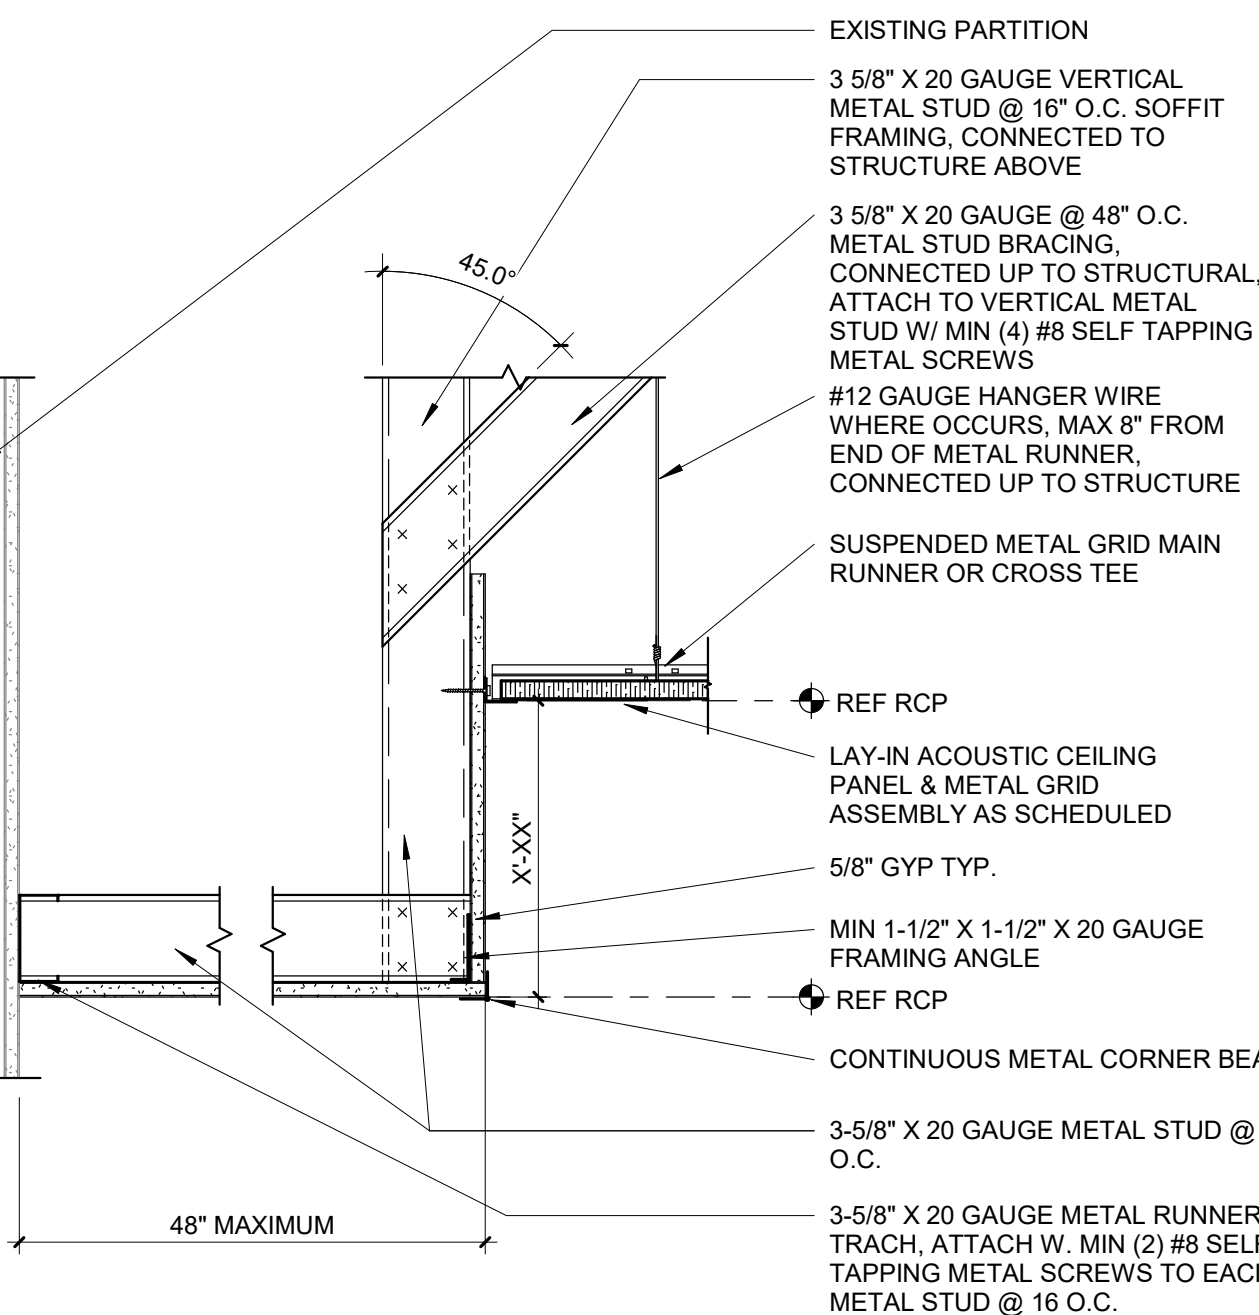


5 GYP BD SOFFIT TO APC 1 1/2" = 1'-0"




Autodesk Docx/6406.24 - HCA - Lee's Summit Medical Center (LSMC) - 2023/6406.24.0001 HCA - LSMC Admin Relocation.rvt 6/3/2025 2:22:09 PM

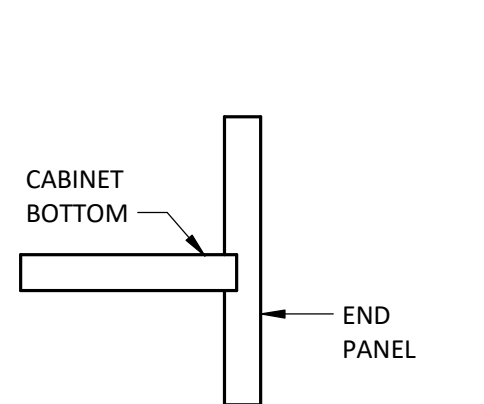


SEC. - UPPER CABINET
EXPOSED END AT VALANCE

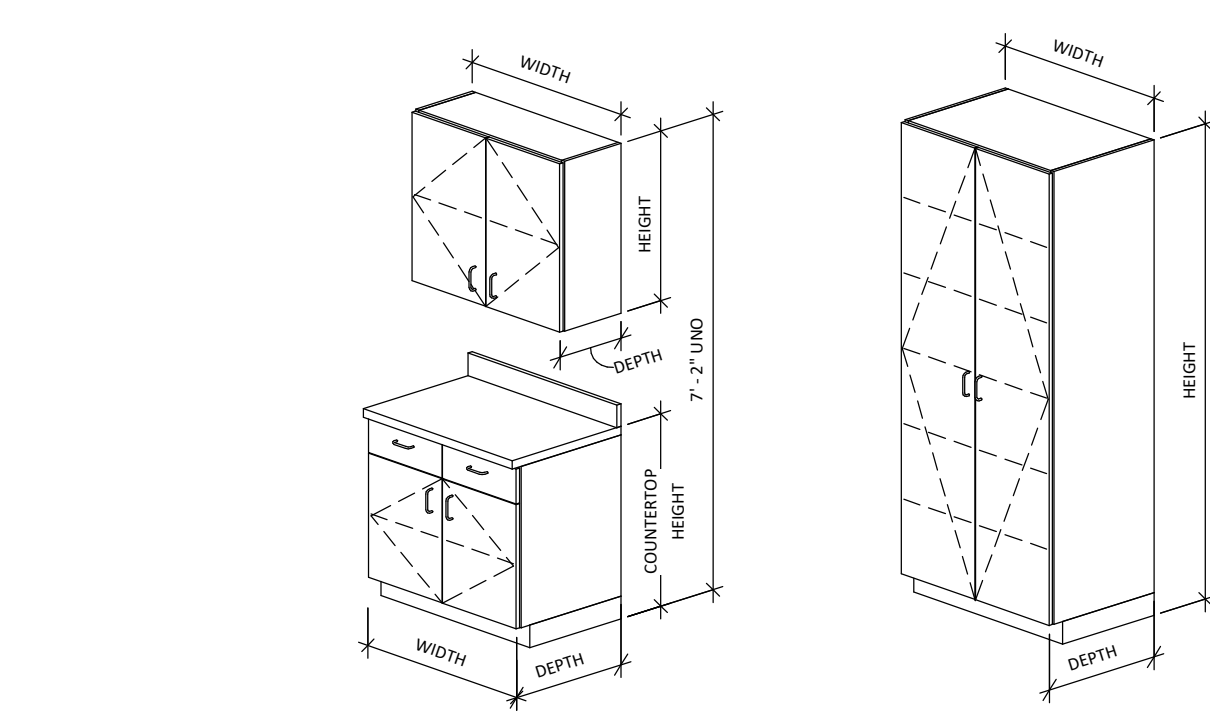


CASEWORK LEGEND

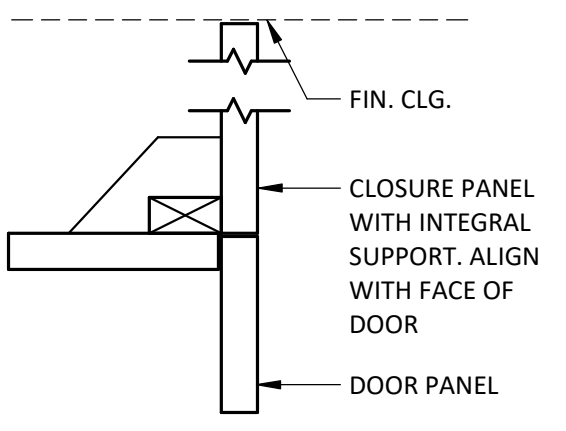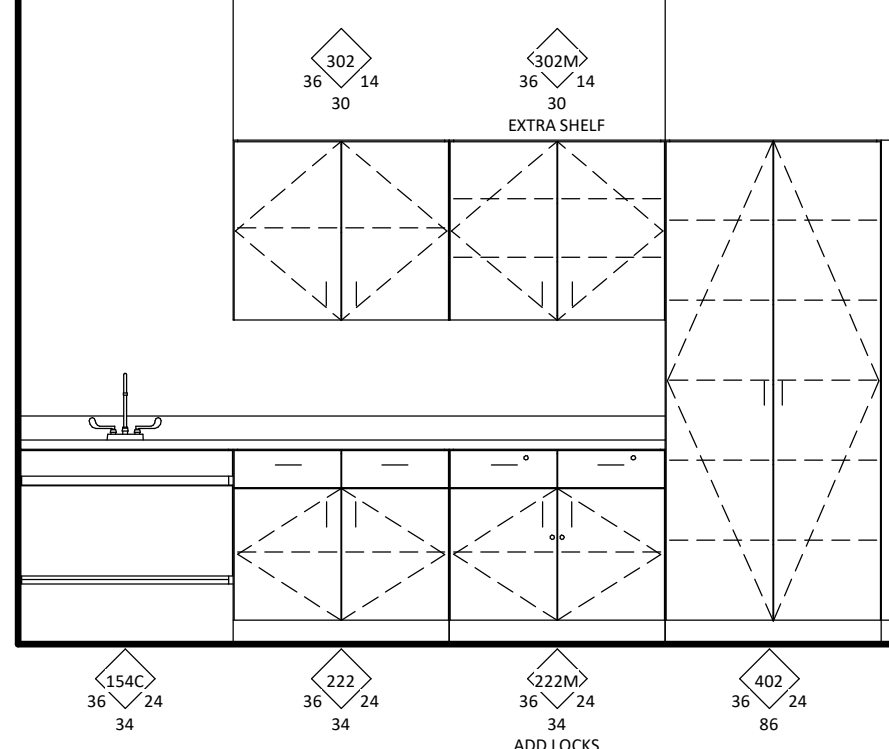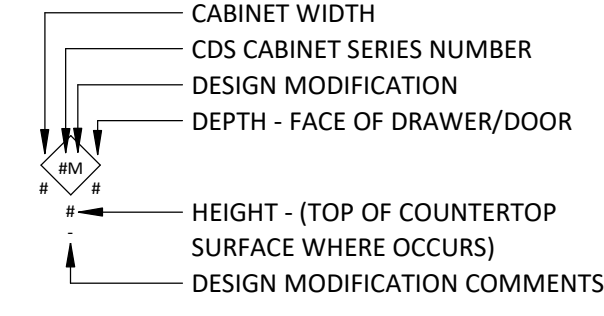


SEC. - UPPER CABINET
CLOSURE PANEL

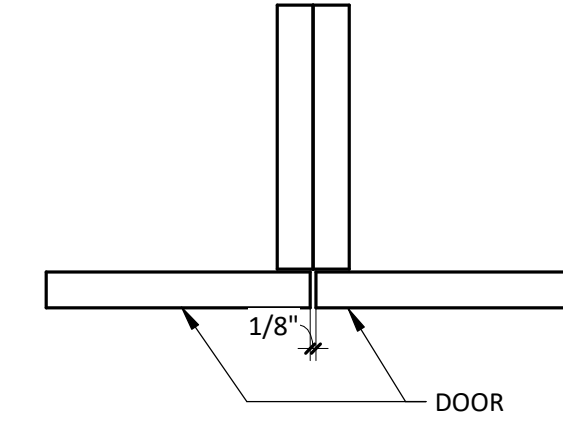


PLAN - CABINET TO CABINET

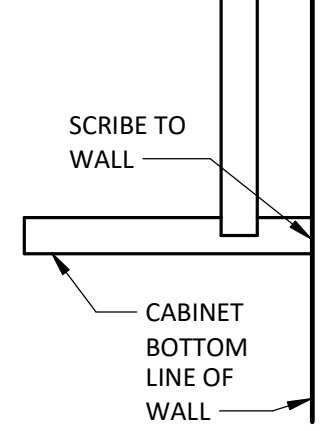


SEC. - UPPER CABINET
BOTTOM AT WALL

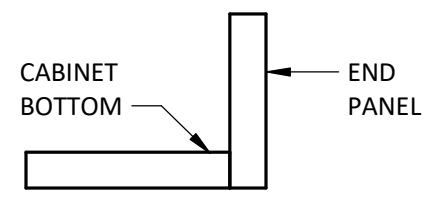


SEC. - UPPER CABINET
EXPOSED EDGE

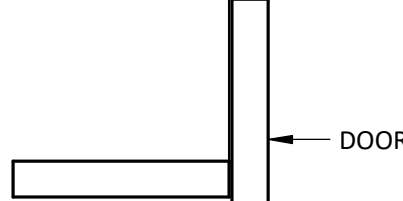


SEC - UPPER CABINET WITH
DOORS

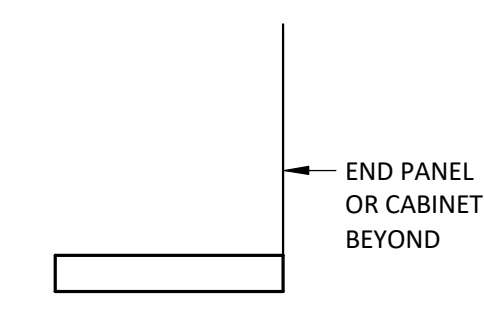


SEC. - UPPER CABINET OPEN

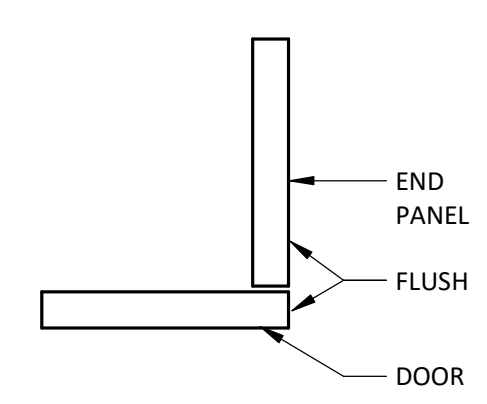


PLAN - END PANEL

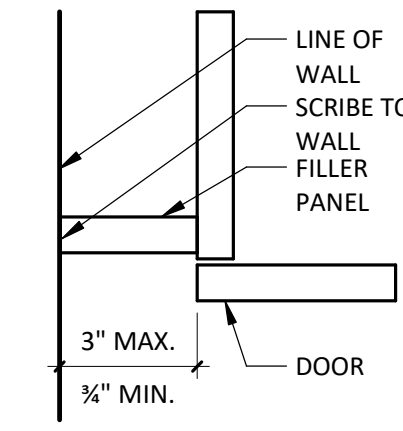


PLAN - FILLER PANEL

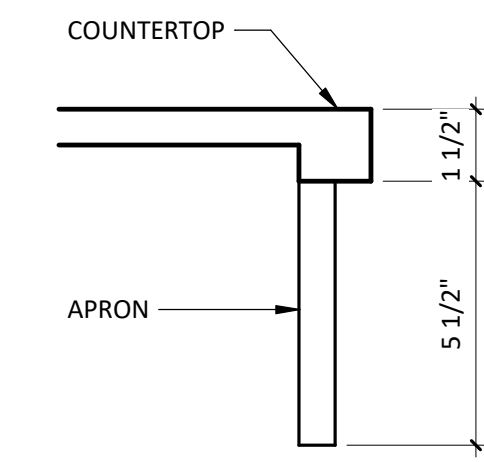


SEC. - KNEE SPACE / APRON

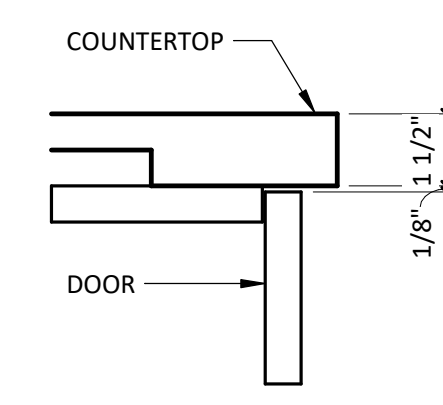


SEC. - COUNTER TOP WITH
DOOR BELOW

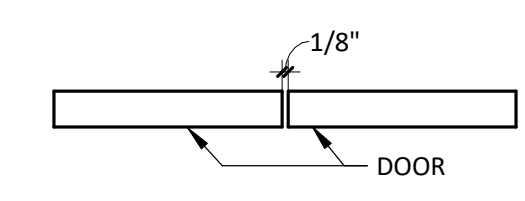


PLAN - DOOR TO DOOR

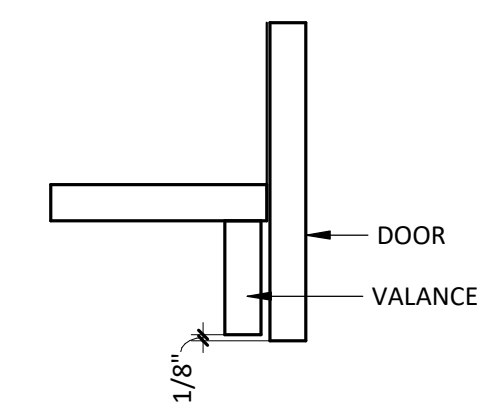


SEC. - UPPER CABINET WITH
DOORS AT VALANCE

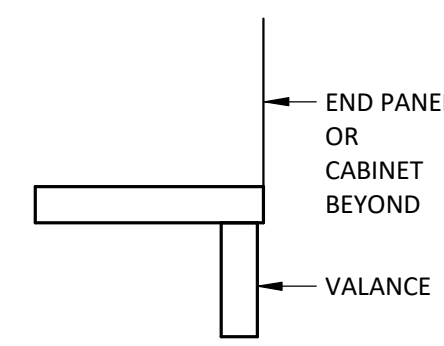


SEC. - UPPER CABINET OPEN
AT VALANCE

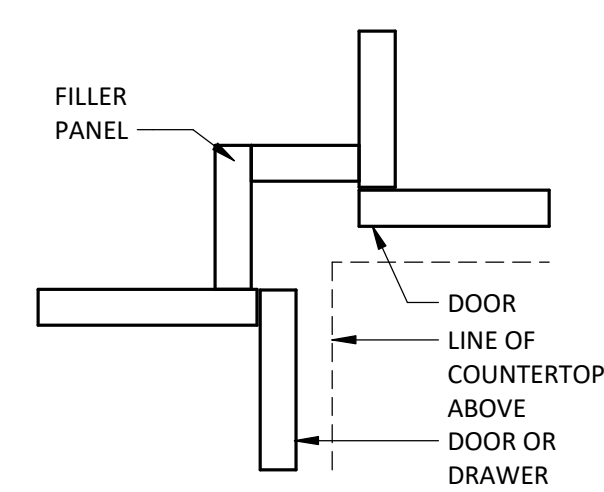


PLAN - INSIDE CORNER FILLER

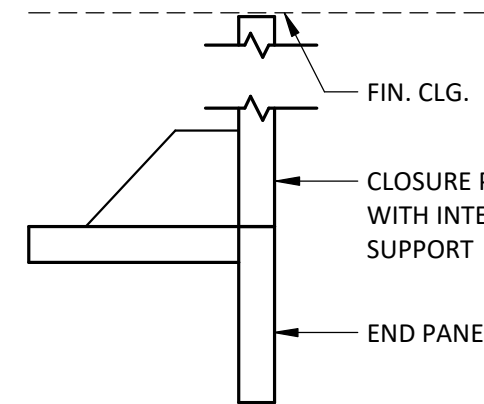


SEC. - UPPER CABINET
CLOSURE PANEL RETURN

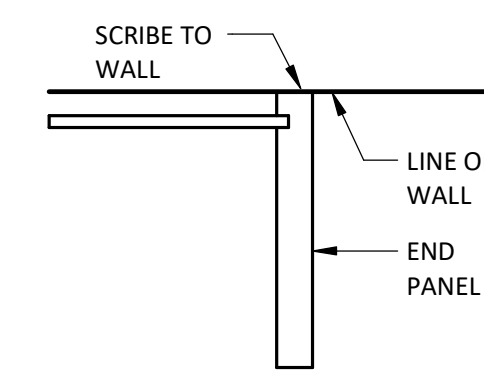


PLAN - END PANEL AT WALL

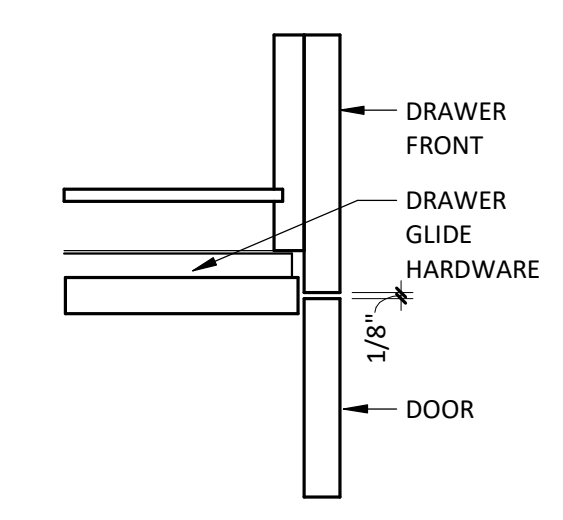


SEC. - DOOR TO DRAWER

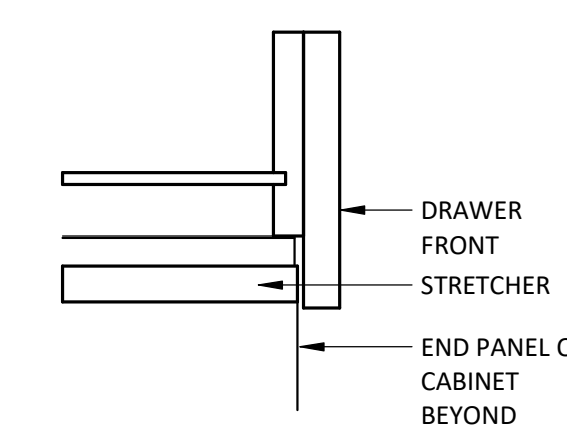

SEC. - OPEN TO DRAWER

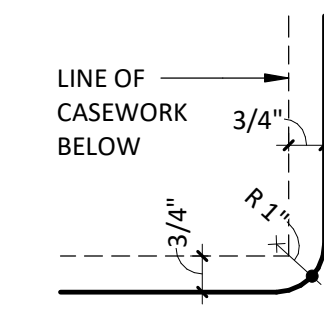

PLAN - COUNTER TOPS AT
OUTSIDE CORNERS

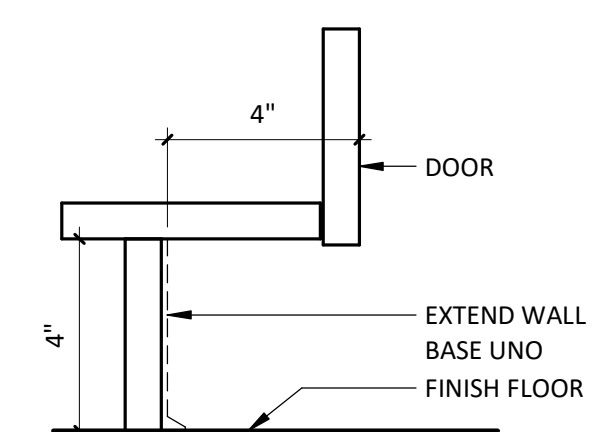

SEC. - DOOR AT BASE


CASEWORK GENERAL NOTES

- CABINETS FOLLOW THE NORTH AMERICAN WOODWORK STANDARDS - CASEWORK DESIGN SERIES
- REFER TO INTERIOR ELEVATIONS FOR CABINETS INFORMATION
- PROVIDE BLOCKING WITHIN PARTITION FOR ALL CABINETS ATTACHED TO WALLS. SEE TYPICAL CABINET ANCHORAGE DETAIL FOR MORE INFORMATION.
- DETAIL SECTIONS WILL BE PROVIDED FOR SPECIALIZED CABINETS. NOT ALL DOOR/DRAWER COMBINATIONS WILL BE DETAILED.
- PROVIDE MIN. 2" FILLER WHERE CABINET ABUTS PARTITION AT SIDE - UNO
- PROVIDE SIDESPLASHES WHERE COUNTERTOPS ABUT PARTITION AT SIDES - UNO
- PROVIDE COUNTERTOP BRACE SUPPORTS AT 32" OC MAX @ KNEE SPACES & LAVATORY COUNTERS
- PROVIDE 2" DIA. GROMMETS AT BACK OF COUNTERTOPS WHERE SHOWN ON PLANS OR ELEVATIONS
- AT THE BOTTOM OF INDIVIDUAL UPPER CABINET UNITS, ALLOW FOR CONTINUOUS RUNS OF UNDERCOUNTER LIGHTS - REFERENCE ELECTRICAL DRAWINGS
- FOR FIELD APPLIED MIRRORS, EXTEND MIRRORS FROM THE TOP OF COUNTERTOP SPLASH TO 7'-2" AFF. UNO X WIDTH SHOWN
- PROVIDE FINISHED END PANELS AND/OR END RETURNS AT OPEN ENDED CABINETS (INCLUDING KNEE SPACES).
- ALL UPPER CABINETS HAVE PLASTIC LAMINATE CLAD "FRONT PANELS" ABOVE IN LIEU OF GYPSUM BOARD FURR DOWNS - UNO VERIFY THE ROOM CEILING HEIGHT TO DETERMINE PROPER "CLOSURE PANEL" HEIGHT.
- CAULK JOINTS BETWEEN COUNTERTOPS AND BUILDING PARTITIONS AND BETWEEN COUNTERTOPS AND ADJACENT CASEWORK. COORDINATE COLOR OF CAULK TO CONDITIONS ON THE JOBSITE AND WITH THE ARCHITECT.
- REFER TO "ARCHITECTURALLY SIGNIFICANT EQUIPMENT" (MEDICAL EQUIPMENT SCHEDULE) FOR PURCHASE & INSTALLATION RESPONSIBILITIES FOR EQUIPMENT ITEM SHOWN ON PLANS & ELEVATIONS. COORDINATE SIZE OF OPENINGS WITHIN CABINETS.



Devenney Group Ltd., Architects
6900 East Camelback Road
Suite 500
Scottsdale, AZ 85251
T: 602.943.8950
www.devenneygroup.com

Consultant:

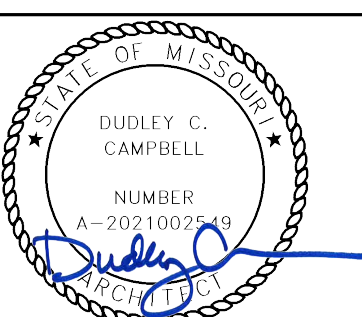

DATE SIGNED: 05/29/25

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ADMINISTRATION
RELOCATION

HCA - LEE'S SUMMIT
MEDICAL CENTER
2000 SE BLUE PKWY
LEE'S SUMMIT, MO 64063

AUTHORITY HAVING JURISDICTION:
CITY OF LEE'S SUMMIT BUILDING DEPT.
MISSOURI DHSS

FACILITY NUMBER:
0972400009

AGENCY APPROVALS:
AGENCY


REVISIONS		
REV #	DESCRIPTION	DATE
A	CITY - 2ND REVIEW	2025/05/29

DATE: 04/18/2025
SCALE: As Indicated
DRAWN: JV
REVIEWED: MM/DP
JOB NUMBER: 6406.24

CASEWORK DETAILS &
LEGEND

AE740


Autodesk Docx/6406.24 - HCA - Lee's Summit Medical Center (LSMC) - r23/6406.24.001 LCA - LSMC Admin Relocation.rvt 6/7/2025 2:22:09 PM

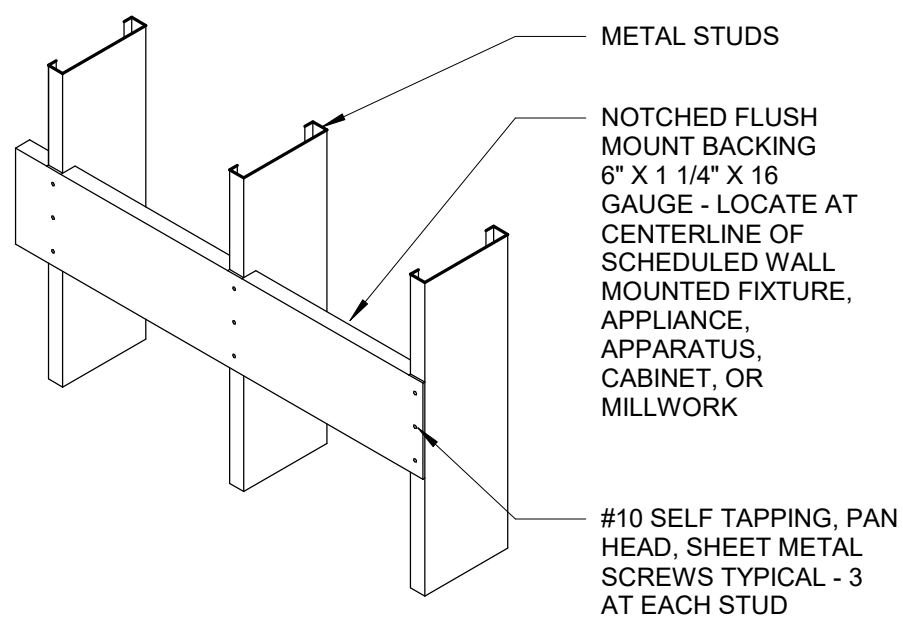

NOTE: GC TO COORDINATE IN-WALL BACKING LOCATIONS WITH ALL WALL MOUNTED EQUIPMENT INSTALLATION REQUIREMENTS.

17 CONTINUOUS METAL BACKING

1" = 1'-0"

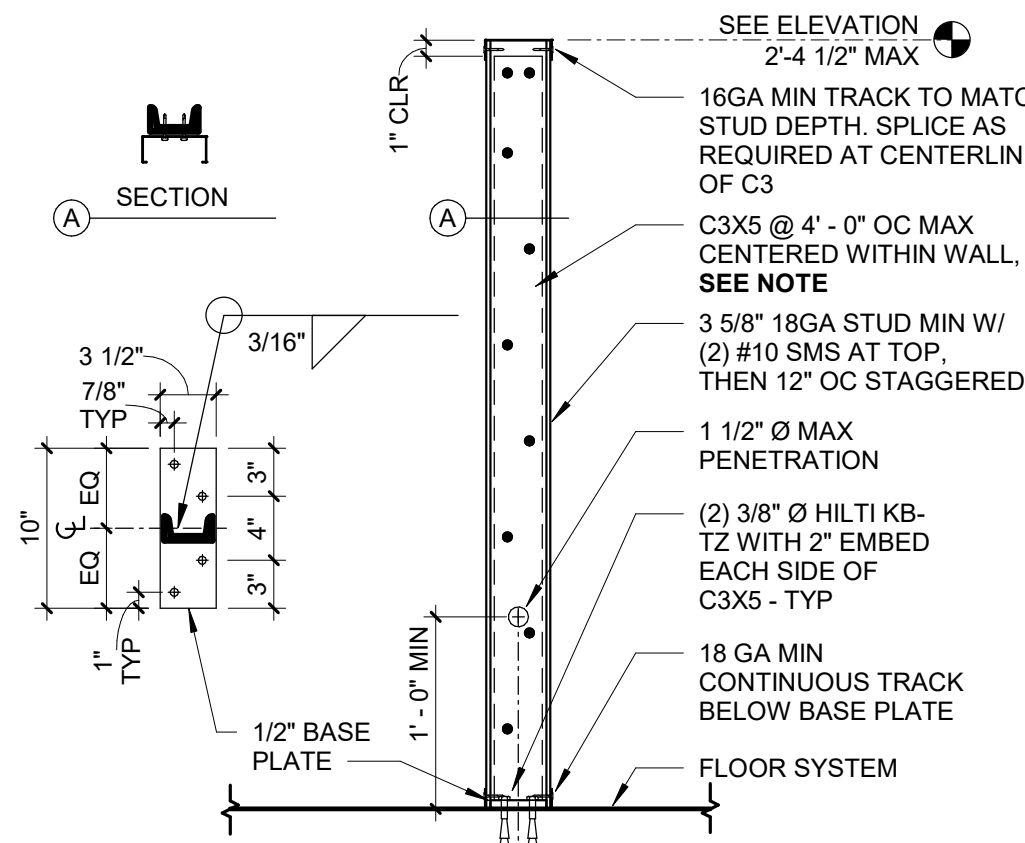


NOTE: WHERE COUNTER OCCURS C3X5 @ 2' - 8\"/>

CANTILEVERED PARTIAL HEIGHT WALL WHERE COUNTERTOP OCCURS

16

1" = 1'-0"

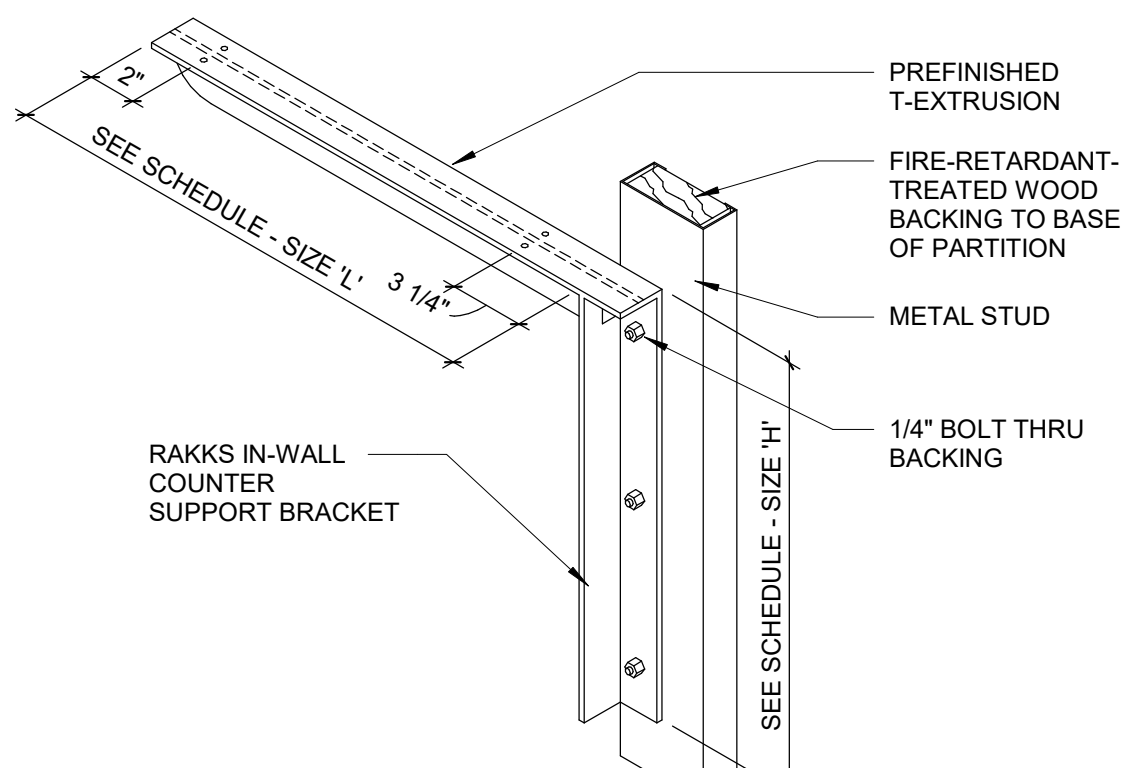

SCHEDULE:


COUNTER DEPTH	SIZE (H x L)	T-EXTRUSION	CAPACITY(LBS)
TO 13"	12" X 11"	2" X 2" X .25"	430
TO 18"	12" X 14"	2" X 2" X .25"	430
TO 25"	18" X 20"	2" X 2" X .25"	300
TO 30"	18" X 26"	2" X 3" X .188"	300

NOTE: AT FIRE RESISTANCE RATED ASSEMBLIES SEAL T-EXTRUSION PENETRATION WITH FIRE SEALANT

COUNTERTOP SUPPORT BRACKET

15


1 1/2" = 1'-0"

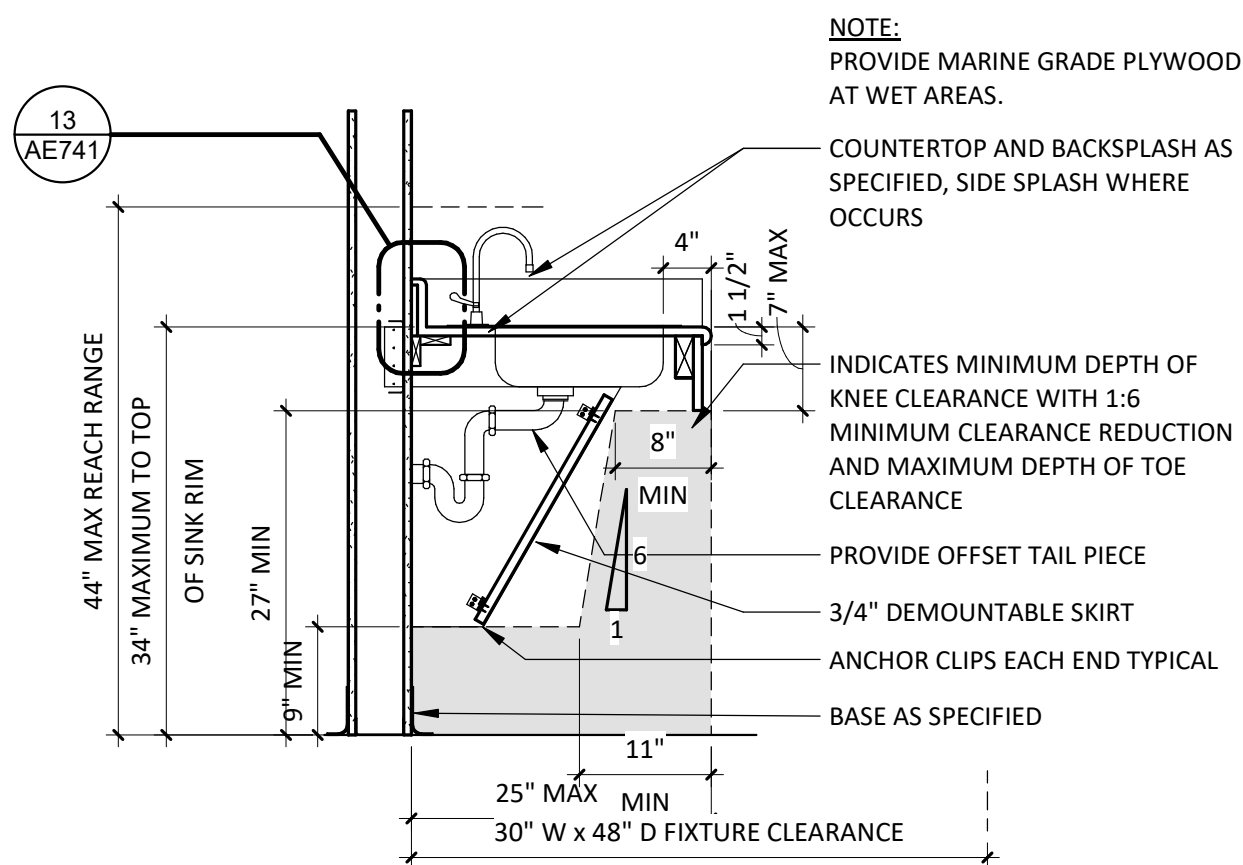

LAV W/ REMOVABLE PLUMBING SHIELD (NON-CAL)

14


3/4" = 1'-0"

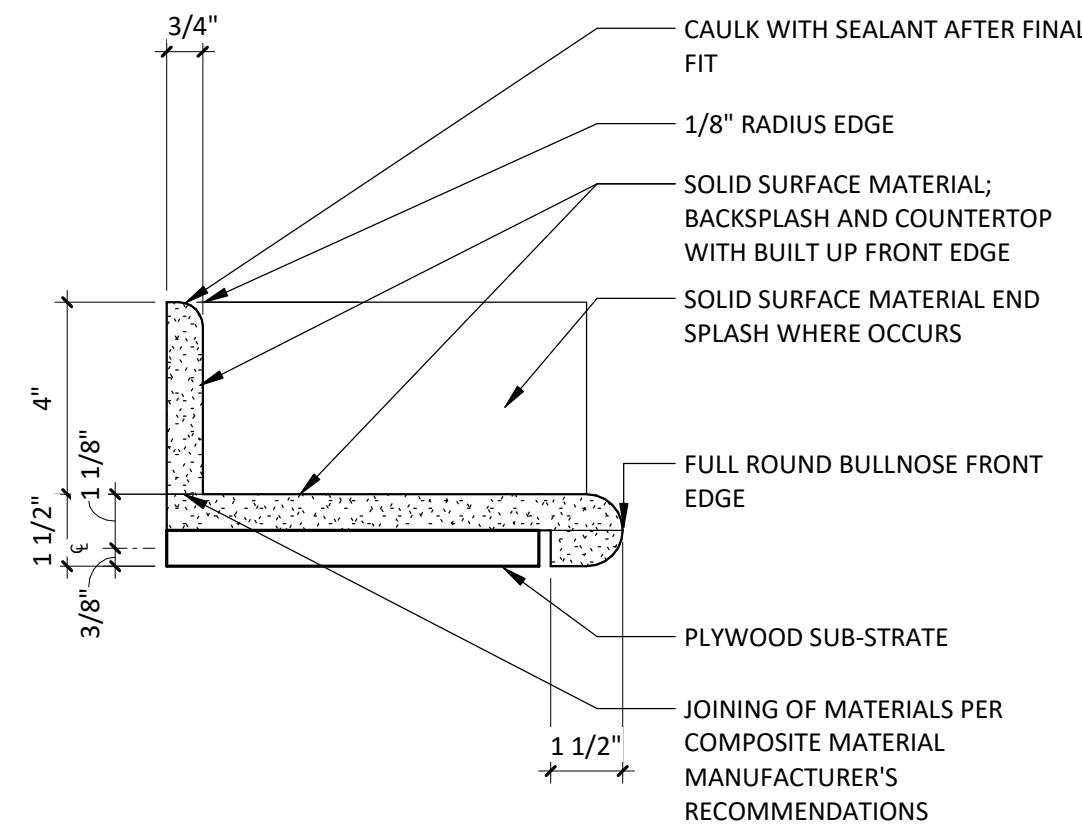

SOLID SURFACE COUNTERTOP

13


3" = 1'-0"

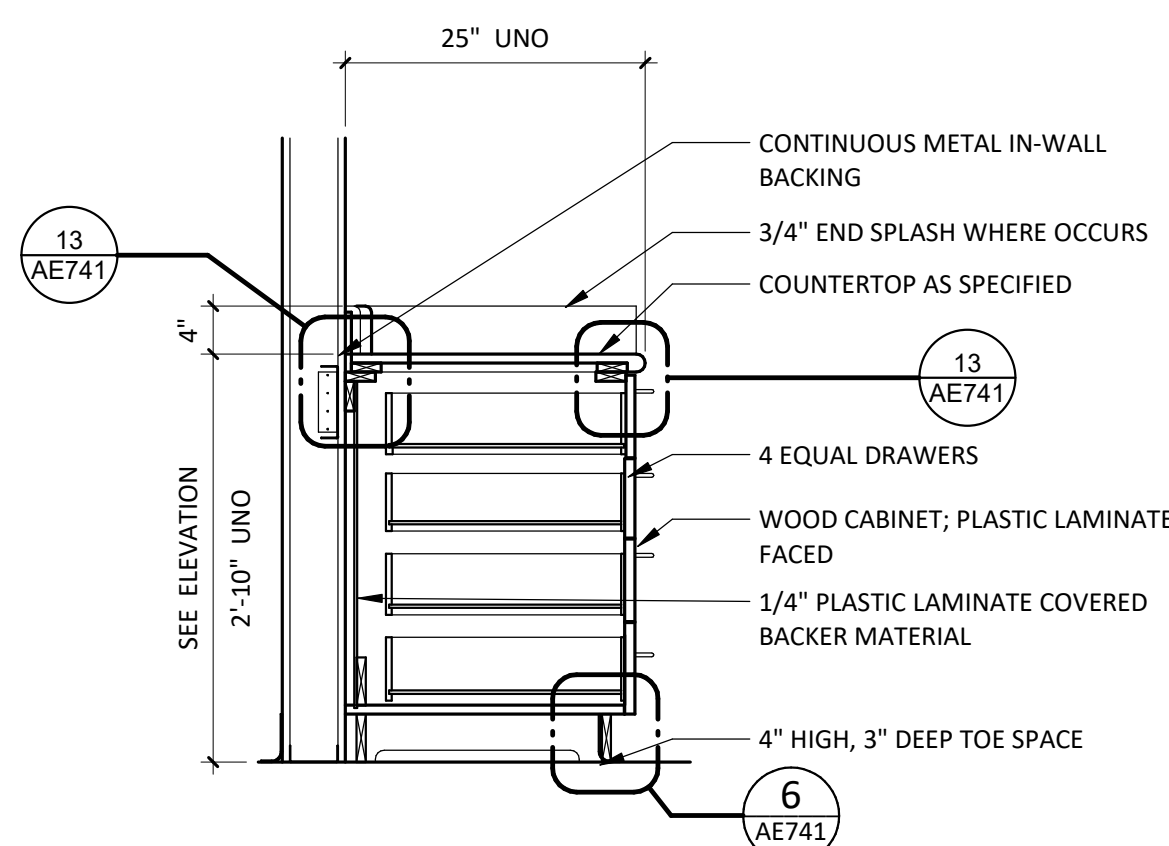

BASE CABINET (4 EQ.)

12


3/4" = 1'-0"

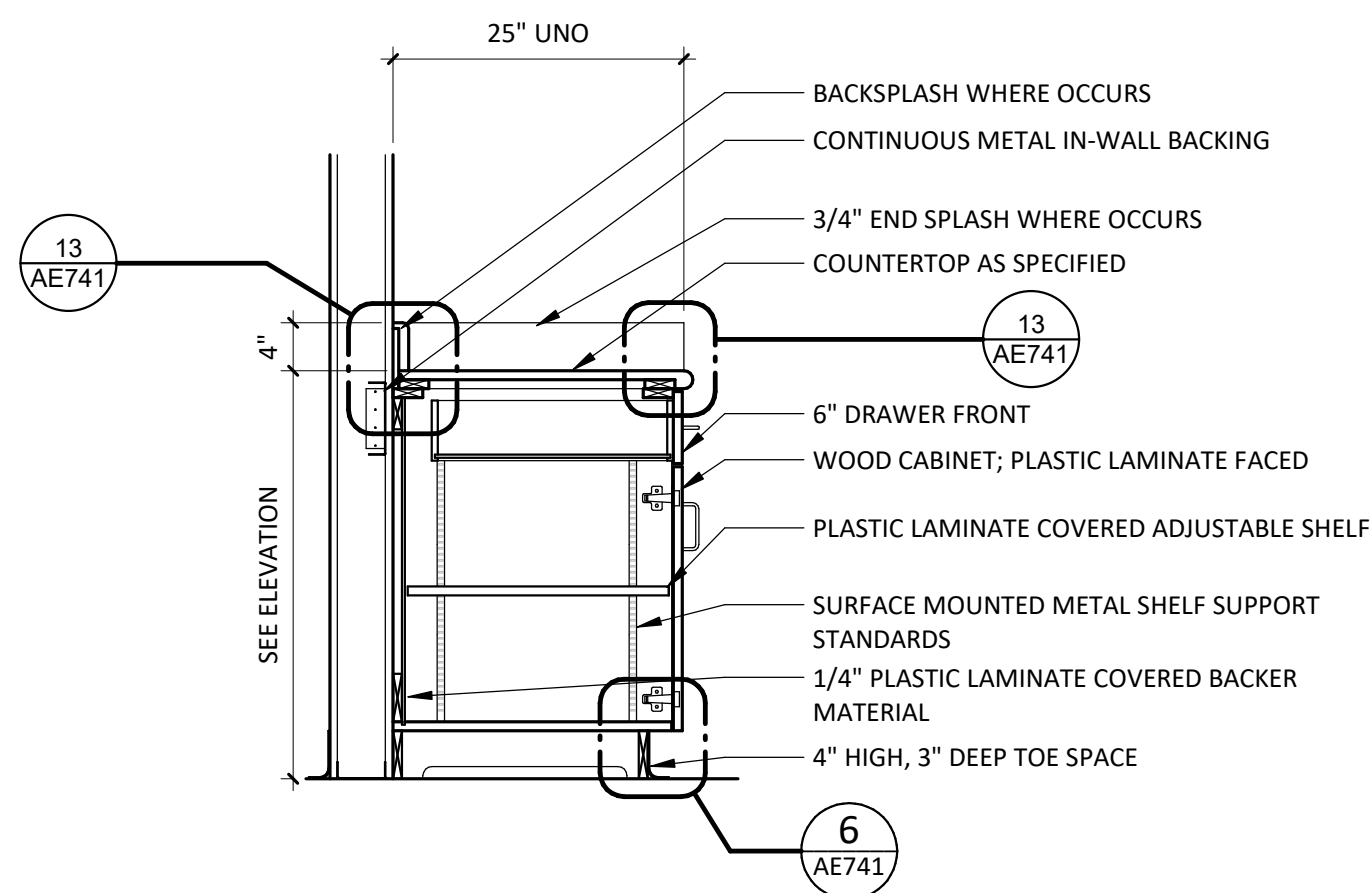

BASE CABINET

11


3/4" = 1'-0"

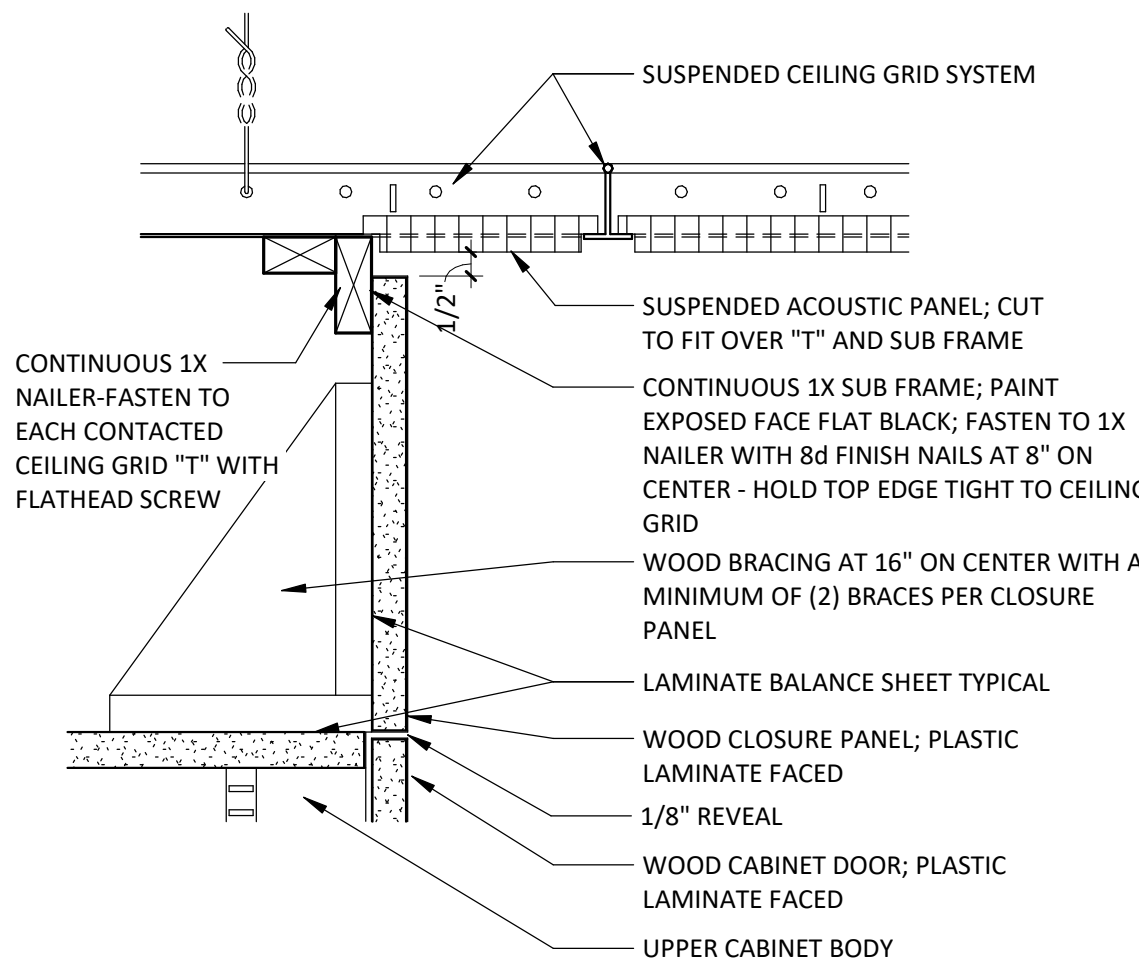

CLOSURE PANEL

10


3" = 1'-0"

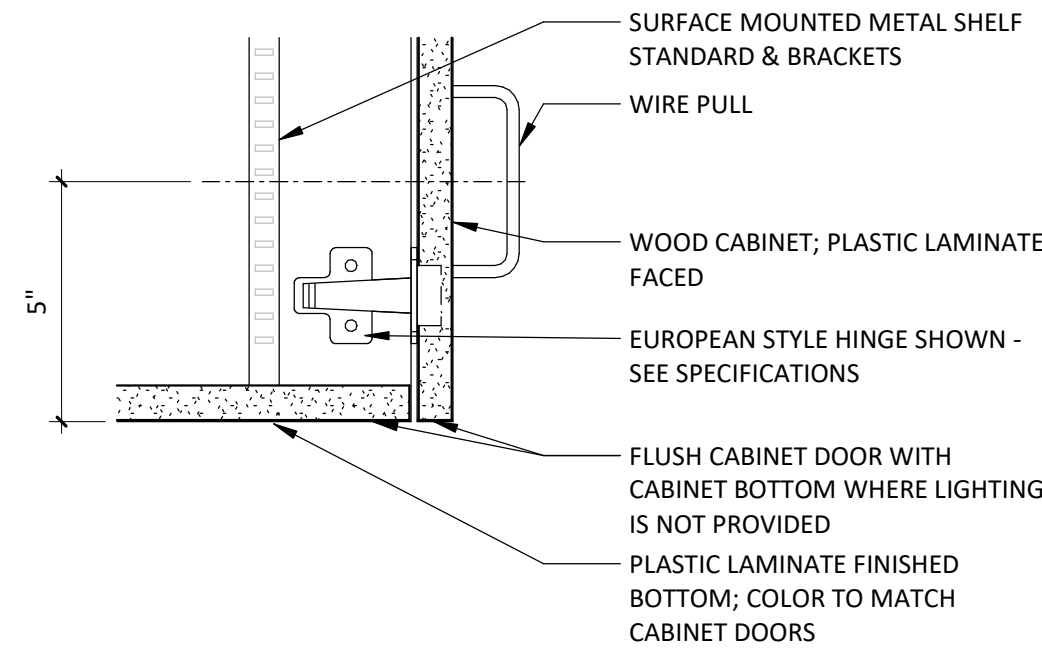

UPPER CABINET HARDWARE

9


3" = 1'-0"

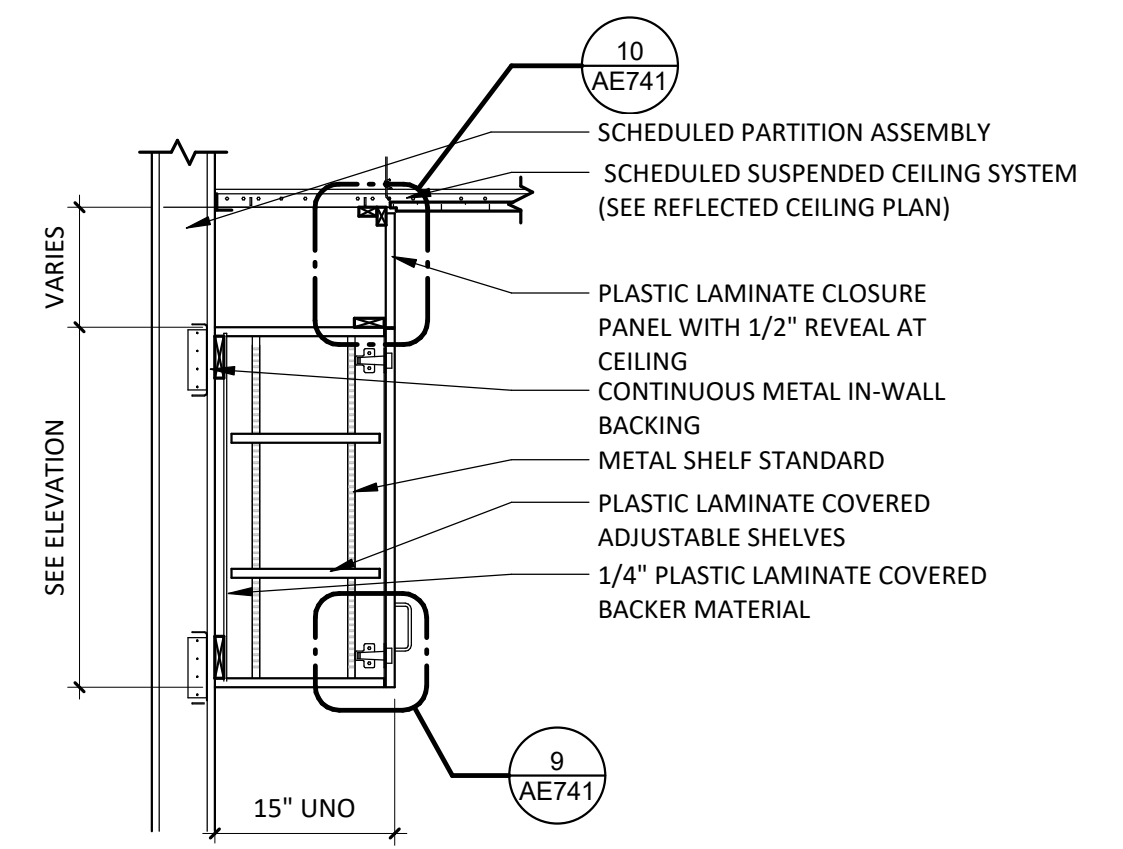

UPPER CABINET

8


3/4" = 1'-0"

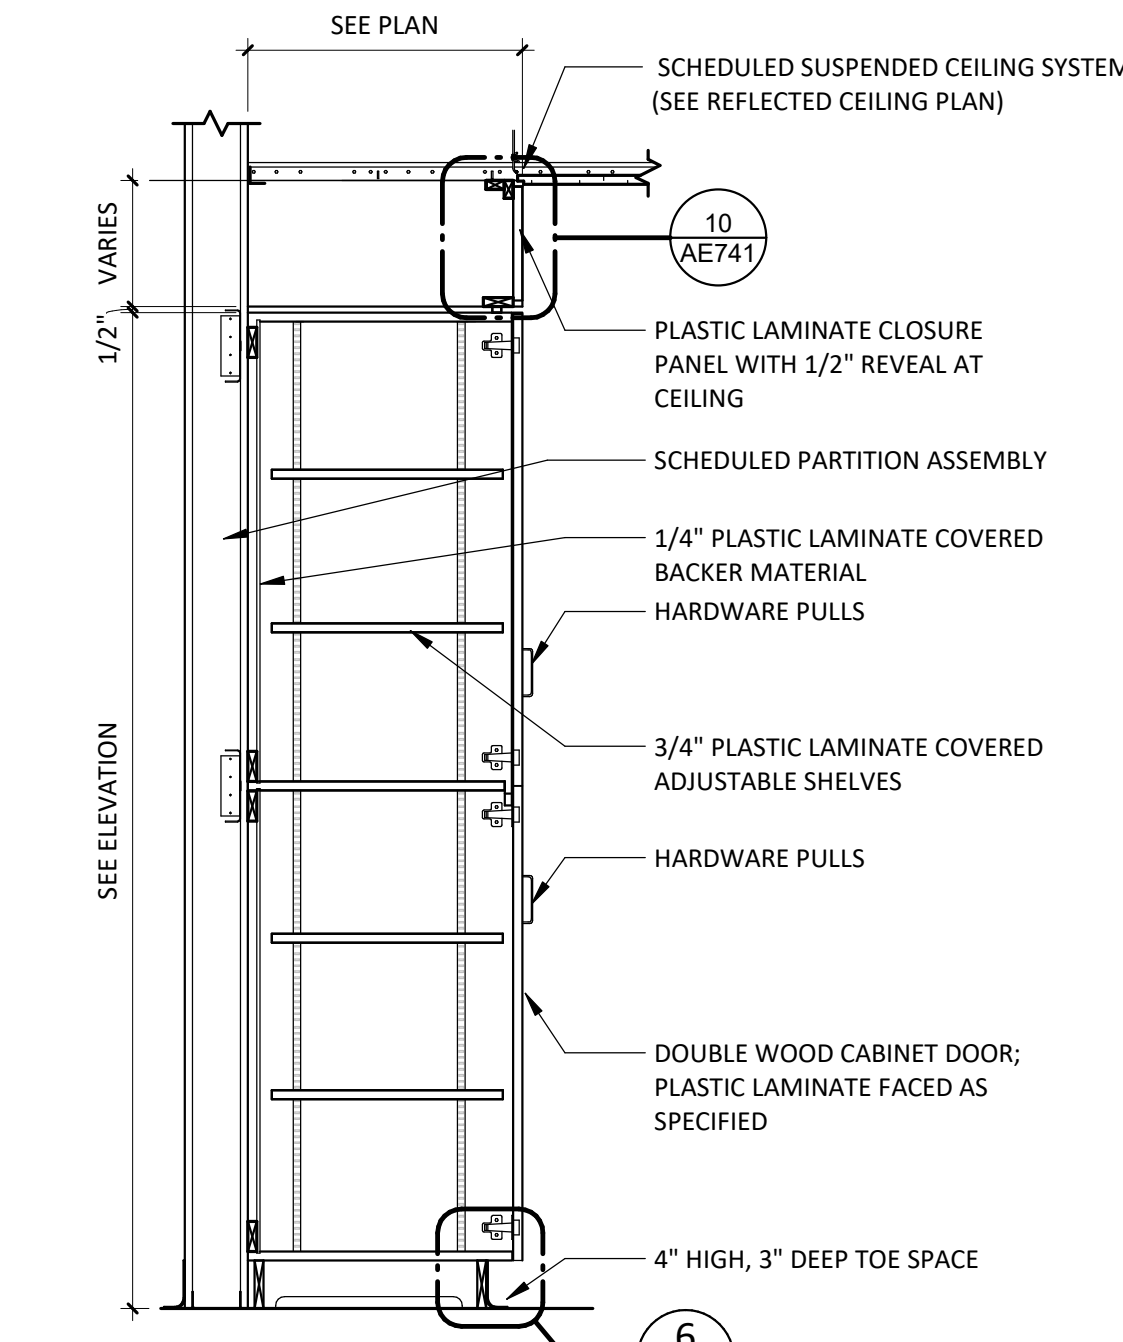

FULL HEIGHT CABINET

7


3/4" = 1'-0"

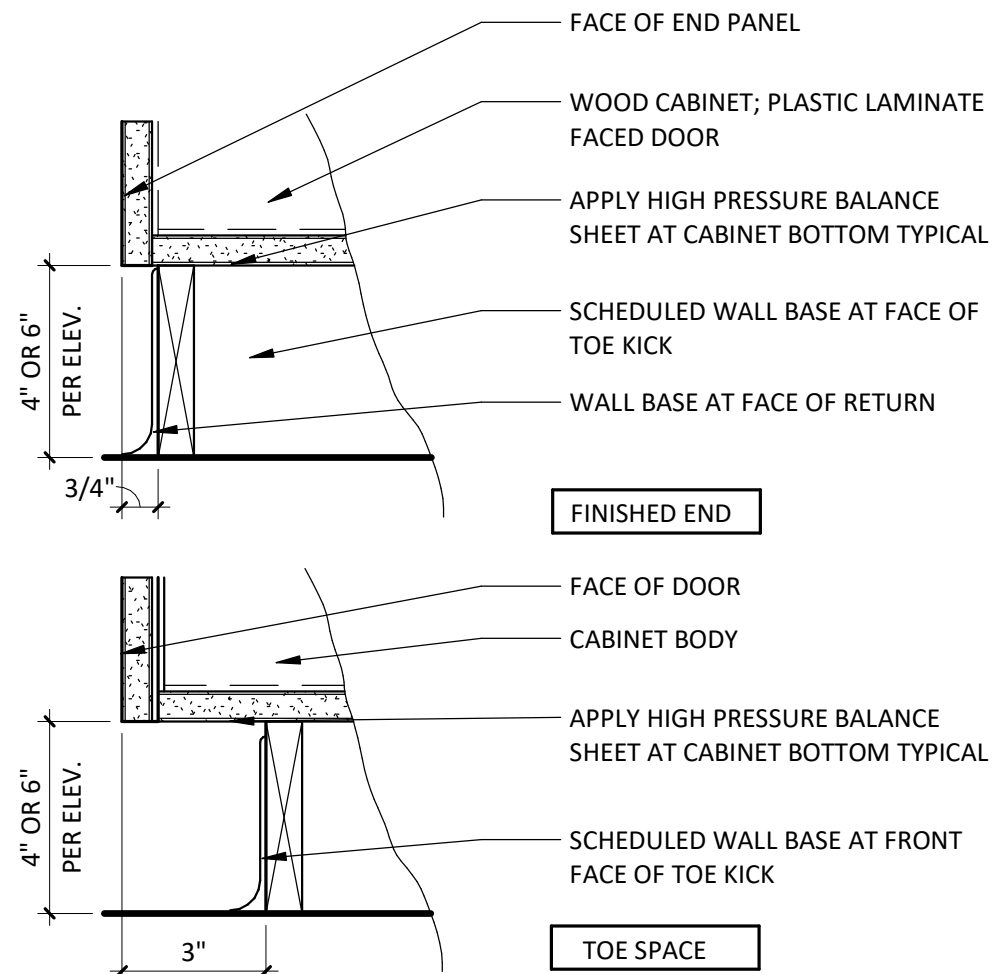

TOE KICK

6


3" = 1'-0"

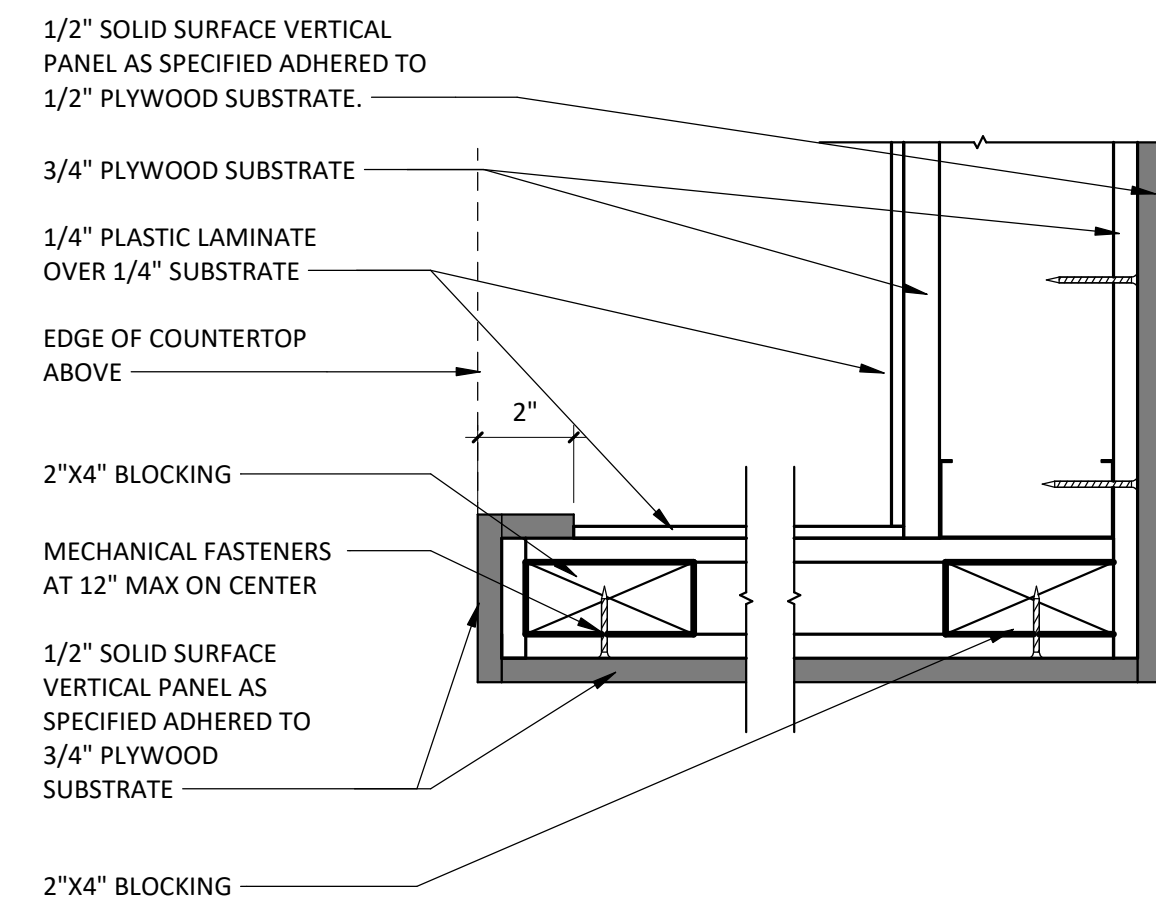

VERTICAL SOLID SURFACE END PANEL

5


3" = 1'-0"

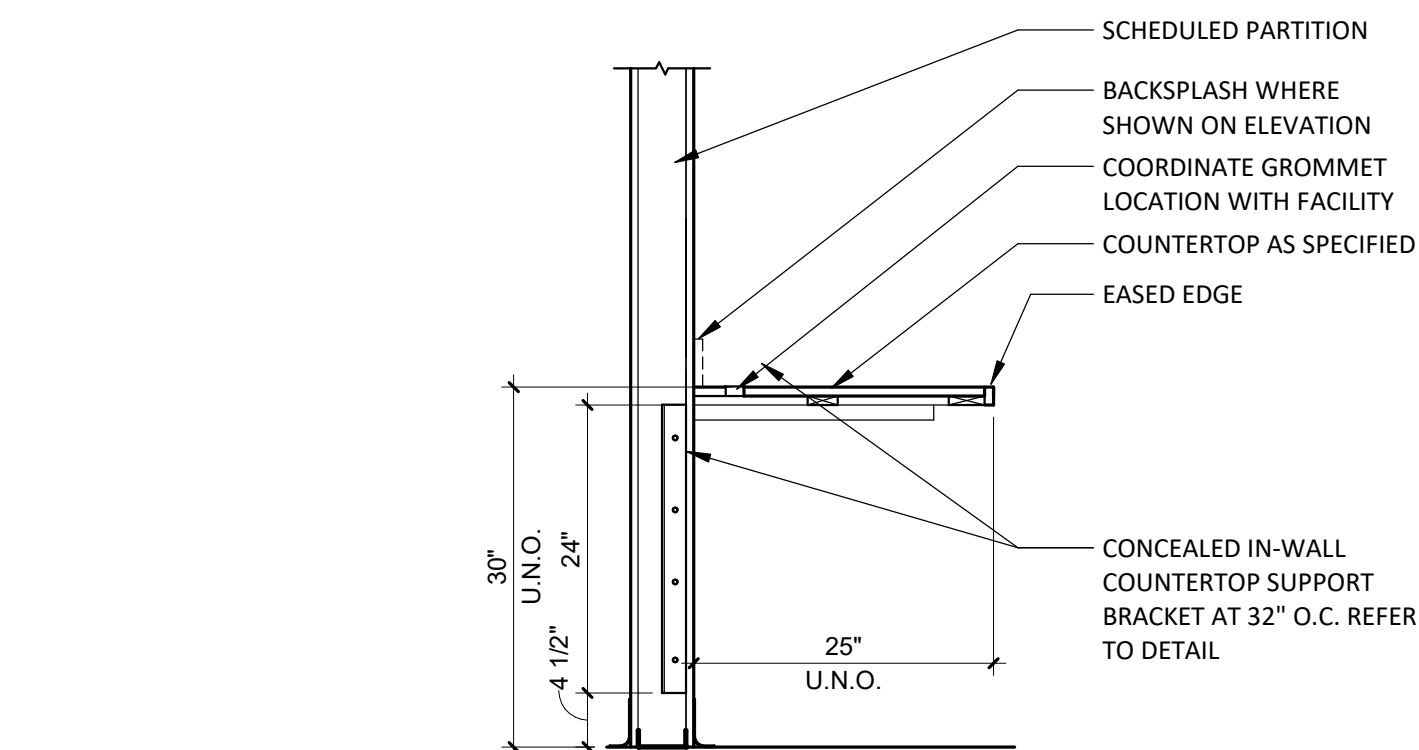

WORK SURFACE

4


3/4" = 1'-0"

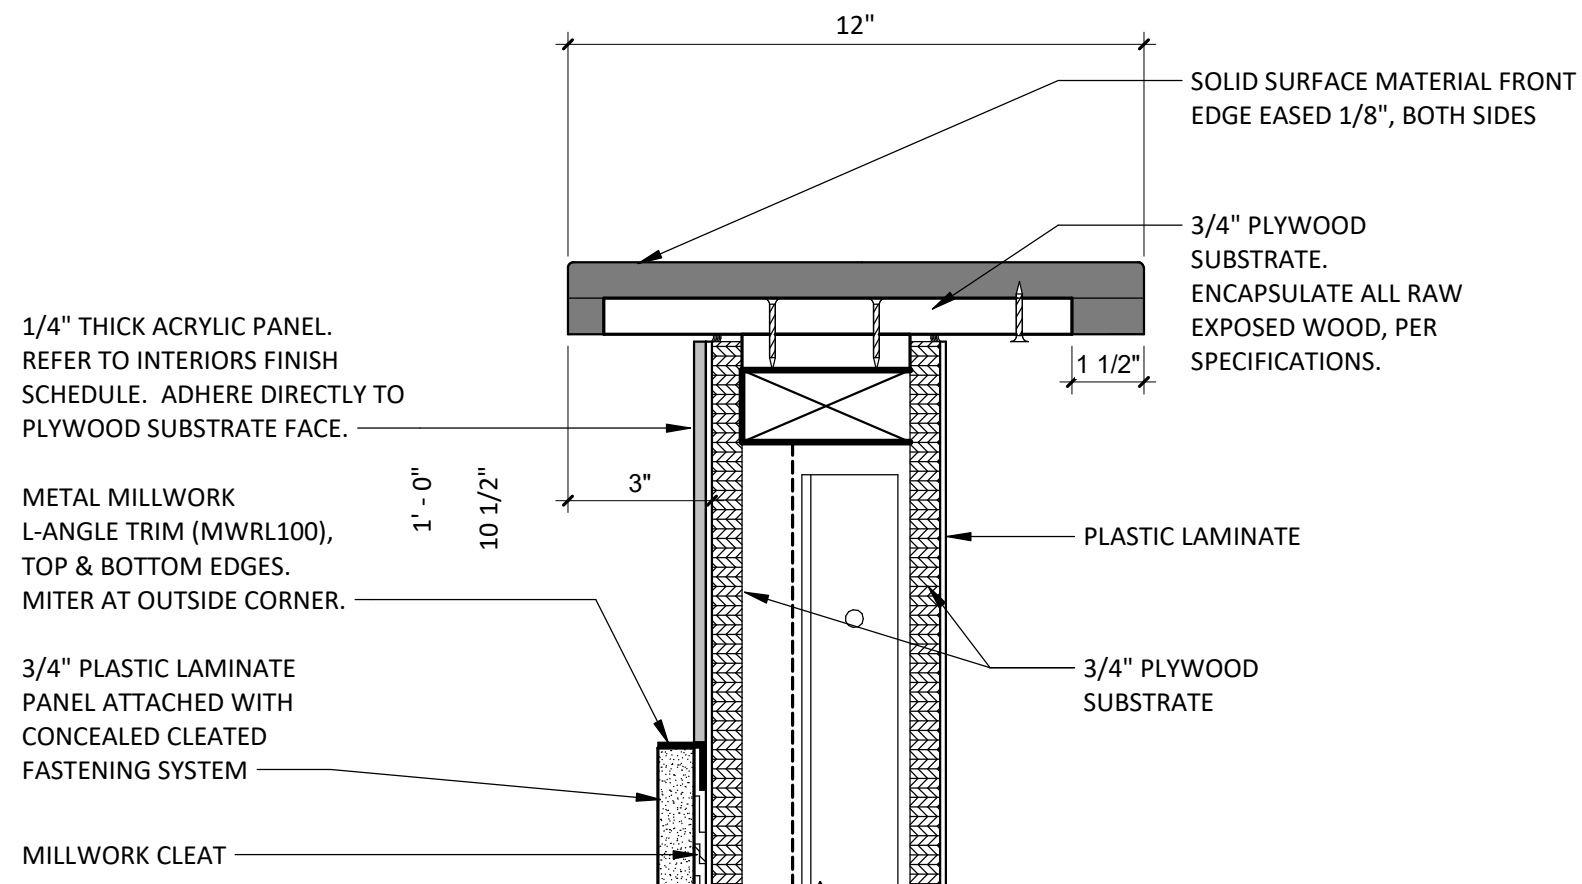

12" TRANSACTION TOP - ENLARGED

3


3" = 1'-0"

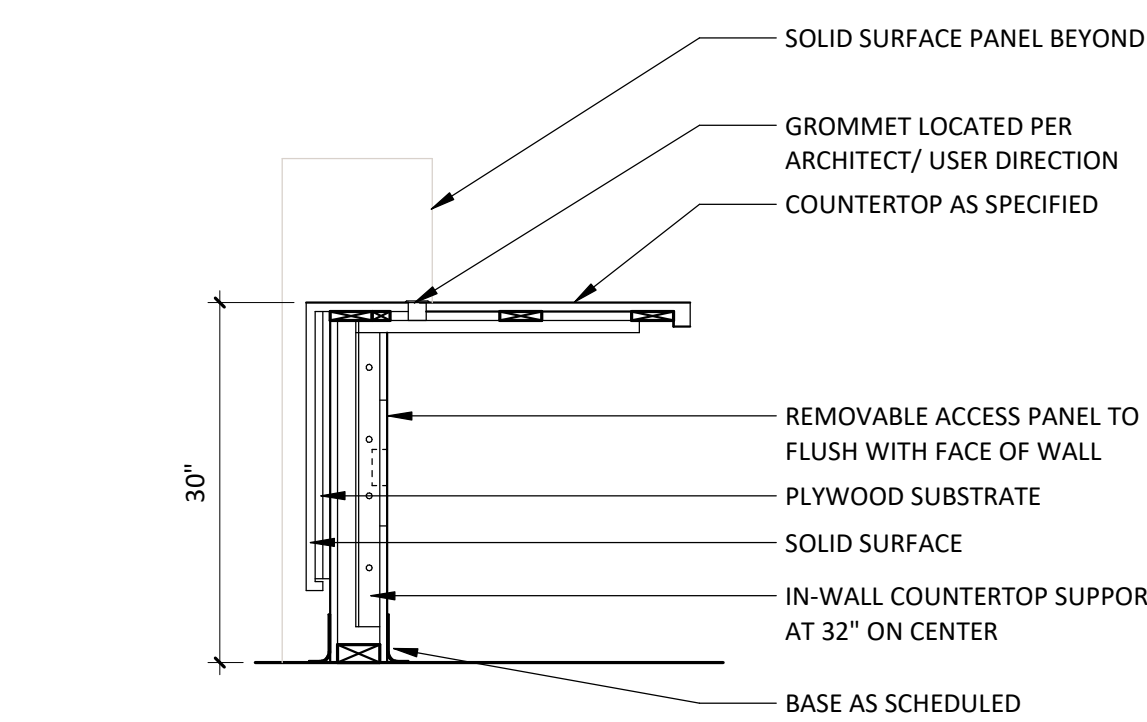

RECEPTION - LOW COUNTER

2

3/4" = 1'-0"

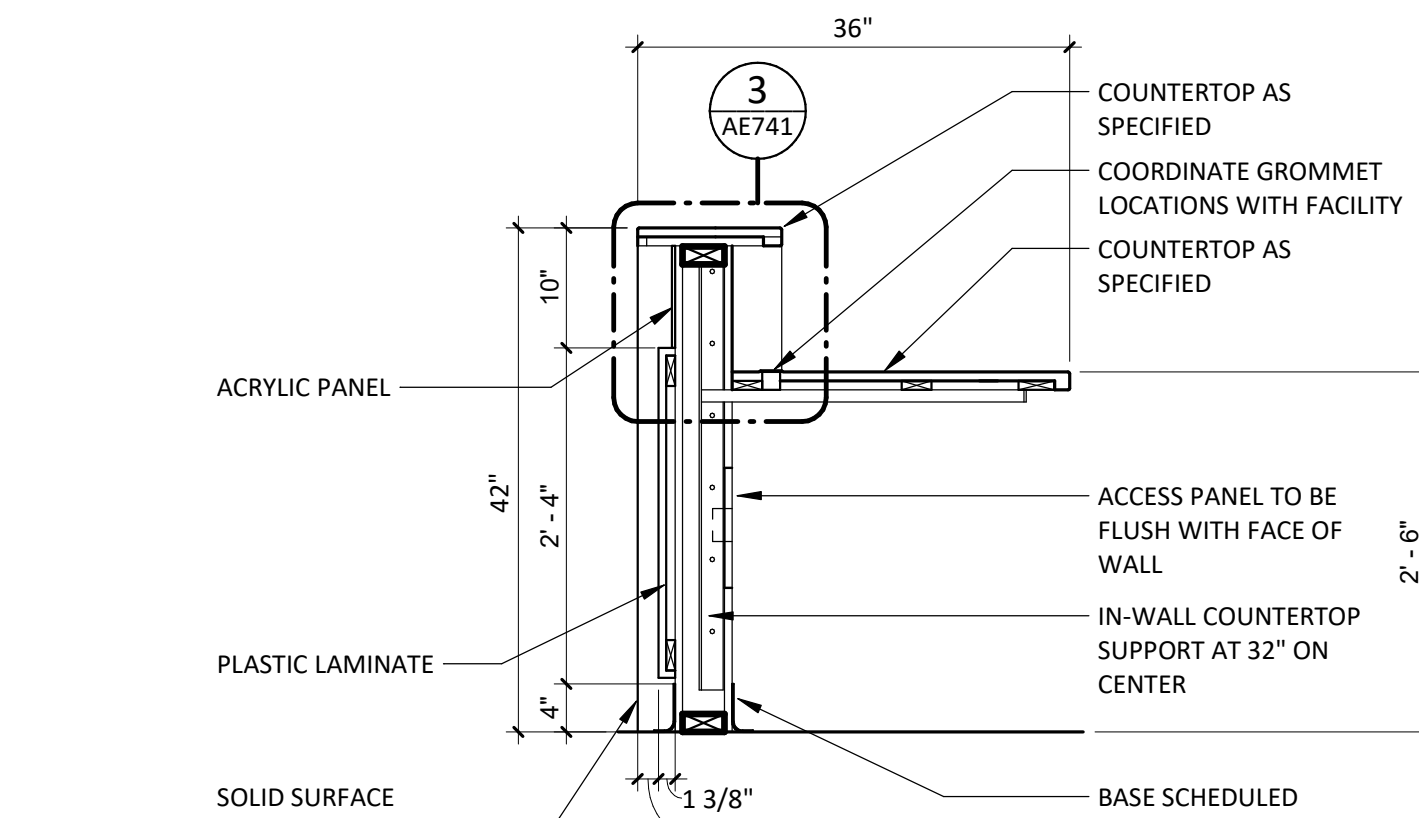


RECEPTION - HIGH COUNTER

1

3/4" = 1'-0"

Consultant:

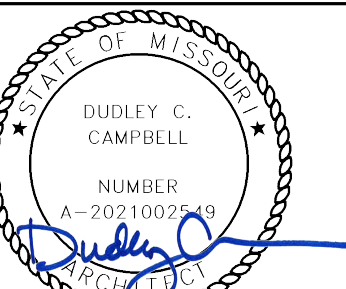

DATE SIGNED: 05.29.25

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ADMINISTRATION RELOCATION

HCA - LEE'S SUMMIT MEDICAL CENTER
2000 SE BLUE PKWY
LEE'S SUMMIT, MO 64063

AUTHORITY HAVING JURISDICTION:
CITY OF LEE'S SUMMIT BUILDING DEPT.
MISSOURI DHSS

FACILITY NUMBER:
0972400009

AGENCY APPROVALS:
AGENCY

REVISIONS		
REV #	DESCRIPTION	DATE
A	CITY - 2ND REVIEW	2025/05/29

DATE: 04/18/2025
SCALE: As indicated
DRAWN: JV
REVIEWED: MM/DP
JOB NUMBER: 6406.24

MILLWORK DETAILS

AE741

FINISH SELECTIONS AND GENERAL NOTES

MATERIAL CONTACTS		
Please contact the following representatives for special pricing.		
MANUFACTURER	TYPE OF FINISH	NAME, EMAIL, PHONE #
Armstrong Ceilings	Acoustical Ceiling Tile	Hedda Metzler 717.209.2793 hmetzler@armstrong.com HPG#6924
Bennu Enterprises	Signage	Tony Hatchell 615.226.4577 tony@bennuigns.com
Carnegie Fabrics	Acoustical Panel Fabric	Tim Butler 615.479.4950 butler@mainsolutionsllc.com
Daltile	Ceramic Tile	Abby Finnegan 615.519.9872 abby.finnegan@daltile.com
Durasein	Solid Surface	Pam Dervarics 610.360.5825 pam.dervarics@durasein.com
Emser Tile	Porcelain Tile	Randy Crowder randycrowder@emser.com
Fry Reglet	Millwork	Nick Green 770.468.2599 nickgreen@fryreglet.com
Griffom	Solid Surface Transition	www.griffom.com
Ketchum Walton CO.	Acoustic Panel - Fabriktrak	Key Reinhardt 312.550.2997 kreinhardt@ketchumandwalton.com
Logistic Solutions	Floor Purchasing	Logistics Solutions LLC Customersvc@logisticsolutions.net 615.750.2014
Mannington	Flooring/Base	Terri Bailey 615.427.8980 hca@mannington.com HPG#5488
MDC Wall Covering	Vinyl Wall Covering	Monica Fox 800.621.4006 mfo@mdcwall.com
Schluter Systems	Metal Trim	Jack Leblanc 225.483.2758 Jack.Leblanc@schluter.com
Shaw	Carpet	Ashley Hart 615.878.2293 ashley.hart@shawcontract.com HPG#500169
Sherwin Williams	Interior Paint	Andrew Filppin andrew.filppin@sherwin.com HPG#5893
Uttermost	Decorative Mirror	www.uttermost.com
Wilsonart	Plastic Laminate	Chris Fleming 615.292.2188 fleminc2@wilsonart.com
3form	Poly Resin	Jenna Harris 615.708.3126 jenna.harris@3-form.com

CEILINGS				
CODE	ITEM	TYPE/ LOCATION	MANUFACT.	DESCRIPTION
ACT1	Acoustical Ceiling Tile - General	General, Back of House, Staff Areas	Armstrong	Fine Fissured 1754 Medium Texture 24"x24" Square Lay-In with 15/16" Prelude XL Grid, Factory Painted White NRC: 0.75, CAC: 35
ACT2	Acoustical Ceiling Tile - Upgraded	Upgraded Public or Patient Areas	Armstrong	Ultima Healthzone High NRC 1445 Fine Texture 24"x24" Square Lay-In with 15/16" Prelude XL Grid, Factory Painted White NRC: 0.80, CAC: 35
EXP	Exposed Ceiling	See Finish Plans		
GYP	Gypsum Board Ceiling	See Finish Plans		See WALLS section for ceiling paints.

WALLS				
CODE	ITEM	LOCATION	MANUFACT.	DESCRIPTION
CWT1	Ceramic Wall Tile	Walls- General	Daltile	Pattern: Vivify Color: Spectra Blue VT03 Size: Mosaic: 14-11/16" x 12-13/16", 1/8" Thickness Grout: Latcrete, Spectralock Pro Premium Grout Color: Light Pewter Grout Joint: 1/8"
EP1	Epoxy Paint	Walls- General	Sherwin Williams	Color: Drift of Mist SW9166 Formula/Finish: Low Gloss Water-Based Epoxy
EP2	VOID			
EP3	Epoxy Paint	GYP Ceilings	Sherwin Williams	Color: SW7007 Ceiling Bright White Formula/Finish: Low Gloss Water-Based Epoxy
P1	Wall Paint	Walls- General	Sherwin Williams	Color: Drift of Mist SW9166 Formula/Finish: Latex Eggshell
P2	Wall Paint	Walls- Accent	Sherwin Williams	Color: Rain SW6219 Formula/Finish: Latex Eggshell
P3	Wall Paint	Walls- Accent	Sherwin Williams	Color: Delft SW9134 Formula/Finish: Latex Eggshell
P4	Soffit Paint	GYP Soffits- Accent	Sherwin Williams	Color: Riverway SW6222 Formula/Finish: Latex Eggshell
P5	Ceiling Paint	GYP Ceilings	Sherwin Williams	Color: Ceiling Bright White SW7007 Formula/Finish: Latex Eggshell
P6	Metal Paint	Door Frames/ Inter. Metal Doors, Metal Door Lite, Laminate Door Lite	Sherwin Williams	Color: Thunder Gray SW7645 Formula/Finish: Semi Gloss Alkyd Enamel Note: For INTERIOR doors ONLY. See architectural drawings and specifications for all exterior finishes.
P7	Detail Paint	Storage/ Supply	Sherwin Williams	Color: SW6868 Real Red Formula/Finish: Latex Eggshell
PWT1	Porcelain Wall Tile	Walls- Field	Emser Tile	Pattern: Milestone Color: Moon Size: 12"x24" Grout: Latcrete, Spectralock Pro Premium Grout Color: Light Pewter 90 Grout Joint: 1/8"
WC1	Porcelain Wall Tile	Board Rooms	MDC	Pattern: Rafter MRE1744 Color: Blue Cargo Type II



METAL TRIM				
CODE	ITEM	LOCATION	MANUFACT.	DESCRIPTION
SCH1	Tile Cove Piece	Walls- Tile	Schluter Systems	Dilex-AHK Finish: Brushed Nickel Anodized Aluminum
SCH2	Tile Edge Trim	Walls- Tile	Schluter Systems	Jolly Aluminum Finish: Brushed Nickel Anodized Aluminum

BASE				
CODE	ITEM	LOCATION	MANUFACT.	DESCRIPTION
RB1	Rubber Base	Walls- General	Mannington	Style: Optimum Edge TP rubber Height: 4" H, 1/8" thick Color: Mocha Adhesive: Manufacturer Recommended Notes: Cove and continuous rolls. Miter inside corners. Do NOT use pre-molded outside corners.
RB2	Rubber Base	Walls- upgraded	Mannington	Style: Edge Effects, Sophisticate EESOP rubber wall base Height: 4.25" H Color: Mocha Adhesive: Manufacturer Recommended Notes: Miter cut all joints. Utilize matching caulk when installed on top of hard surface.

FLOORING				
CODE/ KEY	ITEM	LOCATION	MANUFACT.	DESCRIPTION
C1	Carpet	Offices	Shaw	Style: Living Systems, Source Tile ST315 Color: Radiant 05515 Format: Plank Size: 9' x 36" x 0.209 in. thickness Backing: Synthetic/Ecoworx Adhesive: Manufacturer Recommended Installation: Ashlar
C2	Carpet	Conference Room	Shaw	Style: Living Systems, Observe Tile ST306 Color: Radiant 05515 Format: Plank Size: 9' x 36" x 0.272 in. thickness Backing: Synthetic/Ecoworx Adhesive: Manufacturer Recommended Installation: Ashlar
LVT1	Luxury Vinyl Tile	Floors	Mannington	Style: Amlico Wood Collection Color: Manor Oak AROW7970- Square Edge Size: 9' x 48" x 2.5mm thickness Adhesive: Manufacturer Recommended
PTF1	Porcelain Wall Tile	Walls- Field	Emser Tile	Pattern: Milestone Color: Gray Size: 12" x 24" x 8mm Grout: Latcrete, Spectralock Pro Premium Grout Color: Dusty Grey 60 Grout Joint: 1/8" Installation: 1/3rd Offset
SC	Sealed Concrete	Floors	Sherwin Williams	Style: Armorseal Treadplex Color: Haze Gray Notes: See architectural specifications for information

FLOORING TRANSITION STRIPS				
TS1	Transition Strip	LVT to SVF	Griffom	Ramping TRT#, 1/8" Beveled Corian Color: Neutral Concrete See Flooring for Detail Note About Ramp Size.
TS2	Transition Strip	1/8" Resilient to Carpet	Schluter Systems	Vinpro- S, Aluminum Finish: Brushed Nickel Anodized Aluminum Backfill with thin set to prevent denting.
TS3	Transition Strip	1/8" Resilient to Concrete	Schluter Systems	Vinpro- U, Aluminum Finish: Brushed Nickel Anodized Aluminum Backfill with thin set to prevent denting.
TS4	Existing	New Floor to Existing Flooring	Schluter Systems	Contractor to submit ADA compliant transition from that is appropriate for new/existing flooring heights. Stainless Steel ONLY

CASEWORK				
CODE	ITEM	LOCATION	MANUFACT.	DESCRIPTION
DCP1	Decorative Polyresin Panel	Reception Desk	3form	Varia Ecoresin Color: Specialty Wave Sage + Avalanche (D01) LID # 1059997 Size: 3/8" thick Front: Wave Emboss Back: Sandstone
FR1	Millwork Reveal	Reception Desk	Fry Reglet	Item: Millwork 1/4" Post Finish: Clear Anodized Aluminum
MC1	Millwork Corner	Misc. Casework Corners	Fry Reglet	Item: Millwork Corner Key Angle: 3/16" wing Finish: Clear Anodized Aluminum
PL1	Plastic Laminate	Vertical Surfaces/ Interior Doors	Wilsonart	Pattern: Pinnacle Walnut 7992 Finish: 38 Fine Velvet Texture
SS1	Solid Surface	Transaction/ Countertops	Durasein	Color: Sun Kissed DM5044 Thickness: 1/2" Edge Profile: eased w/ 1.5" Apron
SS2	Solid Surface	Window Stools/ Integral Sinks	Durasein	Color: Natural White DM1002
	Casework Interior Melamine	Casework Interior	See Architectural Specs	Color: White See Architectural Sheets for further details.

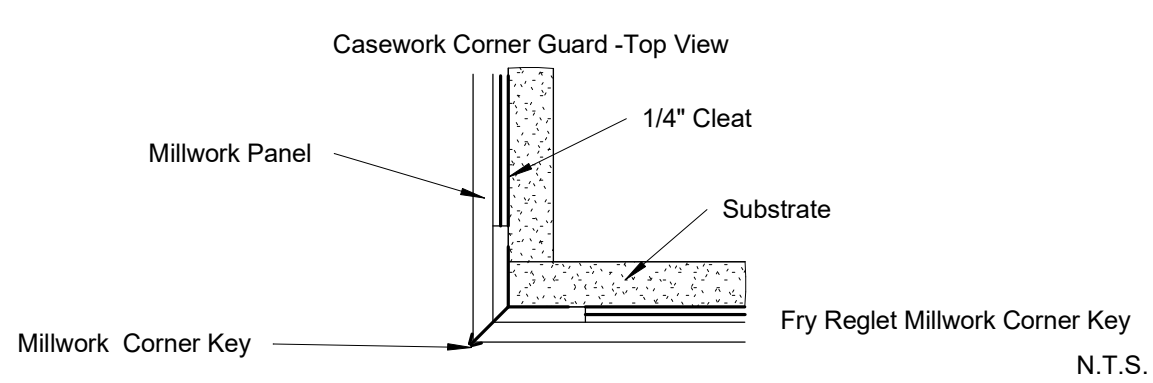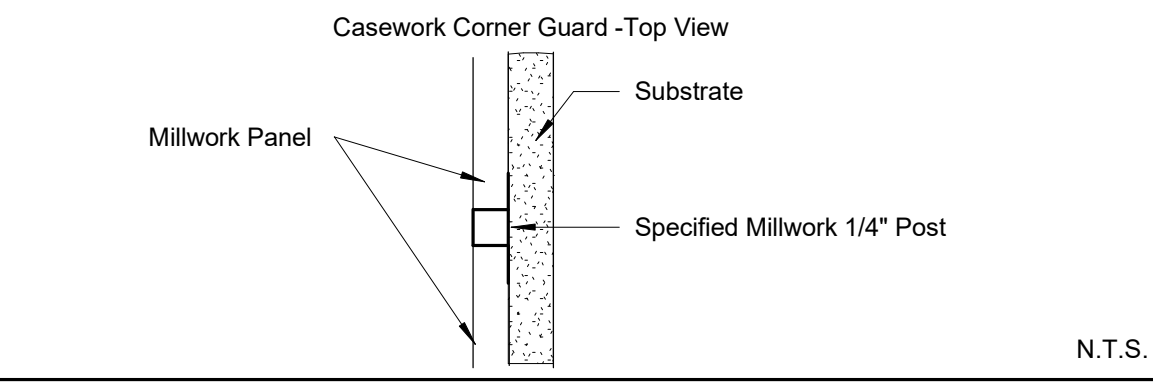MILLWORK CORNER DETAIL	
	
MILLWORK EDGE DETAIL	
	

MISCELLANEOUS				
Contractor Provided/Installed Items				
CODE	ITEM	LOCATION	MANUFACT.	DESCRIPTION
AP1	Acoustical Panel - Tackable	Reception Casework	Ketchum: Walton Co.	Fabritrak Stretched Fabric Wall System profile: 1", S Square NRC Rating of: 0.75 Fire Rating : Class A Notes: Utilize Tackable Core, Micore Fabric Manufacturer: Carnegie Xorel Pattern: Meteor Color: 2000 Notes: See Acoustical Panel Section for more information
D1	Doors	New Interior Arch. Doors	See Arch. Specs	Finish: PL1
MR1	Decor Mirror	Upgraded Toilets	Uttermost	Frame: Aramis 09605 Size: 24"x36"
#	Signage	See sign plans	Bennu Enterprises	Style: To match Facility Standards Notes: Allow a 5% allowance in bid
DWP1	Signage Decorative Wall Panel	Walls- Reception	3form	Product: Profile Panel Modular Surface Pattern/Color: TBD Size: 159" x 6'-0"

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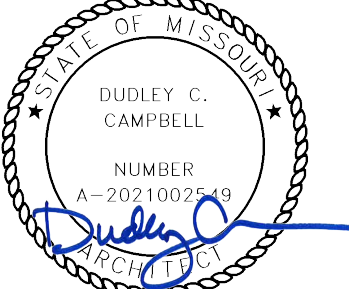
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ADMINISTRATION
RELOCATION

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MEDICAL CENTER
2000 SE BLUE PKWY
LEE'S SUMMIT, MO 64063

AUTHORITY HAVING JURISDICTION:
CITY OF LEE'S SUMMIT BUILDING DEPT.
MISSOURI DHSS

FACILITY NUMBER:
0972400009

AGENCY APPROVALS:

REVISIONS		
REV #	DESCRIPTION	DATE
A	CITY - 2ND REVIEW	2025/05/29

DATE:	2025.04.18
SCALE:	1/8" = 1'-0"
DRAWN:	PC
REVIEWED:	PF
JOB NUMBER:	6406.24


GENERAL FINISH SPECIFICATIONS AND NOTES

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FINISH SELECTIONS AND GENERAL NOTES

LEGEND



ETR= Existing finishes are to remain
PM= Patch and Match existing finishes
NIS= Not in Scope
UON= Unless Otherwise Noted

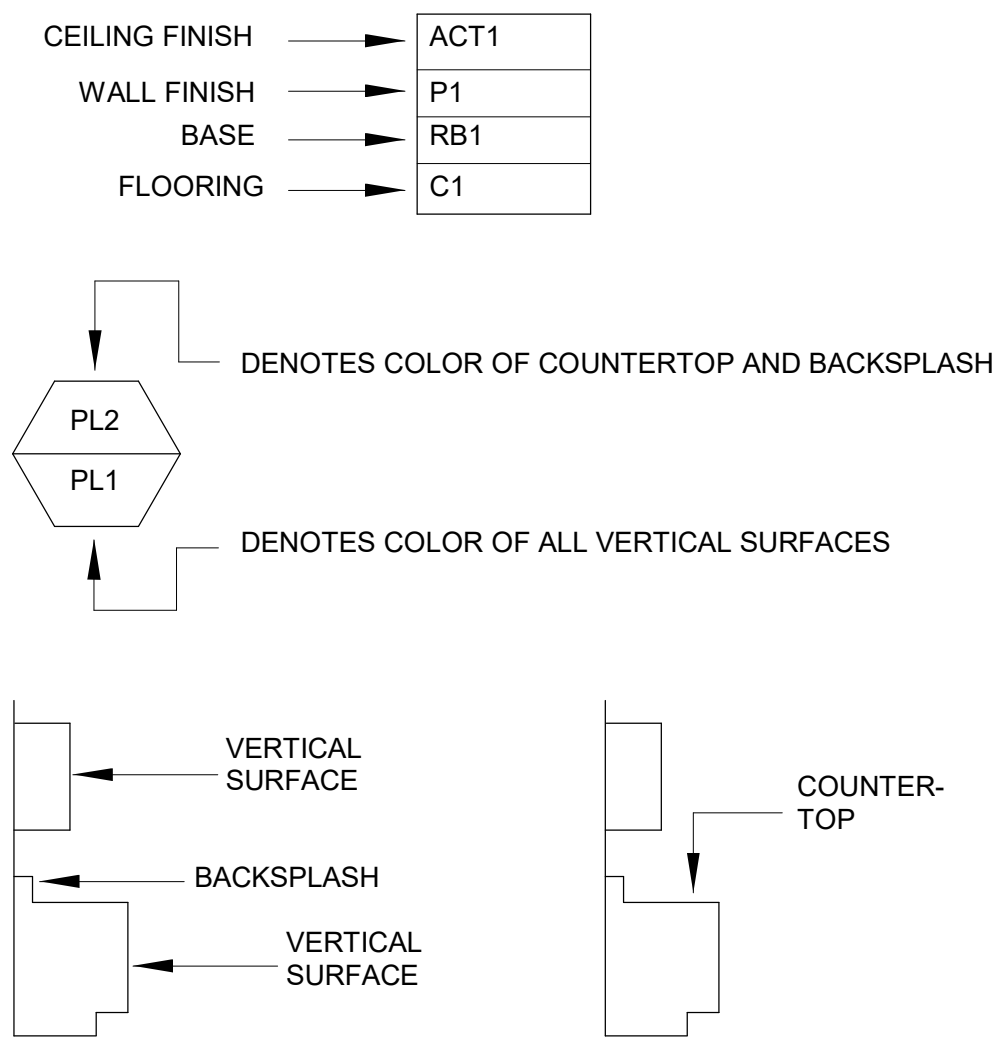GENERAL NOTES

- All work shall be guaranteed against defects for one year.
- All contractors shall visit jobsite and become familiar with existing conditions before submitting bids and/or proceeding with any work. Submission of bid indicates that the contractor has verified existing conditions.
- The drawings attached have been developed from record drawings which may not reflect actual field conditions. In no case shall dimensions be scaled from drawings. The contractor shall verify all conditions architect/designer shall be notified of any subsequent work. Review drawings for clarification prior to proceeding with work.
- Thoroughly clean all light lens and ceiling air diffusers after construction work is complete.
- All parties responsible for delivering finishes to the site should check quantities and delivery dates as soon as bid is awarded to avoid any reselection of material.
- The general contractor shall carefully study and compare the documents and finish plans and shall at once report to the architect any error, inconsistency or omission he may discover.
- Furniture is to be owner furnished, owner installed unless otherwise noted on the furniture plan.
- For all products installed, note industry standards and manufacturer specifications for installation.
- All interior wall, ceiling and trim finishes meet a Class A flamespread rating of 25 or less, and shall have a smoke development of 250 or less.
- All interior flooring meets Class I and II flamespread ratings.
- All flooring at means of egress and wet areas shall meet minimum slip resistance requirements of relevant ANSI and ASTM test methods, in accordance with building codes, ADA guidelines, and local and state AHJs.
- Final Clean Up: The contractor shall coordinate with the project schedule to make certain that all housekeeping cleanup items are done prior to move-in. This would include wiping down, cleaning glass, waxing, waxing, vacuuming, or any other services which would be performed under the contractor's maintenance cleaning programs. Upon completion of work, all waste material, rubbish, tools, construction equipment, machinery and other surplus materials shall be removed from the site.
- NO SUBSTITUTIONS OF SPECIFIED FINISHES WILL BE ALLOWED WITHOUT PRIOR APPROVAL FROM THE INTERIOR DESIGNER.

A: GENERAL FINISHES

- Refer to attached drawings for further clarification of work to be performed and/or for floorplan layout of facility.
- Contractor is to provide "surplus stock" as noted below. Surplus stock shall be provided on each different product manufacturer, style, color and finish specified. Refer to Written Specifications Section in the Project Manual (if applicable) for additional information. Final payment shall not be made until stock is delivered.

Ceiling Tile:	Provide 1 (one) full carton for each product type used.
Interior Paint:	Provide 1 (one) gallon per type/color/finish. Each container MUST have the formula clearly indicated.
Porcelain Tile:	Provide 3% overage per type/color/finish/size.
Rubber Base:	Provide 8 linear feet per type/color for every 500 linear feet installed, or a minimum of 8 linear feet.
Carpet (Modular)	Provide 5% overage per type/color, or a minimum of 1 box of each used.
Luxury Vinyl Tile:	Provide 1 (one) box per type/color for every 50 boxes installed, or a minimum of 1 (one) box.
- Submittal requirements: Contractor is to provide submittals to the Interior Designer for approval prior to fabricating or purchasing materials. All submittals are to be clearly marked with manufacturer, style color and Finish Material Legend code.
3.1 Electronic submittals are acceptable for all product data, shop drawings and samples. **Paint draw downs/Wallcovering samples require physical samples, no exceptions.** For finish samples, a photo of front of sample, as well as manufacturer label, is required.
- Interior Architectural Door material is to be: Plastic Laminate.
4.1 Door finish is to be: D1.
- If casework does not have a finish call-out symbol, the selection will be made in the shop drawings.
- Wood grain laminates are to be installed so that the grain runs in a vertical direction, unless otherwise noted on architectural casework drawings.
- The window stool material is to be: Solid Surface
7.1 The window stool finish is to be: SS2
- To avoid variances and dye lot issues on phased projects, the full amount of project finish materials need to be purchased at one time.

B: CEILING

- When installing lay-in ceilings, lay out grid in room so that cut tiles at perimeter are no less than 9" wide.
- Gypsum (GYP) ceilings are to be painted with the same paint type as adjacent wall. If walls are epoxy, ceilings should be epoxy as well. If walls are latex eggshell, ceilings should be as well.
"ALL CEILINGS SHOULD BE COLOR "CEILING BRIGHT WHITE" UNLESS A SOFFIT ACCENT COLOR IS INDICATED"
- Edges of cut ceiling tiles are to be painted with ceiling manufacturer's matching touch up paint.
- For renovation work where not all ceiling tiles are being replaced: Replace all damaged ceiling tiles as necessary. Utilize existing ceiling tiles from one enclosed room for replacement tiles. Provide all new in above-mentioned enclosed room. This ensures ceiling tiles look uniform, avoiding a mismatched look when damaged tiles are sporadically replaced with new.

C: PAINT


- Prior to the application of paint, the contractor is to repair new or existing surfaces by patching, smoothing and sanding as needed to achieve a surface acceptable for the application of new finish. Prepare door frames or metal surfaces by sanding by chips/burns, filling dents and caulking cracks at corners as required.
- Miscellaneous metal (return and air supply grilles, expansion joints, etc) located on wall surface is to be painted to match the adjacent wall color.
- The contractor is to submit one paint sample of each paint color in the appropriate finish to the Interior designer for approval prior to purchasing paint. Samples are to be painted on 8.5"x11" card stock. Each sample should have the Finish Material Legend code and color formula clearly indicated, as well as the store location where the paint is to be purchased.
- When specified in the Finish Plan, provide paint finishes as noted for the surfaces listed below. Refer to written Architectural Paint Specifications section for further information regarding products, primers, etc. If surfaces exist on the job that are not listed, contact the Interior Designer.
- Caulk all plumbing fixtures, millwork and trim to adjacent surfaces. Color of caulk to match adjacent finish.
- Typical Paint Finishes and Locations: These are "typicals" only. For all locations, refer to finish plans.

GYPSUM BOARD WALLS AND SOFFITS	
Waterbased Epoxy, Low Gloss	Toilets, Water Heater
Latex Eggshell	All Other Areas

GYPSUM BOARD CEILINGS	
Waterbased Epoxy, Low Gloss	Showers, Soiled Areas, Sterile
Latex Eggshell	All Other Areas

INTERIOR METAL SURFACES	
Semigloss Alkyd Enamel	Door Frames, Metal Doors, View Window Sills/Frames, Shelving, Previously painted Wood Trim, Previously painted Metal.


- All prefinished store front windows or factory prefinished frames should not be painted unless otherwise directed architect or Interior Designer.
- Paint all horizontal surfaces on soffits over upper casework to match the vertical wall unless otherwise noted. Soffits indicated to receive accent paint are to be painted on all three sides. **THE BOTTOM OF THE SOFFIT IS TO BE PAINTED THE SAME ACCENT COLOR AS THE SOFFIT SIDES, NOT CEILING WHITE.**
- In the case where a door frame receives a paint color on one side and another paint color on the opposite side of the door, the transition shall occur on the inside corner of the jamb stop.

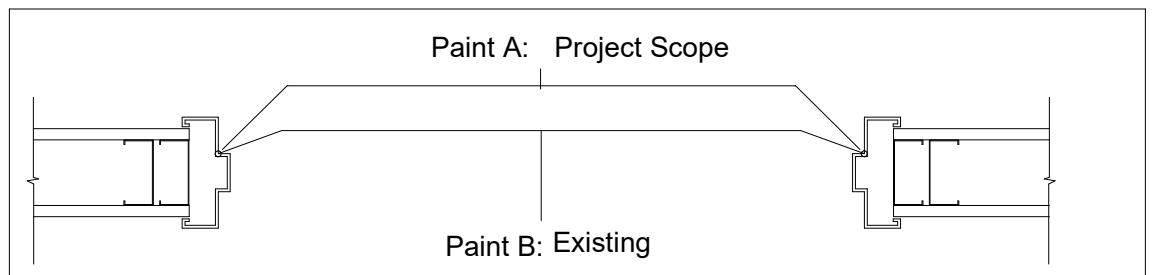

- If rubber base is not used, finish drywall to the floor where sealed concrete is the flooring. Contractor is to install a bead of caulk at drywall/concrete transition.
- All Storage/Supply rooms are to receive a 1" painted horizontal red line 18" from bottom of the sprinkler head around the room, paint color: P7
- In IT, COMM or DATA rooms, do not paint the fire retardant plywood or cover/obstruct the fire rating label in any way.

D: ACOUSTICAL PANELS

- Acoustical Panels are to be furnished and installed by the general contractor. All dimensions must be field-verified before production. In locations with outlet in panel locations refer to diagram below.

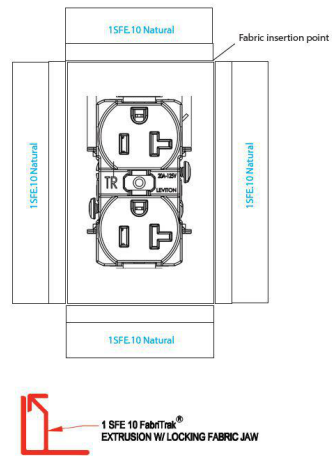


For panel specification and fabric selection and fabric selection(s), see MISCELLANEOUS sections. For locations, see finish plans.



- Casework - Panels to be applied between upper transaction top and work surface and run the full length in between. Line up Edges evenly.

E: TILE

- See Finish Material Legend for grout formulas and colors.
- All transitions between wall tile and paint/wallcovering are to be made with SCH2 along with a bead of wall color matching caulk.
- If floor tile is larger than 2'x2," cut tile to slope to drain.
- Mirror is to be installed so the bottom of the reflective surface is at 40" AFF.

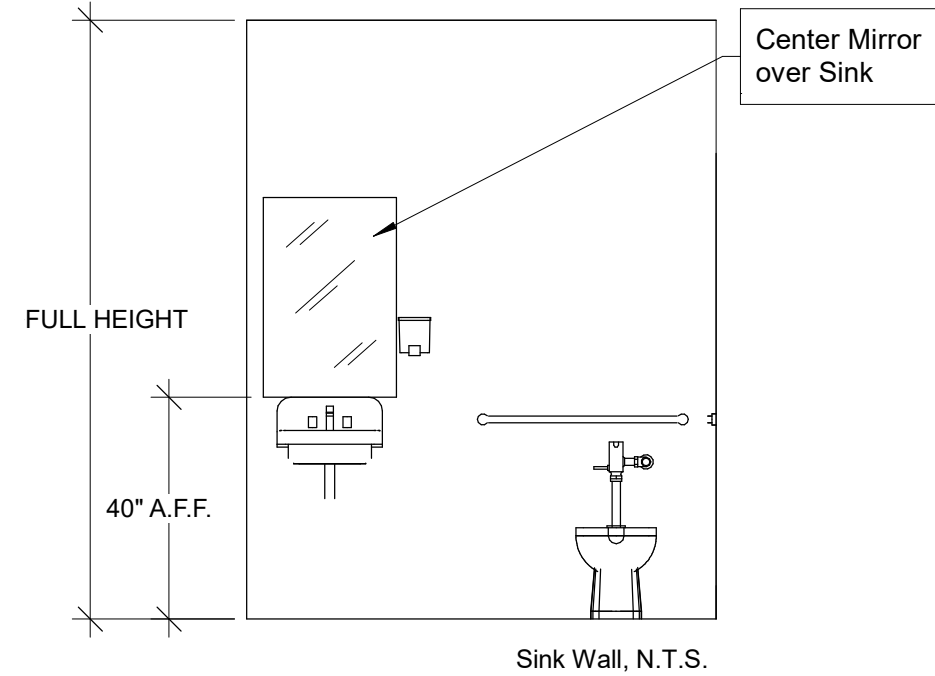


- Walls in Toilets are to receive the following tile pattern(s):
Install so that tile runs fully behind grab bars and dispensers.

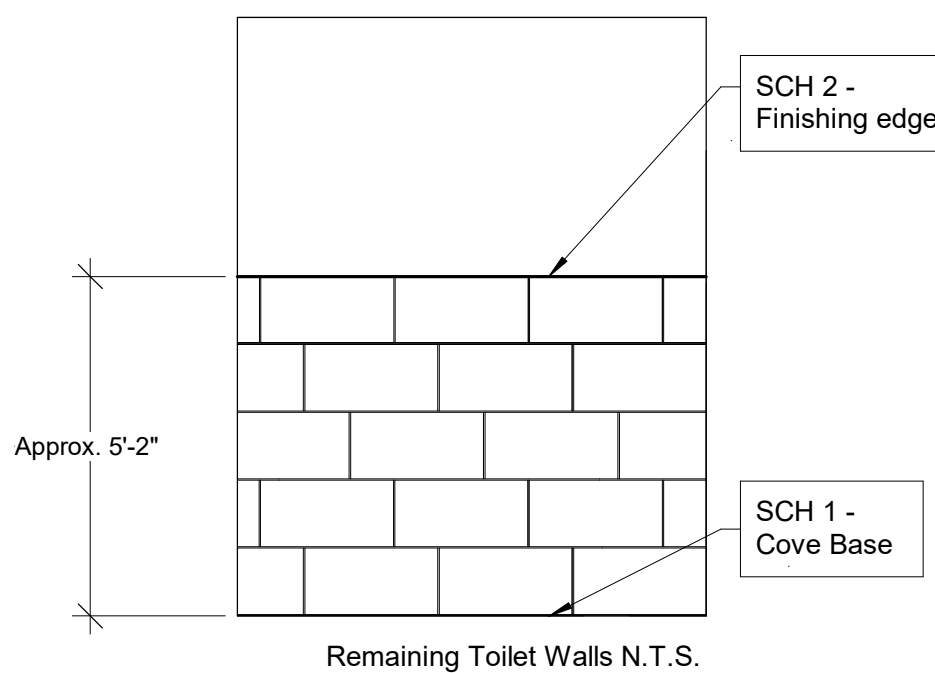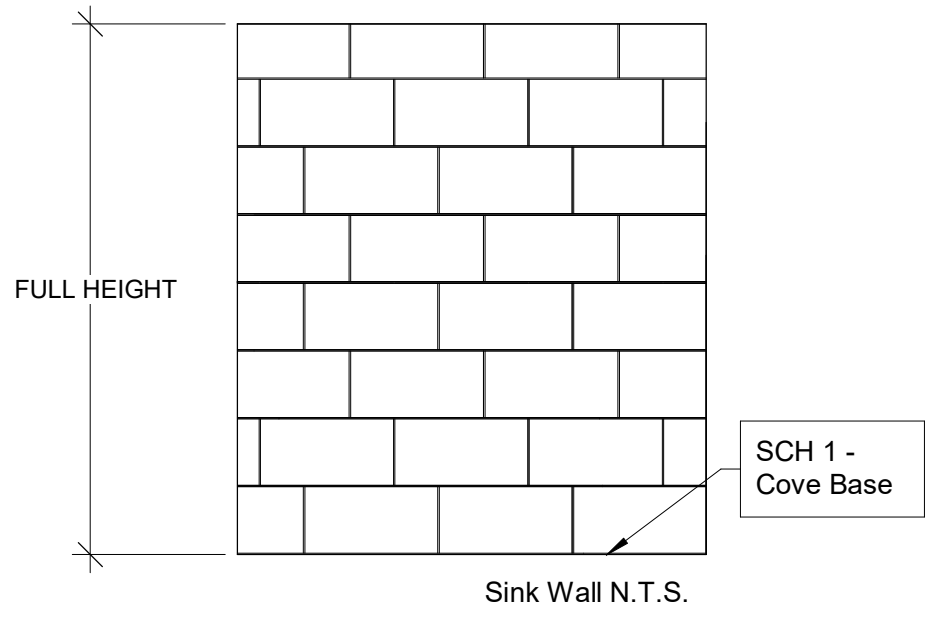

Wall Tile Key:

PWT1

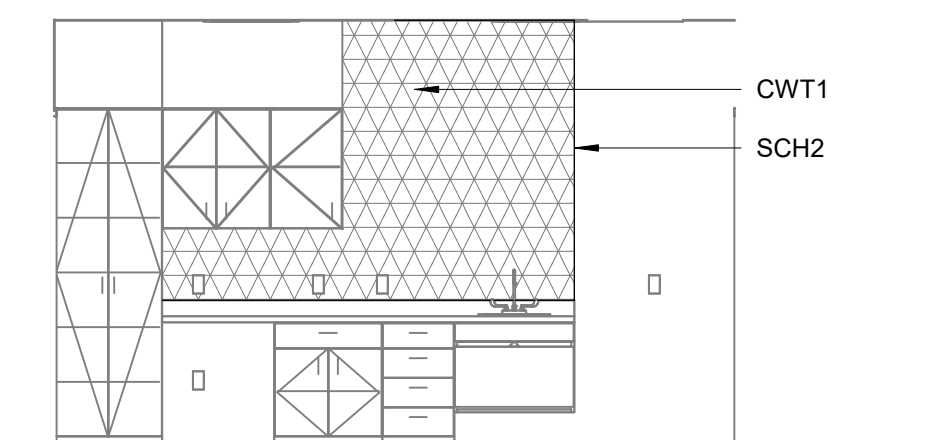

- BREAK/NOURISH
1/4" = 1'-0"

Wall Tile Key:

CWT1

F: SIGNAGE

Furnish interior signage to the following specifications - See MISCELLANEOUS section for style and color selections:

- See signage sheets for verbiage schedule and location plan.
- GC to review package with end user prior to submittal. Note on submittal whether or not this has been approved/reviewed with end user.
- GC to have a 5% allowance for unforeseen changes to signage during submittals.
- Proposed sign styles and colors are to be submitted by the vendor (to Interior Designer, Architect and Owner) for approval during the C/A submittal process. Contractor should allow adequate time for multiple mark-up/approval cycles before the order is placed.
- It is the sign vendor's responsibility to meet all local, state and federal codes.
- It is the sign vendor's responsibility to create/provide all required vector files.
- It is the sign vendor's responsibility to create/provide all fire evacuation map graphics and inserts.
- Signage Requirements:
A. ADA compliant with Braille where required.
B. Recommended contrast between background and verbiage is 70% minimum.
C. Room/Information signs:
a. Lettering height - minimum 5/8" - 2" maximum
b. Pictograms - 6" minimum height with Braille below.
c. Non glare finish.
D. Overhead signage:
Mounting Height - greater than 70" AFF to bottom of character.
Character Height - 70" - 120" = 2" - 3" -
Non glare finish.

G: FLOORING

- All traditional rubber base is to be 4" H, coved, and continuous rolls. Miter inside corners, wrap outside corners of jobsite. Do NOT use premolded corners.
- All sculptured rubber base is to be 4.25" H, straight sections. Miter inside and outside corners. Do NOT use premolded corners.
- All reducer strips and other thresholds are to be located at the centerline of door when in a closed position, unless otherwise noted.
- Utilize clear caulk to seal where flooring transition meets flooring, to eliminate gaps.
- Transition strips are indicated by a bold line on the floor pattern plans. It is the contractor's responsibility to identify locations and quantities of the material-to-material transition strips. If a strip is needed that is not listed in Floor Transition, contractor is to submit proposed product via submittal for approval. All transition are required to meet ADA guidelines.

Flooring Transition = TS#
- ADA compliant porcelain/ceramic/quarry to resilient floor details:

1/4" MAX VERTICAL

1 MAX RISE/RUN

RESILIENT FLOORING

PORCELAIN/CERAMIC TILE


PORCELAIN/CERAMIC TO HAVE SLIGHT RECESS, NO GREATER THAN 1/4".

N.T.S.
- All floor transitions are to be taped or covered during construction, to protect the material until final completion.
- Where new flooring or base is specified, the same flooring or base should extend into any closets, storage areas, etc. adjacent to that space unless otherwise noted.
- For renovations, existing flooring is to be removed by the contractor prior to applying the specified flooring product.
- Floor pattern shall extend under any open space under casework or kneespace, even when it appears to stop on plan.
- Manufacturer's recommended adhesive is to be based on application and concrete moisture %.
- For HCA projects, all flooring should be purchased and tracked through Logistic Solutions and Mannington. See material contacts section for contact people.


H: CASEWORK DESIGNS

Typical Casework Designs are to be as shown in elevations below. All Graining to run in the same direction, unless otherwise noted.

- Reception Desk:

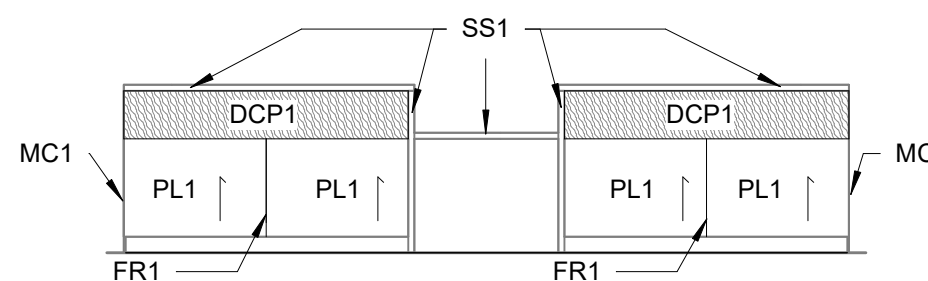

- RECEPTION
1/4" = 1'-0"

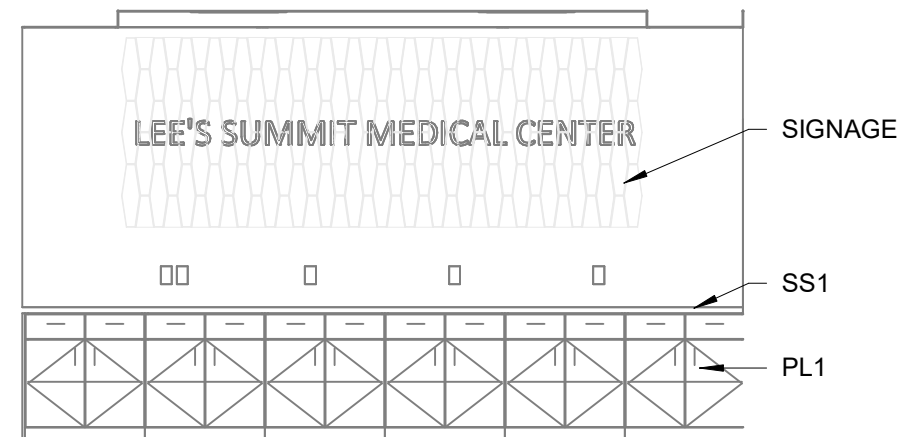

- RECEPTION ACCENT WALL
1/4" = 1'-0"



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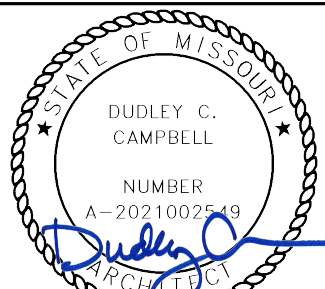
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ADMINISTRATION
RELOCATION

HCA - LEE'S SUMMIT
MEDICAL CENTER
2000 SE BLUE PKWY
LEE'S SUMMIT, MO 64063

AUTHORITY HAVING JURISDICTION:
CITY OF LEE'S SUMMIT BUILDING DEPT.
MISSOURI DHSS

FACILITY NUMBER:
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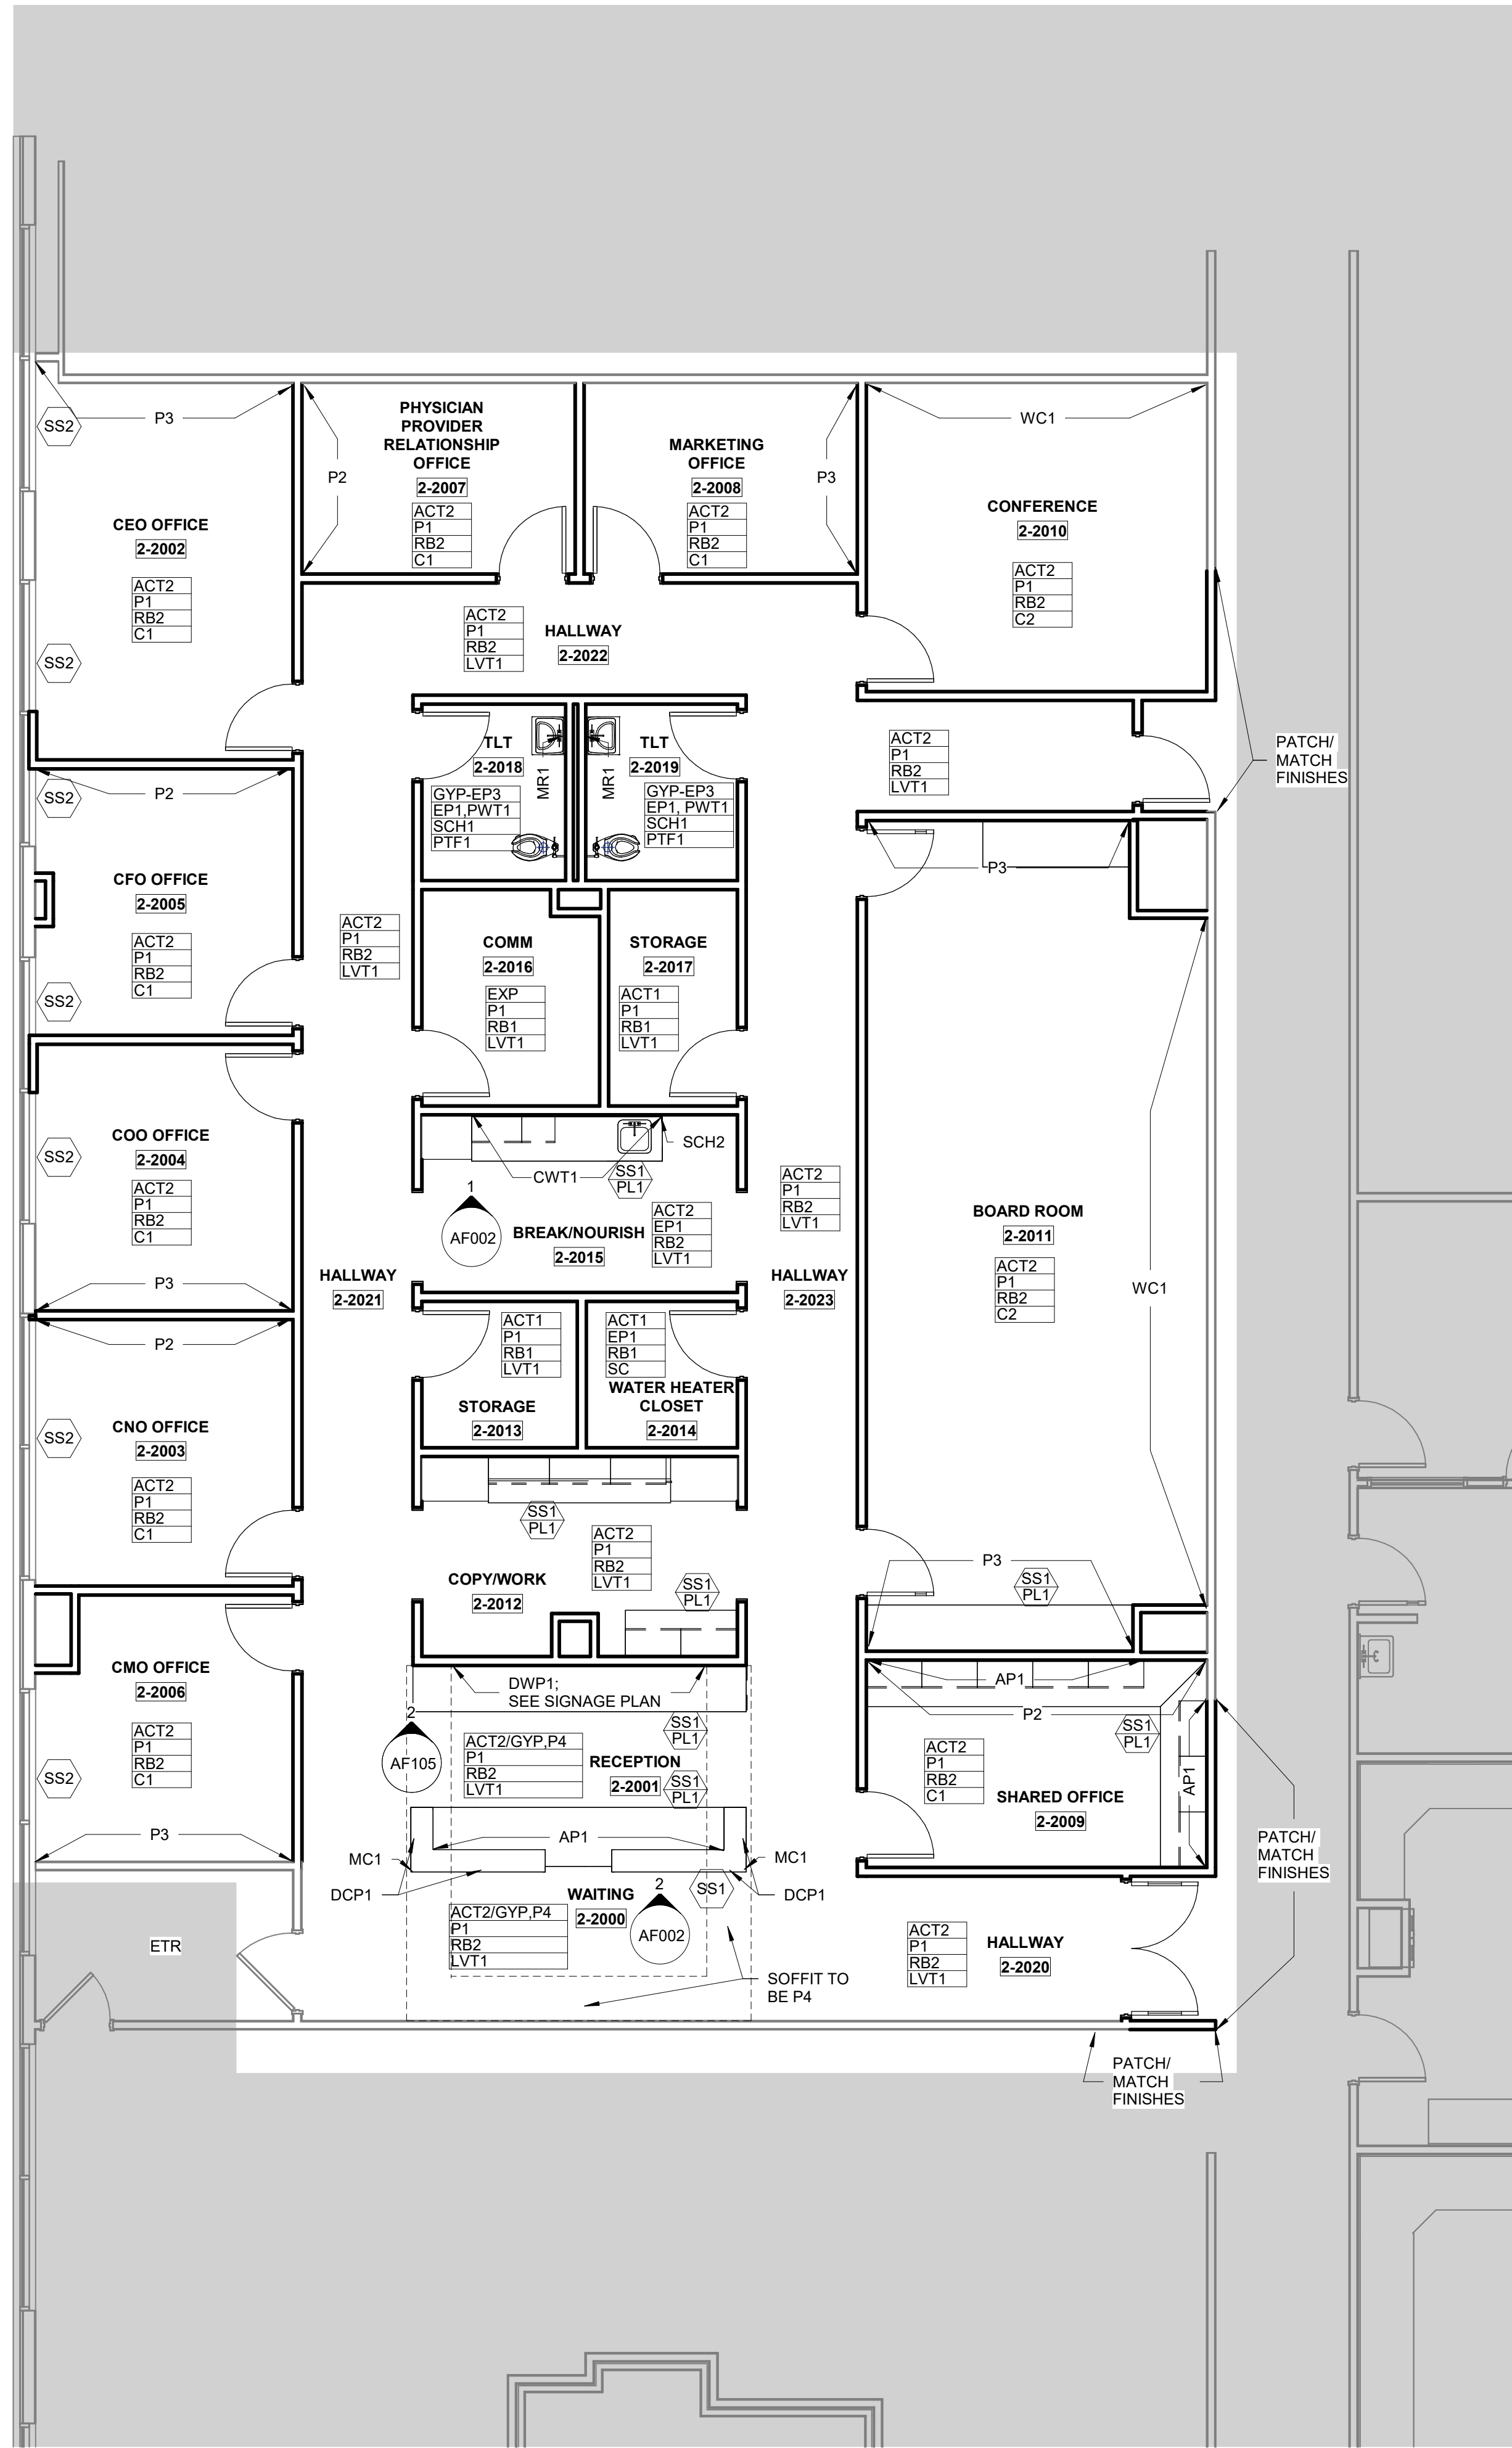
AGENCY APPROVALS:

REVISIONS		
REV #	DESCRIPTION	DATE
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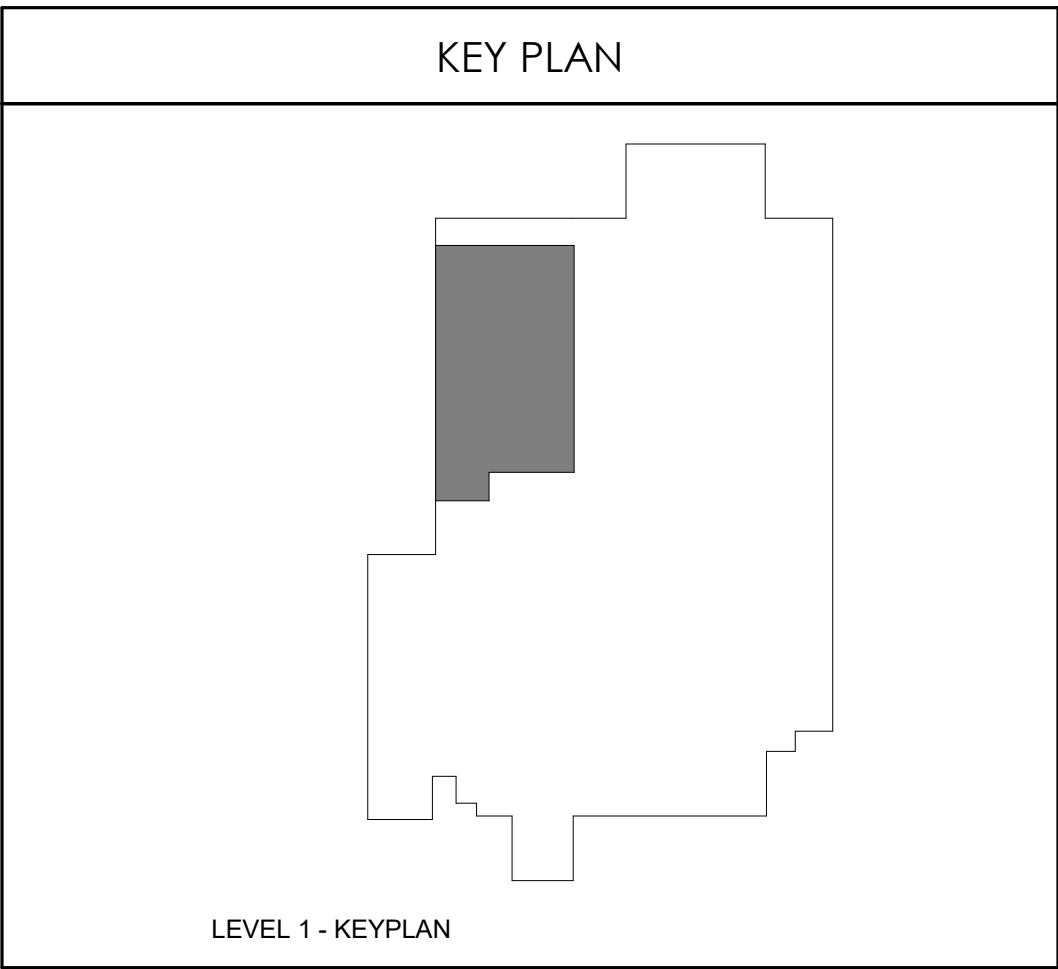
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SCALE: As indicated
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REVIEWED: PF
JOB NUMBER: 6406.24

GENERAL FINISH
SPECIFICATIONS AND NOTES

AF002




1 FINISH PLAN - LEVEL 1
3/16" = 1'-0"



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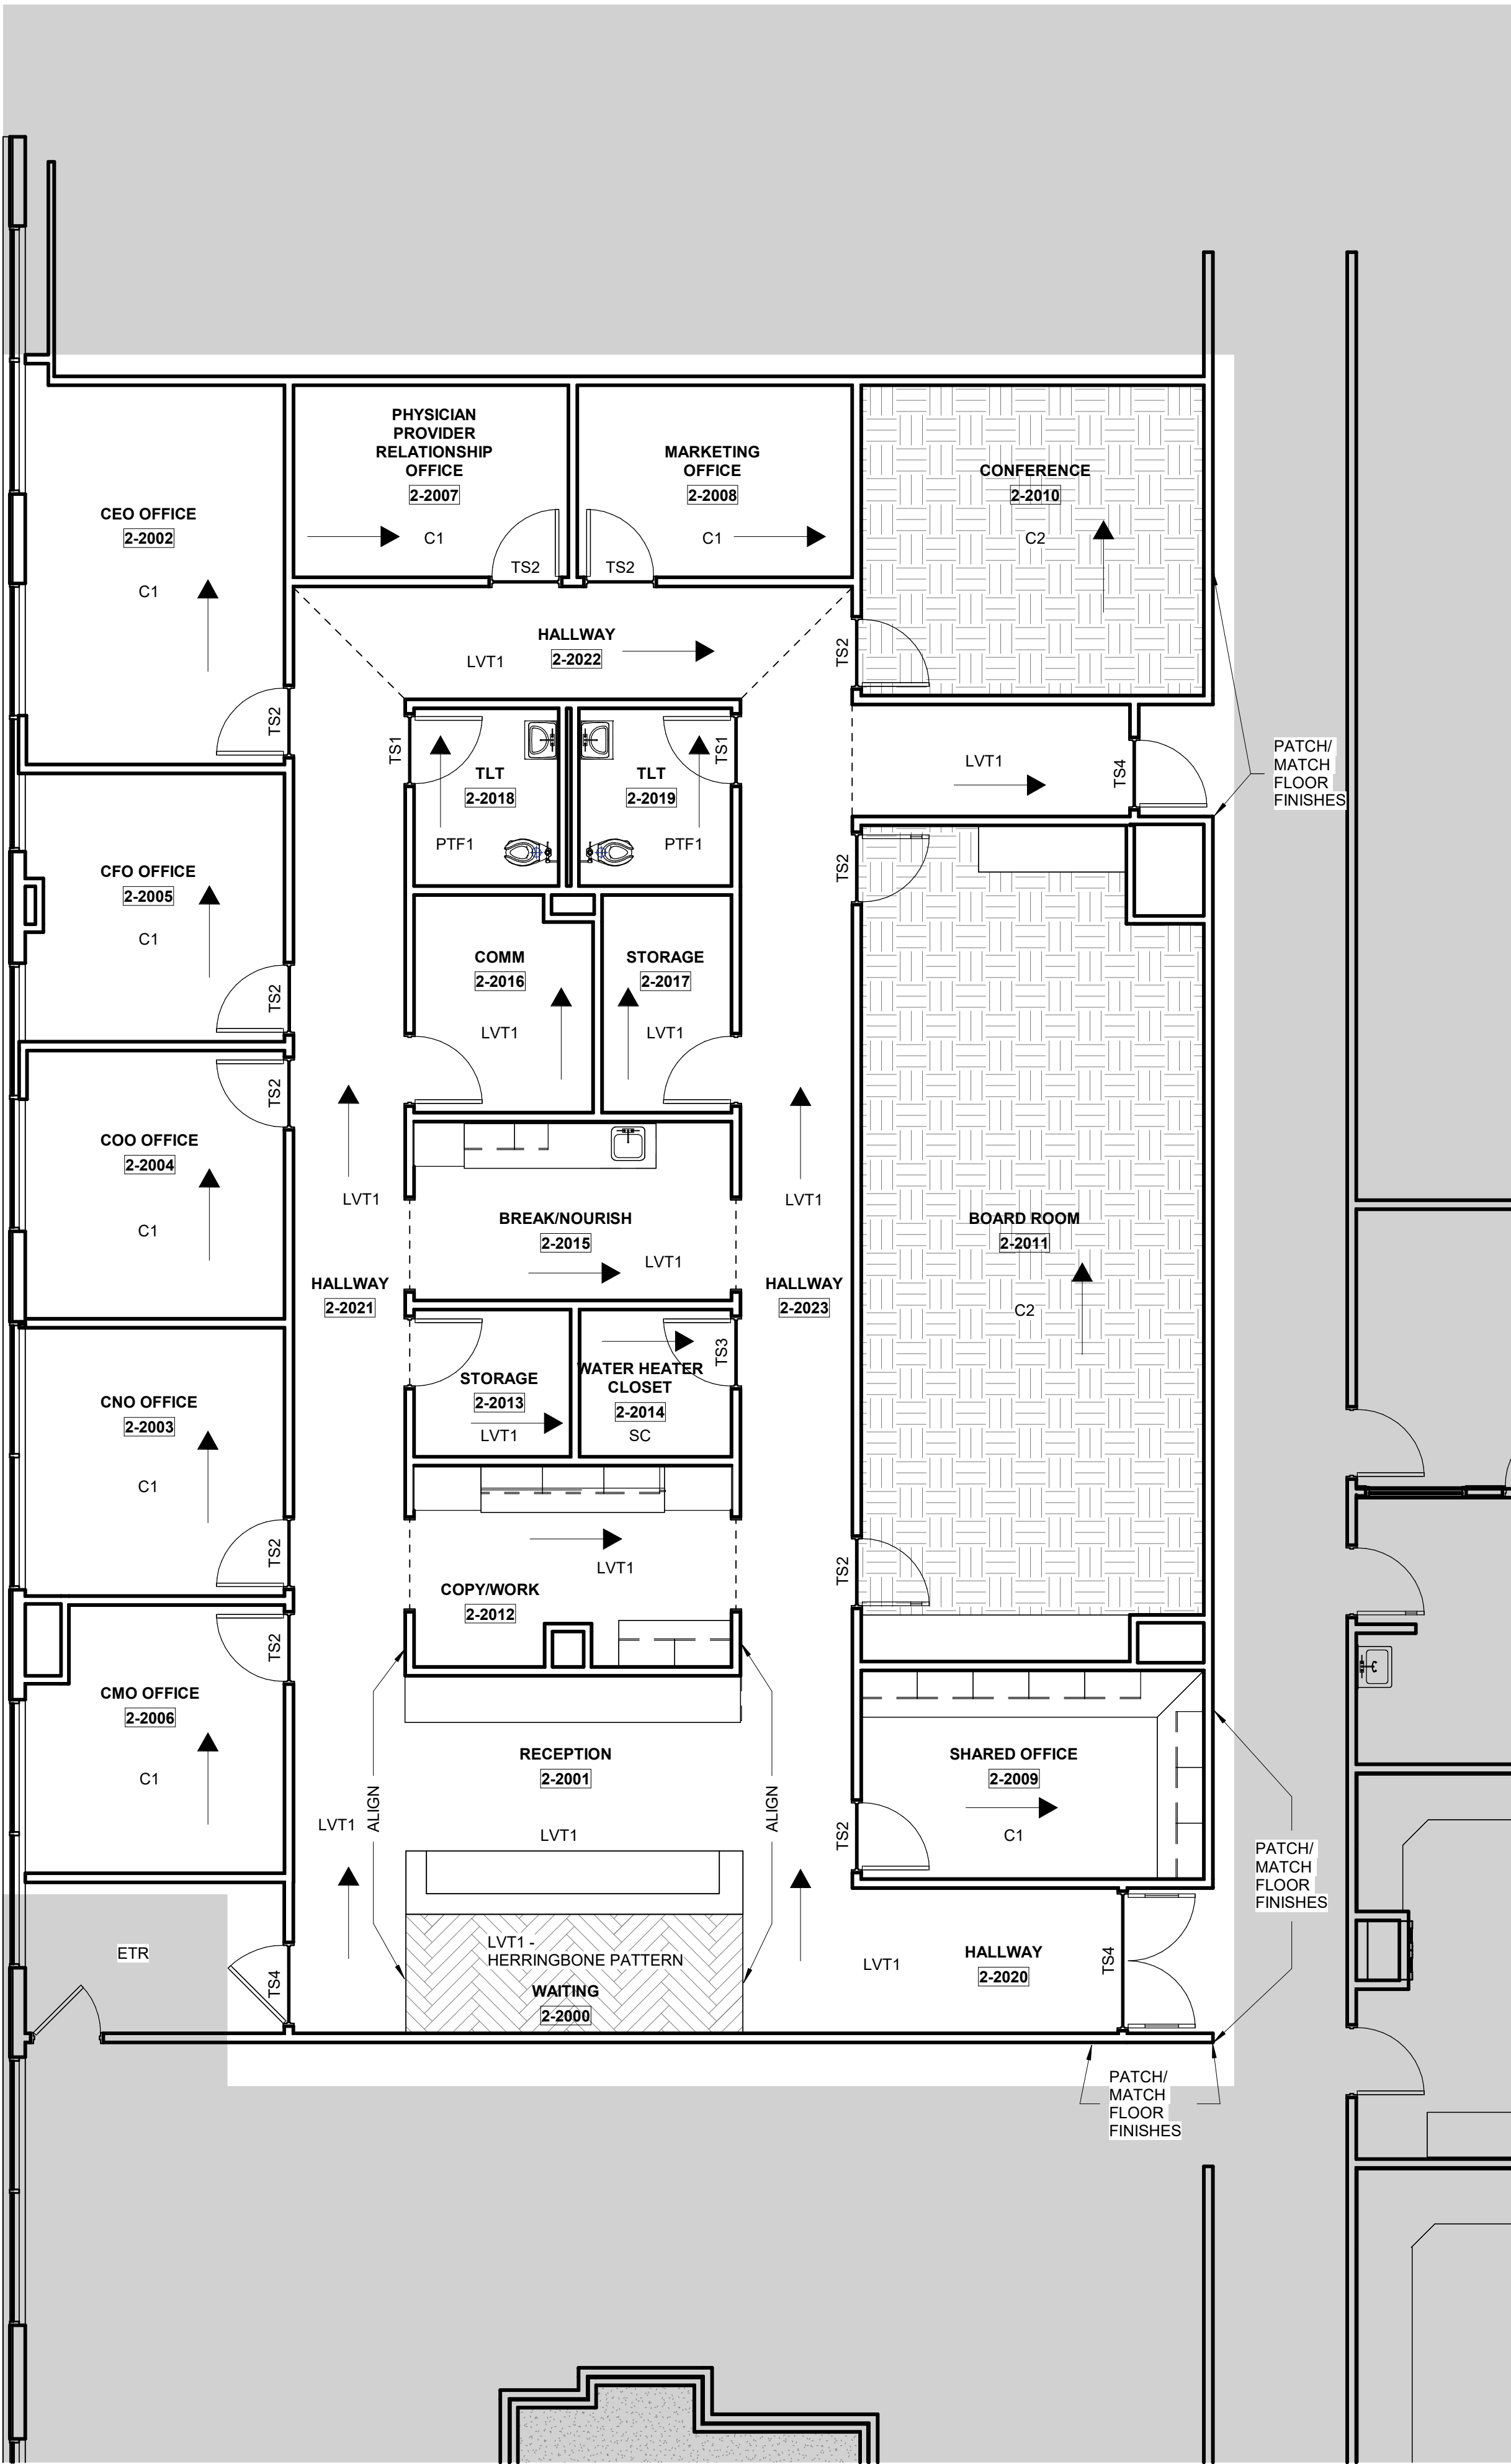
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JOB NUMBER: 6406.24

FINISH FLOOR PLAN - LEVEL
1

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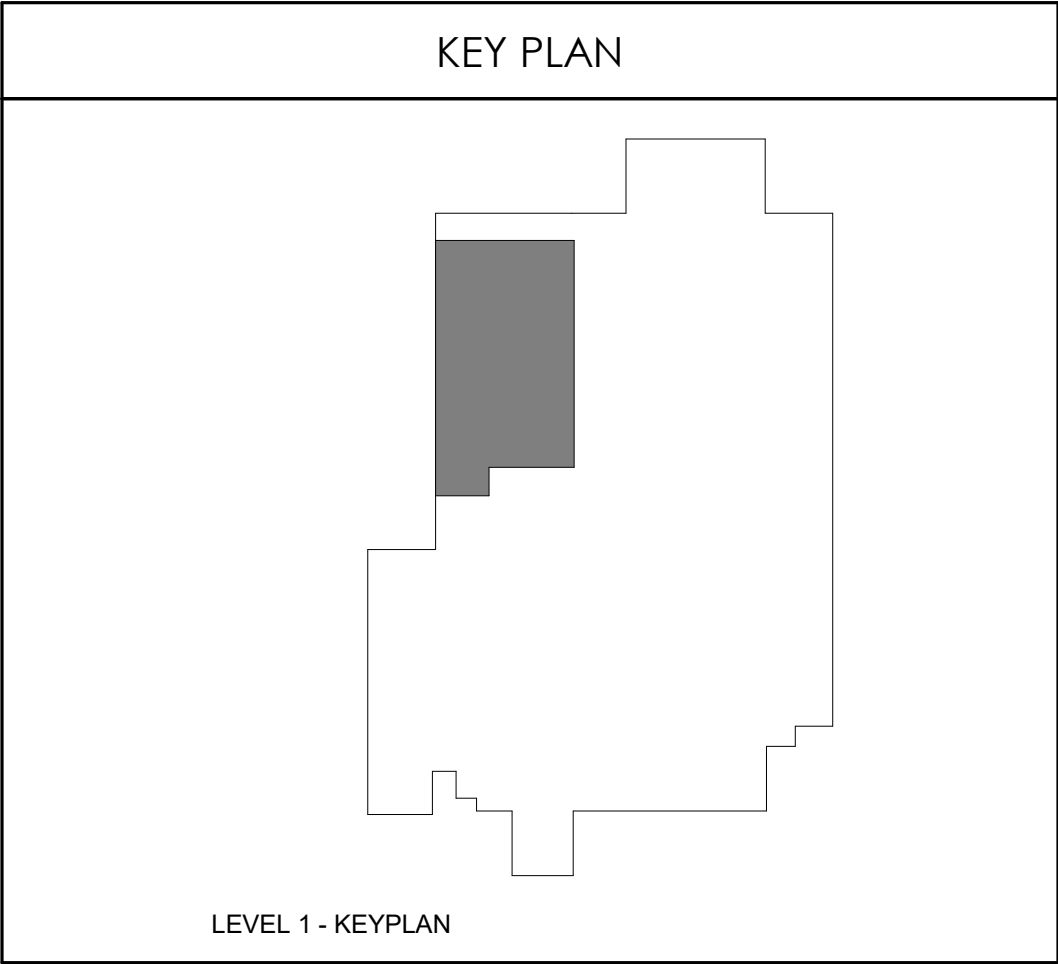


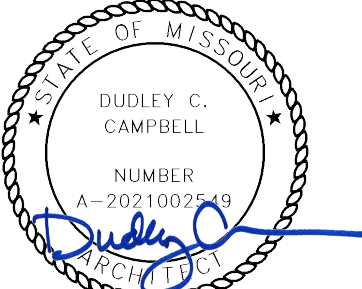1 FLOOR PATTERN PLAN - LEVEL 1
3/16" = 1'-0"

FLOORING				
CODE/KEY	ITEM	LOCATION	MANUFACT.	DESCRIPTION
C1	Carpet	Offices	Shaw	Style: Living Systems, Source Tile 5T315 Color: Radiant 05515 Format: Plank Size: 9' x 36" x 0.209 in. thickness Backing: Synthetic/Ecoworx Adhesive: Manufacturer Recommended Installation: Ashlar
C2	Carpet	Conference Room	Shaw	Style: Living Systems, Observe Tile 5T306 Color: Radiant 05515 Format: Plank Size: 9' x 36" x 0.272 in. thickness Backing: Synthetic/Ecoworx Adhesive: Manufacturer Recommended Installation: Ashlar
LVT1	Luxury Vinyl Tile	Floors	Mannington	Style: Amtico Wood Collection Color: Manor Oak AROW7970- Square Edge Size: 9' x 48" x 2.5mm thickness Adhesive: Manufacturer Recommended
PTF1	Porcelain Wall Tile	Walls-Field	Emser Tile	Pattern: Milestone Color: Gray Size: 12" x 24" x 8mm Grout: Laticrete, Spectralock Pro Premium Grout Color: Dusty Grey 60 Grout Joint: 1/8" Installation: 1/3rd Offset
SC	Sealed Concrete	Floors	Sherwin Williams	Style: Armorseal Treadplex Color: Haze Gray Notes: See architectural specifications for information

FLOORING TRANSITION STRIPS				
TS1	Transition Strip	LVT to SVF	Griffon	Ramping TRT#, 1/8" Beveled Corian Color: Neutral Concrete See Flooring for Detail Note About Ramp Size.
TS2	Transition Strip	1/8" Resilient to Carpet	Schluter Systems	Vinpro- S, Aluminum Finish: Brushed Nickel Anodized Aluminum Backfill with thin set to prevent denting.
TS3	Transition Strip	1/8" Resilient to Concrete	Schluter Systems	Vinpro- U, Aluminum Finish: Brushed Nickel Anodized Aluminum Backfill with thin set to prevent denting.
TS4	Existing	New Floor to Existing Flooring	Schluter Systems	Contractor to submit ADA compliant transition from that is appropriate for new/existing flooring heights. Stainless Steel ONLY

FLOORING LEGEND	
TS	FLOORING TRANSITION TYPE
→	PLANK OR TILE DIRECTION
-----	PATTERN DIRECTION CHANGE





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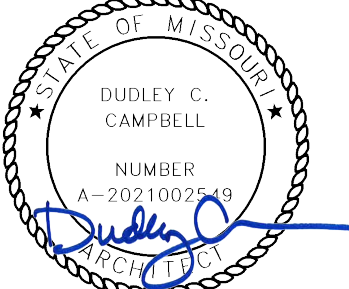
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ADMINISTRATION RELOCATION

HCA - LEE'S SUMMIT MEDICAL CENTER
2000 SE BLUE PKWY
LEE'S SUMMIT, MO 64063

AUTHORITY HAVING JURISDICTION:
CITY OF LEE'S SUMMIT BUILDING DEPT.
MISSOURI DHSS

FACILITY NUMBER:
0972400009

AGENCY APPROVALS:


REVISIONS		
REV #	DESCRIPTION	DATE
A	CITY - 2ND REVIEW	2025/05/29

DATE: 2025.04.18
SCALE: As indicated
DRAWN: PC
REVIEWED: PF
JOB NUMBER: 6406.24


FLOOR PATTERN PLAN - LEVEL 1

AF103

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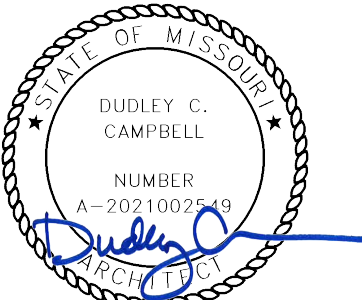
1 FURNITURE PLAN - LEVEL 1
3/16" = 1'-0"

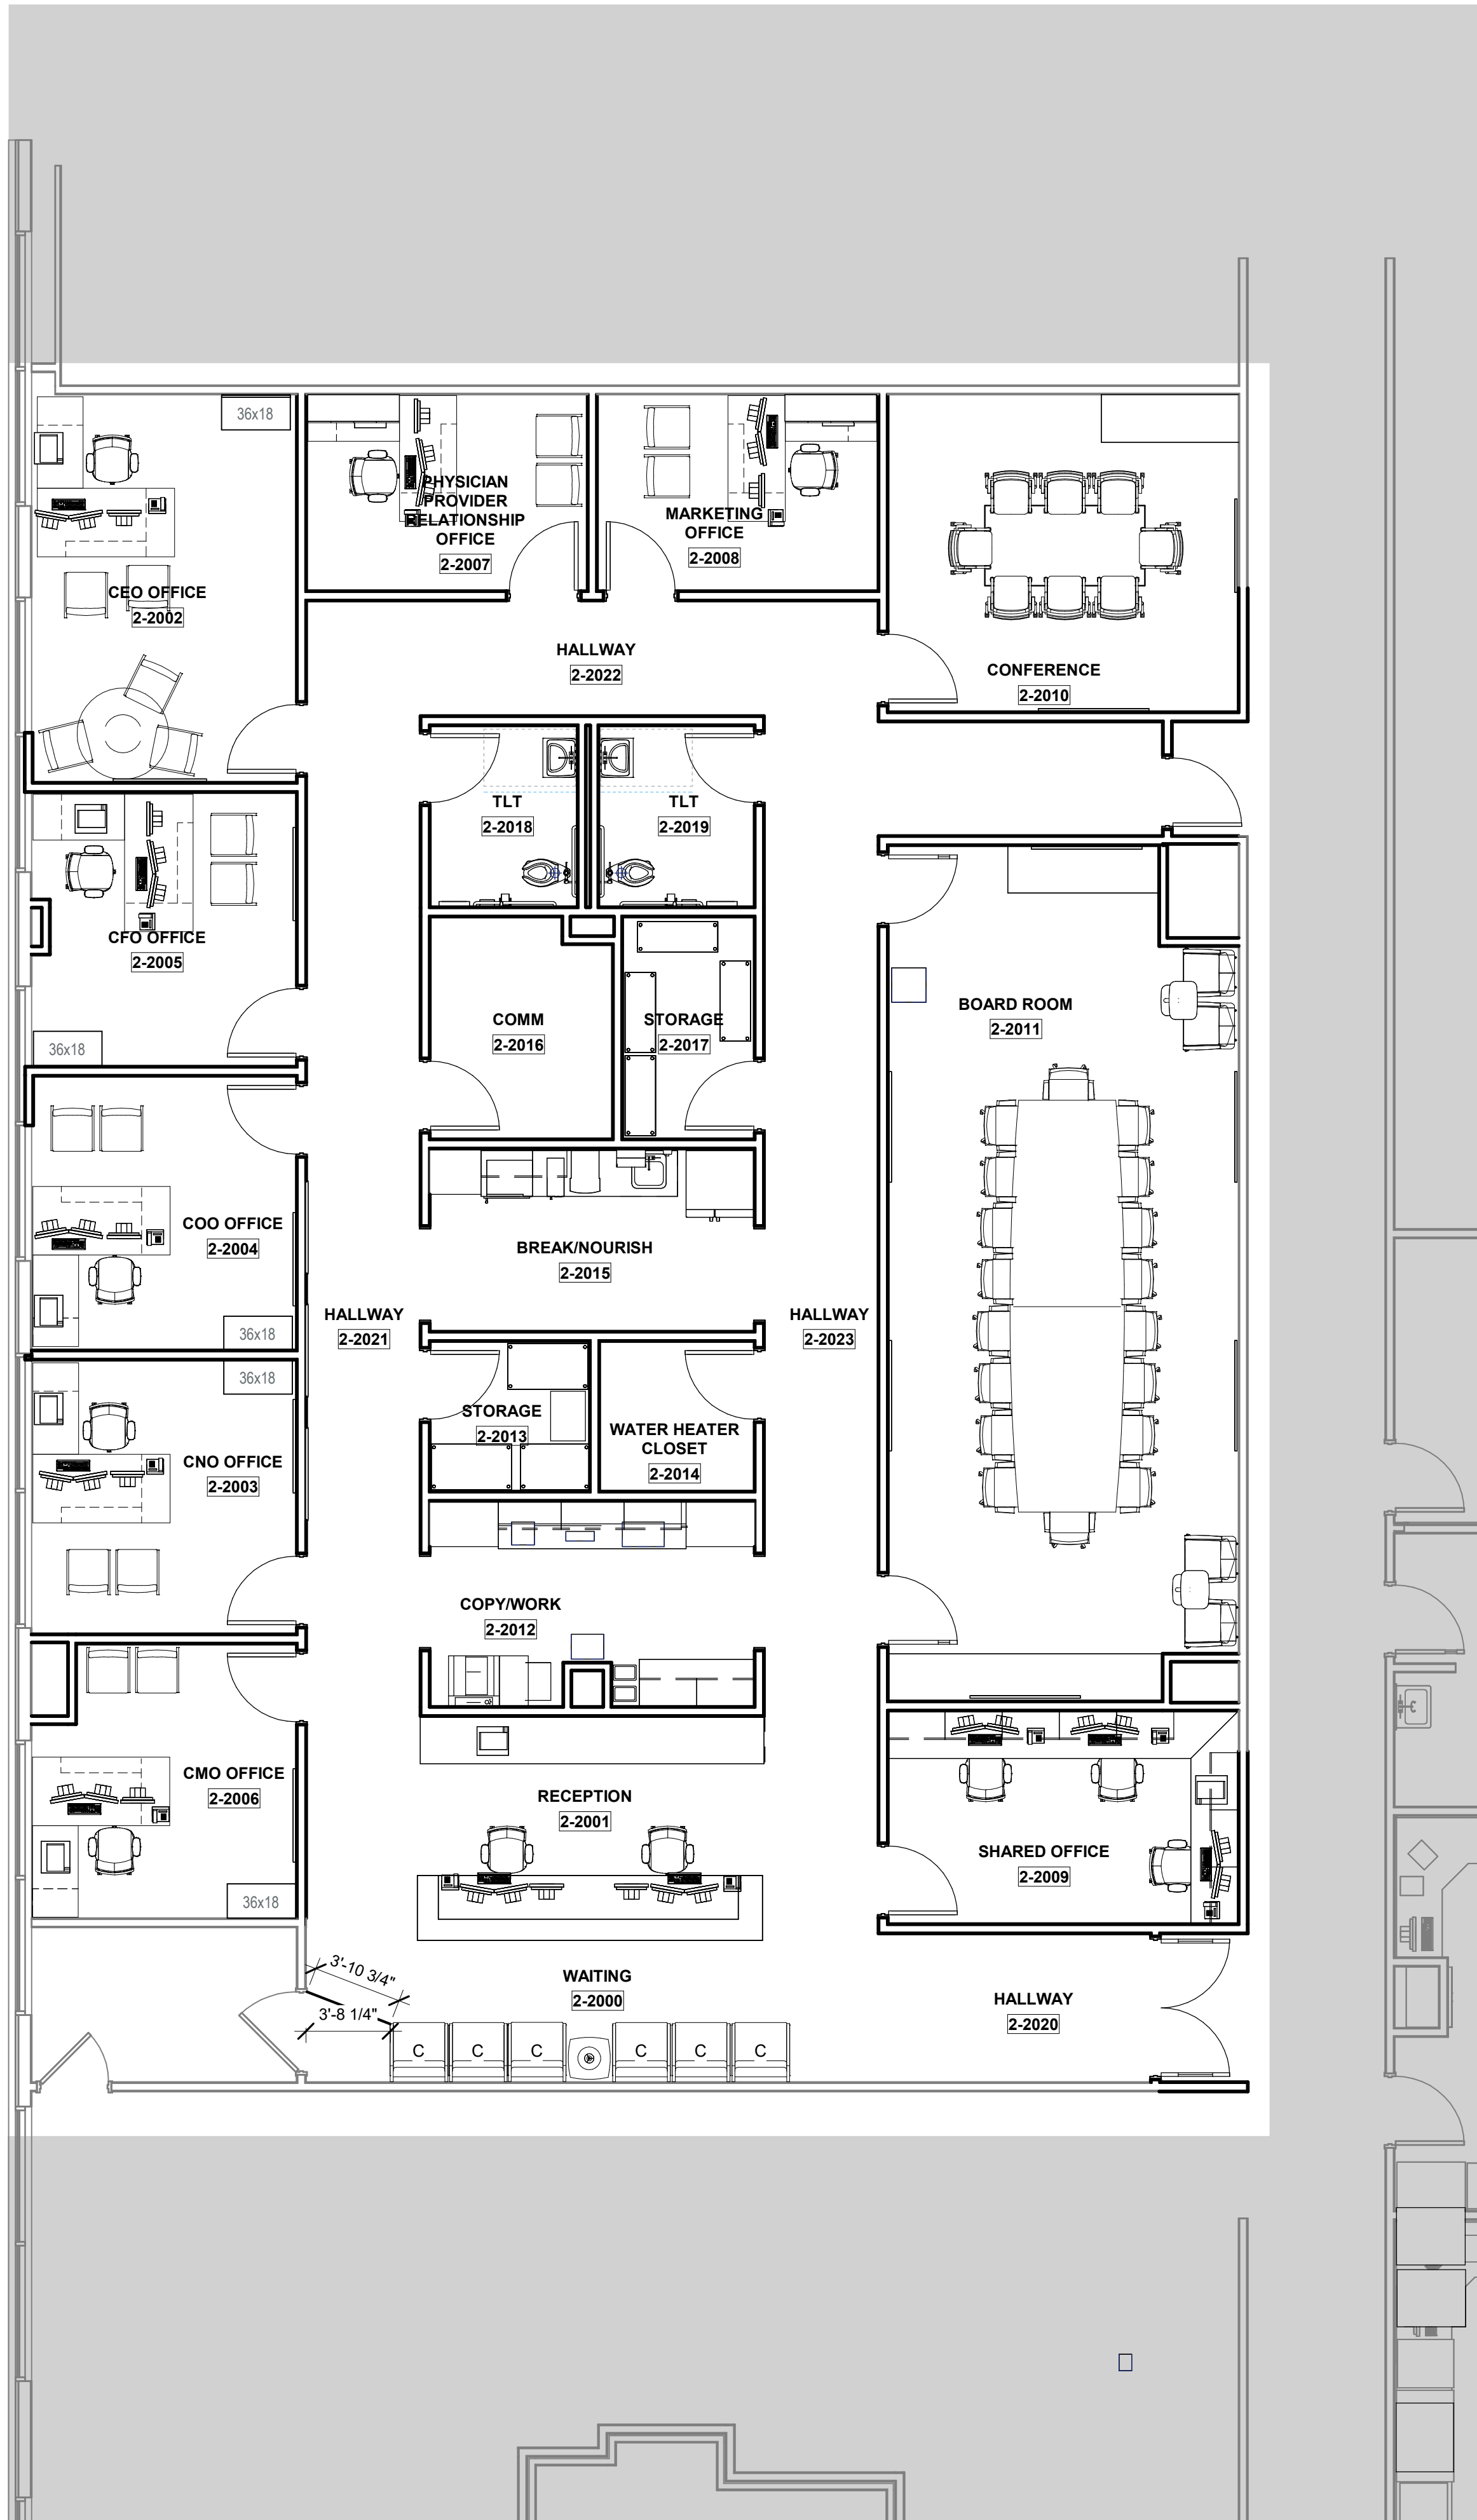

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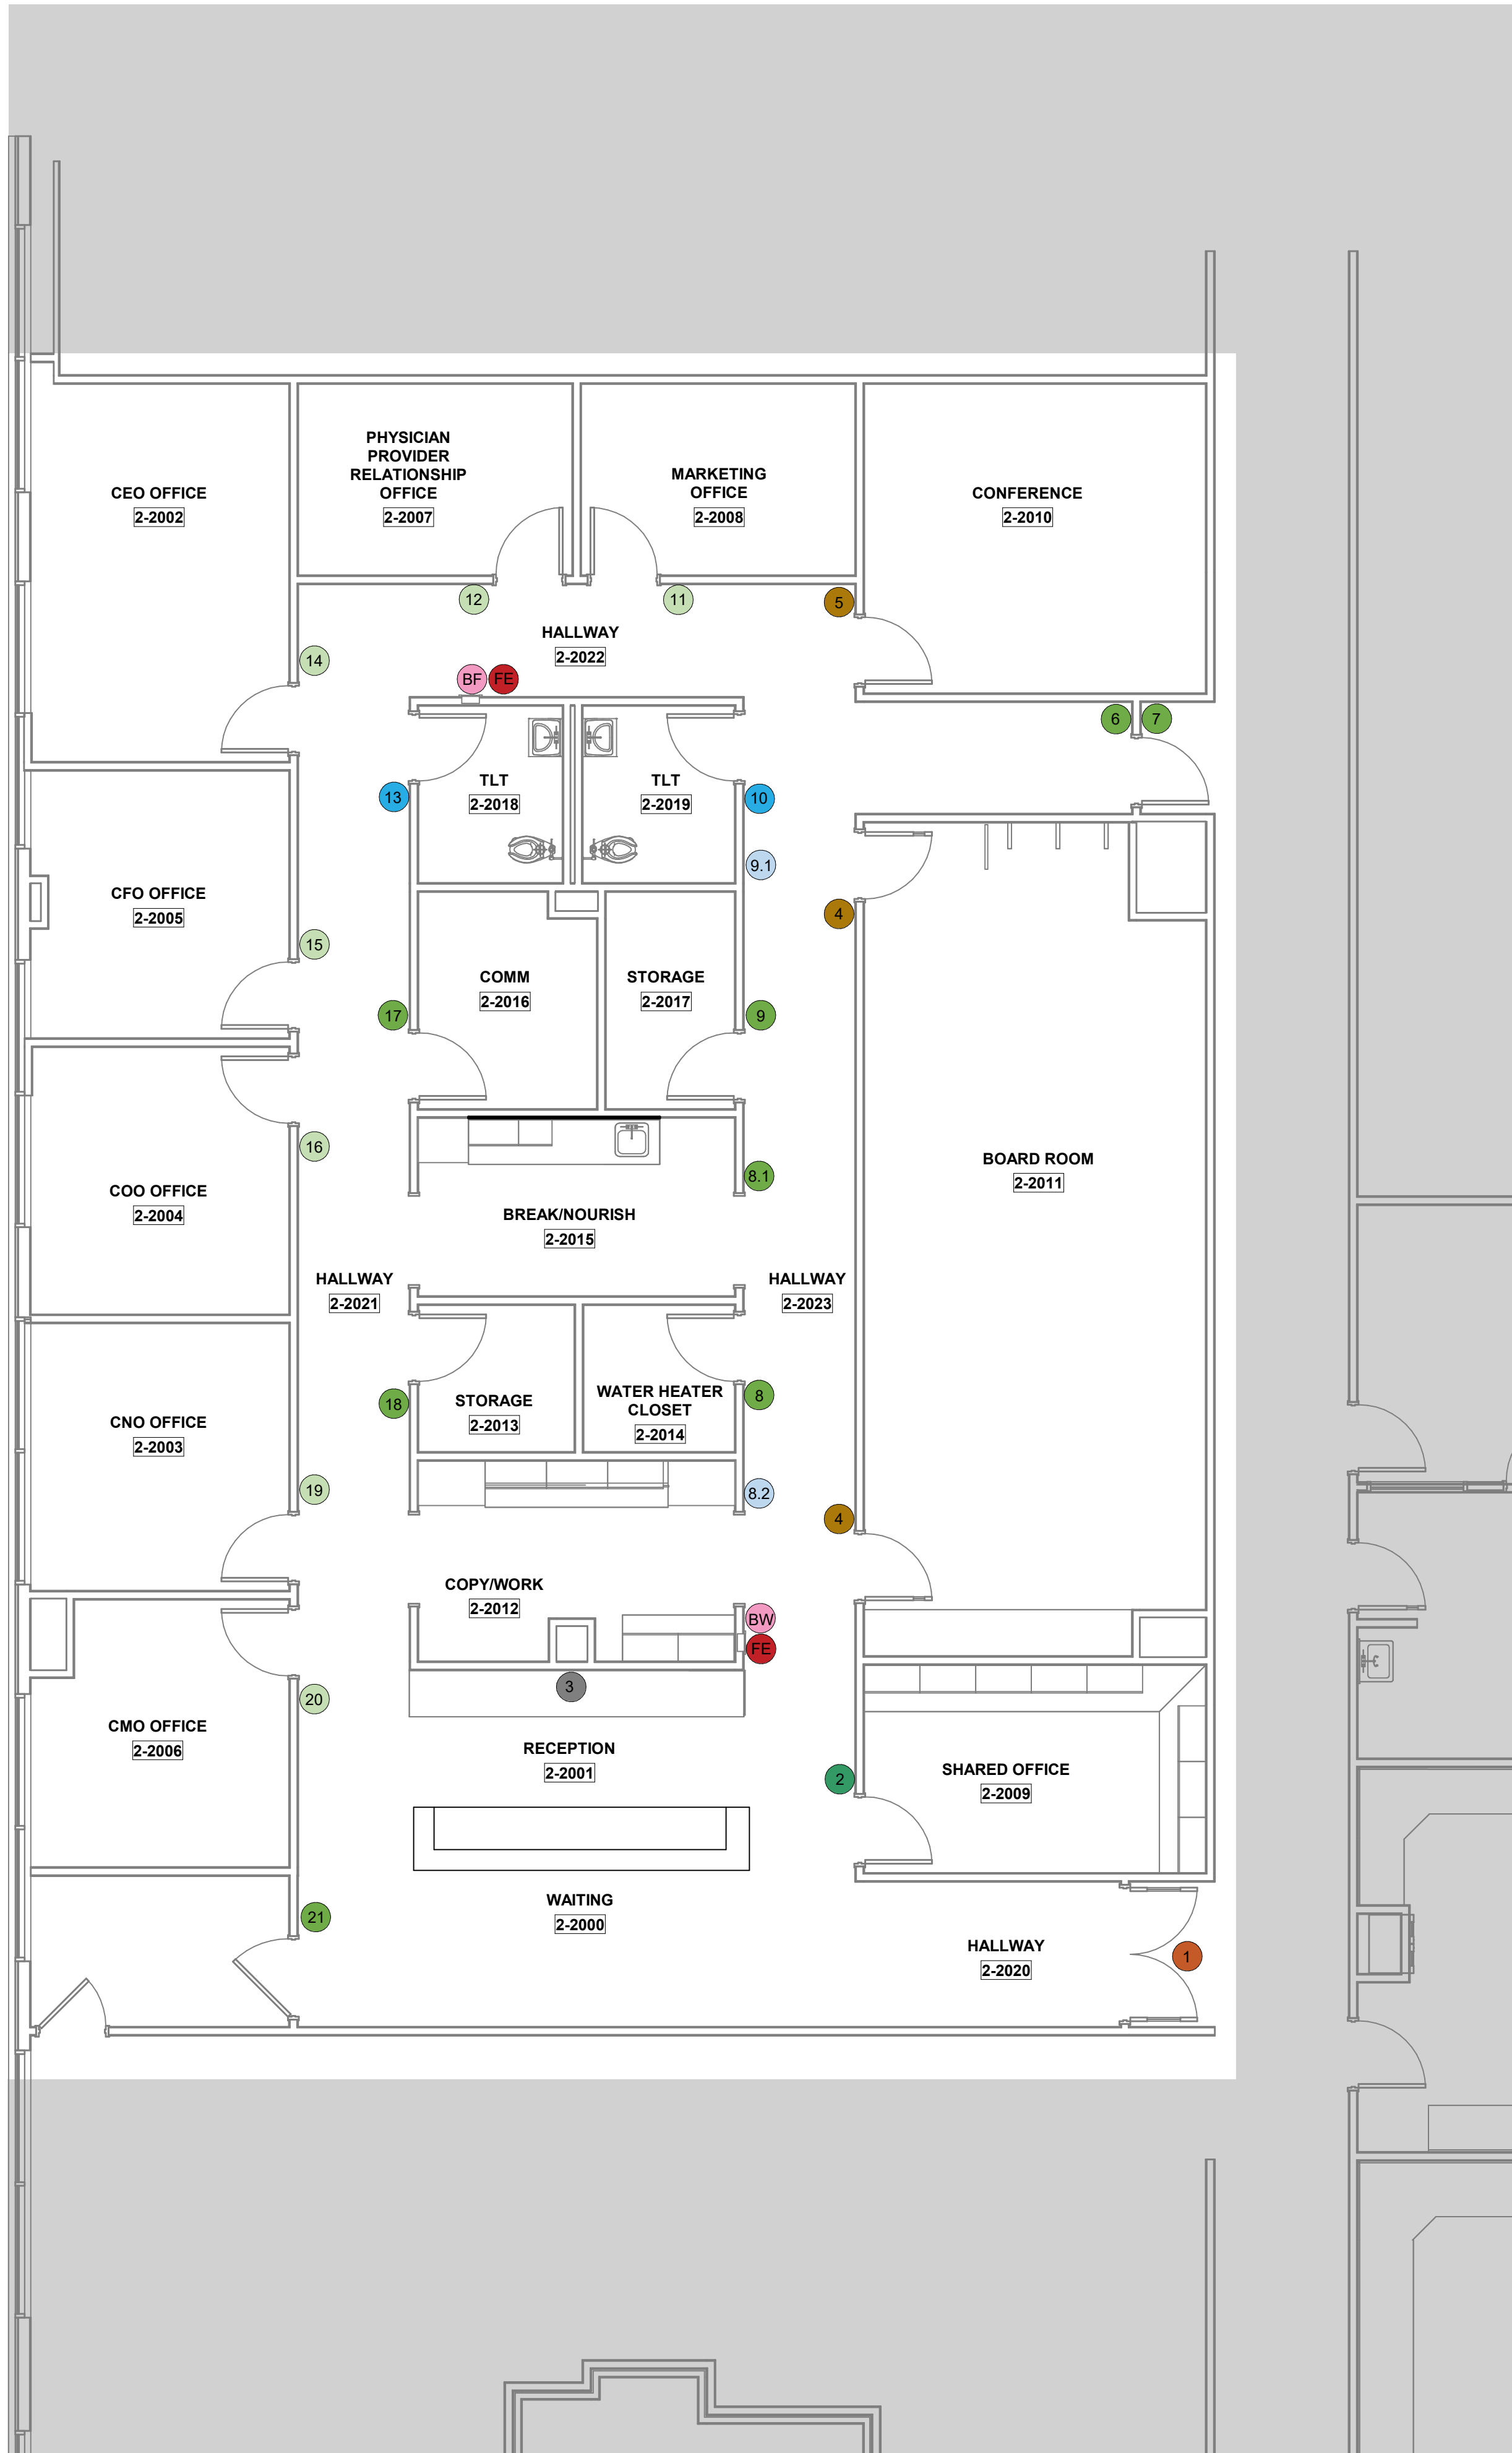
REVISIONS		
REV #	DESCRIPTION	DATE
A	CITY - 2ND REVIEW	2025/05/29

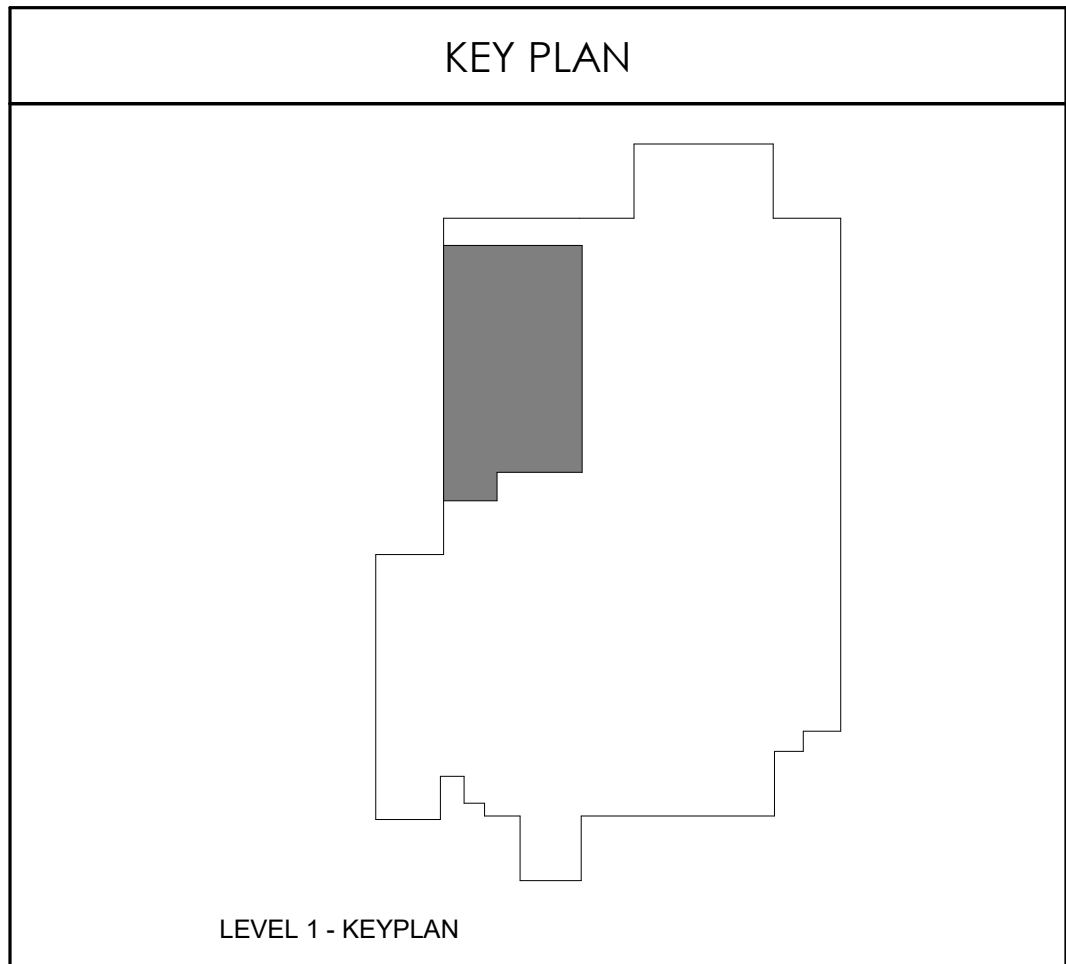DATE: 2025.04.18
SCALE: 3/16" = 1'-0"
DRAWN: PC
REVIEWED: PF
JOB NUMBER: 6406.24

FURNITURE PLAN - LEVEL 1

AF104



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1 SIGNAGE PLAN - LEVEL 1
3/16" = 1'-0"

LOCATION	QTY.	FLOOR	INT-EXT	TYPE	MESSAGE	SYMBOL	NOTES
ADMINISTRATION							
1	1	1	INT	V	ADMINISTRATION		VINYL DOOR?
2	1	1	INT	P4	OFFICE		FACILITY TO CONFIRM VERBIAGE
3	1	1	INT	M	HCA BRANDING SIGNAGE		FACILITY TO CONFIRM VERBIAGE
4	2	1	INT	D	BOARDROOM		DIGITAL SIGN; COORDINATE WITH FACILITY AND ELEC ENGINEER
5	1	1	INT	D	CONFERENCE		DIGITAL SIGN; COORDINATE WITH FACILITY AND ELEC ENGINEER
6	1	1	INT	P	EXIT		
7	1	1	INT	P	STAFF ONLY		FACILITY TO CONFIRM VERBIAGE
8	1	1	INT	P	ELEC/WATER HEATER		FACILITY TO CONFIRM VERBIAGE
8.1	1	1	INT	P	BREAK/NOURISH		FACILITY TO CONFIRM VERBIAGE
8.2	1	1	INT	SD	BREAKROOM & RESTROOM		FACILITY TO CONFIRM VERBIAGE
9	1	1	INT	P	STORAGE		
9.1	1	1	INT	SD	BREAKROOM & LOBBY	FEMALE/MALE/HANDICAP	FACILITY TO CONFIRM VERBIAGE
10	1	1	INT	S	RESTROOM		
11	1	1	INT	P3	MARKETING		NAME SLOT
12	1	1	INT	P3	PHYSICIAN PROVIDER RELATIONSHIP		NAME SLOT/FACILITY TO CONFIRM VERBIAGE
13	1	1	INT	S	RESTROOM	FEMALE/MALE/HANDICAP	
14	1	1	INT	P3	CEO		NAME SLOT
15	1	1	INT	P3	CFO		NAME SLOT
16	1	1	INT	P3	COO		NAME SLOT
17	1	1	INT	P	COMMUNICATION		
18	2	1	INT	P	STORAGE		
19	1	1	INT	P3	CNO		NAME SLOT
20	1	1	INT	P3	CMO		NAME SLOT
21	1	1	INT	P	TBD		
2	2	1	INT	BW	FIRE EXTINGUISHER		BLADE
4	1	INT	FE		FIRE EVACUATION MAPS		LOCATE AS REQUIRED BY FIRE MARSHAL

SIGN TYPE LEGEND	
V	Sign Type : Vinyl Signs
D	Sign Type : Digital Room Sign
P	Sign Type : Room Sign
P3	Sign Type : Room Sign with Name Inserts
P4	Sign Type: Room sign with 2-3 Name Inserts
S	Sign Type : Room Sign with symbol
BW	Sign Type : Blade Ceilings (Fire Extinguisher signs)
FE	Sign Type : Fire Evacuation Plan Signs
M	Sign Type: HCA Branding Metal routed (Logo)
SD	Sign Type: Small Directional



Devenney GROUP
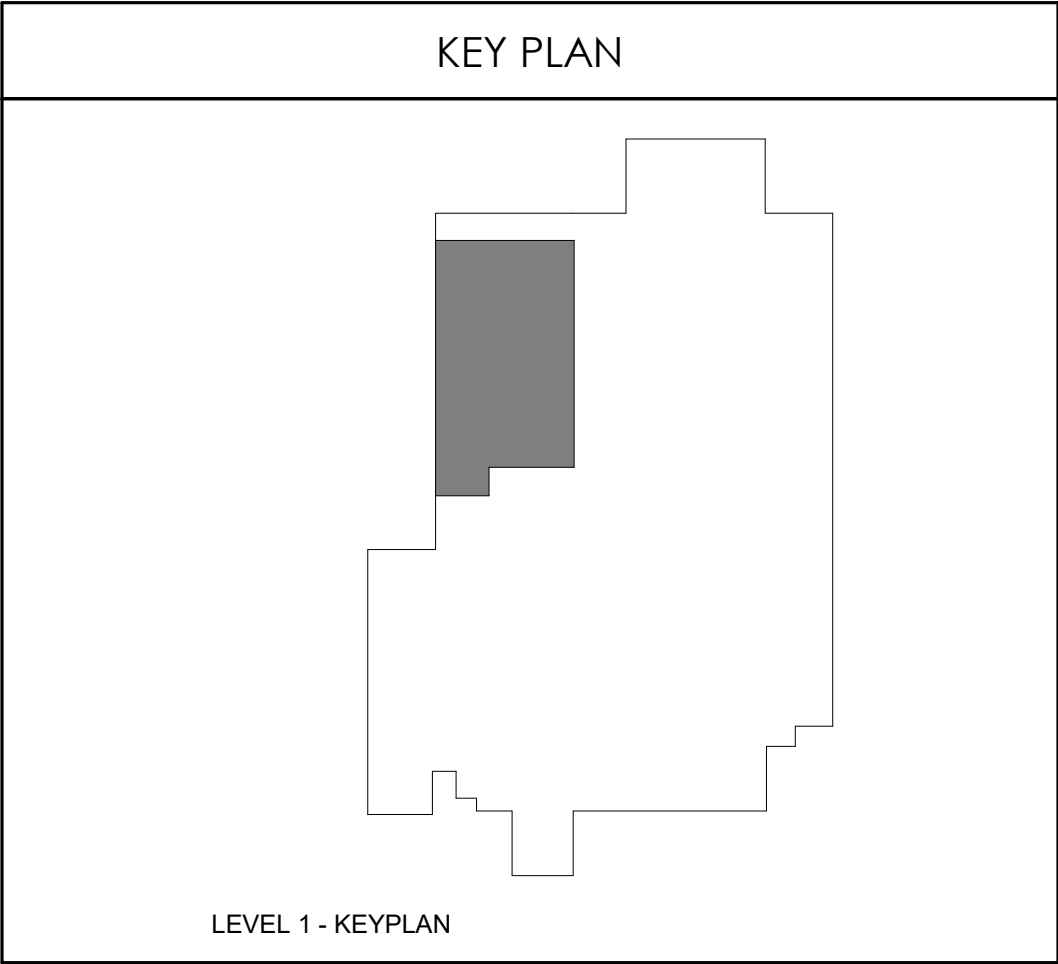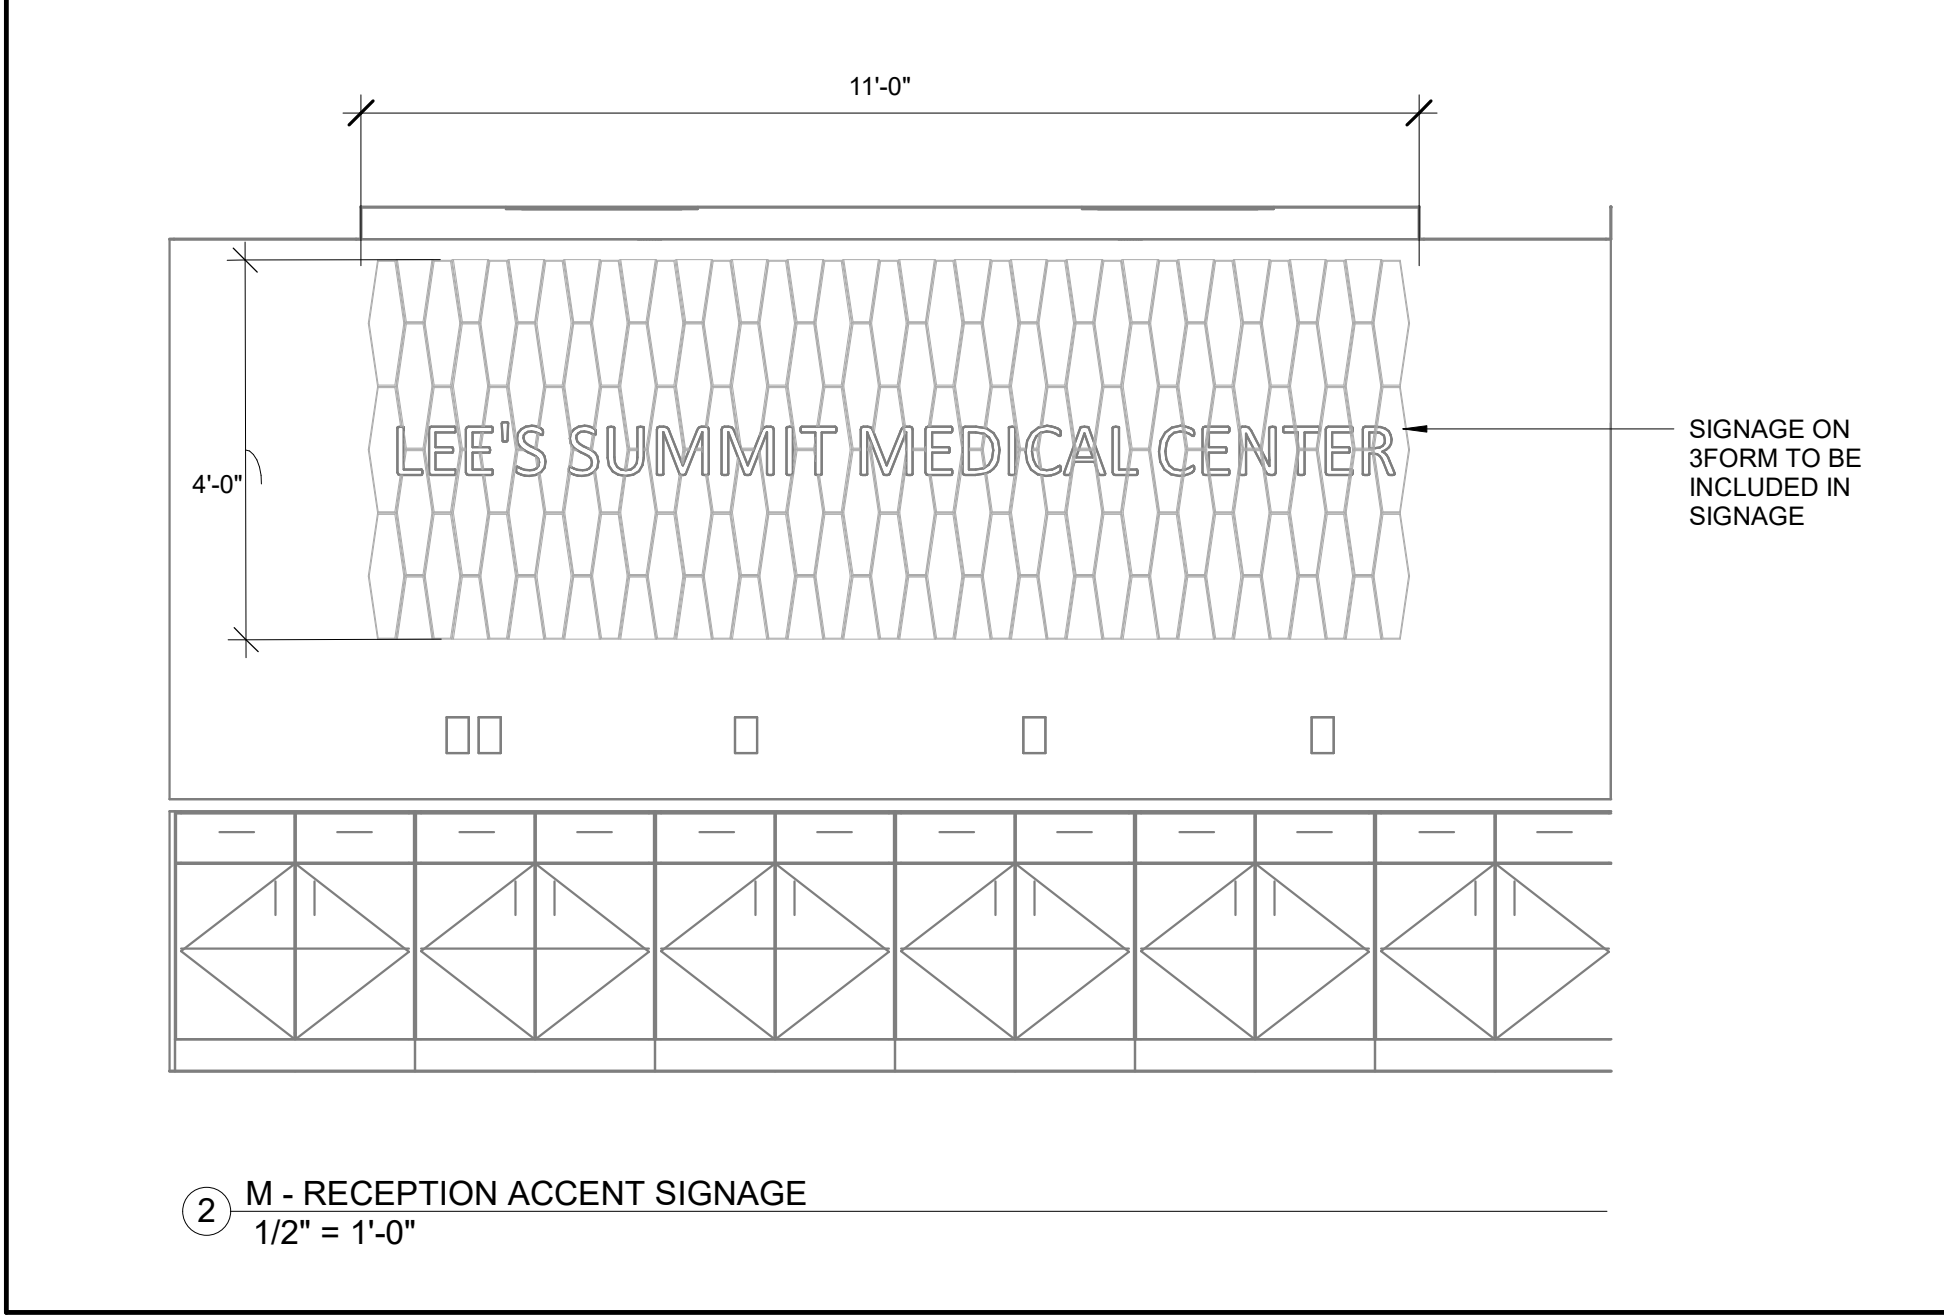
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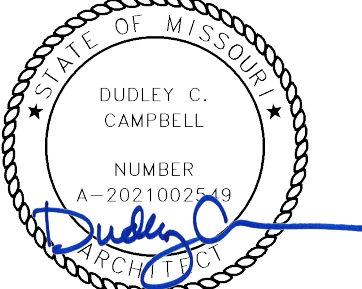
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ADMINISTRATION
RELOCATION

A

HCA - LEE'S SUMMIT
MEDICAL CENTER
2000 SE BLUE PKWY
LEE'S SUMMIT, MO 64063

AUTHORITY HAVING JURISDICTION:
CITY OF LEE'S SUMMIT BUILDING DEPT.
MISSOURI DHSS

FACILITY NUMBER:
0972400009

AGENCY APPROVALS:

REVISIONS		
REV #	DESCRIPTION	DATE
A	CITY - 2ND REVIEW	2025/05/29

DATE: 2025.04.18
SCALE: As indicated
DRAWN: PC
REVIEWED: PF
JOB NUMBER: 6406.24

SIGNAGE PLAN - LEVEL 1


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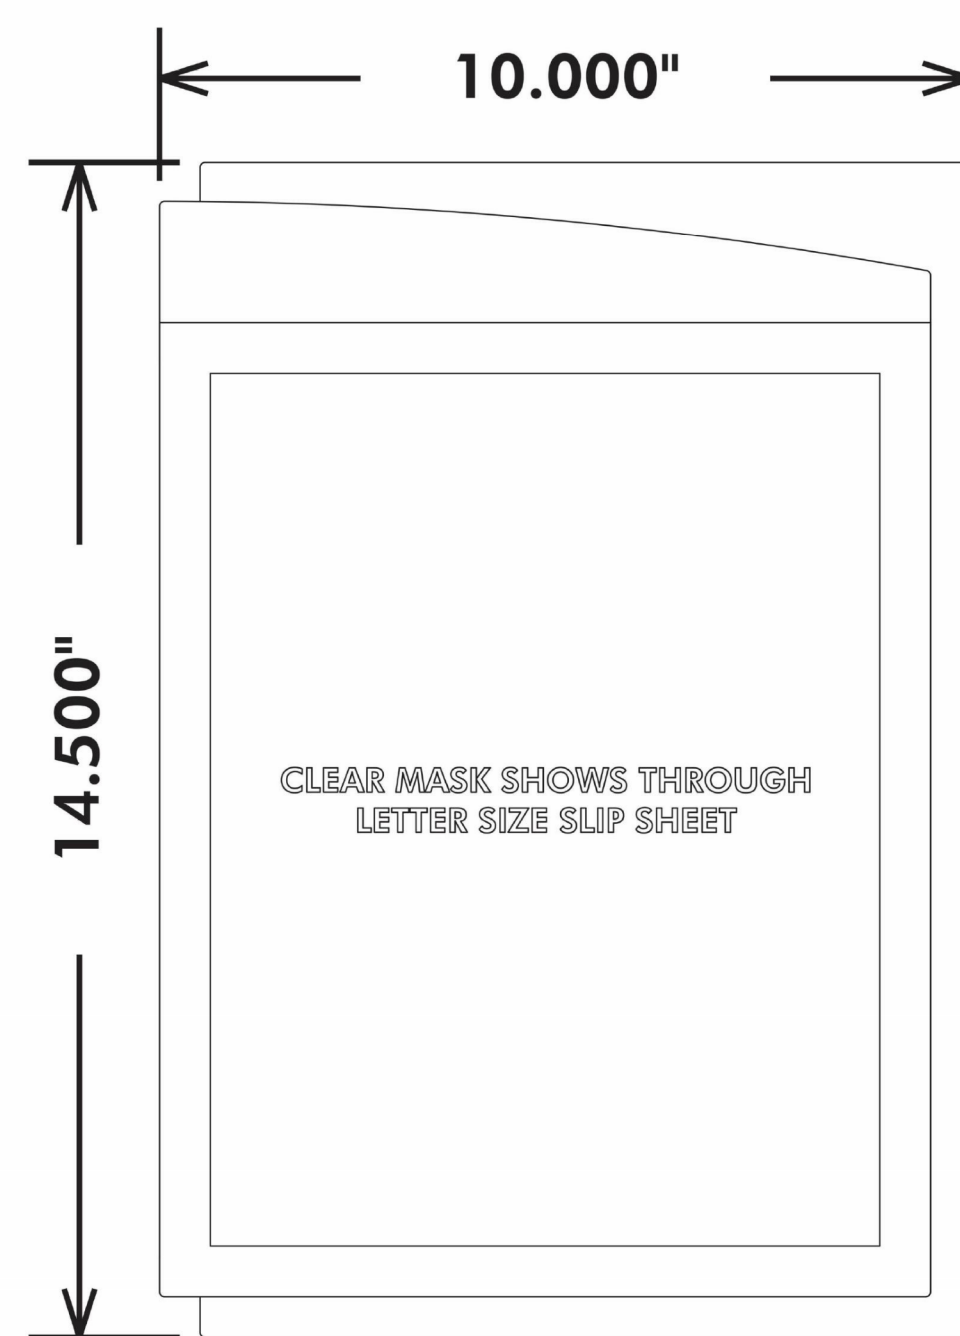
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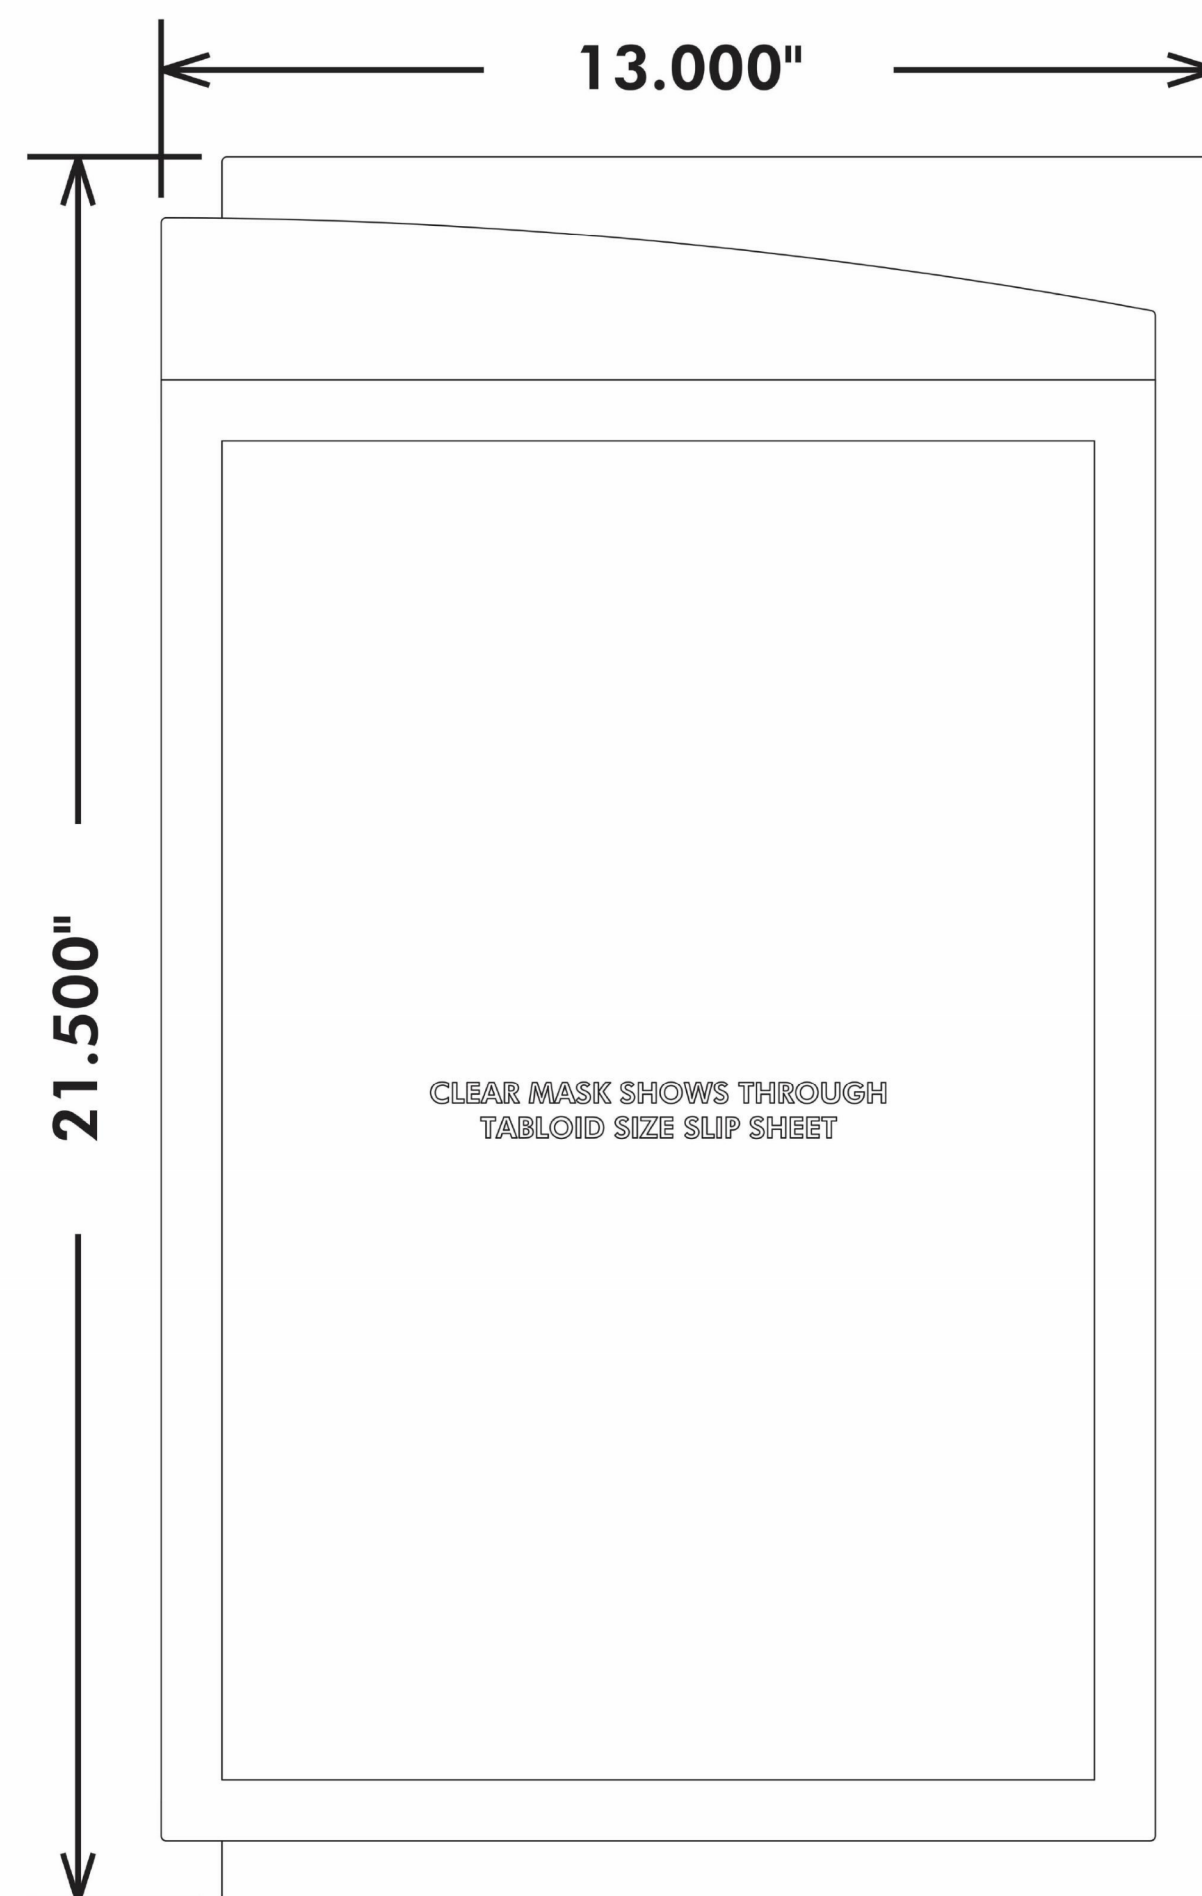
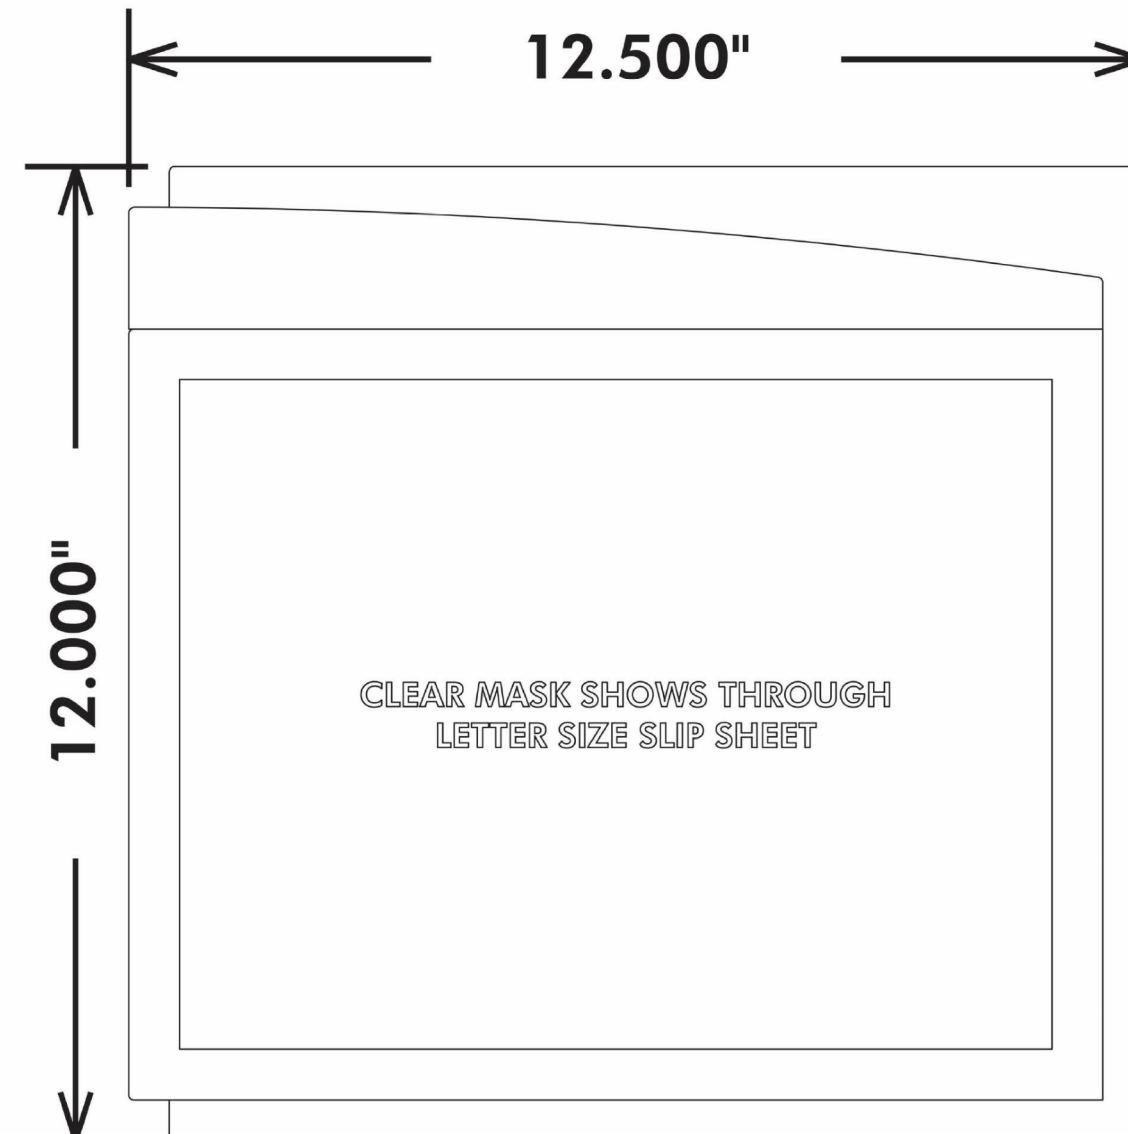
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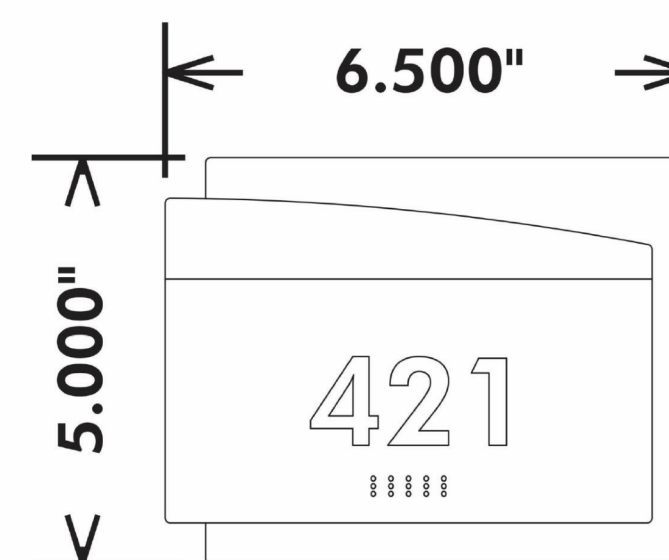
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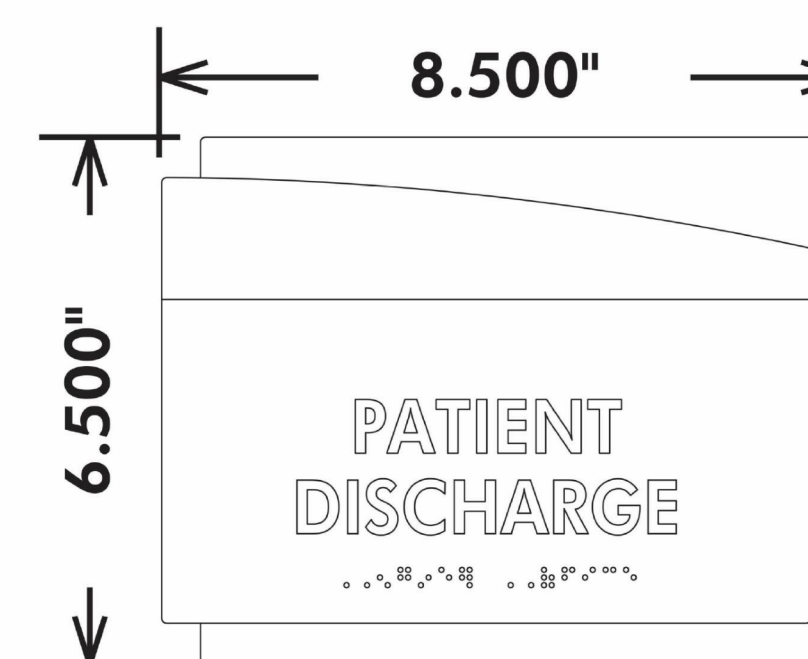
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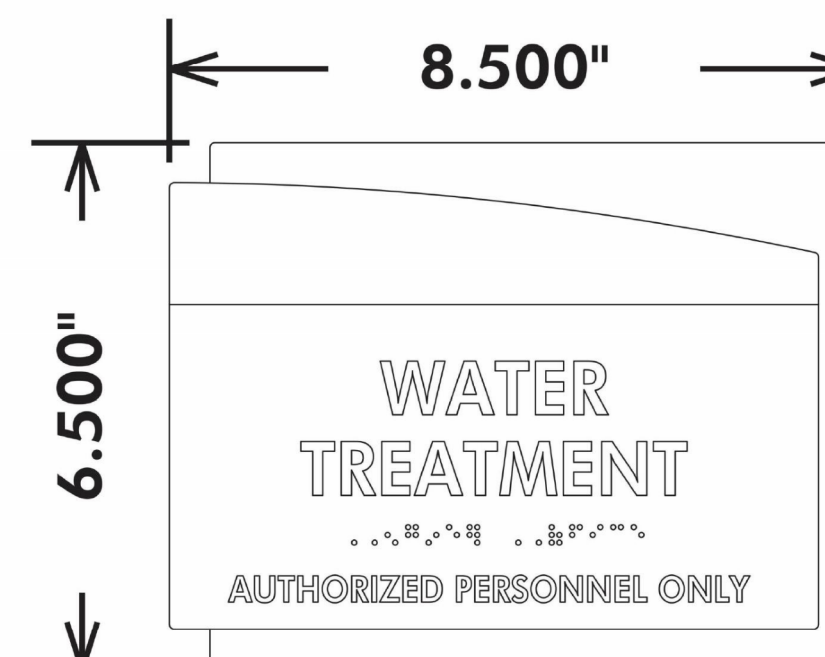
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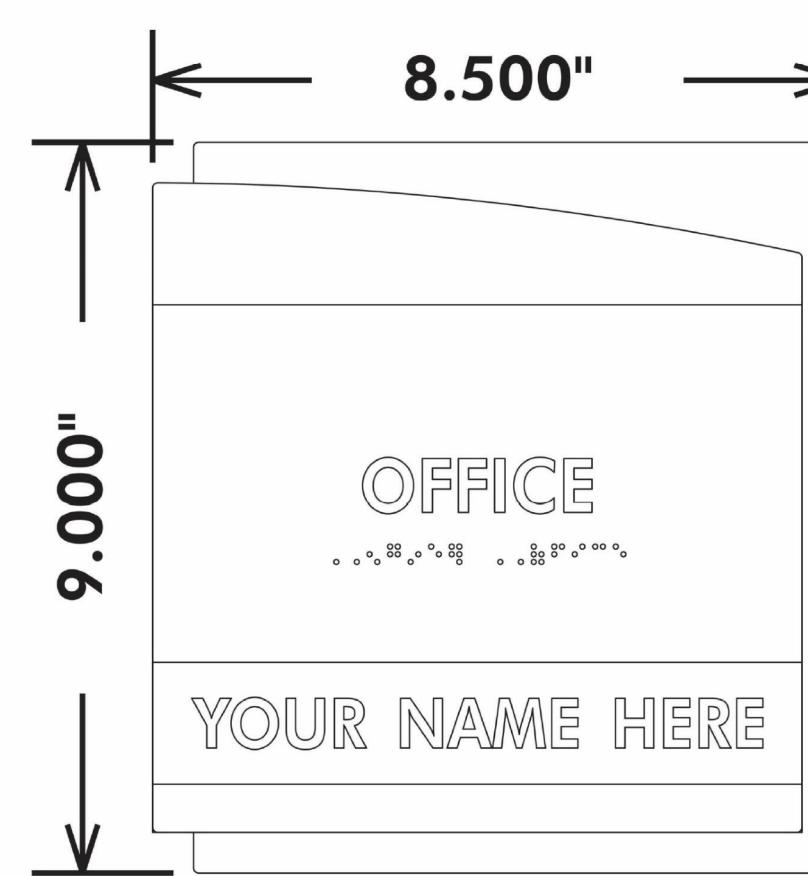
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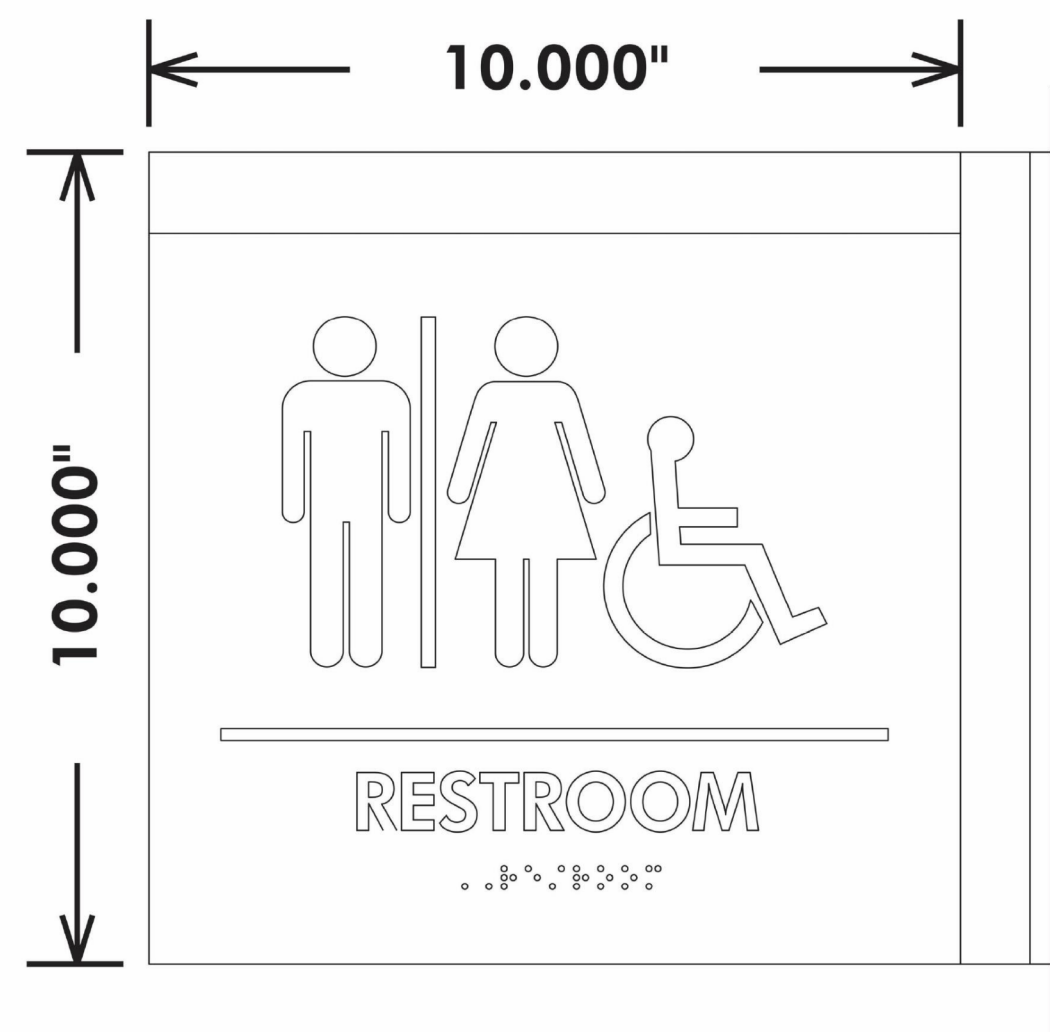
P ROOM ID SIGN



P1 ROOM ID SIGN W/ SUBCOPY




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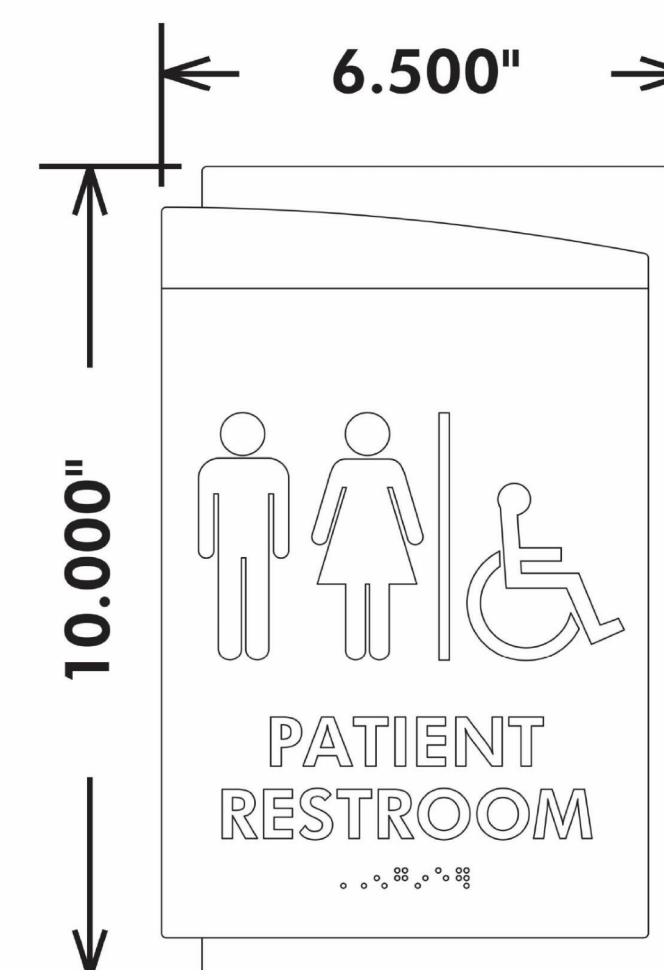
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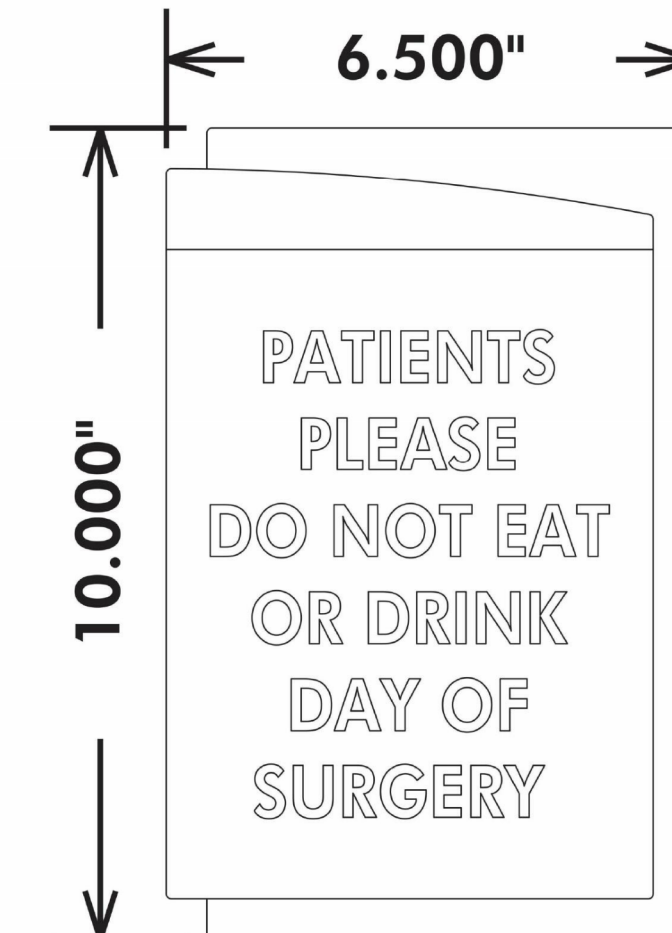
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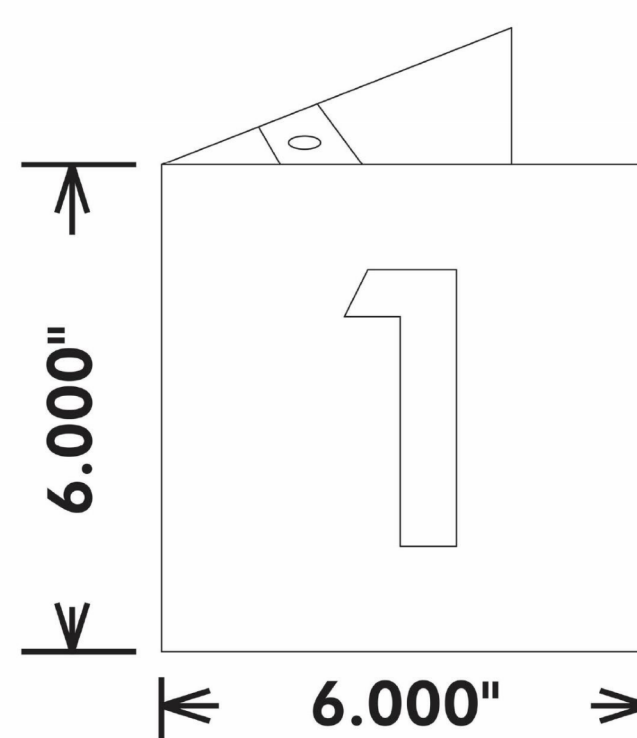
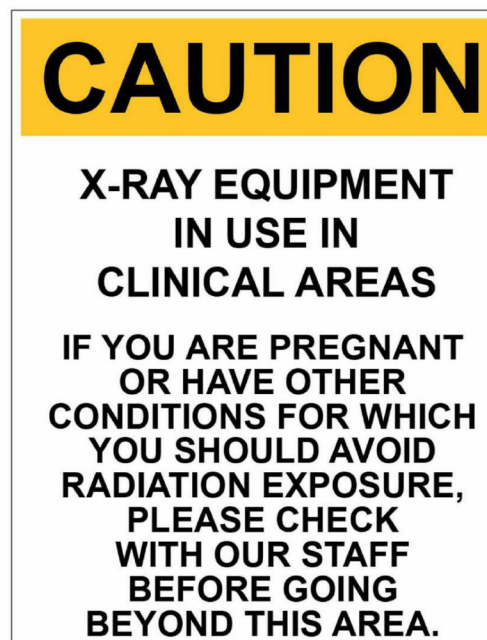
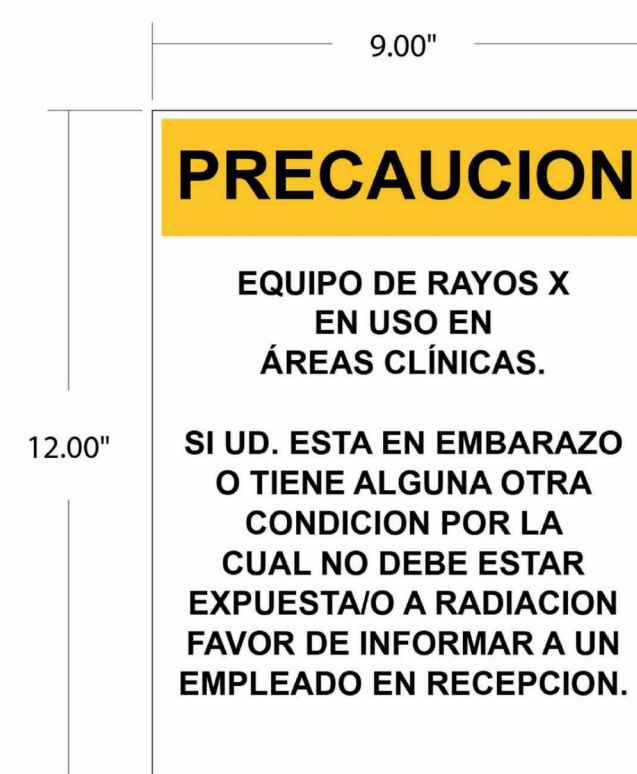
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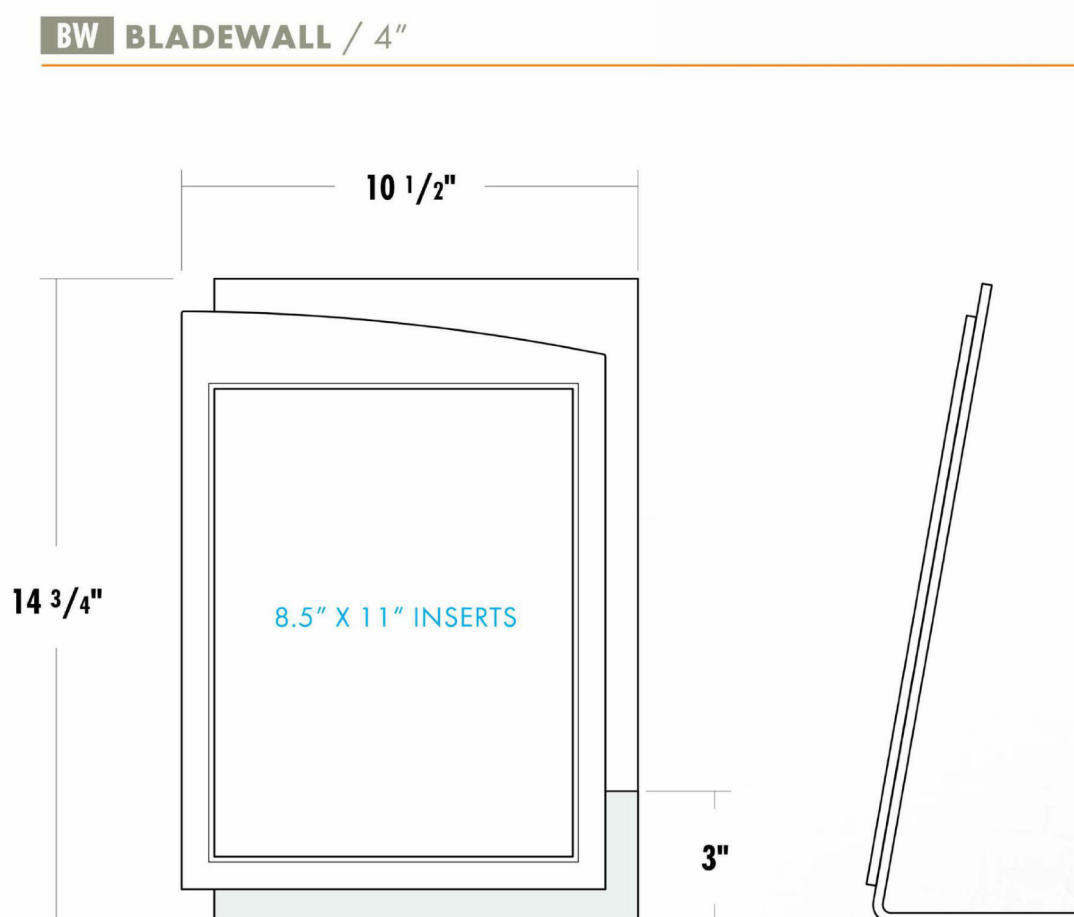
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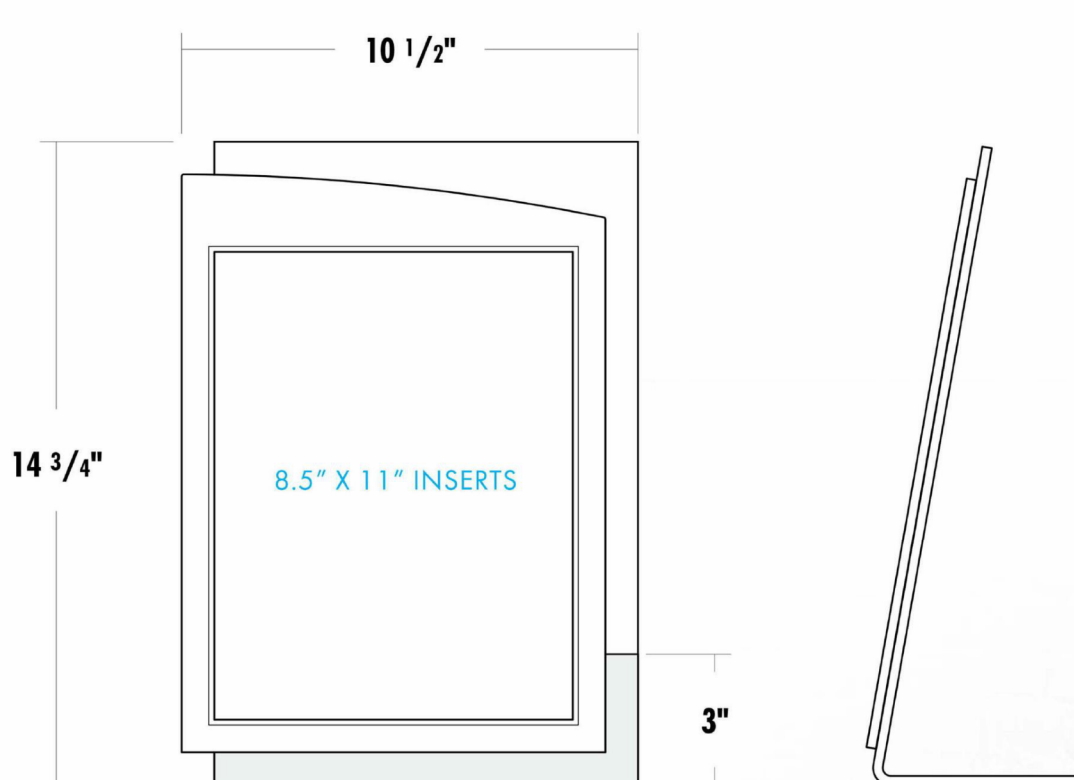
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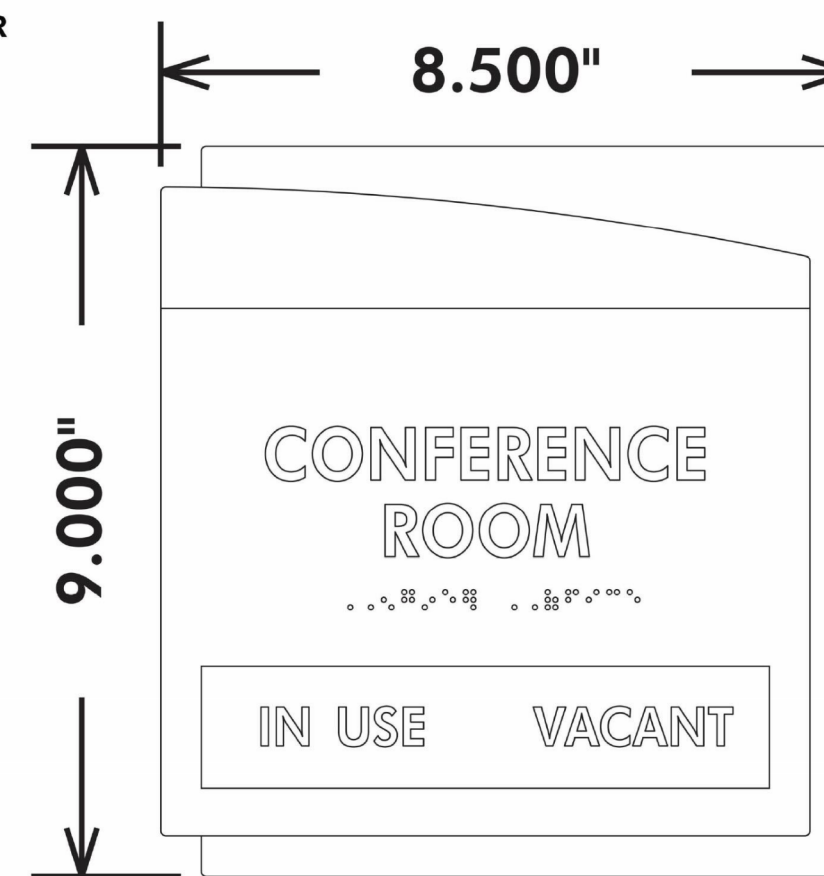
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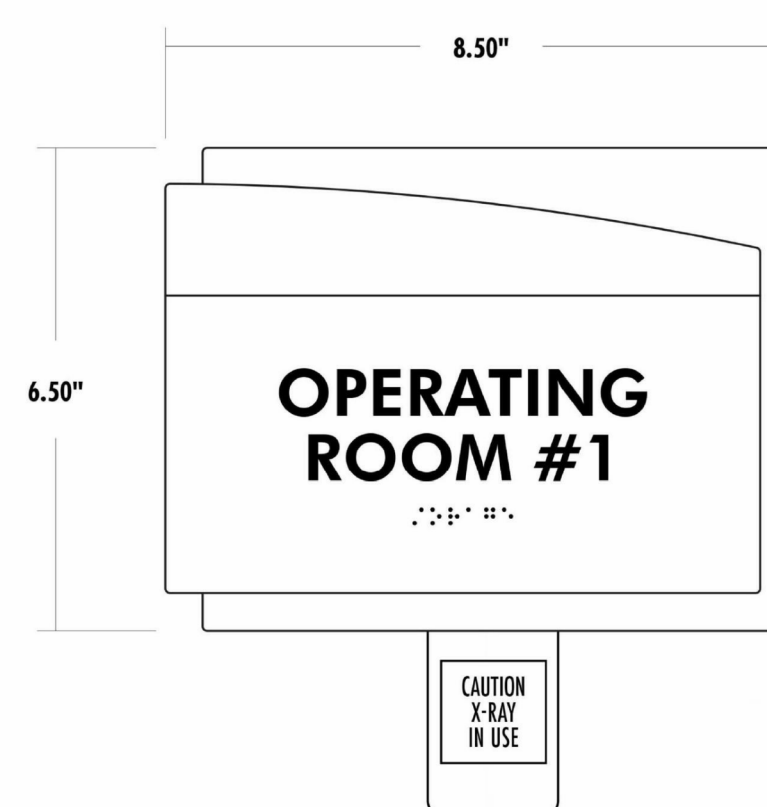
BW BLADEWALL / 4\"/>

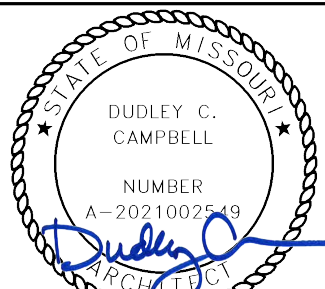

PHS POSTER HOLDER (FREESTANDING) // 8.5\"/>



P2 ROOM ID SIGN W/ IN USE SLIDER

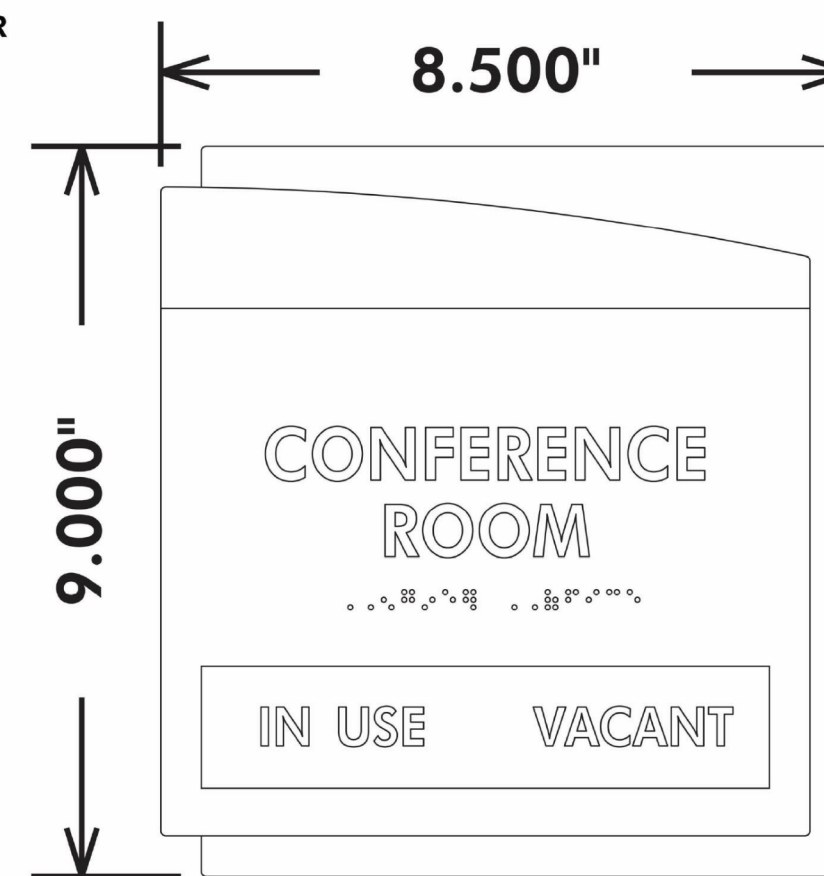

PI-A PATIENT INDICATOR / WITH ALERTBAR


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Consultant:



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ADMINISTRATION RELOCATION

HCA - LEE'S SUMMIT MEDICAL CENTER
2000 SE BLUE PKWY
LEE'S SUMMIT, MO 64063

AUTHORITY HAVING JURISDICTION:
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MISSOURI DHSS
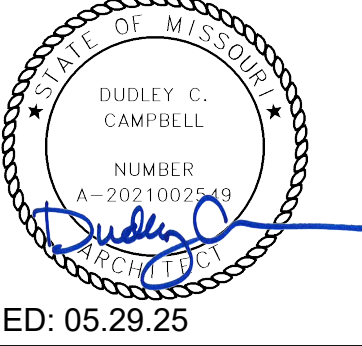
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REVISIONS		
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REVIEWED: PF
JOB NUMBER: 6406.24

SIGNAGE KEY

AF107

FOR REFERENCE ONLY - SIGNAGE TO MATCH FACILITY STANDARDS



PREPARED BY
TONY HATCHELL
BENNU ENTERPRISES, INC.
615.522.4588

DATED 03-22-2017

STANDARD SYMBOLS




STANDARD TYPEFACE
FUTURA HEAVY BT

ABCDEFGHIJ
KLMNOPQ
RSTUVWXY

SIGN FAMILY:
ZEUS

INSTALLATION LOCATIONS


ALL SIGNS TO BE MOUNTED 3" FROM THE EDGE OF THE DOOR FRAME TO THE LEADING EDGE OF THE SIGN UNLESS OTHERWISE OBSTRUCTED BY AN ADJACENT WALL OR OTHER OBSTRUCTION. IN THAT CASE SIGN TO BE CENTERED INTO AREA. IE - IF IT IS TOO TIGHT TO ALLOW THE 3" DISTANCE - AS LONG AS SIGN FITS ON GIVEN WALL AREA IT IS TO GO ON LATCH SIDE AND BE CENTERED ONTO AVAILABLE WALL SPACE.

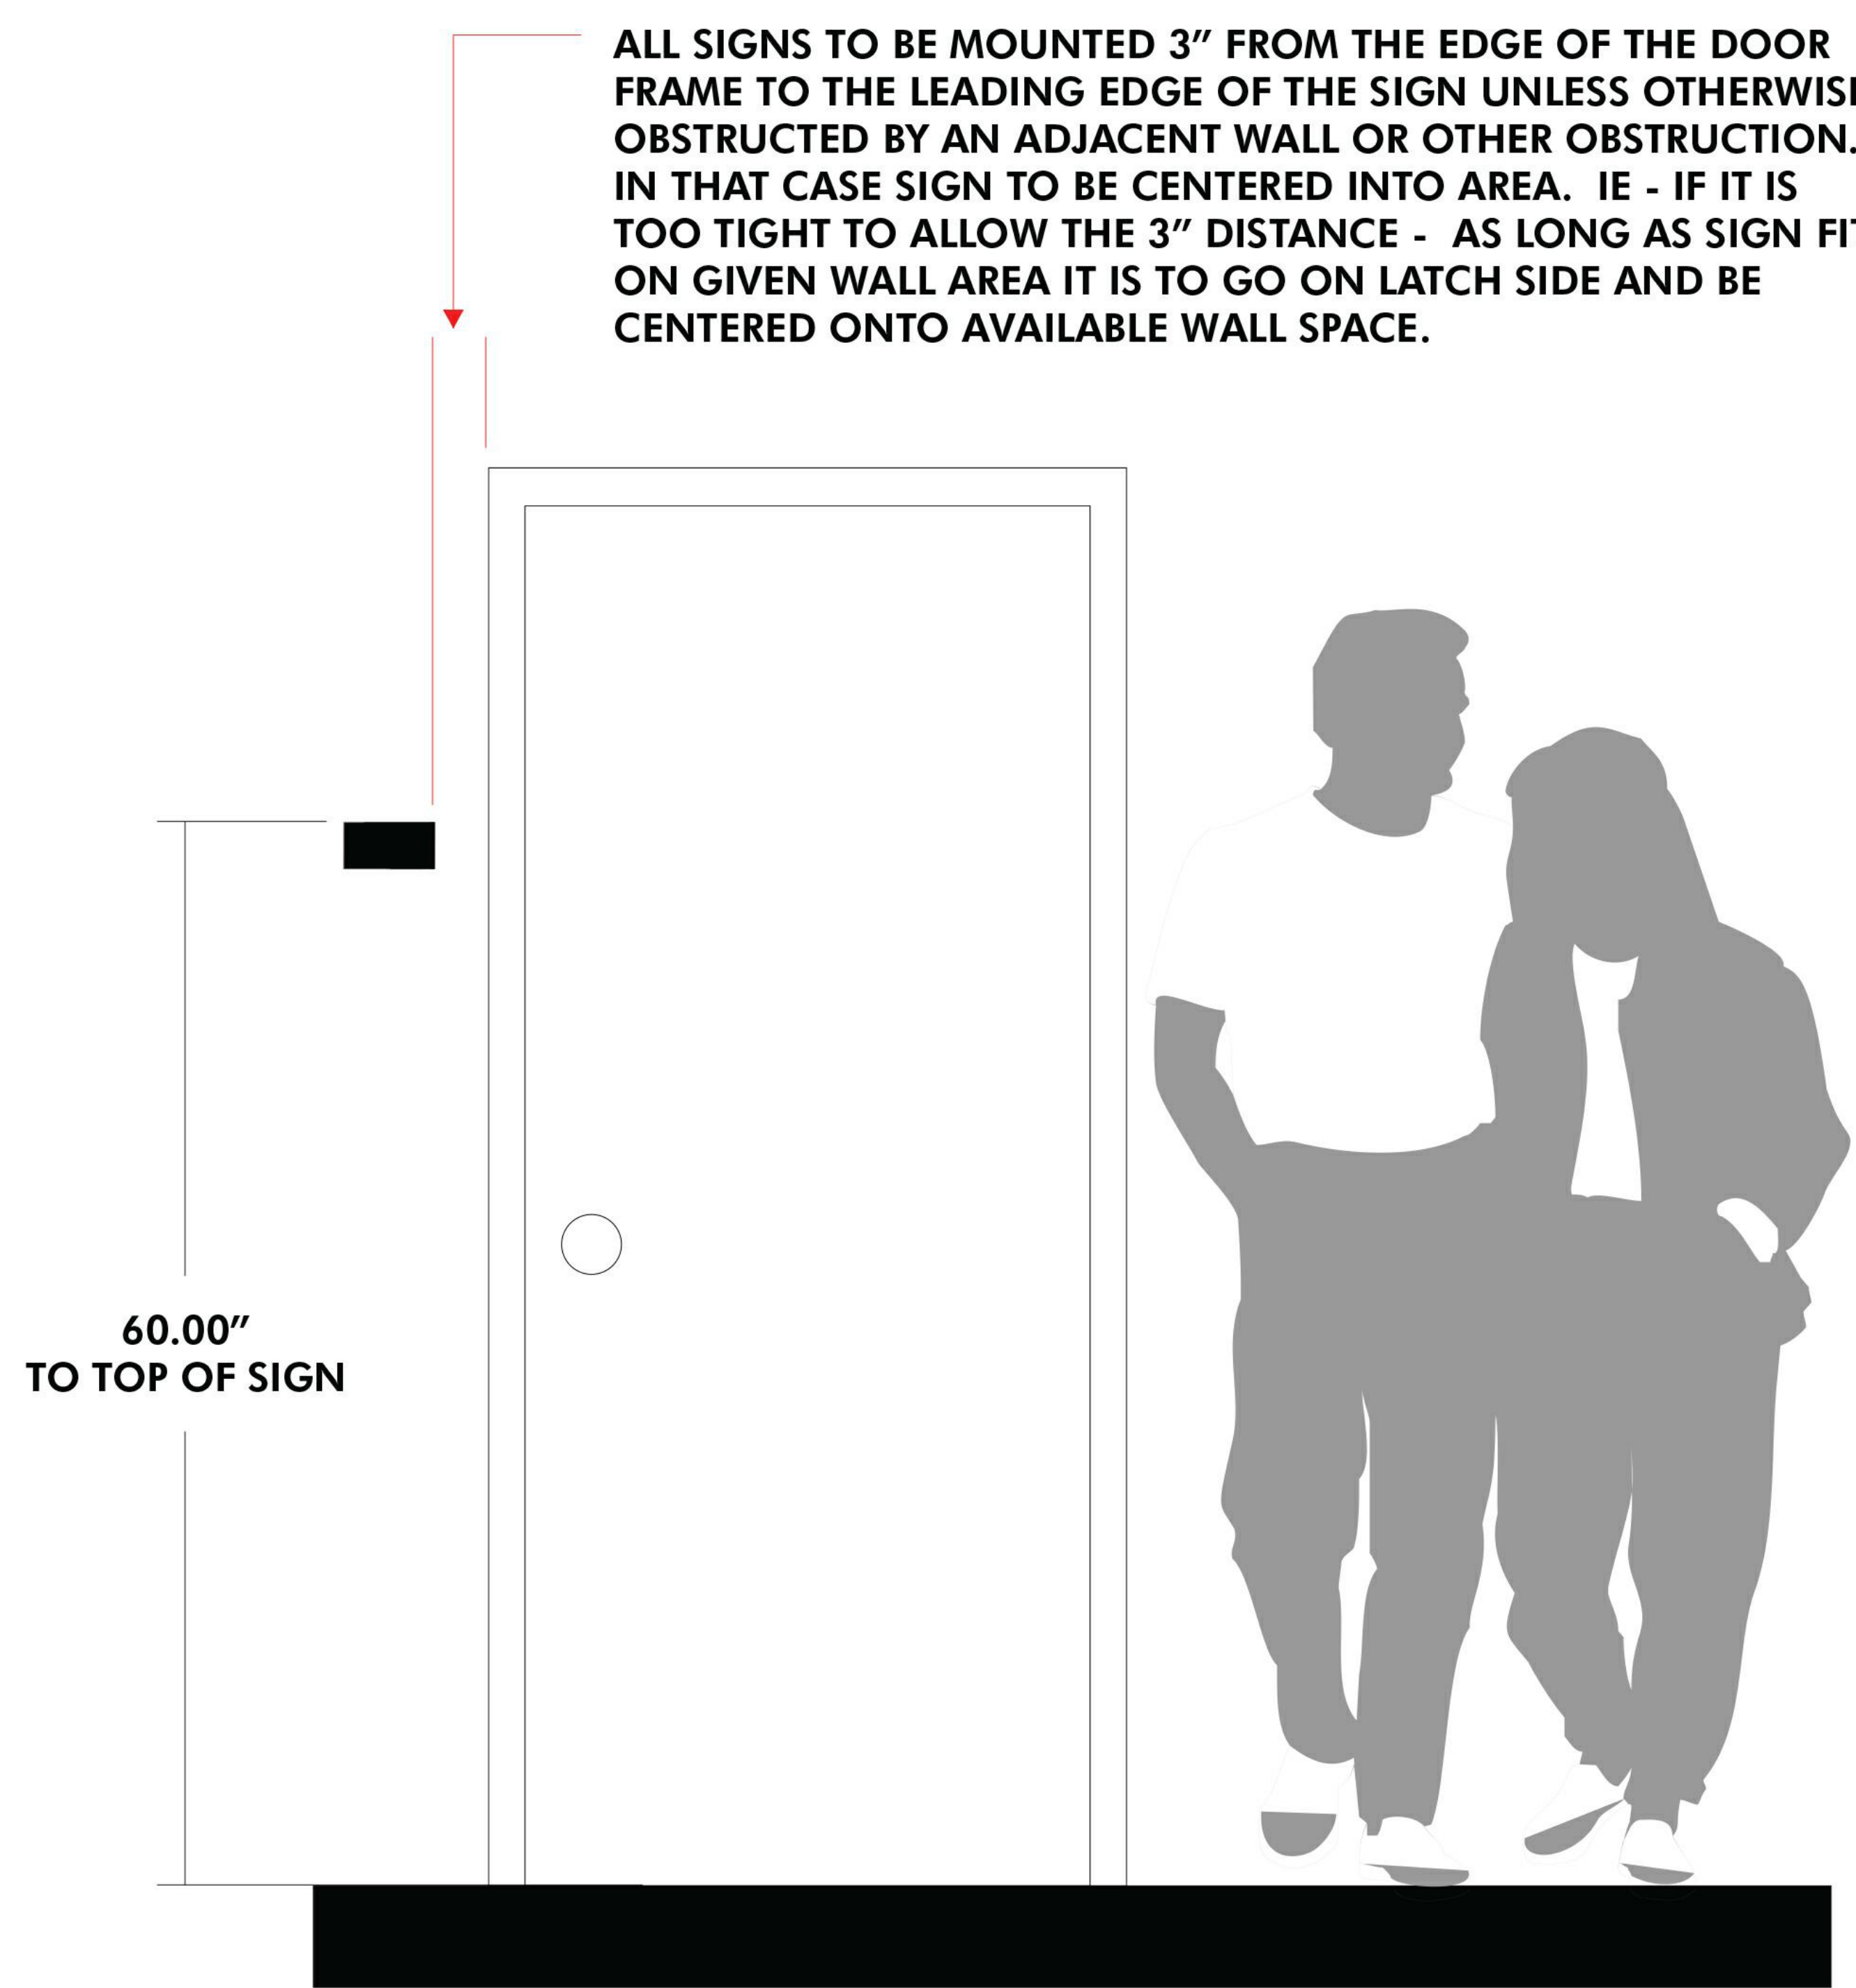

SCALE 3/4" = 1' - 0"

ALL ADA SIGNS TO BE INSTALLED ON LATCH SIDE OF DOOR

INSTALL I.S. SIGNS SO THAT TOP LINE OF BRAILLE TO BE AT 60"

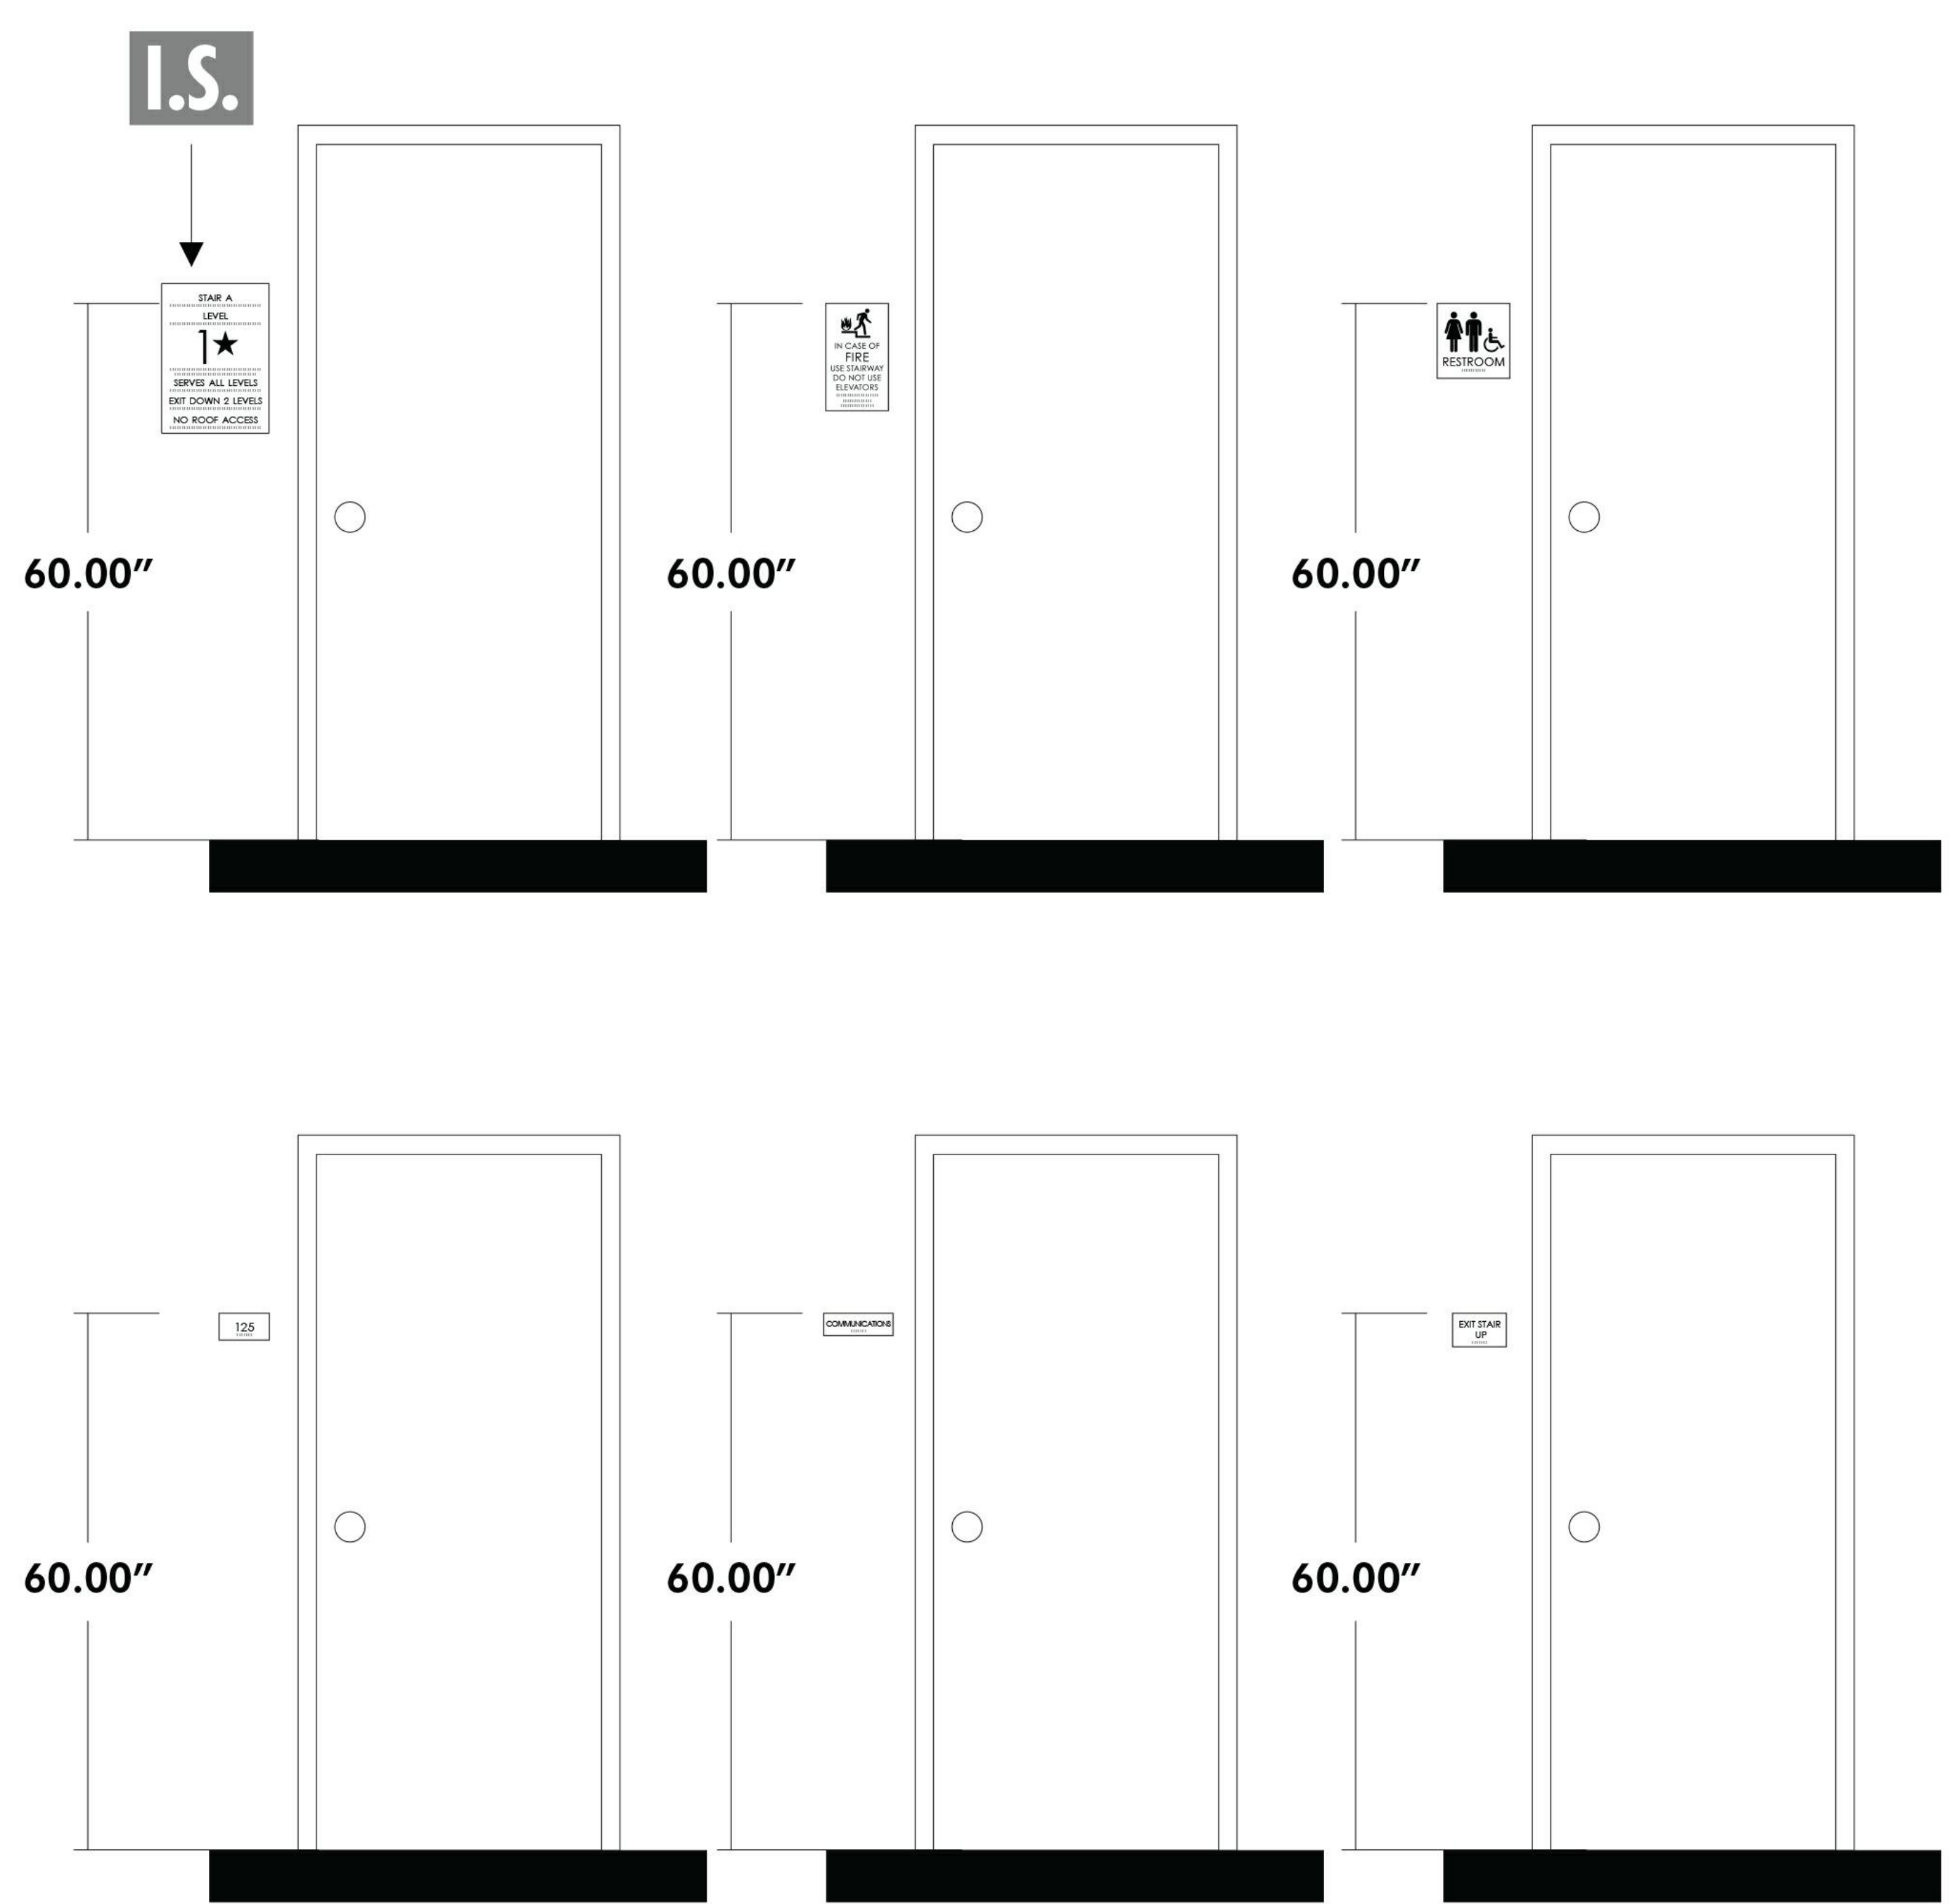

TYPICAL SIGN PROGRAM PLACEMENTS SHOWN

PLUMBING NOTES																																																																																			
GENERAL NOTES	GENERAL NOTES, CONT.	DEMOLITION NOTES																																																																																	
<p>A. ALL PLUMBING WORK SHALL COMPLY WITH ALL APPLICABLE FEDERAL, STATE AND LOCAL BUILDING CODES AND ORDINANCES INCLUDING, BUT NOT LIMITED TO, THE LEE'S SUMMIT, MISSOURI, PLUMBING AND BUILDING CODES & ORDINANCES, NFPA 13 & 14, THE AMERICAN DISABILITIES ACT AND THE LIFE SAFETY CODE. IT IS A REQUIREMENT OF THIS CONTRACT THAT THE CONTRACTOR BE EXPERIENCED IN THIS TYPE OF WORK AND BE THOROUGHLY FAMILIAR WITH THE REQUIREMENTS OF THE APPLICABLE CODES, WHETHER SPECIFICALLY REFERRED TO IN THE DOCUMENTS OR NOT.</p> <p>B. THE CONTRACTOR SHALL OBTAIN ALL NECESSARY PERMITS AND PAY ALL NECESSARY FEES FOR THE PLUMBING WORK.</p> <p>C. THE CONTRACTOR SHALL FURNISH ALL MATERIALS, EQUIPMENT, AND LABOR REQUIRED TO PROVIDE COMPLETE AND WORKING PLUMBING SYSTEMS, AS DESCRIBED IN THE CONTRACT DOCUMENTS, AND FULLY COORDINATED WITH ALL OTHER TRADES.</p> <p>D. REFER TO THE SPECIFICATIONS, THE DRAWINGS AND MANUFACTURER'S CUT SHEETS FOR COMPLETE INFORMATION ON MATERIALS AND METHODS REQUIRED TO INSTALL THE PLUMBING SYSTEMS.</p> <p>E. ALL PLUMBING WORK DONE UNDER THIS CONTRACT SHALL BE ACCOMPLISHED IN A SKILLED WORKMANLIKE AND PROFESSIONAL MANNER.</p> <p>F. ALL PLUMBING AND FIRE PROTECTION PIPING SHALL BE INDEPENDENTLY SUPPORTED, AND EACH SUPPORT SHALL BE INDEPENDENT OF PARTITION AND CEILING SYSTEM SUPPORTS. WHERE INDEPENDENT SUPPORT IS NOT POSSIBLE, AN ENGINEERED SUPPORT SYSTEM SHALL BE UTILIZED. HOLD ALL PIPING IN CEILING SPACES HIGH TO STRUCTURE AS POSSIBLE.</p> <p>G. ALL WORK SHALL BE SCHEDULED AND PERFORMED IN COORDINATION WITH ARCHITECTURAL PLANS, PROJECT SCHEDULES AND HOSPITAL OPERATIONS & REQUIREMENTS. COORDINATE ALL REQUIRED SHUT DOWN OF SYSTEMS OR OUT OF PHASE WORK WITH THE OWNER'S REPRESENTATIVE & HOSPITAL PERSONNEL.</p> <p>H. THE CONTRACTOR SHALL PROTECT THE PLUMBING EQUIPMENT AND FIXTURES FROM DAMAGE DURING HANDLING AND INSTALLATION UNTIL THE PROJECT IS COMPLETED. ANY EQUIPMENT OR FIXTURE THAT IS DAMAGED DURING CONSTRUCTION SHALL BE REPAIRED OR REPLACED AT THE ARCHITECT AND ENGINEER'S DISCRETION, AND AT THE CONTRACTOR'S EXPENSE.</p> <p>I. THE CONTRACTOR SHALL REMOVE ALL EXCESS MATERIAL AND DEBRIS AND CLEAN ALL EQUIPMENT AND FIXTURES UPON COMPLETION OF THE PROJECT.</p> <p>J. THE CONTRACTOR SHALL VISIT THE JOB SITE PRIOR TO BIDDING TO VERIFY THE EXACT SIZE AND LOCATION OF ALL EXISTING PIPING RELATED TO HIS WORK.</p> <p>K. THE CONTRACTOR SHALL COORDINATE THE PLUMBING WORK WITH ALL OTHER TRADES. WORK SHOWN ON THE DRAWINGS IS INTENDED TO PROVIDE THE OVERALL ENGINEERING DESIGN CONCEPT AND MAY REQUIRE RELOCATIONS, FIELD ADJUSTMENTS OR OFFSETS TO COORDINATE WITH OTHER TRADES AND THE BUILDING STRUCTURE. COSTS FOR ALL SUCH MINOR FIELD ADJUSTMENTS SHALL BE INCLUDED IN THE CONTRACTOR'S BID.</p> <p>L. IT IS THE REQUIREMENT OF THESE DOCUMENTS TO ALLOW ALL CEILINGS TO BE CONSTRUCTED AT HEIGHTS AS SHOWN ON THE ARCHITECTURAL DRAWINGS. COORDINATE THE LOCATION OF PIPING AND PROVIDE OFFSETS IN PIPING AS REQUIRED TO MEET THIS REQUIREMENT.</p> <p>M. THE CONTRACTOR SHALL PROVIDE DETAILED AND DIMENSIONED PIPING FABRICATION DRAWINGS FOR APPROVAL BY THE ARCHITECT/ENGINEER. ONE BLUELINE SET OF THE APPROVED DRAWINGS SHALL BE KEPT ON-SITE AT ALL TIMES AND ANY CHANGES REQUIRED IN THE FIELD SHALL BE MARKED ON THESE DRAWINGS. AT THE END OF THE PROJECT, ALL CHANGES SHALL BE TRANSFERRED TO A REPRODUCIBLE DRAWING TO BE GIVEN TO THE OWNER FOR "AS-BUILT" DRAWINGS. REPRODUCTIONS OF THIS DRAWING WILL NOT BE CONSIDERED AS PIPING FABRICATION DRAWINGS.</p> <p>N. ALL PLUMBING EQUIPMENT OR VALVES REQUIRING ACCESS THAT ARE LOCATED ABOVE GYP. BOARD OR OTHERWISE INACCESSIBLE CEILINGS SHALL BE PROVIDED WITH A CEILING ACCESS PANEL SUPPLIED AND INSTALLED BY THE GENERAL CONTRACTOR. THE MECHANICAL CONTRACTOR SHALL COORDINATE THE EXACT LOCATION OF THESE ACCESS PANELS WITH THE GENERAL CONTRACTOR.</p> <p>O. LOCATE ISOLATION VALVES FOR EQUIPMENT AND FIXTURES AS CLOSE TO THE MAIN AS POSSIBLE. PROVIDE CEILING OR WALL ACCESS PANELS AS NEEDED.</p>	<p>P. COORDINATE ALL WALL MOUNTED DEVICE LOCATIONS WITH ARCHITECTURAL INTERIOR ELEVATIONS.</p> <p>Q. ALL CONNECTIONS BETWEEN PIPES OF DISSIMILAR MATERIALS SHALL BE MADE WITH DIELECTRIC UNIONS.</p> <p>R. ALL PLUMBING PIPING SHALL BE IDENTIFIED AS DESCRIBED IN THE SPECIFICATIONS.</p> <p>S. ALL PLUMBING VALVES SHALL BE TAGGED AND NOTED ON THE "AS-BUILT" DRAWINGS.</p> <p>T. SLOPE AND ARRANGE WATER PIPING SYSTEMS TO ESTABLISH HIGH POINTS FOR AIR ELIMINATION AND LOW POINTS TO PERMIT PROPER DRAINING OF EACH SECTION.</p> <p>U. COORDINATE ALL PIPING PENETRATIONS THROUGH THE ROOF AND FLOOR WITH THE BUILDING'S STRUCTURE. REFER TO THE PLUMBING PENETRATION DETAILS, THE ARCHITECTURAL DRAWINGS AND THE PLUMBING SPECIFICATIONS FOR SLEEVEING AND SUPPORT INFORMATION.</p> <p>V. PROVIDE CLEANOUTS AT THE BASE OF ALL STORM AND SANITARY STACKS AND IN INDIVIDUAL WASTE & VENT STACKS AS SHOWN ON THE RISERS.</p> <p>W. LOCATE VENTS THROUGH THE ROOF AT LEAST 25' AWAY FROM ALL FRESH AIR INTAKES OR BUILDING OPENINGS.</p> <p>X. LOCATE ALL WALL CLEANOUTS 18" ABOVE THE FINISHED FLOOR.</p> <p>Y. PROVIDE BACKFLOW PREVENTION DEVICES APPROVED BY THE AHJ FOR ALL ITEMS OF EQUIPMENT THAT ARE REQUIRED BY THE AHJ TO HAVE CROSS CONTAMINATION PROTECTION, WHETHER SHOWN ON THE DRAWINGS OR NOT.</p> <p>Z. PROVIDE A PRV AT THE DOMESTIC WATER SERVICE ENTRANCE TO LIMIT WATER SYSTEM PRESSURE TO THE BUILDING TO 80 PSI.</p> <p>AA. RUN ALL PIPING IN WALLS, CHASES AND ABOVE THE CEILING. PROVIDE CHROME PLATED PIPING WHERE EVER PIPING HAS TO BE EXPOSED.</p> <p>BB. PROVIDE DRIP PANS UNDER PLUMBING LINES WERE REQUIRED BY CODE AND/OR THE OWNER.</p> <p>CC. PROVIDE ACCESS TO ALL VALVES AND TRAP PRIMERS.</p>	<p>A. ALL SECTIONS OF PLUMBING PIPING THAT ARE SHOWN TO BE DEMO'D SHALL BE REMOVED BACK TO MAINS, OR NEAREST ACTIVE LINES, AND CAPPED OR PLUGGED SO THAT NO DEAD ENDS ARE CREATED.</p> <p>B. ALL DEMOLITION WORK SHALL BE SCHEDULED AND PERFORMED IN STRICT COORDINATION WITH ARCHITECTURAL PHASING PLANS, HOSPITAL SCHEDULES, AREA OCCUPANCIES AND OTHER TRADES.</p> <p>C. ALL DEMOLISHED ITEMS THAT ARE NOT RETAINED BY THE OWNER AND ARE NOT CALLED OUT TO BE REINSTALLED BY THE CONTRACT DOCUMENTS SHALL BE DISPOSED OF LEGALLY.</p> <p>D. ANY EXISTING PLUMBING RISERS EXPOSED BY THE REMOVAL OF EXISTING WALLS OR CHASES SHALL BE RELOCATED TO A NEARBY LOCATION AS NOTED ON THE DRAWINGS OR AS APPROVED BY THE ARCHITECT.</p> <p>E. THE CONTRACTOR SHALL REPLACE ALL DAMAGED CEILING TILES AND REPAIR ALL DAMAGED WALL FINISHES DURING DEMOLITION WORK.</p> <p>F. PROVIDE ADDITIONAL VALVES, FITTINGS AND/OR PIPING AS NECESSARY TO PROVIDE UNINTERRUPTED SERVICE TO AREAS OUTSIDE AND INSIDE OF THE AREA WHERE WORK IS BEING PERFORMED.</p> <p>G. INFORMATION PROVIDED ON THESE DRAWINGS HAS BEEN TAKEN FROM DESIGN DRAWINGS AND FIELD OBSERVATIONS. THE CONTRACTOR SHALL VERIFY ALL EXISTING CONDITIONS PRIOR TO PRICING AND COMMENCEMENT OF WORK.</p> <p>H. ALL EXISTING PIPING THAT IS CAPPED OFF OR PLUGGED DURING DEMOLITION SHALL BE CHECKED FOR LEAKS.</p> <p>I. PROVIDE AND INSTALL ALL NECESSARY PIPING AND ACCESSORIES REQUIRED TO MAINTAIN SERVICE TO ALL "EXISTING TO REMAIN" FIXTURES AND EQUIPMENT THAT MAY BE INTERRUPTED DURING DEMOLITION.</p> <p>J. WHERE EXISTING MECHANICAL EQUIPMENT IS DEMOLISHED, REMOVE ALL RELATED PLUMBING TO THE EQUIPMENT AND THEIR ASSOCIATED PIPING BACK TO THE POINT OF ORIGIN.</p> <p>K. ANY FLOOR DRAIN OR FLOOR SINK INDICATED TO BE REMOVED SHALL BE REMOVED COMPLETELY.</p> <p>L. EXISTING FIXTURES AND EQUIPMENT NOT INDICATED TO BE REMOVED SHALL REMAIN IN USE.</p>																																																																																	
<table><tr><th colspan="3">PLUMBING ABBREVIATIONS</th></tr><tr><td>ABV</td><td>ABOVE</td><td>GPM</td></tr><tr><td>ABF</td><td>ABOVE FINISHED FLOOR</td><td>GW</td></tr><tr><td>AFG</td><td>ABOVE FINISH GRADE</td><td>HB</td></tr><tr><td>AP</td><td>ACCESS PANEL</td><td>HD</td></tr><tr><td>AD</td><td>AREA DRAIN</td><td>HW</td></tr><tr><td>BFF</td><td>BELOW FINISH FLOOR</td><td>HWR</td></tr><tr><td>BIG</td><td>BELOW GRADE</td><td>I.E.</td></tr><tr><td>BV</td><td>BALANCING VALVE</td><td>L</td></tr><tr><td>CA</td><td>COMPRESSED AIR</td><td>MH</td></tr><tr><td>CO</td><td>CLEAN OUT</td><td>MS</td></tr><tr><td>CSB</td><td>CLINICAL SERVICE SINK</td><td>NC</td></tr><tr><td>CW</td><td>COLD WATER</td><td>NO</td></tr><tr><td>DD</td><td>DECK DRAIN</td><td>NFWH</td></tr><tr><td>DF</td><td>DRINKING FOUNTAIN</td><td>NFYH</td></tr><tr><td>DN</td><td>DOWN</td><td>OS&V</td></tr><tr><td>DS</td><td>DOWNSPOUT</td><td>PD</td></tr><tr><td>DSN</td><td>DOWNSPOUT NOZZLE</td><td>PRV</td></tr><tr><td>ESH</td><td>EMERGENCY SHOWER</td><td>TMV</td></tr><tr><td>EW</td><td>EYE WASH</td><td>T&P</td></tr><tr><td>EWC</td><td>ELECTRIC WATER COOLER</td><td>VALVE</td></tr><tr><td>FCVA</td><td>FLOOR CONTROL VALVE ASSEMBLY</td><td>TP</td></tr><tr><td>FCO</td><td>FLOOR CLEANOUT</td><td>V</td></tr><tr><td>FD</td><td>FLOOR DRAIN</td><td>VB</td></tr><tr><td>FS</td><td>FLOOR SINK</td><td>VTR</td></tr><tr><td>GC</td><td>GENERAL CONTRACTOR</td><td>WB</td></tr><tr><td>GCO</td><td>GRADE CLEANOUT</td><td>WALL BOX</td></tr></table>	PLUMBING ABBREVIATIONS			ABV	ABOVE	GPM	ABF	ABOVE FINISHED FLOOR	GW	AFG	ABOVE FINISH GRADE	HB	AP	ACCESS PANEL	HD	AD	AREA DRAIN	HW	BFF	BELOW FINISH FLOOR	HWR	BIG	BELOW GRADE	I.E.	BV	BALANCING VALVE	L	CA	COMPRESSED AIR	MH	CO	CLEAN OUT	MS	CSB	CLINICAL SERVICE SINK	NC	CW	COLD WATER	NO	DD	DECK DRAIN	NFWH	DF	DRINKING FOUNTAIN	NFYH	DN	DOWN	OS&V	DS	DOWNSPOUT	PD	DSN	DOWNSPOUT NOZZLE	PRV	ESH	EMERGENCY SHOWER	TMV	EW	EYE WASH	T&P	EWC	ELECTRIC WATER COOLER	VALVE	FCVA	FLOOR CONTROL VALVE ASSEMBLY	TP	FCO	FLOOR CLEANOUT	V	FD	FLOOR DRAIN	VB	FS	FLOOR SINK	VTR	GC	GENERAL CONTRACTOR	WB	GCO	GRADE CLEANOUT	WALL BOX	<div><div>PROJECT DESIGN CRITERIA</div><div><div>LOCATION:</div><div>CITY/STATE:</div><div>LEE'S SUMMIT, MO</div></div><div><div>APPLICABLE CODES:</div><div>BUILDING MECHANICAL PLUMBING</div><div>FIRE PROTECTION ELECTRICAL</div><div>2018 INTERNATIONAL BUILDING CODE 2018 INTERNATIONAL MECHANICAL CODE 2018 INTERNATIONAL PLUMBING CODE 2018 INTERNATIONAL FIRE CODE 2017 INTERNATIONAL ELECTRICAL CODE</div></div></div>	
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PROJECT DESIGN CRITERIA	
LOCATION:	LEE'S SUMMIT, MO
CITY/STATE:	
APPLICABLE CODES:	
BUILDING:	2018 INTERNATIONAL BUILDING CODE
MECHANICAL:	2018 INTERNATIONAL MECHANICAL CODE
PLUMBING:	2018 INTERNATIONAL PLUMBING CODE
FIRE:	2018 INTERNATIONAL FIRE CODE
ELECTRICAL:	2017 INTERNATIONAL ELECTRICAL CODE

PLUMBING PIPING MATERIAL SCHEDULE	
DOMESTIC WATER	
ABOVE GROUND PIPING NPS 2 AND SMALLER	
1. HARD COPPER TUBE, ASTM B 88, TYPE L WATER TUBE, DRAWN TEMPER	
2. HARD COPPER TUBE, ASTM B 88, TYPE L, COPPER PRESSURE-SEAL FITTINGS, AND PRESSURE-SEAL JOINTS.	
UNDER-BUILDING-SLAB, DOMESTIC WATER PIPING, NPS 2 AND SMALLER	
1. SOFT COPPER TUBE, ASTM B 88, TYPE K, NO JOINTS BELOW GRADE.	
SANITARY WASTE AND VENT	
ABOVE GROUND SOIL AND WASTE PIPING	
1. SERVICE CLASS, CAST-IRON SOIL PIPE AND FITTINGS; GASKETS, AND GASKETED JOINTS.	
2. HUBLESS CAST-IRON SOIL PIPE AND FITTINGS; HEAVY-DUTY SHIELDED, STAINLESS-STEEL COUPLINGS, AND HUBLESS-COUPUNG JOINTS.	
3. COPPER DWV TUBE, COPPER DRAINAGE FITTINGS, AND SOLDERED JOINTS.	
ABOVE GROUND VENT PIPING	
1. SERVICE CLASS, CAST-IRON SOIL PIPE AND FITTINGS; GASKETS, AND GASKETED JOINTS.	
2. HUBLESS CAST-IRON SOIL PIPE AND FITTINGS; HEAVY-DUTY SHIELDED, STAINLESS-STEEL COUPLINGS, AND HUBLESS-COUPUNG JOINTS.	
3. COPPER DWV TUBE, COPPER DRAINAGE FITTINGS, AND SOLDERED JOINTS.	
UNDER GROUND SOIL AND WASTE PIPING	
1. SERVICE CLASS, CAST-IRON SOIL PIPING; GASKETS, AND GASKETED JOINTS.	
2. SOLID WALL PVC PIPE, PVC SOCKET FITTINGS, AND SOLVENT-CEMENTED JOINTS.	

PLUMBING SYMBOLS			
ALL SYMBOLS SHOWN MAY NOT APPEAR IN ALL DRAWINGS			
SYMBOL	DESCRIPTION	SYMBOL	DESCRIPTION
	DOMESTIC COLD WATER (CW)		PRESSURE GAUGE WITH GAUGE COOK
	DOMESTIC HOT WATER (HW)		THERMOMETER WITH GAUGE COOK
	DOMESTIC HOT WATER RETURN (HWR)		HOSE BIBB (HB)
	NON-POTABLE WATER		FLOOR CLEANOUT OR GRADE CLEANOUT (FCO, GCO)
	TRAP PRIMER LINE (1/2")		WALL CLEANOUT (WCO)
	TEMPERED WATER		CLEANOUT PLUG
	COLD OR HOT REDUCED PRESSURE PRINCIPLE BACKFLOW PREVENTER (RP2)		DIRECTION OF SLOPE - GRAVITY PIPING
	EXISTING PIPING TO REMAIN		DIRECTION OF FLOW - PRESSURE PIPING
	EXISTING PIPING TO BE REMOVED		PIPING CAPPED OFF
	SANITARY SEWER/WASTE PIPING		BALANCING VALVE
	INDIRECT VENT PIPING		STRAINER
	INDIRECT WASTE		SHOCK ARRESTOR
	CONNECT NEW TO EXISTING		HUB DRAIN (HD)
	STORM DRAIN PIPING		FLOOR DRAIN (FD)
	OVERFLOW STORM DRAIN PIPING		LEGEND NOTE
	COMPRESSED AIR PIPING		FUEL OIL SUPPLY PIPING
	GREASY WASTE		FUEL OIL RETURN PIPING
	SUBSOIL/PERIMETER DRAIN PIPING		DRY FIRE STANDPIPE PIPING
	BUTTERFLY VALVE		SPRINKLER PIPING
	BALL VALVE		DRY SPRINKLER PIPING
	GLOBE VALVE		FIRE PROTECTION PIPING
	TEMPERATURE AND PRESSURE RELIEF VALVE		CONNECT TO EXISTING
	GAS COOK / PLUG VALVE		DEMOLISH TO
	SOLENOID VALVE		
	PRESSURE REGULATING VALVE		
	AQUASTAT		
	CHECK VALVE		
	GATE VALVE		

Devenney GROUP

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Consultant:

STATE OF MISSOURI
JONATHAN DICKERT
NUMBER
PE-2021039369
EXPIRATION DATE
05/29/2025
WSP USA Buildings Inc. 2013001881

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ADMINISTRATION RELOCATION

HCA - LEE'S SUMMIT MEDICAL CENTER

LEE'S SUMMIT, MO 64063

AUTHORITY HAVING JURISDICTION:
CITY OF LEE'S SUMMIT BUILDING DEPT.
MISSOURI DHSS

FACILITY NUMBER:
0972400009

AGENCY APPROVALS:

REVISIONS		
REV #	DESCRIPTION	DATE
A	CITY - 2ND REVIEW	2025/05/29

DATE:	04/18/2025
SCALE:	1/8" = 1'-0"
DRAWN:	CD
REVIEWED:	LW
JOB NUMBER:	6406.24


GENERAL INFORMATION - PLUMBING

P00-00

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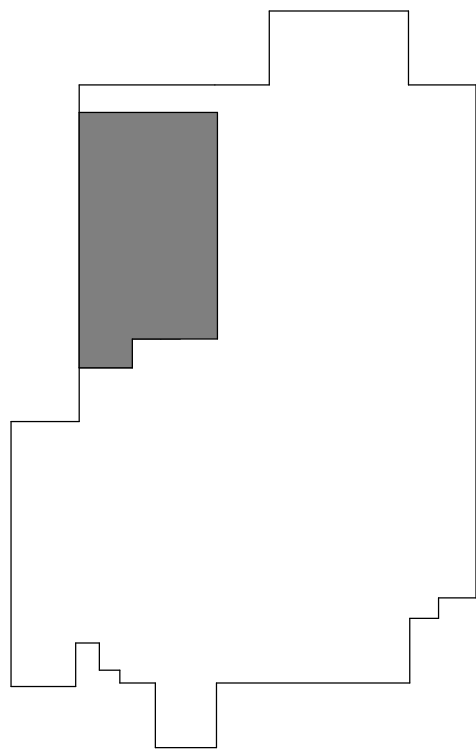
GENERAL NOTES

A. REFER TO P00-00 FOR GENERAL PLUMBING NOTES AND SYMBOLS.

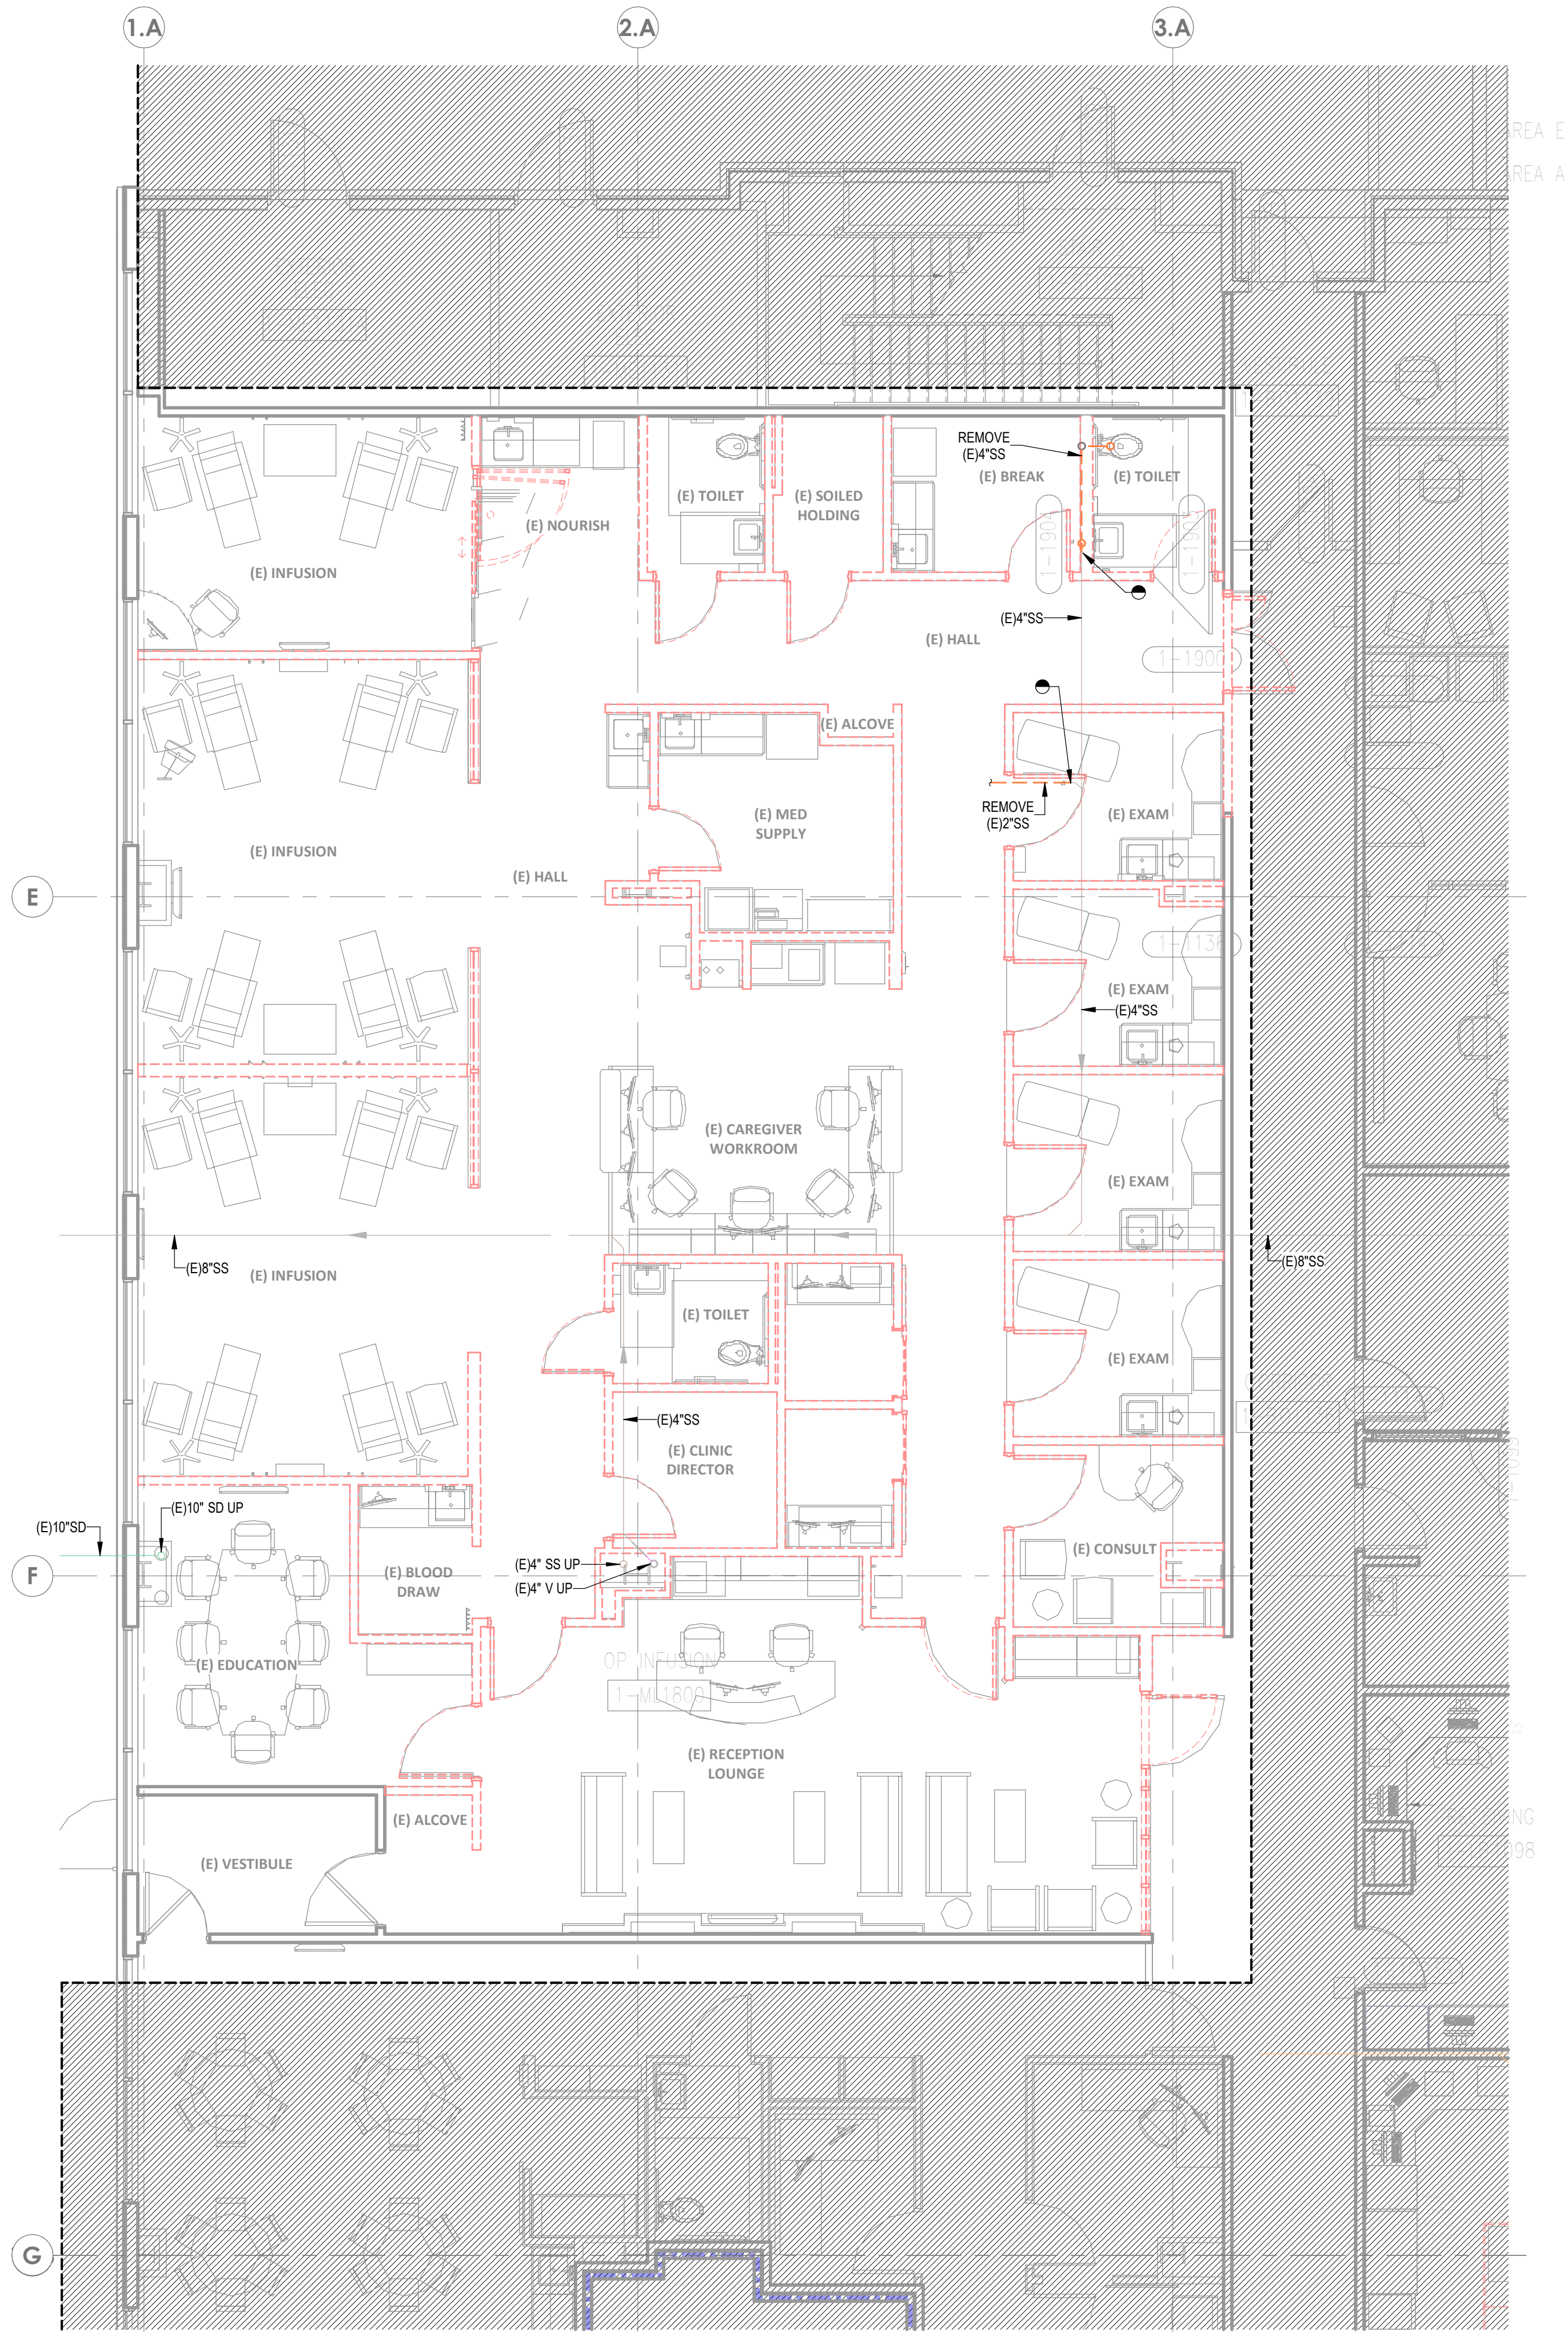

1 UNDERFLOOR DEMOLITION PLAN - PLUMBING
3/16" = 1'-0"

LEVEL 1 - KEYPLAN



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05/29/2025
WSP USA Buildings Inc. 2013001881

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ADMINISTRATION
RELOCATION

HCA - LEE'S SUMMIT MEDICAL
CENTER
2000 SE BLUE PKWY
LEE'S SUMMIT, MO 64063

AUTHORITY HAVING JURISDICTION:
CITY OF LEE'S SUMMIT BUILDING DEPT.
MISSOURI DHSS

FACILITY NUMBER:
097240009

AGENCY APPROVALS:


REVISIONS		
REV #	DESCRIPTION	DATE
A	CITY - 2ND REVIEW	2025/05/29

DATE: 04/18/2025
SCALE: As indicated
DRAWN: CD
REVIEWED: LW
JOB NUMBER: 6406.24

UNDERFLOOR DEMOLITION
PLAN - ADMIN - PLUMBING


PD02-00

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1 DEMOLITION PLAN - LEVEL 1 - ADMIN - PLUMBING
3/16\"/>

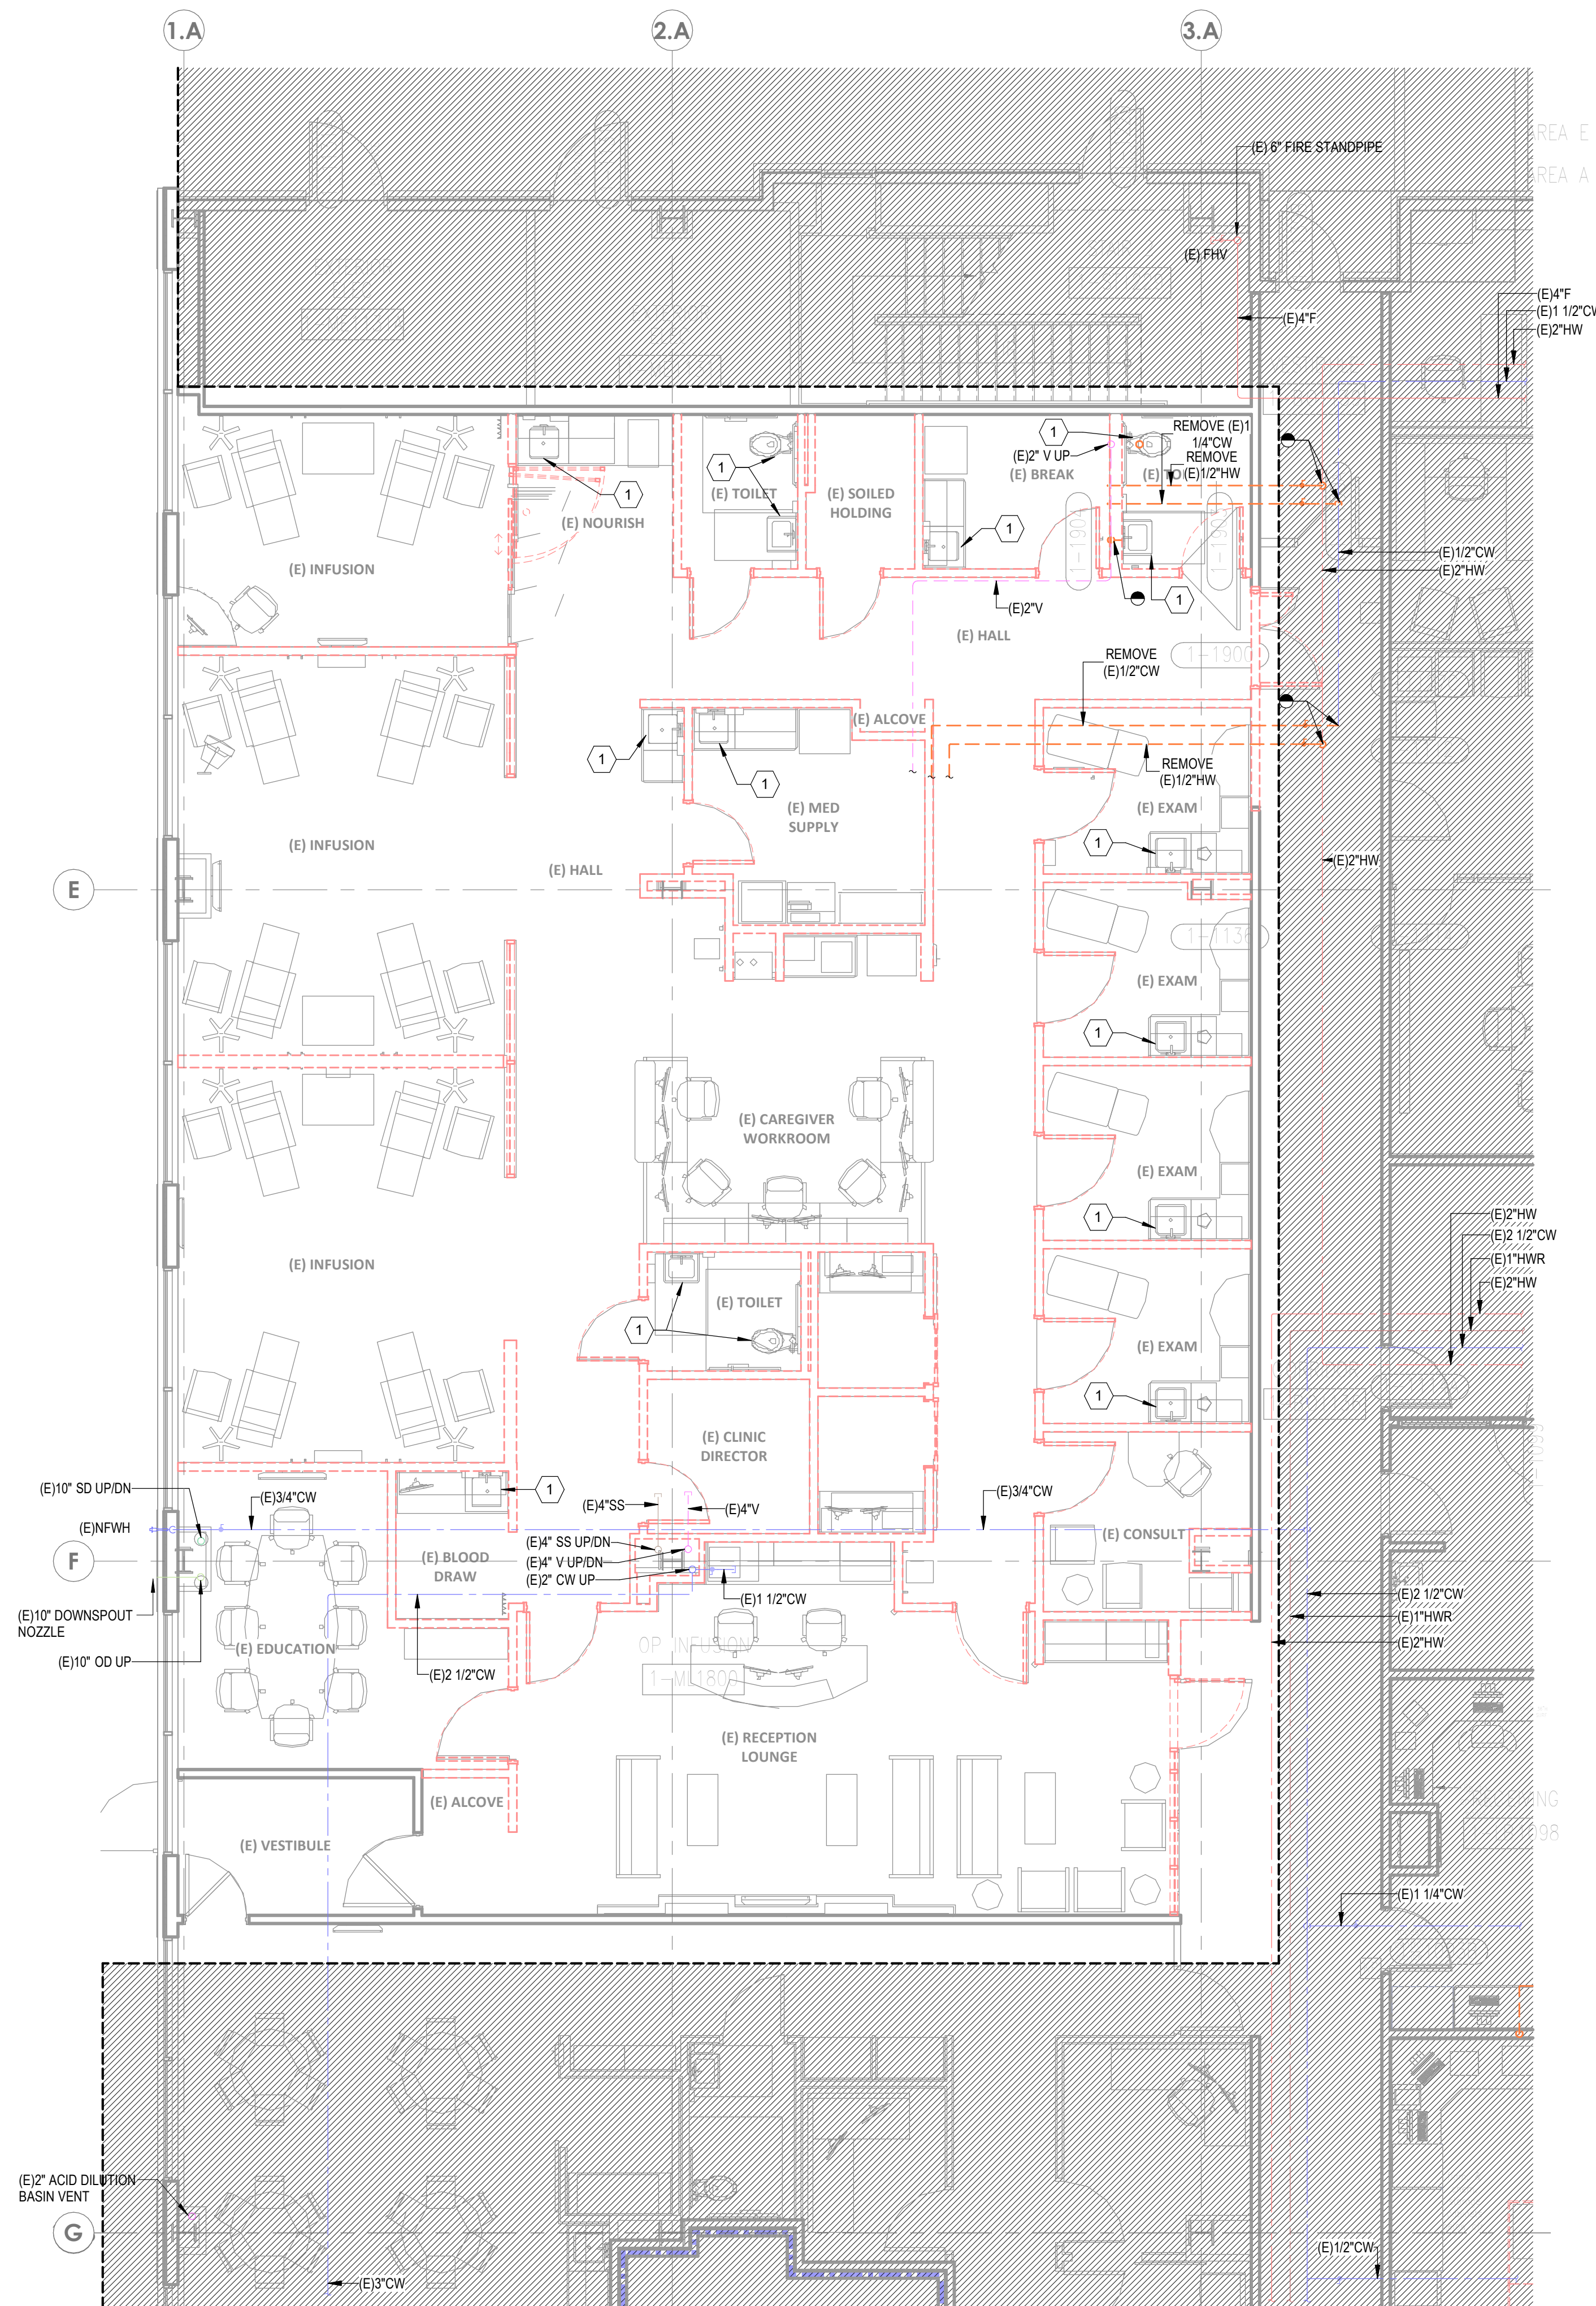LEVEL 1 - KEYPLAN



GENERAL NOTES

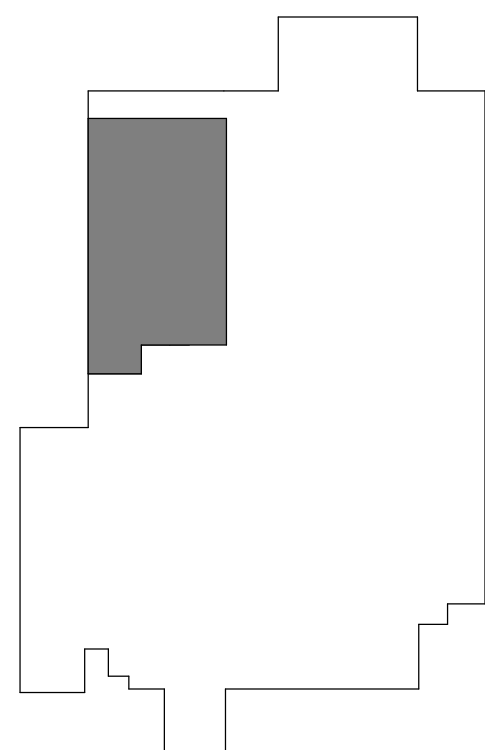A. REFER TO P00-00 FOR GENERAL PLUMBING NOTES AND SYMBOLS.

LEGEND NOTES

1. DEMOLISH EXISTING PLUMBING FIXTURE AND ASSOCIATED WATER, WASTE, AND VENT PIPING BACK TO MAIN AND CAP.




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Consultant:



05/29/2025
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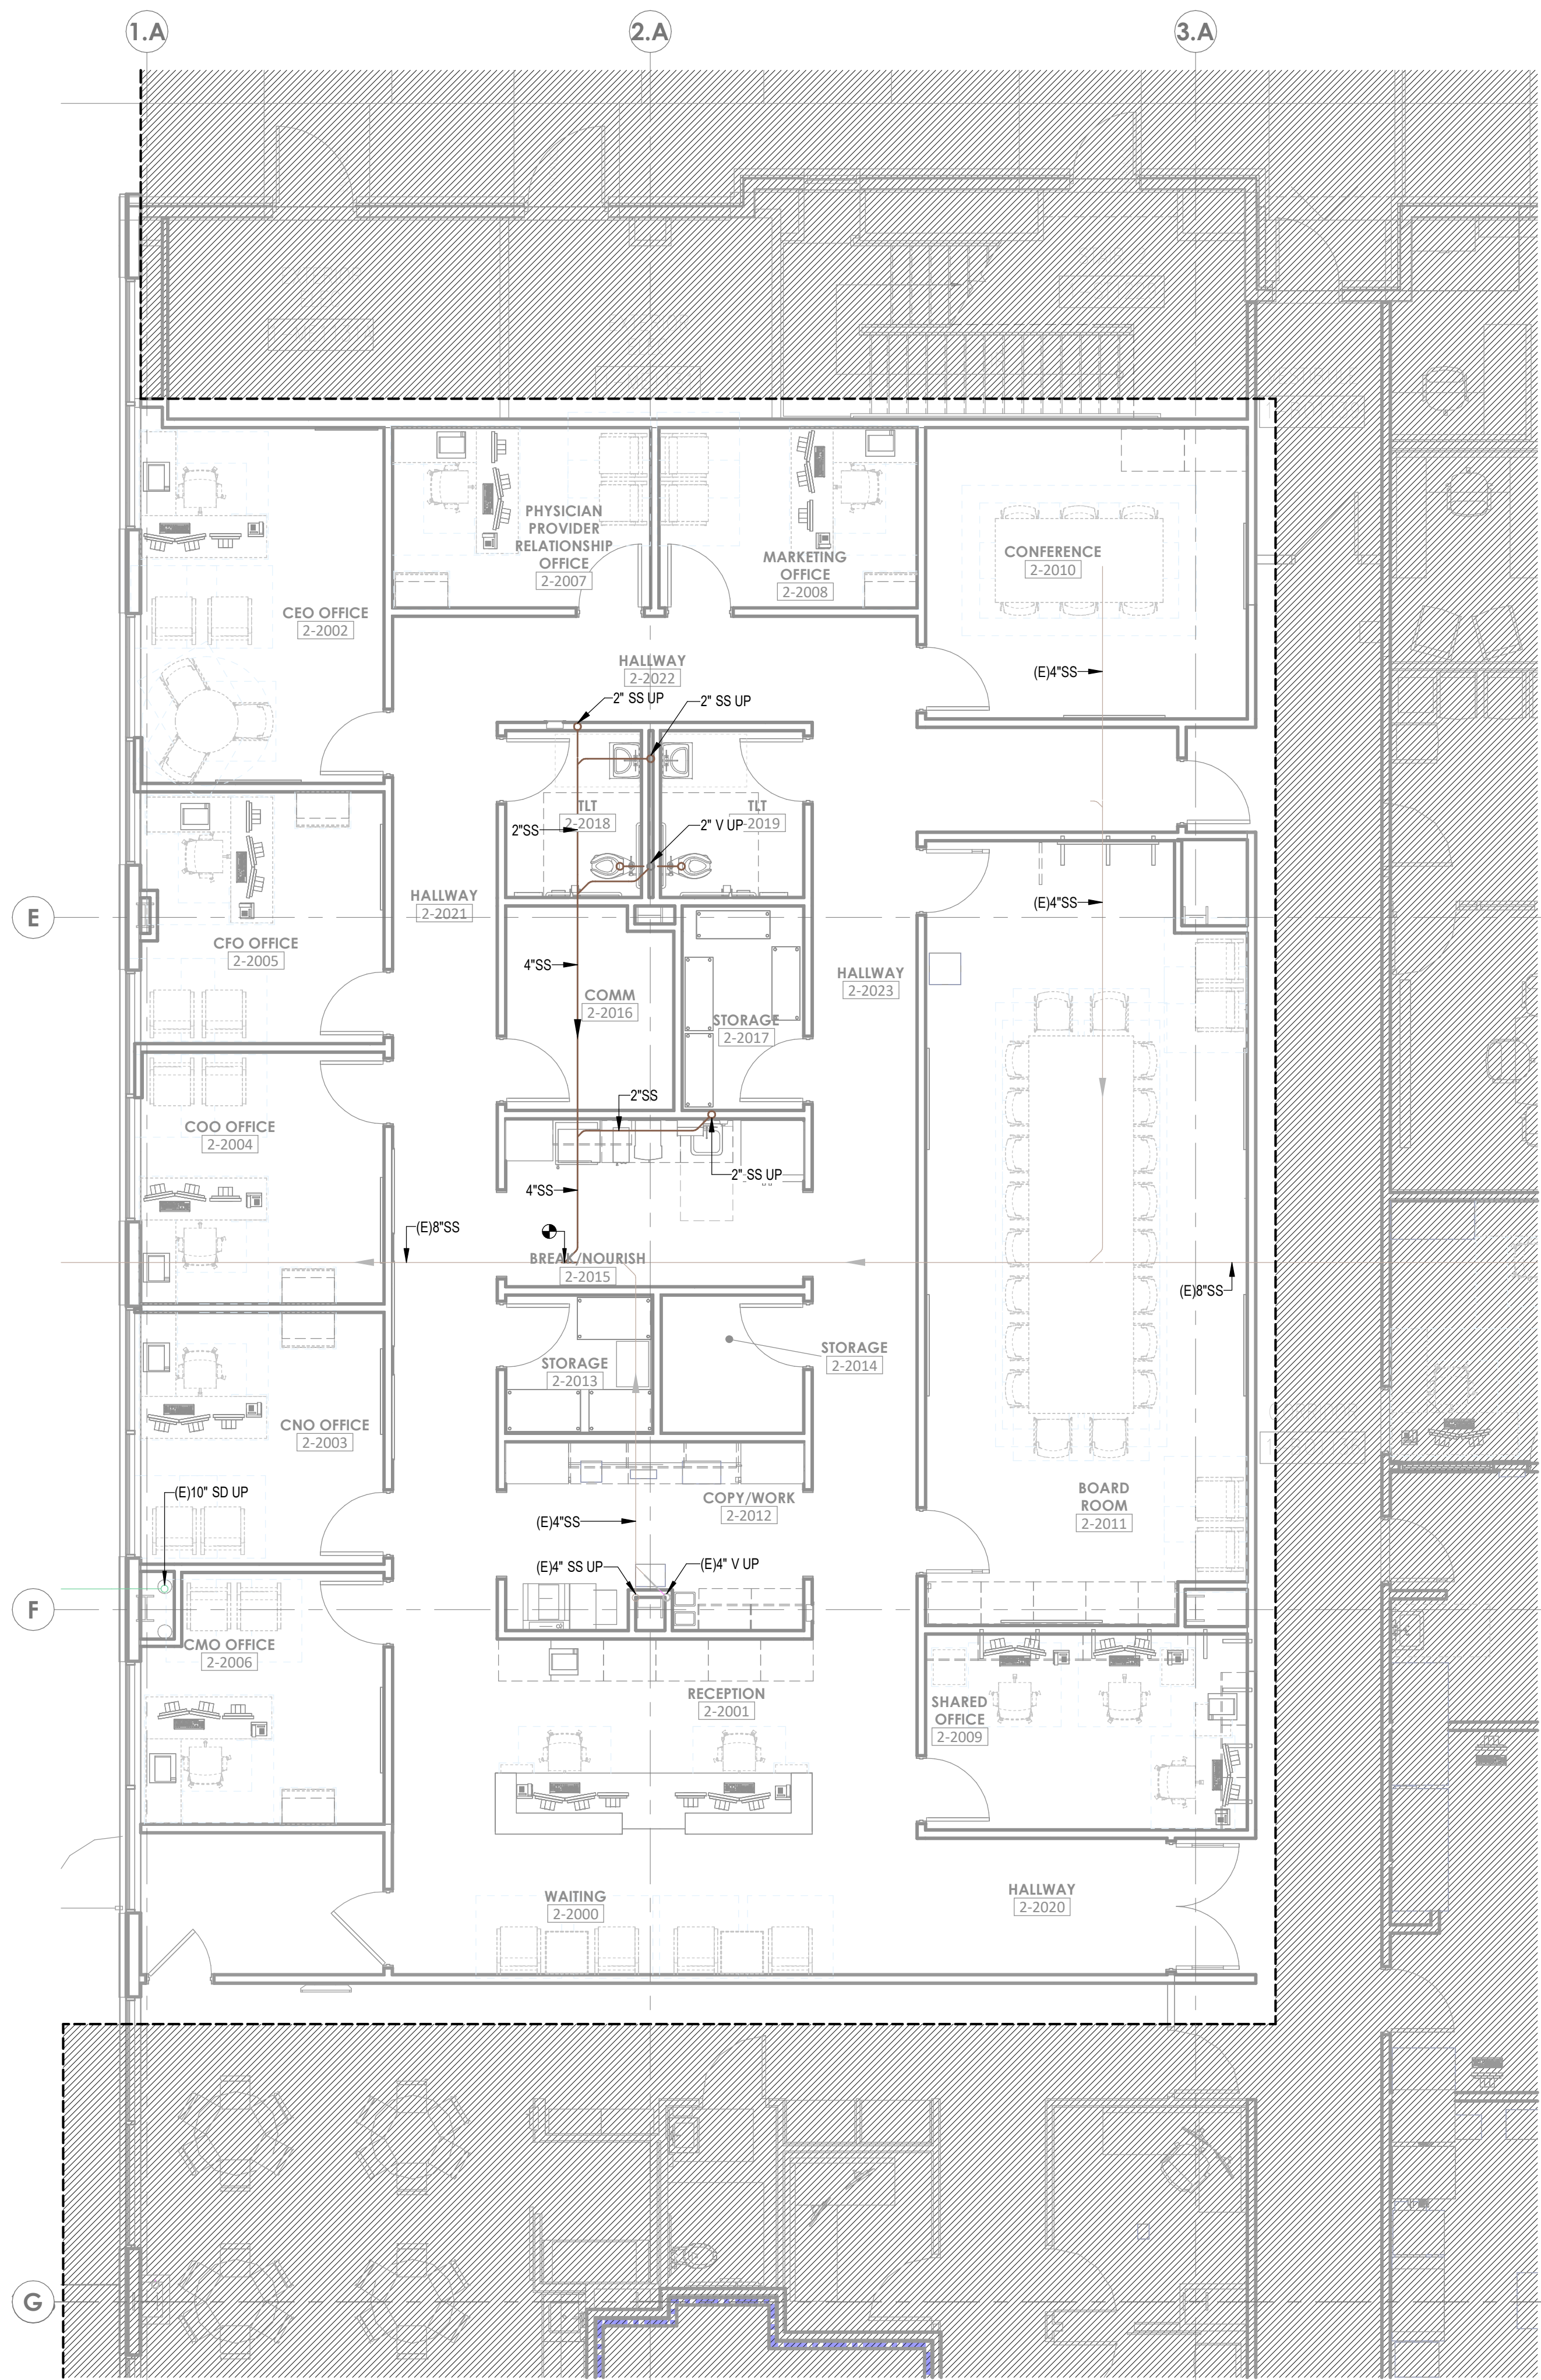
AGENCY APPROVALS:

REVISIONS		
REV #	DESCRIPTION	DATE
A	CITY - 2ND REVIEW	2025/05/29


DATE: 04/18/2025
SCALE: As indicated
DRAWN: CD
REVIEWED: LW
JOB NUMBER: 6406.24

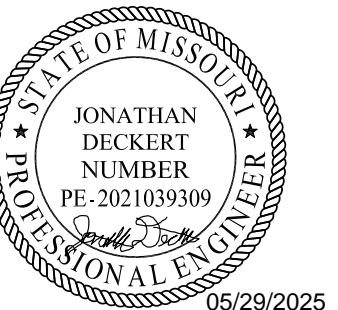DEMOLITION PLAN - LEVEL 1
- ADMIN - PLUMBING

PD02-01



1 UNDERFLOOR PLAN - ADMIN - PLUMBING
3/16" = 1'-0"

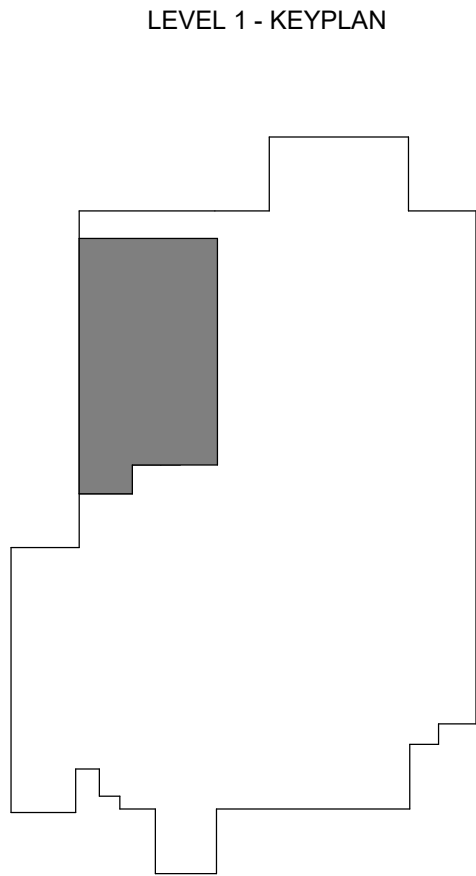


GENERAL NOTES

A. REFER TO P00-00 FOR GENERAL PLUMBING NOTES AND SYMBOLS.



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Consultant:

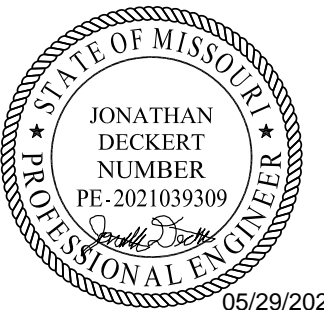

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ADMINISTRATION
RELOCATION

HCA - LEE'S SUMMIT MEDICAL
CENTER
2000 SE BLUE PKWY
LEE'S SUMMIT, MO 64063

AUTHORITY HAVING JURISDICTION:
CITY OF LEE'S SUMMIT BUILDING DEPT.
MISSOURI DHSS

FACILITY NUMBER:
097240009

AGENCY APPROVALS:

REVISIONS		
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UNDERFLOOR PLAN -
ADMIN - PLUMBING


P02-00

6/4/2025 1:04:25 PM Autodesk Docx/6406.24 - HCA - Lee's Summit Medical Center (LSMC) - 1723/MEP - LSNC Admin Relocation R23.rvt Notice of Alternate Billing or Payment Cycle: The Owner may plan to make payments on an alternative schedule. A written description of such billing or payment cycle applicable to the Project is available from the Owner or the Owner's designated agent upon request.



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ADMINISTRATION RELOCATION

HCA - LEE'S SUMMIT MEDICAL
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2000 SE BLUE PKWY
LEE'S SUMMIT, MO 64063
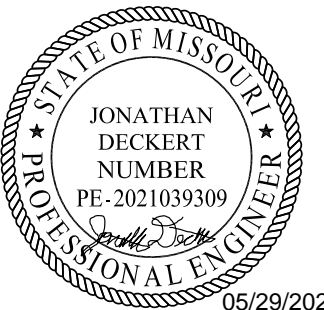
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MISSOURI DHSS

FACILITY NUMBER:
0972400009


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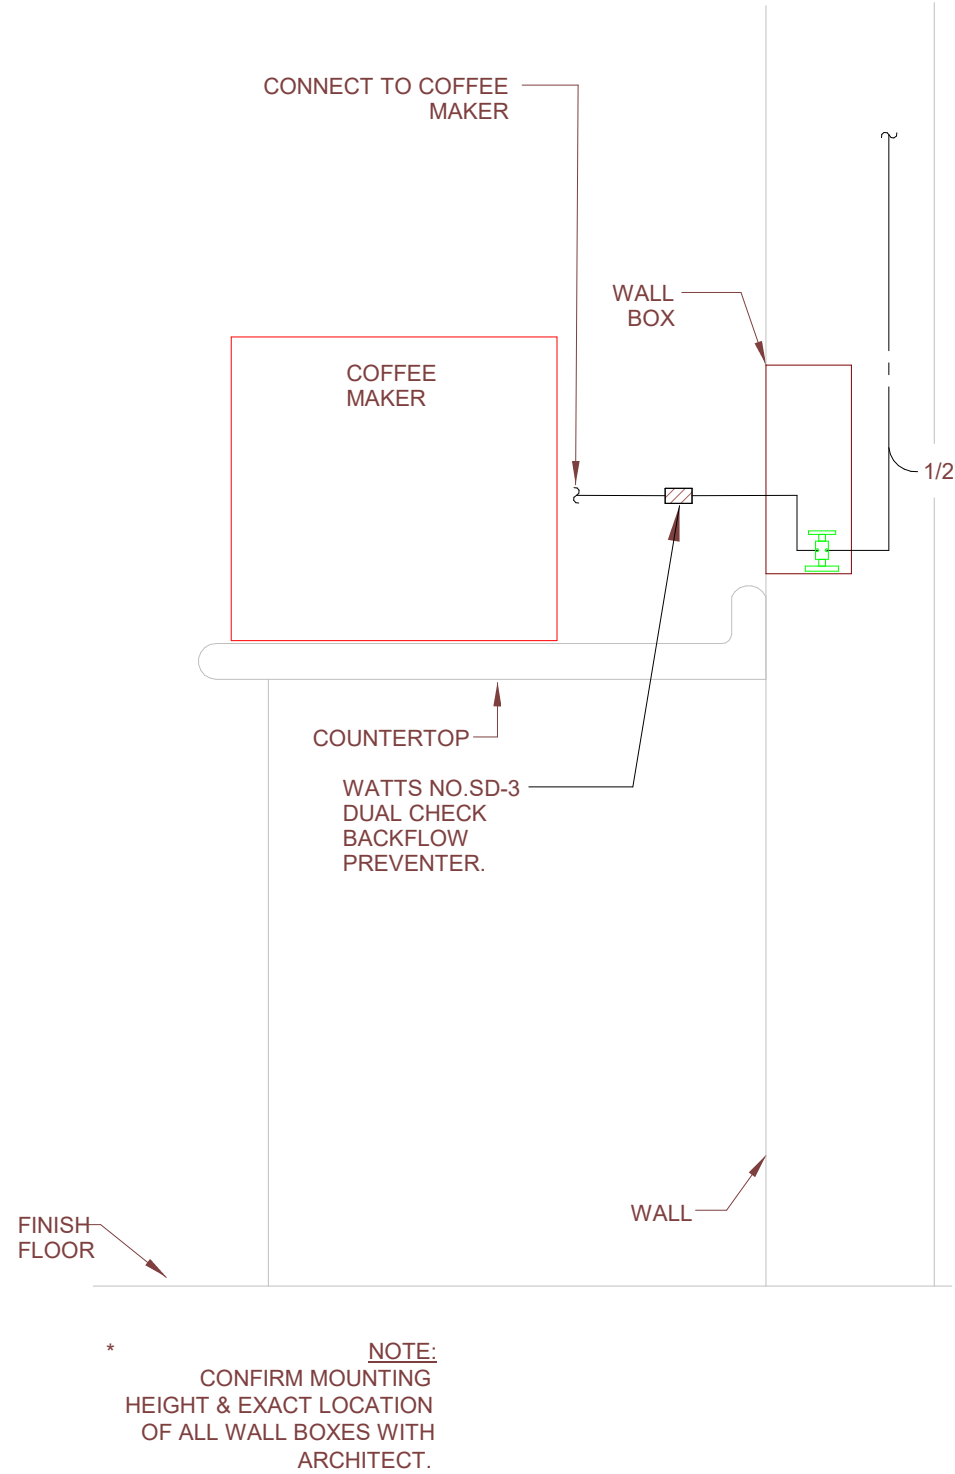
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SCALE: NOT TO SCALE
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DETAILS - PLUMBING


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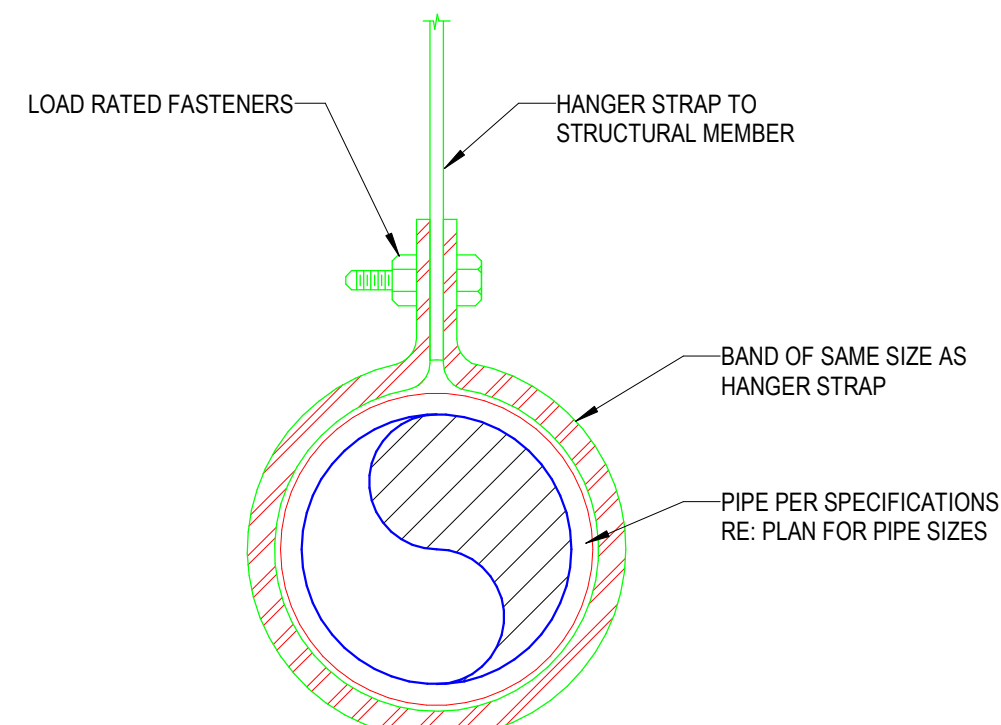
6 INSULATED PIPE THRU WALL - ABOVE GRADE
NOT TO SCALE




8 COFFEE MAKER DETAIL
NOT TO SCALE

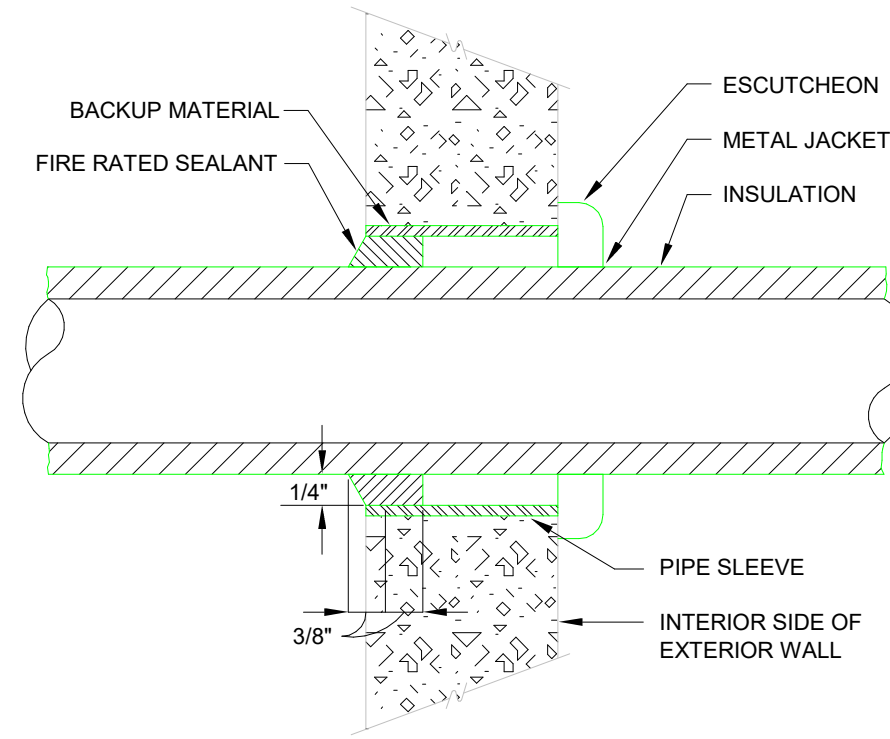


5 WATER HAMMER ARRESTOR (PISTON TYPE) DETAIL
NOT TO SCALE

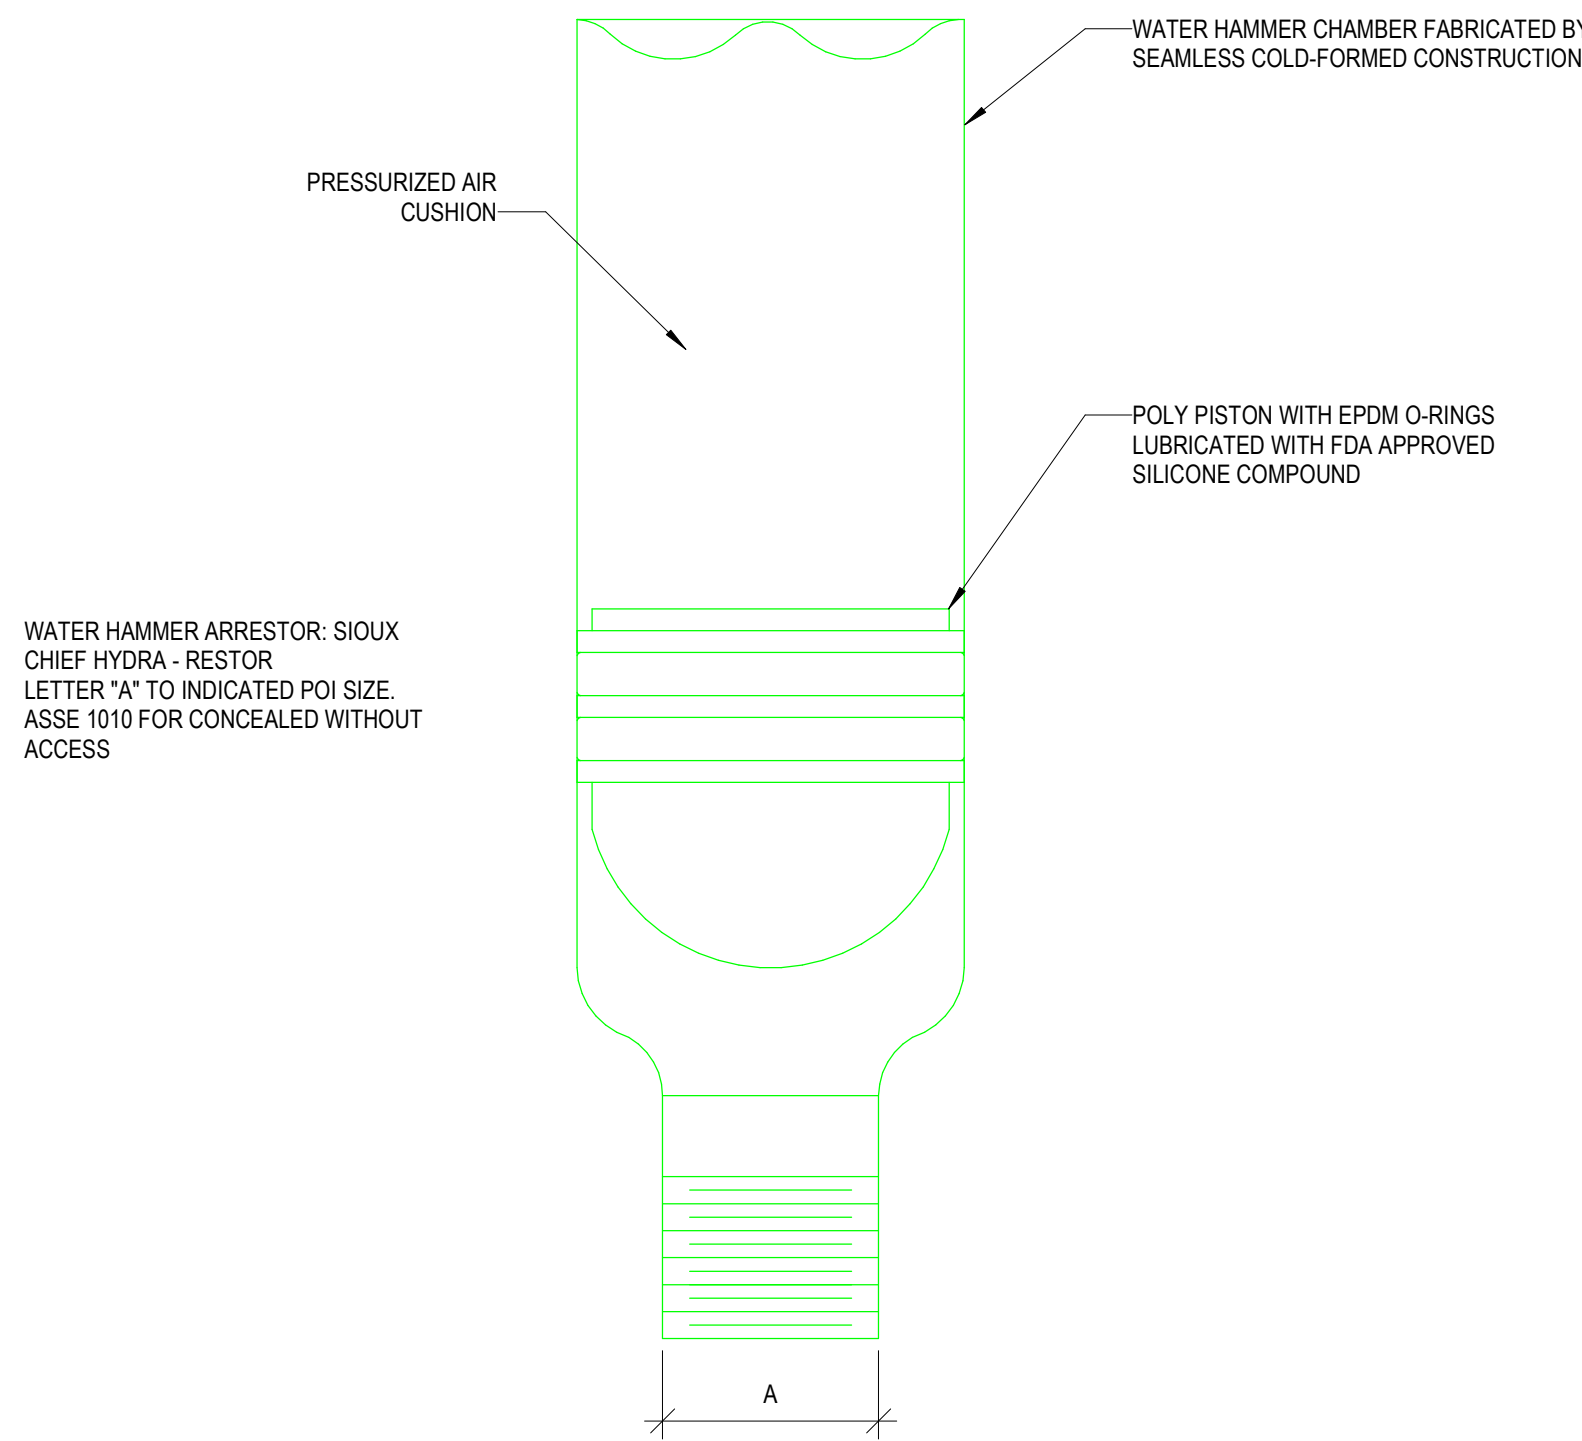


7 PIPE HANGER/SUPPORT DETAIL
NOT TO SCALE

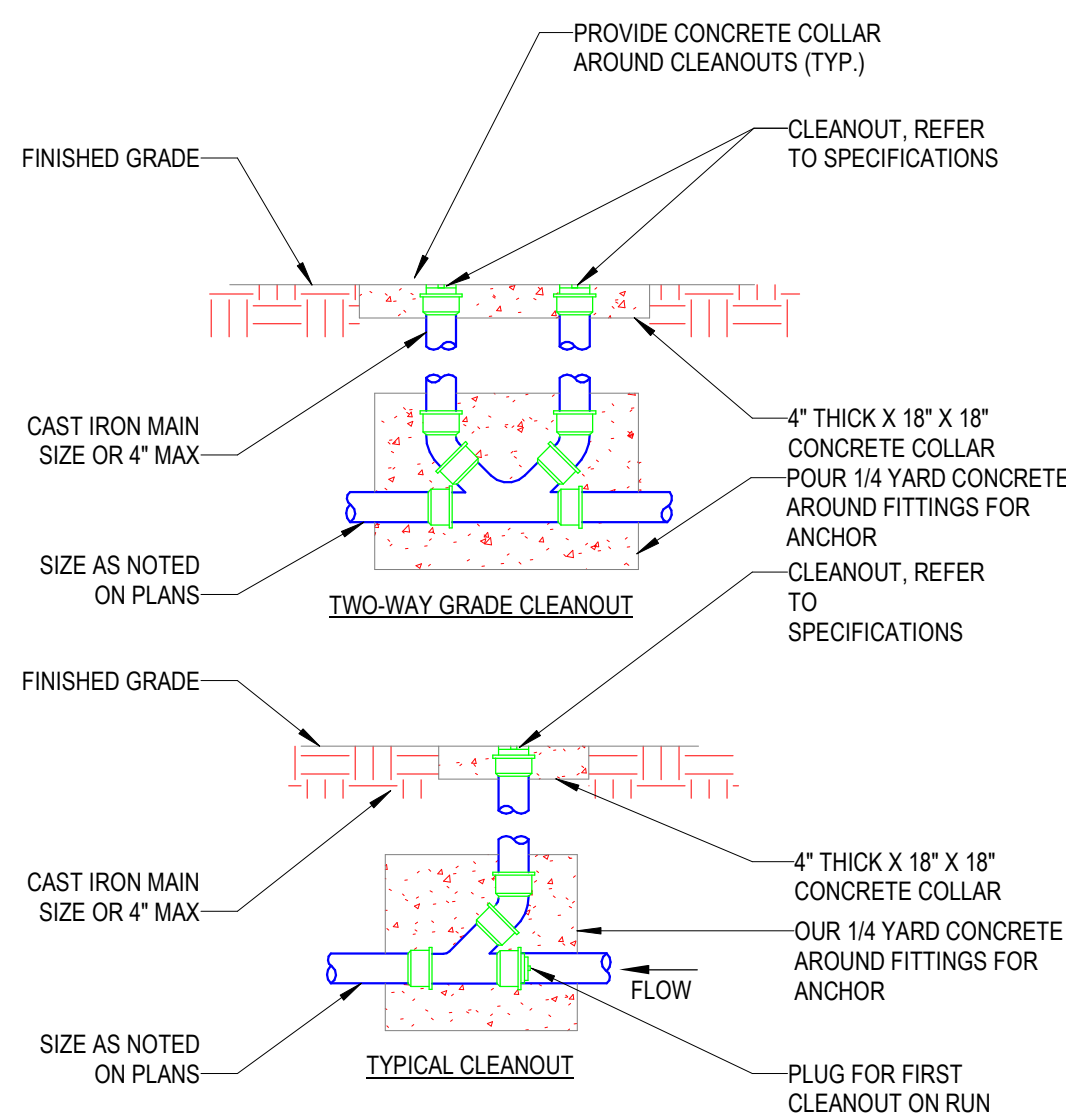


4 CLEANOUT DETAILS
NOT TO SCALE

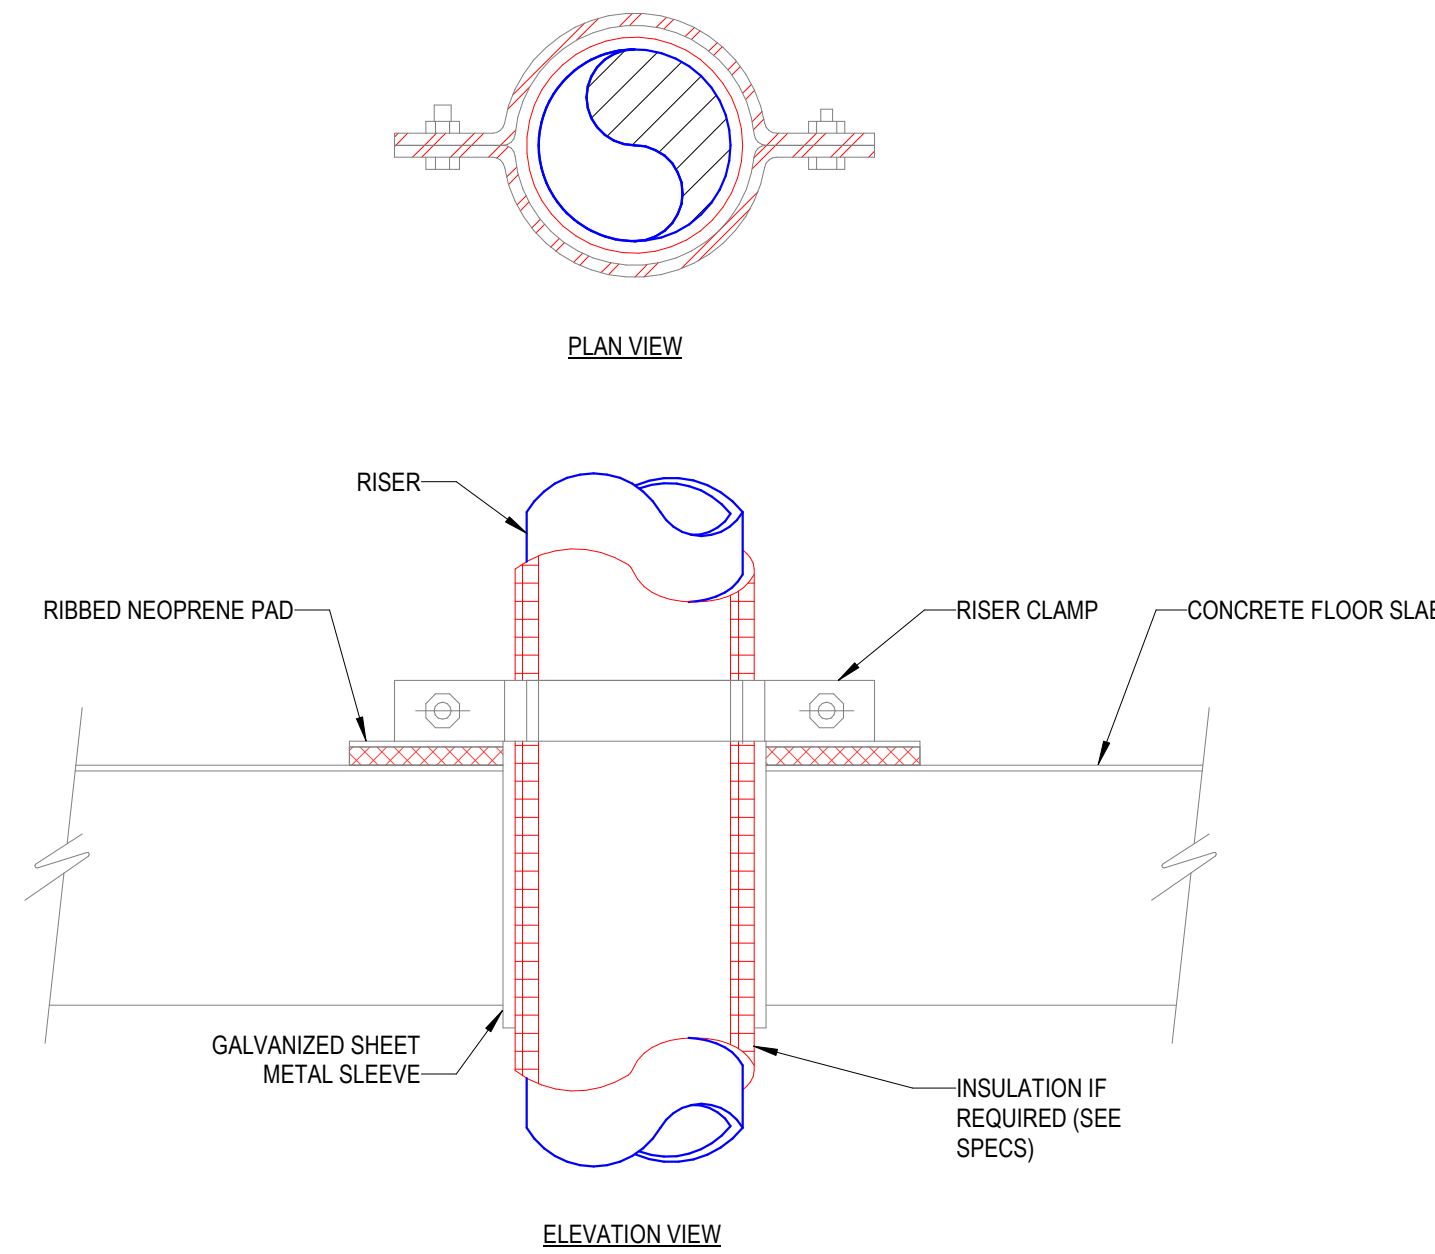

3 TYPICAL FLOOR PENETRATION DETAIL
NOT TO SCALE

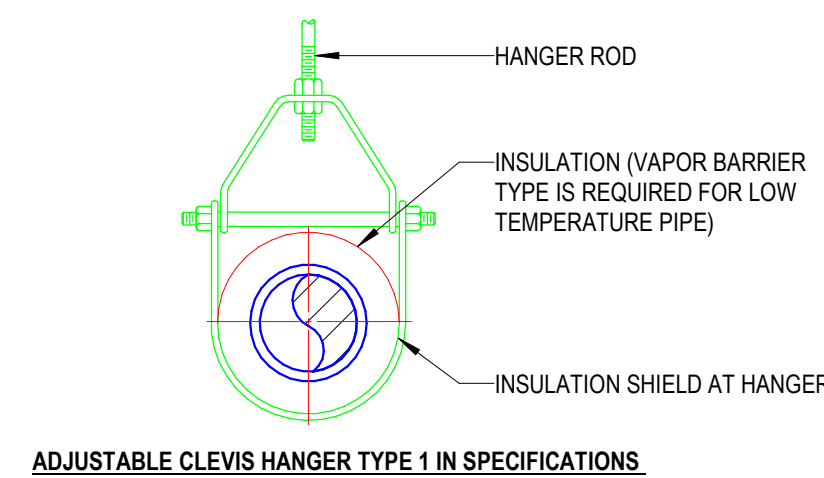


2 PIPE SUPPORT DETAILS
NOT TO SCALE

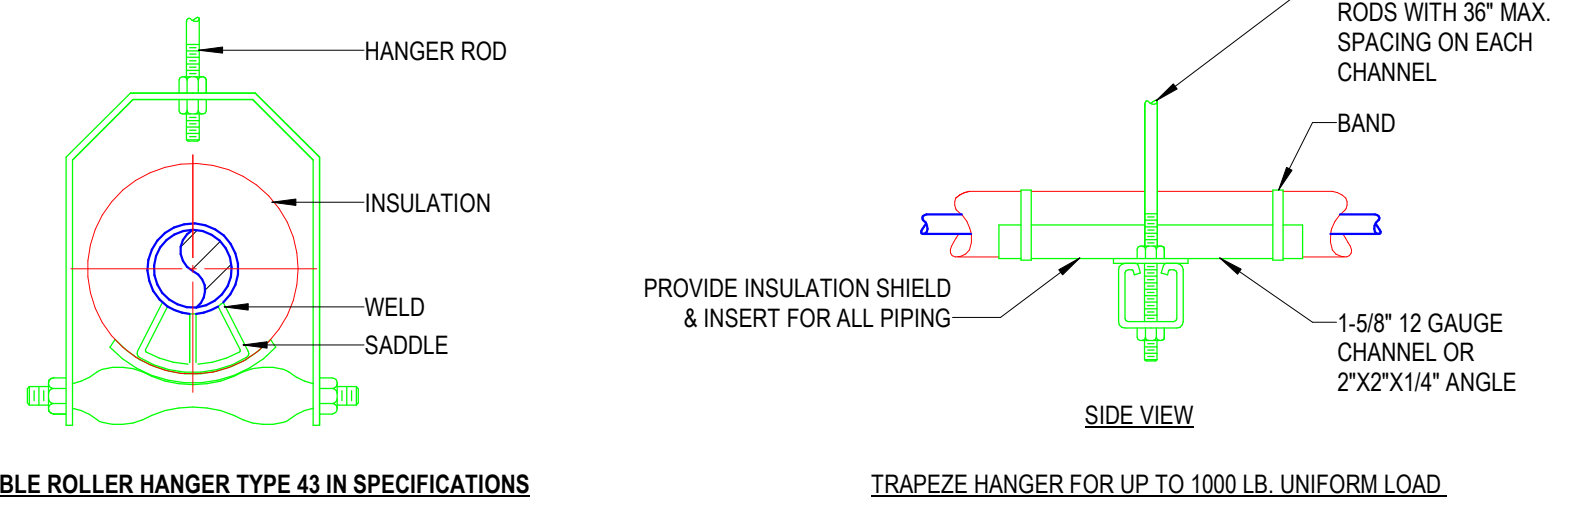

1 TRAPEZE PIPE HANGER DETAILS
NOT TO SCALE

GENERAL NOTES:
A. REFER TO SPECIFICATIONS FOR METHODS & MATERIALS.
B. REFER TO SPECIFICATION SECTION 018703 FOR SEISMIC REQUIREMENTS.

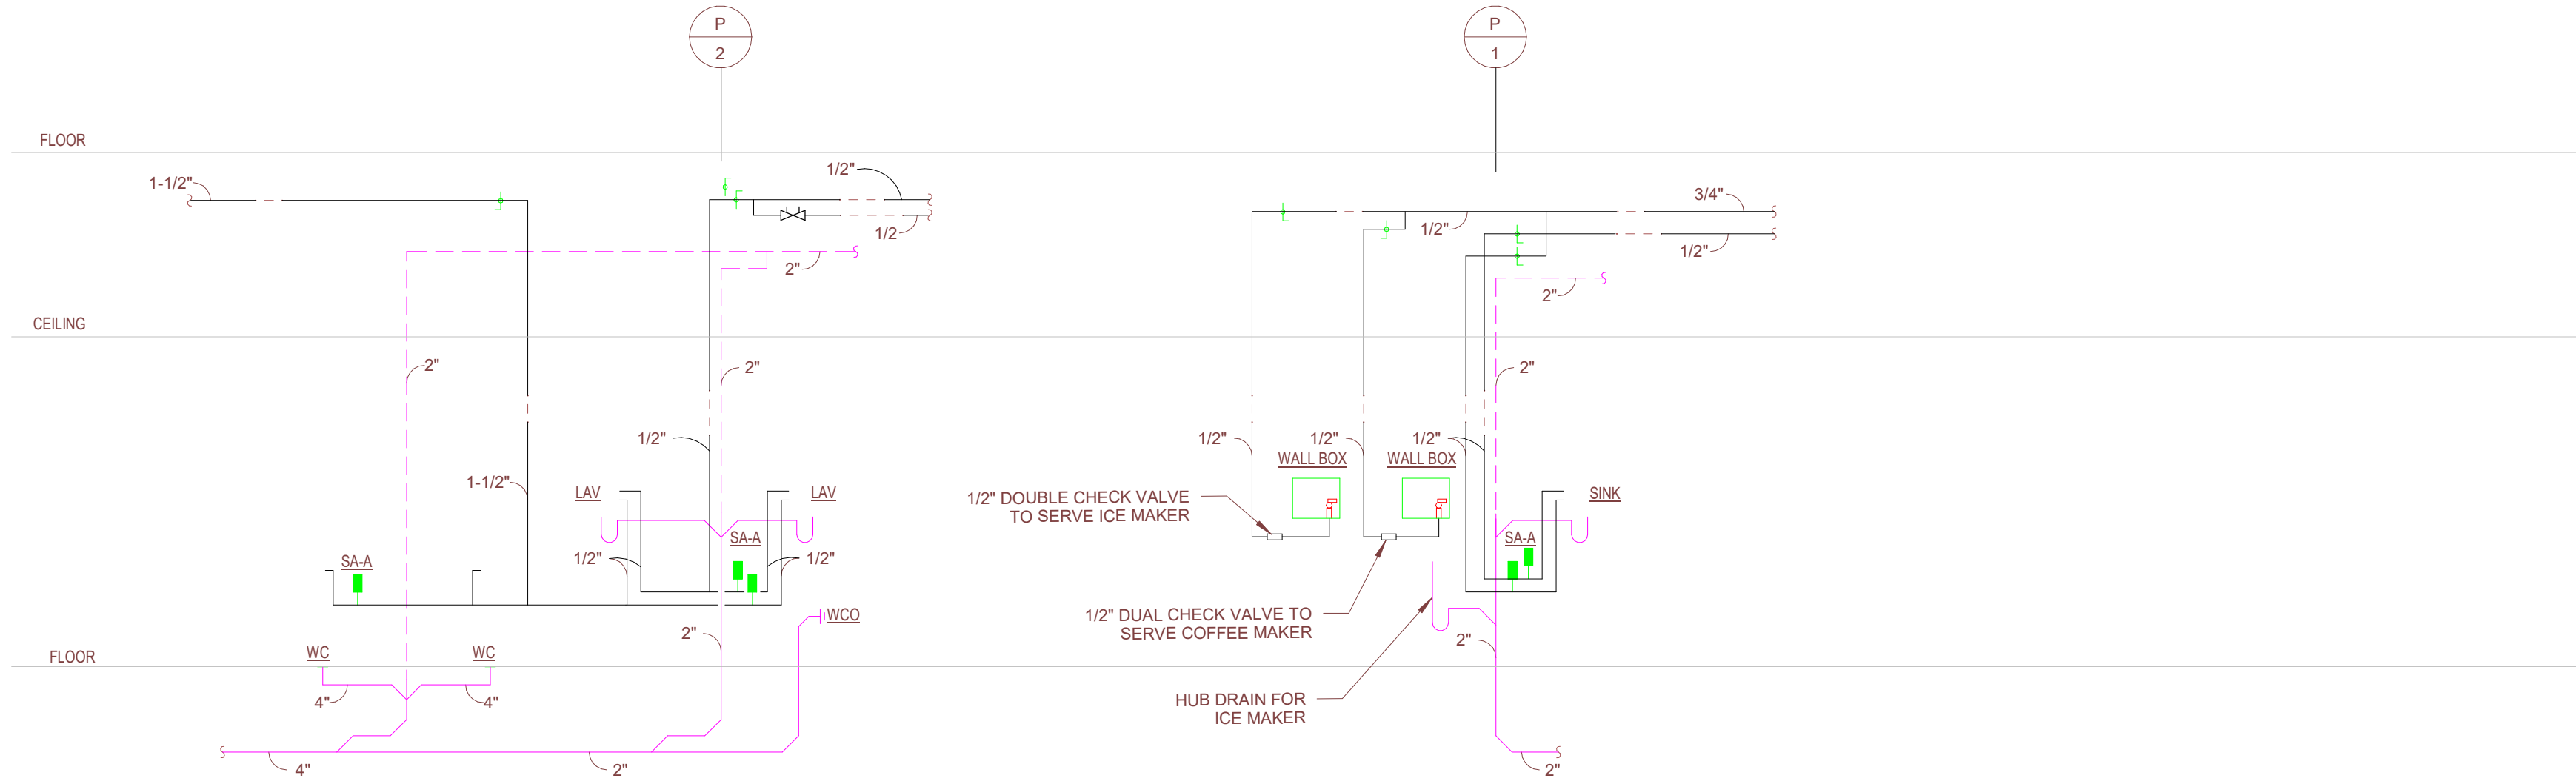

01 PLUMBING RISER DIAGRAMS
NO SCALE

PLUMBING FIXTURE						
HCA DESIG.	FIXTURE TYPE	SAN SEWER	VENT	COLD WATER	HOT WATER	DESCRIPTION
P-101	WATER CLOSET ADA COMPLIANT PUBLIC	4"	2"	1 1/2"	-	WATER CLOSET: ZURN MODEL No. Z3685-BWL1 (WHITE) FLUSH VALVE WATER CLOSET, VITREOUS CHINA, 16-3/4" RIM HEIGHT, 10" ROUGHING-IN, LOW CONSUMPTION 1.1 GALLONS PER FLUSH, ELONGATED BOWL, DIRECT FED SIPHON JET ACTION, FULLY GLAZED TRAPWAY, 1 1/2" TOP SPUD, FLUSH VALVE: ZURN MODEL No. Z-6000-AV-HET, HIGH EFFICIENCY (HET), 1.28 GPF, VACUUM BREAKER FLUSH CONNECTION, 1" I.P.S. BACK-CHECK ANGLE STOP, DIAPHRAGM TYPE MANUAL FLUSH VALVE, CHROME PLATED, VANDAL RESISTANT STOP CAP, SEAT: PROFLO MODEL No. PFT5C0F2000WH, WHITE OPEN SEAT FRONT LESS COVER, WITH SELF SUSTAINING CHECK HINGE.
P-301	LAVATORY - WALL HUNG ADA COMPLIANT PUBLIC	2"	2"	1/2"	1/2"	LAVATORY: ZURN MODEL No. Z5344 WALL HUNG LAVATORY, VITREOUS CHINA, FAUCET: ZURN MODEL No. Z812A4-XL-FC-05 4" FIXED CENTERS RIGID OR SWING GOOSENECK SPOUT, WITH 0.5 GPM FLOW CONTROL IN BASE OF SPOUT, WITH 4" WRISTBLADE HANDLES, MIXING VALVE: WILKINS MODEL No. ZW3870XL-4PC 3/8" POINT OF USE THERMOSTATIC MIXING VALVE 4-PORT, ASSE 1070 LISTED, STRAINER AND TAILPIECE: PROFLO MODEL No. PFGD100 1-1/4" X 6" CP GRID DRAIN AND TAILPIECE, P-TRAP: PROFLO MODEL No. PFTPB400 1-1/4" CHROME PLATED CAST BRASS BODY P-TRAP, TUBULAR BRASS WALL BEND AND No. PFT202WH TRAP WRAP KIT, STOPS AND RISERS: TWO PFXQAC32C LEAD FREE 1/4 TURN CHROME PLATED BRASS ANGLE STOPS, TWO PFTF 1/2" CP ESCUTCHEONS, TWO PFX146324 20" FLEXIBLE STAINLESS STEEL RISERS, AND TWO PROFLO PFX146342 12" 3/8" FLEX RISERS, CARRIER: ZURN MODEL ZZ1231 FLOOR MOUNTED CARRIER
P-402	SINK SINGLE COMPARTMENT ADA COMPLIANT	2"	2"	1/2"	1/2"	SINK: ELAY MODEL L94D1918-553 TYPE 304 NIKEL BEARING STAINLESS STEEL, SELF RIMMING, 19-1/2" X 19" X 5-1/2" DEPTH ADA COMPLIANT WITH OFF-CENTERED OUTLET TO THE REAR, BOWL SIZE 16" X 13-1/2", 3-1/2" DRAIN AND "SOUND GUARD" UNDERCOATING, FAUCET: ZURN MODEL No. Z831B4-XL-FC 1.5, 8" FIXED CENTERS RIGID OR SWING GOOSENECK SPOUT, WITH 1.5 GPM FLOW CONTROL IN BASE OF SPOUT AND WITH 4" WRISTBLADE HANDLES, STRAINER/TAIPIECE: PROFLO MODEL No. PFWTS CHROME PLATED BRASS 4-1/2" WIDE STRAINER WITH PROFLO PFTPB100 17 GA FLANGED TAILPIECE, P-TRAP: PROFLO MODEL No. PFTPB403 1-1/2 17 GA CHROME PLATED CAST BRASS BODY P-TRAP, TUBULAR BRASS WALL BEND, STOPS AND RISERS: TWO PFXQAC32C LEAD FREE 1/4 TURN CHROME PLATED BRASS ANGLE STOPS, TWO PFTF 1/2" CP ESCUTCHEONS AND TWO PFX146324 20" FLEXIBLE STAINLESS STEEL RISERS.
P-804	ICE MAKER BOX	-	-	1/2"	-	OATEY MODEL 39140 20 GAUGE STEEL ICE MAKER BOX WITH 1/4 TURN BALL VALVE AND WATER HAMMER ARRESTOR, LOW LEAD COMPLIANT.



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SCHEDULES - PLUMBING

P08-01

Autodesk Docx/6406.24 - HCA - Lee's Summit Medical Center (LSMC)_rv23/MEP_LSMC Admin Relocation_R23.rvt 6/4/2025 1:04:28 PM Notice of Alternate Billing or Payment Cycle: The Owner may plan to make payments on an alternative schedule. A written description of such billing or payment cycle applicable to the Project is available from the Owner or the Owner's designated agent upon request.

GENERAL NOTES - ALL HVAC SHEETS

- A. ALL MECHANICAL, ELECTRICAL, AND PLUMBING WORK SHALL COMPLY WITH ALL APPLICABLE STATE AND LOCAL BUILDING CODES. REFER TO SPECIFICATIONS FOR MATERIALS AND METHODS FOR MECHANICAL AND PLUMBING CONSTRUCTION.
- B. CONTRACTOR SHALL OBTAIN ALL NECESSARY PERMITS, PAY ALL FEES, AND COMPLY WITH ALL NATIONAL, STATE, AND MUNICIPAL LAWS, CODES, AND ORDINANCES RELATING TO BUILDING AND PUBLIC SAFETY.
- C. CONTRACTOR SHALL FURNISH ALL MATERIALS, EQUIPMENT, AND LABOR REQUIRED FOR A COMPLETE WORKING AND COORDINATED SYSTEM.
- D. COORDINATE THE EXACT LOCATION OF MECHANICAL AND PLUMBING EQUIPMENT WITH THE LOCATIONS OF LIGHT FIXTURES, PIPING, CONDUIT, AND OTHER CONSTRUCTION, TO ALLOW FOR PROPER ACCESS TO SERVICE EQUIPMENT.
- E. COORDINATE THE LOCATION OF DUCTWORK AND PIPING WITH OTHER TRADES AND PROVIDE OFFSETS IN DUCTWORK AND PIPING AS REQUIRED.
- F. IT IS THE INTENT OF THESE DOCUMENTS TO ALLOW ALL CEILING CONSTRUCTION AND HEIGHTS TO BE AS SHOWN ON THE ARCHITECTURAL DRAWINGS. COORDINATE THE LOCATION OF DUCTWORK AND PIPING AND PROVIDE OFFSETS IN DUCTWORK AND PIPING AS REQUIRED TO MEET THIS INTENT.
- G. CONDUIT, PIPING, AND DUCTWORK SHALL BE INDEPENDENTLY SUPPORTED, AND EACH SUPPORT SHALL BE INDEPENDENT OF PARTITION AND CEILING SYSTEM SUPPORTS. WHERE INDEPENDENT SUPPORT IS NOT POSSIBLE AN ENGINEERED SUPPORT SYSTEM SHALL BE UTILIZED.
- H. INSTALL ALL FLOOR MOUNTED EQUIPMENT ON PADS AS SPECIFIED. PAD BY GENERAL CONTRACTOR. COORDINATE REQUIREMENTS WITH GENERAL CONTRACTOR.
- I. ALL WORK SHALL BE SCHEDULED AND PERFORMED IN STRICT COORDINATION WITH ARCHITECTURAL PHASING PLANS AND WITH HOSPITAL SCHEDULES, OCCUPANCIES, AND WORK.
- J. PROTECT EQUIPMENT AND WORK FROM DAMAGE DURING HANDLING AND INSTALLATION UNTIL COMPLETION OF CONSTRUCTION.
- K. REMOVE ALL EXCESS MATERIAL AND DEBRIS AND CLEAN ALL EQUIPMENT UPON COMPLETION OF WORK. TOUCH UP WITH PAINT WHERE REQUIRED.
- L. CONTRACTOR SHALL VISIT JOBSITE AND VERIFY SIZE AND LOCATION OF ALL EXISTING ITEMS AND CONDITIONS.
- M. ALL CONNECTION BETWEEN PIPES OF DISSIMILAR MATERIALS SHALL BE MADE WITH DIELECTRIC UNIONS.
- N. CONTRACTOR SHALL COORDINATE ALL WORK CLOSELY WITH EXISTING CONDITIONS AND WITH ALL OTHER TRADES.
- O. ALL EXISTING FACILITIES SHALL BE PROTECTED DURING THE CONSTRUCTION ACTIVITIES. IT SHALL BE THE RESPONSIBILITY OF THE CONTRACTOR TO RELOCATE AND STORE ITEMS WHICH ARE SUBJECT TO DAMAGE.
- P. ARCHITECT SHALL HAVE FINAL APPROVAL OF ALL GRILLE, DIFFUSER, AND THERMOSTAT LOCATIONS.
- Q. COORDINATE ALL AIR DEVICE LOCATIONS AND MOUNTING FRAME STYLES WITH LIGHTING PLANS AND ARCHITECTURAL REFLECTED CEILING PLANS.
- R. COORDINATE ALL WALL MOUNTED DEVICE LOCATIONS WITH ARCHITECTURAL INTERIOR ELEVATIONS.
- S. DEMOLITION OF EACH PHASE SHALL OCCUR AS PART OF THE WORK FOR THAT PHASE. REMOVE ONLY THE WORK THAT SERVES THE AREA OF DEMOLITION.
- T. PROVISIONS SHALL BE MADE BY THE CONTRACTOR TO PREVENT DISRUPTING ADJACENT AREAS OF THE PHASE IN WHICH WORK IS BEING PERFORMED.
- U. PROVIDE ADDITIONAL VALVES, TAPS, TEMPORARY DUCTWORK, ETC. AS NECESSARY TO PROVIDE UNINTERRUPTED SERVICE TO AREAS OUTSIDE OF THE PHASE IN WHICH WORK IS BEING PERFORMED.
- V. ALL NECESSARY SHUTDOWNS OR OUT OF PHASE WORK SHALL BE COORDINATED WITH THE HOSPITAL REPRESENTATIVE.
- W. DUCT SIZES ARE NET FREE AREA.
- X. PROVIDE ROUND DUCTS TO ALL AIR DEVICES UNLESS NOTED OTHERWISE. DUCT SIZE SHALL MATCH AIR DEVICE NECK SIZE OR THE TABLE IN AIR DEVICE SCHEDULE. WHICHEVER IS LARGER. FLEXIBLE DUCTS SHALL BE SIZED SIMILARLY. DO NOT USE FLEXIBLE DUCTS ABOVE NON-LAYIN CEILINGS.
- Y. TERMINAL BOX INLET DUCTS: SIZE THE RUNOUT DUCT AND ITS TAP AT MAIN TRUCK PER VAV BOX SCHEDULE UNLESS NOTED OTHERWISE ON PLANS.
- Z. TERMINAL BOX OUTLET DUCTS: SIZE THE LOW PRESSURE OUTLET DUCT TO BE SIZE OF TERMINAL BOX DISCHARGE UNLESS NOTED OTHERWISE ON PLANS.
- AA. PROVIDE FRAMED 0.5" BY 0.5" BIRD SCREEN (GALVANIZED STEEL ASSEMBLY) AT ALL DUCTS TERMINATING WITHOUT AN AIR DEVICE, AND AT UNDUCTED AIR FLOW OPENINGS AT EQUIPMENT. PROVIDE 0.5" BY 0.5" BIRD SCREEN (316 STAINLESS STEEL) AT ALL INDOOR FACE OF LOUVERS AND UNDUCTED AIR FLOW OPENINGS TO EQUIPMENT HANDLING OUTSIDE AIR.
- AB. PROVIDE MANUAL VOLUME DAMPER IN EACH AIR DEVICE RUNOUT DUCT AS FAR FROM AIR DEVICE AS POSSIBLE.
- AC. INSTALL SPACE THERMOSTAT ADJACENT TO LATCH SIDE OF DOOR IN SPACE INDICATED.
- AD. INDICATED SPACE THERMOSTAT LOCATIONS ARE APPROXIMATE. AVOID HEAT PRODUCING EQUIPMENT.
- AE. FINAL SPACE THERMOSTAT/SENSOR LOCATIONS SHALL BE AS DIRECTED BY THE ARCHITECT.
- AF. INSTALL HUMIDISTATS IN SIMILAR FASHION.
- AG. INSTALL TURNING VANES IN ALL 90 DEGREE SQUARE ELLS IN SUPPLY, RETURN, AND EXHAUST DUCTS. (NONE ALLOWED IN COMBUSTION AIR DUCTS).
- AH. LOCATE ISOLATION VALVES FOR EQUIPMENT AS CLOSE TO THE MAIN AS POSSIBLE.
- AI. PROVIDE CONDENSATE DRAIN PIPING FROM ALL COOLING COILS TO DRAIN.
- AJ. MULTI-BLADE DAMPERS OF ANY TYPE INSTALLED WITHIN 36" OF AN ELL OR OTHER FITTING SHALL BE INSTALLED WITH THE DAMPER BLADE SHAFTS PARALLEL TO THE AIRSTREAM FLOW DIRECTION UPSTREAM OF THE FITTING.
- AK. COORDINATE LOCATION OF ALL DISCONNECTS, CONTROL PANELS AND ELECTRICAL CONNECTIONS FOR MECHANICAL AND PLUMBING EQUIPMENT TO MAINTAIN NEC REQUIRED CLEARANCES OF 42" DEEP AND 30" WIDE IN FRONT OF EQUIPMENT.
- AL. ALL FIRE AND COMBINATION FIRE/SMOKE DAMPERS SHALL BE INSTALLED IN ACCORDANCE WITH THE MANUFACTURERS INSTALLATION DETAILS AND BE U.L. TESTED AND LISTED.
- AM. FULLY INTEGRATE ALL NEW CONTROLS WITH ALL EXISTING /MODIFIED EQUIPMENT BACK TO NEW FMS AND ENGINEERS WORKSTATION IN RENOVATION PROJECT.
- AN. PROVIDE FILTER GAUGE ACROSS EACH FILTER BANK SERVING CENTRAL AIR SYSTEMS. THE GAUGE SHALL BE RED LINED OR A FILTER ALARM LIGHT INSTALLED TO SIGNAL WITH THE RECOMMENDED MAXIMUM STATIC PRESSURE DROP HAS BEEN REACHED. USE MAXIMUM STATIC PRESSURE AS RECOMMENDED BY FILTER MANUFACTURER.
- AO. PIPE CONNECTIONS LESS THAN 2-1/2" TO HEATING COILS, COOLING COILS, HUMIDIFIERS AND SIMILAR EQUIPMENT SHALL HAVE FLEXIBLE CONNECTORS OR THREE 90-DEGREE OFFSETS IN CLOSE PROXIMITY OF THE CONNECTION.
- AP. CONTRACTOR SHALL RE-INSPECT RECOMMENDED CONNECTION POINTS AFTER DEMOLITION PHASE TO ENSURE TIE-IN POINTS ARE ADEQUATE FOR RENOVATION SYSTEMS.
- AQ. CONTRACTOR SHALL TEST AND BALANCE ALL EXISTING SYSTEMS THAT ARE TO BE CONNECTED TO FOR THE RENOVATION PHASE PRIOR TO INSTALLING NEW WORK AND DOCUMENT VALUES. CONTRACTORS SHALL RE-TEST AND BALANCE EXISTING SYSTEMS AFTER CONNECTION TO ENSURE ALL DOWN STREAM SYSTEMS ARE PROVIDED THE SAME PERFORMANCE AFTER CONSTRUCTION.
- AR. ALL DISCONNECTS DOWN STREAM OF VFDS SHALL BE PROVIDED WITH AUXILIARY CONTACTS TO SHUT DOWN UPSTREAM VFD WHEN SWITCH IS OPEN.

GENERAL PIPING NOTES

- A. REFER TO THE ARCHITECTURAL PHASING PLAN FOR THE AREAS SHOWN ON THIS SET OF PLANS. WORK SHALL BE SCHEDULED AND PERFORMED IN SEQUENCE WITH THE PHASING PLAN.
- B. DEMOLITION OF EACH PHASE SHALL OCCUR AS PART OF THE WORK FOR THAT PHASE. REMOVE ONLY THE WORK THAT SERVES THE AREA OF DEMOLITION.
- C. PROVISIONS SHALL BE MADE BY THE CONTRACTOR TO PREVENT DISRUPTING ADJACENT AREAS OF THE PHASE IN WHICH WORK IS BEING PERFORMED.
- D. PROVIDE ADDITIONAL VALVES, TAPS, TEMPORARY DUCTWORK AND/OR PIPING AS NECESSARY TO PROVIDE UNINTERRUPTED SERVICE TO AREAS OUTSIDE OF THE PHASE IN WHICH WORK IS BEING PERFORMED.
- E. ALL WORK SHALL BE PERFORMED IN STRICT COORDINATION WITH HOSPITAL SCHEDULES, OCCUPANCIES, AND WORK. CONTRACTOR SHALL COORDINATE WITH HOSPITAL REPRESENTATIVE.
- F. ALL NECESSARY SHUTDOWNS OR OUT OF PHASE WORK SHALL BE SCHEDULED WITH THE HOSPITAL REPRESENTATIVE IN A TIMELY MANNER AS TO MINIMIZE THE DISRUPTION TO THE FACILITY.
- G. ARCHITECT SHALL HAVE FINAL APPROVAL OF ALL THERMOSTAT LOCATIONS.
- H. G.C. TO PROVIDE ACCESS DOORS IF REQUIRED FOR ACCESS TO VAVS AND ANY VALVES THAT ARE NOT ACCESSIBLE. VERIFY SIZE AND LOCATIONS WITH MECHANICAL CONTRACTOR.
- I. CONTRACTOR SHALL RE-INSPECT RECOMMENDED CONNECTION POINTS AFTER DEMOLITION PHASE TO ENSURE TIE-IN POINTS ARE ADEQUATE FOR RENOVATION SYSTEMS.
- J. CONTRACTOR SHALL TEST AND BALANCE ALL EXISTING SYSTEMS THAT ARE TO BE CONNECTED TO FOR THE RENOVATION PHASE PRIOR TO INSTALLING NEW WORK AND DOCUMENT VALUES. CONTRACTORS SHALL RE-TEST AND BALANCE EXISTING SYSTEMS AFTER CONNECTION TO ENSURE ALL DOWN STREAM SYSTEMS ARE PROVIDED THE SAME PERFORMANCE AFTER CONSTRUCTION.
- K. CONTRACTOR SHALL COORDINATE ALL SLAB PENETRATIONS WITH EXISTING WAFFLE SLAB RIDGES AND BEAMS.

GENERAL DEMOLITION NOTES

- A. ALL CAPPED DUCT TAPS AND CONNECTING DUCTS THAT ARE NOT BEING USED ARE TO BE REMOVED BACK TO THE MAIN DUCT AND PATCHED AS PER ITEM B BELOW.
- B. PATCH OPENINGS IN EXISTING DUCTWORK THAT IS TO REMAIN INCLUDING OPENINGS. WHERE TAPS OR DUCTWORK ARE TO BE REMOVED, THE FOLLOWING SHALL OCCUR:
- OPENINGS IN THE MAIN DUCTS ARE TO BE COVERED WITH A SHEET METAL PATCH. THE PATCH IS TO BE LARGER THAN THE EXISTING OPENING AND IS TO BE SECURED WITH SHEET METAL SCREWS FOUR INCHES ON CENTERS.
- A LIBERAL QUANTITY OF FIRE RESISTANT ADHESIVE IS TO BE APPLIED TO THE EDGES OF THE METAL PATCH AND THE ASSEMBLY SCREWED IN PLACE.
- C. REFER TO THE ARCHITECTURAL PHASING PLAN FOR THE AREAS SHOWN ON THIS PLAN. WORK SHALL BE SCHEDULED AND PERFORMED IN SEQUENCE WITH THE PHASING PLAN.
- D. DEMOLITION OF EACH PHASE SHALL OCCUR AS PART OF THE WORK FOR THAT PHASE. REMOVE ONLY THE WORK THAT SERVES THE AREA OF DEMOLITION.
- E. PROVISIONS SHALL BE MADE BY THE CONTRACTOR TO PREVENT DISRUPTING ADJACENT AREAS OF THE PHASE IN WHICH WORK IS BEING PERFORMED.
- F. PROVIDE ADDITIONAL VALVES, TAPS, TEMPORARY DUCTWORK AND/OR PIPING AS NECESSARY TO PROVIDE UNINTERRUPTED SERVICE TO AREAS OUTSIDE OF THE PHASE IN WHICH WORK IS BEING PERFORMED.
- G. ALL WORK SHALL BE PERFORMED IN STRICT COORDINATION WITH HOSPITAL SCHEDULES, OCCUPANCIES AND WORK. CONTRACTOR SHALL COORDINATE WITH HOSPITAL REPRESENTATIVE.
- H. ALL NECESSARY SHUTDOWNS OR OUT OF PHASE WORK SHALL BE SCHEDULED WITH THE HOSPITAL REPRESENTATIVE.
- I. FOR ALL MINOR RENOVATION AREAS, THE CONTRACTOR IS TO UNDERTAKE A FULL PRE-TAB OF ALL GRILLES AND DIFFUSERS WITHIN THE AREAS PRIOR TO DEMOLITION. THE REPORT SHOULD BE SENT TO THE EOR. UPON COMPLETION OF THE GRILLE/DIFFUSER REPLACEMENTS IN THESE AREAS, THE CONTRACTOR IS REQUIRED TO RE-BALANCE THE SYSTEM BACK TO THE VALUES DOCUMENTED WITHIN THE PRE-TAB REPORT. PLEASE NOTE THE PRE-TAB IS TO BE PERFORMED PRIOR TO ANY WORK ASSOCIATED WITH THE RESPECTIVE SYSTEMS BEING UNDERTAKEN.

FIRE ALARM SEQUENCE OF OPERATION

UPON FIRE ALARM ALL AIR HANDLING UNITS AND ASSOCIATED EXHAUST FANS SHALL SHUT DOWN BASED ON THEIR RESPECTIVE SMOKE COMPARTMENTS. ALL ISOLATION EXHAUST FANS TO REMAIN IN OPERATION. ALL ASSOCIATED SMOKE AND COMBINATION FIRE/SMOKE DAMPERS SERVING SYSTEMS THAT SHUT OFF UPON FIRE ALARM SHALL CLOSE DURING FIRE ALARM.

DESIGN CRITERIA

LOCATION: CITY/STATE	LEE'S SUMMIT, MISSOURI
APPLICABLE CODES:	
BUILDING	2018 IBC
MECHANICAL	2018 IMC
PLUMBING	2018 IPC
ENERGY	2018 IECC
ELECTRICAL	2017 NEC
FIRE	2018 IFC
LATITUDE: DEG. N. LAT.	38.9
LONGITUDE: DEG. W. LONG.	94.3
ELEVATION: FT. ABOVE SEA LEVEL	997
ASHRAE SUMMER DESIGN CONDITIONS: 0.4% DRY BULB 0.4% WET BULB	89.9 °F 79.5 °F
ASHRAE WINTER DESIGN CONDITIONS: 99% WET BULB HCA DESIGN CRITERIA	3.9 °F -10 °F
BUILDING SPACE DESIGN TEMPERATURES: SUMMER DB WINTER DB	72 °F 68 °F
SUPPLY AIR TEMPERATURE: DEG. F. DRY BULB	55 °F

MECHANICAL ABBREVIATIONS

AC	ABOVE CEILING	GEF	GENERAL EXHAUST FAN
AFF	ABOVE FINISHED FLOOR	HW	HEATING HOT WATER
AHU	AIR HANDLING UNIT	IBT	INVERTED BUCKET TRAP
AI	ANALOG INPUT	IN HG	INCHES MERCURY (PRESSURE)
AO	ANALOG OUTPUT	IN WC	INCHES WATER COLUMN (PRESSURE)
BF	BELOW FLOOR, BLIND FLANGE	LE	LAUNDRY EQUIPMENT
BFC	BELOW FINISHED CEILING	MA	MIXED AIR
BO	BELOW GRADE	MVD	MOTORIZED VOLUME DAMPER
BV	BUTTERFLY VALVE	N	NEW
CHW	CHILLED WATER	OA	OUTSIDE AIR
CRU	COMPUTER ROOM UNIT	OSD	OPPOSED BLADE DAMPER
CRU	CONDENSATE RETURN UNIT	PRV	PRESSURE RELIEF VALVE
CU	CONDENSING UNIT	R	RELOCATED
DI	DIGITAL INPUT	RA	RETURN AIR
DO	DIGITAL OUTPUT	RCA	RECIRCULATED (RETURN) AIR
DS	DISCONNECT SWITCH	RLA	RELIEF AIR
E	EXISTING	SA	SUPPLY AIR
EDH	ELECTRIC DUCT HEATER	SF	SUPPLY FAN
EUH	ELECTRIC UNIT HEATER	SV	SAFETY VALVE
EA	EXHAUST AIR	TAV	THERMOSTATIC AIR VENT (TEAM SYSTEM)
EF	EXHAUST FAN	UH	UNIT HEATER
FOU	FAN COIL UNIT	UNO	UNLESS NOTED OTHERWISE
FMB	FILTER MAKING BOX	VAV	VARIABLE AIR VOLUME
FPS	FAN POWERED BOX	VO	VOLUME DAMPER
FPI	FINS PER INCH	WH	WATER HEATER
GC	GENERAL CONTRACTOR	WHP	WATER-SOURCE HEAT PUMP

CONTROL DIAGRAM SYMBOLS

SYMBOLS	DESCRIPTION
(AI)	ANALOG INPUT
(AO)	ANALOG OUTPUT
(DI)	DIGITAL INPUT
(DO)	DIGITAL OUTPUT
TT-X	TEMPERATURE TRANSMITTER #X
HT-X	RELATIVE HUMIDITY TRANSMITTER #X
V-X	CONTROL VALVE #X
SPT-X	STATIC PRESSURE TRANSMITTER #X
ESC-X	END SWITCH, NORMALLY CLOSED #X
ESO-X	END SWITCH, NORMALLY OPEN #X
TS-X	TEMPERATURE SENSOR #X
SD-X	SMOKE DETECTOR #X
OL	OVERLOAD RELAY #X
DPS-X	DIFFERENTIAL PRESSURE SENSOR #X
CSR-X	CURRENT SENSING RELAY #X
FM-X	FLOW METER #X
FS-X	FLOW SWITCH #X
EAS-X	EMERGENCY AIR HANDLER SHUT DOWN BUTTON #X

MECHANICAL/ELECTRICAL SYSTEM COORDINATION SCHEDULE

SYSTEM	FURNISHED BY	INSTALLED BY	POWER WIRING BY	CONTROL OR SUPERVISION WIRING BY
LIFE SAFETY SYSTEM	XXXXXX	XXXXXX	XX	XXXXXX
SMOKE DAMPER/ACTUATOR	DIV 23	DIV 23	DIV 26	DIV 28
FIRE/SMOKE DAMPER/ACTUATOR	DIV 23	DIV 23	DIV 26	DIV 28
DUCT SMOKE DETECTOR	DIV 28	DIV 23	XX	DIV 28
NURSE CALL/FIRE ALARM INTERFACE	DIV 28	DIV 28	XX	DIV 28
FIRE SPRINKLER SYSTEM	DIV 21	DIV 21	DIV 26	DIV 28
WATERFLOW SWITCHES	DIV 21	DIV 21	XX	DIV 28
TAMPER SWITCHES	DIV 21	DIV 21	XX	DIV 28
SUPERVISORY CONTACTS	DIV 21	DIV 21	XX	DIV 28
MEDICAL GAS ALARM	DIV 22	DIV 22	DIV 26	DIV 28
MOTOR STARTERS (INTEGRAL TO EQUIP.)	DIV 22/23	XXXXXX	DIV 26	DIV 23
MOTOR STARTERS (NON-INTEGRAL TO EQUIP.)	DIV 26	DIV 26	DIV 26	DIV 23
COMBINATION MOTOR STARTER/DISCONNECT (INTEGRAL TO EQUIP.)	DIV 22/23	XXXXXX	DIV 26	DIV 23
COMBINATION MOTOR STARTER/DISCONNECT (NON-INTEGRAL TO EQUIP.)	DIV 23	DIV 26	DIV 26	DIV 23
VARIABLE FREQUENCY DRIVES (VFD'S)	DIV 26	DIV 26	DIV 26	DIV 23
DISCONNECT SWITCHES (NON-INTEGRAL TO EQUIP.)	DIV 26	DIV 26	DIV 26	XXXXXX

NOTE 1: CONTROL OR SUPERVISORY WIRING FOR DISCONNECT SWITCHES WITH AUXILIARY CONTACTS FOR USE WITH VFDS BY DIV. 23.
NOTE 2: DIVISION OF SCOPE BETWEEN TRADES IS THE RESPONSIBILITY OF THE GENERAL CONTRACTOR.
THIS TABLE IS PROVIDED AS A GUIDE TO THE DOCUMENT PREPARATION AND IN NO WAY INDICATES CONTRACTOR MEANS AND METHODS.

MECHANICAL SYMBOLS

ALL SYMBOLS SHOWN MAY NOT APPEAR IN ALL DRAWINGS. SYMBOLS ARE SHOWN SCHEMATICALLY AND MAY NOT BE TO SCALE.

SYMBOL	DESCRIPTION
	NEW EQUIPMENT DESIGNATION (TOP - EQUIP. ABBREV., BOTTOM - MARK)
	NEW DIFFUSER DESIGNATION (TOP - SCHEDULE DESIGN., BOTTOM - CFM)
	NEW EQUIPMENT
	EXISTING EQUIPMENT
	NEW DUCT
	EXISTING DUCT
	EXISTING DUCT TO BE REMOVED OR RELOCATED
	NEW SUPPLY DIFFUSER
	EXISTING SUPPLY DIFFUSER
	EXISTING SUPPLY DIFFUSER TO BE REMOVED OR RELOCATED
	NEW R/A GRILLE
	EXISTING R/A GRILLE
	EXISTING R/A GRILLE TO BE REMOVED OR RELOCATED
	NEW EXHAUST GRILLE
	EXISTING EXHAUST GRILLE
	EXISTING EXHAUST GRILLE TO BE REMOVED OR RELOCATED
	NEW SLOT DIFFUSER
	FLEXIBLE DUCT
	EXISTING SLOT DIFFUSER
	EXISTING SLOT DIFFUSER TO BE REMOVED OR RELOCATED
	THERMOSTAT W/ BACKBOX AND CONDUIT TO ABOVE CEILING
	EXISTING THERMOSTAT TO BE REMOVED OR RELOCATED
	45 DEGREE PRESSURE TAP W/ VOLUME DAMPER
	CONICAL TAP W/ VOLUME DAMPER
	CONICAL TAP W/O VOLUME DAMPER
	MANUAL DAMPER
	FIRE DAMPER
	SMOKE DAMPER
	FIRE/SMOKE DAMPER
	MOTORIZED DAMPER
	BAROMETRIC DAMPER
	CHILLED WATER SUPPLY PIPE
	CHILLED WATER RETURN PIPE
	CONDENSER WATER SUPPLY PIPE
	CONDENSER WATER RETURN PIPE
	REFRIGERANT LIQUID PIPE
	REFRIGERANT GAS PIPE
	HEATING WATER SUPPLY
	HEATING WATER RETURN
	HIGH PRESSURE STEAM
	HIGH PRESSURE CONDENSATE RETURN
	LOW PRESSURE STEAM
	LOW PRESSURE CONDENSATE RETURN
	PUMPED CONDENSATE RETURN
	DOMESTIC COLD WATER
	DOMESTIC HOT WATER
	DOMESTIC HOT WATER RETURN
	SANITARY WASTE LINE
	CONDENSATE DRAIN
	PUMPED SANITARY LINE
	VENT LINE
	DIRECTION OF SLOPE
	DIRECTION OF FLOW
	EXPANSION LOOP
	GATE VALVE
	BUTTERFLY VALVE
	GLOBE VALVE
	TEMPERATURE AND PRESSURE RELIEF VALVE
	BALANCING VALVE
	AUTOMATIC 2-WAY CONTROL VALVE
	AUTOMATIC 3-WAY CONTROL VALVE
	PLUG VALVE/BALANCING COCK
	SOLENOID VALVE
	CHECK VALVE
	HYDRAULIC SHOCK ARRESTOR
	VALVE VERTICAL
	UNION
	VACUUM BREAKER
	P-TRAP
	FLOOR DRAIN W/ P-TRAP
	HUB DRAIN
	FLOOR CLEANOUT OR GRADE CLEANOUT
	CLEANOUT OR WALL CLEANOUT
	PETES PLUG
	GAUGE COCK
	THERMOMETER
	THERMOMETER WELL
	STRAINER W/ BLOW-OFF VALVE
	F&T STEAM TRAP
	CONNECT TO EXISTING
	ELECTRIC PNEUMATIC SWITCH
	POINT OF DEMOLITION




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MISSOURI DHSS

FACILITY NUMBER:
0972400009

AGENCY APPROVALS:

REVISIONS		
REV #	DESCRIPTION	DATE
A	CITY - 2ND REVIEW	2025/05/29

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SCALE: N.T.S.
DRAWN: HO
REVIEWED: JD
JOB NUMBER: 6406.24

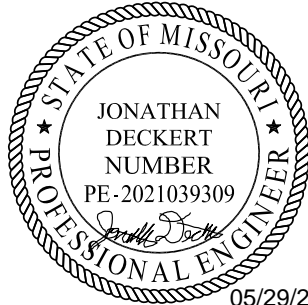
GENERAL INFORMATION -
MECHANICAL

M00-00



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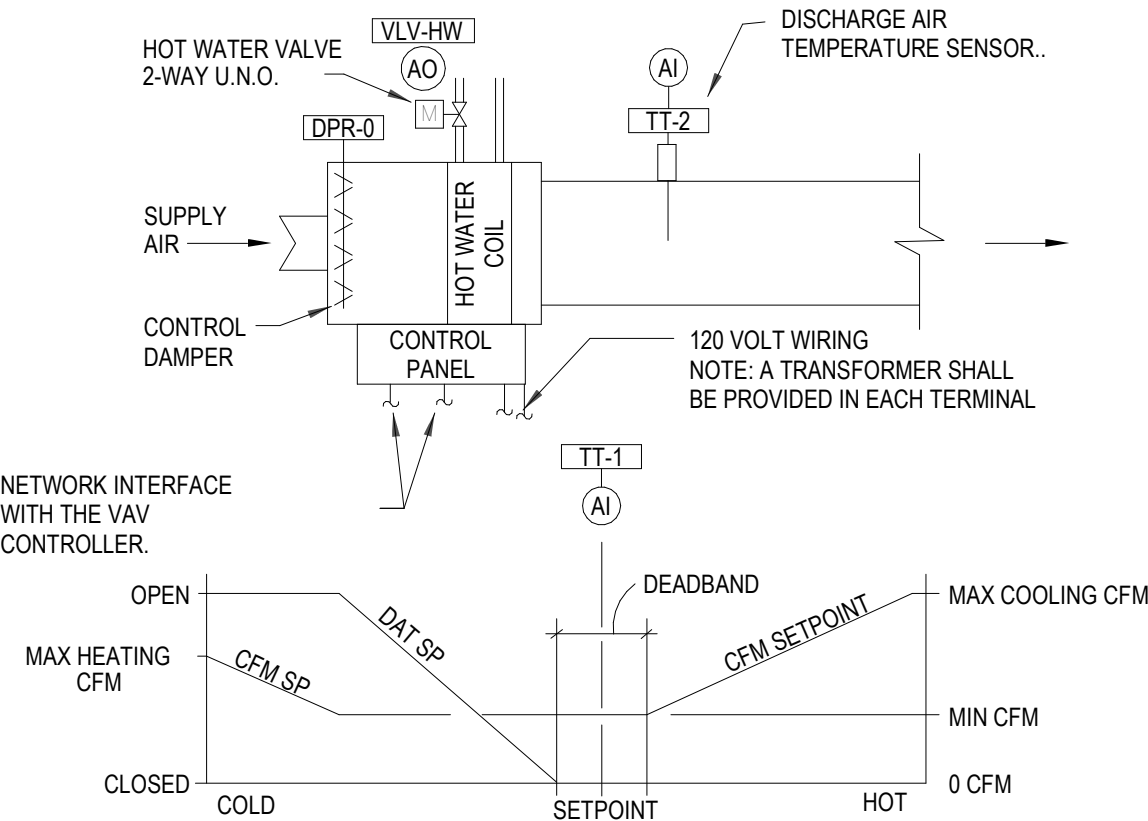
CONTROLS - MECHANICAL

M01-01

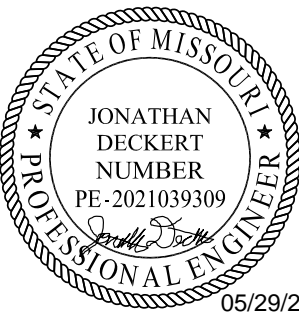THE DDC SYSTEM SHALL CONNECT TO ANY ALARM RELAY AVAILABLE ON THE SPLIT SYSTEMS TO ECHO THE ALARMS THROUGH THE DDC SYSTEM. ALL POINTS TO BE TRENDED. SPLIT SYSTEMS SHALL RUN UNDER ITS OWN CONTROL TO MAINTAIN ROOM TEMPERATURE SETPOINT. TEMPERATURE OF THE ROOMS SERVED BY SPLIT SYSTEMS SHALL BE MONITORED BY BMS AND SHALL ALARM FOR ROOM TEMPERATURE HIGH (85 F) AND LOW (60 F) LIMITS.

FOR SPLIT SYSTEMS IN ROOMS ALSO SERVED BY A VAV BOX THE SPLIT SYSTEM'S TEMPERATURE SETPOINT SHALL BE SET 3 DEGREES ABOVE THE VAV BOX'S TEMPERATURE SETPOINT. THE SPLIT SYSTEM SHALL FUNCTION AS BACKUP COOLING FOR THE FIRE COMMAND ROOM, AND IDF ROOMS IN THE EVENT THE VAV BOX IS UNABLE TO COOL THE ROOM.

2 SPLIT SYSTEM CONTROL SEQUENCE
NOT TO SCALE



TYPICAL VARIABLE VOLUME BOX WITH HOT WATER REHEAT COIL (DUAL PID LOOP)

COOLING AND HEATING
WHEN THE SPACE TEMPERATURE, AS SENSED BY SPACE TEMPERATURE TRANSMITTERS (TT-1), IS BETWEEN THE HEATING AND COOLING SETPOINTS (FROM THE BAS) THE PRIMARY CFM SETPOINT WILL BE AT MINIMUM CFM AND THERE WILL BE NO MECHANICAL HEATING. ON A RISE IN ZONE TEMPERATURE ABOVE THE COOLING SETPOINT, THE PRIMARY CFM SETPOINT WILL INCREASE THE CFM AND THERE WILL BE NO MECHANICAL HEATING. ON A DROP IN ZONE TEMPERATURE BELOW THE HEATING SETPOINT, THE REHEAT COIL WILL MODULATE TO MAINTAIN THE DISCHARGE AIR TEMPERATURE SETPOINT. THE DISCHARGE AIR TEMPERATURE SETPOINT WILL RESET AS THE ZONE TEMPERATURE CHANGES. AFTER THE DISCHARGE AIR TEMPERATURE SETPOINT REACHES THE HIGH LIMIT (95F, ADJ.), THE BOX AIR FLOW IS INCREASED TO THE HEATING MAX FLOW SETPOINT.

THE CONTROL DAMPER SHALL MODULATE TO MAINTAIN THE CFM SETPOINT. THE CFM SETPOINT SHALL BE RESET FROM MINIMUM AIR FLOW TO A MAXIMUM AIR FLOW.


GAIN OF VAV DAMPER CONTROL SHALL NOT EXCEED 20%.

THE DEADBAND SHALL NOT EXCEED $\pm 0.5^{\circ}\text{F}$.
THE FOLLOWING POINTS SHALL BE MAPPED AND TRENDED FROM THE OPERATORS WORKSTATION. A VAV BOX SUMMARY SHALL BE PROGRAMMED TO ALLOW THE OPERATOR TO VIEW THE FOLLOWING POINTS IN TABULAR FORM:

- SPACE TEMPERATURE SETPOINT
- CURRENT SPACE TEMPERATURE
- CFM SETTING
- CURRENT CFM
- DAMPER POSITION
- VALVE POSITION
- VAV DISCHARGE AIR TEMP

ALL POINTS SHALL BE TRENDED.

1 DUAL PID LOOP VARIABLE VOLUME AND CONSTANT VOLUME BOX WITH HEATING WATER COIL
NOT TO SCALE

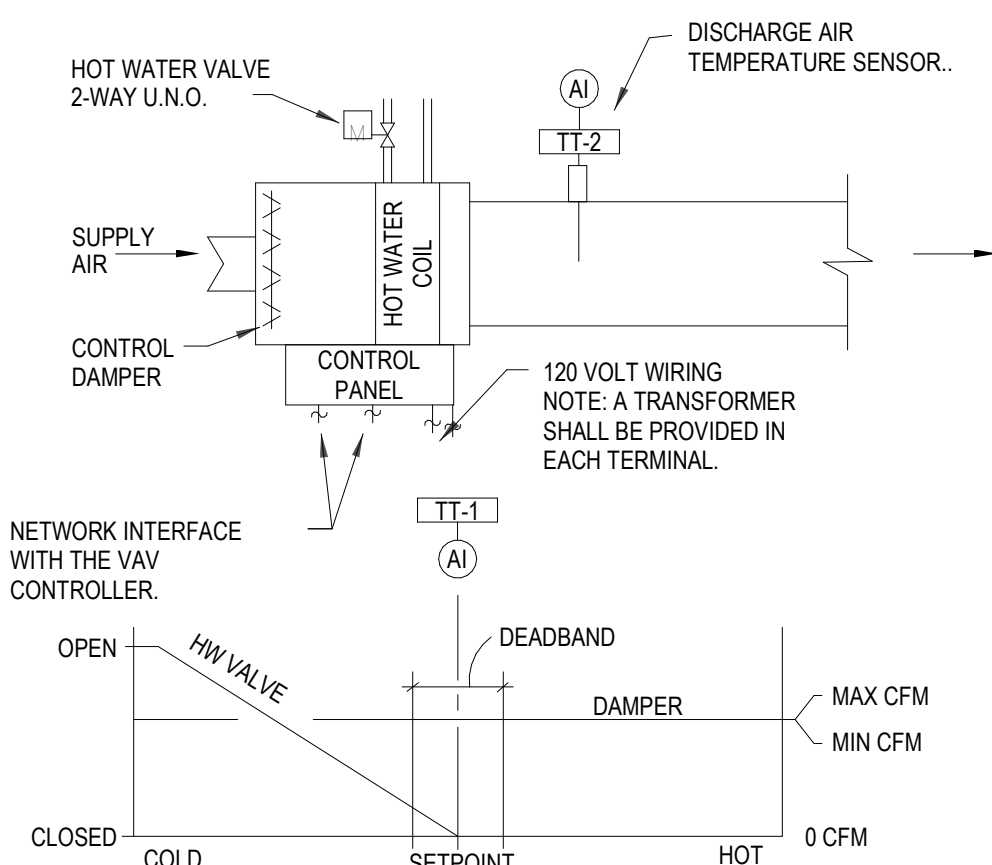

TYPICAL CONSTANT VOLUME BOX WITH HOT WATER REHEAT COIL

COOLING AND HEATING
ON A RISE IN SPACE TEMPERATURE TRANSMITTERS (TT-1) SETPOINT (75 DEG. ADJ.) TT-1 SHALL, THROUGH THE DDC, MODULATE THE HOT WATER VALVE CLOSED. ON A FALL IN SPACE TEMPERATURE (70 DEG. ADJ.), TT-1 SHALL, THROUGH THE DDC, MODULATE OPEN THE HOT WATER VALVE.

THE DAMPER SHALL MODULATE TO MAINTAIN THE CFM SETTING AS INDICATED ON THE DRAWINGS AT ALL TIMES. UNDER NO CIRCUMSTANCES (EXCEPT SMOKE CONTROL IF APPLICABLE) SHALL THE CFM SETTING BE BELOW THAT OF THE MINIMUM CFM AS INDICATED ON THE DRAWINGS.


TEMPERATURE SETPOINT SHALL BE ADJUSTABLE THROUGH THE DDC CONTROL SYSTEM AND SHALL HAVE USER ADJUSTABLE OFFSETS. THE DEADBAND SHALL BE ADJUSTABLE THROUGH THE DDC CONTROL SYSTEM.

GAIN OF VAV DAMPER CONTROL SHALL NOT EXCEED 20%.

THE DEADBAND SHALL NOT EXCEED $\pm 0.5^{\circ}\text{F}$.


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- CURRENT SPACE TEMPERATURE
- CFM SETTING
- CURRENT CFM
- DAMPER POSITION
- VALVE POSITION
- VAV DISCHARGE AIR TEMPERATURE

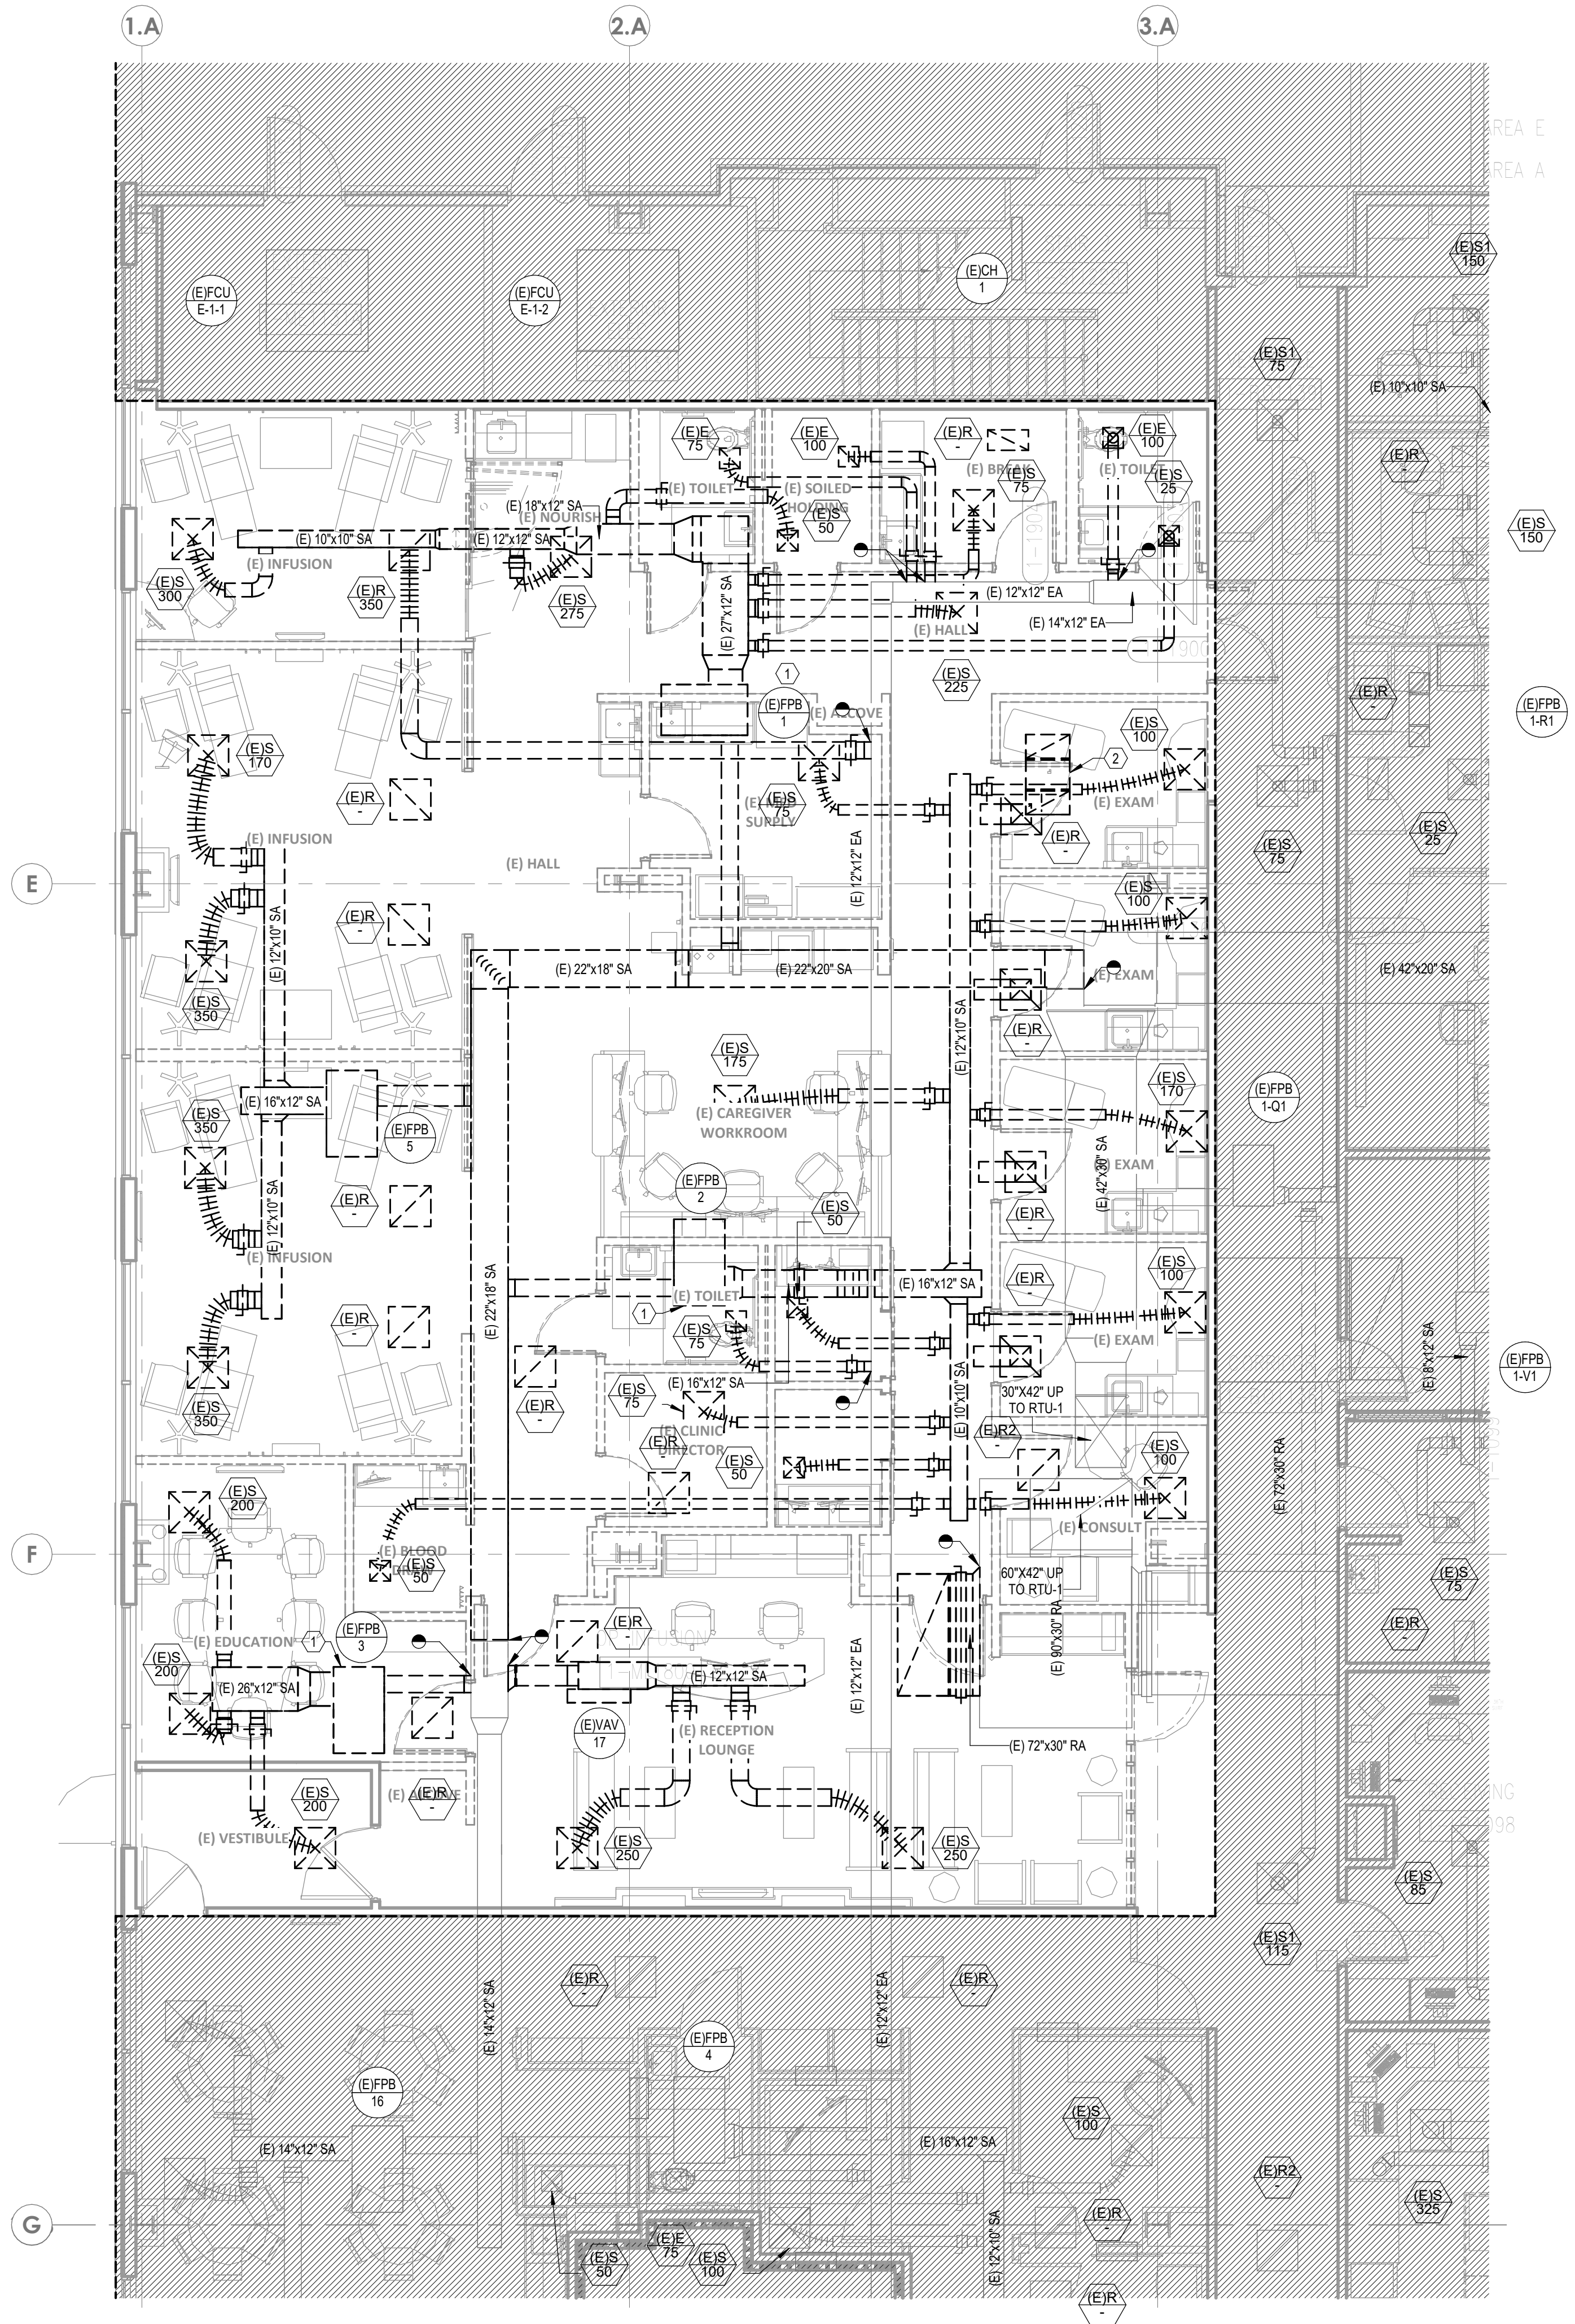

1 DEMOLITION PLAN - LEVEL 1 - ADMIN - HVAC
3/16" = 1'-0"

LEVEL 1 - KEYPLAN

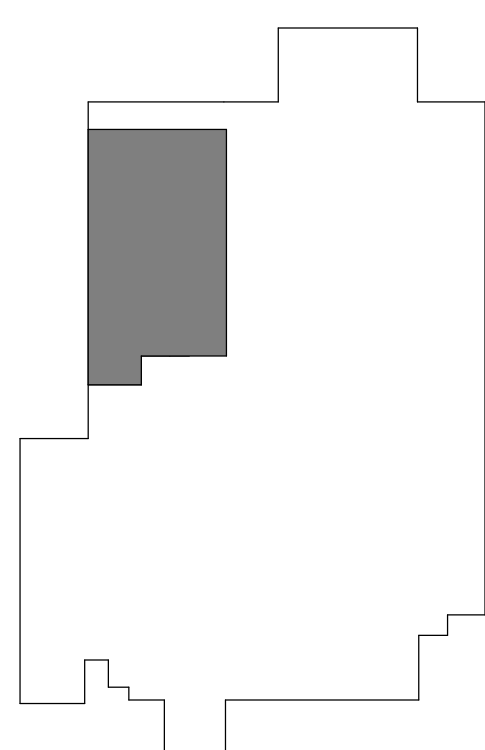

GENERAL DEMO NOTES

- REFER TO MD02-00 FOR GENERAL MECHANICAL NOTES AND SYMBOLS.
- ALL EXISTING CONDITIONS INDICATED ON THESE DRAWINGS ARE APPROXIMATE AND BASED UPON A COMBINATION OF AVAILABLE RECORD DESIGN AND AS-BUILT DOCUMENTS. CONTRACTOR TO VERIFY EXISTING CONDITIONS.
- ALL EXISTING DUCT SIZES AND AIRFLOW VALUES ON PLAN ARE PER THE DESIGN DOCUMENTS AVAILABLE.
- CONTRACTOR TO PRE-TAB ALL SUPPLY AND EXHAUST DUCTWORK SERVED BY EXISTING SYSTEMS MODIFIED AS A PART OF THIS SCOPE. PRE-TAB TO INCLUDE CURRENT CONSTRUCTION SCOPE AREAS AND ALL OUT OF SCOPE AREAS SERVED BY THE MODIFIED SYSTEMS. CONTRACTOR TO DOCUMENT PRECONSTRUCTION VALUES AND PROVIDE TO ENGINEER OF RECORD. UPON COMPLETION OF CONSTRUCTION, REBALANCE ALL EXISTING AREAS TO PRE-TABBED CONSTRUCTION VALUES.

LEGEND NOTES

- DEMOLISH THE FAN POWERED BOX AND ASSOCIATED INLET AND LOW PRESSURE DUCTWORK.
- DEMOLISH RETURN TRANSFER DUCT.

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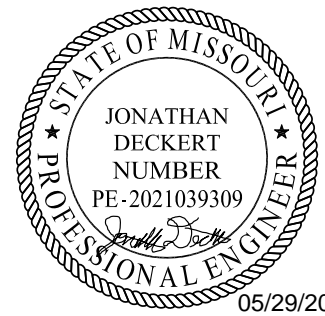
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DEMOLITION PLAN - LEVEL 1
- ADMIN - HVAC

MD02-01


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6/4/2025 2:19:20 PM
A written description of such billing or payment cycle applicable to the Project is available from the Owner or the Owner's designated agent upon request.

GENERAL NOTES

- A. REFER TO MD-00 FOR GENERAL MECHANICAL NOTES, SYMBOLS AND LEGENDS.
B. ALL EXISTING CONDITIONS INDICATED ON THESE DRAWINGS ARE BASED UPON A COMBINATION OF AVAILABLE RECORD DESIGN AND AS-BUILT DOCUMENTS.
C. PROVIDE CEILING ACCESS PANELS FOR ALL EQUIPMENT, COILS, ETC. THAT ARE LOCATED ABOVE HARD CEILINGS UNLESS NOTED OTHERWISE.

LEGEND NOTES


1. REMOVE FAN POWERED BOX AND ASSOCIATED HW PIPING, THERMOSTAT, AND CONTROL WIRING.
2. REMOVE VAV AND ASSOCIATED HW PIPING, THERMOSTAT, AND CONTROL WIRING.

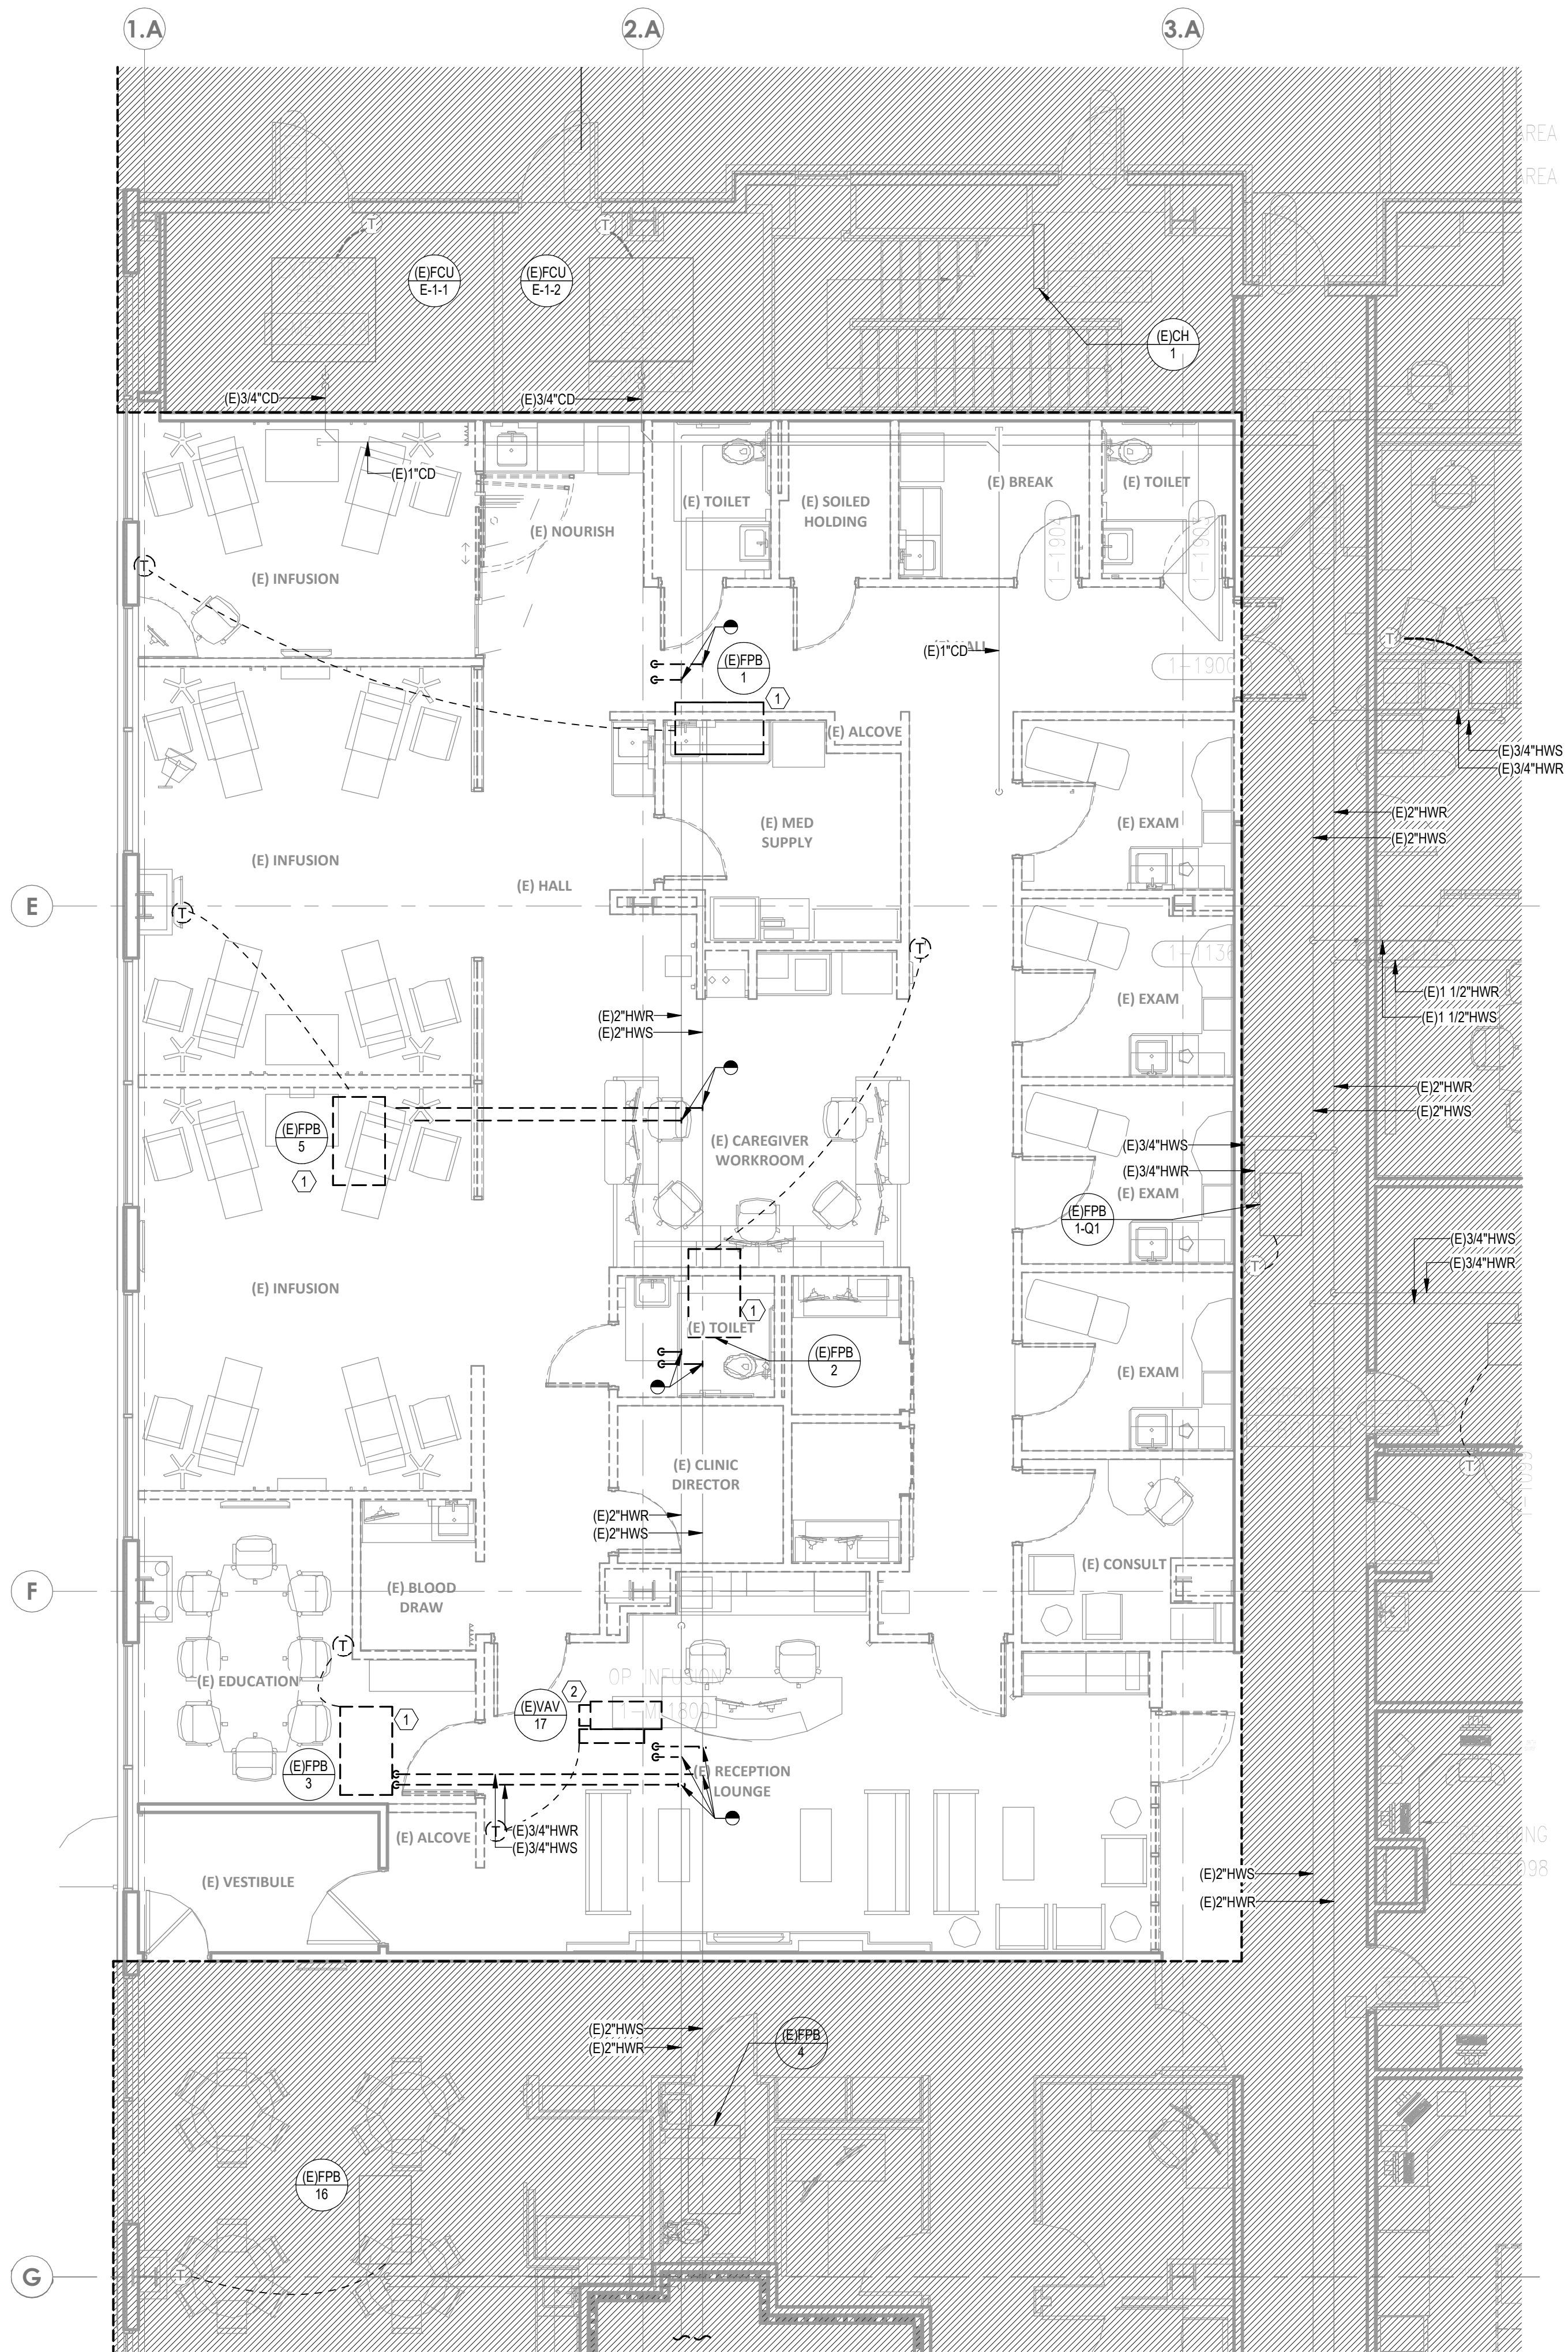

1 DEMOLITION PLAN - LEVEL 1 - ADMIN - HVAC PIPING

3/16" = 1'-0"

LEVEL 1 - KEYPLAN

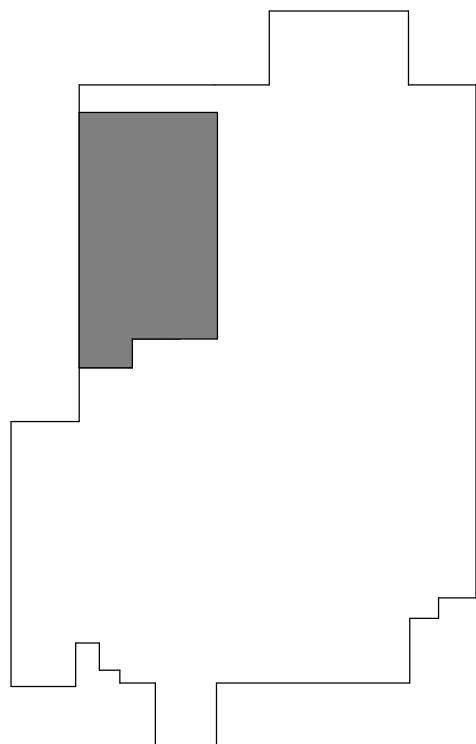

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STATE OF MISSOURI
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DICKERT
NUMBER
PE-2021039300
05/29/2025
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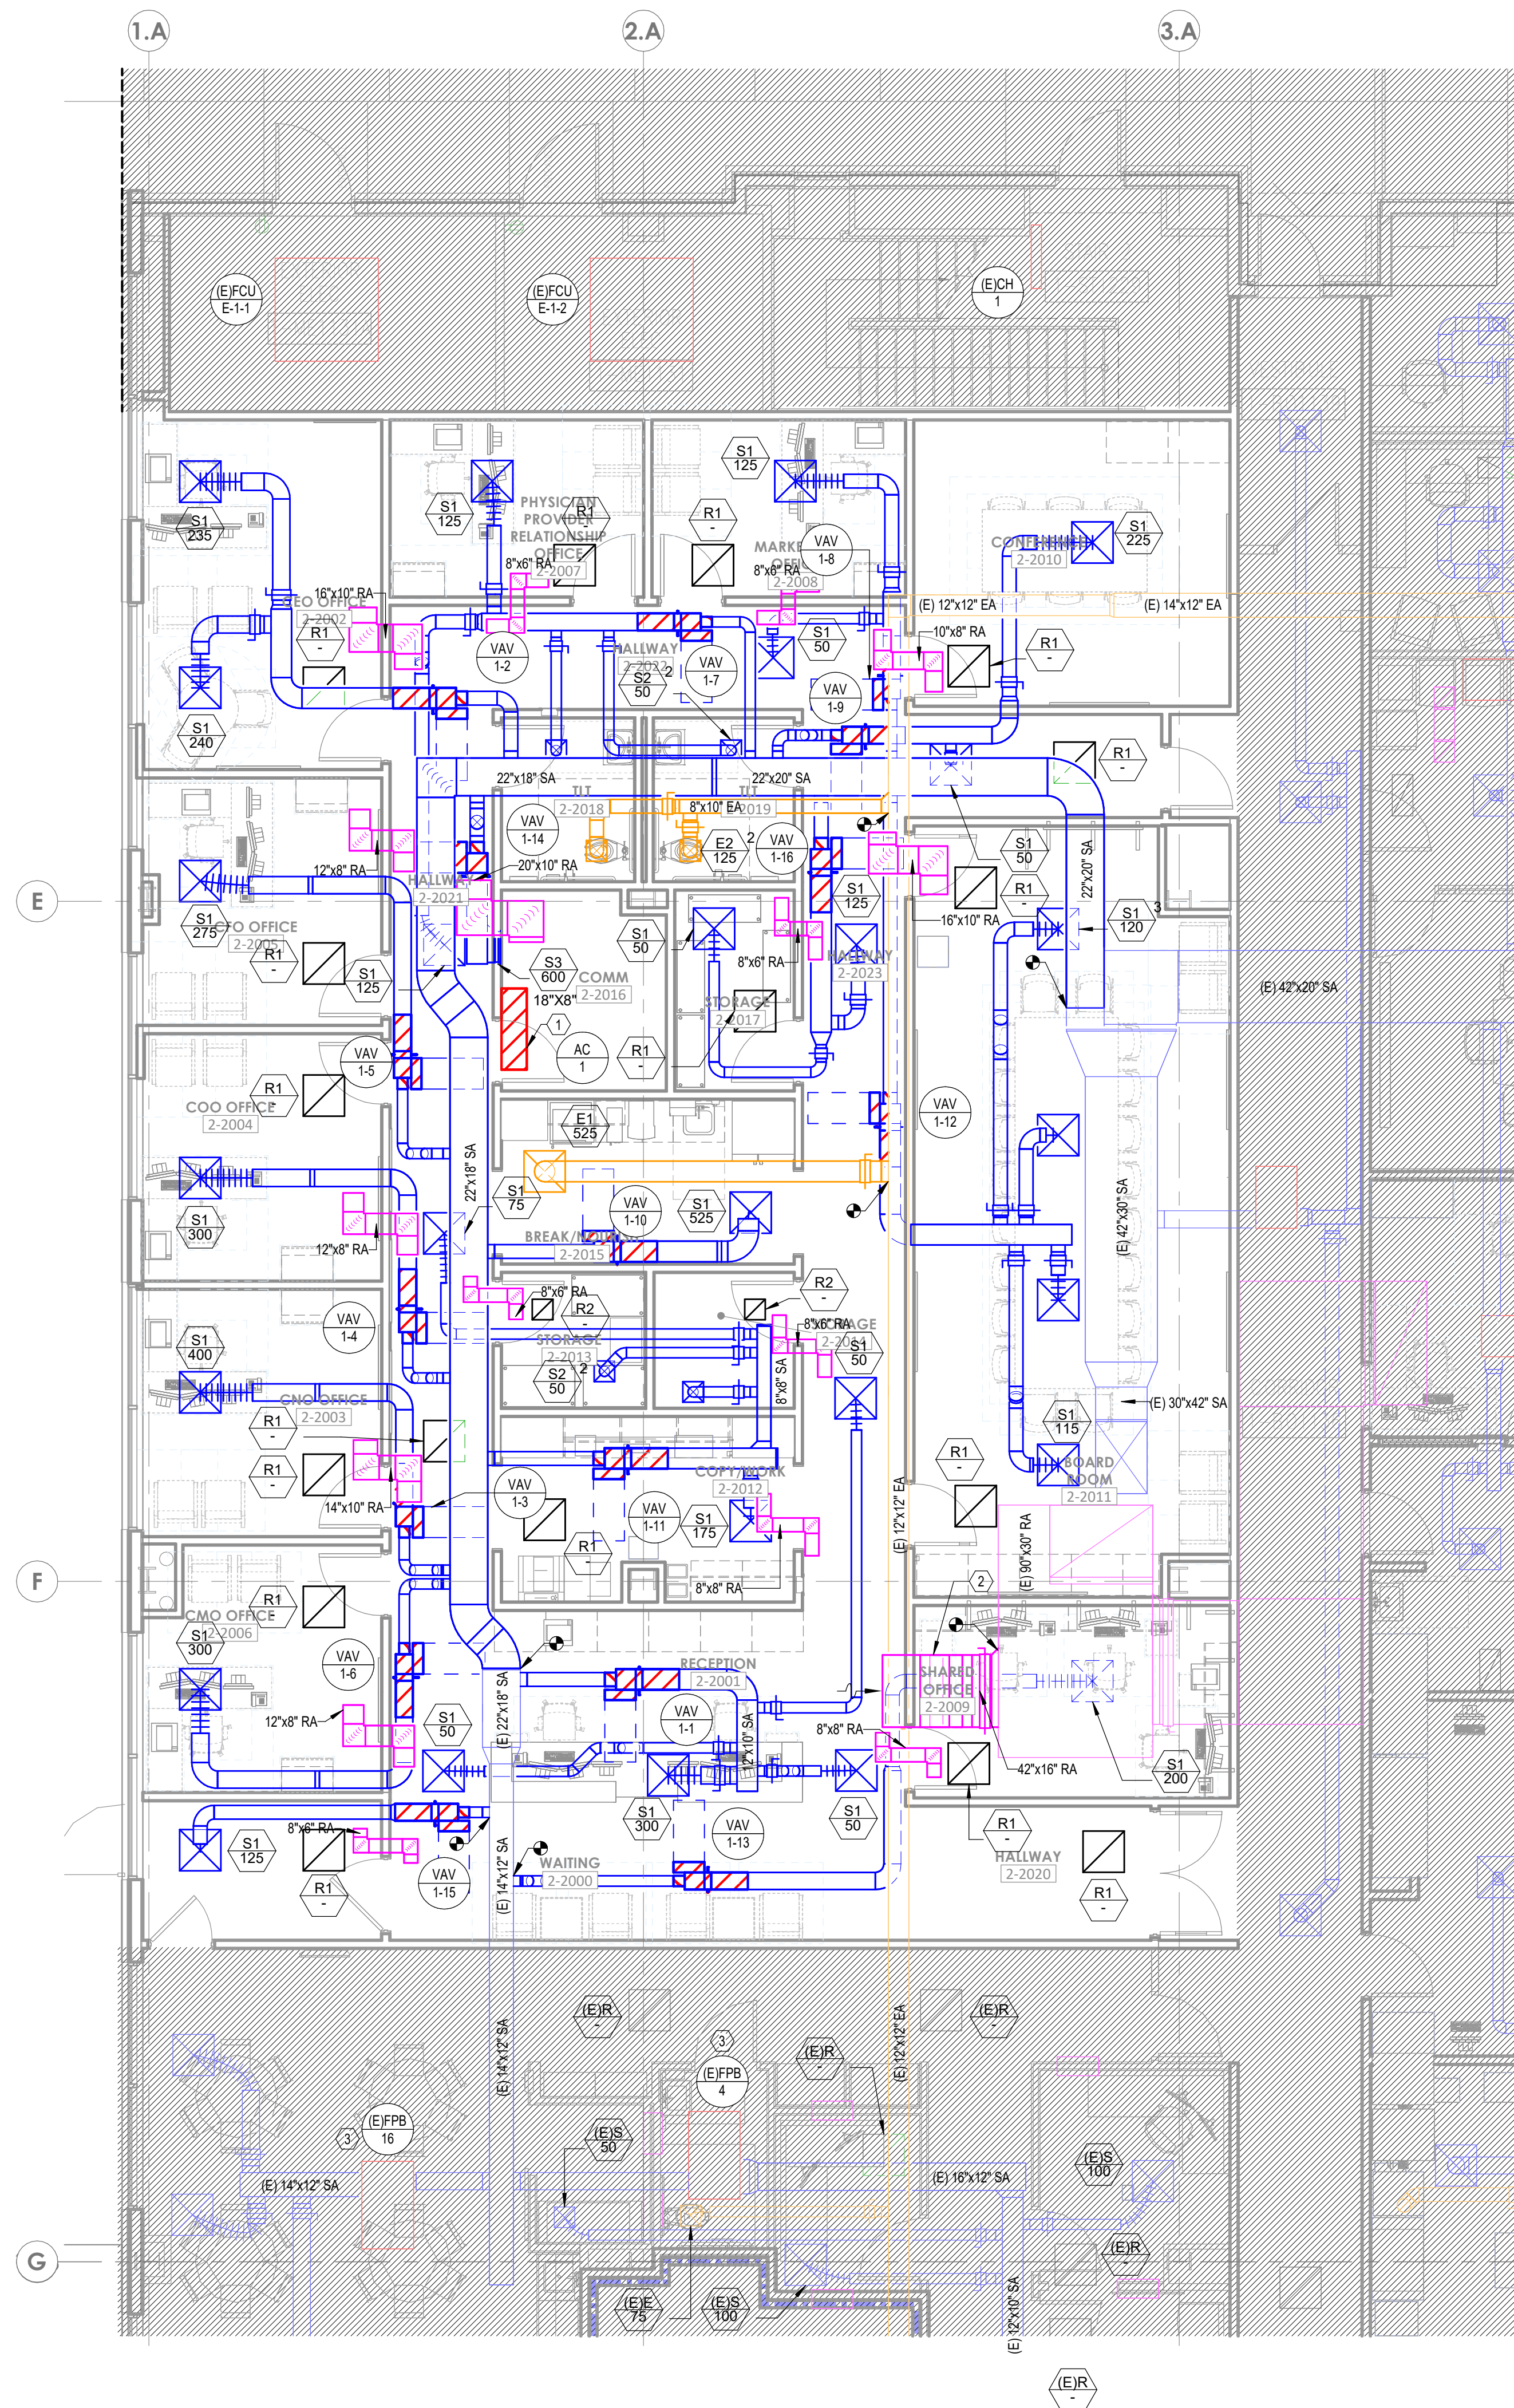
REVISIONS		
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DEMOLITION PLAN - LEVEL 1
- ADMIN - HVAC PIPING


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1 FLOOR PLAN - LEVEL 1 - ADMIN - HVAC
3/16" = 1'-0"

LEVEL 1 - KEYPLAN



GENERAL NOTES

- REFER TO M00-00 FOR GENERAL MECHANICAL NOTES AND SYMBOLS.
- CONTRACTOR TO VERIFY EXISTING CONDITIONS. EXISTING WORK SHOWN IS APPROXIMATE AND REPRESENTATIVE OF EXISTING DESIGN AND AS-BUILT DRAWINGS.
- PROVIDE REMOTE ADJUSTABLE DAMPERS FOR ANY BALANCING DAMPERS LOCATED ABOVE HARD CEILINGS.
- ACCESS PANELS TO BE PROVIDED FOR ANY MECHANICAL EQUIPMENT OR MECHANICAL DEVICES REQUIRING SERVICE LOCATED ABOVE HARD CEILINGS.

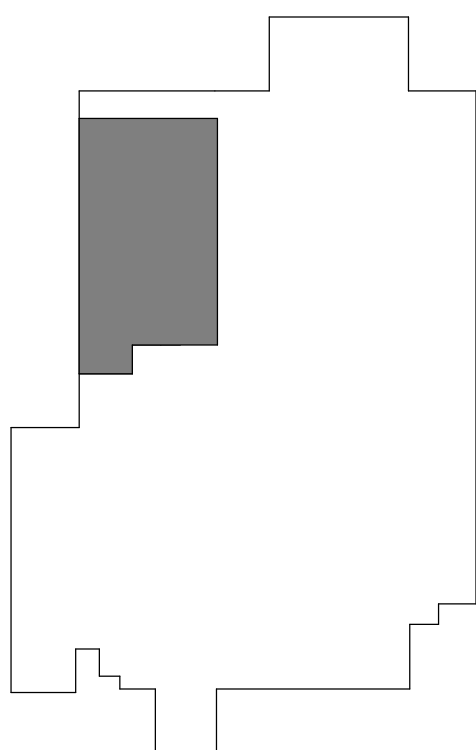LEGEND NOTES

- CONDENSING UNIT ACCU-1 PROVIDED ON ROOF ABOVE FOR AC-1.
- BALANCE TO 4.00 CFM OF RETURN AIR.
- CONTRACTOR TO PROVIDE TEMPORARY HEATING AND COOLING FOR SPACES AFFECTED BY DEMOLITION WORK.




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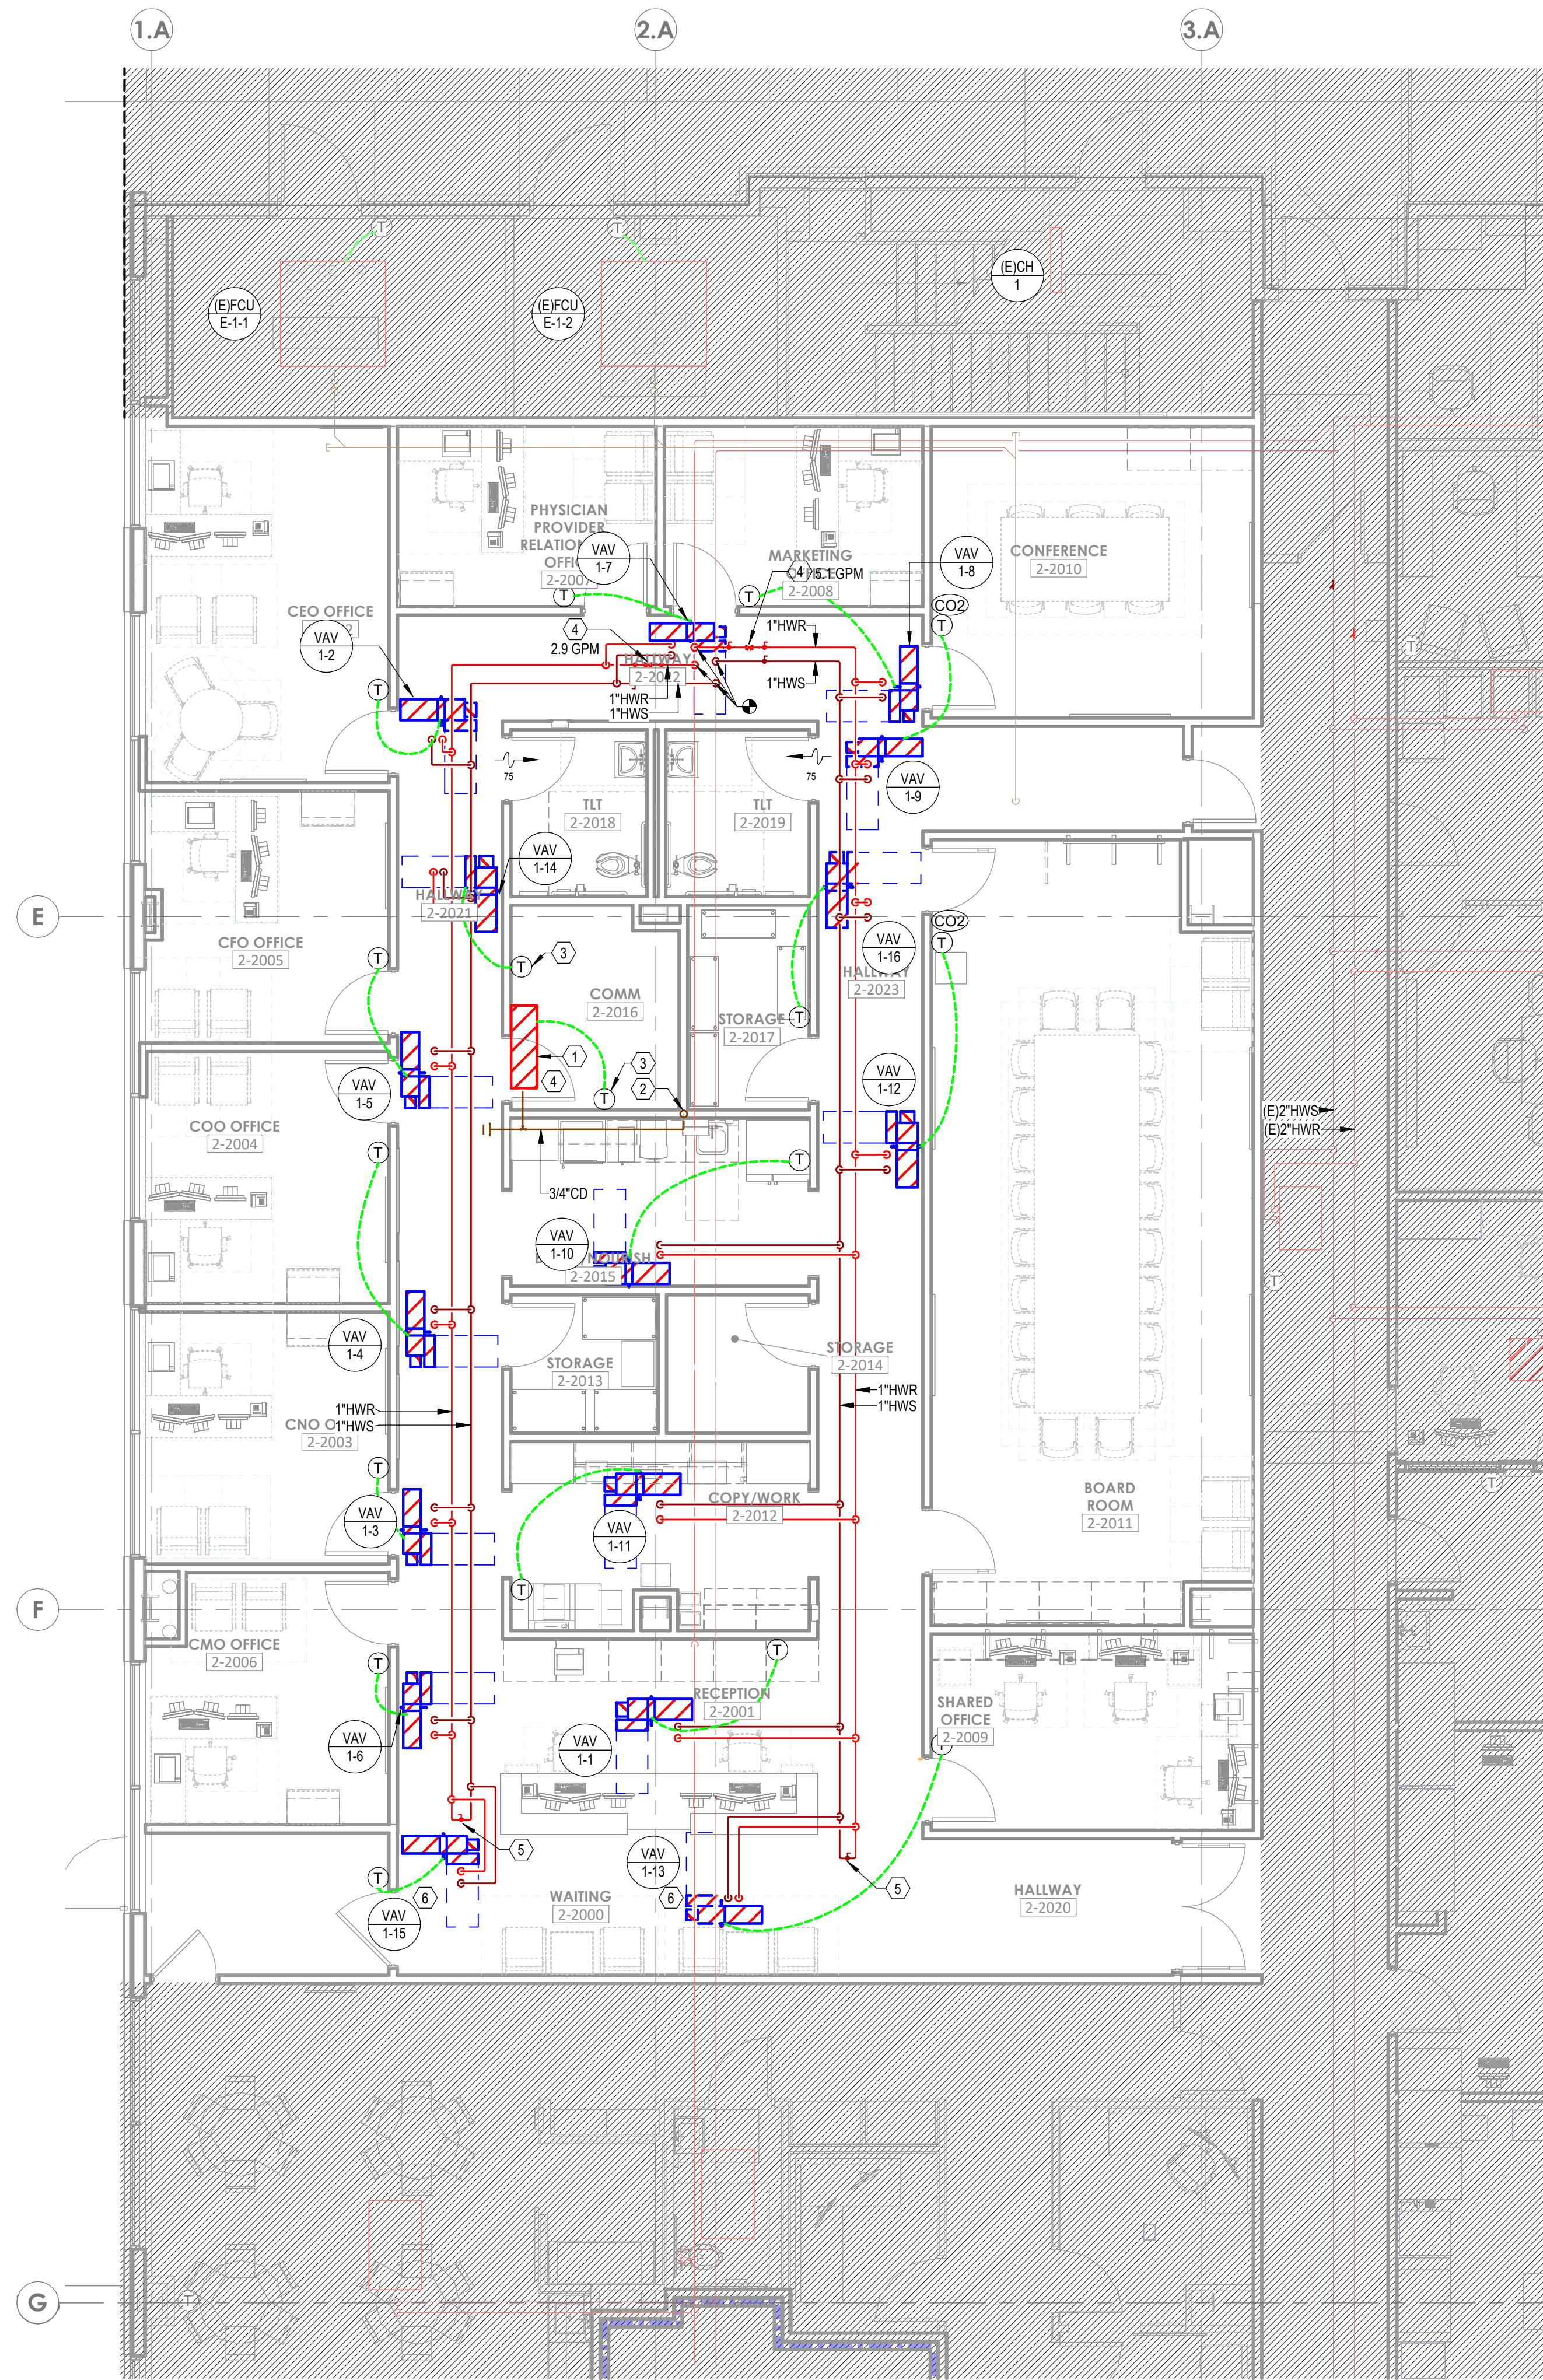
AGENCY APPROVALS:

REVISIONS		
REV #	DESCRIPTION	DATE
A	CITY - 2ND REVIEW	2025/05/29

DATE: 04/18/2025
SCALE: As indicated
DRAWN: HO
REVIEWED: JD
JOB NUMBER: 6406.24


FLOOR PLAN - LEVEL 1 -
ADMIN - HVAC

M02-01

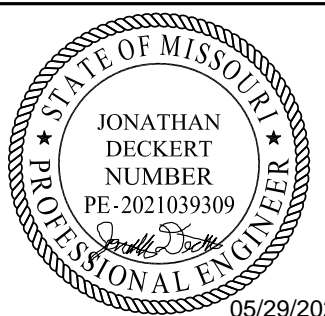

1 FLOOR PLAN - LEVEL 1 - ADMIN - HVAC PIPING
3/16" = 1'-0"

LEVEL 1 - KEYPLAN

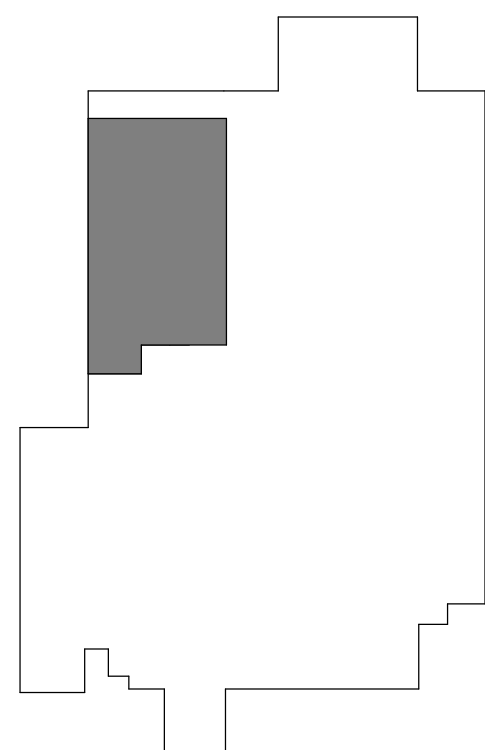

GENERAL DEMO NOTES

- REFER TO M00-00 FOR GENERAL MECHANICAL NOTES AND SYMBOLS.
- ALL EXISTING CONDITIONS INDICATED ON THESE DRAWINGS ARE APPROXIMATE AND BASED UPON A COMBINATION OF AVAILABLE RECORD DESIGN AND AS-BUILT DOCUMENTS. CONTRACTOR TO VERIFY EXISTING CONDITIONS.
- ALL EXISTING PIPE SIZES ON PLAN ARE PER THE DESIGN DOCUMENTS PROVIDED.
- CONTRACTOR TO PRE-TAB ALL SUPPLY AND RETURN PIPING SERVED BY EXISTING SYSTEMS MODIFIED AS A PART OF THIS SCOPE. CONTRACTOR TO DOCUMENT PRECONSTRUCTION VALUES AND PROVIDE TO ENGINEER OF RECORD. UPON COMPLETION OF CONSTRUCTION, REBALANCE ALL EXISTING AREAS TO PRE-TABBED CONSTRUCTION VALUES.

LEGEND NOTES

- SIZE AND ROUTE REFRIGERANT PIPING PER MANUFACTURER'S INSTRUCTIONS FROM AC-1 UP TO CONDENSING UNIT (ACCU-1) ON ROOF. CONTRACTOR SHALL UTILIZE SHAFT AND MINIMIZE DISTURBANCE TO OTHER TENANTS WITH ROUTING.
- ROUTE 3/4" CONDENSATE DRAIN DOWN TO HUB DRAIN BELOW SINK.
- SET THERMOSTAT FOR VAV-14 THREE DEGREES BELOW THERMOSTAT FOR AC-1.
- CALIBRATED ORIFICE BALANCING VALVE BALANCED TO GPM INDICATED.
- PROVIDE END OF MAIN FLUSHING VALVE AT THE END OF HW PIPING RUN. REFER TO DETAIL 06/M07-01.
- PROVIDE 3-WAY CONTROL VALVE FOR VAV AT THE END OF THE PIPING RUN.



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LEE'S SUMMIT, MO 64063

AUTHORITY HAVING JURISDICTION:
CITY OF LEE'S SUMMIT BUILDING DEPT.
MISSOURI DHSS

FACILITY NUMBER:
0972400009

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FLOOR PLAN - LEVEL 1 -
ADMIN - HVAC PIPING




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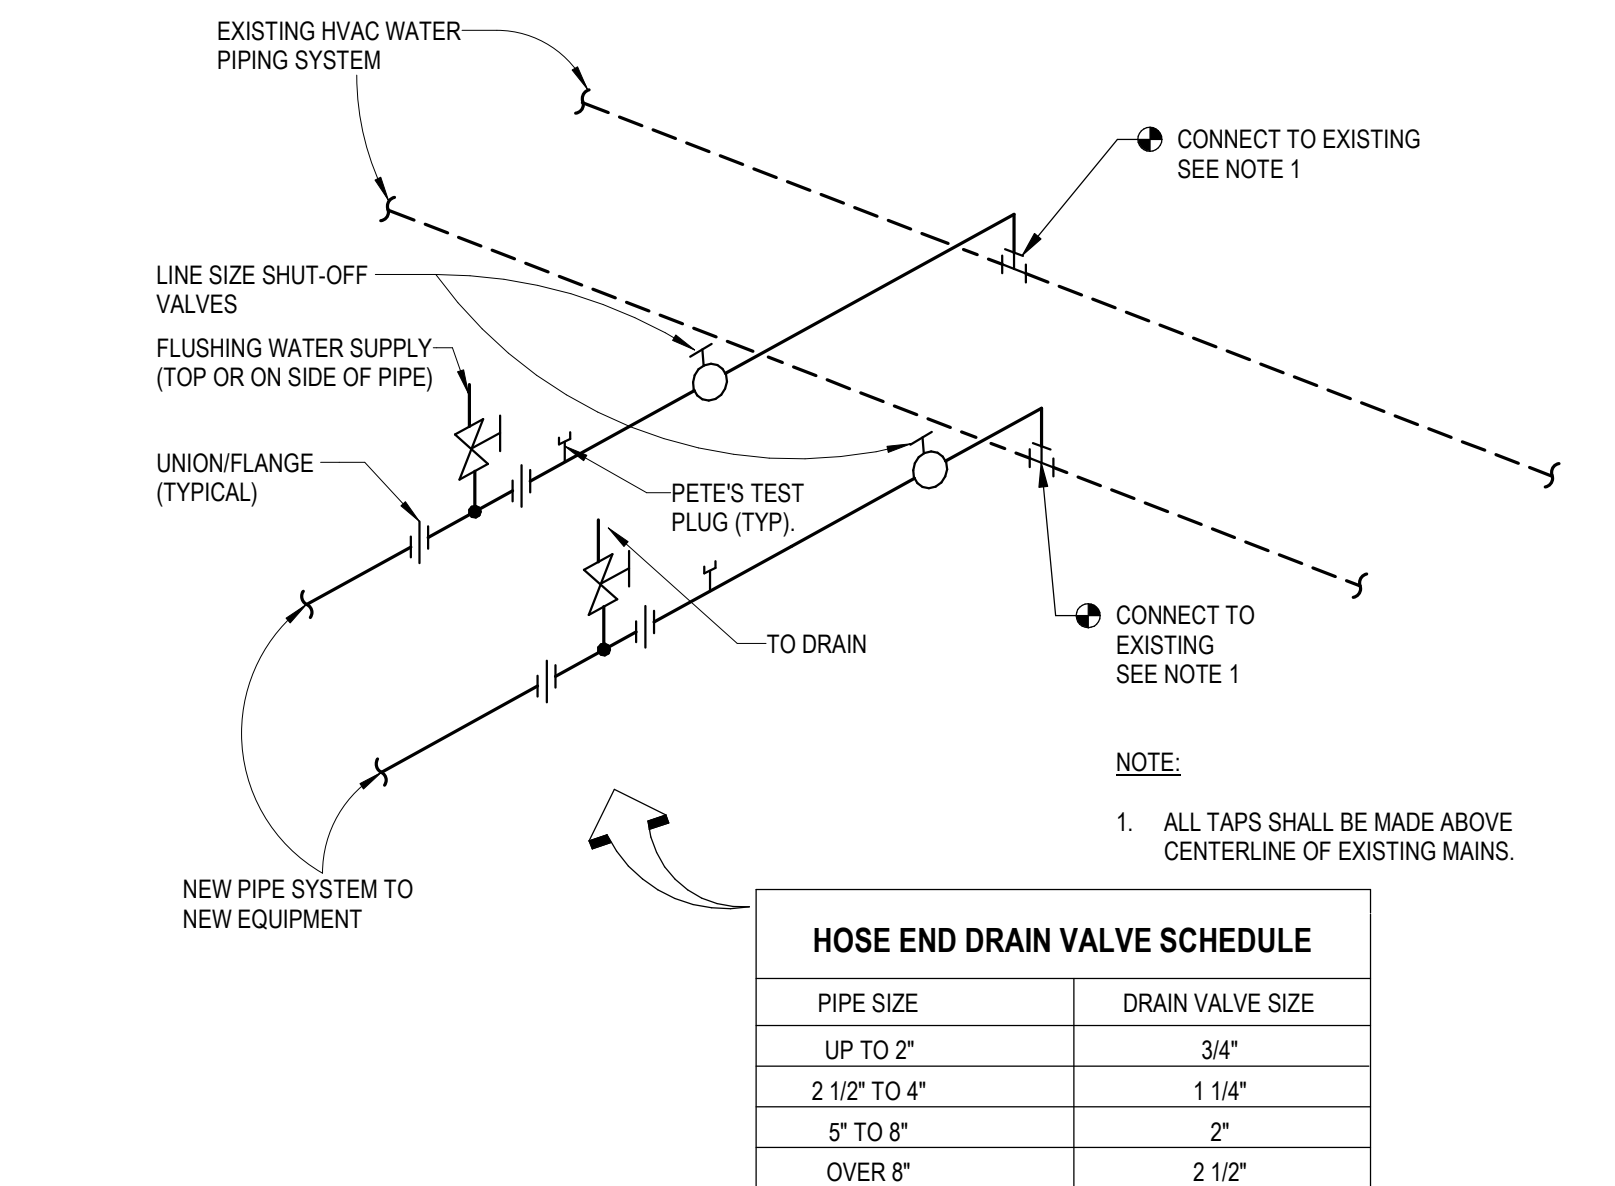
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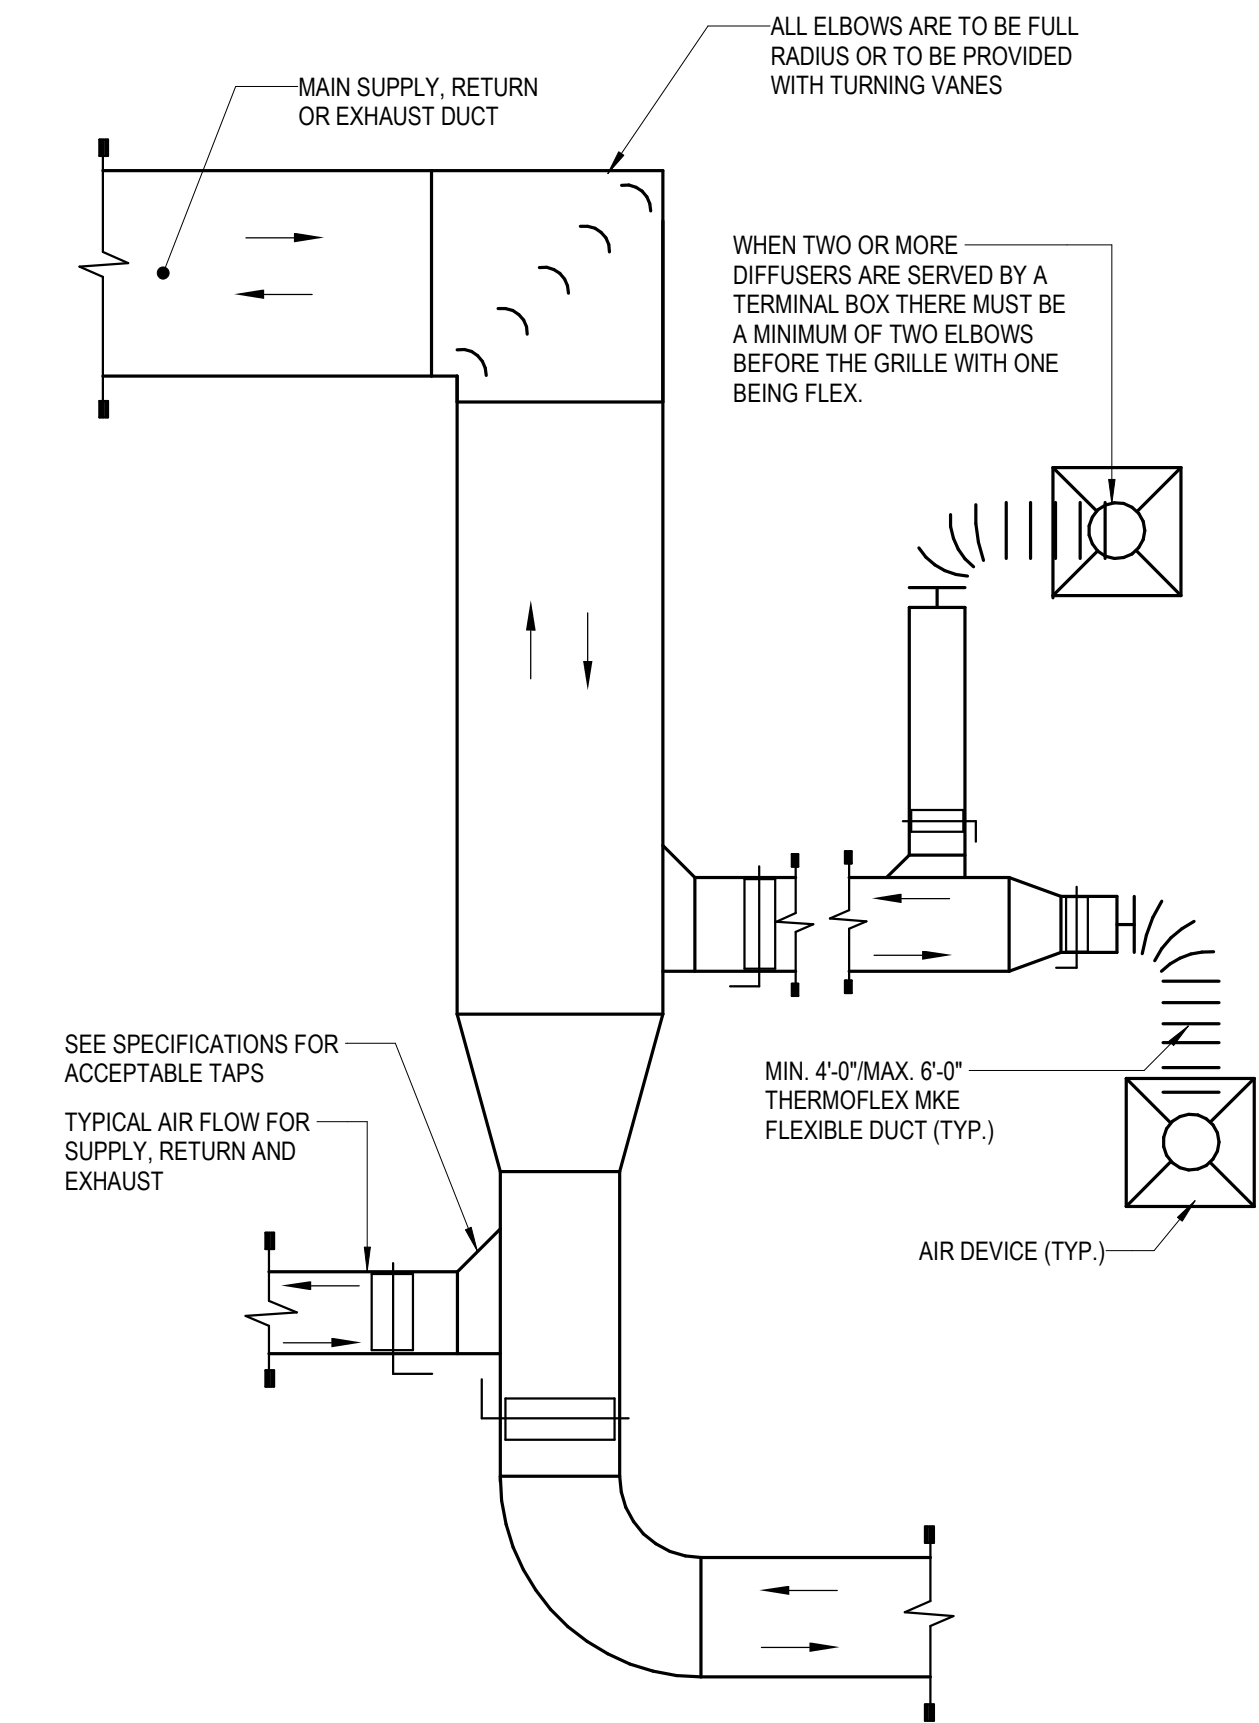
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M06-01







7 PIPING CONNECTION DETAIL
NOT TO SCALE

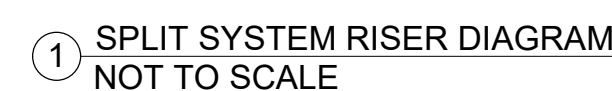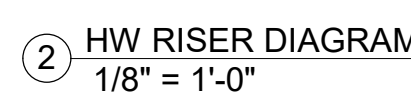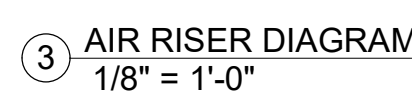


5 TYPICAL LOW PRESSURE SUPPLY, RETURN AND EXHAUST DUCT DETAIL
NOT TO SCALE

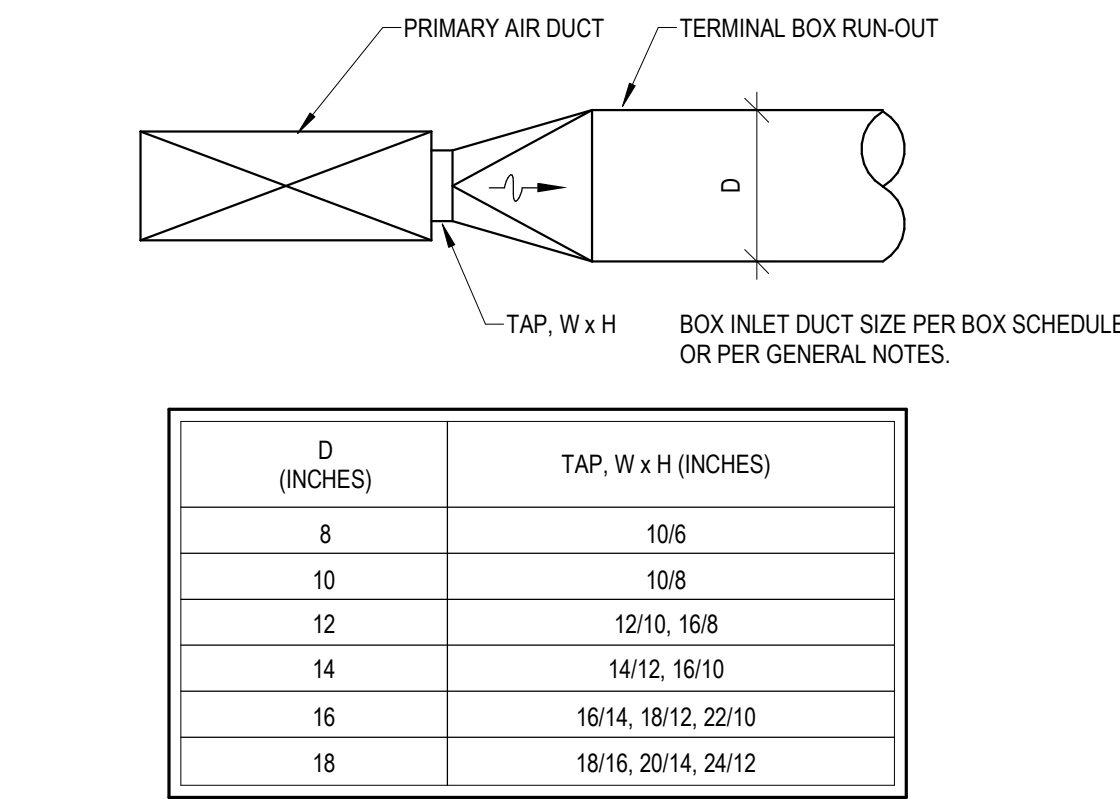


3 TERMINAL BOX INLET DUCT EQUIVALENT RECTANGULAR TO ROUND DUCT TAPS
NOT TO SCALE

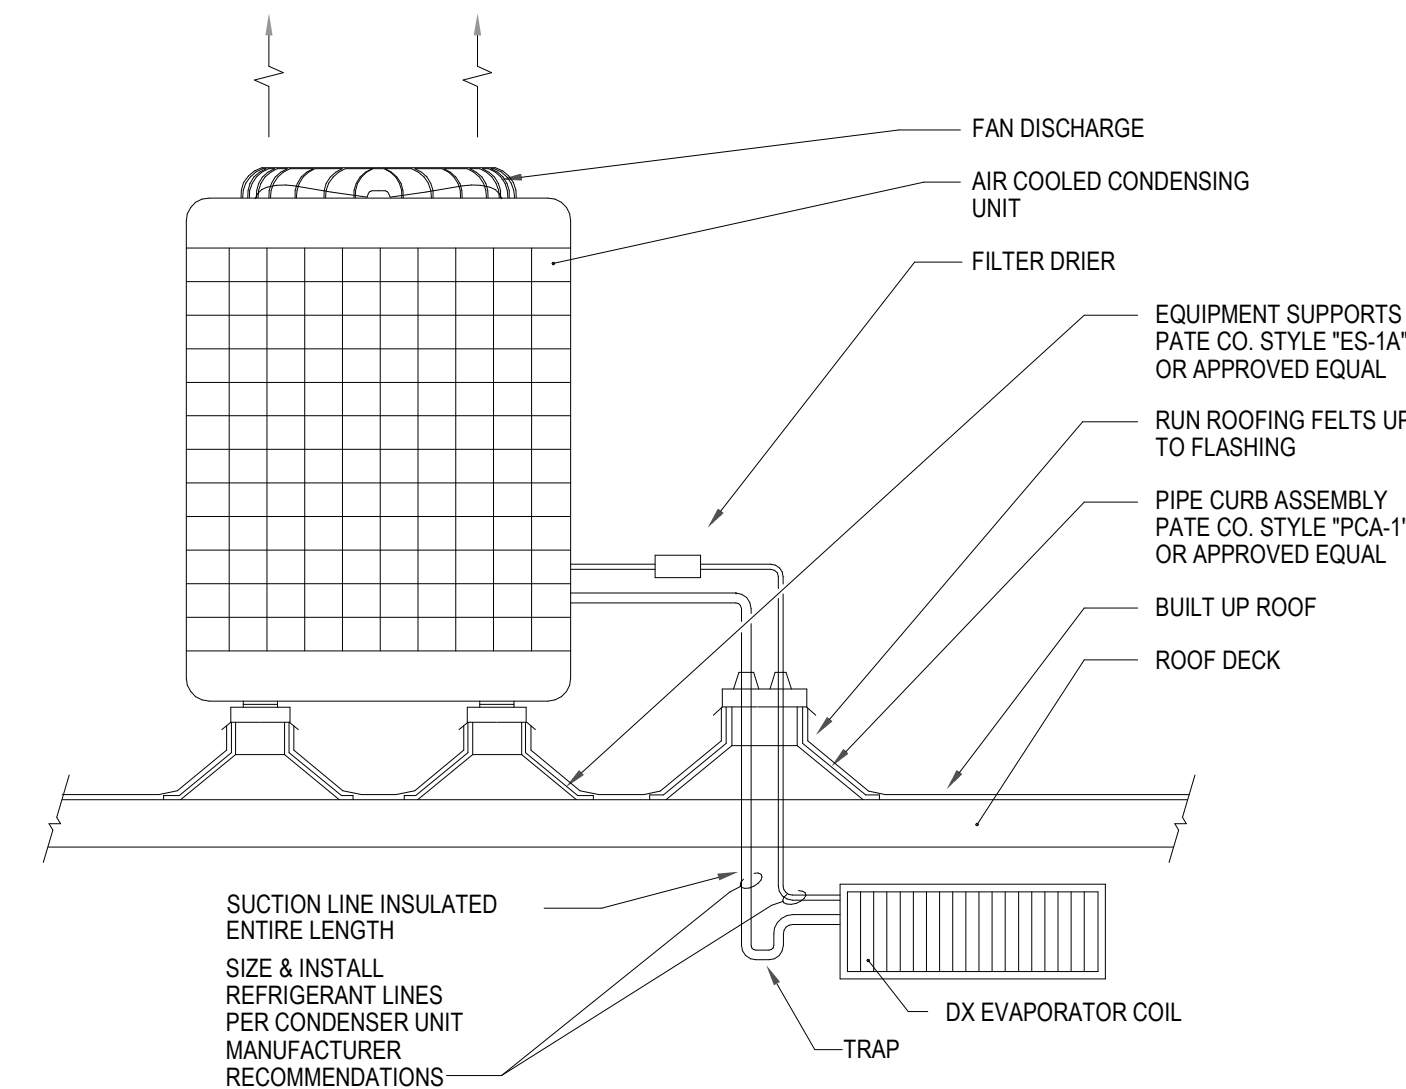


2 SPLIT REFRIGERANT CIRCUIT DETAIL - ROOF MOUNTED
NOT TO SCALE

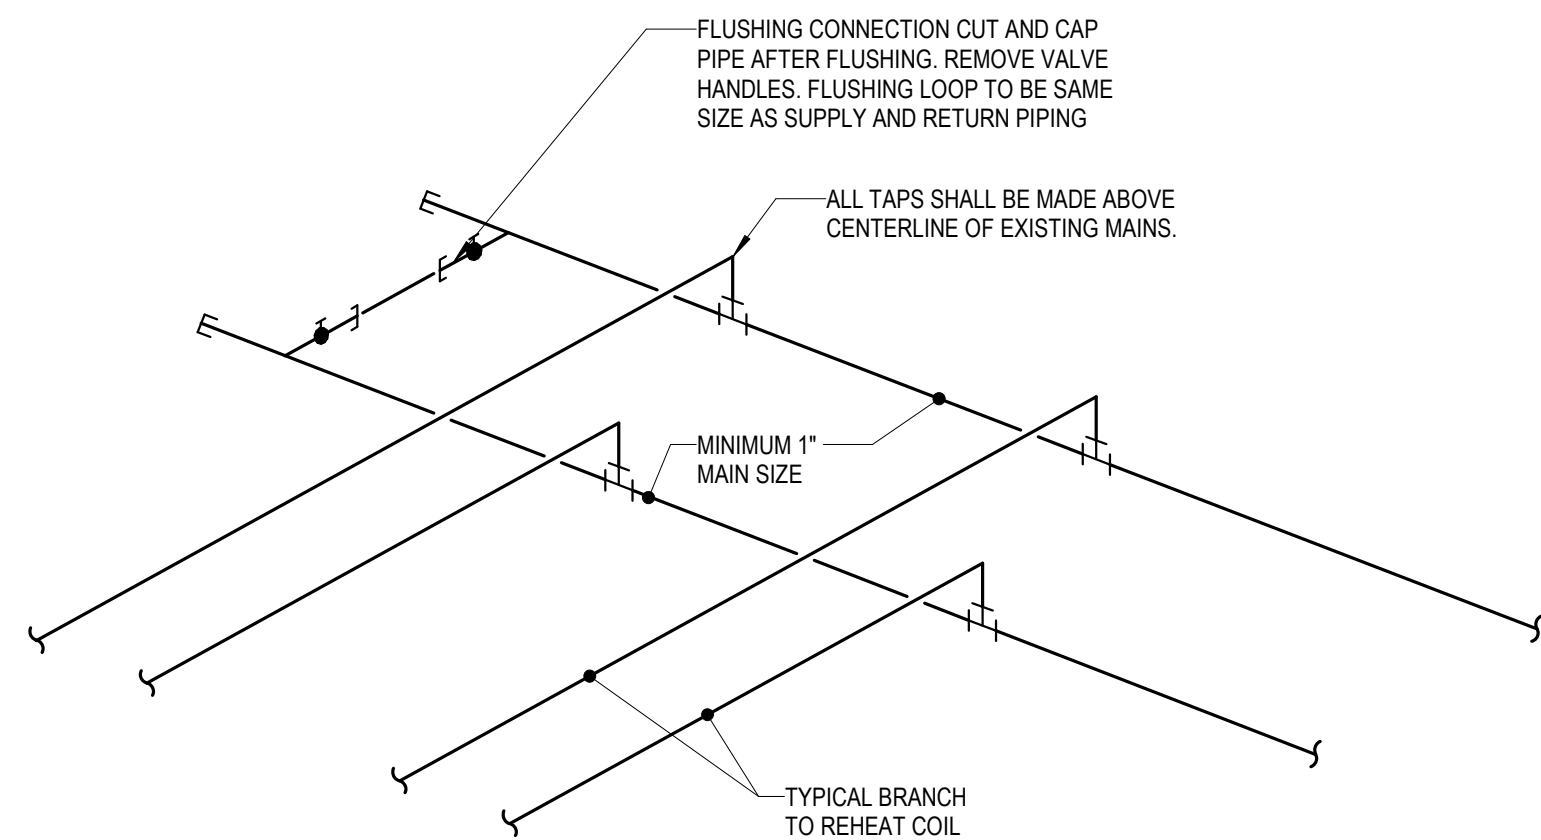

6 HVAC REHEAT HOT WATER END OF MAIN FLUSHING DETAIL
NOT TO SCALE

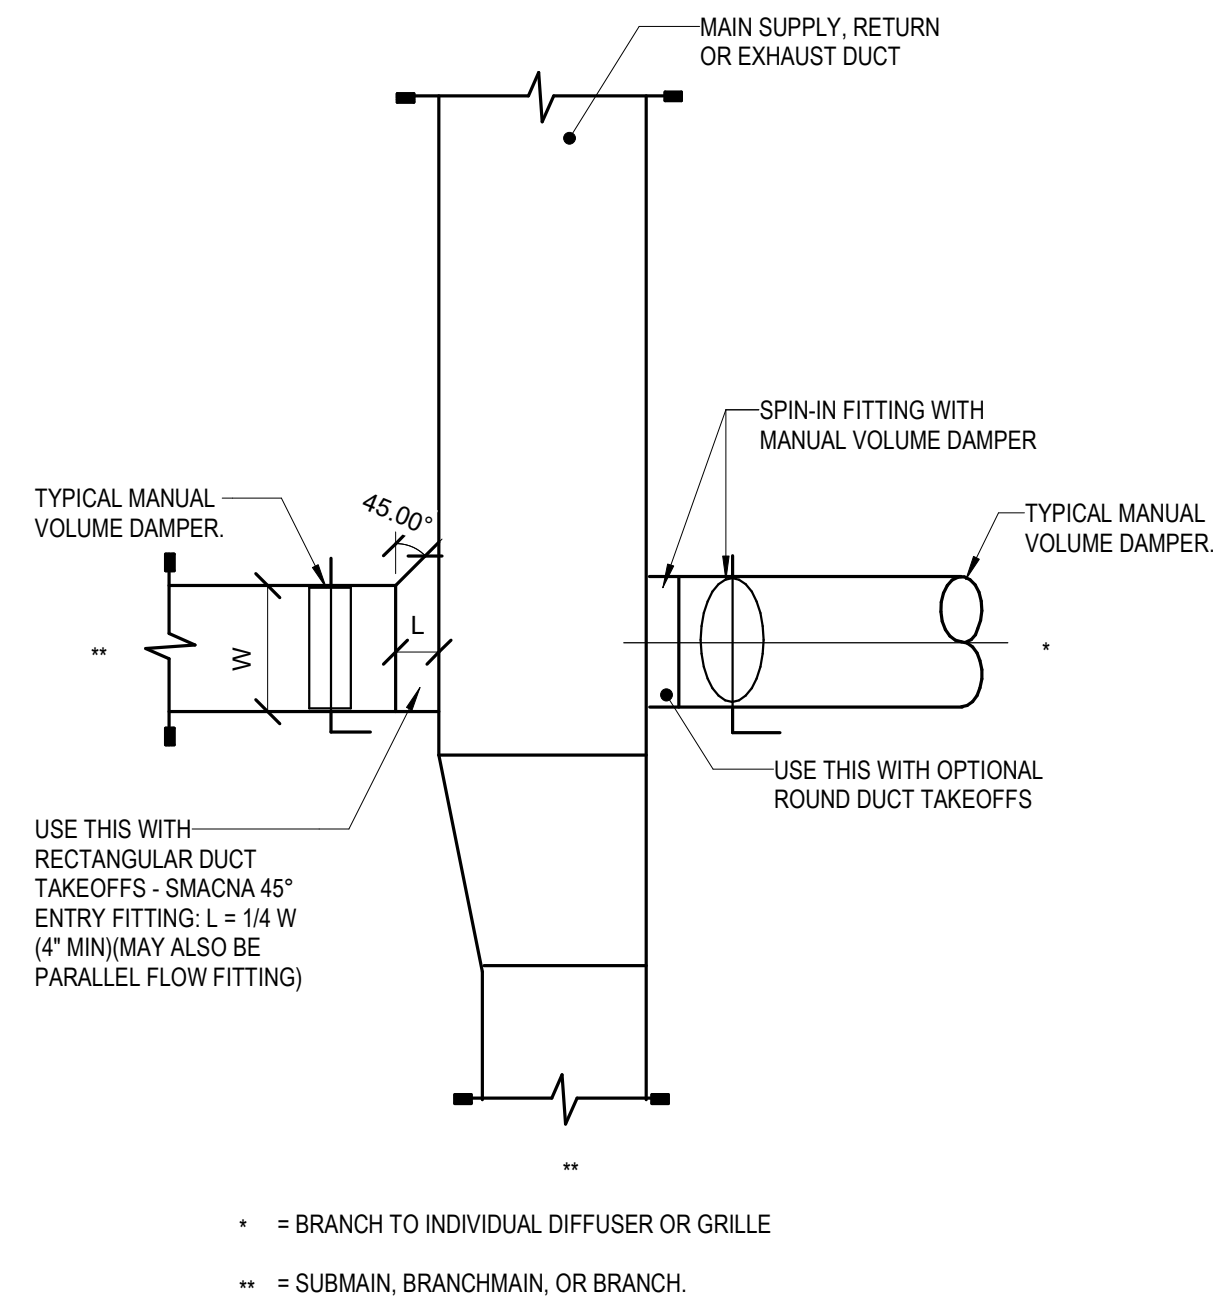

4 LOW PRESSURE DUCT VOLUME DAMPER REQUIREMENTS
NOT TO SCALE

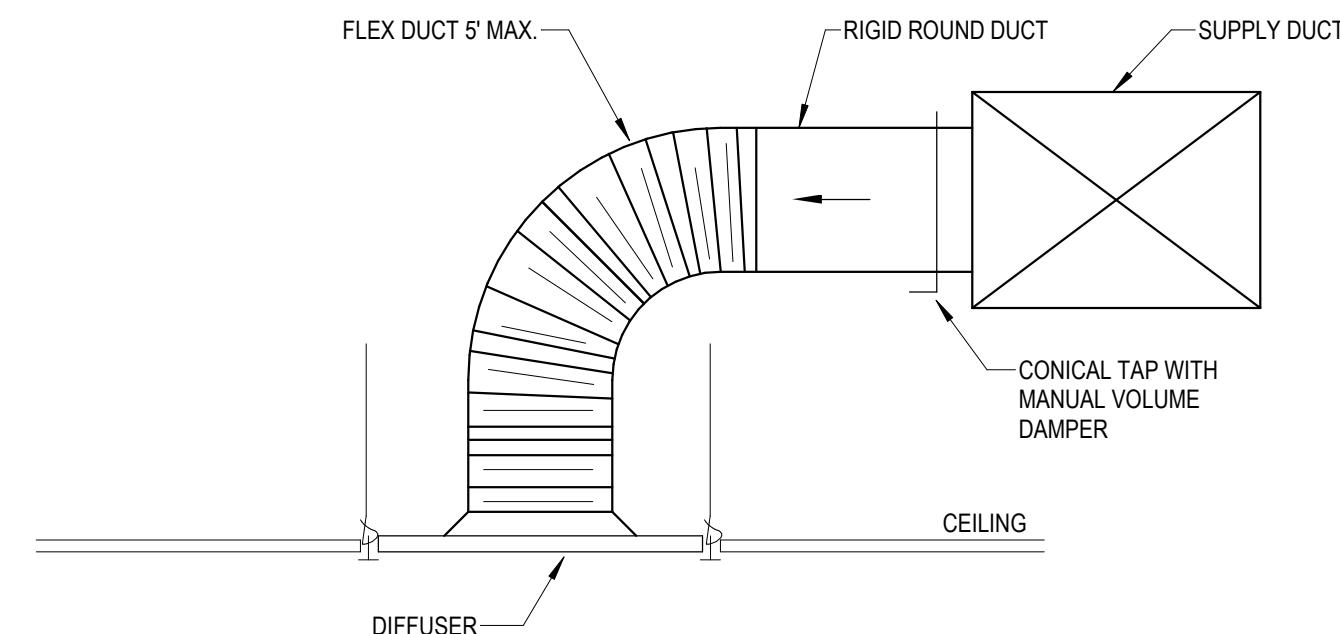

1 DIFFUSER CONNECTION ROUND RUNOUT
NOT TO SCALE



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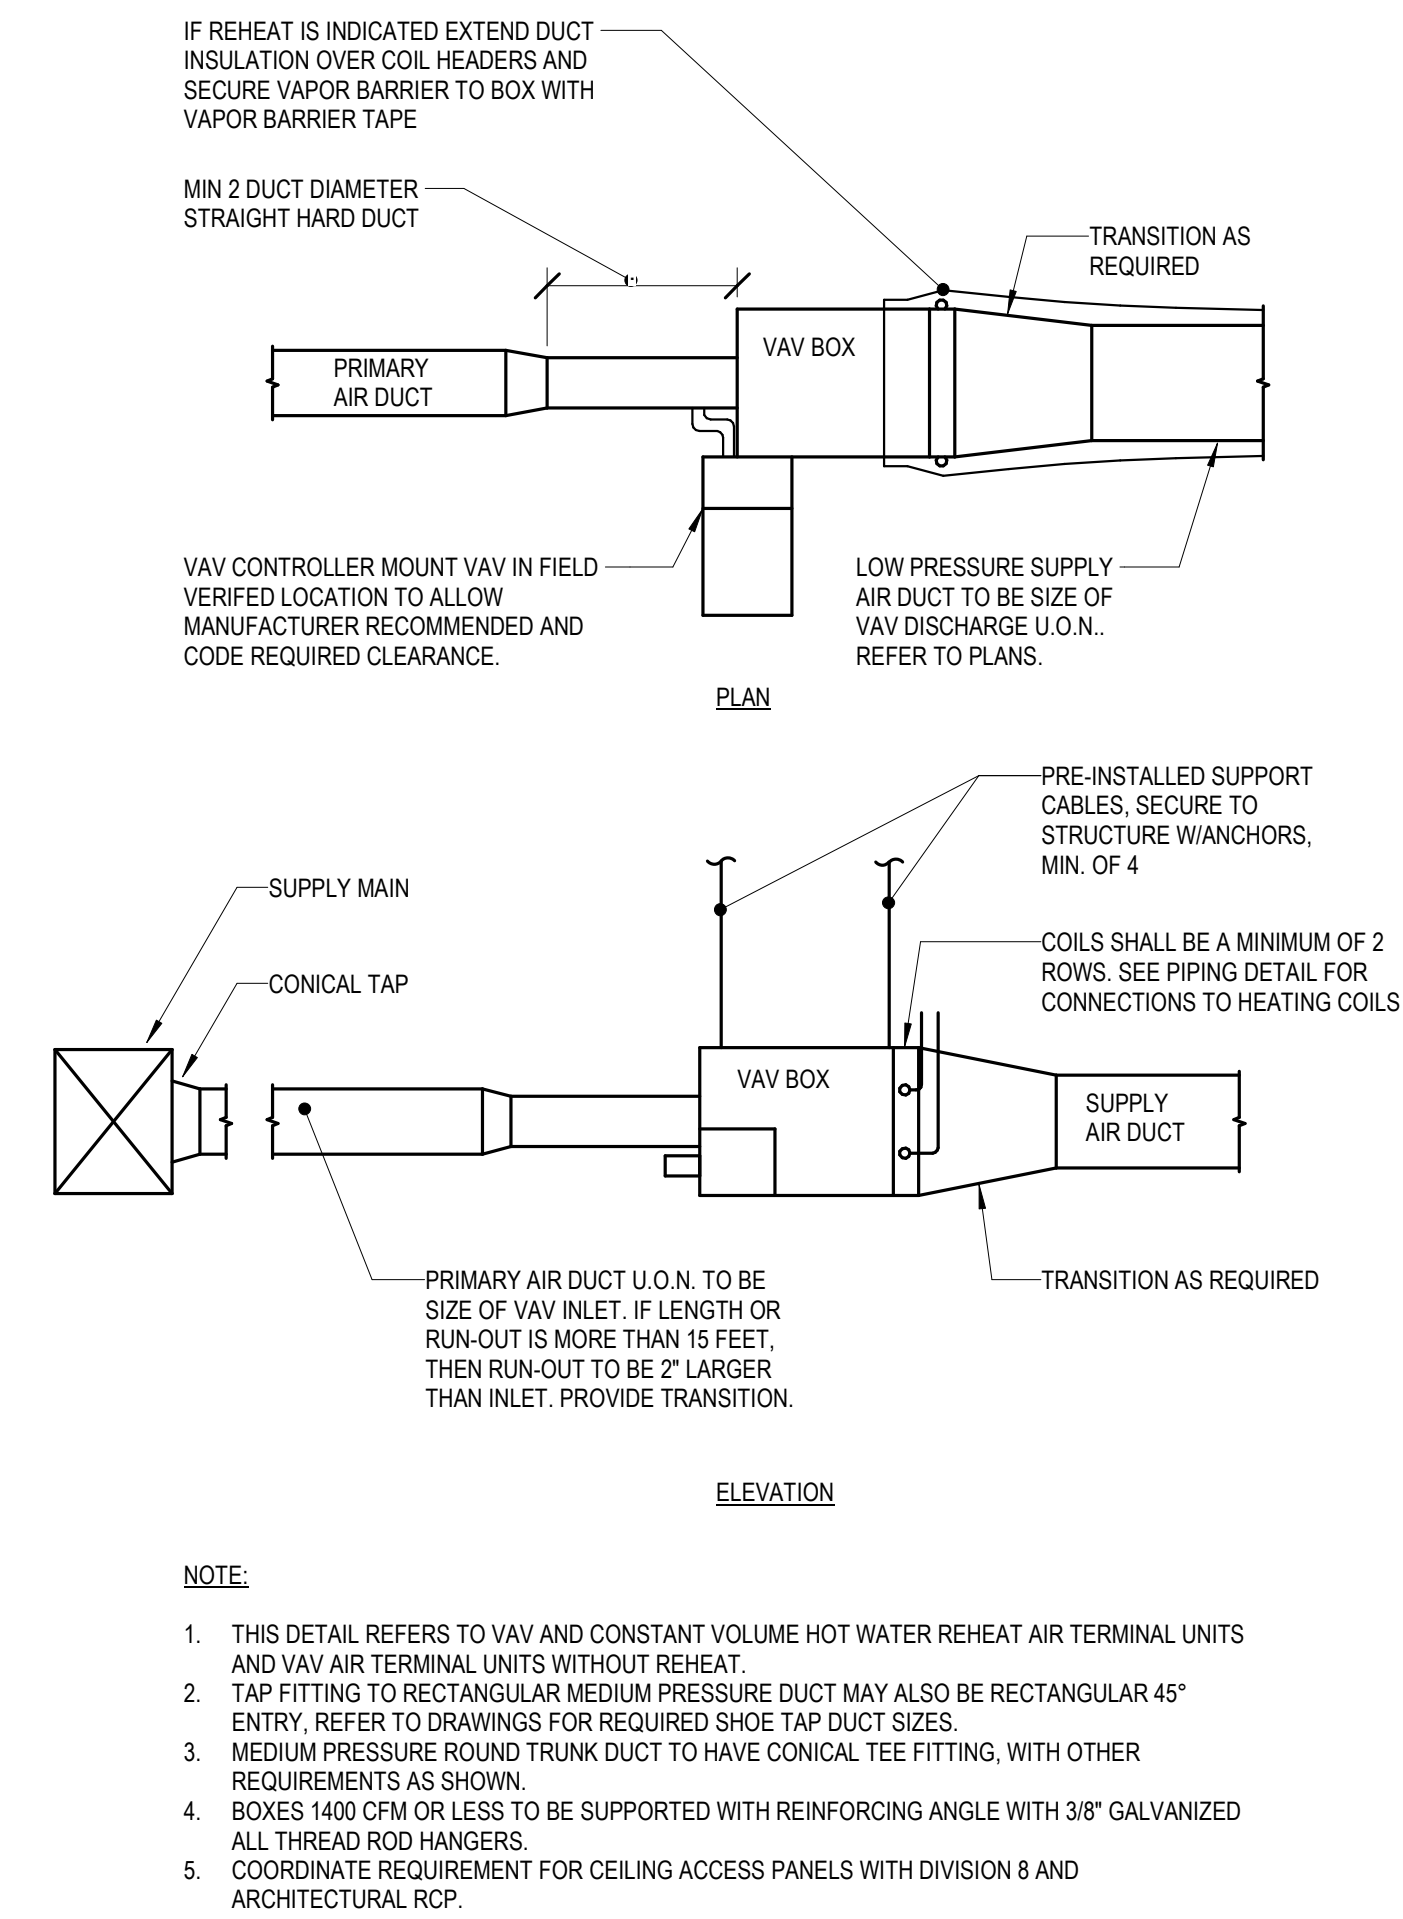
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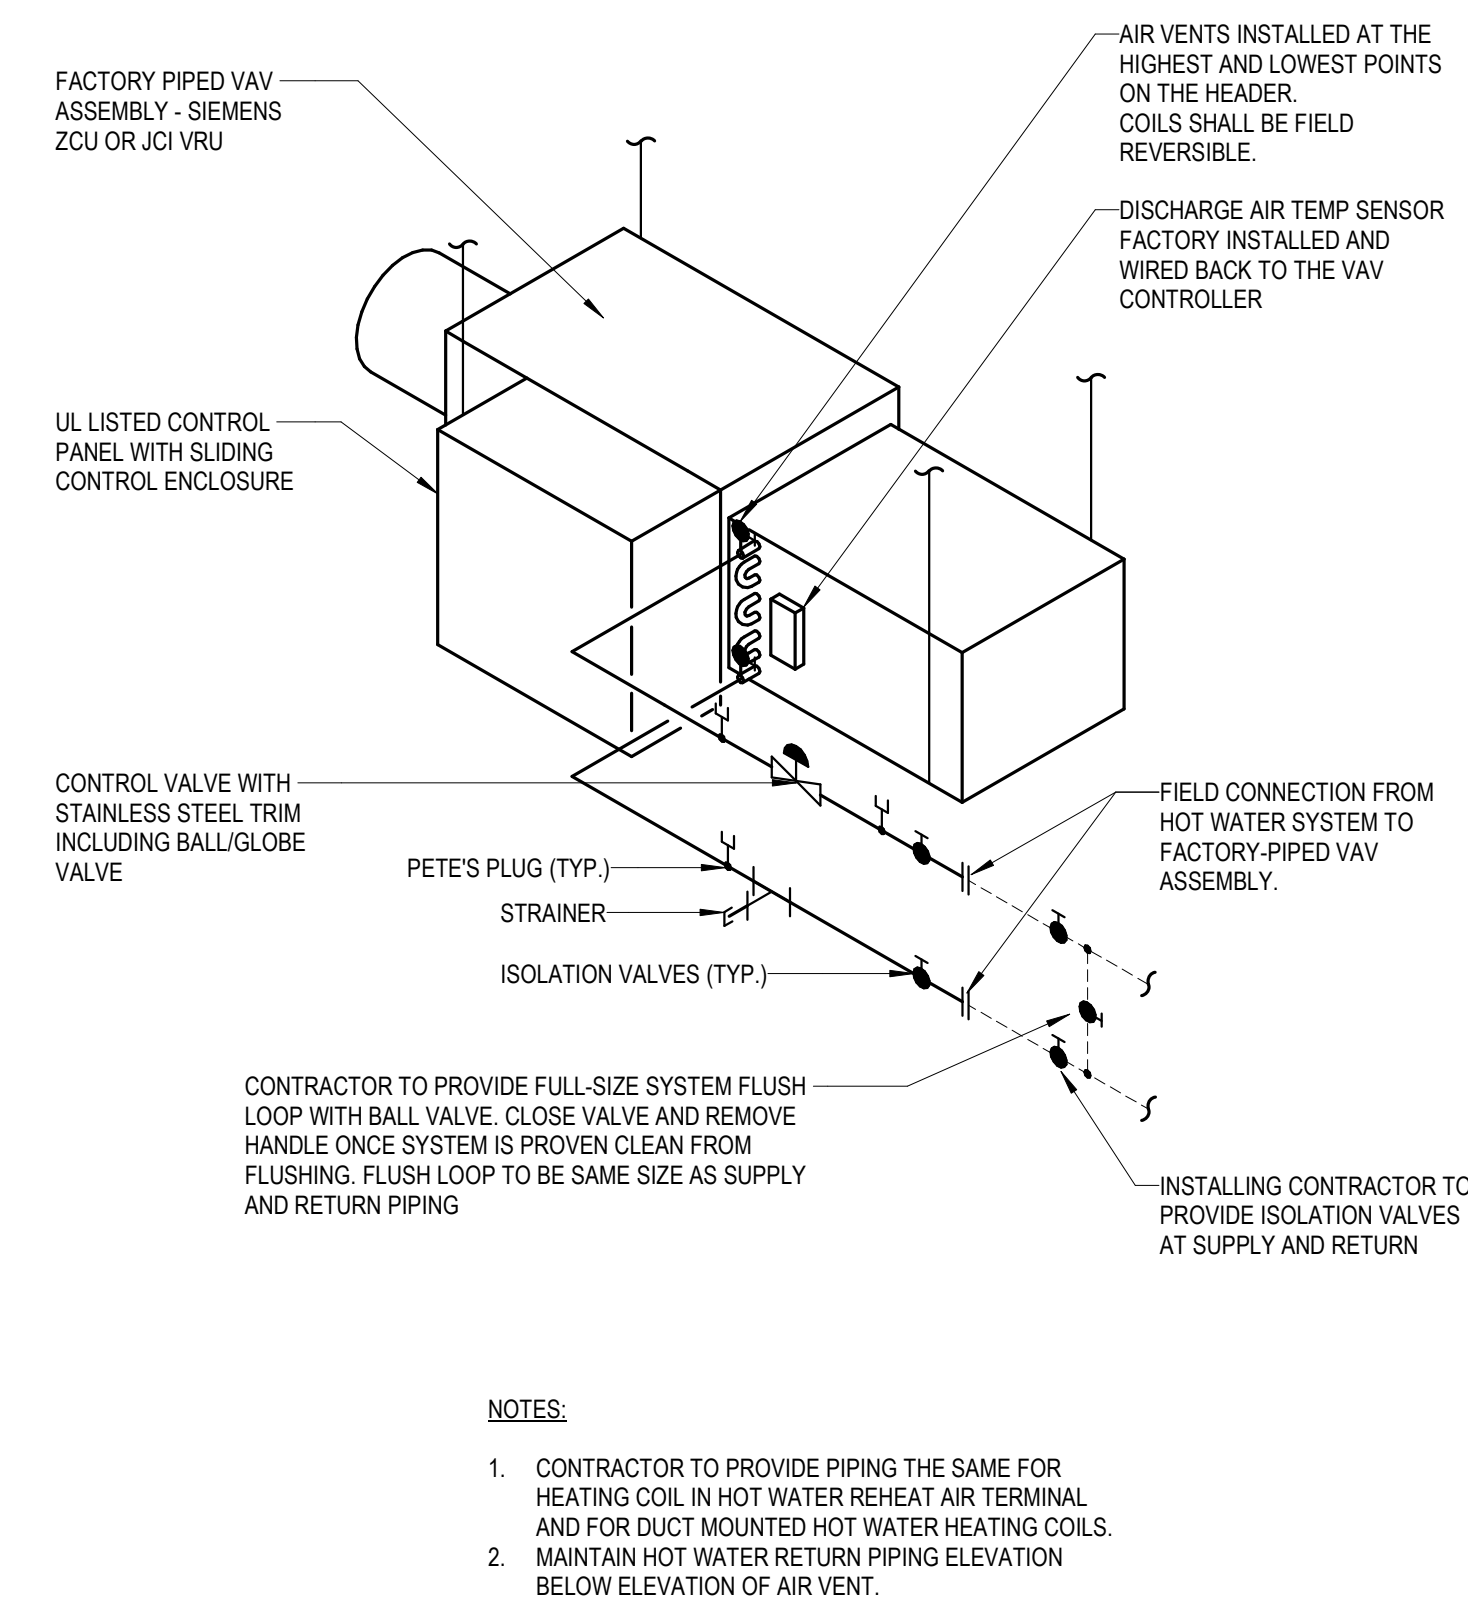
DETAILS - MECHANICAL

M07-01


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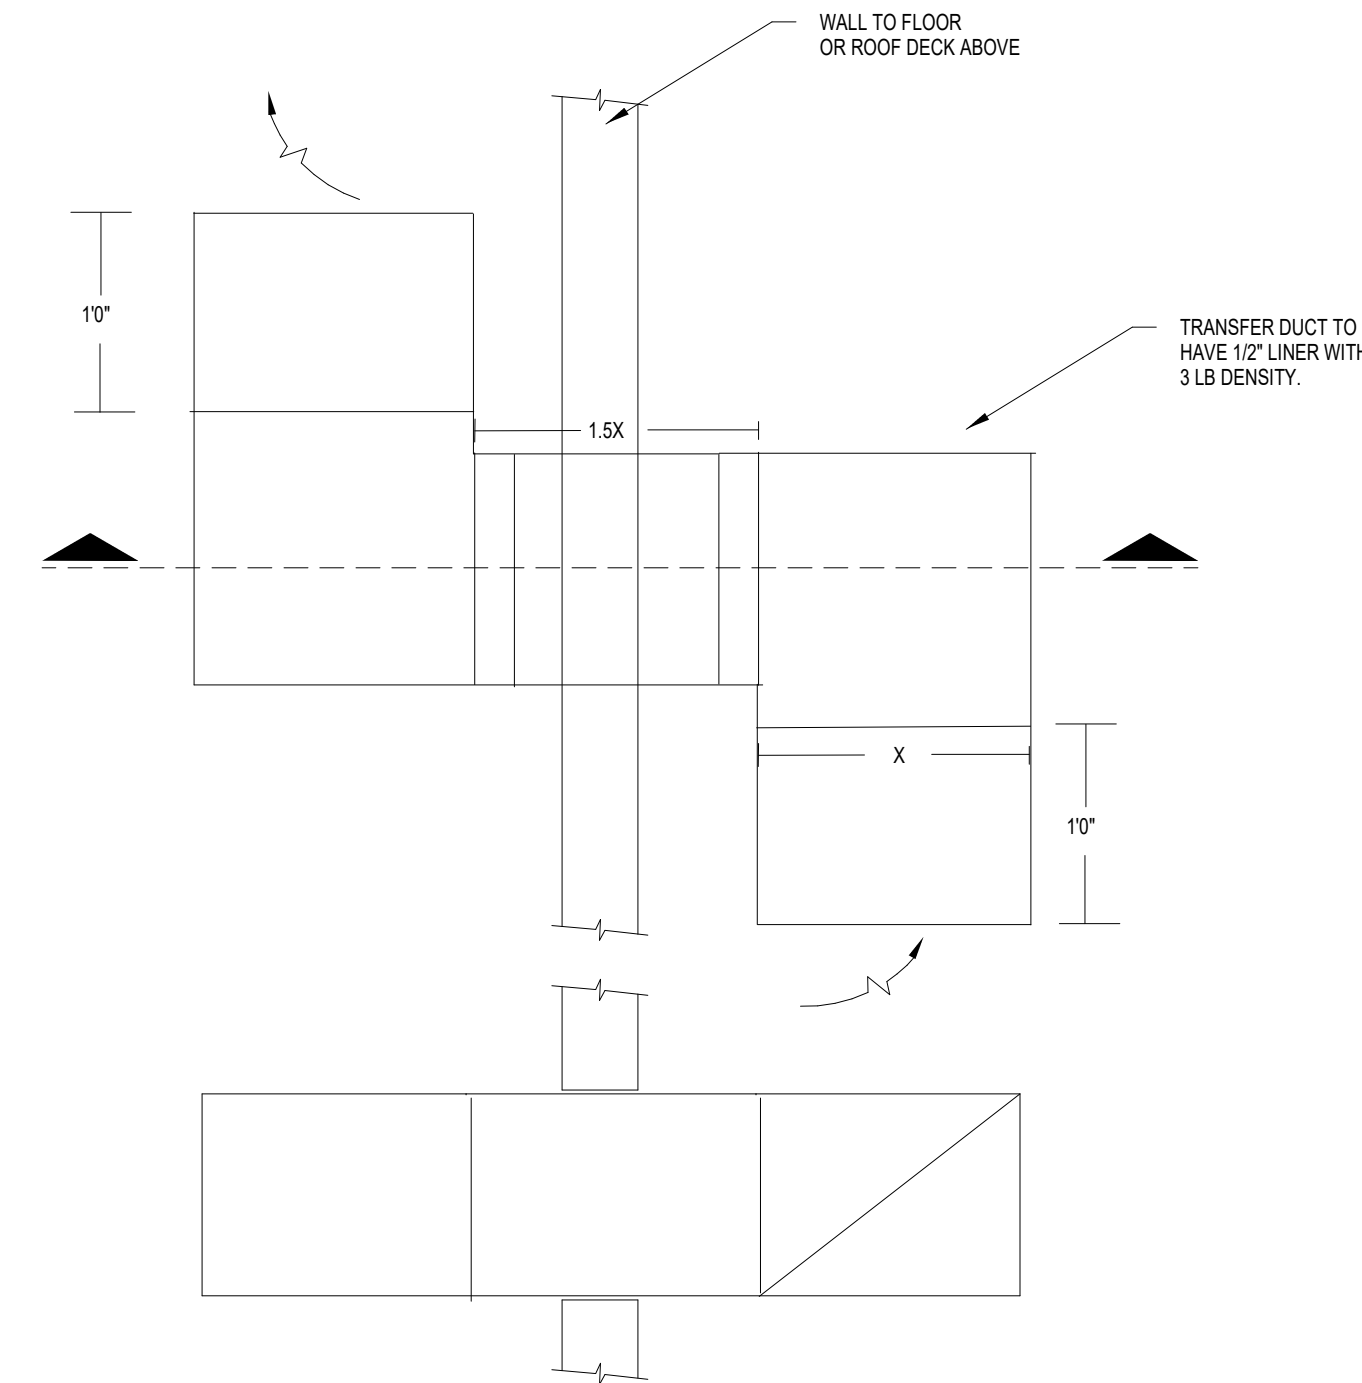
④ VAV BOX INSTALLATION DETAIL
NOT TO SCALE



③ PIPING AT TERMINAL REHEAT
NOT TO SCALE



② MEDIUM PRESSURE SUPPLY DUCT FITTINGS - HORIZONTAL DUCTS
NOT TO SCALE

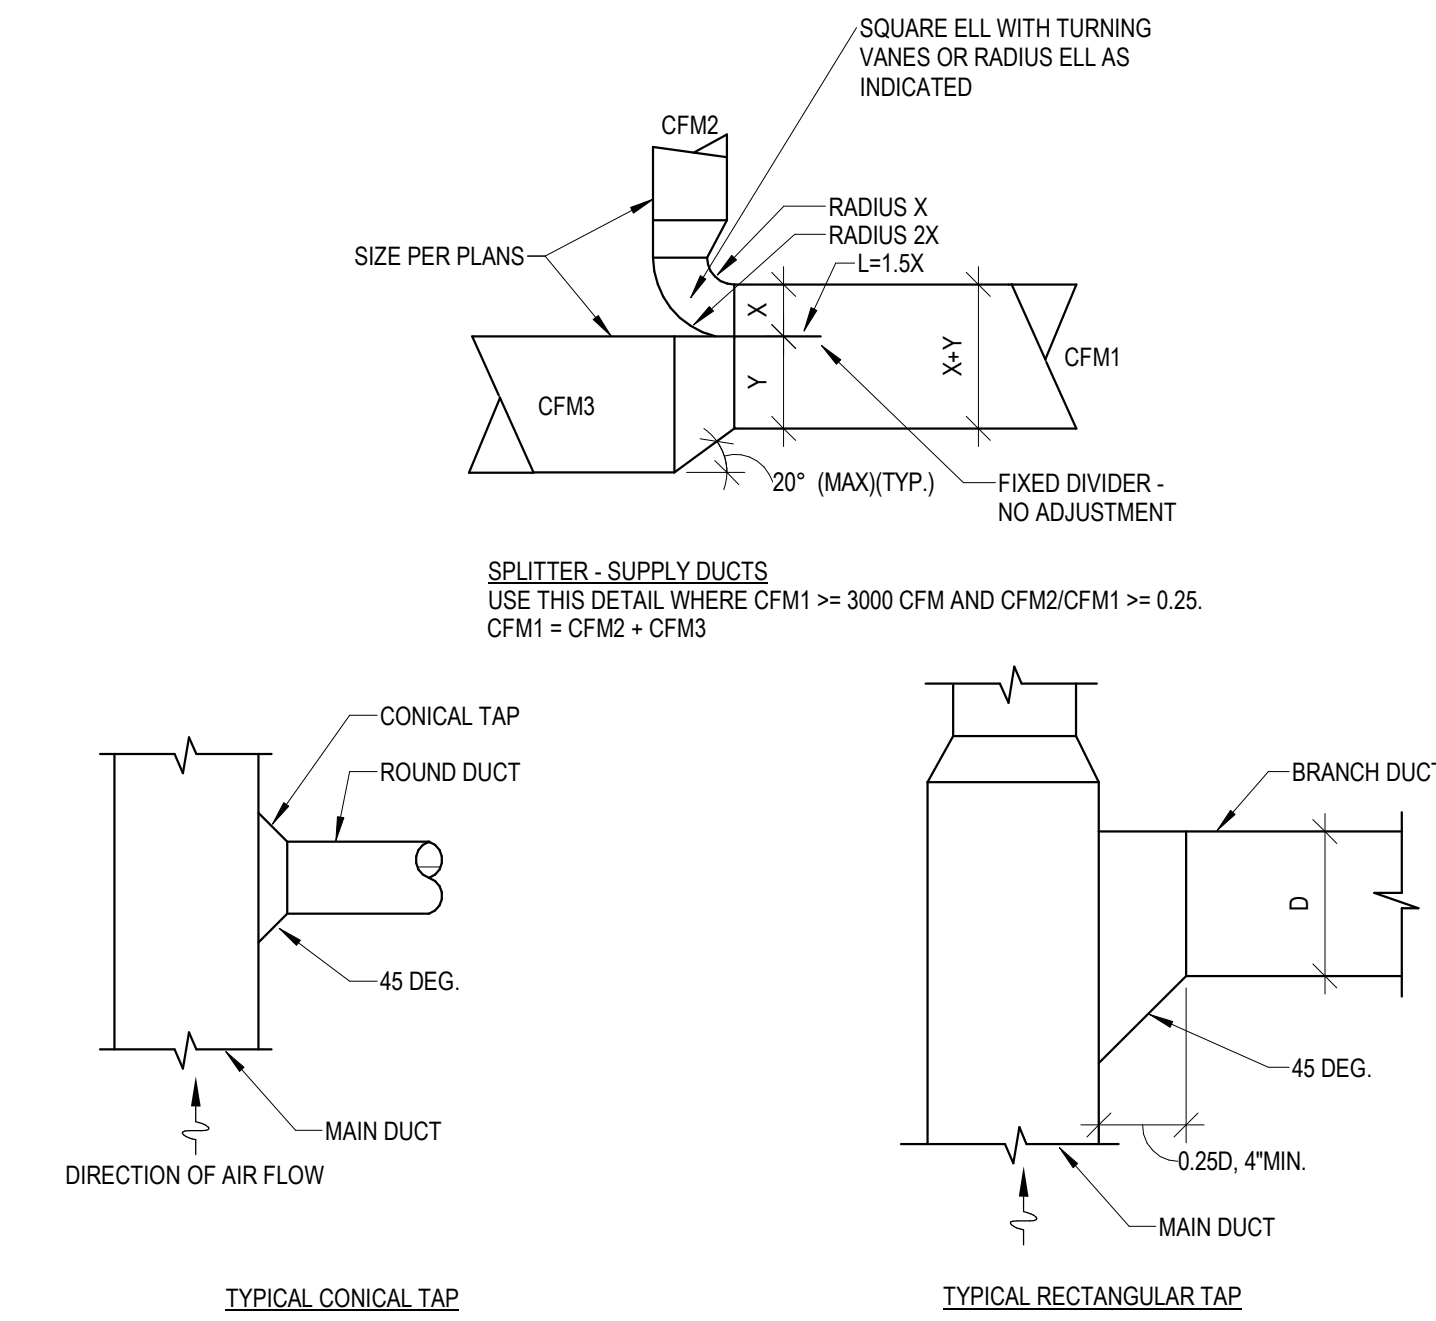

① TYPICAL RETURN AIR TRANSFER DUCT
NOT TO SCALE




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DETAILS - MECHANICAL

M07-02

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AIR DEVICE SCHEDULE								
DESIG.	SIZE	OBD	FINISH	THROW	NECK SIZE	MAX NC LEVEL	MANUFACTURER/MODEL NO.	REMARKS/NOTES
S1	24"X24"	NO	WHITE	ADJ. 4-WAY	NOTE 1	25	PRICE / SPD	CEILING PLAQUE SUPPLY DIFFUSER
S2	12"X12"	NO	WHITE	ADJ. 4-WAY	NOTE 1	25	PRICE/SPD	CEILING PLAQUE SUPPLY DIFFUSER
S3	SEE PLANS	NO	WHITE	ADJ.	FULL SIZE	25	PRICE / 610Z	SIDEWALL SUPPLY GRILLE
R1	24"X24"	NO	WHITE	-	NOTE 1	25	PRICE / SPD	CEILING RETURN GRILLE
R2	12"X12"	NO	WHITE	-	NOTE 1	25	PRICE/SPD	CEILING RETURN GRILLE
E1	24"X24"	NO	WHITE	-	NOTE 1	25	PRICE / SPD	CEILING EXHAUST GRILLE
E2	12"X12"	NO	WHITE	-	NOTE 1	25	PRICE/SPD	CEILING EXHAUST GRILLE
GENERAL NOTES:								
A. CONTRACTOR TO COORDINATE FRAME STYLE WITH ARCHITECTURAL PLANS. FRAME TYPE SHALL MATCH CEILING TYPE AND MODULE DIMENSIONS.								
B. CONTRACTOR TO COORDINATE FINAL FINISHES WITH ARCHITECT. AIR DEVICES TO BE FACTORY PAINTED.								
C. NECK SIZES SHALL BE AS SCHEDULED UNLESS NOTED OTHERWISE ON PLANS.								
D. DUCT MOUNTED AIR DEVICES SHALL BE FLANGE MOUNTED. NO MOUNTING SCREWS SHALL BE VISIBLE EXCEPT ON EXPOSED DUCTWORK.								
NOTES:								
1. 6"Ø 0-100 CFM								
8"Ø 101-225 CFM								
10"Ø 226-400 CFM								
12"Ø 401-600 CFM								
14"Ø 601-900 CFM								
15"x15" 901-1000 CFM								
2. GRILLE SHALL BE DOUBLE DEFLECTION TYPE WITH TWO SETS OF ADJUSTABLE BLADES ORIENTED PERPENDICULAR TO EACH OTHER.								

ADMIN (EXISTING RTU-1) TERMINAL UNIT W/ HEATING WATER COIL SCHEDULE															
DESIGNATION	INLET SIZE (IN)	MIN CFM	MAX HEATING CFM	MAX CFM	OUTLET SIZE (IN / IN)	VALVE MAX APD (IN WG)	HW COIL						MAX N.C.	JCI MODEL NUMBER	NOTES
							EAT DB °F	LAT DB °F	EWT °F	LWT °F	MAX FLOW GPM	MAX WATER P.D. (FT)			
VAV-1-1	8"	450	450	450	10 / 12	0.25	52	95	140	110	1.1	10	30	TSS-08	1-11
VAV-1-2	8"	175	175	475	10 / 12	0.25	52	95	140	110	0.5	10	30	TSS-08	1-11
VAV-1-3	6"	150	150	400	8 / 12	0.25	52	95	140	110	0.4	10	30	TSS-06	1-11
VAV-1-4	6"	100	100	300	8 / 12	0.25	52	95	140	110	0.3	10	30	TSS-06	1-11
VAV-1-5	6"	100	100	275	8 / 12	0.25	52	95	140	110	0.3	10	30	TSS-06	1-11
VAV-1-6	6"	100	100	300	8 / 12	0.25	52	95	140	110	0.3	10	30	TSS-06	1-11
VAV-1-7	6"	350	350	350	8 / 12	0.25	52	95	140	110	0.9	10	30	TSS-06	1-11
VAV-1-8	6"	175	175	175	8 / 12	0.25	52	95	140	110	0.5	10	30	TSS-06	1-11
VAV-1-9	6"	200	200	275	8 / 12	0.25	52	95	140	110	0.5	10	30	TSS-06	1-11
VAV-1-10	8"	175	175	525	10 / 12	0.25	52	95	140	110	0.5	10	30	TSS-08	1-11
VAV-1-11	6"	350	350	350	8 / 12	0.25	52	95	140	110	0.9	10	30	TSS-06	1-11
VAV-1-12	8"	350	350	475	10 / 12	0.25	52	95	140	110	0.9	10	30	TSS-08	1-11
VAV-1-13	6"	75	75	200	8 / 12	0.25	52	95	140	110	0.2	10	30	TSS-06	ALL
VAV-1-14	8"	0	0	600	10 / 12	0.25	-	-	-	-	-	-	30	TSS-08	2-6, 8-9
VAV-1-15	6"	75	75	125	8 / 12	0.25	52	95	140	110	0.2	10	30	TSS-06	ALL
VAV-1-16	6"	175	175	175	8 / 12	0.25	52	95	140	110	0.5	10	30	TSS-06	1-11
NOTES:															
1. MIN MBH= GPMx15.							9. CONTROLS SHALL BE FURNISHED AND SHIPPED TO TERMINAL BOX FACTORY BY TEMPERATURE CONTROLS MANUFACTURER. CONTROLS SHALL BE INSTALLED AT TERMINAL BOX FACTORY BY TERMINAL BOX MANUFACTURER.								
2. UNIT MOUNTED / WIRED FACTORY CONTROL PANEL.															
3. PRESSURE INDEPENDENT CONTROLS COMPATIBLE WITH BUILDING CONTROLS SYSTEM.							10. PROVIDE PIPING CONNECTION TO TERMINAL UNIT REHEAT COILS AS SCHEDULED: 0 - 4.0 GPM : 3/4" 4.1- 8.0 GPM : 1" 8.1 - 15.0 GPM : 1-1/4"								
4. CONSTANT AIR VOLUME (CAV) BOXES SHALL BE IDENTICAL TO VARIABLE AIR VOLUME (VAV) BOXES.							11. VAV BOXES SHALL NOT EXCEED A 95° LEAVING AIR TEMPERATURE WHEN BOX MODEL AND HEATING COIL ARE SELECTED BY MANUFACTURER.								
5. FACTORY INTERNAL INSULATION: INTERNAL FIBER FREE CLOSED CELL INSULATION.							12. PROVIDE 3 WAY VALVE AS INDICATED ON DRAWINGS								
6. CFM DELIVERY SHALL BE ACCURATE WITHIN 5% OF FROM 25-100% OF SCHEDULED BOX CFM.															
7. H.W. COIL SHALL BE LOCATED AT DISCHARGE OF BOX.															
8. OUTLET PLENUM BY INCLUDED BY MANUFACTURER. COORDINATE WITH RUNOUT SIZES TO AIR DEVICES. PROVIDE TRANSITION FROM BOX OUTLET PLENUM TO DUCTWORK. UPSIZE AS REQUIRED.															

SPLIT SYSTEM A/C UNIT SCHEDULE		
DESIGNATION		AC-1
LOCATION		LEVEL 01
SERVICE		COMM
INDOOR UNIT DATA	SUPPLY CFM	1095
	EXT. S.P. (°WG)	-
	VOLTS / PH	208 / 1
	MCA	-
	MCOP	-
	DIMENSIONS (WxHxD) (IN)	47 1/4"x14 23/32"x10 7/16"
COOLING DATA	WEIGHT (LBS)	41
	EAT °F DB/WB	80 / 67
	SENS. HEAT (BTUH)	34,000
	TOTAL HEAT (BTUH)	34,000
CONDENSING UNIT DESIGNATION		ACCU-1
CU DATA	VOLTS / PH	208 / 1
	MCA	23
	MCOP	30
	DIMENSIONS (WxHxD) (IN)	32 3/4"x37 13/32"x13"
	WEIGHT (LBS)	148
SCCR (AMPS)		*
MANUFACTURER		LG
INDOOR FAN COIL MODEL NO.		KNSAP361A
CONDENSING UNIT MODEL NO.		KUSAP361A
NOTES:		
1. CAPACITY AT 105°F O.A.T.		
2. 14.0 MIN. SEER RATING.		
3. CONTRACTOR SHALL PROVIDE AND INSTALL FACTORY POWERED CONTROLS AND CONTROL TRANSFORMER		
4. PROVIDE ELECTRONIC ALTERNATOR AND FLOAT SWITCHES.		
5. FACTORY WIRED SINGLE POINT CONNECTION		
6. ELECTRICAL CONTRACTOR TO CONNECT EXTERIOR UNIT TO INTERIOR UNIT.		
7. PROVIDE SEPARATELY POWERED REFCO COMBI CONDENSATE PUMP AT 120V. PART #3004046.		
8. R-32 REFRIGERANT.		
*SCCR RATING TO MEET OR EXCEED PANEL AIC RATING		
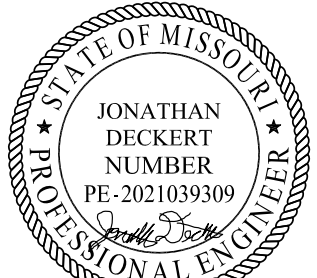
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WSP

STATE OF MISSOURI
JONATHAN DICKERT
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05/29/2025
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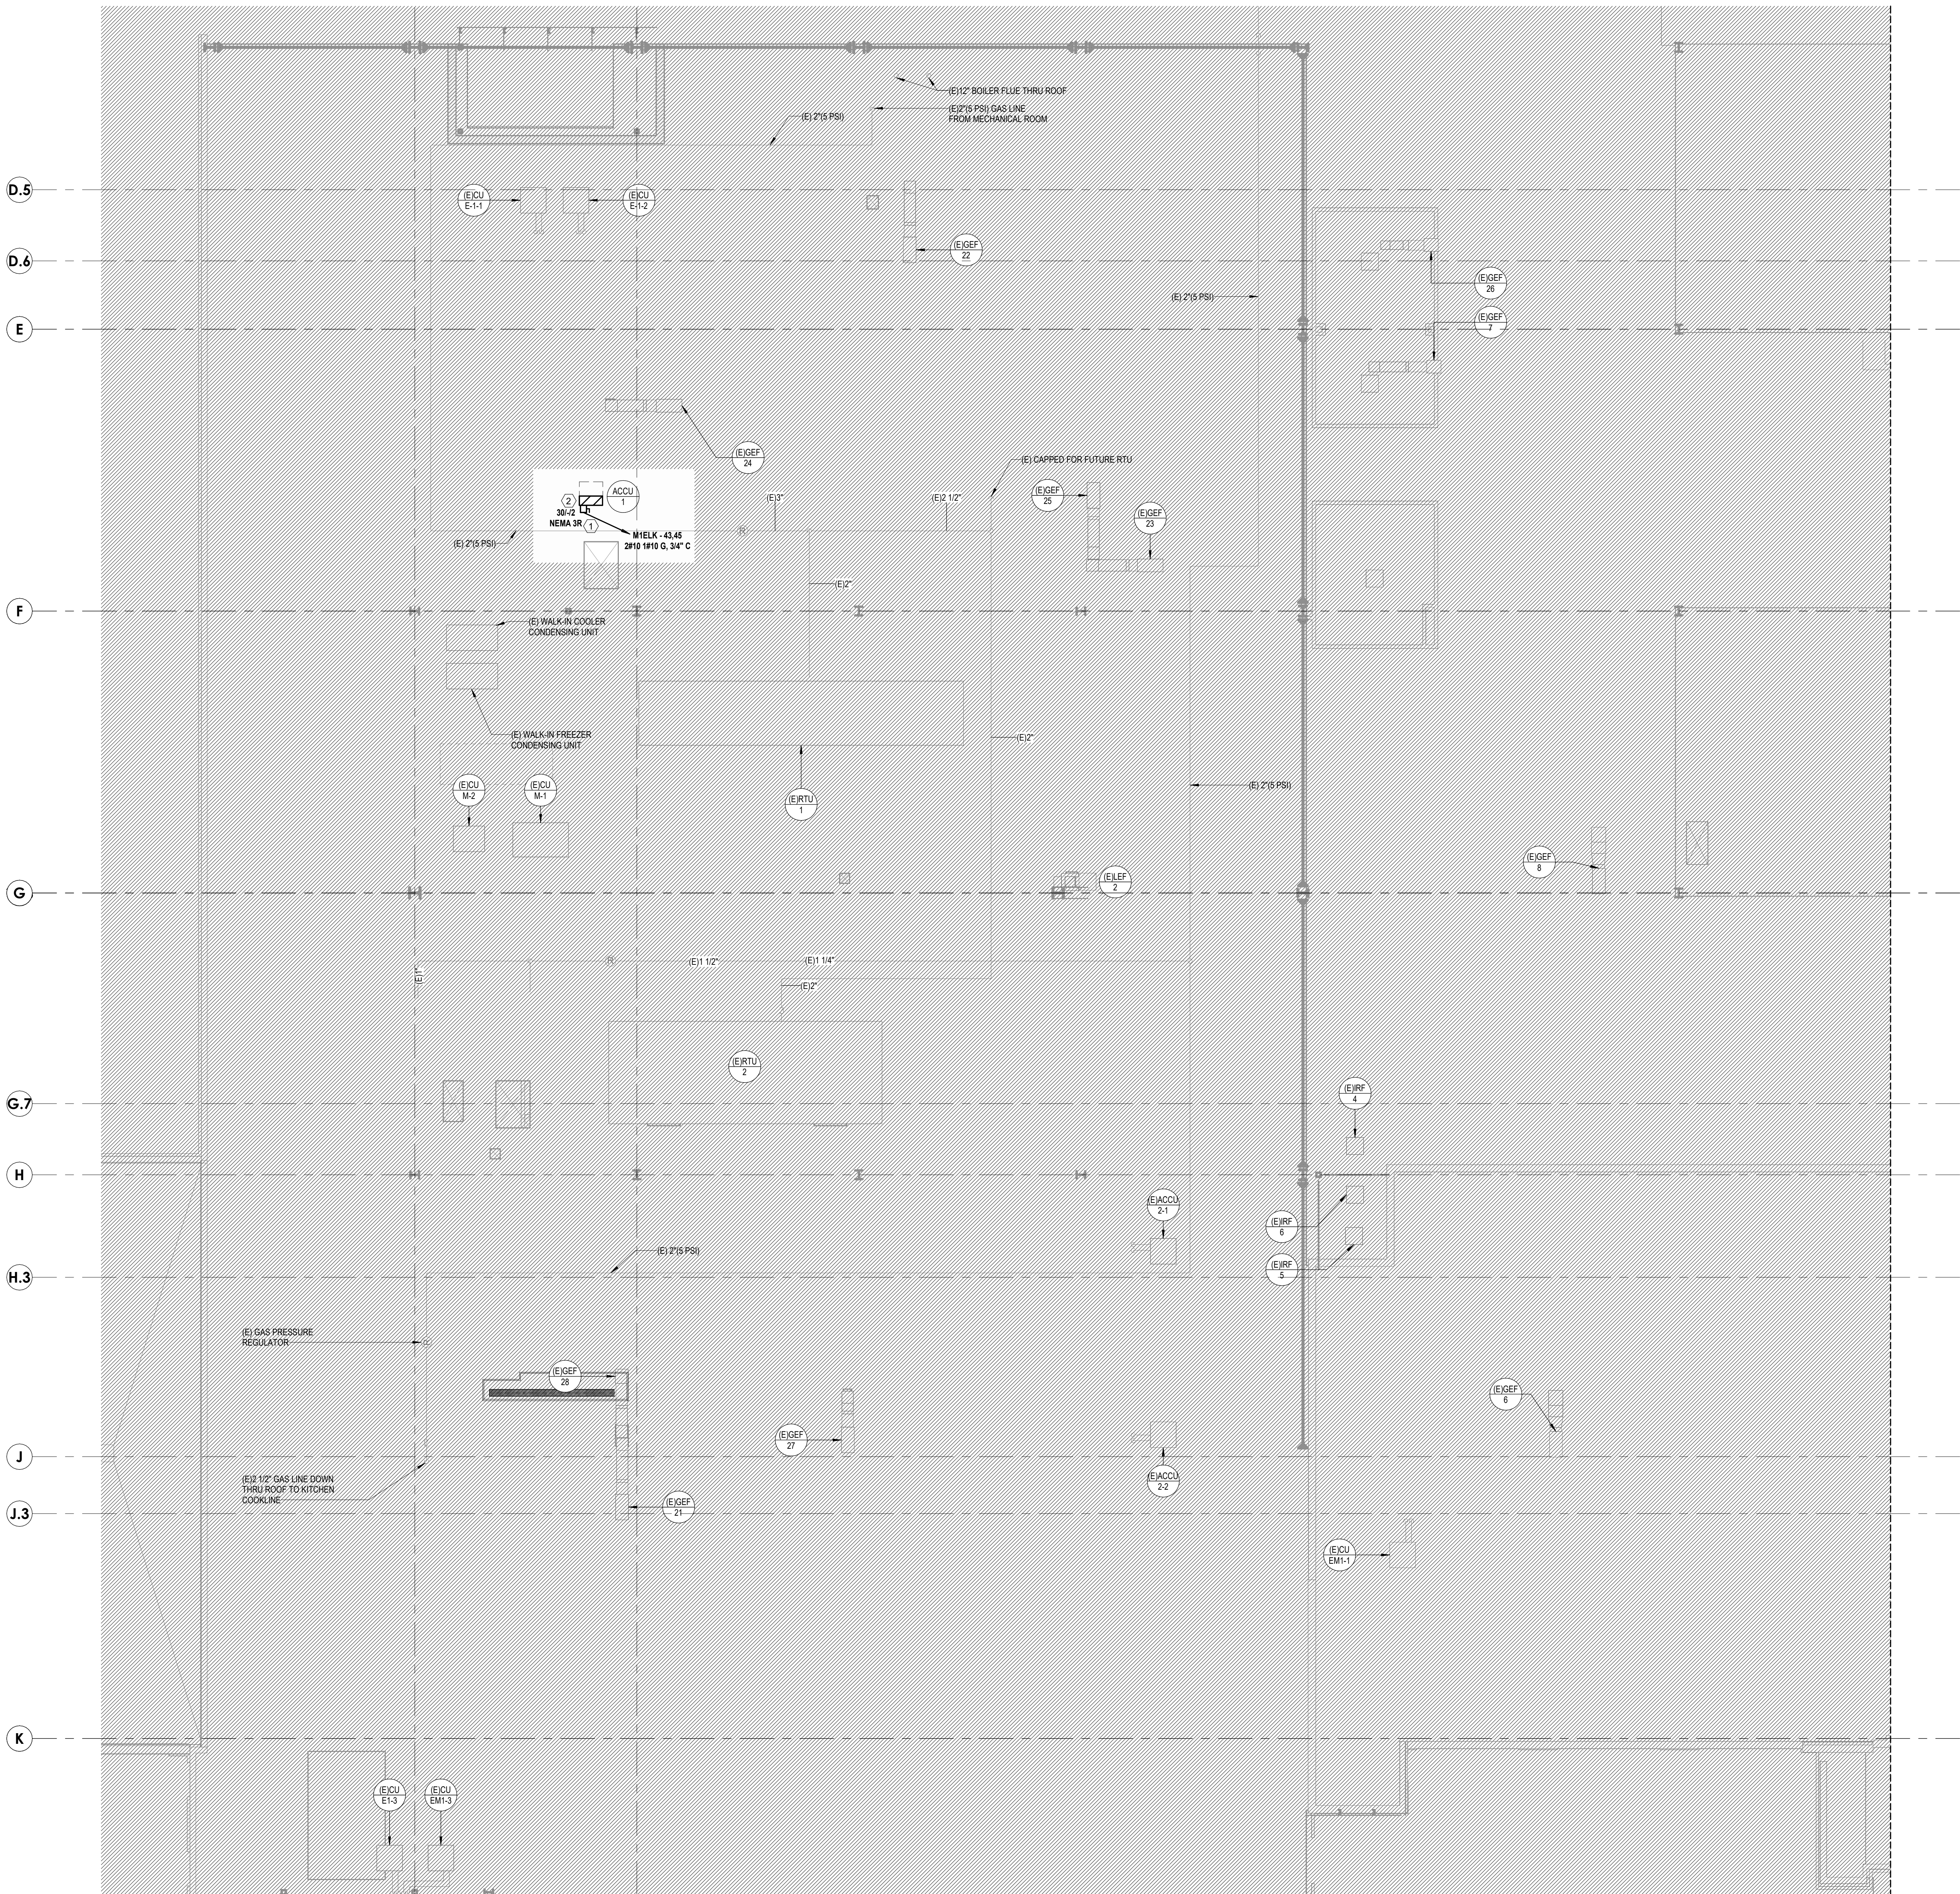
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SCHEDULES - MECHANICAL

M08-01

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1 ATTACHED MOB ROOF PLAN - MEP
1/8" = 1'-0"

GENERAL NOTES

- A. REFER TO M00-00 FOR GENERAL MECHANICAL NOTES AND SYMBOLS.
- B. CONTRACTOR TO VERIFY EXISTING CONDITIONS. EXISTING WORK SHOWN IS APPROXIMATE AND REPRESENTATIVE OF EXISTING DESIGN AND AS-BUILT DRAWINGS.
- C. PROVIDE REMOTE ADJUSTABLE DAMPERS FOR ANY BALANCING DAMPERS LOCATED ABOVE-HARD CEILINGS.
- D. ACCESS PANELS TO BE PROVIDED FOR ANY MECHANICAL EQUIPMENT OR MECHANICAL DEVICES REQUIRING SERVICE LOCATED ABOVE HARD CEILINGS.
- E. REFER TO SHEET E00-00 FOR ELECTRICAL SYMBOLS APPEARING ON THIS SHEET AND ADDITIONAL GENERAL NOTES.
- F. REFER TO SHEET E00 SERIES FOR FEEDER AND PANELBOARD SCHEDULES.
- G. REFER TO AND COORDINATE WITH THE ARCHITECTURAL PLANS, ELEVATIONS, EQUIPMENT VENDOR DRAWINGS AND DETAILS FOR EXACT LOCATIONS AND MOUNTING HEIGHTS OF ALL WIRING DEVICES.
- H. COORDINATE EXACT LOCATIONS OF ALL MECHANICAL EQUIPMENT, INCLUDING BUT NOT LIMITED TO: SMOKE DAMPERS, FIRE-SMOKE DAMPERS, VAV BOXES, FCUS, ETC. WITH MECHANICAL DRAWINGS AND DIVISION 23 CONTRACTOR.
- I. COORDINATE LOCATIONS OF ALL DISCONNECTS, CONTROL PANELS, AND ELECTRICAL CONNECTIONS FOR MECHANICAL AND PLUMBING EQUIPMENT TO MAINTAIN NEC REQUIRED CLEARANCES.

LEGEND NOTES

- 1 SIZE & ROUTE REFRIGERANT PIPING FROM ACCU TO CORRESPONDING AC UNIT PER MANUFACTURER'S REQUIREMENTS.
- 2 PROVIDE 3/4" EMPTY CONDUIT FOR CONTROL WIRING FROM ACCU TO RESPECTIVE AC UNIT.




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2000 SE BLUE PKWY
LEE'S SUMMIT, MO 64063

AUTHORITY HAVING JURISDICTION:
CITY OF LEE'S SUMMIT BUILDING DEPT.
MISSOURI DHSS

FACILITY NUMBER:
0972400009


AGENCY APPROVALS:

REVISIONS		
REV #	DESCRIPTION	DATE
A	CITY - 2ND REVIEW	2025/05/29

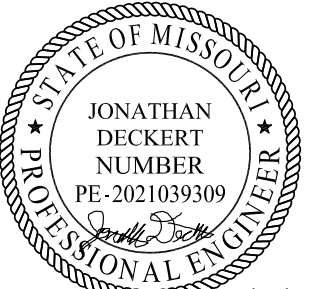DATE: 04/18/2025
SCALE: 1/8" = 1'-0"
DRAWN: HO
REVIEWED: JD
JOB NUMBER: 6406.24

ATTACHED MOB ROOF PLAN
- MEP

MEP02-03

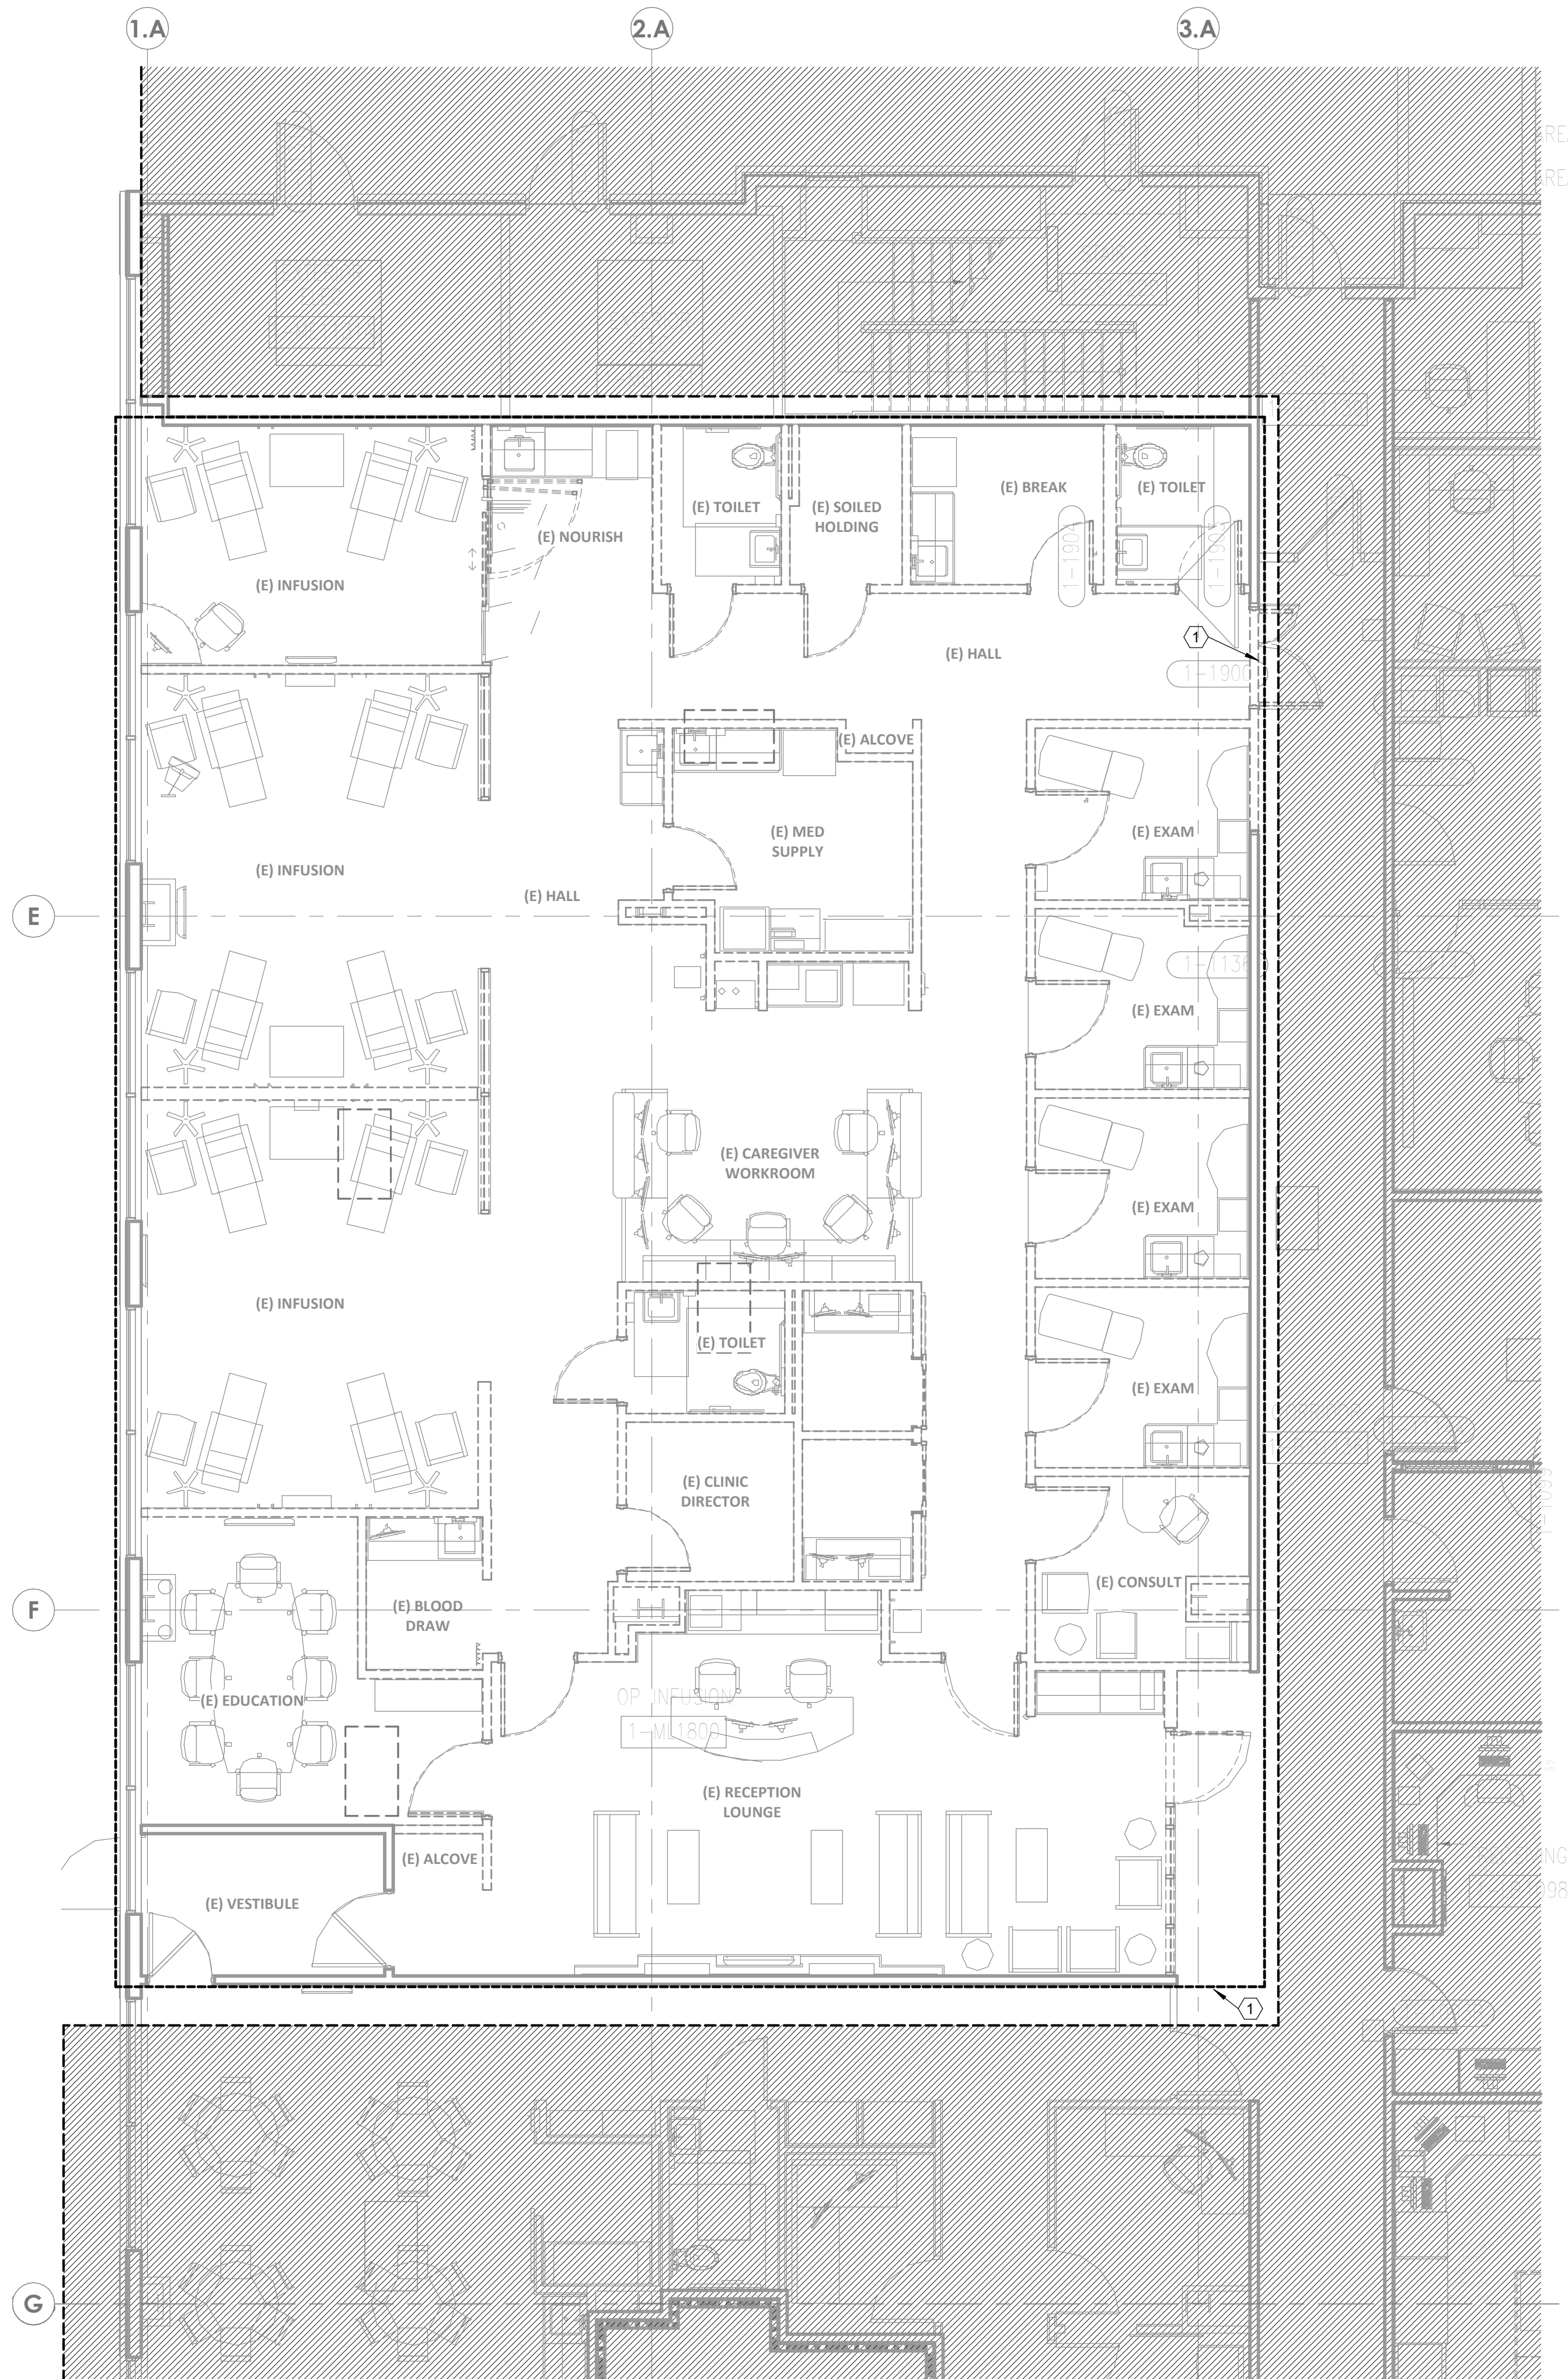

1 DEMOLITION PLAN - LEVEL 1 - ADMIN - ELECTRICAL
3/16" = 1'-0"

GENERAL DEMO NOTES

- REFER TO AND COORDINATE WITH THE ARCHITECTURAL PLANS, ELEVATIONS, AND DETAILS FOR DEMOLITION REQUIREMENTS.
- REFER TO 600-00 FOR ADDITIONAL DEMOLITION NOTES.
- WHERE WALLS ARE BEING DEMOLISHED DOWN TO STUDS, REMOVE ALL ELECTRICAL DEVICES AND ASSOCIATED CONDUIT AND CONDUCTORS CONTAINED THEREIN UNLESS NOTED OTHERWISE.
- WHERE ENTIRE CIRCUIT IS REMOVED, CIRCUIT SHALL BE DEMOLISHED BACK TO POINT OF ORIGINATION. TURN THE CIRCUIT BREAKER OFF AND LABEL AS "SPARE".
- ENERGIZE ALL EXISTING DEVICES THAT WERE INTERRUPTED DURING DEMOLITION.
- WHERE REMOVAL OF DEVICES AND ASSOCIATED CONDUIT AND CONDUCTORS EFFECTS OTHER DEVICES, RECONNECT OR PROVIDE NEW CONDUIT AND CONDUCTORS AS REQUIRED TO ASSURE THAT DEVICES IN ADJACENT AREAS AFFECTED BY THE RENOVATION REMAIN COMPLETELY OPERATIONAL.

LEGEND NOTES

EXISTING POWER DEVICES, FIRE ALARM DEVICES, AND LIGHTING FIXTURES IN THIS ROOM/AREA TO BE DEMOLISHED, UNLESS NOTED OTHERWISE




Devenney Group Ltd., Architects

6900 East Camelback Road
Suite 500
Scottsdale, AZ 85251

T: 602.943.8950

www.devenneygroup.com

Consultant:

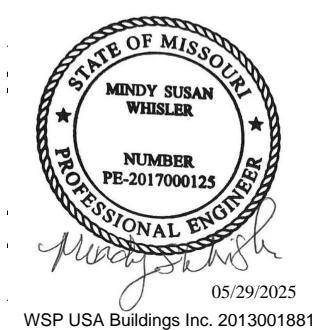

IF THESE PLANS DO NOT BEAR THE SEAL OF A REGISTRANT, THEY ARE TO BE CONSIDERED "PRELIMINARY" AND ARE NOT TO BE USED FOR CONSTRUCTION OR RECORDING. THESE PLANS ARE COPYRIGHTED AND ARE SUBJECT TO COPYRIGHT PROTECTION UNDER THE PROVISIONS OF THE COPYRIGHT ACT OF 1976, AS AMENDED DECEMBER 1990 AND KNOWN AS ARCHITECTURAL WORKS COPYRIGHT PROTECTION ACT OF 1990. THE PROTECTION HEREIN IS NOT LIMITED TO THE OVERALL FORM AS WELL AS THE ARRANGEMENT AND COMPOSITION OF SPACES AND ELEMENTS OF THE DESIGN. UNDER SUCH PROTECTION, UNAUTHORIZED USE OF THESE PLANS CAN LEGALLY RESULT IN THE SEIZURE OF CONSTRUCTION OR BUILDINGS BEING SEIZED AND/OR MONETARY COMPENSATION TO DEVENNEY GROUP LTD.

ADMINISTRATION RELOCATION

HCA - LEE'S SUMMIT MEDICAL
CENTER
2000 SE BLUE PKWY
LEE'S SUMMIT, MO 64063

AUTHORITY HAVING JURISDICTION:
CITY OF LEE'S SUMMIT BUILDING DEPT.
MISSOURI DHSS

FACILITY NUMBER:
0972400009

AGENCY APPROVALS:


REVISIONS		
REV #	DESCRIPTION	DATE
A	CITY - 2ND REVIEW	2025/05/29

DATE: 04/18/2025
SCALE: As indicated
DRAWN: Author
REVIEWED: Checker
JOB NUMBER: 6406.24

DEMOLITION PLAN - LEVEL 1
- ADMIN - ELECTRICAL

ED02-01

ble	Consultant:
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ADMINISTRATION RELOCATION

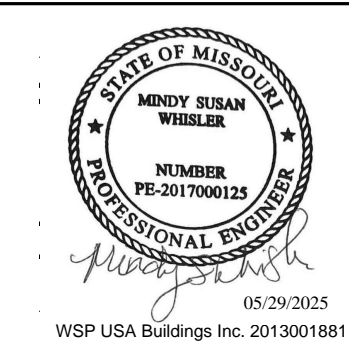HCA - LEE'S SUMMIT MEDICAL
CENTER
2000 SE BLUE PKWY
LEE'S SUMMIT, MO 64063

AUTHORITY HAVING JURISDICTION:
CITY OF LEE'S SUMMIT BUILDING DEPT
MISSOURI DHSS

FACILITY NUMBER
0972400009

AGENCY APPROVALS:

REVISIONS		
REV #	DESCRIPTION	DATE
A	CITY - 2ND REVIEW	2025/05/29


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SCALE:	As indicated
DRAWN:	Author
REVIEWED:	Checker
JOB NUMBER:	6406.24

FLOOR PLAN - LEVEL 1 -
ADMIN - POWER


E02-01

- A. REFER TO SHEET E00-00 FOR ELECTRICAL SYMBOLS APPEARING ON THIS SHEET AND ADDITIONAL GENERAL NOTES
- B. REFER TO SHEET E00 SERIES FOR FEEDER AND PANELBOARD SCHEDULES.
- C. REFER TO AND COORDINATE WITH THE ARCHITECTURAL PLANS, ELEVATIONS, EQUIPMENT VENDOR DRAWINGS AND DETAILS FOR EXACT LOCATIONS AND MOUNTING HEIGHTS OF ALL WIRING DEVICES.
- D. COORDINATE EXACT LOCATIONS OF ALL MECHANICAL EQUIPMENT, INCLUDING BUT NOT LIMITED TO: SMOKE DAMPERS, FIRE/SMOKE DAMPERS, VAV BOXES, FCUs, ETC. WITH MECHANICAL DRAWINGS AND DIVISION 23 CONTRACTOR
- E. COORDINATE LOCATIONS OF ALL DISCONNECTS, CONTROL PANELS, AND ELECTRICAL CONNECTIONS FOR MECHANICAL AND PLUMBING EQUIPMENT TO MAINTAIN NEC REQUIRED CLEARANCES.

1. PROVIDE BLANK FACE (FACELESS) GFCI IN A READILY ACCESSIBLE LOCATION FOR RECEPTACLE INDICATED LABEL. PER DEVICE INDICATED ON DRAWINGS. REFER TO DETAIL 010601-01 FOR MORE INFORMATION.
2. DEVICES TO BE LOCATED IN TV BOX. REFER TO TECHNOLOGY DRAWINGS FOR SPECIFICATION AND DETAILS. COORDINATE EXACT LOCATION WITH MONITOR TV MOUNTING BRACKET. REFER TO ARCHITECTURAL DRAWINGS AND ELEVATIONS FOR BRACKET MOUNTING HEIGHT AND EXACT LOCATIONS PRIOR TO ROUTING.
3. PROVIDE FLOOR, PUNCH-IN/FLOOR FACE BOX EQUAL TO LEGRAND RPB4C300G WITH 1/2" AND 1/2" DUPLEX 350V 15A RECEPTACLE 1 CONDUIT FOR POWER WHEN ROUTED IN SLAB. REFER TO TECHNOLOGY FOR DATA REQUIREMENTS, INCLUDING CORD CORD SIZE(S). COORDINATE EXACT LOCATION WITH ARCHITECT PRIOR TO ROUTING-IN. COORDINATE EXACT LOCATION WITH ARCHITECT PRIOR TO SUBMITTING TO SUBMITTER.
4. INDOOR UNIT TO BE SERVED FROM OUTDOOR UNIT. REFER TO OUTDOOR UNIT FOR MANUFACTURER REQUIREMENTS.
5. PROVIDE 120V POWER CONNECTION TO WALLS IN THIS AREA TO EMERGENCY EQUIPMENT CIRCUIT. PROVIDE 20A TO 30A SWITCH AT CONTROL TRANSFORMERS. REFER TO MANUFACTURER DRAWINGS FOR EXACT LOCATION. PROVIDE 1/2" TERMINAL UNIT PER CIRCUIT. QUANTITY OF WALLS SHALL BE BALANCED BETWEEN THE CIRCUITS INDICATED IN THE SAME SMOKE ZONE. TERMINAL UNITS IN DIFFERENT SMOKE ZONES SHALL NOT BE ON THE SAME CIRCUIT.
6. DEVICES MOUNTED ON RACK. COORDINATE MOUNTING WITH T05-01 POWER FOR INSTALLATION.
7. PROVIDE NEMA 16-30 AND 2410, 1/1013, 3/4"C.
8. JUNCTION BOX LOCATED IN RECEPTION RECEPTION ISLAND FOR ROUTING NO. POWER CIRCUITS INDICATED IN FLOOR MOUNTING MILLWORK. ROUTE 1 CONDUIT FOR LINE TO RECEPTION WALL AND 1 CONDUIT TO SUBMITTER.

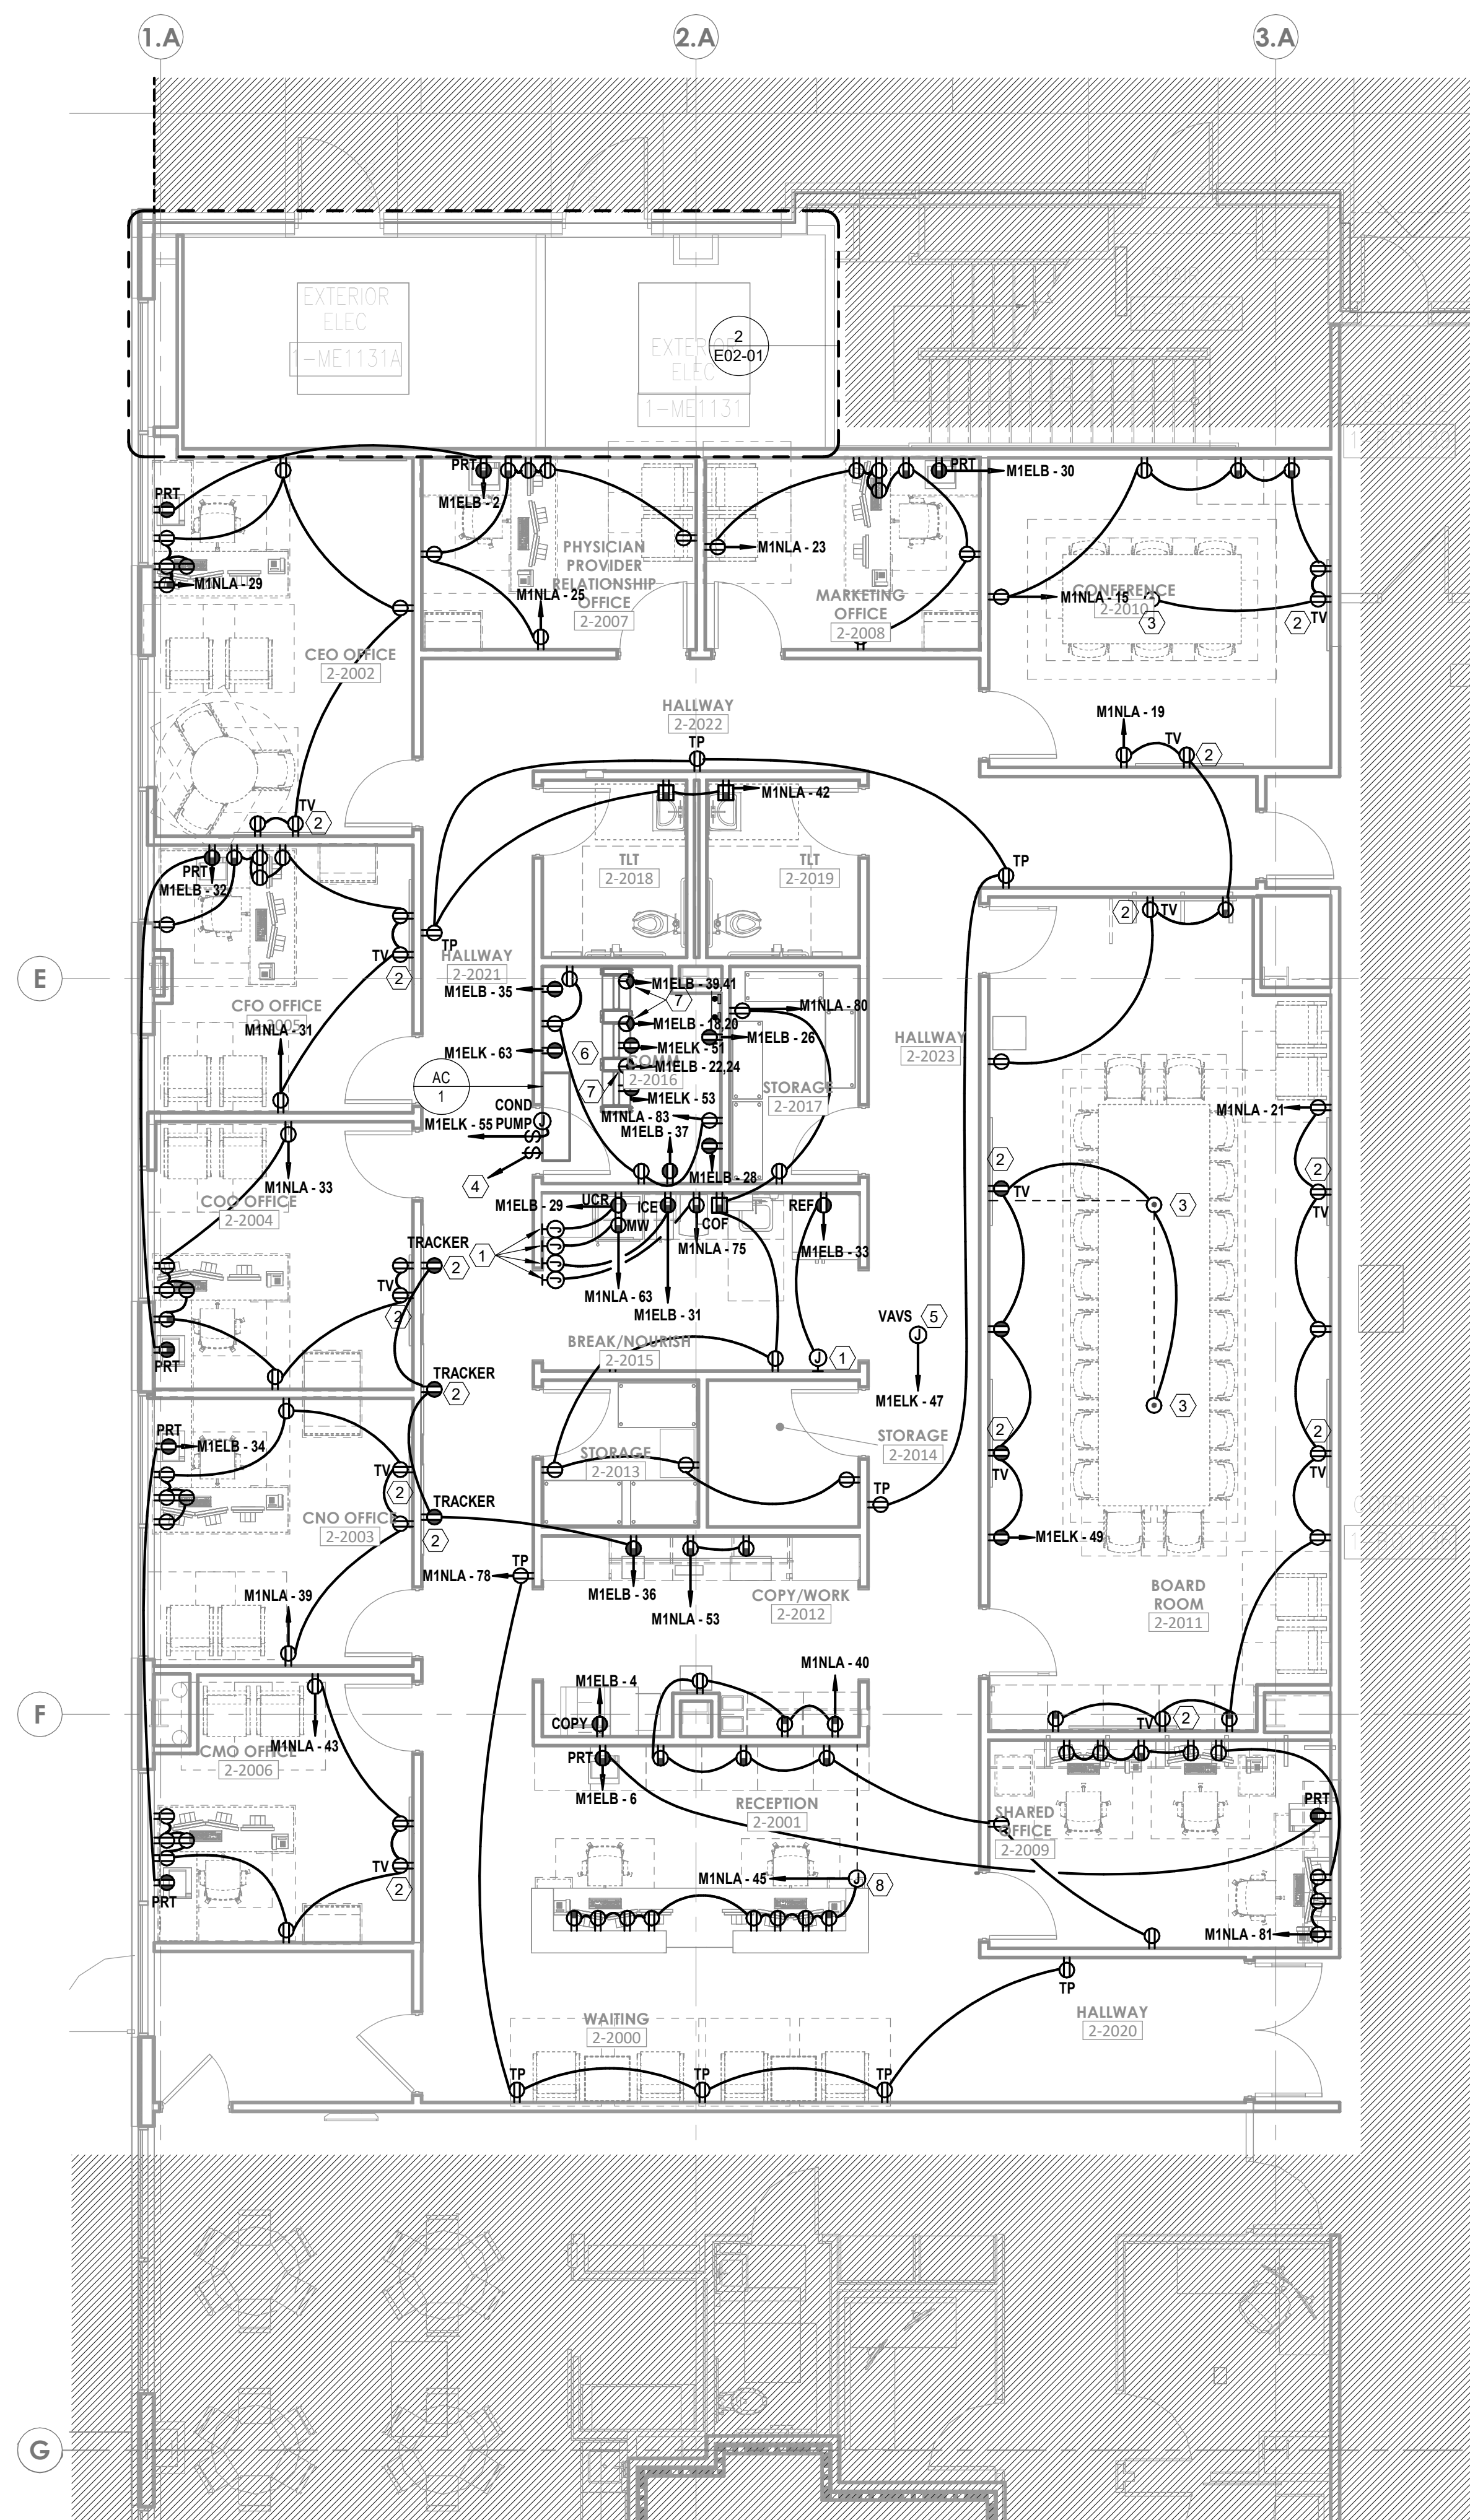

LEVEL 1 - KEYPLAN

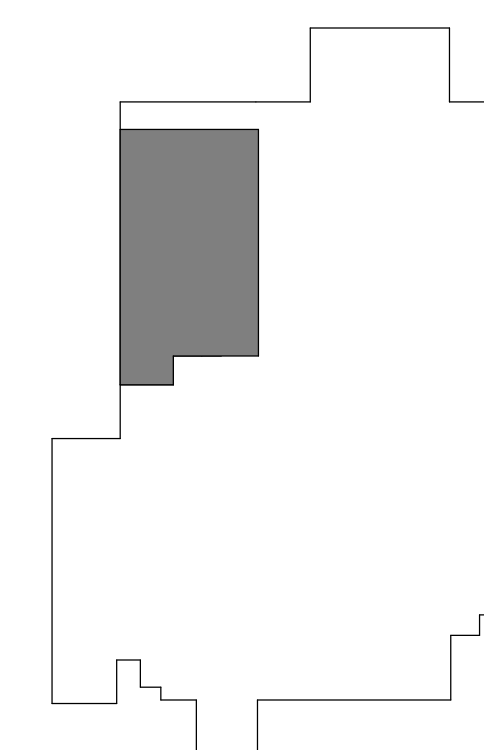

② $\frac{1}{4}'' = 1'-0''$

① $\frac{3}{16}'' = 1'-0'$


- A. REFER TO AND COORDINATE WITH ARCHITECTURAL PLANS, ELEVATIONS, EQUIPMENT VENDOR DRAWINGS AND DETAILS FOR EXACT LOCATIONS AND MOUNTING HEIGHT OF ALL WIRING DEVICES
- B. REFER TO SHEET E00-00 FOR ELECTRICAL SYMBOLS APPEARING ON THIS SHEET AND ADDITIONAL GENERAL NOTES.
- C. REFER TO SHEET E08-01 FOR LIGHT SCHEDULES
- D. CONTRACTORS SHALL USE FMC TRANSITIONS FROM EMT AT BUILDING EXPANSION JOINTS WHEN APPLICABLE. FMC ROUTING SHALL BE PROVIDED TO ALLOW LATERAL AND VERTICAL ADJUSTMENTS IN LINE WITH COORDINATE EXACT LOCATIONS OF EXPANSION JOINTS WITH ARCHITECTURAL DRAWINGS

1 CIRCUIT ON EXISTING LIGHTING LIFE SAFETY CIRCUIT PREVIOUSLY SERVING THIS AREA.
2 CIRCUIT ON EXISTING LIGHTING CRITICAL CIRCUIT PREVIOUSLY SERVING THIS AREA.



A map of the United Kingdom with a small rectangle in the north-east of England indicating the location of the study area.

wsp |

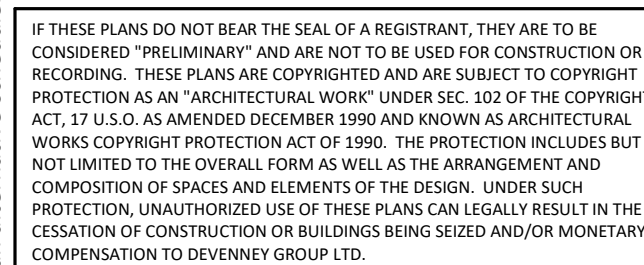

HCA - LEE'S SUMMIT MEDICAL
CENTER
2000 SE BLUE PKWY
LEE'S SUMMIT, MO 64063

FACILITY NUMBER:
0972400009

AGENCY APPROVALS:

REVISIONS		
REV #	DESCRIPTION	DATE
A	CITY - 2ND REVIEW	2025/05

DATE:	04/18/2011
SCALE:	As indicated
DRAWN:	AUGUST
REVIEWED:	CHESTER
JOB NUMBER:	640


FLOOR PLAN - LEVEL 1 -
ADMIN - LIGHTING

E03-01

Autodesk Docs: /6406.24 - HCA - Iwe's Summit Medical Center (ISMC) nr73/MEP ISMC Admin Relocation R23.rvt
6/4/2025 1:43:44 PM


GENERAL NOTES

- A. REFER TO SHEET E04-03 FOR ELECTRICAL SYMBOLS APPEARING ON THIS SHEET AND ADDITIONAL GENERAL NOTES.
- B. COORDINATE EXACT LOCATION OF ALL MECHANICAL EQUIPMENT INCLUDING BUT NOT LIMITED TO F5 DAMPERS, VAV BOXES, FCUS ETC. WITH MECHANICAL DRAWINGS AND DIV 23 CONTRACTOR.
- C. DO NOT SCALE DEVICE LOCATIONS FROM THESE DRAWINGS. REFER TO AND COORDINATE WITH THE ARCHITECTURAL DOCUMENTS. SPECIFICALLY, REFER TO ARCHITECTURAL PLANS, ELEVATIONS, AND DETAILS FOR SPECIALTY.
- D. DELEGATED DESIGN OF FIRE ALARM: REFER TO DIVISION 28 SPECIFICATION SECTION FOR ADDITIONAL SYSTEM REQUIREMENTS. FIRE ALARM INITIATING DEVICES, NOTIFICATION APPLIANCES, CONTROL PANELS, ANNUNCIATOR PANELS, AND OTHER PERIPHERAL DEVICES SHOWN ON THESE DOCUMENTS DO NOT CONSTITUTE THE TOTAL QUANTITY OR TYPE OF DEVICES REQUIRED FOR THE WORK. THE DEVICES AND EQUIPMENT INDICATED ON THESE DOCUMENTS IS SHOWN FOR THE PURPOSE OF COORDINATION ONLY. THESE DRAWINGS AND THE ACCOMPANYING SPECIFICATIONS DEFINE THE SCOPE AND INTENT OF THE FIRE ALARM SYSTEM TO BE PROVIDED IN THE WORK. IN ADDITION TO THE SYSTEM AS SHOWN HEREIN AND SPECIFIED IN THE PROJECT MANUAL, THE LICENSED FIRE ALARM CONTRACTOR SHALL PROVIDE ALL PLANNING, DESIGN, CALCULATIONS, EQUIPMENT, DEVICES, RACEWAYS, BOXES, CABLING, SYSTEM PROGRAMMING AND ANY OTHER COMPONENT OR SERVICE REQUIRED FOR A COMPLETE, FULLY OPERATIONAL SYSTEM THAT MEETS ALL SPECIFIED REQUIREMENTS AND LOCAL CODES.
- E. SMOKE DETECTOR SPACING: FOR AREAS WHICH ARE INDICATED TO HAVE SMOKE DETECTOR COVERAGE THAT DO NOT HAVE A SUSPENDED CEILING (I.E. OPEN TO STRUCTURE), PROVIDE ONE DETECTOR PER STRUCTURAL POCKET TO MEET REQUIREMENTS OF NFPA 72. REFER TO ARCHITECTURAL REFLECTED CEILING PLANS FOR CEILING TYPES AND TO STRUCTURAL SLAB DETAILS FOR SLAB DEPRESSIONS THAT MAY CAUSE CONDITIONS REQUIRING ADDITIONAL DETECTORS.
- F. DETECTORS AT DAMPERS: PROVIDE A DUCT MOUNTED SMOKE DETECTOR AT ALL SMOKE AND COMBINATION FIRESMOKE DAMPER LOCATIONS. EACH DAMPER SHALL HAVE A DISCRETE RELAY LOCATED WITHIN 3 FT. OF THE CONTROLLING COMPONENT; COMMON RELAYS ARE NOT ACCEPTABLE. EXACT DEVICE QUANTITIES AND LOCATIONS FOR DAMPERS ARE SHOWN ON MECHANICAL DRAWINGS. REFER TO AND COORDINATE WITH DIVISION 23 DOCUMENTS, APPROVED SHOP DRAWINGS AND SUBMITTALS AND BETWEEN TRADES WITH HVAC INSTALLER PRIOR TO ROUGH-IN. REFER TO DIVISION 23 AND 28 SPECIFICATIONS AND TO DETAILS FOR ADDITIONAL REQUIREMENTS.
- G. PROVIDE APPROPRIATE EQUIPMENT AND CONNECTION(S) REQUIRED TO RELEASE DOOR HOLDERS UPON ALARM SIGNAL FROM THE FIRE ALARM CONTROL PANEL.

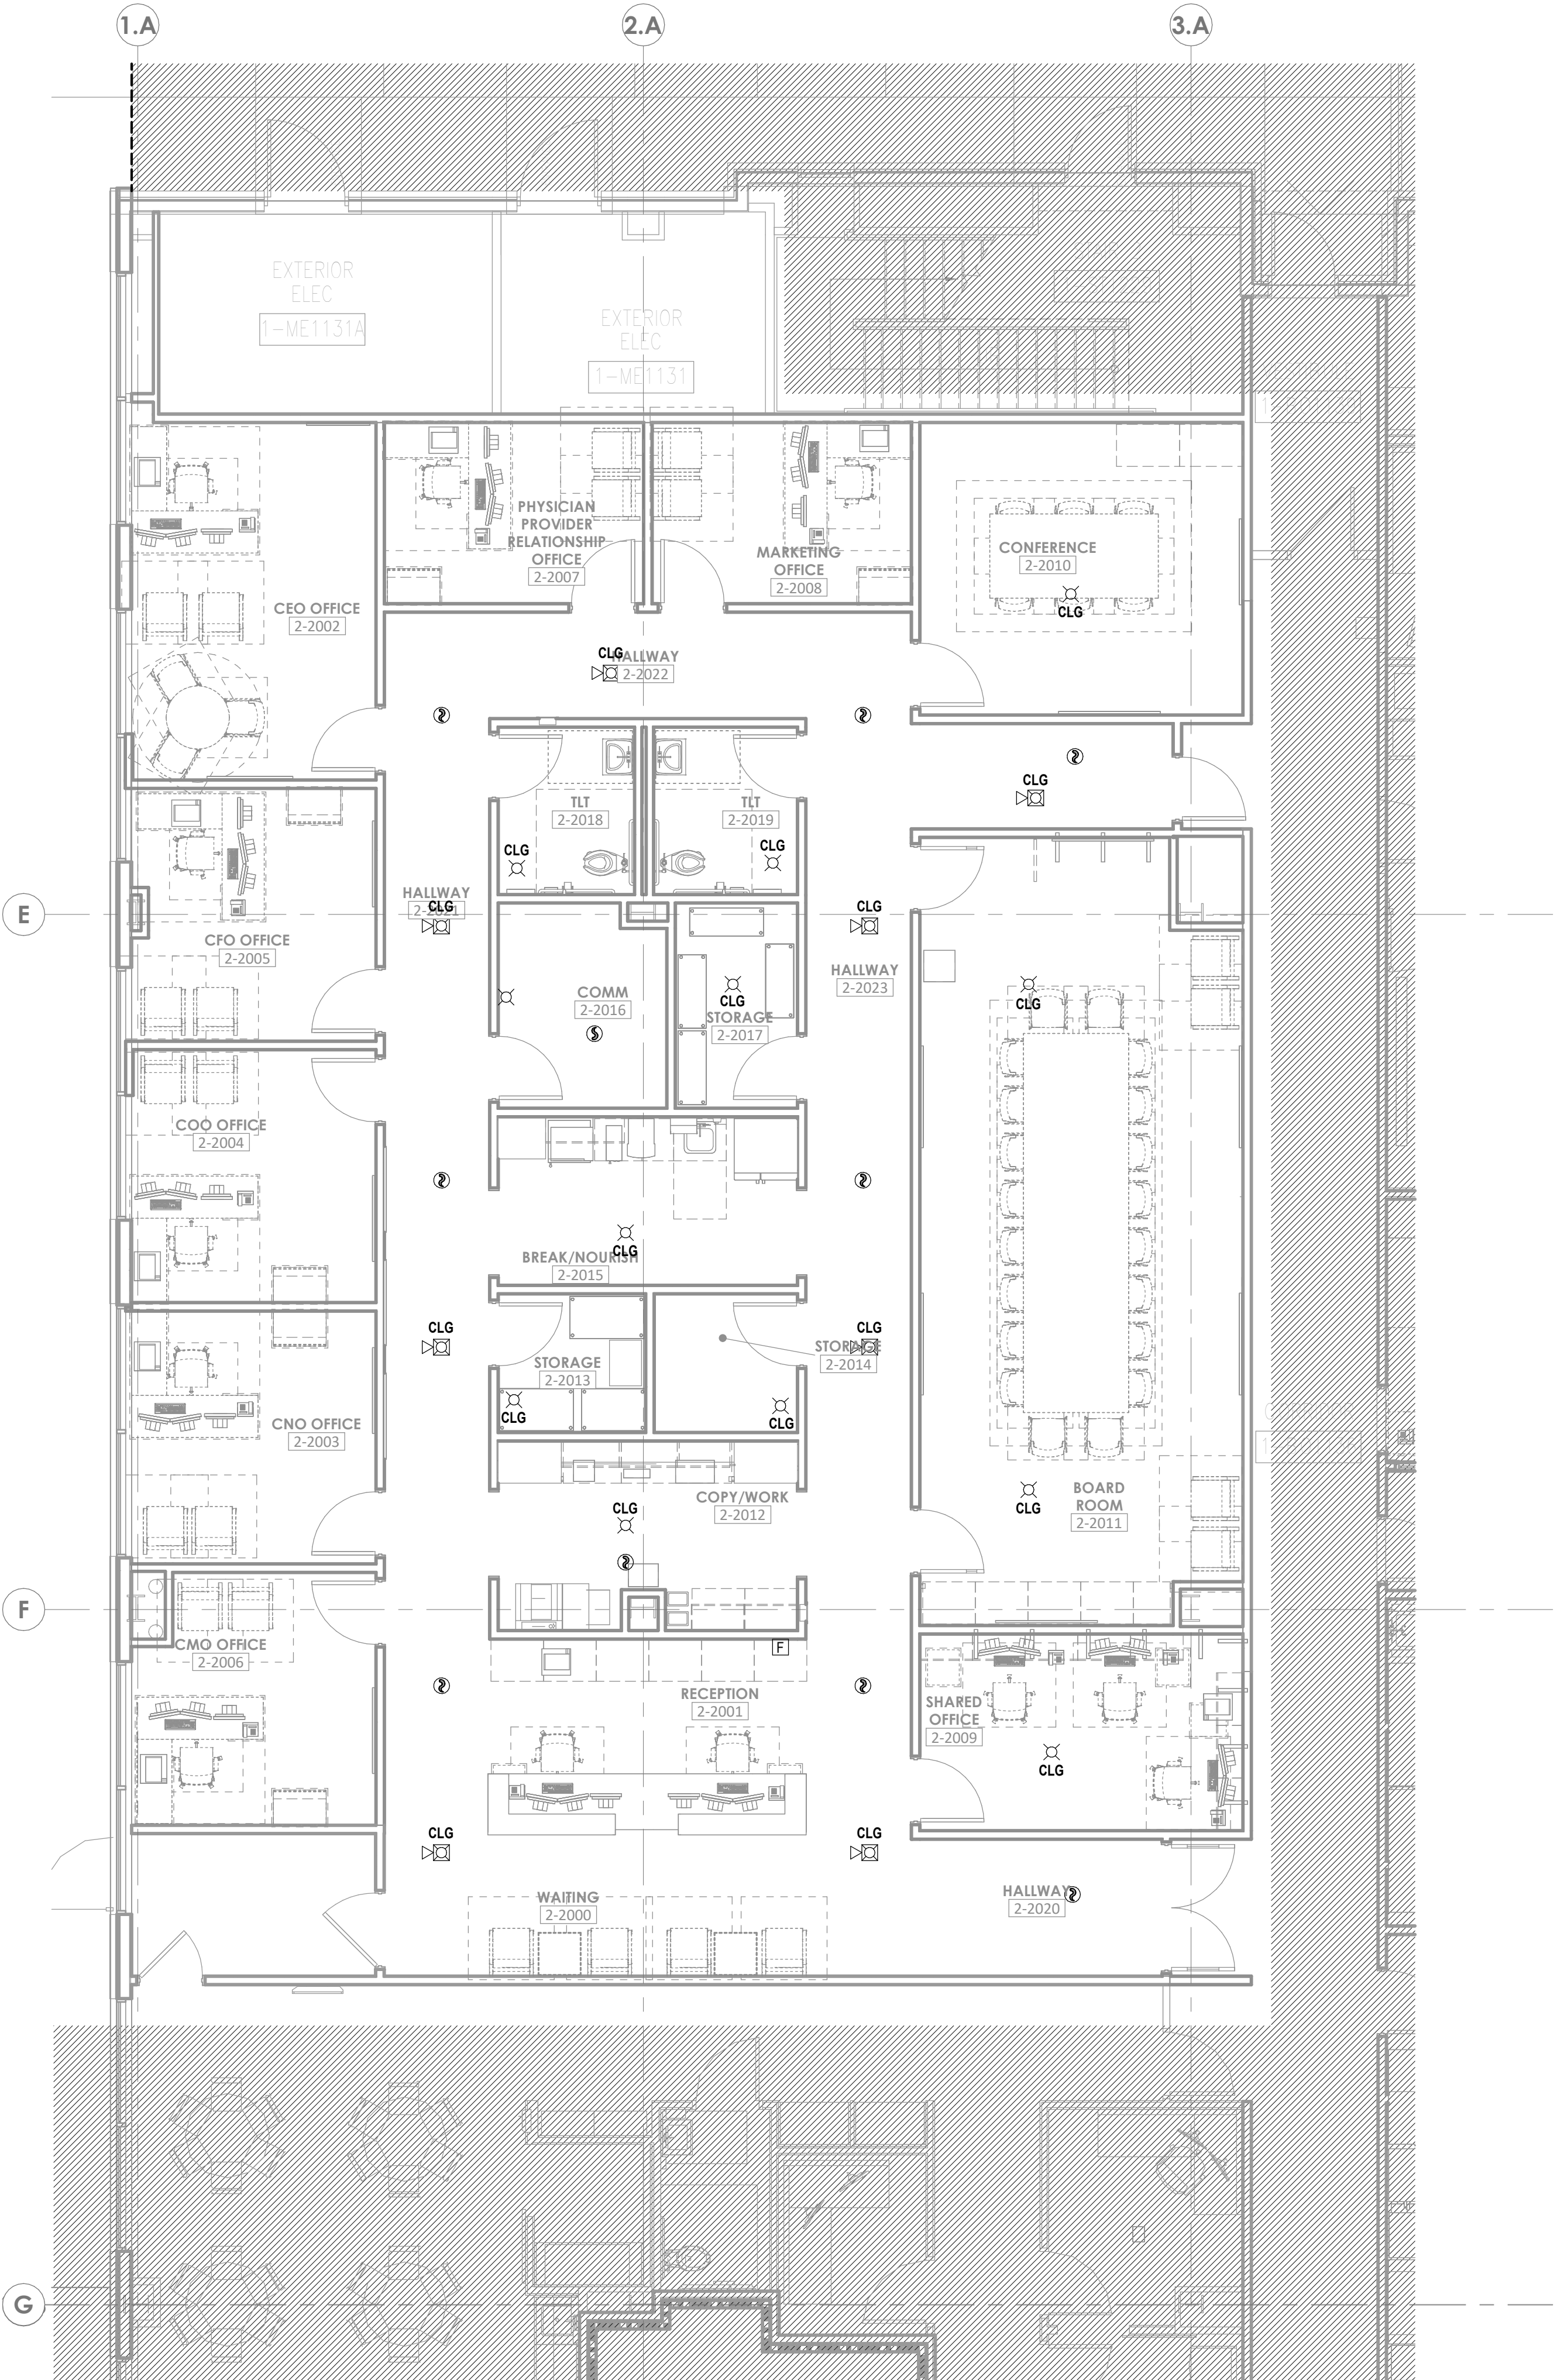

1 FLOOR PLAN - LEVEL 1 - ADMIN - SPECIAL SYSTEMS
3/16" = 1'-0"

LEVEL 1 - KEYPLAN

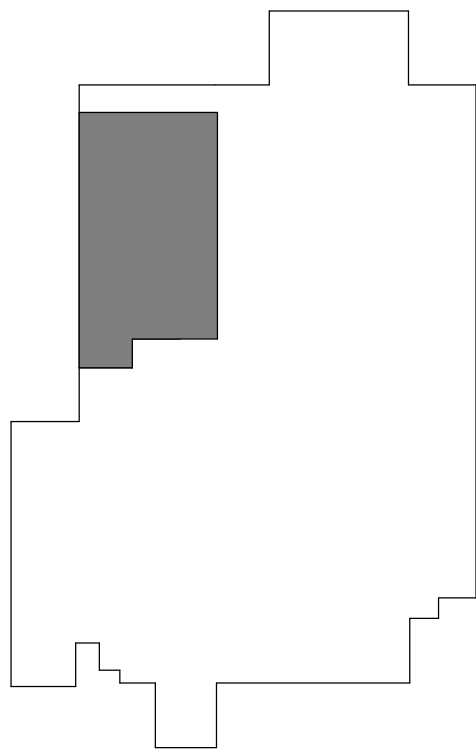

Devenney GROUP

Devenney Group Ltd., Architects

6900 East Camelback Road
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Scottsdale, AZ 85251

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Consultant:

wsp

STATE OF MISSOURI
NOTARY PUBLIC
NUMBER
00291001881
WSP USA Buildings Inc. 2019001881

IF THESE PLANS DO NOT BEAR THE SEAL OF A REGISTRANT, THEY ARE TO BE CONSIDERED "PRELIMINARY" AND ARE NOT TO BE USED FOR CONSTRUCTION OR RECORDING. THESE PLANS ARE COPYRIGHTED AND ARE SUBJECT TO COPYRIGHT ACT, 17 U.S.C. AS AMENDED DECEMBER 1990 AND KNOWN AS ARCHITECTURAL WORKS COPYRIGHT PROTECTION ACT OF 1990. THE PROTECTION INCLUDES BUT IS NOT LIMITED TO THE OVERALL FORM AS WELL AS THE ARRANGEMENT AND COMPOSITION OF SPACES AND ELEMENTS OF THE DESIGN. UNDER SUCH PROTECTION, UNAUTHORIZED USE OF THESE PLANS CAN LEGALLY RESULT IN THE CESSION OF CONSTRUCTION OR BUILDINGS BEING SEIZED AND/OR MONETARY COMPENSATION TO DEVENNEY GROUP LTD.

**ADMINISTRATION
RELOCATION**

HCA - LEE'S SUMMIT MEDICAL
CENTER
2000 SE BLUE PKWY
LEE'S SUMMIT, MO 64063

AUTHORITY HAVING JURISDICTION:
CITY OF LEE'S SUMMIT BUILDING DEPT.
MISSOURI DHSS

FACILITY NUMBER:
0972400009

AGENCY APPROVALS:

REVISIONS		
REV #	DESCRIPTION	DATE
A	CITY - 2ND REVIEW	2025/05/29


DATE: 04/18/2025
SCALE: As indicated
DRAWN: Author
REVIEWED: Checker
JOB NUMBER: 6406.24

FLOOR PLAN - LEVEL 1 -
ADMIN - SPECIAL SYSTEMS

E04-01

Autodesk Docx/Bldg24 - HCA - Lee's Summit Medical Center (LSMC) - r123/MEP - LSNC Admin Relocation - R23.rvt 6/4/2025 1:43:48 PM Notice of Alternate Billing or Payment Cycle: The Owner may plan to make payments on an alternative schedule. A written description of such billing or payment cycle applicable to the Project is available from the Owner or the Owner's designated agent upon request.

Consultant:

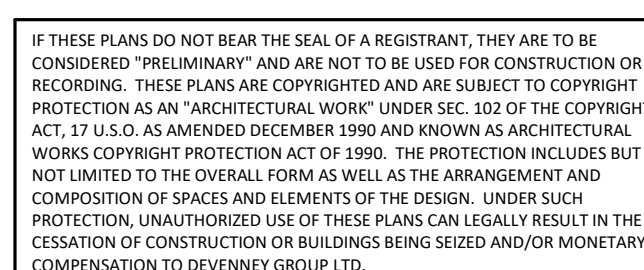

HCA - LEE'S SUMMIT
MEDICAL CENTER
2000 SE BLUE PKWY
LEE'S SUMMIT, MO 64063

AUTHORITY HAVING JURISDICTION:
CITY OF LEE'S SUMMIT BUILDING DEPT
MISSOURI DHSS

FACILITY NUMBER:
0972400009

AGENCY APPROVALS:
AGENCY


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SCALE:	1/8" = 1'-0"
DRAWN:	Auth
REVIEWED:	Checke
JOB NUMBER:	6406.2

E06-01

A. REFER TO SHEET E00-00 FOR ELECTRICAL SYMBOLS APPEARING ON THIS SHEET AND ADDITIONAL GENERAL NOTES.

B. ALL CONDUCTORS ARE EXISTING TO REMAIN UNLESS NOTED WITH NEW WIRE TAG.

1 EXISTING LOAD IS BASED ON DESIGN LOAD FROM A PREVIOUS PROJECT.
2 REMOVED LOAD IS BASED ON DEMOLITION SCOPE FROM PANELBOARD 'M1ELA'

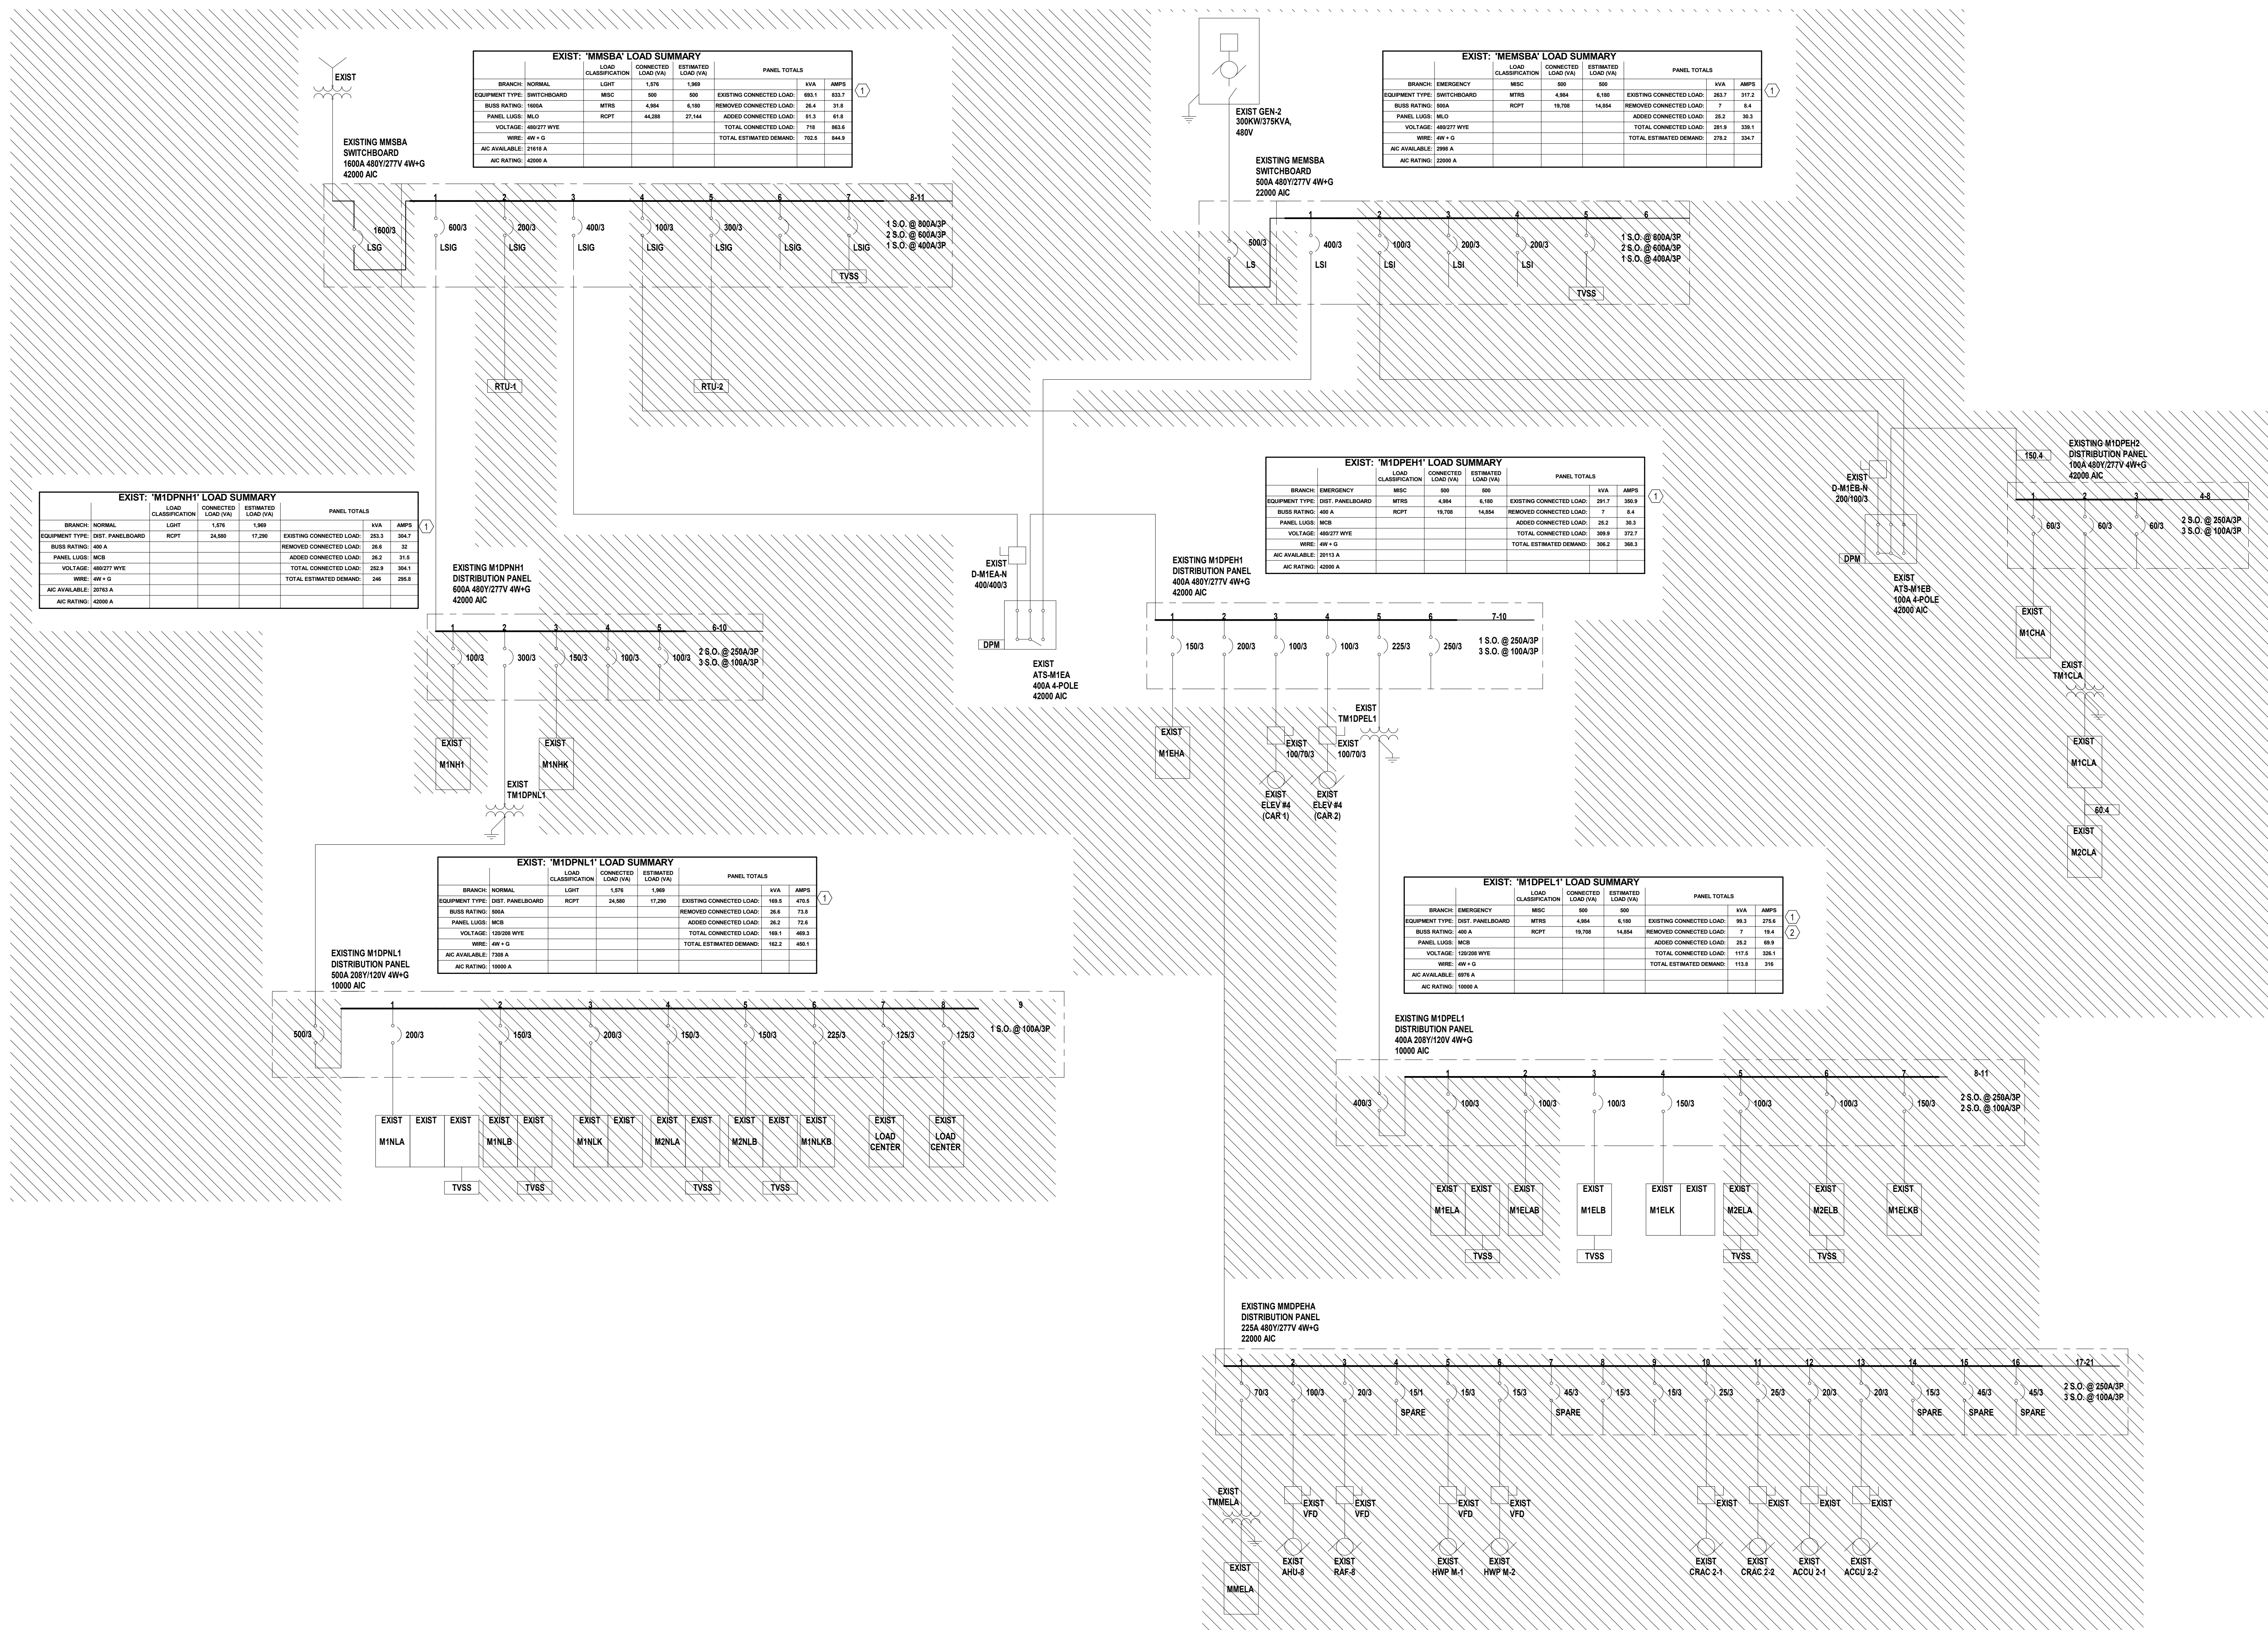



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Consultant:



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ADMINISTRATION RELOCATION

HCA - LEE'S SUMMIT MEDICAL
CENTER
2000 SE BLUE PKWY
LEE'S SUMMIT, MO 64063

AUTHORITY HAVING JURISDICTION:
CITY OF LEE'S SUMMIT BUILDING DEPT.
MISSOURI DHSS

FACILITY NUMBER:
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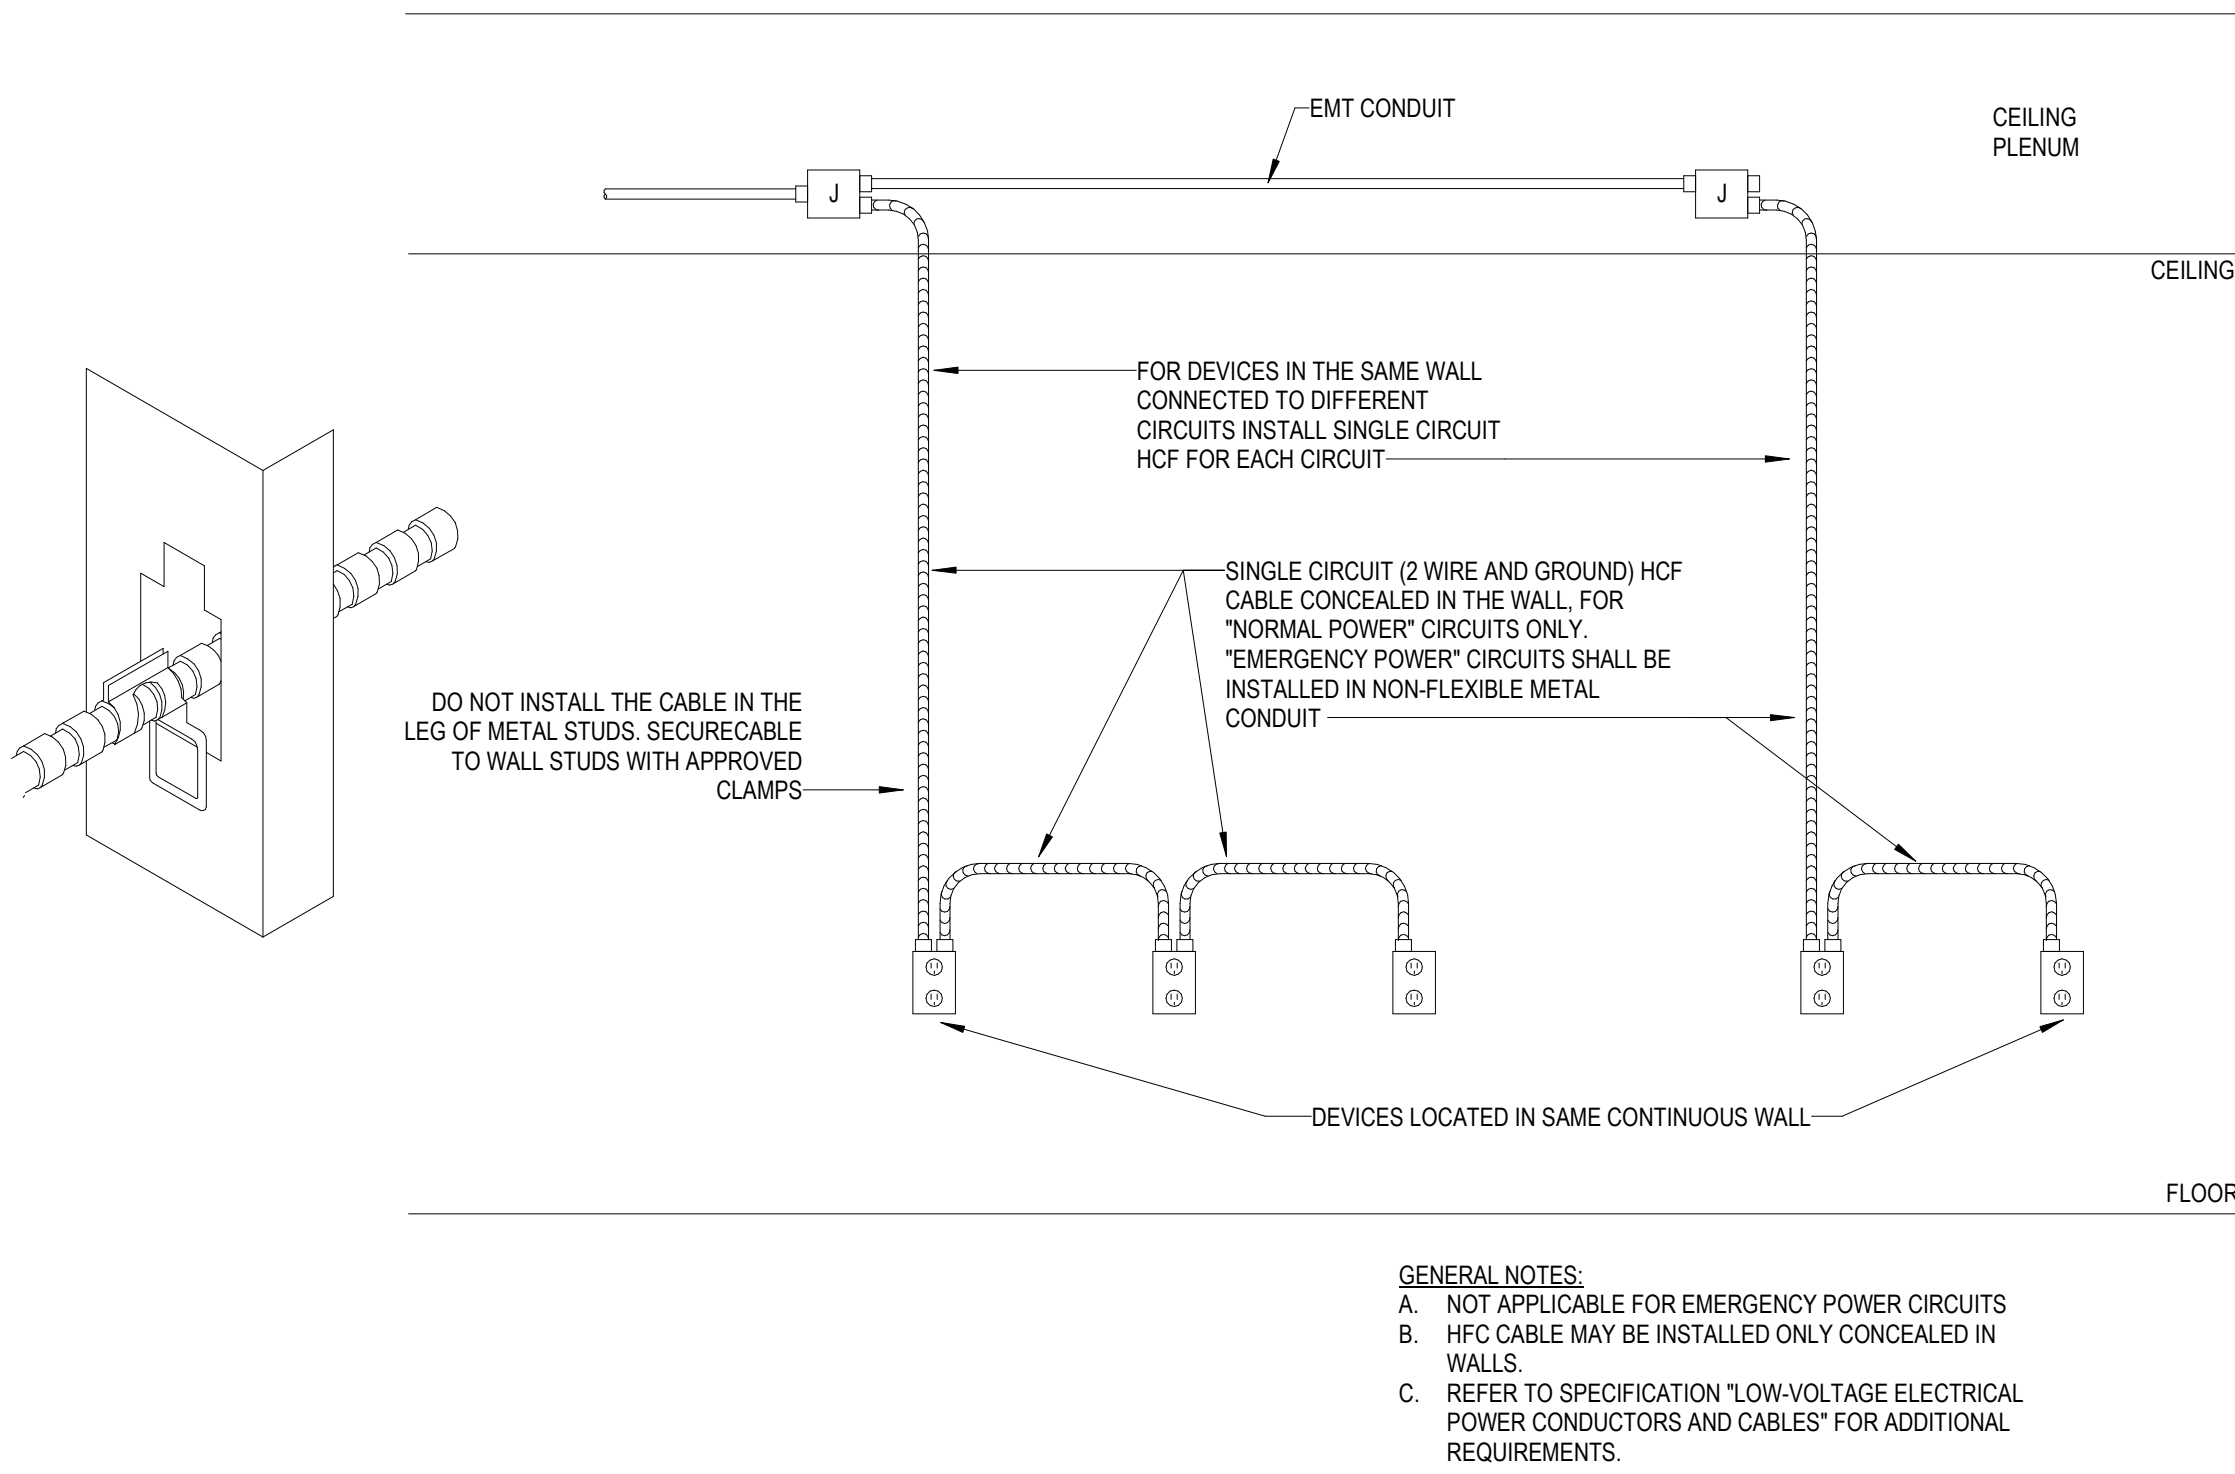
AGENCY APPROVALS:

REVISIONS		
REV #	DESCRIPTION	DATE
A	CITY - 2ND REVIEW	2025/05/29


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SCALE: N.T.S.
DRAWN: Author
REVIEWED: Checker
JOB NUMBER: 6406.24

DETAILS - ELECTRICAL


E07-01




8 HEALTHCARE FACILITIES CABLE (HCF) INSTALLATION DETAIL
N.T.S.

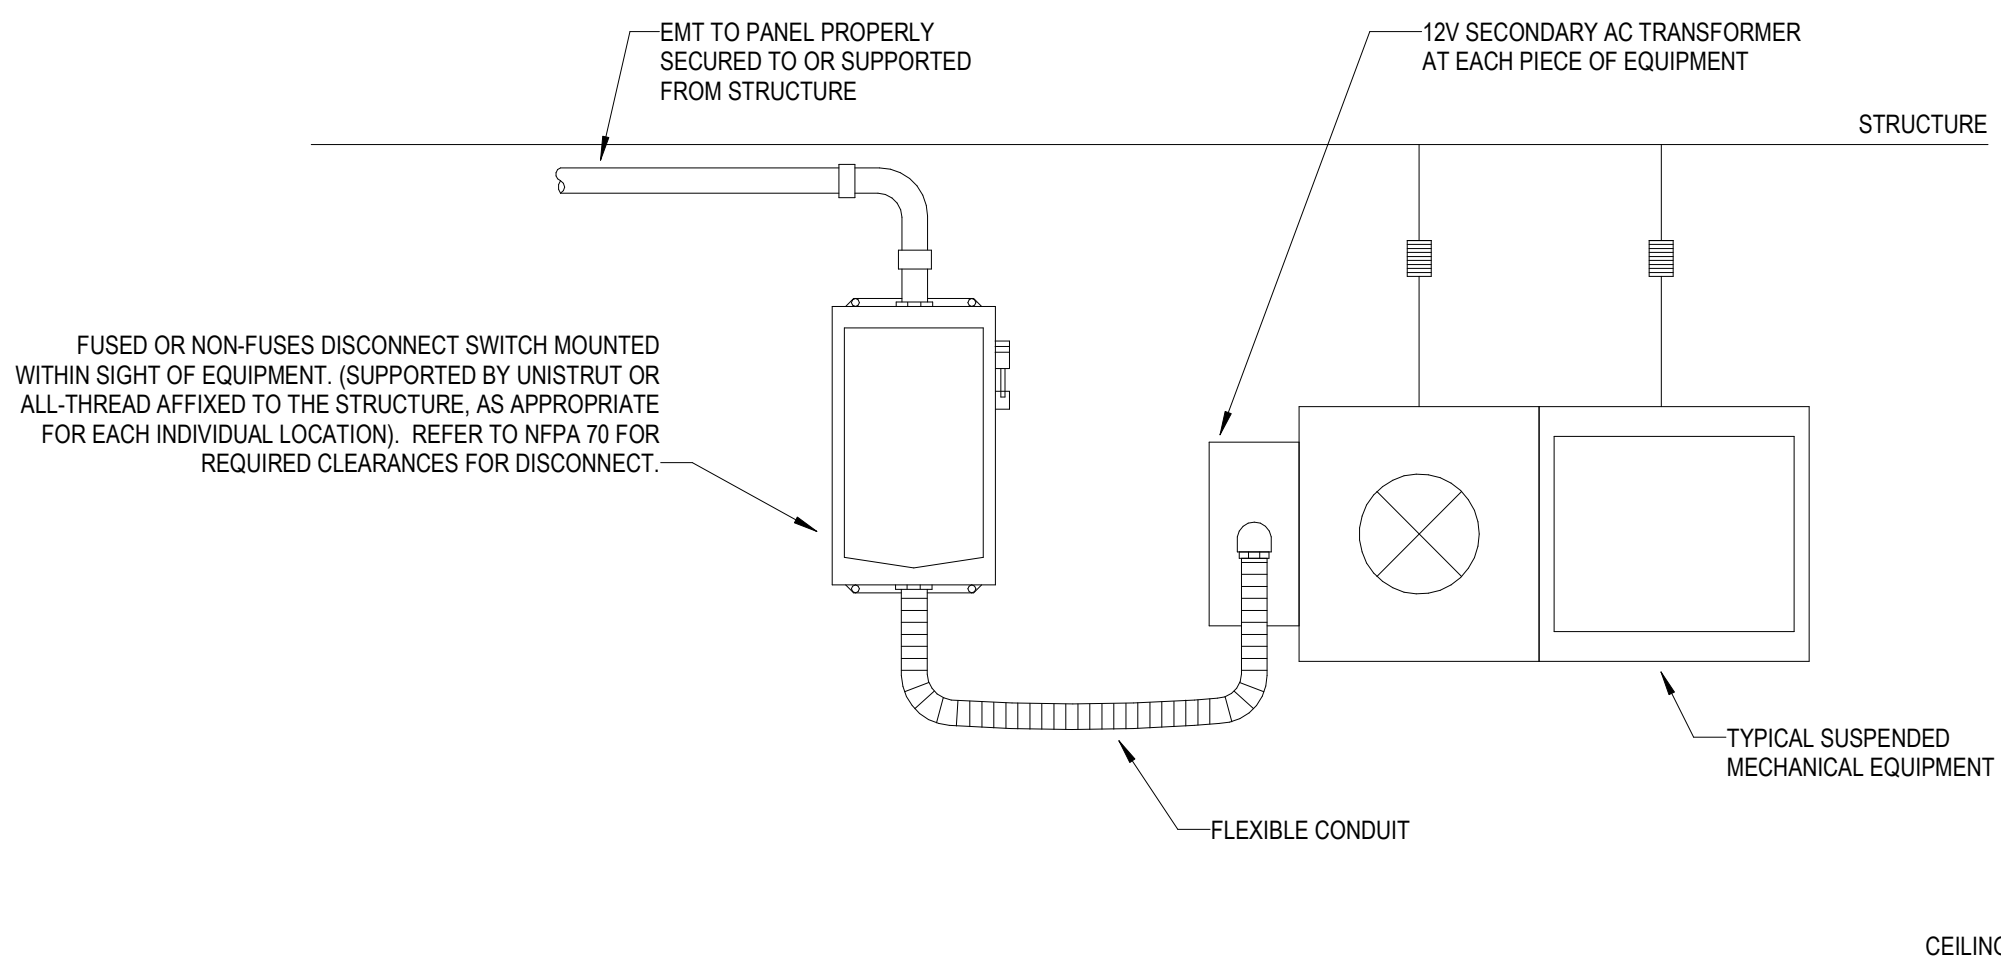


2 TYPICAL SUSPENDED MECH. EQUIPMENT HEAVY DUTY DISC. CONNECTION DETAIL
N.T.S.

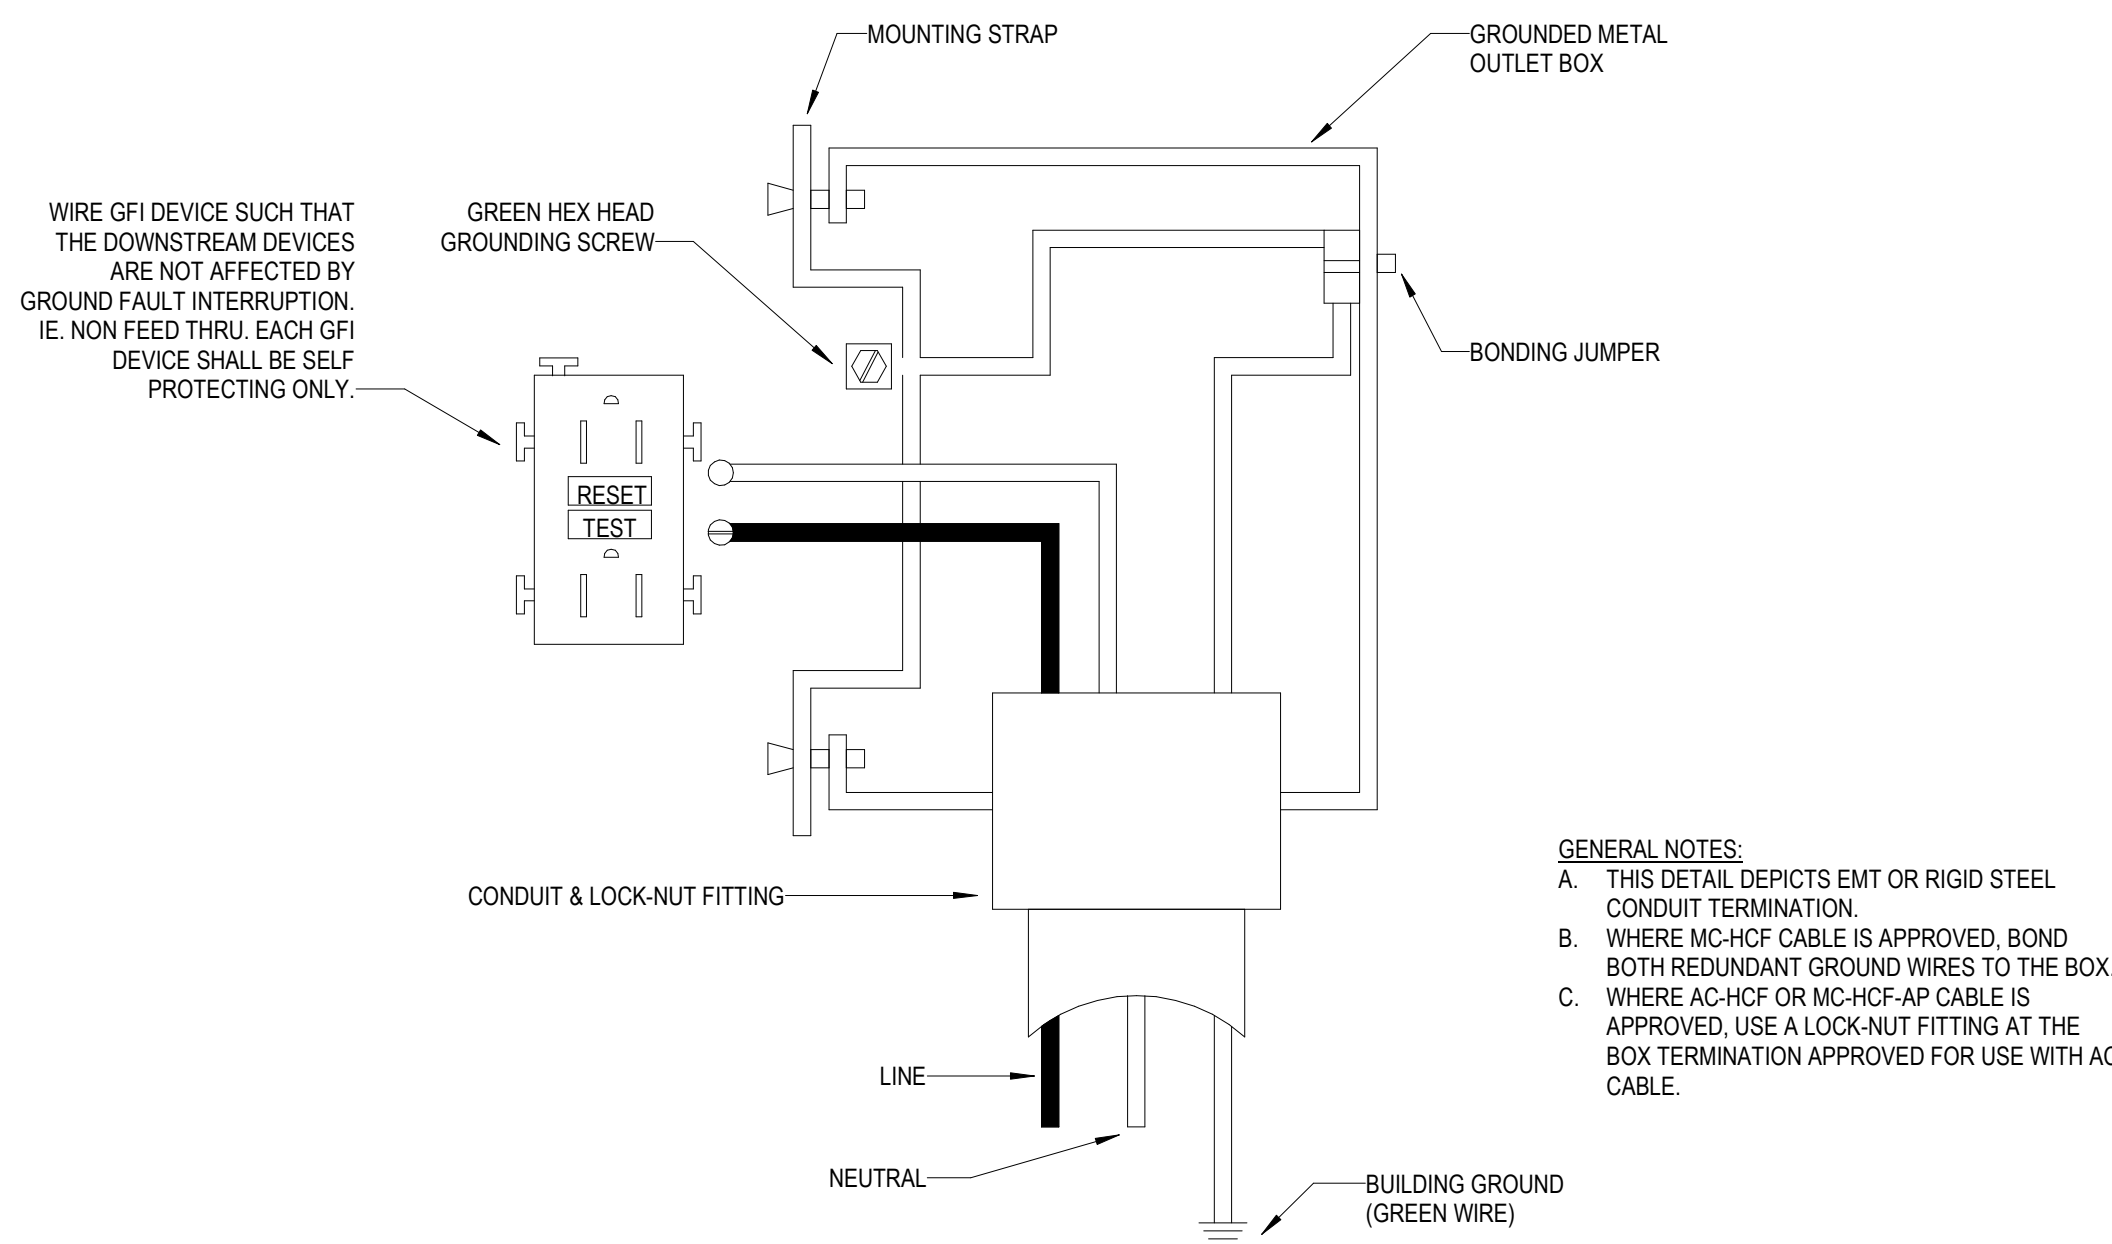


4 GFI RECEPTACLE - WIRING DIAGRAM
N.T.S.

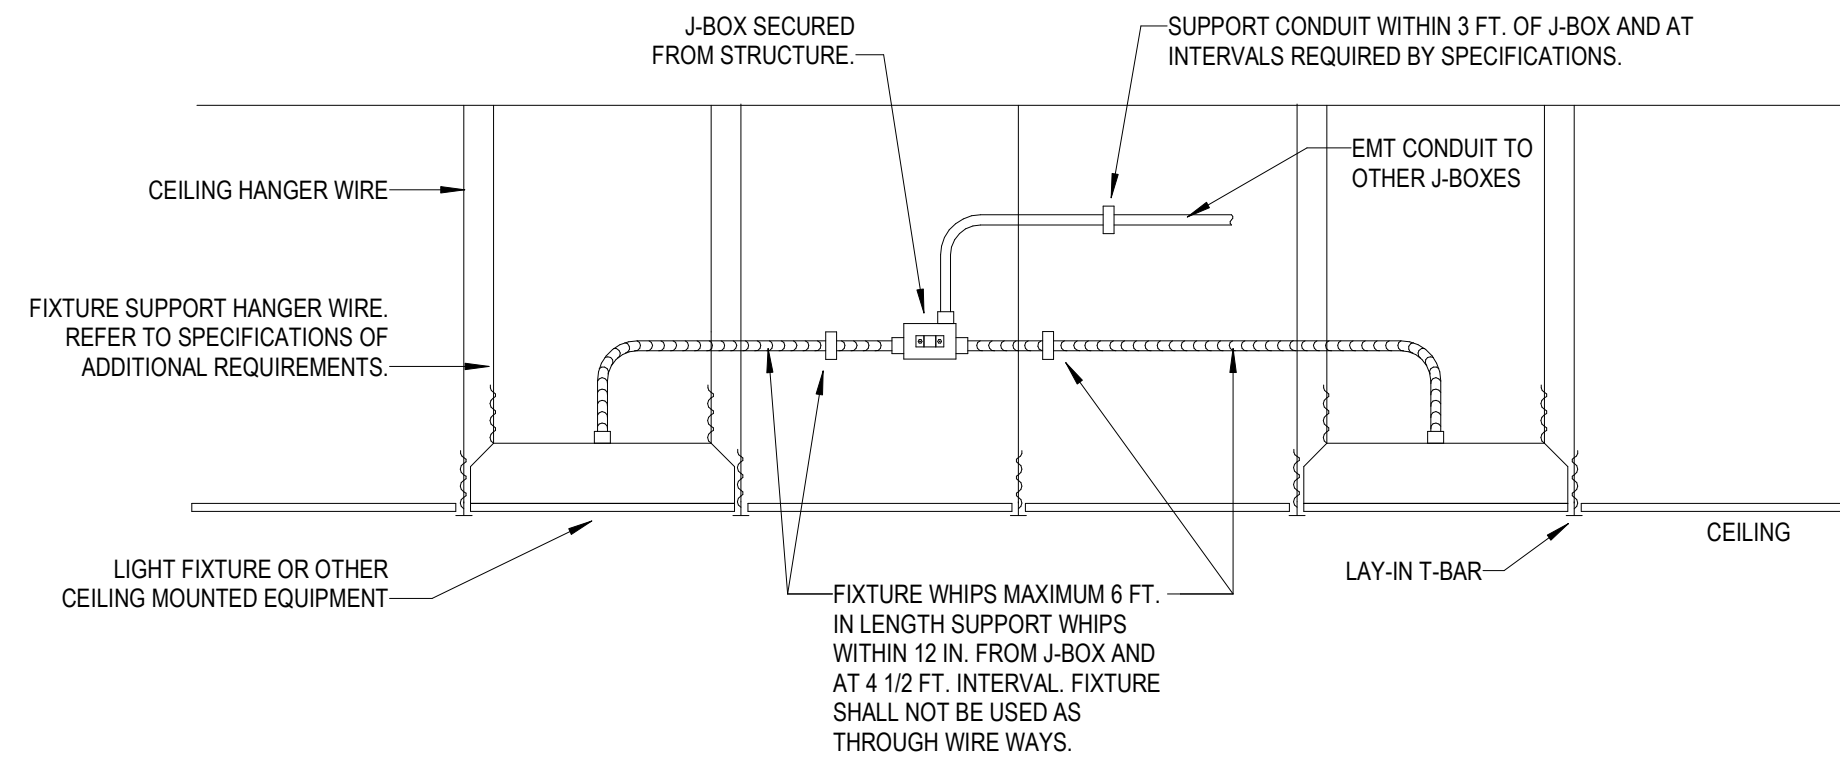

5 LAY-IN FIXTURE MOUNTING DETAIL
N.T.S.

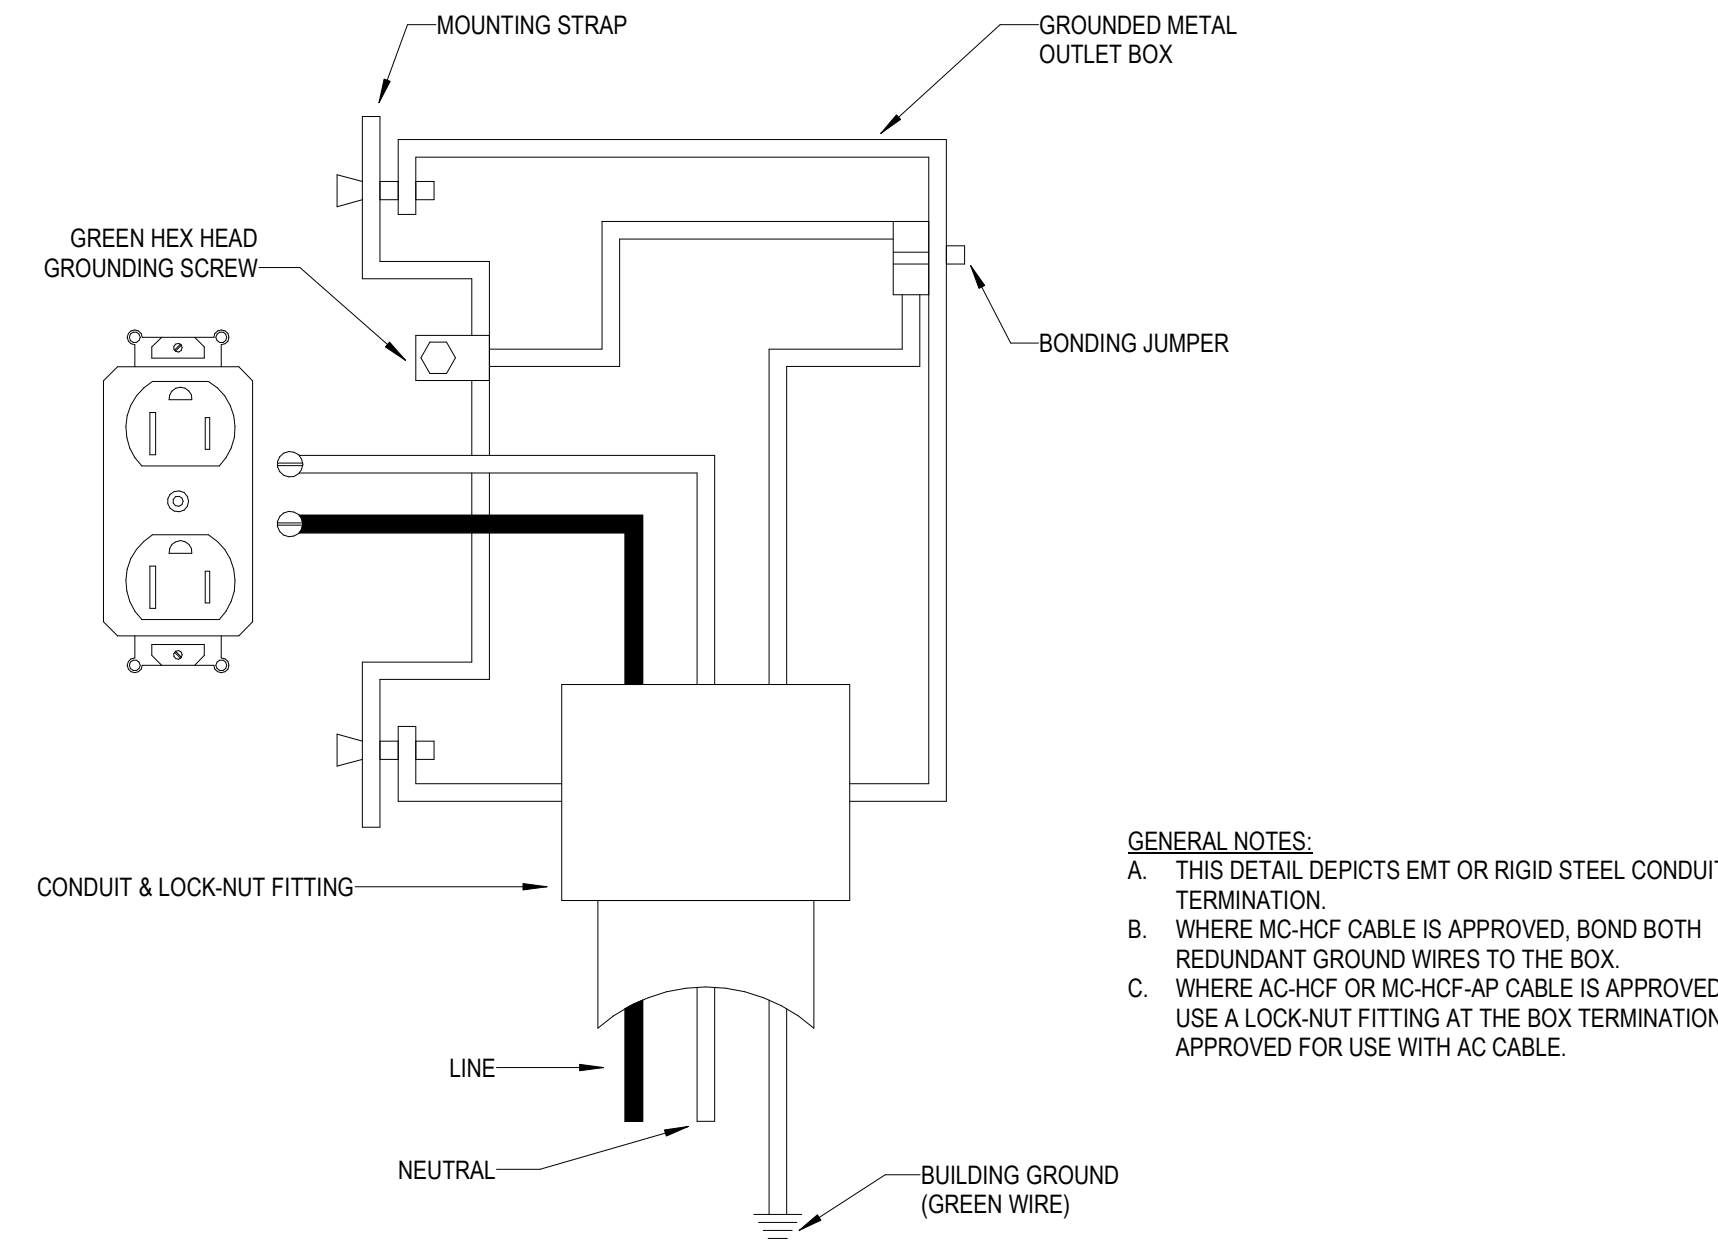

3 RECEPTACLE GROUNDING DETAIL
N.T.S.

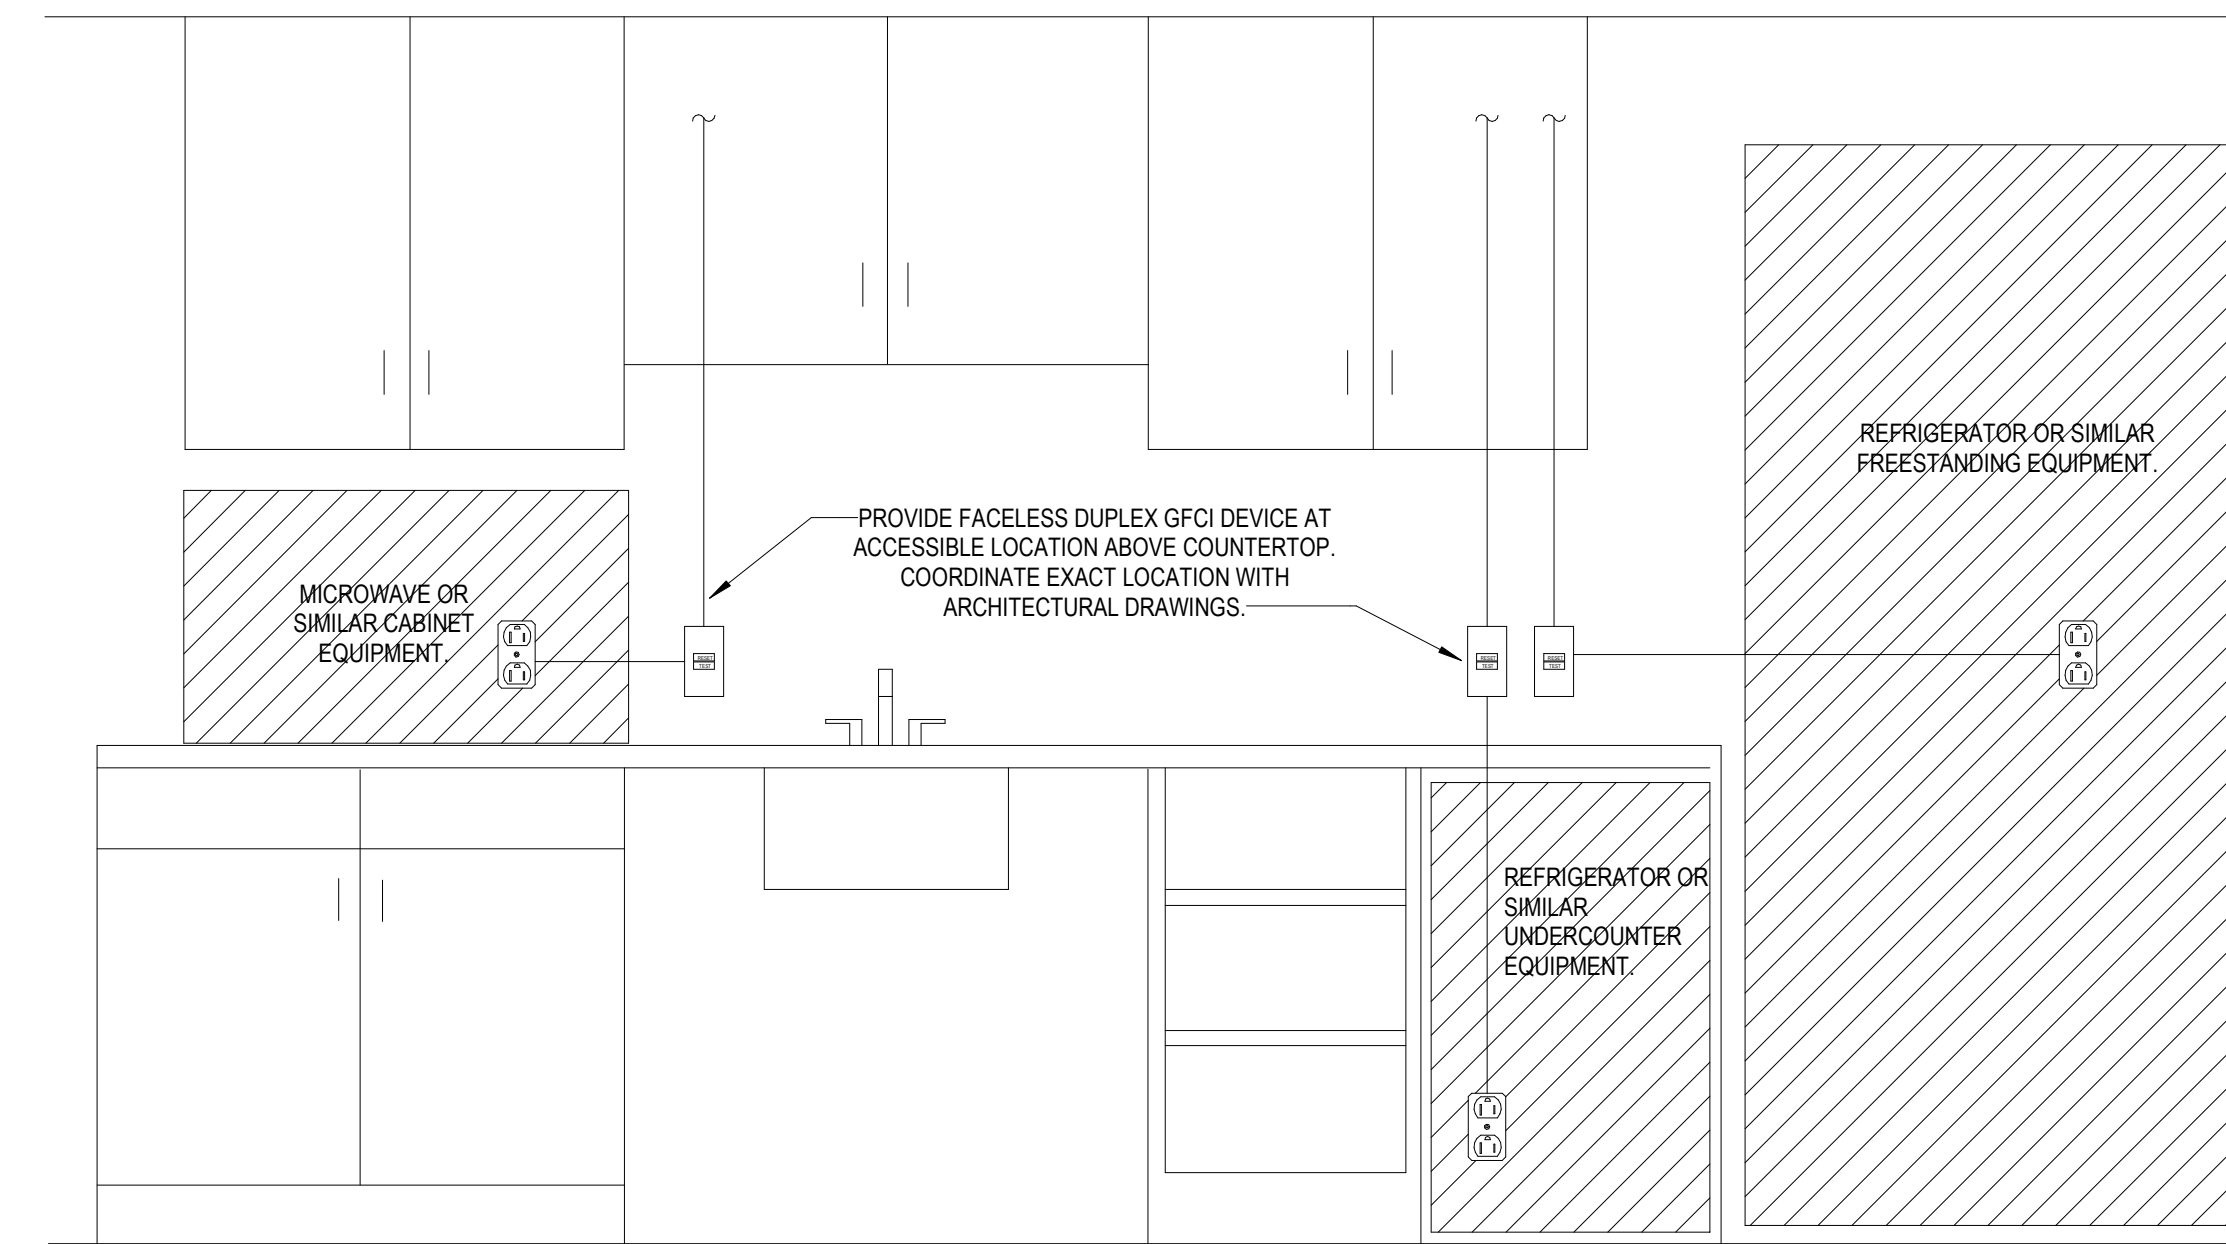

1 ACCESSIBLE GFCI DETAIL
N.T.S.

Autodesk Docx/6406.24 - HCA - Lee's Summit Medical Center (LSMC) r723/MEP_LSMC Admin Relocation R23.rvt 6/4/2025 1:43:51 PM Notice of Alternate Billing or Payment Cycle: The Owner may plan to make payments on an alternative schedule. A written description of such billing or payment cycle applicable to the Project is available from the Owner or the Owner's designated agent upon request.

ELECTRICAL LUMINAIRE FIXTURE SCHEDULE

TYPE	PHYSICAL DESCRIPTION							ELECTRICAL SPECIFICATIONS							MANUFACTURER INFORMATION			
	DESCRIPTION	LOCATION	HOUSING	REFLECTOR	SHIELDING	FINISH	MOUNTING	COLOR TEMP.	LAMP	LUMENS	HOURS	VA	UNITS	BALLAST / DRIVER	VOLTAGE	MANUFACTURER	CATALOG NUMBER	REMARKS
A1	2 x 4' LED VOLUMETRIC TROFFER	PUBLIC AND CORRIDOR	ONE PIECE STEEL	ACRYLIC LINEAR PRISMATIC DIFFUSER	N/A	MATTE WHITE POWDERCOAT	RECESSED GYPSUM BOARD OR LAY IN CEILING	4,000	LED	4,000	60000	32	EACH	LED DRIVER - LINEAR DIMMING 0-10V DOWN TO 1%	120	LITHONIA	#2VTL4 40L ADP E21 LP840	
A2	2 x 4' LED VOLUMETRIC TROFFER	PUBLIC AND CORRIDOR	ONE PIECE STEEL	ACRYLIC LINEAR PRISMATIC DIFFUSER	N/A	MATTE WHITE POWDERCOAT	RECESSED GYPSUM BOARD OR LAY IN CEILING	4,000	LED	4,800	60000	39	EACH	LED DRIVER - LINEAR DIMMING 0-10V DOWN TO 1%	120	LITHONIA	#2VTL4 48L ADP E21 LP840	
D2	2 x 2' LED VOLUMETRIC TROFFER	STAFF WORKING	ONE PIECE STEEL	ACRYLIC LINEAR PRISMATIC DIFFUSER	WHITE REGRESSED ALUMINUM DOOR	MATTE WHITE POWDERCOAT	RECESSED GYPSUM BOARD OR LAY IN CEILING	4,000	LED	4,000	60000	33	EACH	LED DRIVER - LINEAR DIMMING 0-10V DOWN TO 1%	120	LITHONIA	#2VTL2 40L ADP E21 LP840	
F1	2 x 2' LED ACRYLIC LENSED PREMIUM TROFFER	RESTROOM	22 GA. STEEL HOUSING	#1/2 TRANSMISSIVE 0.125" LENS	HINGED AND LATCHED FROM EITHER SIDE, ENCLOSED SPRING LOADED CAM LATCH, WHITE REGRESSED ALUMINUM DOOR WITH MITERED CORNERS	PAINTED AFTER FABRICATION	RECESSED GYPSUM BOARD OR LAY IN CEILING	4,000	LED	3,300	72000	29	EACH	LED DRIVER - LINEAR DIMMING 0-10V DOWN TO 1%	120	LITHONIA	#2GTL 2 X 33L RW E21 LP840	
J2	4'-0" LED LOW PROFILE LENSED STRIPLIGHT WITH DROP LENS FOR 10% UPLIGHT	STORAGE AND FACILITY	20 GA. HEAVY DUTY STEEL HOUSING	SYMMETRIC REFLECTOR	COLD ROLLED STEEL	WHITE FINISH, PAINTED AFTER FABRICATION	CHAIN HUNG AT 9'-0" A.F.F. LOCATED AROUND EQUIPMENT	4,000	LED	7,000	50000	30	EACH	LED DRIVER - LINEAR DIMMING 0-10V DOWN TO 1%	120	LITHONIA	#ZL1D L48 SMR 7000LM FST MVOLT 40K 80CR WH PAF	
M4	6' LED DOWNLIGHT WITH 45 DEGREE CUT OFF	PATIENT ROOMS	16 GA. GALVANIZED STEEL CONSTRUCTION	HIGH-IMPACT, FROSTED POLYCARBONATE LENS	LIGHT ENGINE AND DRIVER ACCESSIBLE THROUGH APERTURE	MATTE WHITE SELF-FLANGED, SEMI-SPECULAR FINISH	RECESSED GYPSUM BOARD OR LAY IN CEILING	4,000	LED	2,000	60000	20	EACH	LED DRIVER - LINEAR DIMMING 0-10V DOWN TO 1%	120	GOTHAM	#EV06 4020 AR MWD LSS MVOLT G210	
N1	RECESSED LINER PERIMETER COVE SYSTEM, CONTINUOUS ROHS - REFER TO ARCHITECTURAL DRAWINGS FOR EXACT LENGTHS	BOARD ROOMS, PERIMETER SYSTEM	EXTRUDED ALUMINUM, 20 GA. COLD ROLLED STEEL INTERNAL WIRING TRAYS	EXTRUDED CLEAR FROST REGRESSED ACRYLIC LENS	N/A	NATURAL ALUMINUM HOUSING, HIGH REFLECTANCE MATTE WHITE FASCIA	RECESSED CEILING, VERIFY CEILING TYPE PRIOR TO ORDERING	4,000	LED	109	50000	10	LF	LED DRIVER - LINEAR DIMMING 0-10V DOWN TO 1%	120	MARK ARCHITECTURAL LIGHTING	#SPRLD LOP 3FT RLP FL 80CR 40K 600LMF MIN1 MVOLT ZT	
X1	LED DECORATIVE RECESSED EDGE-LIT EXIT LIGHT, SINGLE FACE	EGRESS	20 GA. GALVANIZED STEEL, EXTRUDED ALUMINUM HOUSING	SATIN ALUMINUM TRIM PLATE, MOLDED TEXTURED LETTERS	N/A	6 INCH HIGH RED LETTERS ON MIRROR BACKGROUND, DIRECTIONAL CHEVRON INDICATORS AS REQUIRED	BACK / CEILING / END MOUNTING AS REQUIRED PER PLANS	0	LED	10	87600	1	EACH	N/A	120	LITHONIA	#LRP 1 RMR 120127	
X2	LED DECORATIVE RECESSED EDGE-LIT EXIT LIGHT, DOUBLE FACE	EGRESS	20 GA. GALVANIZED STEEL, EXTRUDED ALUMINUM HOUSING	SATIN ALUMINUM TRIM PLATE, MOLDED TEXTURED LETTERS	N/A	6 INCH HIGH RED LETTERS ON MIRROR BACKGROUND, DIRECTIONAL CHEVRON INDICATORS AS REQUIRED	BACK / CEILING / END MOUNTING AS REQUIRED PER PLANS	0	LED	15	87600	2	EACH	N/A	120	LITHONIA	#LRP 2 RMR 120127	

LIGHTING CONTROL REQUIREMENTS AND SEQUENCE OF OPERATIONS

TAG	SPACE TYPES	CONTROL		MANUAL CONTROL/OVERRIDE		OCCUPANCY SENSOR		PHOTOCELL CONTROL
		CONTROL DESCRIPTION	CONTROL SYSTEM TYPE	DEVICE	DURATION	TYPE/LOCATION	SET POINT	
1	PUBLIC AREAS, RECEPTION, CORRIDORS	MANUAL ON TO 100%, MANUAL OFF, DIMMING VIA MANUAL CONTROLS	STAND-ALONE	LINE VOLTAGE SWITCH	N/A	N/A	N/A	CEILING MOUNTED IN DAYLIGHT ZONES OVER 150W, 1 MIN FAD RATE
2	RESTROOMS/TOILET	AUTO ON TO 100%, AUTO OFF, MANUAL ON/OFF/DIM	STAND-ALONE	LINE VOLTAGE SWITCH	20 MIN	DUAL-TECH. WALL	AUTO ON/DIM, 20 MIN SET POINT	CEILING MOUNTED IN DAYLIGHT ZONES OVER 150W, 1 MIN FAD RATE
3	ENCLOSED ROOMS (OFFICE, BREAK, SUPPORT, ETC)	AUTO ON TO 50%, MANUAL ON TO 100%/OFF/DIM, AUTO OFF	STAND-ALONE	LINE VOLTAGE SWITCH	20 MIN	DUAL-TECH. WALL	AUTO ON 50%, AUTO OFF, 20 MIN SET POINT	CEILING MOUNTED IN DAYLIGHT ZONES OVER 150W, 1 MIN FAD RATE
4	ELECTRICAL, MECHANICAL, COMM ROOMS	MANUAL ON/OFF	STAND-ALONE	LINE VOLTAGE SWITCH	N/A	N/A	N/A	
5	ENCLOSED ROOMS (LARGE OFFICE, BREAK, SUPPORT, ETC)	AUTO ON TO 50%, MANUAL ON TO 100%/OFF/DIM, AUTO OFF	STAND-ALONE	LOW VOLTAGE WALL STATION	20 MIN	DUAL-TECH. CEILING	AUTO ON 50%, AUTO OFF, 20 MIN SET POINT	CEILING MOUNTED IN DAYLIGHT ZONES OVER 150W, 1 MIN FAD RATE

EXIST: M1NLA

LOCATION: EXTERIOR ELEC 1-ME1131
MAIN BUS: 225 A
MCB: N/A
VOLTAGE: 120/208 WYE
A/C AVAILABLE: 9970 A
A/C RATING: 10000 A

FED FROM: MIDPNL1
WIRES: 4W + G + IG
ENCLOSURE: NEMA 1
BUS TYPE: COPPER
MOUNTING: SURFACE
PANEL LUGS: MLO
NUMBER OF SECTIONS: 3

NEUTRAL BUS: YES
GROUND BUS: YES
ISOLATED GROUND BUS: YES
200% NEUTRAL: NO
FEED THROUGH LUGS: YES
POLES PER SECTION: 42

CKT NO.	DESCRIPTION	TOTAL LOAD (VA)	CIRCUIT BREAKER AMPS / POLES	A	B	C	CIRCUIT BREAKER POLES /	TOTAL LOAD (VA)	DESCRIPTION	CKT NO.	
1	EXISTING LOAD	--	20 1	1	20	--	EXISTING LOAD	--	EXISTING LOAD	2	
3	EXISTING LOAD	--	20 1	1	20	--	EXISTING LOAD	--	EXISTING LOAD	4	
5	EXISTING LOAD	--	20 1	1	20	--	EXISTING LOAD	--	EXISTING LOAD	6	
7	EXISTING LOAD	--	20 1	1	20	--	EXISTING LOAD	--	EXISTING LOAD	8	
9	EXISTING LOAD	--	20 1	1	20	--	EXISTING LOAD	--	EXISTING LOAD	10	
11	LIGHT - ROOMS	1,101	20 1	1	20	--	EXISTING LOAD	--	EXISTING LOAD	12	
13	LIGHT - HALLWAY	474	20 1	1	20	--	EXISTING LOAD	--	EXISTING LOAD	14	
15	RCPT - CONFERENCE, MARK OFF. 2-2008	1,440	20 1	1	20	--	EXISTING LOAD	--	EXISTING LOAD	16	
17	SPARE	--	20 1	1	20	--	EXISTING LOAD	--	EXISTING LOAD	18	
19	RCPT - CONFERENCE, BOARD RM. 2-2011	900	20 1	1	20	--	EXISTING LOAD	--	EXISTING LOAD	20	
21	RCPT - BOARD ROOM 2-2011	1,440	20 1	1	20	--	EXISTING LOAD	--	EXISTING LOAD	22	
23	RCPT - MARKETING OFFICE 2-2008	1,260	20 1	1	20	--	EXISTING LOAD	--	EXISTING LOAD	24	
25	RCPT - PHYSICIAN OFFICE 2-2007	1,080	20 1	1	20	--	EXISTING LOAD	--	EXISTING LOAD	26	
27	EXISTING LOAD	--	20 1	1	20	--	EXISTING LOAD	--	EXISTING LOAD	28	
29	RCPT - CEO OFFICE 2-2002	1,440	20 1	1	20	--	EXISTING LOAD	--	EXISTING LOAD	30	
31	RCPT - CFO OFFICE 2-2005	1,440	20 1	1	20	--	EXISTING LOAD	--	EXISTING LOAD	32	
33	RCPT - COO OFFICE 2-2004	1,440	20 1	1	20	--	EXISTING LOAD	--	EXISTING LOAD	34	
35	EXISTING LOAD	--	20 1	1	20	--	EXISTING LOAD	--	EXISTING LOAD	36	
37	EXISTING LOAD	--	20 1	1	20	--	EXISTING LOAD	--	EXISTING LOAD	38	
39	RCPT - CMO OFFICE 2-2003	1,440	20 1	1	20	--	RCPT - STG. COPYWRK 2-2012	1,440	EXISTING LOAD	40	
41	EXISTING LOAD	--	20 1	1	20	0.880	RCPT - TLT, HALLWAY 2-2022, 2-2023	42	EXISTING LOAD	42	
43	RCPT - CNO OFFICE 2-2006	1,440	20 1	1	20	--	EXISTING LOAD	--	EXISTING LOAD	44	
45	RCPT - RECEPTION 2-2001	1,440	20 1	1	20	--	EXISTING LOAD	--	EXISTING LOAD	46	
47	EXISTING LOAD	--	80 3	1	20	--	EXISTING LOAD	--	EXISTING LOAD	48	
49	--	--	--	--	1	20	--	EXISTING LOAD	--	EXISTING LOAD	50
51	--	--	--	--	1	20	--	EXISTING LOAD	--	EXISTING LOAD	52
53	RCPT - LAMINTR-COPYWRK2-2015	1,000	20 1	1	20	--	EXISTING LOAD	--	EXISTING LOAD	54	
55	SPARE	--	20 1	1	20	--	EXISTING LOAD	--	EXISTING LOAD	56	
57	SPARE	--	20 1	1	20	--	EXISTING LOAD	--	EXISTING LOAD	58	
59	SPARE	--	20 1	1	20	--	EXISTING LOAD	--	EXISTING LOAD	60	
61	SPARE	--	20 1	1	20	--	EXISTING LOAD	--	EXISTING LOAD	62	
63	RCPT - MW-COPYWRK 2-2015	1,200	20 1	1	20	--	EXISTING LOAD	--	EXISTING LOAD	64	
65	EXISTING LOAD	--	20 1	1	20	--	EXISTING LOAD	--	EXISTING LOAD	66	
67	EXISTING LOAD	--	20 1	1	20	--	EXISTING LOAD	--	EXISTING LOAD	68	
69	EXISTING LOAD	--	30 2	1	20	--	EXISTING LOAD	--	EXISTING LOAD	70	
71	--	--	--	--	1	20	--	EXISTING LOAD	--	EXISTING LOAD	72
73	EXISTING LOAD	--	20 1	1	20	--	EXISTING LOAD	--	EXISTING LOAD	74	
75	RCPT - COF-COPYWRK 2-2015	600	20 1	1	20	--	EXISTING LOAD	--	EXISTING LOAD	76	
77	EXISTING LOAD	--	20 1	1	20	900	RCPT - HALLWAY 2-2020	78	EXISTING LOAD	80	
79	EXISTING LOAD	--	20 1	1	20	1,440	RCPT - BREAK, STG, TLT 2-2018	82	EXISTING LOAD	84	
81	RCPT - SHARED OFFICE 2-2009	1,440	20 1	1	20	--	EXISTING LOAD	--	EXISTING LOAD	86	
83	RCPT - TOL, STG, COMM 2-2016	720	20 1	1	20	--	EXISTING LOAD	--	EXISTING LOAD	88	
85	EXISTING LOAD	--	20 1	1	20	--	EXISTING LOAD	--	EXISTING LOAD	90	
87	EXISTING LOAD	--	20 1	1	20	--	EXISTING LOAD	--	EXISTING LOAD	92	
89	EXISTING LOAD	--	20 1	1	20	--	EXISTING LOAD	--	EXISTING LOAD	94	
91	EXISTING LOAD	--	20 1	1	20	--	EXISTING LOAD	--	EXISTING LOAD	96	
93	EXISTING LOAD	--	40 2	1	20	--	EXISTING LOAD	--	EXISTING LOAD	98	
95	--	--	--	--	1	20	--	EXISTING LOAD	--	EXISTING LOAD	100
97	EXISTING LOAD	--	20 2	1	20	--	EXISTING LOAD	--	EXISTING LOAD	102	
99	--	--	--	--	1	20	--	EXISTING LOAD	--	EXISTING LOAD	104
101	EXISTING LOAD	--	20 1	1	20	--	EXISTING LOAD	--	EXISTING LOAD	106	
103	EXISTING LOAD	--	20 1	1	20	--	EXISTING LOAD	--	EXISTING LOAD	108	
105	EXISTING LOAD	--	20 1	1	20	--	EXISTING LOAD	--	EXISTING LOAD	110	
107	EXISTING LOAD	--	20 1	1	20	--	EXISTING LOAD	--	EXISTING LOAD	112	
109	EXISTING LOAD	--	20 1	1	20	--	EXISTING LOAD	--	EXISTING LOAD	114	
111	EXISTING LOAD	--	20 1	1	20	--	EXISTING LOAD	--	EXISTING LOAD	116	
113	EXISTING LOAD	--	20 1	1	20	--	EXISTING LOAD	--	EXISTING LOAD	118	
115	EXISTING LOAD	--	20 1	1	20	--	EXISTING LOAD	--	EXISTING LOAD	120	
117	EXISTING LOAD	--	20 1	1	20	--	EXISTING LOAD	--	EXISTING LOAD	122	
119	EXISTING LOAD	--	20 1	1	20	--	EXISTING LOAD	--	EXISTING LOAD	124	
121	EXISTING LOAD	--	20 3	3	30	--	EXISTING LOAD	--	EXISTING LOAD	126	
123	--	--	--	--	--	--	--	--	--	128	
125	--	--	--	--	--	--	--	--	--	126	

LOAD CLASSIFICATION		CONNECTED LOAD (VA)	ESTIMATED DEMAND (VA)	PANEL TOTALS		
LIGHT		1,576	1,969	EXISTING CONNECTED LOAD:	KVA	AMPS
RCPT		24,580	17,290		35.2	97.8
				REMOVED CONNECTED LOAD:	26.6	73.8
				ADDED CONNECTED LOAD:	26.2	72.6
				TOTAL CONNECTED LOAD:	34.8	96.5
				TOTAL ESTIMATED DEMAND:	27.9	77.4
NOTES: EXISTING LOAD IS BASED ON DESIGN LOAD FROM AN ONGOING PROJECT AT THE FACILITY.						

EXIST: M1ELK

LOCATION: ELEC 1-ME1072
MAIN BUS: 225 A
MCB: N/A
VOLTAGE: 120/208 WYE
A/C AVAILABLE: EXISTING
A/C RATING: 10000 A

FED FROM: MIDPEL1
WIRES: 4W + G
ENCLOSURE: NEMA 1
BUS TYPE: COPPER
MOUNTING: SURFACE
PANEL LUGS: MLO
NUMBER OF SECTIONS: 2

NEUTRAL BUS: YES
GROUND BUS: YES
ISOLATED GROUND BUS: YES
200% NEUTRAL: NO
FEED THROUGH LUGS: YES
POLES PER SECTION: 42

CKT NO.	DESCRIPTION	TOTAL LOAD (VA)	CIRCUIT BREAKER AMPS / POLES	A	B	C	CIRCUIT BREAKER POLES /...	TOTAL LOAD (VA)	DESCRIPTION	CKT NO.
1	EXISTING LOAD	--	20 1	1	20	--	EXISTING LOAD	--	EXISTING LOAD	2
3	EXISTING LOAD	--	20 1	1	20	--	EXISTING LOAD	--	EXISTING LOAD	4
5	EXISTING LOAD	--	20 1	1	20	--	EXISTING LOAD	--	EXISTING LOAD	6
7	EXISTING LOAD	--	20 1	2	20	--	EXISTING LOAD	--	EXISTING LOAD	8
9	EXISTING LOAD	--	20 1	--	--	--	EXISTING LOAD	--	EXISTING LOAD	10
11	SPARE	--	20 1	1	20	--	EXISTING LOAD	--	EXISTING LOAD	12
13	SPARE	--	15 3	1	20	--	EXISTING LOAD	--	EXISTING LOAD	14
15	--	--	--	1	20	--	EXISTING LOAD	--	EXISTING LOAD	16
17	--	--	--	1	20	--	EXISTING LOAD	--	EXISTING LOAD	18
19	SPARE	--	20 3	1	20	--	EXISTING LOAD	--	EXISTING LOAD	20
21	--	--	--	1	20	--	EXISTING LOAD	--	EXISTING LOAD	22
23	--	--	--	1	20	--	SPARE	--	SPARE	24
25	SPARE	--	20 1	1	20	--	SPARE	--	SPARE	26
27	SPARE	--	20 1	1	20	--	SPARE	--	SPARE	28
29	SPARE	--	20 1	1	20	--	SPARE	--	SPARE	30
31	SPARE	--	20 1	1	20	--	SPARE	--	SPARE	32
33	EXISTING LOAD	--	20 1	1	20	--	SPARE	--	SPARE	34
35	EXISTING LOAD	--	20 1	1	20	--	SPARE	--	SPARE	36
37	EXISTING LOAD	--	20 1	1	20	--	SPARE	--	SPARE	38
39	SPARE	--	20 1	1	20	--	SPARE	--	SPARE	40
41	SPARE	--	20 1	1	20	--	SPARE	--	SPARE	42
43	ADMIN ACCU-1	4,784	30 2	1	20	--	SPARE	--	SPARE	44
45	--	--	--	1	20	--	SPARE	--	SPARE	46
47	ADMIN VAVS	500	20 1	1	20	--	SPARE	--	SPARE	48
49	RCPT - BOARD ROOM 2-2011	1,440	20 1	1	20	--	SPARE	--	SPARE	50
51	RCPT - COMM 2-2016	180	20 1	1	20	--	SPARE	--	SPARE	52
53	RCPT - COMM 2-2016	180	20 1	1	20	--	SPARE	--	SPARE	54
55	AC-1 COND PUMP	200	20 1	1	20	--	SPARE	--	SPARE	56
57	SPARE	--	20 1	1	20	--	SPARE	--	SPARE	58
59	EXISTING LOAD	--	20 1	1	20	--	SPARE	--	SPARE	60
61	EXISTING LOAD	--	20 1	1	20	--	SPARE	--	SPARE	62
63	RCPT - COMM 2-2016	180	20 1	1	20	--	SPARE	--	SPARE	64
65	SPARE	--	20 1	1	20	--	SPARE	--	SPARE	66
67	SPARE	--	20 1	1	20	--	SPARE	--	SPARE	68
69	SPARE	--	20 1	1	20	--	SPARE	--	SPARE	70
71	SPARE	--	20 1	1	20	--	SPARE	--	SPARE	72
73	SPARE	--	20 1	1	20	--	SPARE	--	SPARE	74
75	SPARE	--	20 1	1	20	--	SPARE	--	SPARE	76
77	SPARE	--	20 1	1	20	--	SPARE	--	SPARE	78
79	SPARE	--	20 1	1	20	--	SPARE	--	SPARE	80
81	SPARE	--	20 1	1	20	--	SPARE	--	SPARE	82
83	SPARE	--	20 1	1	20	--	SPARE	--	SPARE	84




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Consultant:



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ADMINISTRATION RELOCATION

HCA - LEE'S SUMMIT MEDICAL
CENTER
2000 E BLUE PKWY
LEE'S SUMMIT, MO 64063

AUTHORITY HAVING JURISDICTION:
CITY OF LEE'S SUMMIT BUILDING DEPT.
MISSOURI DHSS

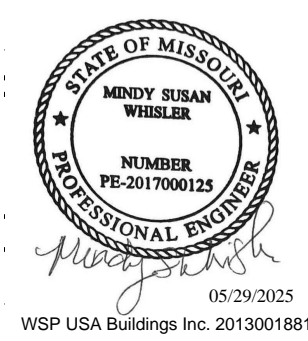FACILITY NUMBER:
0972400009

AGENCY APPROVALS:

REVISIONS		
REV #	DESCRIPTION	DATE
A	CITY - 2ND REVIEW	2025/05/29

DATE: 04/18/2025
SCALE: 1/8" = 1'-0"
DRAWN: FT
REVIEWED: MC
JOB NUMBER: 6406.24

GENERAL INFORMATION - TECHNOLOGY

T00-00






TECHNOLOGY GENERAL NOTES:

- CONTRACTOR SHALL VISIT THE SITE PRIOR TO SUBMITTING THEIR PROPOSAL AND BECOME FAMILIAR WITH THE CONDITIONS UNDER WHICH THE WORK WILL BE PERFORMED, AND CORRELATE THEIR SITE OBSERVATIONS WITH THE REQUIREMENTS OF THE CONTRACT DOCUMENTS. INCONSISTENCIES DISCOVERED SHALL BE REPORTED TO THE ARCHITECT AND ENGINEER AT ONCE, BEFORE SUBMITTAL OF BID PROPOSAL.
- ALL COMMUNICATIONS PRODUCTS AND INSTALLATIONS SHALL COMPLY WITH ALL APPLICABLE STATE AND LOCAL CODES. REFER TO MANUFACTURER'S SPECIFICATIONS FOR MATERIALS, SIZES AND METHODS FOR COMMUNICATIONS CONSTRUCTION. CONTRACTOR SHALL OBTAIN ALL NECESSARY PERMITS, PAY ALL FEES, AND COMPLY WITH ALL NATIONAL, STATE, AND MUNICIPAL LAWS, CODES, AND ORDINANCES RELATING TO BUILDING AND PUBLIC SAFETY.
- CONTRACTOR SHALL FURNISH ALL MATERIALS, EQUIPMENT, AND LABOR REQUIRED FOR A COMPLETE WORKING AND COORDINATED SYSTEM.
- UNLESS OTHERWISE NOTED, ALL EQUIPMENT AND MATERIALS SHALL BE NEW AND U.L. LISTED OR LABELED. EQUIPMENT AND MATERIALS SHALL BE INSTALLED IN ACCORDANCE WITH MANUFACTURER'S RECOMMENDATIONS, AND LISTINGS OR LABELING REQUIREMENTS AND RESTRICTIONS. PROVIDE SUBMITTAL DATA AS DEPICTED IN THE COMMUNICATIONS SPECIFICATIONS.
- CONTRACTOR SHALL PROVIDE SHOP DRAWINGS FOR APPROVAL OF ALL COMMUNICATIONS MATERIALS PROPOSED TO BE PROVIDED UNDER THIS CONTRACT. ANY DEVIATIONS FROM ITEMS SPECIFIED SHALL BE CLEARLY IDENTIFIED AND APPROVED. NO WORK IS AUTHORIZED WITHOUT SHOP DRAWINGS REVIEWED BY ENGINEER.
- REFER TO AND COORDINATE WITH ARCHITECTURAL DRAWINGS FOR EXACT LOCATION AND MOUNTING HEIGHTS OF ALL DEVICES AND EQUIPMENT.
- REFER TO AND COORDINATE WITH DIVISION 23 AND 26 FOR THE LOCATION OF ALL ITEMS LOCATED IN THE CEILING INCLUDING, BUT NOT LIMITED TO SUPPLY-AIR DIFFUSERS, RETURN-AIR DIFFUSERS AND FIRE SPRINKLER HEADS.
- ALL PENETRATIONS THROUGH FIRE RATED WALLS OR PARTITIONS SHALL BE MADE IN ACCORDANCE WITH U.L. 483 "FIRE RESISTANCE DIRECTORY". PENETRATIONS SHALL BE SLEEVED AND SEALED WITH A U.L. APPROVED FIRE RATED SEALANT. REFER TO ARCHITECTURAL LIFE SAFETY PLANS FOR FIRE RATED WALL LOCATIONS.
- CONTRACTOR SHALL COORDINATE AND SCHEDULE ALL OUTGAGES WITH OWNER'S REPRESENTATIVE.
- CONTRACTOR SHALL WARRANTY WORK FOR ONE (1) YEAR FROM THE COMPLETION OF THE PROJECT AND PROVIDE OWNER WITH AS-BUILT DRAWINGS.
- SPACE ALLOCATIONS FOR MATERIALS, EQUIPMENT AND DEVICES HAVE BEEN MADE ON THE BASIS OF PRESENT AND KNOWN FUTURE REQUIREMENTS AND THE DIMENSIONS OF ITEMS OF EQUIPMENT AND/OR DEVICES OF A PARTICULAR MANUFACTURER WHETHER INDICATED OR NOT. THE CONTRACTOR SHALL VERIFY THAT ALL MATERIALS, EQUIPMENT AND DEVICES PROPOSED FOR USE ON THIS PROJECT ARE WITHIN THE CONSTRAINTS OF THE ALLOCATED SPACE.
- ALL EMPTY CONDUIT SYSTEMS SHALL CONTAIN A PULL WIRE FOR FUTURE PULLING OF CONDUCTORS.
- DEVICES LOCATED WITHIN MECHANICAL/ELECTRICAL SPACES AND/OR CENTRAL UTILITY PLANT SHALL BE INSTALLED IN CONDUIT PATHWAYS FROM DEVICE LOCATION TO ACCESSIBLE CEILING SPACE WITHIN THE NEAREST CORRIDOR OR DIRECTLY TO IDF ROOM. COMBINATION PATHWAY MAY BE COMBINED INTO A JUNCTION POINT AND ROUTED THROUGH LARGER CONDUIT WHERE APPLICABLE. CONDUITS SHALL BE SIZED AT 40% FILL CAPACITY AT TIME OF INSTALLATION.
- COMMUNICATIONS/LOW-VOLTAGE/SECURITY CABLING SHALL BE RATED FOR THE ENVIRONMENT THAT IT IS TO BE INSTALLED (CMP - PLENUM RATED SPACES; CMP - NON-PLENUM RATED SPACES; OUTDOOR RATED CABLING, ETC.) WHERE APPLICABLE.
- ALL UNDER SLAB OR IN-SLAB CONDUITS SHALL BE INSTALLED IN A MANNER THAT PREVENTS WATER INFILTRATION OF THE CONDUIT. IT IS THE CONTRACTOR'S RESPONSIBILITY TO ENSURE GROUND WATER, RAIN WATER OR CONSTRUCTION WATER IS PREVENTED FROM ENTERING AND/OR REMOVED FROM THE CONDUITS PRIOR TO PLACEMENT OF COMMUNICATIONS CABLES. SEE ELECTRICAL SPECIFICATIONS, DETAILS AND PLANS FOR ADDITIONAL CONDUIT SEALING REQUIREMENTS.
- ALL CONDUIT STUBS AND/OR EMT SLEEVES SHALL BE FITTED WITH PLASTIC PROTECTIVE BUSHINGS. BUSHINGS SHALL BE RATED FOR THE ENVIRONMENT THEY ARE TO BE INSTALLED.
- ALL COMMUNICATIONS/LOW-VOLTAGE/SECURITY CONDUITS SIZED 2" OR LARGER SHALL HAVE A MINIMUM BEND RADIUS OF 10:1 OF THE INSIDE DIAMETER FOR ALL ELBOWS. ALL CONDUIT 2" OR SMALLER SHALL HAVE A MINIMUM BEND RADIUS OF 6:1 OF THE INSIDE DIAMETER FOR ALL ELBOWS.
- CONDUITS 2" AND SMALLER GENERALLY DO NOT APPEAR ON DRAWINGS EXCEPT FOR SPECIFIC CONDITIONS, BUT ARE REQUIRED. REFER TO CONTRACT DOCUMENTS (INCLUDING SCHEDULES, SHEET NOTES, DETAILS AND SPECIFICATIONS) FOR ADDITIONAL INFORMATION.
- SPACE ALLOCATIONS FOR MATERIALS, EQUIPMENT AND DEVICES HAVE BEEN MADE ON THE BASIS OF PRESENT AND KNOWN FUTURE REQUIREMENTS AND THE DIMENSIONS OF ITEMS OF EQUIPMENT OR DEVICES OF A PARTICULAR MANUFACTURER, WHETHER INDICATED OR NOT. THE CONTRACTOR SHALL VERIFY THAT ALL MATERIALS, EQUIPMENT AND DEVICES PROPOSED FOR USE ON THIS PROJECT ARE WITHIN THE CONSTRAINTS OF THE ALLOCATED SPACE.

ABBREVIATIONS

ACP	ACCESS CONTROL PANEL
AF	ABOVE FINISHED FLOOR
AHU	AUTHORITY HAVING JURISDICTION
AMP	OVERHEAD PAGING AMPLIFIER
AV	AUDIO VISUAL EQUIPMENT (COORDINATE OUTLET INSTALLATION WITH AV VENDOR)
BAS/BMS	BUILDING AUTOMATION/MANAGEMENT SYSTEM (COORDINATE OUTLET INSTALLATION WITH BAS EQ. VENDOR)
BFC	BELOW FINISHED CEILING
BVC	BABY VIEWING CAMERA DEVICE
CAB	CABINET
CCI	WALL MOUNTED "CCI" WORKSTATION (IF APPLICABLE)
CLK	WALL CLOCK
CPU	COMPUTER WORKSTATION
CT	CABLE TRAY
DAS	DISTRIBUTED ANTENNA SYSTEM
DEMARC	DEMARCATION ROOM
DA	DIAMETER
EMT	ELECTRICAL METAL TUBING
EQ	EQUIPMENT
(EX)	EXISTING
FM	FETAL MONITORING
HUGS	INFANT PROTECTION SYSTEM
IDF	INTERMEDIATE DISTRIBUTION FRAME (SEE TDR)
INFO	INFORMATION MONITOR
LV	LOW VOLTAGE
MAX	MAXIMUM
MDF	MAIN DISTRIBUTION FRAME (SEE TEC)
MEDS	MEDICATION DISTRIBUTION EQUIPMENT
MFR	MANUFACTURER
MN	MINIMUM
MON	MONITOR
NA	NOT APPLICABLE
NUR	NURSE CALL
NTS	NOT TO SCALE
OR INT.	OPERATING ROOM INTEGRATION EQUIPMENT (COORDINATE OUTLET INSTALLATION WITH OR INT. VENDOR)
PACS	PACS VIEWING STATION
PM	PHYSIOLOGICAL/PATIENT MONITORING
PROX	WALL MOUNTED "PROXIMITY SYSTEMS" WORKSTATION (IF APPLICABLE)
PTS	PHUEMATIC TUBE SYSTEM (COORDINATE OUTLET INSTALLATION WITH PTS VENDOR)
RTLS	REAL TIME LOCATING SYSTEM
TEC	TELECOMMUNICATIONS DISTRIBUTION ROOM (SEE IDF)
TELE	TELEMETRY SYSTEM
TRK	TRACKER MONITOR
TV	TELEVISION
UNO	UNLESS NOTED OTHERWISE
UON	UNLESS OTHERWISE NOTED
W	WALL PHONE
WAP	WIRELESS ACCESS POINT
WP	WEATHERPROOF
WRK	WALL MOUNTED WORKSTATION ON ARM



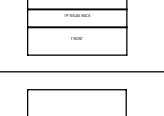
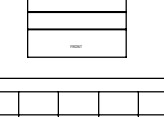
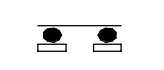
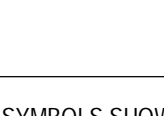
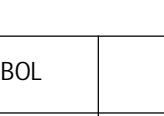
PUBLIC ADDRESS LEGEND

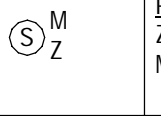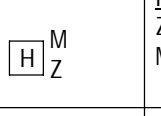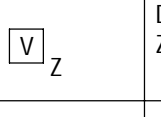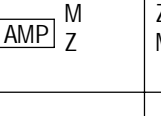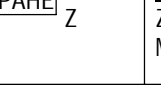ALL SYMBOLS SHOWN MAY NOT APPEAR ON ALL DRAWINGS. SYMBOLS ARE SHOWN SCHEMATIC AND MAY NOT BE TO SCALE.			
SYMBOL	DESCRIPTION	MTG. HEIGHT UNO (NOTE 1)	
	PA SPEAKER Z = ZONE NUMBER M = MOUNT	M: C = LAY IN CEILING F = CEILING FLUSH (HARD LID) W = WALL P = POLE L = LANDSCAPE	NA
	PA SPEAKER - HORN TYPE Z = ZONE NUMBER M = MOUNT	M: W = WALL P = POLE L = LANDSCAPE	NA
	PA VOLUME CONTROL - DOUBLE GANG BACKBOX, 2 1/2" DEEP, WITH SINGLE GANG DEVICE COVER, 3/4" CONDUIT STUBBED ABOVE ACCESSIBLE CEILING SPACE.		48" AFF
	PA AMPLIFIER Z = ZONE NUMBER M = MOUNT	M: W = WALL SHELF R = RACK/CABINET	NA
	PA HEADEND - MIXER, AUDIO INPUTS AND CONTROLS Z = ZONE NUMBER M = MOUNT	M: W = WALL SHELF R = RACK/CABINET	NA






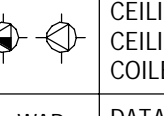

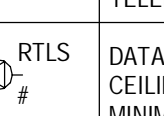
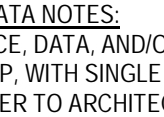
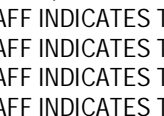
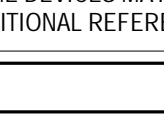
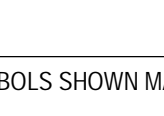
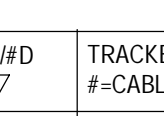
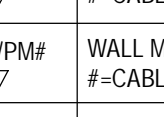
PUBLIC ADDRESS NOTES:

- COORDINATE WITH ARCHITECTURAL ELEVATIONS FOR EXACT MOUNTING HEIGHTS OF ALL WALL MOUNTED DEVICES.
- 48" AFF INDICATES TO TOP OF DEVICE.
- 18" AFF INDICATES TO CENTER OF DEVICE.
- 60" AFF INDICATES TO BOTTOM OF DEVICE.
- 80" AFF INDICATES TO CENTER OF DEVICE.
- ALL OTHER MOUNTING HEIGHTS REFER TO CENTERLINE OF DEVICE.

GENERAL SYMBOLS LEGEND

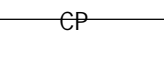ALL SYMBOLS SHOWN MAY NOT APPEAR ON ALL DRAWINGS. SYMBOLS ARE SHOWN SCHEMATIC AND MAY NOT BE TO SCALE.			
SYMBOL	DESCRIPTION	BACK BOX	MTG. HEIGHT UNO (NOTE 1)
	PROPOSED CABLE PATH. SEE DETAILS FOR MORE INFORMATION. CABLE PATH SHOWN FOR COORDINATION PURPOSES ONLY. PATH SHALL BE FIELD VERIFIED BY INSTALLATION CONTRACTOR.		
	2" UNLESS NOTED OTHERWISE, PRE-MANUFACTURED SLEEVE FIRE RATED PATHWAY DEVICE THROUGH RATED WALL, EMT SLEEVE THROUGH NON-RATED WALL.		
	VERTICAL CORE AND SLEEVE THROUGH FLOOR. PROVIDE EMT SLEEVE, EQUIPPED WITH PLASTIC BUSHING ON BOTH ENDS. REFER TO FLOOR PLANS FOR SIZING. RATING SHALL MATCH FLOOR BEING PENETRATED. REFER TO ARCHITECTURAL DRAWINGS FOR FLOOR RATINGS.		
	2 POST FREESTANDING EQUIPMENT RACK. SIZE AND LOCATION AS SHOWN ON DRAWINGS AND SPECS.		
	4 POST FREESTANDING EQUIPMENT RACK. SIZE AND LOCATION AS SHOWN ON DRAWINGS AND SPECS.		
	BASKET TRAY. SIZE AND LOCATION AS SHOWN ON DRAWINGS AND SPECS.		
	TELECOMMUNICATIONS GROUND BUSS BAR (TGB) - 1/4" X 4" X 12". CPI PART # 40153-012 OR EQUAL.		






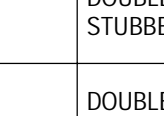
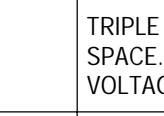
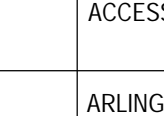
VOICE/DATA SYMBOLS LEGEND

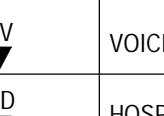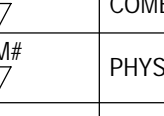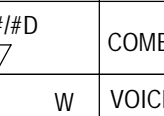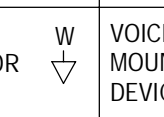ALL SYMBOLS SHOWN MAY NOT APPEAR ON ALL DRAWINGS. SYMBOLS ARE SHOWN SCHEMATIC AND MAY NOT BE TO SCALE.			
# = DESIGNATES CABLE/JACK COUNT FOR DEVICE			
SYMBOL	DESCRIPTION	BACK BOX	MTG. HEIGHT UNO (NOTE 1)
	VOICE ONLY OUTLET		18" AFF
	HOSPITAL DATA NETWORK ONLY OUTLET		18" AFF
	COMBINATION VOICE & HOSPITAL DATA NETWORK OUTLET		18" AFF
	PHYSIOLOGICAL MONITORING NETWORK OUTLET		18" AFF
	FETAL MONITORING NETWORK OUTLET		18" AFF
	COMBINATION PHYSIOLOGICAL MONITORING NETWORK & HOSPITAL DATA NETWORK OUTLET		18" AFF
	VOICE AND/OR DATA OUTLET, WALL PHONE STYLE FACEPLATE. 1 VOICE/DATA CABLE. PROVIDE DOUBLE GANG BACK, 2 1/2" DEEP, WITH SINGLE GANG DEVICE COVER AND 1" CONDUIT PATHWAY STUBBED ABOVE ACCESSIBLE CEILING SPACE.		48" AFF
	VOICE AND/OR DATA OUTLET, WALL PHONE STYLE FACEPLATE. 1 VOICE/DATA CABLE. MOUNTED ABOVE COUNTER, PROVIDE DOUBLE GANG BACK, 2 1/2" DEEP, WITH SINGLE GANG DEVICE COVER AND 1" CONDUIT PATHWAY STUBBED ABOVE ACCESSIBLE CEILING SPACE.		42" AFF
	ABOVE COUNTER OUTLET, #-CABLE QUANTITY, MOUNTED ABOVE THE COUNTER TOP. PROVIDE DOUBLE GANG BACK BOX, 2 1/2" DEEP, WITH SINGLE GANG DEVICE COVER AND 1" CONDUIT PATHWAY STUBBED ABOVE ACCESSIBLE CEILING SPACE.		42" AFF
	FLOOR MOUNTED OUTLET, #-CABLE QUANTITY. REFER TO ELECTRICAL (E) SHEETS FOR ADDITIONAL, ROUGH IN REQUIREMENTS.		FLOOR
	CEILING MOUNTED OUTLET, #-CABLE QUANTITY. OUTLET TO BE HOUSED ABOVE ACCESSIBLE CEILING. CABLE TO LOCATION SHOWN ON THE FLOOR PLANS AND LEAVE A MINIMUM 25 FEET COILED AT THE LOCATION.		ABOVE ACCESSIBLE CEILING
	DATA OUTLET FOR WIRELESS ACCESS POINT DEVICE. #-CABLE QUANTITY. OUTLET TO BE HOUSED ABOVE ACCESSIBLE CEILING UNLESS NOTED OTHERWISE. CABLE TO LOCATION SHOWN ON THE FLOOR PLANS WITH A MINIMUM 25 FEET COILED AT THE OUTLET LOCATION. CONTRACTOR SHALL RELOCATE OUTLETS AND MOUNT DEVICE PER OWNERS IT WIRELESS SURVEY.		ABOVE ACCESSIBLE CEILING
	WIRELESS TELEMETRY MONITORING OUTLET, #-CABLE QUANTITY. OUTLET TO BE LOCATED ABOVE ACCESSIBLE CEILING SPACE. CABLE TO LOCATION SHOWN ON THE FLOOR PLANS AND LEAVE A MINIMUM 25 FEET COILED AT THE OUTLET LOCATION. ROUTE OTHER END TO NEAREST TELEMETRY BACKBOARD LOCATION, LEAVING A MINIMUM 15 FEET COILED UP.		ABOVE ACCESSIBLE CEILING
	DATA OUTLET FOR RTLS DEVICE, #-CABLE QUANTITY. OUTLET TO BE HOUSED ABOVE ACCESSIBLE CEILING UNLESS NOTED OTHERWISE. CABLE TO LOCATION SHOWN ON THE FLOOR PLANS WITH A MINIMUM 25 FEET COILED AT THE DEVICE LOCATION.		ABOVE ACCESSIBLE CEILING

VOICE/DATA NOTES:

- VOICE, DATA, AND/OR COMBINATION OUTLET, #-OUTLET/CABLE QUANTITY, PROVIDE DOUBLE GANG DEVICE BACK BOX, 2 1/2" DEEP, WITH SINGLE GANG DEVICE COVER AND 1" CONDUIT PATHWAY STUBBED ABOVE ACCESSIBLE CEILING SPACE.
- REFER TO ARCHITECTURAL ELEVATIONS FOR EXACT MOUNTING HEIGHTS OF ALL DEVICES.
- CONTRACTOR SHALL COORDINATE EXACT MOUNTING HEIGHTS OF OUTLETS FOR TELEVISIONS, INFO, MONITORS, DIGITAL SIGNAGE, AND/OR OTHER WALL MOUNTED MONITORS WITH VENDOR PROVIDED MOUNTING BRACKET PRIOR TO ROUGH IN.
- 48" AFF INDICATES TO TOP OF DEVICE.
- 18" AFF INDICATES TO CENTER OF DEVICE.
- 60" AFF INDICATES TO BOTTOM OF DEVICE.
- 80" AFF INDICATES TO BOTTOM OF DEVICE.
- ALL OTHER MOUNTING HEIGHTS REFER TO CENTERLINE OF DEVICE.
- SOME DEVICES MAY HAVE SPECIAL DESCRIPTORS CALLING OUT EQUIPMENT SERVED BY OUTLET. SEE ABBREVIATIONS FOR ADDITIONAL REFERENCE.

TELEVISION/MONITOR SYMBOLS LEGEND

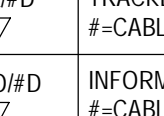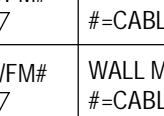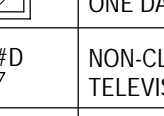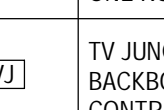ALL SYMBOLS SHOWN MAY NOT APPEAR ON ALL DRAWINGS. SYMBOLS ARE SHOWN SCHEMATIC AND MAY NOT BE TO SCALE.			
SYMBOL	DESCRIPTION	BACK BOX	MTG. HEIGHT UNO (NOTE 1)
	TRACKER MONITOR: #-CABLE QUANTITY	D	NOTE 2
	INFORMATION MONITOR: #-CABLE QUANTITY	D	NOTE 2
	WALL MOUNTED PHYSIOLOGICAL MONITORING TRACKER MONITOR: #-CABLE QUANTITY OF PATIENT MONITORING DATA CABLES	A	NOTE 2
	WALL MOUNTED FETAL MONITORING TRACKER MONITOR: #-CABLE QUANTITY OF FETAL MONITORING DATA CABLES	A	NOTE 2
	SECURITY MONITOR: ONE DATA CABLE	A	NOTE 2 & 4
	NON-CLINICAL TELEVISION (WAITING RM, BREAK RM, ETC.): TELEVISION OUTLET - ONE RG6 COAX CABLE + #-CABLE QUANTITY OF DATA CABLES	D	NOTE 2 & 3
	PATIENT ROOM TELEVISION OUTLET: ONE RG6 COAX CABLE, NURSE CALL PILLLOW SPEAKER JACK, & FOUR DATA CABLES	E	NOTE 2 & 3
	TV JUNCTION BOARD. PROVIDE A MINIMUM 4' X 4' OF CLEAR WALL BACKBOARD SPACE FOR CATV EQUIPMENT AND CONNECTIONS. REFER TO CONTRACT DRAWINGS FOR EXACT LOCATION OF TVJ.	NA	NA

TELEVISION ROUGH IN LEGEND

SYMBOL	DESCRIPTION
A	DOUBLE GANG BACK BOX, 2 1/2" DEEP, WITH SINGLE GANG DEVICE COVER AND 1" CONDUIT PATHWAY STUBBED ABOVE ACCESSIBLE CEILING SPACE.
B	DOUBLE GANG BACK BOX, 2 1/2" DEEP, WITH DOUBLE GANG DEVICE COVER AND 1" CONDUIT PATHWAY STUBBED ABOVE ACCESSIBLE CEILING SPACE.
C	TRIPLE GANG BACK BOX, 2 1/2" DEEP AND 1" CONDUIT PATHWAY STUBBED ABOVE ACCESSIBLE CEILING SPACE. POWER AND LOW VOLTAGE OUTLET SHALL SHARE SAME BACK BOX. CONTRACTOR TO PROVIDE VOLTAGE PARTITION WITHIN BACK BOX.
D	ARLINGTON RECESSED AV BOX (PART # TVBS507). PROVIDE (1) 1" CONDUIT PATHWAY STUBBED TO ABOVE ACCESSIBLE CEILING SPACE.
E	ARLINGTON RECESSED AV BOX (PART # TVBS6413). PROVIDE (1) 1" CONDUIT PATHWAY STUBBED TO ABOVE ACCESSIBLE CEILING SPACE.

TELEVISION NOTES:

- REFER TO ARCHITECTURAL ELEVATIONS FOR EXACT MOUNTING HEIGHTS OF ALL WALL MOUNTED DEVICES.
- COORDINATE OUTLET LOCATION WITH TV MOUNTING BRACKET PRIOR TO ROUGH IN.
- REFER TO RESPONSIBILITY MATRIX FOR OWNERSHIP OF RESPONSIBILITY AT TELEVISION DEVICE OUTLET.
- REFER TO SECURITY SHEETS FOR DEVICE LOCATION.
- 48" AFF INDICATES TO TOP OF DEVICE.
- 18" AFF INDICATES TO CENTER OF DEVICE.
- 60" AFF INDICATES TO BOTTOM OF DEVICE.
- 80" AFF INDICATES TO BOTTOM OF DEVICE.
- ALL OTHER MOUNTING HEIGHTS REFER TO CENTERLINE OF DEVICE.

ACCESS CONTROL SYMBOLS LEGEND

ALL SYMBOLS SHOWN MAY NOT APPEAR ON ALL DRAWINGS. SYMBOLS ARE SHOWN SCHEMATIC AND MAY NOT BE TO SCALE.				
SYMBOL	DESCRIPTION		BACK BOX	MTG. HEIGHT UNO (NOTE 1)
	MOUNT	TECHNOLOGY		CEILING OR WALL MOUNT
 EXAMPLE	C - CEILING F - FLUSH M - MULLION R - RACK T - TURNSTILE	D - DESK H - HIDDEN P - POLE S - SURFACE W - WALL	- SPECIFIC TO DEVICE - CAN BE MULTIPLE EX - EXISTING ETR - EXISTING TO REMAIN	XX
	CARD ACCESS READER S - SMART CARD F - ELEVATOR FLOOR CALL I - IC-CLASS M - MAGSTRIPE	H - ELEVATOR HALL CALL P - PROXIMITY W - WIEGAND	D1	48" AFF
	BIOMETRIC ACCESS READER F - FINGERPRINT I - IRIS V - VOICE	H - HAND GEOMETRY R - RETINA	D1	48" AFF
	CARD ACCESS READER W/KEYPAD B - BARCODE F - ELEVATOR FLOOR CALL I - IC-CLASS M - MAGSTRIPE	S - SMART CARD H - ELEVATOR HALL CALL P - PROXIMITY W - WIEGAND DUAL PUSH BUTTON	D1	48" AFF
	KEYPAD D - DRY CONTACT	W - WIEGAND	D1	48" AFF
	PUSH BUTTON D - DIRECT POWER DROP	X - REQUEST TO EXIT	D2	48" AFF
	REMOTE RELEASE BUTTON U - UNDER COUNTER	W - WALL	D2	18" AFF
	ACCESS CONTROL PANEL		N/A	(NOTE#4)
	DOOR CONTACT		N/A	AS REQD.
	PANIC BUTTON H - HARDWIRED W - WIRELESS		N/A	AS REQD.
	KEY SWITCH A - ALTERNATE ACTION K - KEYED ALIKE LD - LED	IC - INTERCHANGEABLE CORE L - LATCHING M - MOMENTARY	D2	48" AFF
	LOCK POWER SUPPLY		N/A	AS REQD.
	PUSH PAD WAVE PLATE - DOOR OPENING ACTUATOR (NOTE #3)		D2	48" AFF







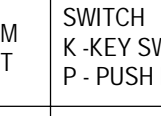
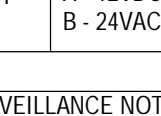
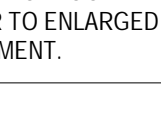
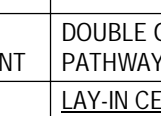
ACCESS CONTROL NOTES:

- REFER TO ARCHITECTURAL ELEVATIONS FOR EXACT MOUNTING HEIGHTS OF ALL WALL MOUNTED DEVICES.
- REFER TO FLOOR PLANS FOR DEVICE LOCATION LAYOUT.
- PUSH PAD/WAVE PLATES ARE SHOWN FOR COORDINATION OF BACK BOX ROUGH IN PURPOSES ONLY. REFER TO DIV 08 SPECIFICATIONS FOR ADDITIONAL HARDWARE INFORMATION.
- REFER TO ENLARGED COMM ROOM LAYOUT FOR EXACT PLACEMENT OF ACCESS CONTROL EQUIPMENT.

ACCESS CONTROL BACK BOX SCHEDULE

SYMBOL	DESCRIPTION
D1	DOUBLE GANG BACK BOX, 2 1/2" DEEP, WITH SINGLE GANG DEVICE COVER AND 3/4" CONDUIT PATHWAY STUBBED ABOVE ACCESSIBLE CEILING SPACE.
D2	DOUBLE GANG BACK BOX, 3 1/2" DEEP, WITH SINGLE GANG DEVICE COVER AND 3/4" CONDUIT PATHWAY STUBBED ABOVE ACCESSIBLE CEILING SPACE.
D3	DOUBLE GANG BACK BOX, 2 1/2" DEEP, WITH DOUBLE GANG DEVICE COVER AND 3/4" CONDUIT PATHWAY STUBBED ABOVE ACCESSIBLE CEILING SPACE.
D4	DOUBLE GANG BACK BOX, 3 1/2" DEEP, WITH DOUBLE GANG DEVICE COVER AND 3/4" CONDUIT PATHWAY STUBBED ABOVE ACCESSIBLE CEILING SPACE.
P1	PROPRIETARY BACK BOX WITH 3/4" CONDUIT PATHWAY STUBBED ABOVE ACCESSIBLE CEILING SPACE. REFER TO MANUFACTURER SPECIFICATIONS FOR DEVICE BACK BOX REQUIREMENTS AND PART #S.

VIDEO SURVEILLANCE SYMBOLS LEGEND

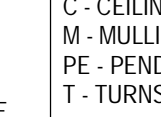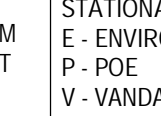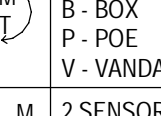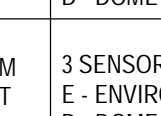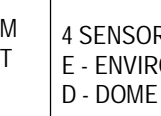
ALL SYMBOLS SHOWN MAY NOT APPEAR ON ALL DRAWINGS. SYMBOLS ARE SHOWN SCHEMATIC AND MAY NOT BE TO SCALE.				
SYMBOL	DESCRIPTION		BACK BOX	MTG. HEIGHT UNO (NOTE 1)
	M-MOUNTING TYPE	T-TECHNOLOGY (CAMERA TYPE)		CEILING OR WALL MOUNT
	C - CEILING M - MULLION P - PENDANT T - TURNSTILE	D - DESK M - MULLION P - POLE R - RACK S - SURFACE CO - CORNER	- SPECIFIC TO DEVICE - CAN BE MULTIPLE - SHOWN BELOW FOR EACH CAMERA ZZZ = FIELD OF VIEW	XX
	STATIONARY CAMERA E - ENVIRONMENTAL P - POE V - VANDAL RESISTANT	C - COVERT D - DOME F - FISHEYE		AS REQD.
	PANTILT/zoom CAMERA B - BOX P - POE V - VANDAL RESISTANT	E - ENVIRONMENTAL D - DOME		AS REQD.
	2 SENSOR CAMERA E - ENVIRONMENTAL D - DOME	P - POE V - VANDAL RESISTANT		
	3 SENSOR CAMERA E - ENVIRONMENTAL D - DOME	P - POE V - VANDAL RESISTANT		AS REQD.
	4 SENSOR CAMERA E - ENVIRONMENTAL D - DOME	P - POE V - VANDAL RESISTANT		AS REQD.
	MONITOR D - DESKTOP R - RECESSED	S - SWING ARM T - WITH TILT	D2	AS REQD.
	VIDEO RECORDER D - DVR	N - NVR		AS REQD.
	SWITCH K - KEY SWITCH P - PUSH BUTTON	T - TOGGLE	D2	AS REQD.
	POWER SUPPLY A - 12VDC B - 24VAC	P - POE		AS REQD.

VIDEO SURVEILLANCE NOTES:

- REFER TO ARCHITECTURAL ELEVATIONS FOR EXACT MOUNTING HEIGHTS OF ALL WALL MOUNTED DEVICES.
- REFER TO FLOOR PLANS FOR DEVICE LOCATION LAYOUT.
- REFER TO ENLARGED COMM ROOM LAYOUT AND TYPICAL EQUIPMENT RACK LAYOUTS FOR EXACT PLACEMENT OF HEADEND EQUIPMENT.


VIDEO SURVEILLANCE BACK BOX SCHEDULE

INDOOR WALL MOUNT	DOUBLE GANG BACK BOX, 2 1/8" DEEP, MOUNTED VERTICALLY, WITH SINGLE GANG DEVICE COVER AND 3/4" CONDUIT PATHWAY STUBBED ABOVE ACCESSIBLE CEILING SPACE.
INDOOR CEILING MOUNT	LAY-IN CEILING: 2X2 METAL CAMERA CEILING TILE WITH ADDITIONAL CEILING GRID SUPPORT HARD-PANEL CEILING: DOUBLE GANG BACK BOX, 2 1/8" DEEP, FLUSH MOUNTED IN CEILING, AND 3/4" CONDUIT PATHWAY STUBBED TO ABOVE ACCESSIBLE CEILING SPACE.
OUTDOOR WALL MOUNT	SINGLE GANG WEATHERPROOF BACK BOX, 2 1/8" DEEP, FLUSH MOUNTED VERTICALLY, AND 3/4" CONDUIT PATHWAY STUBBED ABOVE ACCESSIBLE CEILING SPACE WITHIN BUILDING.
OUTDOOR CORNER MOUNT	DOUBLE GANG ALUMINUM WEATHERPROOF BACK BOX, 2 1/8" DEEP, SURFACE MOUNTED APPROXIMATELY SAME HEIGHT AS CORNER MOUNT, 3/4" LIQUID-TITE FROM BACK BOX TO CAMERA (WITH DRIP LOOP), AND 3/4" CONDUIT PATHWAY FROM BACK BOX STUBBED TO ABOVE ACCESSIBLE CEILING SPACE, WITHIN BUILDING.
PARAPET MOUNT	DOUBLE GANG ALUMINUM WEATHERPROOF BACK BOX, 2 1/8" DEEP, SURFACE MOUNTED ON INSIDE OF PARAPET, 3/4" LIQUID-TITE FROM BACK BOX TO CAMERA (WITH DRIP LOOP), AND 3/4" CONDUIT PATHWAY FROM BACK BOX STUBBED TO ABOVE ACCESSIBLE CEILING SPACE WITHIN BUILDING.

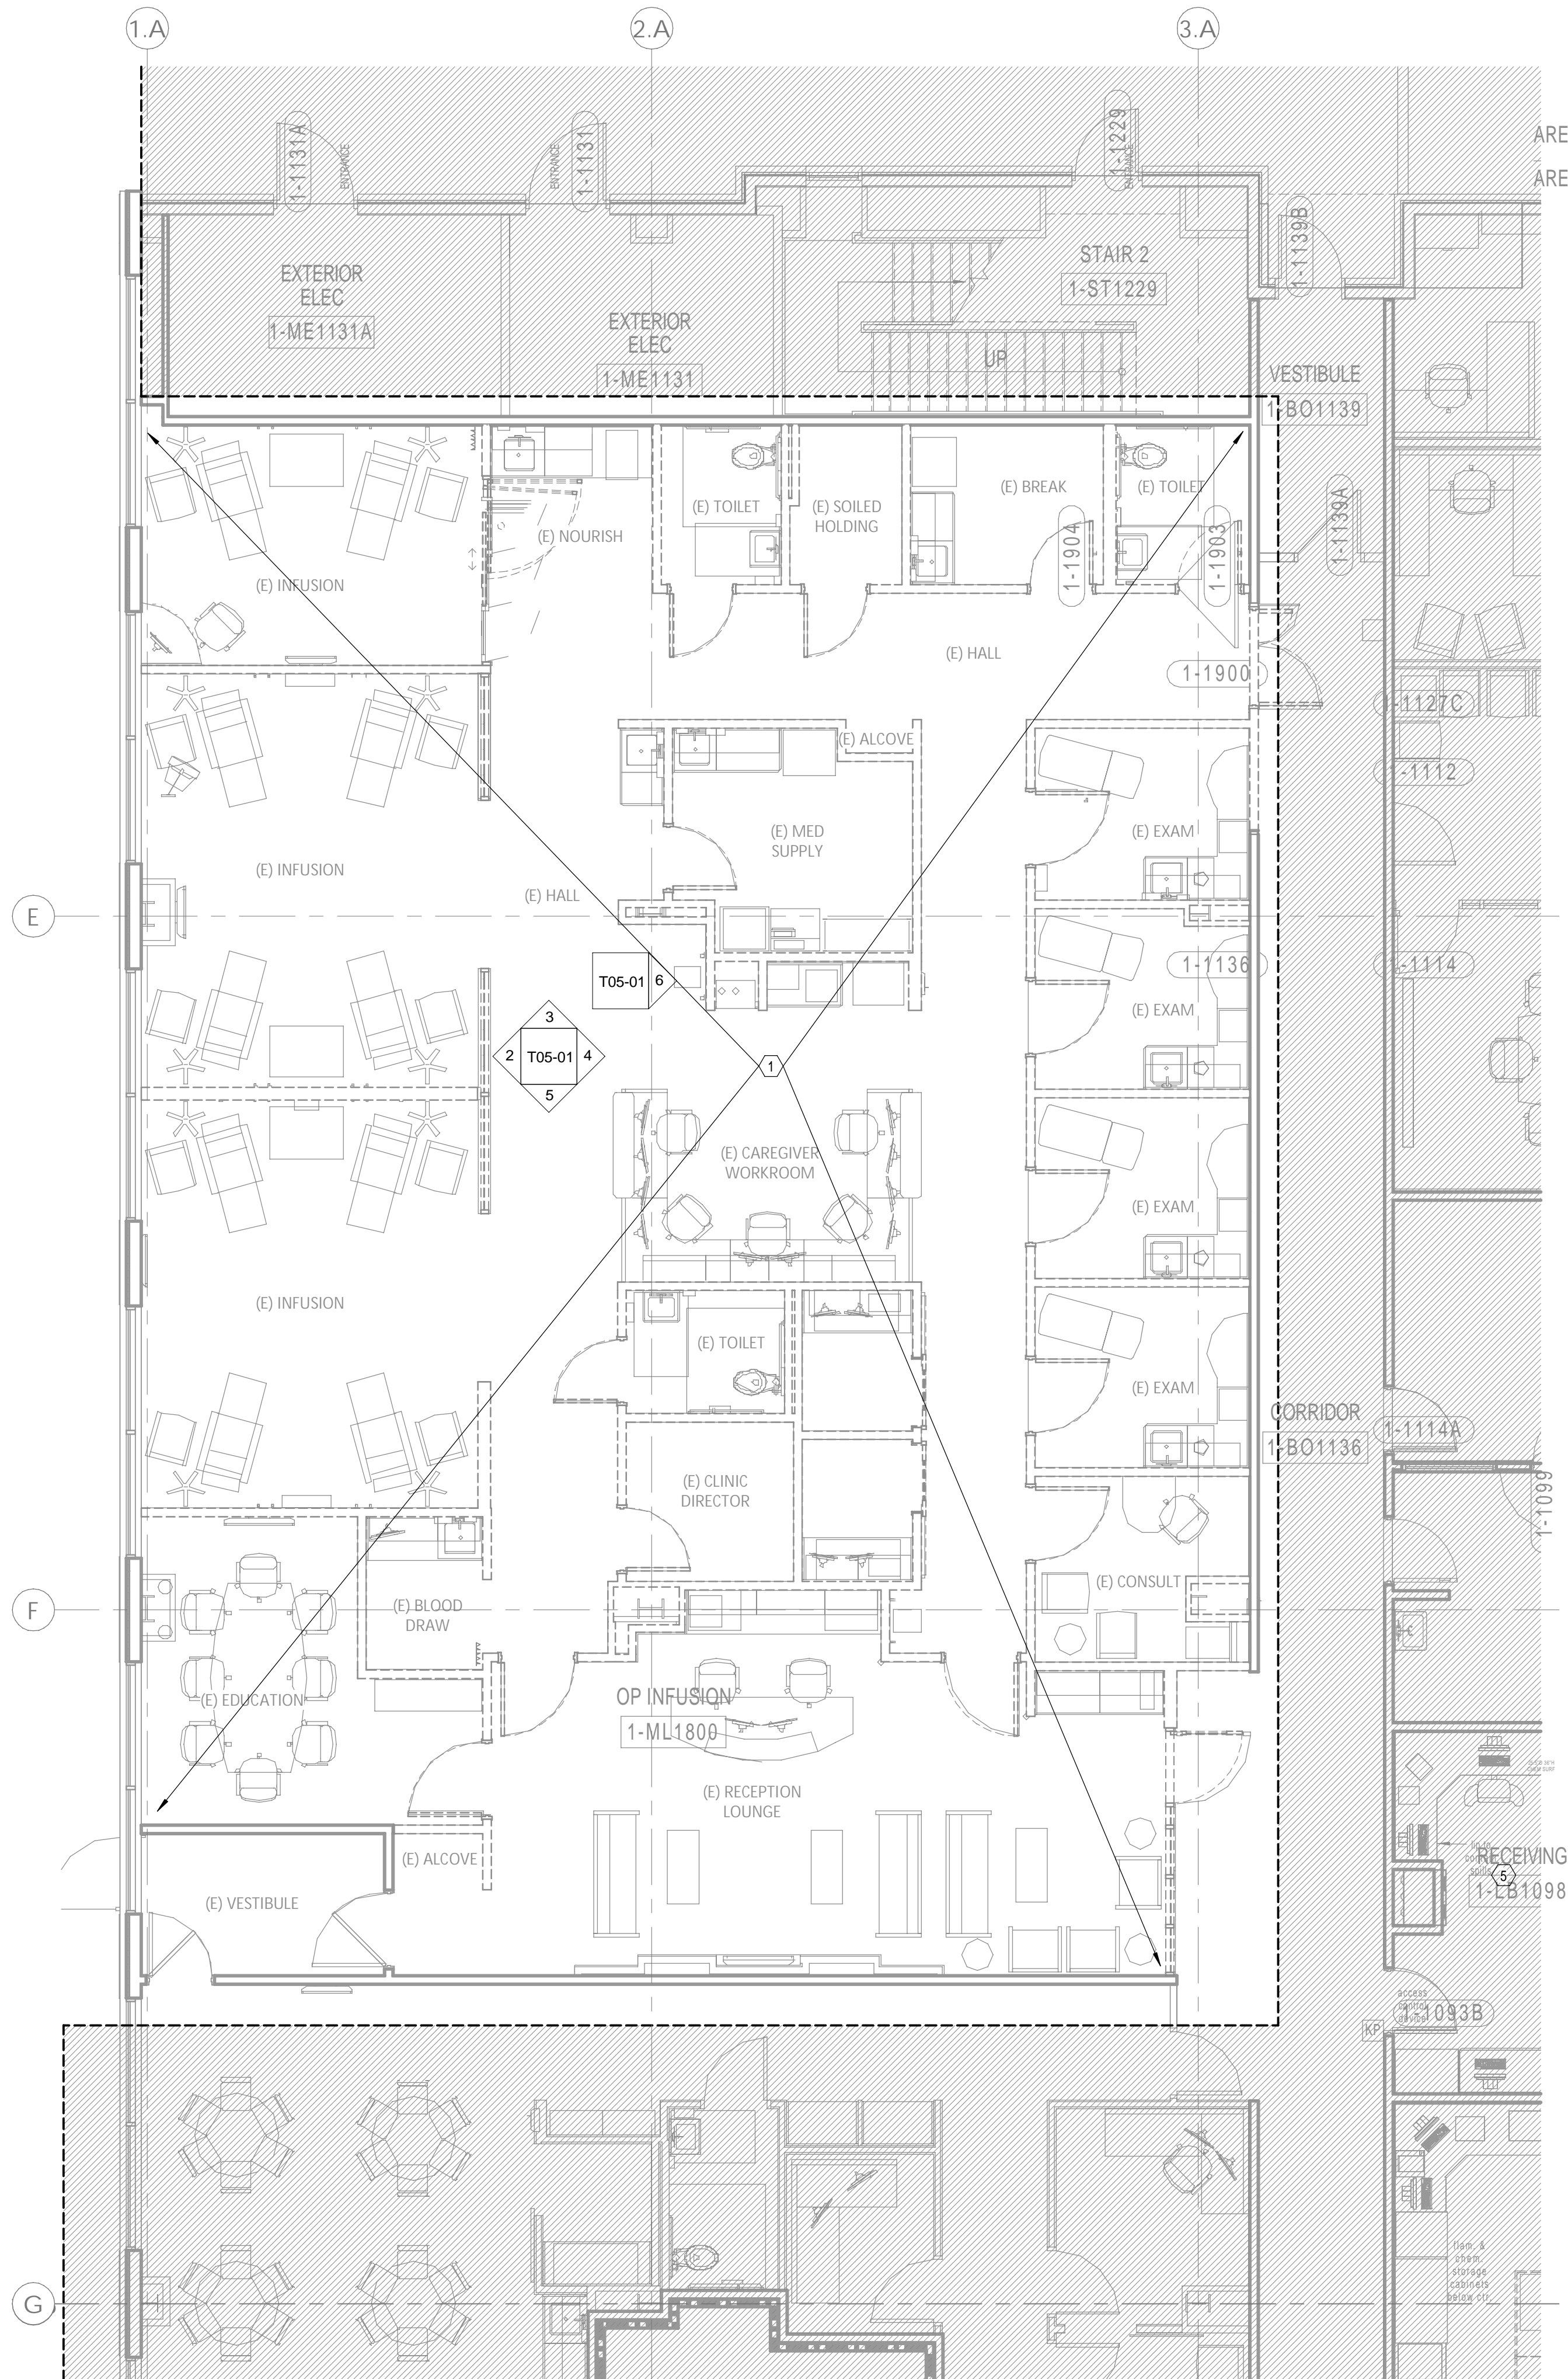

1 DEMOLITION PLAN - LEVEL 1 - ADMIN - COMMUNICATIONS
3/16" = 1'-0"

LEVEL 1 - KEYPLAN

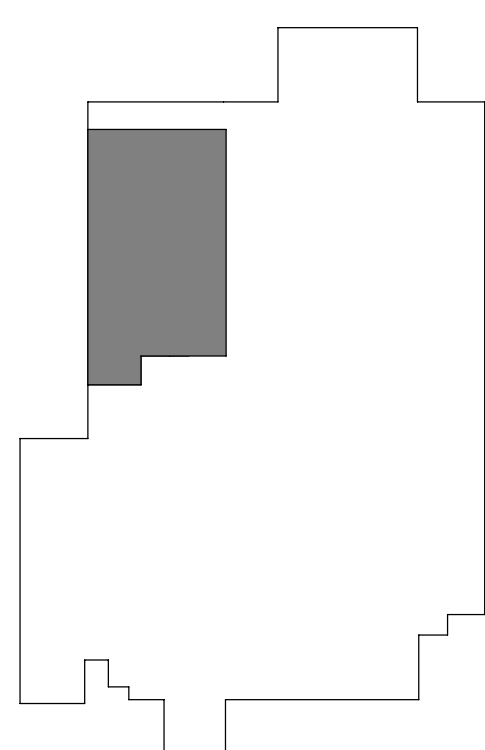

GENERAL NOTES:

- ALL EXISTING DEVICES MAY NOT BE SHOWN ON PLAN. CONTRACTOR SHALL FIELD VERIFY EXISTING CONDITIONS AND COORDINATE WITH ARCHITECTURAL PLANS AND OTHER TRADES TO DETERMINE THE OUTCOME OF EACH DEVICE WHERE NO CONSTRUCTION IS TO OCCUR. EXISTING DEVICES SHALL BE PROTECTED IN PLACE AND REMAIN IN OPERATION THROUGHOUT DURATION OF ALL PROJECT PHASES.
- INFORMATION PROVIDED ON THESE DRAWINGS HAVE BEEN TAKEN FROM DESIGN DRAWING AND FIELD OBSERVATIONS. CONTRACTOR SHALL VERIFY ALL EXISTING CONDITIONS PRIOR TO PRICING AND COMMENCEMENT OF WORK.
- PROVIDE FOR ANY AND ALL DEMOLITION WORK NECESSARY TO ACCOMMODATE ALL NEW CONSTRUCTION, INCLUDING ARCHITECTURAL, MECHANICAL, PLUMBING AND/OR ELECTRICAL WORK.
- WHERE EXISTING WALLS ARE BEING DEMOLISHED, REMOVE ALL EXISTING COMMUNICATIONS/ LOW VOLTAGE DEVICES AND THEIR ASSOCIATED CONDUITS, BACKBOXES AND CABLING BACK TO POINT OF ORIGIN. EXISTING CABLING PASSING THROUGH DEMO AREA, NOT BEING DEMOLISHED, SHALL BE SUPPORTED UTILIZING J-HOOK CABLE SUPPORTS INSTALLED PER DIVISION 27 SPECIFICATIONS.
- CONTRACTOR SHALL COORDINATE THE REMOVAL OR RELOCATION OF ALL COMMUNICATIONS/ LOW VOLTAGE DEVICES (INCLUDING BUT NOT LIMITED TO VOICE, DATA, OVERHEAD PAGING, VIDEO SURVEILLANCE CAMERAS, PHYSIOLOGICAL MONITORING, TELEMETRY, NURSE CALL, SECURITY ACCESS CONTROL, ETC.) WITH ARCHITECTURAL DRAWINGS.
- CONTRACTOR IS RESPONSIBLE FOR RESTORATION OF DAMAGE TO FIREPROOFING, FINISHES OR STRUCTURE CAUSED BY TELECOM/ LOW-VOLTAGE, OR SECURITY CONTRACTORS. RESTORATION SHALL BE RESTORED TO "SAME CONDITION" AS BEFORE DAMAGE OCCURRED. CONTRACTOR SHALL OBTAIN WRITTEN ACCEPTANCE OF RESTORATION FROM OWNER. IF DEMOLITION IS REQUIRED TO INSTALL AN ITEM, THE CONTRACTOR SHALL RESTORE THE AREA TO PREVIOUS CONDITION, OR REPLACE DAMAGED ITEMS WITH NEW ITEMS TO MATCH EXISTING.
- WHERE AREAS BEING DEMOLISHED CONTAIN INFANT PROTECTION SYSTEM (IPS) DEVICES, CONTRACTOR SHALL DISABLE IPS EQUIPMENT AND PROVIDE INTERIM SYSTEM PROGRAMMING PRIOR TO REMOVAL TO PREVENT FALSE ALARMING AND LOCKDOWN OF DEMOLITION AREA.


LEGEND NOTES

- EXISTING WALL MOUNTED AND CEILING DEVICES AND ASSOCIATED CABLING, CONDUIT AND BACKBOXES WITHIN WALL/AREA SHALL BE DEMOLISHED TO POINT OF ORIGIN. EXISTING CABLING ROUTING THROUGH THIS AREA THAT IS NOT TO BE DEMOLISHED SHALL BE SUPPORTED BY J-HOOK STYLE SUPPORTS INSTALLED PER DIVISION 27 SPECIFICATIONS.



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ADMINISTRATION RELOCATION

HCA - LEE'S SUMMIT MEDICAL
CENTER
2000 SE BLUE PKWY
LEE'S SUMMIT, MO 64063

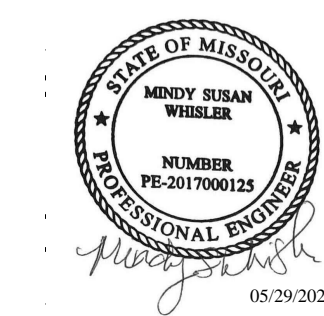AUTHORITY HAVING JURISDICTION:
CITY OF LEE'S SUMMIT BUILDING DEPT.
MISSOURI DHSS

FACILITY NUMBER:
0972400009

AGENCY APPROVALS:


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REV #	DESCRIPTION	DATE
A	CITY - 2ND REVIEW	2025/05/29

DATE: 04/18/2025
SCALE: 3/16" = 1'-0"
DRAWN: FT
REVIEWED: MC
JOB NUMBER: 6406.24

DEMOLITION PLAN - LEVEL 1
- ADMIN -
COMMUNICATIONS

TD02-01

Autodesk Docs/6406.24 - HCA - Lee's Summit Medical Center (LSMC)_LV23/MEP_LSMC Admin Relocation_R23.rvt
6/4/2025 1:33:19 PM
Notice of Alternate Billing or Payment Cycle: The Owner may plan to make payments on an alternative schedule. A written description of such billing or payment cycle applicable to the Project is available from the Owner or the Owner's designated agent upon request.

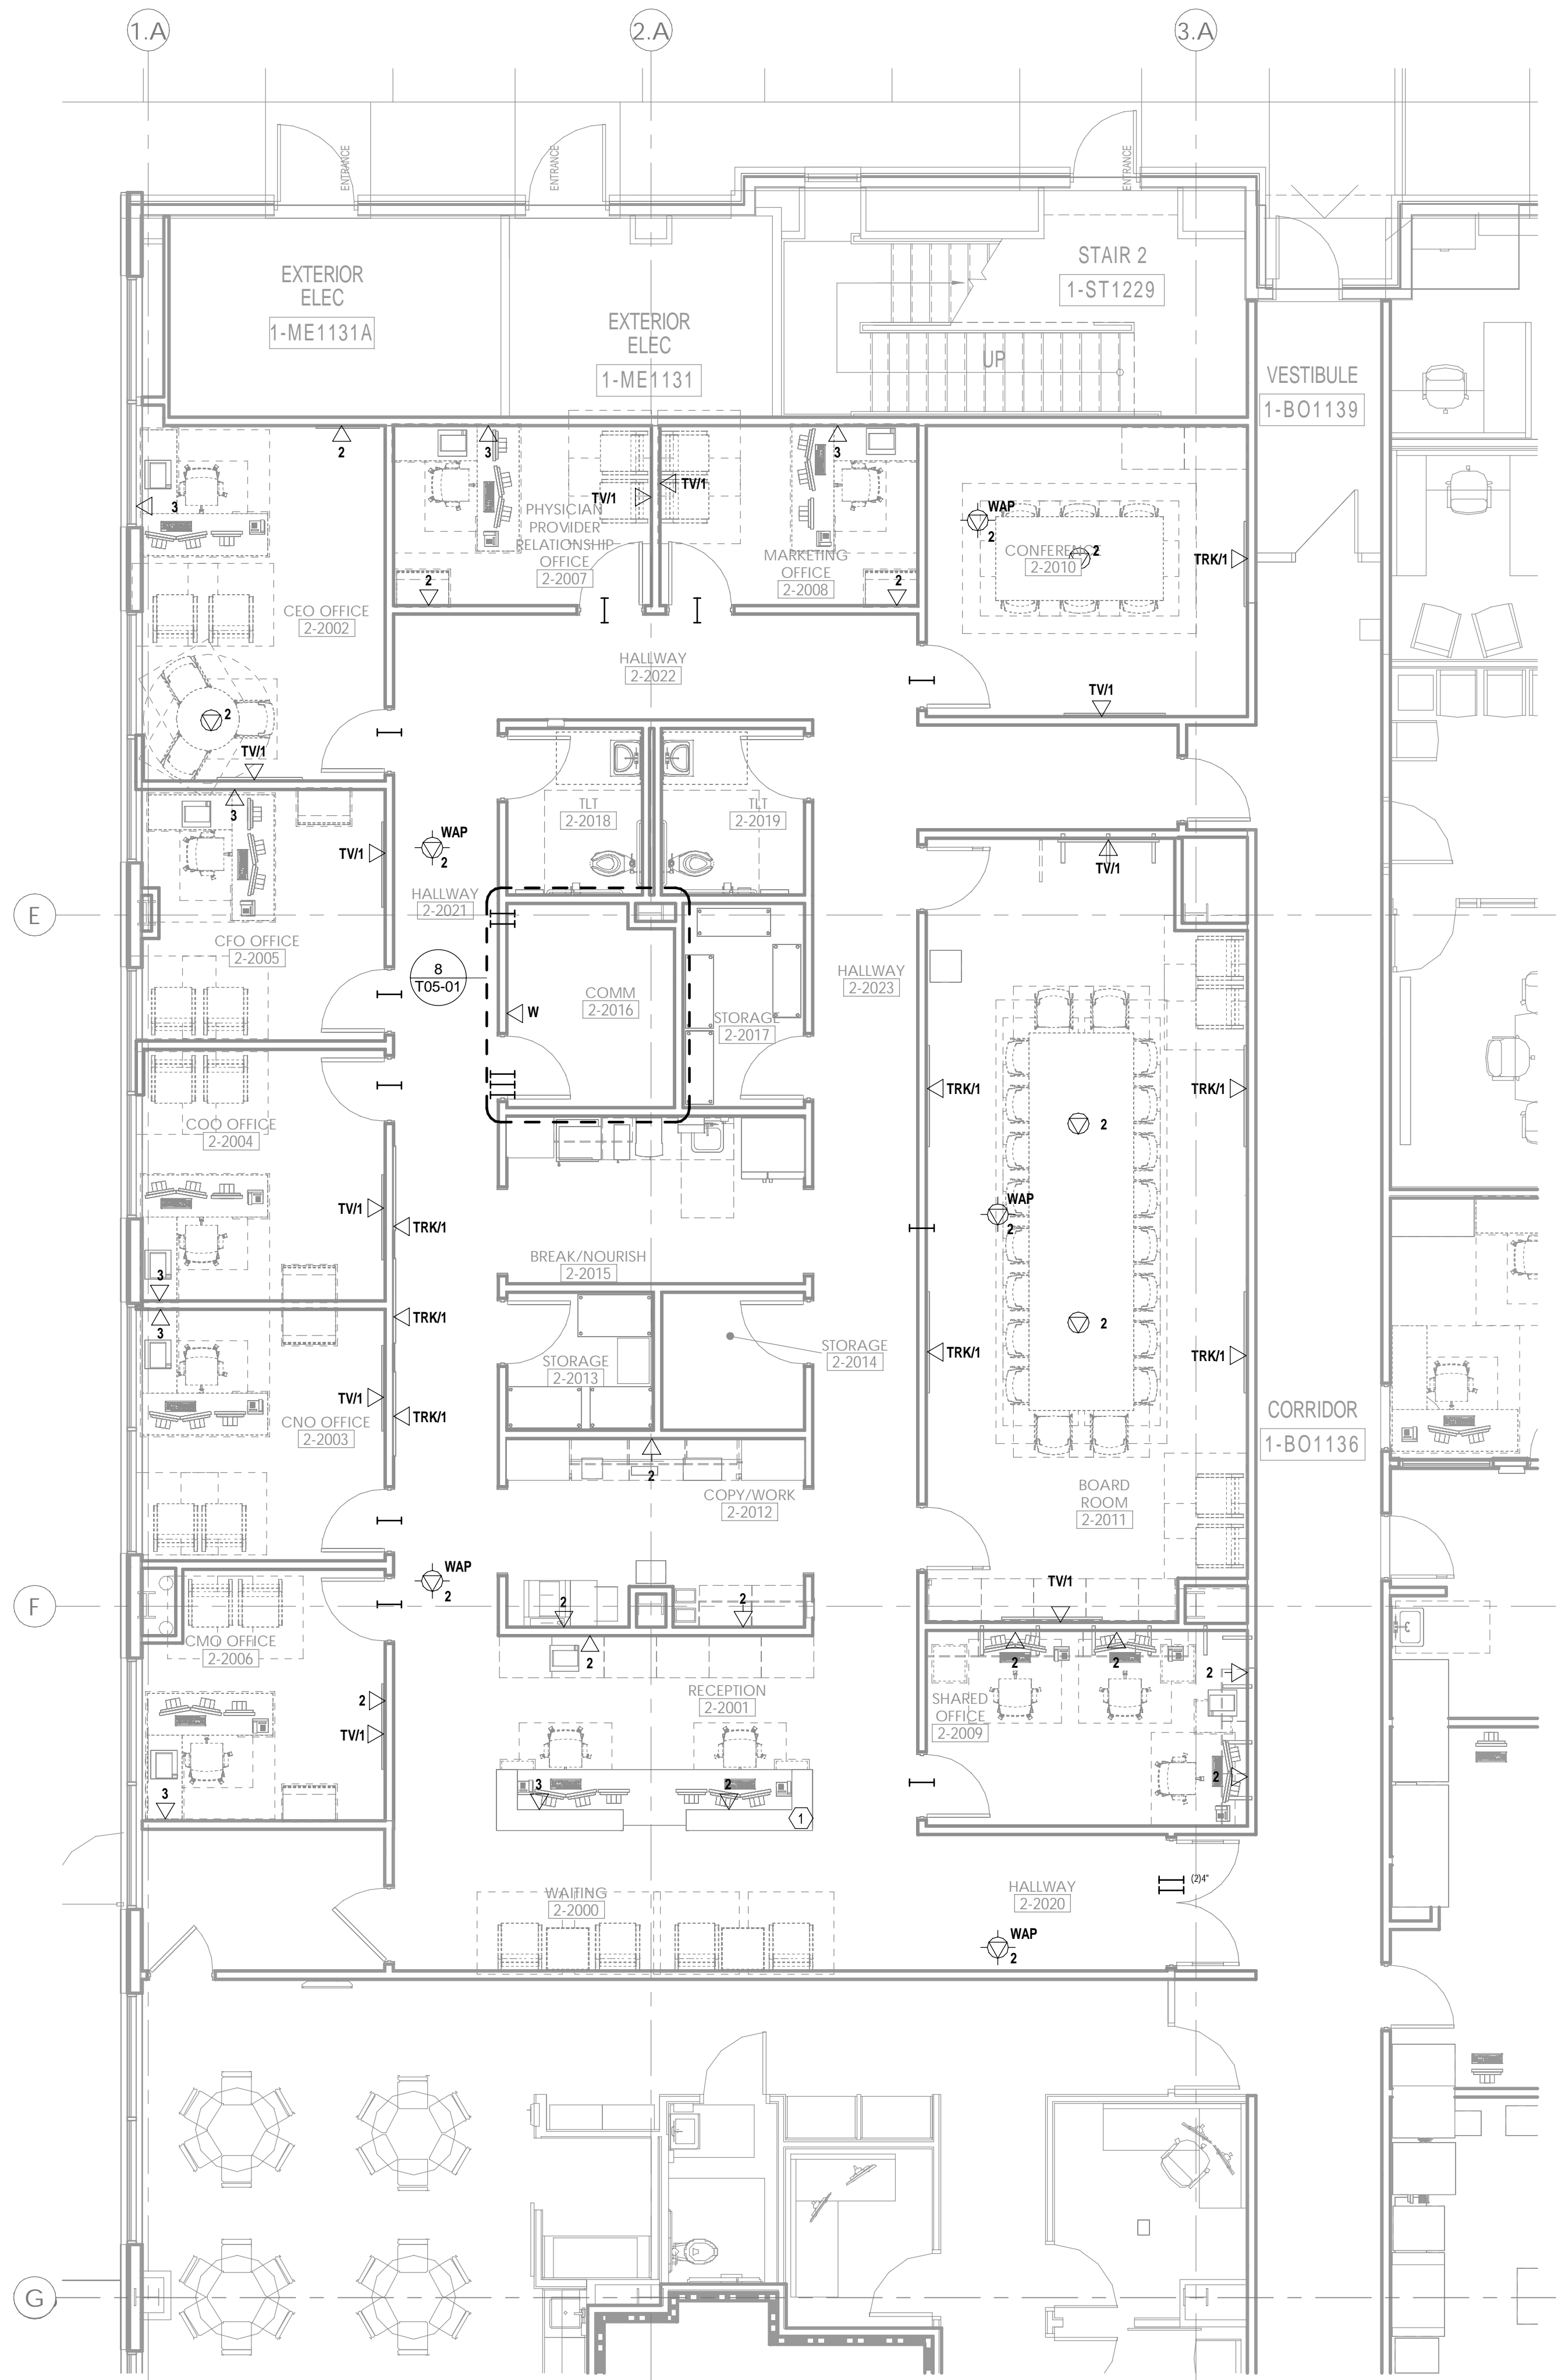

1 FLOOR PLAN - LEVEL 1 - ADMIN - COMMUNICATIONS
3/16" = 1'-0"

GENERAL NOTES:

- A. REFER TO AND COORDINATE WITH ARCHITECTURAL PLANS, ELEVATIONS, AND DETAILS FOR EXACT LOCATIONS OF ALL DEVICES.
- B. REFER TO SHEET T00-00 FOR GENERAL NOTES AND SYMBOLS APPEARING ON THIS SHEET.
- C. ALL DEVICES WITHIN ROOMS CONTAINING HARD PAN CEILINGS SHALL HAVE CONDUITS ROUTED TO ABOVE ACCESSIBLE CEILING SPACE IN CORRIDOR.
- D. COMMUNICATIONS CONDUIT PATHWAYS SHALL NOT CONTAIN ANY LENGTH GREATER THAN 100 FEET BETWEEN PULL POINTS. NO SECTION OF CONDUIT SHALL CONTAIN MORE THAN TWO 90-DEGREE BENDS, OR EQUIVALENT, BETWEEN PULL POINTS. IF THERE IS REVERSE BEND IN THE SECTION, A PULL POINT SHALL BE INSTALLED. PULL BOXES SHALL NOT BE USED IN LIEU OF BENDS. THE INSIDE RADIUS OF ALL CONDUIT BENDS SHALL BE AT LEAST 10 TIMES THE INTERNAL DIAMETER. BENDS IN CONDUIT SHALL NOT CONTAIN ANY KINKS OR OTHER DISCONTINUITIES THAT MAY HAVE A DETRIMENTAL EFFECT ON THE CABLE SHEATH DURING INSTALLATION. NO DAISY CHAINING OF BACK BOXES ALLOWED UNLESS OTHERWISE NOTED.
- E. ALL CABLING SHALL BE SUPPORTED ABOVE ACCESSIBLE CEILING SPACE USING LOW-VOLTAGE SUPPORTS SIZED AT 40% FILL BASED ON CURRENT NEEDS.


LEGEND NOTES

- 1. CONTRACTOR SHALL PROVIDE (1) 2" AND (1) 1" CONDUIT PATHWAY FROM WITHIN MILLWORK TO NEAREST ACCESSIBLE ABOVE CEILING SPACE FOR CABLING PATHWAY.



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ADMINISTRATION
RELOCATION

HCA - LEE'S SUMMIT MEDICAL
CENTER
2000 SE BLUE PKWY
LEE'S SUMMIT, MO 64063

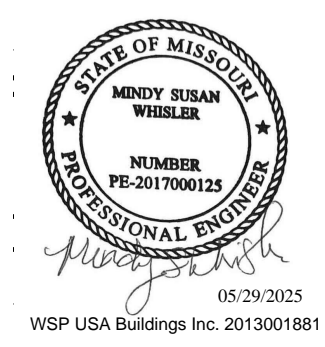AUTHORITY HAVING JURISDICTION:
CITY OF LEE'S SUMMIT BUILDING DEPT.
MISSOURI DHSS

FACILITY NUMBER:
0972400009

AGENCY APPROVALS:


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REV #	DESCRIPTION	DATE
A	CITY - 2ND REVIEW	2025/05/29

DATE: 04/18/2025
SCALE: 3/16" = 1'-0"
DRAWN: FT
REVIEWED: MC
JOB NUMBER: 6406.24


FLOOR PLAN - LEVEL 1 -
ADMIN -
COMMUNICATIONS

T02-01

Autodesk Docs/6406.24 - HCA - Lee's Summit Medical Center (SMC)_T02-01 MEP_L1-NC Admin Relocation_R23.rvt 6/4/2025 1:33:22 PM

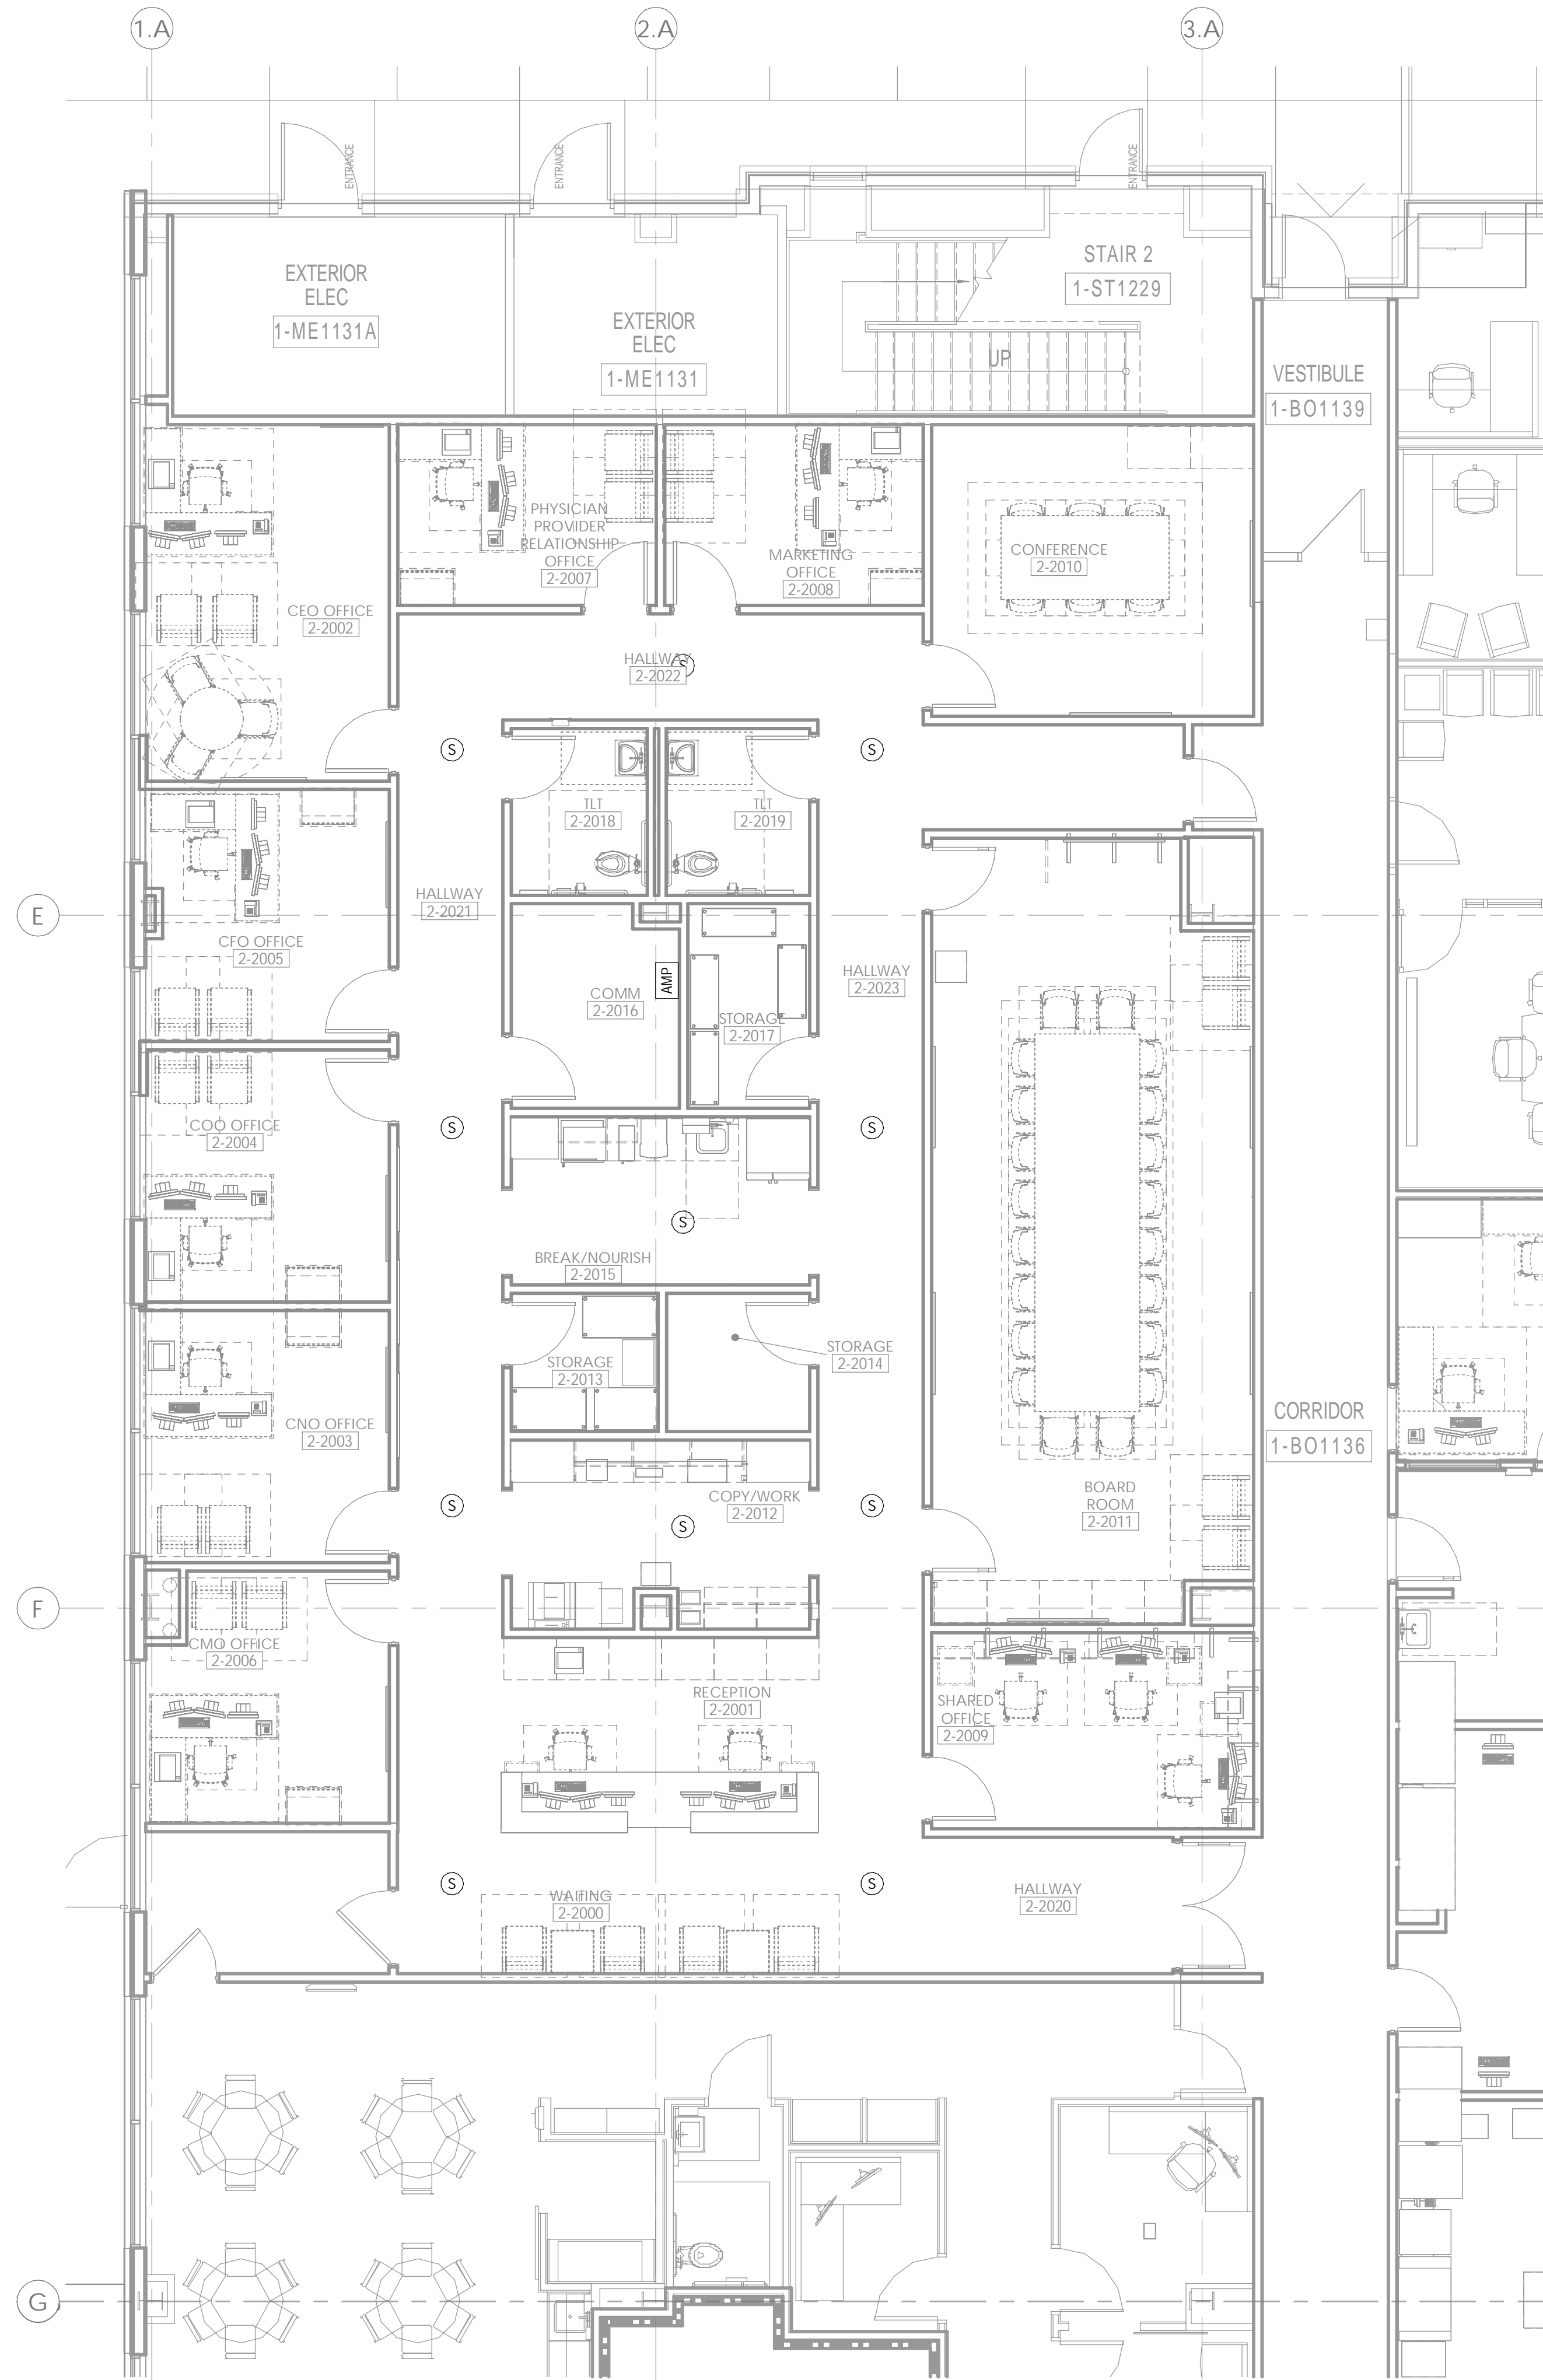

1 FLOOR PLAN - LEVEL 1 - ADMIN - LOW VOLTAGE
3/16" = 1'-0"

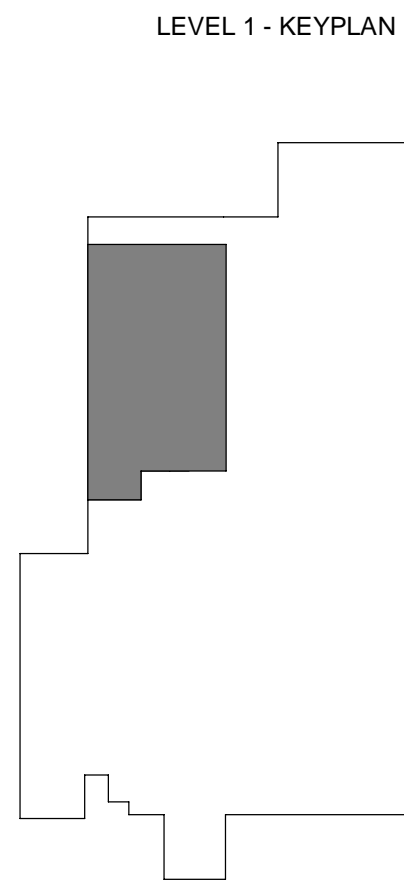


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- E. ALL CABLING SHALL BE SUPPORTED ABOVE ACCESSIBLE CEILING SPACE USING LOW-VOLTAGE SUPPORTS SIZED AT 40% FILL BASED ON CURRENT NEEDS.
- F. ALL OVERHEAD PAGING SPEAKERS SHOWN SHALL BE DAISY-CHAINED USING PUBLIC ADDRESS CALL CABLE TYPE "S".
- G. CONTRACTOR SHALL SIZE PAGING AMPLIFIER TO PROVIDE A 40% GROWTH RATE AT TIME OF INSTALLATION. OVERHEAD PAGING EQUIPMENT WILL BE HOUSED IN ONE IDF ROOM PER FLOOR AS NOTED PER ENLARGED FLOOR PLANS.
- H. CONTRACTOR SHALL LABEL BOTH ENDS OF NURSE CALL CABLE TO CLEARLY IDENTIFY WHAT ROOMSPACE & DEVICE EACH CABLE IS ASSOCIATED WITH.
- I. CONTRACTOR SHALL LEAVE A MINIMUM OF 18 INCHES OF SLACK AT ALL WALL MOUNTED NURSE CALL DEVICES, 15 FEET AT ALL CEILING MOUNTED NURSE CALL DEVICES, AND 25 FEET OF SLACK AT TE NURSE CALL HEADEND PANEL/NETWORK SWITCH LOCATION.



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ADMINISTRATION
RELOCATION

HCA - LEE'S SUMMIT MEDICAL
CENTER
2000 SE BLUE PKWY
LEE'S SUMMIT, MO 64063

AUTHORITY HAVING JURISDICTION:
CITY OF LEE'S SUMMIT BUILDING DEPT.
MISSOURI DHSS

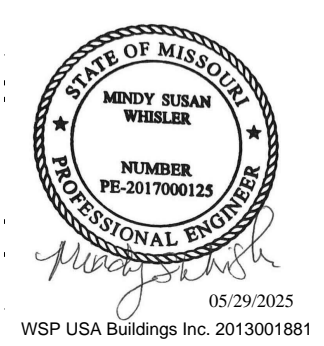FACILITY NUMBER:
0972400009

AGENCY APPROVALS:

REVISIONS		
REV #	DESCRIPTION	DATE
A	CITY - 2ND REVIEW	2025/05/29

DATE: 04/18/2025
SCALE: 3/16" = 1'-0"
DRAWN: FT
REVIEWED: MC
JOB NUMBER: 6406.24

FLOOR PLAN - LEVEL 1 -
ADMIN - LOW VOLTAGE

T03-01

Autodesk Docs/6406.24 - HCA - Lee's Summit Medical Center (SMC)_r123/MEP_LSMC Admin Relocation_023.rvt 6/4/2025 1:33:24 PM Notice of Alternate Billing or Payment Cycle: The Owner may plan to make payments on an alternative schedule. A written description of such billing or payment cycle applicable to the Project is available from the Owner or the Owner's designated agent upon request.



WSP

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ELIMINATED AND ARE NOT TO BE USED FOR CONSTRUCTION
OF ANY PLANS ARE COPYRIGHTED AND ARE SUBJECT TO COPYRIGHT
IN "ARCHITECTURAL WORK" UNDER SEC. 102 OF THE COPYRIGHT
ACT AMENDED DECEMBER 1990 AND KNOWN AS ARCHITECTURAL
PROTECTION ACT OF 1990. THE PROTECTION INCLUDES BUT
THE OVERALL FORM AS WELL AS THE ARRANGEMENT AND
SPACES AND ELEMENTS OF THE DESIGN. UNDER SUCH
AUTHORIZED USE OF THESE PLANS CAN LEGALLY RESULT IN
THE CONSTRUCTION OR BUILDINGS BEING SEIZED AND/OR MONETARY
TO DEVNEY GROUP LTD.

2000 SE BLUE PKWY
LEE'S SUMMIT, MO 640

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MISSOURI DHSS

FACILITY NUMBER:
0972400009


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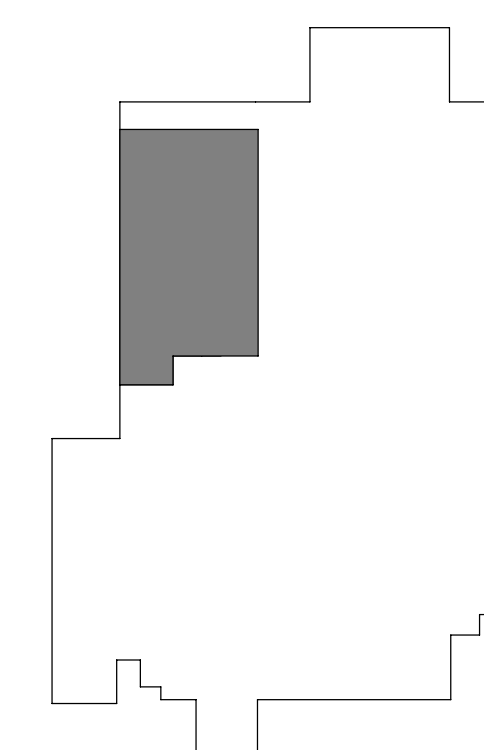
FLOOR PLAN - LEVEL 1
ADMIN - SECURITY


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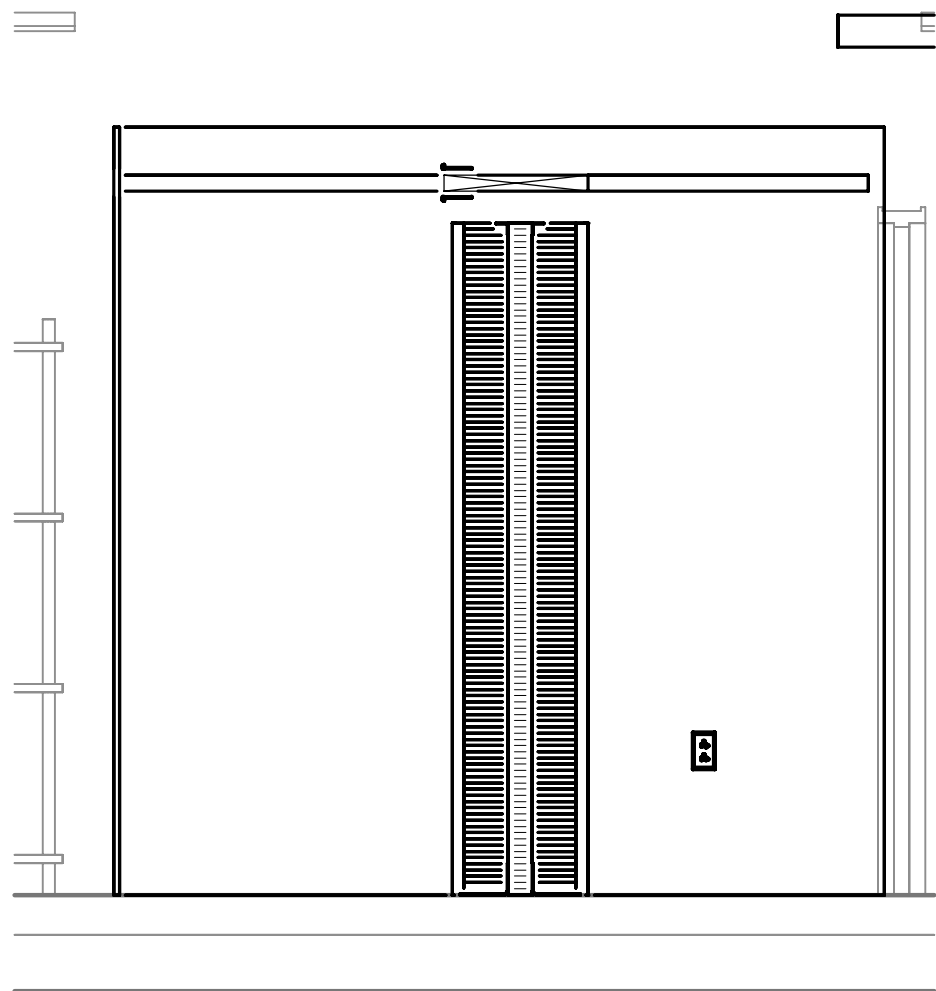
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3/16" = 1'-0"

LEVEL 1 - KEYPLAN




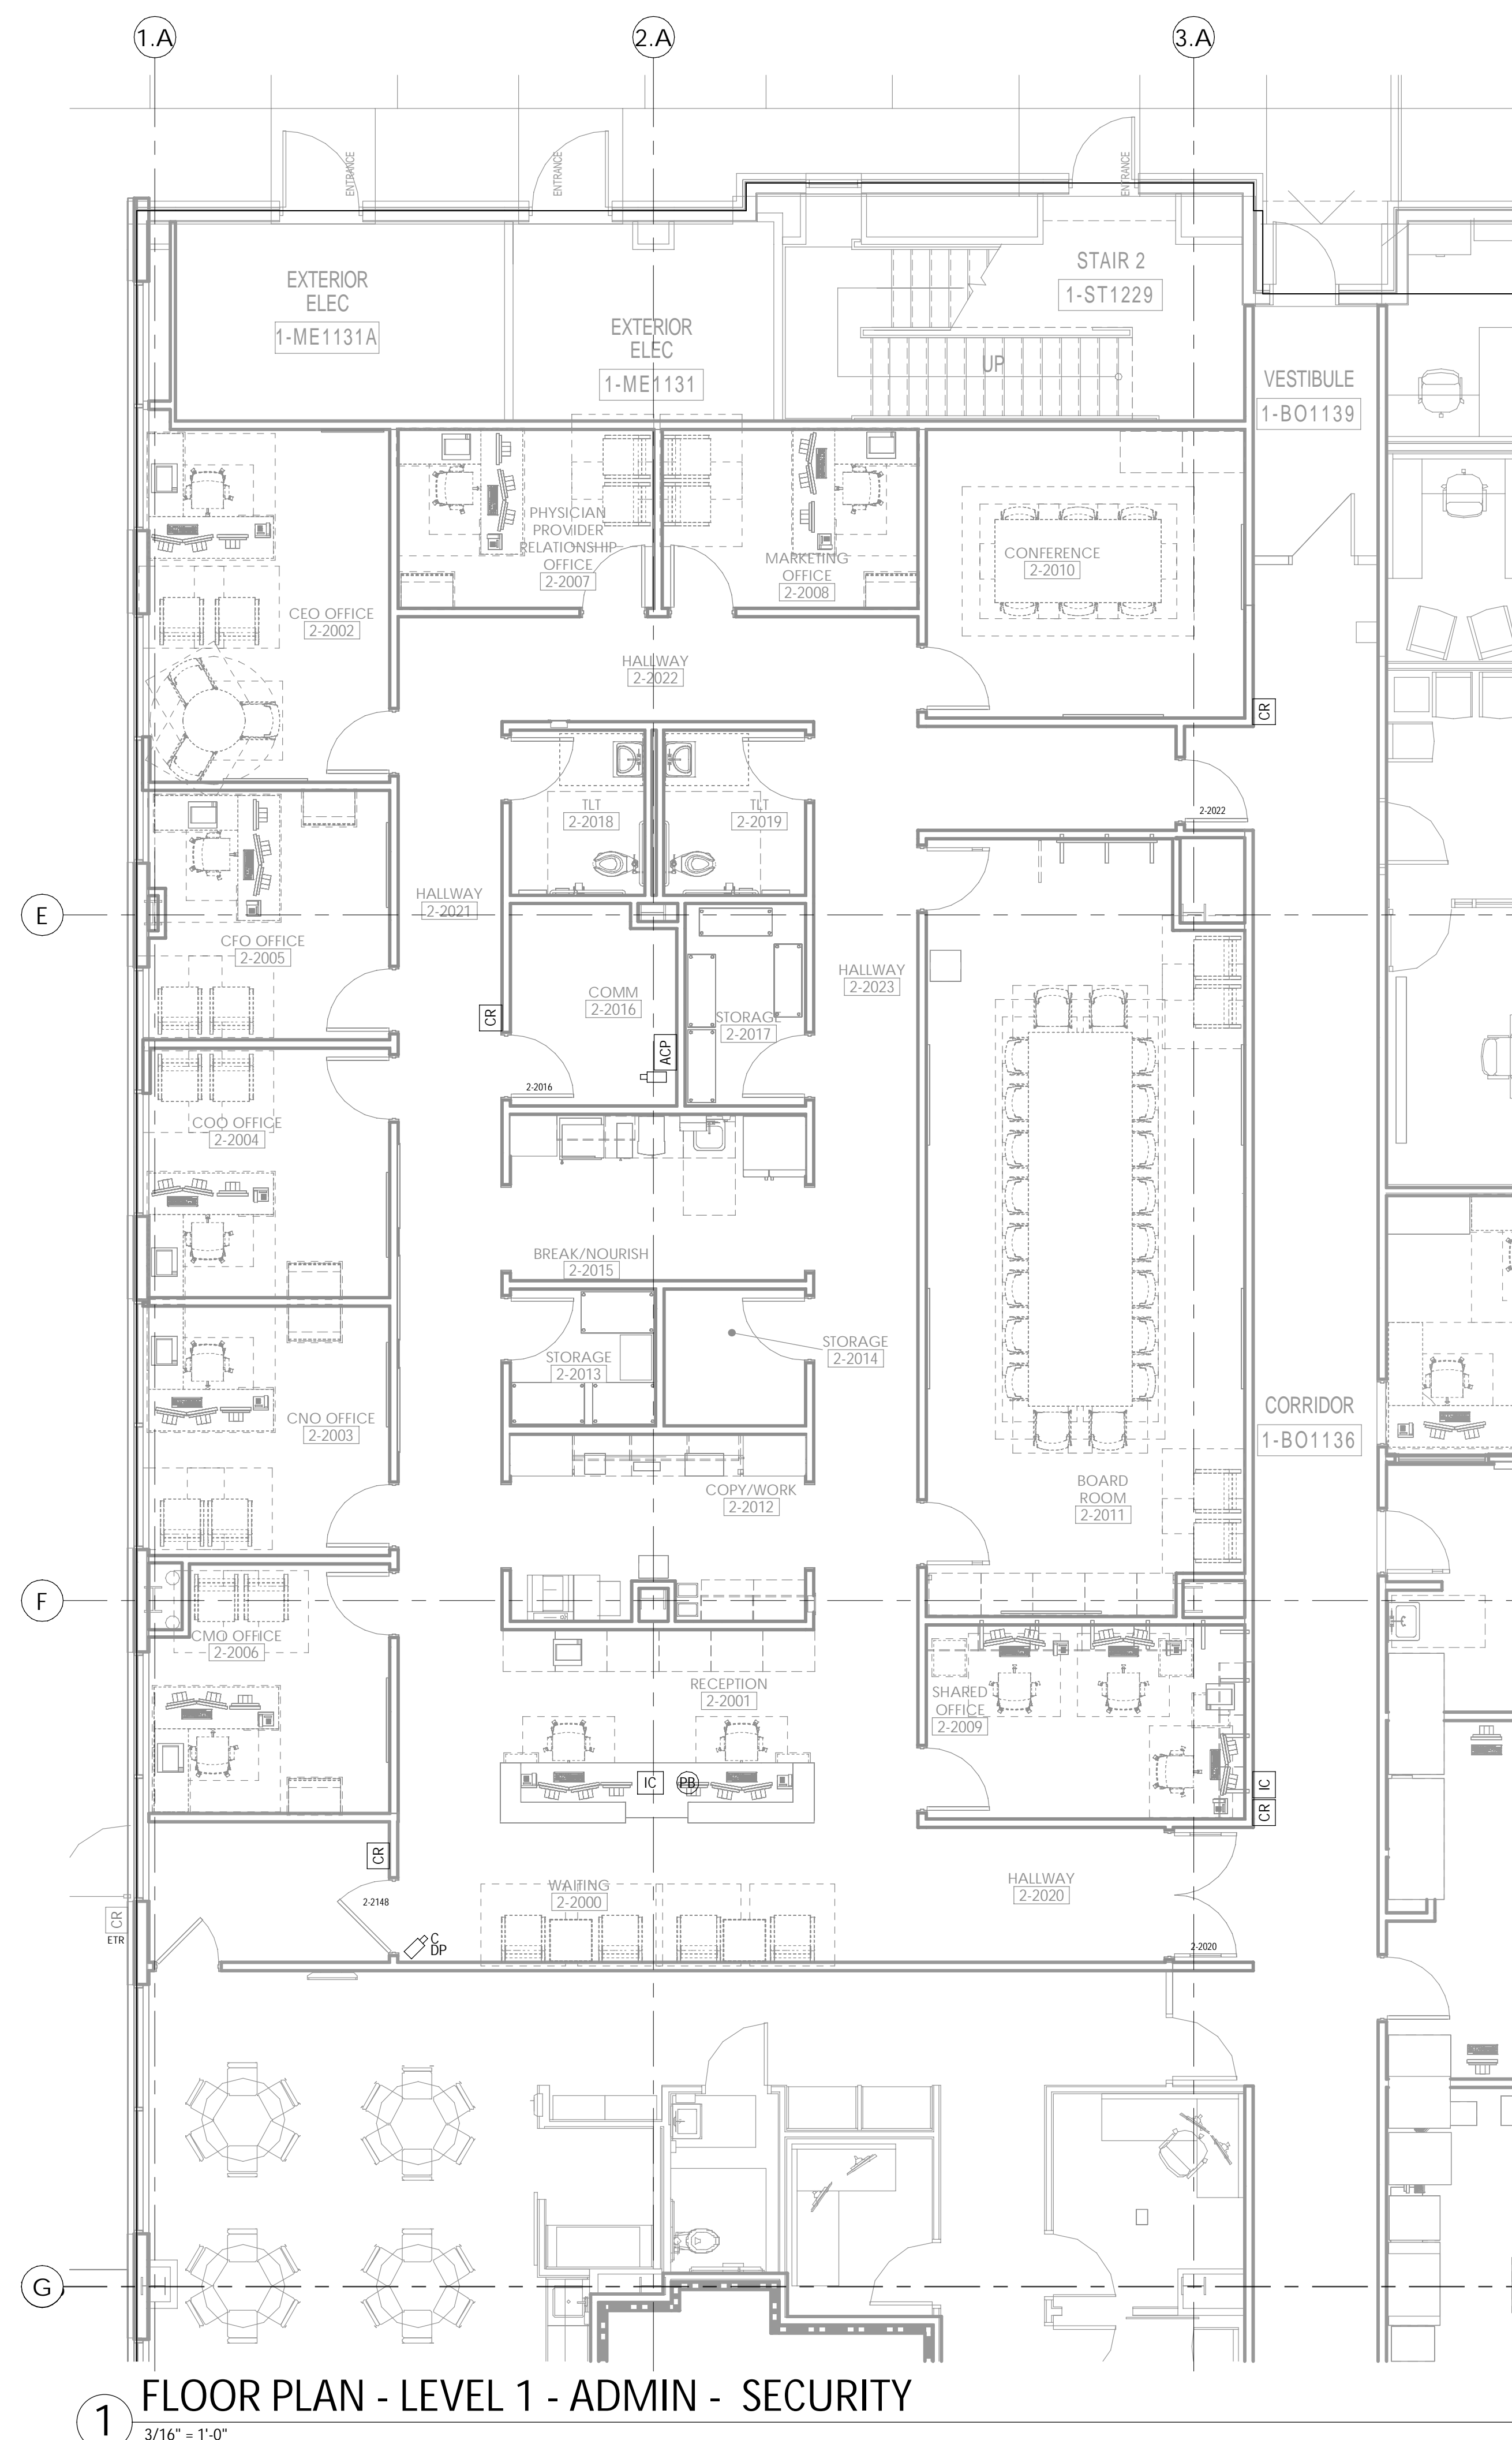


6 COMM 2-2016 - ELEVATION 10
1/2" = 1'-0"

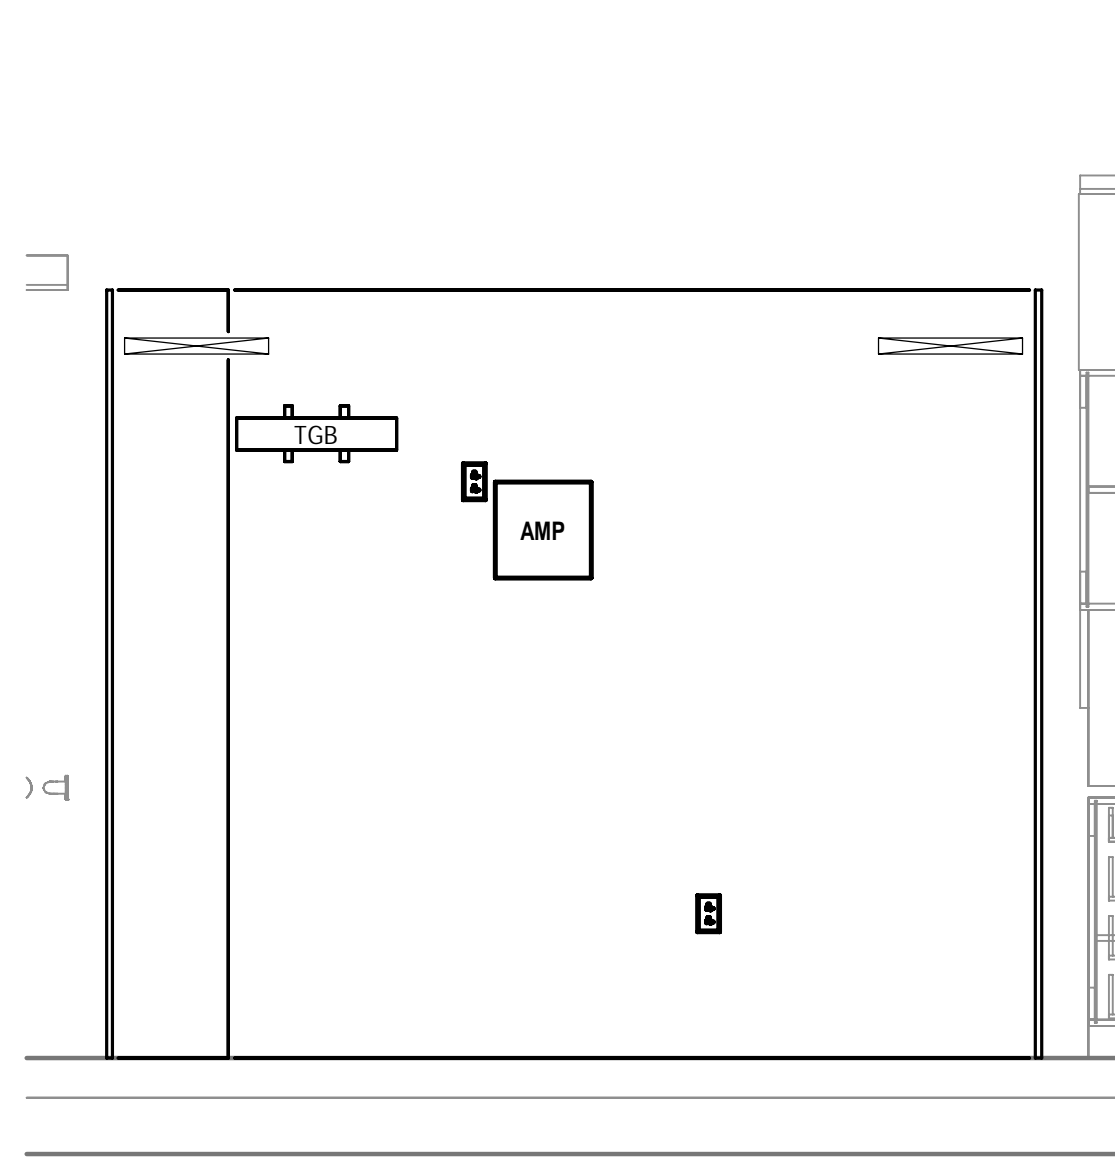


5 COMM 2-2016 - ELEVATION 9
1/2" = 1'-0"

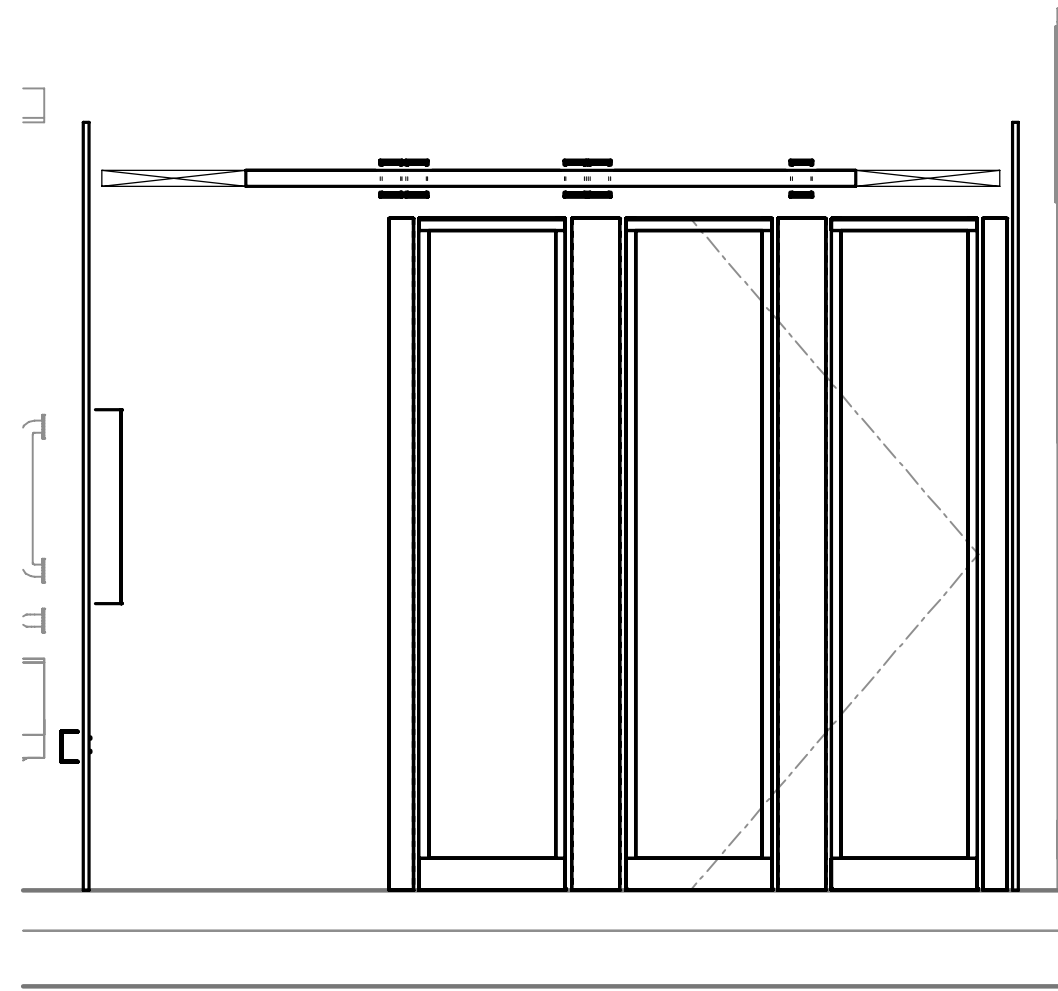


4 COMM 2-2016 - ELEVATION 8
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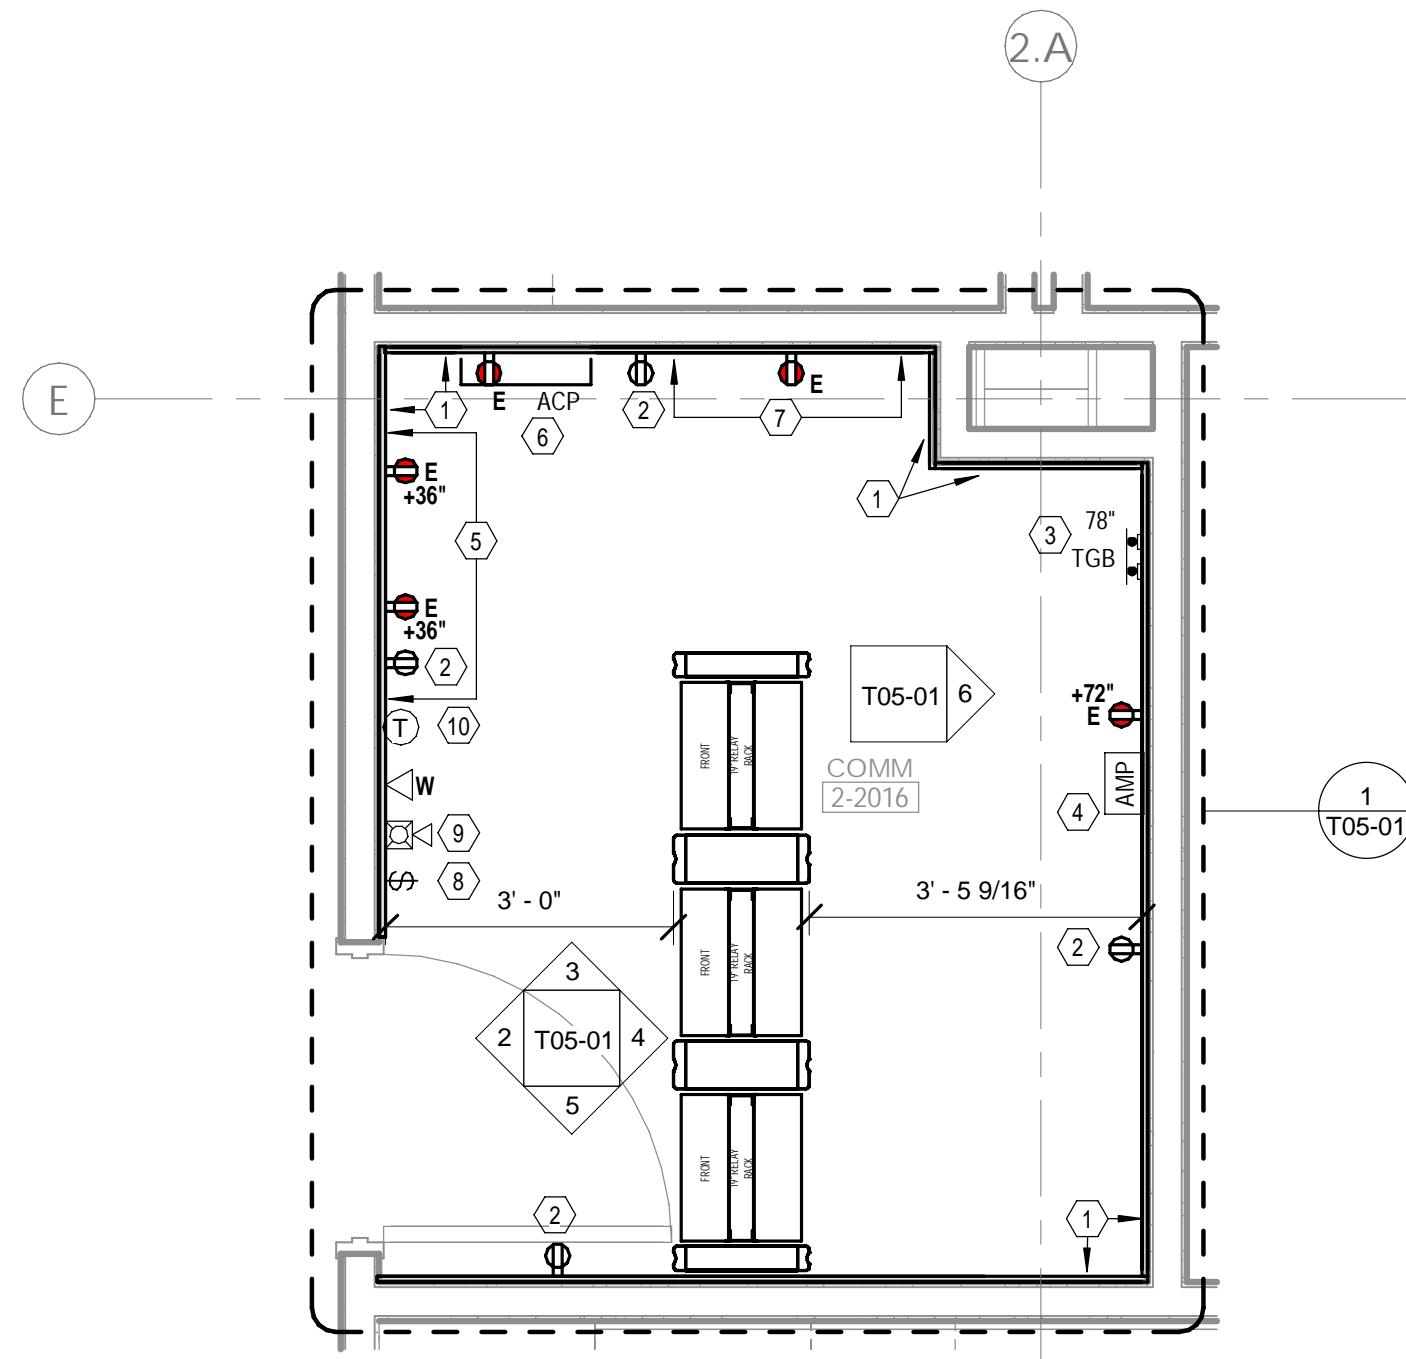
3 COMM 2-2016 - ELEVATION 7
1/2" = 1'-0"

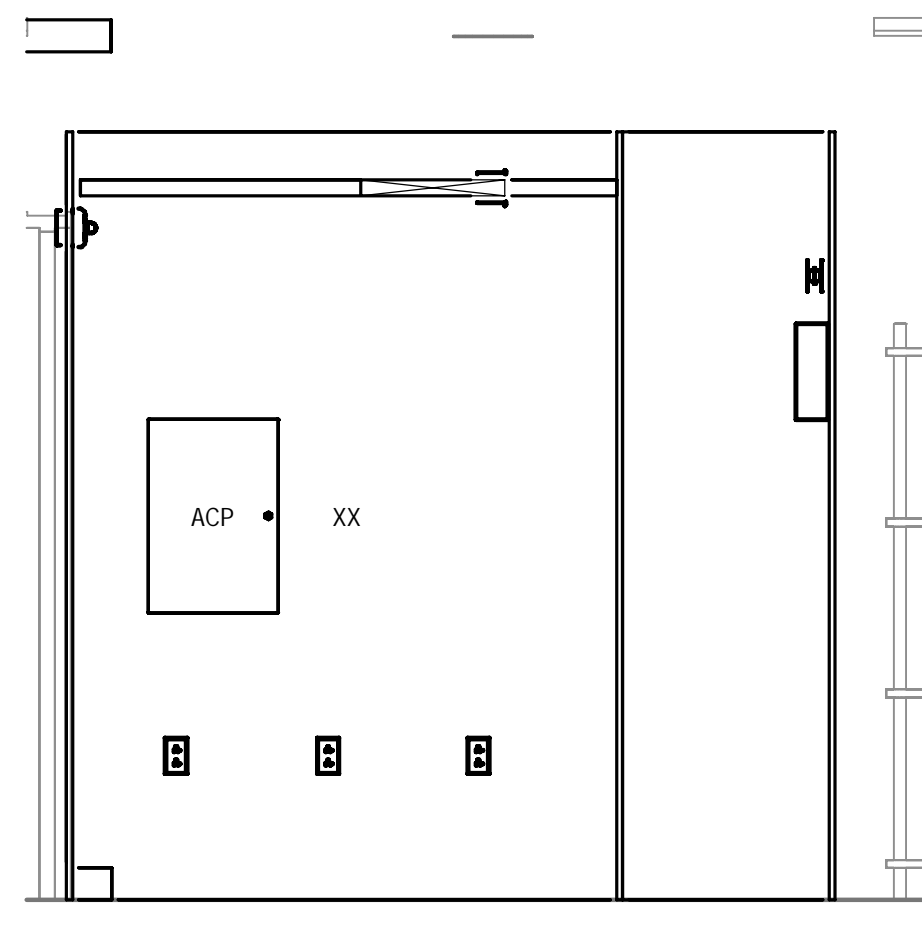

2 COMM 2-2016 - ELEVATION 6
1/2" = 1'-0"

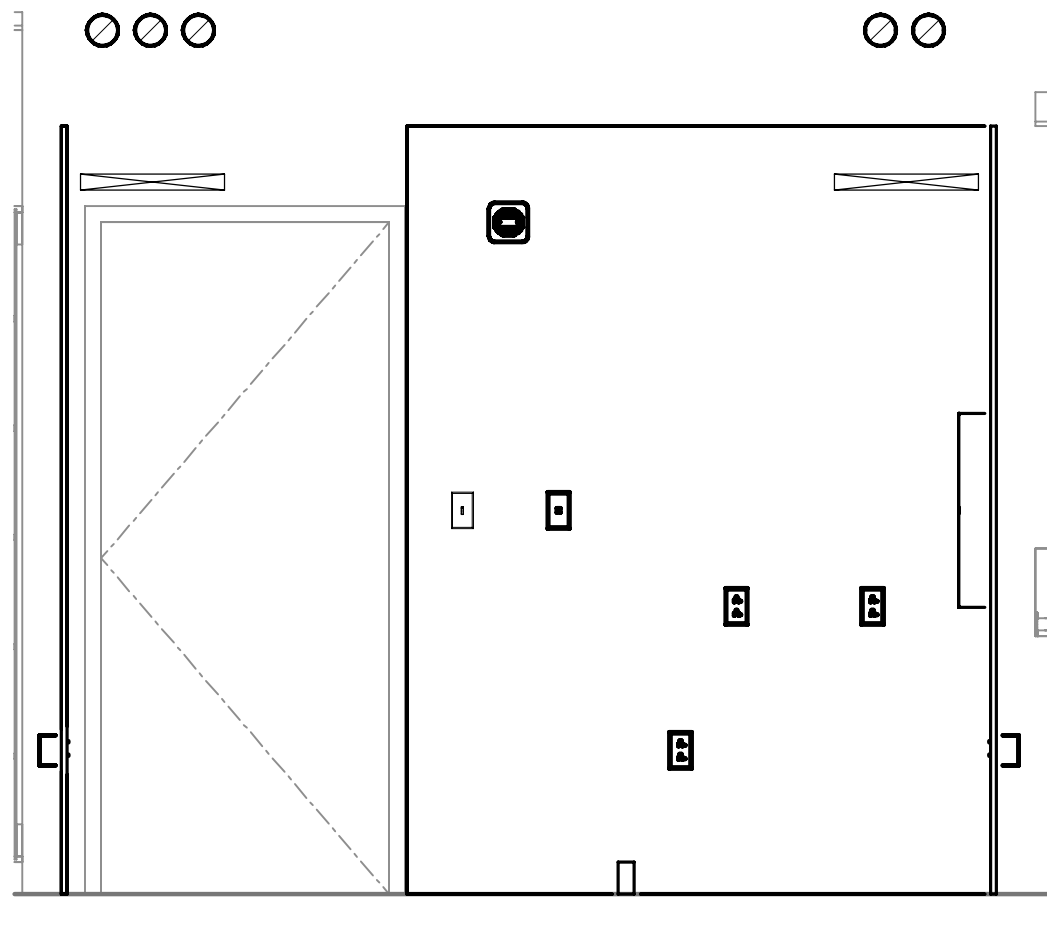

1 ENLARGED - COMM 2-2016 - UPPER
1/2" = 1'-0"

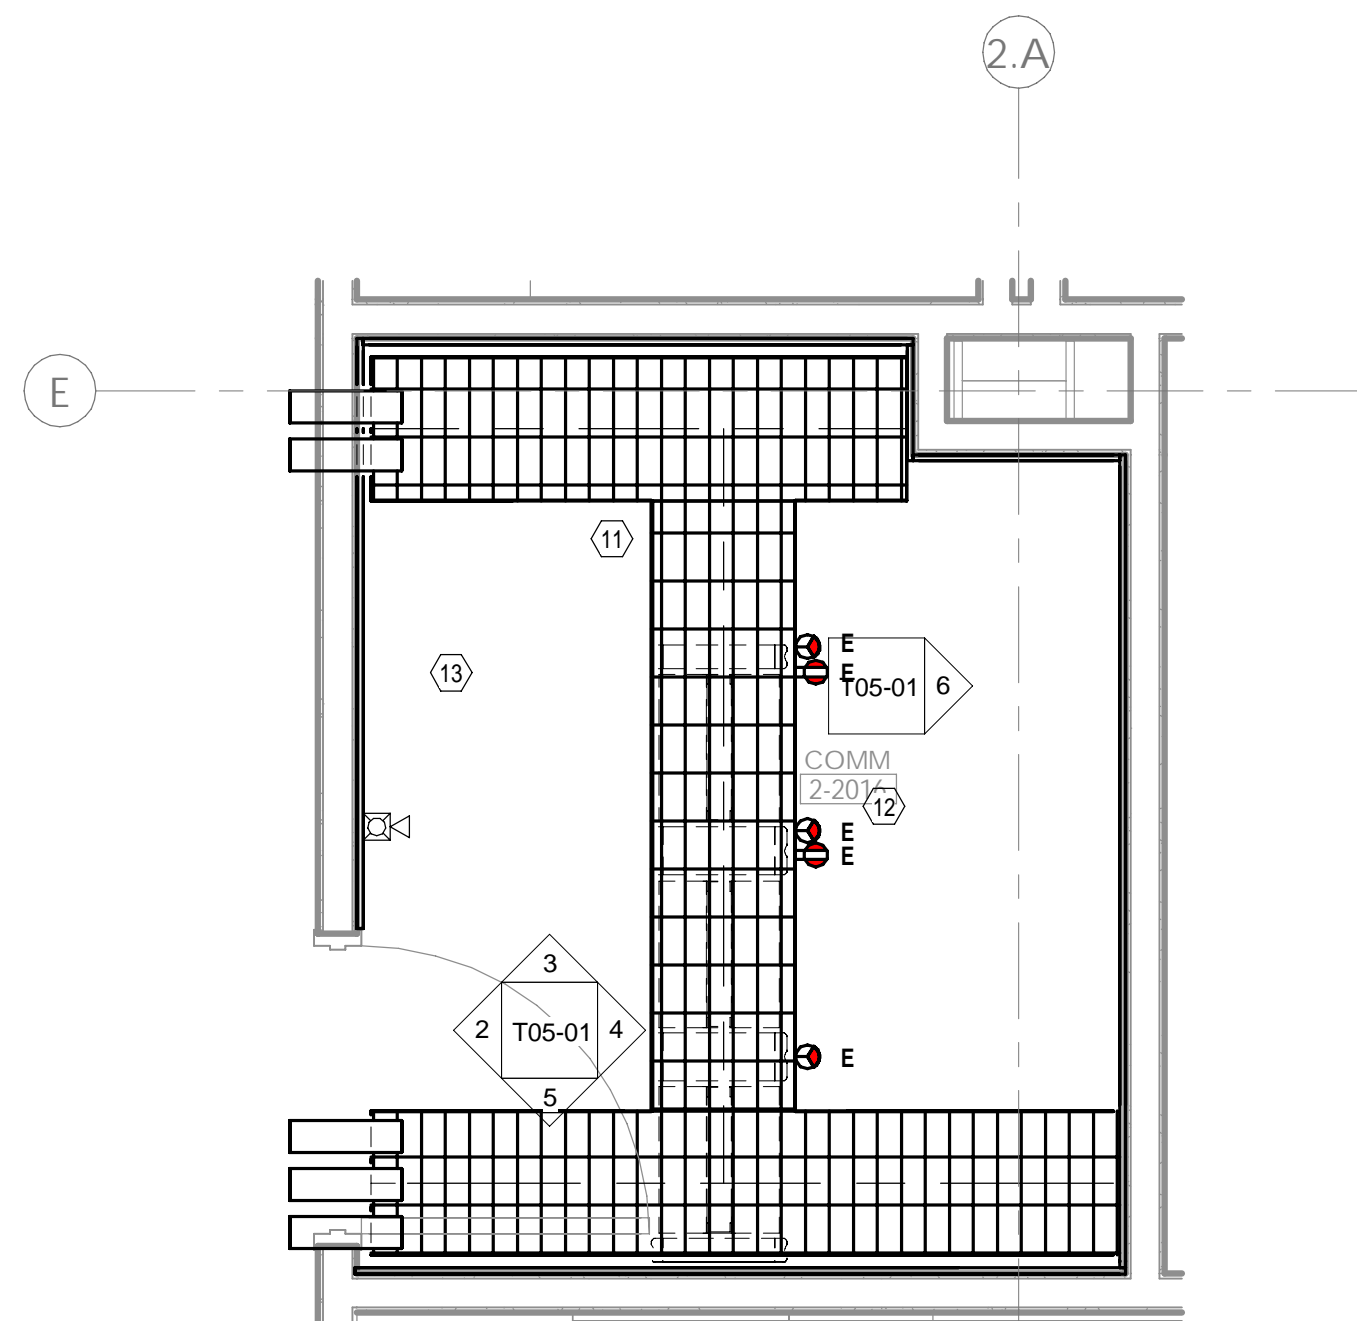

8 ENLARGED - COMM 2-2016
1/2" = 1'-0"

LEGEND NOTES:

1. PROVIDE 3/4" A/C GRADE FIRE RETARDANT PLYWOOD WITH TWO COATS OF PAINT (MATCH WALL COLOR) FROM FINISHED FLOOR TO 8' AFF ON THIS ENTIRE WALL AS SHOWN. MANUFACTURER FIRE RATING STAMP SHALL BE LEFT UNCOVERED ON 'A' SIDE FOR INSPECTION ON EACH SHEET OF PLYWOOD WITHIN IDF/COMM ROOM.
2. ELECTRICAL OUTLET ON NORMAL POWER FOR CONVENIENCE RECEPTACLE. OUTLET SHOWN FOR COORDINATION PURPOSES ONLY. OUTLET SHALL BE MOUNTED 18" AFF.
3. LOCATION OF TELECOMMUNICATIONS GROUNDING BUS BAR (TGB). ELECTRICAL CONTRACTOR SHALL PROVIDE A TELECOMMUNICATIONS GROUND BACKBONE FROM BUILDING GROUND. ALL BONDING WITHIN THIS ROOM SHALL BE DEDICATED HOME-RUN CONNECTIONS FROM INDIVIDUAL EQUIPMENT/HARDWARE TO THE TGB. NO DAISY-CHAINING OF GROUND SHALL BE PERMITTED OTHER THAN BASKET TRAY. BUS BAR SHALL BE MOUNTED AT 78" AFF.
4. LOCATION OF OVERHEAD PAGING AMPLIFIER SYSTEM EQUIPMENT. ELECTRICAL CONTRACTOR SHALL PROVIDE DUPLEX POWER OUTLET ON EMERGENCY POWER MOUNTED AT 72" AFF.
5. LOCATION OF CATV TELEVISION JUNCTION EQUIPMENT. CONTRACTOR SHALL ACCOUNT FOR APPROXIMATELY 4'x4' OF WALL SPACE FOR CABLE TERMINATIONS AND EQUIPMENT TO BE PLACED IN THIS LOCATION BY TELEVISION SYSTEM VENDOR. ELECTRICAL CONTRACTOR SHALL PROVIDE (2) DUPLEX POWER OUTLETS, ON NORMAL POWER, MOUNTED AT 36" AFF AT THIS LOCATION. COORDINATE WITH TELEVISION SYSTEM VENDOR FOR ADDITIONAL REQUIREMENTS WITHIN THIS AREA.
6. LOCATION OF SECURITY ACCESS CONTROL PANEL(S). ELECTRICAL CONTRACTOR SHALL PROVIDE A MINIMUM OF (1) DUPLEX RECEPTACLE, ON EMERGENCY POWER, FOR EACH PANEL. COORDINATE EXACT PLACEMENT OF RECEPTACLES WITH THE DIVISION 28 ACCESS CONTROL INSTALLATION CONTRACTOR PRIOR TO ROUGH IN. DIVISION 27 CONTRACTOR SHALL COORDINATE NETWORK CONNECTION REQUIREMENTS WITH THE ACCESS CONTROL INSTALLATION CONTRACTOR.
7. AREA DESIGNATED FOR OFD DISTRIBUTED ANTENNA SYSTEM (DAS) EQUIPMENT. ELECTRICAL CONTRACTOR SHALL PROVIDE DUPLEX POWER OUTLET ON EMERGENCY POWER MOUNTED AT 18" AFF.
8. LIGHT SWITCH SHOWN FOR COORDINATION PURPOSES ONLY.
9. FIRE ALARM STROBE SHOWN FOR COORDINATION PURPOSES ONLY.
10. THERMOSTAT DEVICE SHOWN FOR COORDINATION PURPOSES ONLY. DEVICE SHALL BE MOUNTED ON "COLD" SIDE OF EQUIPMENT CABINET/TRACTS AS SHOWN.
11. PROVIDE 18"x2" WIRE MESH BASKET TRAY AS SHOWN. MOUNT BASKET TRAY AT 7' 6" ABOVE FINISHED FLOOR AND CONNECT BASKET TRAY TO EQUIPMENT RACKS UTILIZING MANUFACTURER'S ELEVATION KITS. CONTRACTOR SHALL UTILIZE MANUFACTURER'S "WATERFALL" DEVICES FOR TRANSITIONING OF CABLES FROM BASKET TRAY TO WITHIN VERTICAL WIRE MANAGERS.
12. ELECTRICAL OUTLETS, ON EMERGENCY POWER, MOUNTED TO SIDE OF BASKET TRAY. CENTER OUTLETS OVER VERTICAL WIRE MANAGEMENT BETWEEN EQUIPMENT RACKS AS SHOWN.
13. CONTRACTOR SHALL PROVIDE 4" PRE-MANUFACTURED FIRE SLEEVE DEVICES THROUGH RATED WALL FOR CABLEING PATHWAY.

GENERAL NOTES:

- A. ALL METAL SURFACES WITHIN IDF ROOMS SHALL BE BONDED TO GROUND BUS BAR AS PER J-STD-607 STANDARDS.
- B. ELECTRICAL, FIRE, SAFETY AND MECHANICAL DEVICES ARE SHOWN FOR LOCATING PURPOSES ONLY. REFER TO ELECTRICAL AND MECHANICAL SHEETS FOR ADDITIONAL DETAILS.
- C. NO SPRINKLER HEADS OR PIPING SHALL BE INSTALLED DIRECTLY ABOVE ANY ELECTRONIC EQUIPMENT RACKS IN THE IDF/COMM ROOMS. CAGES SHALL BE INSTALLED ON SPRINKLER HEADS TO PREVENT ACCIDENTAL DISCHARGE. NO MAIN SPRINKLER PIPING SHALL ENTER THE IDF/COMM SPACE. ONLY BRANCHES OF THE PIPING SYSTEM SPECIFICALLY SERVICING THE IDF ROOMS SHALL BE PERMITTED TO PENETRATE IDF/COMM ROOMS.
- D. PENETRATION INTO CORRIDORS SHALL BE POSITIONED 6' ABOVE THE ASSOCIATED CORRIDOR CABLE TRAY.
- E. SYSTEMS THAT ARE NOT DIRECTLY RELATED TO THE SUPPORTING IDF/COMM ROOMS ARE NOT PERMITTED TO PASS THROUGH IDF/COMM ROOMS.
- F. AIR TEMPERATURE WITHIN ROOM SHALL BE MAINTAINED BETWEEN 65 AND 76 DEGREES FAHRENHEIT, MEASURED AT THE THERMOSTAT LOCATION.
- G. HUMIDITY MUST REMAIN WITHIN RANGE OF 50% TO 60%.
- H. SYSTEM VENDOR SHALL COORDINATE EXACT LOCATION OF EQUIPMENT WITHIN IDF/COMM ROOMS WITH OWNERS REPRESENTATIVE(S) PRIOR TO INSTALLATION. NO WORK SHALL PROCEED PRIOR TO OWNER APPROVAL.
- I. DATA DEVICE SCHEDULE SHOWN FOR OWNER USE ONLY. CONTRACTOR SHALL PERFORM THEIR OWN CALCULATIONS FOR BID.




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Consultant:



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HCA - LEE'S SUMMIT MEDICAL
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2000 SE BLUE PKWY
LEE'S SUMMIT, MO 64063

AUTHORITY HAVING JURISDICTION:
CITY OF LEE'S SUMMIT BUILDING DEPT.
MISSOURI DHSS

FACILITY NUMBER:
0972400009
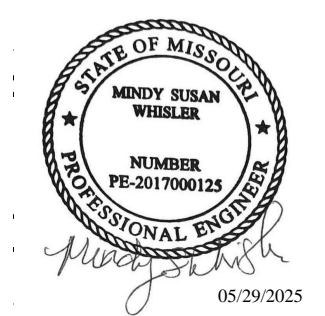
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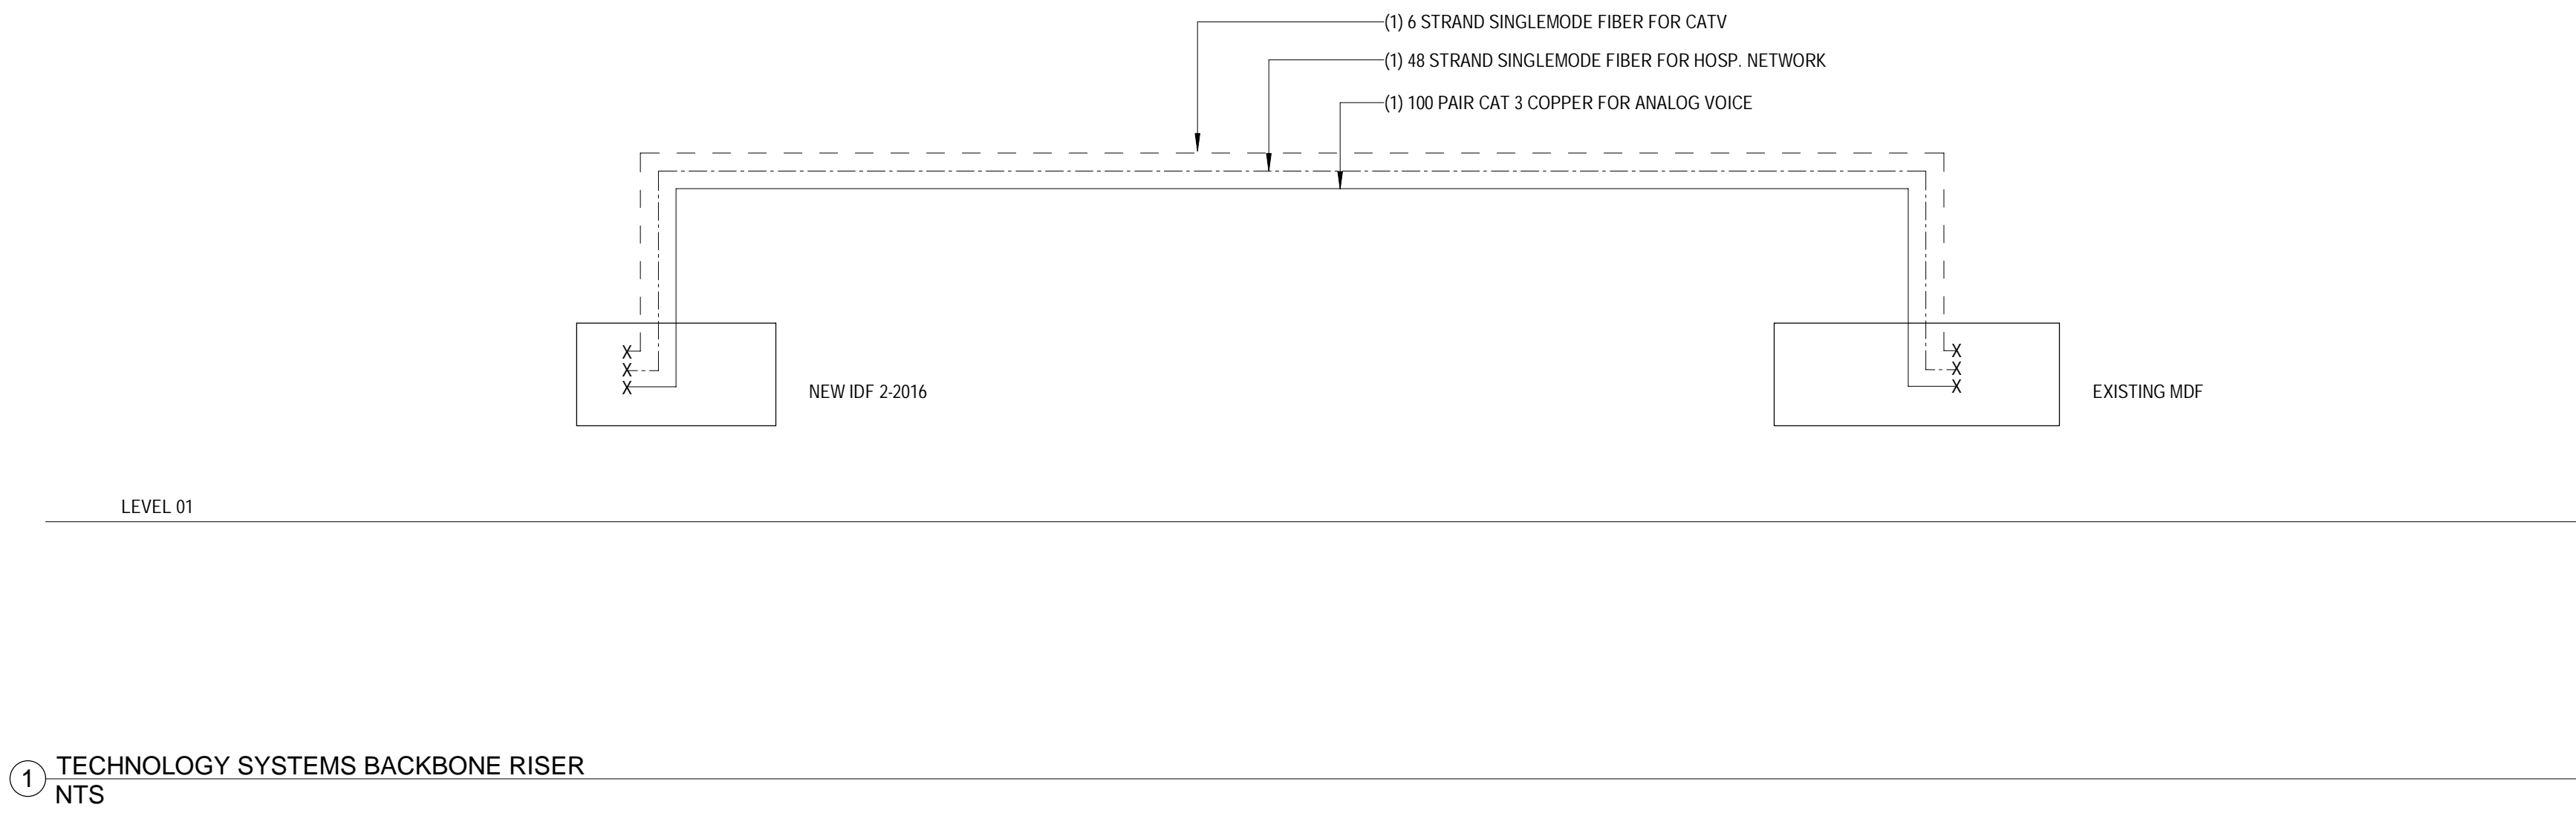
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DATE: 04/18/2025
SCALE: 1/2" = 1'-0"
DRAWN: FT
REVIEWED: MC
JOB NUMBER: 6406.24

ENLARGED PLAN - TECHNOLOGY


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Autodesk Docx/16406.24 - HCA - Lee's Summit Medical Center (SMC)_T05-01 Admin Relocation.dwg 6/4/2025 1:33:29 PM 6/4/2025 1:33:29 PM A written description of such billing or payment cycle applicable to the Project is available from the Owner or the Owner's designated agent upon request. Notice of Alternate Billing or Payment Cycle: The Owner may plan to make payments on an alternative schedule. A written description of such billing or payment cycle applicable to the Project is available from the Owner or the Owner's designated agent upon request.



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FACILITY NUMBER:
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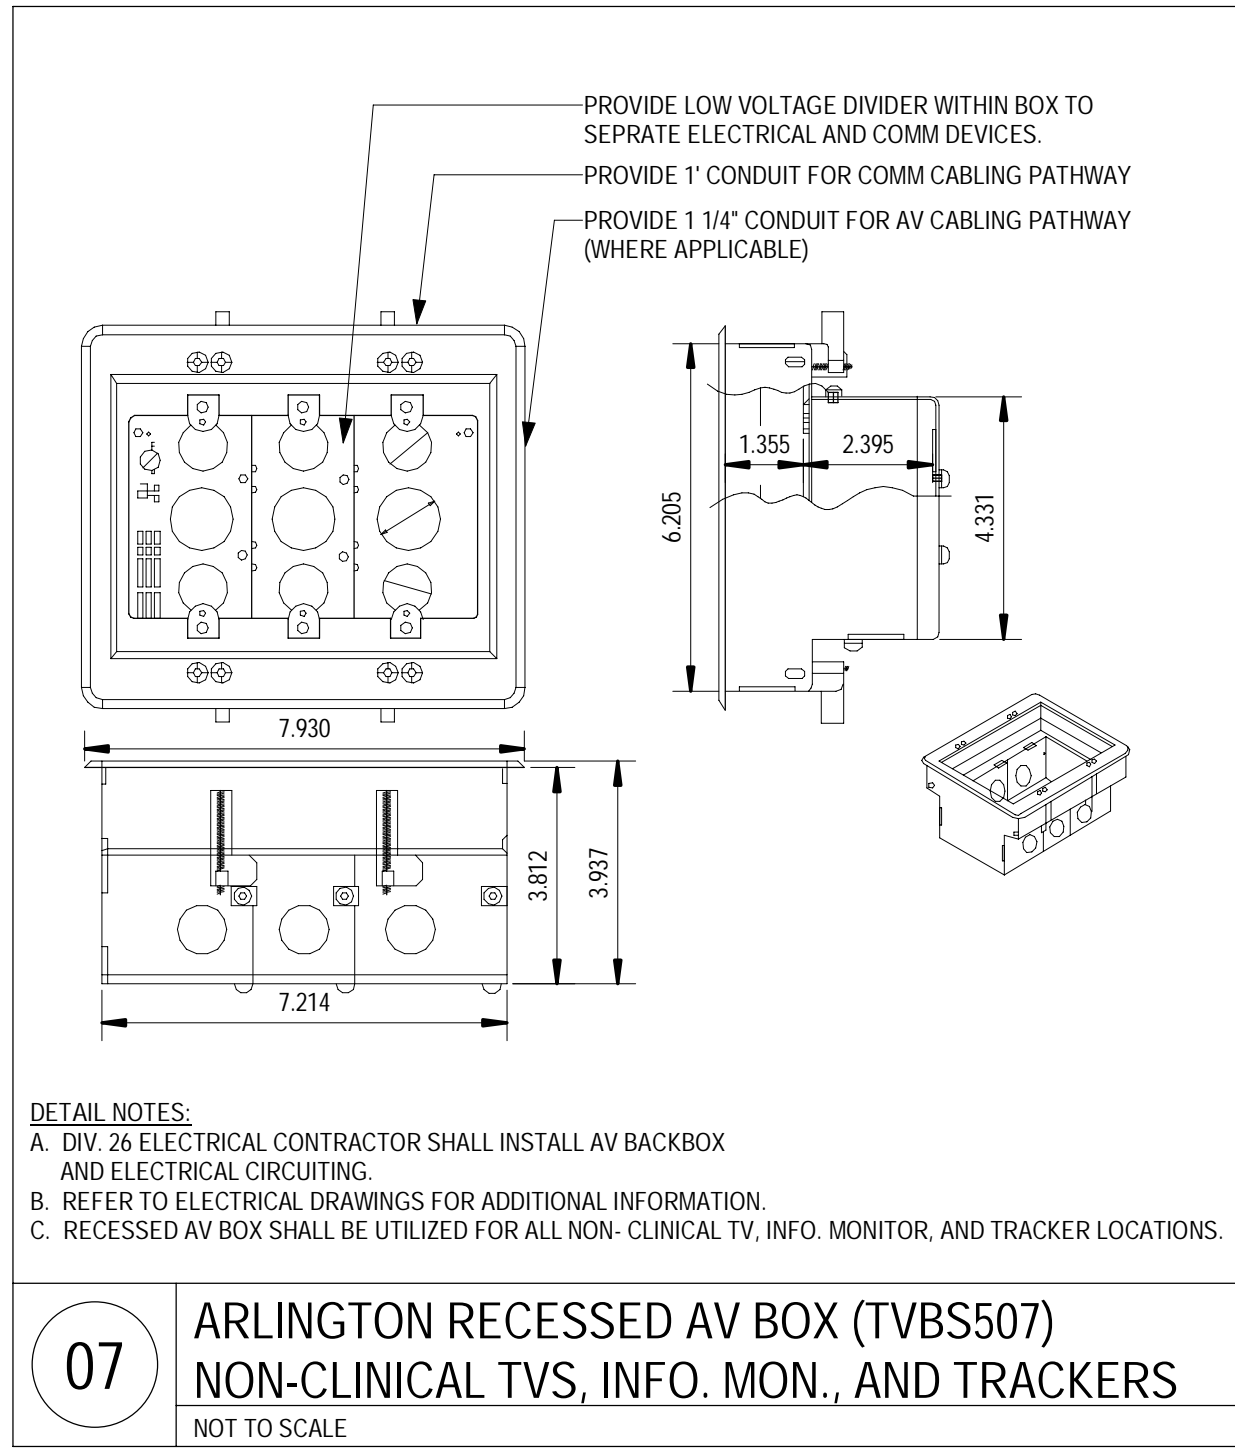
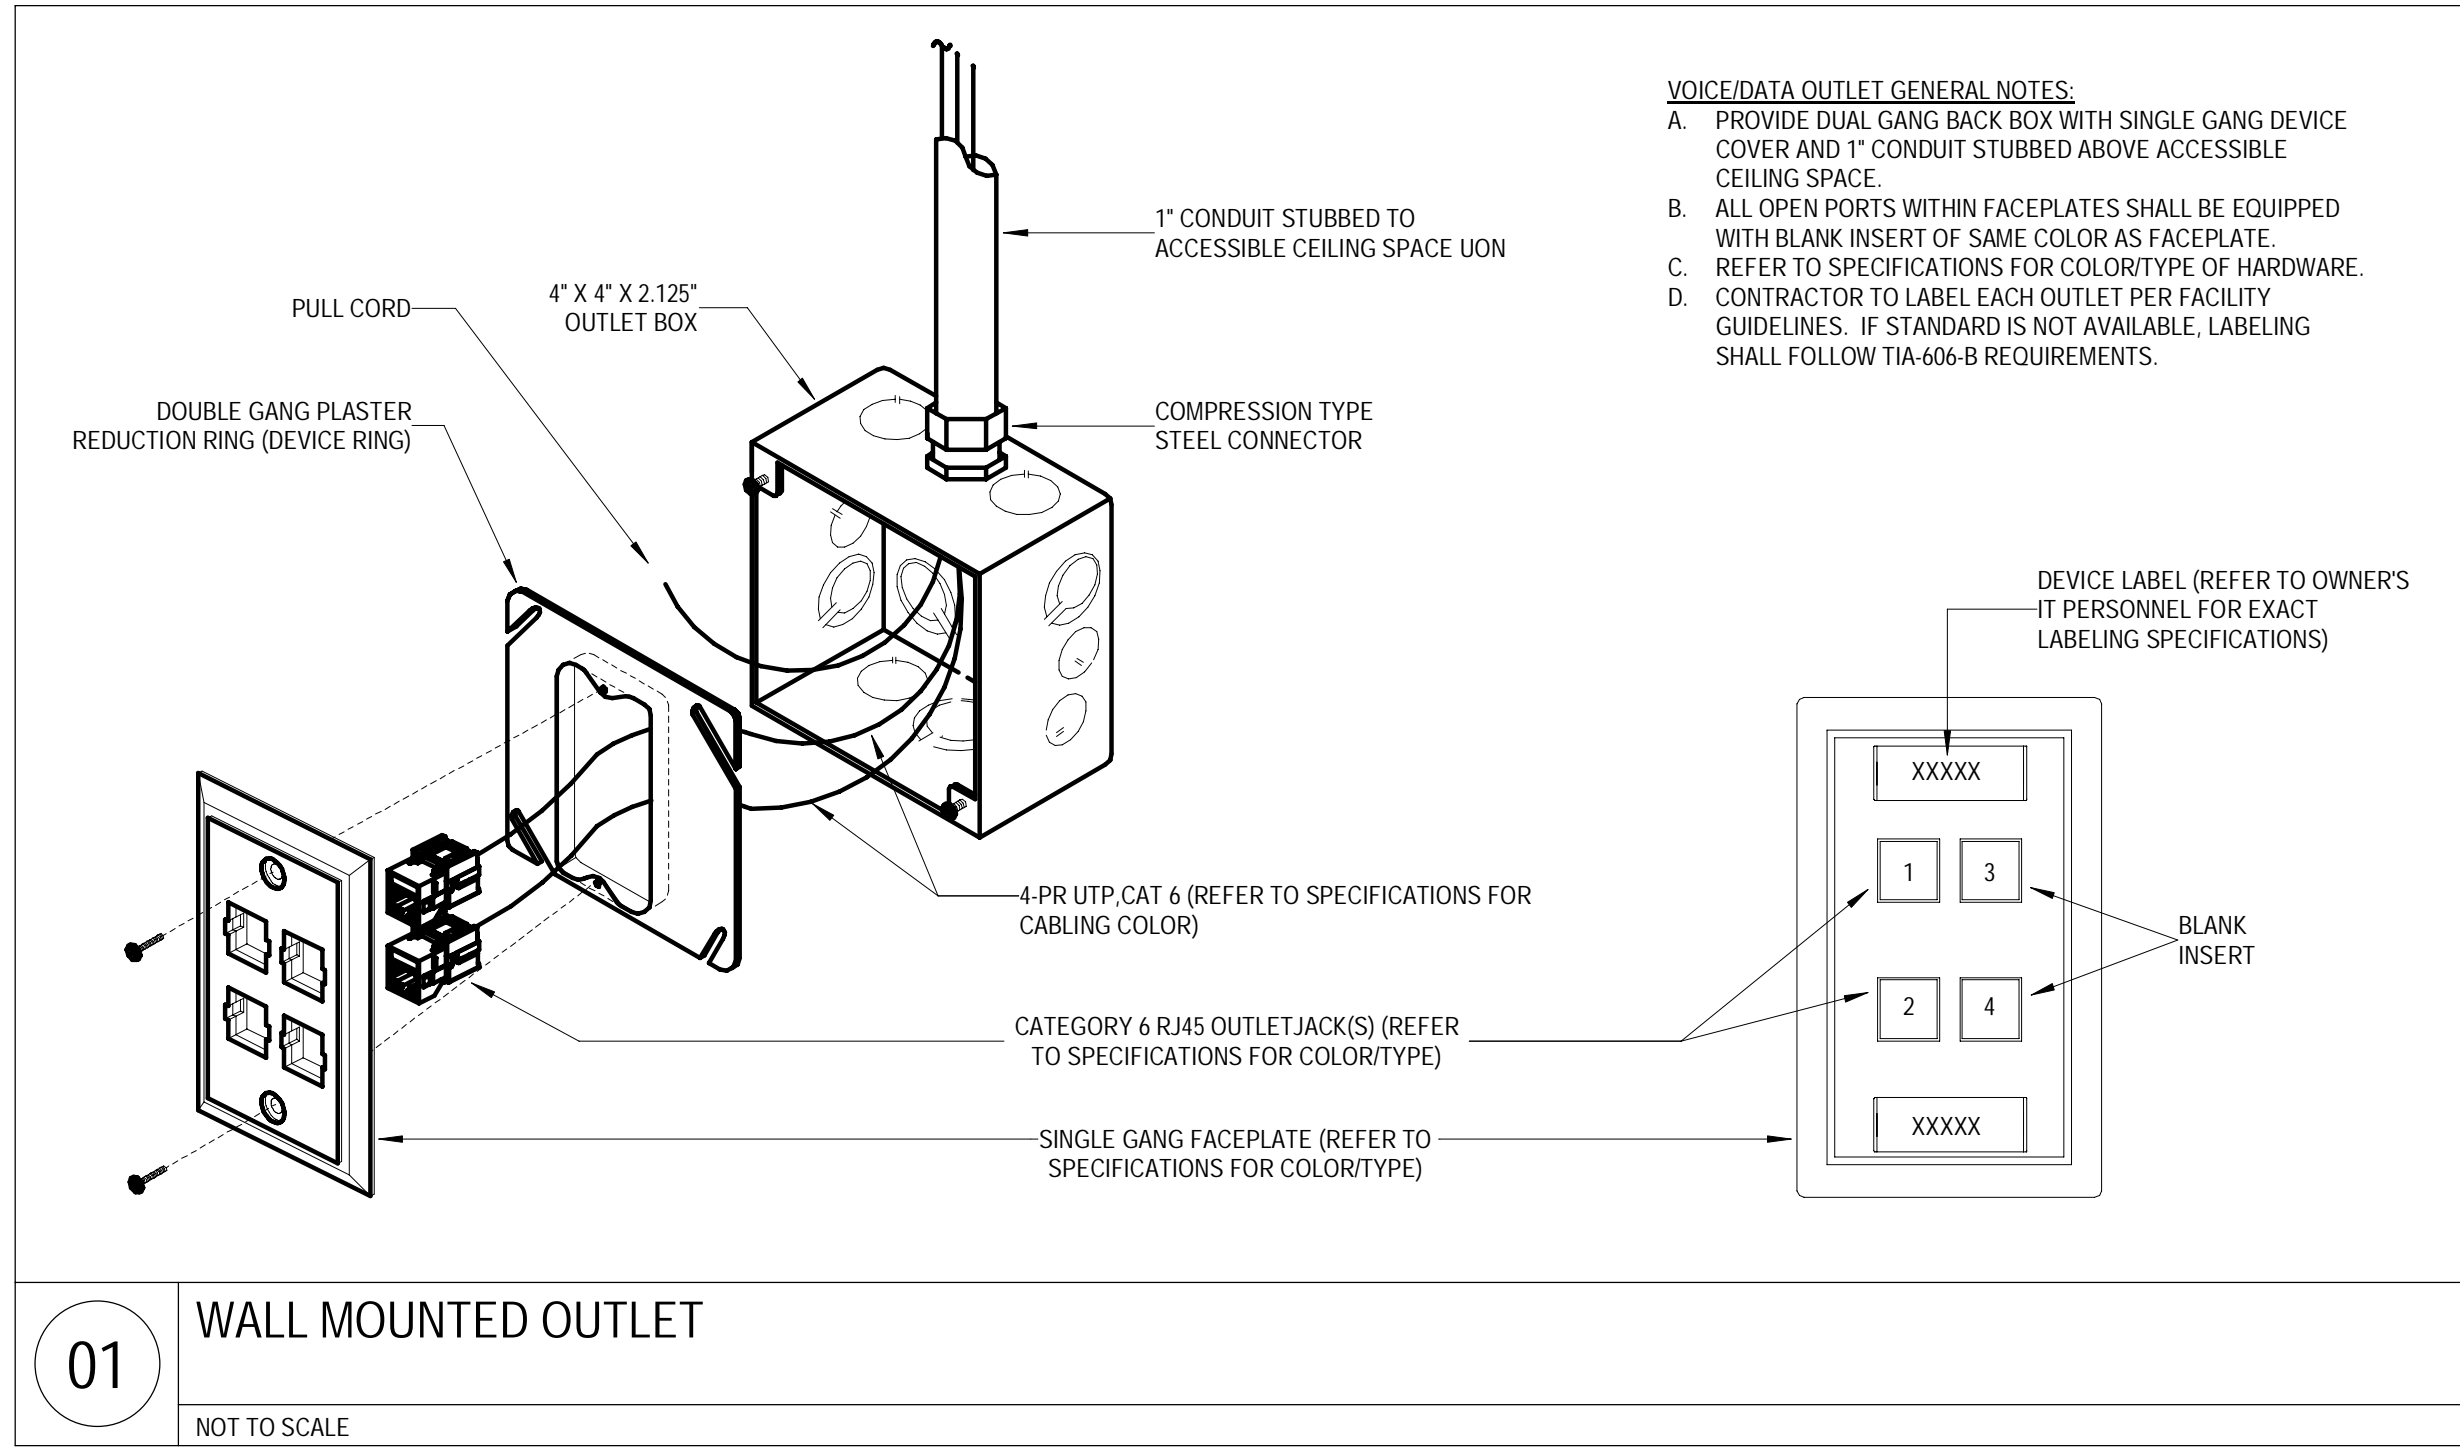
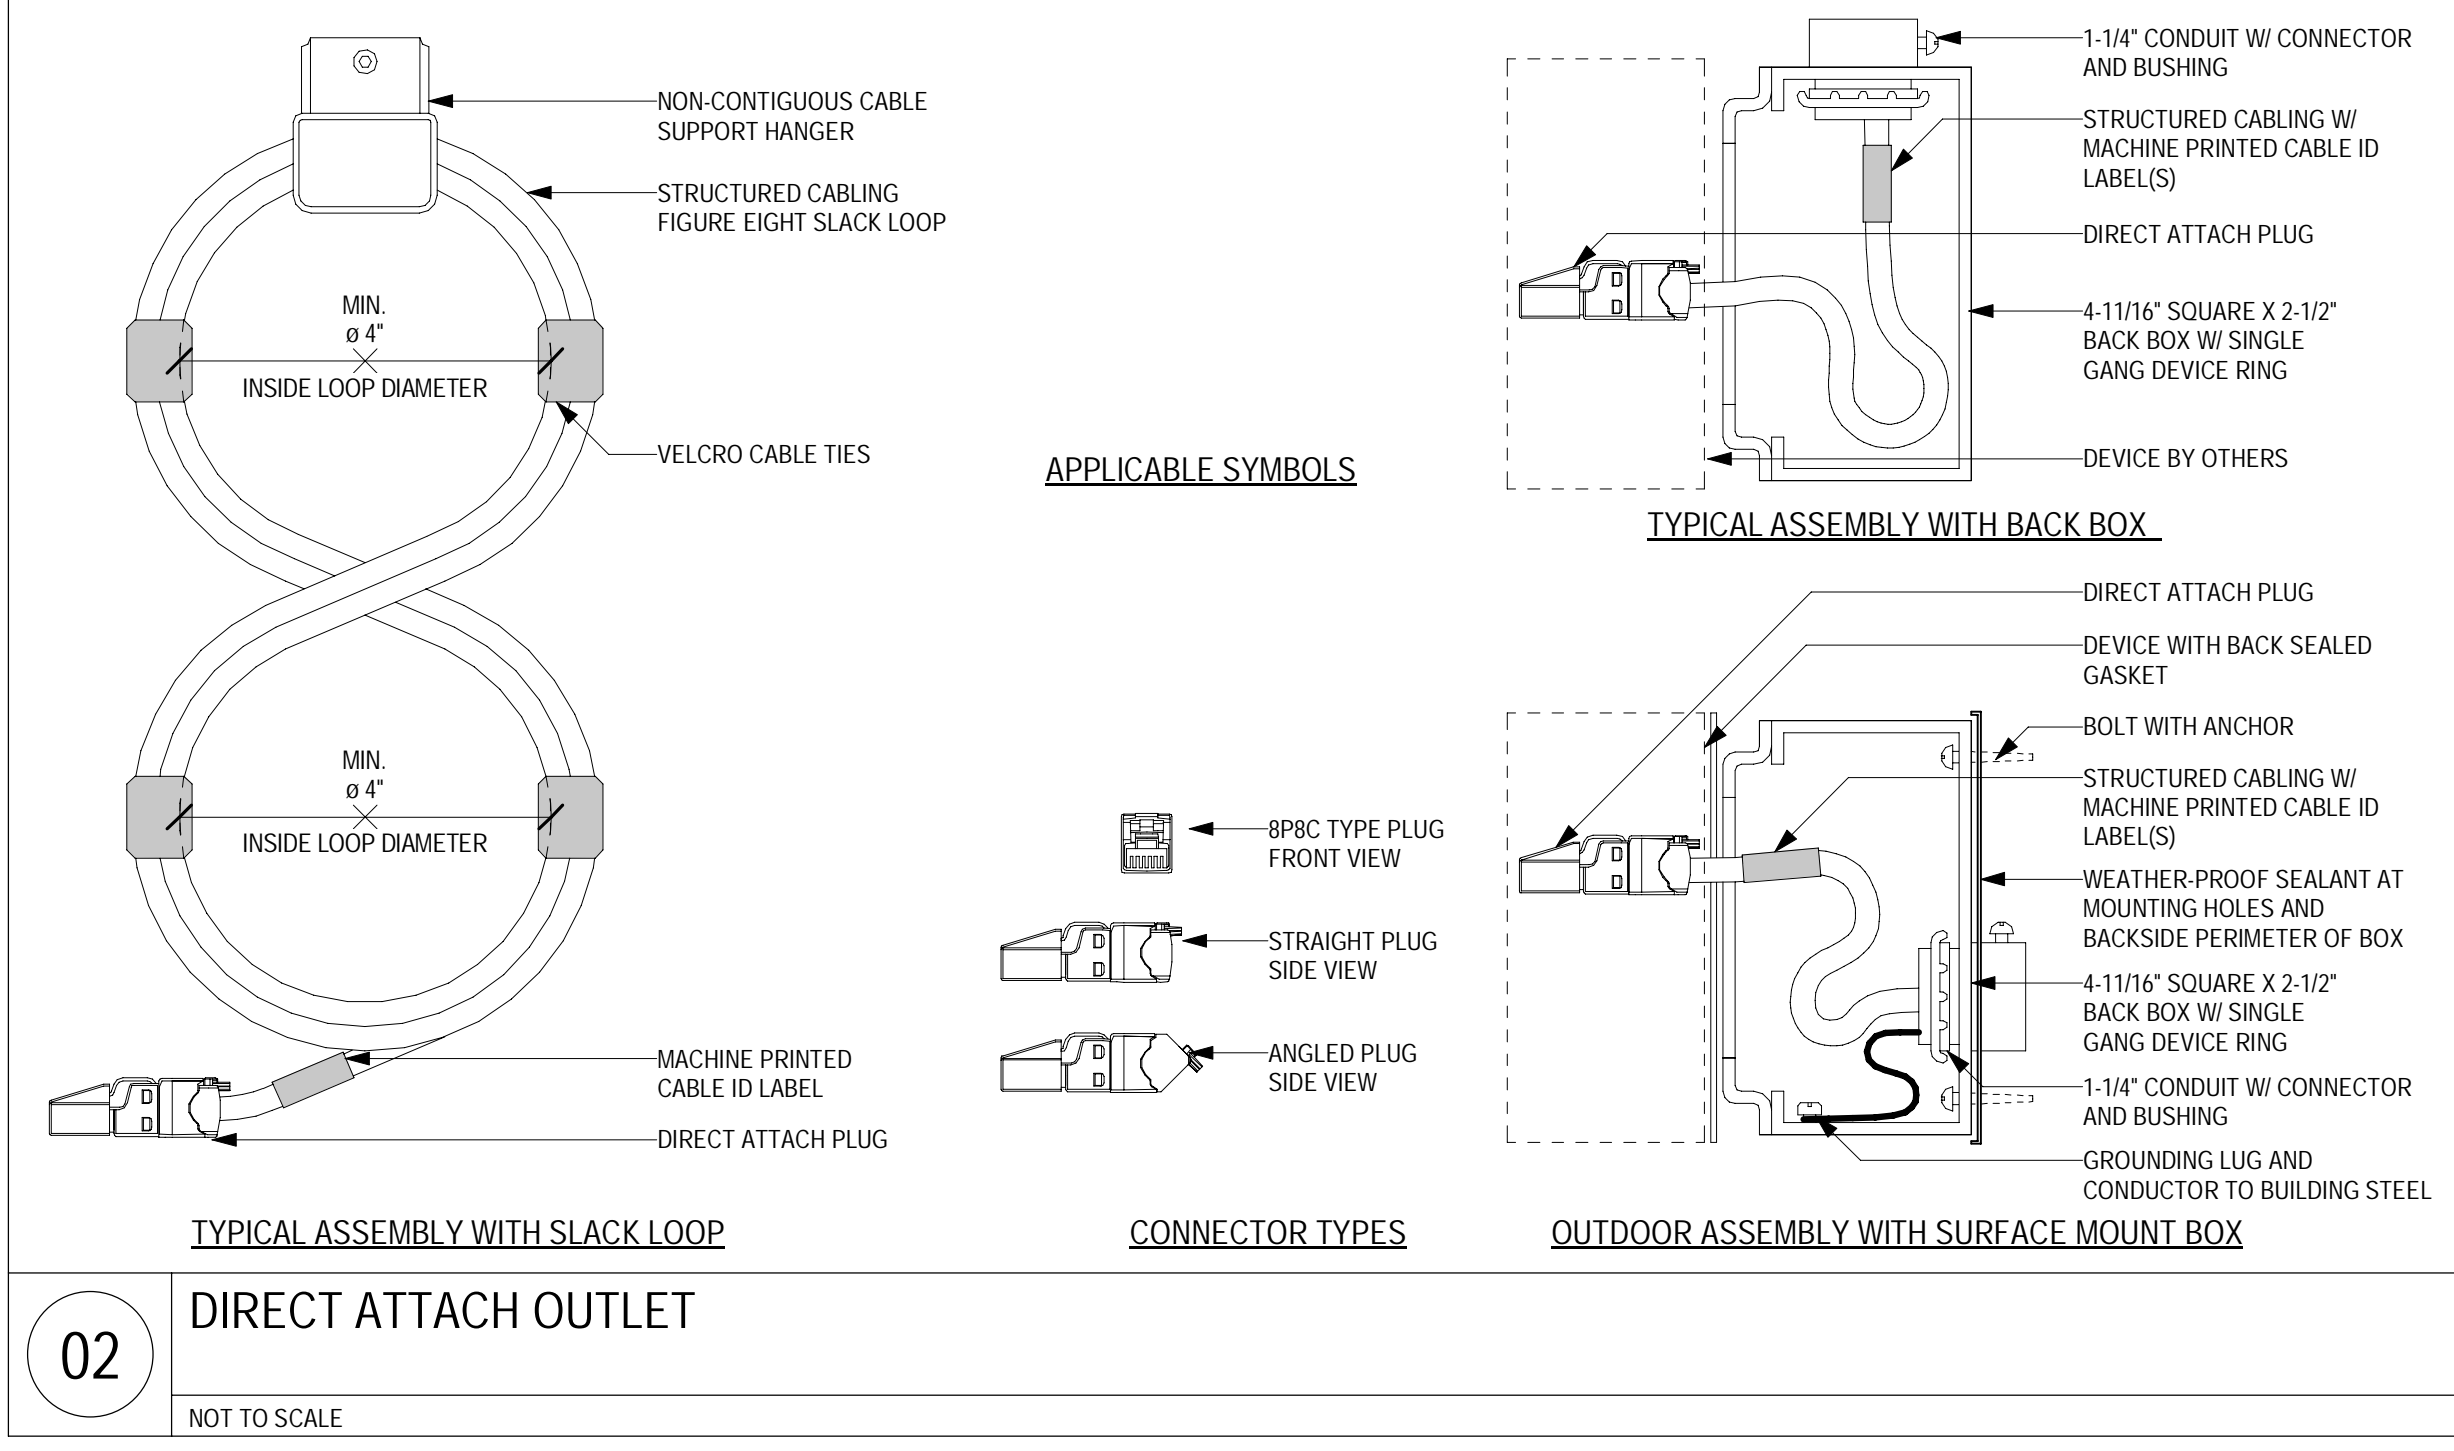
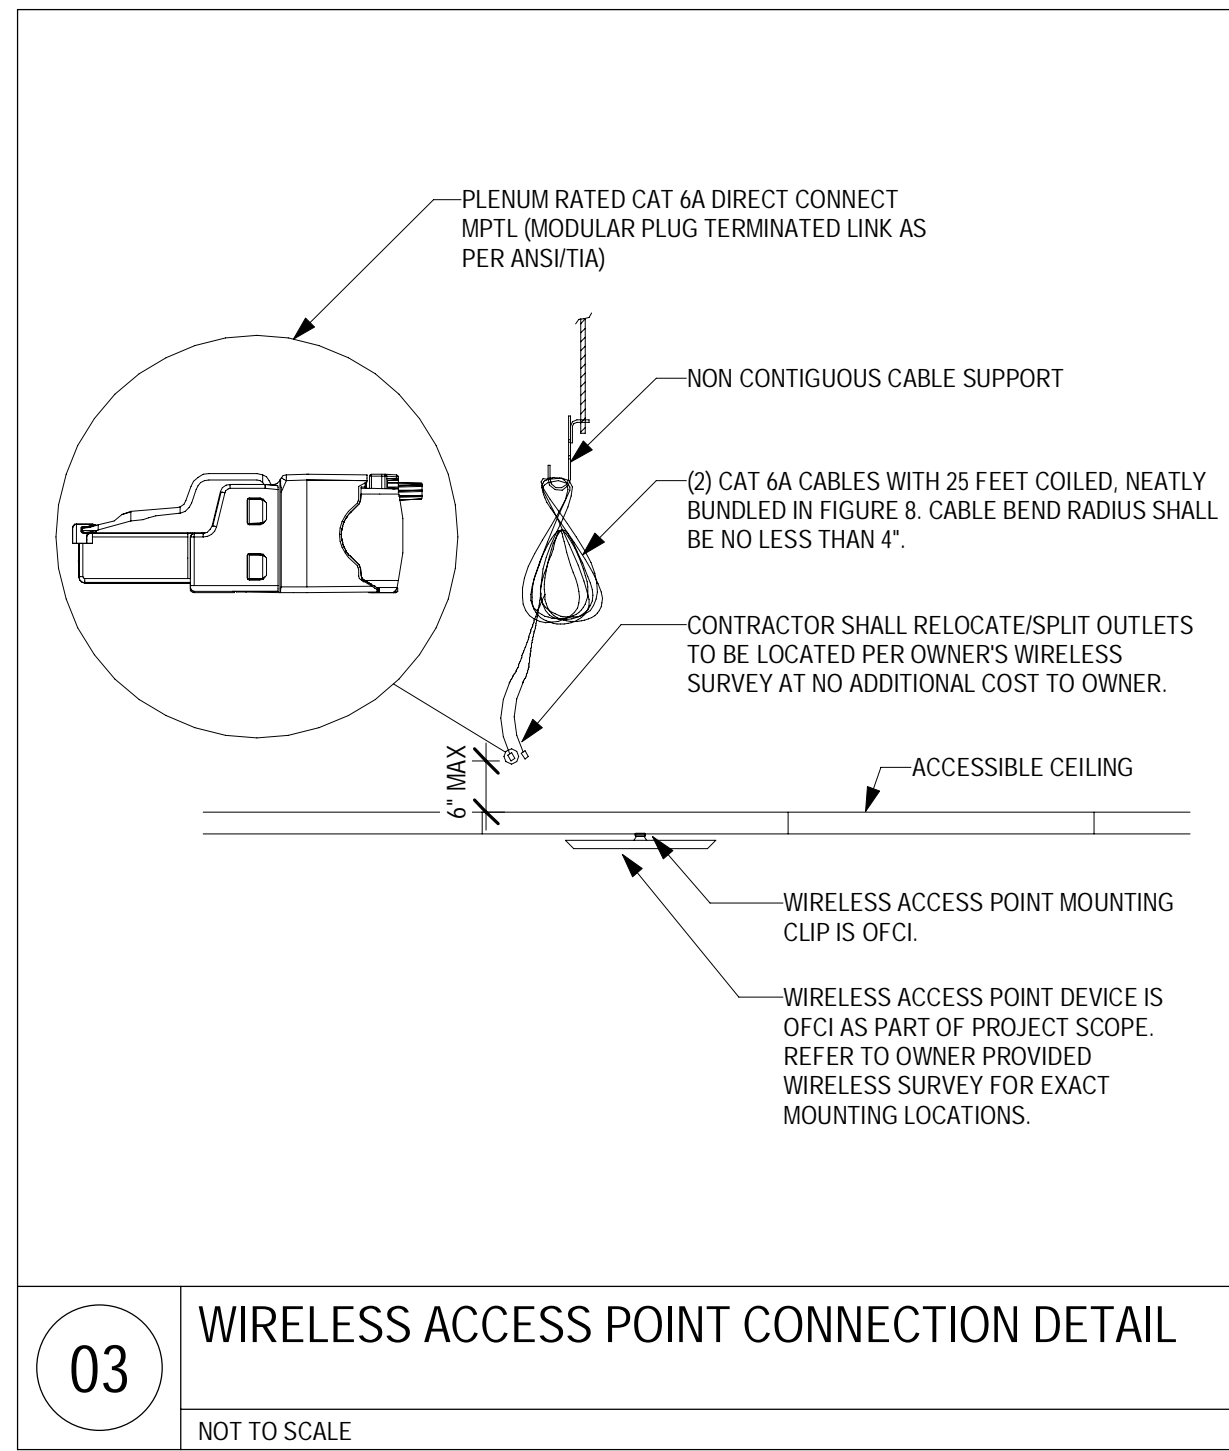
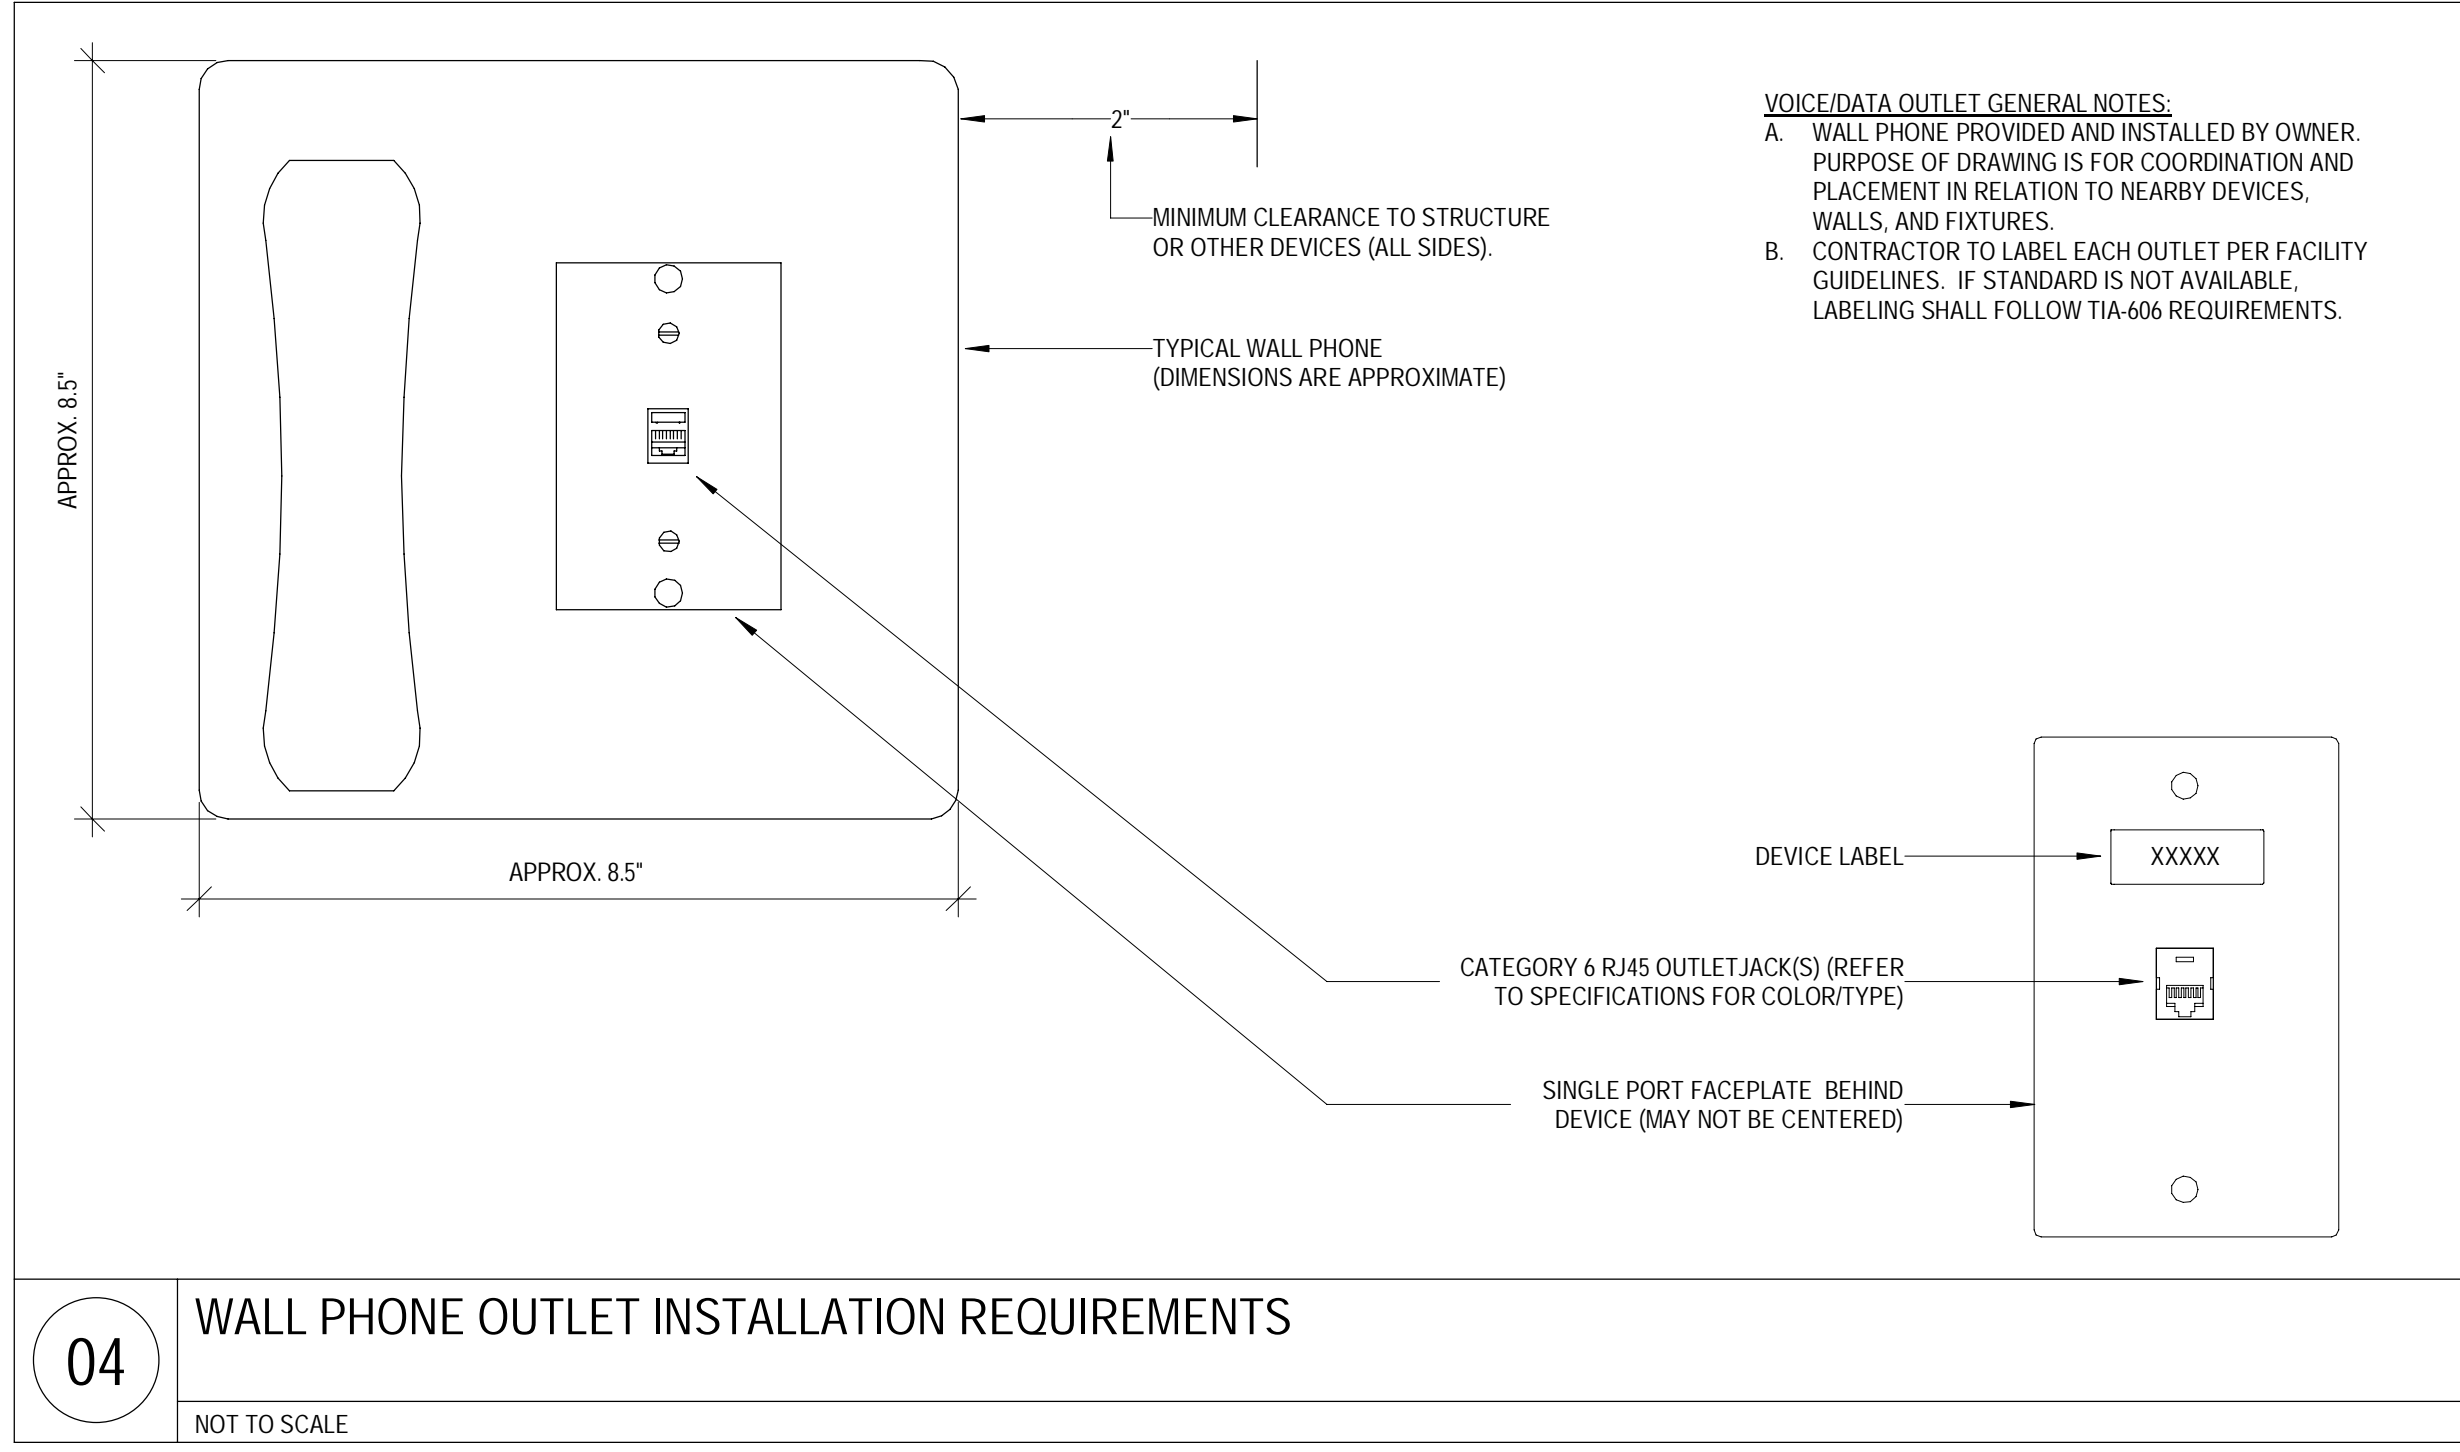
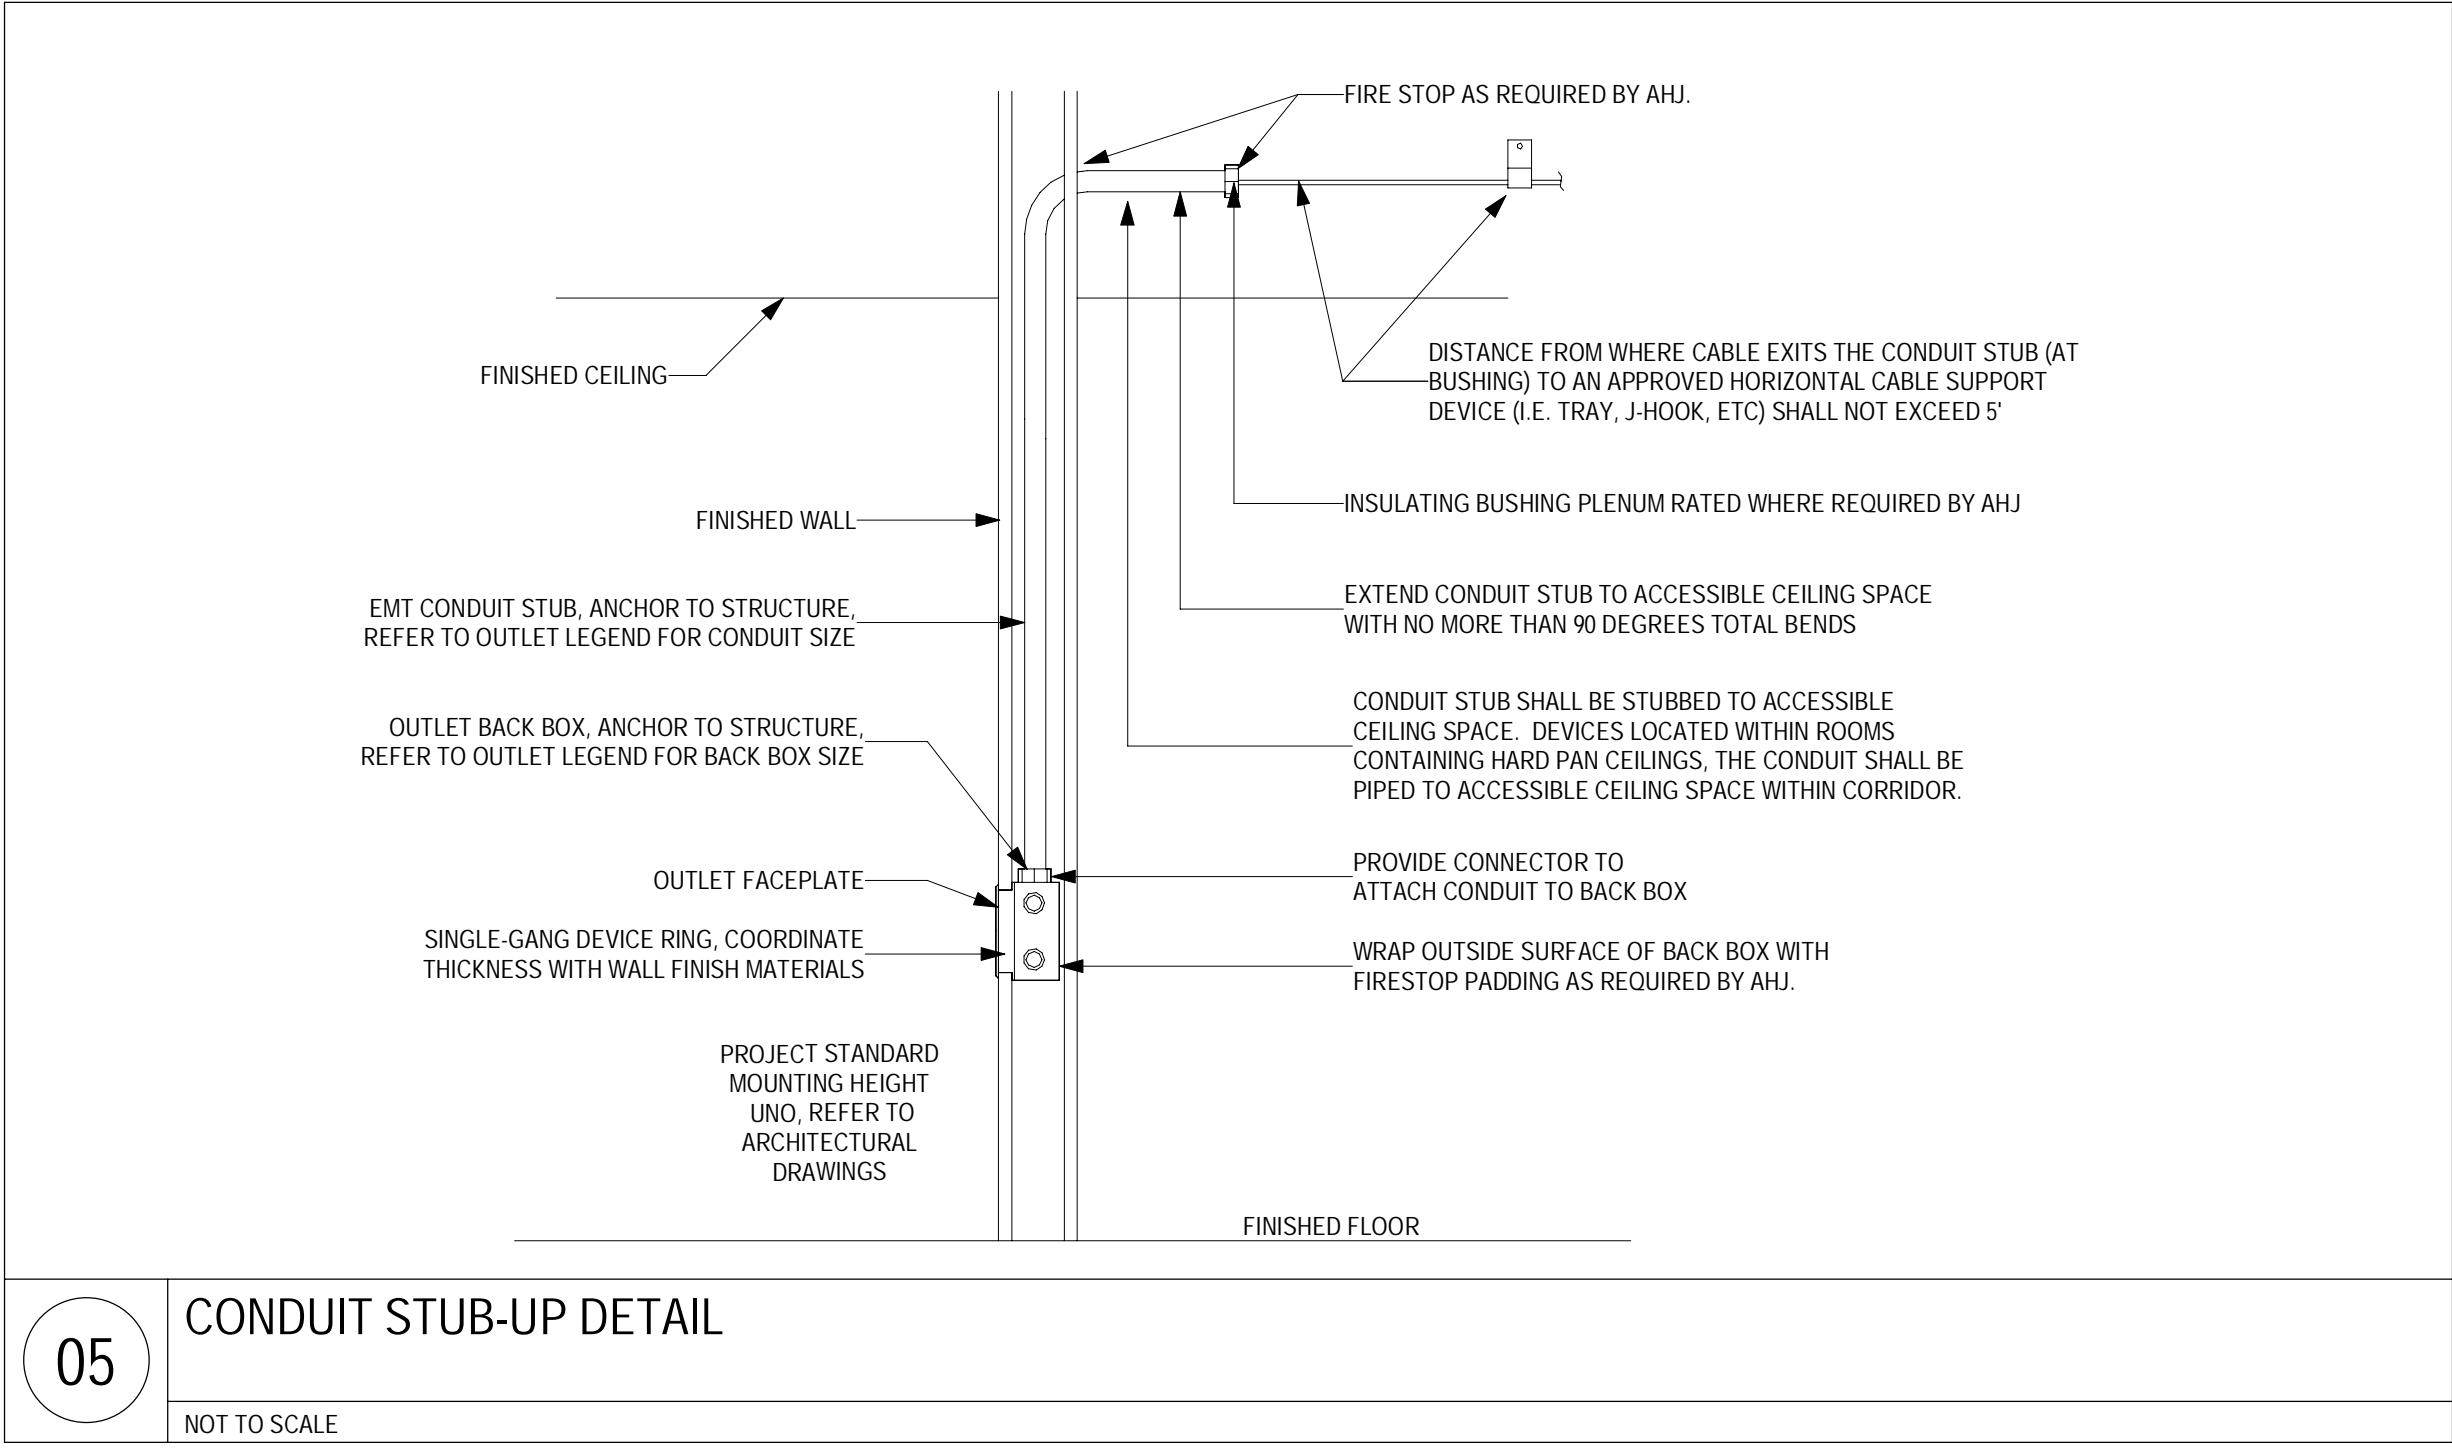
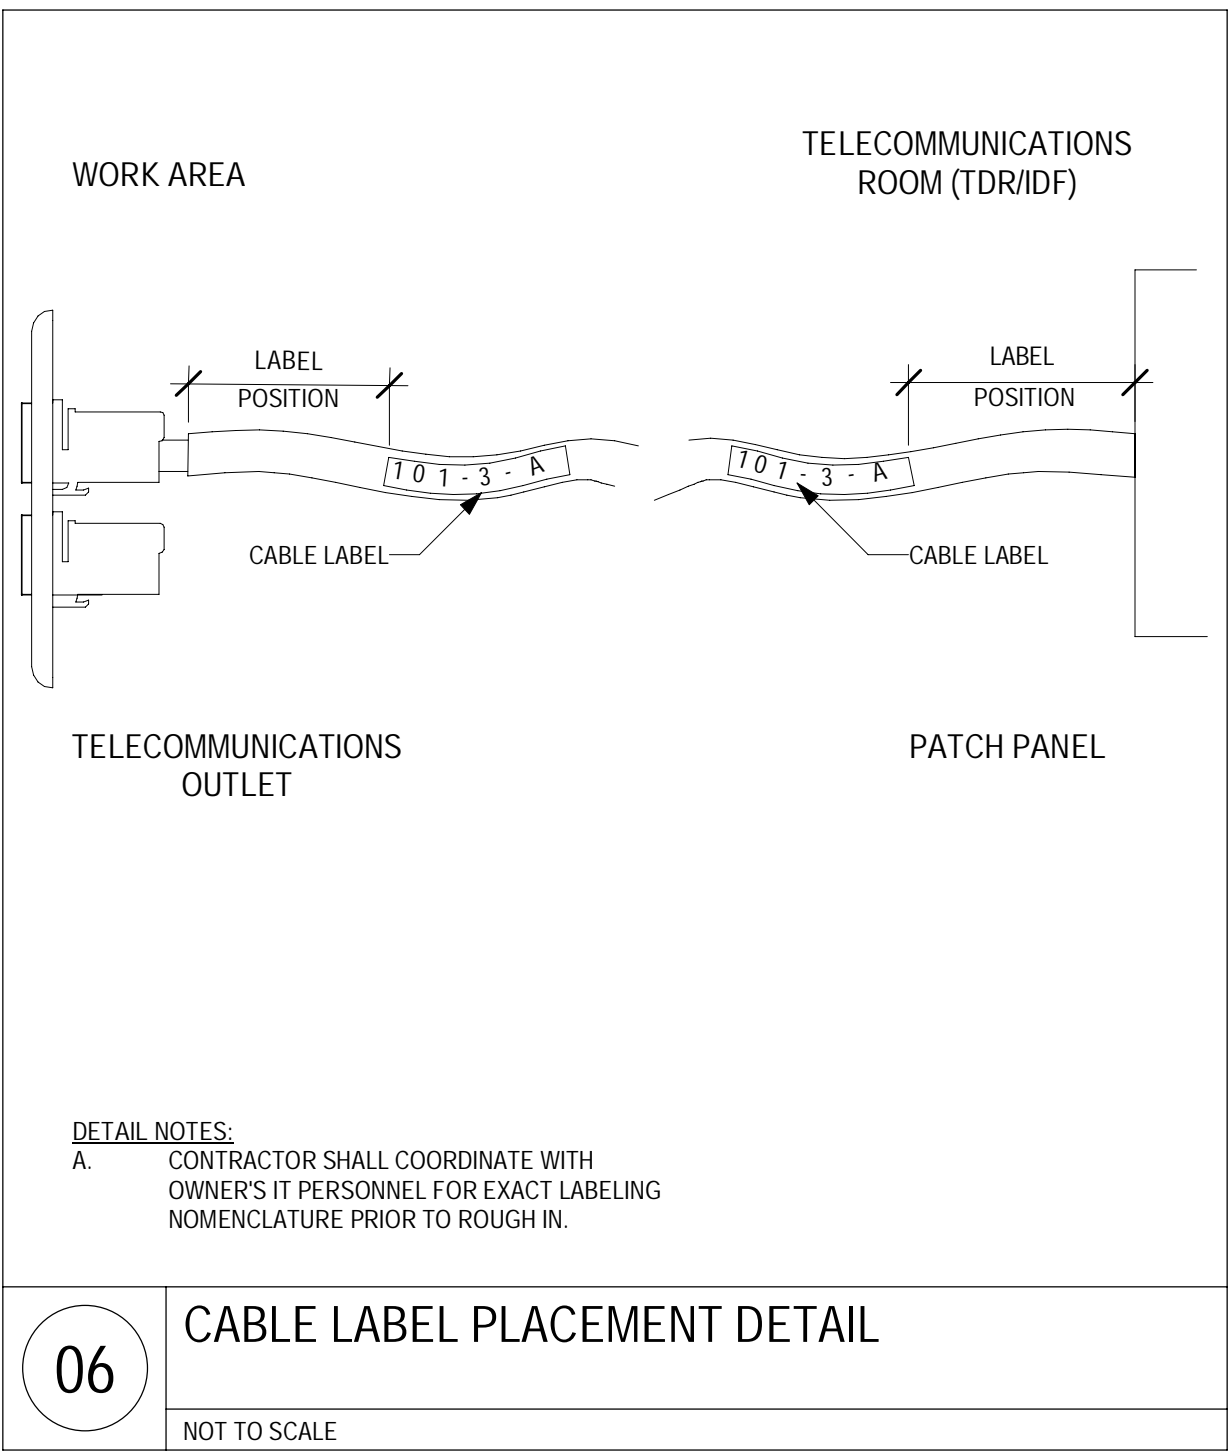
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DATE: 04/18/2025
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DRAWN: FT
REVIEWED: MC
JOB NUMBER: 6406.24


RISER DIAGRAM - TECHNOLOGY

T06-01

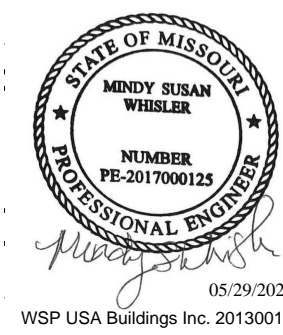

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AGENCY APPROVALS:

REVISIONS		
REV #	DESCRIPTION	DATE
A	CITY - 2ND REVIEW	2025/05/29
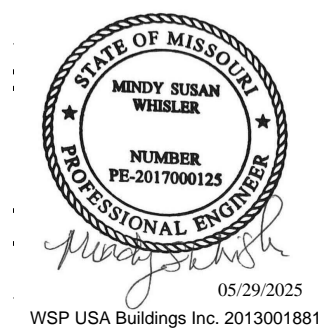
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SCALE: As Indicated
DRAWN: FT
REVIEWED: MC
JOB NUMBER: 6406-24

DETAILS - TECHNOLOGY



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Autodesk Docs / 6406-24 - HCA - Lee's Summit Medical Center 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IF THESE PLANS DO NOT BEAR THE SEAL OF A REGISTRANT, THEY ARE TO BE CONSIDERED "PRELIMINARY" AND ARE NOT TO BE USED FOR CONSTRUCTION OR RECORDING. THESE PLANS ARE COPYRIGHTED AND ARE SUBJECT TO COPYRIGHT PROTECTION AS AN "ARCHITECTURAL WORK" UNDER SEC. 102 OF THE COPYRIGHT ACT, 17 U.S.C. AS AMENDED DECEMBER 1990 AND KNOWN AS ARCHITECTURAL WORKS COPYRIGHT PROTECTION ACT OF 1990. THE PROTECTION INCLUDES BUT NOT LIMITED TO THE OVERALL FORM AS WELL AS THE ARRANGEMENT AND COMPOSITION OF SPACES AND ELEMENTS OF THE DESIGN. UNDER SUCH PROTECTION, UNLAWFUL INFRINGEMENTS OF THE PLANS CAN LEAD TO RESULTS IN THE CESSATION OF CONSTRUCTION OR BUILDINGS BEING SEIZED AND/OR MONETARY COMPENSATION TO THE DESIGN GROUP, LTD.

T07-02



NOT TO SCALE

wsp

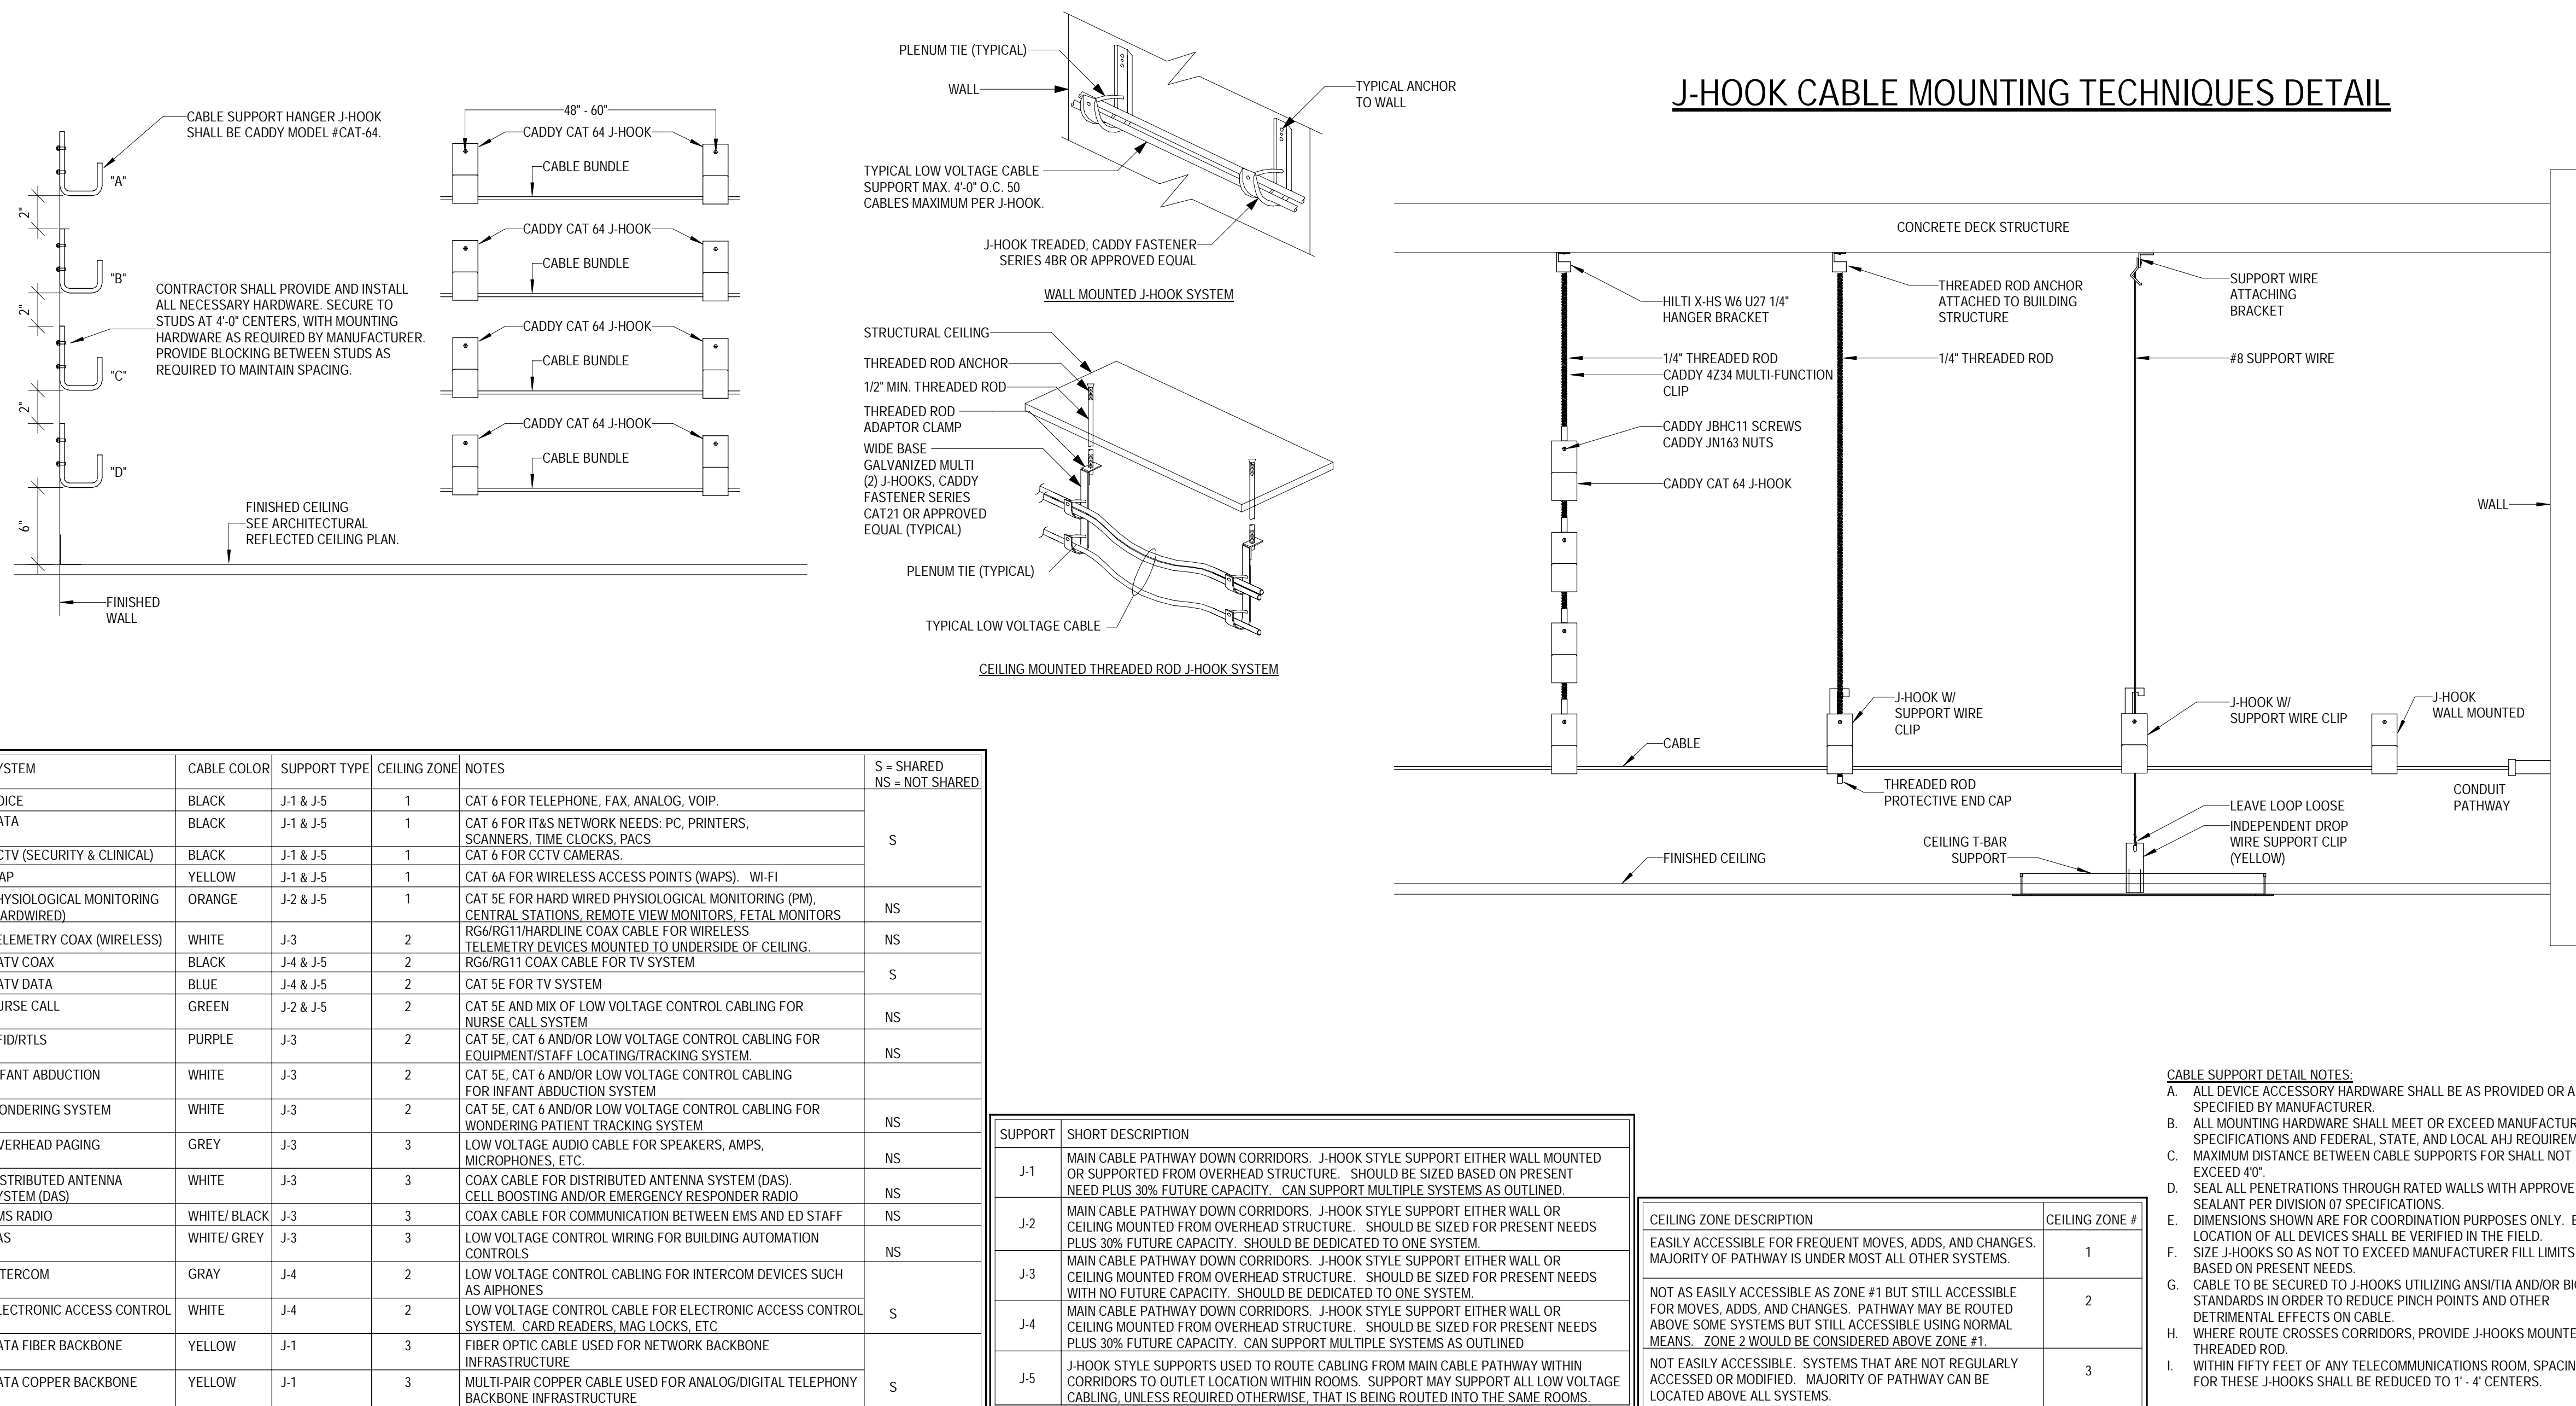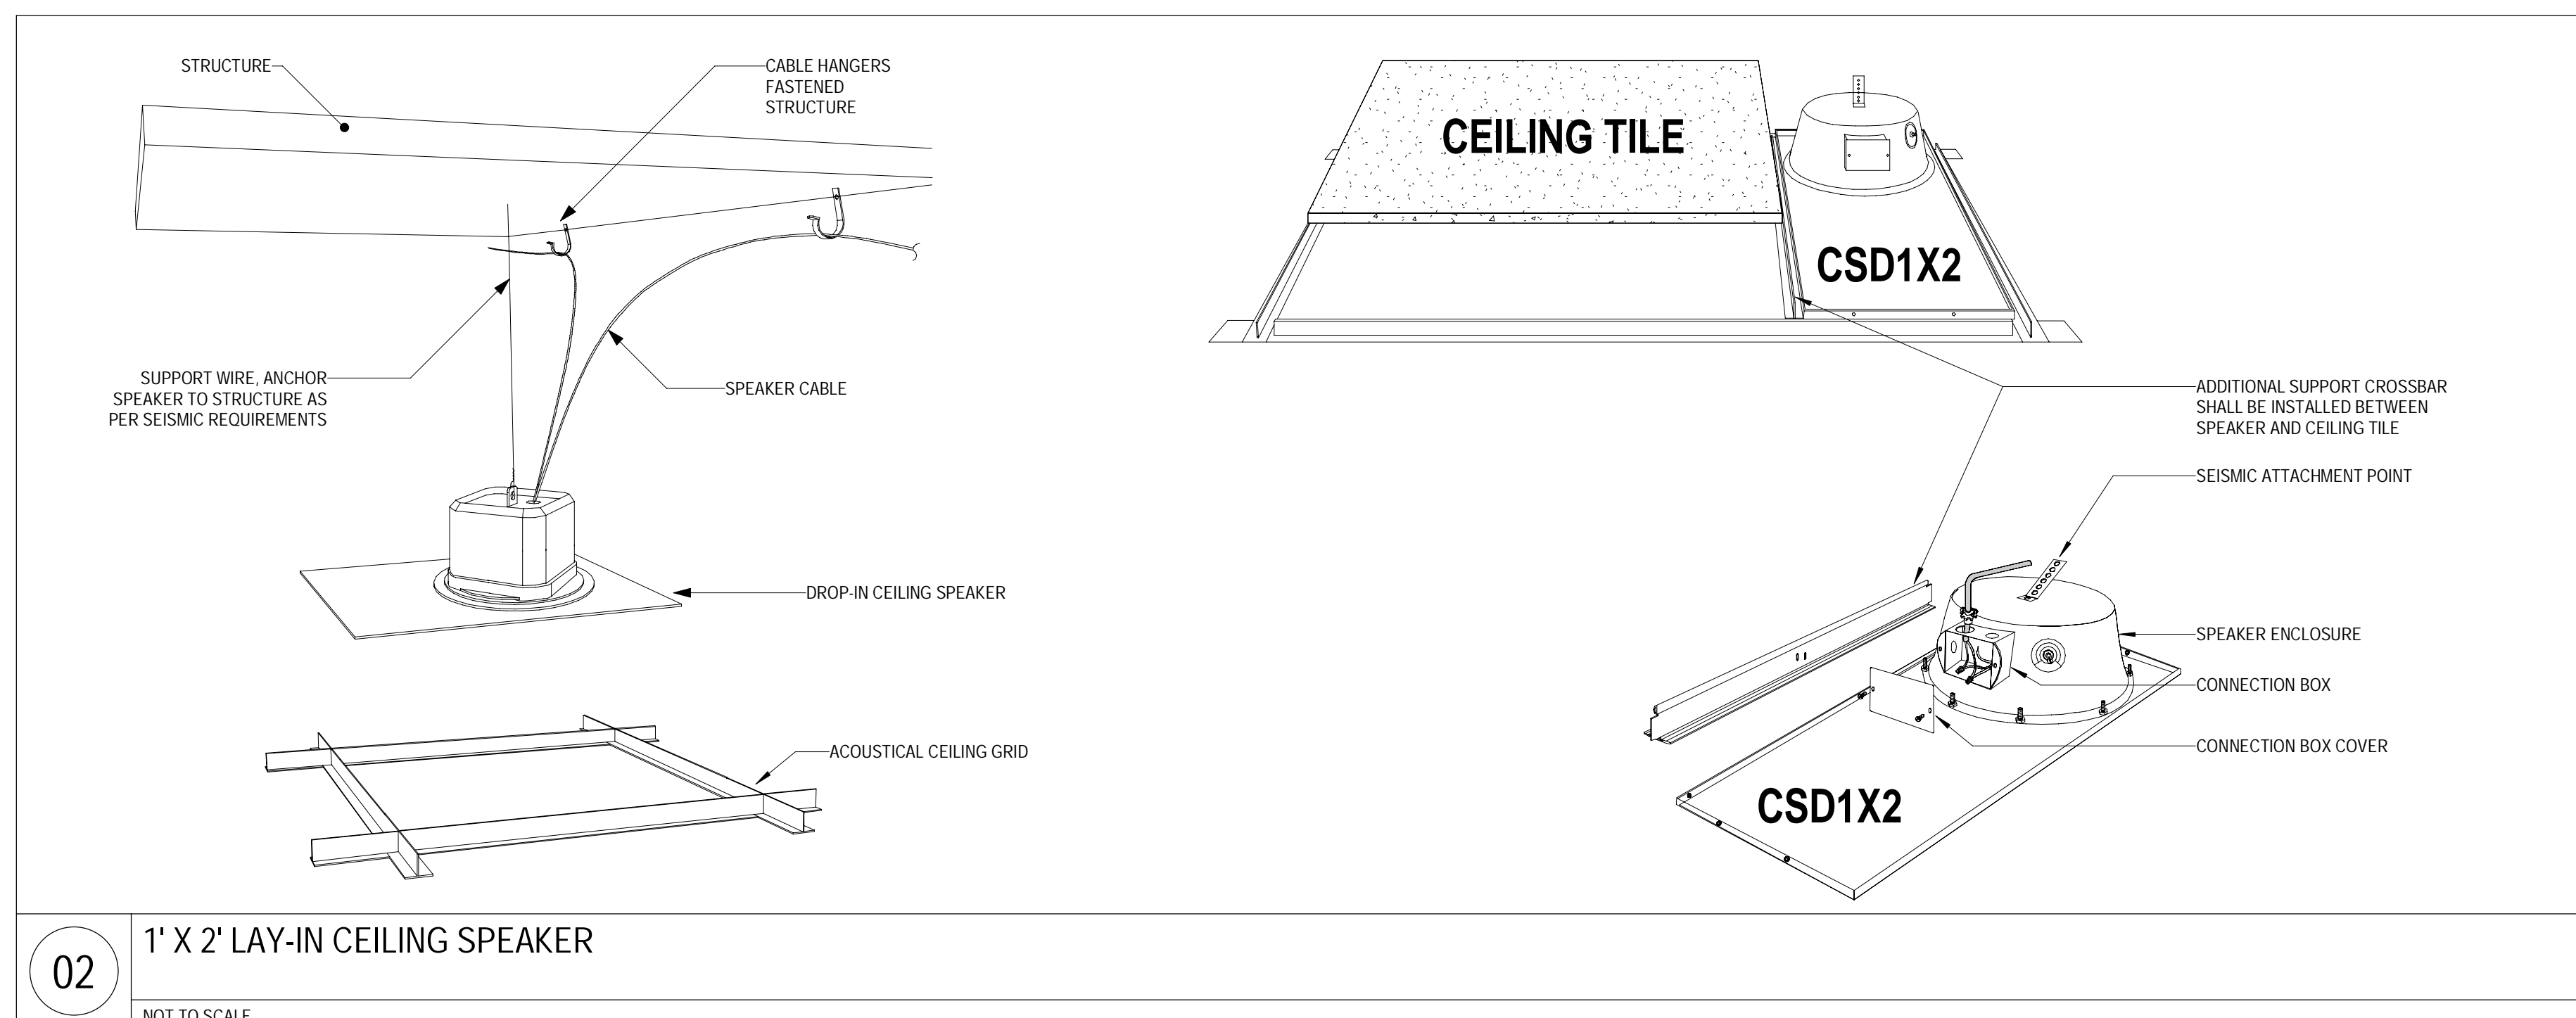

ADMINISTRATION RELOCATION

CENTER
2000 SE BLUE PKWY
LEE'S SUMMIT, MO 64063

FACILITY NUMBER
0972400009

FACILITY NUMBER:
0972400009

AGENCY APPROVALS:

DATE:	04/18/2012
SCALE:	As indicated
DRAWN:	
REVIEWED:	
JOB NUMBER:	640

DETAILS - TECHNOLOGY

T07-03



NOT TO SCALE




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- B. RETURN TO FLOOR PLANS FOR DEVICE LOCATIONS.
- C. WRITING TO DEVICES SHALL MEET OR EXCEED DEVICE MANUFACTURER'S REQUIREMENTS.
- D. DOOR HARDWARE PROVIDED AND INSTALLED BY DIV. 08. HARDWARE IS SHOWN FOR COORDINATION PURPOSES ONLY. HARDWARE INSTALLATION AND TESTING METHODS FOR THESE DEVICES SHALL BE BY DIV. 08.
- E. DIVISION 28 CONTRACTOR SHALL PROVIDE PROPER RATCHET AND LOCKING DEVICES TO MEET OR EXCEED MANUFACTURER'S REQUIREMENTS. PROVIDE PROPER MAGNETIC LOCKS, AND AUTO OPENERS FOR DOORS TO OPERATE AS PER HARDWARE SPECIFICATION NOTES.
- F. PROVIDE DIVISION 28 CONTRACTOR WITH ALL INFORMATION FOR INFRASTRUCTURE, INSTALLATION, AND OPERATIONAL VERIFICATION OF DOOR SYSTEMS PRIOR TO ROUGH-IN. NOT ALL DOOR DEVICES MAY BE SHOWN ON THIS SHEET. REFER TO DIVISION 28 CONTRACTOR FOR HARDWARE LISTING.
- G. SEPARATE POWER SUPPLY MAY BE REQUIRED. CHECK WITH DIV. 24 FOR REQUIREMENTS AND DIV. 7 SPECIFICATIONS.
- H. CONDUIT BY DIV. 24, 3/4" HOLE IN FRAME DRILLED BY DIV. 08 OR DIV. 24. DOOR DEVICE PROVIDED AND INSTALLED BY ACCESS CONTROL CONTRACTOR.
- I. DOOR STATUS SWITCHES/MAY REQUIRE TO BE RELOCATED TO AVOID INTERFERENCE (E.G. VERTICAL RODS, COORDINATORS, ETC.).
- J. COORDINATE WITH ELECTRICAL SHEETS FOR POWER TO ALL ELECTRICAL SUPPLIES AND HARDWARE. PROVIDE HARDWARE SPECIFICATION FOR POWER SUPPLY RESPONSIBILITIES.
- K. PROVIDE HARDWARE FOR CABLE PALLEY BETWEEN HINGE, EYE, AND LOCKING DEVICE SHALL BE BY DOOR PROVIDER. ACCESS CONTROL JUNCTION BOX SHALL BE INSTALLED ON INSIDE OF DOOR IN A CONCEALED LOCATION. JUNCTION BOX SHALL BE A DOWEL CABLE BOX WITH DOUBLE CABLE DRILLING AND BLANK COVER PLATE. IN ADDITION TO CONDUIT PATHWAYS SHOWN, PROVIDE 3/4" CONDUIT PATHWAY FROM



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TECHNOLOGY SYSTEMS EQUIPMENT AND STRUCTURED CABLING COORDINATION SCHEDULE															
SYSTEM	EQUIPMENT			CABLING					ROUGH IN					GROUNDING	
	EQUIPMENT FURNISHED BY	EQUIPMENT INSTALLED BY	TEST/CERTIFIED BY	CABLE FURNISHED BY	CABLE INSTALLED BY	CABLE TERMINATIONS BY	LABELLED BY	TEST/CERTIFIED BY	CONDUIT SLEEVES BY (NOTE 2)	CONDUIT PATHWAYS BY (NOTE 3)	PRE-MANUFACTURED FIRE SLEEVE BY (NOTE 4)	BACK BOXES PROVIDED BY	BACK BOXES INSTALLED BY (NOTE 5)	FLOOR/WALL CORES/SLEEVES BY (NOTE 6)	CONNECTION TO TGB BY
IT&S SYSTEMS - VOICE/DATA															
IT&S VOICE EQUIPMENT (WORKSTATION) (NOTE 9)	OWNER	OWNER	OWNER	DIV 27	DIV 27	DIV 27	DIV 27	DIV 27	DIV 27	DIV 26	DIV 27	DIV 26	DIV 26	DIV 26	N/A
IT&S DATA EQUIPMENT (WORKSTATION) (NOTE 9)	OWNER	OWNER	OWNER	DIV 27	DIV 27	DIV 27	DIV 27	DIV 27	DIV 27	DIV 26	DIV 27	DIV 26	DIV 26	DIV 26	N/A
WIRELESS ACCESS POINT (WAP)	OWNER	DIV 27	OWNER	DIV 27	DIV 27	DIV 27	DIV 27	DIV 27	DIV 27	DIV 26	DIV 27	DIV 26	DIV 26	DIV 26	N/A
IT&S DATA EQUIPMENT (TECTOR)	OWNER	OWNER	OWNER	N/A	N/A	N/A	N/A	N/A	N/A	N/A	N/A	N/A	N/A	N/A	N/A
IT&S VOICE EQUIPMENT (TECTOR)	OWNER	OWNER	OWNER	N/A	N/A	N/A	N/A	N/A	N/A	N/A	N/A	N/A	N/A	N/A	N/A
WORKSTATION EQUIPMENT PATCH CORDS	OWNER	OWNER	OWNER	N/A	N/A	N/A	N/A	N/A	N/A	N/A	N/A	N/A	N/A	N/A	N/A
MEDICAL EQUIPMENT NETWORK CONNECTED DEVICES (NOTE 9)	OWNER	OWNER	OWNER	DIV 27	DIV 27	DIV 27	DIV 27	DIV 27	DIV 27	DIV 26	DIV 27	DIV 26	DIV 26	DIV 26	N/A
TIME CLOCK (EMPLOYEE)	OWNER	GC	OWNER	DIV 27	DIV 27	DIV 27	DIV 27	DIV 27	DIV 27	DIV 26	DIV 27	DIV 26	DIV 26	DIV 26	N/A
NURSE CALL CODE BLUE															
STATION DEVICES	NC	NC	NC	DIV 27	DIV 27	NC	NC	NC	DIV 27	DIV 26	DIV 27	DIV 26	DIV 26	DIV 26	N/A
HEADEND CABINET (IF APPLICABLE)	NC	NC	NC	DIV 27	DIV 27	NC	NC	NC	DIV 27	DIV 26	DIV 27	DIV 26	DIV 26	DIV 26	N/A
NETWORK SWITCHES (IF APPLICABLE)	NC	NC	NC	DIV 27	DIV 27	NC	NC	NC	DIV 27	DIV 26	DIV 27	DIV 26	DIV 26	DIV 26	N/A
CALL CORD/PULLBOX SPEAKERS	NC	NC	NC	N/A	N/A	N/A	N/A	N/A	N/A	N/A	N/A	N/A	N/A	N/A	N/A
PATCH CORDS	OWNER	OWNER	OWNER	N/A	N/A	N/A	N/A	N/A	N/A	N/A	N/A	N/A	N/A	N/A	N/A
CATV SYSTEMS															
COAXIAL CABLE	N/A	N/A	N/A	DIV 27	DIV 27	TV	TV/DIV 27	TV	DIV 27	DIV 26	DIV 27	DIV 26	DIV 26	DIV 26	TV
DATA CABLE	N/A	N/A	N/A	DIV 27	DIV 27	DIV 27	DIV 27	DIV 27	DIV 27	DIV 26	DIV 27	DIV 26	DIV 26	DIV 26	N/A
CROSS ROOM NURSE CALL CONTROL	TV	TV	TV	DIV 27	DIV 27	DIV 27	DIV 27	DIV 27	DIV 27	DIV 26	N/A	DIV 26	DIV 26	N/A	N/A
TV OUTLET COVER PLATE	DIV 27	DIV 27	DIV 27	N/A	N/A	N/A	N/A	N/A	N/A	N/A	N/A	N/A	N/A	N/A	N/A
TELEVISIONS (PATIENT, WAITING, STAFF LOUNGE, ETC.)	TV	TV	TV	N/A	N/A	N/A	N/A	N/A	N/A	N/A	N/A	N/A	N/A	N/A	N/A
TELEVISION WALL MOUNTING BRACKET	TV	GC	N/A	N/A	N/A	N/A	N/A	N/A	N/A	N/A	N/A	N/A	N/A	N/A	N/A
CATV EQUIPMENT (SPLITTERS/COMBINERS/AMPLIFIERS)	TV	TV	TV	N/A	N/A	N/A	TV	N/A	N/A	N/A	N/A	N/A	N/A	N/A	TV
CROSS CONNECTS/PATCH CORD	TV	TV	TV	N/A	N/A	N/A	N/A	N/A	N/A	N/A	N/A	N/A	N/A	N/A	N/A
SECURITY SYSTEMS															
NVR/DVR	OWNER	OWNER	OWNER	N/A	N/A	N/A	N/A	N/A	N/A	N/A	N/A	N/A	N/A	N/A	OWNER
SURVEILLANCE CAMERAS/MOUNTS/LICENSES	OWNER	OWNER	OWNER	DIV 27	DIV 27	DIV 27	DIV 27	DIV 27	DIV 27	DIV 26	DIV 27	DIV 26	DIV 26	DIV 26	N/A
NETWORK SWITCHES	OWNER	OWNER	OWNER	N/A	N/A	N/A	N/A	N/A	N/A	N/A	N/A	N/A	N/A	N/A	OWNER
PATCH CORDS	OWNER	OWNER	OWNER	N/A	N/A	N/A	N/A	N/A	N/A	N/A	N/A	N/A	N/A	N/A	N/A
ELECTRONIC ACCESS CONTROL SYSTEM	DIV 28	DIV 28	DIV 28	DIV 28	DIV 28	DIV 28	DIV 28	DIV 28	DIV 28	DIV 26	DIV 28	DIV 26	DIV 26	DIV 26	N/A
DOOR HARDWARE	DIV 08	DIV 08	DIV 08	DIV 08	DIV 08	DIV 08	DIV 08	N/A	N/A	DIV 26	N/A	DIV 26	DIV 26	N/A	N/A
WIRELESS PANIC BUTTON (IF APPLICABLE)	PB	PB	PB	N/A	N/A	N/A	PB	PB	N/A	N/A	N/A	N/A	N/A	N/A	N/A
WIRED PANIC BUTTON (IF APPLICABLE)	DIV 28	DIV 28	DIV 28	DIV 28	DIV 28	DIV 28	DIV 28	DIV 28	DIV 28	DIV 26	DIV 28	DIV 26	DIV 26	N/A	N/A
INFANT PROTECTION	OWNER	OWNER	OWNER	OWNER	OWNER	OWNER	OWNER	OWNER	OWNER	OWNER	OWNER	OWNER	OWNER	OWNER	N/A
INTRUSION DETECTION	DIV 28	DIV 28	DIV 28	DIV 28	DIV 28	DIV 28	DIV 28	DIV 28	DIV 28	DIV 26	DIV 28	DIV 26	DIV 26	N/A	N/A
EMERGENCY (BLUE) PHONE	GC	GC	DIV 26/27	DIV 26/27	DIV 26/27	DIV 26/27	DIV 26/27	DIV 26/27	DIV 26/27	DIV 26	DIV 27	DIV 26	DIV 26	N/A	DIV 26
INTERCOM	DIV 28	DIV 28	DIV 28	DIV 28	DIV 28	DIV 28	DIV 28	DIV 28	DIV 28	DIV 26	DIV 28	DIV 26	DIV 26	DIV 26	N/A
OVERHEAD PAGING SYSTEM															
SPEAKERS/HORNS	DIV 27	DIV 27	DIV 27	DIV 27	DIV 27	DIV 27	DIV 27	DIV 27	DIV 27	DIV 26	DIV 27	DIV 26	DIV 26	DIV 26	N/A
AMPLIFIERS	DIV 27	DIV 27	DIV 27	N/A	N/A	N/A	N/A	N/A	N/A	N/A	N/A	N/A	N/A	N/A	DIV 27
VOLUME CONTROL	DIV 27	DIV 27	DIV 27	DIV 27	DIV 27	DIV 27	DIV 27	DIV 27	DIV 27	DIV 26	DIV 27	DIV 26	DIV 26	DIV 26	N/A
TELEPHONE ACCESS EQUIPMENT	DIV 27	DIV 27	DIV 27	DIV 27	DIV 27	DIV 27	DIV 27	DIV 27	DIV 27	DIV 26	DIV 27	DIV 26	DIV 26	DIV 26	N/A
ZONE DISTRIBUTION EQUIPMENT (IF APPLICABLE)	DIV 27	DIV 27	DIV 27	DIV 27	DIV 27	DIV 27	DIV 27	DIV 27	DIV 27	DIV 26	DIV 27	DIV 26	DIV 26	DIV 26	N/A
PATIENT MONITORING SYSTEM															
PHYSIOLOGICAL MONITORING (PM)	PM	PM	PM	DIV 27	DIV 27	DIV 27	DIV 27	DIV 27	DIV 27	DIV 26	DIV 27	DIV 26	DIV 26	DIV 26	N/A
FETAL MONITORING (FM)	PM	PM	PM	DIV 27	DIV 27	DIV 27	DIV 27	DIV 27	DIV 27	DIV 26	DIV 27	DIV 26	DIV 26	DIV 26	N/A
TELEMETRY	PM	PM	OWNER	OWNER	OWNER	OWNER	OWNER	OWNER	OWNER	OWNER	OWNER	OWNER	OWNER	OWNER	N/A
NETWORK SWITCHES	OWNER	OWNER	OWNER	N/A	N/A	N/A	N/A	N/A	N/A	N/A	N/A	N/A	N/A	N/A	OWNER
PATCH CORDS	OWNER	OWNER	OWNER	N/A	N/A	N/A	N/A	N/A	N/A	N/A	N/A	N/A	N/A	N/A	N/A
TELECOMMUNICATIONS ROOMS (TECTOR)															
OPEN FRAME EQUIPMENT RACKS (POST/UPS)	DIV 27	DIV 27	DIV 27	N/A	N/A	N/A	N/A	N/A	N/A	N/A	N/A	N/A	N/A	N/A	DIV 27
ENCLOSED EQUIPMENT CABINETS	OWNER	OWNER	OWNER	N/A	N/A	N/A	N/A	N/A	N/A	N/A	N/A	N/A	N/A	N/A	DIV 27
BASKET TRAY & SUPPORT HARDWARE	DIV 27	DIV 27	DIV 27	N/A	N/A	N/A	N/A	N/A	N/A	N/A	N/A	N/A	N/A	N/A	DIV 27
FIRE RATED PLYWOOD BACKBOARDS	DIV 26	DIV 26	DIV 26	N/A	N/A	N/A	N/A	N/A	N/A	N/A	N/A	N/A	N/A	N/A	N/A
CABLE MANAGEMENT (VERTICAL/HORIZONTAL)	DIV 27	DIV 27	DIV 27	N/A	N/A	N/A	N/A	N/A	N/A	N/A	N/A	N/A	N/A	N/A	DIV 27
UNINTERRUPTIBLE POWER SUPPLY (UPS)	OWNER	OWNER	OWNER	N/A	N/A	N/A	N/A	N/A	N/A	N/A	N/A	N/A	N/A	N/A	N/A
NETWORK SWITCHES, SERVERS, & ADDITIONAL NETWORK GEAR EQUIP.	OWNER	OWNER	OWNER	N/A	N/A	N/A	N/A	N/A	N/A	N/A	N/A	N/A	N/A	N/A	OWNER
TELEPHONE SYSTEM EQUIPMENT	OWNER	OWNER	OWNER	N/A	N/A	N/A	N/A	N/A	N/A	N/A	N/A	N/A	N/A	N/A	OWNER
CROSS CONNECTS/PATCH CORDS	OWNER	OWNER	OWNER	N/A	N/A	N/A	N/A	N/A	N/A	N/A	N/A	N/A	N/A	N/A	N/A
GROUNDING/BONDING															
TELECOMMUNICATIONS BONDING BACKBONE (TGB)	DIV 26	DIV 26	DIV 26	DIV 26	DIV 26	DIV 26	DIV 26	DIV 26	DIV 26	DIV 26	DIV 26	N/A	N/A	DIV 26	DIV 26
TELECOMMUNICATIONS GROUNDING BUSS BAR (TGB)	DIV 26	DIV 26	DIV 26	N/A	N/A	N/A	N/A	N/A	N/A	N/A	N/A	N/A	N/A	N/A	N/A
MISC. SYSTEMS															
SYNCHRONIZED CLOCK SYSTEMS	DIV 26 OR 27	DIV 26 OR 27	DIV 26 OR 27	DIV 26 OR 27	DIV 26 OR 27	DIV 26 OR 27	DIV 26 OR 27	DIV 26 OR 27	N/A	N/A	N/A	DIV 26	DIV 26	N/A	N/A
REAL TIME LOCATING SYSTEM (RTLS)	OWNER	OWNER	OWNER	DIV 27	DIV 27	DIV 27	DIV 27	DIV 27	DIV 27	DIV 26	DIV 27	DIV 26	DIV 26	DIV 26	N/A
DISTRIBUTED ANTENNA SYSTEMS (DAS)	OWNER	OWNER	OWNER	OWNER	OWNER	OWNER	OWNER	OWNER	OWNER	OWNER	OWNER	OWNER	OWNER	OWNER	OWNER
EMERGENCY RESPONDER RADIO COMMUNICATIONS (ERRCS)	OWNER	OWNER	OWNER	OWNER	OWNER	OWNER	OWNER	OWNER	OWNER	OWNER	OWNER	OWNER	OWNER	OWNER	OWNER
TEMPERATURE MONITORING SYSTEM	OWNER	OWNER	OWNER	DIV 27	DIV 27	DIV 27	DIV 27	DIV 27	DIV 27	DIV 26	DIV 27	DIV 26	DIV 26	DIV 26	N/A
EMS RADIO	OWNER	OWNER	OWNER	OWNER	OWNER	OWNER	OWNER	OWNER	OWNER	OWNER	OWNER	OWNER	OWNER	OWNER	N/A
NOTES: 1. ALL SYSTEMS SHOWN MAY NOT BE PRESENT IN PROJECT. REFER TO FLOOR PLANS FOR SYSTEMS INCLUDED IN PROJECT. 2. INCLUDES CONDUIT SLEEVES, NOT TO EXCEED 18 INCHES IN LENGTH, THROUGH GYPSUM PARTITIONS. SLEEVES EXCEEDING 18" IN LENGTH SHALL BE PROVIDED BY DIV 26 CONTRACTOR. 3. INCLUDES CONDUIT PATHWAY EXCEEDING 18 INCHES IN LENGTH. INCLUDES ALL NECESSARY CONNECTIONS, PULL BOXES, AND PLASTIC BUSHINGS. 4. INCLUDES PRE-MANUFACTURED FIRE SLEEVE SYSTEMS. 5. INCLUDES REQUIRED CONDUIT STUB UP TO ABOVE ACCESSIBLE CEILING SPACE. 6. INCLUDES SLEEVES THROUGH CONCRETE/MASONRY WALLS REQUIRING CORING OR LEAVE-OUTS. 7. CROSS ROOM SOUND CABLE TERMINATED BY NURSE CALL VENDOR AT PATIENT STATION. DIV 27 CONTRACTOR SHALL TERMINATE CROSS ROOM SOUND CABLE AT TV OUTLET AND PROVIDE FACEPLATE. 8. LIGHTING CONTROL CABLE TERMINATED BY NURSE CALL VENDOR AT PATIENT STATION. NURSE CALL VENDOR SHALL PROVIDE DIV 26 CONTRACTOR LIGHTING CONTROL RELAY. DIV 26 CONTRACTOR SHALL CONNECT RELAY WITH LIGHT. 9. VOICE/DATA WORKSTATION & MEDICAL EQUIPMENT DEVICES INCLUDE, BUT ARE NOT LIMITED TO THE FOLLOWING: A. PCS B. TRACKER MONITORS C. COPIERS D. WIRELESS ACCESS POINTS E. SCANNERS F. ULTRA SOUND MACHINE H. LAB EQUIPMENT (STERILIZERS, ETC.) I. ADDITIONAL MEDICAL EQUIPMENT															
ABBREVIATIONS: • DIV 08 - DOOR HARDWARE CONTRACTOR • DIV 26 - ELECTRICAL CONTRACTOR • DIV 27 - COMMUNICATIONS CABLING CONTRACTOR • DIV 28 - ELECTRONIC ACCESS CONTROL/SECURITY CONTRACTOR • OWNER - OWNER OR OWNER'S VENDOR • NC - NURSE CALL VENDOR • PB - CENTURION PANIC BUTTON VENDOR • ME - MEDICAL EQUIPMENT PLANNER • TV - TELEVISION VENDOR • SP - SERVICE PROVIDER • GC - GENERAL CONTRACTOR • PM - PHYSIOLOGICAL MONITORING VENDOR • N/A - NOT APPLICABLE • TEC - TELECOMMUNICATIONS EQUIPMENT ROOM / IDF • TDR - TELECOMMUNICATIONS DISTRIBUTION ROOM / IDF															

Devenney GROUP
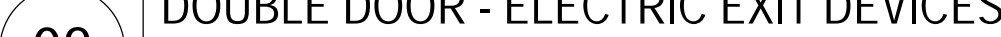
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Consultant:

WSP

PROFESSIONAL SEAL OF ARCHITECT
ANDY SEAN WILDER
REGISTERED PROFESSIONAL ARCHITECT
MISSOURI
05/29/2025
WSP USA Buildings Inc. 2013001881

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ADMINISTRATION
RELOCATION

HCA - LEE'S SUMMIT MEDICAL
CENTER

2000

SE BLUE PKWY

LEE'S SUMMIT, MO 64063

AUTHORITY HAVING JURISDICTION:
CITY OF LEE'S SUMMIT BUILDING DEPT.
MISSOURI DHSS

FACILITY NUMBER:
0972400009

AGENCY APPROVALS:

REVISIONS

REV #	DESCRIPTION	DATE
A	CITY - 2ND REVIEW	2025/05/29

DATE:

04/18/2025

SCALE:

1/8" = 1'-0"

DRAWN:

FT

REVIEWED:

MC


JOB NUMBER:

6406.24

SCHEDULES - TECHNOLOGY

T08-01

6/4/2025 1:33:34 PM Autodesk Docs/16406.24 - HCA - Lee's Summit Medical Center (LSMC)_r1231/MEP_LSMC_Admin Relocation_R23.rvt Notice of Alternate Billing or Payment Cycle: The Owner may plan to make payments on an alternative schedule. A written description of such billing or payment cycle applicable to the Project is available from the Owner or the Owner's designated agent upon request.

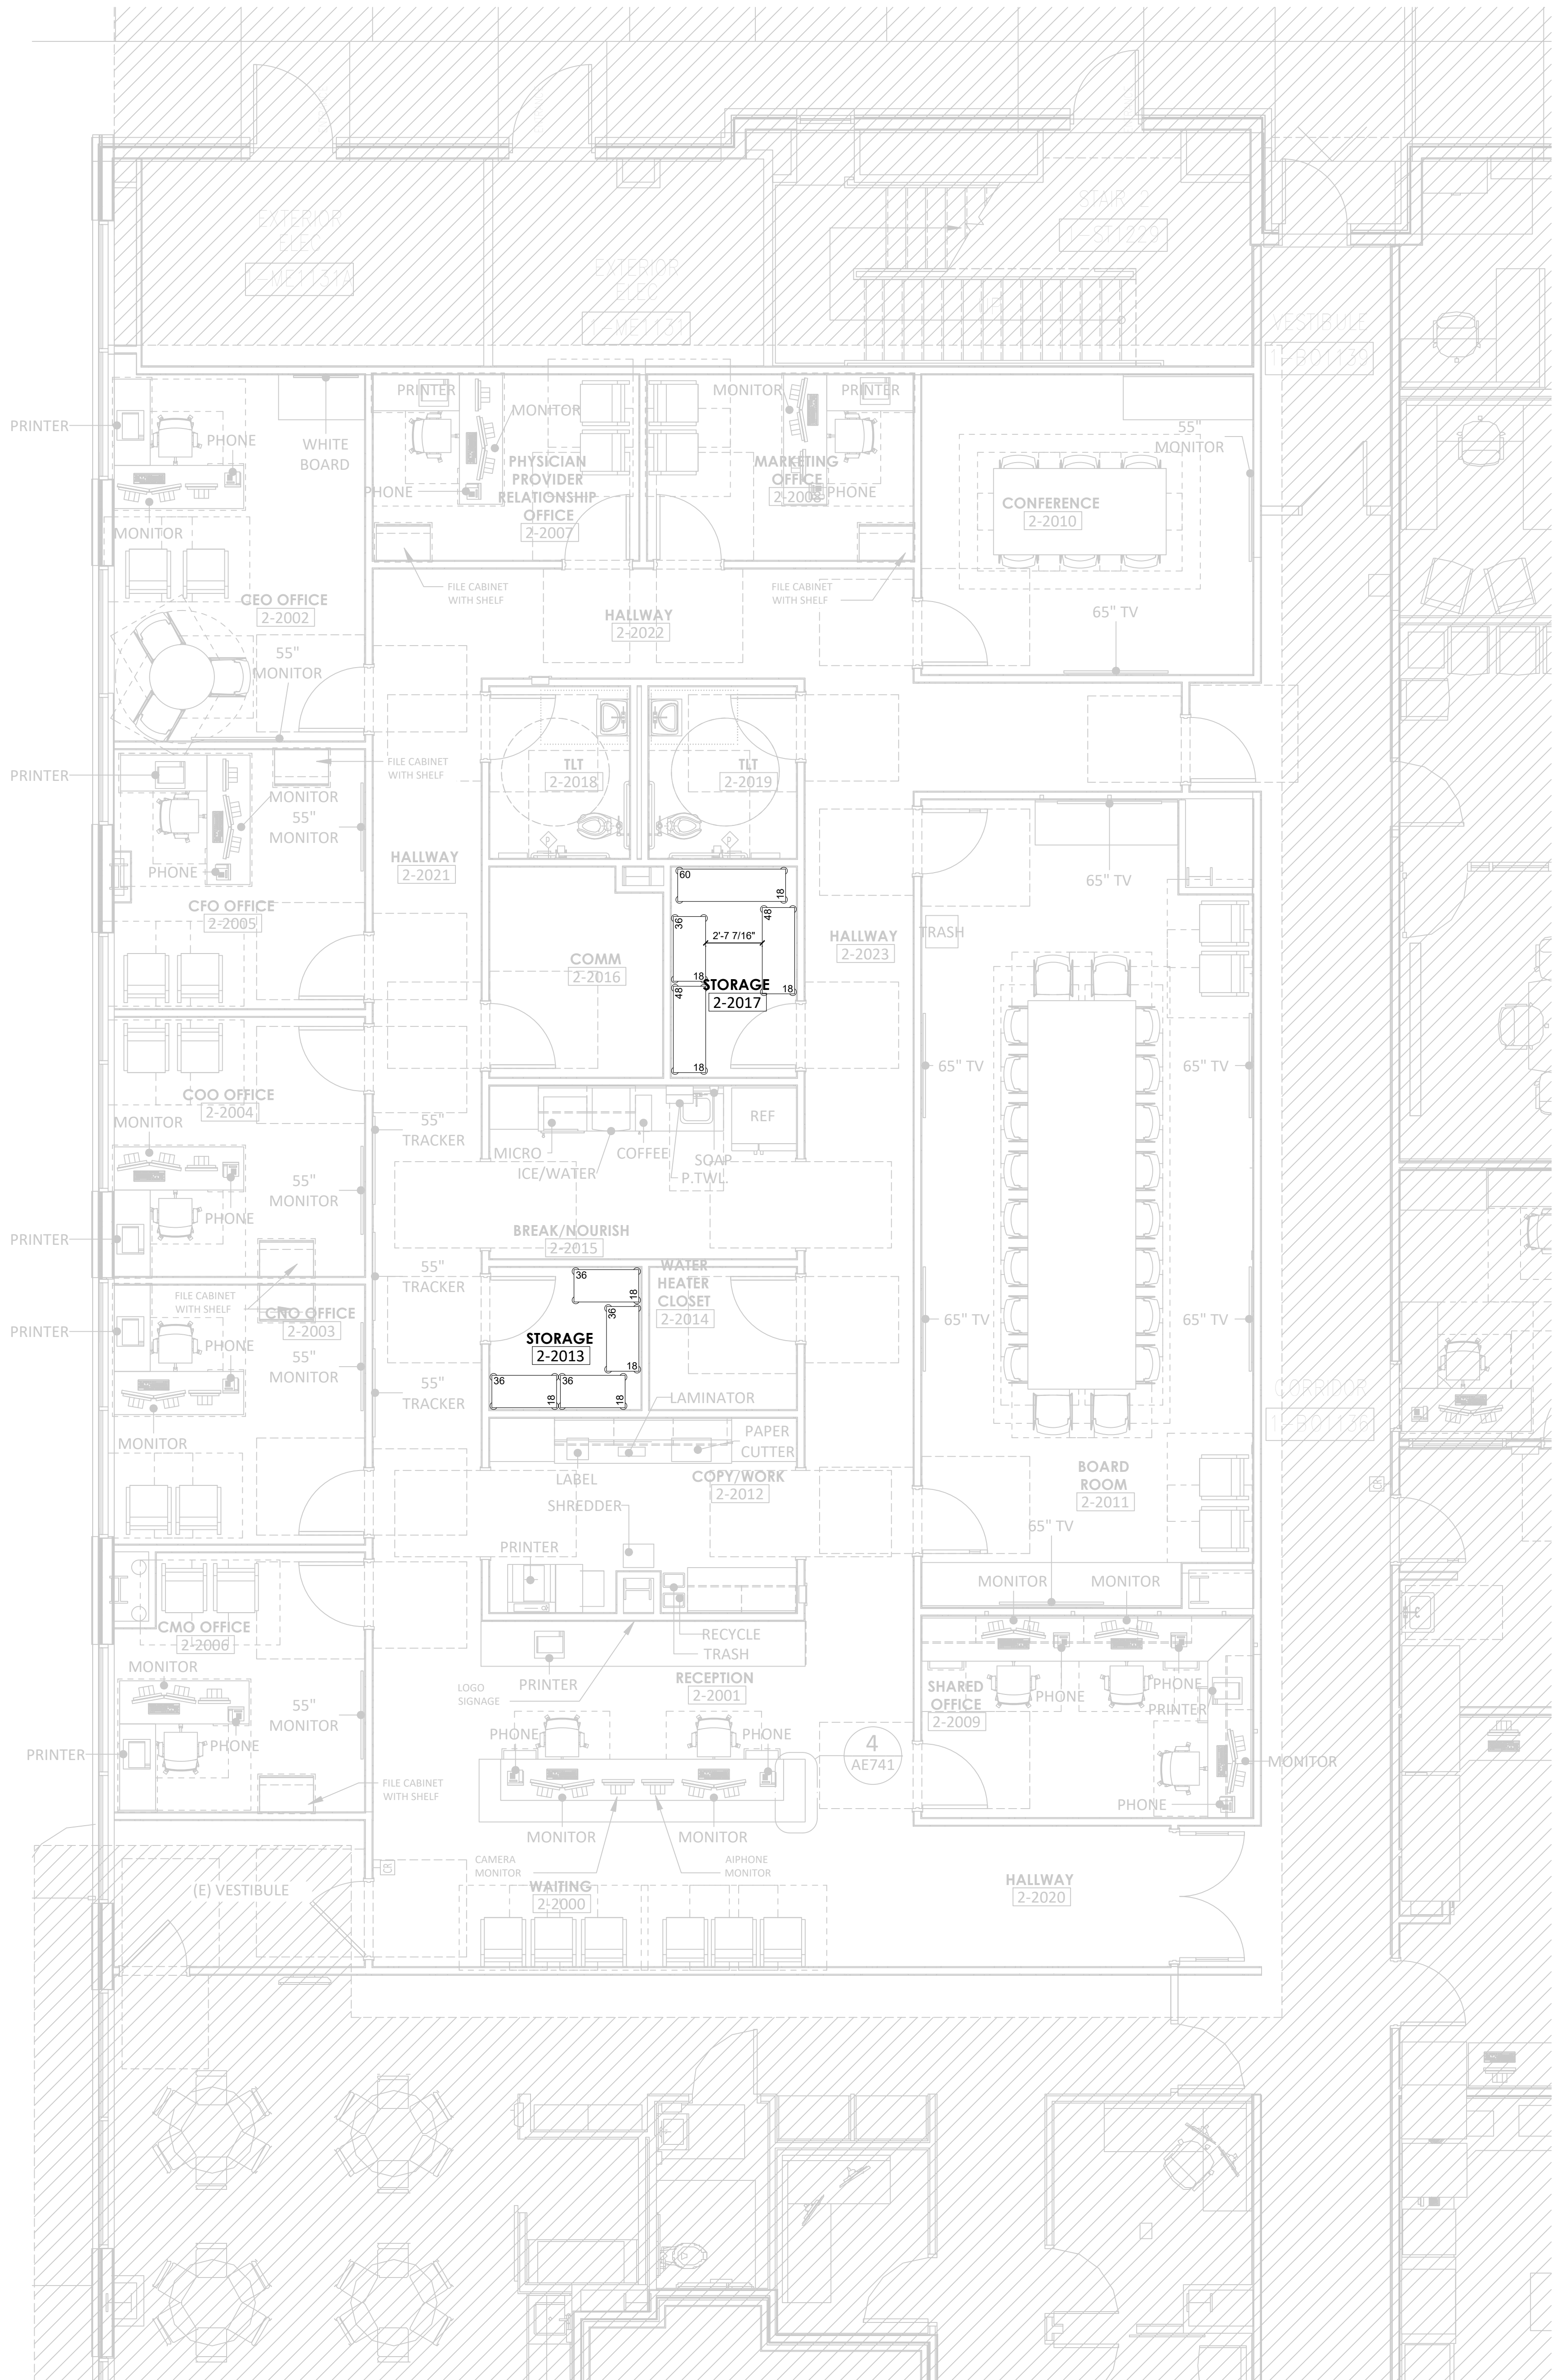

ARCH. FIRM: DEVENNEY GROUP

Storage Systems

UNLIMITED

A CME Corp Company

ARCH. DATE: 03-06-2025

PROJ. MANAGER: CA

DWN. BY: DB

SCALE: 1/4"=1'-0"

SS REV. -

LEE'S SUMMIT MEDICAL CENTER

2000 SE BLUE PKWY LEE'S SUMMIT, MO 64063

ADMIN


ISSUE DATE: 04-11-2025

STORAGE SYSTEMS LAYOUT

QUOTE #: 150745


DRAWING #

SS-1

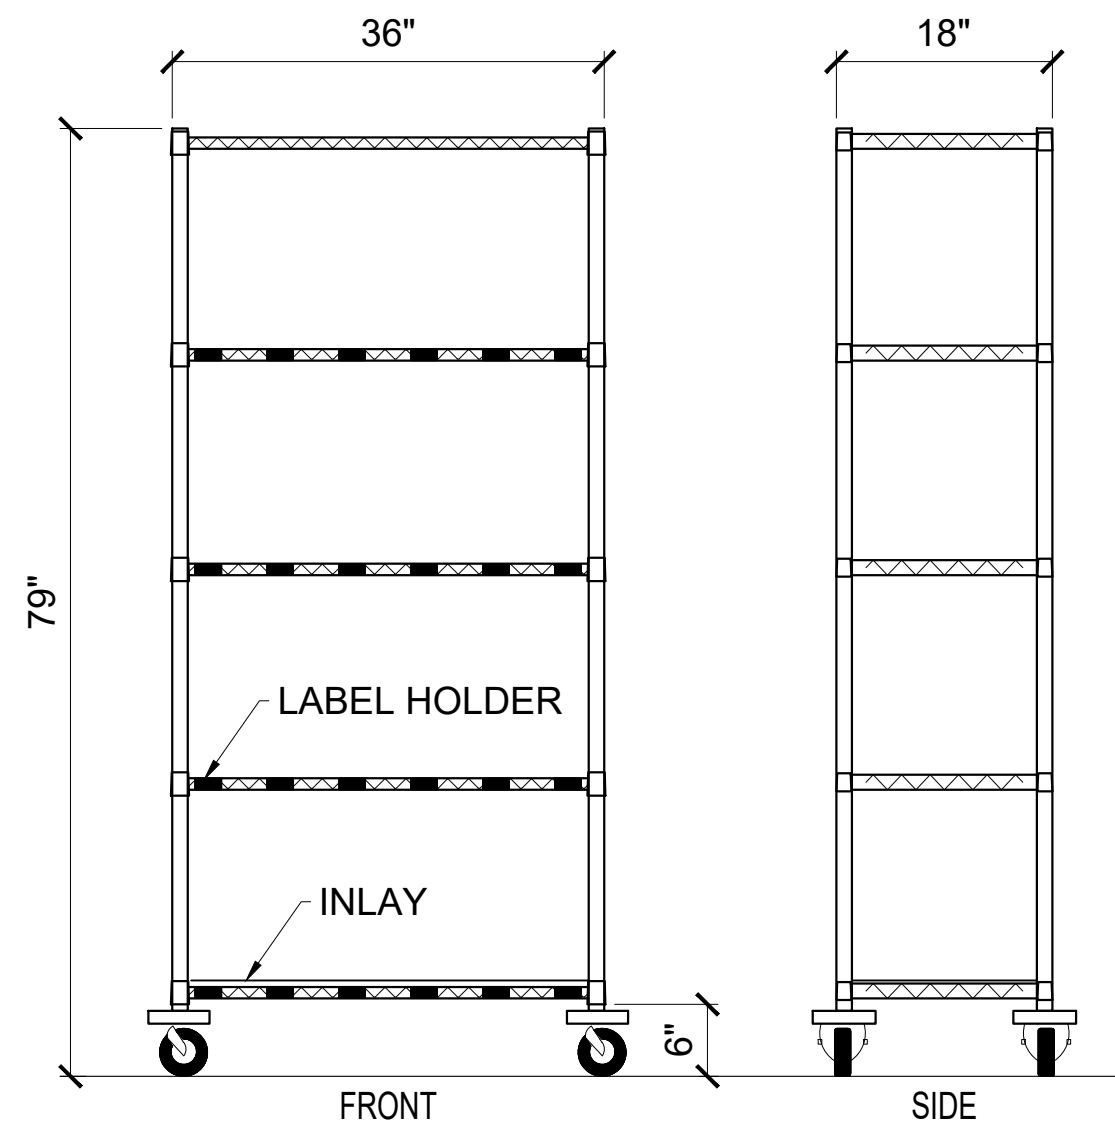


#SSUKIT1275
WIRE SHELVING 36"W x 18"D x 79"H
5 SHELVES WITH CASTERS
QUANTUM

Room
2-2013
2-2017

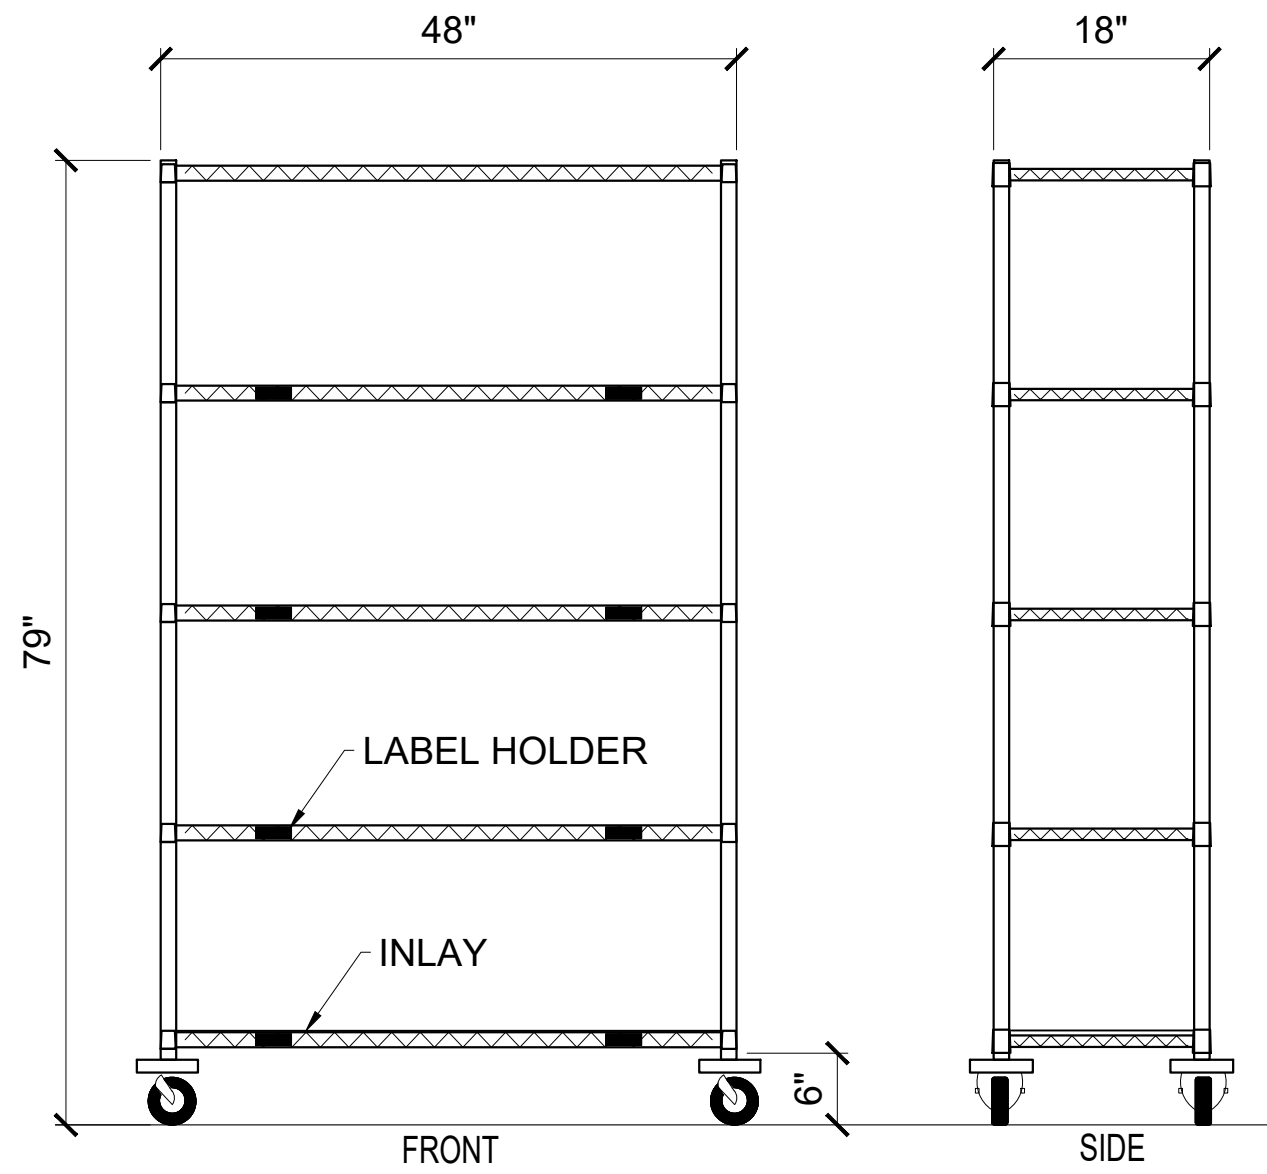

#SSUKIT1291
WIRE SHELVING 48"W x 18"D x 79"H
5 SHELVES WITH CASTERS
QUANTUM

Room
2-2017

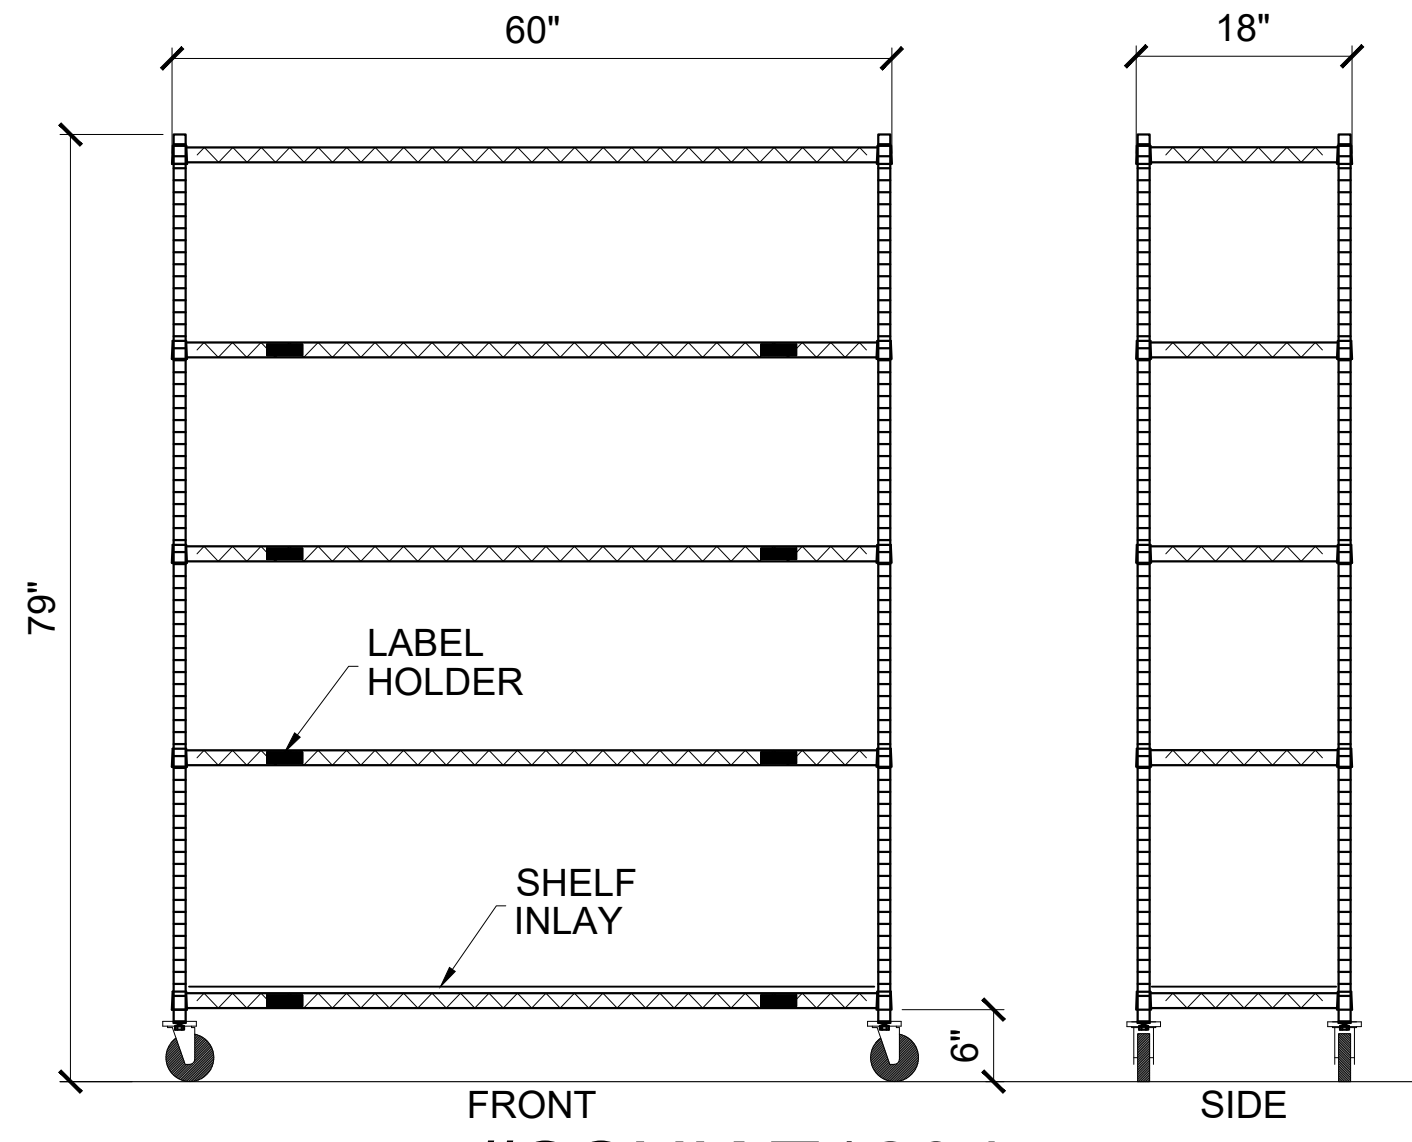

#SSUKIT1294
WIRE SHELVING 60"W x 18"D x 79"H
5 SHELVES WITH CASTERS
QUANTUM

Room
2-2017

ARCHITECT / CONTRACTOR NOTE:
① VERIFY LOCKER LOCATION TO A HEIGHT OF 84" AFF. IS FREE AND CLEAR OF ANY OBSTRUCTIONS SUCH AS: CLOCKS, TELEPHONE JACKS, ELECTRICAL OUTLETS, LIGHT SWITCHES, FIRE ALARMS, THERMOSTATS, CALL BOXES, ETC...
② CLARIFY ALL OBSTRUCTIONS WITH A DESCRIPTION AND DIMENSION TO THE OBSTRUCTION.
INSTALLER NOTE:
① VERIFY CEILING HEIGHTS.
② RETURN ALL INFORMATION TO STORAGE SYSTEMS UNLIMITED WITH ANY OTHER PERTINENT INFORMATION.
③ VERIFY ALL ROOM DIMENSIONS INCLUDING DOOR OPENINGS, WINDOW OPENINGS, AND COLUMNS.

ARCH. FIRM: DEVENNEY GROUP

StorageSystems

UNLIMITED

A CME Corp Company

ARCH. DATE: 03-06-2025

PROJ. MANAGER: CA

DWN. BY: DB

SCALE: NTS

SS REV. .

LEE'S SUMMIT MEDICAL CENTER

2000 SE BLUE PKWY LEE'S SUMMIT, MO 64063

ADMIN

ISSUE DATE: 04-11-2025

EQUIPMENT ELEVATIONS

QUOTE #: 150745

DRAWING #

SS-2