
A. REFER TO P00-00 FOR GENERAL PLUMBING NOTES AND SYMBOLS.

LEGEND NOTES

- 2" GREASE WASTE FROM HAND SINK.
 4" GREASE WASTE FROM FLOOR SINK.
- 2" VENT UP.
- 4. 4" GREASE WASTE FROM FLOOR TROUGH. 5. 4" VENT UP.
- 6. 3" SANITARY FROM FUNNEL FLOOR DRAIN. UPTO FCO.
- 8. 2" GREASE WASTE FROM DISPOSER. 9. 3" GREASE WASTE FROM TROUGHVEYOR.
- 10. 3" GREASE WASTE FROM MOP SINK. 11. 4" SANITARY FROM WATER CLOSET. 12. 2" SANITARY FROM LAVATORY.

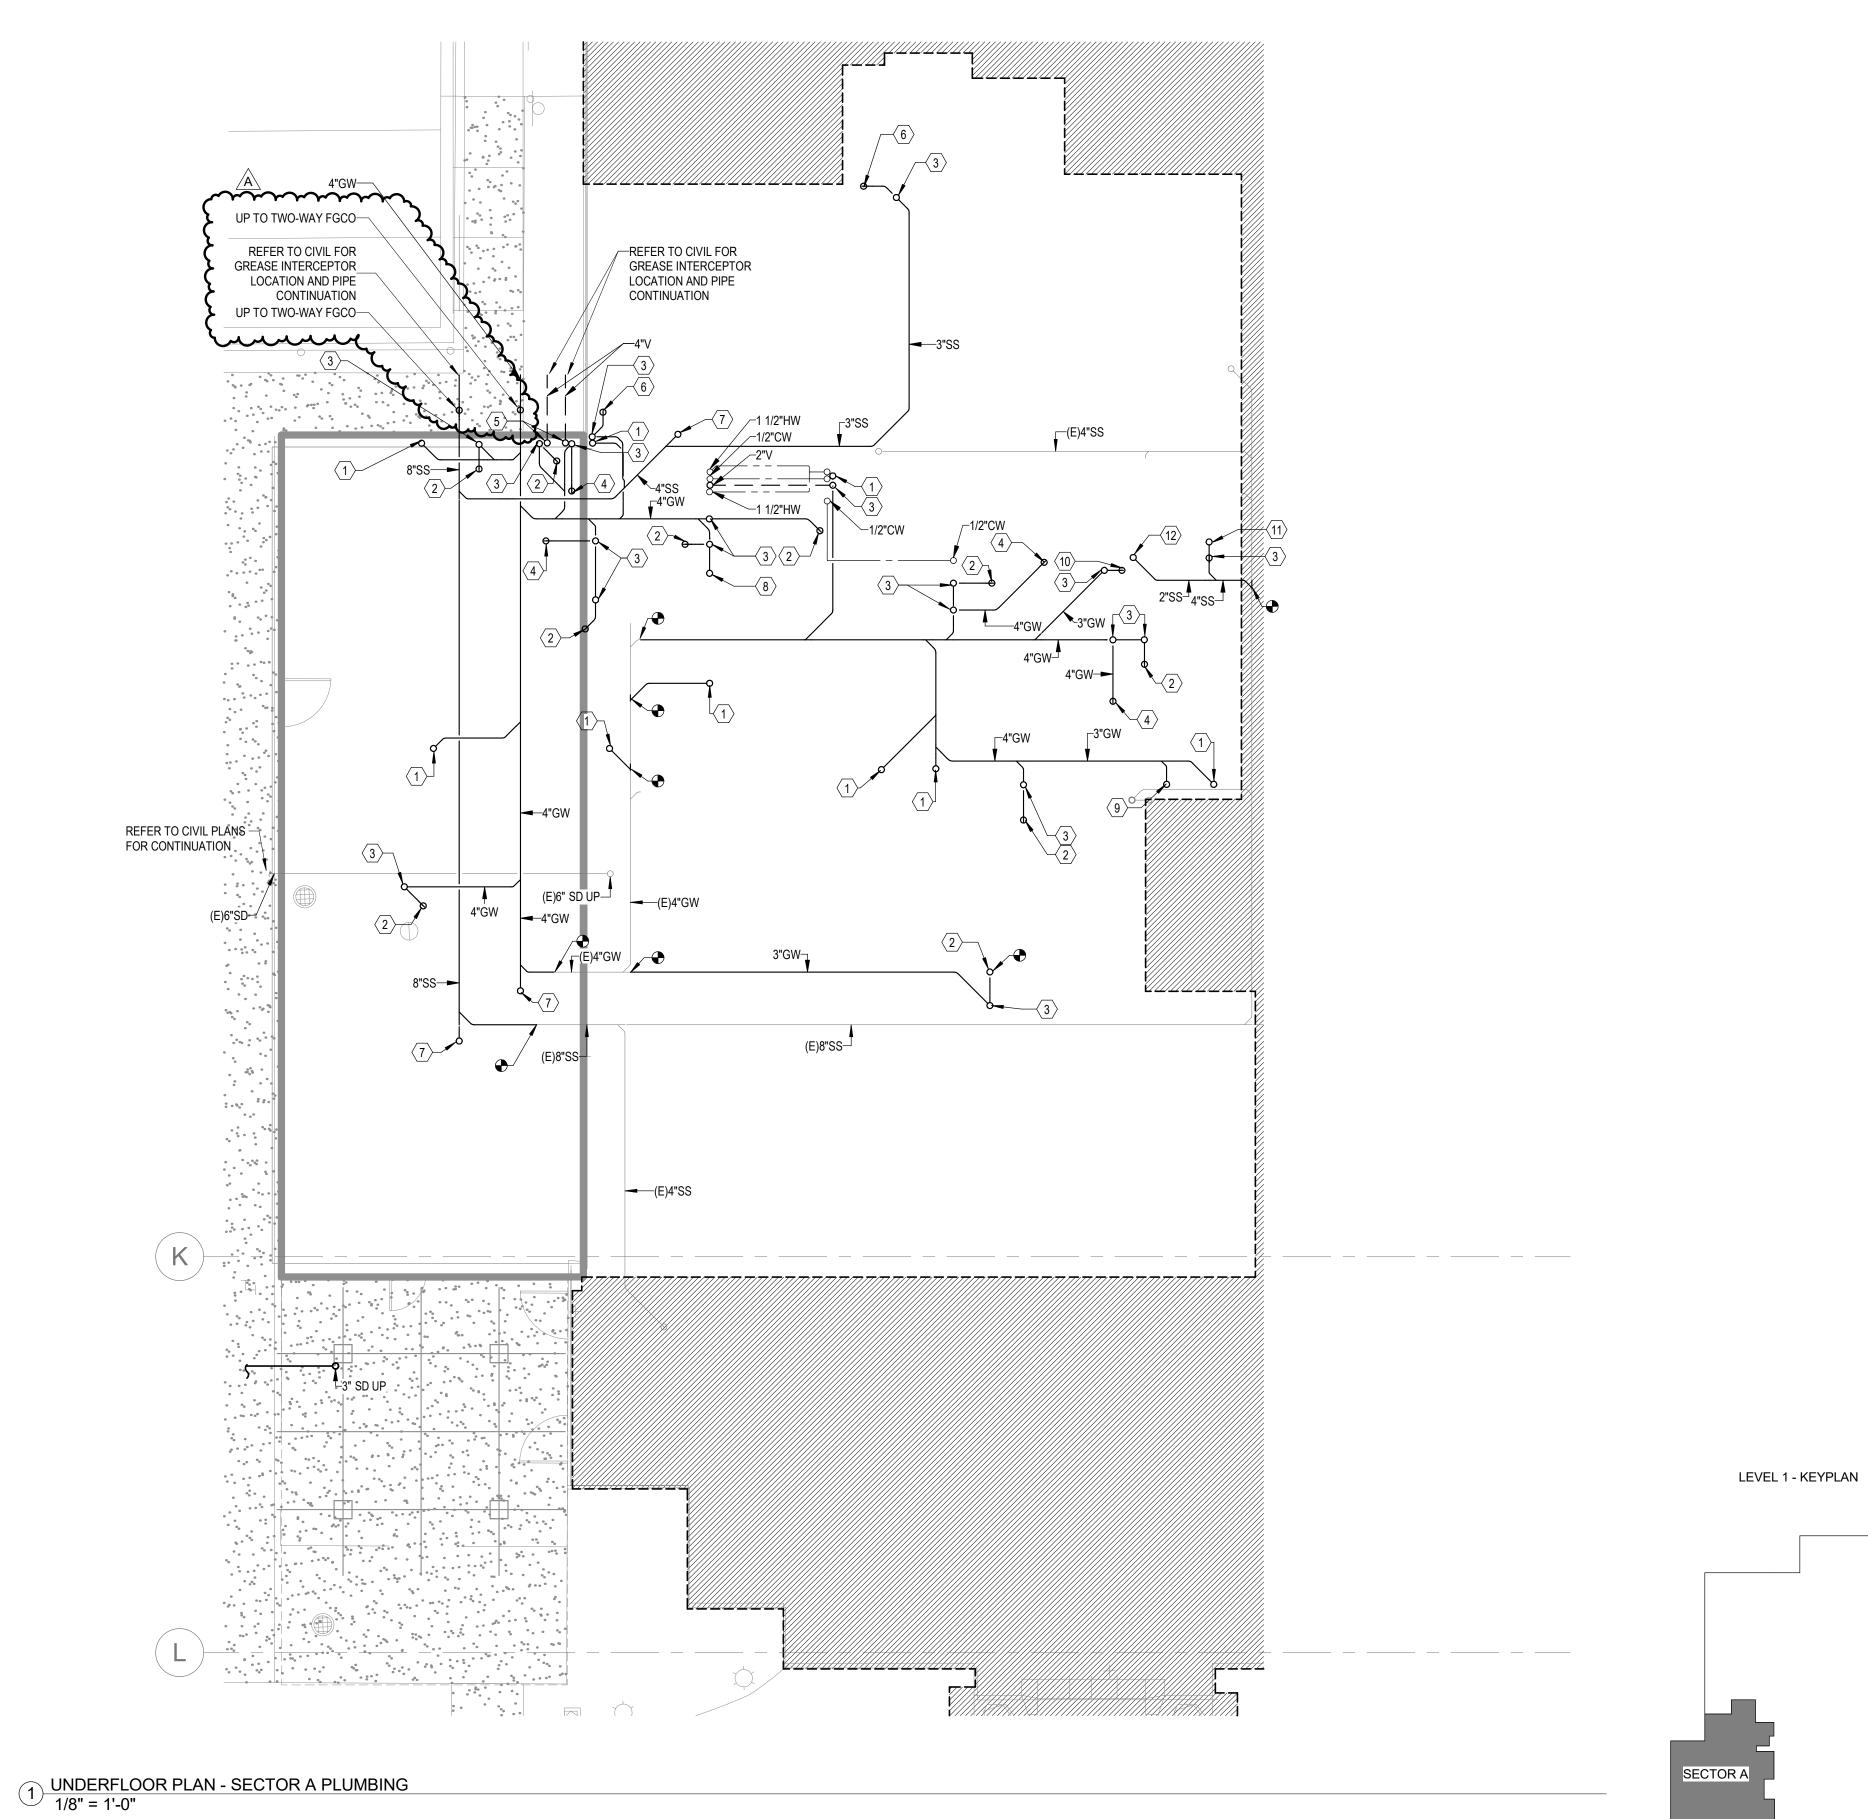




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> **INPATIENT BED EXPANSION**

HCA - LEE'S SUMMIT MEDICAL CENTER 2100 SE BLUE PKWY LEE'S SUMMIT, MO 64063

AUTHORITY HAVING JURISDICTION: CITY OF LEE'S SUMMIT BUILDING DEPT. MISSOURI DHSS

AUTHORITY HAVING JURISDICTION'S PROJECT NO:

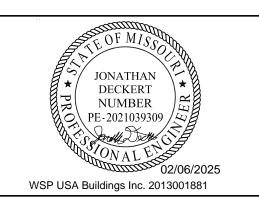FACILITY NUMBER: 0972400009

AGENCY APPROVALS:

REVISIONS DESCRIPTION DATE 2025/02/06 CITY - 2ND REVIEW

DATE:

DRAWN:

REVIEWED: 1/8" = 1'-0" 9 JOB NUMBER: 6406.24

UNDERFLOOR PLAN -PLUMBING

P02-00

A. REFER TO P00-00 FOR GENERAL PLUMBING NOTES AND SYMBOLS.

LEGEND NOTES

- 1. 1/2" COLD WATER FILTERED FOR CUBE ICE MAKER. 2. 1/2" COLD WATER FILTERED FOR AMBIENT CARBONATOR.
- 3. 1/2" COLD WATER FILTERED FOR COFFEE BREWER.
- 5. 1/2" COLD WATER FILTERED FOR ICED TEA BREWER.
- 7. 1/2" HOT & COLD WATER FOR HAND SINK.
- 9. 1/2" HOT & COLD WATER FOR PRE-RINSE UNIT. 10. 1/2" HOT & COLD WATER FOR TROUGHVEYOR.
- 20. 1/2" HOT & COLD WATER FOR SUPPLY. 21. 1/2" HOT WATER FOR PRE-RINSE UNIT.
- 23. 1" GAS @ 80,000 BTU's FOR FILTER ASSEMBLY. 24. 3/4" GAS @ 84,000 BTU's FOR COUNTERTOP GRIDDLE.
- 26. 3/4" GAS @ 180,000 BTU's FOR COUNTERTOP 6-BURNER RANGE.
- 28. 1" COLD WATER FOR HIGH TEMP FLIGHT TYPE DISH MACHINE.
- 31. 1/2" HOT & COLD WATER FOR HOSE REEL MIXING CABINET.
- 33. 1/2" FILTERED WATER FROM BELOW SERVING ICE DISPENSER, ICED TEA BREWER AND
- COFFEE BREWER.
- 34. 3/4"RPZ. 35. 1/2"RPZ. 36. EMERGENCY GAS SHUT-OFF VALVE INTERLOCKED WITH ANSUL SYSTEM.
- PAD. IF EXISTING FLOOR DRAIN CONFLICTS WITH NEW EQUIPMENT PAD DIMENSIONS, DEMOLISH EXISTING FLOOR DRAIN AND PROVIDE NEW FLOOR DRAIN AND CONNECT TO

FOR FIXTURE SPECIFICATION

GENERAL NOTES

- 4. 1/2" COLD WATER FILTERED FOR SPECIALTY DRINK DISPENSER.
- 6. 1/2" COLD WATER FOR FILL FAUCET.
- 8. 3/4" COLD WATER FOR WATER FILTRATION ASSEMBLY.
- 11. 3/4" GAS @ 200,000 BTU's FOR 40 GAL. TILT SKILLET. 12. 1/2" HOT & COLD WATER FOR PANTRY FAUCET.
- 13. 3/4" GAS @ 72,000 BTU's FOR DOUBLE STEAMER. 14. 3/4" GAS @ 100,000 BTU's FOR DOUBLE CONVECTION OVEN.
 15. 3/4" GAS @ 115,000 BTU's FOR COMBI OVEN.
- 16. 1/2" COLD WATER FOR DOUBLE STEAMER.
- 17. 1/2" COLD WATER FILTERED FOR DOUBLE STEAMER. 18. 1/2" COLD WATER FOR COMBI OVEN.
- 19. 3/4" COLD WATER FILTERED FOR COMBI OVEN.

22. 3/4" COLD WATER FOR PRE-RINSE UNIT/DISPOSER.

- 25. 3/4" GAS @ 108,000 BTU's FOR COUNTERTOP CHARBROILER.
- 27. 1" HOT WATER @ 110 DEG MIN. FOR HIGH TEMP FLIGHT TYPE DISH MACHINE.
- 29. 1/2" COLD WATER FOR WATER FILTRATION ASSEMBLY. 30. 1/2" HOT & COLD WATER FOR HOSE BIBB.
- 32. 3/4" HOT & COLD WATER FOR FAUCET.
- 37. COORDINATE EXISTING FLOOR DRAIN LOCATION WITH NEW MECHANICAL EQUIPMENT

EXISTING BRANCH PIPING.

FIXTURE SPECIFICATION. 40. FLOOR TROUGH PROVIDED BY KITCHEN CONTRACTOR. REFER TO KITCHEN DRAWINGS . Devenney GROU

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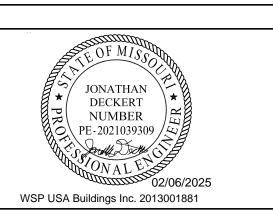
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MISSOURI DHSS

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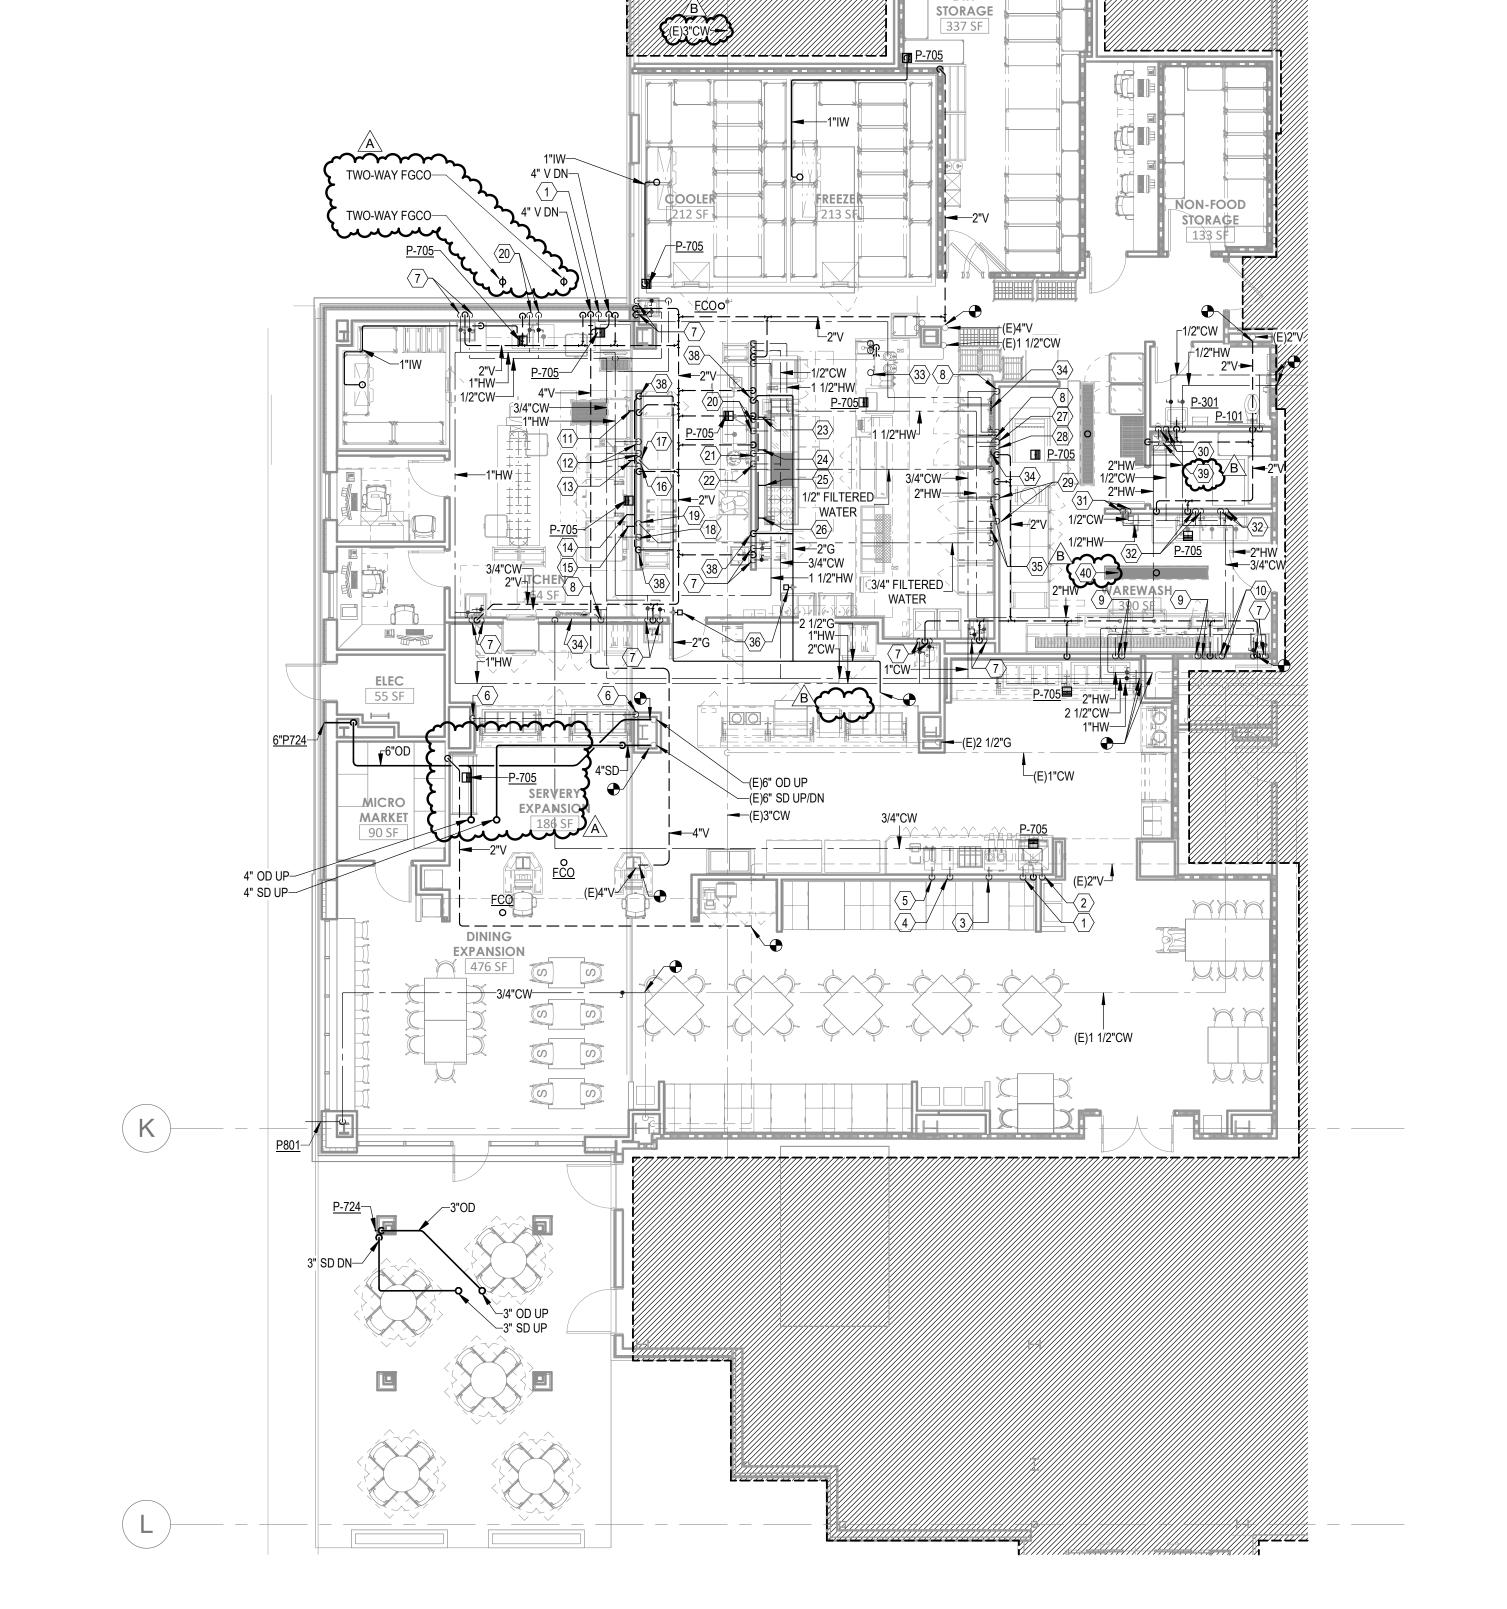
LEVEL 1 - KEYPLAN

REVISIONS DATE DESCRIPTION 2025/02/06 CITY - 2ND REVIEW 2025/02/06 DESIGN COORDINATION

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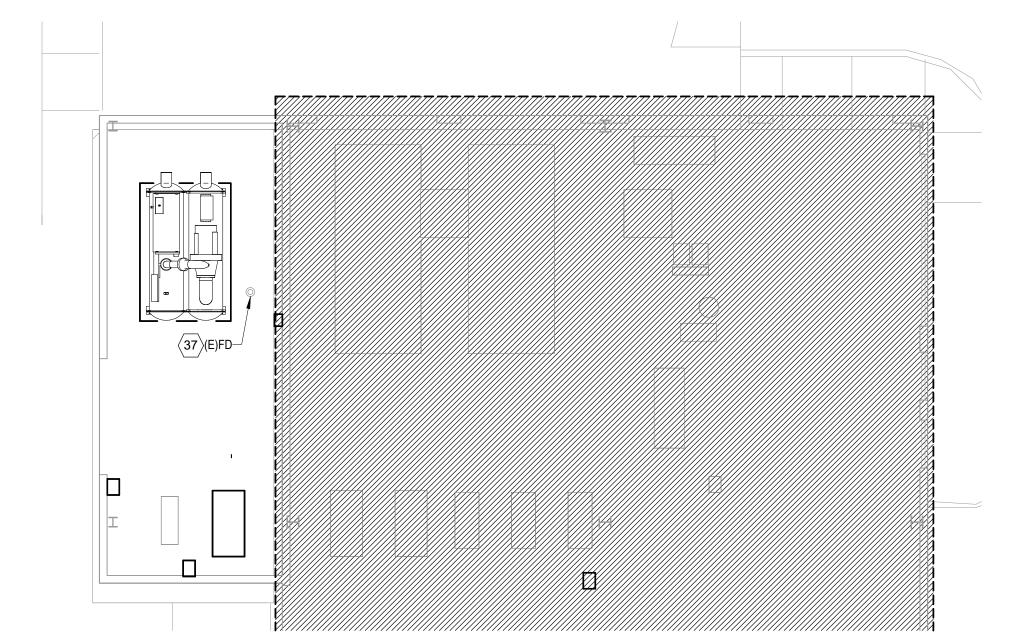
FLOOR PLAN - LEVEL 1 -SECTOR A - KITCHEN, SERVERY & DINING -PLUMBING

P02-01



12.6

1/8" = 1'-0" FLOOR PLAN - LEVEL 1 - SECTOR A - KITCHEN, SERVERY & DINING - PLUMBING



2 FLOOR PLAN - LEVEL 01 - SECTOR C - PLUMBING 1/8" = 1'-0"

A. REFER TO P00-00 FOR GENERAL PLUMBING NOTES AND SYMBOLS.

LEGEND NOTES

CONNECT TO EXISTING 4"V PIPING ABOVE SECOND FLOOR CEILING.
 CONNECT TO EXISTING 6" STORM DRAIN STACK.
 CONNECT TO EXISTING 6" OVERFLOW DRAIN STACK.

4. EXTEND EXISTING 6" FIRE STANDPIPE UP TO THIRD LEVEL.





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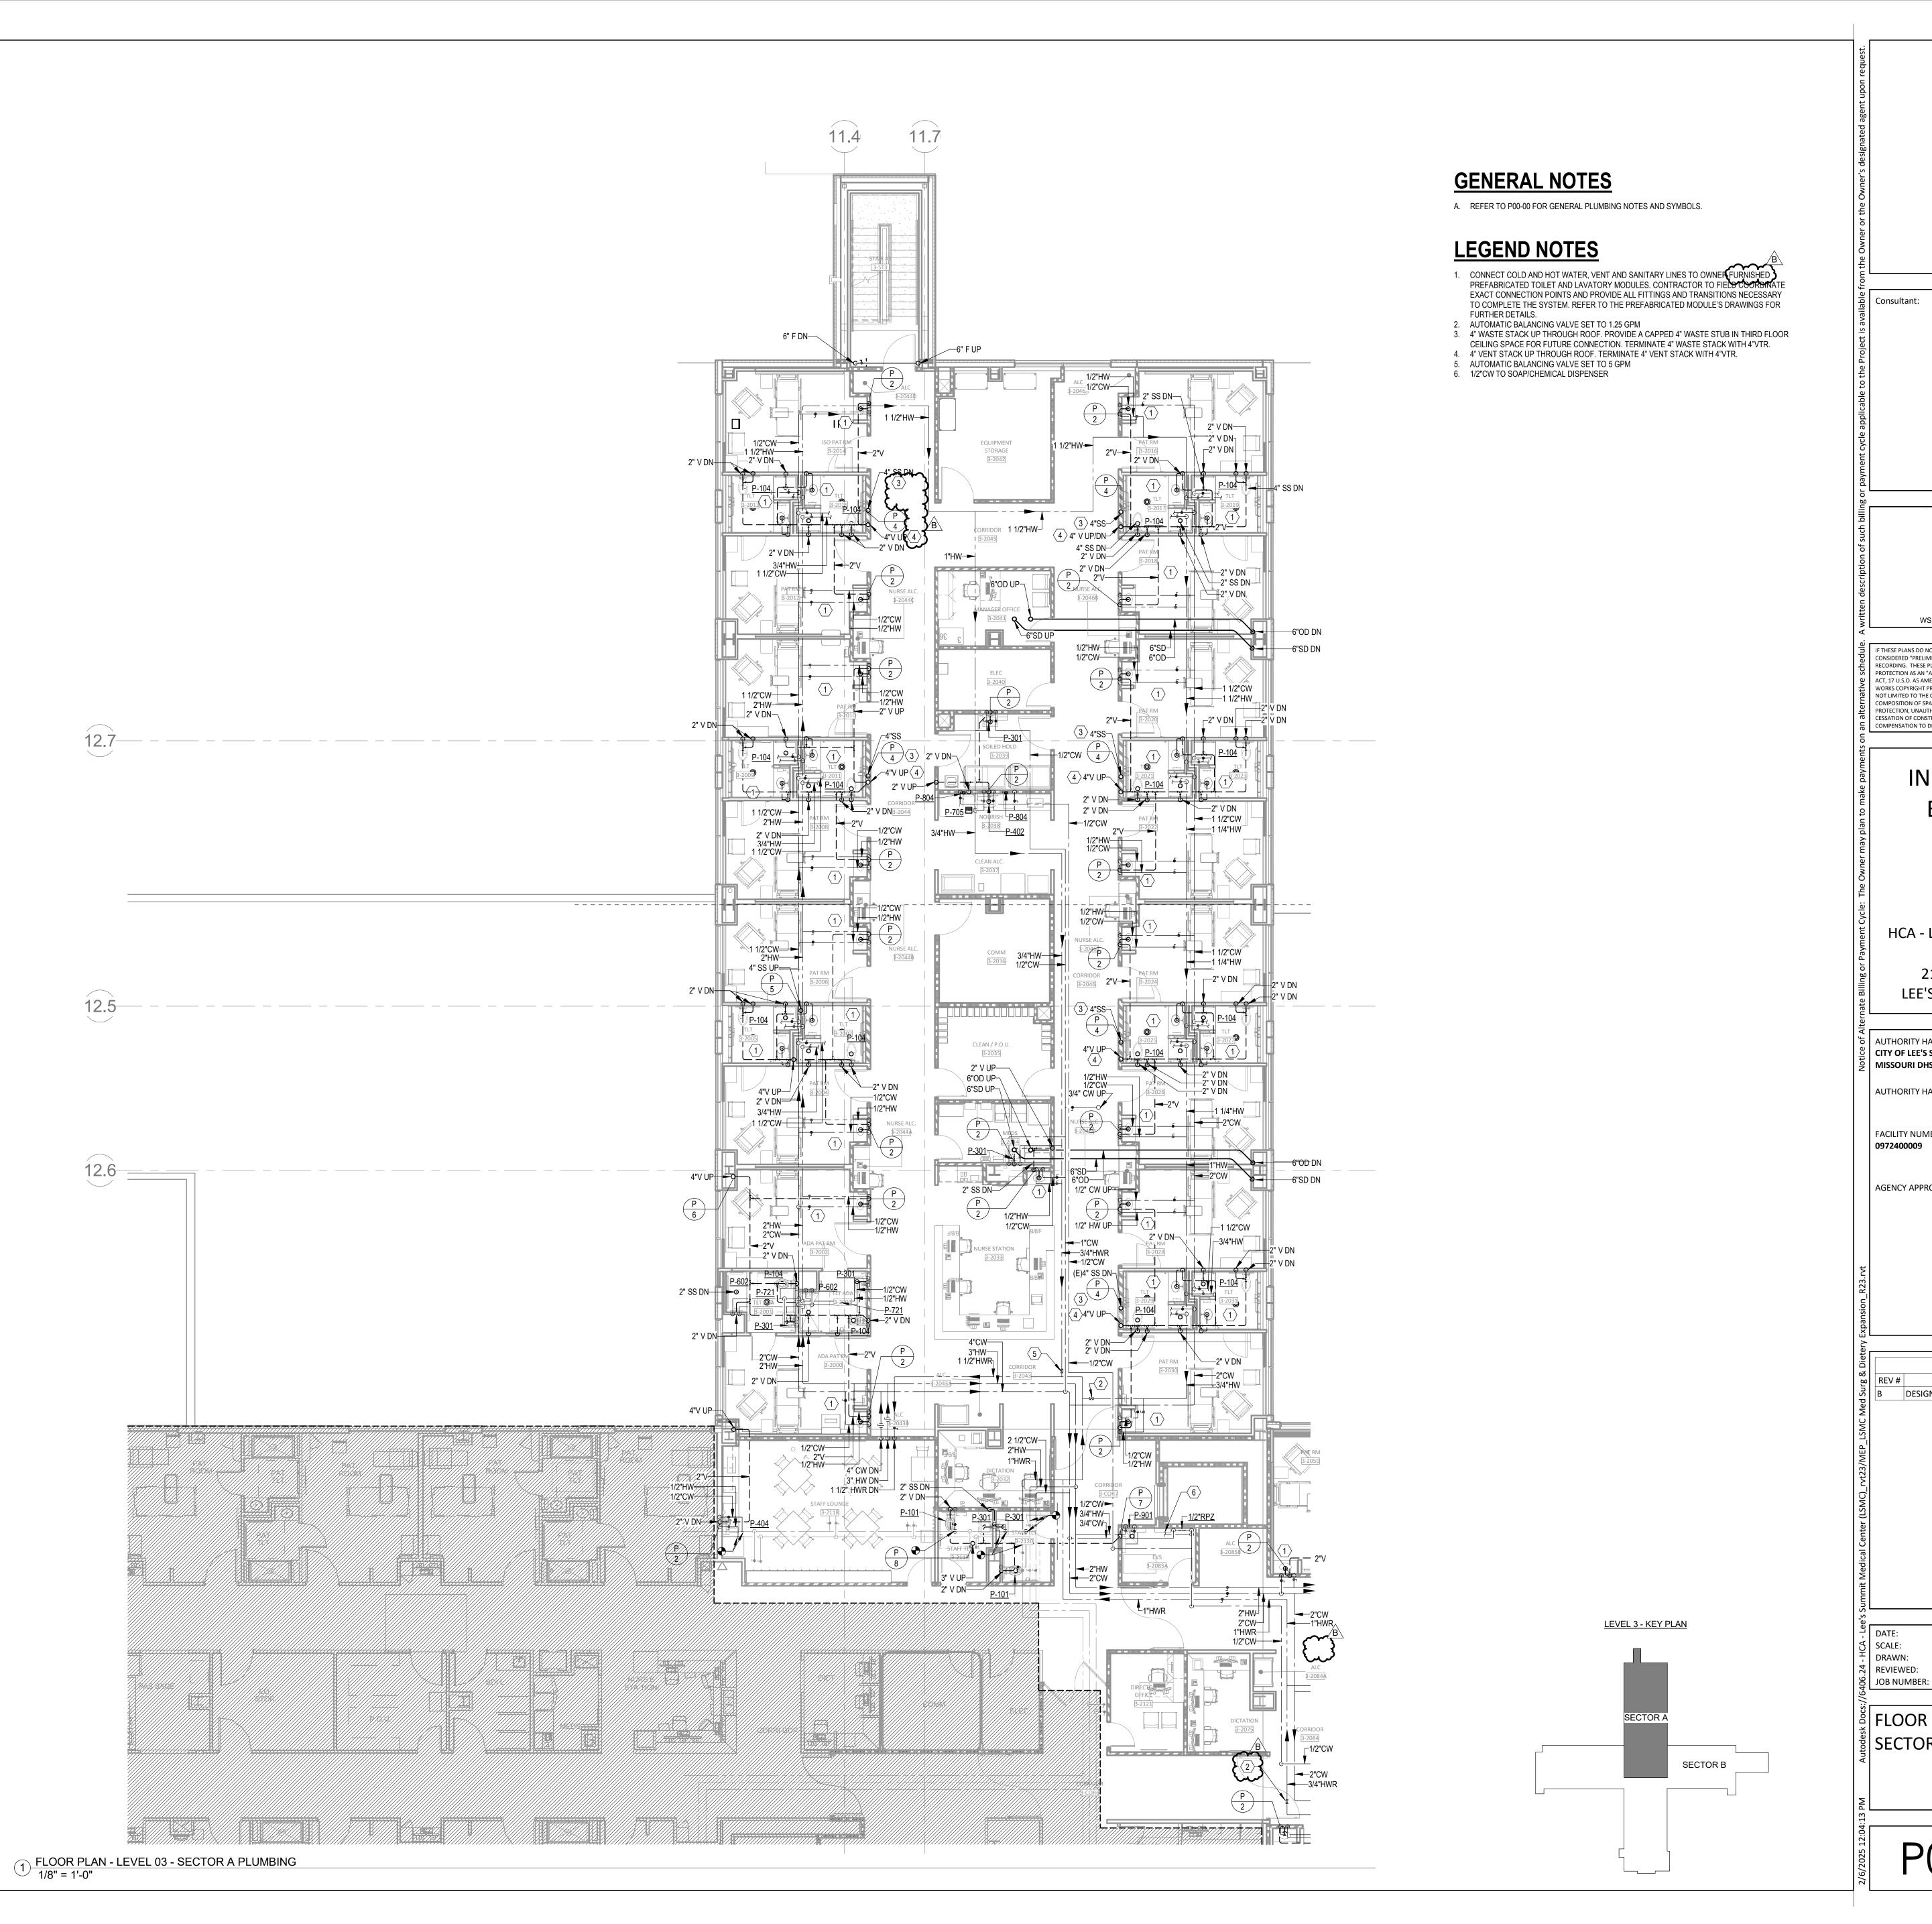
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FLOOR PLAN - LEVEL 02 - SECTOR B - PLUMBING

LEVEL 2 - KEY PLAN

P02-02B

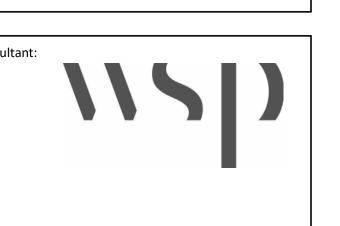

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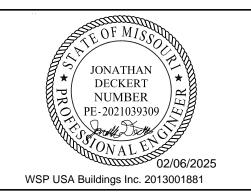
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FLOOR PLAN - LEVEL 03 -SECTOR A - PLUMBING

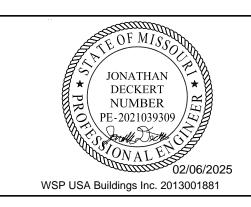P02-03A


A. REFER TO P00-00 FOR GENERAL PLUMBING NOTES AND SYMBOLS.

LEGEND NOTES


1. DEMOLISH EXISTING COLD, HOT AND HOT WATER RETURN PIPING TO BELOW FLOOR.
REFER TO NEW PLUMBING PLANS FOR NEW VENT ROUTING.

2. AUTOMATIC BALANCING VALVE SET TO 1.25 GPM

3. AUTOMATIC BALANCING VALVE SET TO 5 GPM

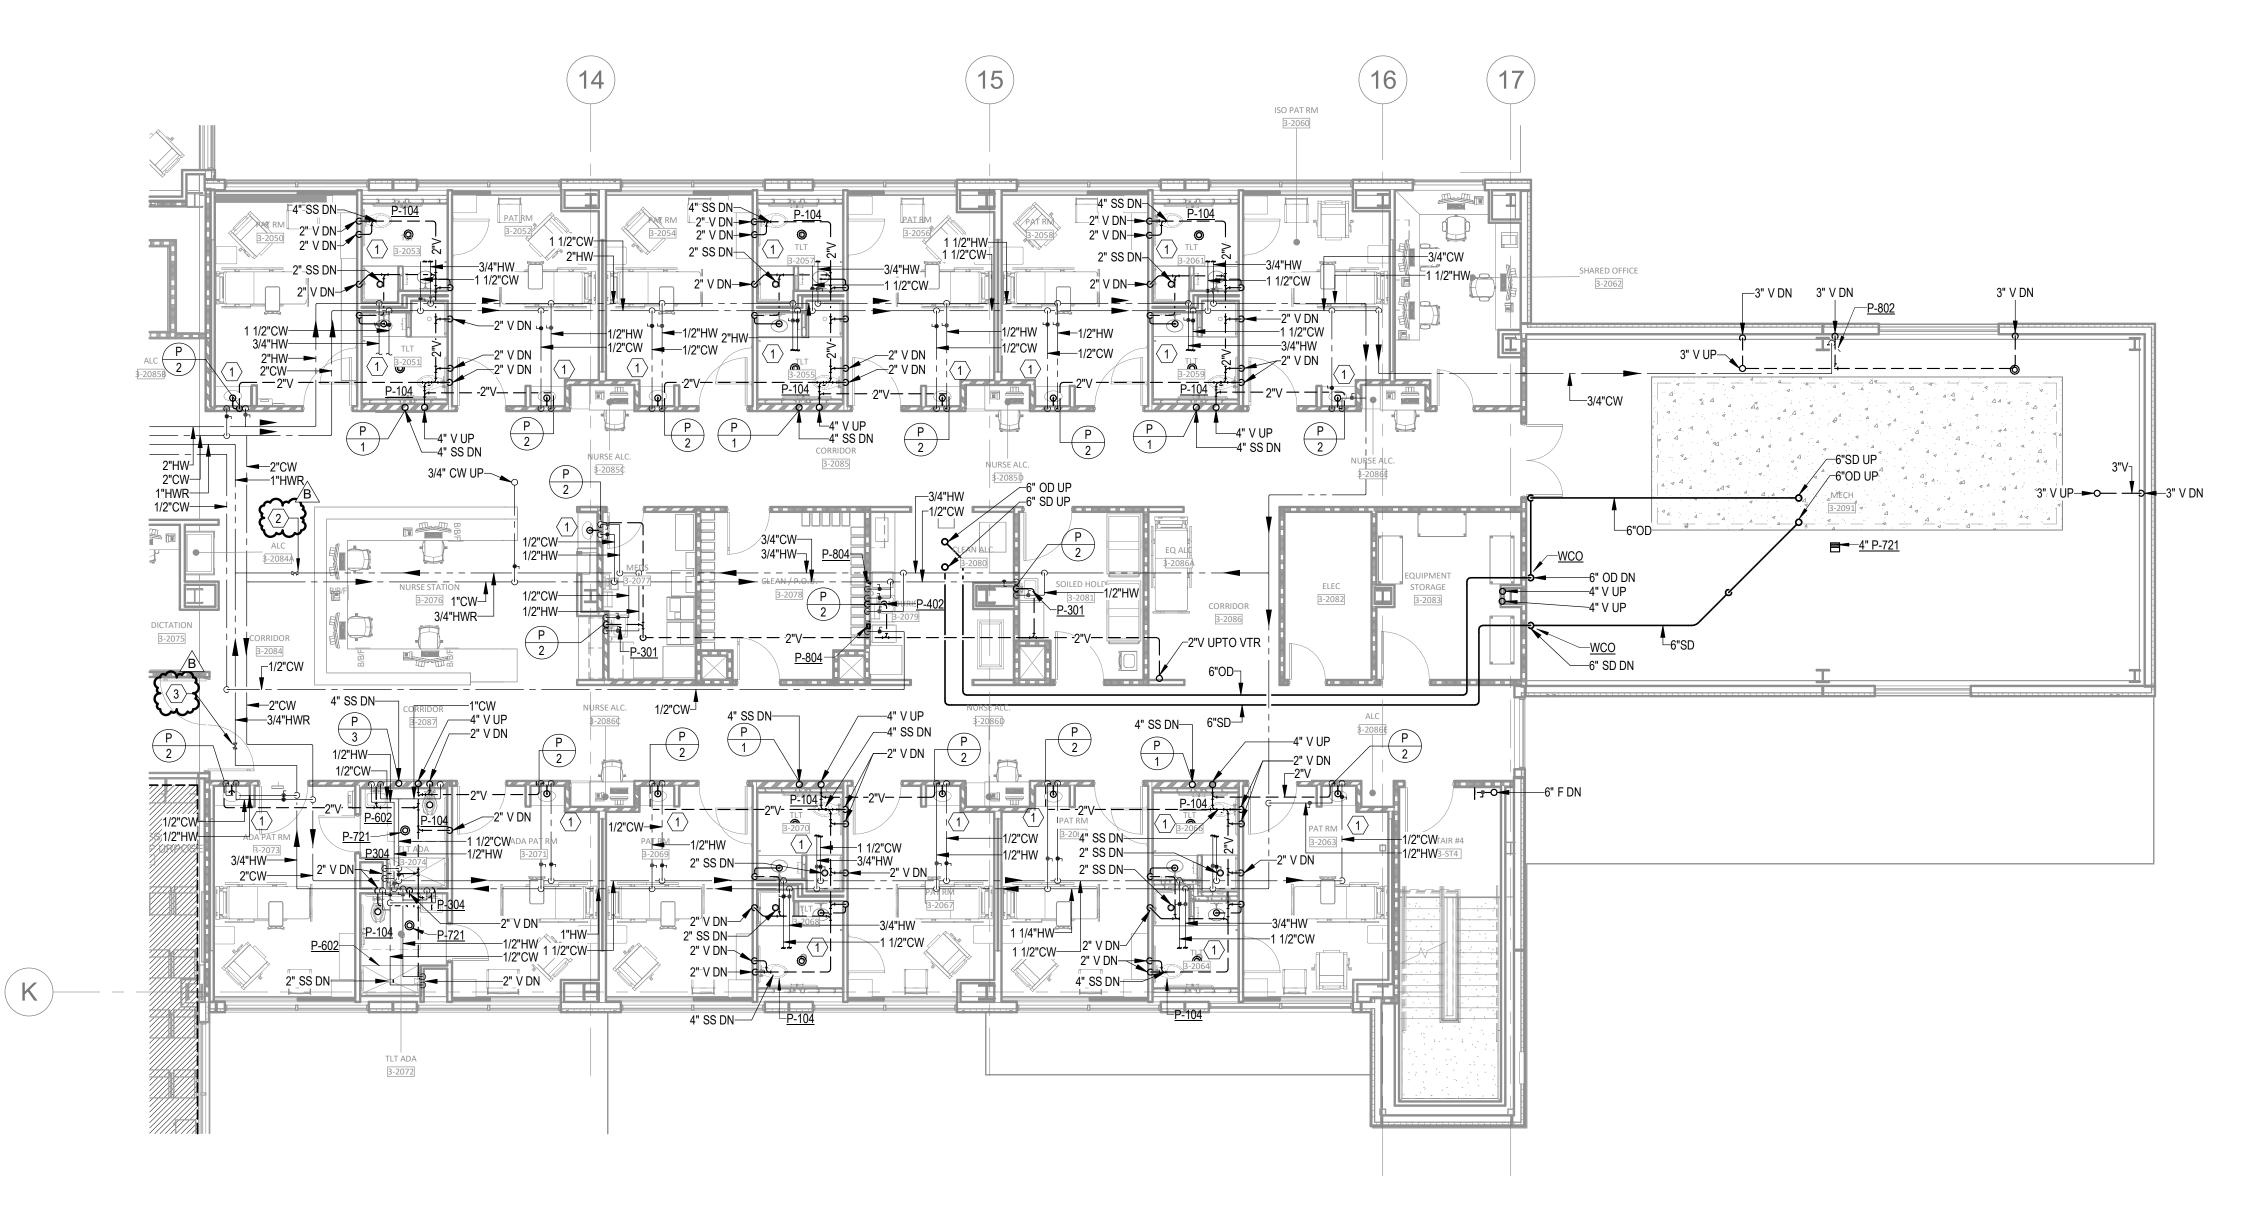

1 FLOOR PLAN - LEVEL 03 - SECTOR B PLUMBING 1/8" = 1'-0"

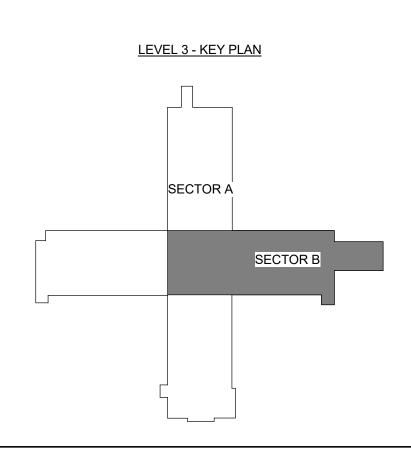


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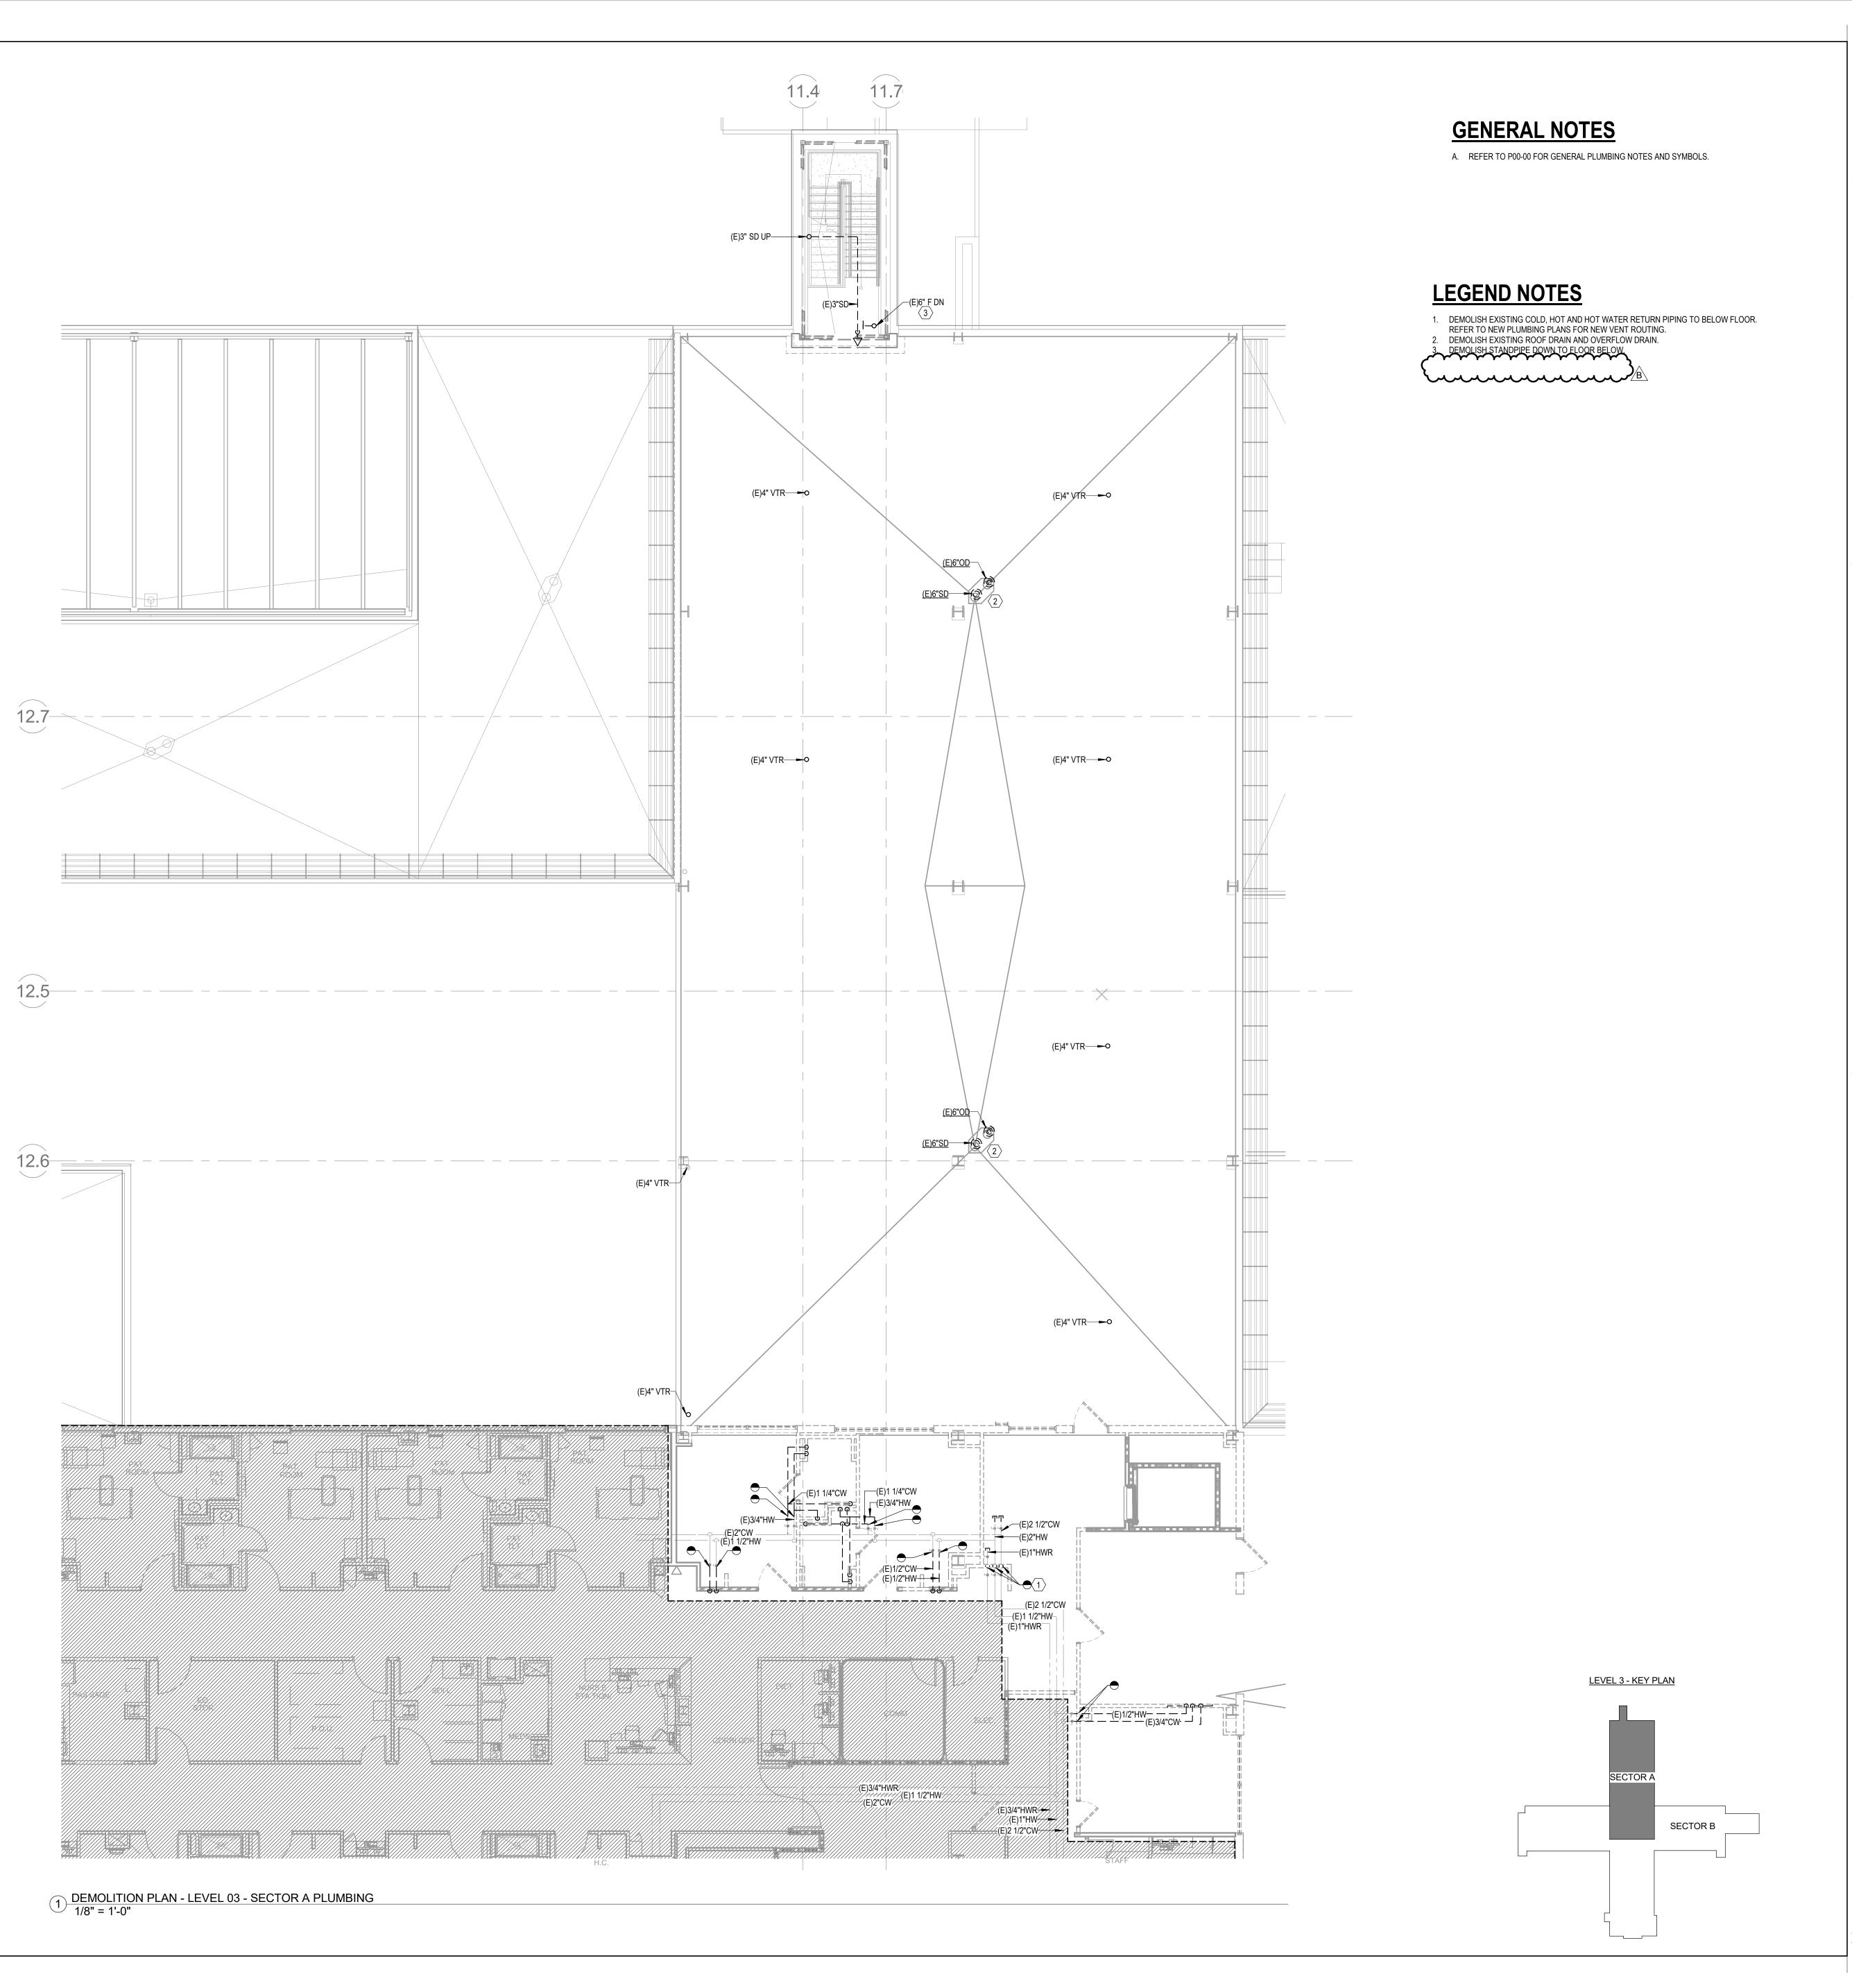
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FLOOR PLAN - LEVEL 03 SECTOR B - PLUMBING

P02-03B




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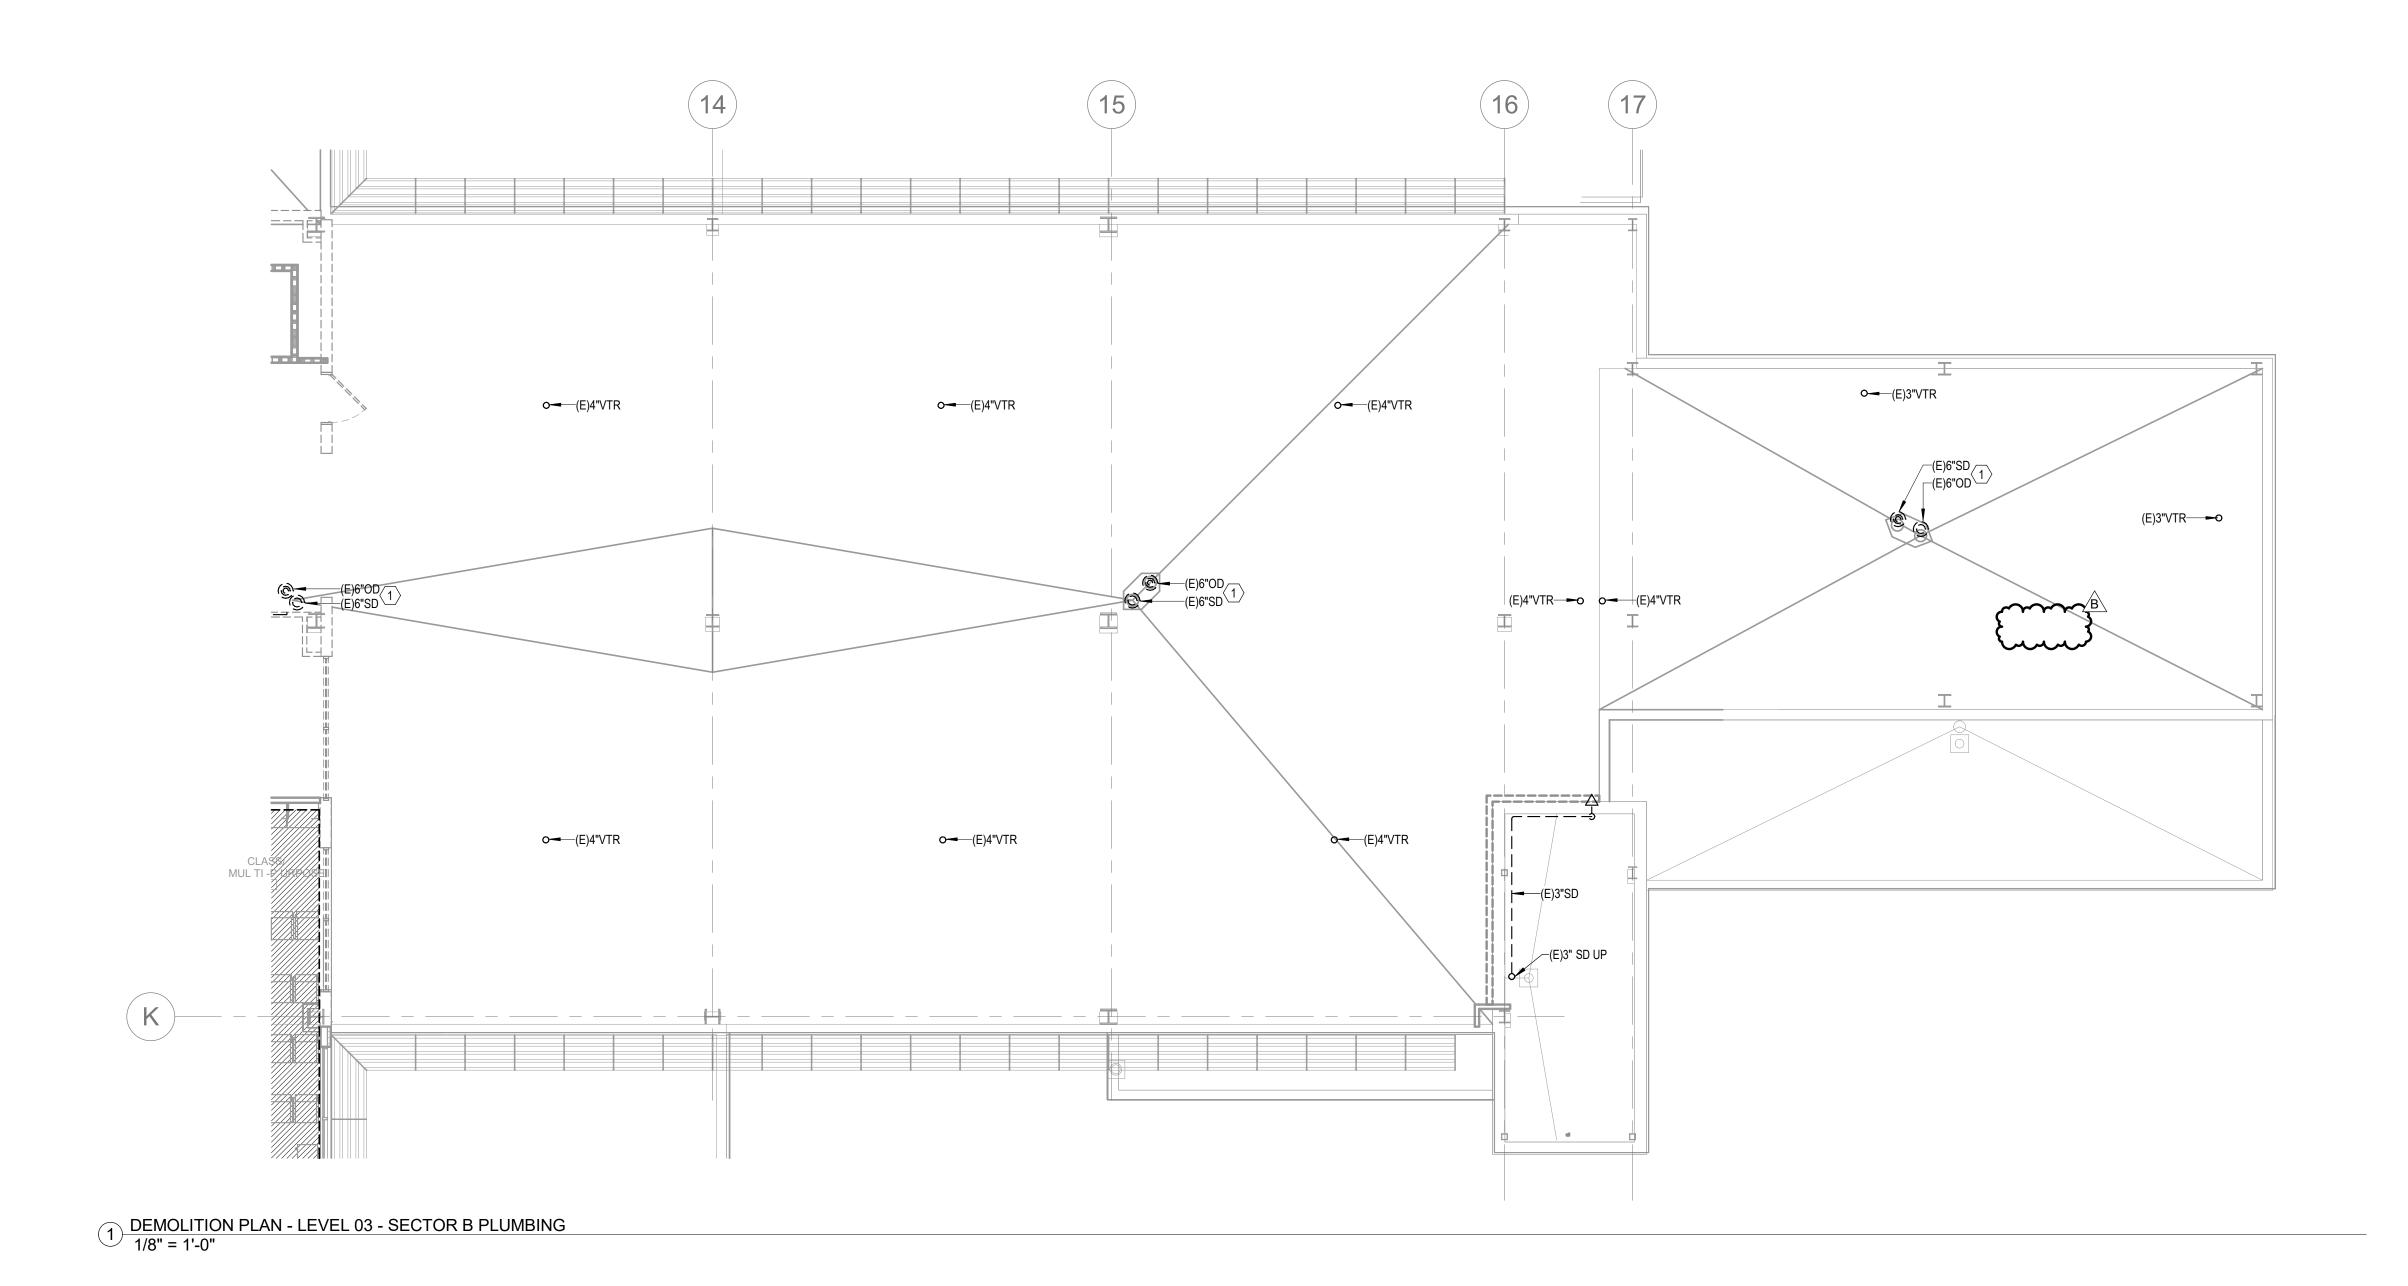
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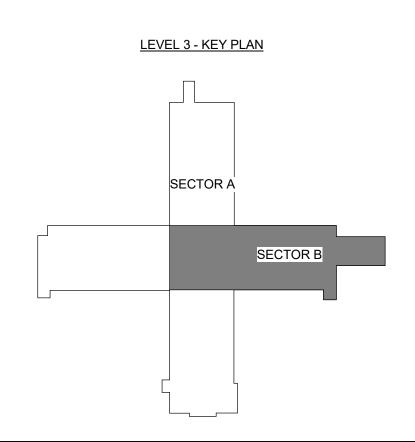
DEMOLITION PLAN - LEVEL
03 - SECTOR A - PLUMBING

PD02-03A

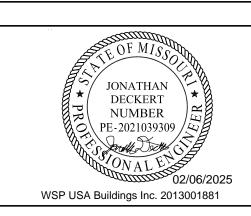LEGEND NOTES

1. DEMOLISH EXISTING ROOF DRAIN AND OVERFLOW DRAIN.



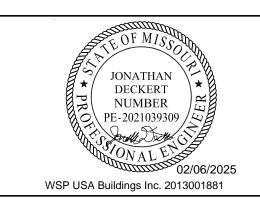

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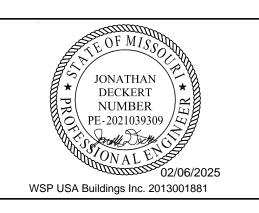
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DEMOLITION PLAN - LEVEL

03 - SECTOR B - PLUMBING

PD02-03B

						PLUMBING FIXTURE
HCA DESIG.	FIXTURE TYPE	SAN.SEWER	VENT	COLD WATER		DESCRIPTION
P-101	WATER CLOSET ADA COMPLIANT PUBLIC	4"	2"	1 1/2"	-	WATER CLOSET: ZURN MODEL No. Z5665-BWL1 (WHITE) FLUSH VALVE WATER CLOSET, VITREOUS CHINA, 16-3/4" RIM HEIGHT, 10" ROUGHING-IN, LOW CONSUMPTION 1.1 GALLONS PER FLUSH, ELONGATED BOWL, DIRECT FED SIPHON JET ACTION, FULLY GLAZED TRAPWAY, 1½" TOP SPUD. FLUSH VALVE: ZURN MODEL No. Z-6000-AV-HET, HIGH EFFICIENCY (HET) 1.28 GPF, VACUUM BREAKER FLUSH CONNECTION, 1" I.P.S. BACK-CHECK ANGLE STOP, DIAPHRAGM TYPE MANUAL FLUVALVE, CHROME PLATED, VANDAL RESISTANT STOP CAP. SEAT: PROFLO MODEL No. PFTSCOF2000WH, WHITE OPEN SEAT FRONT LESS COVER, WITH SELF SUSTAINING CHECK HINGE.
P-104	WATER CLOSET ADA COMPLIANT PATIENT OFFSET	4"	2"	1 1/2"	-	WATER CLOSET: ZURN MODEL No. Z5666-BWL-BA-AM (WHITE) FLUSH VALVE WATER CLOSET, VITREOUS CHINA, 16-3/4" RIM HEIGHT, 10" ROUGHING-IN, 1.28 HIGH-EFFICIENCY TOILET, ELONGAT BOWL WITH BED PAN LUGS, DIRECT FED SIPHON JET ACTION, FULLY GLAZED TRAPWAY, 1½" TOP SPUD. FLUSH VALVE: ZURN MODEL No. Z-6011-AV-BWN-WS1 BEDPAN WASHER, 1.6 GPF, EXPOSED, QUIET DIAPHRAGM-TYPE, CHROME PLATED, FLUSHOMETER VALVE WITH A POLISHED EXTERIOR. CHLORAMINE RESISTANT, DUAL SEAL DIAPHRAGM WITH CLOG RESISTANT, TRIPLE FILTERED BY-PASS. ADA COMPLIANT WITH A NON-HOLD OPEN AND NO LEAK HANDLE FEATURE, BEDPAN WASHER ASSEMBLY WITH OFFSET FLUSH TUBE, WALL BRACKET AND SUPPORT ROD, HIGH BACK PRESSURE VACUUM BREAKER, ONE-PIECE BOTTOM HEX COUPLING NUT, ADJUSTABLE TAILPIECE 1" I.P.S. SCREWDRIVER BACK-CHECK ANGLE STOP, OFFSET FOR ADA APPLICATIONS, SPUD COUPLING AND FLANGE FOR 1½" TOP SPUD. SEAT: PROFLO MODEL No. PFTSCOF2000WH, WHITE OPEN SEAT FRONT LESS COVER, WITH SELF SUSTAINING CHECK HINGE.
P-301	LAVATORY - WALL HUNG ADA COMPLIANT	2"	2"	1/2"	1/2"	LAVATORY: ZURN MODEL No. Z5344 WHITE 20X18 4CC WALL MOUNT WALL MOUNT LAVATORY, VITREOUS CHINA. PUBLIC
P-304	PUBLIC LAVATORY - WALL HUNG ADA COMPLIANT PATIENT	2"	2"	1/2"	1/2"	LAVATORY: ZURN MODEL No. Z5344 WHITE 20X18 4CC WALL MOUNT WALL HUNG LAVATORY, VITREOUS CHINA. PATIENT FAUCET: ZURN MODEL No. Z812A4-XL-FC1.5 SWING GOOSENECK SPOUT, WITH 1.5 GPM FLOW CONTROL IN BASE OF SPOUT, WITH 4" WRISTBLADE HANDLES. STRAINER AND TAILPIECE: PROFLO MODEL No. PFGD101 1-1/4" X 6" CP OFFSET GRID DRAIN AND TAILPIECE P-TRAP: PROFLO MODEL No. PFPTB400 1-1/4" CHROME PLATED CAST BRASS BODY P-TRAP. TUBULAR BRASS WALL BEND. No. PF203WH TRAP WRAP KIT. STOPS AND RISERS: TWO PFXQAC32C LEAD FREE 1/4 TURN CHROME PLATED BRASS ANGLE STOPS, TWO PFE7 1/2" CP ESCUTCHEONS AND TWO PFX146324 20" FLEXIBLE STAINLESS STEEL RISERS. CARRIER: ZURN MODEL 771231 FLOOR MOUNTED CARRIER
-402	SINK SINGLE COMPARTMENT ADA COMPLIANT		<u>-4</u> -	1/2	1/2	CARRIER: ZURN MODEL ZZ1231 FLOOR MOUNTED CARRIER SINK: ELKAY MODEL LRAD1919-55-3 TYPE 304 NICKEL BEARING STAINLESS STEEL, SELF RIMMING. 19-1/2" X 19 X 5-1/2" DEPTH ADA COMPLIANT WITH OFF-CENTERED OUTLET TO THE REAR. BOWL SIZE 16"x 13-1/2". 3-1/2" DRAIN AND "SOUND GUARD" UNDERCOATING. FAUCET: ZURN MODEL No. Z831B4-XL-FC 1.5, 8" FIXED CENTERS RIGID OR SWING GOOSENECK SPOUT, WITH 1.5 GPM FLOW CONTROL IN BASE OF SPOUT AND WITH 4" WRISTBLADE HANDLES. STRAINER/TAILPIECE: PROFLO MODEL No. PFWTS CHROME PLATED BRASS 4-1/2" WIDE STRAINER WITH PROFLO PFTPB100 17 GA FLANGED TAILPIECE. P-TRAP: PROFLO MODEL No. PFPTB403 1-1/2 17 GA CHROME PLATED CAST BRASS BODY P-TRAP, TUBULAR BRASS WALL BEND. STOPS AND RISERS: TWO PFXQAC32C LEAD FREE 1/4 TURN CHROME PLATED BRASS ANGLE STOPS, TWO PFE7 1/2" CP ESCUTCHEONS AND TWO PFX146324 20" FLEXIBLE STAINLESS STEEL RISERS.
P-404	SINK SINGLE COMPARTMENT ADA COMPLIANT	2"	2"	1/2"	1/2"	SINK: ELKAY MODEL LRAD-1919-55-3 TYPE 304 NICKEL BEARING STAINLESS STEEL, SELF RIMMING. 19-1/2" X 19" X 5-1/2" DEPTH ADA COMPLIANT WITH OFF-CENTERED OUTLET TO THE REAR. BOWL SIZE 16"x 13-1/2". 3-1/2" DRAIN AND "SOUND GUARD" UNDERCOATING. FAUCET: ZURN MODEL No. Z7870C-XL-C, 8" FIXED CENTERS SINGLE HANDLE KITCHEN FAUCET, WITH 2.2 GPM FLOW RATE. STRAINER/TAILPIECE: PROFLO MODEL No. PF151ACP BASKET DRAIN WITH 1-1/2" 20 GAUGE TAILPIECE. P-TRAP: PROFLO MODEL No. PFPTB403 1-1/2 17 GA CHROME PLATED CAST BRASS BODY P-TRAP, TUBULAR BRASS WALL BEND. STOPS AND RISERS: TWO PFXQAC32C LEAD FREE 1/4 TURN CHROME PLATED BRASS ANGLE STOPS, TWO PFE7 1/2" CP ESCUTCHEONS AND TWO PFX146324 20" FLEXIBLE STAINLESS STEEL RISERS.
P-602	SHOWER (SOLID SURFACE)	2"	2"	1/2"	1/2"	ENCLOSURE: REFER TO ARCHITECT FOR SHOWER ENCLOSURE SPECIFICATION. WALLS, GRAB BAR, SOAP DISH, FOLD-UP SEAT FURNISHED BY OTHERS. FAUCET: SYMMONS No. SYM9605-PLR-X-231 PRESSURE BALANCING SHOWER VALVE, ADA COMPLIANT, DIVERTER WITH VOLUME CONTROL, INTEGRAL SERVICE STOPS AND LEVER HANDLE. SUPER SHOWER HEAD WITH ARM AND FLANGE. ADA HAND HELD SHOWER, INLINE VACUUM BREAKER, 60" HOSE AND 36" SLIDE BAR. INSTALL FAUCET ASSEMBLY OFFSET AS DIRECTED BY TH ADA RULES. DRAIN: 2" SELF CAULKING BRASS SHOWER DRAIN.
P-705	FLOOR SINK	AS NOTED ON PLANS	-	-	-	ZURN MODEL ZN-1901-KC-2, SANI-FLOR RECEPTOR 12" DIAMETER 8" DEEP CAST IRON BODY ROUND, MEMBRANE FLASHING CLAMP AND ANCHOR FLANGE WITH SEEPAGE HOLES, LIGHT-DUTY GRATE WITH SLOTTED OPENINGS, WHITE ACID RESISTING PORCELAIN ENAMEL INTERIOR AND TOP, COMPLE
P-710	ROOF DRAIN	AS NOTED ON PLANS	-	-	-	ZURN MODEL ZA-100-NH-DR, 15" DIAMETER ROOF DRAIN. DURA-COATED IRON BODY WITH COMBINATION MEMBRANE FLASHING CLAMP/GRAVEL GUARD AND LOW SILHOUETTE NO-HUB ALUMINUM DOME.
P-711	OVERFLOW DRAIN	AS NOTED ON PLANS	-	-	-	ZURN MODEL ZA-100-NH-DR-W2, 15" DIAMETER ROOF DRAIN. DURA-COATED IRON BODY WITH COMBINATION MEMBRANE FLASHING CLAMP/GRAVEL GUARD AND LOW SILHOUETTE NO-HUB ALUMINUM DOME AND 2" INTERNAL WATER DAM.
P-721	FLOOR DRAIN DECON	AS NOTED ON PLANS	-	-		ZURN MODEL Z-550-NL-AR-P-Y, ROUND, ACID RESISTANT EPOXY COATED CAST IRON BODY WITH NEO-LOC BOTTOM OUTLET, SEEPAGE PAN AND COMBINATION MEMBRANE FLASHING CLAMP FRAME FOR MEDIUM-DUTY SLOTTED GRATE, SEDIMENT BUCKET AND TRAP PRIMER CONNECTION.
P-724	DOWNSPOUT NOZZLE	AS NOTED ON PLANS	-	-		ZURN MODEL ZARB199-IP-SS, ALL PLAIN BRONZE BODY DOWN SPOUT NOZZLE WITH THREADED INLET AND REMOVABLE STAINLESS SCREEN.
P-801	WALL HYDRANT EXTERIOR	-	-	3/4"		ZURN MODEL Z-131034X8, EXPOSED ANTI-SIPHON NON-FREEZE WALL HYDRANT WITH VACUUM BREAKER AND STAINLESS STEEL FACE. 8" WALL THICKNESS.
P-802	WALL HYDRANT INTERIOR	-	-	3/4"		ZURN MODEL Z-1341-P34-LK-PC, EXPOSED ANTI-SIPHON LOOSE KEY WALL HYDRANT WITH VACUUM BREAKER AND POLISHED CHROME FINISH.
P-804	ICE MAKER BOX	-	-	1/2"		OATEY MODEL 39140 20 GAUGE STEEL ICE MAKER BOX WITH 1/4 TURN BALL VALVE AND WATER HAMMER ARRESTOR, LOW LEAD COMPLIANT.
P-819 P-901	JANITOR SINK AND EYEWASH	3"	2"	3/4"		ZURN MODEL Z-1388XL34ACVB, NON-FREEZE ROOF HYDRANT WITH VACUUM BREAKER AND CASING GUARD. MOP SINK: STERN WILLIAMS #SB-902, 24" X 24" X 12" SQUARE TERRAZZO MOP SINK WITH STAINLESS STEEL CAP, SS RIM GAURDS AND PROFLO PFWG24S SS WALL GUARDS FOR 24X24 MOP BATTER FAUCET: SPEAKMAN SEF9000-TW EYEWASH FAUCET AND MIXING VALVE TRAINNER/TAILPIECE: STERN-WILLIAMS TC3TCNH GASKET. DRAIN: STERN WILLIAMS STC3NH MOP SINK GASKET FOR CAST IRON PIPE. AT EACH MOP SINK LOCATION PROVIDE A 1/2" REDUCED PRESSURE BACKFLOW PREVENTER (RPZ) ON A HOT WATER LINE ADJACENT TO THE MOP SINK FOR CONNECTION TO A SOAP MACHINE.


			N	<u>IEDICAL</u>	AIR COM	<u>IPRESS</u>	OR SC	HEDUL	<u>.E</u>			
Mark			System	Capacity ²	Pacakge BTU/HR ³	Noise Level ⁴	System FLA			Receiver	Receiver	Package
	Model Number	HP	50 psig	110 psig			208V (A)	230B (A)	460V (C)	Size (gallons)	Height (H) (inches)	Weight (pounds)
MAC-1	PATTON'S MEDICAL 62-33-204(A/B/C)	20	139.2	128	101,868	82	156	143	72	200	89	3,035
. Capao . Packa	al Operating conditions at a cities are shown as NFPA sage BTU/HR are shown with levels are shown in dB(A) v	ystem c the res	apacities (re erve compr	eserve com ressor on sta	pressor on sta andby.					et per Minute	(ICFM).	

CONSTRUCTION
As Noted on Plans Review

Devenney Group Ltd., Architects

6900 East Camelback Road Suite 500 Scottsdale, AZ 85251 T: 602.943.8950

www.devenneygroup.com

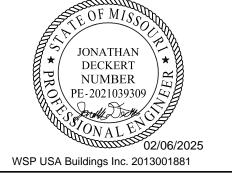

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INPATIENT BED EXPANSION

HCA - LEE'S SUMMIT MEDICAL CENTER 2100 SE BLUE PKWY LEE'S SUMMIT, MO 64063

S AUTHORITY HAVING JURISDICTION: MISSOURI DHSS

AUTHORITY HAVING JURISDICTION'S PROJECT NO:

FACILITY NUMBER: 0972400009

AGENCY APPROVALS:

REVISIONS REV # DESCRIPTION
B DESIGN COORDINATION DATE 2025/02/06

DATE:
SCALE:
SCALE:
SCALE:
STANDIA BOLI
STAN 2024/12/05 1/8" = 1'-0"

SCHEDULES - PLUMBING

P08-01




- A. REFER TO M00-00 FOR GENERAL MECHANICAL NOTES AND
- B. CONTRACTOR TO VERIFY EXISTING CONDITIONS. EXISTING
- WORK SHOWN IS APPROXIMATE AND REPRESENTATIVE OF EXISTING DESIGN AND AS-BUILT DRAWINGS.
- C. PROVIDE REMOTE ADJUSTABLE DAMPERS FOR ANY BALANCING DAMPERS LOCATED ABOVE HARD CEILINGS. D. ACCESS PANELS TO BE PROVIDED FOR ANY MECHANICAL
- EQUIPMENT OR MECHANICAL DEVICES REQUIRING SERVICE LOCATED ABOVE HARD CEILINGS. E. CONTRACTOR SHALL PROVIDE TEMPORARY EXHAUST FANS FOR


ALL EXHAUST SYSTEMS BEING MODIFIED BY THIS PROJECT. COORDINATE TEMPORARY EXHAUST, PHASING, AND ROOM SHUTDOWN REQUIREMENTS WITH OWNER.

LEGEND NOTES

- 32"x24" SA DUCT UP TO RTU-3 ON ROOF.
 28"x22" RA DUCT UP TO RTU-3 ON ROOF.
 24"x24" EA DUCT UP TO KEF-2. GREASE EXHAUST TO HAVE TWO HOUR RATED FIRE WRAP.
 22"x14" STAINLESS STEEL EA DUCT UP TO KEF-5.
- 5. -----NOT USED------B 6. ----NOT USED-----7. 12"x12" STAINLESS STEEL EA DUCT UP TO KEF-3.
- 8. -----NOT USED------9. -----NOT USED------
- B 10. -----NOT USED------11. 52"x14" MA DUCT UP TO MAU-1.
- 12. -----NOT USED------13. PROVIDE 36"X12" DUCT WITH MOTORIZED DAMPER. PROVIDE SHEET METAL TO COVER REMAINDER OF LOUVER OPENING. CONNECT MOTORIZED DAMPER TO REFRIGERANT MONITORING SYSTEM TO BE CONTROLLED THE SAME AS EXISTING LOUVER DAMPERS. 14. CONNECT MAKE UP AIR TO KITCHEN HOOD. PROVIDE DUCT SIZE AND BALANCE CFM.
- 15. CONNECT GREASE EXHAUST TO KITCHEN HOOD. PROVIDE DUCT SIZE AND BALANCE CFM. 16. 10"X20" EXISTING EA DUCT UP TO NEW KEF-4. GREASE EXHAUST TO HAVE TWO HOUR RATED FIRE WRAP.
- 17. CONNECT STAINLESS STEEL EXHAUST TO DISHWASHER. 18. 1000 CFM OF MAKEUP AIR TO KITCHEN HOOD. CONNECT TO EXISTING MAKEUP AIR CONNECTION.
- 19. RELOCATED EXISTING KITCHEN HOOD FIRE SUPPRESSION SYSTEM. 20. BALANCE NEW DIFFUSER/GRILLE TO CFM SHOWN.
- 21. MODIFY OR RECALIBRATE REFRIGERANT MONITORING STATION AS NEEDED FOR NEW SENSOR AT CH-3.
- 22. CONNECT CH-3 TO EXISTING REFRIGERANT MONITORING ALARM SYSTEM. PROVIDE NEW HORNS AND STROBES. 23. 24"x24" EA DUCT UP TO KEF-1. GREASE EXHAUST TO HAVE TWO HOUR RATED FIRE WRAP.
- 24. VFDS FOR KEF-1, KEF-2, KEF-4, AND KEF-5. REFER TO ELECTRICAL DRAWINGS FOR LOCATIONS AND LABELS.
- 25. PROVIDE SOUND LAGGING FOR 15' OF HORIZONTAL DUCT AND VERTICAL DUCT UP TO RTU AS SHOWN WITH DASHED LINE. REFER TO DETAIL 01/M07-02.
- 26. PROVIDE STATIC PRESSURE SENSOR FOR RTU-3. 27. PROVIDE EPO BUTTON FOR RTU-3.

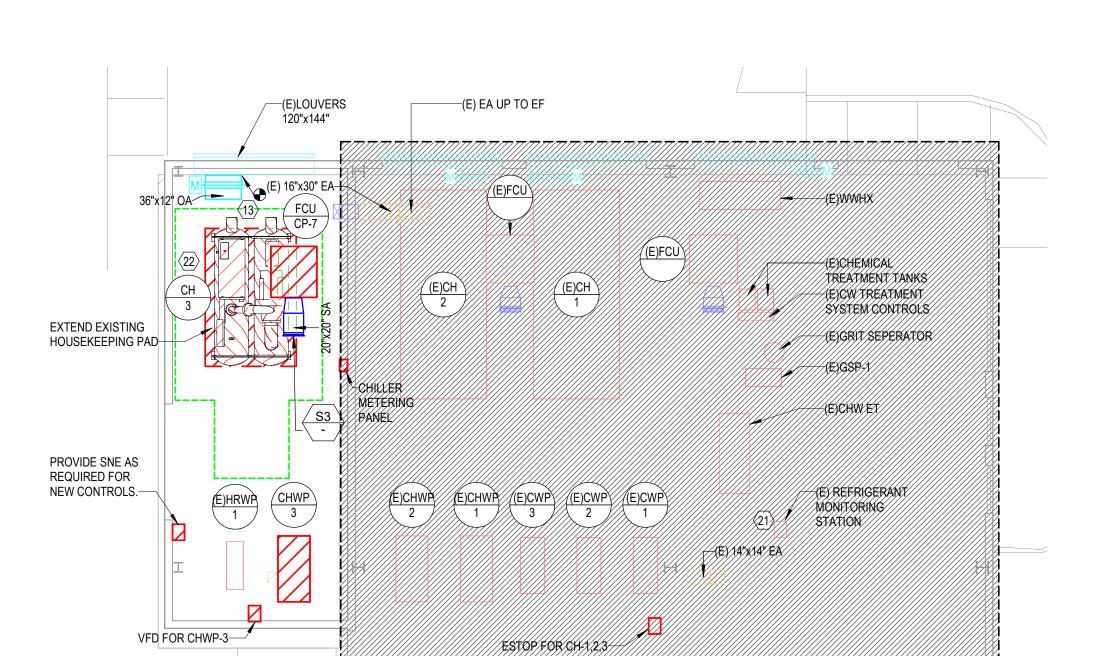

2 FLOOR PLAN - LEVEL 01 - SECTOR C - HVAC 1/8" = 1'-0"

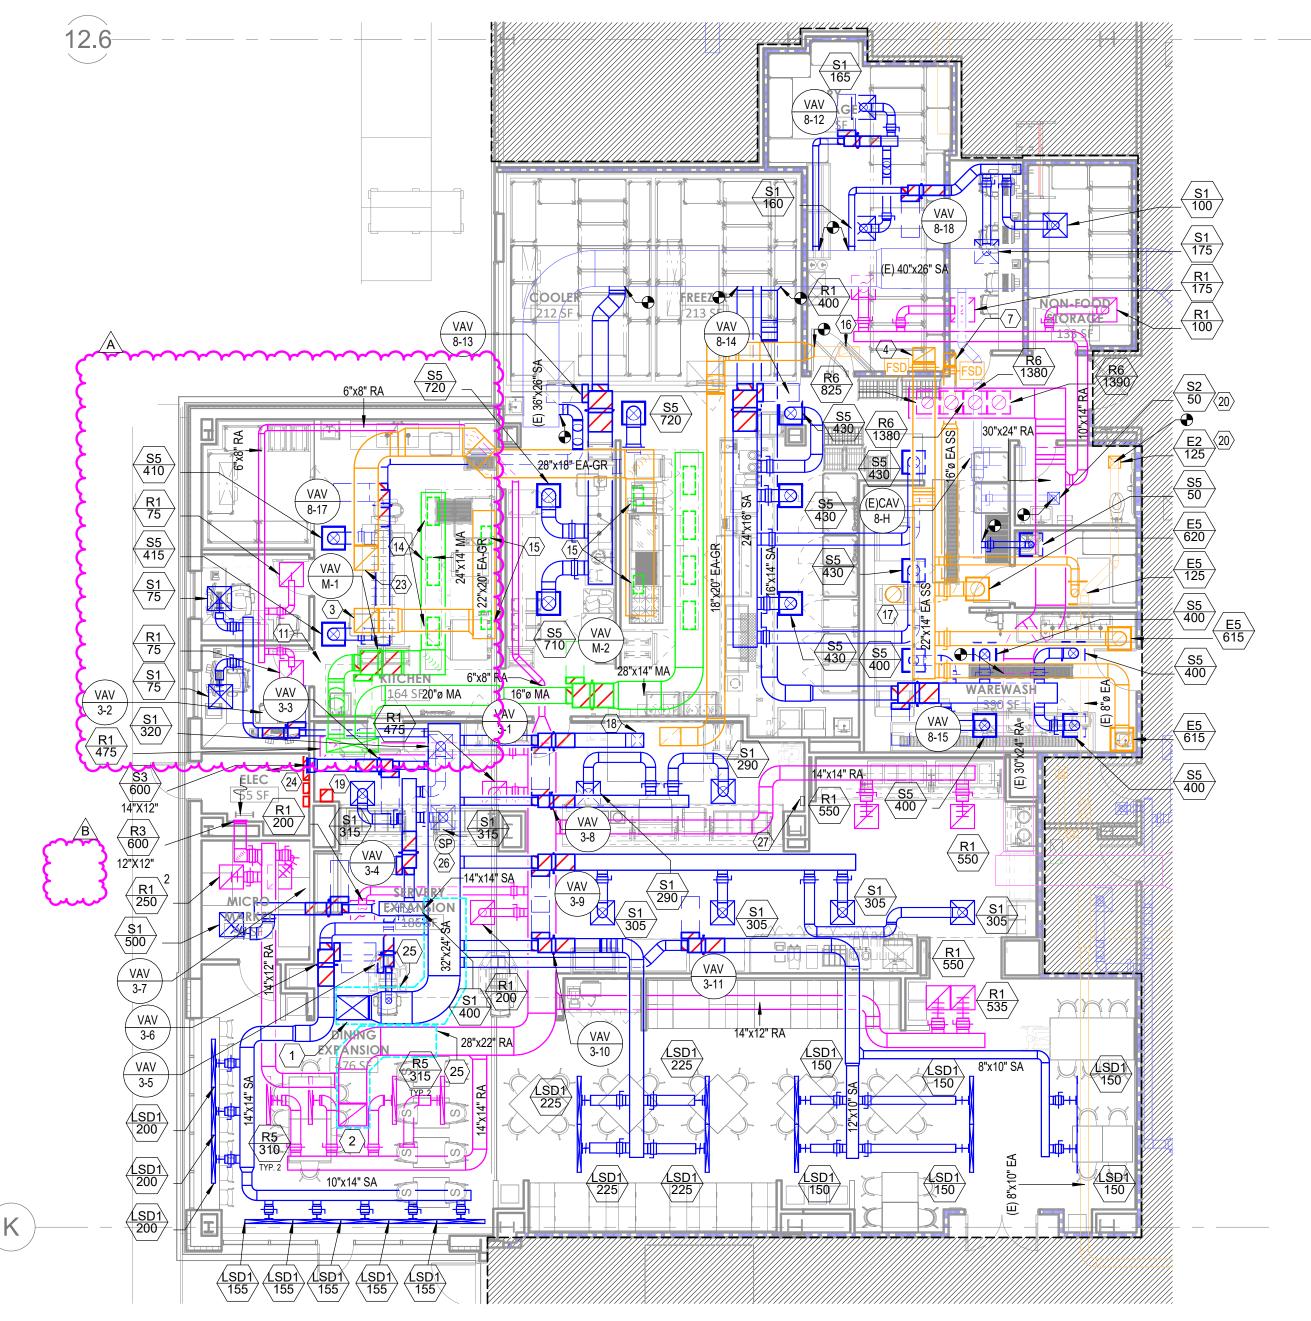

3 FLOOR PLAN - LEVEL 1 - SECTOR A - KITCHEN, SERVERY & DINING - HVAC 1/8" = 1'-0"

11.7

1 FLOOR PLAN - LEVEL 01 - SECTOR D - HVAC 1/8" = 1'-0"

Devenney GROU 6900 East Camelback Road Suite 500


CONSTRUCTION
As Noted on Plans Review

Devenney Group Ltd., Architects

Scottsdale, AZ 85251 T: 602.943.8950



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INPATIENT BED EXPANSION

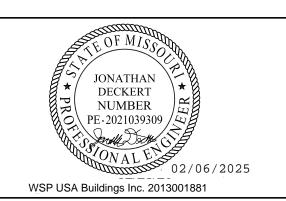HCA - LEE'S SUMMIT MEDICAL CENTER 2100 SE BLUE PKWY LEE'S SUMMIT, MO 64063

AUTHORITY HAVING JURISDICTION: CITY OF LEE'S SUMMIT BUILDING DEPT. MISSOURI DHSS


AUTHORITY HAVING JURISDICTION'S PROJECT NO:

FACILITY NUMBER:

AGENCY APPROVALS:

	REVISIONS	
	KEVISIONS	
V #	DESCRIPTION	DATE
	CITY - 2ND REVIEW	2025/02/06
	DESIGN COORDINATION	2025/02/06

LEVEL 1 - KEYPLAN

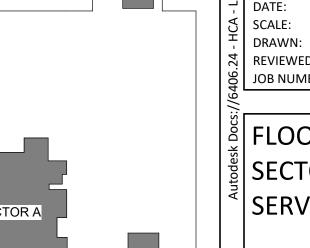

DATE: 1/8" = 1'-0" REVIEWED: 9 JOB NUMBER: 6406.24

FLOOR PLAN - LEVEL 1 -SECTOR A - KITCHEN, SERVERY & DINING - HVAC

M02-01

- A. REFER TO M00-00 FOR GENERAL MECHANICAL NOTES AND
- B. CONTRACTOR TO VERIFY EXISTING CONDITIONS. EXISTING WORK SHOWN IS APPROXIMATE AND REPRESENTATIVE OF
- EXISTING DESIGN AND AS-BUILT DRAWINGS.
 C. PROVIDE REMOTE ADJUSTABLE DAMPERS FOR ANY
- C. PROVIDE REMOTE ADJUSTABLE DAMPERS FOR ANY BALANCING DAMPERS LOCATED ABOVE HARD CEILINGS.D. ACCESS PANELS TO BE PROVIDED FOR ANY MECHANICAL
- LOCATED ABOVE HARD CEILINGS.


 E. CONTRACTOR SHALL PROVIDE TEMPORARY EXHAUST FANS FOR ALL EXHAUST SYSTEMS BEING MODIFIED BY THIS PROJECT. COORDINATE TEMPORARY EXHAUST, PHASING, AND ROOM SHUTDOWN REQUIREMENTS WITH OWNER.

EQUIPMENT OR MECHANICAL DEVICES REQUIRING SERVICE


LEGEND NOTES


- 14"x10" ISO EA DUCT UP TO IEF-02 ON ROOF.
 24"x12" EA DUCT UP TO GEF-30 ON ROOF.
- 24"x12" EA DUCT UP TO GEF-30 ON ROOF.
 CONNECT SUPPLY TO AIR DEVICE PROVIDED BY PRE-FABRICATED BATHROOM POD
- MANUFACTURER.
 4. CONNECT EXHAUST TO AIR DEVICE PROVIDED BY PRE-FABRICATED BATHROOM POD
- MANUFACTURER.
 5. 18"x18" EA DUCT UP TO GEF-13 ON ROOF.
 6. 16"x16" EA DUCT UP TO GEF-1 ON ROOF.
- 26"x18" EA DUCT UP TO GEF-2 ON ROOF.
 PROVIDE SOUND LAGGING FOR 15' OF HORIZONTAL DUCT AND VERTICAL DUCT UP TO
- EXHAUST FAN AS SHOWN WITH DASHED LINE. REFER TO DETAIL 01/M07-02.

 9. PROVIDE SOUND LAGGING FOR 25' OF HORIZONTAL DUCT AND VERTICAL DUCT DOWN TO AHU AS SHOWN WITH DASHED LINE.

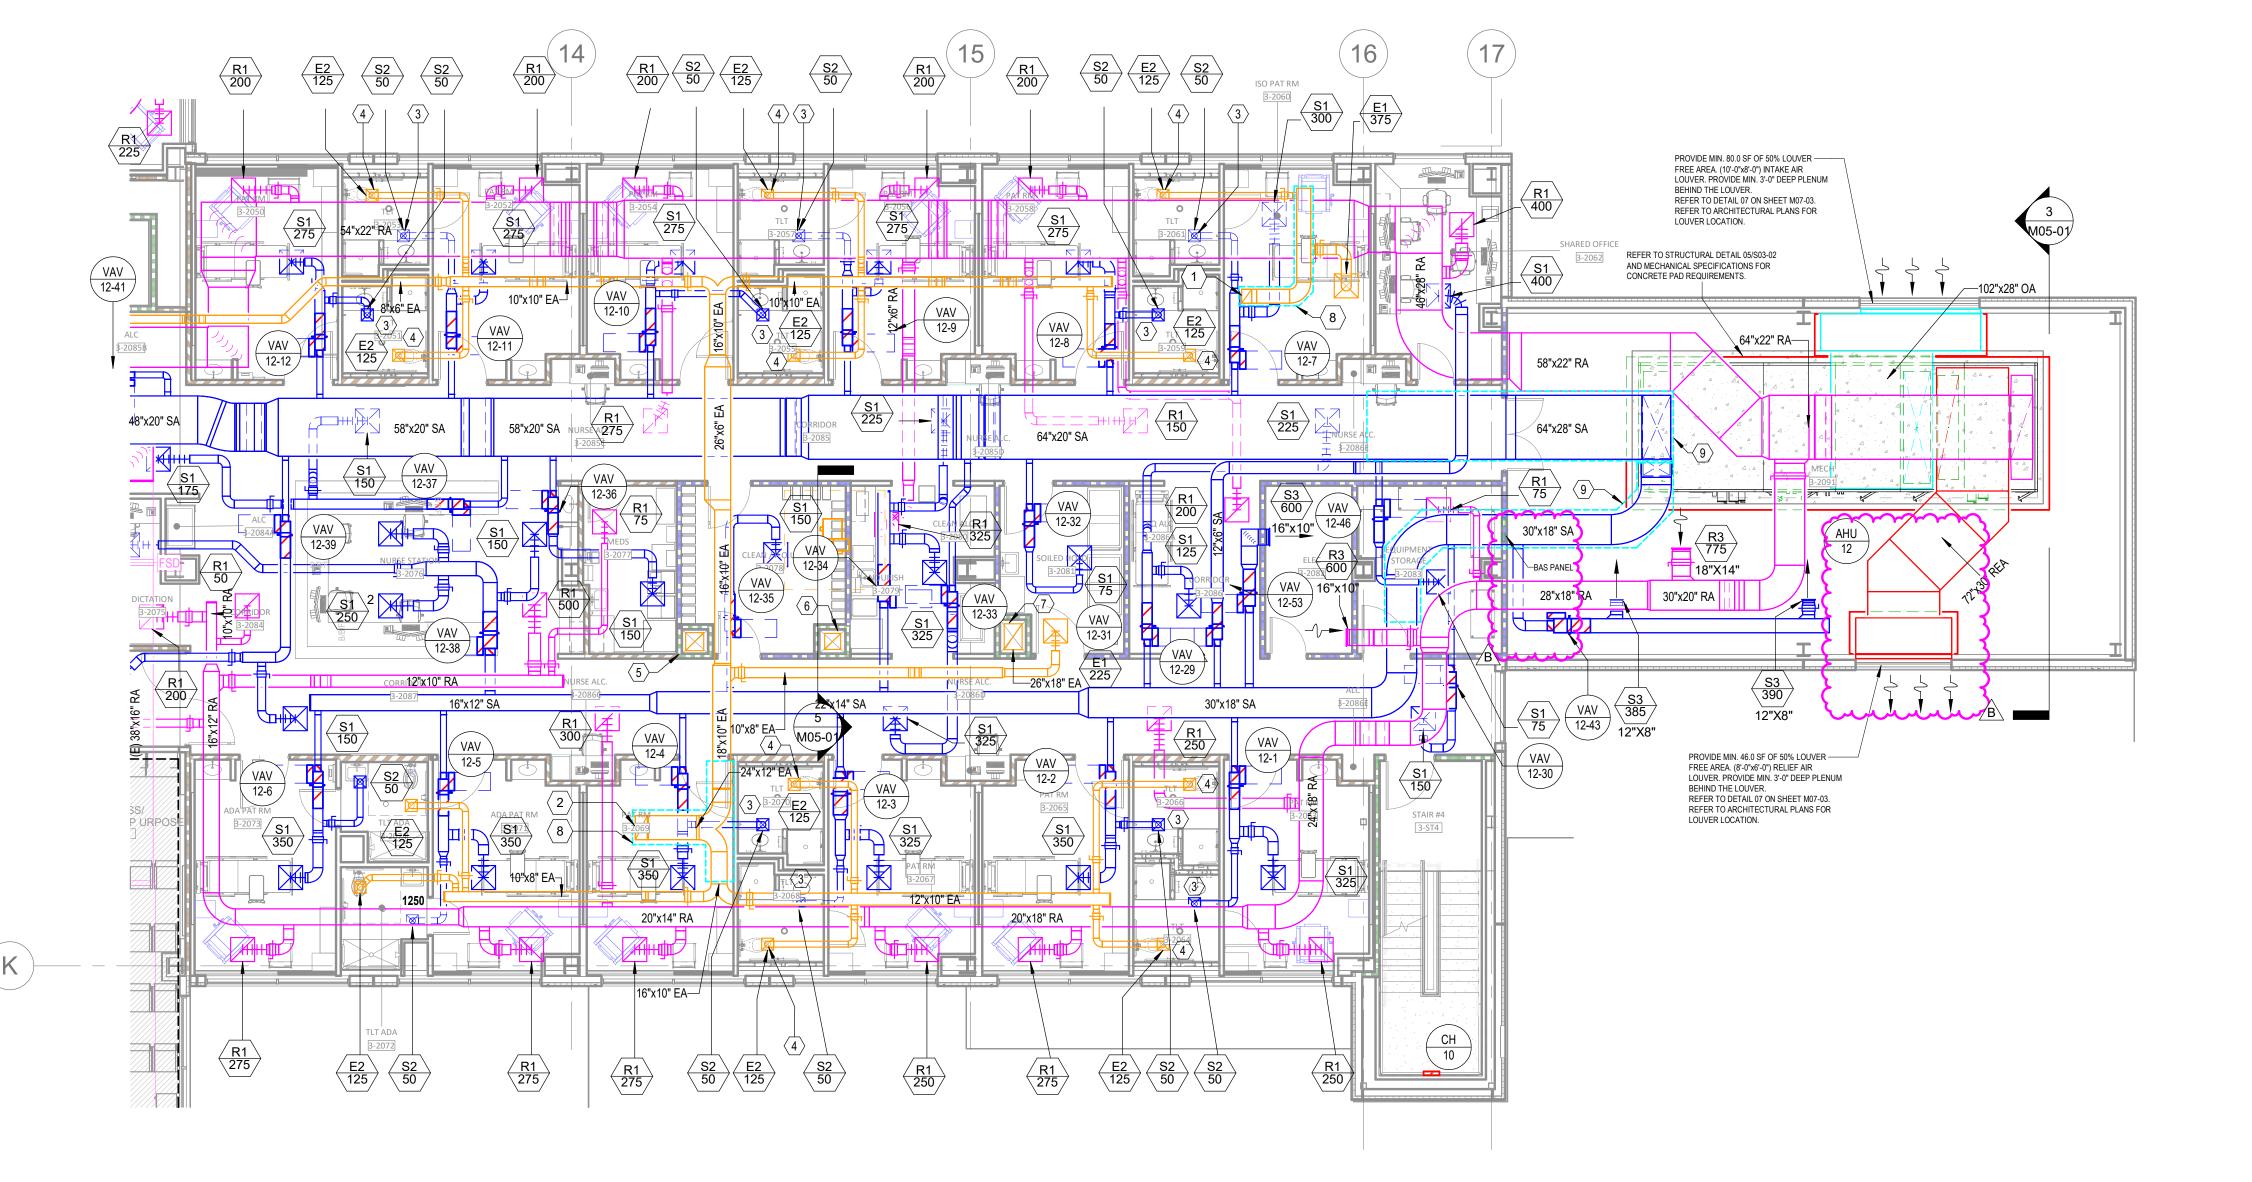

1 FLOOR PLAN - LEVEL 03 - SECTOR B HVAC 1/8" = 1'-0"

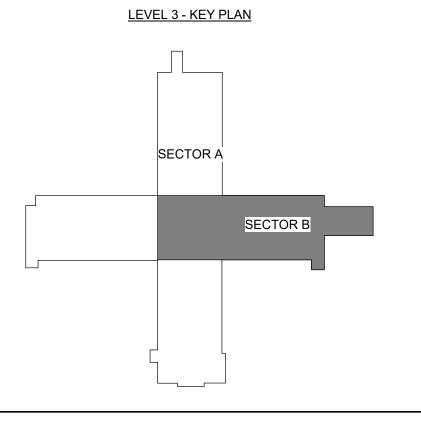

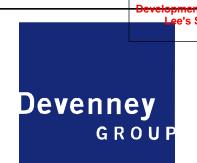

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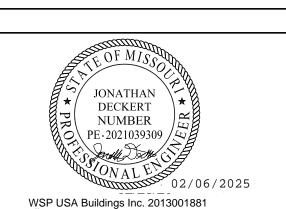
6900 East Camelback Road Suite 500

Scottsdale, AZ 85251

T: 602.943.8950

ltant:

www.devenneygroup.com



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INPATIENT BED EXPANSION

HCA - LEE'S SUMMIT MEDICAL CENTER 2100 SE BLUE PKWY LEE'S SUMMIT, MO 64063

AUTHORITY HAVING JURISDICTION:
CITY OF LEE'S SUMMIT BUILDING DEPT.
MISSOURI DHSS

AUTHORITY HAVING JURISDICTION'S PROJECT NO:

FACILITY NUMBER: **0972400009**

AGENCY APPROVALS:

REV# DESCRIPTION


REV # DESCRIPTION DATE

B DESIGN COORDINATION 2025/02/06


DATE: 2024/12/05
SCALE: 1/8" = 1'-0"
H DRAWN: HO
REVIEWED: JD
JOB NUMBER: 6406.24


FLOOR PLAN - LEVEL 03 - SECTOR B HVAC

M02-03B

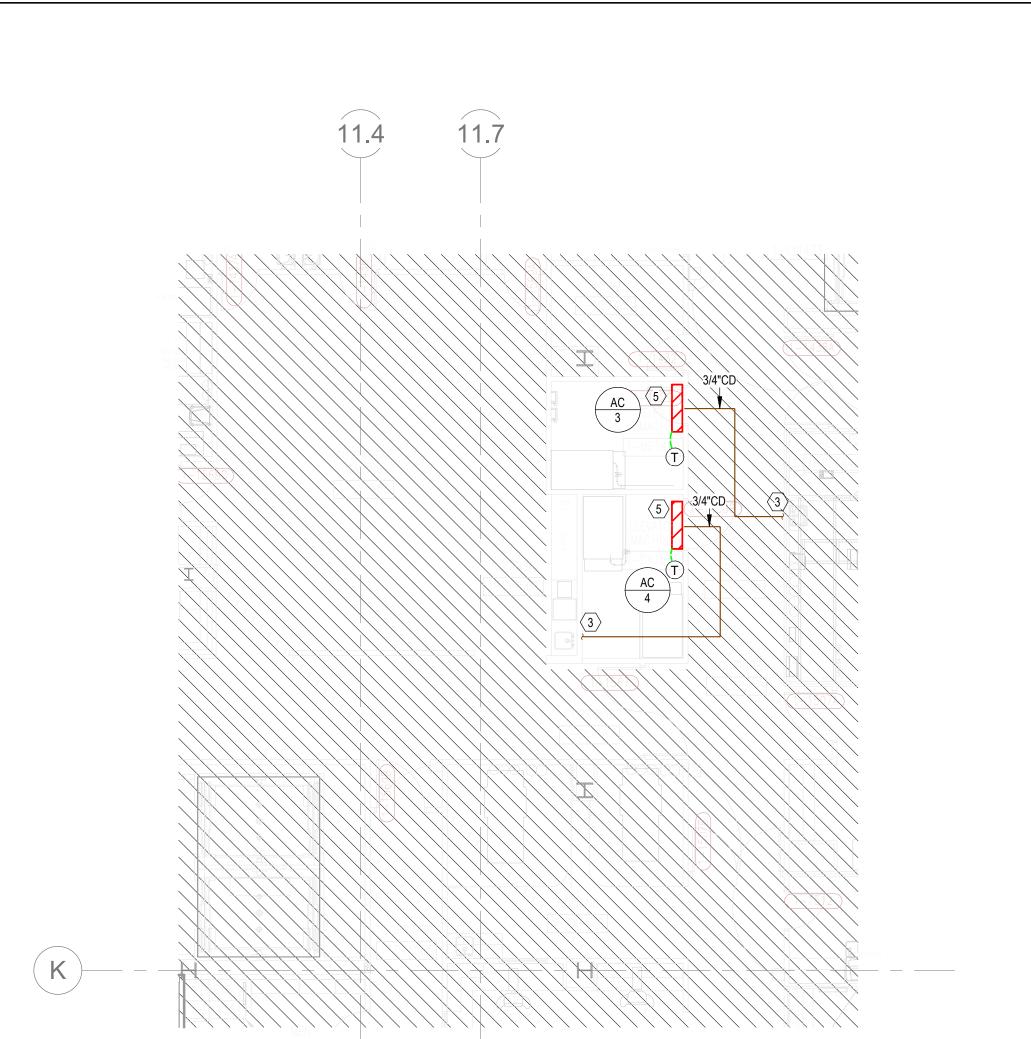

4 FLOOR PLAN - LEVEL 01 - SECTOR D - HVAC PIPING 1/8" = 1'-0"

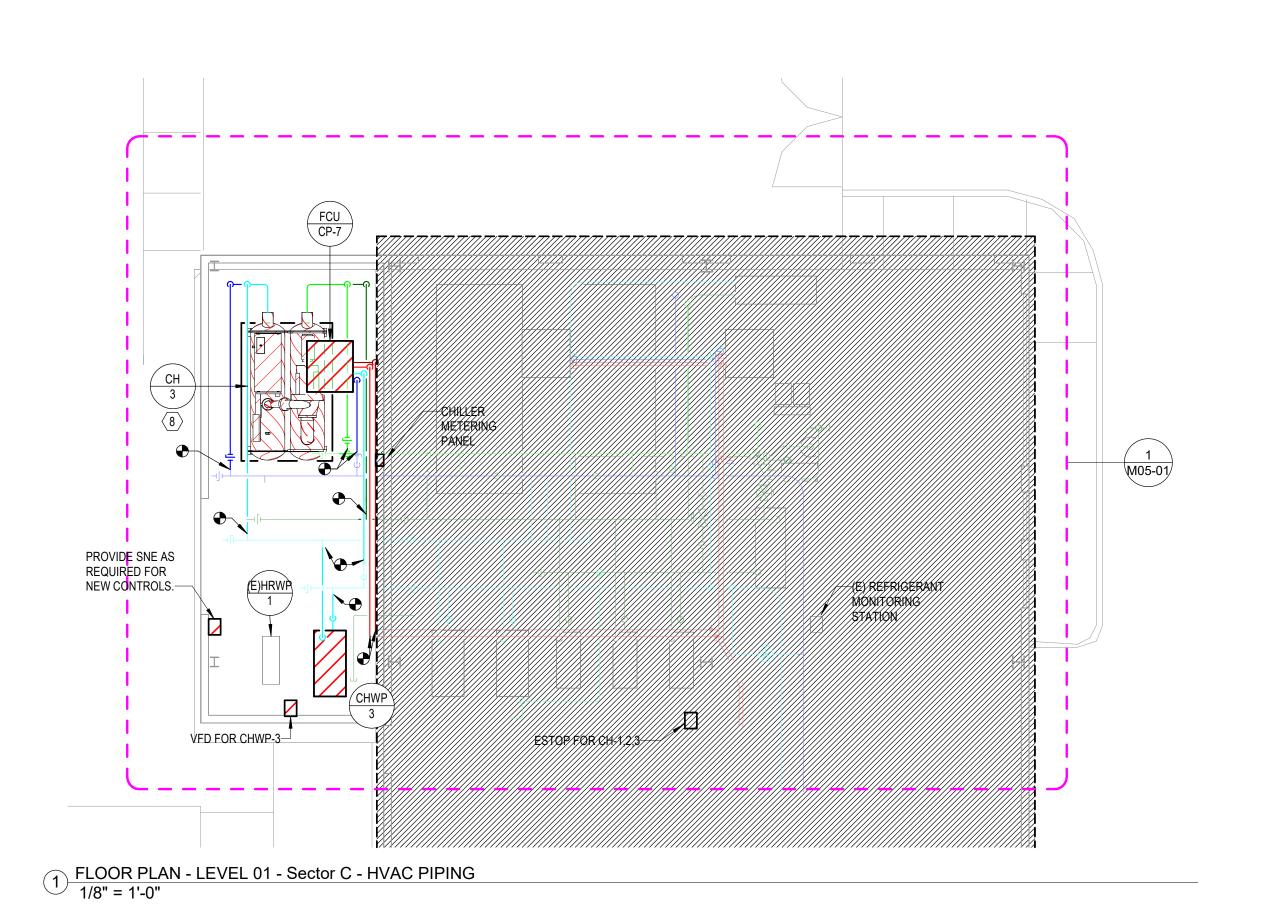

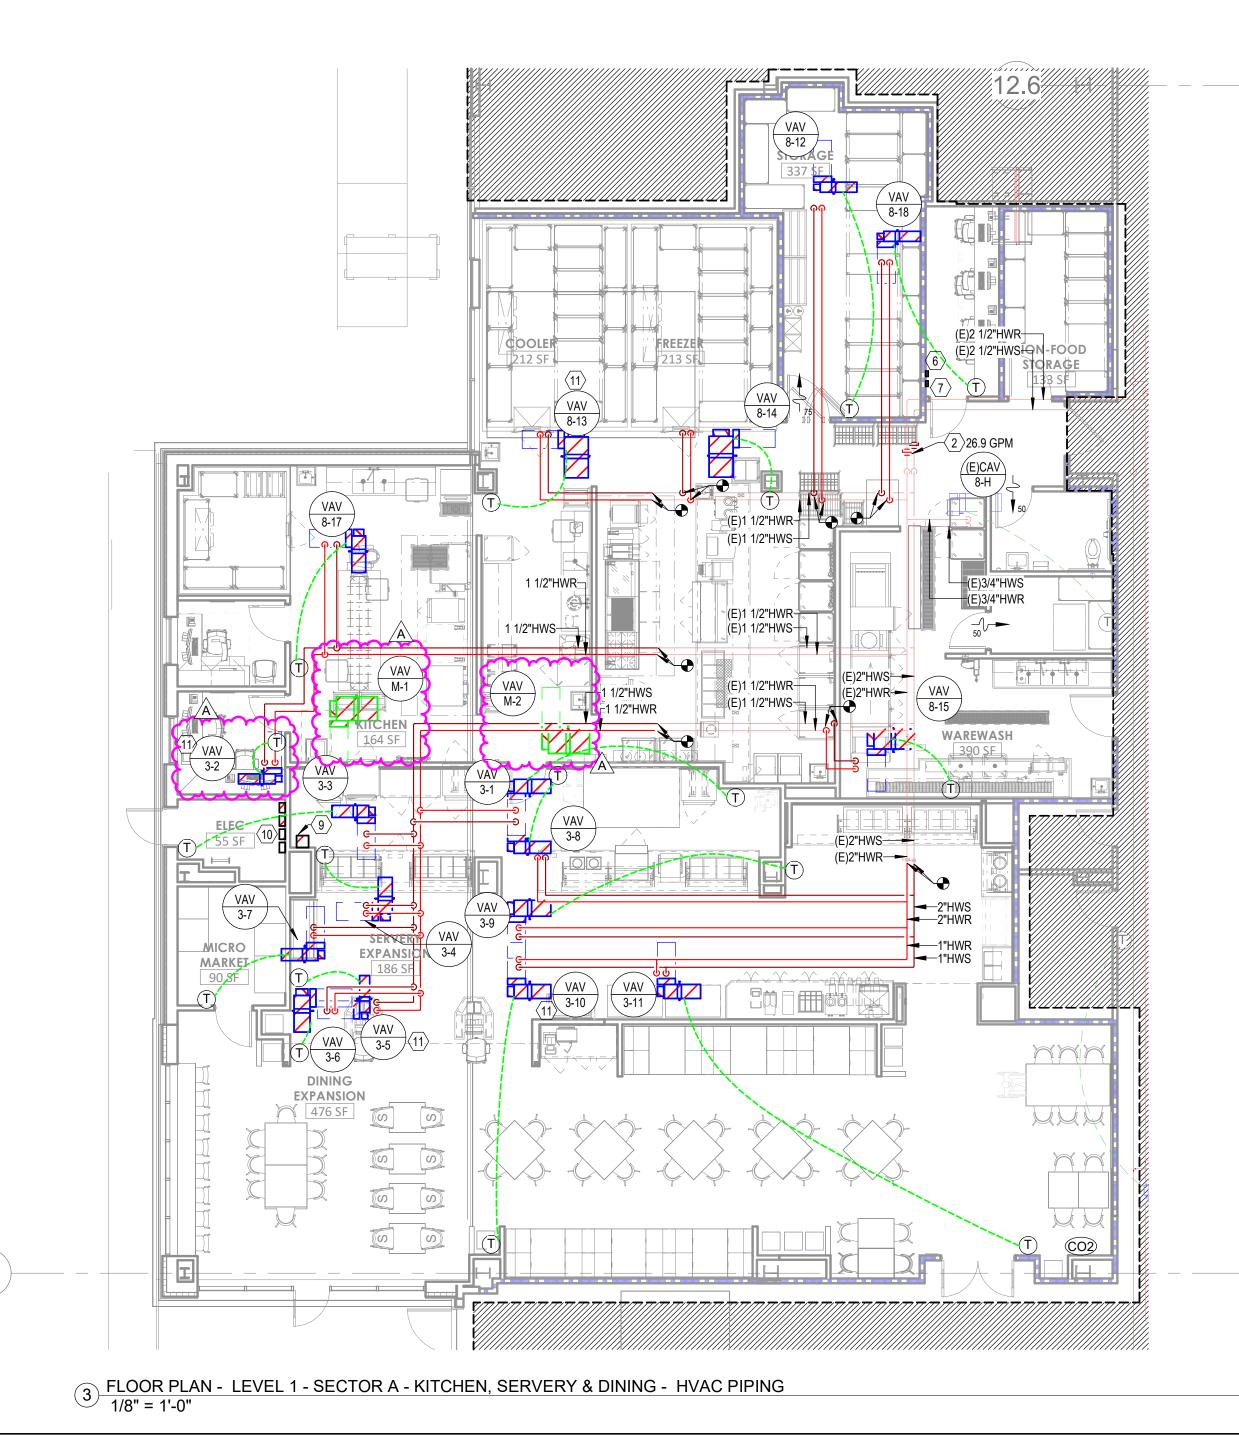

GENERAL NOTES

- A. REFER TO M00-00 FOR GENERAL MECHANICAL NOTES, SYMBOLS AND LEGENDS. B. ALL EXISTING CONDITIONS INDICATED ON THESE DRAWINGS ARE BASED UPON A
- COMBINATION OF AVAILABLE RECORD DESIGN AND AS-BUILT DOCUMENTS. C. PROVIDE CEILING ACCESS PANELS FOR ALL EQUIPMENT, COILS, ETC. THAT ARE

LOCATED ABOVE HARD CEILINGS UNLESS NOTED OTHERWISE.

LEGEND NOTES

- NOTE NOT USED.
 DIFFERENTIAL PRESSURE CONTROL STATION BALANCED TO GPM INDICATED. REFER TO
- 3. ROUTE 3/4" CONDENSATE DRAIN DOWN IN WALL AND DISCHARGE TO LAVATORY TAILPIECE WITH AIR GAP. PROVIDE ESCUTCHEON AT WALL PENETRATION.
- 4. ----NOT USED----
 5. SIZE AND ROUTE REFRIGERANT PIPING PER MANUFACTURER'S INSTRUCTIONS UP TO CONDENSING UNIT ON ROOF.
- 6. EPO SWITCH FOR NEW RTU-3.7. EPO SWITCH FOR NEW MAU-1.
- 8. REFER TO CHILLER INSTALLATION DETAIL.
- 9. RELOCATED EXISTING KITCHEN HOOD FIRE SUPPRESSION SYSTEM. 10. VFDS FOR KEF-1, KEF-2, KEF-4, AND KEF-5. REFER TO ELECTRICAL DRAWINGS FOR
- LOCATIONS AND LABELS.
- 11. PROVIDE 3-WAY CONTROL VALVE FOR VAV AT THE END OF THE PIPING RUN.



CONSTRUCTION
As Noted on Plans Review


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Scottsdale, AZ 85251 T: 602.943.8950

Suite 500





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COMPENSATION TO DEVENNEY GROUP LTD.

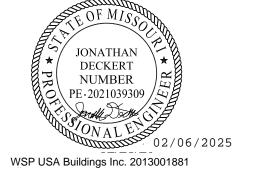INPATIENT BED EXPANSION

HCA - LEE'S SUMMIT MEDICAL CENTER 2100 SE BLUE PKWY LEE'S SUMMIT, MO 64063

AUTHORITY HAVING JURISDICTION: CITY OF LEE'S SUMMIT BUILDING DEPT. MISSOURI DHSS

AUTHORITY HAVING JURISDICTION'S PROJECT NO:

FACILITY NUMBER: 0972400009

AGENCY APPROVALS:

REVISIONS DESCRIPTION DATE ည်း REV# 2025/02/06 CITY - 2ND REVIEW

LEVEL 1 - KEYPLAN



PIPING M03-01

1/8" = 1'-0"

6406.24

luest.

GENERAL NOTES

LEGEND NOTES

FUTURE USE.

DETAIL 05/M07-03.

3-2091.

A. REFER TO M00-00 FOR GENERAL MECHANICAL NOTES, SYMBOLS AND LEGENDS.

LOCATED ABOVE HARD CEILINGS UNLESS NOTED OTHERWISE.

1. CALIBRATED ORIFICE BALANCING VALVE BALANCED TO GPM INDICATED.

2. ROOM DIFFERENTIAL PRESSURE SENSOR AND MONITOR. SENSOR SHALL BE PLACED

ABOVE THE DOOR AND MONITOR SHALL BE PLACED 48" ABOVE FINISHED FLOOR. SYSTEM COMPONENTS SHALL INCLUDE THE FOLLOWING: PRESSURE SENSORS,

4. 4" HWS/R PIPING FROM FLOOR BELOW. VALVE & CAP PIPING BELOW ROOF FOR FUTURE

5. 1" HPS AND 1-1/2" HPCR FROM FLOOR BELOW. VALVE & CAP PIPING BELOW ROOF FOR

6 PROVIDE EPO SWITCH NOR NEW AHU-12.

8. TERMINATE AND AIR GAP CONDENSATE ABOVE FLOOR SINK LOCATED IN MECH ROOM

9. PROVIDE PRV FOR STEAM LINE SERVING HUMIDIFCATION SECTION. REFER TO DETAIL

11. PROVIDE 3-WAY CONTROL VALVE FOR VAV AT THE END OF THE PIPING RUN.

10. DIFFERENTIAL PRESSURE CONTROL STATION BALANCED TO GPM INDICATED. REFER TO

PRESSURE MONITOR, PRESSURE CABLE, TRANSFORMER CABLE AND TRANSFORMER.

3. 6" CHS/R PIPING FROM FLOOR BELOW. VALVE & CAP PIPING BELOW ROOF FOR FUTURE

B. ALL EXISTING CONDITIONS INDICATED ON THESE DRAWINGS ARE BASED UPON A COMBINATION OF AVAILABLE RECORD DESIGN AND AS-BUILT DOCUMENTS.
 C. PROVIDE CEILING ACCESS PANELS FOR ALL EQUIPMENT, COILS, ETC. THAT ARE

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Devenney

GROUF


CONSTRUCTION
As Noted on Plans Review

6900 East Camelback Road Suite 500

Scottsdale, AZ 85251 T: 602.943.8950

www.devenneygroup.com



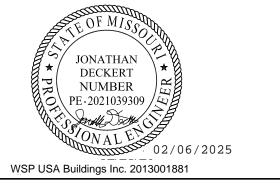

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COMPENSATION TO DEVENNEY GROUP LTD.

INPATIENT BED EXPANSION

HCA - LEE'S SUMMIT MEDICAL CENTER 2100 SE BLUE PKWY LEE'S SUMMIT, MO 64063

AUTHORITY HAVING JURISDICTION:
CITY OF LEE'S SUMMIT BUILDING DEPT.
MISSOURI DHSS

AUTHORITY HAVING JURISDICTION'S PROJECT NO:

FACILITY NUMBER: **0972400009**

AGENCY APPROVALS:

REVISIONS


REV # DESCRIPTION DATE

B DESIGN COORDINATION 2025/02/06

DATE: 2024/12/05
SCALE: 1/8" = 1'-0"
DRAWN: HO
REVIEWED: JD
JOB NUMBER: 6406.24

FLOOR PLAN - LEVEL 03 - SECTOR B HVAC PIPING

M03-03B

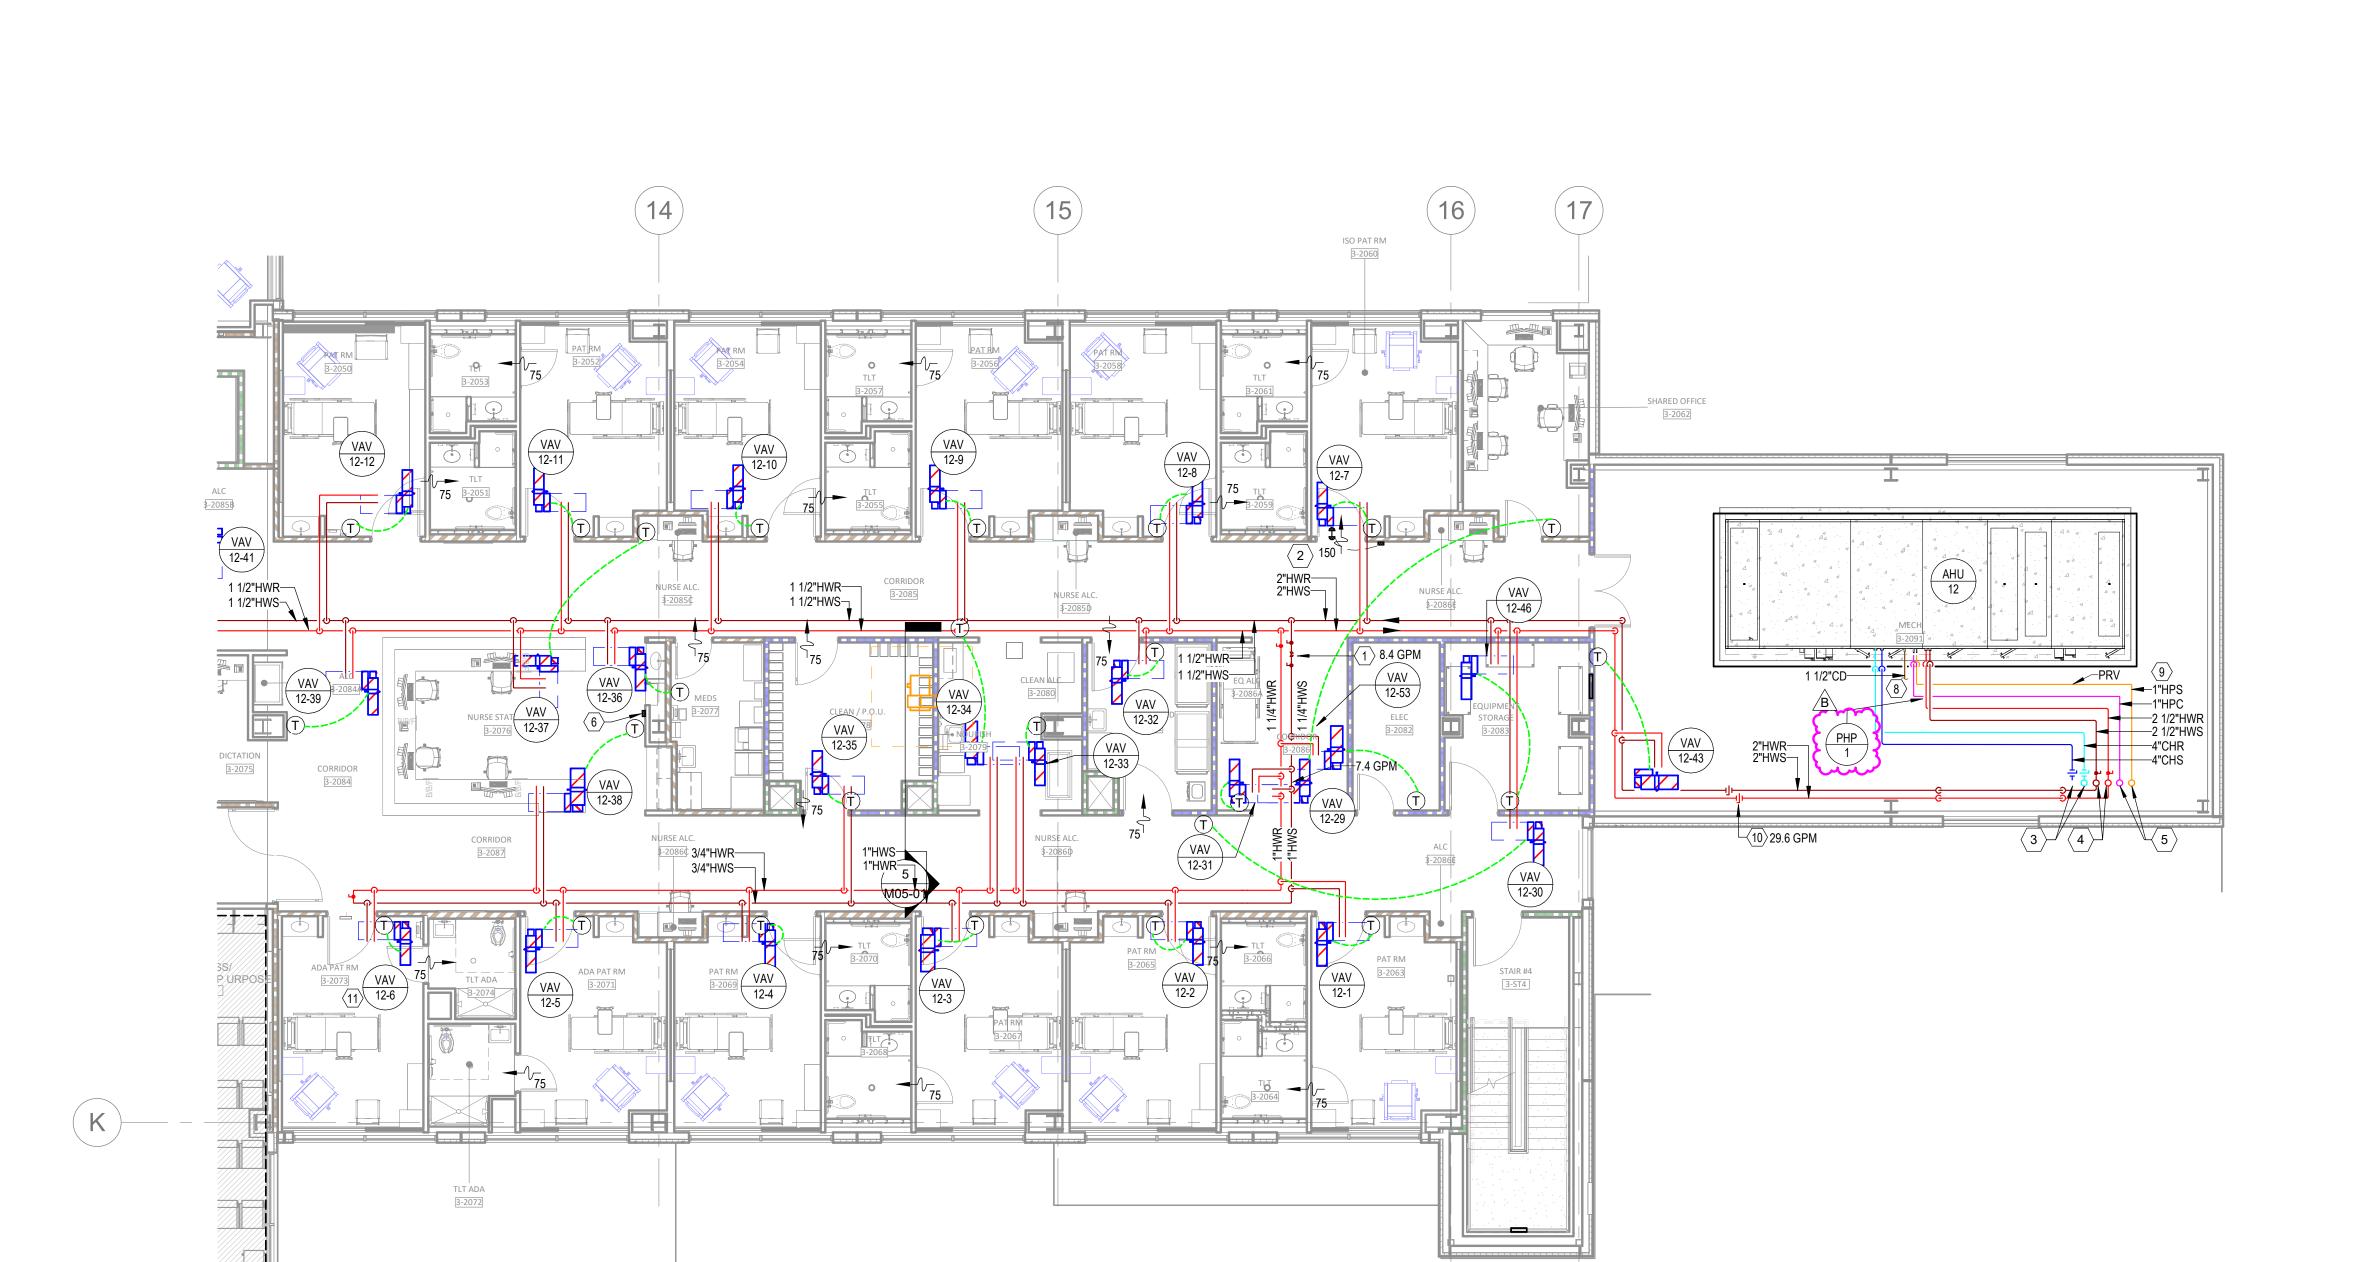



1 FLOOR PLAN - LEVEL 03 - SECTOR B HVAC PIPING 1/8" = 1'-0"


SECTOR A


SECTOR


A. REFER TO M00-00 FOR GENERAL MECHANICAL NOTES, SYMBOLS AND LEGENDS.
 B. ALL EXISTING CONDITIONS INDICATED ON THESE DRAWINGS ARE BASED UPON A COMBINATION OF AVAILABLE RECORD DESIGN AND AS-BUILT DOCUMENTS.

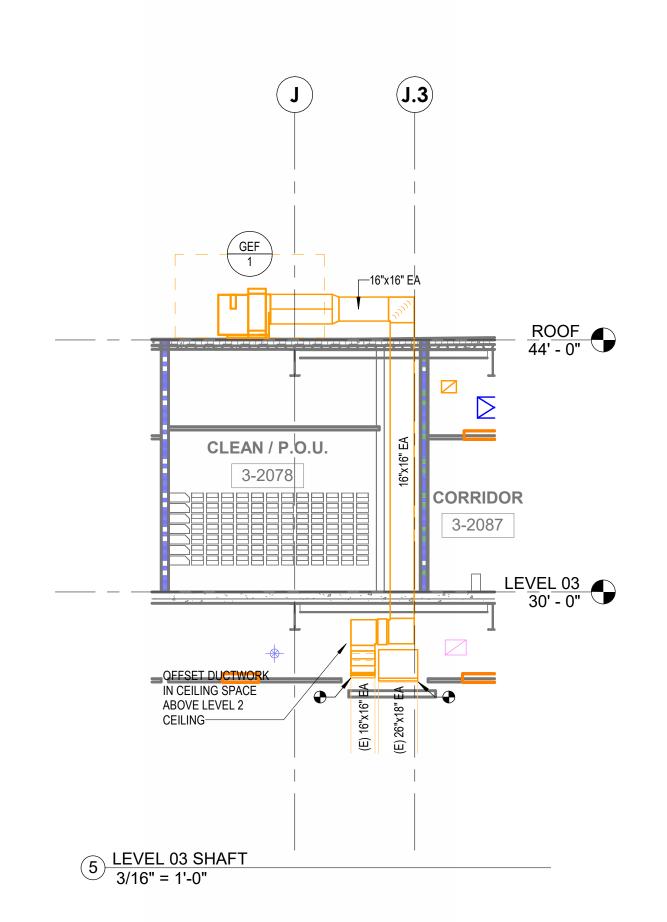

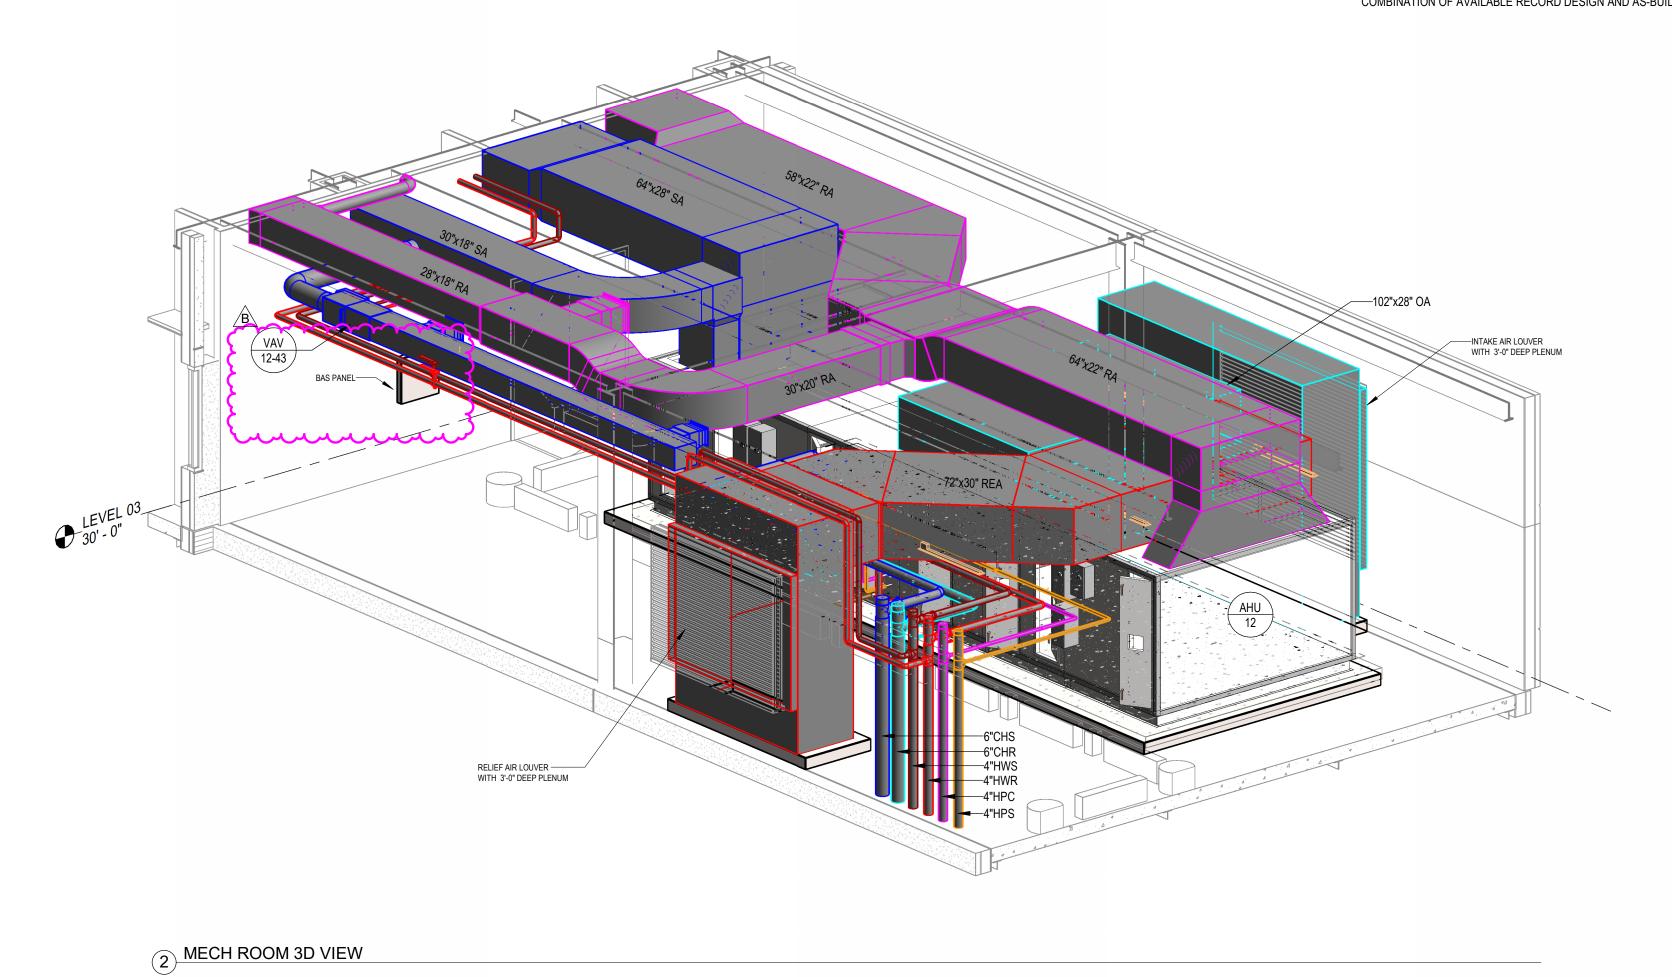

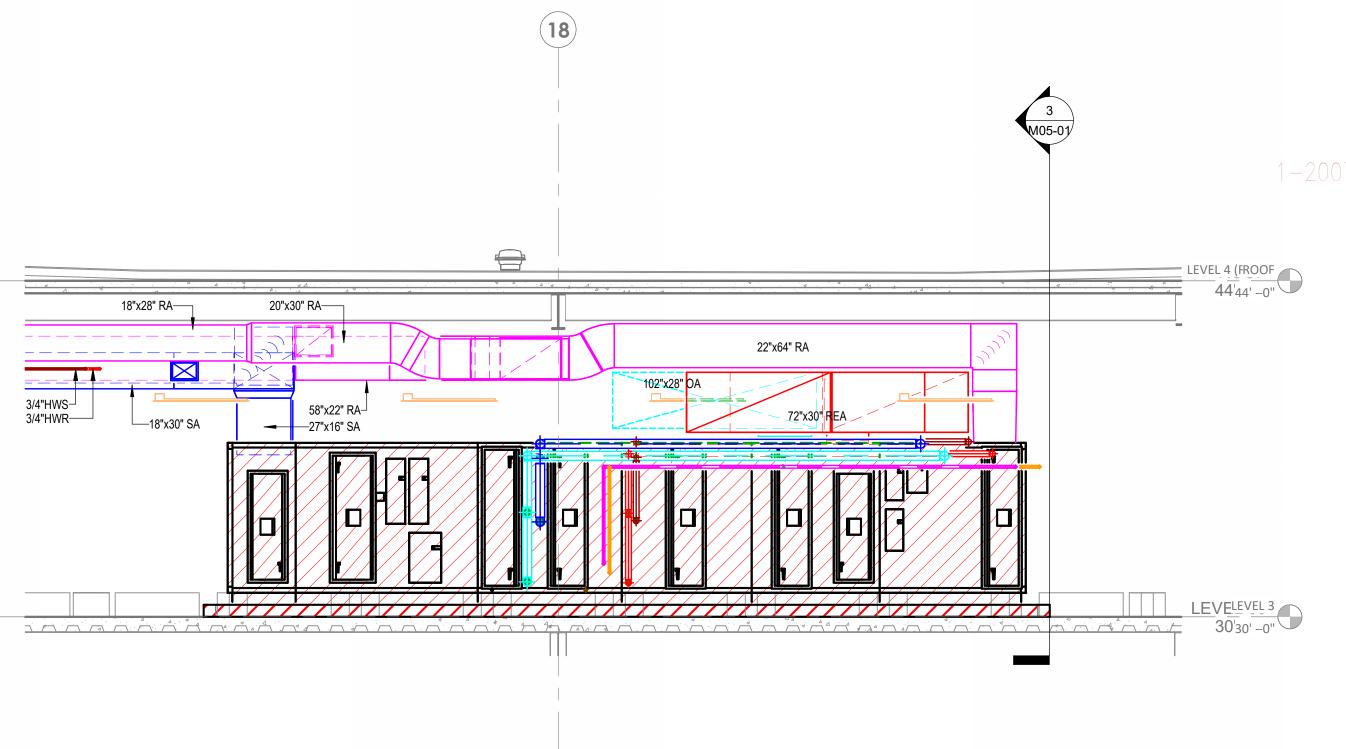

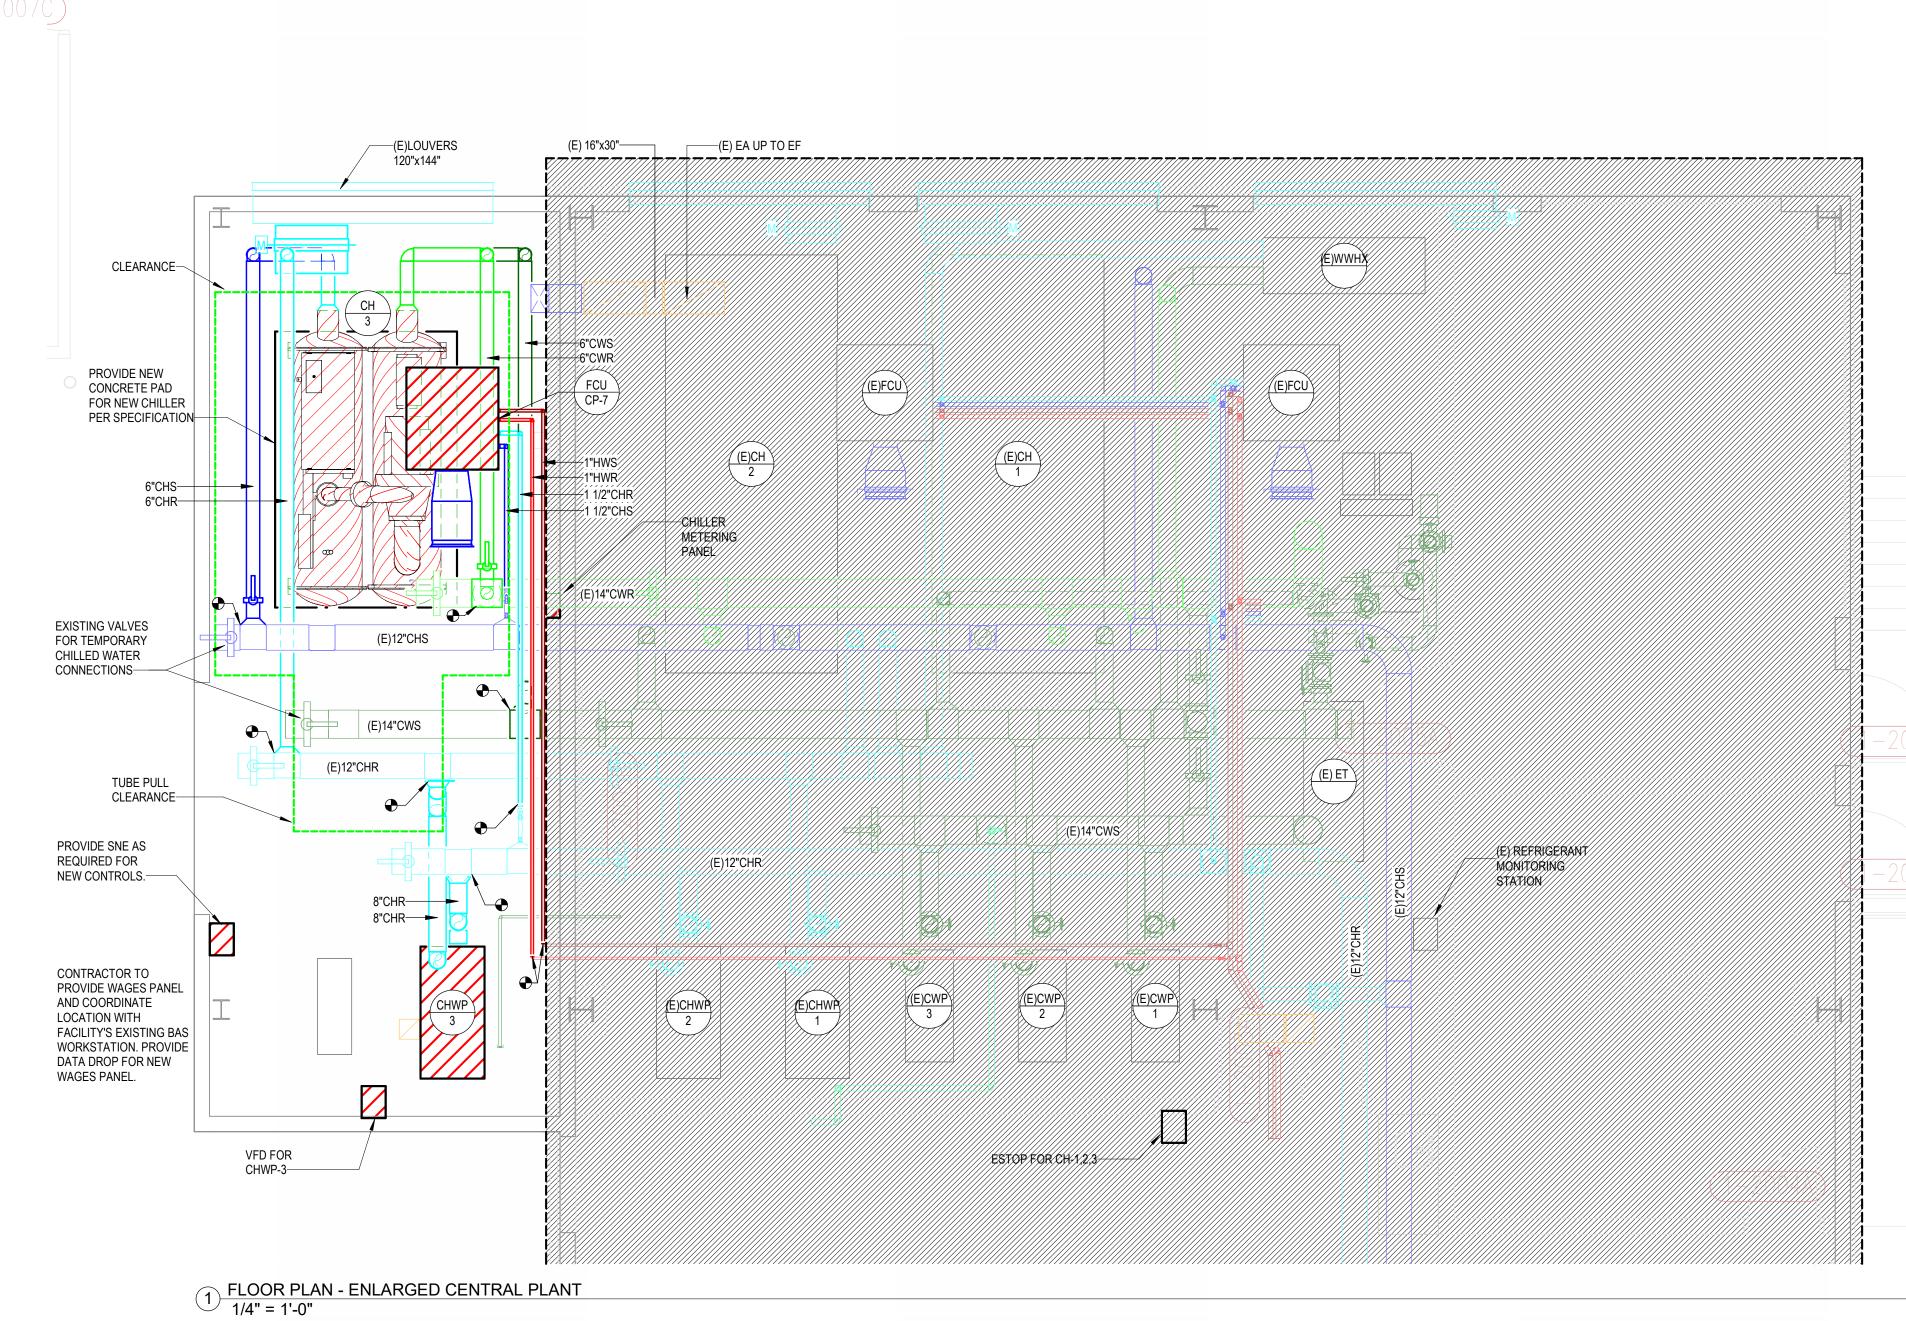

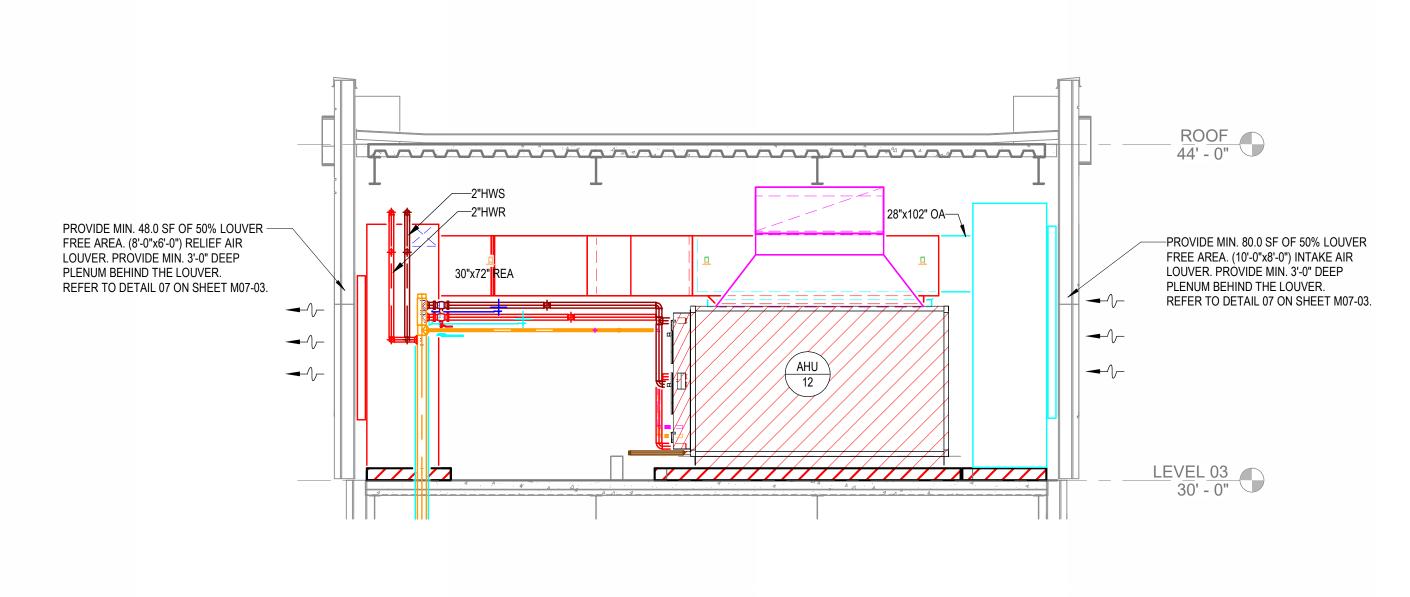


4 MECH ROOM - SECTION 2 1/4" = 1'-0"

3 MECH ROOM - SECTION 1 1/4" = 1'-0" Devenney
GROUP


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ENLARGED PLAN MECHANICAL

M05-01

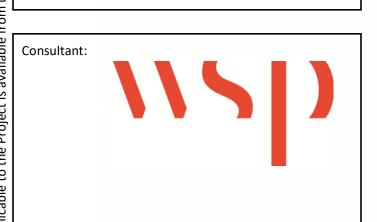


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2024/12/05 1/8" = 1'-0"

6406.24

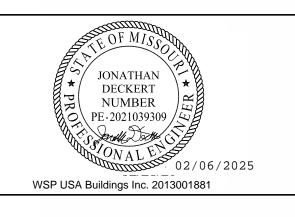RISER DIAGRAM -

M06-01

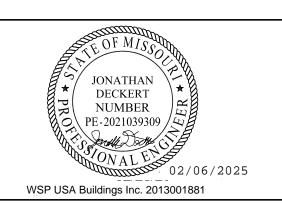Г		T	1	/\ IF			SCHEDULE	T		
DESIG.	SIZE	OBD	FINISH	THROW	NECK SIZE	MAX NC LEVEL	MANUFACTURER/MODEL NO.	REMARKS/NOTES		
S1	24"X24"	NO	WHITE	ADJ. 4-WAY	NOTE 1	25	PRICE / SPD	CEILING PLAQUE SUPPLY DIFFUSER		
S2	12"X12"	NO	WHITE	ADJ. 4-WAY	NOTE 1	25	PRICE/SPD	CEILING PLAQUE SUPPLY DIFFUSER		
S3	SEE PLANS	NO	WHITE	ADJ.	FULL SIZE	25	PRICE / 610Z	SIDEWALL SUPPLY GRILLE		
S5	24"X24"	NO	WHITE	DOWN	NOTE 1	25	PRICE / PDS	ALUMINUM PERFORATED FACE SUPPLY DIFFUSER		
LSD1	48" LONG, (2) 1" SLOTS	45	WHITE	VERTICAL, HORIZONTAL	-	25	TITUS / ML-39	EILING LINEAR SLOT SUPPLY AIR DIFFUSER / 2,3		
R1	24"X24"	NO	WHITE	-	NOTE 1	25	PRICE / SPD	CEILING RETURN GRILLE		
						,,,,,,				
R3	SEE PLANS		WHITE	-	FULL SIZE	25	PRICE / 610Z	SIDEWALL RETURN GRILLE		
.4 .4 .		4 .4 .4	444							
R5	48" LONG, (2) 1" SLOTS	NO	BLACK	-	NOTE 1	25	PRICE / SDR100, (2) SLOT	CEILING SLOT DIFFUSER / 4,6		
R6	24"X24"	NO	WHITE	-	NOTE 1	25	PRICE / PDR	ALUMINUM PERFORATED FACE RETURN DIFFUSER		
E1	24"X24"	NO	WHITE	-	NOTE 1	25	PRICE/SPD	CEILING EXHAUST GRILLE		
E2	12"X12"	NO	WHITE	·····	NOTE 1	25	PRICE/SPD	CEILING EXHAUST GRILLE		
w	24"X24"	NO	WHITE		NOTE 1	25	PRICE / PDR	ALUMINUM PERFORATED FACE EXHAUST DIFFUSER		

- A. CONTRACTOR TO COORDINATE FRAME STYLE WITH ARCHITECTURAL PLANS. FRAME TYPE SHALL MATCH CEILING TYPE AND MODULE DIMENSIONS.
- B. CONTRACTOR TO COORDINATE FINAL FINISHES WITH ARCHITECT. AIR DEVICES TO BE FACTORY PAINTED.
- C. NECK SIZES SHALL BE AS SCHEDULED UNLESS NOTED OTHERWISE ON PLANS.
- D. DUCT MOUNTED AIR DEVICES SHALL BE FLANGE MOUNTED. NO MOUNTING SCREWS SHALL BE VISIBLE EXCEPT ON EXPOSED DUCTWORK.

NOTES:

1. 6"Ø	0-100	CFM
8"Ø	101-225	CFM
10"Ø	226-400	CFM
12"Ø	401-600	CFM
14"Ø	601-900	CFM
15"x15	" 901-1000	CFM

2. GRILLE SHALL BE DOUBLE DEFLECTION TYPE WITH TWO SETS OF ADJUSTABLE BLADES ORIENTED PERPENDICULAR TO EACH OTHER.

N	MAKEUP AIR UNIT NAT	URAL GAS-DX COOLING SCHEDULE							
MARK		MAU-1							
SERVI	ES	KITCHEN HOODS							
	DESIGN CFM (1250 FT. ELEVATION)	5820							
7	E.S.P./T.S.P. ("WG)	2 / 2.58							
SUPPLY FAN	FAN TYPE/SIZE	DIRECT DRIVE BACKWARD CURVED ALUMINUM/24"							
JPPL	FAN MOTOR HP (MIN.)	5							
าร	POWER (V/PH/Hz)	460/3							
(1)	TYPE / NO. OF STAGES / POSITION	NATURAL GAS INDIRECT FIRED / FULL MODULATION / 10:1 TURNDOWN / DRAW-THROUGH							
GAS HEATING DATA	EAT °F / LAT °F	-7/69.2							
HEATI DATA	CAPACITY MBH OUTPUT (MIN)	480							
GAS	MBH INPUT (MAX)	600							
	EFFICIENCY (MIN)	-							
	TYPE COIL / W x H (INCHES) / SQ FT / POSITION	DX/ 45 SF / DRAW-THROUGH							
₹	CFM	5820							
L DA	MAX. FACE VEL. (FPM) / MAX. AIR P.D. ("WG)	129.3/0.11							
00 0	TOTAL / SENS / LAT (MBH) (MIN)/SHR	491.4/295.2/196.2/0.60							
COOLING COIL DATA	EAT °F DB/WB	102/78							
000	DX COIL LAT °F DB/WB & GAS BYPASS COIL LAT °F DB	51.0/50.9 & 68							
	MIN. ROWS/MAX. FINS PER INCH	6/14							
OUTSID	DE AIR CFM (MIN/MAX)	5820/5820							
WEIGH	T (LBS.) (OPERATING)	5753							
АТА	TYPE / THICKNESS	PLEATED / 4" THICK							
	MINIMUM EFFICIENCY (%)	MERV 8							
FILTER	MAX. VELOCITY (FPM)	181.9							
ш	P.D. (CLEAN/DIRTY) (IN WC)	0.04/0.35							
	MCA	83							
SICAL	MOCP	90							
ELECTRICAL	V / PH	460 / 3							
WxHx	L (MAXIMUM)	100.25" X 101.75" X 161.5"							
	, in the second	AAON RNA-040-D-A-3-HABBB-CB2L0							
NOTES		ALL							

- 1. FURNACE: 409 STAINLESS STEEL CONSTRUCTION. CONDENSATE DRAIN CONNECTION.
- 2. UNIT SHALL INCLUDE HOT GAS BYPASS COMPONENT. 3. MAIN POWER AND CONTROL PANEL WITH DISCONNECT SWITCH AND SINGLE-POINT POWER CONNECTION SERVING ALL
- ELECTRICAL ITEMS INCLUDING CONTROLS AND LIGHT FIXTURES. 4. STAINLESS STEEL COIL DRAIN PAN AND COIL CASING.
- 5. VAPORTIGHT LED LIGHT FIXTURE IN EACH ACCESSIBLE SECTION.
- 6. FULL PERIMETER STEEL INSULATED ROOF CURB, MINIMUM 30" HIGH, NO CANT, INSULATED, LEVEL TOP.
- 7. PROVIDE SOUND BLANKETING, MANUFACTURER'S REFRIGERANT DETECTION SYSTEM, AND POSITIVE AIRFLOW SWITCH FOR GAS BURNER. 8. SCCR: 10k

AIR HANDLING UNIT -SCHEDULE

MARK		AHU-12
SERVI	ES	LEVEL 3 NORTH AND EAST WINGS
	CFM (AHU TOTAL SA)	22000
	BALANCE CFM	20250
_	ESP / TSP ("WC)	2.50/6.51
'FAN	FAN MOTOR QTY / HP (MIN)	2 / 20 HP
SUPPLY FAN	FAN MOTOR BHP	15.30 BHP
S	(VOLTS/PHASE)	460/3
	FAN WHEEL TYPE	SWSI
	DRIVE	DIRECT
	CFM (AHU TOTAL RA)	16000
	BALANCE CFM	14400
FAN	ESP / TSP ("WC)	1.5/2.32
RETURN FAN	FAN MOTOR QTY / HP (MIN)	2 / 7.5 HP
RET	FAN MOTOR BHP	5.05 BHP
	(VOLTS/PHASE)	460/3
	FAN WHEEL TYPE	SWSI
	DRIVE	DIRECT
	TYPE COIL / W x H (INCHES)	CHW/129x75
	DESIGN CFM	22000
⋖	MAX. FACE VEL. (FPM)	430
COIL DATA	(MAX. AIR P.D. ("WG) = 1.00 U.N.O.)	0.57
100	TOTAL / SENS / LAT (MBH) (MINIMUM)	1108/667/441
-ING	EAT °F DB/WB	80/67
COOLING	LAT °F DB/WB	51.1/50.7
	EWT °F / LWT °F (REFERENCE)	42/54.1
	GPM (MAXIMUM)	182.5
	WATER PD (FT.) (MAXIMUM)	16.8
	MINIMUM ROWS / MAXIMUM FINS PER INCH	6/8
	TYPE / POSITION	HW/PREHEAT
	DESIGN CFM	22000
_	MAX. FACE VEL. (FPM) (AT MAX AHU CFM)	430
DAT/	MAXIMUM AIR P.D. ("WG) (AT MAX AHU CFM)	0.09
	EAT °F DB / LAT °F DB (REFERENCE)	43/66
HEATING COIL DATA	MINIMUM MBH OUTPUT	820
leat	EWT °F / LWT °F (REFERENCE)	140/110
_	GPM (MAXIMUM)	56.2
	WATER PD (FT.) (MAXIMUM)	2.5
	MINIMUM ROWS / MAXIMUM FINS PER INCH	1/8
	TYPE	DIRECT INJECTION STEAM
ATA	DESIGN CFM	22000
HUMIDIFIER DATA	STEAM PSI	15
DIFIE	HUMIDIFICATION LOAD (LBS/HR)	201
IMOT.	EAT & RH % / LAT & RH%	50 & 20% / 55 & 42%
_	ABSORPTION DISTANCE (IN)	5.4
OUTSI	DE AIR CFM (MIN/MAX) (AT FULL COOLING)	5850 / 22000
∢	ТҮРЕ	4" MINI PLEAT
Ţ	EEEICIENICY (9/) (ACHDAE 52)	I

EFFICIENCY (%) (ASHRAE 52)

MAXIMUM VELOCITY (FPM)

분 P.D. (CLEAN/DIRTY) (INCHES W.G.)

EFFICIENCY (%) (ASHRAE 52)

MAXIMUM VELOCITY (FPM)

MANUFACTURER / MODEL NO. (JCI)

UNIT NOMINAL DIMENSIONS (INCHES) WIDTH x HEIGHT x LENGTH

WEIGHT (LBS.)

NOTES

60% (MERV 11)

90% (MERV 14)

0.42 / 0.85 12" RIGID

0.49 / 1.5

15487

XTI - 75x129

129x75x399

NOTES (AHU's):

- ISP EQUALS AHU SP LOSS WITH DIRTY FILTERS. TSP EQUALS ESP + ISP. TSP LISTED IS FOR REFERENCE ONLY.
- 2. FAN MOTOR NAMEPLATE HP SHALL NOT BE EXCEEDED AT SCHEDULED CFM AND TSP
- 3. IF MANUFACTURER'S COOLING COIL PROMOTES MOISTURE CARRYOVER AT THE ALLOWABLE MAX FACE VELOCITY, THEY SHALL OVERSIZE THE COIL FACE AREA TO PREVENT MOISTURE CARRYOVER AT THESE CONDITIONS.
- 4. COILS SHALL NOT BE COATED UNLESS NOTED OTHERWISE.
- 5. COOLING COIL SENSIBLE HEAT RATIO (SHR) TOLERANCE EQUALS PLUS OR MINUS 0.3. EXAMPLE: CSHR = 0.79 MAX = 0.76 MIN=0.82
- 6. 5/8" OD TUBES
- 7. PROVIDE LED LIGHT FIXTURE IN EACH ACCESSIBLE SECTION. PROVIDE ONE TIMER SWITCH WITH PILOT LIGHT TO ENERGIZE ALL LIGHTS. FACTORY WIRE ALL
- FIXTURES AND SWITCHES TO EXTERNAL JUNCTION BOX FOR FIELD CONNECTION TO A 120V CIRCUIT 8. PRE-FILTERS SHALL BE SNAP-IN TYPE WITH SUPPORTS ON ALL FOUR SIDES. FILTER BANK SHALL BE FULL-SIZE.
- 9. HORIZONTAL DRAW-THRU
- 10. DOUBLE WALL CONSTRUCTION WITH THERMAL PERFORMANCE AS SPECIFIED.
- 11. INTERNALLY ISOLATED FAN, DRIVE, AND MOTOR.
- 12. PROVIDE (2) VARIABLE FREQUENCY DRIVES FOR EACH SUPPLY FAN ARRAY. VFDs TO BE SIZED FOR 50% OF THE FAN ARRAY'S AGREGATE FAN HORSEPOWER.
- 13. COIL CASINGS SHALL BE STAINLESS STEEL.
- 14. FINAL BALANCED CFM TO BE COORDINATED WITH T&B CONTRACTER AFTER CONSTRUCTION COMPLETION. 15. SCCR RATING SHALL MATCH PANELBOARD RATING.
- 16. PROVIDE SEPARATE MINIMUM OUTSIDE AIR AND ECONOMIZER OUTSIDE AIR DAMPERS. 17. SCCR: 10k




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vt23/MEP_LSMC Med Surg			

DATE:
DRAWN:
PROVIDENCE OF THE COMMENT OF THE COMME As indicated 9 JOB NUMBER: 6406.24

SCHEDULES - MECHANICAL

M08-01

	DESIGNATION	FCU-CP-7				
	LOCATION	LEVEL 1 CUP				
	SERVICE	LEVEL 1 CUP				
	MAX CFM	1750				
	EXT. S.P. ("WG)	0.5				
FAN	FAN MOTOR HP (MIN) (1750 RPM)	1				
DATA	POWER SUPPLY (VOLTS/PHASE)	460 / 3				
	DRIVE	ECM				
	FAN RPM	1148				
	TYPE / MIN SQ. FT.	CHW				
	СҒМ	1750				
	MAX FACE VELOCITY (FPM)	435				
	EAT °F DB/WB	75 / 63				
COOLING	LAT °F DB/WB	54.4 / 53.7				
COIL	EWT °F/DT	44 / 12				
DATA	GPM	11.1				
	WATER P.D. (FT)	2.62				
	MIN. NO. OF ROWS / MAX FINS PER INCH	6 / 10				
	TYPE / PH = PREHEAT, RH = REHEAT	RH				
	CFM	1750				
	MAX FACE VELOCITY (FPM)/MAX APD ("W.G.)	435				
	MIN. MBH OUTPUT	87.9				
HEATING	EAT °F DB / LAT °F DB	50 / 88.8				
COIL	EWT °F/DT	140 / 30				
DATA	BALANCED GPM	4				
	WATER P.D. (MAX FT)	4.18				
	MIN. NO. OF ROWS / MAX FINS PER INCH	2 / 10				
OUTSIDE AIR C	FM (MIN / MAX) (AT FULL COOLING)	NONE				
	TYPE & THICKNESS	TA/2" PLEATED FLAT				
FILTER	EFFICIENCY (%) / MERV RATING	65%/11				
DATA	MAX. VELOCITY (FPM)	315				
	P.D. (DIRTY / CLEAN)	0.85/0.3				
MANUFACTURE	ER / MODEL NO.	ENVIROTEC HDD 16				
	(INCHES) LENGTH x WIDTH x HEIGHT W/O PLENUMS	40 x 44 x 21				
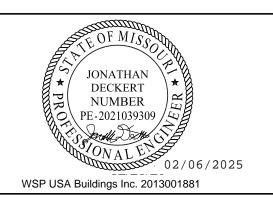
<u> </u>	
1.	FIBER FREE 1" THICK INSULATION.
	COIL REMOVAL ACCESS ON BOTH SIDES

- DRAIN PAN: STAINLESS STEEL REMOVABLE, MAIN AND OVERFLOW CONNECTIONS. COILS: SLIDE IN/OUT ON RAILS. HORIZONTAL DRAW-THRU.
- 2. MAIN POWER AND CONTROL PANEL WITH SINGLE POINT POWER AND INTEGRAL DISCONNECT SWITCH.
- 3. IF ANY MANUFACTURER'S COOLING COIL PROMOTES MOISTURE CARRYOVER AT THE ALLOWABLE MAXIMUM FACE VELOCITY THEY SHALL OVERSIZE COOLING COIL FACE AREA TO PREVENT MOISTURE CARRYOVER
- 4. COILS: NO COATINGS, NO TURBULATORS
- 5. SCCR: 10k

	SPLIT SYSTEM A/C UN	VII SCHEDULE			
	DESIGNATION	LEVEL 3 / LEVEL 01			
	LOCATION	LEVEL 3 / LEVEL 01 COMM / EXISTING ELEV MACHINE RMS TWG) PH 208 / 1 - (xHxD) (IN) 47 1/4"X14 23/32"X10 7/16" LBS) 41 (WB (BTUH) 34,000 (BTUH) ON ACCU-2, 3, 4 PH 208 / 1 23			
	SERVICE	COMM / EXISTING ELEV MACHINE RMS			
	SUPPLY CFM	1095			
	EXT. S.P. ("WG)	-			
INDOOR UNIT		208 / 1			
DATA		-			
DATA		-			
	DIMENSIONS (WxHxD) (IN)	47 1/4"X14 23/32"X10 7/16"			
	WEIGHT (LBS)	41			
COOLING	EAT °F DB/WB	80 / 67			
COOLING DATA	SENS. HEAT (BTUH)	34,000			
DATA	TOTAL HEAT (BTUH)	34,000			
CONDEN	SING UNIT DESIGNATION	ACCU-2, 3, 4			
	VOLTS / PH	208 / 1			
CU	MCA	23			
DATA	MOCP	30			
DATA	DIMENSIONS (WxHxD) (IN)	32 3/4"X37 13/32"X13"			
	WEIGHT (LBS)	148			
	SCCR (AMPS)	*			
N	MANUFACTURER	LG			
INDOOF	R FAN COIL MODEL NO.	LSN363HLV3			
CONDE	USING UNIT MODEL NO	SU363HLV3			

- 1. CAPACITY AT 105°F O.A.T.
- 2. 14.0 MIN. SEER RATING. 3. CONTRACTOR SHALL PROVIDE AND INSTALL FACTORY POWERED
- CONTROLS AND CONTROL TRANSFORMER
- 4. PROVIDE ELECTRONIC ALTERNATOR AND FLOAT SWITCHES. FACTORY WIRED SINGLE POINT CONNECTION
- 6. ELECTRICAL CONTRACTOR TO CONNECT EXTERIOR UNIT TO INTERIOR UNIT.
- 7. R-32 REFRIGERANT. *SCCR RATING TO MEET OR EXCEED PANEL AIC RATING

										Н	I.W. COIL					
ESIGNATION	INLET	MIN		MAX COOLING		VALVE MAX	EAT	LAT	EWT		MAX WATER		MIN	MAX	JCI	NOTES
\/A\/ 4O 4	SIZE (IN)	CFM	CFM	CFM	(IN / IN)	APD (IN WG)	DB °F	DB °F	°F	°F	P.D. (FT)	GPM	ROWS	N.C.	MODEL NUMBER	4 0 4
VAV-12-1 VAV-12-2	6"	200	200	375	8 / 12	0.25	52	95	140	110	10	0.5	2	30	TSS-06	1, 3-1
/AV-12-2 /AV-12-3	6" 6"	200 200	200	400 375	8 / 12 8 / 12	0.25 0.25	52 52	95 95	140 140	110	10	0.5	2 2	30 30	TSS-06 TSS-06	1, 3-1; 1, 3-1;
VAV-12-3 VAV-12-4	6"	200	200	400	8 / 12	0.25	52	95	140	110	10	0.5	2	30	TSS-06	1, 3-1
/AV-12-5	6"	200	200	400	8 / 12	0.25	52	95	140	110	10	0.5	2	30	TSS-06	1, 3-1
VAV-12-6	6"	200	200	400	8 / 12	0.25	52	95	140	110	10	0.5	2	30	TSS-06	ALL
VAV-12-7	6"	350	350	350	8 / 12	0.25	52	95	140	110	10	0.9	2	30	TSS-06	1, 3-1
VAV-12-8	6"	175	175	325	8 / 12	0.25	52	95	140	110	10	0.5	2	30	TSS-06	1, 3-1
VAV-12-9	6"	175	175	325	8 / 12	0.25	52	95	140	110	10	0.5	2	30	TSS-06	1, 3-1
/AV-12-10	6"	175	175	325	8 / 12	0.25	52	95	140	110	10	0.5	2	30	TSS-06	1, 3-1
/AV-12-11	6"	175	175	325	8 / 12	0.25	52	95	140	110	10	0.5	2	30	TSS-06	1, 3-1
/AV-12-12	6"	200	200	325	8 / 12	0.25	52	95	140	110	10	0.5	2	30	TSS-06	1, 3-1
/AV-12-13	6"	175	175	350	8 / 12	0.25	52	95	140	110	10	0.5	2	30	TSS-06	1, 3-1
/AV-12-14	6"	175	175	350	8 / 12	0.25	52	95	140	110	10	0.5	2	30	TSS-06	1, 3-1
'AV-12-15 'AV-12-16	6" 6"	175 175	175 175	350 350	8 / 12 8 / 12	0.25 0.25	52 52	95 95	140 140	110	10	0.5	2 2	30 30	TSS-06 TSS-06	1, 3-1; 1, 3-1;
AV-12-16 AV-12-17	6"	175	175	350	8 / 12	0.25	52	95	140	110	10	0.5	2	30	TSS-06	1, 3-1. 1, 3-1.
AV-12-17 AV-12-18	6"	175	175	350	8 / 12	0.25	52	95	140	110	10	0.5	2	30	TSS-06	1, 3-1
AV-12-10 AV-12-19	6"	175	175	350	8 / 12	0.25	52	95	140	110	10	0.5	2	30	TSS-06	1, 3-1
AV-12-20	6"	150	150	300	8 / 12	0.25	52	95	140	110	10	0.4	2	30	TSS-06	ALL
AV-12-21	6"	350	350	350	8 / 12	0.25	52	95	140	110	10	0.9	2	30	TSS-06	ALL
AV-12-22	6"	200	200	375	8 / 12	0.25	52	95	140	110	10	0.5	2	30	TSS-06	1, 3-1
AV-12-23	6"	200	200	375	8 / 12	0.25	52	95	140	110	10	0.5	2	30	TSS-06	1, 3-1
AV-12-24	6"	200	200	375	8 / 12	0.25	52	95	140	110	10	0.5	2	30	TSS-06	1, 3-1
AV-12-25	6"	200	200	375	8 / 12	0.25	52	95	140	110	10	0.5	2	30	TSS-06	1, 3-1
AV-12-26	6"	200	200	375	8 / 12	0.25	52	95	140	110	10	0.5	2	30	TSS-06	1, 3-1
AV-12-27	6"	200	200	375	8 / 12	0.25	52	95	140	110	10	0.5	2	30	TSS-06	1, 3-1
AV-12-28	6"	200	200	375	8 / 12	0.25	52	95	140	110	10	0.5	2	30	TSS-06	1, 3-1
AV-12-29	6"	125	130	400	8 / 12	0.25	52	95	140	110	10	0.4	2	30	TSS-06	1, 3-1
AV-12-30	6"	75	75	150	8 / 12	0.25	52	95	140	110	10	0.2	2	30	TSS-06	1, 3-1
AV-12-31	6"	350	350	350	8 / 12	0.25	52	95	140	110	10	0.9	2	30	TSS-06	1, 3-1
AV-12-32 AV-12-33	6" 6"	75 175	75 175	75 325	8 / 12 8 / 12	0.25 0.25	52 52	95 95	140 140	110	10	0.2	2	30 30	TSS-06 TSS-06	1, 3-1 1, 3-1
AV-12-33 AV-12-34	8"	425	425	550	10 / 12	0.25	52	95	140	110	10	1.1	2	30	TSS-08	1, 3-1
'AV-12-34	6"	150	150	150	8 / 12	0.25	52	95	140	110	10	0.4	2	30	TSS-06	1, 3-1
AV-12-36	6"	75	75	150	8 / 12	0.25	52	95	140	110	10	0.2	2	30	TSS-06	1, 3-1
'AV-12-37	6"	325	325	325	8 / 12	0.25	52	95	140	110	10	0.8	2	30	TSS-06	1, 3-1
AV-12-38	10"	850	850	850	12.5 / 14	0.25	52	95	140	110	10	2.1	2	30	TSS-10	1, 3-1
AV-12-39	6"	150	150	300	8 / 12	0.25	52	95	140	110	10	0.4	2	30	TSS-06	1, 3-1
AV-12-40	6"	75	75	200	8 / 12	0.25	52	95	140	110	10	0.2	2	30	TSS-06	1, 3-1
AV-12-41	6"	200	200	250	8 / 12	0.25	52	95	140	110	10	0.5	2	30	TSS-06	1, 3-1
AV-12-42	8"	0	0	600	10 / 12	0.25	52	95	140	110	10	0.0	2	30	TSS-08	1, 3-1
AV-12-43	10"	250	250	775	12.5 / 14	0.25	52	95	140	110	10	0.7	2	30	TSS-10	1, 3-1
AV-12-44	6"	300	300	300	8 / 12	0.25	52	95	140	110	10	0.8	2	30	TSS-06	1, 3-1
AV-12-45	10"	425	425	850	12.5 / 14	0.25	52	95	140	110	10	1.1	2	30	TSS-10	1, 3-1
AV-12-46	6"	50	65	75	8 / 12	0.25	52	95	140	110	10	0.2	2	30	TSS-06	1, 3-1
AV-12-47 AV-12-48	6" 8"	75 225	75 225	150 450	8 / 12 10 / 12	0.25 0.25	52 52	95 95	140 140	110	10	0.2	2 2	30 30	TSS-06 TSS-08	1, 3-1 1, 3-1
AV-12-46 AV-12-49	6"	150	150	150	8 / 12	0.25	52	95	140	110	10	0.6	2	30	TSS-06	1, 3-1
4V-12-49 4V-12-50	8"	0	0	600	10 / 12	0.25	52	95	140	110	10	0.4	2	30	TSS-08	1, 3-1
AV-12-50 AV-12-51	8"	350	350	675	10 / 12	0.25	52	95	140	110	10	0.0	2	30	TSS-08	1, 3-1
V-12-51 V-12-52	6"	75	75	75	8 / 12	0.25	52	95	140	110	10	0.2	2	30	TSS-06	1, 3-1
AV-12-53	8"	0	0	600	10 / 12	0.25	52	95	140	110	10	0.0	2	30	TSS-08	1, 3-1
AV-12-54	6"	50	65	125	8 / 12	0.25	52	95	140	110	10	0.2	2	30	TSS-06	1, 3-1
AV-12-55	8"	600	600	600	10 / 12	0.25	52	95	140	110	10	1.5	2	30	TSS-08	1, 3-1
AV-12-56	6"	50	65	100	8 / 12	0.25	52	95	140	110	10	0.2	2	30	TSS-06	1, 3-1

- 2. PROVIDE 3 WAY VALVE AS INDICATED ON DRAWINGS.
- 3. UNIT MOUNTED / WIRED FACTORY CONTROL PANEL.
- 4. PRESSURE INDEPENDENT CONTROLS COMPATIBLE WITH BUILDING CONTROLS
- 5. CONSTANT AIR VOLUME (CAV) BOXES SHALL BE IDENTICAL TO VARIABLE AIR VOLUME (VAV) BOXES.
- 6. FACTORY INTERNAL INSULATION: INTERNAL FIBER FREE CLOSED CELL INSULATION.
- 7. CFM DELIVERY SHALL BE ACCURATE WITHIN 5% OF FROM 25-100% OF SCHEDULED BOX CFM.
- 8. H.W. COIL SHALL BE LOCATED AT DISCHARGE OF BOX.
- 9. OUTLET PLENUM BY INCLUDED BY MANUFACTURER. COORDINATE WITH RUNOUT SIZES TO AIR DEVICES. PROVIDE TRANSITION FROM BOX OUTLET PLENUM TO DUCTWORK. UPSIZE AS REQUIRED.

- 11. PROVIDE PIPING CONNECTION TO TERMINAL UNIT REHEAT COILS AS SCHEDULED:
 - 0 4.0 GPM 4.1 - 8.0 GPM : 1-1/4" 8.1 - 15.0 GPM
- 12. VAV BOXES SHALL NOT EXCEED A 95° LEAVING AIR TEMPERATURE WHEN BOX MODEL AND HEATING COIL ARE SELECTED BY MANUFACTURER.

		PUMI	P SCI	HEDL	JLE						
	MIN. EFF.		TDH		M	OTOR ELECTRICA	٩L		WEIGHT		
TYPE	(%)	GPM	(FT)	HP	RPM	VOLT/PHASE	DRIVE	AVAILABLE FAULT (AIC)	(LBS)	MANUFACTURER / MODEL	NOTES
VERTICAL IN-LINE	28.6	30	5	1/3	2042	120 / 1	НОА	5k	41	ARMSTRONG / SERIES 4380	2,3
END SUCTION	80	860	130	50	1750	460 / 3	VFD	18k	1000	BELL & GOSSETT / 1510 - 4GB	ALL
<u> </u>											

. VFD FURNISHED BY DIVISION 26 CONTRACTOR.

MARK

CHWP-3

2. PUMP MOTOR SHALL BE NON-OVERLOADING THROUGHOUT THE FULL RANGE OF THE PUMP CURVE

SERVES

AHU-12

CHILLED WATER

3. DISCONNECT SWITCH FURNISHED BY DIVISION 26 CONTRACTOR.

* AIC RATING SHALL MEET OR EXCEED PANEL RATING

						W	ATER	CO	OLED	CH	ILLER	SCH	EDUL	.E						
DESIGNATION	SERVES	TYPE	TONS			EVAPORAT	OR DATA					CONDENS	ER DATA				ELECTRIC DA	ATA	MANUFACTURER / MODEL	NOTES
				GPM	FOUL FACT	EWT (°F)	LWT (°F)	PASS	P.D. (FT)	GPM	FOUL FACT	EWT (°F)	LWT (°F)	PASS	P.D. (FT)	FLA	KW / TON	VOLTS / PH		
CH-3	CENTRAL PLANT	CENTRIFUGAL	430	857	0.0001	58	42	2	9.83	1310	0.00025	85	95	2	6.13	334	0.5987	460/3	YORK / YMC2-S1512BBS	ALL

NOTES:

- VFD AND HARMONIC FILTER
- MAINTAIN RECOMMENDED MANUFACTURER'S CLEARANCES.
- CHILLER SHALL BE SELECTED AT 58 F EWT / 42 F LWT BUT SHALL OPERATE AT 54 F EWT / 42 F LWT.
- SCCR: 42k

Devenney GROUF Devenney Group Ltd., Architects

CONSTRUCTION As Noted on Plans Review

6900 East Camelback Road Suite 500 Scottsdale, AZ 85251 T: 602.943.8950

www.devenneygroup.com

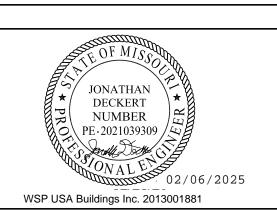


FIGURE 15 IF THESE PLANS DO NOT BEAR THE SEAL OF A REGISTRANT, THEY ARE TO BE CONSIDERED "PRELIMINARY" AND ARE NOT TO BE USED FOR CONSTRUCTION OR RECORDING. THESE PLANS ARE COPYRIGHTED AND ARE SUBJECT TO COPYRIGHT PROTECTION AS AN "ARCHITECTURAL WORK" UNDER SEC. 102 OF THE COPYRIGHT O ACT, 17 U.S.O. AS AMENDED DECEMBER 1990 AND KNOWN AS ARCHITECTURAL WORKS COPYRIGHT PROTECTION ACT OF 1990. THE PROTECTION INCLUDES BUT IS NOT LIMITED TO THE OVERALL FORM AS WELL AS THE ARRANGEMENT AND COMPOSITION OF SPACES AND ELEMENTS OF THE DESIGN. UNDER SUCH
PROTECTION, UNAUTHORIZED USE OF THESE PLANS CAN LEGALLY RESULT IN THE CESSATION OF CONSTRUCTION OR BUILDINGS BEING SEIZED AND/OR MONETARY COMPENSATION TO DEVENNEY GROUP LTD.

INPATIENT BED EXPANSION

HCA - LEE'S SUMMIT MEDICAL CENTER 2100 SE BLUE PKWY LEE'S SUMMIT, MO 64063

authority having jurisdiction: CITY OF LEE'S SUMMIT BUILDING DEPT.

AUTHORITY HAVING JURISDICTION'S PROJECT NO:

FACILITY NUMBER: 0972400009

AGENCY APPROVALS:

REVISIONS DATE DESCRIPTION ω REV#
 S | B
 DESIGN COORDINATION
 2025/02/06

DATE:

Property of the control of th 12" = 1'-0" 9 JOB NUMBER:

SCHEDULES - MECHANICAL

M08-03

ARK	TYPE	SYSTEM	MINIMUM PRESSURE RATING(PSIG)	BODY	INTERNAL CONSTRUCTION	INLET/OUTLET PIPING	INTEGRAL	0175		PACITY	ODIFICE DIA	MANUFACTURER/MODEL NO.	NOTE
	(DESCRIPTION)	APPLICATION	(SATURATED)	MATERIAL	MATERIALS	ARRANGEMENT	COMPONENTS	SIZE (INCHES)	DIFFERENTIAL (PSI)	PPH	ORIFICE DIA. (INCHES)	(SARCO)	NOTES
T-1	FLOAT AND	LPS ONLY	15	CAST IRON	STAINLESS	IN-LINE	1. FLOAT	0.75	0.25	279	0.22"	FTI-15	1,2
Γ-2	THERMOSTATIC TRAP				STEEL	HORIZONTAL	2. THERMOSTATIC AIR VENT	1.25	0.25	600	0.31"	FTI-15	1,2
Γ-3								1.50	0.25	1100	0.50"	FTI-15	1,2
-4								2.00	0.25	2600	2 AT 0.75	FTB-175	1,2
Г-5								2.00	0.25	6000	0.94"	FTB-20	1,2
-6								2.00	0.25	12000	2 AT 2.12"	FTB-30	1,2
-7								2.50	0.25	19000	2 AT 2.12"	FTB-125	1,2
-8	FLOAT AND THERMOSTATIC	HPS ONLY	125	CAST IRON	STAINLESS STEEL	IN-LINE HORIZONTAL	1. FLOAT	0.75	0.25	100	0.12"	FTI-125	1,2
-9	TRAP	(NOTE 7)			SIEEL	HORIZONTAL	2. THERMOSTATIC AIR VENT	1.25	0.25	400	0.25"	FTI-125	1,2
-10								1.50	0.25	920	2 AT 0.38"	FTB-175	1,2
-11								2.00	0.25	2600	2 AT 0.75"	FTB-175	1,2
-12								2.50	0.25	7000	2 AT 1.50"	FTB-175	1,2
⁻ -1	INVERTED BUCKET TRAP	HPS ONLY (NOTE 6)	125	CAST IRON	STAINLESS STEEL	IN-LINE HORIZONTAL	1. INVERTED BUCKET	0.75	20	446	0.12"	B1H-125	1,2,3
-2	BUCKETTRAP	(NOTE 0)			SIEEL	HORIZONTAL	2. STRAINER, MONEL 3. BIMETALIC AIR	0.75	20	1100	0.20"	B2-125	1,2,3
Г-3							VENT, INTERNAL	1.0	20	2080	0.25"	B3-125	1,2,3
/-1	THERMOSTATIC AIR VENT	LPS HPS	125	BRASS	STAINLESS STEEL	1. VERTICAL INLET	1. THERMOSTATIC	0.38" X 0.25"	50 PSIG INLET	40 SCFM AIR	-	T202	2,4
/-2	AIR VENT	пго			SIEEL	2. HORIZONTAL	AIR VENT	0.50	50 PSIG INLET	88 SCFM AIR	-	VS204	1,2
V-3						OR VERTICAL OUTLET		0.75	50 PSIG INLET	112 SCFM AIR	-	VS206	1,2
3-1	VACUUM BREAKER	LPS HPS	125	BRASS	STAINLESS STEEL	1. VERTICAL INLET 2. HORIZONTAL OUTLET	1. BALL CHECK VALVE	0.5" X 0.12"	6" HG VACUUM	4.0 SCFM AIR	-	VB14	2,4,5

	T		ιпυ	-0 IEF	RMINA	LUINI	ı vv/ □			VG		.W. COIL	COI		ПЕО	ULE	
DESIGNATION	BOX	INLET	MIN	MAY HEATING	MAX COOLING	OUTLET SIZE	VALVE MAX	EAT	LAT	EWT	1	MAX WATER	MAX ELOW	MIN	MAX	JCI	NOTES
DESIGNATION	TYPE	SIZE (IN)	CFM	CFM	CFM	(IN / IN)	APD (IN WG)	DB °F	DB °F	°F	°F	P.D. (FT)	GPM	ROWS	N.C.	MODEL NUMBER	NOTES
VAV-8-12	A	6"	100	100	325	8 / 12	0.25	52	95	140	110	10	0.3	2	30	TSS-06	1, 3-12
VAV-8-13	F	16"	650	650	2,150	18 / 24	0.25	52	95	140	110	10	1.6	2	30	TSS-16	ALL
VAV-8-14	F	16"	650	650	2,150	18 / 24	0.25	52	95	140	110	10	1.6	2	30	TSS-16	1, 3-12
VAV-8-15	E	14"	600	600	2,000	17.5 / 20	0.25	52	95	140	110	10	1.5	2	30	TSS-14	1, 3-12
VAV-8-17	С	10"	250	250	825	12.5 / 14	0.25	52	95	140	110	10	0.7	2	30	TSS-10	1, 3-12
VAV-8-18	Α	6"	225	225	275	8 / 12	0.25	52	95	140	110	10	0.6	2	30	TSS-06	1, 3-12
3		UNIT MOUNTE	D / WIRED	FACTORY CONT	ROL PANEL.					PROVIDI COILS A	S SCHE	G CONNECTIO EDULED: 0 - 4.0 GPM 4.1 - 8.0 GPM 8.1 - 15.0 GPM		NAL UNIT REF : 3/4" : 1" : 1-1/4"	IEAT		
4		PRESSURE INI SYSTEM.	DEPENDEN	IT CONTROLS CO	OMPATIBLE WITH	BUILDING CONTF	ROLS		12.			ALL NOT EXCE					
5		CONSTANT AII VOLUME (VAV		(CAV) BOXES SH	IALL BE IDENTICA	L TO VARIABLE A	AIR										
6		FACTORY INTE	ERNAL INS	ULATION: INTERN	NAL FIBER FREE C	LOSED CELL INS	SULATION.										
7		CFM DELIVERY		E ACCURATE WIT	THIN 5% OF FROM	25-100% OF											
8		H.W. COIL SHA	ALL BE LO	CATED AS DISCHA	ARGE OF BOX.												
9				LUDED BY MANU OUT SIZES TO AI													

MAU TERMINAL UNIT SCHEDULE

									DESIGNATION	INLET	MIN	MAX HEATING	MAX	OUTLET SIZE	VALVE MAX	MAX	JCI	NOTES
										SIZE (IN)	CFM	CFM	CFM	(IN / IN)	APD (IN WG)	N.C.	MODEL NUMBER	
									VAV-M-1	16"	2,700	2,700	2,700	18 / 24	0.25	30	TSS-16	ALL
									VAV-M-2	16"	3,120	3,120	3,120	18 / 24	0.25	30	TSS-16	ALL
	W	ΔΙΙ Ι	HFΔT	FR S	CHF	DULE			2.	A) B)	ND COOLING CFN COOLING CFM HEATING CFM :	I ARE PER PLANS AS FO = BOX MAXIMUM CFM. = MINIMUM COOLING CFI Y CONTROL PANEL.		CFM.	11.	TEMPERATURE TERMINAL BOX	CONTROLS MANUFACTUR FACTORY BY TERMINAL B G CONNECTION TO TERMI	IAL UNIT REHEAT
	V V					DOLL			4	PRESSURE INDE	PENDENT CONTI	ROLS COMPATIBLE WITH	I BLUI DING CONTE	201 S			0 - 4.0 GPM 4.1 - 8.0GPM 8.1 - 15.0 GPM	: 3/4" : 1" : 1-1/4"
DESIGNATION	SERVES	KW	VOLTS/PH	STAGES	FAN CFM	MANUFACTURER/MODEL NO.	REMARKS/NOTES			SYSTEM.	OLUME (CAV) BO	DXES SHALL BE IDENTICA					ALL NOT EXCEED A 95° LEA	
CH-9,10	STAIRS	5	208/1	1	250	QMARK AWH-4508	1,2,3		6.	, ,		: INTERNAL FIBER FREE	CLOSED CELL INS	SULATION.				
NOTES:									7.	CFM DELIVERY S		ATE WITHIN 5% OF FROI	И 25-100% OF					
1	COMPLETE WITH THE	ERMOSTAT.							8.	H.W. COIL SHALL	BE LOCATED AT	DISCHARGE OF BOX.						
2	COMPLETE WITH FUS	SED DISCON	NECT SWITCH.						9.	COORDINATE WI	TH RUNOUT SIZE	Y MANUFACTURER. ES TO AIR DEVICES. COUTLET PLENUM TO DI	JCTWORK. UPSIZI	E AS REQUIRED.				
								•										


William Market M

CONSTRUCTION
As Noted on Plans Review Devenney GROUP

Devenney Group Ltd., Architects 6900 East Camelback Road Suite 500

T: 602.943.8950 www.devenneygroup.com

Scottsdale, AZ 85251

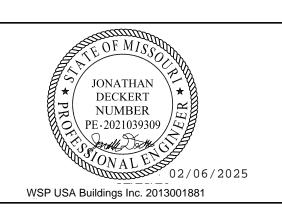

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INPATIENT BED EXPANSION

HCA - LEE'S SUMMIT MEDICAL CENTER 2100 SE BLUE PKWY LEE'S SUMMIT, MO 64063

AUTHORITY HAVING JURISDICTION: MISSOURI DHSS

AUTHORITY HAVING JURISDICTION'S PROJECT NO:

FACILITY NUMBER: 0972400009


AGENCY APPROVALS:

REVISIONS REV # DESCRIPTION
B DESIGN COORDINATION DATE 2025/02/06

DATE:
SCALE:
DRAWN:
REVIEWED:
JOB NUMBER: SCHEDULES - MECHANICAL

2024/12/05 As indicated

M08-04

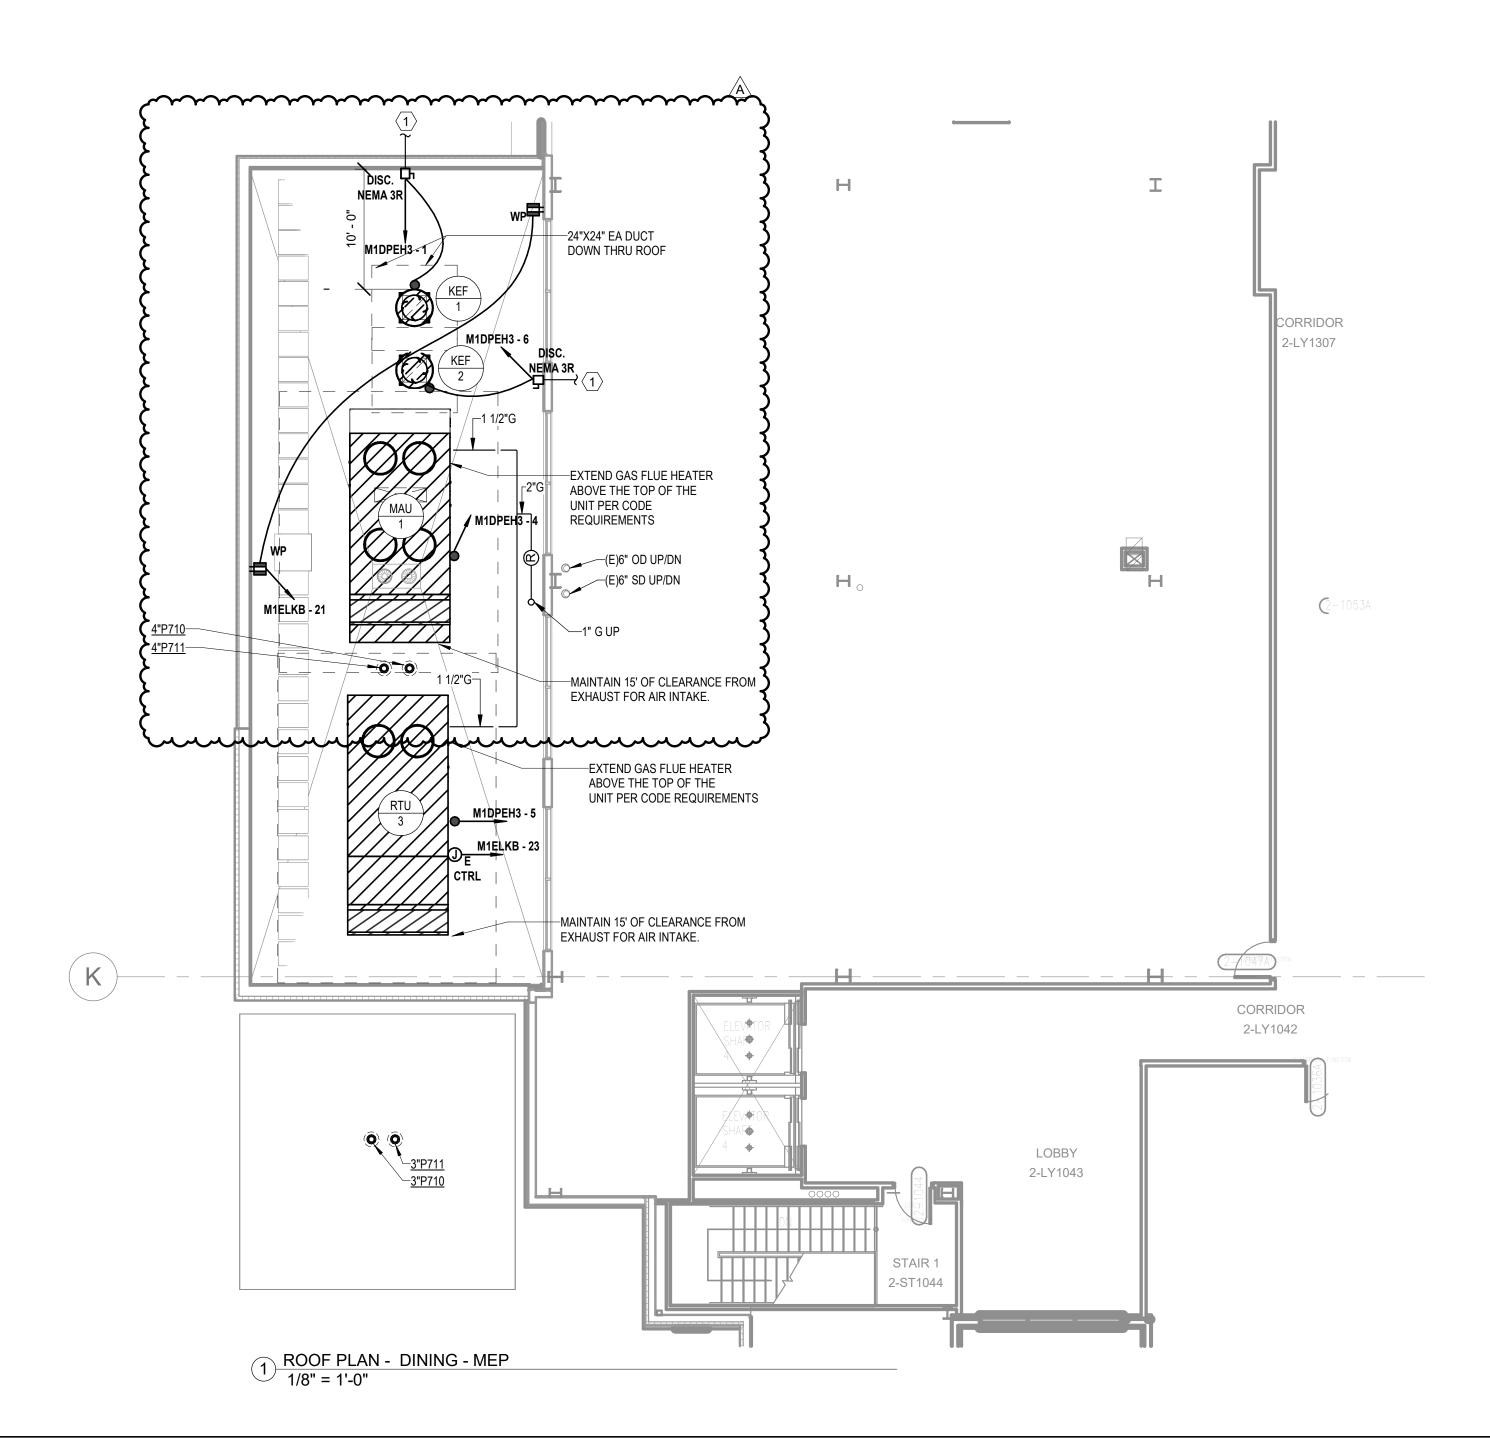

- A. REFER TO M00-00 FOR GENERAL MECHANICAL NOTES AND SYMBOLS. B. CONTRACTOR TO VERIFY EXISTING CONDITIONS. EXISTING
- WORK SHOWN IS APPROXIMATE AND REPRESENTATIVE OF
- EXISTING DESIGN AND AS-BUILT DRAWINGS. C. PROVIDE REMOTE ADJUSTABLE DAMPERS FOR ANY BALANCING DAMPERS LOCATED ABOVE HARD CEILINGS.
- D. ACCESS PANELS TO BE PROVIDED FOR ANY MECHANICAL EQUIPMENT OR MECHANICAL DEVICES REQUIRING SERVICE LOCATED ABOVE HARD CEILINGS.
- E. REFER TO SHEET E00-00 FOR ELECTRICAL SYMBOLS APPEARING ON THIS SHEET AND ADDITIONAL GENERAL NOTES F. REFER TO SHEET E08 SERIES FOR FEEDER AND PANELBOARD SCHEDULES.
- G. REFER TO AND COORDINATE WITH THE ARCHITECTURAL PLANS, ELEVATIONS, EQUIPMENT VENDOR DRAWINGS AND DETAILS FOR EXACT LOCATIONS AND MOUNTING
- HEIGHTS OF ALL WIRING DEVICES H. COORDINATE EXACT LOCATIONS OF ALL MECHANICAL EQUIPMENT, INCLUDING BUT NOT LIMITED TO: SMOKE DAMPERS, FIRE/SMOKE DAMPERS, VAV BOXES, FCU'S, ETC. WITH MECHANICAL DRAWINGS AND DIVISION 23 CONTRACTOR
- I. COORDINATE LOCATIONS OF ALL DISCONNECTS, CONTROL PANELS, AND ELECTRICAL CONNECTIONS FOR MECHANICAL AND PLUMBING EQUIPMENT TO MAINTAIN NEC REQUIRED CLEARANCES.

LEGEND NOTES

DISCONNECT SWITCHES INSTALLED ON THE LOAD SIZE OF VFD SHALL BE EQUIPPED WITH INTERLOCK ACCESSORY AUXILIARY CONTACTS, WHICH "BREAK" BEFORE THE SAFETY SWITCH IS OPEN. PROVIDE CONDUIT WITH INTERLOCK WIRING FROM DISCONNECT SWITCH AUXILIARY CONTACTS TO VFD, AND CONNECT AS REQUIRED TO SHUTDOWN VFD PRIOR TO DISCONECTING POWER TO THE MOTOR.



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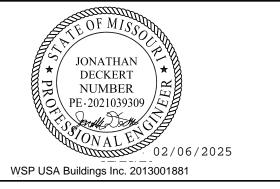
6900 East Camelback Road

CONSTRUCTION As Noted on Plans Review

Suite 500 Scottsdale, AZ 85251 T: 602.943.8950

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AUTHORITY HAVING JURISDICTION: | CITY OF LEE'S SUMMIT BUILDING DEPT. MISSOURI DHSS

AUTHORITY HAVING JURISDICTION'S PROJECT NO:

FACILITY NUMBER: 0972400009

AGENCY APPROVALS:

REVISIONS DATE DESCRIPTION ည္ REV# 2025/02/06 CITY - 2ND REVIEW

DATE:
DRAWN:
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ROOF PLAN - AREA D - MEP

MEP02-02D



Devenney

GROU

Devenney Group Ltd., Architects


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6406.24

1/8" = 1'-0"

ATTACHED MOB ROOF PLAN



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GROUP
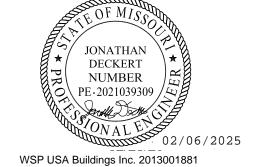
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SITE & BRIDGE EARLY RELEASE PACKAGE

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FACILITY NUMBER: **0972400009**

AGENCY APPROVALS:

REVISIONS

REV # DESCRIPTION DATE

B DESIGN COORDINATION 2025/02/06

JOB NUMBER:

SITE PLAN - PHOTOMETRICS

As indicated

E01-01

A. REFER TO SHEET E00-00 FOR ELECTRICAL SYMBOLS APPEARING ON THIS SHEET AND

ADDITIONAL GENERAL NOTES B. REFER TO SHEET E08 SERIES FOR FEEDER AND PANELBOARD SCHEDULES. C. REFER TO AND COORDINATE WITH THE ARCHITECTURAL PLANS, ELEVATIONS, EQUIPMENT VENDOR DRAWINGS AND DETAILS FOR EXACT LOCATIONS AND MOUNTING

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LEGEND NOTES

CAREFULLY REVIEW AND COORDINATE THE EXACT REQUIREMENTS OF THE FOOD SERVICE EQUIPMENT WITH THE EQUIPMENT SUPPLIER PRIOR TO ROUGH-IN. REFER TO VENDOR DRAWINGS FOR EQUIPMENT, BRANCH CIRCUIT REQUIREMENTS, TERMINATION DETAILS, AND OTHER ITEMS NECESSARY TO PROVIDE THE PROPER ELECTRICAL WORK FOR THE FOOD SERVICE EQUIPMENT INSTALLATION. 2 REFER TO 'ELECTRICAL CONNECTIONS SCHEDULE' IN KITCHEN VENDOR DRAWINGS FOR

ADDITIONAL INFORMATION ON 'E#'S TAGS'. 3 HATCHED REGION INDICATES HOOD LOCATION. ALL CIRCUITS UNDERNEATH HOOD SHALL

HAVE SHUNT TRIP BREAKERS. 4 FEEDER FROM PANEL TO LOAD CENTER SHALL BE ROUTED UNDERNEATH SLAB.

COORDINATE EXACT STUB UP LOCATIONS WITH FOOD SERVICE VENDOR PRIOR TO 5 PROVIDE ALL WIRING, DEVICES, BOXES AS REQUIRED TO COMPLETE SYSTEM WIRING PER

KITCHEN VENDOR DRAWINGS. REFER TO KITCHEN VENDOR PLANS FOR MORE

6 JUNCTION BOX LOCATED IN FLOOR UNDER POS STATION FOR ROUTING OF EQUIPMENT

POWER CIRCUITS INDICATED IN THIS POS STATION MILLWORK. ROUTE 1" CONDUIT UNDER FLOOR TO THE RECEPTACLE AS INDICATED. 7 PROVIDE 120V POWER CONNECTION TO VAV'S IN THIS AREA TO EMERGENCY EQUIPMENT CIRCUIT INDICATED. PROVIDE 20A 1P SWITCH AT CONTROL TRANSFORMER(S). REFER TO MECHANICAL DRAWINGS FOR BOX LOCATIONS. MAXIMUM OF 15 TERMINAL UNITS PER

CIRCUIT. QUANTITY OF VAV'S SHALL BE BALANCED BETWEEN THE CIRCUITS INDICATED IN THE SAME SMOKE ZONE. TERMINAL UNITS IN DIFFERENT SMOKE ZONES SHALL NOT BE ON THE SAME CIRCUIT. 8 INDOOR UNIT TO BE SERVED FROM OUTDOOR UNIT. REFER TO OUTDOOR UNIT FOR MANUFACTURER REQUIREMENTS.

9 DEVICE(S) TO BE LOCATED IN TV BACK-BOX; REFER TO TECHNOLOGY DRAWINGS FOR SPECIFICATION AND DETAILS. COORDINATE EXACT LOCATION WITH MONITOR/ TV MOUNTING BRACKET. REFER TO ARCHITECTURAL DRAWINGS AND ELEVATIONS FOR BRACKET MOUNTING HEIGHT AND EXACT LOCATIONS PRIOR TO ROUGH-IN.

10 CONNECT VARIABLE FREQUENCY DRIVE (VFD) TO RESPECTIVE DISCONNECT SWITCH LOCATED ON KITCHEN ROOF. 11 EXISTING MECHANICAL EQUIPMENT TO BE RE-CONNECTED TO EQUIPMENT PANEL HCPDPQH1. ALL ASSOCIATED EXISTING STARTER(S) AND DISCONNECT(S) TO REMAIN. EXISTING CONDUCTORS AND CONDUIT TO REMAIN AND SPLICE WITH NEW CONDUCTOR TO EXTEND TO NEW POWER PANEL. CONTRACTOR TO VERIFY EXISTING CONDUCTOR AND CONDUIT IN ACCEPTABLE CONDITION TO RE-USE. LABEL THE UPSTREAM BREAKER AS

12 PROVIDE 120V POWER CONNECTION TO FIRE/SMOKE DAMPERS, SMOKE DAMPERS, AND MOTORIZED DAMPERS IN THIS AREA. PROVIDE SEPARATE RELAYS FOR EACH SMOKE ZONE TO MEET MECHANICAL SEQUENCES. REFER TO THE ARCHITECTURAL LIFE SAFETY PLANS FOR SMOKE WALLS AND MECHANICAL PLANS FOR THE LOCATIONS OF ALL FIRE/SMOKE DAMPERS, SMOKE DAMPERS, AND MOTORIZED DAMPERS.



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Consultant:



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AGENCY APPROVALS:


REVISIONS DESCRIPTION DATE DESIGN COORDINATION 2025/02/06

LEVEL 1 - KEYPLAN




SECTOR A - KITCHEN, SERVERY & DINING -POWER

E02-01

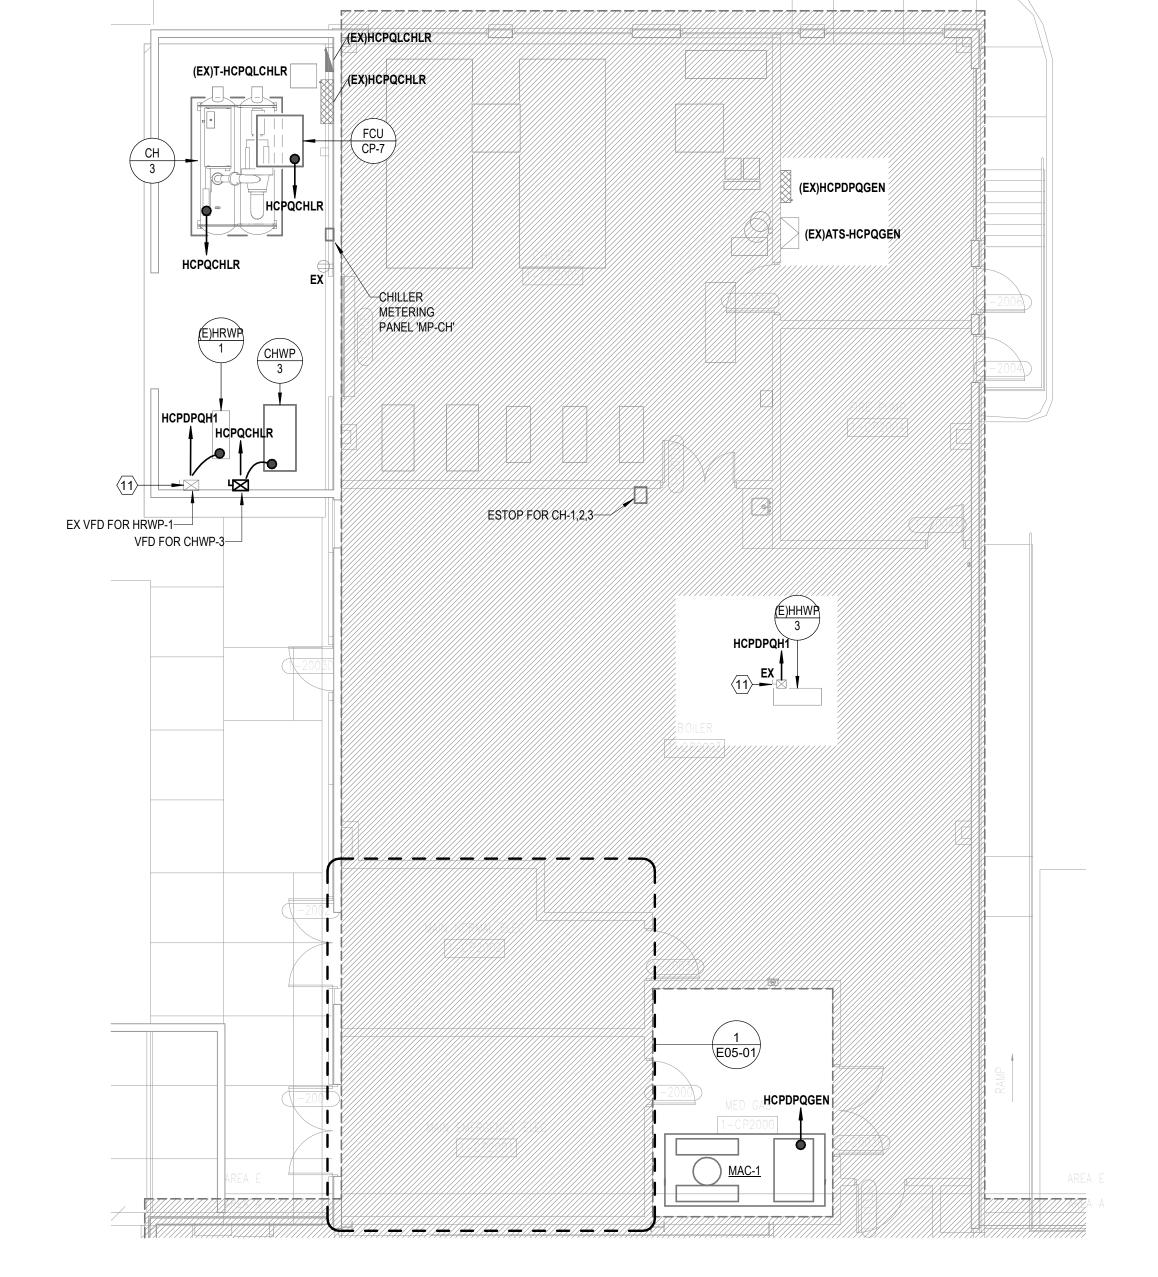



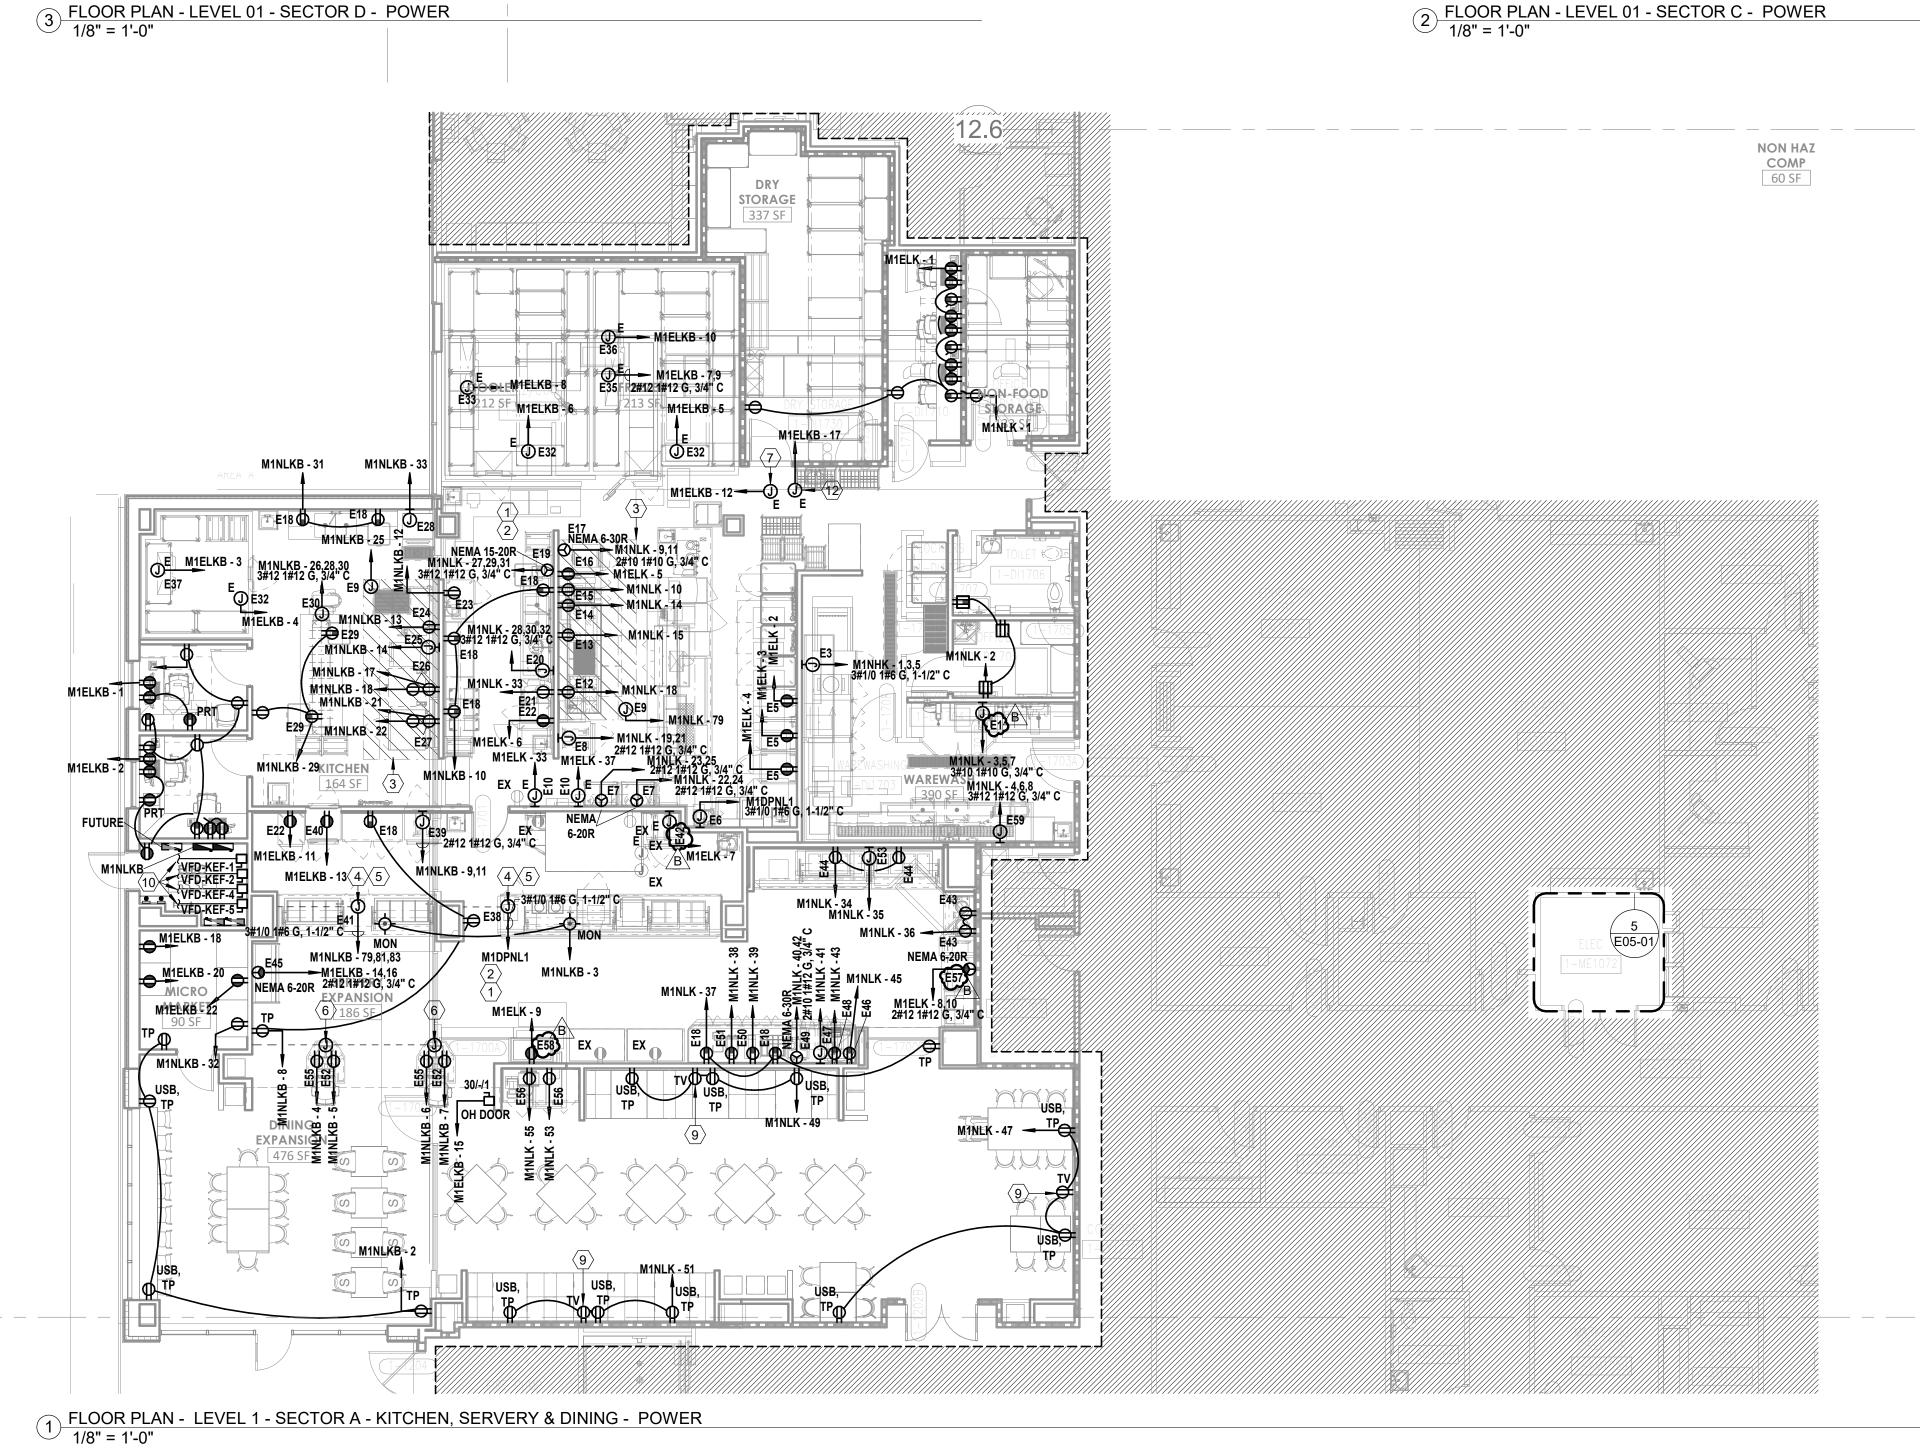

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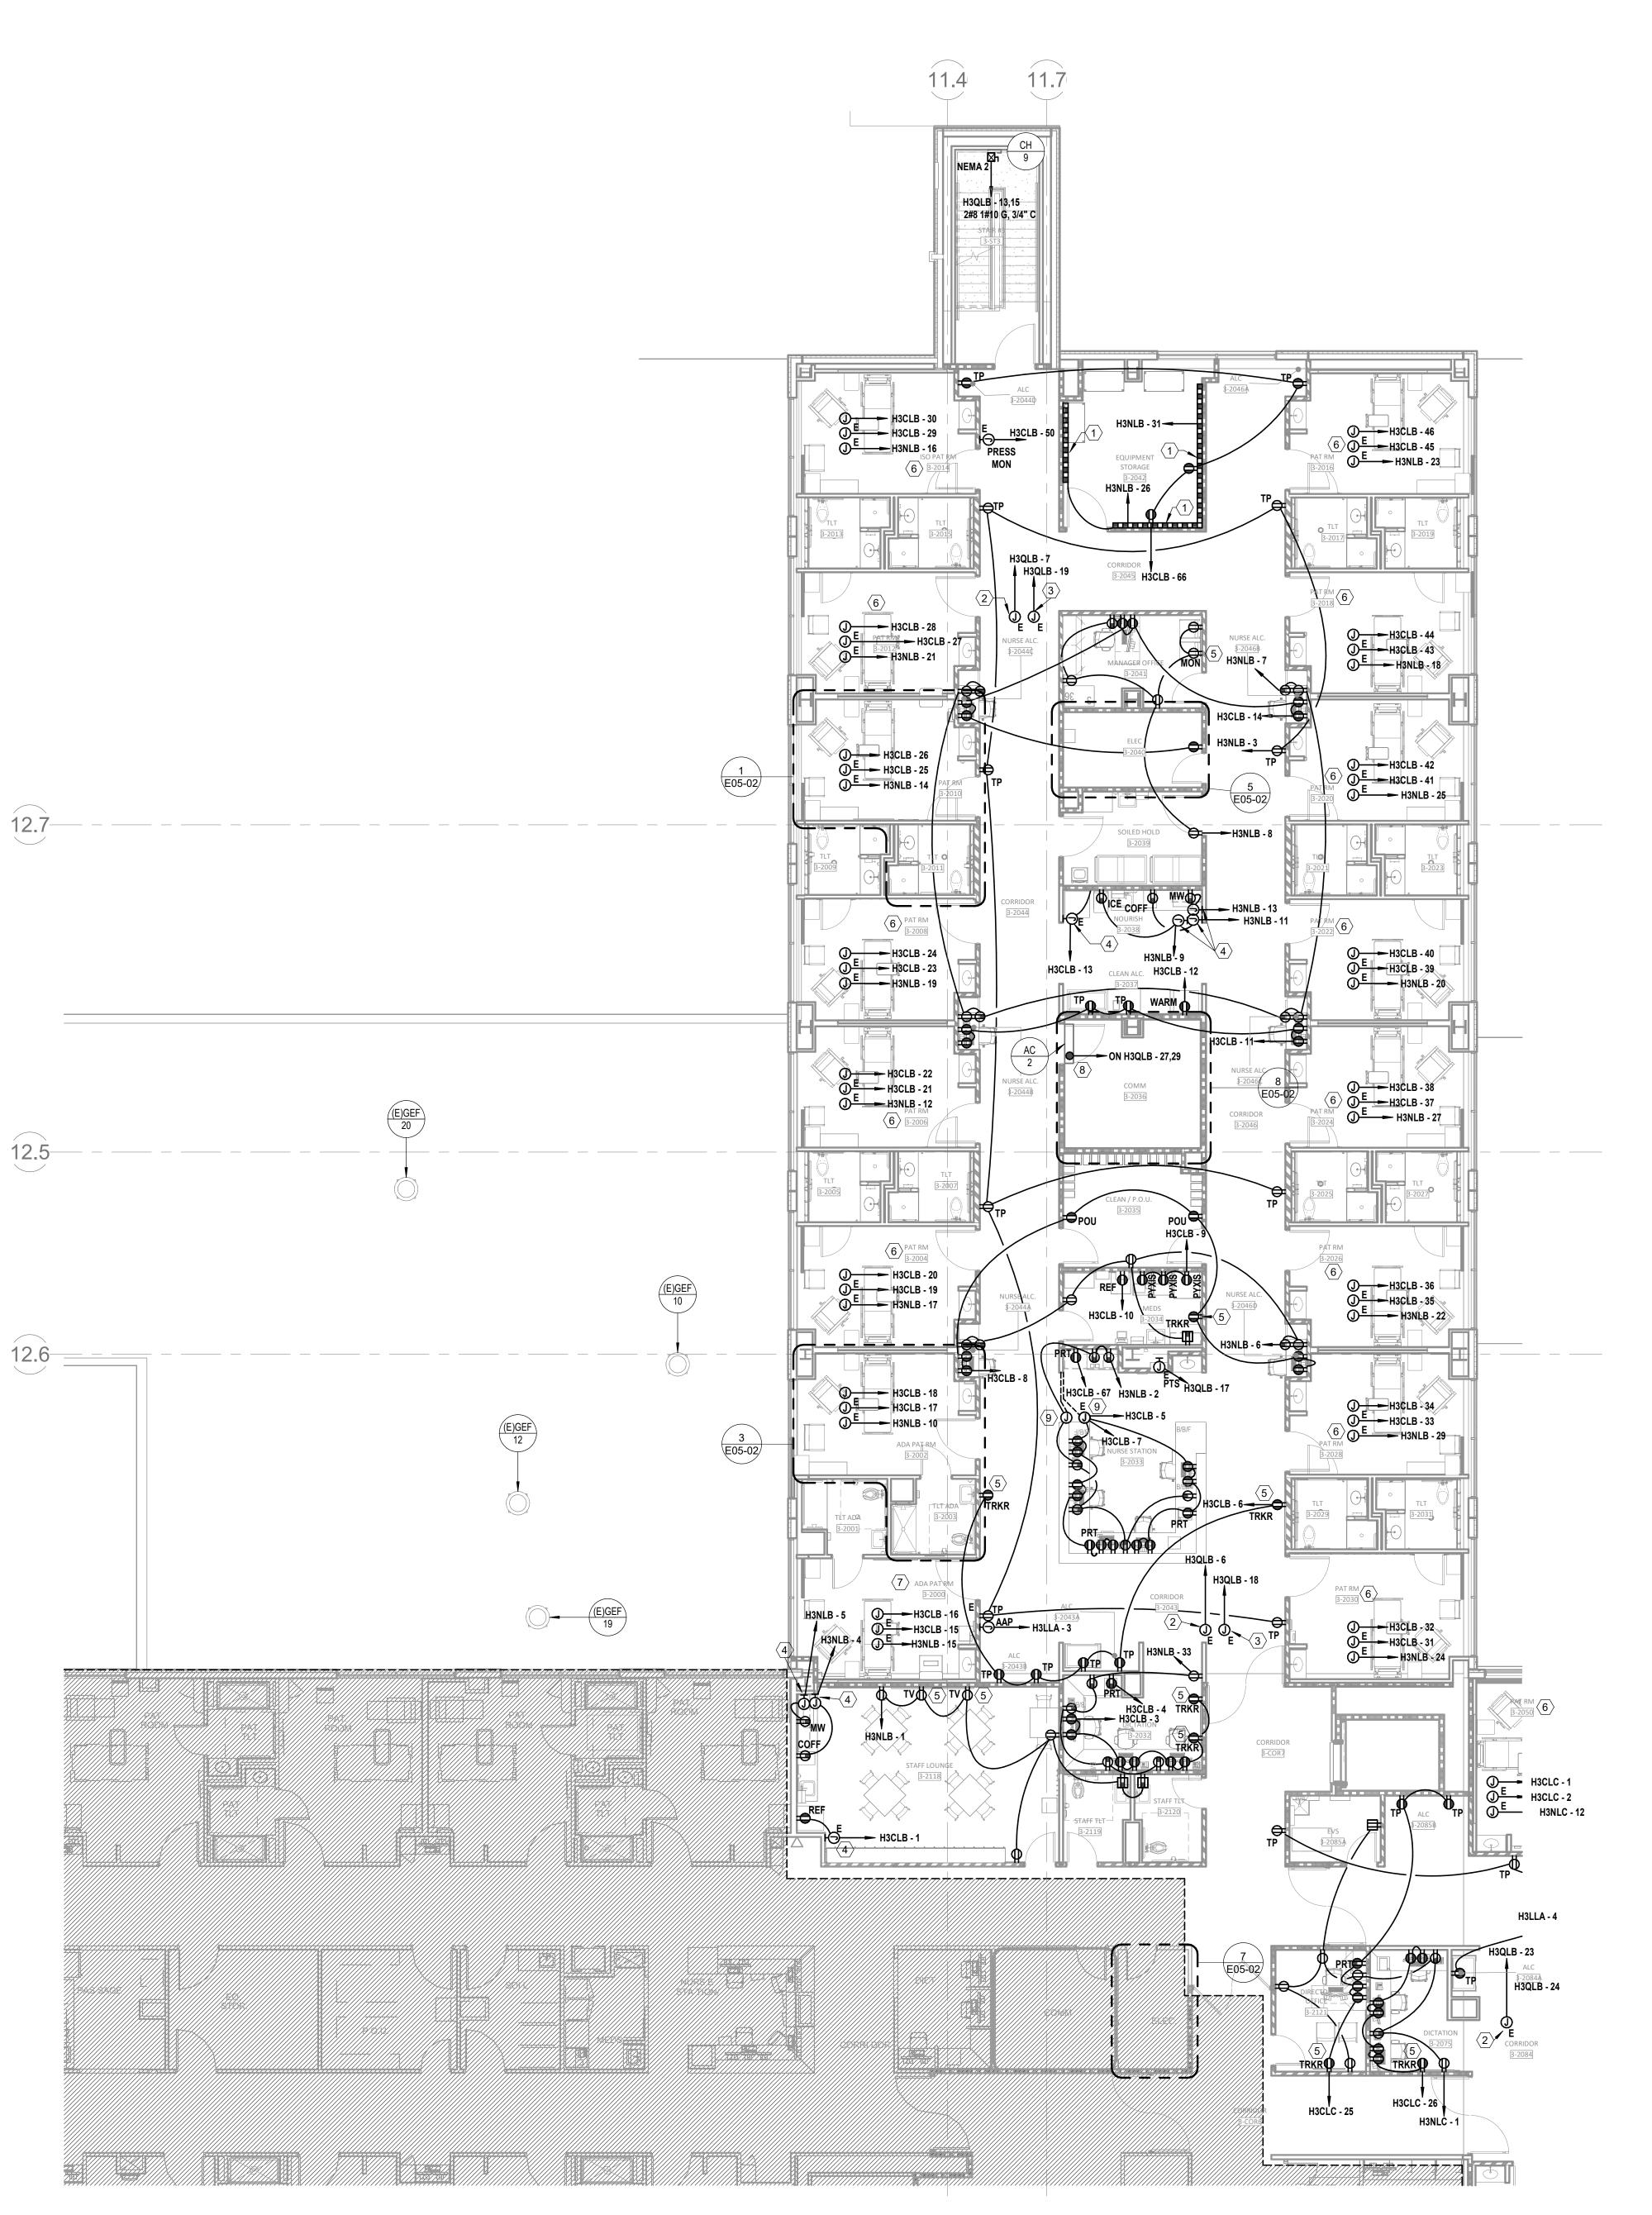
DRAWN:

REVIEWED: 1/8" = 1'-0"

FLOOR PLAN - LEVEL 03 -SECTOR A POWER

JOB NUMBER:

E02-03A



LEVEL 3 - KEY PLAN SECTOR B

GENERAL NOTES

ADDITIONAL GENERAL NOTES

REQUIRED CLEARANCES.

THE SAME CIRCUIT.

01/E07-01 FOR MORE INFORMATION.

MANUFACTURER REQUIREMENTS.

ON E5 SERIES FOR TYPICAL POWER DEVICE LAYOUT.

POWER" ON E5 SERIES FOR TYPICAL POWER DEVICE LAYOUT.

HEIGHTS OF ALL WIRING DEVICES

A. REFER TO SHEET E00-00 FOR ELECTRICAL SYMBOLS APPEARING ON THIS SHEET AND

EQUIPMENT VENDOR DRAWINGS AND DETAILS FOR EXACT LOCATIONS AND MOUNTING

D. COORDINATE EXACT LOCATIONS OF ALL MECHANICAL EQUIPMENT, INCLUDING BUT NOT LIMITED TO: SMOKE DAMPERS, FIRE/SMOKE DAMPERS, VAV BOXES, FCU'S, ETC. WITH

E. COORDINATE LOCATIONS OF ALL DISCONNECTS, CONTROL PANELS, AND ELECTRICAL

CONNECTIONS FOR MECHANICAL AND PLUMBING EQUIPMENT TO MAINTAIN NEC

PROVIDE PLUGMOLD EQUAL TO WIREMOLD AL3300 SERIES WITH DUPLEX RECEPTACLES AT 12" C.C. MOUNTED AT 4'-0" TO BOTTOM OF PLUGMOLD ABOVE FINISH FLOOR. COORDINATE

2 PROVIDE 120V POWER CONNECTION TO VAV'S IN THIS AREA TO EMERGENCY EQUIPMENT CIRCUIT INDICATED. PROVIDE 20A 1P SWITCH AT CONTROL TRANSFORMER(S). REFER TO MECHANICAL DRAWINGS FOR BOX LOCATIONS. MAXIMUM OF 15 TERMINAL UNITS PER CIRCUIT. QUANTITY OF VAV'S SHALL BE BALANCED BETWEEN THE CIRCUITS INDICATED IN THE SAME SMOKE ZONE. TERMINAL UNITS IN DIFFERENT SMOKE ZONES SHALL NOT BE ON

3 PROVIDE 120V POWER CONNECTION TO FIRE/SMOKE DAMPERS, SMOKE DAMPERS, AND MOTORIZED DAMPERS IN THIS AREA. PROVIDE SEPARATE RELAYS FOR EACH SMOKE ZONE

TO MEET MECHANICAL SEQUENCES REFER TO THE ARCHITECTURAL LIFE SAFETY PLANS FOR SMOKE WALLS AND M02-03A AND M02-03B FOR THE LOCATIONS OF ALL FIRE/SMOKE DAMPERS, SMOKE DAMPERS, AND MOTORIZED DAMPERS.

4 PROVIDE BLANK FACE (FACELESS) GFCI IN A READILY ACCESSIBLE LOCATION FOR RECEPTACLE INDICATED LABEL PER DEVICE INDICATED ON DRAWINGS. REFER TO DETAIL

6 REFER TO "ENLARGED FLOOR PLAN - LEVEL 03 - MED SURG - TYP PATIENT ROOM - POWER"

9 JUNCTION BOX LOCATED IN FLOOR UNDER NURSE STATION ISLAND FOR ROUTING NORMAL AND CRITICAL EMERGENCY POWER CIRCUITS INDICATED IN NURSE STATION MILLWORK.

ROUTE 1" CONDUIT UNDER FLOOR TO THE NEAREST WALL AND ABOVE ACCESSIBLE

5 DEVICE(S) TO BE LOCATED IN TV BACK-BOX; REFER TO TECHNOLOGY DRAWINGS FOR SPECIFICATION AND DETAILS. COORDINATE EXACT LOCATION WITH MONITOR/ TV MOUNTING BRACKET. REFER TO ARCHITECTURAL DRAWINGS AND ELEVATIONS FOR

BRACKET MOUNTING HEIGHT AND EXACT LOCATIONS PRIOR TO ROUGH-IN.

7 REFER TO "ENLARGED FLOOR PLAN - LEVEL 03 - MED SURG - TYP ADA PATIENT ROOM -

8 INDOOR UNIT TO BE SERVED FROM OUTDOOR UNIT. REFER TO OUTDOOR UNIT FOR

B. REFER TO SHEET E08 SERIES FOR FEEDER AND PANELBOARD SCHEDULES. C. REFER TO AND COORDINATE WITH THE ARCHITECTURAL PLANS, ELEVATIONS,

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WITH ARCHITECTURAL ELEVATIONS FOR MORE DETAILS.

LEGEND NOTES


1) FLOOR PLAN - LEVEL 03 - SECTOR A POWER 1/8" = 1'-0"

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- 8 REFER TO "ENLARGED FLOOR PLAN LEVEL 03 MED SURG TYP PATIENT ROOM POWER" ON E5 SERIES FOR TYPICAL POWER DEVICE LAYOUT. 9 REFER TO "ENLARGED FLOOR PLAN - LEVEL 03 - MED SURG - TYP ADA PATIENT ROOM -POWER" ON E5 SERIES FOR TYPICAL POWER DEVICE LAYOUT.



LEVEL 3 - KEY PLAN


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AGENCY APPROVALS:

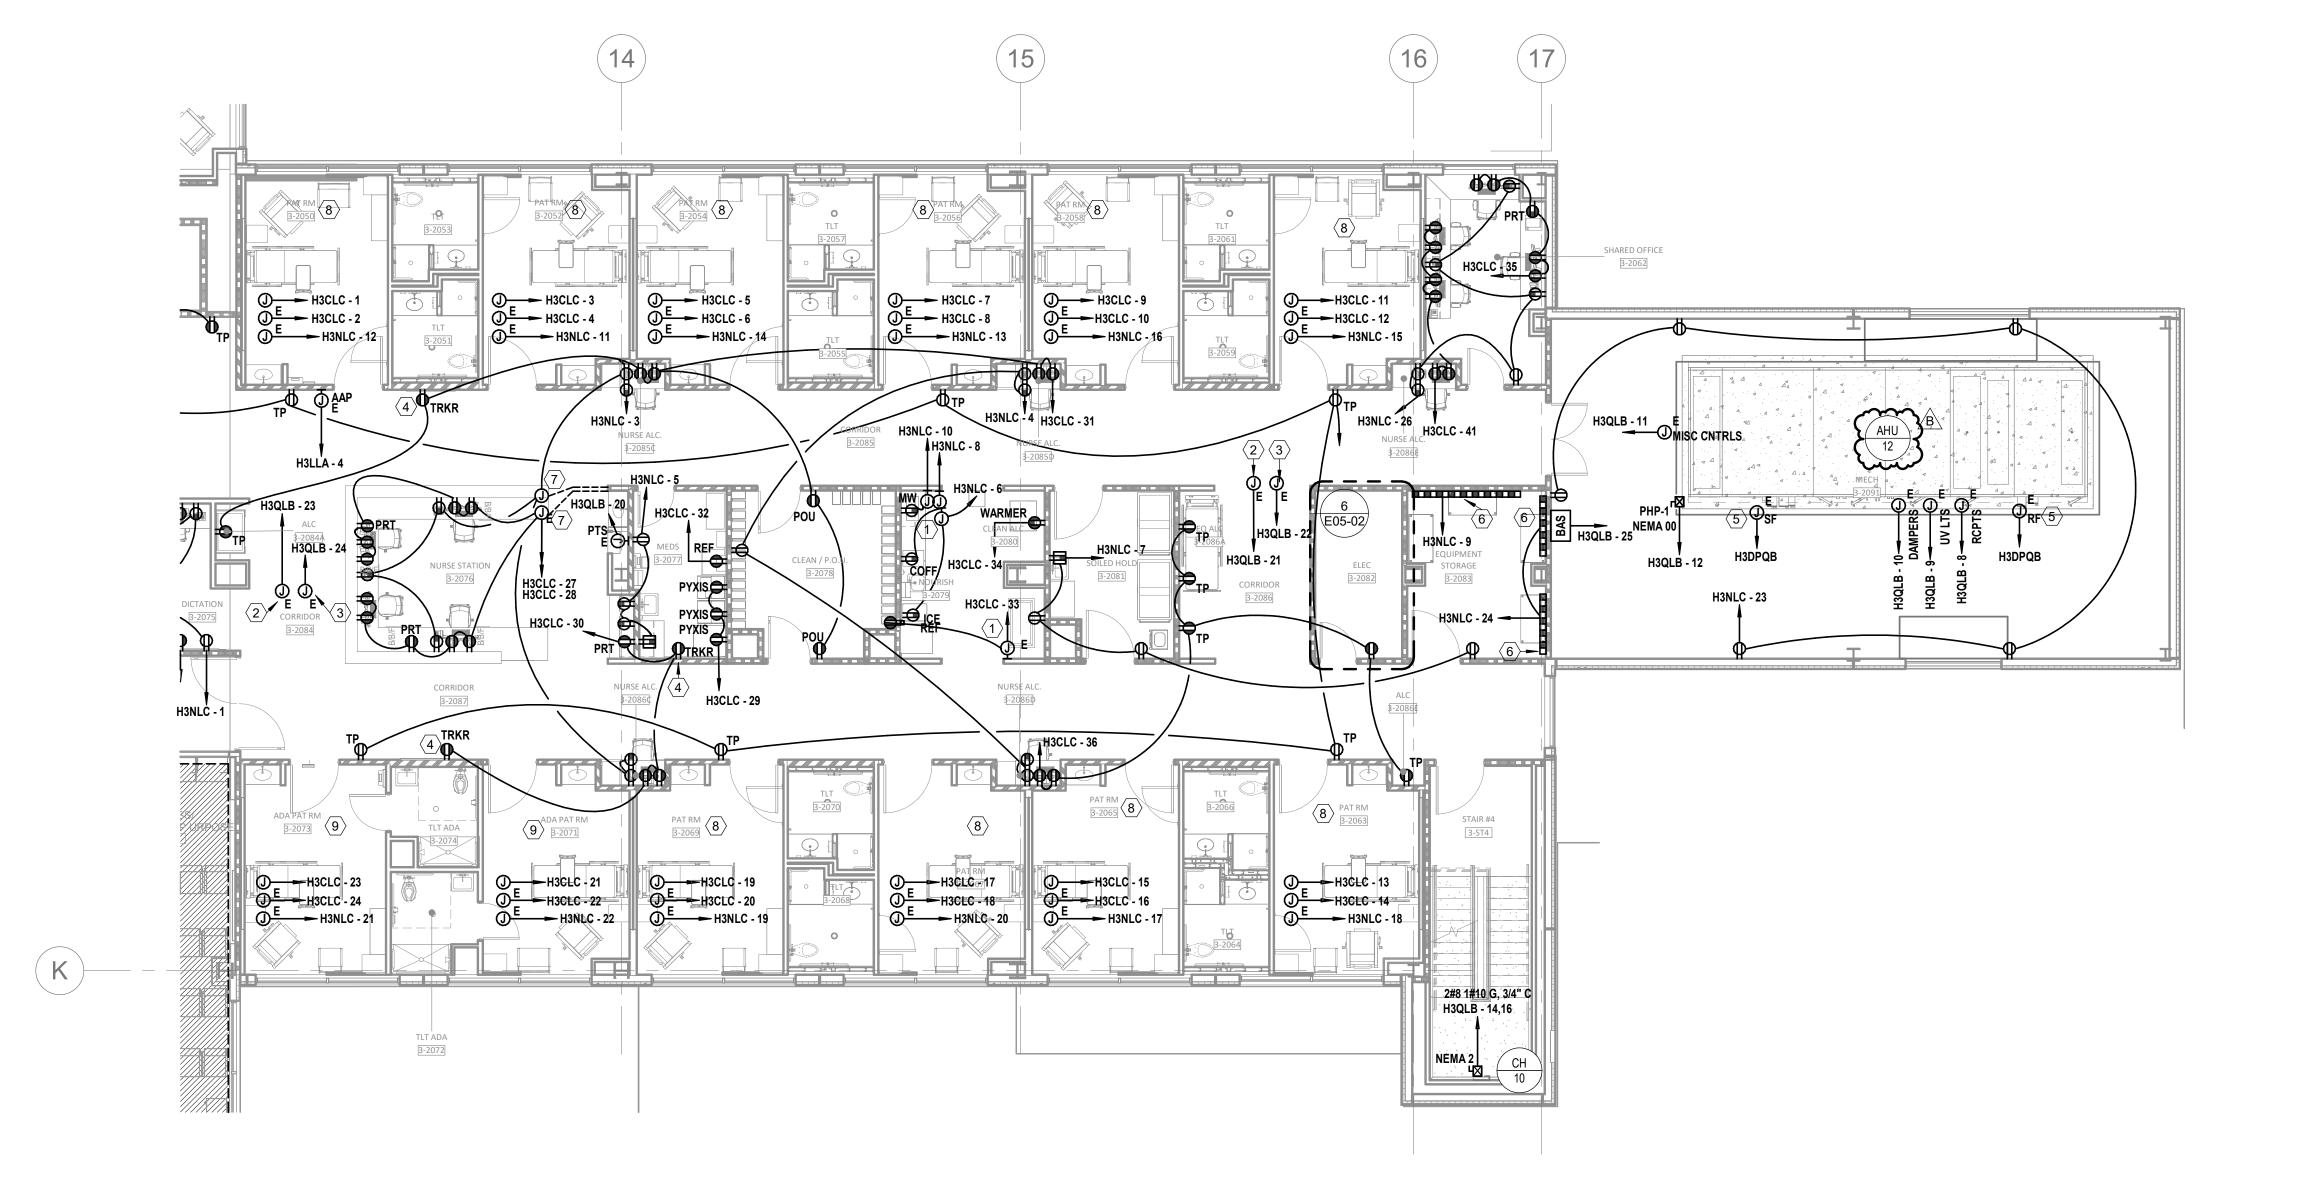REVISIONS DESCRIPTION 2025/02/06 B DESIGN COORDINATION

DATE

DATE:

DRAWN:

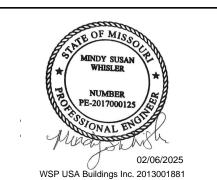REVIEWED: 1/8" = 1'-0" JOB NUMBER:

FLOOR PLAN - LEVEL 03 -SECTOR B POWER

E02-03B

- A. REFER TO AND COORDINATE WITH ARCHITECTURAL PLANS, ELEVATIONS, EQUIPMENT VENDOR DRAWINGS AND DETAILS FOR EXACT LOCATIONS AND MOUNTING HEIGHT OF
- ALL WIRING DEVICES

 B. REFER TO SHEET E00-00 FOR ELECTRICAL SYMBOLS APPEARING ON THIS SHEET AND
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- ADDITIONAL GENERAL NOTES.

 C. REFER TO SHEET E8-02 FOR LIGHT SCHEDULES

 D. CONTRACTORS SHALL USE FMC TRANSITIONS FROM FMT AT BUILDING EXPANSION
- D. CONTRACTORS SHALL USE FMC TRANSITIONS FROM EMT AT BUILDING EXPANSION JOINTS WHEN APPLICABLE. FMC ROUTING SHALL BE PROVIDED TO ALLOW LATERAL AND VERTICAL ADJUSTMENTS IN LINE WITH COORDINATE EXACT LOCATIONS OF EXPANSION JOINTS WITH ARCHITECTURAL DRAWINGS

LEGEND NOTES

- 1 REFER TO "ENLARGED FLOOR PLAN LEVEL 03 MED SURG TYP PATIENT ROOM LIGHTING" ON E5 SERIES FOR TYPICAL LIGHTING LAYOUT.
- 2 REFER TO "ENLARGED FLOOR PLAN LEVEL 03 MED SURG TYP ADA PATIENT ROOM LIGHTING" ON E5 SERIES FOR TYPICAL LIGHTING LAYOUT.

LEVEL 3 - KEY PLAN

SECTOR B

3 SWITCH TO BE PROVIDED WITH PRE-FABRICATED WALLS.
 4 LIGHT FIXTURE TO BE PROVIDED WITH PRE-FABRICATED SINK POD.



CONSTRUCTION
As Noted on Plans Review


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REVISIONS
DESCRIPTION DATE
DESIGN COORDINATION 2025/02/0

DATE: 2024/12/05
SCALE: 1/8" = 1'-0"
DRAWN: Author
REVIEWED: Checker
JOB NUMBER: 6406.24

FLOOR PLAN - LEVEL 03 -

E03-03A

CONSTRUCTION
As Noted on Plans Review

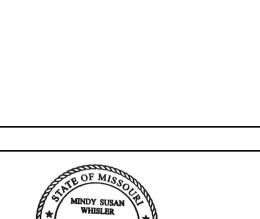GENERAL NOTES

- A. REFER TO AND COORDINATE WITH ARCHITECTURAL PLANS, ELEVATIONS, EQUIPMENT VENDOR DRAWINGS AND DETAILS FOR EXACT LOCATIONS AND MOUNTING HEIGHT OF
- ALL WIRING DEVICES B. REFER TO SHEET E00-00 FOR ELECTRICAL SYMBOLS APPEARING ON THIS SHEET AND ADDITIONAL GENERAL NOTES.
- C. REFER TO SHEET E8-02 FOR LIGHT SCHEDULES D. CONTRACTORS SHALL USE FMC TRANSITIONS FROM EMT AT BUILDING EXPANSION JOINTS WHEN APPLICABLE. FMC ROUTING SHALL BE PROVIDED TO ALLOW LATERAL AND VERTICAL ADJUSTMENTS IN LINE WITH COORDINATE EXACT LOCATIONS OF EXPANSION

LEGEND NOTES

- REFER TO "ENLARGED FLOOR PLAN LEVEL 03 MED SURG TYP PATIENT ROOM -LIGHTING" ON E5 SERIES FOR TYPICAL LIGHTING LAYOUT.
- 2 REFER TO "ENLARGED FLOOR PLAN LEVEL 03 MED SURG TYP ADA PATIENT ROOM -LIGHTING" ON E5 SERIES FOR TYPICAL LIGHTING LAYOUT.

LEVEL 3 - KEY PLAN

SECTOR B

3 SWITCH TO BE PROVIDED WITH PRE-FABRICATED WALLS. 4 LIGHT FIXTURE TO BE PROVIDED WITH PRE-FABRICATED SINK POD.



JOINTS WITH ARCHITECTURAL DRAWINGS

www.devenneygroup.com



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Devenney Group Ltd., Architects

6900 East Camelback Road

Scottsdale, AZ 85251

T: 602.943.8950

Suite 500



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INPATIENT BED EXPANSION

HCA - LEE'S SUMMIT MEDICAL CENTER 2100 SE BLUE PKWY LEE'S SUMMIT, MO 64063

AUTHORITY HAVING JURISDICTION: CITY OF LEE'S SUMMIT BUILDING DEPT. MISSOURI DHSS

AUTHORITY HAVING JURISDICTION'S PROJECT NO:

FACILITY NUMBER: 0972400009


AGENCY APPROVALS:

REVISIONS DATE DESCRIPTION ☐ B DESIGN COORDINATION 2025/02/06

DATE:
SCALE:
DRAWN:
REVIEWED: 1/8" = 1'-0" JOB NUMBER:

FLOOR PLAN - LEVEL 03 -SECTOR B LIGHTING

E03-03B

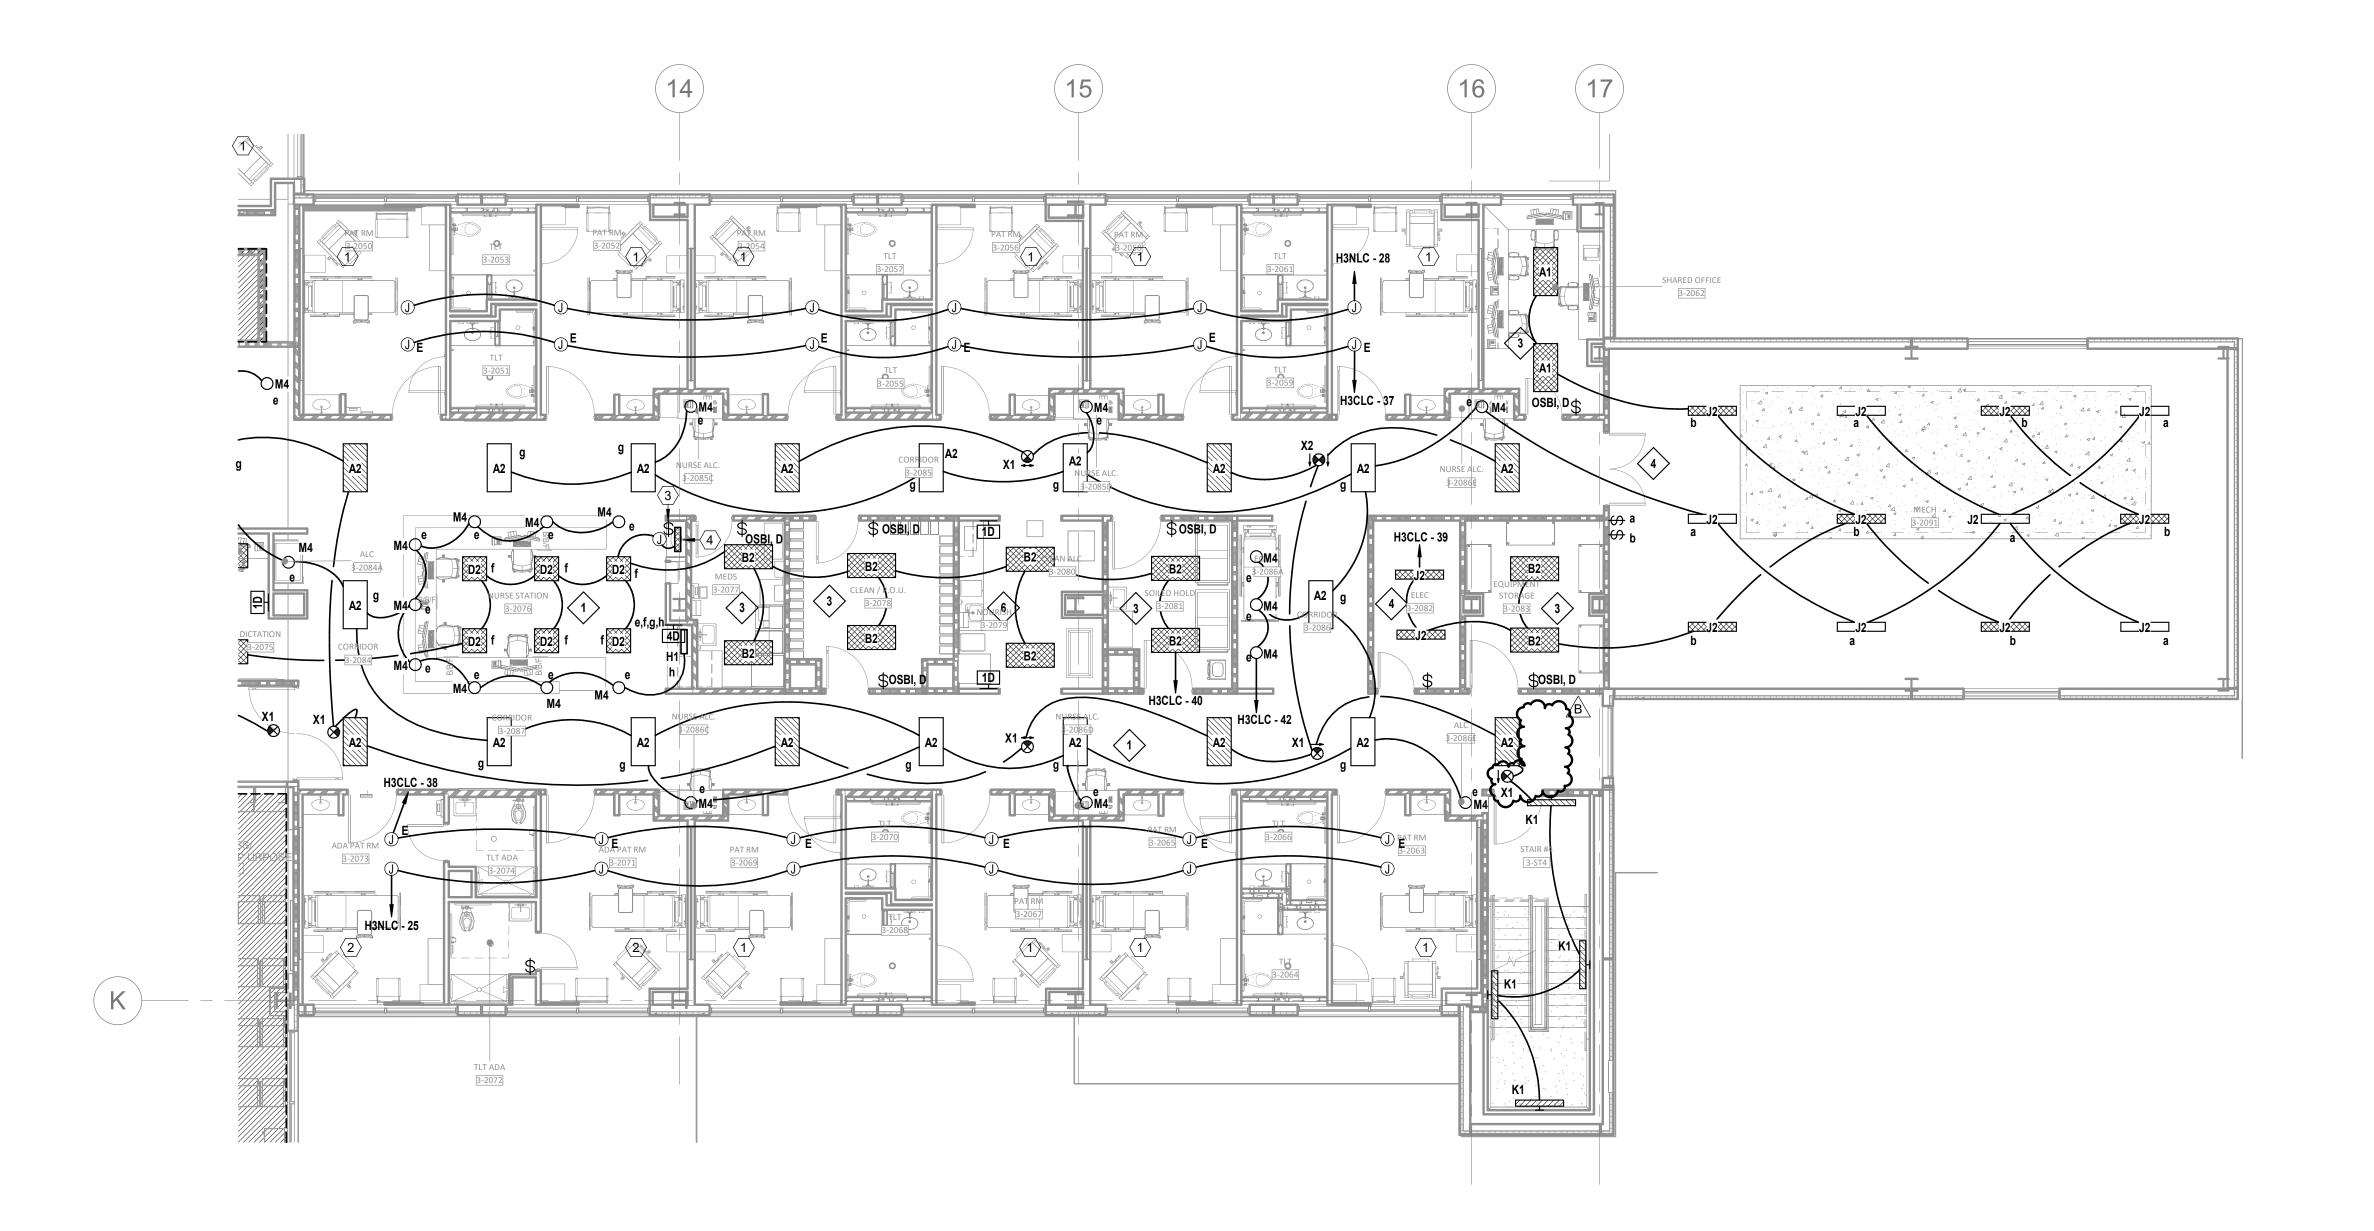


- A. REFER TO SHEET E00-00 FOR ELECTRICAL SYMBOLS APPEARING ON THIS SHEET AND ADDITIONAL GENERAL NOTES.
- B. COORDINATE EXACT LOCATION OF ALL MECHANICAL EQUIPMENT INCLUDING BUT NOT LIMITED TO F/S DAMPERS, VAV BOXES, FCU'S ETC. WITH MECHANICAL DRAWINGS AND DIV.23 CONTRACTOR.
- C. DO NOT SCALE DEVICE LOCATIONS FROM THESE DRAWINGS. REFER TO AND COORDINATE WITH THE ARCHITECTURAL DOCUMENTS. SPECIFICALLY, REFER TO
- ARCHITECTURAL PLANS, ELEVATIONS, AND DETAILS FOR SPECIALTY. D. DELEGATED DESIGN OF FIRE ALARM: REFER TO DIVISION 28 SPECIFICATION SECTION FOR ADDITIONAL SYSTEM REQUIREMENTS. FIRE ALARM INITIATING DEVICES, NOTIFICATION APPLIANCES, CONTROL PANELS, ANNUNCIATOR PANELS, AND OTHER PERIPHERAL DEVICES SHOWN ON THESE DOCUMENTS DO NOT CONSTITUTE THE TOTAL QUANTITY OR TYPE OF DEVICES REQUIRED FOR THE WORK. THE DEVICES AND EQUIPMENT INDICATED ON THESE DOCUMENTS IS SHOWN FOR THE PURPOSE OF COORDINATION ONLY. THESE DRAWINGS AND THE ACCOMPANYING SPECIFICATIONS DEFINE THE SCOPE AND INTENT OF THE FIRE ALARM SYSTEM TO BE PROVIDED IN THE WORK. IN ADDITION TO THE SYSTEM AS SHOWN HEREIN AND SPECIFIED IN THE PROJECT MANUAL, THE LICENSED FIRE ALARM CONTRACTOR SHALL PROVIDE ALL PLANNING, DESIGN, CALCULATIONS, EQUIPMENT, DEVICES, RACEWAYS, BOXES, CABLING, SYSTEM PROGRAMMING AND ANY OTHER COMPONENT OR SERVICE REQUIRED FOR A COMPLETE, FULLY OPERATIONAL SYSTEM THAT MEETS ALL SPECIFIED REQUIREMENTS AND LOCAL CODES.
- E. SMOKE DETECTOR SPACING: FOR AREAS WHICH ARE INDICATED TO HAVE SMOKE DETECTOR COVERAGE THAT DO NOT HAVE A SUSPENDED CEILING (I.E. OPEN TO STRUCTURE), PROVIDE ONE DETECTOR PER STRUCTURAL POCKET TO MEET REQUIREMENTS OF NFPA 72. REFER TO ARCHITECTURAL REFLECTED CEILING PLANS FOR CEILING TYPES AND TO STRUCTURAL SLAB DETAILS FOR SLAB DEPRESSIONS THAT MAY CAUSE CONDITIONS REQUIRING ADDITIONAL DETECTORS.
- F. DETECTORS AT DAMPERS: PROVIDE A DUCT MOUNTED SMOKE DETECTOR AT ALL SMOKE AND COMBINATION FIRE/SMOKE DAMPER LOCATIONS. EACH DAMPER SHALL HAVE A DISCRETE RELAY LOCATED WITHIN 3 FT. OF THE CONTROLLING COMPONENT; COMMON RELAYS ARE NOT ACCEPTABLE. EXACT DEVICE QUANTITIES AND LOCATIONS FOR DAMPERS ARE SHOWN ON MECHANICAL DRAWINGS. REFER TO AND COORDINATE WITH DIVISION 23 DOCUMENTS, APPROVED SHOP DRAWINGS AND SUBMITTALS AND BETWEEN TRADES WITH HVAC INSTALLER PRIOR TO ROUGH-IN. REFER TO DIVISION 23 AND 28 SPECIFICATIONS AND TO DETAILS FOR ADDITIONAL REQUIREMENTS.
- G. PROVIDE APPROPRIATE EQUIPMENT AND CONNECTION(S) REQUIRED TO RELEASE DOOR HOLDERS UPON ALARM SIGNAL FROM THE FIRE ALARM CONTROL PANEL. H. PROVIDE EQUIPMENT AND CONNECTION(S) REQUIRED TO MONITOR KITCHEN HOOD
- SUPPRESSION SYSTEM(S).

FIRE SMOKE DAMPER LOCATED BETWEEN LEVEL 02 AND 03, REFER TO M02-02A FOR EXACT (LOCATION.

LEVEL 3 - KEY PLAN

SECTOR B

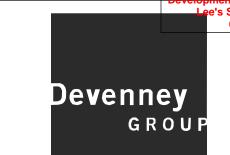

CONSTRUCTION
As Noted on Plans Review


Devenney Group Ltd., Architects

6900 East Camelback Road Suite 500 Scottsdale, AZ 85251

T: 602.943.8950

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> **INPATIENT BED EXPANSION**

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AUTHORITY HAVING JURISDICTION'S PROJECT NO:

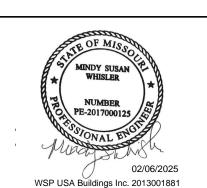FACILITY NUMBER: 0972400009

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REVISIONS DATE DESCRIPTION 2025/02/06 DESIGN COORDINATION

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REVIEWED: 1/8" = 1'-0" Checker 6406.24 JOB NUMBER:


FLOOR PLAN - LEVEL 03 -SECTOR A SPECIAL SYSTEMS

E04-03A

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- SUPPRESSION SYSTEM(S).

<u>B</u>

1 FIRE SMOKE DAMPER LOCATED BETWEEN LEVEL 02 AND 03, REFER TO M02-02B FOR EXACT. william which were the second that the second terms are the second terms and the second terms are the second terms

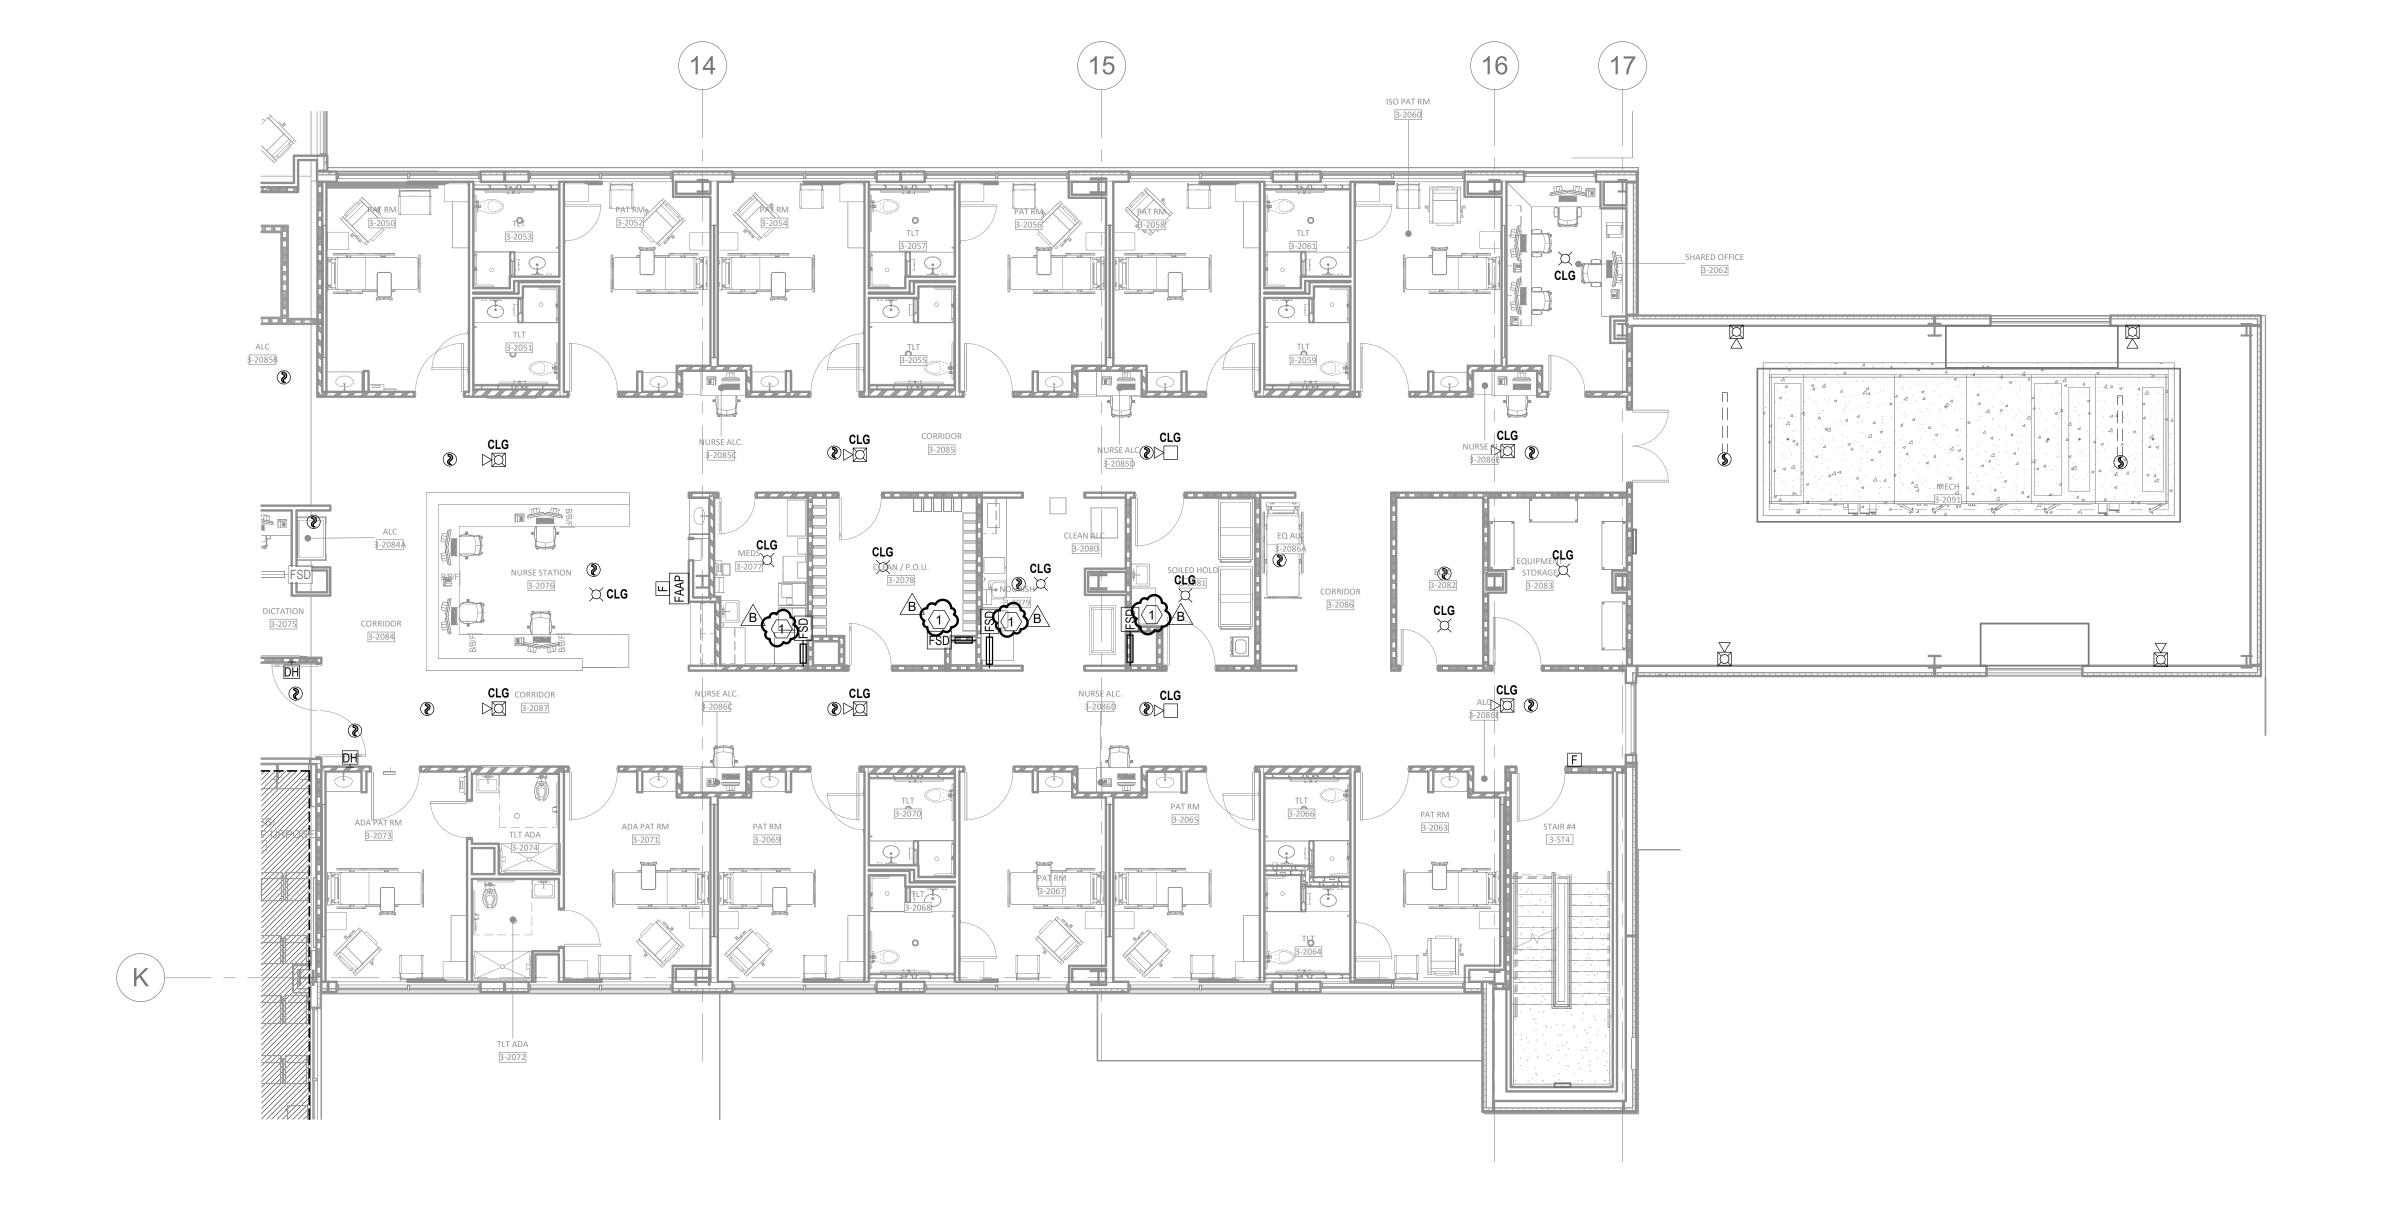


LEVEL 3 - KEY PLAN SECTOR B Devenney GROUF

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COMPENSATION TO DEVENNEY GROUP LTD.

INPATIENT BED EXPANSION

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AUTHORITY HAVING JURISDICTION: CITY OF LEE'S SUMMIT BUILDING DEPT. MISSOURI DHSS

AUTHORITY HAVING JURISDICTION'S PROJECT NO:

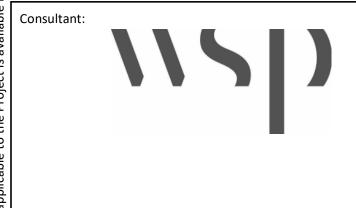FACILITY NUMBER: 0972400009

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REV#	DESCRIPTION	DATE
В	DESIGN COORDINATION	2025/02/06

DATE:

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FLOOR PLAN - LEVEL 03 -SECTOR B SPECIAL SYSTEMS

E04-03B

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Scottsdale, AZ 85251

T: 602.943.8950

Suite 500

Consultant:

GENERAL NOTES


- A. REFER TO SHEET E00-00 FOR ELECTRICAL SYMBOLS APPEARING ON THIS SHEET AND
- ADDITIONAL GENERAL NOTES B. REFER TO SHEET E08 SERIES FOR FEEDER AND PANELBOARD SCHEDULES. C. REFER TO AND COORDINATE WITH THE ARCHITECTURAL PLANS, ELEVATIONS,
- EQUIPMENT VENDOR DRAWINGS AND DETAILS FOR EXACT LOCATIONS AND MOUNTING HEIGHTS OF ALL WIRING DEVICES D. COORDINATE EXACT LOCATIONS OF ALL MECHANICAL EQUIPMENT, INCLUDING BUT NOT
- LIMITED TO: SMOKE DAMPERS, FIRE/SMOKE DAMPERS, VAV BOXES, FCU'S, ETC. WITH MECHANICAL DRAWINGS AND DIVISION 23 CONTRACTOR E. COORDINATE LOCATIONS OF ALL DISCONNECTS, CONTROL PANELS, AND ELECTRICAL CONNECTIONS FOR MECHANICAL AND PLUMBING EQUIPMENT TO MAINTAIN NEC

LEGEND NOTES


REQUIRED CLEARANCES.

- RECEPTACLE TO BE PROVIDED AND INSTALLED BY ELECTRICAL CONTRACTOR. ONLY RESPONSIBLE FOR PROVIDING CIRCUITRY TO JUNCTION BOX AS SHOWN. ONLY AND PROVIDED WITH OWNER FURNISHED, PRE-FABRICATED POD UNLESS OTHERWISE NOTED. ABOVE CEILING JUNCTION BOXES SHOWN ARE PROVIDED WITH
- 4 DEVICE(S) TO BE LOCATED IN TV BACK-BOX; REFER TO TECHNOLOGY DRAWINGS FOR SPECIFICATION AND DETAILS. COORDINATE EXACT LOCATION WITH MONITOR/ TV MOUNTING BRACKET. REFER TO ARCHITECTURAL DRAWINGS AND ELEVATIONS FOR
- BRACKET MOUNTING HEIGHT AND EXACT LOCATIONS PRIOR TO ROUGH-IN.
- 7 SWITCH TO BE PROVIDED WITH PRE-FABRICATED WALLS. 8 PROVIDE CONNECTION TO NURSE CALL SYSTEM. THE AMBIENT/READING LIGHT IN THE OVER BED LIGHT FIXTURE TO BE CONTROLLED BY THE PILLOW SPEAKER. LOW VOLTAGE CONTRACTOR IS RESPONSIBLE FOR PROVIDING AND INSTALLING LOW VOLTAGE CABLING FROM THE OVER BED LIGHT FIXTURE TO NURSE CALL DEVICE. THE PILLOW SPEAKER SHALL BE PROVIDED WITH TWO SWITCHES FOR INDIVIDUAL CONTROL OF THE AMBIENT/READING LIGHT. COORDINATE THE EXACT LOW VOLTAGE CONTROLLER IN THE OVER BED LIGHT FOR INDIVIDUAL CONTROL. TYPICAL ALL PATIENT ROOMS REFER TO DETAILS ON E07-02.
- 9 LIGHT FIXTURE TO BE PROVIDED WITH PRE-FABRICATED SINK POD. 10 CONTRACTOR TO FURNISH AND INSTALL ALL DEVICES IN FOOTWALL.



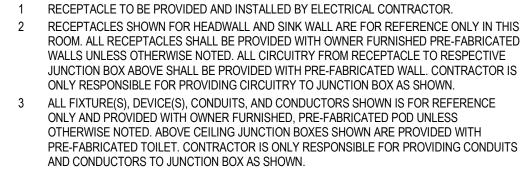

- 5 REFER TO E2 SERIES FLOOR PLANS FOR SPECIFIC PANELBOARD CIRCUITING.
- 6 REFER TO E3 SERIES FLOOR PLANS FOR SPECIFIC PANELBOARD CIRCUITING.

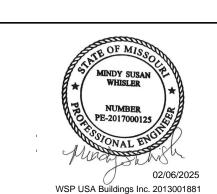

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COMPENSATION TO DEVENNEY GROUP LTD.

INPATIENT BED EXPANSION

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FACILITY NUMBER: 0972400009

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REVISIONS DATE DESCRIPTION ω REV# 2025/02/06 DESIGN COORDINATION

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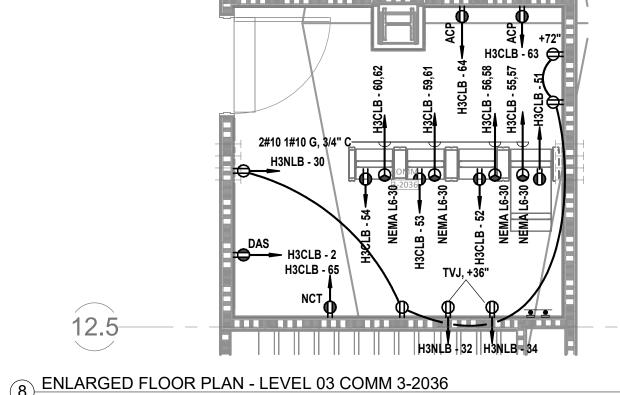
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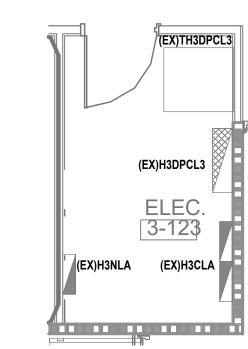
REVIEWED: As indicated Author Checker S JOB NUMBER: 6406.24

ENLARGED PLANS -ELECTRICAL


E05-02

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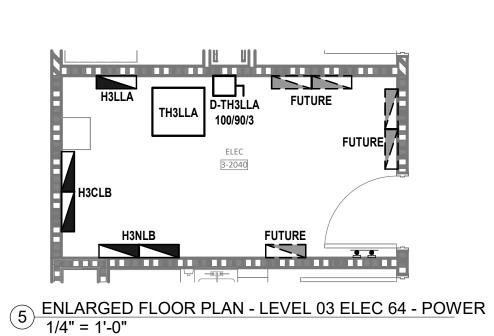


7 ENLARGED FLOOR PLAN - LEVEL 03 ELEC 123 - POWER 1/4" = 1'-0"



6 ENLARGED FLOOR PLAN - LEVEL 03 ELEC 229 - POWER 1/4" = 1'-0"

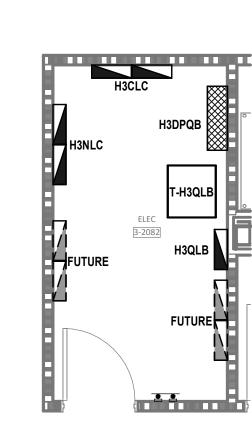
MANAGER OFFICE 3-2041




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3-2000


FLOOR PLAN - LEVEL 03 - MED SURG - TYP ADA PATIENT ROOM - LIGHTING 1/4" = 1'-0"

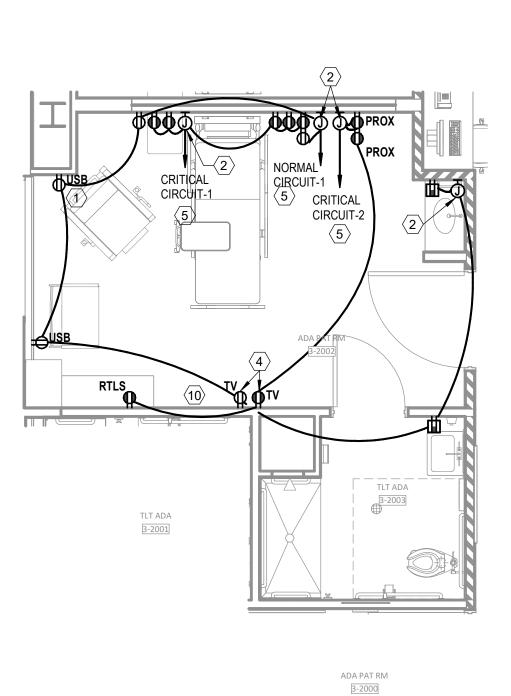

3 FLOOR PLAN - LEVEL 03 - MED SURG - TYP ADA PATIENT ROOM - POWER 1/4" = 1'-0"

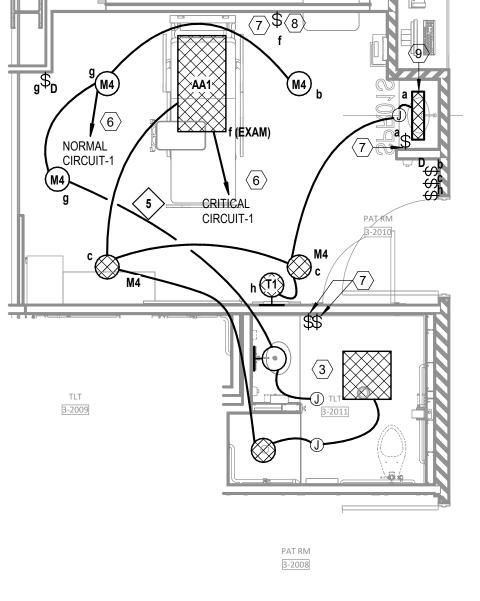

2 FLOOR PLAN - LEVEL 03 - MED SURG - TYP PATIENT ROOM - LIGHTING 1/4" = 1'-0"

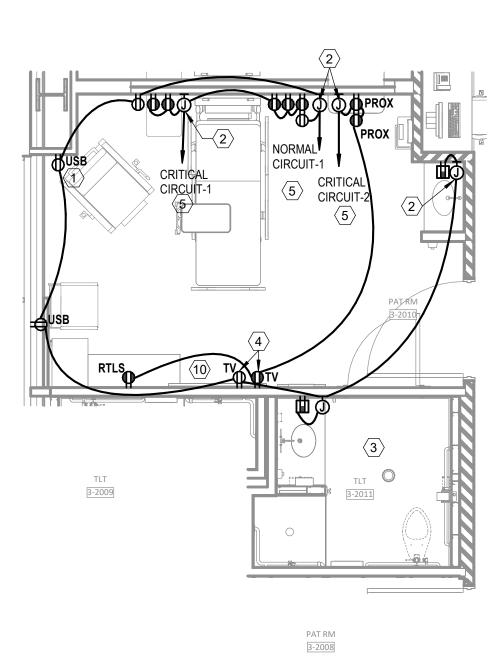

1 FLOOR PLAN - LEVEL 03 - MED SURG - TYP PATIENT ROOM - POWER 1/4" = 1'-0"

RELEASED FOR
CONSTRUCTION
As Noted on Plans Review

Development Services Departme

GENERAL NOTES

A. REFER TO SHEET E00-00 FOR ELECTRICAL SYMBOLS APPEARING ON THIS SHEET AND ADDITIONAL GENERAL NOTES.
 B. ALL CONDUCTORS ARE EXISTING TO REMAIN UNLESS NOTED WITH NEW WIRE TAG.

LEGEND NOTES

- 1 EXISTING LOAD IS BASED ON 30 DAY METERING LOAD FROM 06/05/2024 07/05/2024 X 1.25.
- 2 EXISTING LOAD IS BASED ON LAST 12 MONTHS OF UTILITY TRANSFORMER DATA.

Devenney
GROUP

Devenney Group Ltd., Architects

Devenney Group Ltd., Archite 6900 East Camelback Road Suite 500 Scottsdale, AZ 85251 T: 602.943.8950

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FACILITY NUMBER: **0972400009**

AGENCY APPROVALS:

REVISIONS

REV # DESCRIPTION DATE

DESIGN COORDINATION 2025/02/06

DATE: 2024/12/05

SCALE: 1/8" = 1'-0"


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REVIEWED: Checker


JOB NUMBER: 6406.24

ONE LINE DIAGRAM -

E06-01

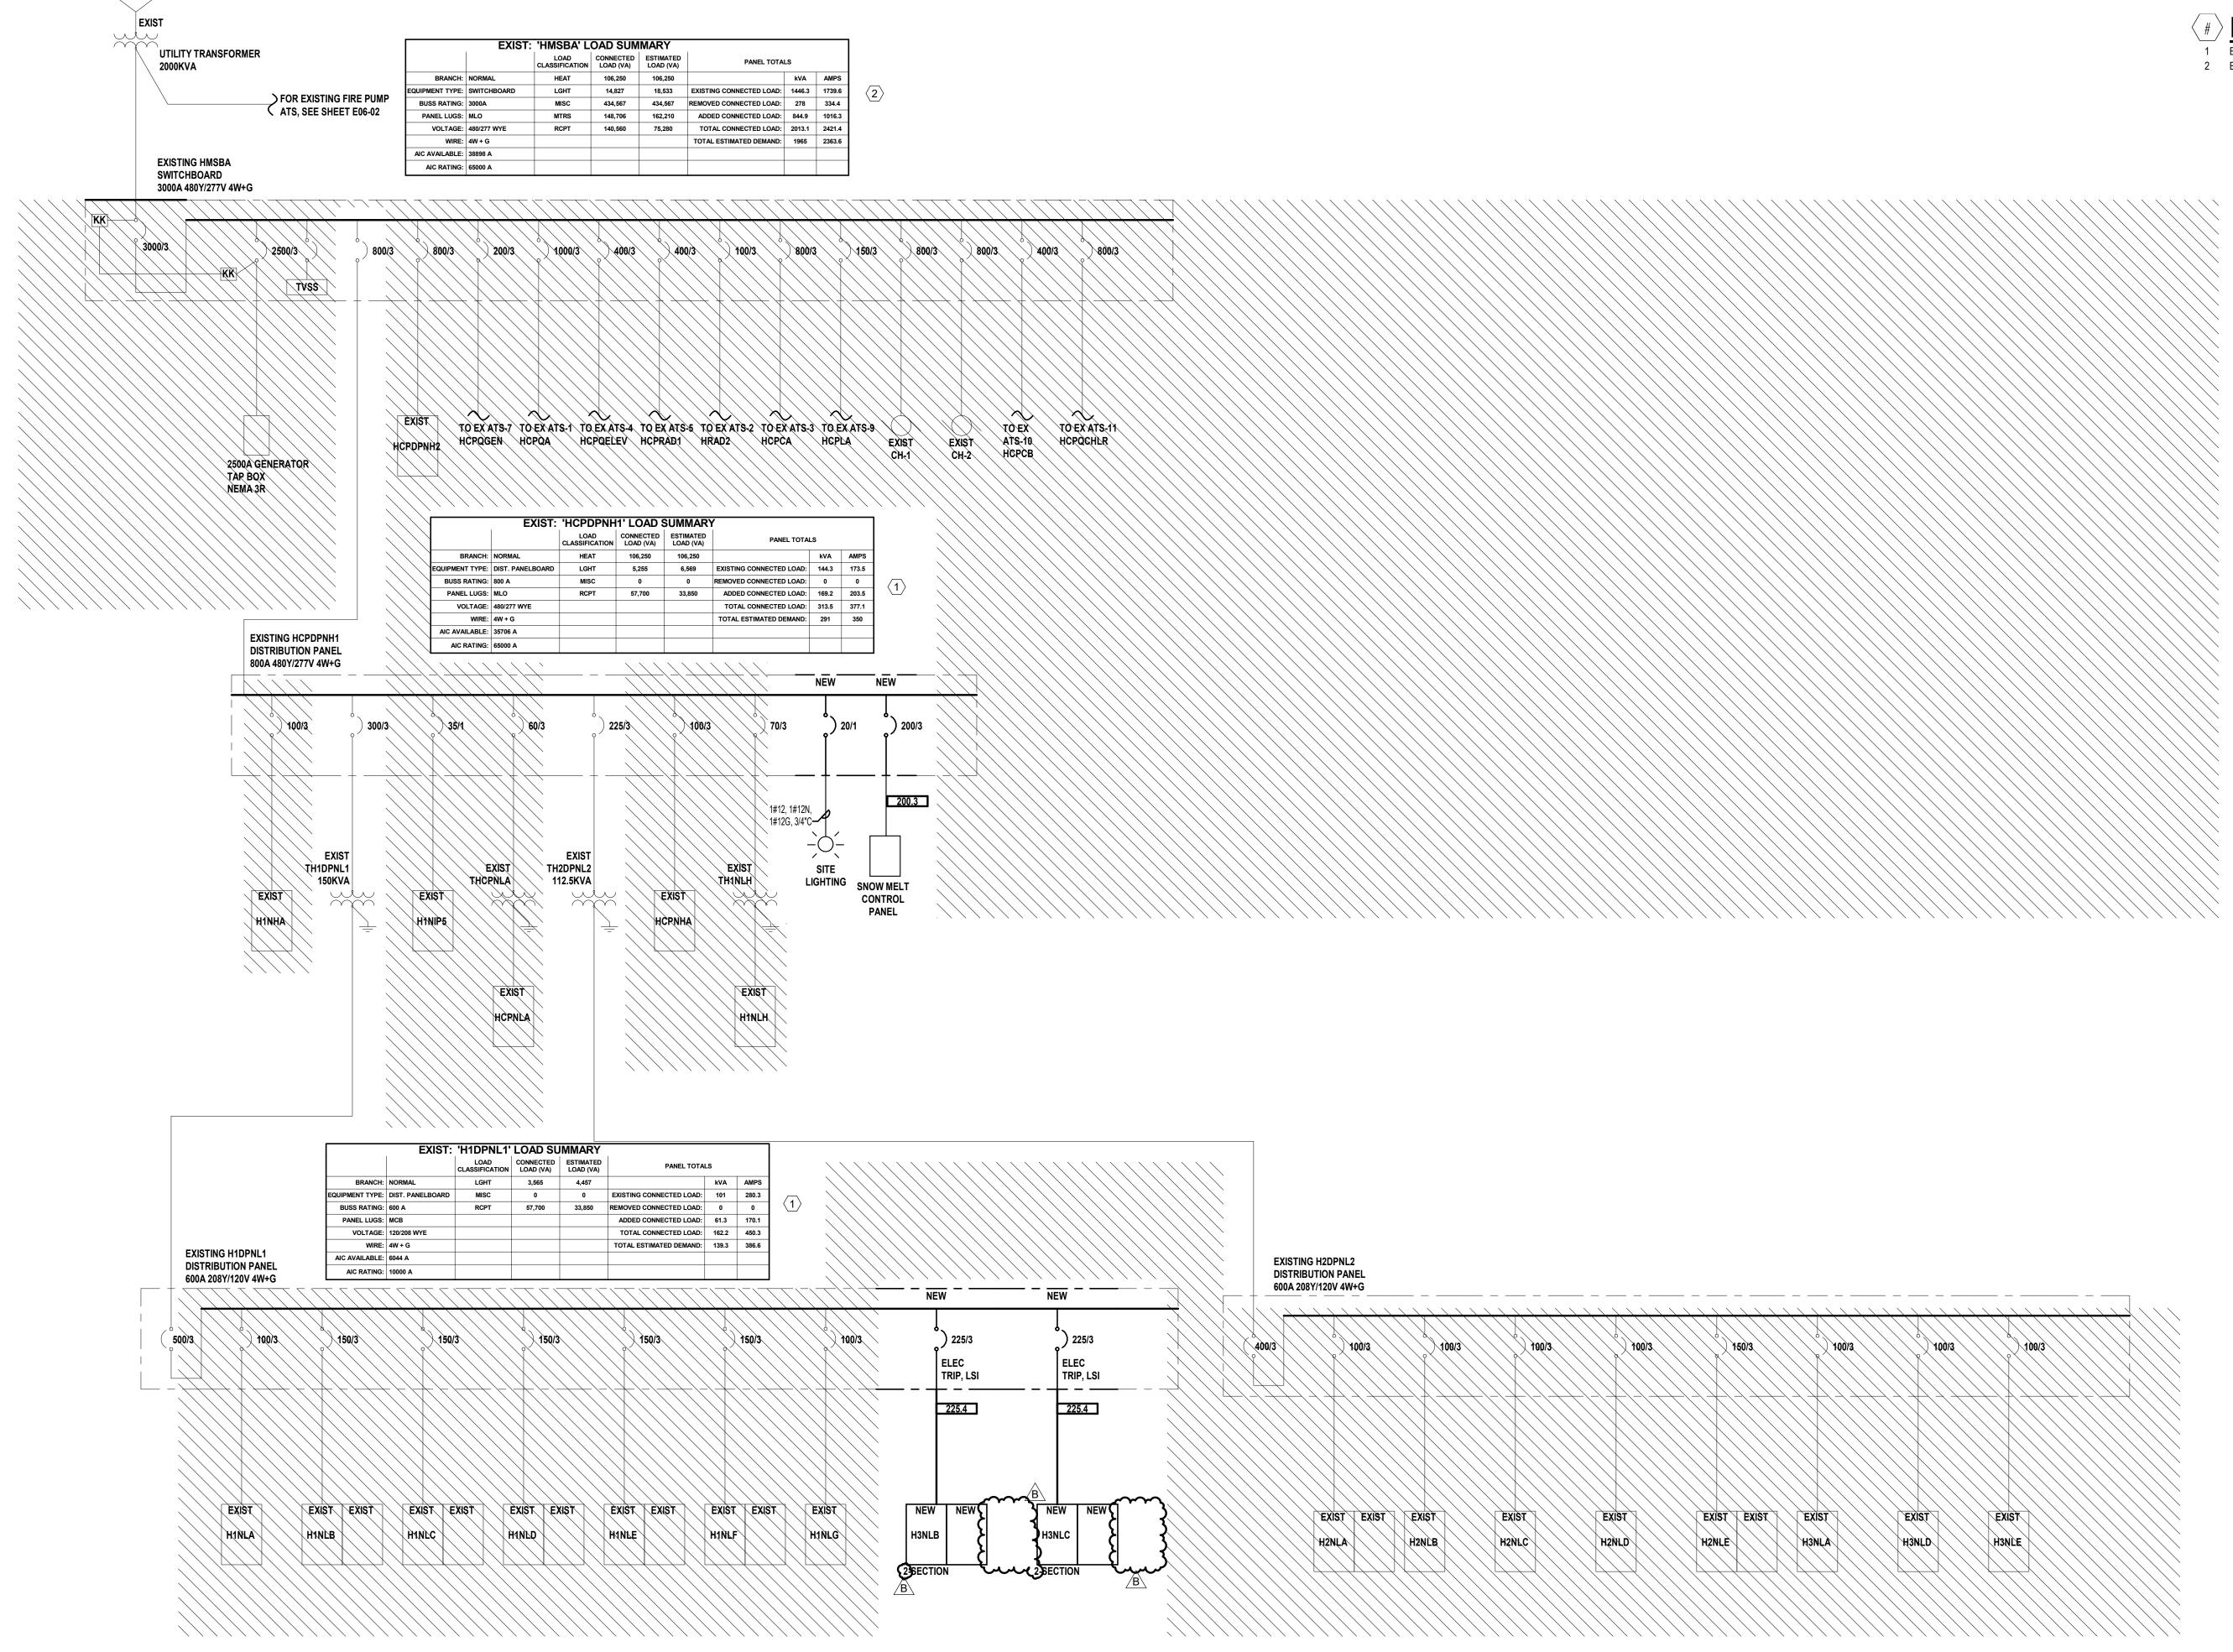

1 HOSPITAL - NORMAL ONE-LINE DIAGRAM N.T.S

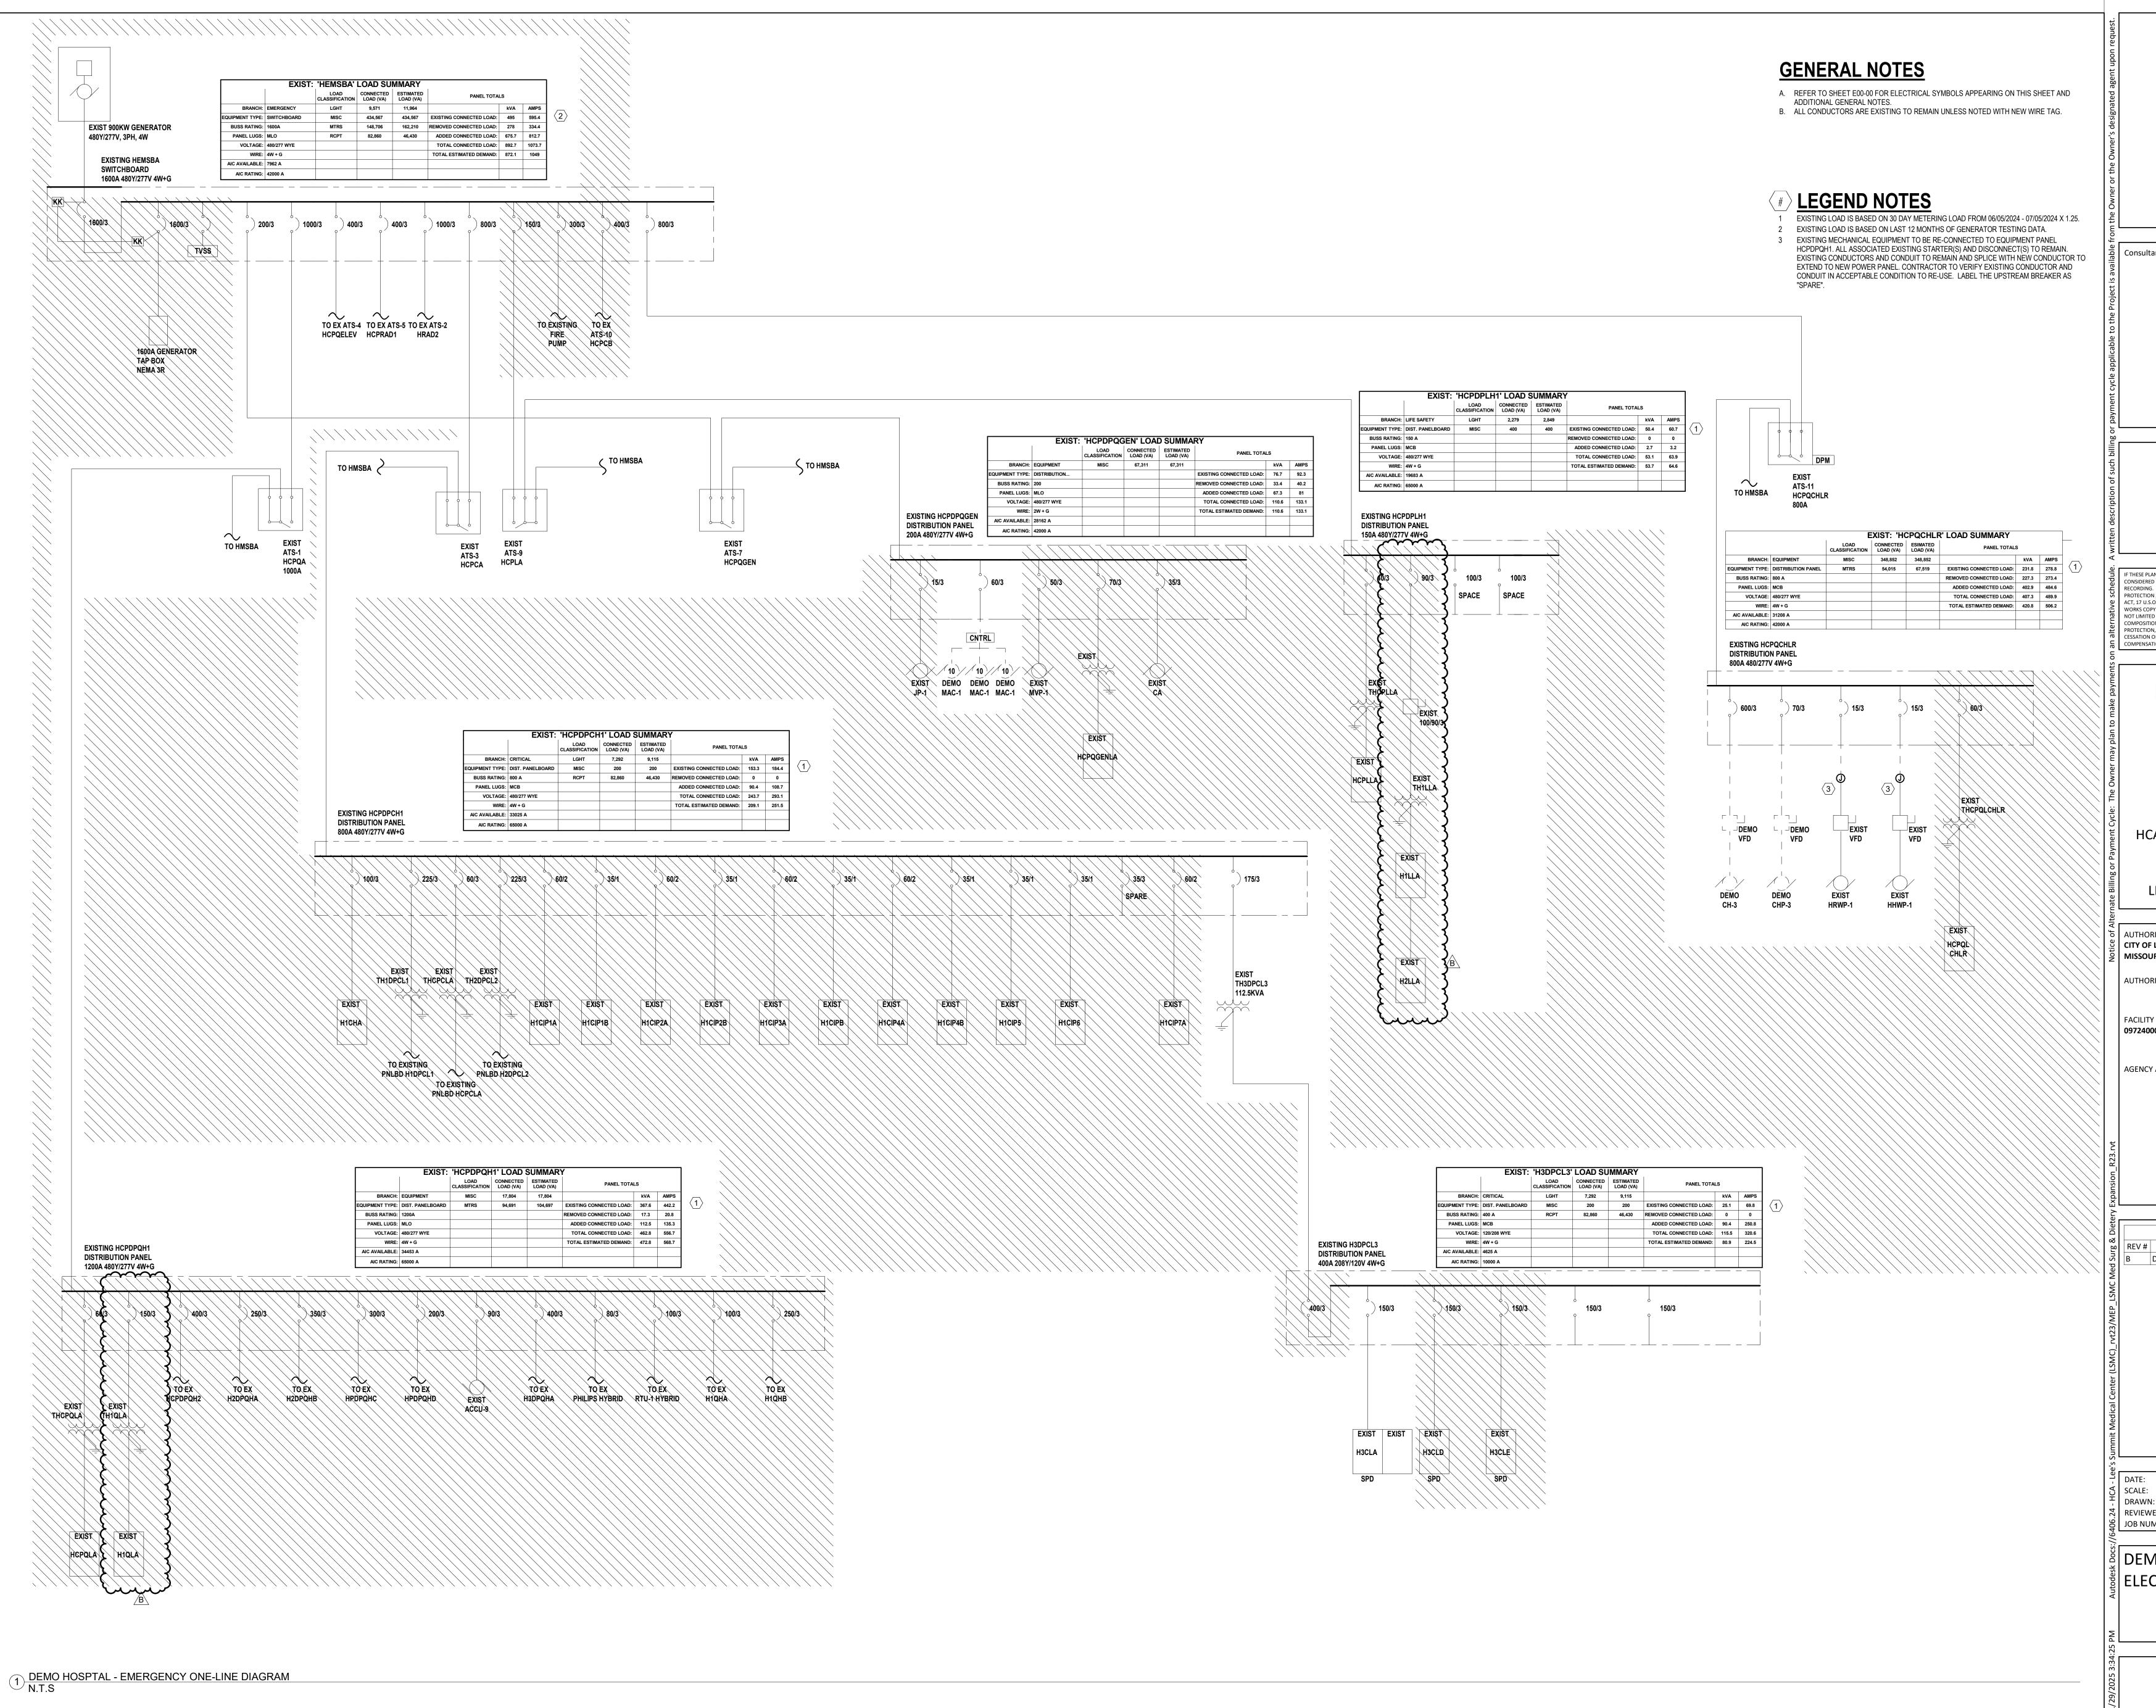

Devenney GROU

CONSTRUCTION
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DESCRIPTION

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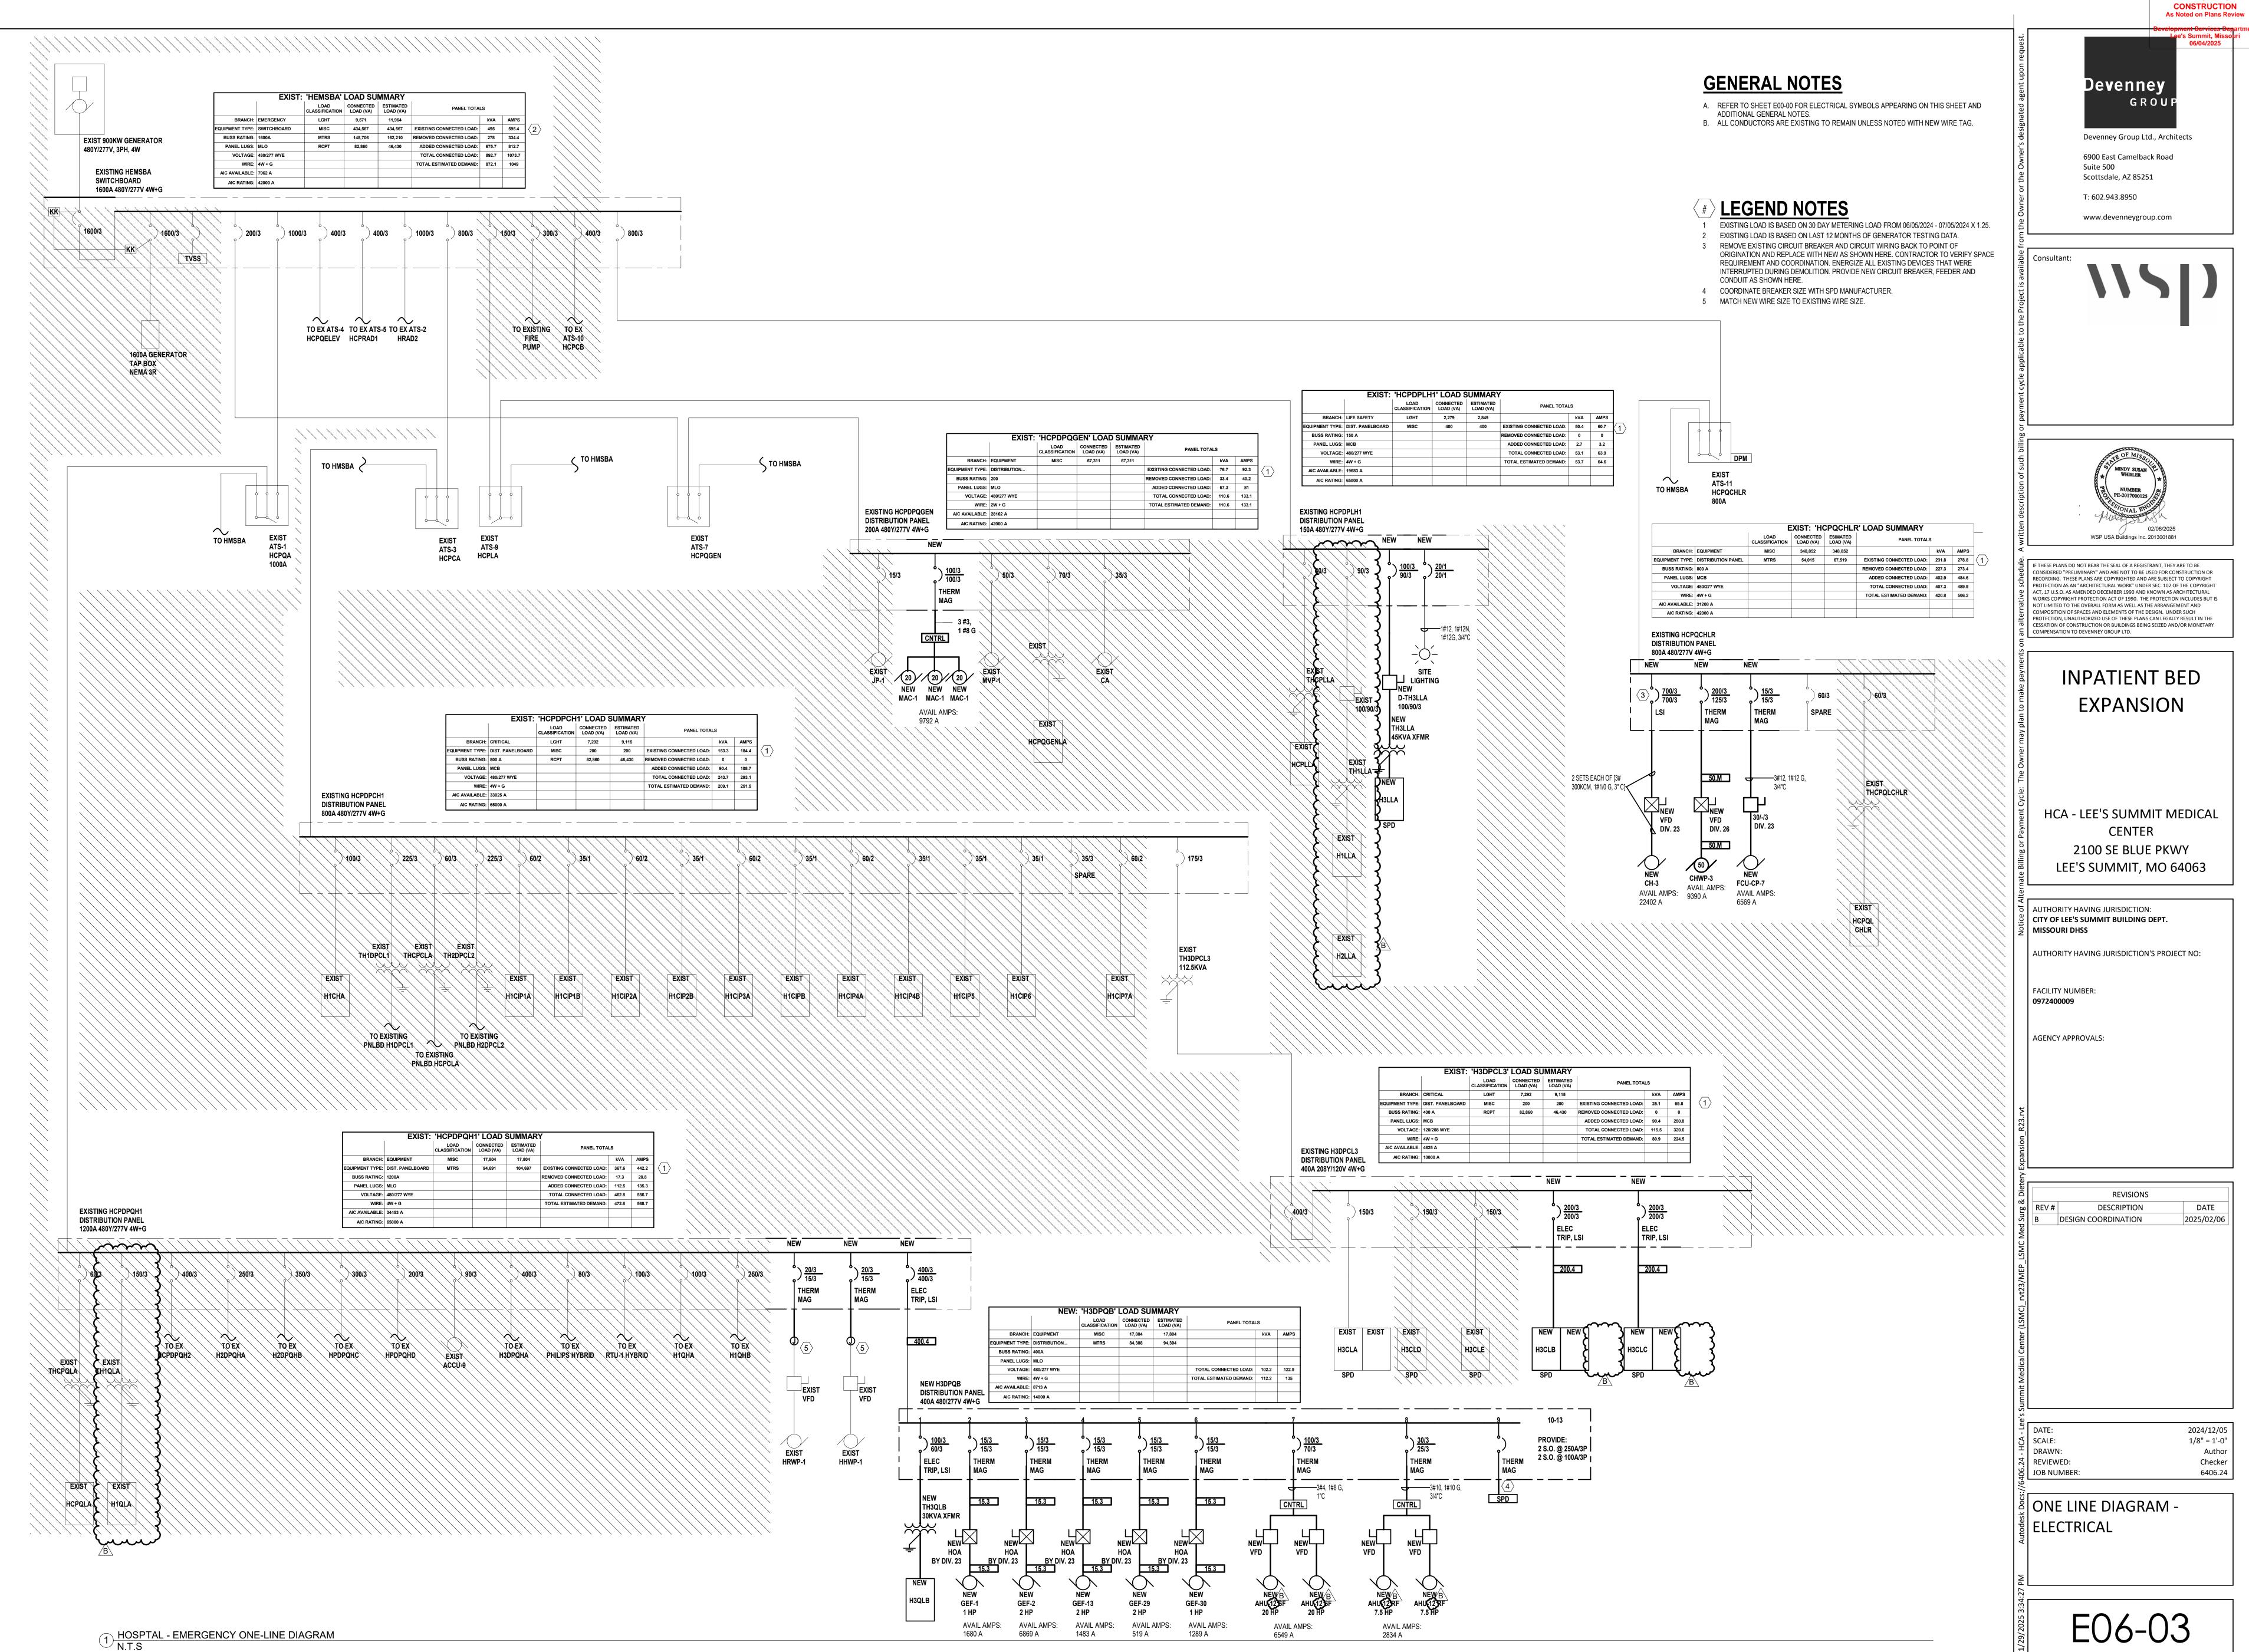
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REVIEWED: Checker 6406.24 JOB NUMBER:


DEMO ONE LINE DIAGRAM -ELECTRICAL


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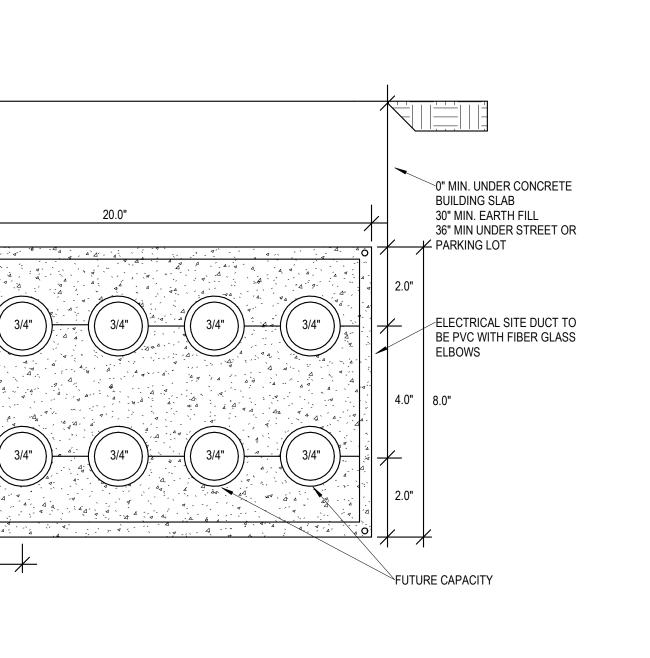


CONTRACTOR TO PROVIDE ALL NECESSARY EQUIPMENT AND CONNECTIONS REQUIRED TO ACCOMPLISH THE FUNCTIONS INDICATED, AT MINIMUM. SEQUENCE OF OPERATIONS INDICATED IS SCHEMATIC. MODIFY TO SUIT EXISTING HOSPITAL CONDITIONS AND MEET APPLICABLE CODE REQUIREMENTS.

INLET HOLES FACING INTO AIR FLOW-

PROVIDE DUCT MOUNTED SMOKE DETECTOR UPSTREAM OF RETURN AIR FAN IN RETURN AIR

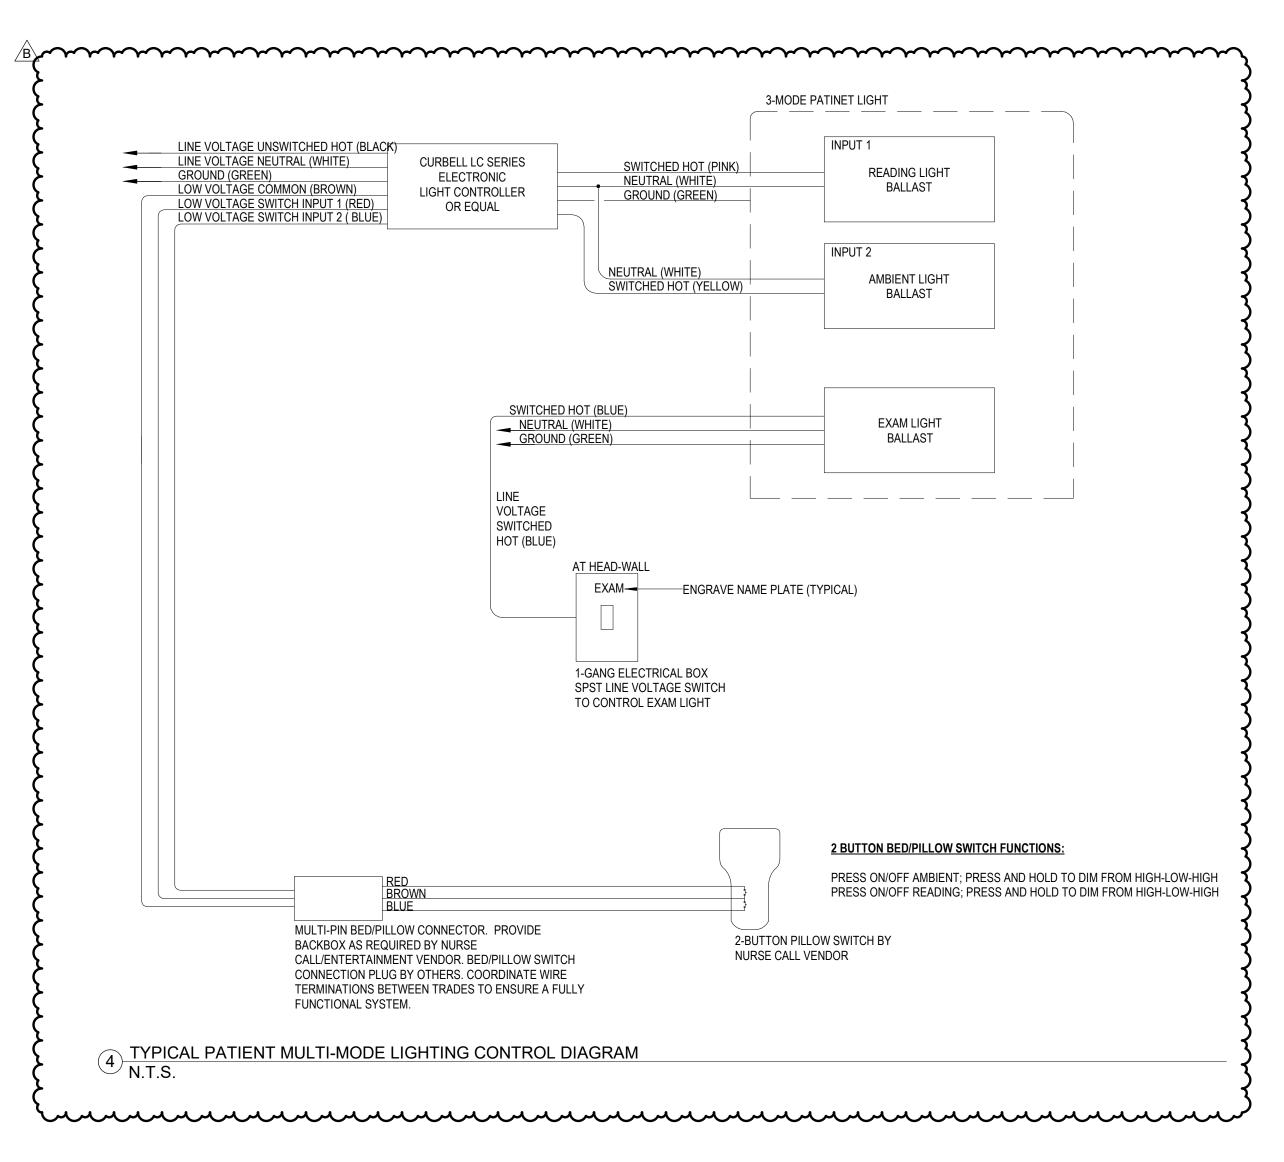FIRE ALARM SEQUENCE OF OPERATIONS

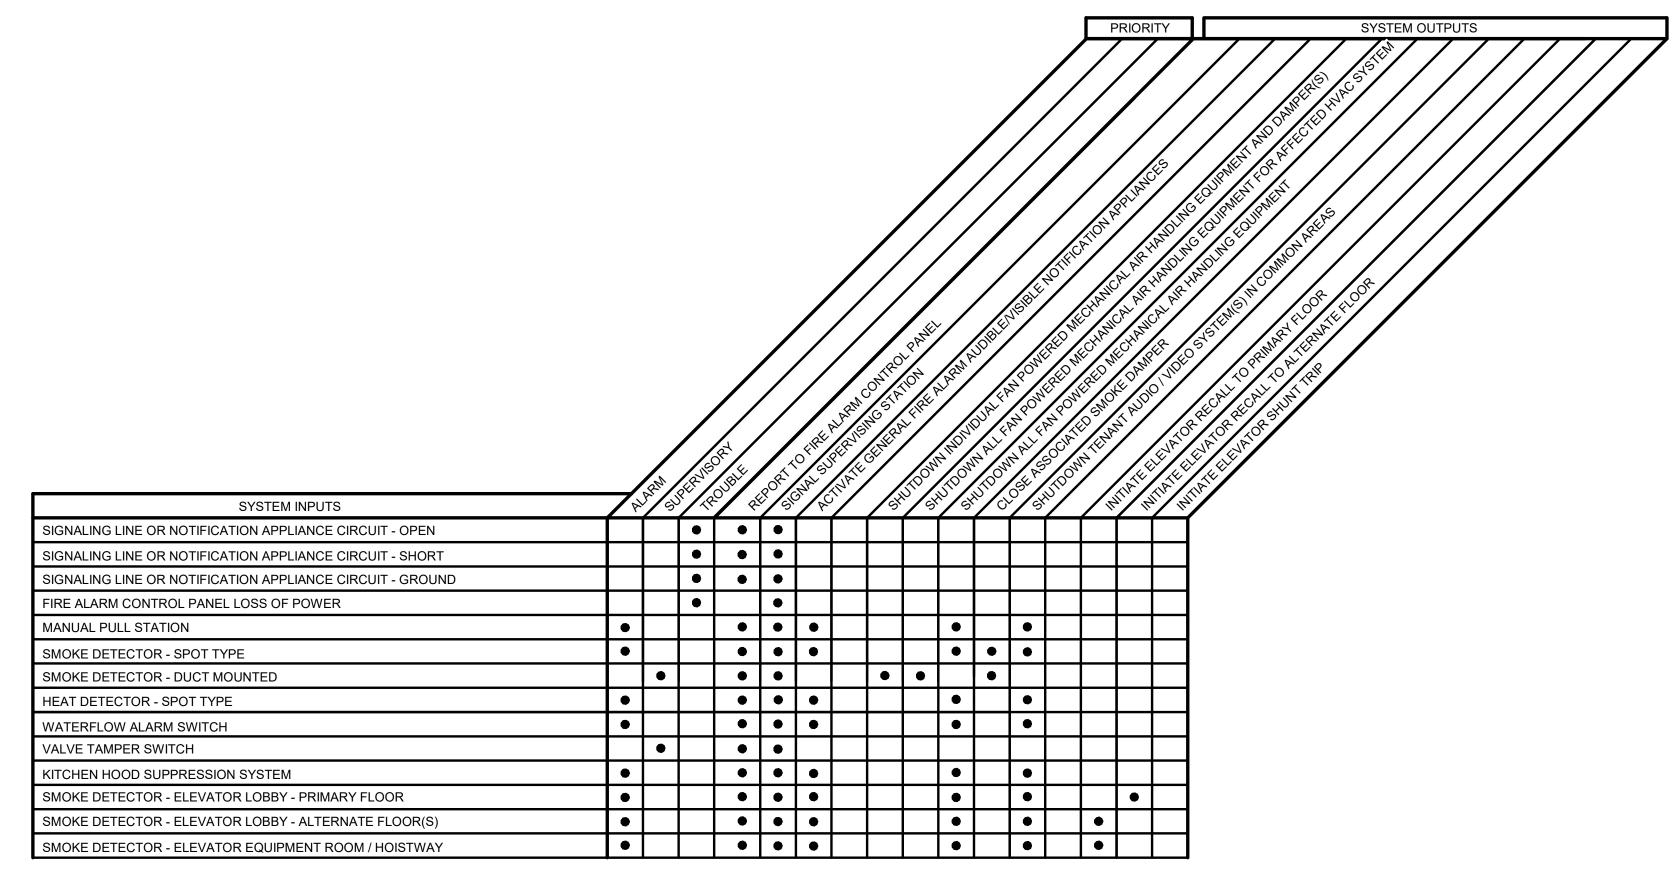

REINFORCED CONCRETE

ENCASEMENT (MINIMUM

#4 REBAR WITH #4 TIES @

24" O.C., (TYPICAL, VERIFY ADEQUACY OF

REBAR QUANTITIES AND

SIZES WITH STRUCTURAL

3 DUCTBANK SECTION N.T.S.

ENGINEER).-

2-INCHES)

1) INDOOR AIR HANDLING UNIT DUCT MOUNTED SMOKE DETECTOR DETAIL N.T.S.

REMOTE LED DETECTOR STATUS INDICATOR AND TEST

"DETECTOR ADDRESS"


NORMAL "AHU OR EQUIP. NO."

SWITCH ON WALL OR UNISTRUT MOUNTED AT VISIBLE LOCATION IN MECHANICAL ROOM THAT CAN BE

Fire Alarm Module

REACHED WITHOUT A LADDER.

REMOTE TEST INDICATOR

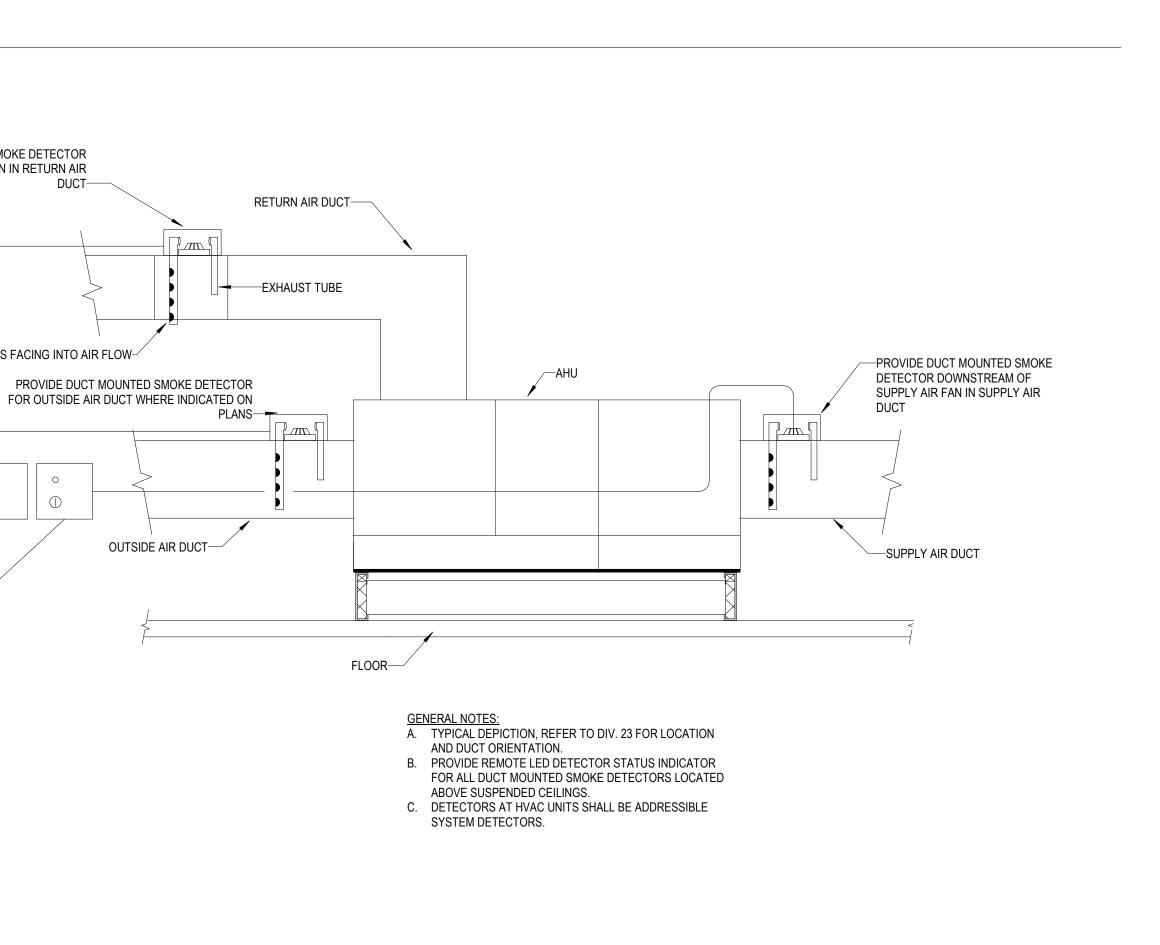

As Noted on Plans Review Devenney GROU Devenney Group Ltd., Architects

6900 East Camelback Road


www.devenneygroup.com

Scottsdale, AZ 85251

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Suite 500

CONSTRUCTION

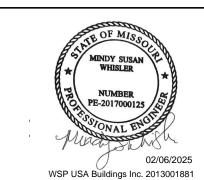

IF THESE PLANS DO NOT BEAR THE SEAL OF A REGISTRANT, THEY ARE TO BE CONSIDERED "PRELIMINARY" AND ARE NOT TO BE USED FOR CONSTRUCTION OR RECORDING. THESE PLANS ARE COPYRIGHTED AND ARE SUBJECT TO COPYRIGHT PROTECTION AS AN "ARCHITECTURAL WORK" UNDER SEC. 102 OF THE COPYRIGHT Q ACT, 17 U.S.O. AS AMENDED DECEMBER 1990 AND KNOWN AS ARCHITECTURAL WORKS COPYRIGHT PROTECTION ACT OF 1990. THE PROTECTION INCLUDES BUT IS NOT LIMITED TO THE OVERALL FORM AS WELL AS THE ARRANGEMENT AND COMPOSITION OF SPACES AND ELEMENTS OF THE DESIGN. UNDER SUCH CESSATION OF CONSTRUCTION OR BUILDINGS BEING SEIZED AND/OR MONETARY COMPENSATION TO DEVENNEY GROUP LTD.

> **INPATIENT BED EXPANSION**

HCA - LEE'S SUMMIT MEDICAL CENTER 2100 SE BLUE PKWY LEE'S SUMMIT, MO 64063

AUTHORITY HAVING JURISDICTION: CITY OF LEE'S SUMMIT BUILDING DEPT. MISSOURI DHSS

AUTHORITY HAVING JURISDICTION'S PROJECT NO:

FACILITY NUMBER: 0972400009

AGENCY APPROVALS:

REVISIONS DATE DESCRIPTION oREV# DESIGN COORDINATION 2025/02/06

DATE:
CHANN:
CHA As indicated Checker 9 JOB NUMBER: 6406.24

DETAILS - ELECTRICAL

E07-02

						<u>ELECTRICAL L</u>	<u>UMINAIRE FIXTURE</u>	<u>SCH</u>	<u>EDU</u>	<u>LE</u>								
TYPE		1	T	PHYSICAL DESCRIPT	<u>rion</u>			001.05			ELECTR	RICAL SPI	ECIFICAT	TIONS			MANUFACTURER INFORMATION	<u>N</u>
ITPE	DESCRIPTION	LOCATION	HOUSING	REFLECTOR	SHIELDING	<u>FINISH</u>	MOUNTING	COLOR TEMP.	LAMP	LUMENS	HOURS	<u>VA</u>	<u>UNITS</u>	BALLAST / DRIVER	VOLTAGE	MANUFACTURER	CATALOG NUMBER	REMARKS
A1	2' x 4' LED VOLUMETRIC TROFFER	PUBLIC AND CORRIDOR	ONE PIECE STEEL	ACRYLIC LINEAR PRISMATIC DIFFUSER	N/A	MATTE WHITE POWDERCOAT	RECESSED GYPSUM BOARD OR LAY IN CEILING	4,000	LED	4,000	60000	32	EACH	LED DRIVER - LINEAR DIMMING 0-10V DOWN TO 1%	120	LITHONIA	#2VTL4 40L ADP EZ1 LP840	
A2	2' x 4' LED VOLUMETRIC TROFFER	PUBLIC AND CORRIDOR	ONE PIECE STEEL	ACRYLIC LINEAR PRISMATIC DIFFUSER	N/A	MATTE WHITE POWDERCOAT	RECESSED GYPSUM BOARD OR LAY IN CEILING	4,000	LED	4,800	60000	39	EACH	LED DRIVER - LINEAR DIMMING 0-10V DOWN TO 1%	120	LITHONIA	#2VTL4 48L ADP EZ1 LP840	
AA1	2' x 4' MULTI-MODE PAT TROFFER WITH SEPARATE LIGHTING CONTROLS FOR EXAM AND AMBIENT/READING LIGHTING VIA LOW VOLTAGE CONTROLLER (PILLOW SPEAKER)	PATIENT ROOMS	20 GA. COLD ROLLED STEEL, DIE-CAST EXTRUDED ALUMINUM FRAME	DIFFUSE HIGH-EFFICENCY ACRYLIC LENS	N/A	LOW GLOSS WHITE POWDER COAT	RECESSED CEILING	4,000	LED	4,209	85000	20	EACH	LED DRIVER - LINEAR DIMMING 0-10V DOWN TO 1%	120	KENALL	#MPCNG X24-42L/21L/96L-40K8-40K8-DCC-DVLVCDF-80 24	
B2	2' x 4' LED ACRYLIC LENSED PREMIUM TROFFER	PREP/REC, IV/TH	22 GA. STEEL HOUSING	#12 TRANSMISSIVE 0.125" LENS	HINGED AND LATCHED FROM EITHER SIDE, ENCLOSED SPRING LOADED CAM LATCH, WHITE REGRESSED ALUMINUM DOOR WITH MITERED CORNERS	PAINTED AFTER FABRICATION	RECESSED GYPSUM BOARD OR LAY IN CEILING	4,000	LED	10,000	72000	83	EACH	LED DRIVER - LINEAR DIMMING 0-10V DOWN TO 1%	120	LITHONIA	#2GTL 4 100L RW EZ1 LP840 PAF	
В3	2' x 4' LED ACRYLIC LENSED PREMIUM TROFFER	STAFF WORKING	22 GA. STEEL HOUSING	#12 TRANSMISSIVE 0.125" LENS	HINGED AND LATCHED FROM EITHER SIDE, ENCLOSED SPRING LOADED CAM LATCH, WHITE REGRESSED ALUMINUM DOOR WITH MITERED CORNERS	PAINTED AFTER FABRICATION	RECESSED GYPSUM BOARD OR LAY IN CEILING	4,000	LED	4,800	72000	36	EACH	LED DRIVER - LINEAR DIMMING 0-10V DOWN TO 1%	120	LITHONIA	#2GTL 4 48L RW EZ1 LP840 PAF	
взк	2' x 4' LED LENSED TROFFER, WET LOCATION LISTED, INVERTED LENS	FOOD SERVICE	22 GA. STEEL HOUSING	#12 TRANSMISSIVE 0.125" LENS	N/A	MATTE WHITE POWDERCOAT	RECESSED GYPSUM BOARD OR LAY IN CEILING	4,000	LED	7,645	72000	53	EACH	LED DRIVER - LINEAR DIMMING 0-10V DOWN TO 1%	120	LITHONIA	#2GTL 4 72L FW A12125(INV) EZ1 LP840 ABC	
D2	2' x 2' LED VOLUMETRIC TROFFER	STAFF WORKING	ONE PIECE STEEL	ACRYLIC LINEAR PRISMATIC DIFFUSER	WHITE REGRESSED ALUMINUM DOOR	MATTE WHITE POWDERCOAT	RECESSED GYPSUM BOARD OR LAY IN CEILING	4,000	LED	4,000	60000	33	EACH	LED DRIVER - LINEAR DIMMING 0-10V DOWN TO 1%	120	LITHONIA	#2VTL2 40L ADP EZ1 LP840	
F1 .	2' x 2' LED ACRYLIC LENSED PREMIUM TROFFER	RESTROOM	22 GA. STEEL HOUSING	#12 TRANSMISSIVE 0.125" LENS	HINGED AND LATCHED FROM EITHER SIDE, ENCLOSED SPRING LOADED CAM LATCH, WHITE REGRESSED ALUMINUM DOOR WITH MITERED CORNERS	PAINTED AFTER FABRICATION	RECESSED GYPSUM BOARD OR LAY IN CEILING	4,000	LED	3,300	72000	29	EACH	LED DRIVER - LINEAR DIMMING 0-10V DOWN TO 1%	120	LITHONIA	#2GTL X 2 33L RW EZ1 LP840	
F1K	2' x 2' LED LENSED TROFFER, WET LOCATION LISTED, INVERTED LENS	FOOD SERVICE	22 GA. STEEL HOUSING	#12 TRANSMISSIVE 0.125" LENS	N/A	MATTE WHITE POWDERCOAT	RECESSED GYPSUM BOARD OR LAY IN CEILING	4,000	LED	5,051	72000	42	EACH	LED DRIVER - LINEAR DIMMING 0-10V DOWN TO 1%	120	LITHONIA	#2GTL 2 48L FW A12125(INV) EZ1 LP840 ABC	
H1	2' LED UNDERCABINET LIGHT WITH ROCKER SWITCH	UNDERCABINET	20 GA. STEEL HOUSING	HIGH IMPACT ACRYLIC LENS	N/A	ANTIMICROBIAL WHITE, PAINTED AFTER FABRICATION	SURFACE MOUNTED	4,000	LED	1,221	65000	12	EACH	LED DRIVER - LINEAR DIMMING 0-10V DOWN TO	120	HEALTHCARE-LIGHTING	#HUC523 MVOLT LED40 S1 AM	
J2	4'-0" LED LOW PROFILE LENSED STRIPLIGHT WITH DROP LENS FOR 10% UPLIGHT	STORAGE AND FACILITY	20 GA. HEAVY DUTY STEEL HOUSING	SYMMETRIC REFLECTOR	COLD ROLLED STEEL	WHITE FINISH, PAINTED AFTER FABRICATION	CHAIN HUNG AT 9'-0" A.F.F. LOCATED AROUND FOUIPMENT	4,000	LED	7,000	50000	30	EACH	LED DRIVER - LINEAR DIMMING 0-10V DOWN TO 1%	120	LITHONIA	#ZL1D L48 SMR 7000LM FST MVOLT 40K 80CRI	
K1	4'-0" LED PREMIUM LED WALL BRACKET, UP/DOWN LIGHT DISTRIBUTION; FIXTURE DIMS TO APPROXIMATELY 50% LIGHT OUTPUT WHEN UNOCCUPIED. LIGHTS WILL AUTOMATIC DIM BASE ON AVAILABLE DAYLIGHT.	STAIRS	NORMAL 2.5" X 4.375" EXTRUDED ALUMINUM HOUSING	0.125" HIGH-IMPACT CLEAR PRISMATIC ACRYLIC DIFFUSE	DIE CAST END PLATES	RAL#7046 FINISH, PAINTED AFTER FABRICATION	WALL MOUNTED, REFER TO ARCHITECTURAL FOR MOUNTING HEIGHT	4,000	LED	4,800	50000	23	EACH	LED DRIVER - LINEAR DIMMING 0-10V DOWN TO 1%	120	MARK ARCHITECTURAL LIGHTING	#S2LWID MSL4 90CRI 40K 600LMF I90CRI I40K I600LMF MIN1 SCT MVOLT RAL#7046 ZT	
L3	LED VANITY SCONCE, 24" LENGTH, DIRECT-INDIRECT	TOILET ROOMS	N/A	N/A	N/A	BRUSHED ALUMINUM FINISH	WALL MOUNTED, REFER TO ARCHITECTURAL FOR MOUNTING HEIGHT	4,000	LED	1,932	60000	14	EACH	LED DRIVER - LINEAR DIMMING 0-10V DOWN TO 1%	120	WINONA	#WFW4608 24LONG LEDX2 40K MVOLT OAE BA MEZ126783-MOD	
M1	6" LED DOWNLIGHT WITH 45 DEGREE CUT OFF	PUBLIC AND CORRIDOR	16 GA. GALVANIZED STEEL CONSTRUCTION	HIGH-IMPACT, FROSTED POLYCARBONATE LENS	LIGHT ENGINE AND DRIVER ACCESSIBLE THROUGH APERATURE	MATTE WHITE SELF-FLANGED, SEMI-SPECULAR FINISH	RECESSED GYPSUM BOARD OR LAY IN CEILING	4,000	LED	6,000	60000	10	EACH	LED DRIVER - LINEAR DIMMING 0-10V DOWN TO 1%	120	GOTHAM	#EVO6 40/10 AR MWD LSS MVOLT GZ10	
M2	6" LED DOWNLIGHT WITH 45 DEGREE CUT OFF	FOOD SERVICE	16 GA. GALVANIZED STEEL CONSTRUCTION	HIGH-IMPACT, FROSTED POLYCARBONATE LENS	LIGHT ENGINE AND DRIVER ACCESSIBLE THROUGH APERATURE	MATTE WHITE SELF-FLANGED, SEMI-SPECULAR FINISH	RECESSED GYPSUM BOARD OR LAY IN CEILING	4,000	LED	1,500	60000	15	EACH	LED DRIVER - LINEAR DIMMING 0-10V DOWN TO 1%	120	GOTHAM	#EVO6 40/15 AR MWD LSS MVOLT GZ10	
M4	6" LED DOWNLIGHT WITH 45 DEGREE CUT OFF	PATIENT ROOMS	16 GA. GALVANIZED STEEL CONSTRUCTION	HIGH-IMPACT, FROSTED POLYCARBONATE LENS	LIGHT ENGINE AND DRIVER ACCESSIBLE THROUGH APERATURE	MATTE WHITE SELF-FLANGED, SEMI-SPECULAR FINISH	RECESSED GYPSUM BOARD OR LAY IN CEILING	4,000	LED	2,000	60000	20	EACH	LED DRIVER - LINEAR DIMMING 0-10V DOWN TO 1%	120	GOTHAM	#EVO6 40/20 AR MWD LSS MVOLT GZ10	
N2	RECESSED CONTINUOS LINEAR	DINING	EXTRUDED ALUMINUM, 20 GA. COLD ROLLED STEEL	PRECISION FORMED STEEL	N/A	NATURAL ALUMINUM HOUSING, HIGH REFLECTANCE MATTE WHITE FASCIA	RECESSED CEILING, VERIFY CEILING TYPE PRIOR TO ORDERING	4,000	LED	345	50000	32	LF	LED DRIVER - LINEAR DIMMING 0-10V DOWN TO 1%	120	MARK ARCHITECTURAL LIGHTING	#SL6L LOP 8FT FLP 80CRI 40K 400LMF MIN1 120V ZT	
N3	RECESSED CONTINUOS LINEAR	DINING	EXTRUDED ALUMINUM, 20 GA. COLD ROLLED STEEL	PRECISION FORMED STEEL	N/A	NATURAL ALUMINUM HOUSING, HIGH REFLECTANCE MATTE WHITE FASCIA	RECESSED CEILING, VERIFY CEILING TYPE PRIOR TO ORDERING	4,000	LED	345	50000	24	LF	LED DRIVER - LINEAR DIMMING 0-10V DOWN TO 1%	120	MARK ARCHITECTURAL LIGHTING	#SL6L LOP 6FT FLP 80CRI 40K 400LMF MIN1 120V ZT	
R2	6" LED SHOWER LIGHT, IP 65 RATED	RESTROOM	20 GA. STEEL HOUSING	ALUMINIUM DIE CAST REFLECTOR	REGRESSED PRISMATIC LENS	SPECULAR CLEAR ALZAK REFLECTOR FINISH	RECESSED GYPSUM BOARD OR LAY IN CEILING, VERIFY CEILING TYPE BEFORE ORDERING	4,000	LED	1,000	60000	10	EACH	LED DRIVER	120	GOTHAM	#EVO6 40/10 DFR MVOLT EZ1	
T1	RECTANGULAR LED NIGHT LIGHT	PATIENT ROOMS	HEAVY GUAGE STEEL FACEPLATE	N/A	N/A	POLYESTER POWDERCOAT FINISH	RECESSED IN WALL AT 20" A.F.F. TO CENTERLINE OF FIXTURE	3,000	LED	0	50000	1	EACH	LED DRIVER	120	HEALTHCARE-LIGHTING	#HNL610 MVOLT LED30 AM	
X1	ED DECORATIVE RECESSED EDGE-LIT EXIT LIGHT, SINGLE FACE	EGRESS	20 GA. GALVANIZED STEEL, EXTRUDED ALUMINUM HOUSING	SATIN ALUMINUM TRIM PLATE MOLDED TEXTURED LETTERS	5, N/A	6 INCH HIGH RED LETTERS ON MIRROR BACKGROUND, DIRECTIONAL CHEVRON INDICATORS AS REQUIRED	BACK / CEILING / END MOUNTING AS REQUIRED PER PLANS	0	LED	10	87600	1	EACH	N/A	120	LITHONIA	#LRP 1 RMR 120/277	
	LED DECORATIVE RECESSED EDGE-LIT EXIT LIGHT, DOUBLE FACE	EGRESS		SATIN ALUMINUM TRIM PLATE MOLDED TEXTURED LETTERS		6 INCH HIGH RED LETTERS ON MIRROR BACKGROUND, DIRECTIONAL CHEVRON INDICATORS AS REQUIRED	BACK / CEILING / END MOUNTING AS REQUIRED PER PLANS	0	LED	15	87600	2	EACH	N/A	120	LITHONIA	#LRP 2 RMR 120/277	

						EXTERIOR ELECTRIC	AL LUMINAIRE FIXT	<u>URE</u>	SCH	IEDUI	<u>LE</u>							
TVDE				PHYSICAL DESCRIP	<u>TION</u>						ELECTRI(CAL SPE	CIFICAT	<u>'IONS</u>			MANUFACTURER INF	DRMATION
TYPE	DESCRIPTION	LOCATION	HOUSING	REFLECTOR	SHIELDING	<u>FINISH</u>	MOUNTING	COLOR TEMP.	<u>LAMP</u>	LUMENS	HOURS	VA	<u>UNITS</u>	BALLAST / DRIVER	<u>VOLTAGE</u>	MANUFACTURER	CATALOG NUMBER	<u>REMARKS</u>
M1	6" LED DOWNLIGHT WITH 45 DEGREE CUT OFF	CANOPY	16 GA. GALVANIZED STEEL CONSTRUCTION	HIGH-IMPACT, FROSTED POLYCARBONATE LENS	LIGHT ENGINE AND DRIVER ACCESSIBLE THROUGH APERATURE	MATTE WHITE SELF-FLANGED, SEMI-SPECULAR FINISH	RECESSED	4,000	LED	1,500	60000	12	EACH	LED DRIVER - LINEAR DIMMING 0-10V DOWN TO 1%	120	GOTHAM	#EVO6 40/15 AR MWD LSS MVOLT GZ10	
S1	ARCHITECTURAL SINGLE HEAD LED SITE FIXTURE, TYPE IV DISTRIBUTION	EXTERIOR SITE	DIE-CAST ALUMINUM	TYPE IV MEDIUM	NONE	TGIC THERMOSET POWDER COAT FINISH IN DARK BRONZE	POLE MOUNTED - 20'-0" ROUND ALUMINUM POLE ON 2'6" CONCRETE BASE	4,000	LED	5,543	10000	89	EACH	LED DRIVER	277	LITHONIA	#DSX0LED-20C-1000-40K-BLC-MVOLT-RPA-DD BXD AND POLE RSA-20	
S2	ARCHITECTURAL DOUBLE HEAD LED SITE FIXTURE, TYPE IV DISTRIBUTION	EXTERIOR SITE	DIE-CAST ALUMINUM	TYPE IV MEDIUM	NONE	TGIC THERMOSET POWDER COAT FINISH IN DARK BRONZE	POLE MOUNTED - 20'-0" ROUND ALUMINUM POLE ON 2'6" CONCRETE BASE	4,000	LED	5,543	10000	89	EACH	LED DRIVER	277	LITHONIA	#DSX0LED-20C-1000-40K-BLC-MVOLT-RPA-DD BXD AND POLE RSA-20	
S3	BOLLARD LED SQUARE FLAT TOP	EXTERIOR SITE	N/A	N/A	N/A	TGIC POWDER COAT FINISH IN BLACK	SURFACE MOUNTED	5,000	LED	1,535	50000	72	EACH	LED DRIVER	120	HYDREL	#3140C-H42-8COB-50K-MVOLT-FT-BL	
SR1	ILLUMINATED RAIL	BRIDGE	STAINLESS STEEL	CLEAR LENS	N/A	STAINLESS STEEL 316	REFER TO MANUFACTURE SPEC SHEET	4,000	LED	8,000	60000	160	EACH	LED DRIVER	277	VIVA RAILINGS	#IR LIN 1.5 316 40K H CL 0	
Z1	LED TRAPEZOIDAL WALL PACK WITH PHOTOCELL, WIDE DISTRIBUTION	EXTERIOR	DIE CAST ALUMINUM, DIE-CAST DOOR FRAME WITH SOLID SILICONE GASKET, IP65	N/A	FULL CUTOFF	THERMOSET POWDER COAT FINISH, DARK BRONZE, CONFIRM WITH ARCHITECT	WALL MOUNTED, REFER TO ARCHITECTURAL FOR MOUNTING HEIGHT	4,000	N/A	1,500	100000	<varies< td=""><td>EACH</td><td>LED DRIVER</td><td>120</td><td>LITHONIA</td><td>#WST LED P1 40K VW MVOLT PE DDBXD</td><td></td></varies<>	EACH	LED DRIVER	120	LITHONIA	#WST LED P1 40K VW MVOLT PE DDBXD	

		LIGHTING CONTROL	L REQUIREN	MENTS AND S	EQUE	NCE OF C	PERATIONS	
		CONTROL		MANUAL CONTROL/OVE	RRIDE		OCCUPANCY SENSOR	
TAG	SPACE TYPES	CONTROL DESCRIPTION	CONTROL SYSTEM TYPE	DEVICE	DURIATION	TYPE/LOCATION	SET POINT	PHOTOCELL CONTROL
1 PUBLIC	C AREAS, RECEPTION, CORRIDORS	MANUAL ON TO 100%, MANUAL OFF, DIMMING VIA MANUAL CONTROLS	STAND-ALONE	LINE VOLTAGE SWITCH	N/A	N/A	N/A	N/A
2 RESTF	ROOMS/TOILET	AUTO ON TO 100%, AUTO OFF, MANUAL ON/OFF/DIM	STAND-ALONE	LINE VOLTAGE SWITCH	20 MIN	DUAL-TECH, WALL	AUTO ON/DIM; 20 MIN SET POINT	CEILING MOUNTED IN DAYLIGHT ZONES OVER 150W, 1 MIN FAD RATE
3 ENCLO	OSED ROOMS (OFFICE, BREAK, SUPPORT, ETC)	AUTO ON TO 50%, MANUAL ON TO 100%/OFF/DIM, AUTO OFF	STAND-ALONE	LINE VOLTAGE SWITCH	20 MIN	DUAL-TECH, WALL	AUTO ON 50%, AUTO OFF; 20 MIN SET POINT	CEILING MOUNTED IN DAYLIGHT ZONES OVER 150W, 1 MIN FAD RATE
4 ELECT	RICAL, MECHANICAL, COMM ROOMS	MANUAL ON/OFF	STAND-ALONE	LINE VOLTAGE SWITCH	N/A	N/A	N/A	N/A
5 PATIE	NT CARE AREAS	MANUAL ON/OFF/DIM	STAND-ALONE	LINE VOLTAGE SWITCH	N/A	N/A	N/A	MANUAL ON/OFF/DIM
6 DEPAR	RTMENT AREAS (KITCHEN, LAB)	AUTO ON TO 50%, MANUAL ON TO 100%/OFF/DIM, AUTO OFF	STAND-ALONE	LOW VOLTAGE WALL STATION	20 MIN	DUAL-TECH, CEILING	AUTO ON 50%, AUTO OFF; 20 MIN SET POINT	CEILING MOUNTED IN DAYLIGHT ZONES OVER 150W, 1 MIN FAD RATE
7 ENCLO	OSED ROOMS (LARGE OFFICE, BREAK, SUPPORT,	AUTO ON TO 50%, MANUAL ON TO 100%/OFF/DIM, AUTO OFF	STAND-ALONE	LOW VOLTAGE WALL STATION	20 MIN	DUAL-TECH, CEILING	AUTO ON 50%, AUTO OFF; 20 MIN SET POINT	CEILING MOUNTED IN DAYLIGHT ZONES OVER 150W, 1 MIN FAD RATE




Devenney Group Ltd., Architects

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INPATIENT BED EXPANSION

HCA - LEE'S SUMMIT MEDICAL CENTER 2100 SE BLUE PKWY LEE'S SUMMIT, MO 64063

AUTHORITY HAVING JURISDICTION:
CITY OF LEE'S SUMMIT BUILDING DEPT.
MISSOURI DHSS

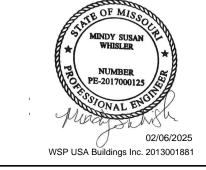AUTHORITY HAVING JURISDICTION'S PROJECT NO:

FACILITY NUMBER: **0972400009**

AGENCY APPROVALS:

REV# DESCRIPTION DATE
B DESIGN COORDINATION 2025/02/06

DATE: 2024/12/
SCALE:
DRAWN: Auth
REVIEWED: Check
JOB NUMBER: 6406.

SCHEDULES - ELECTRICAL

E08-02

MISC 18,971 18,971 RCPT 8,280 8,280 TOTAL CONNECTED LOAD: 36.4 TOTAL ESTIMATED DEMAND: 33.2	1	LOCATION: ELEC 1-1303 MAIN BUS: 225 A MCB: 225A VOLTAGE: 120/208 WYE AIC AVAILABLE: 3882 A AIC RATING: 10000 A			NUMBE	ENC B MC PAN	ED FROM WIRES LOSURE US TYPE DUNTING EL LUGS ECTIONS	: 4W + :: NEM/ :: COPF :: SURF :: MCB	G A 1 PER		NEUTRAL GROUND ISOLATED GROUND 200% NEUT FEED THROUGH LI POLES PER SECT	BUS: YES BUS: NO RAL: NO UGS: YES	AL
R. ROPT - OFFICES		DESCRIPTION		LOAD	BRE	AKER	I I	BRE	KER	LOAD	DESCRIP	ΓΙΟΝ	CK
3		RCPT - OFFICES		· · ·						+	RCPT - DINING EXPANS	ION 1-1300	2
The content of the			,	-	4	1							
9 B - HEATED CABINET - SERVERY	5	*RCPT - PRT - SERVERY EXPAI	NSION B	180	20	1		1	20	1,800	*RCPT - POS - SERVER	Y EXPANSION B	. 6
11	7	*RCPT - PRT - SERVERY EXPAI	NSION B	180	20	1		1	20	540	*RCPT - SERVERY EXPA	NSION B 1-11	8
13 RCPT - SKILLET - KITCHEN EXPANSION 180 20	9	JB - HEATED CABINET - SERVE	RY	1,705	20	2		1	20	540	*RCPT - KITCHEN 1-130	16	10
15 SHUNT TRIP 7 RCPT - VOVEN - KITCHEN EXPANSION	11							1	20	1,920	*RCPT - HEATED CABIN	ET - KITCHEN	12
17 RCPT - OVEN - KITCHEN EXPANSION 1,176 20 1	13		PANSION	180	20	1		•	20	150		KPANSION 1-1306	
19 SHUNT TRIP						-							16
21 ROPT - OVEN - KITCHEN EXPANSION			NSION	1,176	_	•				<u> </u>		N EXPANSION	18
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27 SHUNT TRIP						-						1 1 1 1 1 1 1 1 1 1 1 1 1 1 1 1 1 1 1	24
29 *RCPT - KITCHEN EXPANSION 1-1306 540 20 1 1 20				,	_	-				· ·		ANSION 1-1306	26
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36 SPARE								•				1 1-1302	34
37 SPARE			31011	,									36
39 SPARE													38
1													40
SPARE						•							42
## SPARE						•							44
Apare						1							46
SPARE													48
SPARE	49	SPARE			20	1		1	20		SPARE		50
SPARE	51					1		1					52
57 SPARE								1					54
SPARE													56
61 SPARE 20 1													58
63 SPARE													60
65 SPARE 20 1						•							62
67 SPARE 20 1 1 20 SPARE 69 SPARE 20 1 1 20 SPARE 71 SPARE 20 1 1 20 SPARE 73 SPARE 20 1 1 20 SPARE 75 SPARE 20 1 1 20 SPARE 77 SPARE 20 1 1 20 SPARE 77 SPARE 20 1 1 20 SPARE 77 SPARE 20 1 1 20 SPARE 79 LOAD CENTER #41 - SERVERY 13,776 125 3 1 20 SPARE 83 1 1 20 SPARE 87 A / 112 A / 111 A													64 66
69 SPARE 20 1													68
Total Estimated Demand: Total Estimated						•							70
Total Estimated Demand: Total Estimated													72
Total Estimated Demand: Total Estimated Demand: Total Estimated Demand: Total Estimated Demand: 33.2 Total Estimated Dem								•					74
TOTAL ESTIMATED DEMAND TOTAL ESTIMATED DEMAND 33.2 TOT						1							76
81		SPARE				1		_ 1	20				78
SPARE	79	LOAD CENTER #41 - SERVERY		13,776	125	3		1					80
R7 A / 112 A / 111 A													82
LOAD CLASSIFICATION CONNECTED LOAD (VA) ESTIMATED DEMAND (VA) PANEL TOTALS KTCH 9,187 5,972 kVA MISC 18,971 18,971 RCPT 8,280 8,280 TOTAL CONNECTED LOAD: 36.4 TOTAL ESTIMATED DEMAND: 33.2	83	<u> </u>						•	20		SPARE		84
KTCH 9,187 5,972 kVA MISC 18,971 18,971 RCPT 8,280 8,280 TOTAL CONNECTED LOAD: 36.4 TOTAL ESTIMATED DEMAND: 33.2					1								
KTCH 9,187 5,972 kVA MISC 18,971 18,971 RCPT 8,280 8,280 TOTAL CONNECTED LOAD: 36.4 TOTAL ESTIMATED DEMAND: 33.2		LOAD CLASSIFICATION	CONNEC	TED LOA	D (VA)	ESTIN		EMAND)		PANEL TOTAL	S	
MISC 18,971 18,971 RCPT 8,280 8,280 TOTAL CONNECTED LOAD: 36.4 TOTAL ESTIMATED DEMAND: 33.2		KTCH		9,187								kVA A	MPS
RCPT 8,280 8,280 TOTAL CONNECTED LOAD: 36.4 TOTAL ESTIMATED DEMAND: 33.2		MISC		18.971			18.971						
TOTAL ESTIMATED DEMAND: 33.2							· · · · · · · · · · · · · · · · · · ·						
TOTAL ESTIMATED DEMAND: 33.2													
										TO	TAL CONNECTED LOAD:	36.4	101.1
										TOTA	L ESTIMATED DEMAND:	33.2	92.2
NOTES: *INDICATES GFCI BREAKER	NC	TES: *INDICATES GFCI BREAK	ĖR						1				

E	(IST: M1NHK LOCATION: ELEC 1-ME MAIN BUS: 225 A MCB: N/A VOLTAGE: 480/277 WY AIC AVAILABLE: 1800 A AIC RATING: 14000 A		NUMBE	ENC B MC	LOSUR US TYP DUNTING EL LUG	S: 4W E: NEM E: COF G: SUF S: MLC	+ G //A 1 PPER RFACE		NEUTRAL B GROUND B ISOLATED GROUND B 200% NEUTR FEED THROUGH LU POLES PER SECTI	US: YES US: YES US: NO AL: NO GS: NO	RMAL
CKT NO.	DESCRIPTION	TOTAL LOAD (VA)	BRE	CUIT AKER POLES	АВС	BRE	RCUIT EAKER LES /	TOTAL LOAD (VA)	DESCRIPTI	ON	CKT NO.
1	*DISHWASHER - WAREWASH		125	3		1	20		EXISTING LOAD		2
3		11-1312 73,234				1	20		EXISTING LOAD		4
5						1	20		EXISTING LOAD		6
7	SPARE		20	1		1	20		EXISTING LOAD		8
9	SPARE		20	1		1	20		SPARE		10
11	SPARE		20	1		1	20		SPARE		12
13	SPARE		50	3		1	20		SPARE		14
15						1	20		SPARE		16
17						1	20		SPARE		18
19	SPARE		30	3		1	20		SPARE		20
21						1	20		SPARE		22
23						1	20		SPARE		24
 25	SPARE		20	2		1	20		SPARE		26
 27						1	20		SPARE		28
29	SPARE		20	1		1	20		SPARE		30
31	SPARE		20	1		1	20		SPARE		32
33	SPARE		20	1		1	20		SPARE		34
35	SPARE		20	1		1	20		SPARE		36
37	SPARE		20	1		1	20		SPARE		38
39	SPARE		20	1		1	20		SPARE		40
41	SPARE		20	1		1	20		SPARE		42
				91 A	/ 91 A /	91 A					
	LOAD CLASSIFICATION	CONNECTED LOA	D (VA)	ESTIN	IATED (VA)		D		PANEL TOTALS	}	
	MISC	75,234			75,234	4				kVA	AMPS
		,						EXIST	NG CONNECTED LOAD:	64.8	77.9
									/ED CONNECTED LOAD:	57.6	69.3
									DED CONNECTED LOAD:	75.2	90.5
									TAL CONNECTED LOAD:	82.4	99.1
								TOTA	L ESTIMATED DEMAND:	82.4	99.1


N	LOCATION: ELEC 1-ME 1072 MAIN BUS: 225 A MCB: 150A VOLTAGE: 120/208 WYE AIC AVAILABLE: 2595 A AIC RATING: 10000 A	3		NUMBE	ENC B' MC PANI	ED FROM WIRES LOSURE US TYPE DUNTING EL LUGS ECTIONS	: 4W + : NEMA : COPP : SURF : MCB	G .1 ER		NEUTRAL B GROUND B ISOLATED GROUND B 200% NEUTR FEED THROUGH LU POLES PER SECTI	BUS: YES BUS: NO RAL: NO IGS: YES	NCY
CKT NO.	DESCRIPTION		TOTAL LOAD (VA)	1		АВС	CIRC BREA POLE	KER	TOTAL LOAD (VA)	DESCRIPT	ION	CKT NO.
1	RCPT - DIRECTOR OFFICE 1-1304	4	540	20	1		1	20	1,080	RCPT - OFFICE 1-1305		2
3	JB - EVAP - WALK IN FREEZER		216	20	1		1	20	1,200	JB - LIGHTS - WALK IN FF	REEZER	4
5	JB - LIGHTS - WALK IN FREEZER		1,200	20	1		1	20	1,200	JB - LIGHTS - WALK IN C	OOLER	6
7	JB - EVAP - WALK IN FREEZER		3,806	20	2		1	20	324	JB - EVAP - WALK IN CO	OLER	8
9							1	20	1,800	JB - HEAT TAPE- WALK II	N FREEZER	10
11	*RCPT - REF - SERVERY EXPANS	SION A	912	20	1		1	20	500	JB - VAV		12
3	*RCPT - REF - SERVERY EXPANS	SION A	900	20	1		2	20	2,895	*RCPT - REF CASE - SER	VERY	14
5	ROLLING SHUTTER - DINING 1-13	300A	720	20	1							16
7	JBOX - FSD		500	20	1		1	20	912	RCPT - REF - MICRO MAR	RKET 1-1302	18
9	KEF-3		1,176	20	1		1	20	912	RCPT - REF - MICRO MAR	RKET 1-1302	20
1	RCPT - ROOF CONV		360	20	1		1	20	912	RCPT - REF - MICRO MAI		22
3	RTU-3 CONTROLS		0	20	1		1	20		SPARE		24
<u>-</u> 5	SPARE			20	1		1	20		SPARE		26
7	SPARE			20	1		1	20		SPARE		28
9	SPARE			20	1		1	20		SPARE		30
1	SPARE			20	1		1	20		SPARE		32
3	SPARE			20	1		1	20		SPARE		34
	SPARE			20	1		1	20		SPARE		36
7	SPARE			20	1		3	70	19.000	JB - REF RACK		38
<u>′</u> 9	SPARE			20	1			70		3B - IVEL TVACIO		40
1	SPARE			20	1							40
	SFAILL				•	/ 128 A /	96 A					42
	LOAD CLASSIFICATION	CONNECT	ED LOA	D (VA)		IATED DE (VA)				PANEL TOTALS	<u> </u>	
	KTCH		1,812			1,812					kVA	AMPS
	MISC		29,746			29,746						
	MTRS		1,896			•						
						2,190						
	RCPT		7,611			7,611						
									TO1	TAL CONNECTED LOAD:	41.1	114
									TOTA	L ESTIMATED DEMAND:	41.4	114.8
NC	OTES: *INDICATES GFCI BREAKER	₹										

F)	KIST: M1NLK					-D		DN:: 4			NORM	ΔΙ
L /		070			FE	ED FROM				NEUTDAL D		
	LOCATION: ELEC 1-ME1	072			ENO		5: 4W +			NEUTRAL B		
	MAIN BUS: 225 A					LOSURE				GROUND B		
	MCB: N/A	_				US TYPE				ISOLATED GROUND B		
	VOLTAGE: 120/208 WYI	=				OUNTING EL LUGS				200% NEUTR	_	
	AIC AVAILABLE: 5580 A			NII IMPE						FEED THROUGH LU		
	AIC RATING: 10000 A			NUMBE	K OF S	ECTIONS	5 . Z			POLES PER SECTI	ON: 42	
			TOTAL	CIR	CUIT		CIR	CUIT	TOTAL			\top
CKT	DESCRIPTION		LOAD		AKER	АВС	BRE	AKER	LOAD	DESCRIPT	ION	
NO.			(VA)	AMPS /	POLES		POL	ES /	(VA)			1
1	RCPT - CALL CENTER, DRY S		1,080	20	1		1	20	360	RCPT - CART STORAGE	1-1313	
3	*SINK HEATER - WAREWASH	1-1312	8,996	40	3		3	20	3,166	*TROUGHVEYOR- WARE	WASH 1-1312	
5										-		_
7												4
9	RCPT - OVEN - KITCHEN 1-13	06	6,000	30	2		1	20	756	RCPT - FRYER - KITCHE	N 1-1306	
11							1		4 000	SHUNT TRIP	N 4 4000	
13 15	SHUNT TRIP RCPT - GRIDDLE KITCHEN 1-	1206	180	20	1		1	20	1,080	RCPT - FRYER - KITCHE	N 1-13U6	
15 17	SHUNT TRIP	1300	180		1		1	20	1 020	SHUNT TRIP RCPT - EQUIP STAND - K	(ITCHEN 4 4200	_
17 19	*ROLL-IN CABINET - KITCHEN	1 1-130E	1,705	20	2		1		1,020	SHUNT TRIP	1-1306	<u> </u>
21		1-1300	1,705	20			2	20		*RCPT - DISH DISP -KITC	HFN 1-1306	+
23	*RCPT - DISH DISP -KITCHEN	1-1306	3,182	20	2				J, 10Z		711LI4 1-13UU	+
<u>25</u> 25		1-1000	3,162				1	20		SPARE		
27	*RCPT KITCHEN 1-1306		790	20	3		3	20	2,375	*DISPOSER - KITCHEN 1	I-1306	
29											. 1000	+
31												+
33	*RCPT - SLICER - KITCHEN 1	-1306	672	20	1		1	20	888	*RCPT - DROP IN COLD I	PAN - SERVERY.	
35	*SHIELD LTS - SERVERY 1-13	01B	1,200	20	1		1	20	1,008	*RCPT - DROP IN SOUP -	- SERVERY	
37	*RCPT - SERVERY 1-1301		540	20	1		1	20	1,800	*RCPT - TEA - SERVERY	1-1301	
39	*RCPT - DRINK DISP - SERVE	RY 1-1301	1,800	20	1		2	30	2,500	*RCPT - COFFEE - SERV	ERY 1-1301	
41	*RCPT - ICE - SERVERY 1-130	1	1,056	20	1					-		
43	*RCPT - SERVERY 1-1301		1,800	20	1		1	20		EXISTING LOAD		
45	*RCPT - SERVERY 1-1301		1,800	20	1		1	20		EXISTING LOAD		
47	RCPT - DINING 1-1300		720	20	1		1	20		EXISTING LOAD		
49	RCPT - DINING 1-1300		720	20	1		1	20		EXISTING LOAD		\perp
51	RCPT - DINING 1-1300		720	20	1		1	20		EXISTING LOAD		
53 55	RCPT - MW - DINING 1-1300 RCPT - MW - DINING 1-1300		1,608 1,608	20	1		1	20 20	180	SPARE EXISTING LOAD		
57	LGHT - KITCHEN 1-1306, SER	VERY 1-1301	844	20	1		1	20		EXISTING LOAD		
59	LGHT - DINING 1-1300	VEIXI I-1001	664	20	1		1	20		SPARE		+
61	SPARE			20	1		1	20		EXISTING LOAD		
63	SPARE			20	1		1	20		EXISTING LOAD		
65	SPARE			20	1		1	20		EXISTING LOAD		
67	SPARE			20	1		1	20		EXISTING LOAD		
69	EXISTING SHUNT TRIP				1		1	20		SPARE		
71	EXISTING HOOD LIGHTS		200	20	1		1	20		SPARE		
73	EXISTING SHUNT TRIP				1		1	20		SPARE		
75	EXISTING HEAT LAMP		300	20	1		1	20		SPARE		
77	SHUNT TRIP		1 900	20	1		1	20		SPARE		
79 81	HOOD LIGHTS EXISTING SHUNT TRIP		1,800	20 20	1		1	20 20		SPARE SPARE		
83	EXISTING SHOWL TRIP			20	1		1	20		SPARE		
50						/ 166 A /						
						MATED D)				
	LOAD CLASSIFICATION	CONNECT	TED LOA	D (VA)	· · · ·	(VA)				PANEL TOTALS	5	
	KTCH	2	22,838			14,845	;				kVA A	MP
	LGHT		1,508			1,885			EXISTI	NG CONNECTED LOAD:	55.3 1	153.
	MISC		16,418			16,418				ED CONNECTED LOAD:		122.
	RCPT		17,536			13,768				ED CONNECTED LOAD:		161.
	NOI I		17,000			13,700	•			TAL CONNECTED LOAD:		191. 192.
									IOIA	L ESTIMATED DEMAND:	58 1	160.


E)	(IST: M1ELK LOCATION: ELEC 1-ME1072			FE	ED FROM WIRES	l: M1DP s: 4W + 0			EM NEUTRAL B	IERGE US: YES	NCY
	MAIN BUS: 225 A MCB: N/A			В	LOSURE US TYPE	: COPP	ER		GROUND B ISOLATED GROUND B	US: NO	
	VOLTAGE : 120/208 WYE				DUNTING		ACE		200% NEUTR		
	AIC AVAILABLE: 4340 A AIC RATING: 10000 A		NUMBE		EL LUGS ECTIONS				FEED THROUGH LU POLES PER SECTI		
CKT NO.	DESCRIPTION	TOTAL LOAD (VA)	BRE	CUIT AKER POLES	АВС	CIRC BREA POLE	KER	TOTAL LOAD (VA)	DESCRIPTI	ION	C
	RCPT - CALL CENTER	1,080	20	1		1	20	1,020	*RCPT - REF - KITCHEN I	B 1-1306	
3	*RCPT - REF - KITCHEN B 1-1306	1,020	20	1		1	20	1,020	*RCPT - REF - KITCHEN I		
5	*RCPT - UCR - KITCHEN B 1-1306	960	20	1		1	20	912	*RCPT - REF - KITCHEN I	B 1-1306	
7	*ROLL IN FRZ - SERVERY 1-1301 *RCPT - ICE CREAM - SERVERY 1-1	1,705 301B 180	20 20	1		2	20	2,895	*RCPT - REF CASE - SER	VERY 1-1301	
11	SPARE		20	1		1	20	1,484	EXISTING LOAD		1
13	SPARE		15	3		1	20	977	LGHT - KITCHEN B 1-130	6	
15						1	20	382	LGHT - SERVERY 1-1301		
17						1	20	264	LGHT - DINING 1-1300		
19	SPARE		20	3		1	20	1,632	EXISTING LOAD		2
21						1	20	1,632	EXISTING LOAD		
23						1	20		SPARE		- :
	SPARE		20	1		1	20		SPARE		
	SPARE		20	1		1	20		SPARE		
	SPARE		20	1		1	20		SPARE		
	SPARE	400	20	1		1	20 20		SPARE		
	HOOD CONTROLS EXISTING LOAD	100 100	20	1		1	20		SPARE SPARE		
	HOOD CONTROLS	100	20	1		1	20		SPARE		
_	SPARE		20	1		1	20		SPARE		
	SPARE		20	1		1	20		SPARE		
	SPARE		20	1		1	20		SPARE		
	SPARE		20	1		1	20		SPARE		
	SPARE		20	1		1	20		SPARE		
49	SPARE		20	1		1	20		SPARE		
	SPARE		20	1		1	20		SPARE		
	SPARE		20	1		1	20		SPARE		
	SPARE		20	1		1	20		SPARE		
	SPARE		20	1		1	20		SPARE		
59	EXISTING SHUNT TRIP			1		1	20		SPARE		
61 63	EXISTING LOAD SPARE		20 20	1 1		1	20		SPARE SPARE		
	SPARE		20	1		1	20		SPARE		
	SPARE		20	1		1	20		SPARE		
83	SPARE		20	1 69 A	/ 51 A / 3	•	20		SPARE		{
	LOAD CLASSIFICATION CO	NNECTED LOA	D (VA)	ESTIN	IATED DI (VA)	EMAND			PANEL TOTALS	5	
	KTCH	6,637			4,314					kVA	AMPS
	LGHT	1,623			2,028			EXISTI	NG CONNECTED LOAD:	44.6	123.7
	MISC	300			300				ED CONNECTED LOAD:	43.7	121.4
	RCPT	8,903			8,903				DED CONNECTED LOAD:	17.5	48.5
	INOI ⁻ I	0,303			0,903				TAL CONNECTED LOAD:	18.3	
							1	101	AL CONNECTED LUAD:	10.3	50.8
								TAT:	L ESTIMATED DEMAND:	16.4	45.5


NOTES: EXISTING LOAD IS BASED ON 30 DAY METERING LOAD FROM 06/05/2024 - 07/05/2024 X 1.25.
*INDICATES GFCI BREAKER

M1NLKB	M1NHK	M1NLK
	M1ELKB	M1ELK

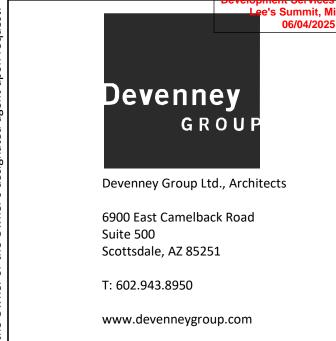

CONSTRUCTION
As Noted on Plans Review

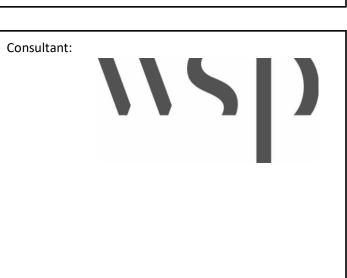

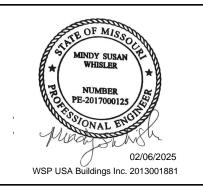

IF THESE PLANS DO NOT BEAR THE SEAL OF A REGISTRANT, THEY ARE TO BE CONSIDERED "PRELIMINARY" AND ARE NOT TO BE USED FOR CONSTRUCTION OR RECORDING. THESE PLANS ARE COPYRIGHTED AND ARE SUBJECT TO COPYRIGHT PROTECTION AS AN "ARCHITECTURAL WORK" UNDER SEC. 102 OF THE COPYRIGHT ACT, 17 U.S.O. AS AMENDED DECEMBER 1990 AND KNOWN AS ARCHITECTURAL WORK'S COPYRIGHT PROTECTION ACT OF 1990. THE PROTECTION INCLUDES BUT IS NOT LIMITED TO THE OVERALL FORM AS WELL AS THE ARRANGEMENT AND COMPOSITION OF SPACES AND ELEMENTS OF THE DESIGN. UNDER SUCH PROTECTION, UNAUTHORIZED USE OF THESE PLANS CAN LEGALLY RESULT IN THE CESSATION OF CONSTRUCTION OR BUILDINGS BEING SEIZED AND/OR MONETARY COMPENSATION TO DEVENNEY GROUP LTD.

INPATIENT BED EXPANSION

HCA - LEE'S SUMMIT MEDICAL CENTER 2100 SE BLUE PKWY LEE'S SUMMIT, MO 64063

AUTHORITY HAVING JURISDICTION:
CITY OF LEE'S SUMMIT BUILDING DEPT.
MISSOURI DHSS

AUTHORITY HAVING JURISDICTION'S PROJECT NO:

FACILITY NUMBER:
0972400009

AGENCY APPROVALS:

	REVISIONS	
REV#	DESCRIPTION	DATE
В	DESIGN COORDINATION	2025/02/06

DATE: 2024/12/ SCALE: DRAWN: Autl REVIEWED: Chec JOB NUMBER: 6406

SCHEDULES - ELECTRICAL

E08-04

1 DEMOLITION PLAN - LEVEL 01 - COMMUNICATIONS
1/8" = 1'-0"

GENERAL NOTES:

- BE PROTECTED IN PLACE AND REMAIN IN OPERATION THROUGHOUT DURATION OF ALL PROJECT
- B. INFORMATION PROVIDED ON THESE DRAWINGS HAVE BEEN TAKEN FROM DESIGN DRAWING AND
- AND COMMENCEMENT OF WORK. C. PROVIDE FOR ANY AND ALL DEMOLITION WORK NECESSARY TO ACCOMMODATE ALL NEW
- CONSTRUCTION, INCLUDING ARCHITECTURAL, MECHANICAL, PLUMBING AND/ OR ELECTRICAL WORK. D. WHERE EXISTING WALLS ARE BEING DEMOLISHED, REMOVE ALL EXISTING COMMUNICATIONS/ LOW VOLTAGE DEVICES AND THEIR ASSOCIATED CONDUITS, BACKBOXES AND CABLING BACK TO POINT OF ORIGINATION. EXISTING CABLING PASSING THROUGH DEMO AREA, NOT BEING DEMOLISHED, SHALL BE SUPPORTED UTILIZING J-HOOK CABLE SUPPORTS INSTALLED PER DIVISION 27 SPECIFICATIONS.
- VOLTAGE DEVICES (INCLUDING BUT NOT LIMITED TO VOICE, DATA, OVERHEAD PAGING, VIDEO SURVEILLANCE CAMERAS, PHYSIOLOGICAL MONITORING, TELEMETRY, NURSE CALL, SECURITY ACCESS CONTROL, ETC.) WITH ARCHITECTURAL DRAWINGS. F. CONTRACTOR IS RESPONSIBLE FOR RESTORATION OF DAMAGE TO FIREPROOFING, FINISHES OR STRUCTURE CAUSED BY TELECOM, LOW-VOLTAGE, OR SECURITY CONTRACTORS. RESTORATION

- 1. LOCATION OF EXISTING COMMUNICATIONS IDF ROOM CURRENTLY SERVIING AREA. CONTRACTOR SHALL COORDINATE WITH OWNER'S IT&S PERSONNEL TO CLEAN UP ROOM AND CLEAR UP ADDITIONAL SPACE FOR NEW DEVICE TERMINATIONS AND EQUIPMENT. ALL DEMOLISHED CABLING SHALL BE REMOVED TO POINT OF ORIGINATION.
- 2. DOCUMENT EXISTING LOCATIONS OF ALL CEILING DEVICES WITHIN THIS AREA. REMOVE, CLEAN, STORE AND PROTECT EXISTING CABLING IN PLACE. AFTER NEW CEILING HAS BEEN INSTALLED, CONTRACTOR SHALL REINSTALL EXISTING DEVICES INTO NEW CEILINGS AT PREVIOUSLY
- DOCUMENTED LOCATIONS. REPLACE DAMAGED DEVICES AND HARDWARE AS REQUIRED. 3. EXISTING WALL DEVICES SHALL BE REMOVED FROM WALLS AND CABLING PROTECTED IN PLACE TO WALLS AT PREVIOUS LOCATIONS. 4. EXISTING WALL MOUNTED DEVICES AND ASSOCIATED CABLING, CONDUIT AND BACKBOXES WITHIN
- JHOOK STYLE SUPPORTS INSTALLED PER DIVISION 27 SPECIFICATIONS. LOCATION. RELOCATE EXISTING TELEVISION COAX AND POWER AS REQUIRED. ADD AN ADDITIONAL

- A. ALL EXISTING DEVICES MAY NOT BE SHOWN ON PLAN. CONTRACTOR SHALL FIELD VERIFY EXISTING CONDITIONS AND COORDINATE WITH ARCHITECTURAL PLANS AND OTHER TRADES TO DETERMINE THE OUTCOME OF EACH DEVICE. WHERE NO CONSTRUCTION IS TO OCCUR, EXISTING DEVICES SHALL
- FIELD OBSERVATIONS. CONTRACTOR SHALL VERIFY ALL EXISTING CONDITIONS PRIOR TO PRICING
 - Scottsdale, AZ 85251 T: 602.943.8950
- www.devenneygroup.com E. CONTRACTOR SHALL COORDINATE THE REMOVAL OR RELOCATION OF ALL COMMUNICATIONS/ LOW
- SHALL BE RESTORED TO "SAME CONDITION" AS BEFORE DAMAGE OCCURED. CONTRACTOR SHALL OBTAIN WRITTEN ACCEPTANCE OF RESTORATION FROM OWNER. IF DEMOLITION IS REQUIRED TO INSTALL AN ITEM, THE CONTRACTOR SHALL RESTORE THE AREA TO PREVIOUS CONDITION, OR REPLACE DAMAGED ITEMS WITH NEW ITEMS TO MATCH EXISTING. G. WHERE AREAS BEING DEMOLISHED CONTAIN INFANT PROTECTION SYSTEM (IPS) DEVICES, CONTRACTOR SHALL DISABLE IPS EQUIPMENT AND PROVIDE INTERIM SYSTEM PROGRAMMING PRIOR

TO REMOVAL TO PREVENT FALSE ALARMING AND LOCKDOWN OF DEMOLITION AREA.



NETWORK OUTLET TO THIS LOCATION.

- ALLOW NEW WALL COVERING. CONTRACTOR SHALL PROVIDE NEW DEVICE PLATES AND REINSTALL TO
- WALL/AREA SHALL BE DEMOLISHED TO POINT OF ORIGINATION. EXISTING CABLING ROUTING THROUGH THIS AREA THAT IS NOT TO BE DEMOLISHED SHALL BE SUPPORTED BY JHOOK STYLE SUPPORTS INSTALLED PER DIVISION 27 SPECIFICATIONS. 5. EXISTING WALL MOUNTED AND CEILING DEVICES AND ASSOCIATED CABLING, CONDUIT AND
- BACKBOXES WITHIN WALL/AREA SHALL BE DEMOLISHED TO POINT OF ORIGINATION. EXISTING CABLING ROUTING THROUGH THIS AREA THAT IS NOT TO BE DEMOLISHED SHALL BE SUPPORTED BY 6. EXISTING TELEVISION OUTLET BOX SHALL BE REPLACED WITH NEW ARLINGTON AV BACKBOX AT THIS



Devenney

GROU

Devenney Group Ltd., Architects

6900 East Camelback Road

Suite 500

Consultant:

CONSTRUCTION As Noted on Plans Review

IF THESE PLANS DO NOT BEAR THE SEAL OF A REGISTRANT, THEY ARE TO BE CONSIDERED "PRELIMINARY" AND ARE NOT TO BE USED FOR CONSTRUCTION OR RECORDING. THESE PLANS ARE COPYRIGHTED AND ARE SUBJECT TO COPYRIGHT PROTECTION AS AN "ARCHITECTURAL WORK" UNDER SEC. 102 OF THE COPYRIGHT ACT, 17 U.S.O. AS AM "ARCHITECTURAL WORK" UNDER SEC. 102 OF THE COPYRIGHT

ACT, 17 U.S.O. AS AMENDED DECEMBER 1990 AND KNOWN AS ARCHITECTURAL

WORKS COPYRIGHT PROTECTION ACT OF 1990. THE PROTECTION INCLUDES BUT IS

NOT LIMITED TO THE OVERALL FORM AS WELL AS THE ARRANGEMENT AND

COMPOSITION OF SPACES AND ELEMENTS OF THE DESIGN. UNDER SUCH

PROTECTION, UNAUTHORIZED USE OF THESE PLANS CAN LEGALLY RESULT IN THE

COMPOSITION OF CONSTRUCTION OR BUILDINGS BEING SEIZED AND/OR MONETARY COMPENSATION TO DEVENNEY GROUP LTD.

INPATIENT BED EXPANSION

HCA - LEE'S SUMMIT MEDICAL CENTER 2100 SE BLUE PKWY LEE'S SUMMIT, MO 64063

AUTHORITY HAVING JURISDICTION: CITY OF LEE'S SUMMIT BUILDING DEPT. MISSOURI DHSS

AUTHORITY HAVING JURISDICTION'S PROJECT NO:

FACILITY NUMBER: 0972400009

AGENCY APPROVALS:

Έ
2/06

SCALE: 1/8" = 1'-0" 기 DRAWN: REVIEWED: 9 JOB NUMBER:

DEMOLITION PLAN - LEVEL 1 - SECTOR A - KITCHEN, SERVERY & DINING -COMMUNICATIONS

TD02-01

