



\*NO WORK ON RISER, NO CALCS NEEDED

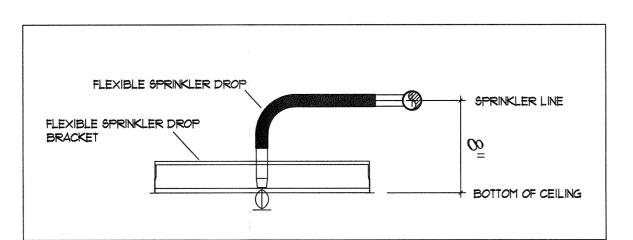

TYPICAL FLEXIBLE SPRINKLER DROP PIPING TO BE INSTALLED 8" ABOVE CEILING TO ALLOW FOR FLEXIBLE SPRINKLER DROP CONNECTIONS

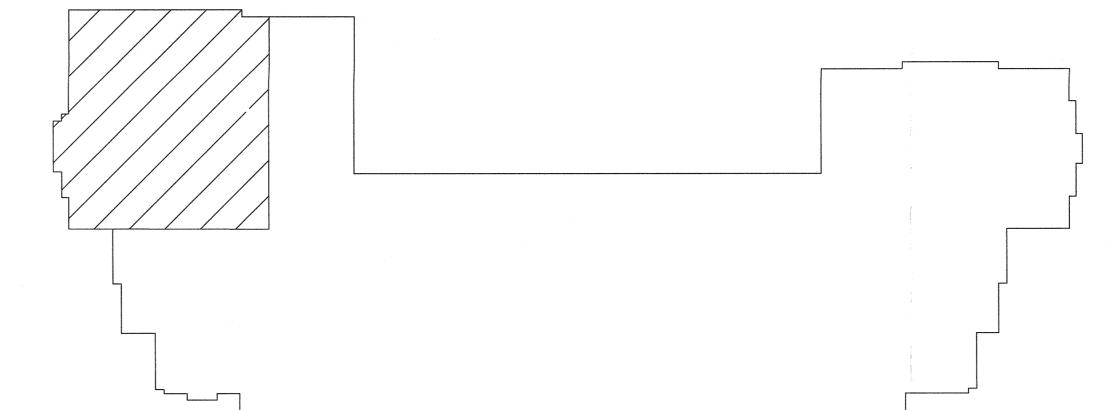


### RELEASED FOR CONSTRUCTION As Noted on Plan Review


**Lee's Summit Fire Department** Lee's Summit, Missouri 06/02/2025


# SITE PLAN = N.T.S.

## GENERAL NOTES

- 1. THE SYSTEM DESIGN CRITERIA COMPLIES WITH THE REQUIREMENTS OF NFPA 13 2016EDITION.
- 2. ALL PIPING SHALL CONFORM WITH THE REQUIREMENTS OF NFPA 13 2016 EDITION.
- 3. ALL FITTINGS SHALL CONFORM WITH THE REQUIREMENTS OF NFPA 13 2016 EDITION.
- 4. ALL HANGERS SHALL CONFORM TO THE REQUIREMENTS OF NFPA 13 2016 EDITION.
- 5. FITTINGS FOR 1" THRU 2" SHALL BE CAST IRON THREADED. FITTINGS FOR 2 1/2" THRU 4" PIPING ARE TO BE GROOVED
- 6. LENGTHS OF PIPING I" THRU 2" ARE SHOWN AS THREAD TO THREAD UNLESS NOTED AS: G- GROOVE OR C- CENTER. 2 1/2" THRU 4" PIPE LENGTHS ARE SHOWN AS CENTER TO CENTER UNLESS NOTED AS: G - GROOVE, W - WELD, F -FACE OR FLANGE OR T - THREAD.
- 1. ALL SECTIONS OF TRAPPED PIPING SHALL HAVE AUXILIARY DRAINS WHERE REQUIRED.
- 8. THE OWNER SHALL BE RESPONSIBLE FOR PROVIDING ADEQUATE HEAT TO PREVENT THE PIPING FROM FREEZING.
- 9. ALL SWITCHBOARDS, PANEL BOARDS, DISTRIBUTION BOARDS AND MOTOR CONTROL CENTERS SHALL BE PROTECTED FROM DAMAGE BY OTHERS.

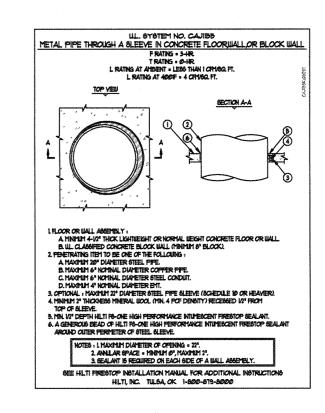

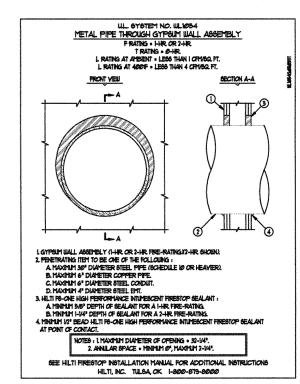

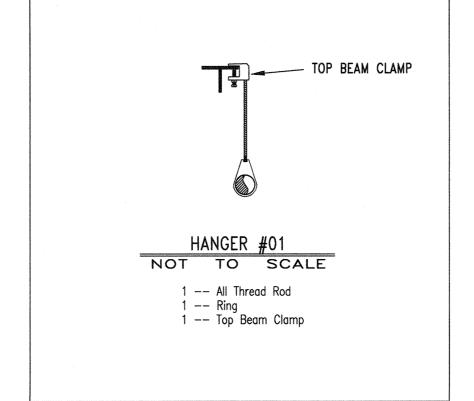

#### HANGER SPACING TABLE

HANGER SPACING FOR STEEL PIPE (SCH. 40)

HANGER SPACING

11/2" 4 LARGER 15'

4" & LARGER

HANGER SPACING FOR STEEL PIPE (THINWALL)



## FIRE SPRINKLER TENANT FINISH

KIDZ FIRST THERAPY LAKEWOOD BUSINESS PARK 2704 NE INDEPENDENCE AVE. LEE'S SUMMIT, MO 64046

FIRE PROTECTION SYSTEMS INC. "We are your Advantage" 404B N.W. 11th Street

Blue Springs, MO. 64015

Tel. (816) 224-3400

DRAWN BY DANIAL LOGSTON REVISION DATE DATE DRAWN 5-21-2025 CONTRACT NUMBER J-2472 DRAWING NUMBER l OF

REVIEWING AUTHORITY


LS FIRE DEPT

HEADS THIS SHEET

34

TOTAL HEADS FOR JOB 34

SCALE 1/8" = 1'-0"

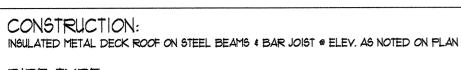

SCREWED 2" AND SMALLER TO BE SCH. 40 PIPE. WELDED 2" AND LARGER TO BE SCH. 10 PIPE.

DESIGN CRITERIA: PER NFPA \*13, LIGHT HAZARD, Ø.10 GPM/SQFT FOR 1500 SQFT. OPERATING MAX 225 SQFT/HEAD SPACING + 100 GPM FOR HOSE ALLOWANCE

-			
	DATE	REVISION	

Symbols

Symbol	Description	Symbol	Count	NPT	Orif.	Make	Model	Finish	Style	Temp.	K=	SIN
$\bigcirc$	Hydraulic Reference Points	•							EXISTING PENDENT TO REMAIN			
€=0′-0″	Elev. Below Top of Steel	•	20	1/2"	1/2"	YIKING	QR	CHROME	PENDENT	155'	56	VK3Ø21
EL=0'-0"	Elev. Above Finished Floor	•							EXISTING EC PENDENT TO REMAIN			
+ (TOS 0'-0"	Elev. of Top of Steel	0	14	3/4"	3/4"	VIKING	QR	CHROME	EC PENDENT	155'	11.2	VK608
Ø'-Ø"	Ceiling Height	-[							1" PLUG			
<del>/</del>	Denotes Hanger Location	0							EXISTING UPRIGHT TO REMAIN			
0	Rise up or down											
ALL PIPE CUTS ARE CENTER TO CENTER												

Sprinkler Head Summary

ASSUMES NO RESPONSIBILITY FOR UNAUTHORIZED USE OF THESE DRAWINGS. THE USE OF THIS DRAWING FOR STRUCTURAL OR ARCHITECTURAL PURPOSES IS NOT AUTHORIZED. THIS PRINT IS THE EXCLUSIVE DROPERTY OF. PROPERTY OF;

THIS DRAWING SHALL BE USED AS A CONSTRUCTION GUIDE ONLY.

NOTICE OF NONRESPONSIBILITY

ADVANTAGE FIRE PROTECTION SYSTEMS, INC.

SCALE 1/4"=1'-0"

ADVANTAGE FIRE PROTECTION SYSTEMS, INC