Greystone - Masterplan

LOT: 143 Hook Farms

ADDRESS: 2618 SW Firefly Lane, Lees Summit, MO



Sheet List				
Sheet Name				
Cover Sheet				
Front Elevations - W/ 3 Car Garage				
Side Elevations - Full Basement - Farmhouse				
Foundation Plan - Full Basement				
Floor Plan - Full Basement				
Floor Plan - Main Level				
Roof Plan - Farmhouse - Fully covered Patio/Deck				
Floor Plan - Structural POD Options 24" Extension				
Floor Plan - W/ 3 Car Garage - W/ Extended Pantry				
POD Options				
RCP/Electrical Plan				
Details				
Details				
Details				

Change/Revision Log:

. 1. Updated address on all pages.


Item #1: The 2x6 walls on main floor are changed to 2x4.


Item #3: Board and Batten returns corrected in elevation.

Item #2: LVLs added to support dropped floor for zero entry shower in primary bath.

May 19, 2025:


May 23, 2025:

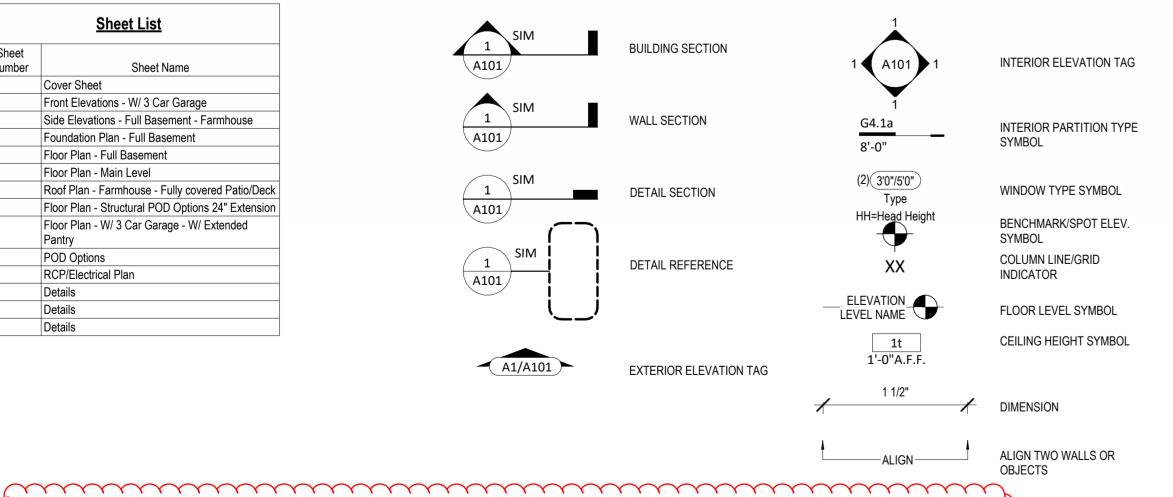

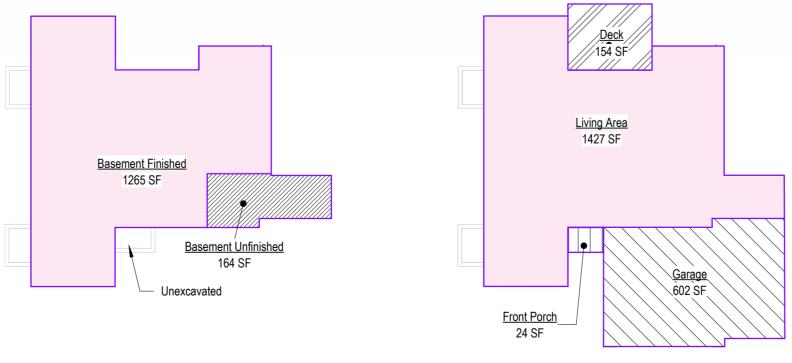

<u>Deck</u> /154 SF
<u>Living Area</u> 1427 SF
Garage 602 SF

11)-	Basement Area - W/ Extended pantry 1/16" = 1'-0"
	1/16" = 1'-0"

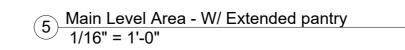

General Information

2018 Interior Energy Cons. C	ode (Table N1102.1.2)
Doors & Windows:	U-0.32 MAX
Glazing SHGF:	0.40
Skylights: Roof	U-0.55 MAX
Attic Ceilings:	R-49 MIN
Vaults:	R-38 MIN
Vaults < 500sf:	R-30 MIN
Wood Frame Walls:	R-20 or R-13 + 5 MIN
Basement Walls:	R-13 or R-10 Continuou
Floor (over unconditioned):	R-19 MIN
Slab on Grade:	R-10 for 24" MIN
Ductwork:	R-8 MIN
Fuel Fired Furnace:	
Electic Furnace:	No Minimum
Cooling System:	13 SEER MIN
Water Heater	
Gas Fired Storage:	0.67 EF MIN
Gas Fired Instant:	0.62 EF MIN
Electic Storage:	0.97 EF MIN
Electic Instant:	0.93 EF MIN

An energy efficient certificate is required to be

RC 2018	
Ground Snow Load:	20PSF
Vind Speed:	115mph
Topography Effects:	No
Seismic Design Category:	Α
Damage From Weather:	Severe
Frost Line Depth:	36 inches
Termite:	Moderate to Heav
Vinter Design Temperature:	6 F
ce Barrier Underlayment:	Yes
Flood Hazard:	
Air Freezing Index:	927 or less
Jean Annual Temperature:	55 5 E

is required for any dwelling with air infiltration at a rate of less than 5 air changes per hour (at ACH50 standard R303.4). 2. Carbon monoxide detectors required (R315)

1. Whole House Mechanical Ventilation System

- 3. Steel columns shall be minimum schedule 40
- 4. Deck Ledger attachment to house shall be per
- Tables 507.9.1.3. 5. New provisions for attachment of rafters,
- 6. Programmable thermostat required
- air leakage rate (N1103.2.2.1)
- 8. Building cavities used as return air plenums shall be sealed to prevent leakage across the thermal envelope. (N1103.2.3)
- 9. Certain hot water pipes shall be insulated (N1103.4)
- 10. All exhaust fans shall terminate to the building exterior (M1507.2)
- 11. Makeup air system required for kitchen exhaust hoods that exceed 400 CFM M1503.4 12. Building cavities in a thermal envelope wall (including the wall between the house and garage) shall not be used as return air
- plenums (unless the required insulation and air barrier are maintained) (M1601.1.1,#7.5) 13. An air handling system shall not serve both the living space and the garage (M1601.6)
- 14. A concrete-Encased grounding electrode ('UFER' Ground) connection complies with the requirments of the 2018 IRC Section E3608.1.2 in providing a connection with no
- less than the required minimum of steel. 15. Compliance with the requirments and show connection as needed for roof beam, trus, rafter, and girder connections for uplift per IRC
- 16. Garage Door Rating: DASMA 115 MPH Rated

Area - W/ Extended pantry & Living

Basement Unfinished


Front Porch

1265 SF 1427 SF

2692 SF

24 SF 602 SF


lasterplan Farms

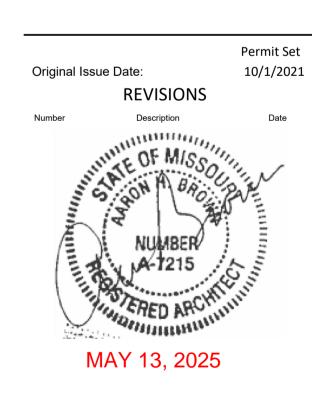


Permit Set


PLAN DESCRIPTION: Cover Sheet



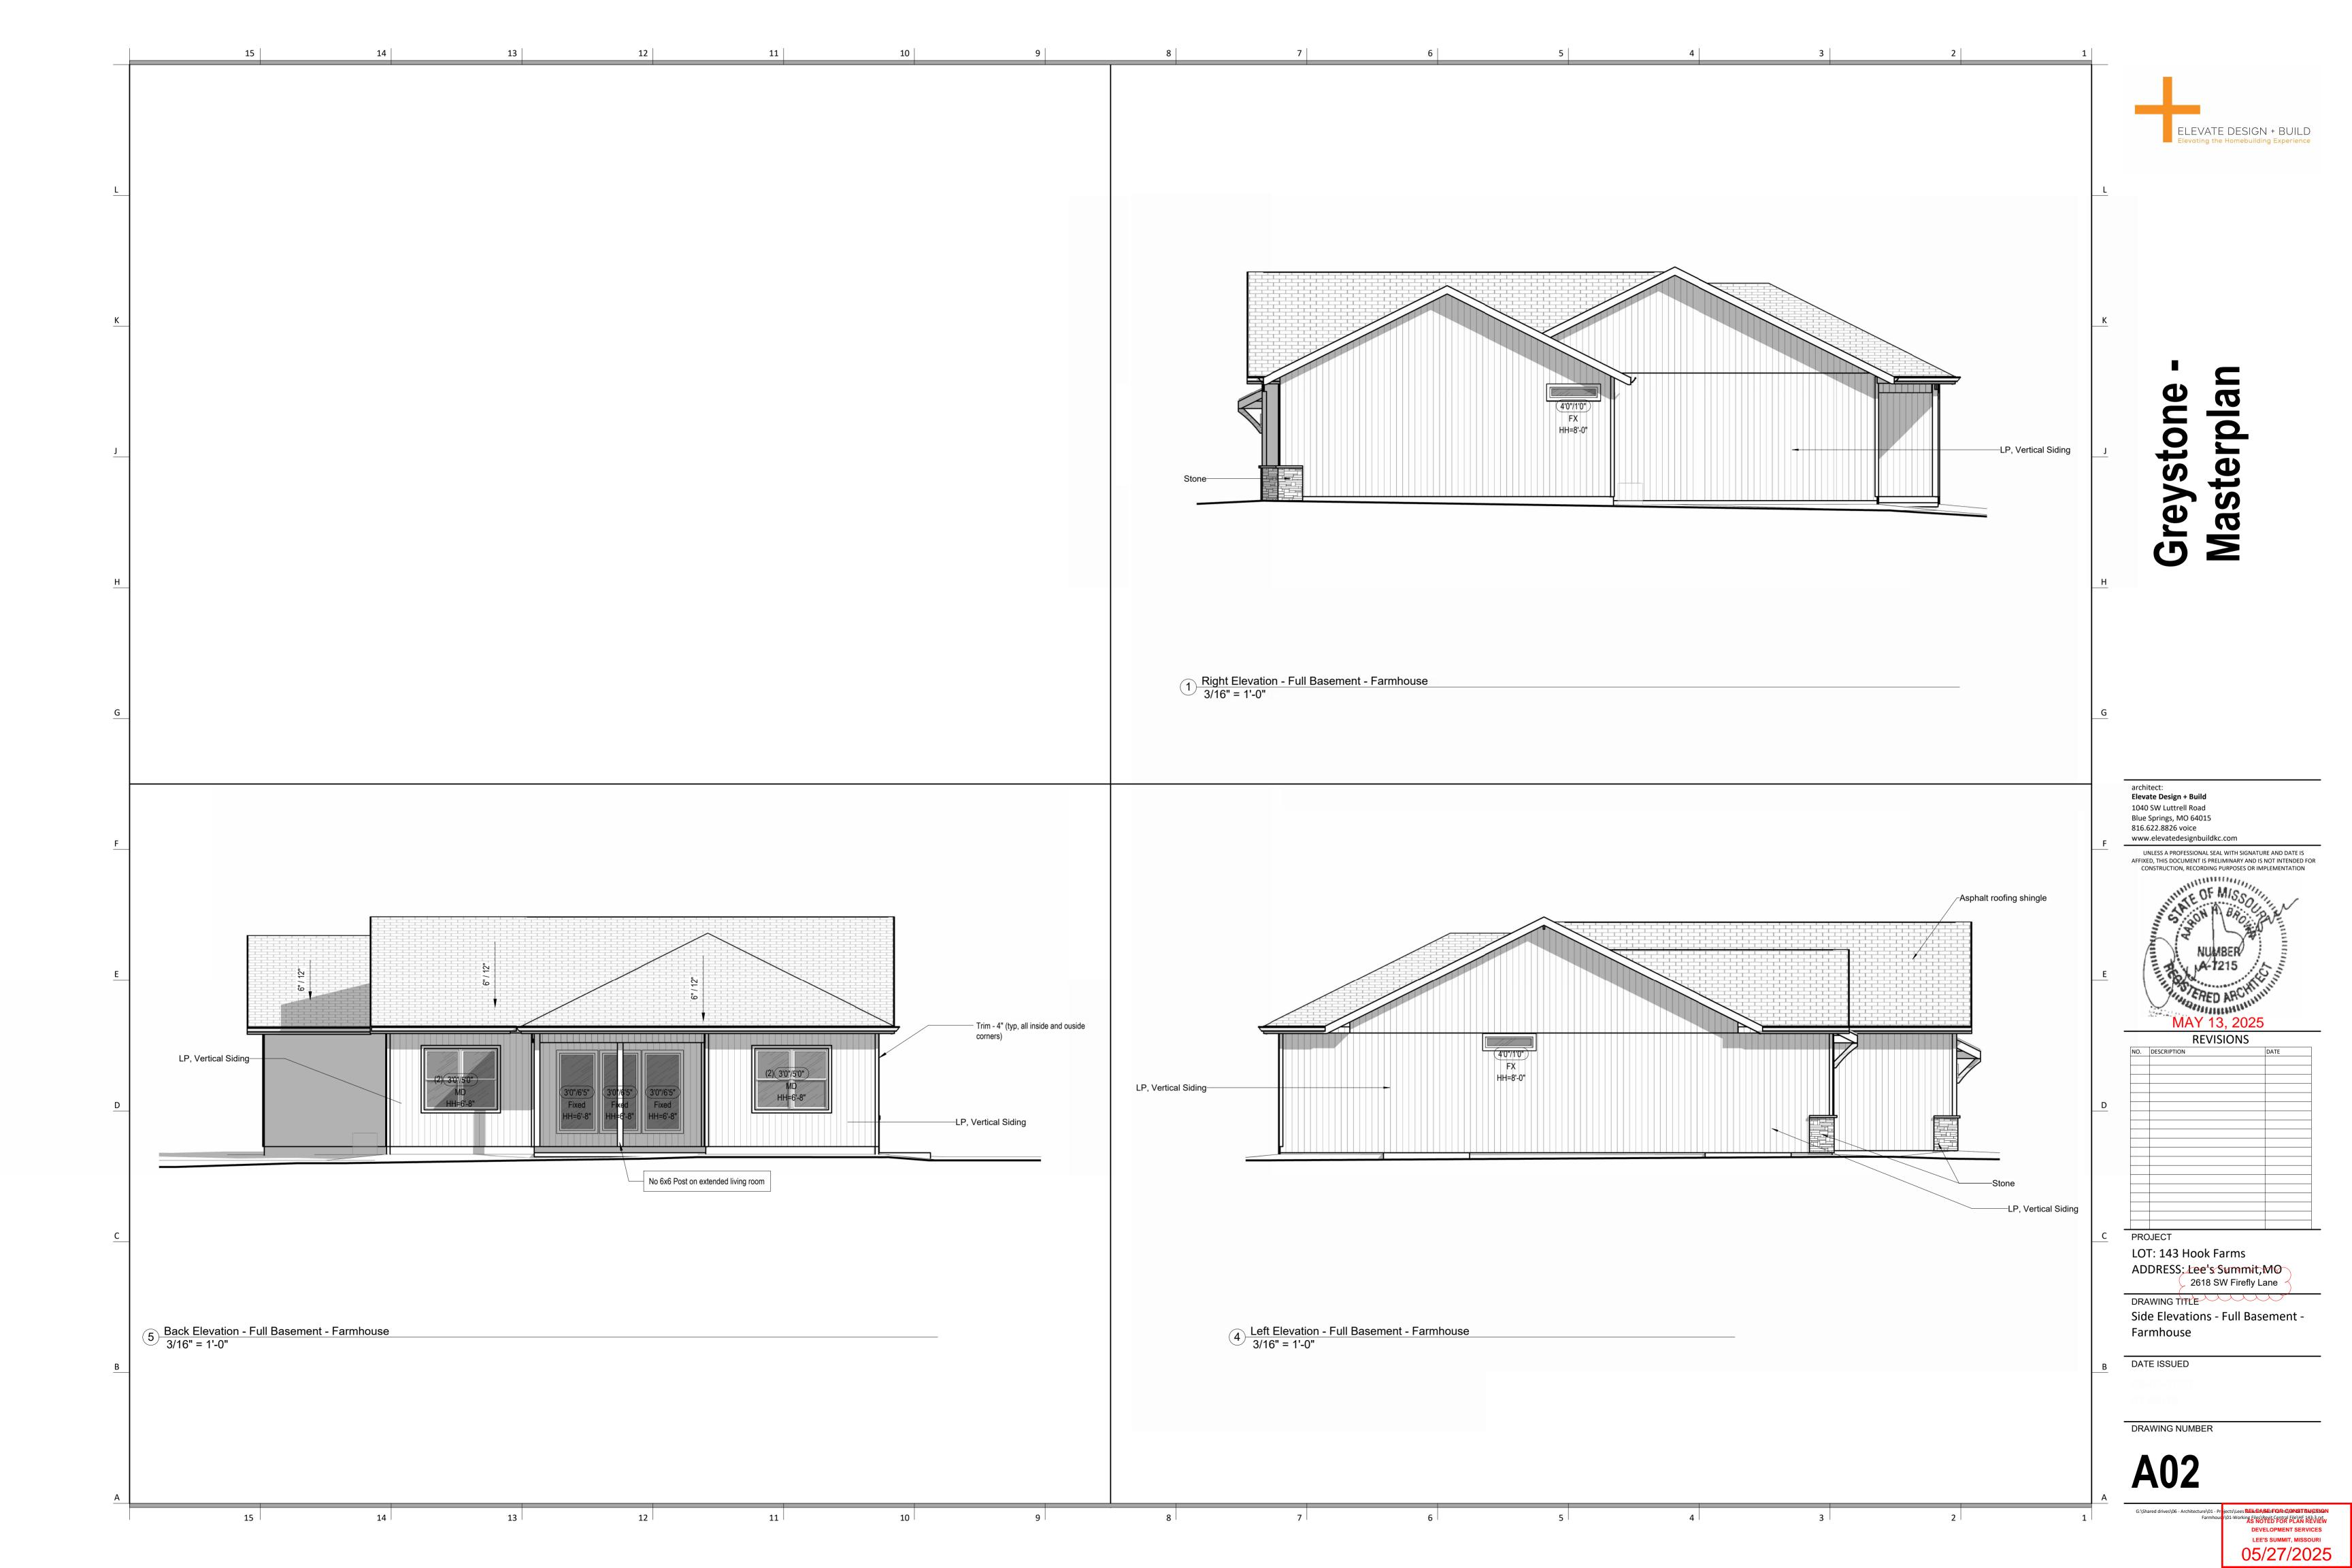


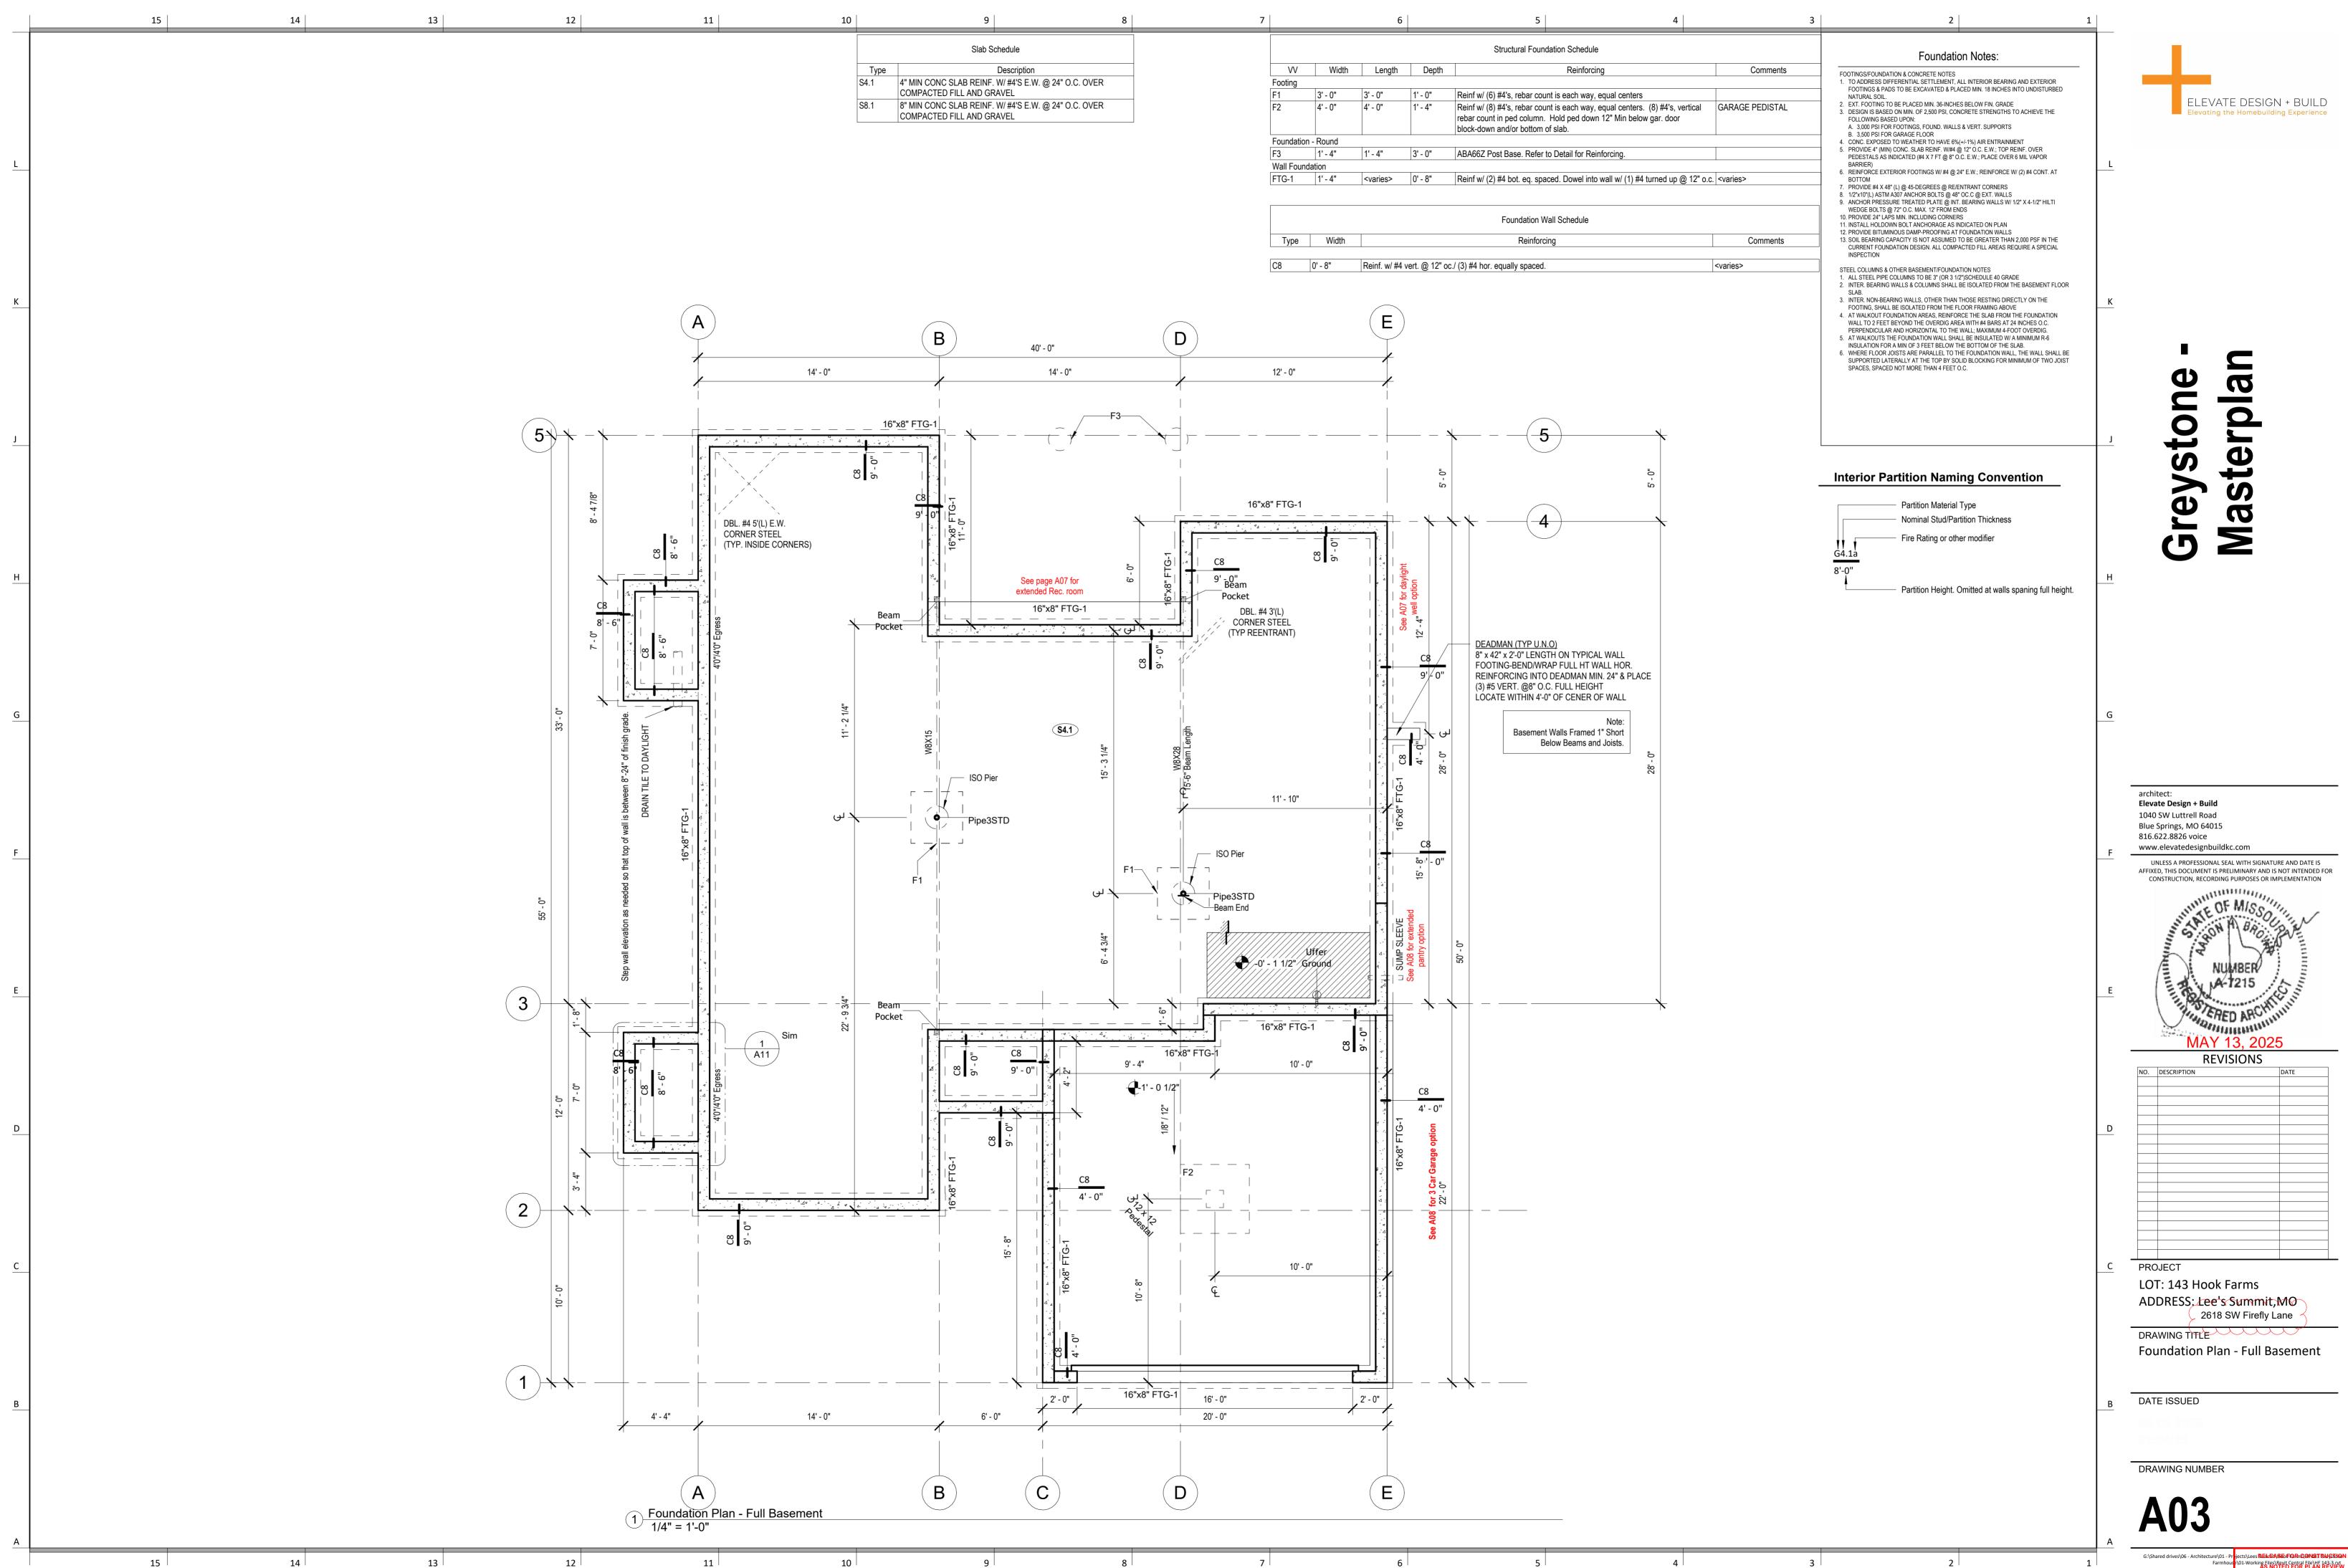


ture\01 - Pr jects\Lees BELEGASE FOR DE CANST BUGITION
Farmhouse\01-Working Files\Revit Central File\HF 143-3 ort
AS NOTED FOR PLAN REVIEW
DEVELOPMENT SERVICES
LEE'S SUMMIT, MISSOURI
05/27/2025

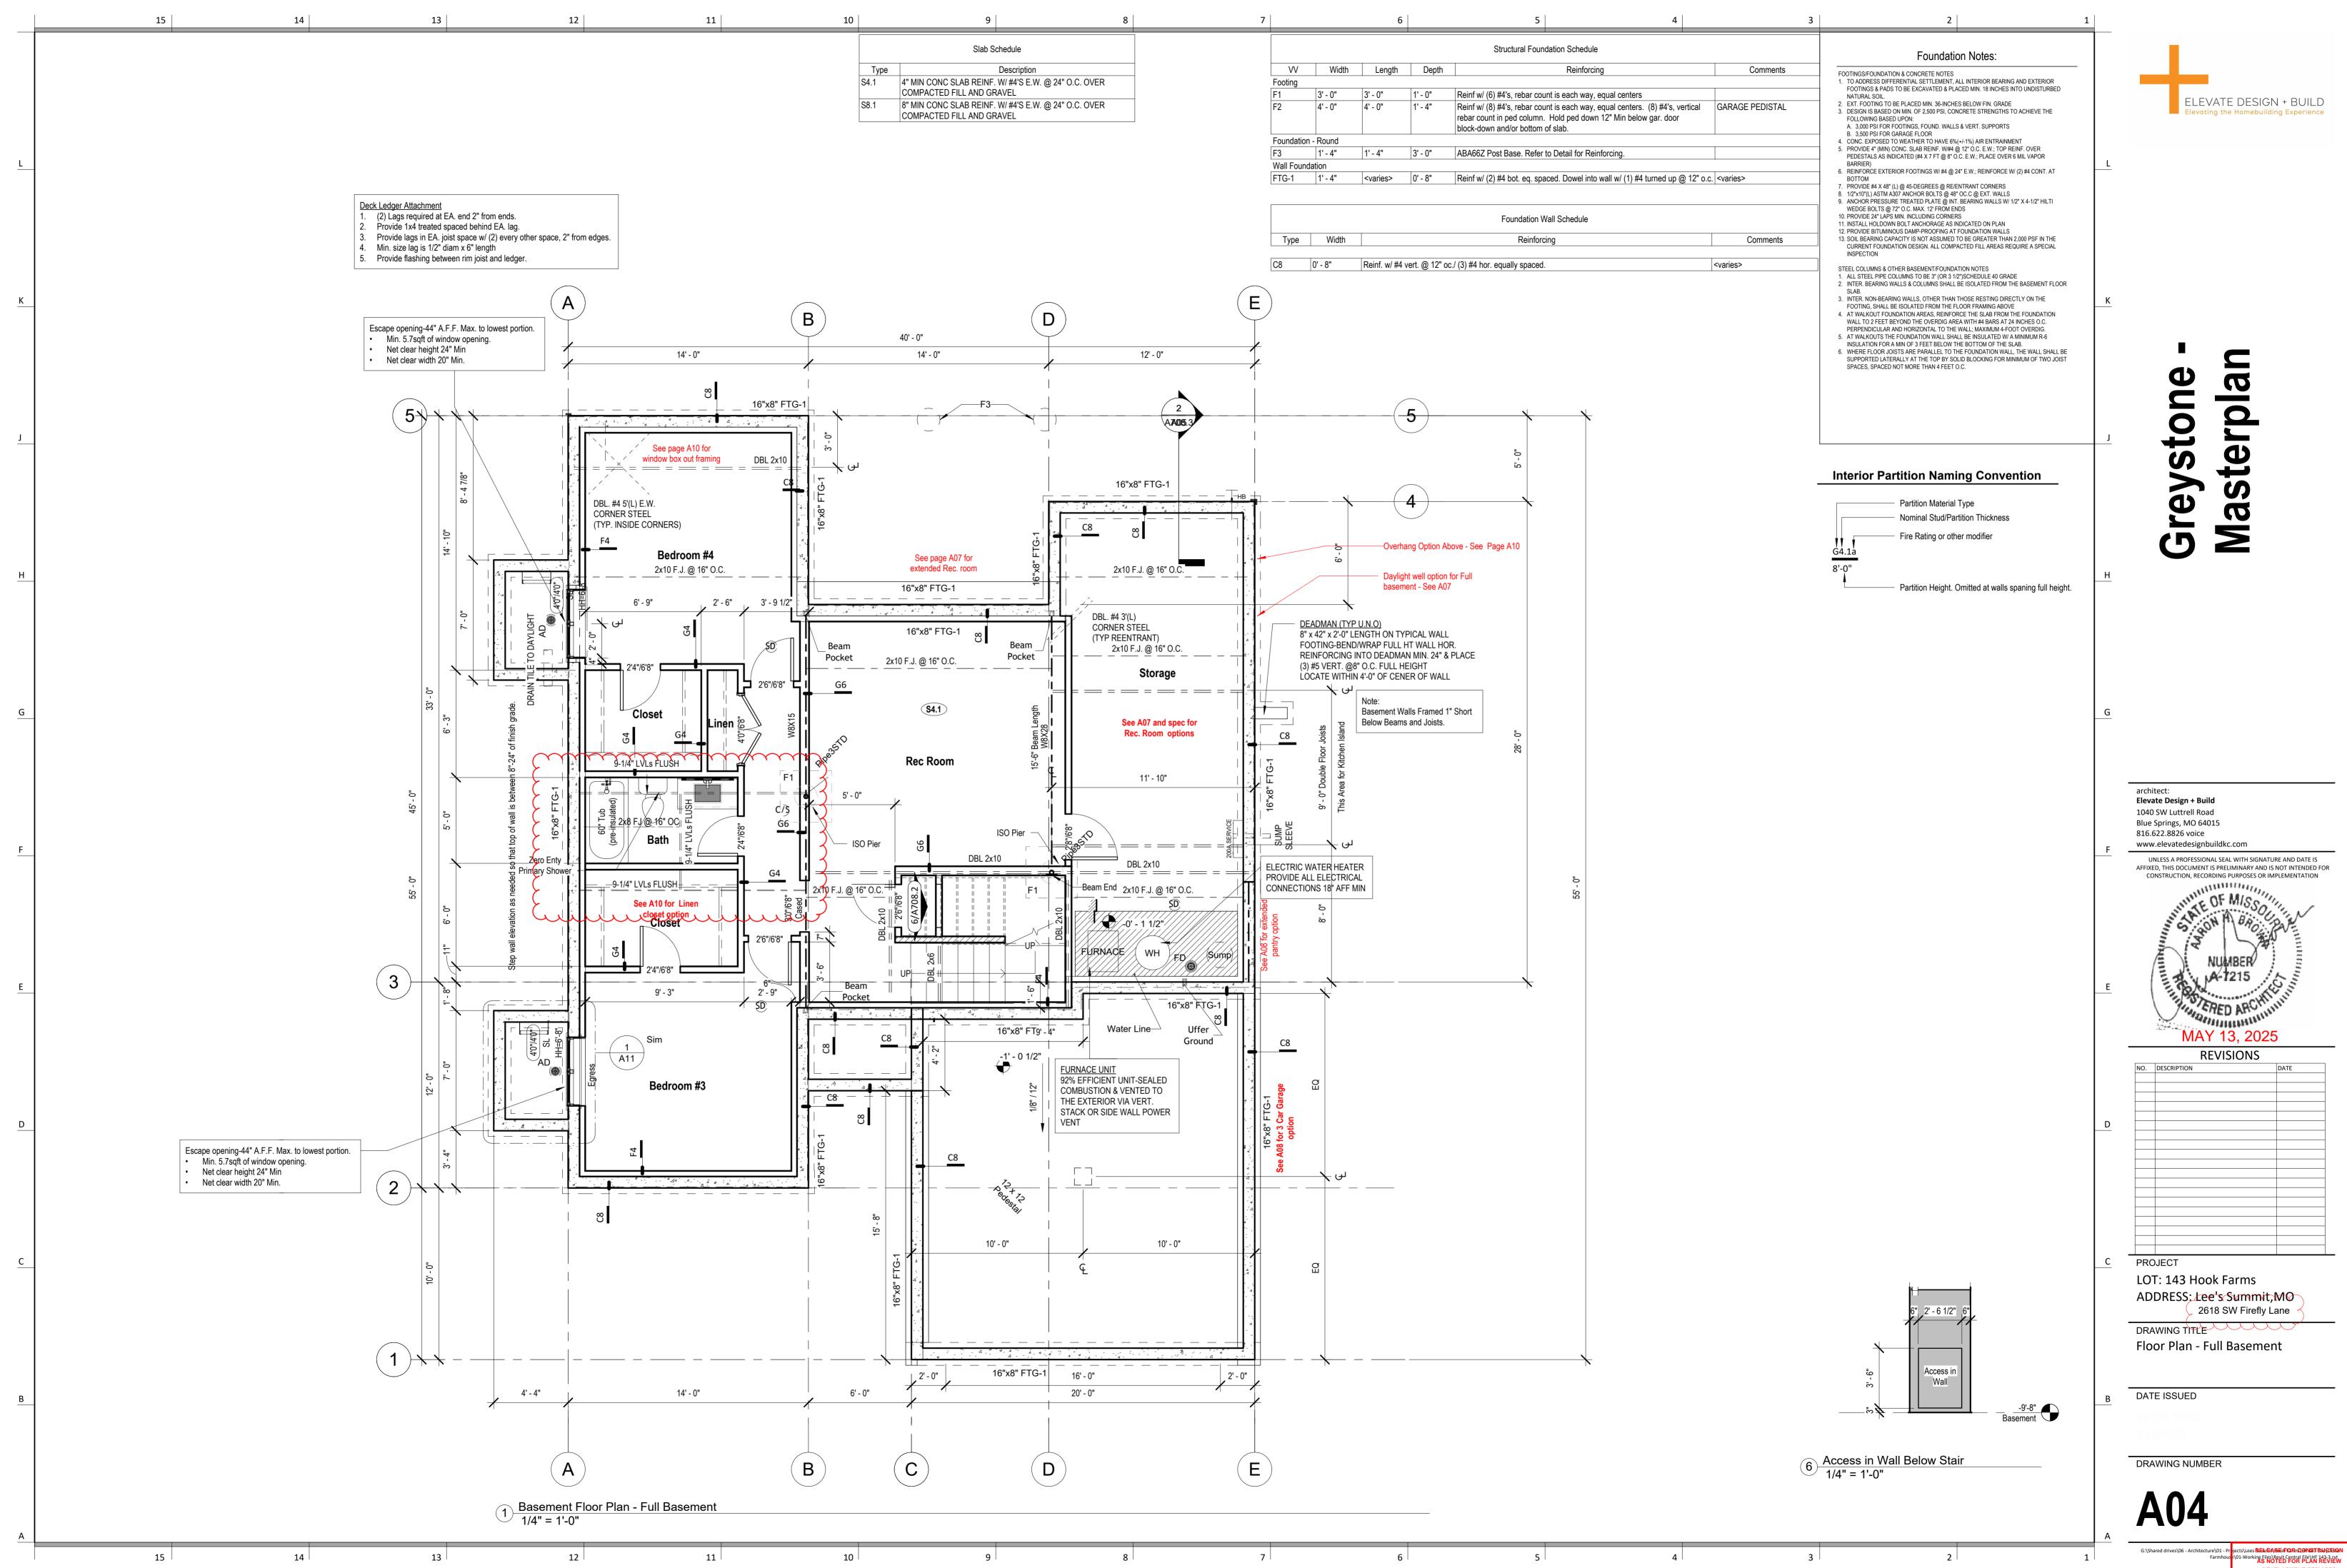



ces RELIDARIDICA ROBRET BIAGRICAN OFKING FIRE NEW ICENTRAL FIRE NEW ICENTRAL FIRE NEW ICES LEE'S SUMMIT, MISSOURI

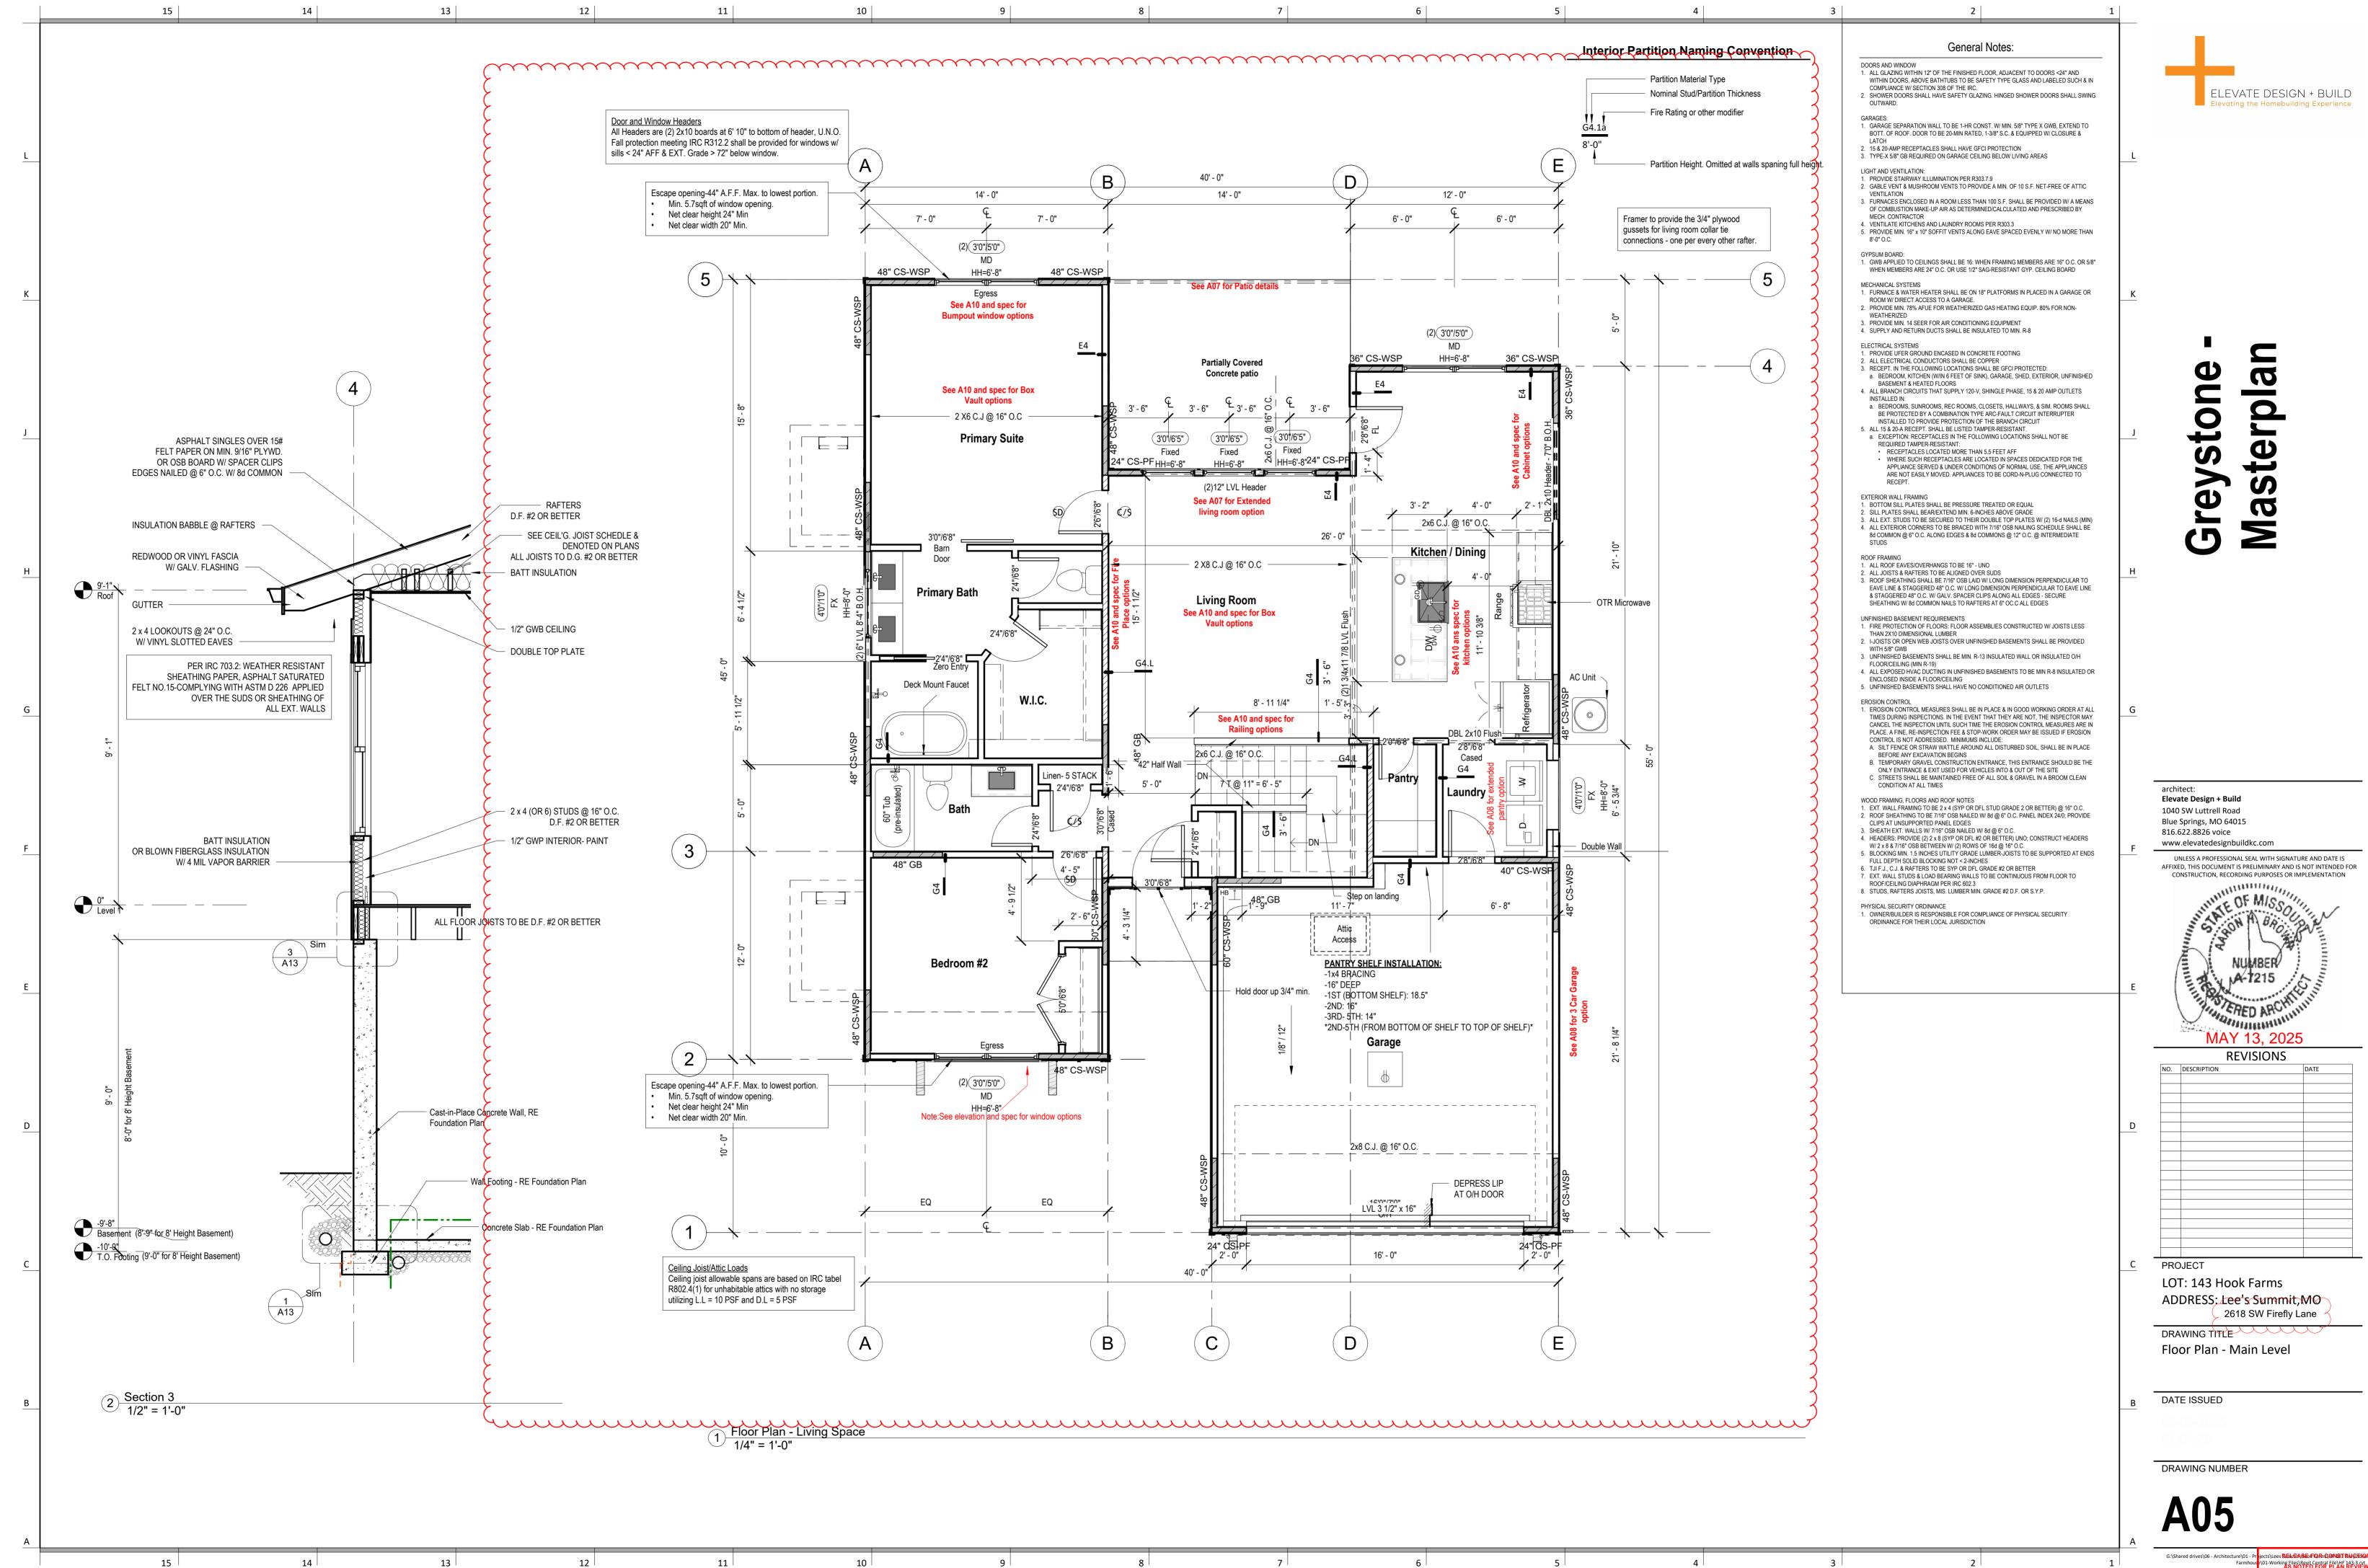


ture(01-Pr jects(Lees BELEEA & Eran Canas Trugettion Farmhouse (01-Working Files) Revit Central File/HF 143-3 M CAS NOTED FOR PLAN REVIEW DEVELOPMENT SERVICES LEE'S SUMMIT, MISSOURI 05/27/2025

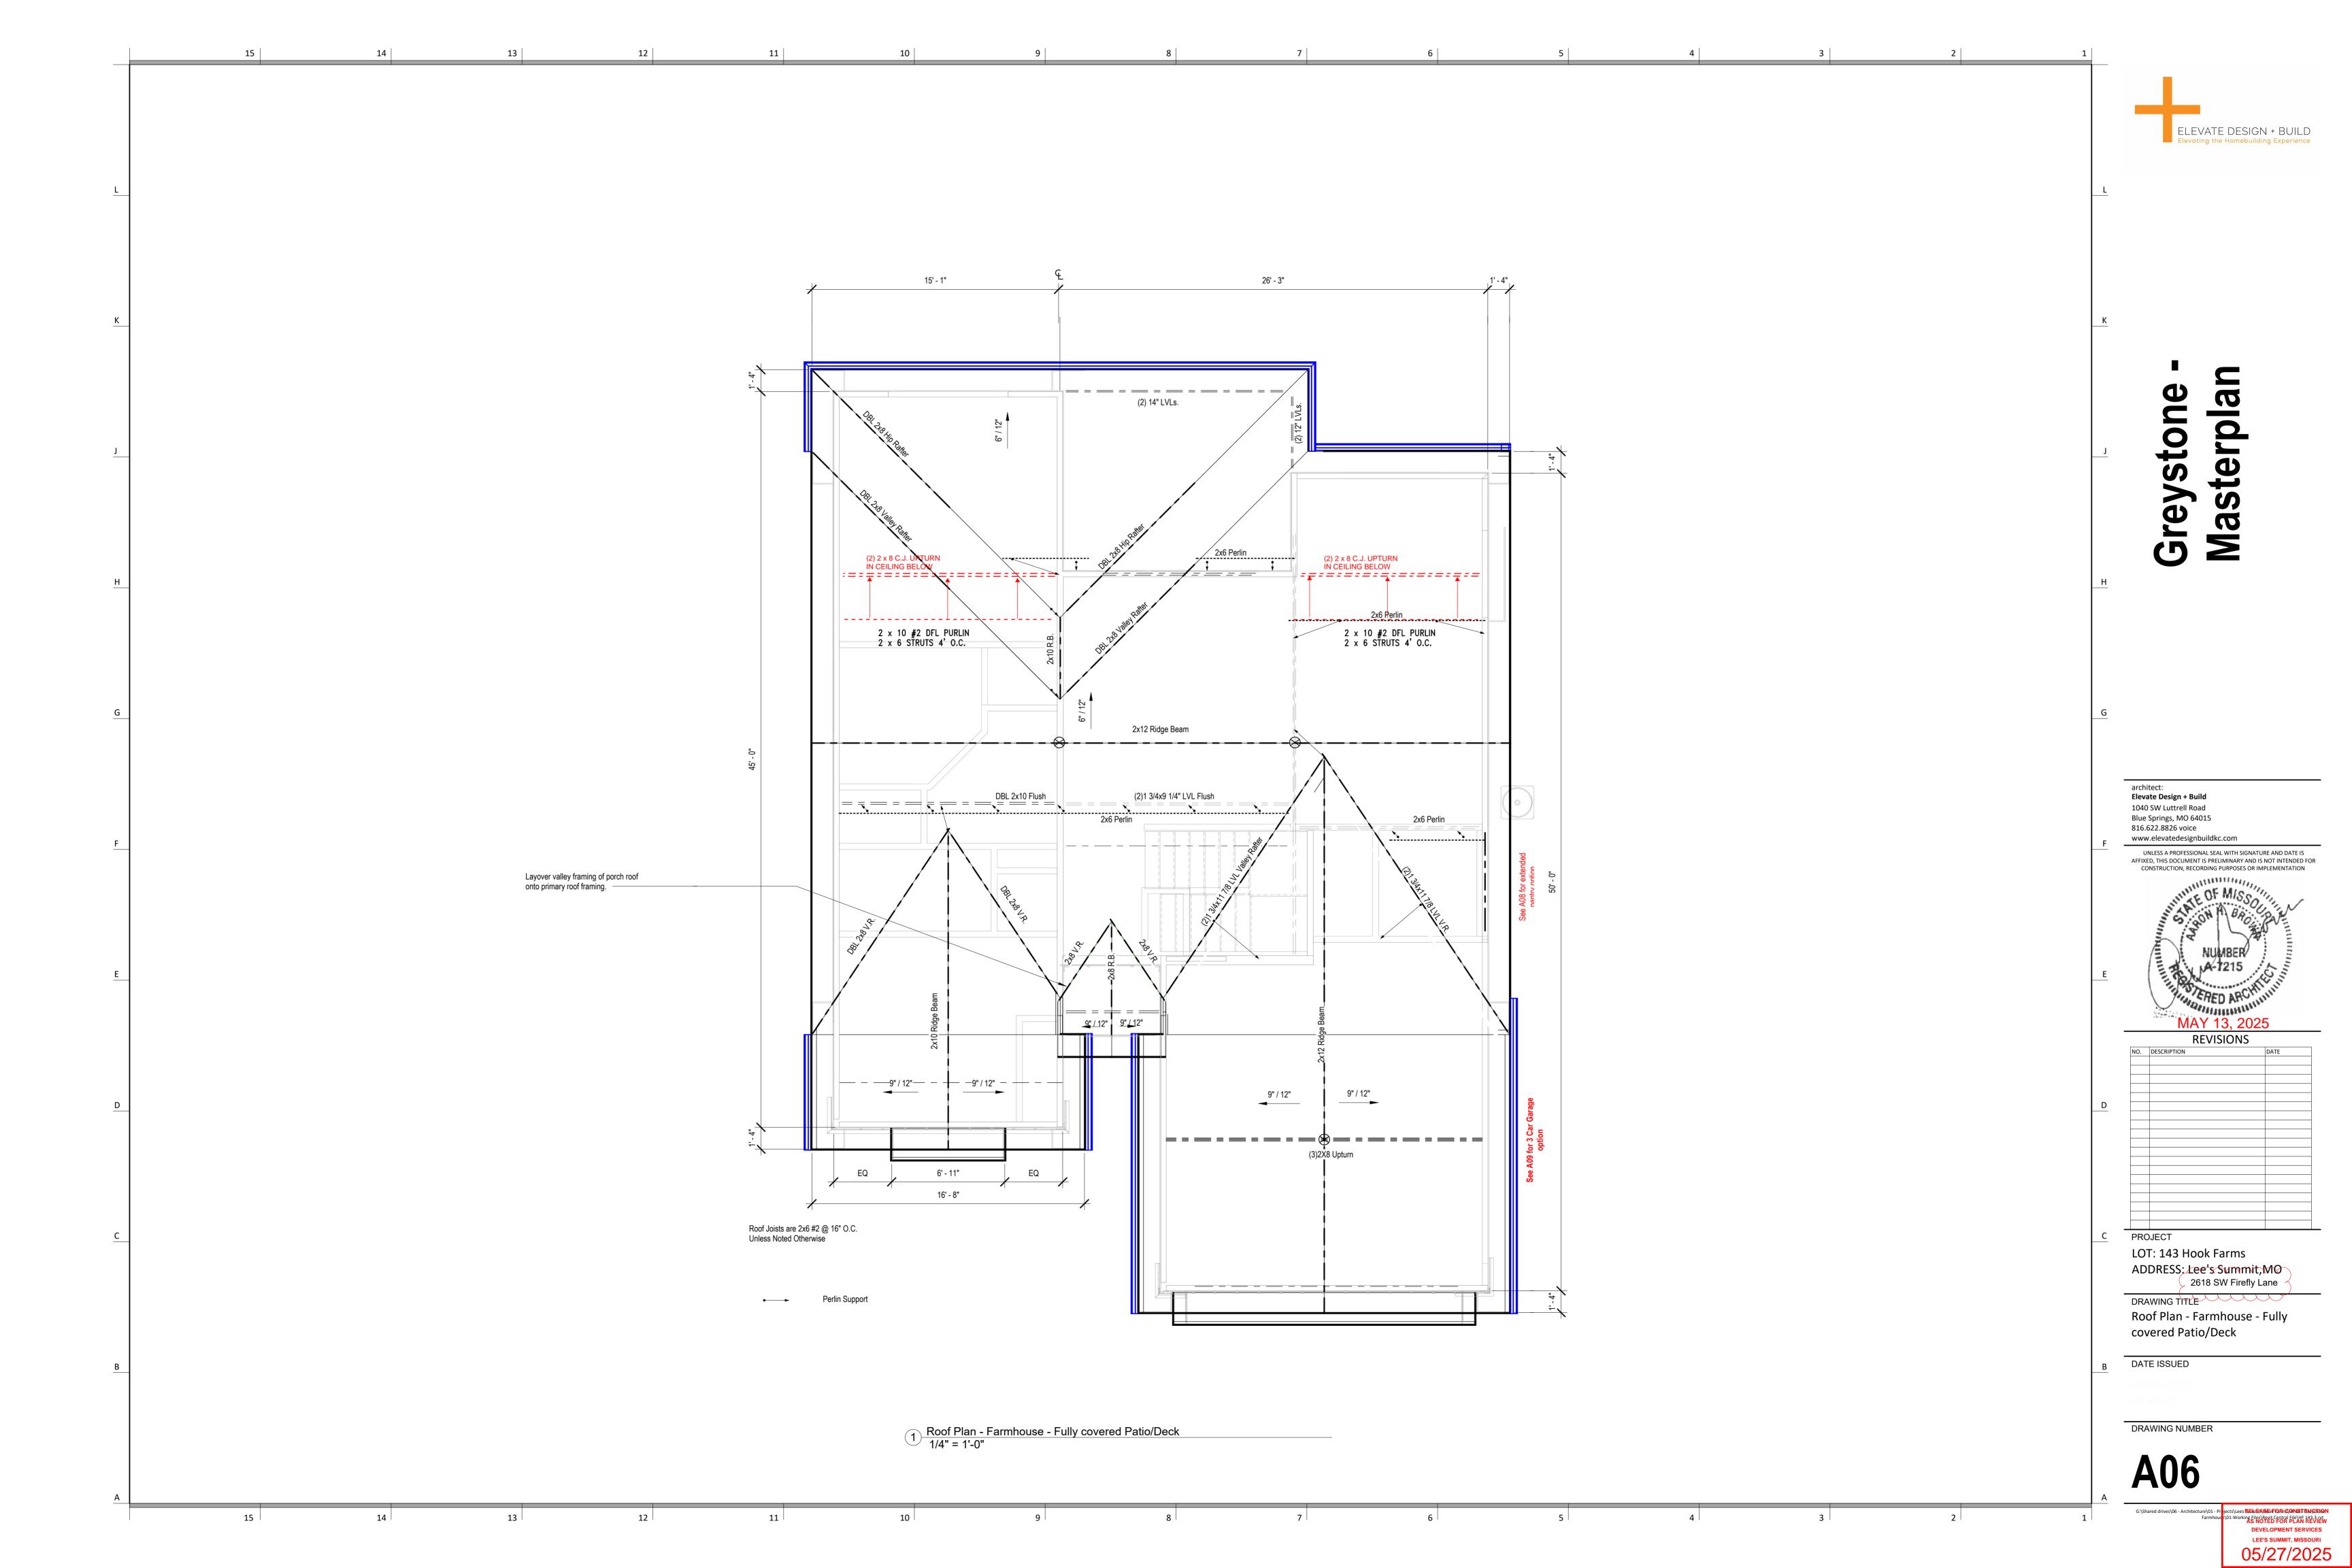


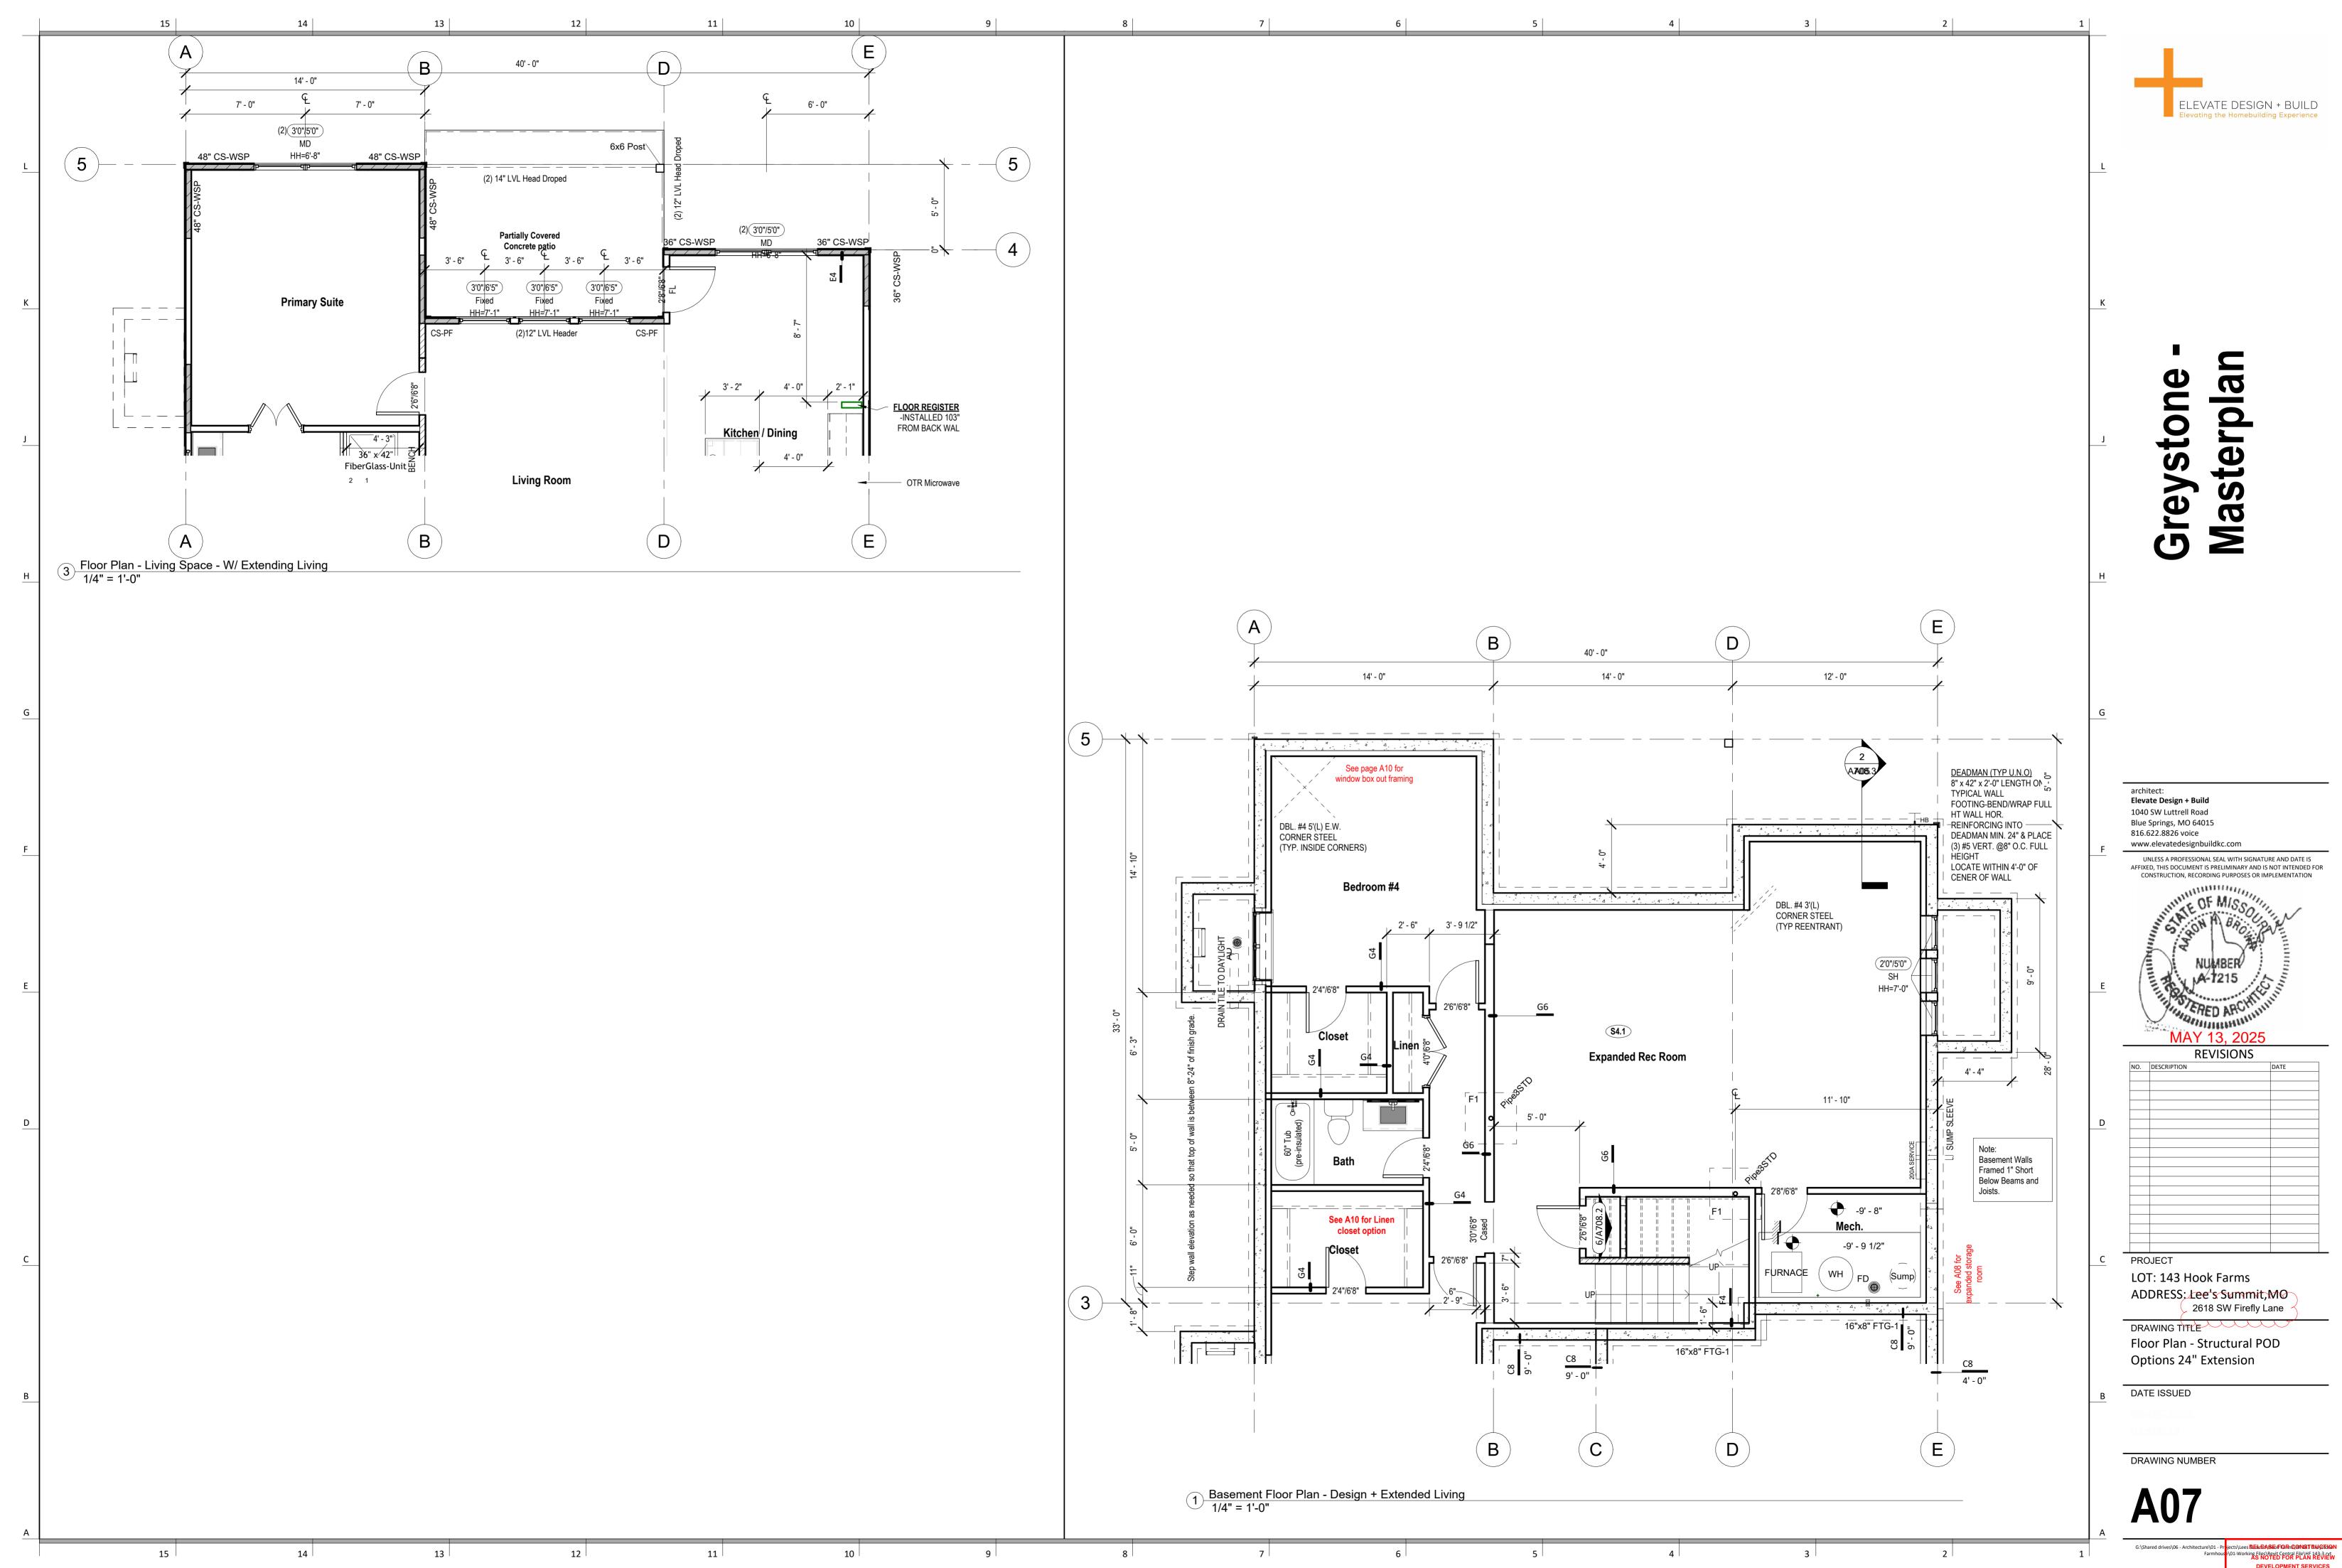

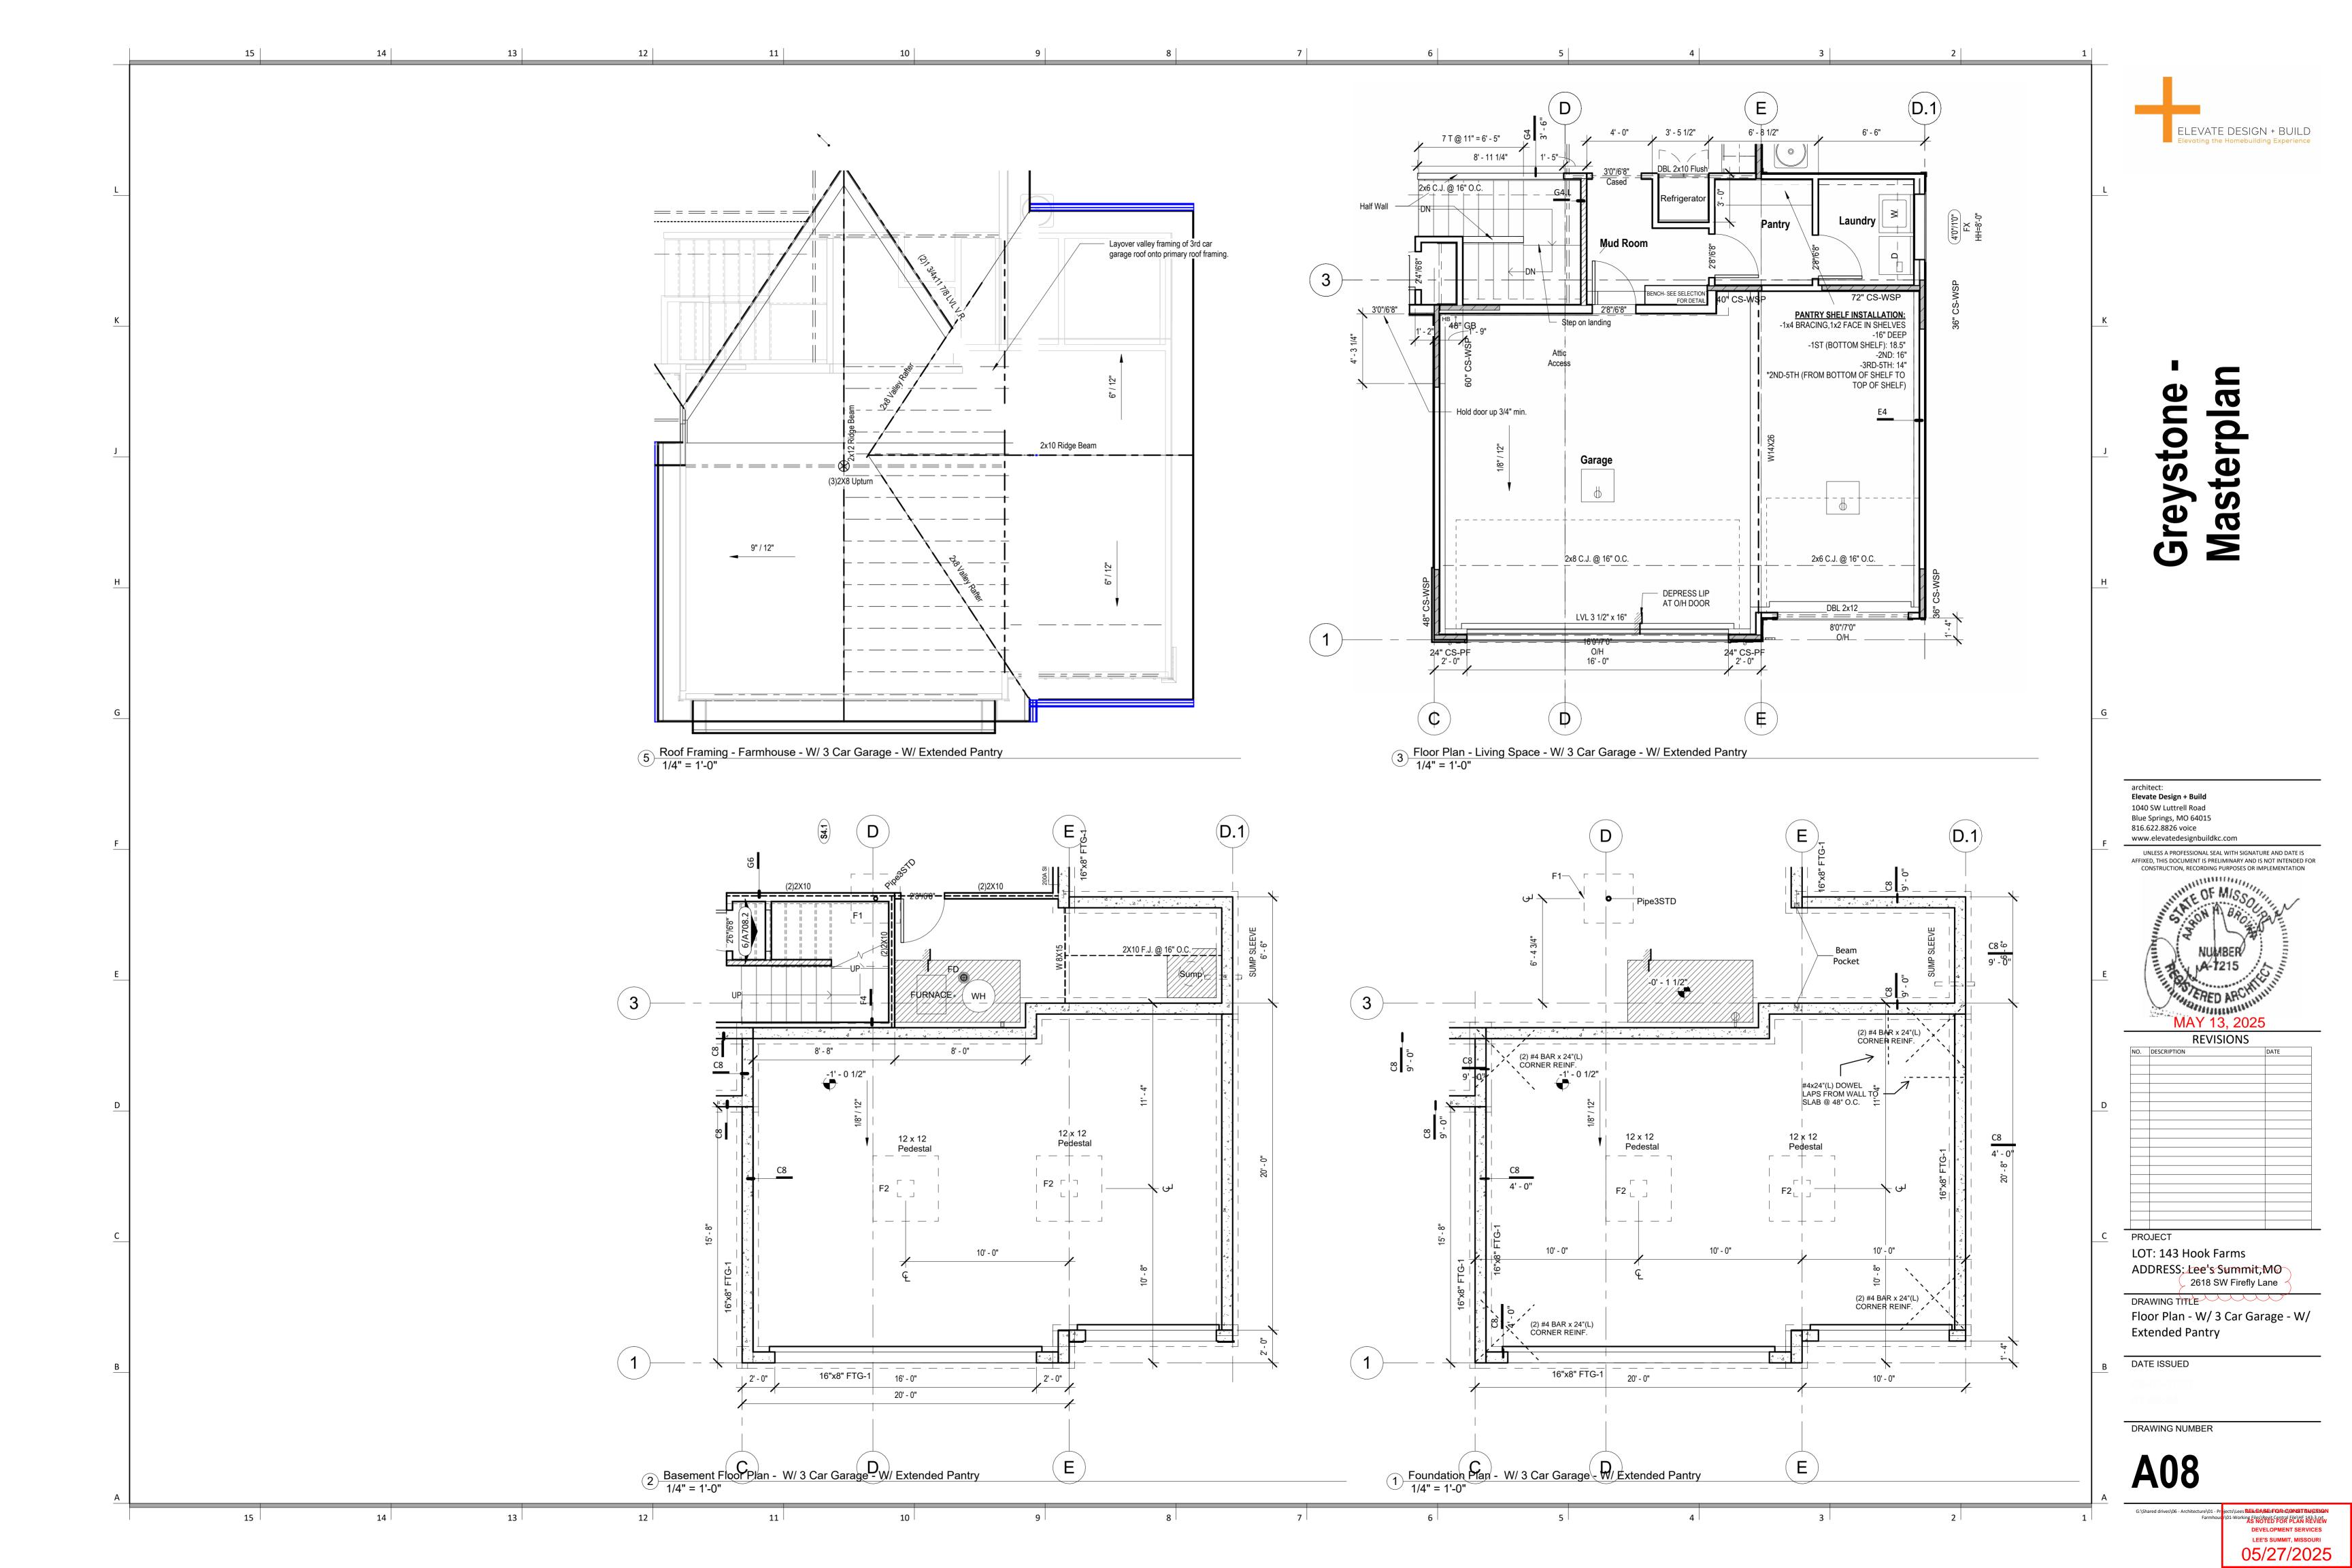


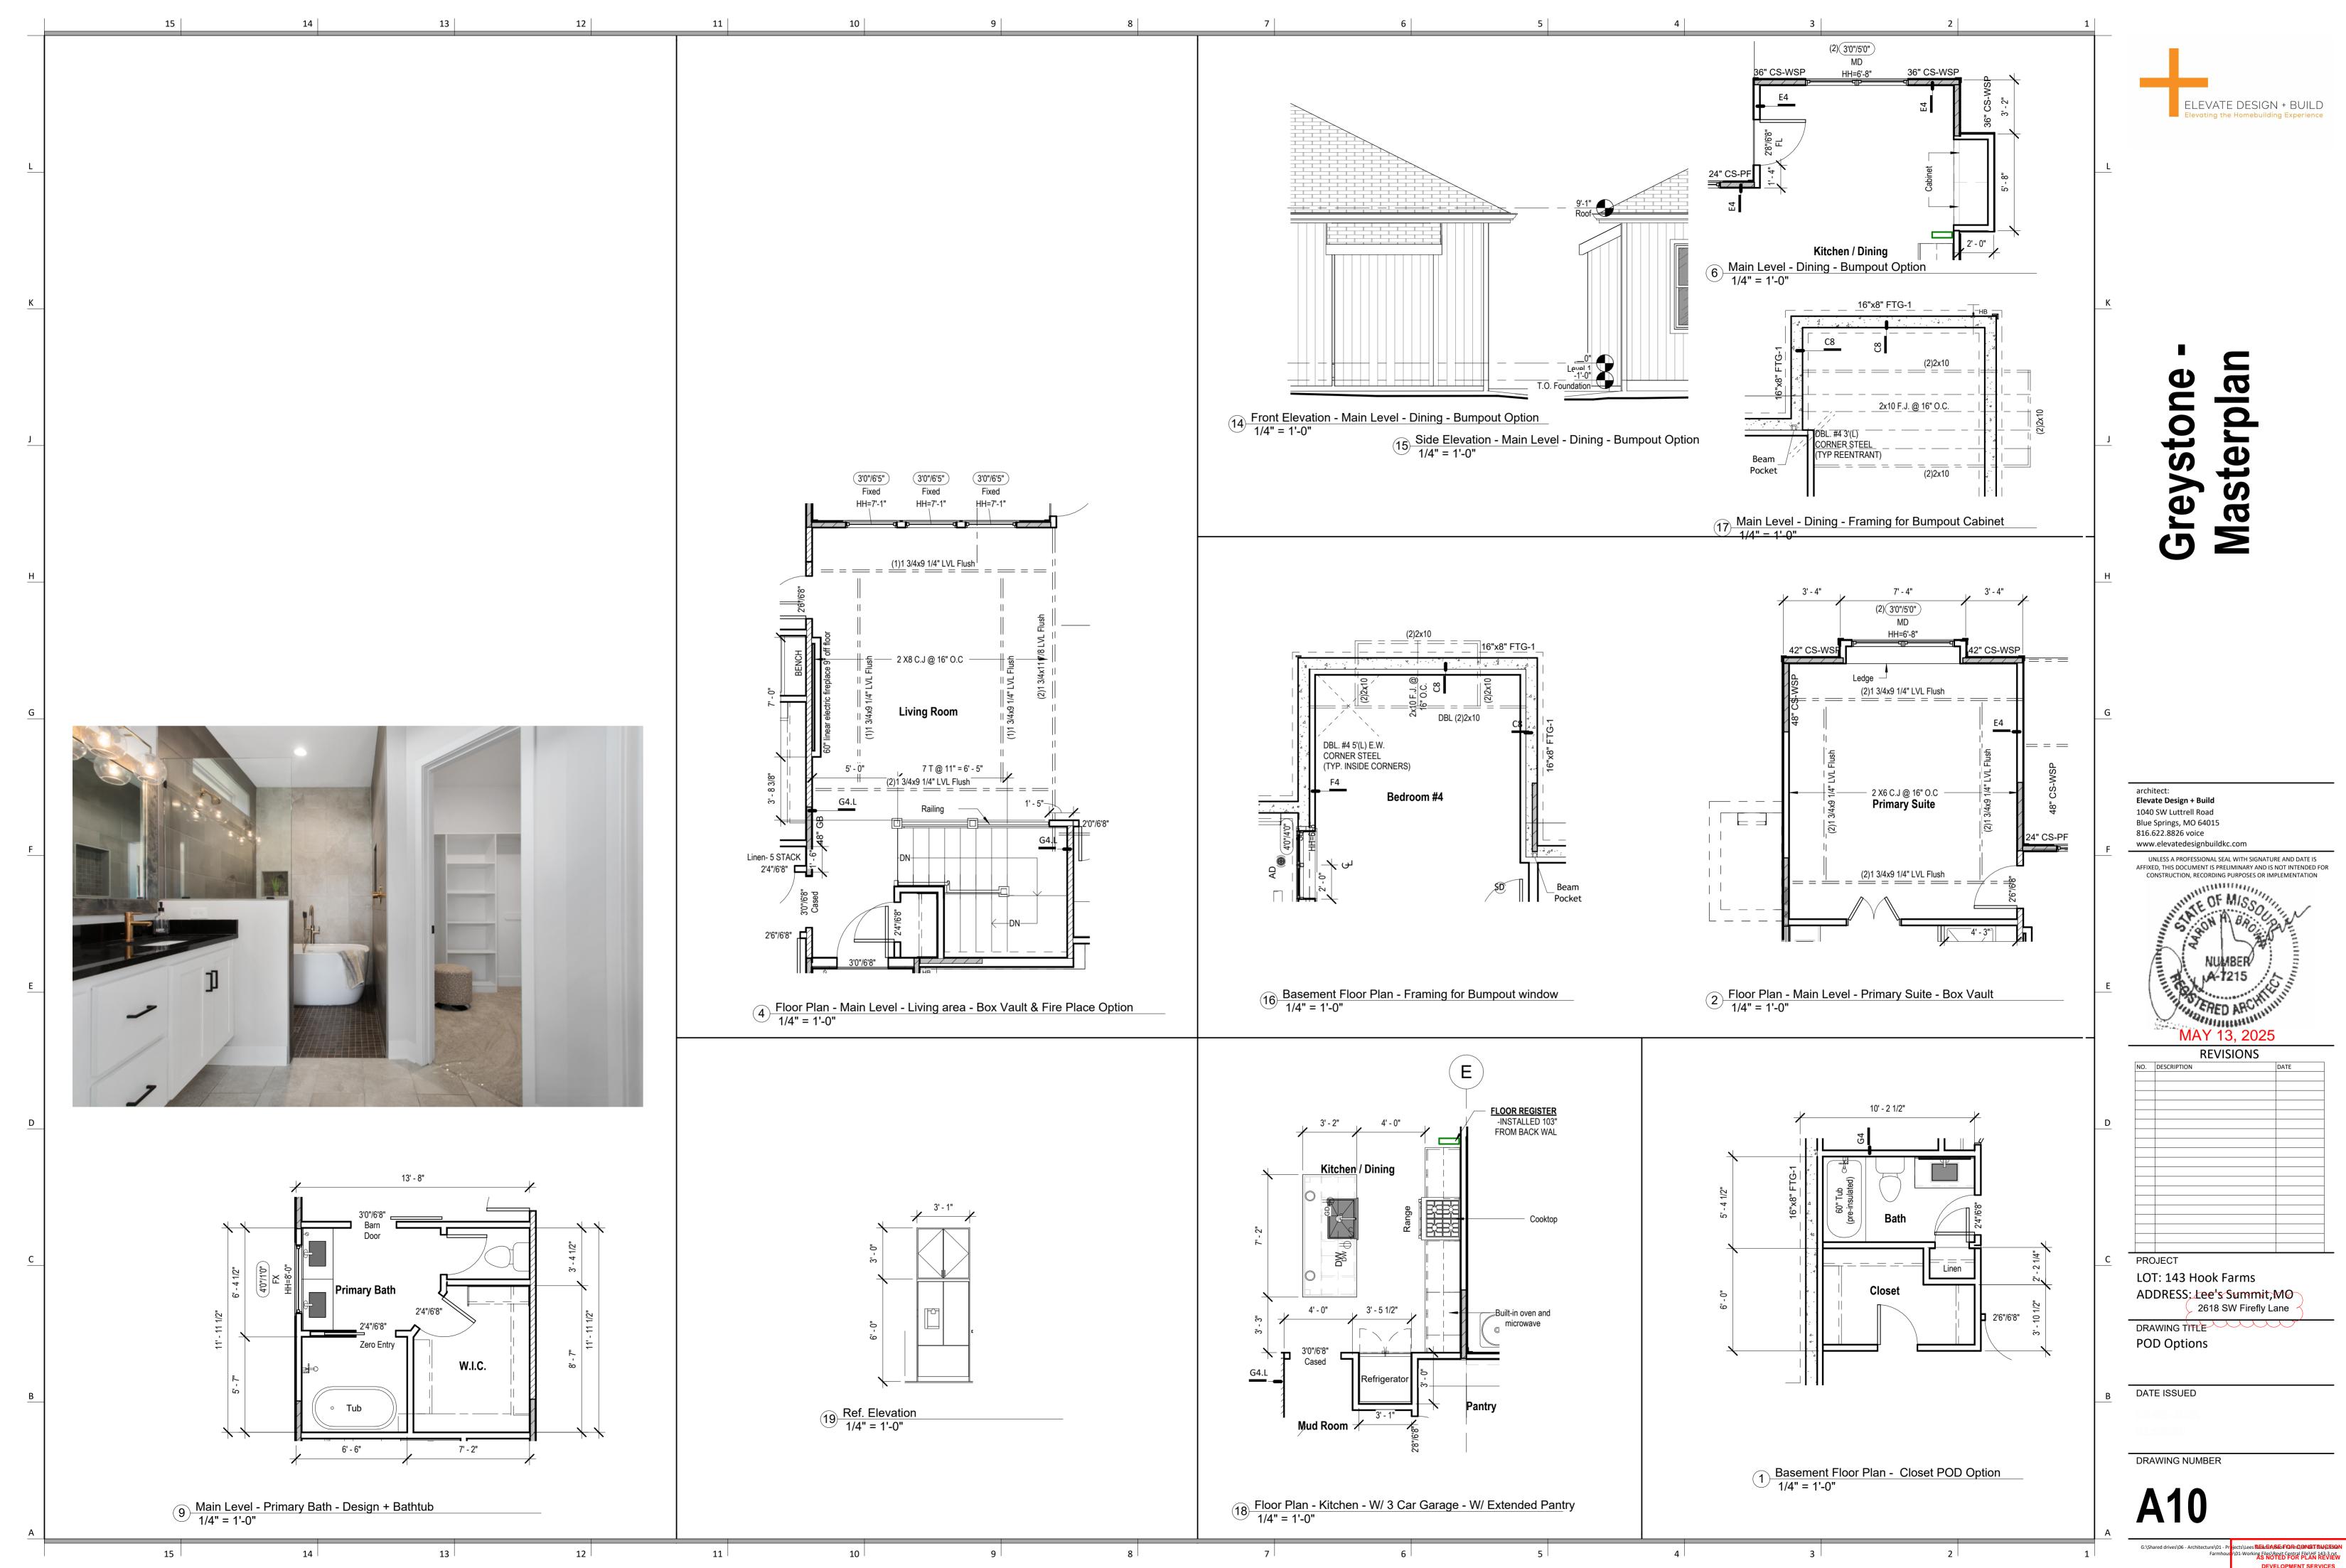

DEVELOPMENT SERVICES LEE'S SUMMIT, MISSOURI 05/27/2025

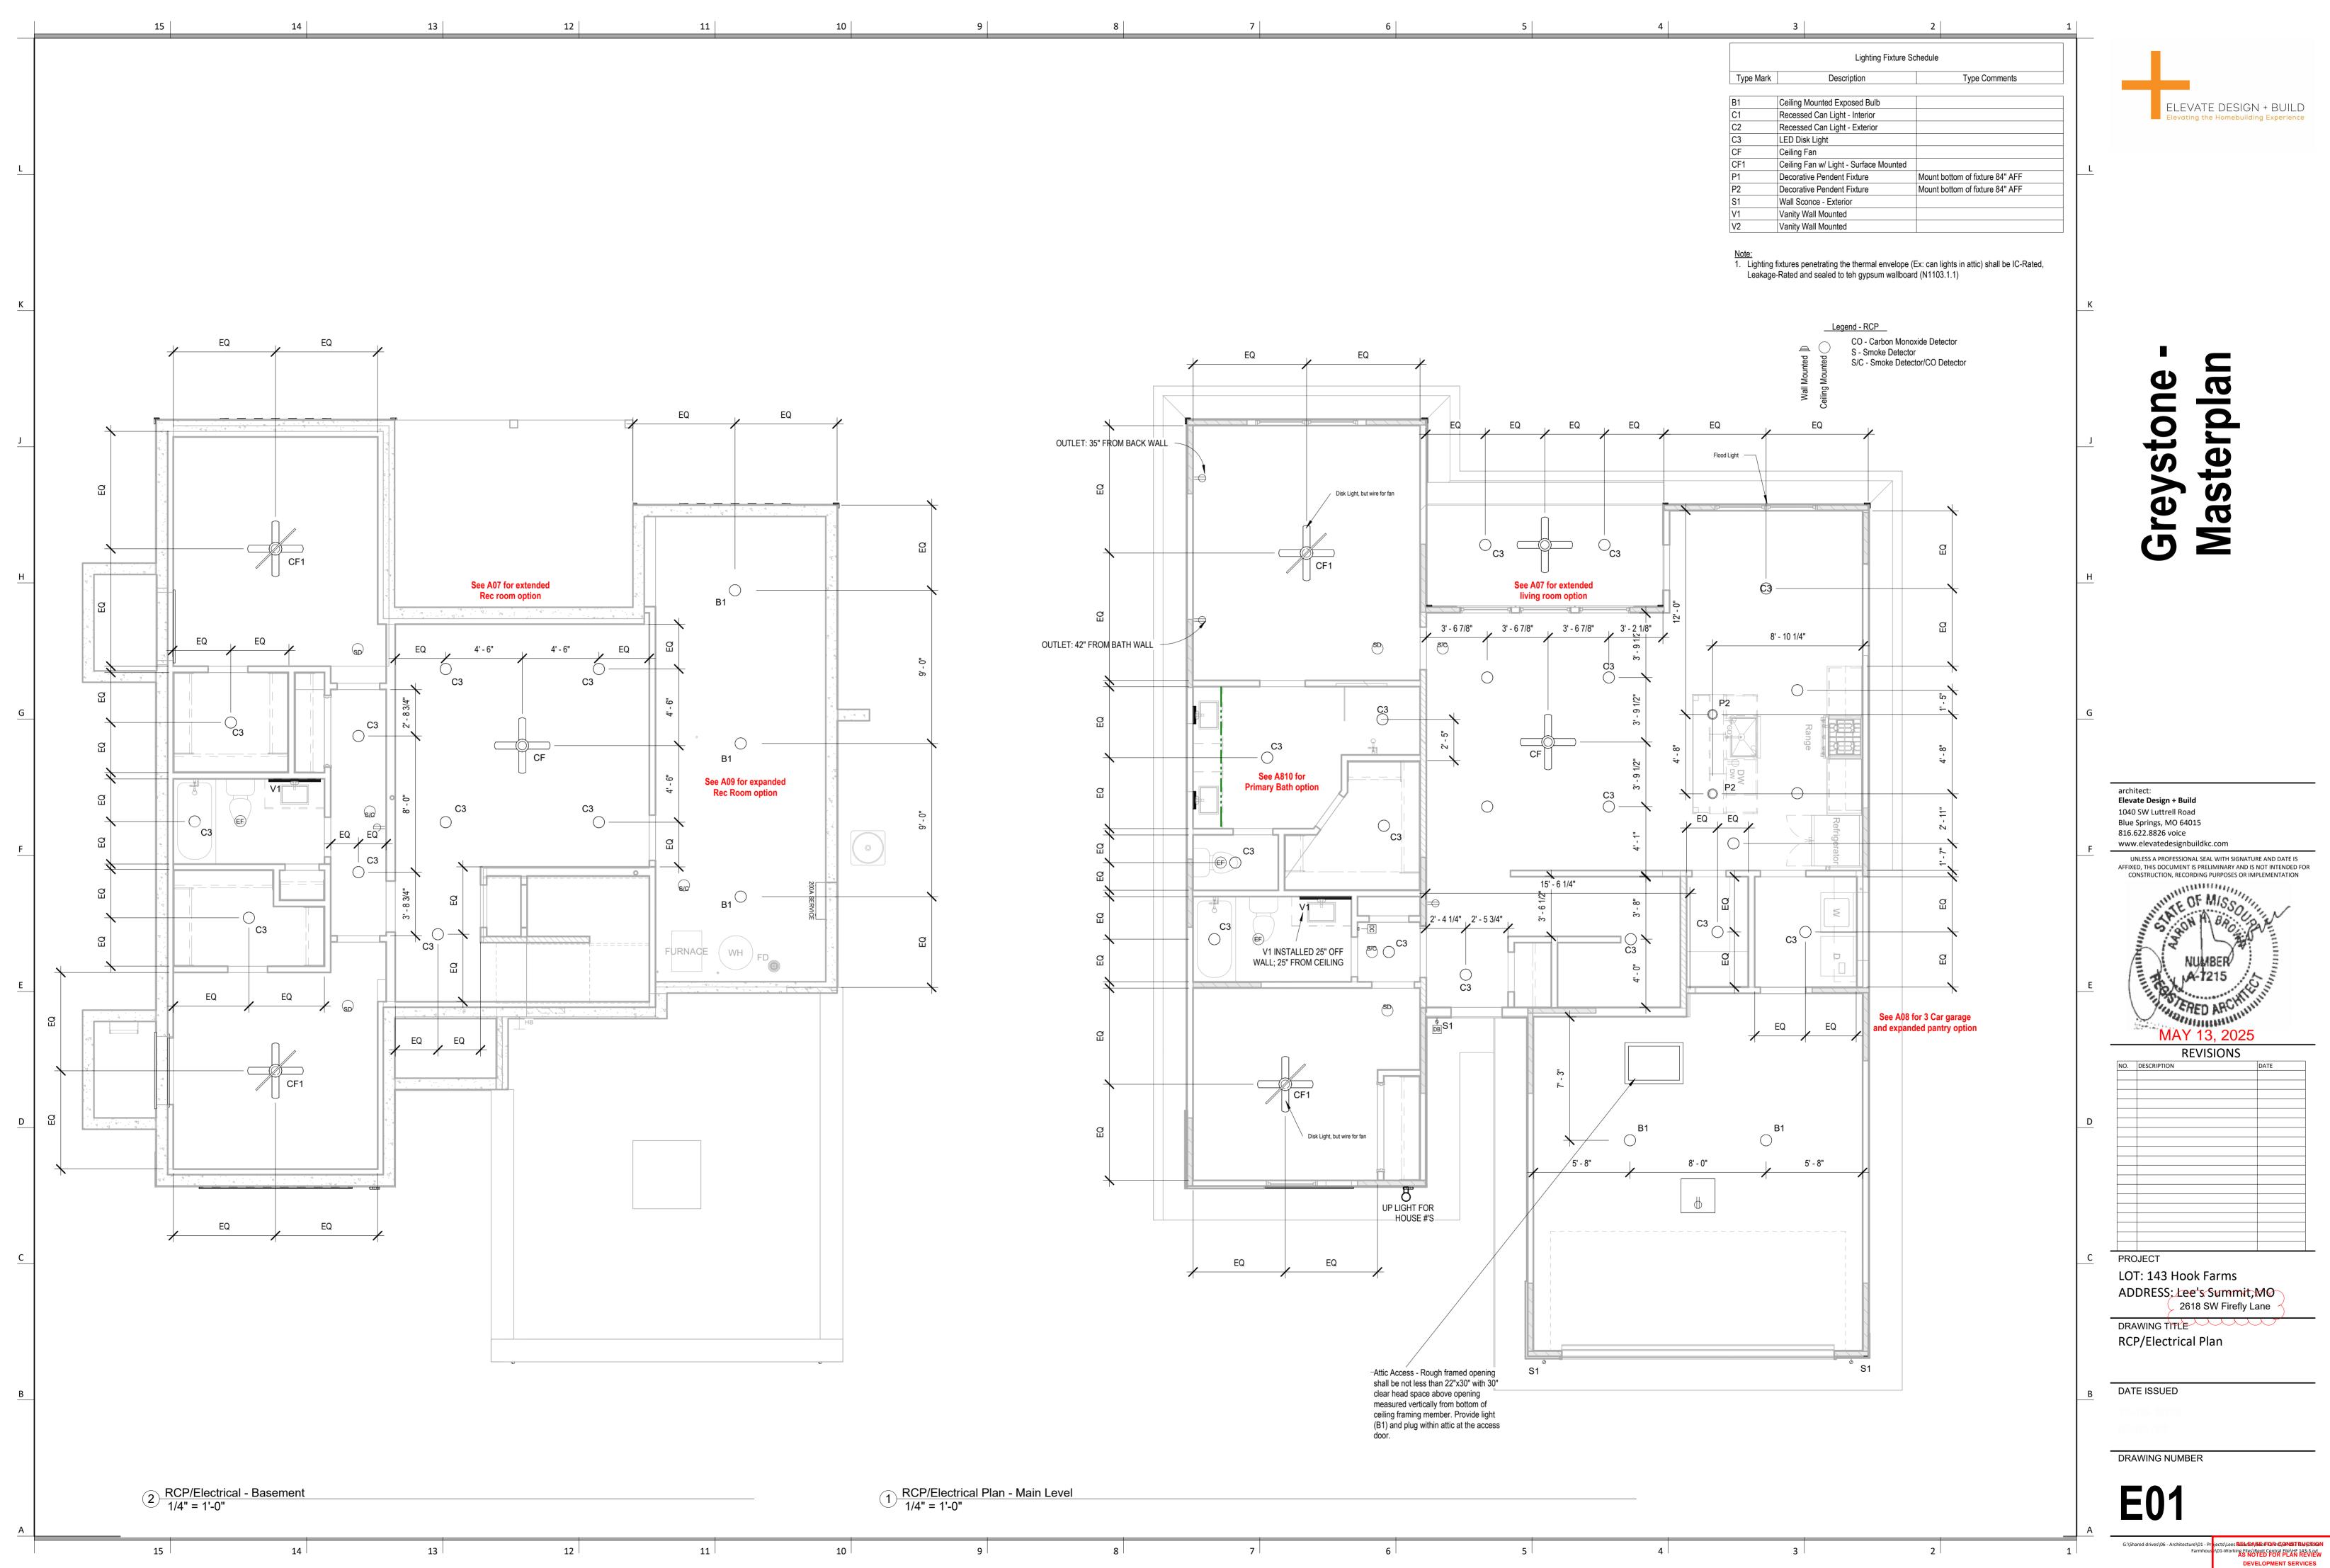


DEVELOPMENT SERVICES LEE'S SUMMIT, MISSOURI 05/27/2025

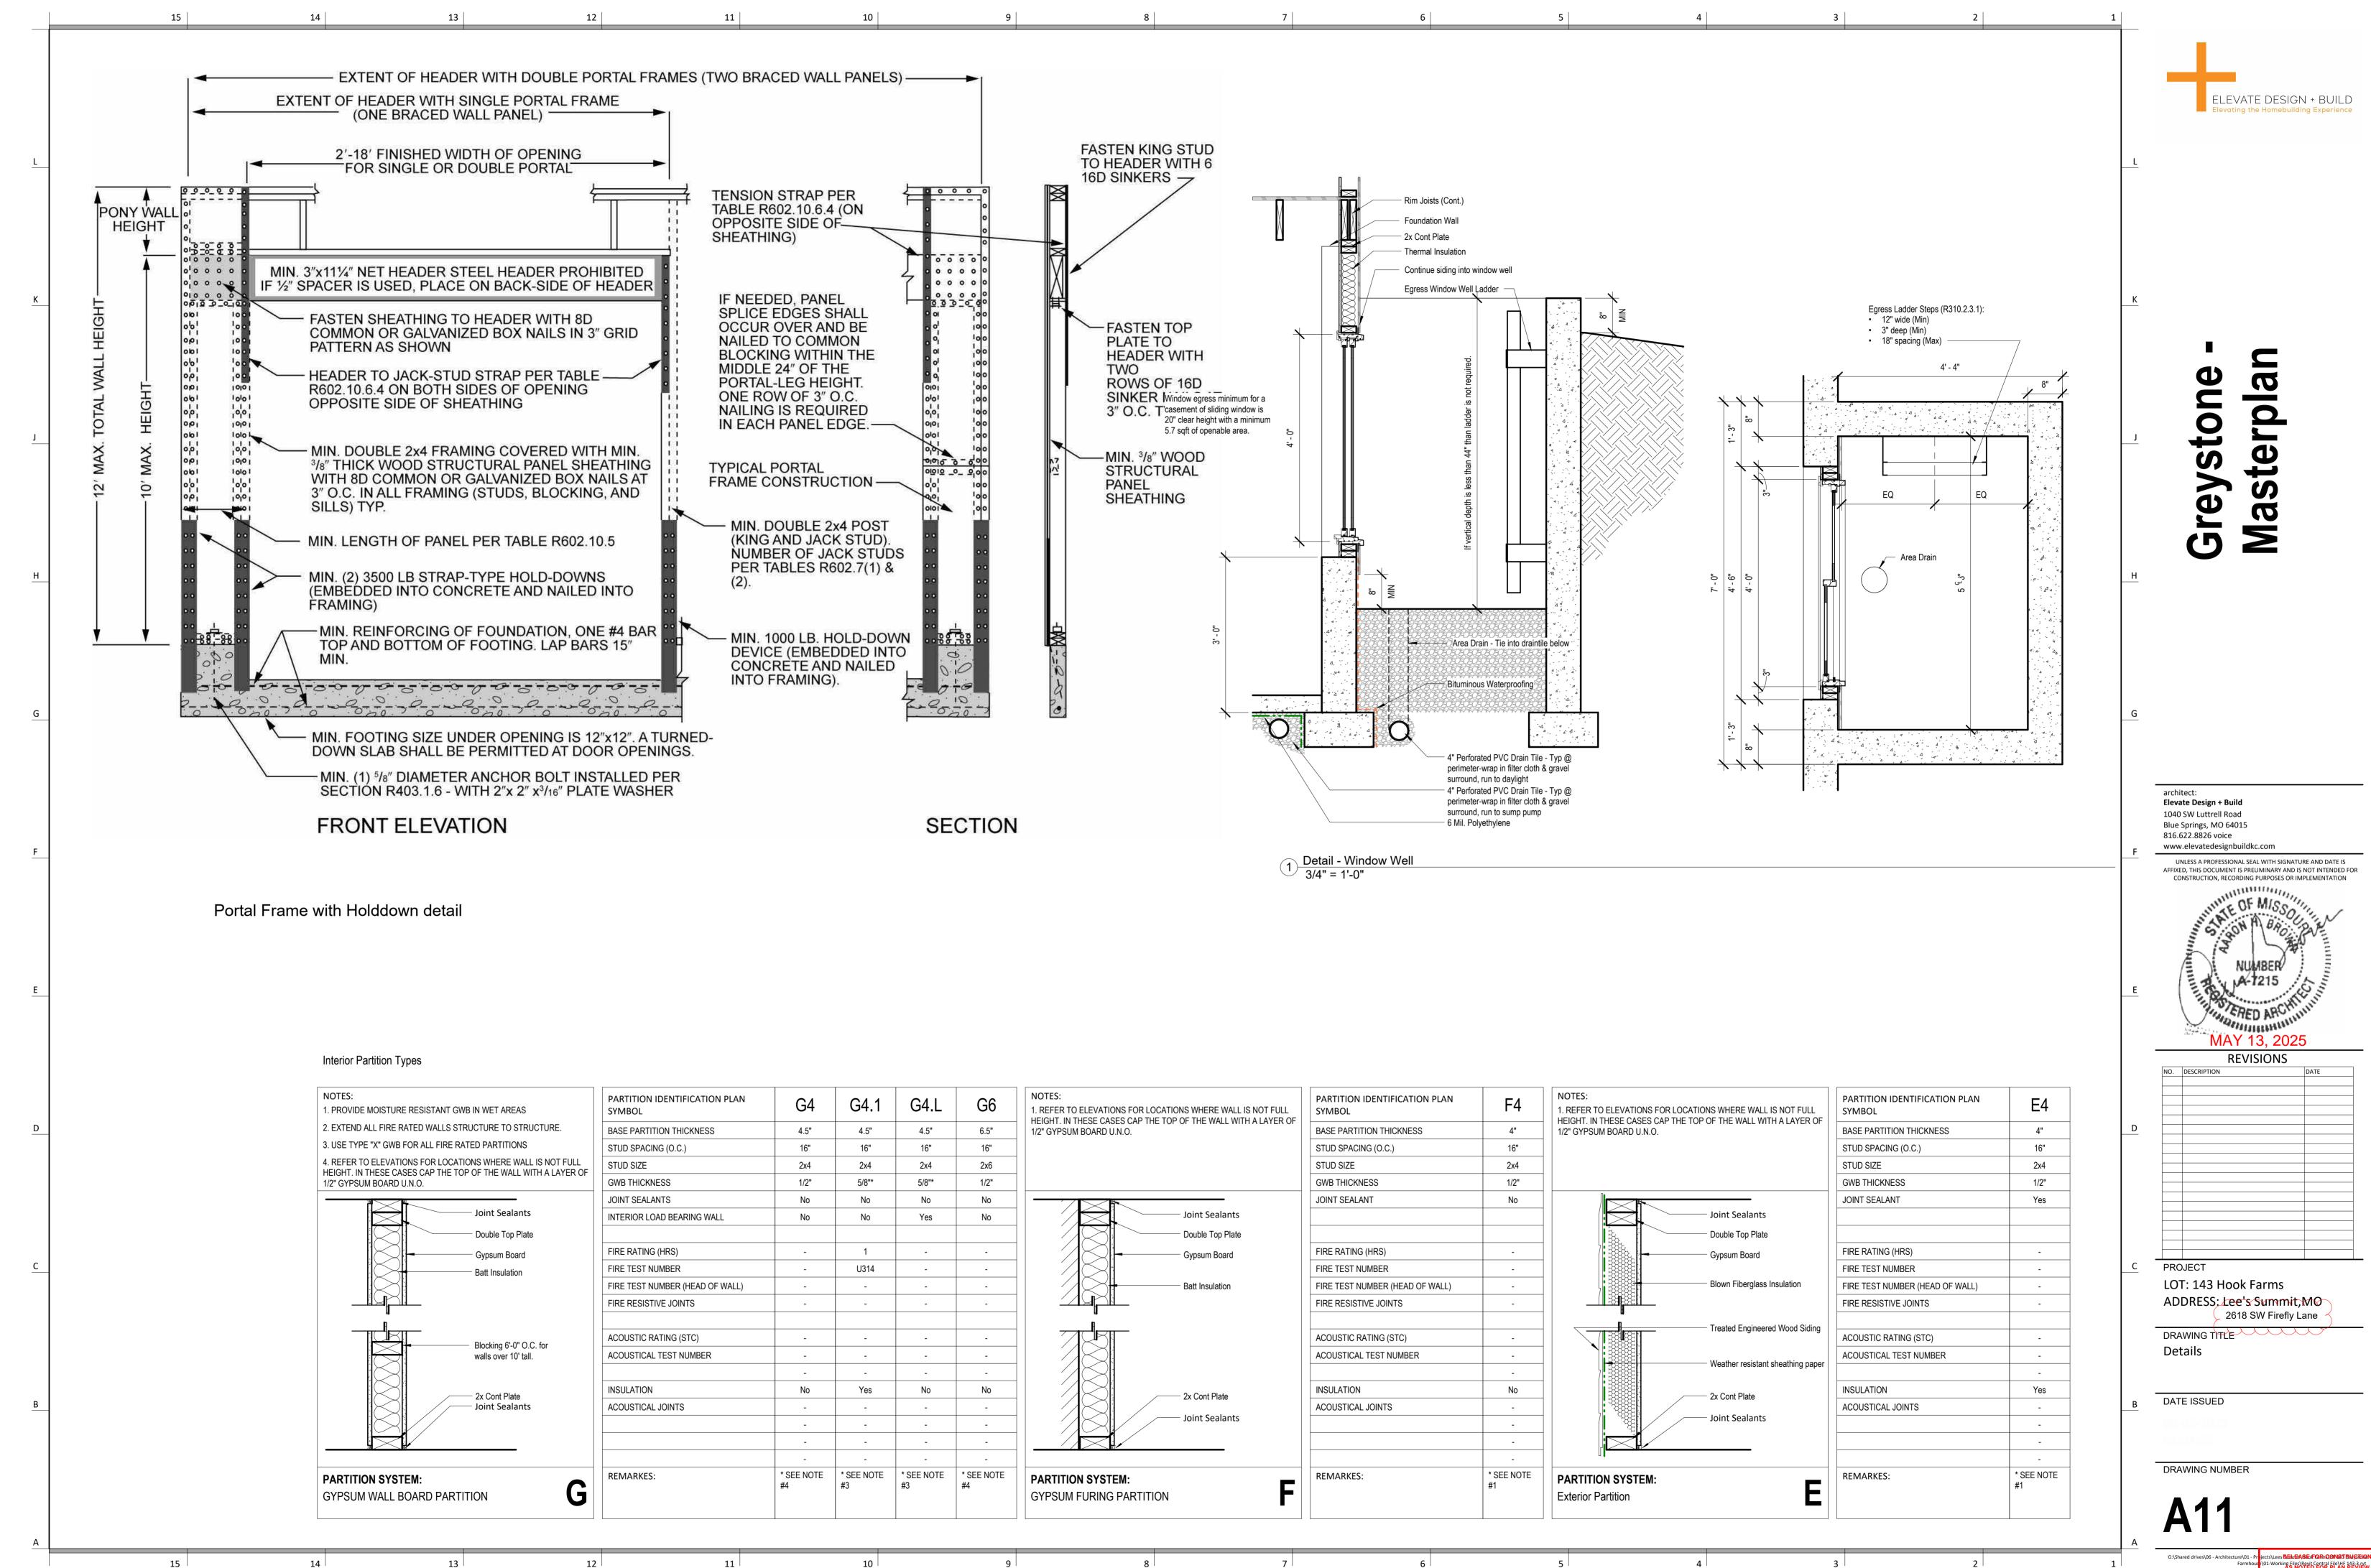

Nuces RELIGIA SED FORM CONSTRUCTION
Working Fleshevit Central Fleshe 143-3 pt
DEVELOPMENT SERVICES
LEE'S SUMMIT, MISSOURI

05/27/2025

rking Files\Revit Central File\HF 143-3.rvt DEVELOPMENT SERVICES LEE'S SUMMIT, MISSOURI 05/27/2025

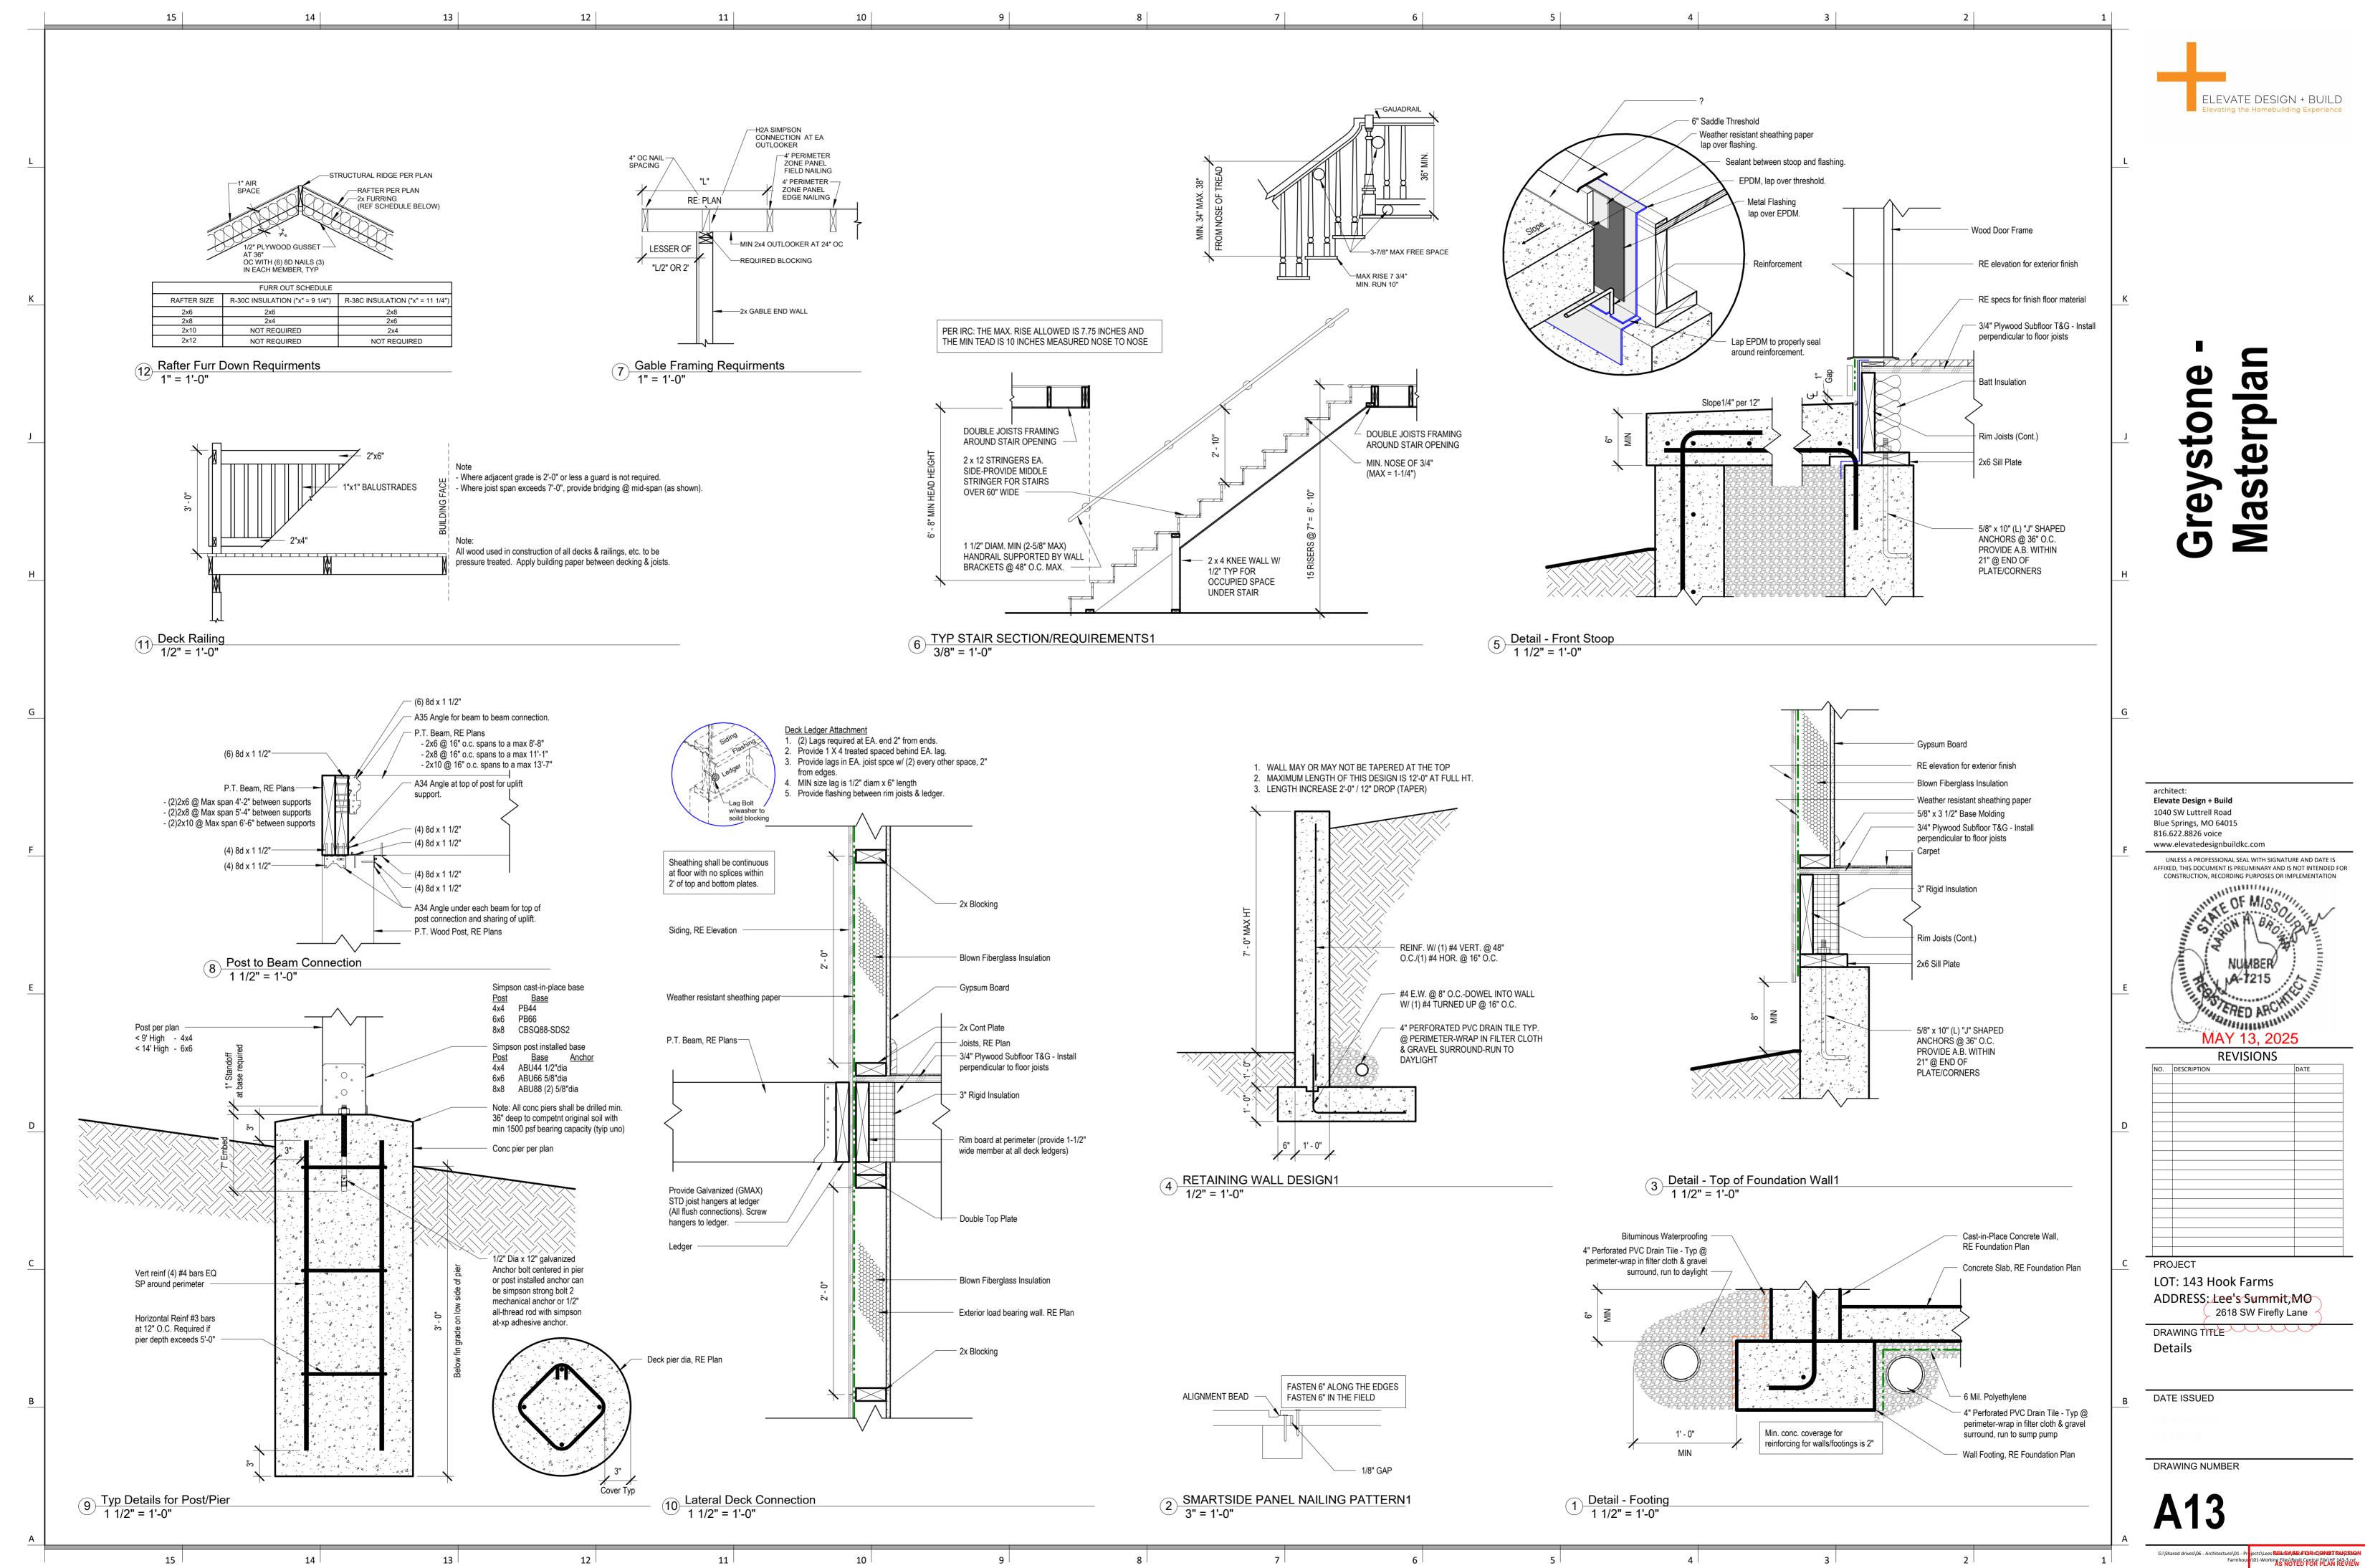

ects\Lees Billim Abio Form Connat Bulgition Not-Working Files\Revi Central File\H 1833 ptw AS NOTED FOR PLAN REVIEW DEVELOPMENT SERVICES LEE'S SUMMIT, MISSOURI 05/27/2025