Greystone - Masterplan

LOT: 143 Hook Farms

ADDRESS: 2618 SW Firefly Lane, Lees Summit, MO

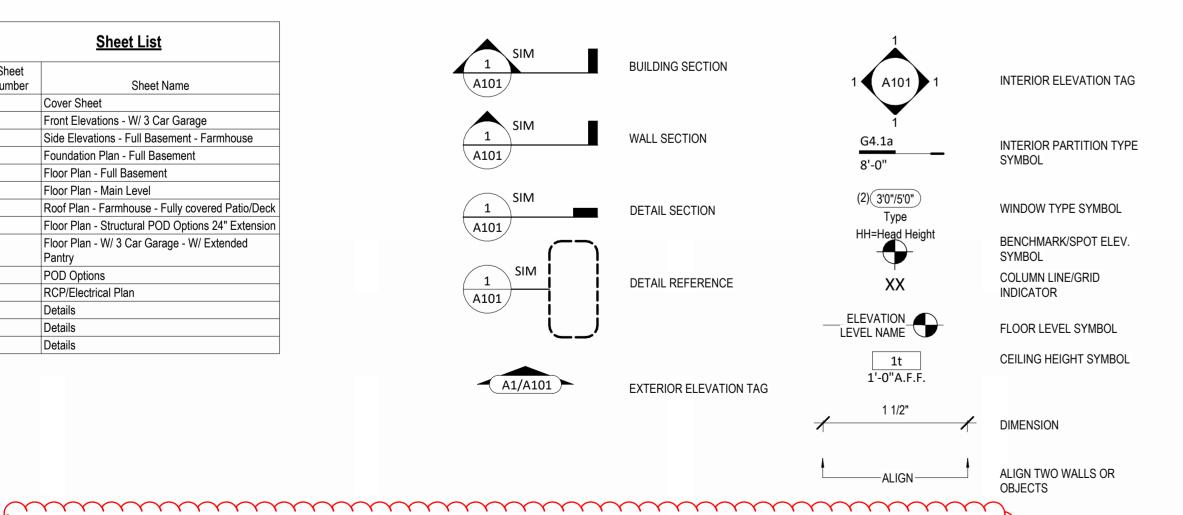


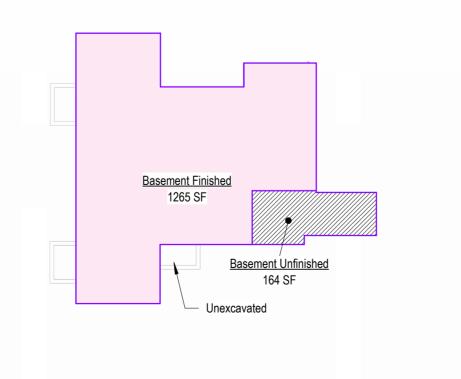
Sheet List				
Sheet Number	Sheet Name			
00	Cover Sheet			
A01	Front Elevations - W/ 3 Car Garage			
A02	Side Elevations - Full Basement - Farmhouse			
A03	Foundation Plan - Full Basement			
A04	Floor Plan - Full Basement			
A05	Floor Plan - Main Level			
A06	Roof Plan - Farmhouse - Fully covered Patio/Deck			
A07	Floor Plan - Structural POD Options 24" Extension			
A08	Floor Plan - W/ 3 Car Garage - W/ Extended Pantry			
A10	POD Options			
E01	RCP/Electrical Plan			
A11	Details			
A12	Details			
A13	Details			

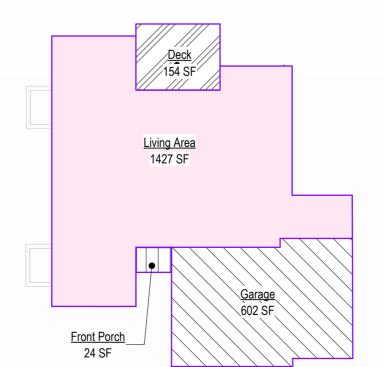
Change/Revision Log:

. 1. Updated address on all pages.

May 19, 2025:







<u>Li</u>	ving Area 427 SF	
Front Porch 24 SF	Garage 602 SF	

11	Basement Area - W/ Extended pantry 1/16" = 1'-0"
	1/16" = 1'-0"

Main Level Area - W/ Extended pantry
1/16" = 1'-0"

General Information

2018 Interior Energy Cons. C	Code (Table N1102.1.2)
Doors & Windows:	U-0.32 MAX
Glazing SHGF:	0.40
Skylights:	U-0.55 MAX
Roof	
Attic Ceilings:	R-49 MIN
Vaults:	R-38 MIN
Vaults < 500sf:	R-30 MIN
Wood Frame Walls:	R-20 or R-13 + 5 MIN
Basement Walls:	R-13 or R-10 Continuou
Floor (over unconditioned):	R-19 MIN
Slab on Grade:	R-10 for 24" MIN
Ductwork:	R-8 MIN
Fuel Fired Furnace:	90% AFUE MIN
Electic Furnace:	No Minimum
Cooling System:	13 SEER MIN
Water Haster	
Water Heater	0.07 FF MIN
Gas Fired Storage:	0.67 EF MIN
Gas Fired Instant:	0.62 EF MIN
Electic Storage: Flectic Instant:	0.97 EF MIN
Electic instant:	0.93 EF MIN

An energy efficient certificate is required to be

IRC 2018	
Ground Snow Load:	20PSF
Wind Speed:	115mph
Topography Effects:	No
Seismic Design Category:	Α
Damage From Weather:	Severe
Frost Line Depth:	36 inches
Termite:	Moderate to He
Winter Design Temperature:	6 F
Ice Barrier Underlayment:	Yes
Flood Hazard:	
Air Freezing Index:	927 or less
Maan Annual Tamanaratura	EEEE

- 1. Whole House Mechanical Ventilation System is required for any dwelling with air infiltration at a rate of less than 5 air changes per hour (at ACH50 standard R303.4). 2. Carbon monoxide detectors required (R315)
- 3. Steel columns shall be minimum schedule 40
- 4. Deck Ledger attachment to house shall be per Tables 507.9.1.3.
- 5. New provisions for attachment of rafters,
- 6. Programmable thermostat required
- air leakage rate (N1103.2.2.1)
- 8. Building cavities used as return air plenums shall be sealed to prevent leakage across the thermal envelope. (N1103.2.3)
- 9. Certain hot water pipes shall be insulated (N1103.4)
- 10. All exhaust fans shall terminate to the building exterior (M1507.2)
- 11. Makeup air system required for kitchen exhaust hoods that exceed 400 CFM M1503.4 12. Building cavities in a thermal envelope wall (including the wall between the house and garage) shall not be used as return air
- plenums (unless the required insulation and air barrier are maintained) (M1601.1.1,#7.5) 13. An air handling system shall not serve both the living space and the garage (M1601.6)
- 14. A concrete-Encased grounding electrode ('UFER' Ground) connection complies with the requirments of the 2018 IRC Section E3608.1.2 in providing a connection with no
- less than the required minimum of steel. 15. Compliance with the requirments and show connection as needed for roof beam, trus, rafter, and girder connections for uplift per IRC
- 16. Garage Door Rating: DASMA 115 MPH Rated

Area - W/ Extended pantry & Living

Basement Unfinished

Front Porch

Garage

1265 SF

1427 SF

2692 SF

24 SF

602 SF

945 SF

RELEASE FOR CONSTRUCTION AS NOTED FOR PLAN REVIEW DEVELOPMENT SERVICES LEE'S SUMMIT, MISSOURI 05/19/2025



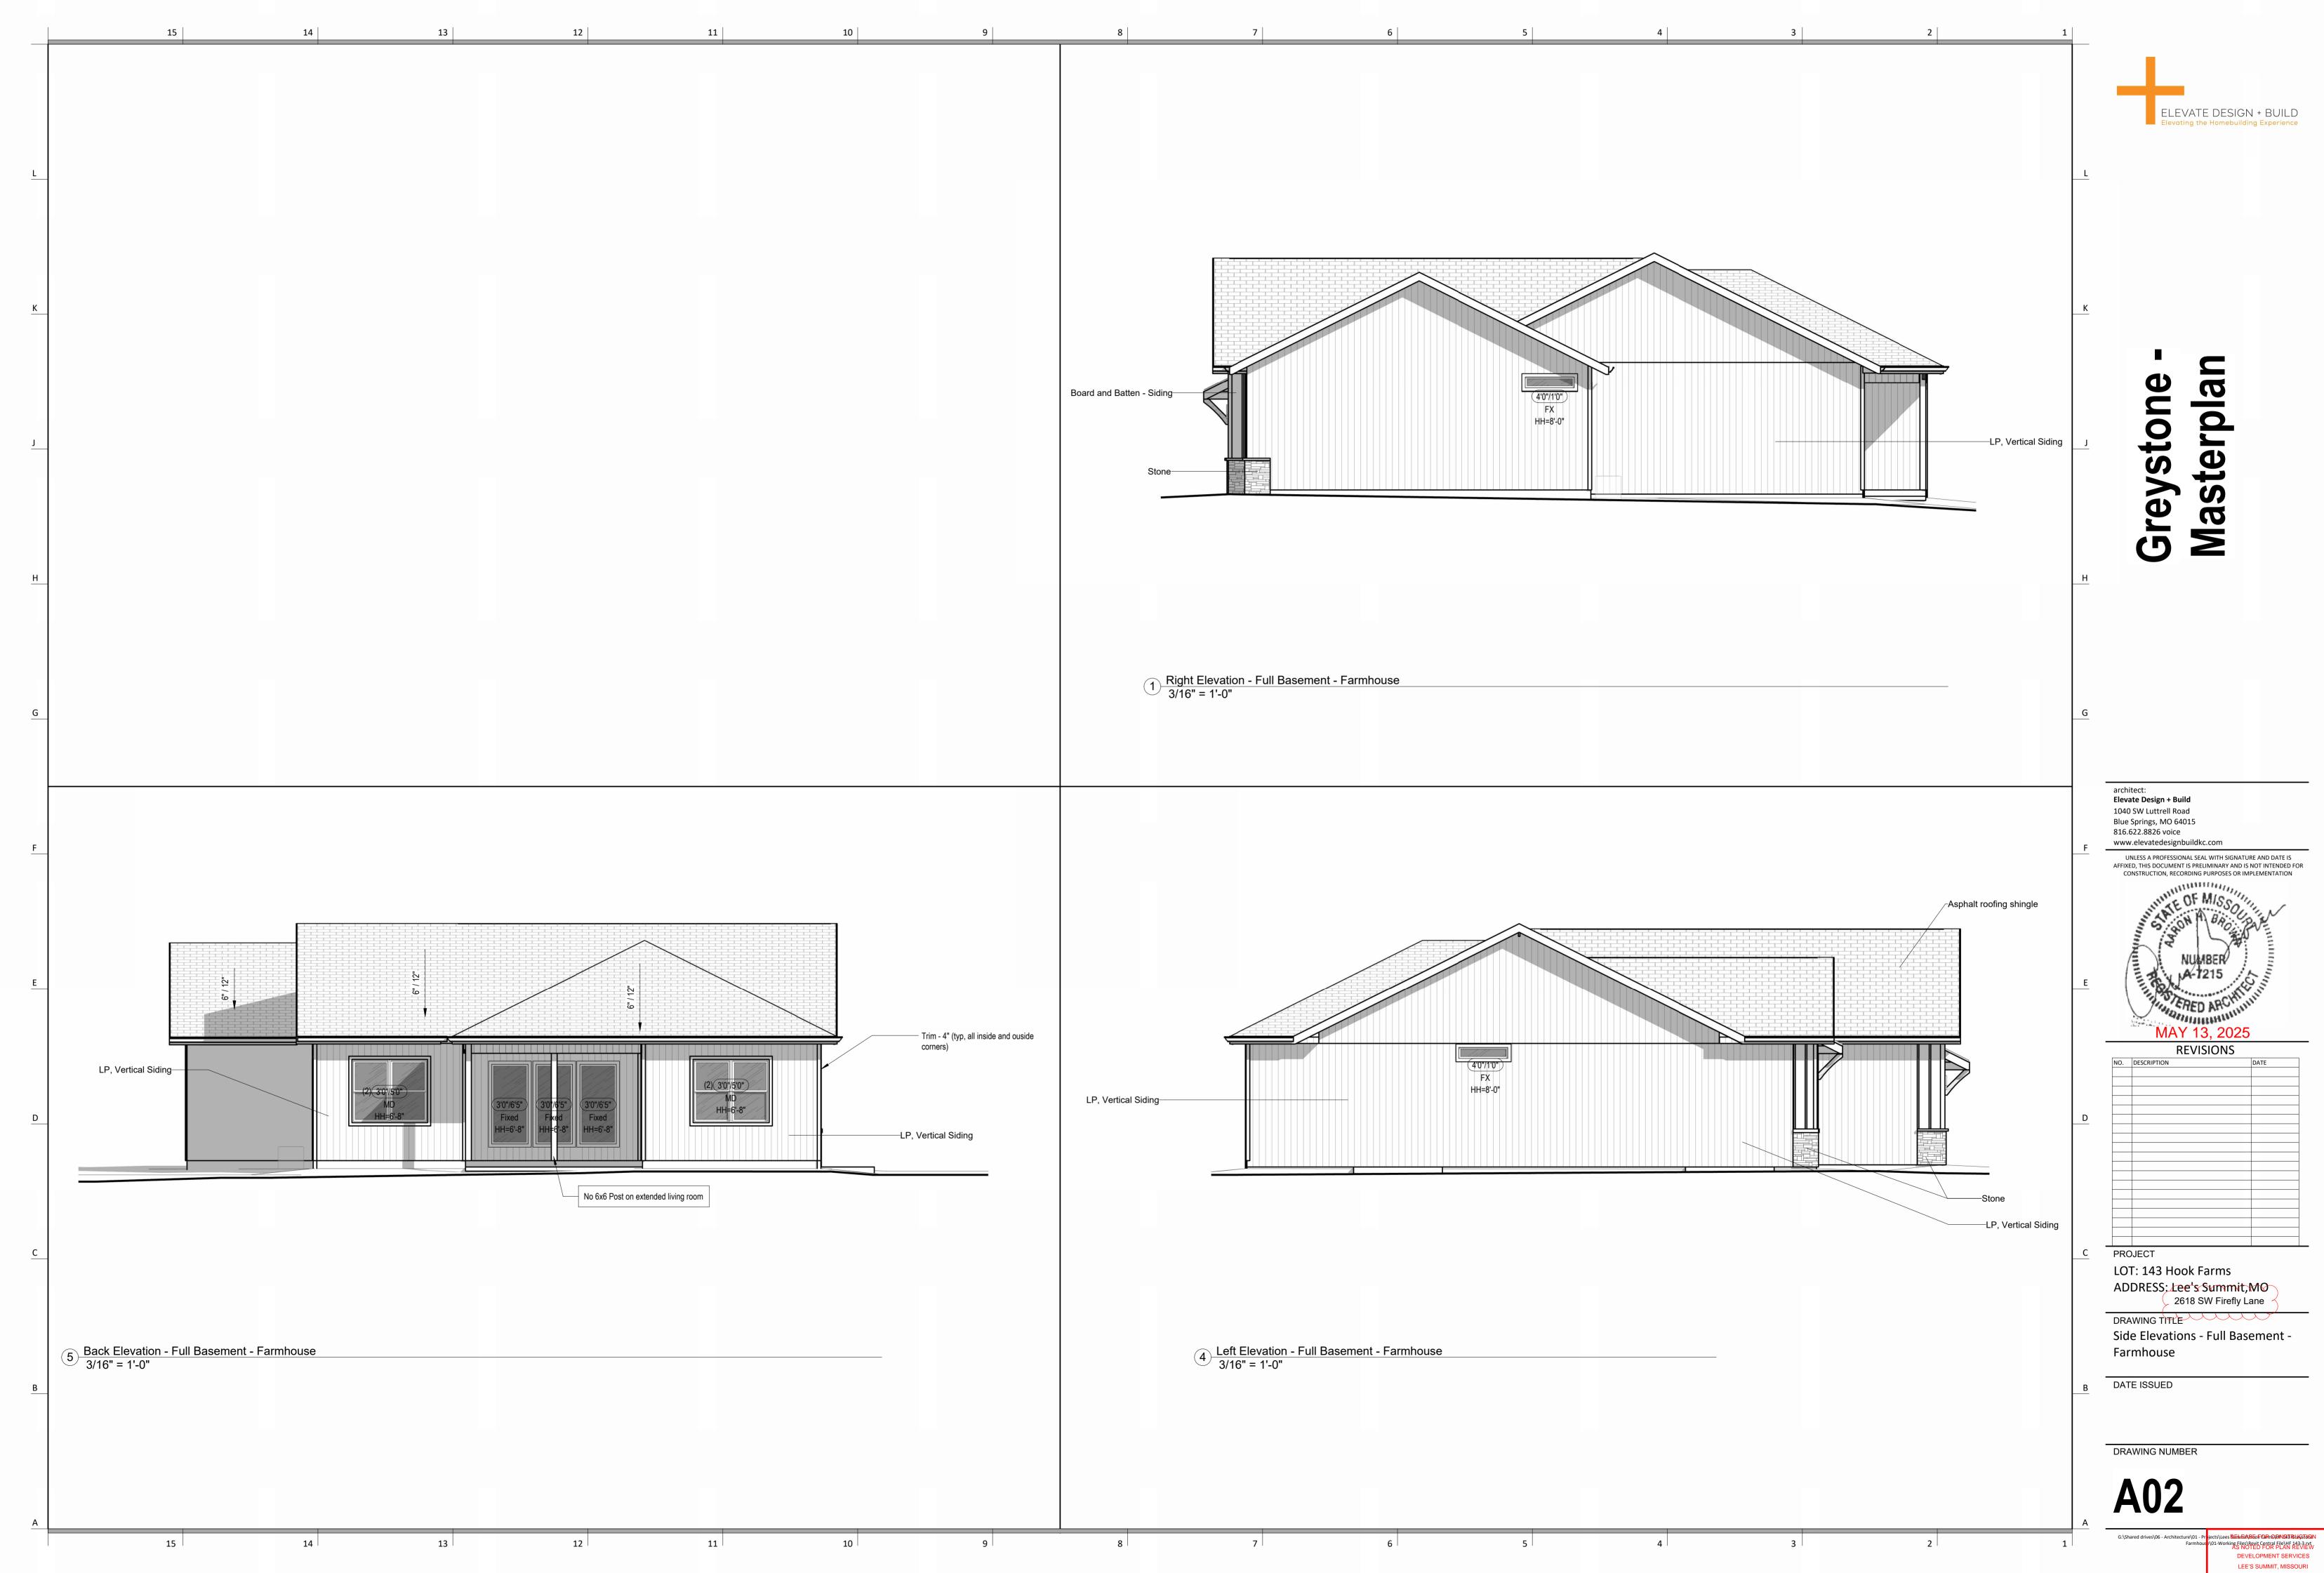
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Permit Set Original Issue Date: 10/1/2021 REVISIONS MAY 13, 2025

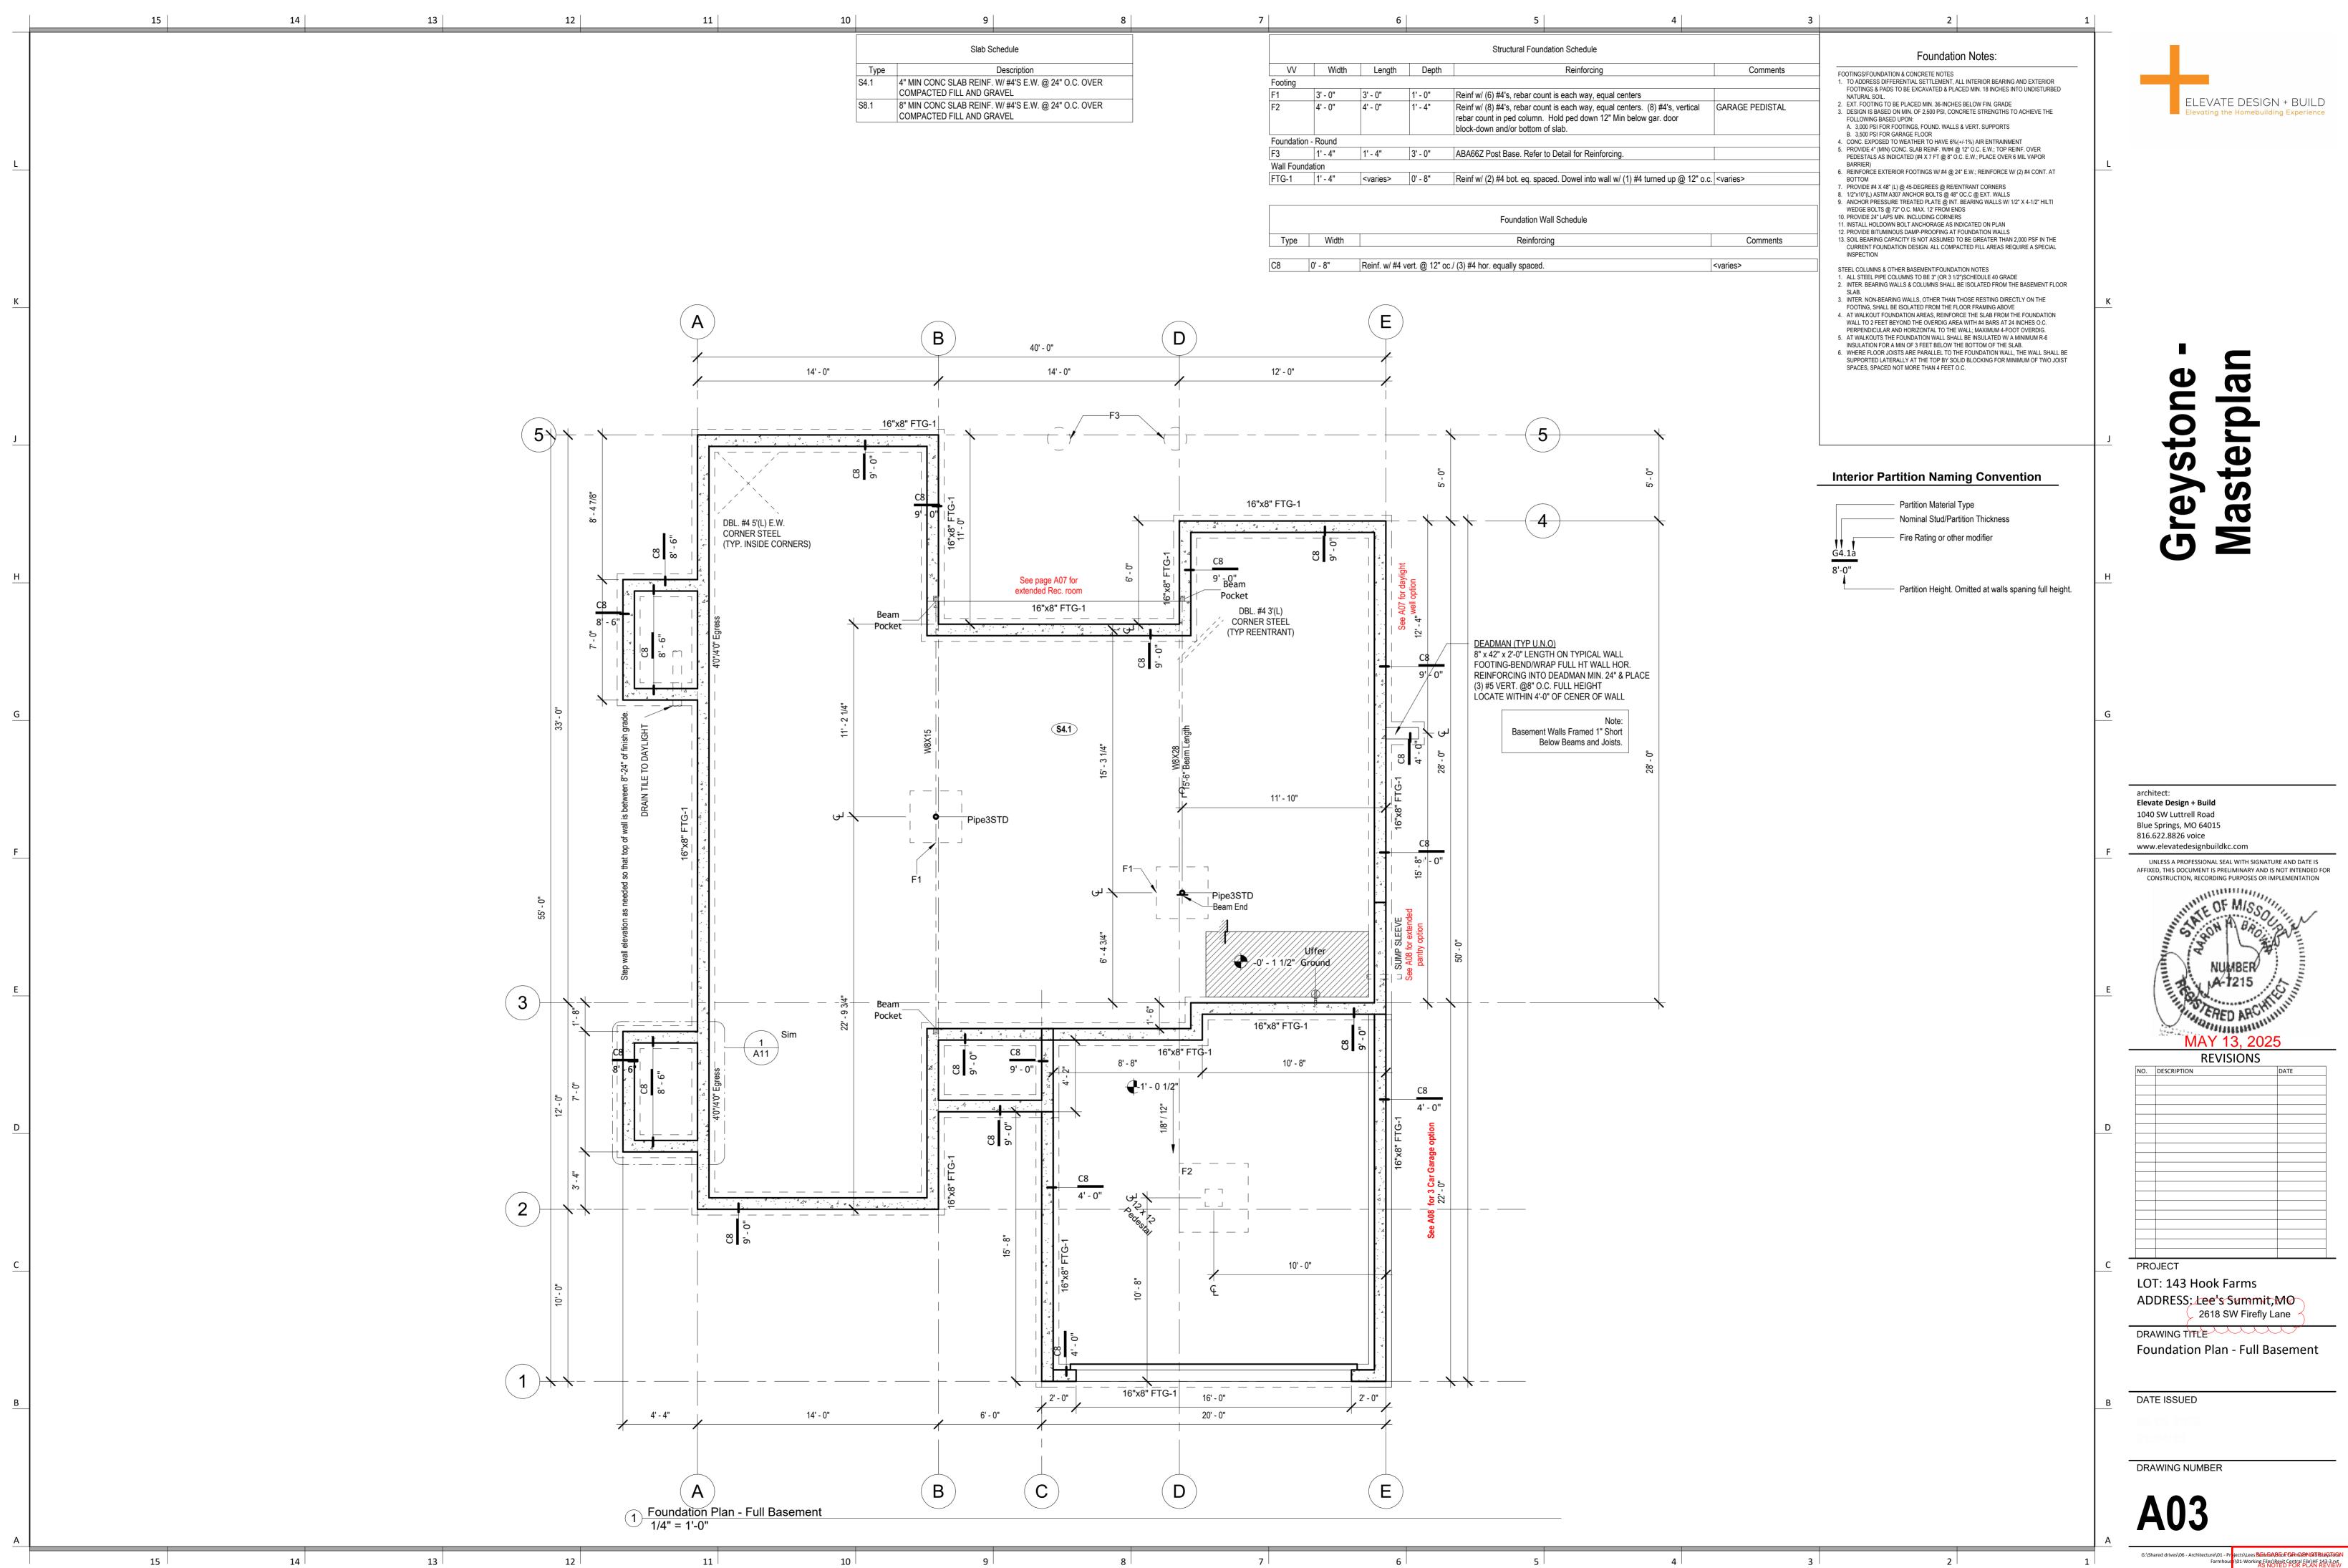
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PLAN DESCRIPTION: Cover Sheet

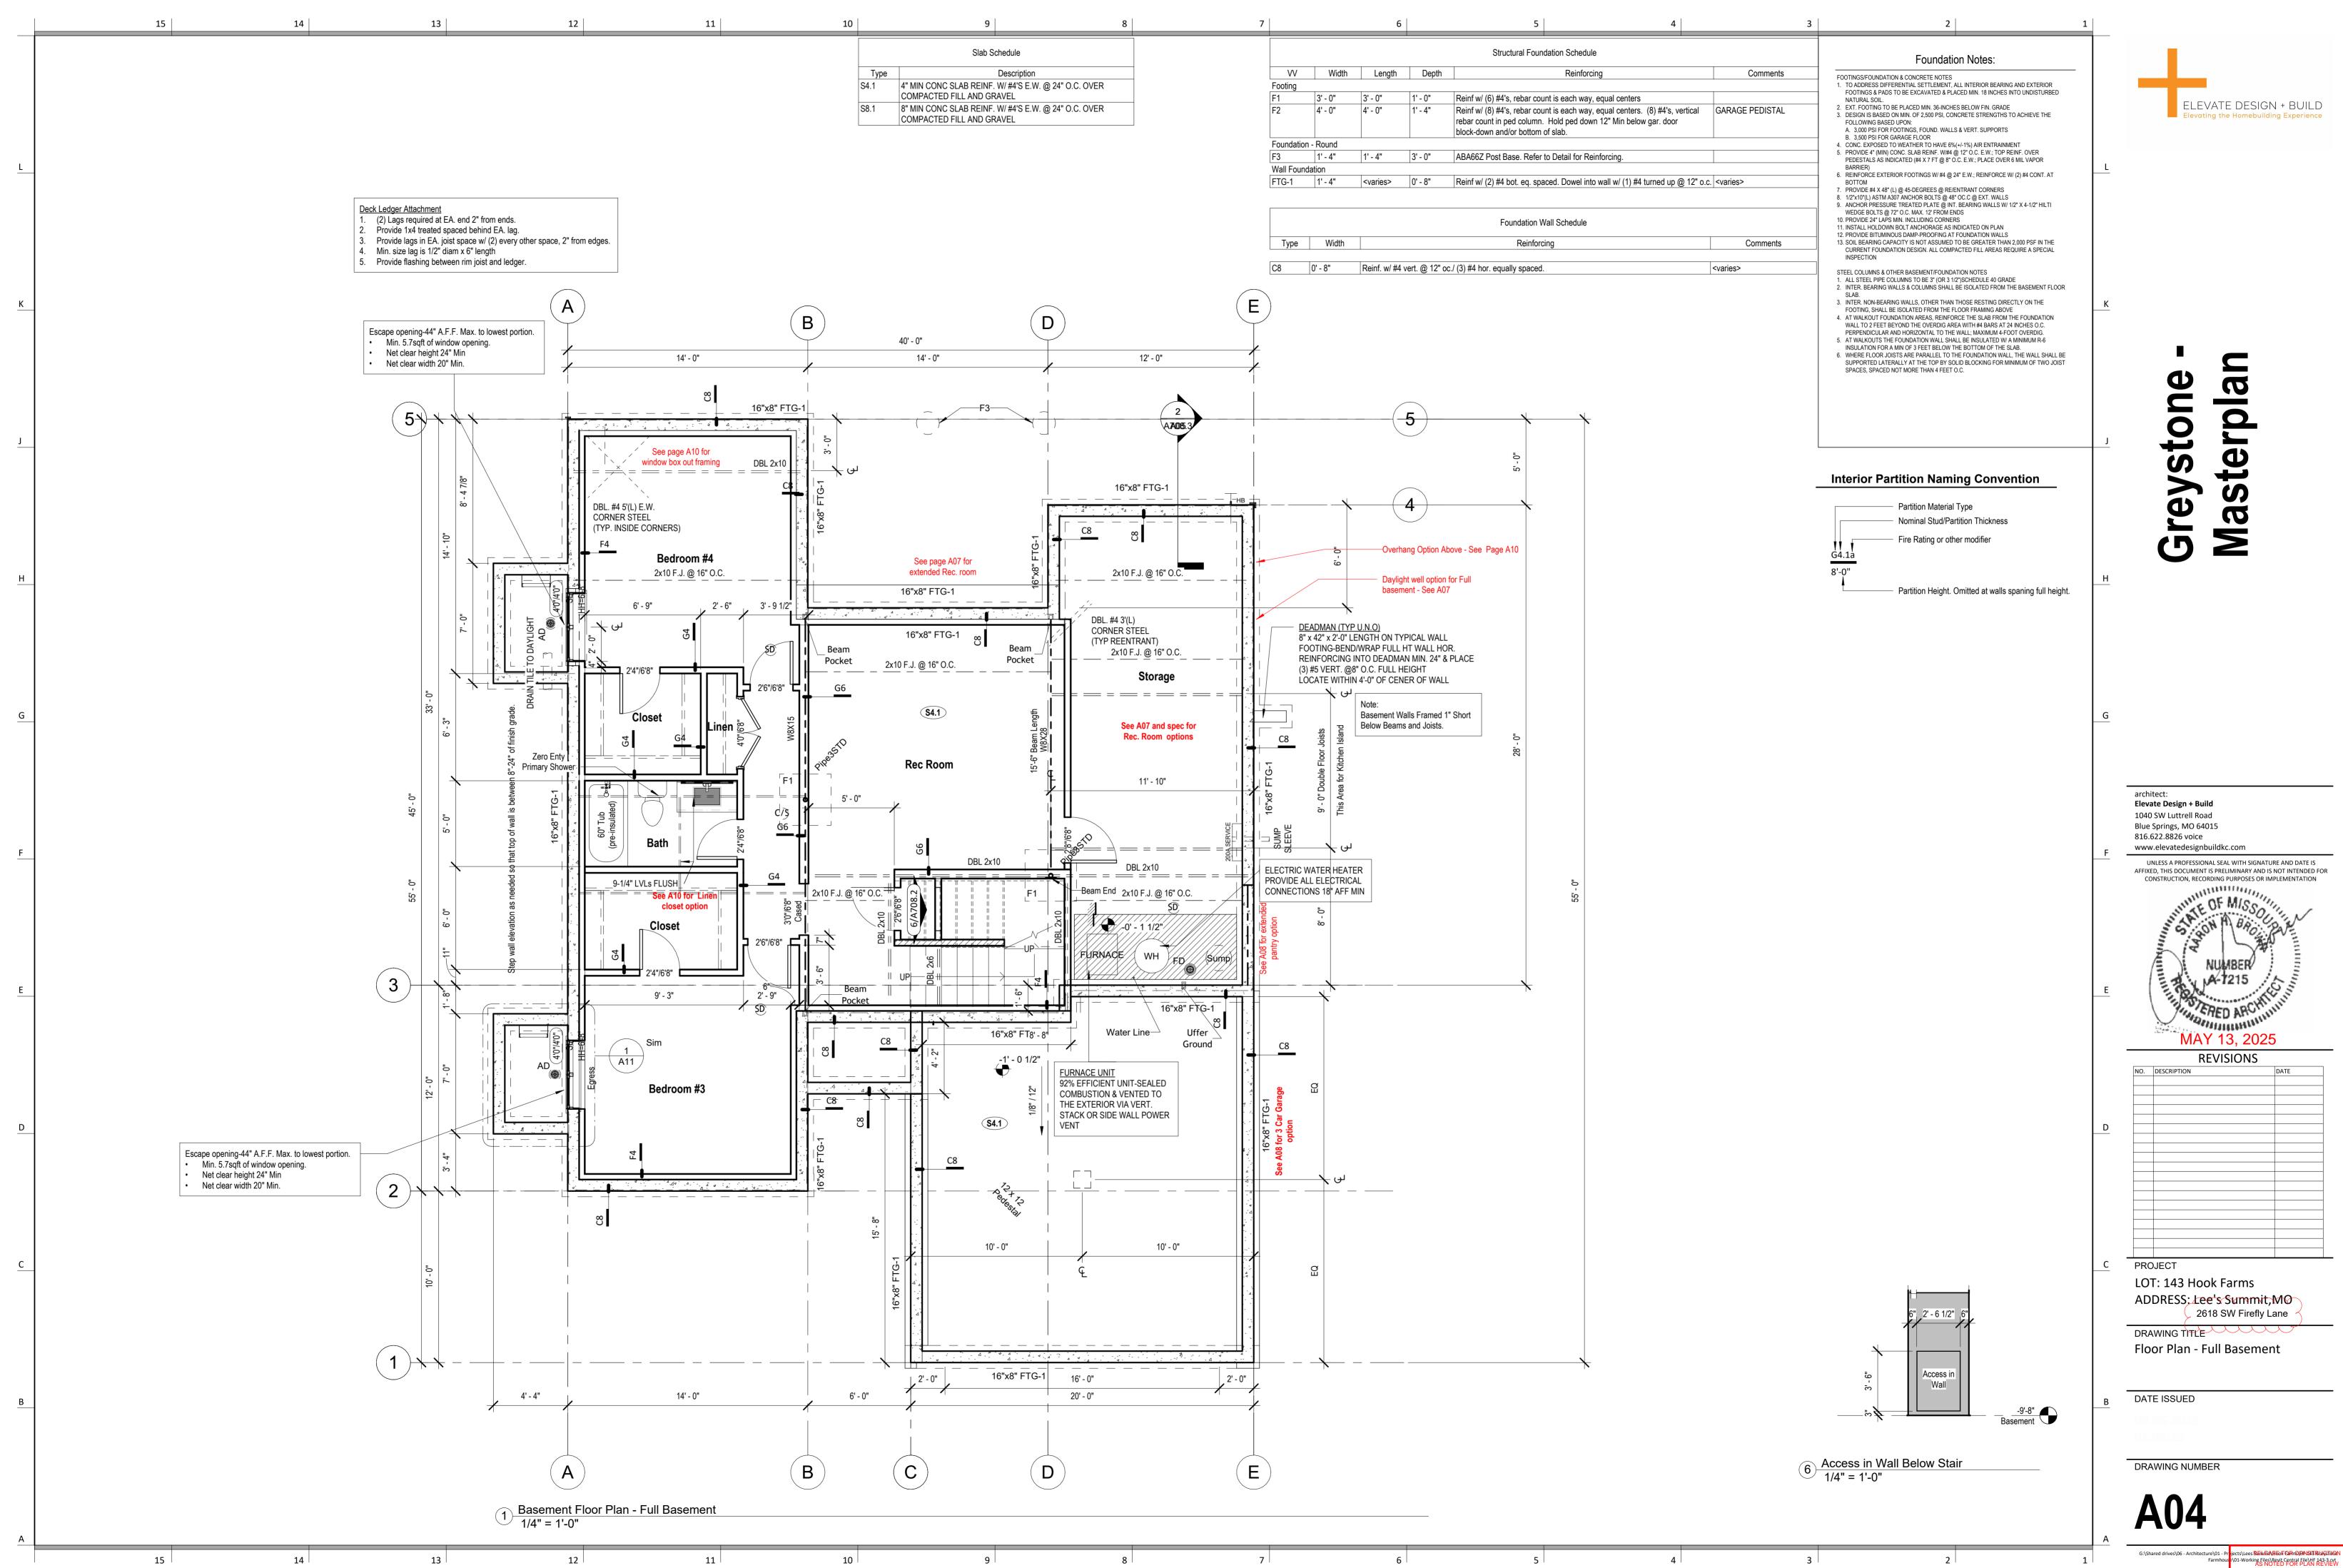




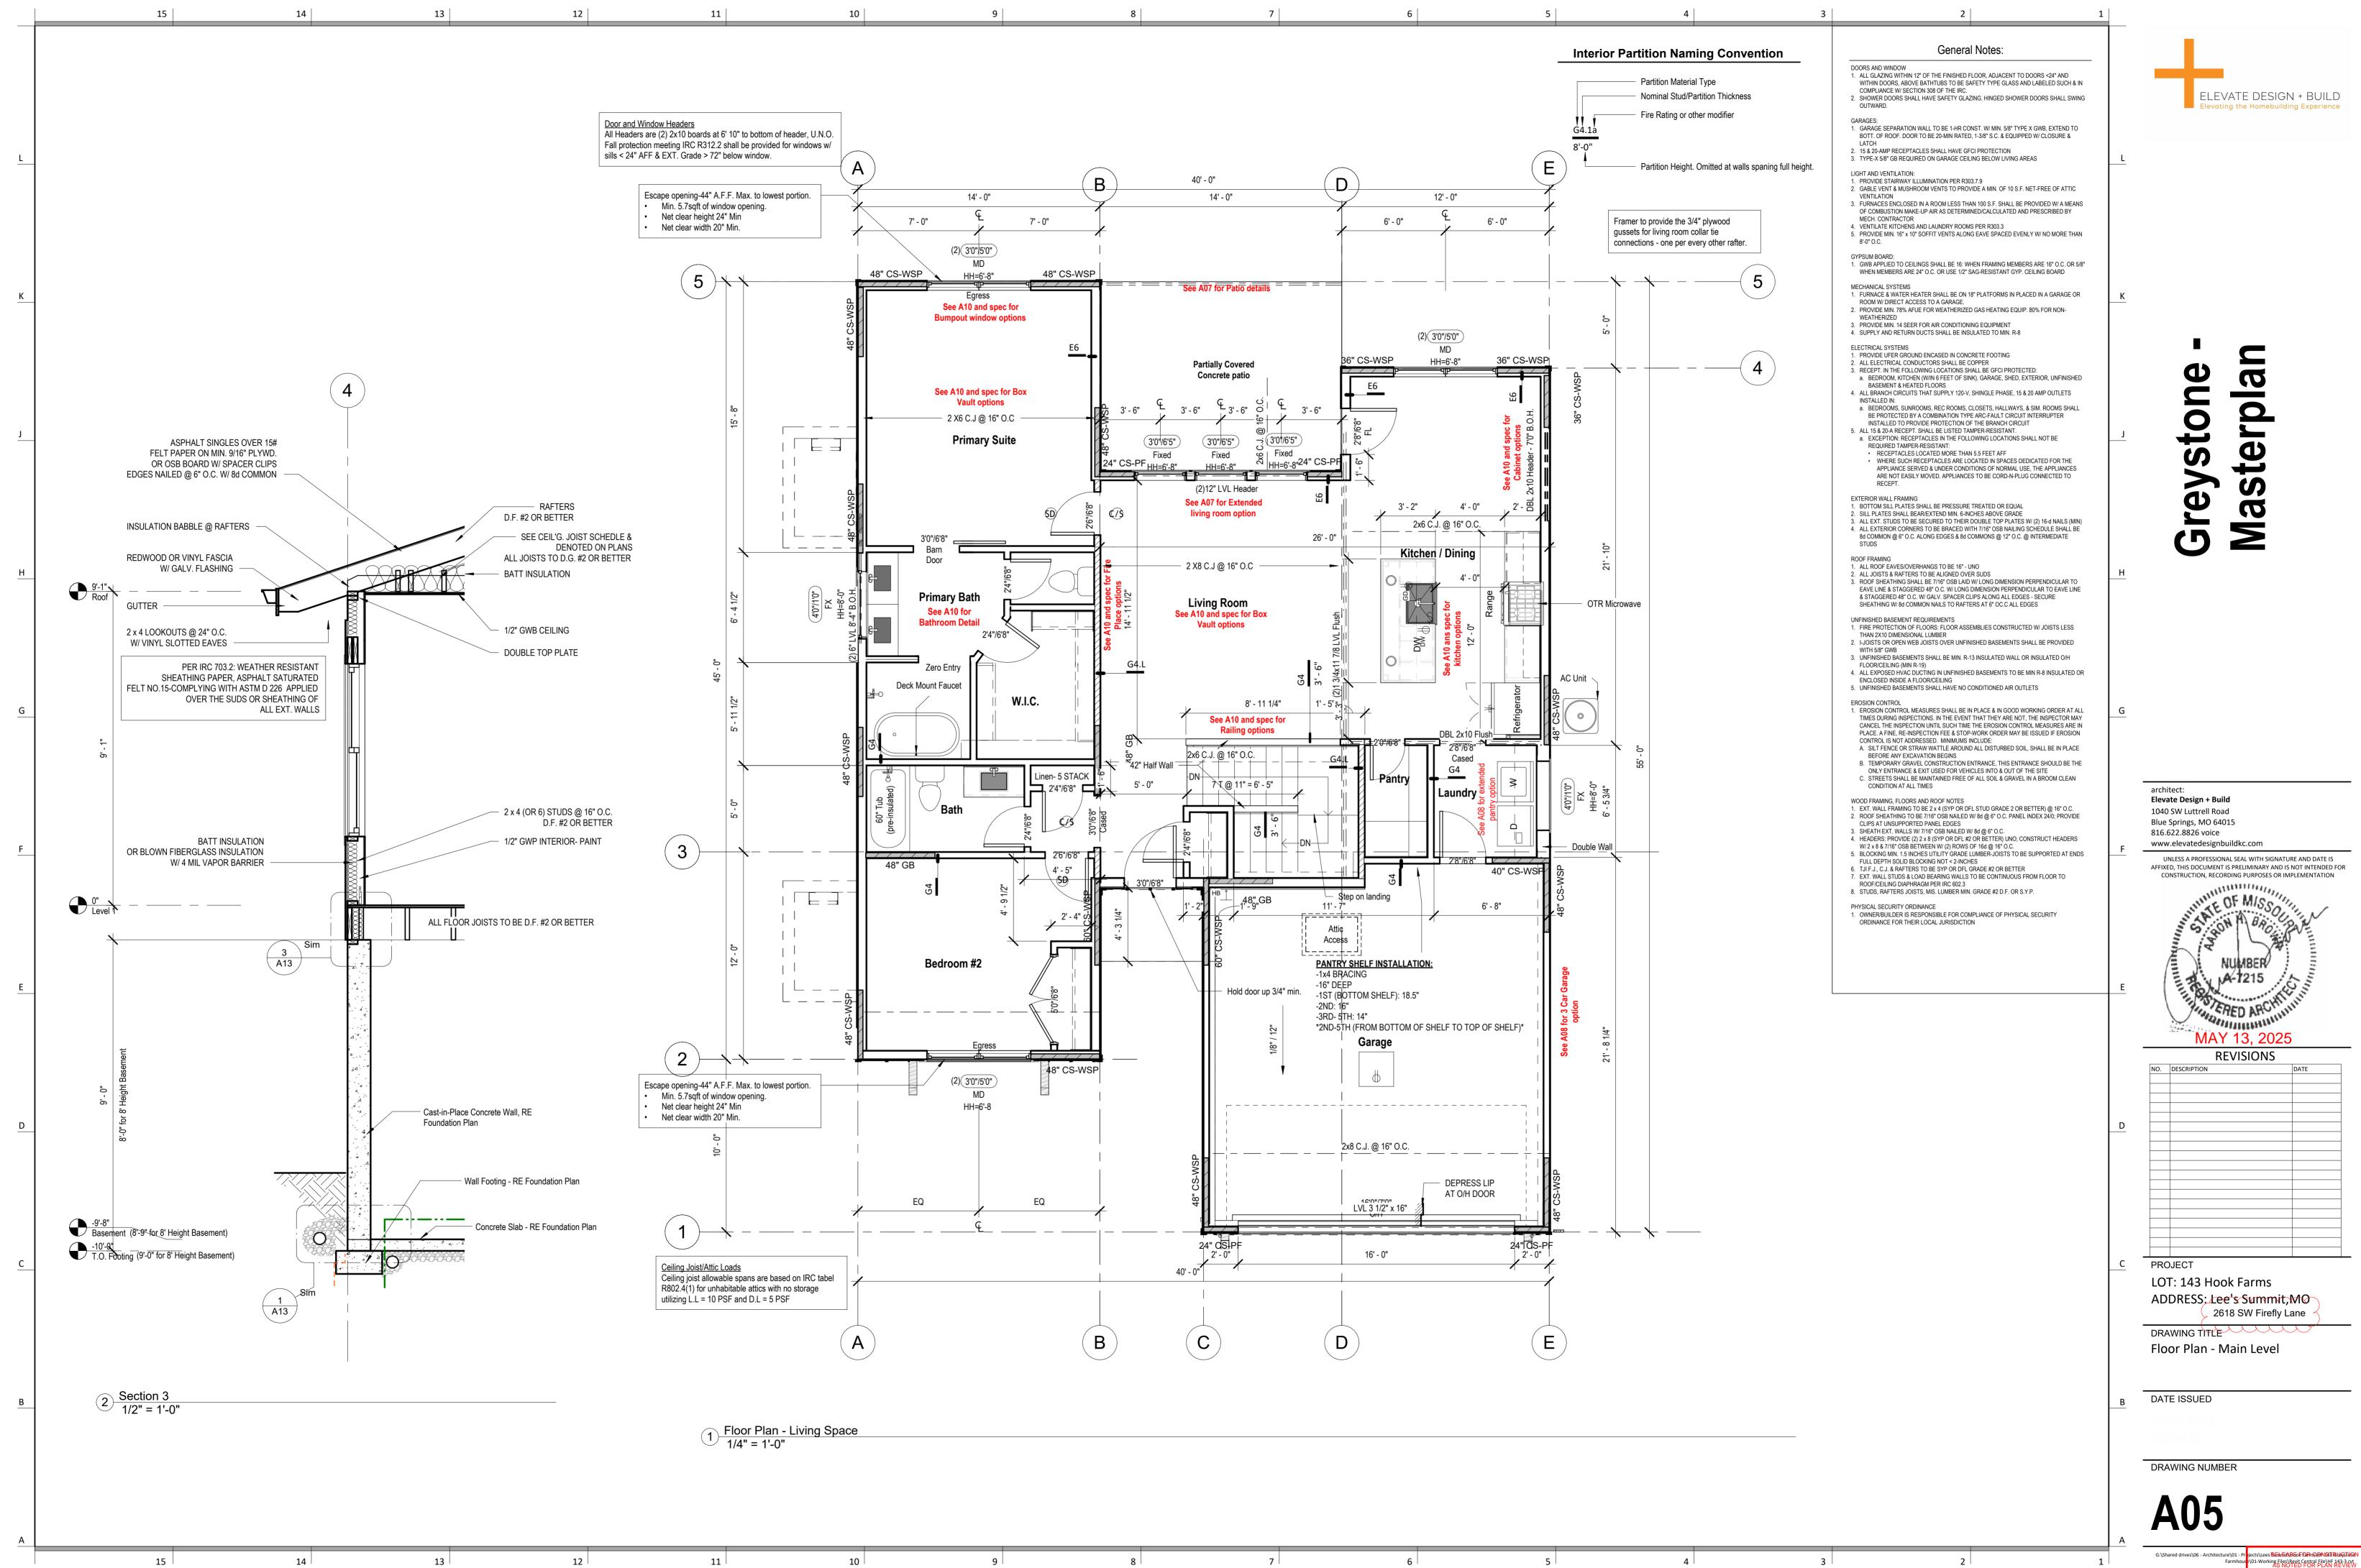
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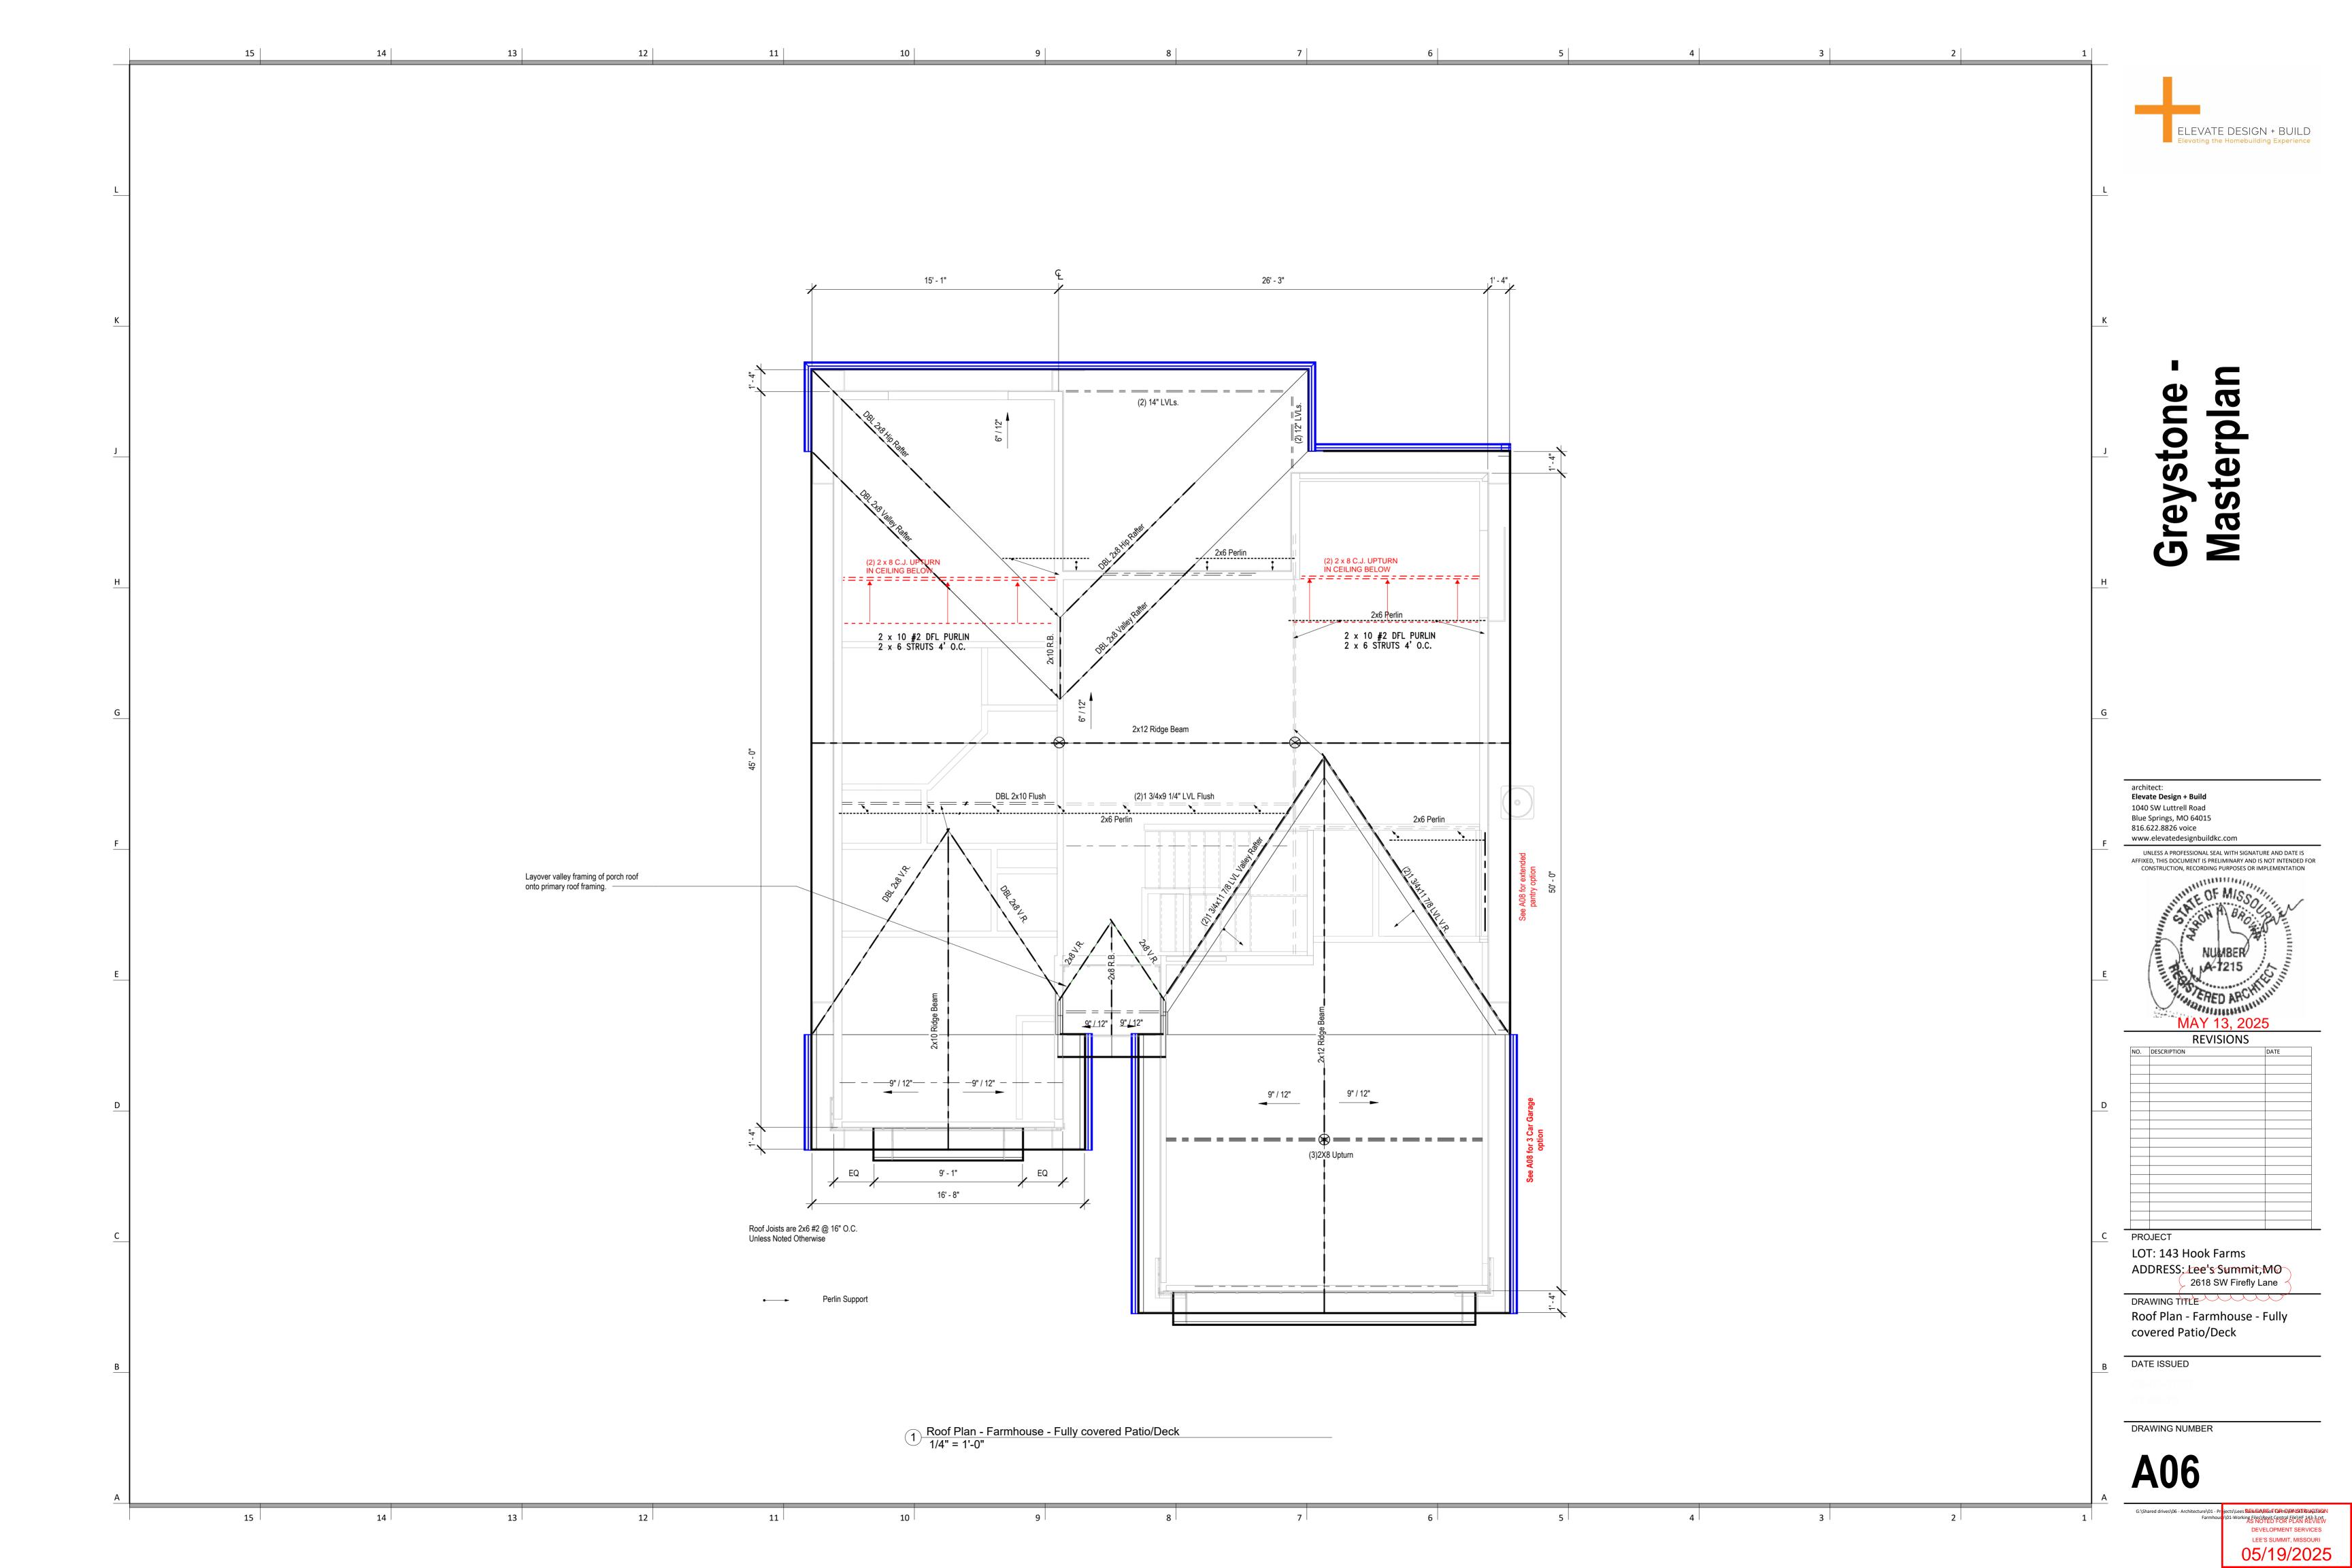


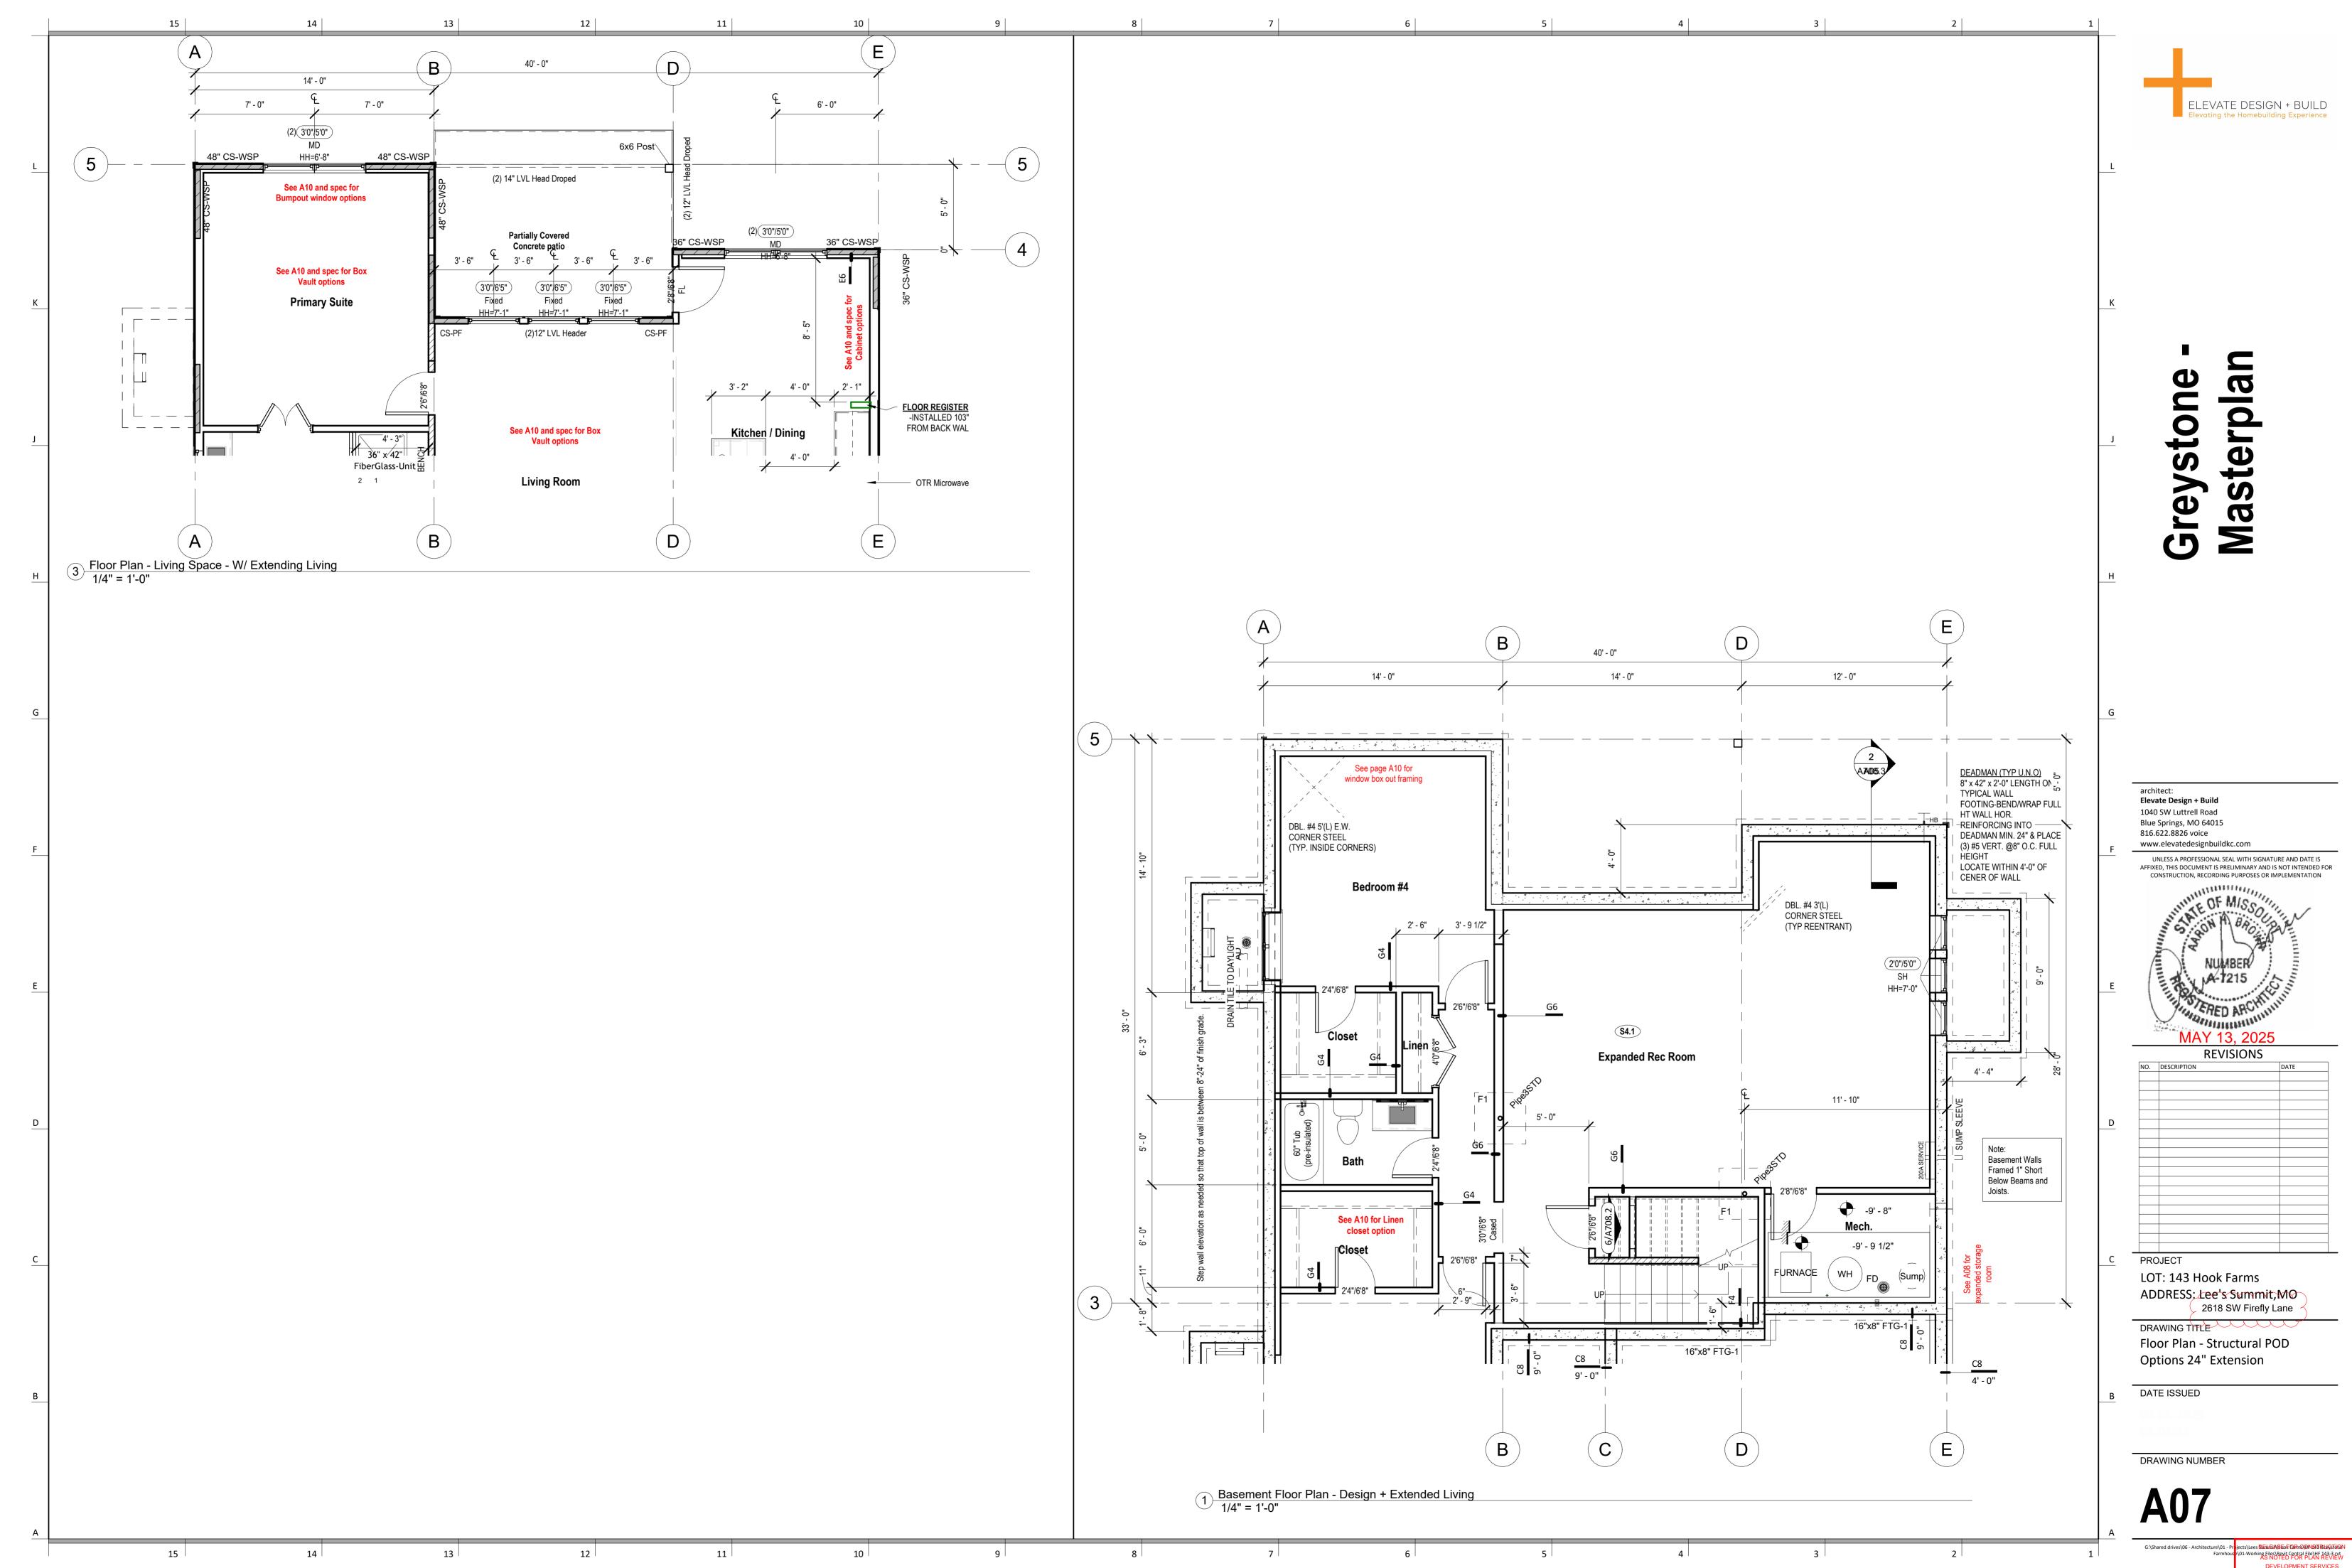
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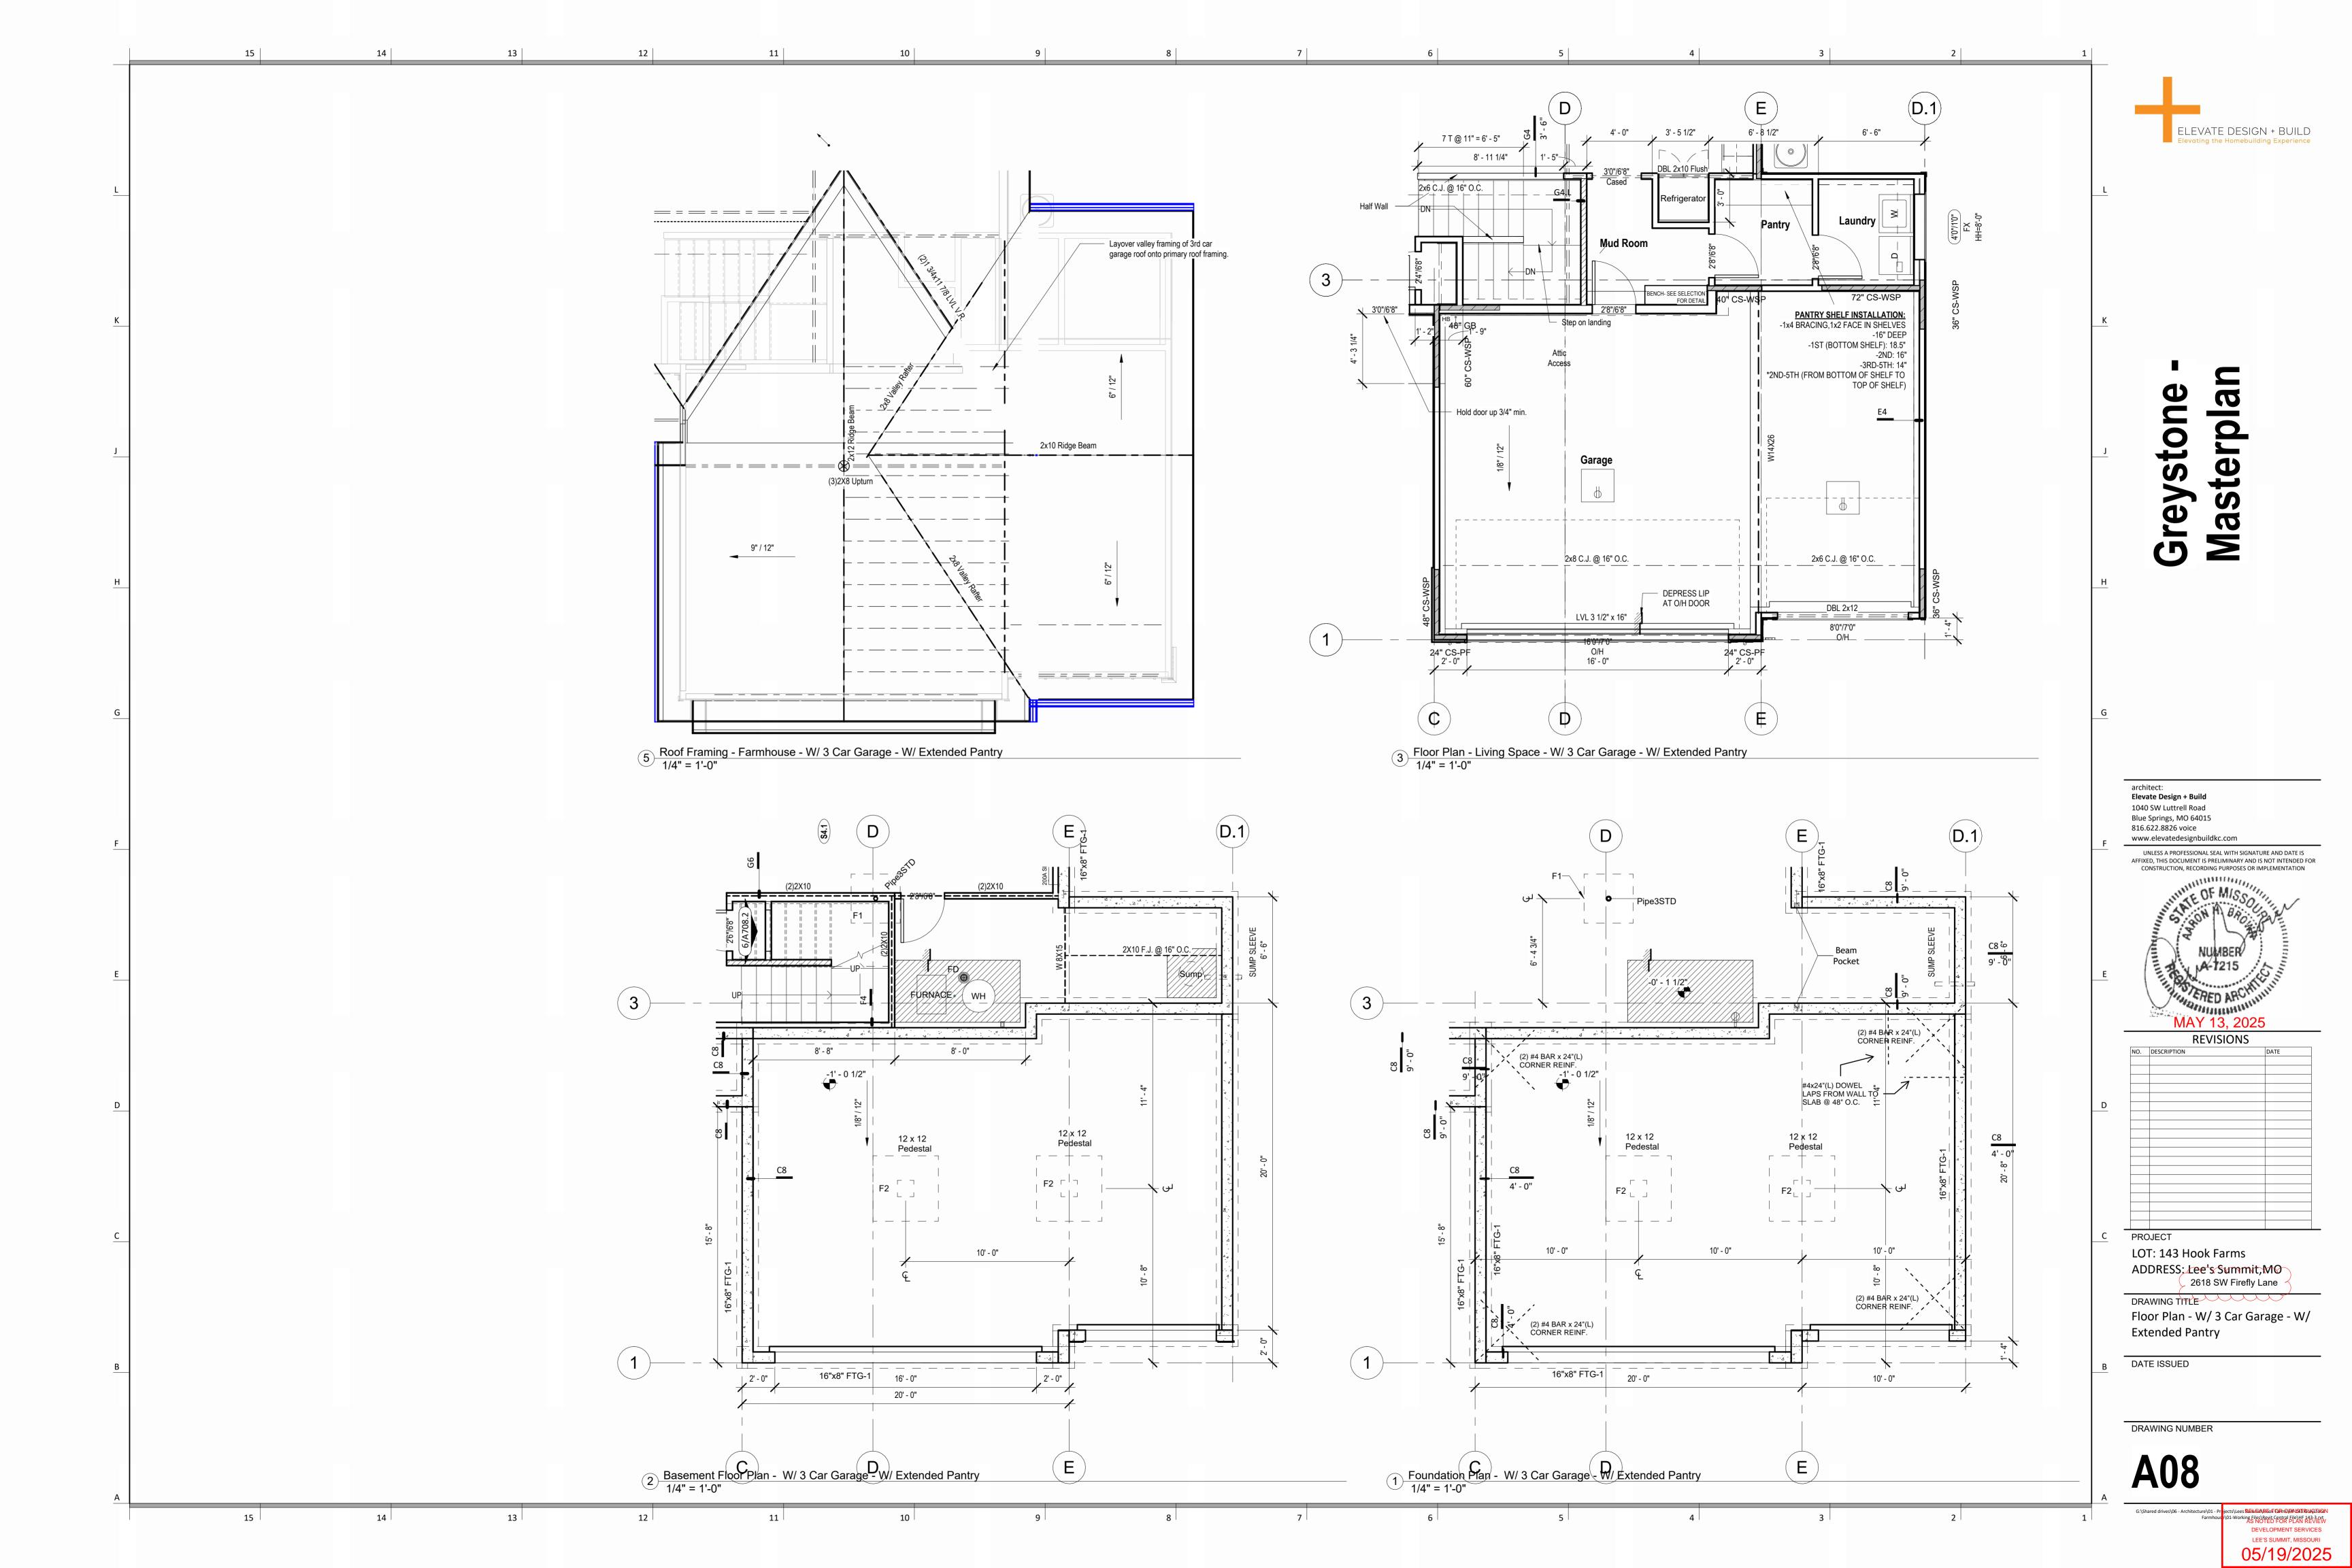
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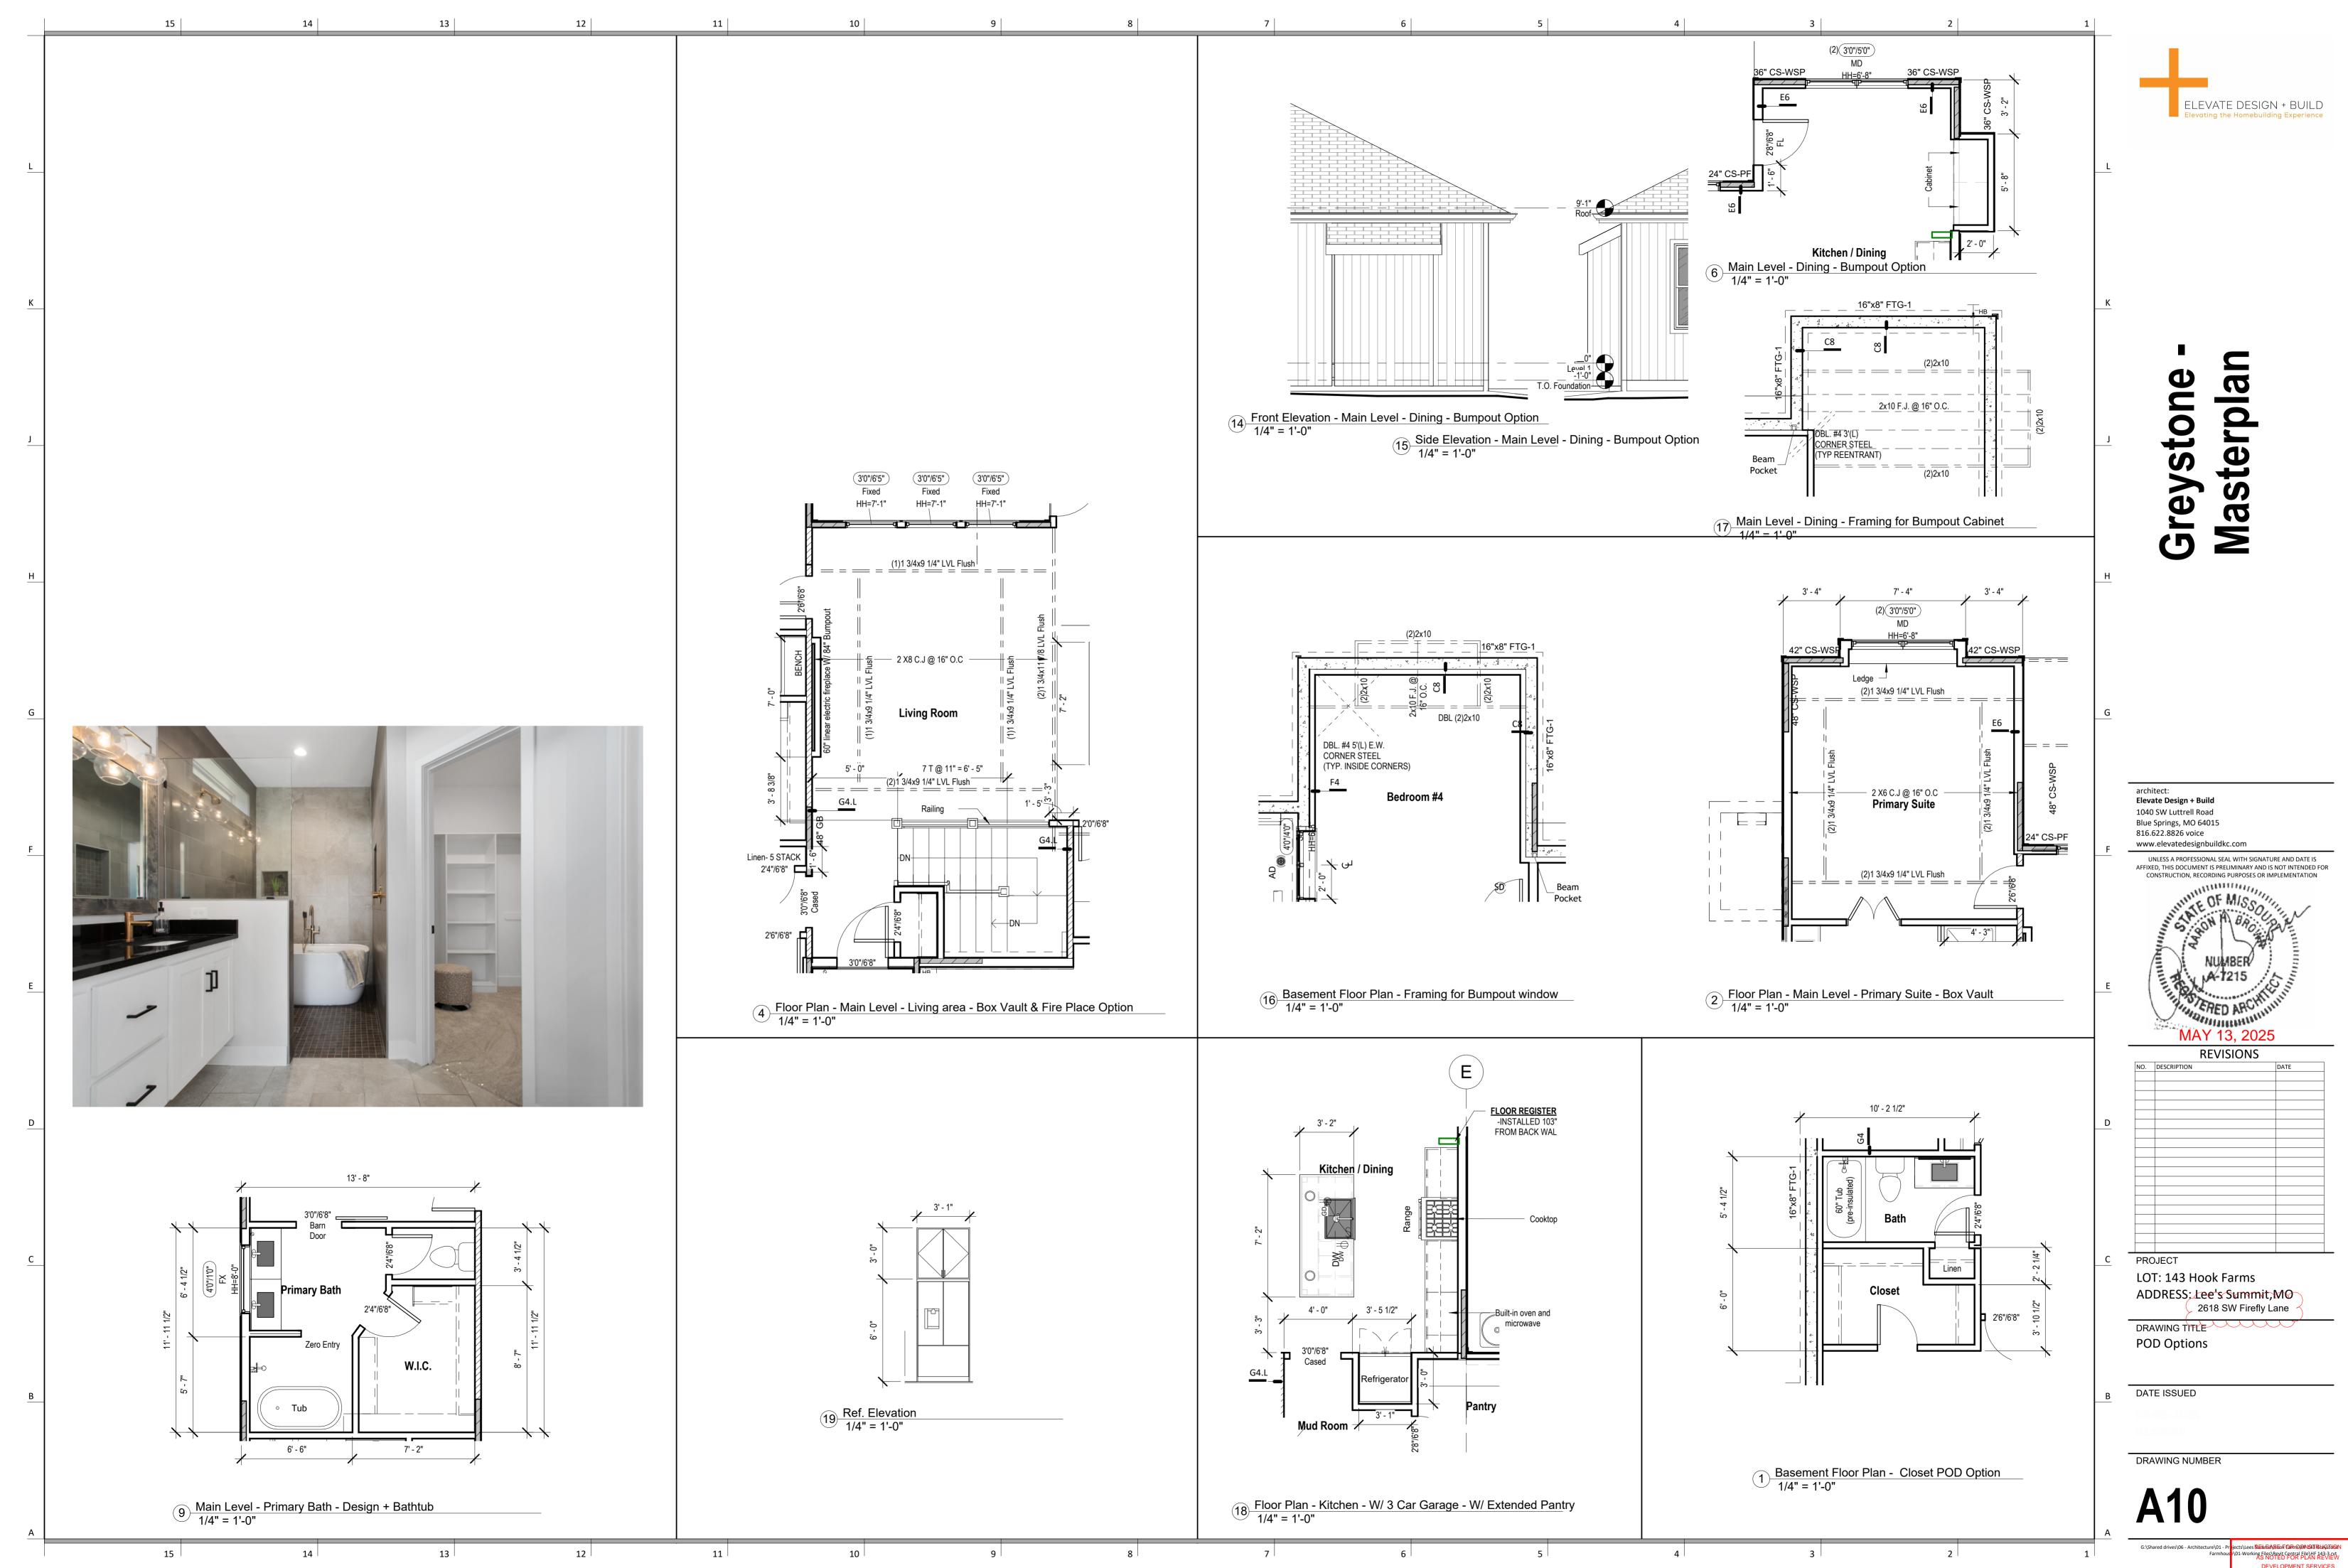
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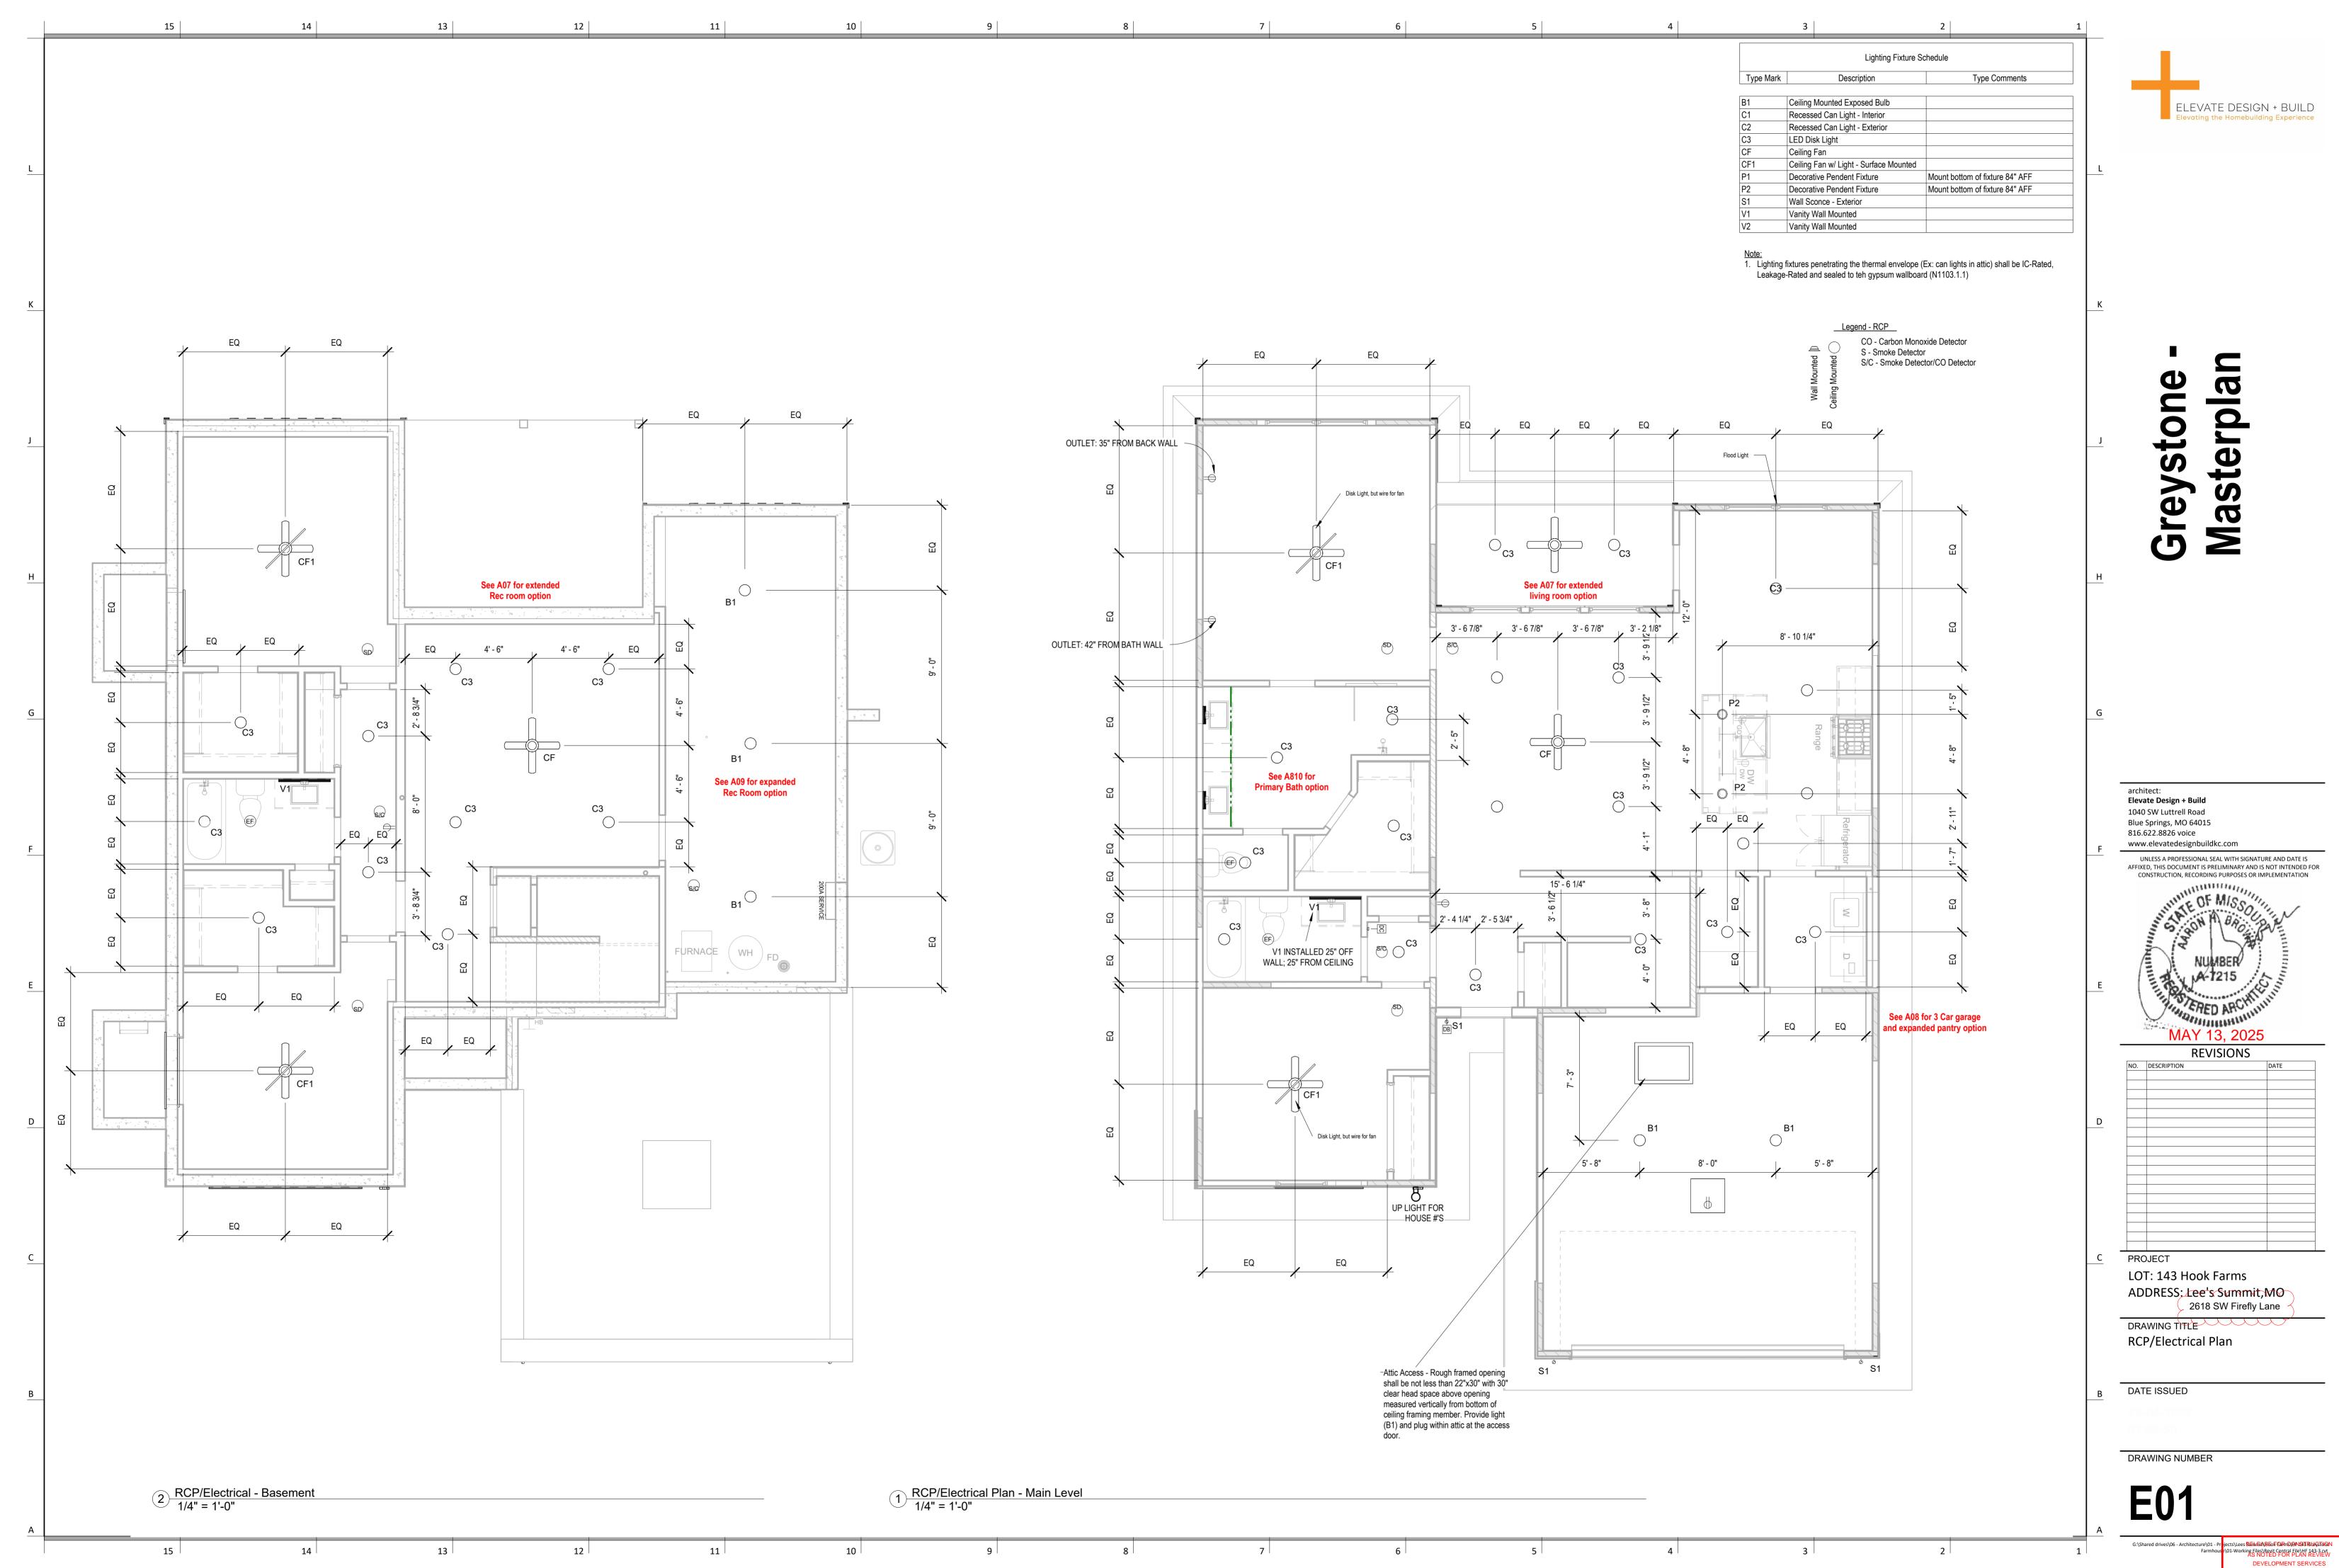


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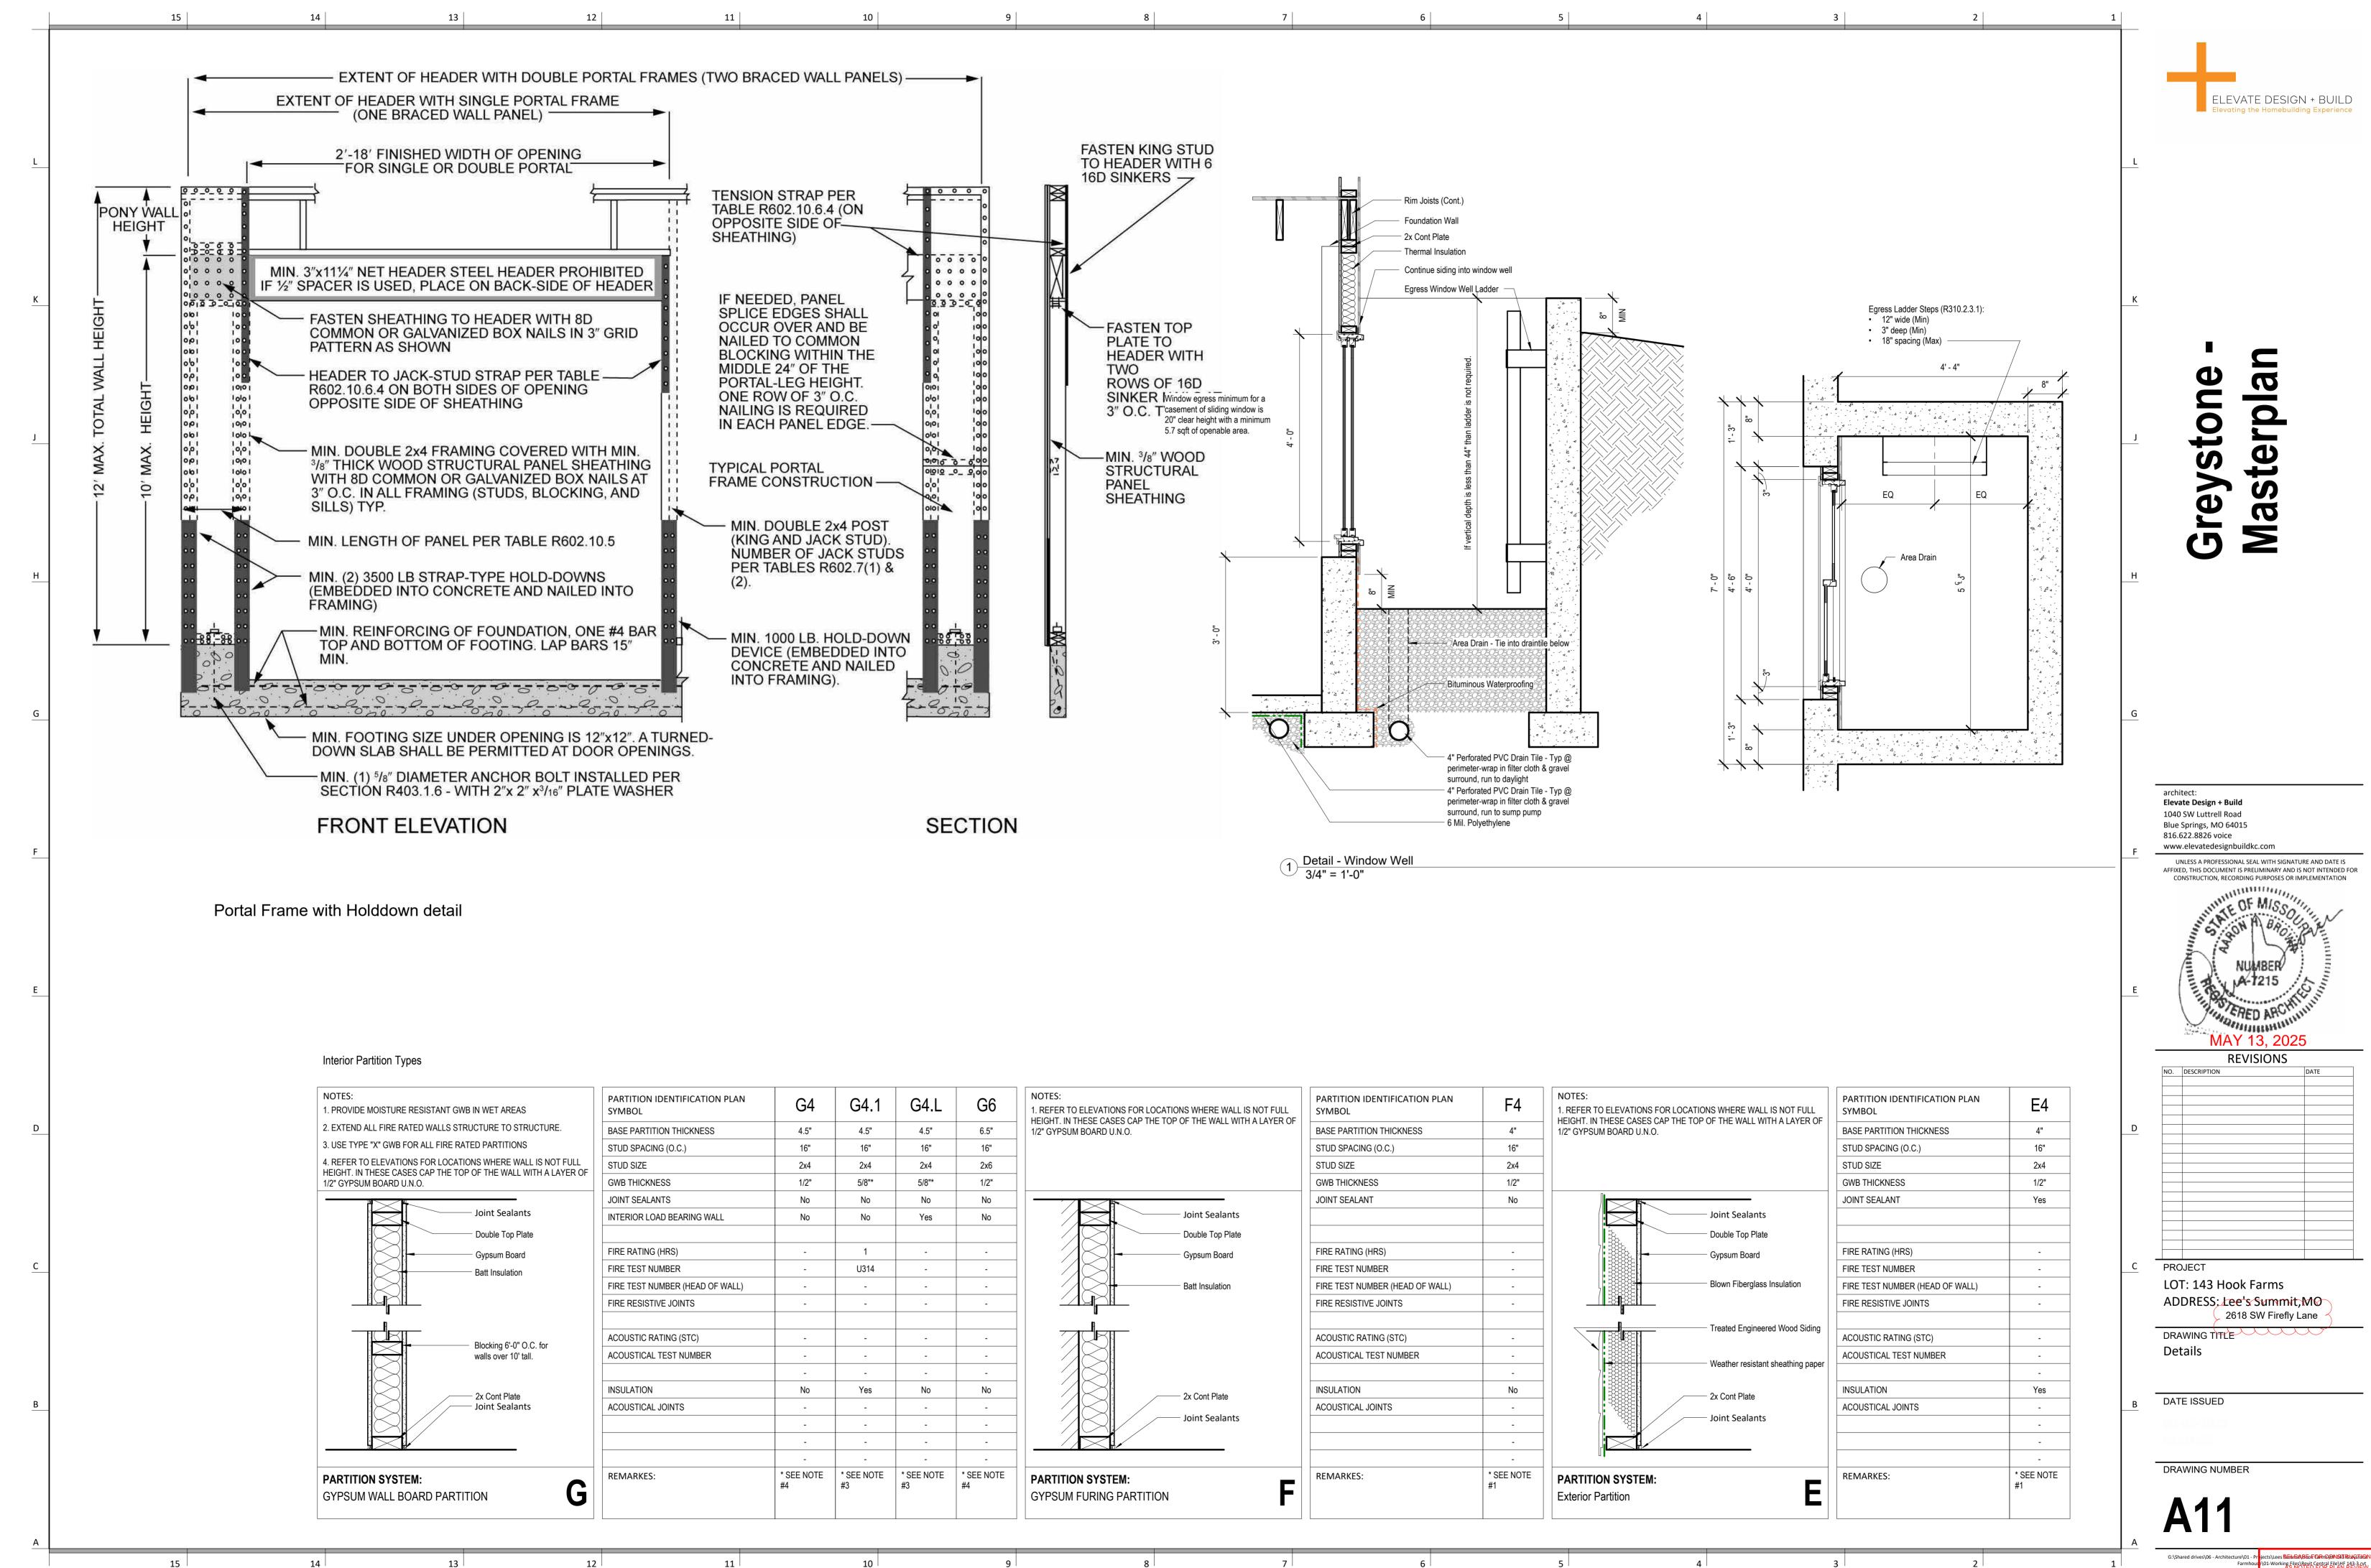


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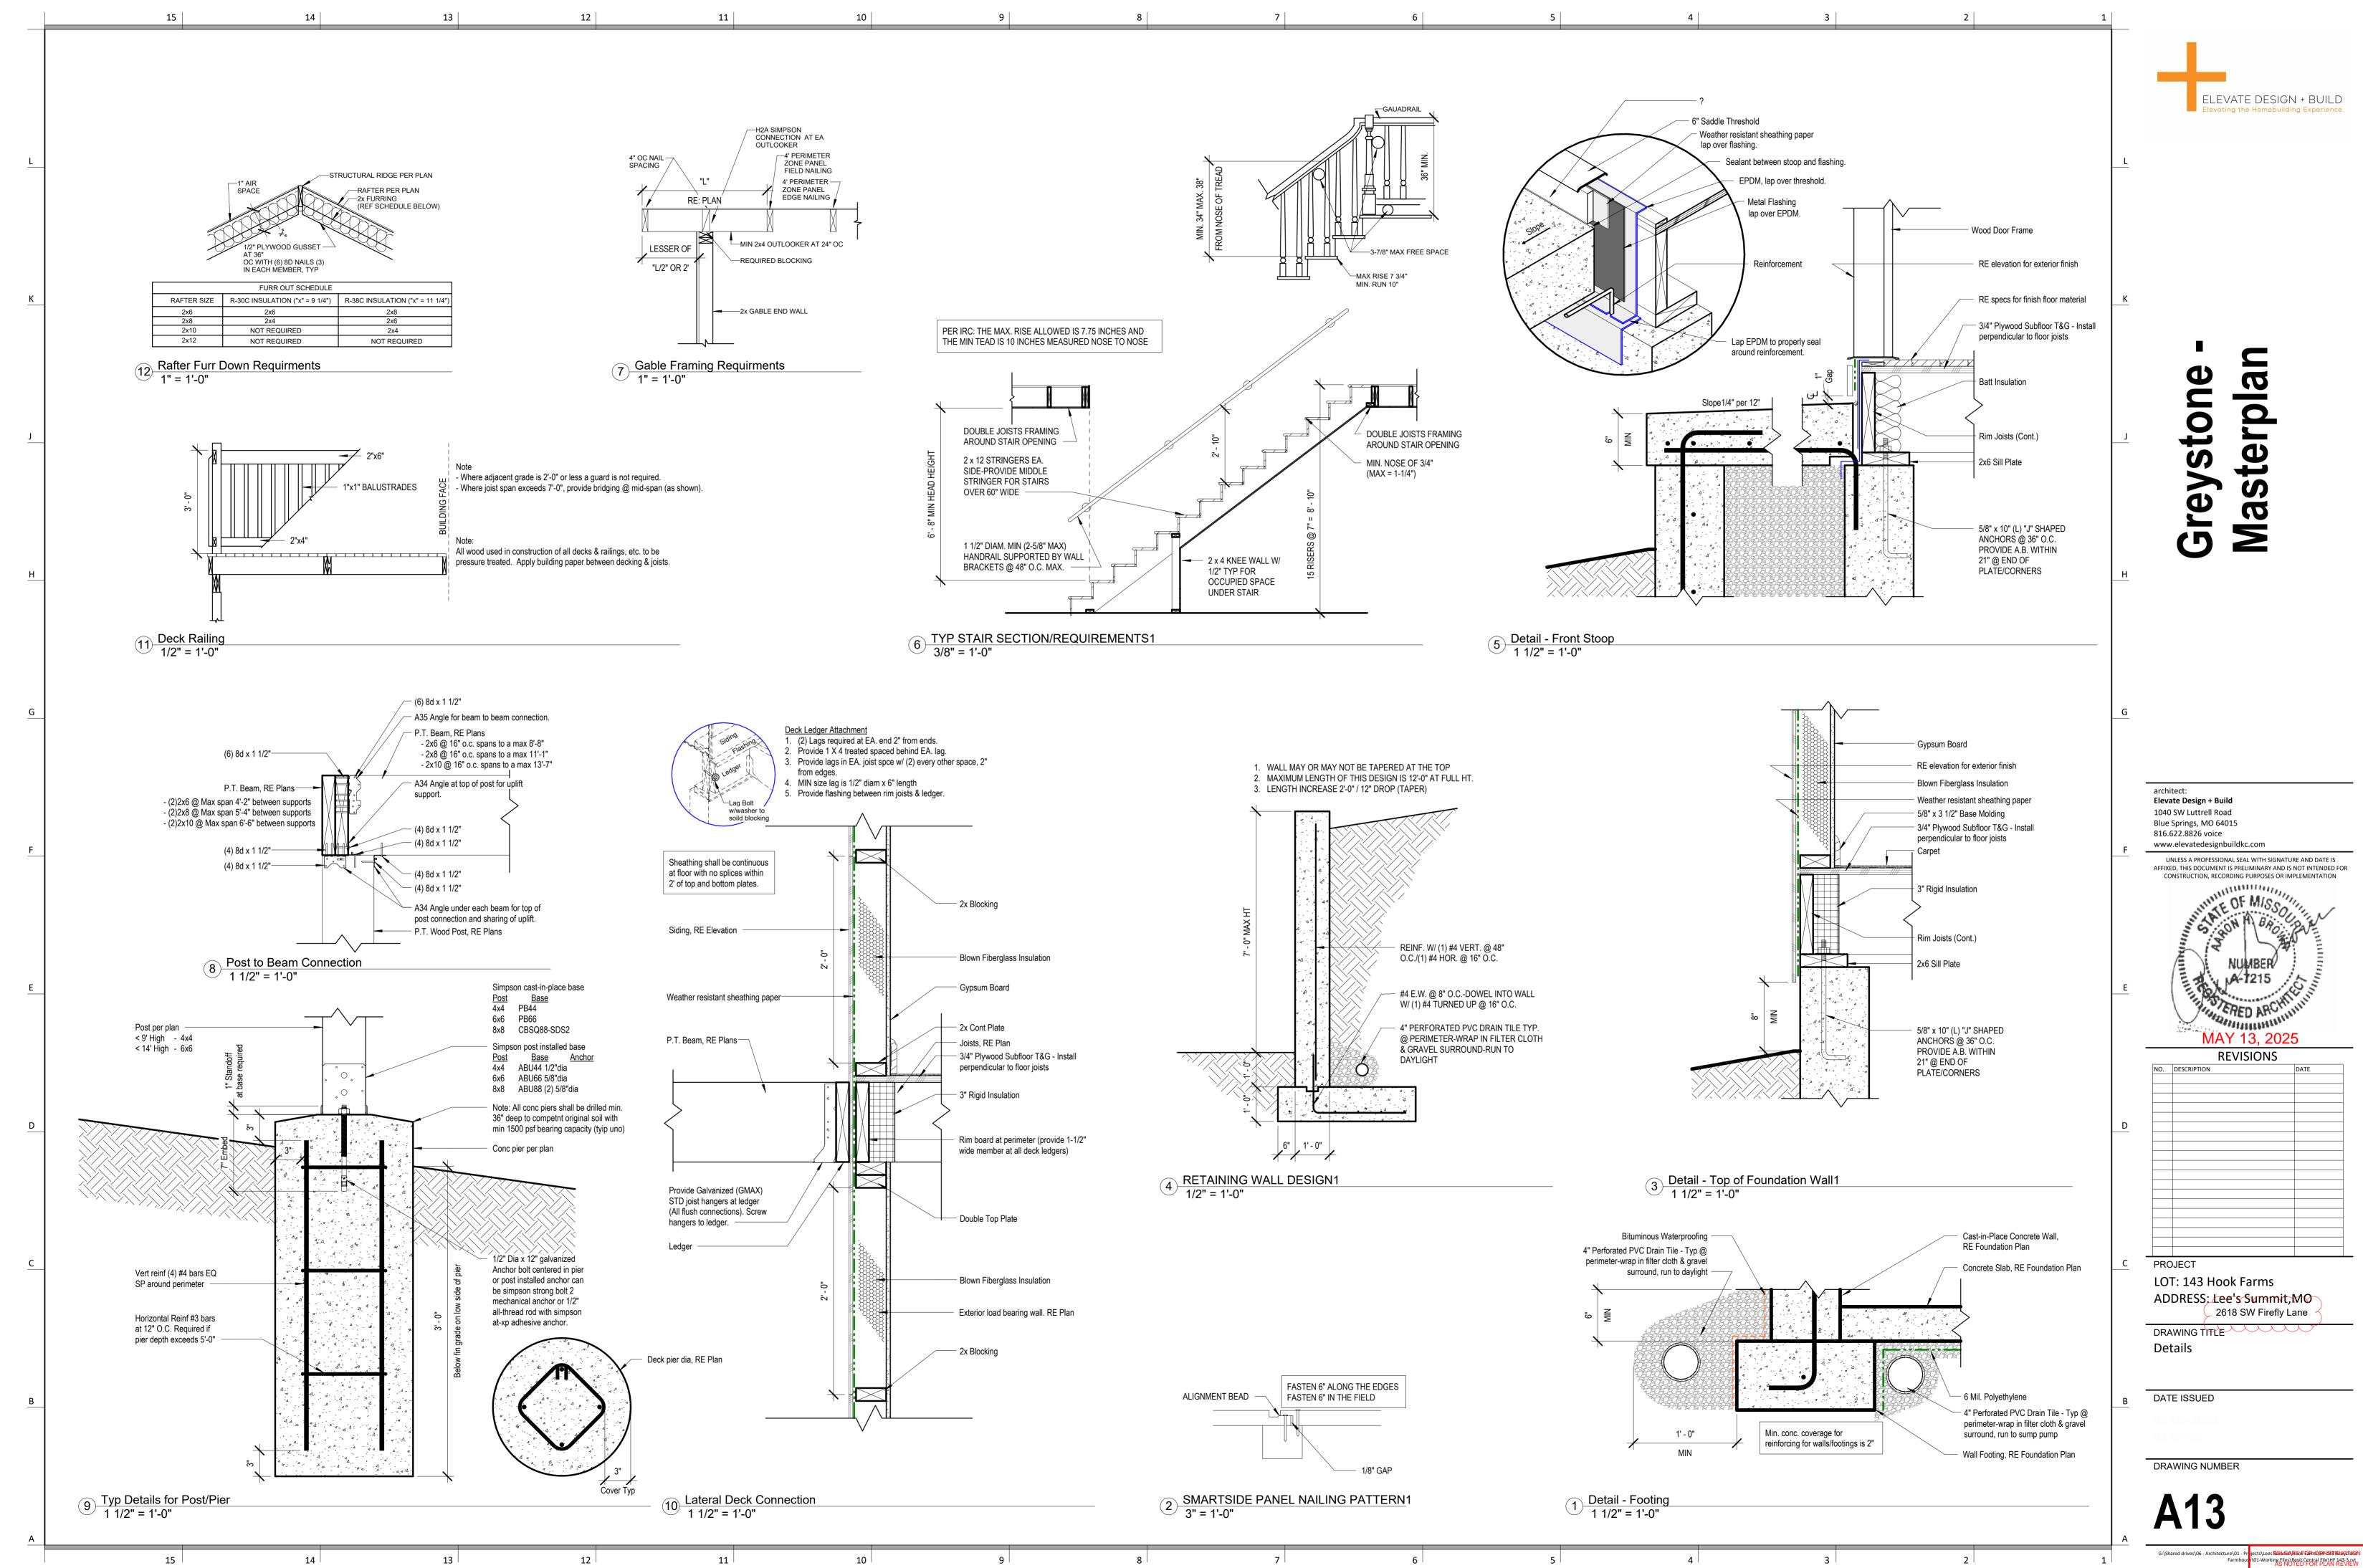
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