STRUCTURAL NOTES:

1. ALL CONSTRUCTION SHALL CONFORM TO 2018 INTERNATION RESIDENTIAL CODE OR ATTACHED ENGINEER SPECIFICATIONS WHERE APLLICABLE.

FOUNDATION NOTES:

- 1. ALL FOOTINGS MEET OR EXCEED MINIMUM FROST DEPTH OF 36". SOIL BEARING CAPACITY SHALL BE 1500 PSF. COMPRESSSIVE STRENGTH OF CONCRETE FC COMPRESSIVE STRENGTH SHALL BE DAMPPROOFED. DAMPPROOFING SHALL EXTEND FROM THE EDGE OF THE FOOTING TO THE FINISHED GRADE (R-406.1). METHOD OF DAMPPROOFING OR WATERPROOFING SHALL BE A MINIMUM 6-MIL. THICK MOISTURED BARRIER OVER POROUS GRAVEL BASE UNDER BASEMENT FLOOR SLAB PER R405.2.2. LAP JOINTS SHALL BE
- MINIMUM 6". FOUNDATION WALLS SHALL BE 4.
- DAMPPROOFED PER IRC SECTION R406. FOUNDATION DRAINAGE WILL BVE IN 5.
- ACCORDANCE WITH IRC SECTION R405.
- BASEMENT EGRESS OPENINGS SHALL BE IN 6. ACCORDANCE WITH IRC SECTION R310.1.
- ALL INTERIOR FOOTINGS OF LOAD BEARINGS 7. WALLS AND COLUMNS SHALL BE ISOLATED
- FROM THE BASEMENT FLOOR SLAB. ALL ANCHOR BOLTS SHALL NOT BE SPACED 8. MORE THAN 3' O.C. AND BE EMBEDDED INTO
- THE CONCRETE A MINIMUM OF 7".
- 9. IF BASEMENT SLAB ELEVATION IS ABOVE GRADE CONSULT ENGINEER.
- ALL EGRESS WINDOW HEADERS ON LOWER 10. LEVEL TO BE (2)2X10 UNLESS OTHERWISE NOTED.
- 11. ALL LOWER LEVEL FRAMED WALLS TO BE BRACED USING CS-WSP FOR THEIR ENTIRE LENGTH.

DEAD MAN SPACING:

- ALL DEAD MAN SHALL BE SPACED NO MORE 1. THAN 16' FROM EGRESS WELL, REAR GARAGE WALL, 24" RETURN ON FOUNDATION WALL OR ANOTHER DEAD MAN.
- DEAD MEN ARE NOT REQUIRED ON 2.
- EXTERIOR GARAGE WALLS OR FOUNDATION WALLS THAT ARE 5' OR LESS. WALL TRANSITIONING FROM ELSS THAN 5' 3. TALL TO MORE THAN 5' TALL WITH STEP DOWNS: A DEAD MAN IS REQUIRED WITHIN 8'
- OF STEP DOWN (tRANSITIONING FROM LESS THAN 5' TALL TO MORE THAN 5' TALL WALL LOCATION) ON WALL 5' TALL OR MORE.

ALL NON TREATED LUMBER SIZES ARE DOUGLAS FIR-LARCH #2 OR SOUTHERN YELLOW PINE #1 UNLESS OTHERWISE NOTED


ALL TREATED/ROT RESISTANT LUMBER SIZES ARE #2 TREATED SOUTHERN YELLOW PINE, UNLESS OTHERWISE NOTED

8'-0" FOUNDATION WALL EXCEPT AT STEP DOWNS TO BE LOCATED IN THE FIELD

UNBALANCED FILL NOT TO EXCEED 4'-0" AT UNRESTRAINED WALLS

ALL FOOTING TO BE BELOW FROST LINE (3'-0") AS REQUIRED PER SITE

ISOLATED FOOTINGS AND COLUMN PADS						
SYM F	PIER SYM PAD SIZE DEPTH		R	MINIMUM EINFORCEMENT GRADE 40 KSI STEEL	SCHEDULE 40 STEEL COLUMN, MIN FY = 35 KSI	
	30"x30"	1'-0"		(5) #4 BAR E.W.	3" DIAMETER	
B	36"x36"	1'-0"		(6) #4 BAR E.W.	3" DIAMETER	
	42"x42"	1'-2"		(7) #4 BAR E.W.	3" DIAMETER	
	48"x48"	1'-4"		(8) #4 BAR E.W.	3" DIAMETER	
E	54"x54"	1'-4"	(9) #4 BAR E.W.		3.5" DIAMETER	
F	60"x60"	1'-6"	(10) #4 BAR E.W.		3.5" DIAMETER	
ISOLATED FOOTINGS AND COLUMN PADS			*DENOTES STEEL COLUMN NOT REQUIRED			
SYM	PIER DIAMETEF	R DEP	ГΗ	COLUMN AND PAD SIZ MAXIMUM COLUMN HE COLUMNS GREATER T A SEPARATE ENGINEE	HEIGHT OF 10'. R THAN 10' REQUIRE EERED A-F SPACING OF	
G	12"	3'-0	"	DESIGN. FOOTINGS A- 6" O.C. WITH 3" CLEAR		
Ĥ	16"	3'-0	"		2	
\bigcirc	18"	3'-0	"			
K	24"	3'-0	"			
\bigtriangleup	28"	3'-0)"			

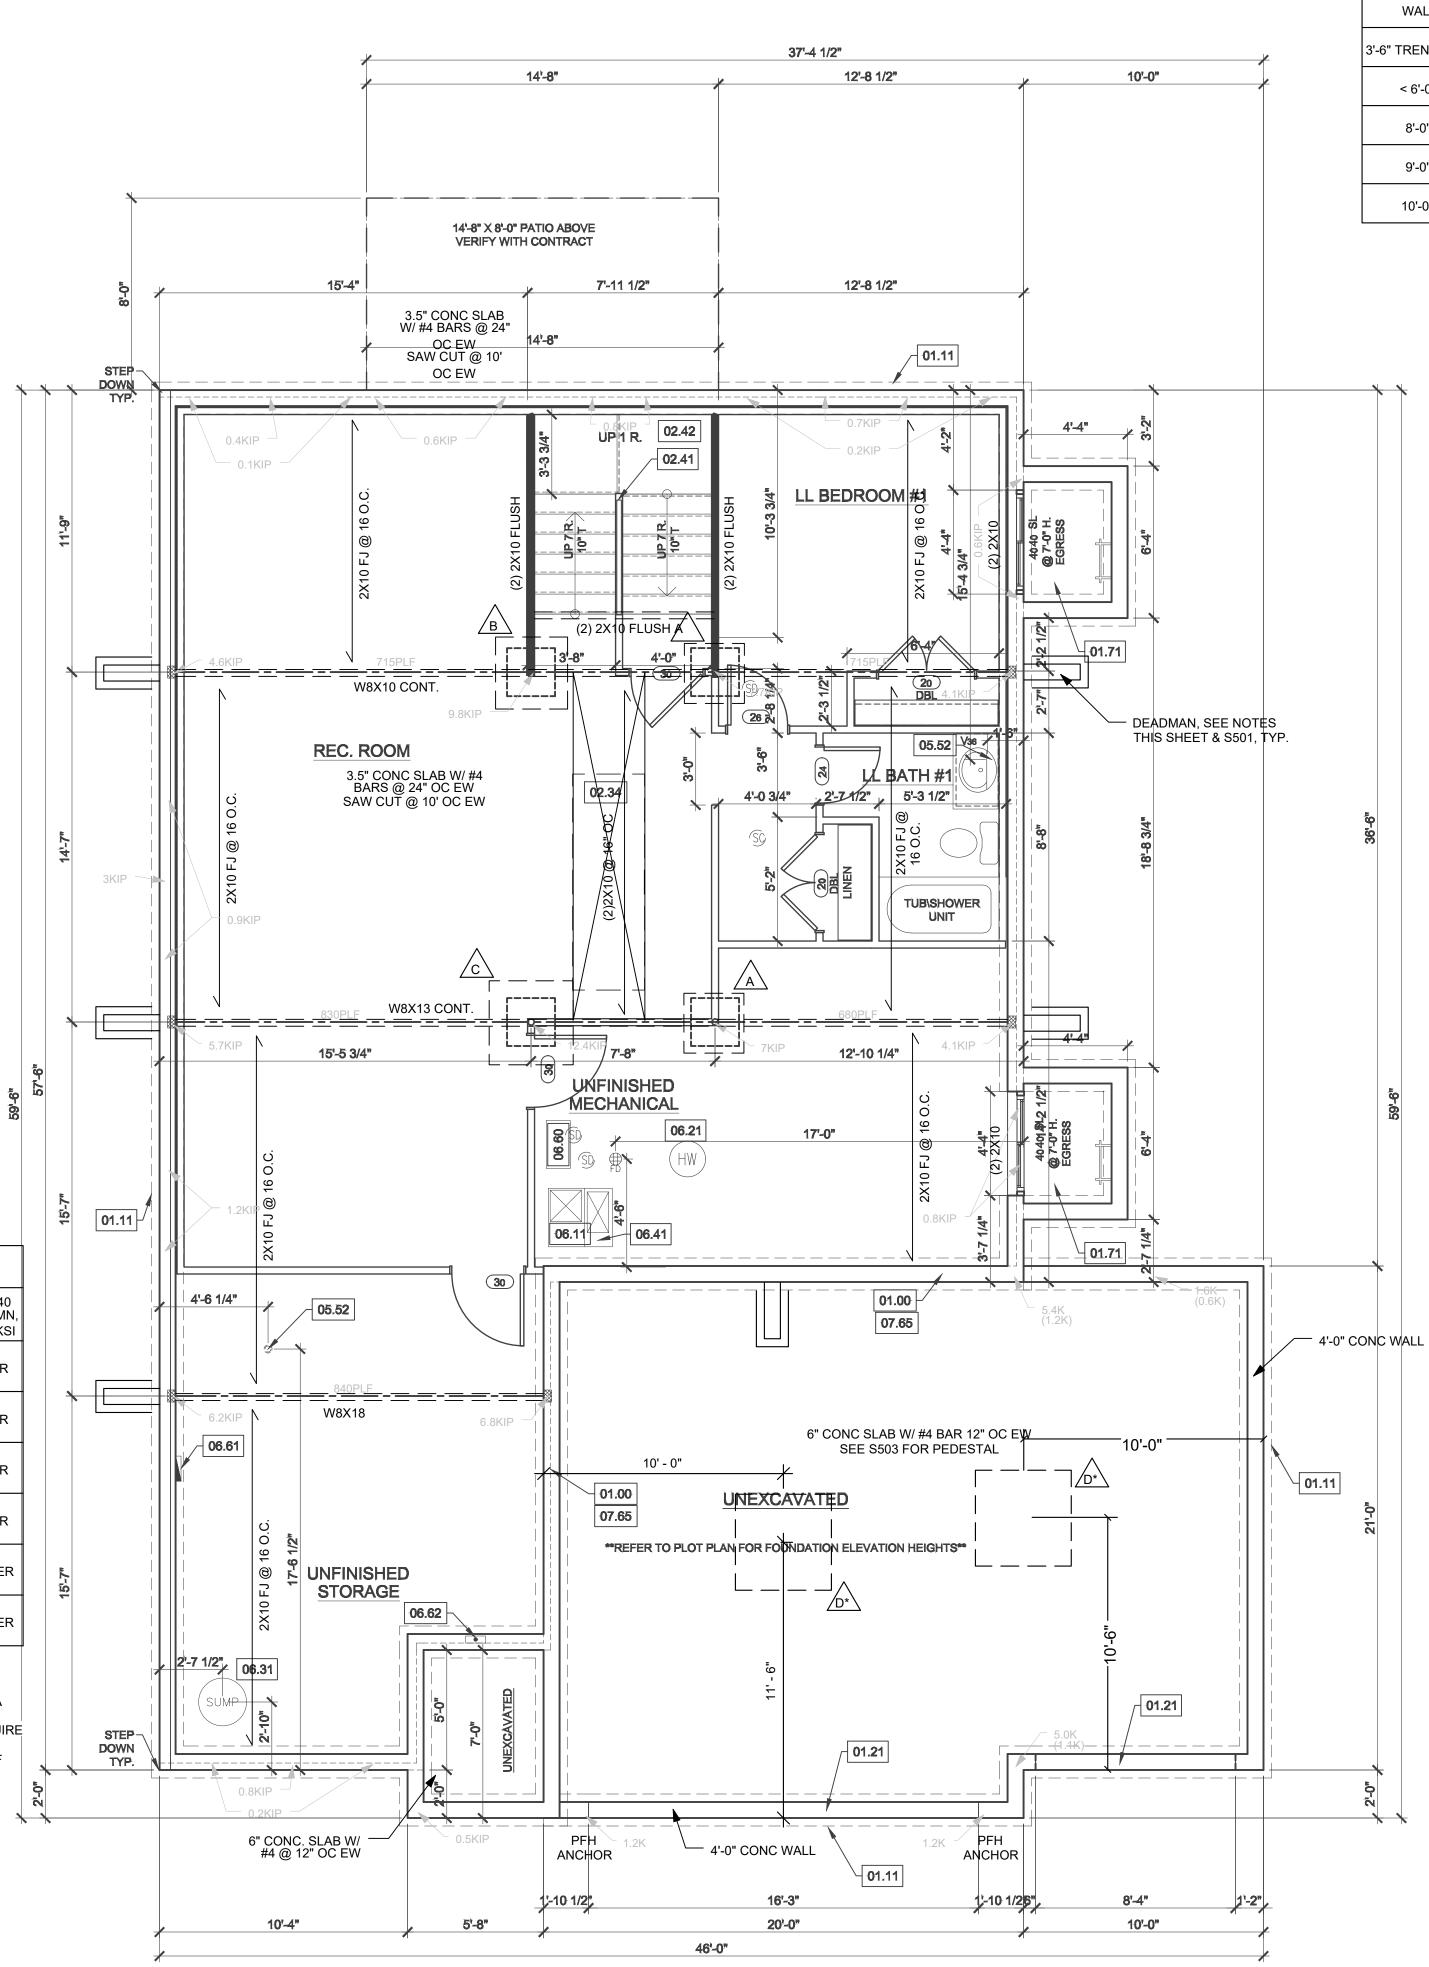

FOUNDATION WALL AND FOOTING TABLE (3000 PSI CONCRETE AND 40 F FROM INSIDE TENSION FACE)				
WALL TYPE	NOMINAL WALL THICKNESS	VERTICAL SPACING AND SIZE	HORIZONTAL SPACI AND SIZE	
3'-6" TRENCH FOOTING	16"	#4 BARS @18" O.C.	(2) #4 BARS TOP & BOT. CONT.	
< 6'-0" WALL		#4 BARS @36" O.C.		
8'-0" WALL	0"	#4 BARS @16" O.C.		
9'-0" WALL	8"	#4 BARS @12" O.C.	#4 BARS @ 24" O.C	
10'-0" WALL		#4 BARS @8" O.C.		

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	WINDOW	/ SC	HED	J
TYPE	STYLE	WIDTH	HEIGHT	٦
SL	BASEMENT EGRESS SLIDER	4'-0"	4'-0"	

	DOOR SCHEDULE				
STYLE	WIDTH	HEIGHT	FRAME DEPTH		
HINGED - DOUBLE	4'-0"	6'-8"	4 1/2"		
HINGED - SINGLE	3'-0"	6'-8"	4"		
HINGED - SINGLE	2'-6"	6'-8"	4 1/2"		
HINGED - SINGLE	2'-4"	6'-8"	4 1/2"		

FOUNDATION PL

TE AND 40 KSI REBAR PLACED 2"	REFERENCE KEYNOTES	CPG DBA
AND SIZE 4 BARS TOP & OT. CONT. 16" x 8" CONC. FTG. W/ (2) #4 BARS CONT. ARS @ 24" O.C.	 01 - FOUNDATION 01.00 - HOLD SILL PLATE BACK 2" 01.11 - CONTINUOUS CONCRETE FOOTING 01.21 - RECESS TOP OF FOUNDATION WALL 01.32 - 2X6 STUD WALL WITH TREATED SILL PLATE CONCRETE WINDOW WELL FOR EGRESS WITH 01.71 - LADDER. PROVIDE SLEEVE THROUGH WALL FOR FOUNDATION DRAIN. TOP OF WINDOW WELL TO BE 3" BELOW TOP OF FOUNDATION. 	HOMES A CLAYTON COMPANY 120 SE 30TH ST. LEE'S SUMMIT, MO 64082 816-246-6700
NOOM FINISH ROOM NAME Area REC ROOM 710 WER LEVEL BEDROOM #1 155 NFINISHED MECHANICAL 248 JNFINISHED STORAGE 294 OWER LEVEL BATH #1 38 STAIRCASE 72	122-TRM 12.34 - PROVIDE ADDITIONAL BRACING FOR ISLAND ABOVE. 12.42 - FIRE RATED SHEETROCK UNDER STAIRS 12.42 - FIRE RATED SHEETROCK UNDER STAIRS 12.52 - PLUMBING 12.52 - PLUMBING FLANGE ABOVE. HEADER JOISTS AS NEEDED 13.52 - PLUMBING FLANGE ABOVE. HEADER JOISTS AS NEEDED 14.1 - SHALL BE DIRECT FUEL BURNING APPLIANCES 15.1 - STALL BE DIRECT FUEL BURNING APPLIANCES 15.1 - STALL BE DIRECT TWITED TO EXTERIOR FOR 15.2 - PLUMBING FLANGE ABOVE. HEADER INSTALL PER 15.2 - MANUFACTURERS RECOMMENDATIONS. 15.31 - PROVIDE ALEXTRENOR FOR 15.31 - PROVIDE SLEETRICAL GFCI 15.31 - PROVIDE SLEETRICAL GFCI 15.31 - PROVIDE SLEETRICAL GFCI 15.31 - PROVIDE SLEETRICAL GFCI 16.31 - SUMP PIT AND PUMP. PROVIDE SLEETRICAL GFCI 15.31 - PROVIDE GLEETRICAL FIREL 15.31 - PROVIDE GLEETRICAL FOR SUMPONDES 15.31 - PROVIDE GLEETRICAL FOR SUMPONDES 15.31 - PROVIDE GECHTICAL PANEL 15.32 - PROVIDE GECHTICAL PANEL 15.32 - PROVIDE GFCI RECEPTACLE AND SWITCH FOR HUMDIFIER. 15.32 - LINE OF FLOOR ABOVE 16.42 - PROVIDE GFCI RECEPTACLE AND SWITCH FOR HUMDIFIER. 15.32 - PROVIDE GFCI RECEPTACLE FOR SUMP PUMP. 15.32 - PROVIDE GFCI RECEPTACLE FOR SUMP PUMP. 15.32 - PROVIDE GFCI RECEPTACLE FOR SUMP PUMP. 15.32 - PROVIDE GFCI RECEPTACLE FOR SUMP PUMP. 15.33 - AC HANGAR. VERIFY LOCATION ON SITE. 15.11 - GAS METER. VERIFY LOCATION ON SITE. 15.11 - GAS METER. VERIFY LOCATION ON SITE. 15.12 - ELECTRIC PANEL. VERIFY LOCATION ON SITE. 15.13 - CHANGAR. VERIFY LOCATION ON SITE. 15.14 - GAS METER. VERIFY LOCATION ON SITE. 15.15 - ELECTRIC PANEL. VERIFY LOCATION ON SITE. 15.12 - ELECTRIC PANEL. VERIFY LOCATION ON SITE. 15.12 - ELECTRIC PANEL. VERIFY LOCATION ON SITE. 15.12 - ELECTRIC PANEL. VERIFY LOCATION ON SITE. 15.13 - ELECTRIC PANEL. VERIFY LOCATION ON SITE. 15.14 - ELECTRIC PANEL VERIFY LOCATION ON SITE. 15.15 - ELECTRIC PANEL V	<text><text><text><text></text></text></text></text>
DULE ME DEPTH QUANTITY 4 1/2" 2 4" 3 4 1/2" 1 4 1/2" 1	GENERAL NOTES - FOUNDATION BASEMENT BACK WATER VALVES REQUIRED ON ALL BASEMENT PLUMBING FIXTURES. PROVIDE MEANS OF CONTROLLING PRESSURE CAUSED BY THERMAL EXPANSION. ALL SILLS & SLEEPERS SUPPORTED ON CONCRETE OR MASONRY SHALL BE OF DECAY-RESISTANT MATERIALS. DIMENSIONAL LUMBER IS LABELED PER INDUSTRY STANDARD TERMINOLOGY. ACTUAL LUMBER SIZING IS EXPECTED TO VARY PER VENDOR.	VERSION: R5.1 ISSUE DATE:
	ALL INTERIOR NON-LOAD BEARING, NON-BRACED, NON-CABINET WALLS ARE ALLOWED AT 24" O.C. SMOKE AND CARBON MONOXIDE DETECTORS SHOW ON	05/01/2025 SHEET NUMBER:
N PLAN SCALE: 1/4"=1'-0"	SMORE AND CARBON MONOAIDE DETECTORS SHOW ON PLANS ARE TO BE CONSIDERED RECOMMENDATIONS ONLY. FINAL PLACEMENT IS TO BE DETERMINED BY MUNICIPAL REQUIREMENTS. WINDOW SIZES ARE WRITTEN IN FEET AND INCHES PER INDUSTRY STANDARDS. EX: 3050 SH = 3'-0" X 5'-0" SINGLE HUNG, 3066 FIX = 3'-0" X 6'-6" FIXED.	A2.0