

7520 V KANSA WWW	CONST As Noted or Lee's Sum 04/3 VASHING S CITY, N V.HJMARC	NO 64114
INFOR HERE CONFIDER REPRODU WHOLE O PRIOR WI	MATION CC EIN IS CONS NTIAL. THIS NOT TO BE JCED, OR D DR PART WI	DOCUMENT USED, ISCLOSED IN THOUT THE RMISSION OF
<b>MIDWEST DISTRIBUTION T.I.</b>	SCANNELL PROPERTIES	LEE'S SUMMIT LOGISTICS BUILDING B LOT 2 1220 NW MAIN ST. LEE'S SUMMIT, MO 64086
DESCRIPTION		
REVISION DATE		)N 2
ISSUE DA 04/23/2 PROJ. # 2509.1 DRAWING DRAWING	TE. 025 SCALE: As indica	ated

CREATING TWO 6'-00" WIDE BY 7'-00" HIGH OPENINGS WITHIN AN EXISTING NON FIRE RATED DEMISING

### SHEET INDEX REVISION REVISION SHEET # SHEET NAME # DATE GENERAL CVR COVER SHEET ARCHITECTURAL A101 OVERALL FLOOR PLAN 04/23/2025 ELECTRICAL E1.00 WAREHOUSE LIGHTING PLAN E2.00 RISER DIAGRAM

## PROJECT INFORMATION

DISCIPLINE

SERIES


KEY PLAN 1/32" = 1'-0" 1

 $\langle | \rangle$ 


- SHEET IN SERIES

- G GENERAL
- K KITCHEN
- L LANDSCAPE
- M MECHANICAL
- P PLUMBING S STRUCTURAL
- T TECHNOLOGY
  - SHEET NUMBER KEY

)	8	4	
12	7	3 4	
11	6	<sup>7</sup> 3 2 6 2	Delicitiemmone
10	5	1	Big Big   PERMIT DOCUMENTS   DOCUMENTS 19182214   OURCT NO 1918   SHEET GUIDE 1918

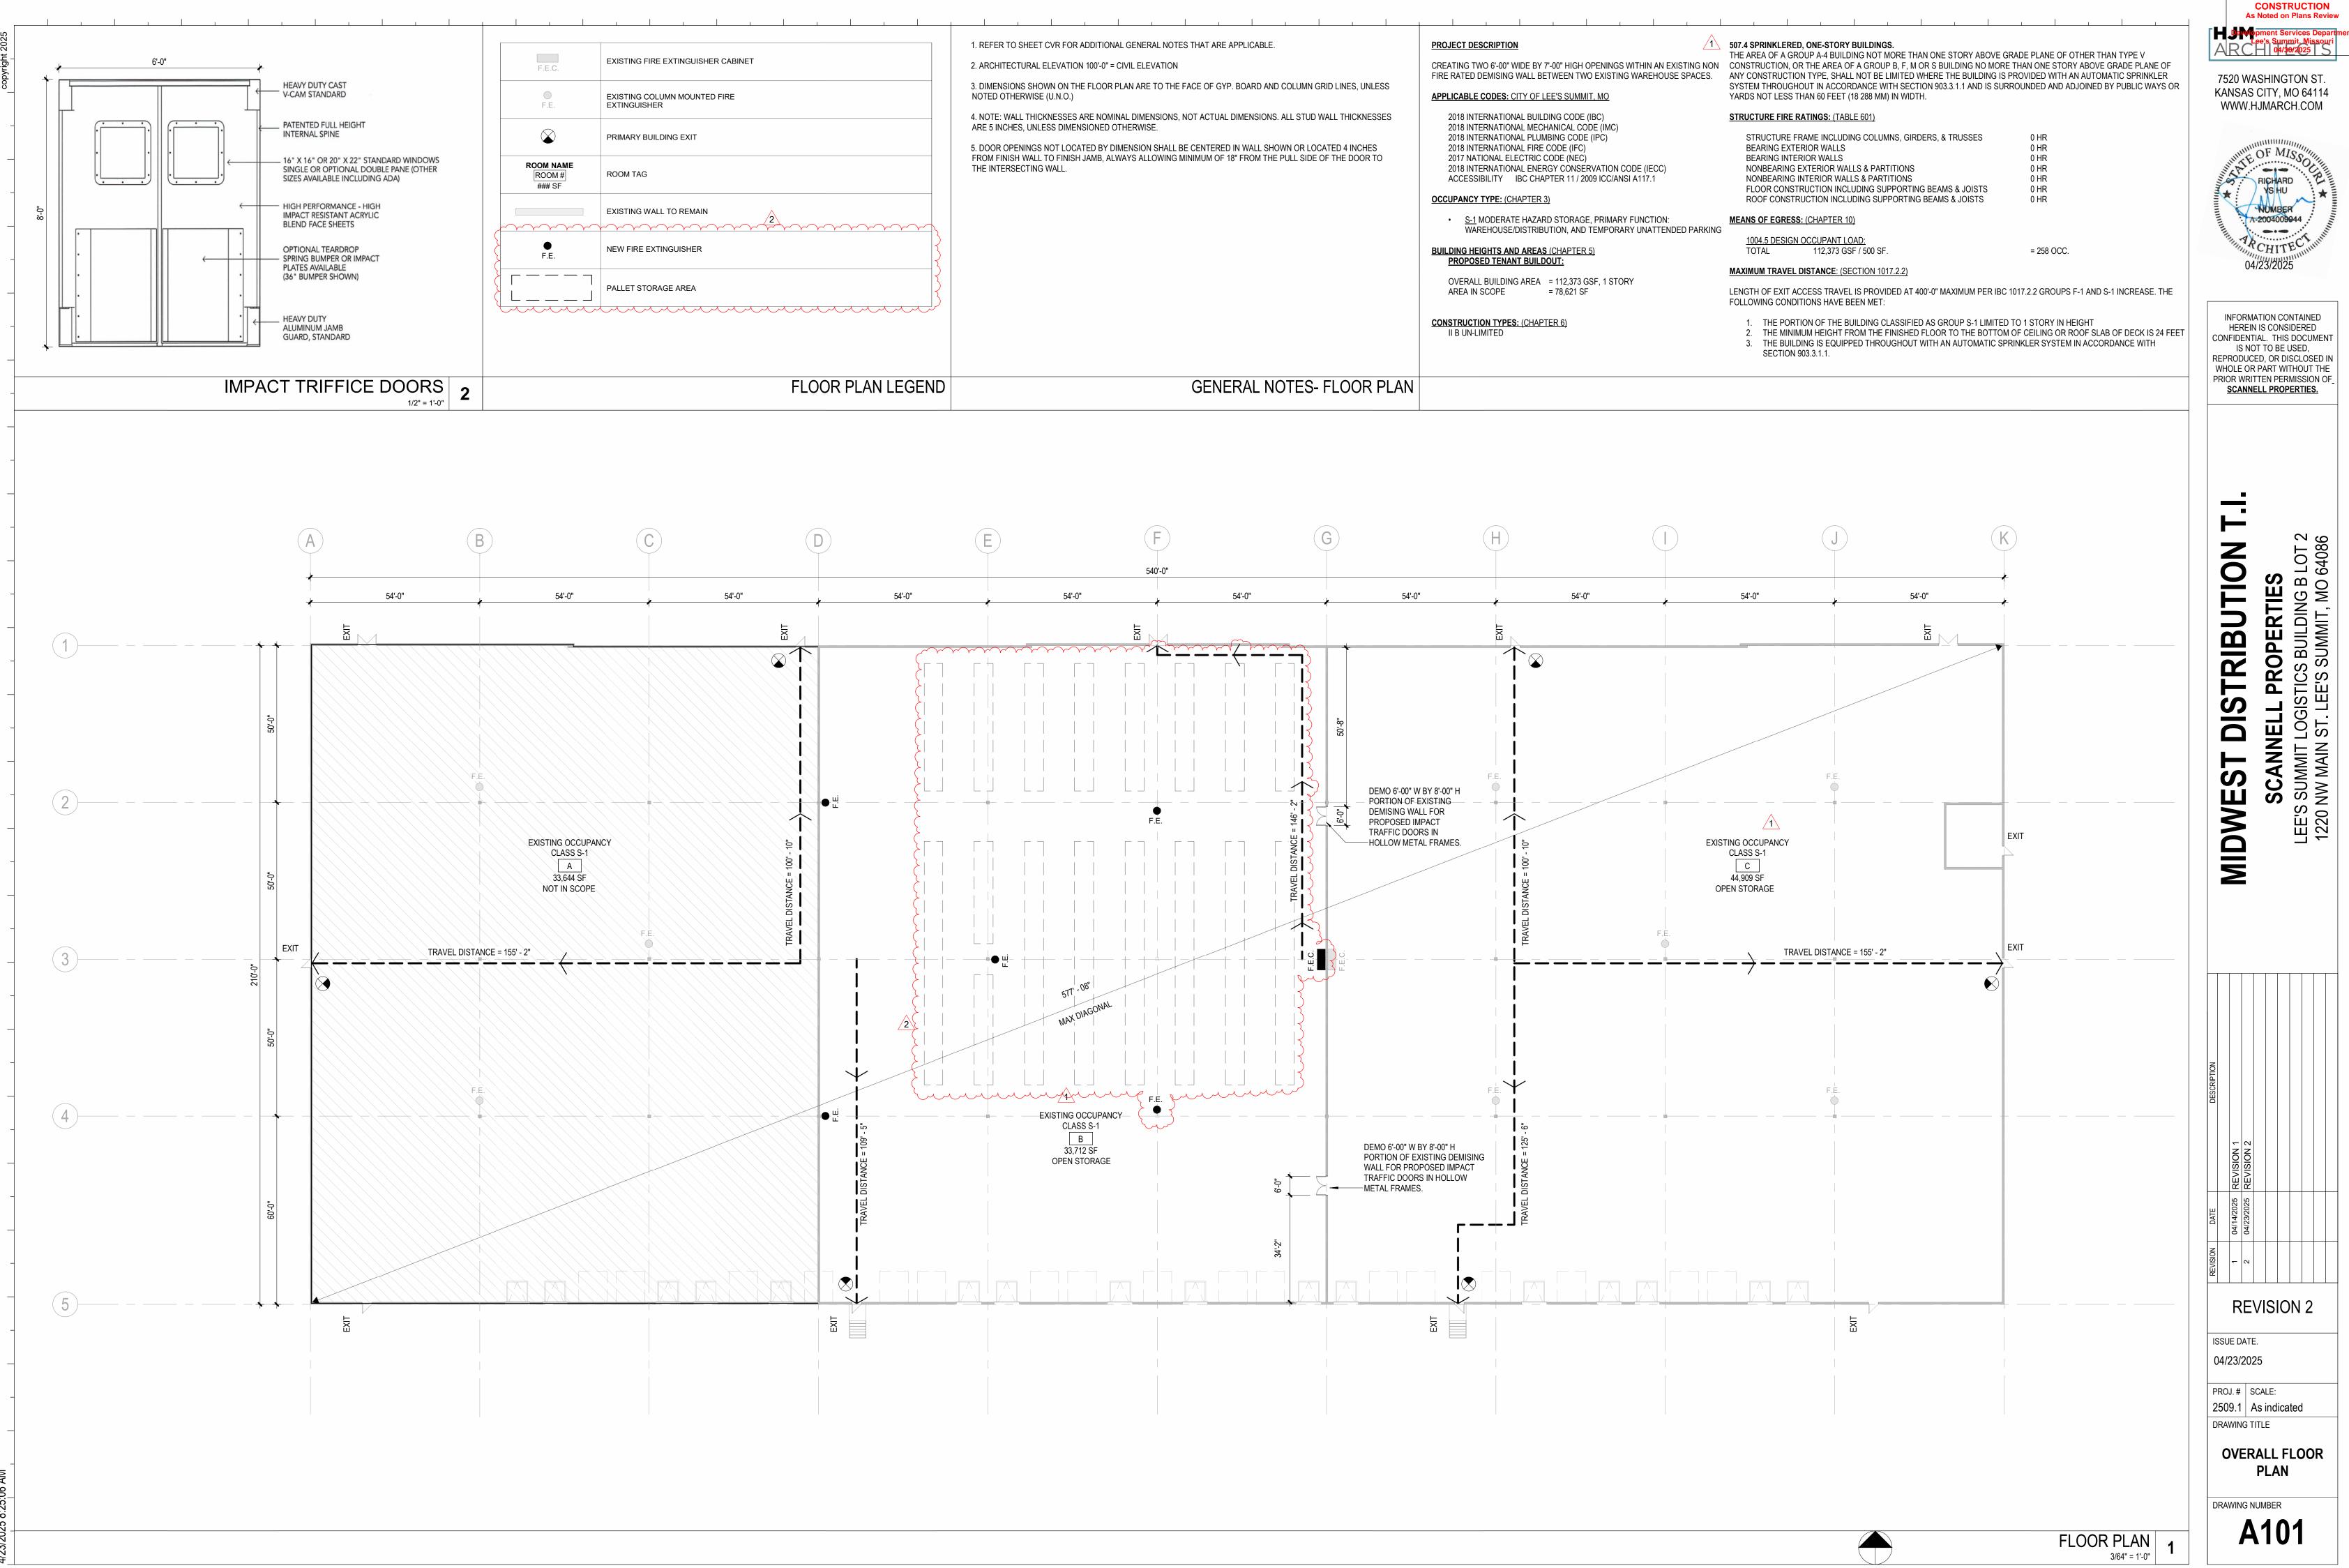

RELEASED FOR

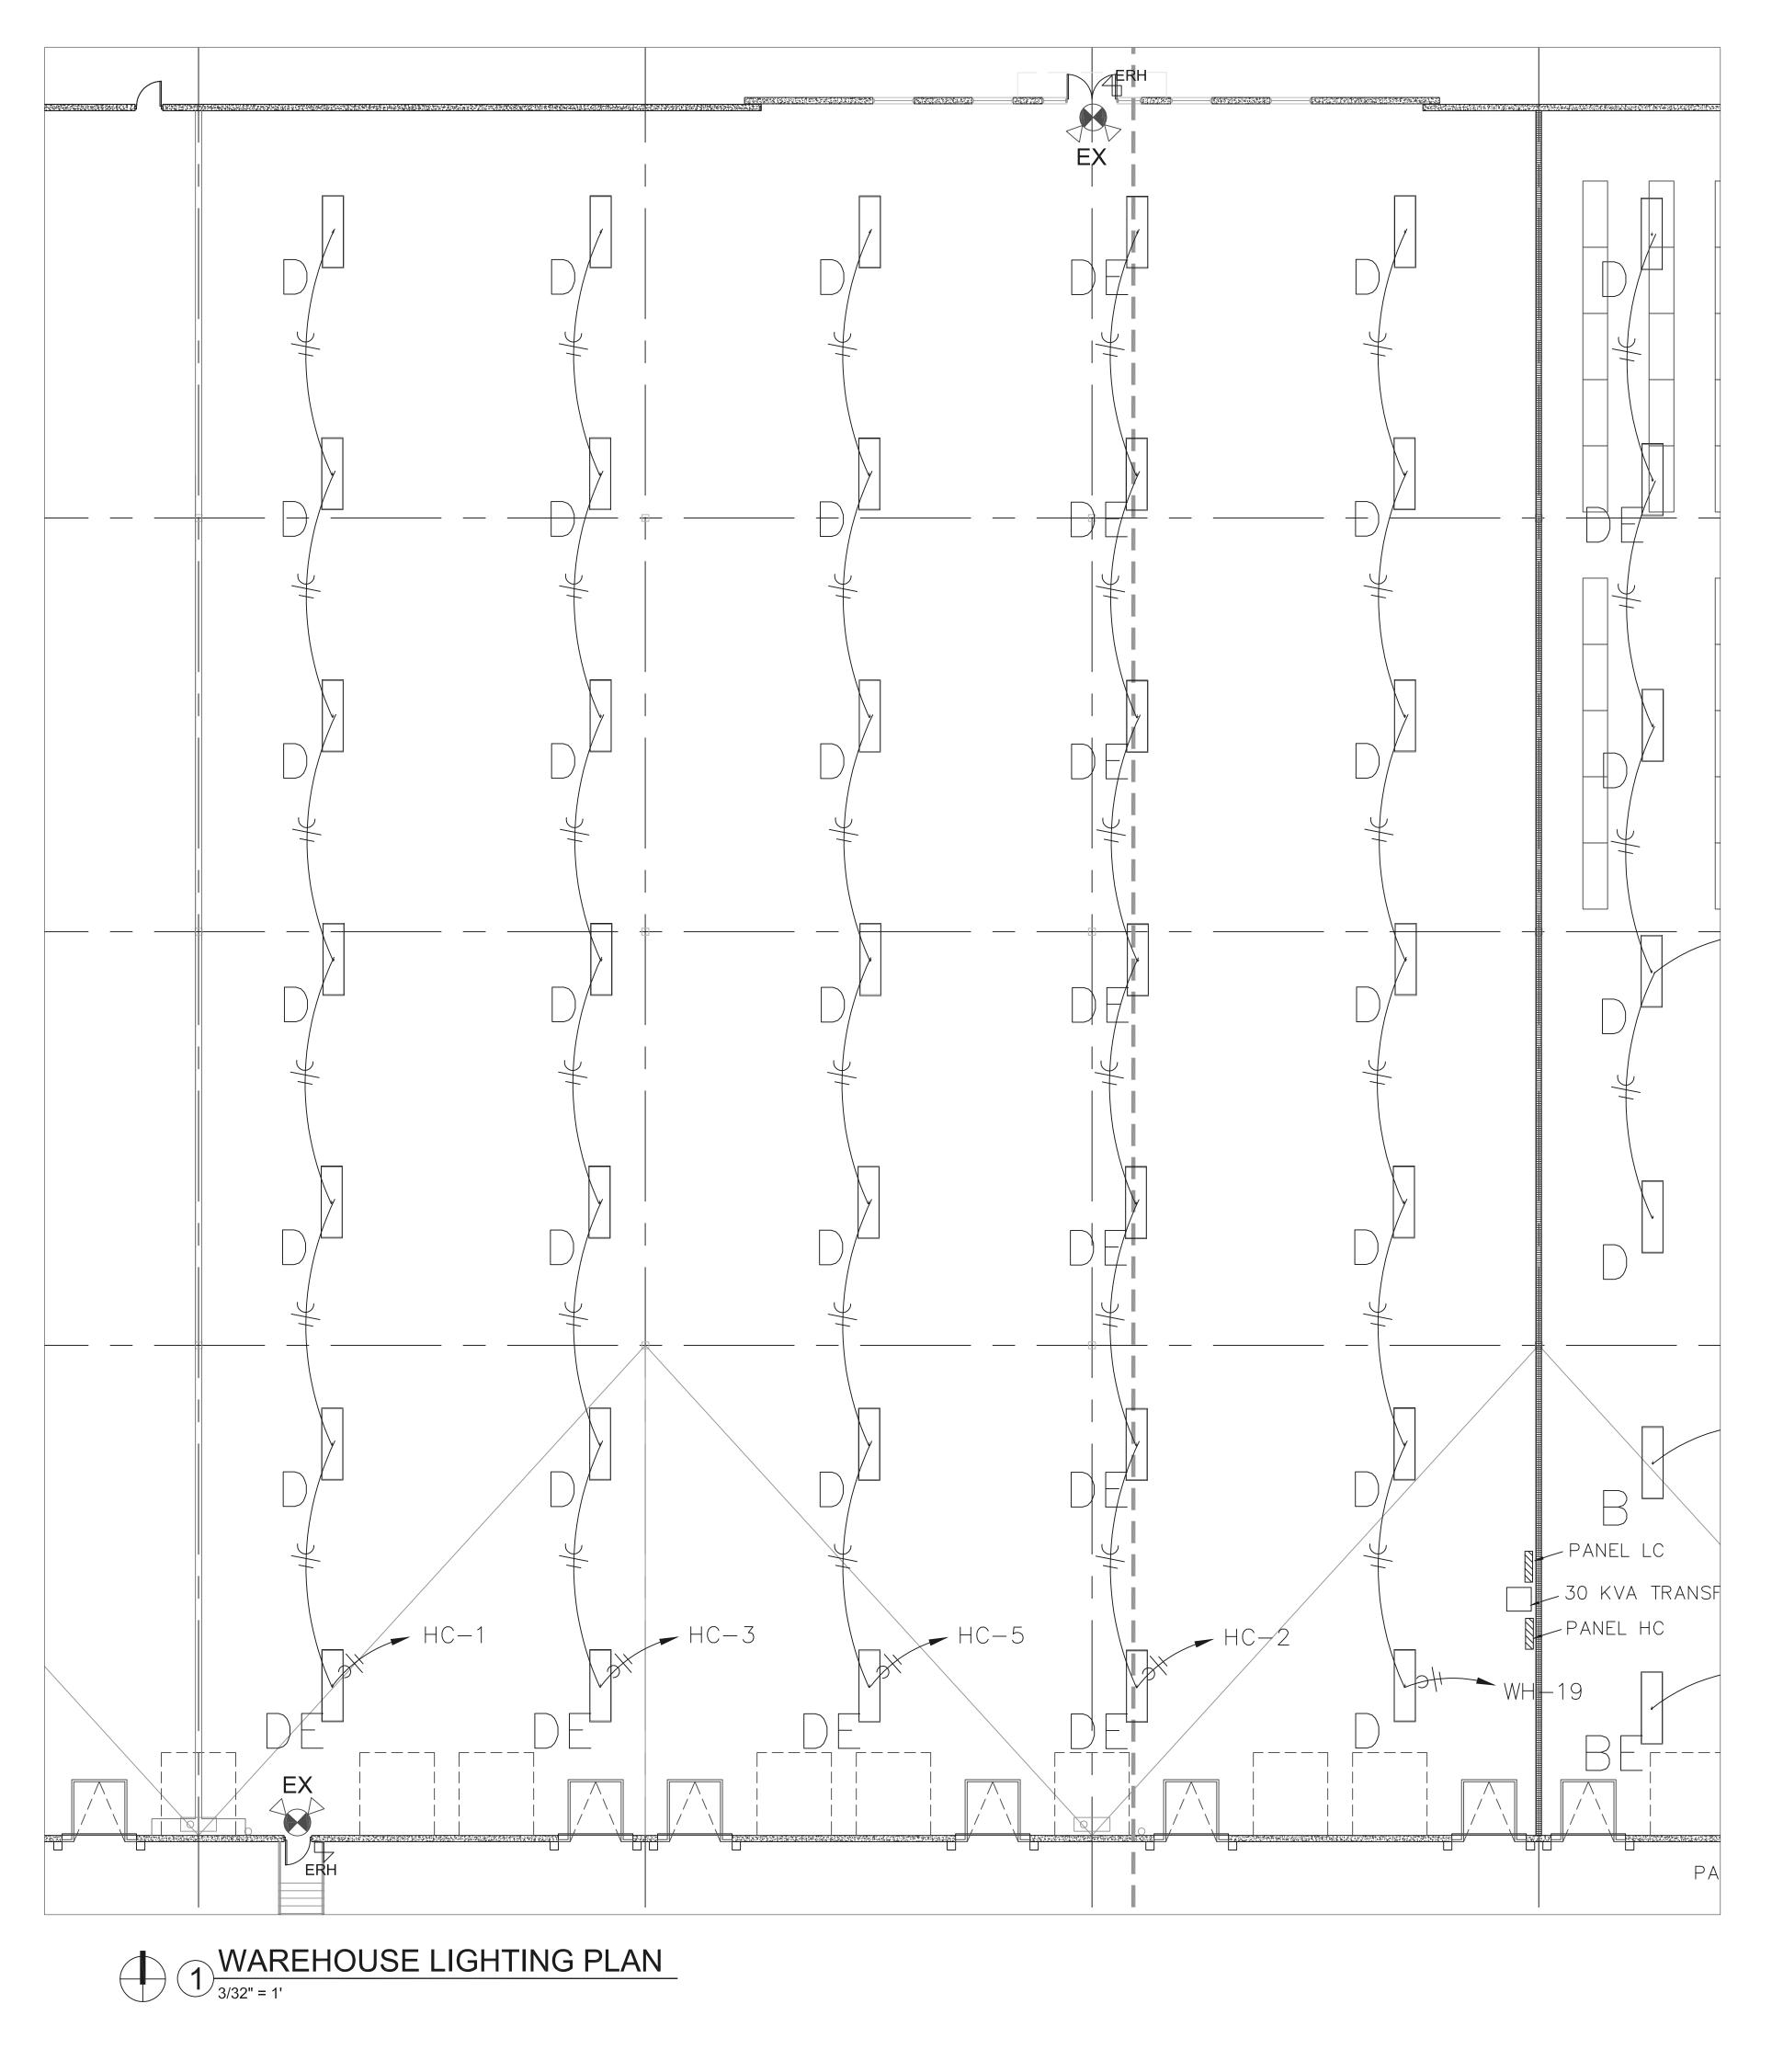

responsibility only for the design of mechanical, plumbing and electrical disciplines contained herein, generally indicated in bold type.



220018

GREGORY P GLADFELTER NUMBER E-2000150421 03/12/2025

Gladfelter Engineering Group

10511 Augusta Drive, Kansas City, KS 66109 Phone 816—916—4675 Email gpg@aeconsort.com

Gladfelter Engineering Group (GEG) assumes design responsibility for this project for only the mechanical, plumbing and electrical disciplines with drawing sheet number beginning with M, P and E. All other drawings should be considered the work of others. Further, drawings in this project set may contain drawing information, including but not limited to: architectural plans, sections and elevations, site plans and surveys and other information pertinent to showing the mechanical, plumbing and electrical work which is furnished by others, generally indicated by screened or light type. GEG assumes no responsibility or liability for the accuracy or regulatory compliance for work prepared by others even though shown on MPE drawings. GEG assumes

HERITAGE ELECTRIC, L.L.C. 841 N. MARTWAY Olathe, Kansas phone (913) 747 0528 (913) 747 0539 fax



THIS DRAWING HAS BEEN PRODUCED BY HERITAGE ELECTRIC, LLC. FOR THEIR COORDINATION OF THE ELECTRICAL INSTALLATION AND MAY NOT BE USED FOR ANY OTHER PURPOSE COPYRIGHT 2008. HERITAGE ELECTRIC, LLC. THE SEAL OF THE ELECTRICAL P.E. APPLIES TO ONLY THIS DRAWING, SPECIFICATIONS AND OTHER DOCUMENTS BEARING THE PERSONAL SEAL OF THE UNDERSIGNED PROFESSIONAL AND DISCLAIM ANY RESPONSIBILITY FOR ALL OTHER DRAWINGS, SPECIFICATIONS, ESTIMATES, REPORTS OR OTHER DOCUMENTS WHICH DO NOT CONTAIN THE PERSONAL SEAL OF THE UNDERSIGNED PROFESSIONAL

ISSUE DATES PERMIT SET 08.29.23

1220 NW Main Street LEE'S SUMMIT, MO 64086

Midwest Distributors

LEE'S SUMMIT LOGISTICS BUILDING B

PROJECT INFORMATION


THIS DRAWING AND THE IDEAS, DESIGNS AND CONCEPTS CONTAINED HEREIN ARE THE EXCLUSIVE INTELLECTUAL PROPERTY OF CURRAN ARCHITECTURE, AND ARE NOT TO BE USED OR REPRODUCED, WHOLE OR IN PART, WITHOUT THE WRITTEN CONSENT OF CURRAN ARCHITECTURE. © COPYRIGHT 2021, CURRAN ARCHITECTURE



CERTIFICATION

RELEASED FOR CONSTRUCTION As Noted on Plans Review

evelopment Services Depart Lee's Summit, Missouri 04/30/2025

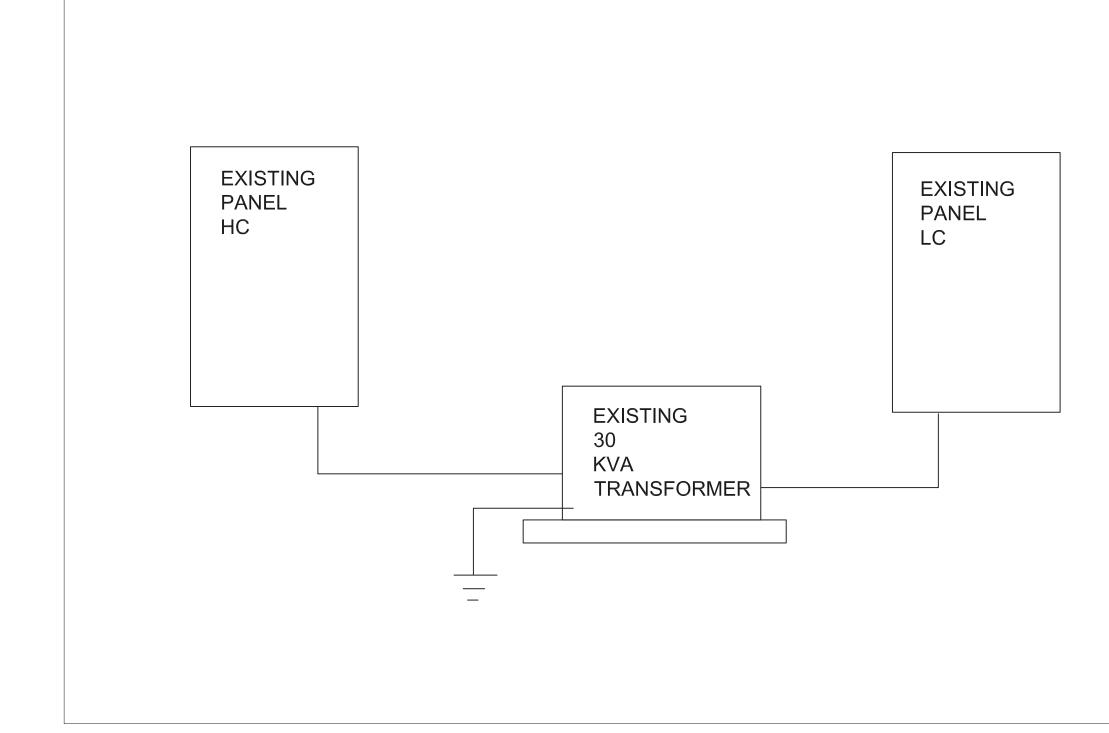

# 

LIGHT FIXTURE SCHEDULE											
TYPE	MANUFACTURER	CATALOG NO.	LAMPS	MOUNTING	VOLTS	REMARKS					
D	HE WILLIAMS	GH-2-L300-840-FA-DIM-UN V	LED	CEILING	277	PROVIDE WITH INTEGRAL MOTION SENSOR					
DE	HE WILLIAMS	GH-2-L300-840-FA-DIM-UN V	LED	CEILING	277	SAME AS TYPE D DNLY WITH EM BALLAST					
EX	COMPASS	CCR	LED	WALL	UNV	EXISTING					
ERH	COMPASS	CUWZ-PC	LED	WALL	UNV	EXISITNG					

СТ	SERVES	VA	OCP	WIRE	PHASE	WIRE		OCP	VA	SERVES	ССТ
1	WAREH OU SE LIGHTS	1596	20/1	2-#12, 1-#12G	A	2-#12, 1-#12G		20/1	1596	WAREH OUSE LIGHTS	2
3	WAREH OU SE LIGHTS	1596	20/1	2-#12-1-#12G	В	3-#8-1-#10G		50/3	6925	MAU1	4
5	WAREHOUSE LIGHTS	1596	20/1	2-#12-1-#12G	С				6925		6
7	OVERHEAD DOOR	200	20/3	4-#10-1-#12G	A				6925		8
9		200			В	2-#12, 1-#12G		20/1	1596	WAREHOUSE LIGHTS	10
11		200			С						12
13					A						14
15					В						16
17					С						18
19					A						20
21					В						22
23					C						24
25					A						26
27					В						28
29					C						30
31					A						32
33					В						34
35					C	3-#8,1#10G		50/3	1000	TRANSFORMER	36
37					A			-	800	TRANSFORMER	38
39					В			-	600	TRANSFORMER	40
41					C			•			42
TES:					LOAD SUM	MMARY	CONN	NEC	DEM	LOAD BALANCE PER PHASE	
	1 NEMA 1 ENCLOSURE				1-LIGHTIN	G	7980	1.25	997	5 PHASE A	11
:	2 PROVIDE BOLT ON BREAKERS				2-RECEPT	ACLES	2400	NEC	240	0 PHASE B	10
	3				3-KITCHEN	N	0	0.65		0 PHASE C	9
					4-HVAC		20775	1	2077	5 LOWEST PHASE PLUS 10%	
					5-NON-CO		600		60		1069
					LARGEST	MOTOR	0	0.25		0 REBALANCE LOADS	· · ·
					TOTAL VA	A	31755	i	3375	i0	
					TOTAL AN	MDS	38.2		40.	6	

PANE	L: LC 100	MB	120	/ 208 V, 3PH,	4W.+GRND.					NEW PANEL	
ст	SERVES	VA	OCP	WIRE	PHASE	WIRE		OCP	VA	SERVES	CCT
1	DOCK POWER	800	20/1	2-#12,1-#12G	A	2-#12,1-#12G		20/1	200	GFCI RECEP	2
3	DOCK POWER	800	20/1	2-#12,1-#12G	В	2-#12,1-#12G		20/1		SPARE	4
5	SPARE		20/1		C	2-#12,1-#12G		20/1		SPARE	6
7	SPARE		20/1		A	2-#12,1-#12G		20/1		SPARE	8
9	SPARE		20/1		В	2-#12,1-#12G		20/1		SPARE	10
11	SPARE		20/1		C	2-#12,1-#12G		20/1		SPARE	12
13	SPACE				A					SPACE	14
15	SPACE				В					SPACE	16
17	SPACE				C	-				SPACE	18
19	SPACE				A	-				SPACE	20
21	SPACE				В	-				SPACE	22
23	SPACE			-	C	-				SPACE	24
25	SPACE				A					SPACE	26
27	SPACE				В					SPACE	28
29	SPACE				С					SPACE	30
31	SPACE				A	-				SPACE	32
33	SPACE				В					SPACE	34
35	SPACE				C					SPACE	36
37	SPACE				A	-				SPACE	38
39	SPACE				В					SPACE	40
41	SPACE				С					SPACE	42
TES:					LOAD SUI	MMARY	CONN	NEC	DEM	LOAD BALANCE PER PHASE	
	1 NEMA 1 ENCLOSURE				1-LIGHTIN	G	0	1.25	0	PHASE A	10
	2 PROVIDE BOLT ON BREAKERS				2-RECEPT	ACLES	1800	NEC	1800	PHASE B	8
;	3				3-KITCHE	N	0	0.65	0	PHASE C	
					4-HVAC		0	1	0	LOWEST PHASE PLUS 10%	
					5-NON-CO	NT	0	1	0	0 + 10%	
					LARGEST	MOTOR	0	0.25	0	REBALANCE LOADS	I
					TOTAL V	A	1800	)	1800		
					TOTAL A	MDe	5.0		5.0		

OVERCURRE PROTECTIO DEVICE RAT	N REQUIRED	EQUIPMENT GROUNDING CONDUCTOR SIZE	SINGE PHASE 2 WIRE + GND CONDUIT SIZE	SINGLE PHASE 3 WIRE + GND, CONDUIT SIZE	THREE PHASE 3 WIRE + GND CONDUIT SIZE	THREE PHASE 4 WIRE + GND CONDUIT SIZE
(AMPS)	10 11/5					
15 	12 AWG	12 AWG	3/4"	3/4"	3/4″	3/4″
20	10 AWG	12 AWG	3/4"	3/4"	3/4"	3/4″
30	10 AWG	10 AWG	3/4"	3/4"	3/4"	3/4"
35	8 AWG	10 AWG	3/4	3/4	3/4	3/4
40	8 AWG	10 AWG	3/4″	3/4"	3/4″	3/4″
45	8 AWG	10 AWG	3/4″	3/4″	3/4″	1″
50	8 AWG	10 AWG	3/4″	3/4″	3/4″	1″
60	6 AWG	10 AWG	1″	1″	1″	1-1/4″
70	4 AWG	8 AWG	1″	1″	1″	1-1/4″
80 	4 AWG 3 AWG	8 AWG	1″	1-1/4"	1-1/4"	1-1/4"
100	3 AWG	8 AWG	1" 1-1/4"	1-1/4" 1-1/2"	1-1/4"	1-1/4"
vide	electrical			0		
Elect work bran /ices CIFICAT conduit as onnection c cable is ranch wir irring shal irring devic istallatio LUMINUM REFER TO I	rical work shall be c ch wiring s shall be 21	Shall be hall be hall be Da COMME SING SET SCREW IAL CONNECTIONS HN COPPER UNLI NT NEC 2017 MMERCIAL GRADE ADA STANDARDS BE USED FOR F ANUAL FOR 480	as per qualified copper, ncial gra therwise noted ss otherwise no connectors to light fixtur ess otherwise n RATED AT 20 AN EEDERS LARGER	NEC 2017 electricio de and c oted es provide with oted ip ihen #2 otherwis	' olor sha 10' WHIP ON ALI SE COPPER	L HIGHBAYS
Elect Work Work bran vices <u>CIFICAT</u> CONDUIT AF CONDUIT	shall be of shall be of shall be 21 ONS ONS OVE GRADE SHALL BE S SHALL BE MADE US S ACCETABLE FOR FIN ING SHALL BE 412 TH L BE AS PER CURREN CES SHALL BE OF CO N SHALL ADHERE TO XHHW-#2 CABLE MAN (CP&L STANDARDS M G/EQUIPMENT IN WAR	Shall be done by hall be o hall be o Da comme e EMT UNLESS O RIGID PVC UNLE SING SET SCREW IAL CONNECTIONS HN COPPER UNLE NT NEC 2017 MMERCIAL GRADE ADA STANDARDS BE USED FOR F ANUAL FOR 480 EHOUSE SHALL B Check Softw rior Ligh 90.1 (201 Midwest New Cor	as per qualified opper, rcial gra therwise noted ss otherwise no connectors to light fixtur ess otherwise no rated at 20 AN eeders larger services to are Version ting Com	NEC 2017 electricia de and c oted es provide with oted ip then #2 otherwis rovide a min of <b>4.1.5.5</b> <b>pliance (</b>	Contractor: Hansen Electric Martway Driv KS 66061	L HIGHBAYS
Elect Work bran vices <u>CIFICAT</u> conduit at onnection c cable is ranch wirk iring shal iring device stallatio LUMINUM REFER TO I	construction Site: 1220 NW Main Street Lee's Summit, MO 64086	Shall be done by hall be o hall be o Da comme e EMT UNLESS O RIGID PVC UNLE SING SET SCREW IAL CONNECTIONS HN COPPER UNLE NT NEC 2017 MMERCIAL GRADE ADA STANDARDS BE USED FOR F ANUAL FOR 480 EHOUSE SHALL B Check Softw rior Ligh 90.1 (201 Midwest New Cor	as per qualified opper, rcial gra therwise noted ss otherwise no connectors to light fixtur ess otherwise no rated at 20 AN eeders larger services to dunted to p <b>are Version</b> <b>ting Com</b>	NEC 2017 electricia de and c oted es provide with oted ip then #2 otherwis rovide a min of <b>4.1.5.5</b> <b>pliance (</b>	2010 Sha 2010 Sha 10' WHIP ON AL SE COPPER 36' CLEAR HEIG Contractor: Hansen Electric Marsen Electric Marsen Electric Marsen Marsen Electric Marsen Marsen Electric Marsen Marsen Marsen Marsen Marsen Marsen Marsen Marsen Marsen Marsen Electric Marsen Marse	L HIGHBAYS

~chitect

COMche	eck Software Version 4	1.5.5			
Interio	or Lighting Comp	liance C	ertifi	cate	9
Project Information					
Energy Code: Project Title: Project Type:	90.1 (2016) Standard Midwest Distributors New Construction				
Construction Site: 1220 NW Main Street Lee's Summit, MO 64086	Owner/Agent:	Olathe, k 913-747-	lansen Electric lartway Driv (S 66061		n
Allowed Interior Lighting Po	ower				
A	A rea Category	B Floor Area (ft2)	C Allowed Watts / ft2		D wed Wati B X C)
1-Warehouse:Medium Bulky/Pallet M	laterial Storage	34200	0.35		11970
Proposed Interior Lighting	Power	Το	tal Allowed W	atts =	11970
	A tion / Lamp / Wattage Per Lamp / Ballast	B Lamps/ Fixture	C # of Fixtures	D Fixture Watt.	E (C X D)
1-Warehouse:Medium Bulky/Pal LED 1: Other:	et Material Storage	1	40	228	9120
			Total Propos	ed Watts =	9120
Interior Lighting PASSES: I	Design 24% better than code				pping
Interior Lighting Compliand					
Compliance Statement: The pro	posed interior lighting design represented in	i this document is co	onsistent wit	h the buil	ding plar

specifications, and other calculations submitted with this permit application. The proposed interior lighting systems have been designed to meet the 90.1 (2016) Standard requirements in COMcheck Version 4.1.5.5 and to comply with any applicable mandatory requirements listed in the Inspection Checklist, Sering Hansen V.P. Jung Han 03/12/2025 Name - Title Bignature Date

Project Title: Midwest Distributors Data filename: Untitled.cck

## ELECTRICAL GENERAL NOTES

1. WORK INCLUDED. FURNISH ALL LABOR, MATERIAL, SERVICES AND SKILLED SUPERVISION NECESSARY FOR THE CONSTRUCTION, ERECTION, INSTALLATION CONNECTIONS, TESTING AND ADJUSTMENTS OF ALL CIRCUITS AND ELECTRICAL EQUIPMENT SPECIFIED HEREIN, OR NOTED ON THE DRAWINGS, AND ITS DELIVERY TO THE OWNER COMPLETE IN ALL RESPECTS READY FOR USE.

2. CONTRACT DRAWINGS THE CONTRACT DRAWINGS ARE SHOWN IN PART DIAGRAMMATIC, INTENDED TO CONVEY THE SCOPE OF WORK. INDICATING THE GENERAL ARRANGEMENT OF EQUIPMENT, CONDUIT AND OUTLETS. VERIFY SPACES FOR THE INSTALLATION OF THE MATERIALS BASED ON ACTUAL DIMENSIONS OF EQUIPMENT FURNISHED. IF A QUESTION EXISTS AS TO THE EXACT INTENDED LOCATION OF OUTLETS OR EQUIPMENT, OBTAIN INSTRUCTIONS FROM THE ARCHITECT/ENGINEER BEFORE PROCEEDING WITH WORK.

3. MINIMUM SIZE OF CONDUIT SHALL BE 1/2" UNLESS NOTED OTHERWISE.

4. ALL WIRING FOR LIGHTING, RECEPTACLE AND POWER CIRCUITS WHERE NOT SHOWN ON DRAWINGS SHALL BE WITH #12 CONDUCTORS, NUMBER AS REQUIRED IN CONDUIT SIZED PER N.E.C. PROVIDE EQUIPMENT GROUNDING CONDUCTOR FOR ALL BRANCH CIRCUITS AND FEEDERS. HOMERUNS TO PANEL SHALL BE IN INDIVIDUAL CONDUITS, UNLESS NOTED OTHERWISE, WITH CIRCUITS AS SHOWN.

5. THE USE OF TYPE 'MC' AND TYPE 'AC' CABLE IS PERMITTED IN ALL AREAS PER NEC AND LOCAL CODE REQUIREMENTS.

6. THE USE OF ALUMINUM CONDUCTORS WITH AMPACITY EQUIVALENT TO COPPER IS PERMITTED IN ALL AREAS PER NEC REQUIREMENTS.

7. ALL JUNCTION BOXES, PULL BOXES, AND PANELBOARDS SHALL BE RIGIDLY ATTACHED TO STRUCTURE.

8. COORDINATE ALL WORK WITH OTHER TRADES AND EXISTING CONDITIONS AS REQUIRED TO PROPERLY INSTALL ALL SYSTEMS AS INTENDED, WITHIN THE CONFINES OF THE SPACE AVAILABLE, AND WITHOUT INTERFERENCES.

9. ALL CONDUIT, BOXES, ETC. SHALL BE CONCEALED OR MOUNTED FLUSH WITH CEILING OR WALL CONSTRUCTION, CONDUITS SHALL BE MOUNTED AS HIGH AS POSSIBLE. NO SURFACE MOUNTED CONDUIT, BOXES, ETC. WILL BE PERMITTED WITHOUT PERMISSION OF THE ENGINEER PRIOR TO INSTALLATION. ALL CONDUIT PENETRATIONS SHALL BE FIRE-CAULKED AS REQUIRED.



CERTIFICATION

RELEASED FOR CONSTRUCTION As Noted on Plans Review elopment Services Departme


Lee's Summit, Missouri 04/30/2025

THIS DRAWING AND THE IDEAS, DESIGNS AND CONCEPTS CONTAINED HEREIN ARE THE EXCLUSIVE INTELLECTUAL PROPERTY OF CURRAN ARCHITECTURE, AND ARE NOT TO BE USED OR REPRODUCED, WHOLE OR IN PART, WITHOUT THE WRITTEN CONSENT OF CURRAN ARCHITECTURE. © COPYRIGHT 2021, CURRAN ARCHITECTURE

PROJECT INFORMATION

LEE'S SUMMIT LOGISTICS **BUILDING B** 

> Midwest Distributors 1220 NW Main Street LEE'S SUMMIT, MO 64086

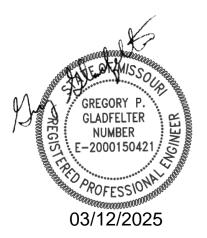

Gladfelter Engineering Group

### 10511 Augusta Drive, Kansas City, KS 66109 Phone 816-916-4675 Email gpg@aeconsort.com

Gladfelter Engineering Group (GEG) assumes design responsibility for this project for only the mechanical, plumbing and electrical disciplines with drawing sheet number beginning with M, P and E. All other drawings should be considered the work of others. Further, drawings in this project set may contain drawing information, including but not limited to: architectural plans, sections and elevations, site plans and surveys and other information pertinent to showing the mechanical, plumbing and electrical work which is furnished by others, generally indicated by screened or light type. GEG assumes no responsibility or liability for the accuracy or regulatory compliance for work prepared by others even though shown on MPE drawings. GEG assumes responsibility only for the design of mechanical, plumbing and electrical disciplines contained herein, generally indicated in bold type.

HERITAGE ELECTRIC, L.L.C. 841 N. MARTWAY Olathe, Kansas phone (913) 747 0528 (913) 747 0539 fax



THIS DRAWING HAS BEEN PRODUCED BY HERITAGE ELECTRIC, LLC. FOR THEIR COORDINATION OF THE ELECTRICAL INSTALLATION AND MAY NOT BE USED FOR ANY OTHER PURPOSE COPYRIGHT 2008. HERITAGE ELECTRIC, LLC. THE SEAL OF THE ELECTRICAL P.E. APPLIES TO ONLY THIS DRAWING, SPECIFICATIONS AND OTHER DOCUMENTS BEARING THE PERSONAL SEAL OF THE UNDERSIGNED PROFESSIONAL AND DISCLAIM ANY RESPONSIBILITY FOR ALL OTHER DRAWINGS, SPECIFICATIONS, ESTIMATES, REPORTS OR OTHER DOCUMENTS WHICH DO NOT CONTAIN THE PERSONAL SEAL OF THE UNDERSIGNED PROFESSIONAL

ISSUE DATES PERMIT SET 08.29.23

> 220018 RISER DIAGRAM

