

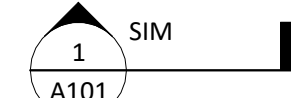
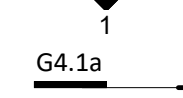
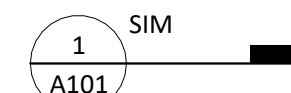
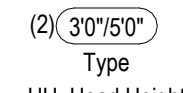
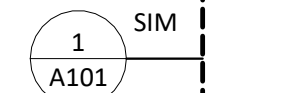



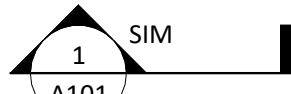



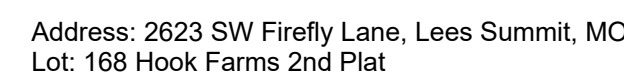


Address: 2623 SW Firefly Lane, Lees Summit, MO
Lot: 168 Hook Farms 2nd Plat

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	BUILDING SECTION		INTERIOR ELEVATION TAG
	WALL SECTION		INTERIOR PARTITION TYPE SYMBOL
	DETAIL SECTION		WINDOW TYPE SYMBOL
	DETAIL REFERENCE		BENCHMARK/SPOT ELEV. SYMBOL
	EXTERIOR ELEVATION TAG		COLUMN LINE/GRID INDICATOR
			FLOOR LEVEL SYMBOL
			CEILING HEIGHT SYMBOL
			DIMENSION
			ALIGN TWO WALLS OR OBJECTS



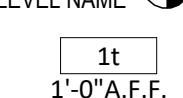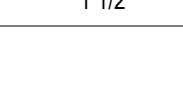General Information


An energy efficient certificate is required to be posted in or on the electrical panel before the final inspection. The certificate will be provided with all new residential permits. It is the permit holder/contractor's responsibility to ensure the certificate has accurate information and is posted before final inspection -- Owner/Contractor is responsible for meeting the prescriptive requirements of IRC chapter 11 unless a HER Index Analysis for Performance Compliance based on the plans is submitted to the AHJ for approval.

1. Whole House Mechanical Ventilation System is required for any dwelling with air infiltration at a rate of less than 5air changes per hour (at ACH50 standard A303.4).
2. Carbon monoxide detectors required (R315)
3. Steel columns shall be minimum schedule 40 (R501.1)
4. Deck Ledger Attachment to house shall be per Tables S709.1, 9.1.3.
5. New provisions for attachment of rafters, trusses and roof beams. (R802.3 and R802.1)
6. Programmable thermostat required (N103.1.1)
7. Air handlers shall be rated for Maximum % air leakage rate (N103.2.2.1)
8. Building cavities used as return air plenums shall be sealed to prevent leakage across the thermal envelope. (N103.2.3)
9. Certain water pipes shall be insulated (N103.4)
10. All exhaust fans shall terminate to the building exterior (M1507.2)
11. Makeup air system required for kitchen exhaust hood that exceed 400 CFM M1503.4
12. Building must be in a thermal envelope wall (including the wall between the house and garage) shall not be used as return air plenums (unless the required insulation and air barrier are maintained) (M1601.1,1.87.5)
13. An air handling system shall not serve both the living space and the garage (M1601.6)
14. Building must have grounding electrode (UFER Ground) connection complies with the requirements of the 2018 IRC Section E3608.1.2 in providing a connection with no less than the required minimum of steel.
15. Compliance with the requirements and show connection as needed for roof beam, truss, rafter and girdler connections for uplift per IRC 802.11
16. Garage Door Rating: DASMA 115 MPH Rated

Permit Set

00

Project No.

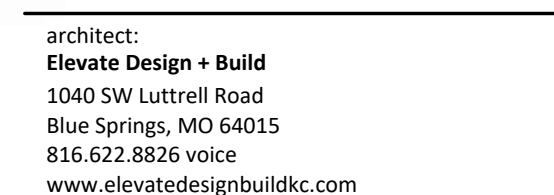

REVISIONS


PROJECT
Address: 2623 SW Firefly Lane,
Lees Summit, MO
Lot: 168 Hook Farms 2nd Plat

DATE ISSUED

A706.2



④ Back Elevation - Full Basement - Modern
3/16" = 1'-0"

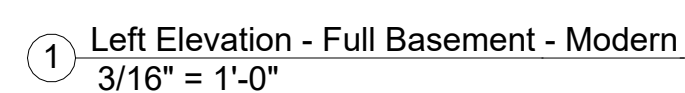

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JANUARY 1, 2025

[illegible]

DRAWING TITLE
Side Elevations - Full Basement -
Shed

DATE ISSUED

DRAWING NUMBER

A301.1

G:\Shared drives\06 - Architecture\02 - Master Plan\Greystone Masterplan\01-Working Files\Revit Central File\Greystone Master Plan.rvt

Structural Foundation Schedule						
Type	Width	Length	Depth	Reinforcing		Comments
Footing						
F1	3'-0"	3'-0"	1'-0"	Reinf w/ (6) #4's, rebar count is each way, equal centers		GARAGE PEDISTAL
F2	4'-0"	4'-0"	1'-4"	Reinf w/ (8) #4's, rebar count is each way, equal centers. (8) #4's, vertical rebar count in pier column. more pier down 12" with rebar gap, pour block-down and/or bottom of slab.		
Foundation - Round						
F3	1'-4"	1'-4"	3'-0"	ABA662 Post Base, Refer to Detail for Reinforcing.		
Wall Foundation						
FTG-1	1'-4"	<varies>	0'-8"	Reinf w/ (2) #4 bot. eq. spaced. Dowel into wall w/ (1) #4 turned up @ 12" o.c.		<varies>

Foundation Notes:

FOOTINGS FOUNDATION & CONCRETE NOTES

1. ADDRESS EXISTING SETTLEMENT. ALL INTERIOR BEARING AND EXTERIOR FOOTINGS & PADS TO BE EXCAVATED & BELOW FIN. 18 INCHES UNDISTURBED NATURAL SOIL.
2. EXT. FOOTING TO BE PLACED MIN. 36 INCHES BELOW FIN. GRADE.
3. DESIGN IS BASED ON MIN. OF 2,500 PSI. CONCRETE STRENGTHS TO ACHIEVE THE FOLLOWING BASED UPON:
 - A. 1,000 PSI FLOOR SLAB, WALLS & VERT. SUPPORTS
 - B. 1,500 PSI FOR GARAGE FLOORS
4. CONC. EXPOSED TO WEATHER TO HAVE 60%+1% AIR ENTRAINMENT
5. PROVIDE 4" MIN. CONC. SLAB OVER 8" MIN. CONC. E.W. TOP REIN. OVER CONC. DEPOSITED AS INDICATED (MAX 7" FT OF CONC. SLAB OVER 8" MIN. VAPOR BARRIER)
6. REINFORCE EXISTING FOOTINGS W/ #4 @ 24" E.W. REINFORCE W/ (2) #4 CONT. AT BOTTOM
7. PROVIDE #5 X 4" (L) @ 45-DEGREES OR REINTEMENT CORNERS
8. 12X12"X18" ASTMA #27 ANCHOR BOLTS @ 8" IN CONC. EXTS. WALLS
9. ANCHORS PRECAST INTO PLATE AT 8" IN CONC. WALLS W/ #4 X 12" HILTI.
10. PROVIDE #4 @ 12" C.C. MAX. FOR FOUNDATIONS
11. PROVIDE 24" LAPS MIN. INCLUDING CORNERS
12. INITIAL HOLD DOWN BOLT & ANCHOR BOLTS TO BE CASTED ON PLAN
13. PROVIDE BITUMINUM DAMP PROOFING AT FOUNDATION WALLS
14. SOIL BEARING CAPACITY IS NOT ASSUMED TO BE GREATER THAN 2,000 PSF IN THE CURRENT FOUNDATION DESIGN. ALL COMPACTED FILL AREAS REQUIRE A SPECIAL INSPECTION

STEEL COLUMNS & OTHER BASEMENT FOUNDATION NOTES

1. ALL STEEL PIPE COLUMNS SHALL BE 30" OR 36" 10Y50CHS @ 40 GRADE
2. INTER. BEARING WALLS & COLUMNS SHALL BE ISOLATED FROM THE BASEMENT FLOOR SLAB
3. INTER. NON-BEARING WALLS, OTHER THAN THOSE RESTING DIRECTLY ON THE FOOTING, SHALL BE ISOLATED FROM THE FLOOR FRAMING ABOVE
4. AT WALL/COLT FOUNDATION AREAS, REINFORCE THE SLAB FROM THE FOUNDATION WALL TO 2 FEET BEYOND THE OVERSIDE AREA WITH #4 BARS AT 24 INCHES C.C.
5. PROVIDE 12" MIN. AIR AND MOISTURE BARRIER TO THE FOUNDATION WALL, THE WALL SHALL BE W/20KTSI THE FOUNDATION WALL SHALL BE INSULATED W/ MINIMUM R 6 INSULATION FOR A MIN. OF 3 FEET BELOW THE BOTTOM OF THE SLAB
6. PROVIDE 12" MIN. AIR AND MOISTURE BARRIER TO THE FOUNDATION WALL, THE WALL SHALL BE SUPPORTED LATERALLY ON THE TOP BY SLOTTED BLOCKING FOR MINIMUM OF TWO JOIST SPACES, SPACED NOT MORE THAN 4 FEET C.C.

Interior Partition Naming Convention

The diagram illustrates the naming convention for an interior partition. It shows the text 'G4.1a 8'-0"' with arrows pointing to each part of the code. The arrows point to 'G4.1a' and '8'-0"' from the left, and to '8'-0"' from the bottom. The labels are: 'Partition Material Type' (points to 'G'), 'Nominal Stud/Partition Thickness' (points to '4'), 'Fire Rating or other modifier' (points to '1a'), and 'Partition Height. Omitted at walls spanning full height.' (points to '8'-0"').

Partition Material Type

Nominal Stud/Partition Thickness

Fire Rating or other modifier

Partition Height. Omitted at walls spanning full height.

Greystone - Masterplan

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[illegible]

DRAWING TITLE
Floor Plan - Full Basement

DATE ISSUED

DRAWING NUMBER

A402.1


REVISIONS

PROJECT
Address: 2623 SW Firefly Lane
Lees Summit, MO
Lot: 168 Hook Farms 2nd Plat

DRAWING NUMBER

A501



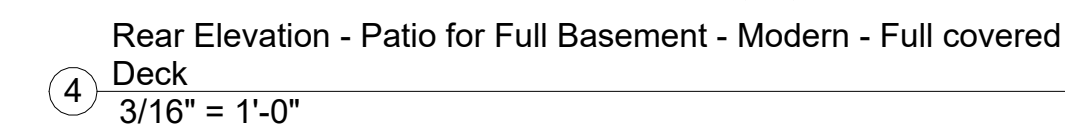

A circular professional seal for Aaron A. Brown, a Registered Architect in the State of Missouri. The seal features the text "STATE OF MISSOURI" at the top, "AARON A. BROWN" in the center, "NUMBER LA-7215" below the name, and "REGISTERED ARCHITECT" at the bottom. A stylized signature is written over the seal.

REVISIONS

PROJECT

Address: 2623 SW Firefly Lane,
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DATE ISSUED

DRAWING NUMBER

A503.1

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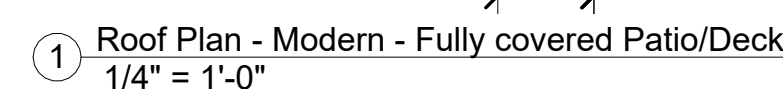
PROJECT

DRAWING TITLE
Roof Plan - Shed - Fully covered
Patio/Deck

DATE ISSUED

DRAWING NUMBER

A602.1










PROJECT


Address: 2623 SW Firefly Lane,
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DATE ISSUED

DRAWING NUMBER

A709



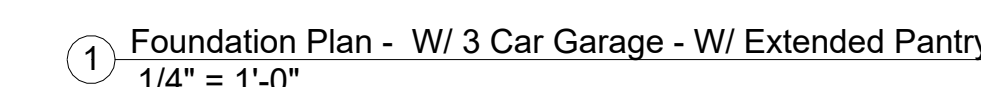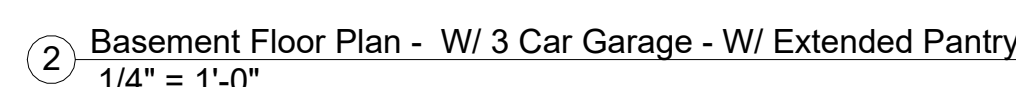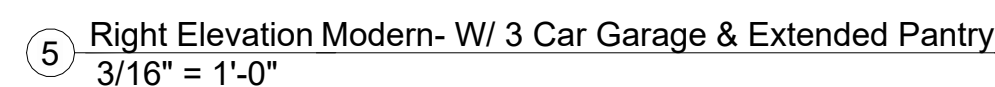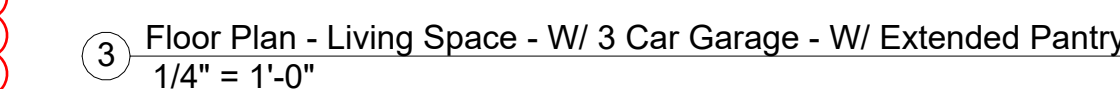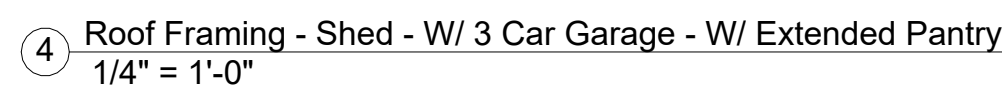

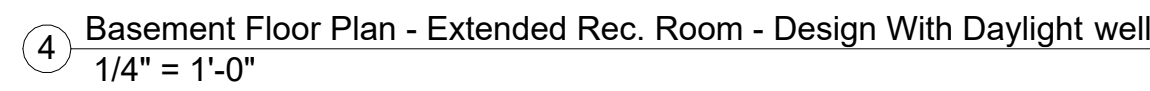1 Basement Floor Plan - Extended Rec. Room - Design
1/4" = 1'-0"

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JANUARY 1, 2025

[illegible]

DRAWING TITLE
POD Options

DATE ISSUED _____

DRAWING NUMBER

A714



Greystone - Masterplan

architect:
Elevate Design + Build
1040 SW Luttrell Road
Blue Springs, MO 64015
816.622.8826 voice
www.elevatedesignbuildkc.com

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PROJECT



Address: 2623 SW Firefly Lane,
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Lot: 168 Hook Farms 2nd Plat

DRAWING TITLE
POD Options


DATE ISSUED

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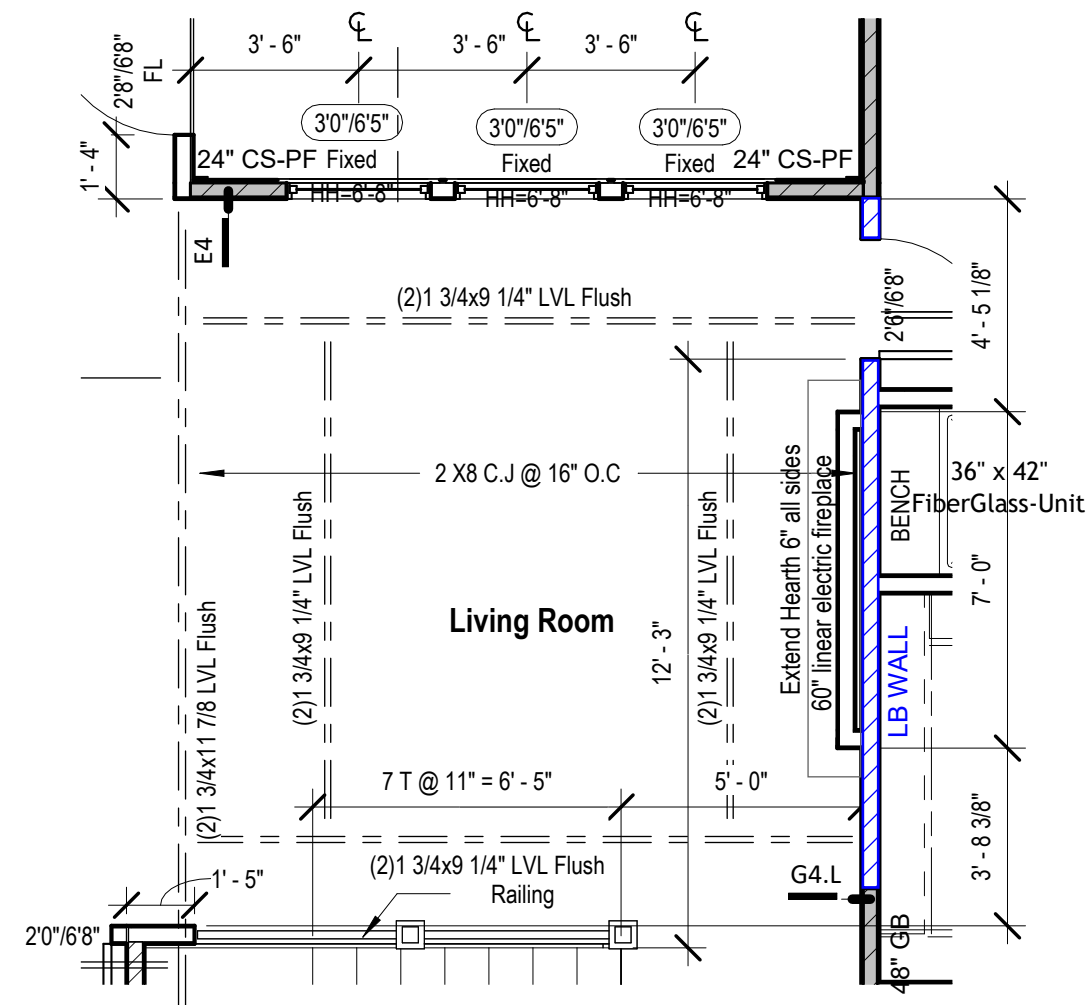
A715

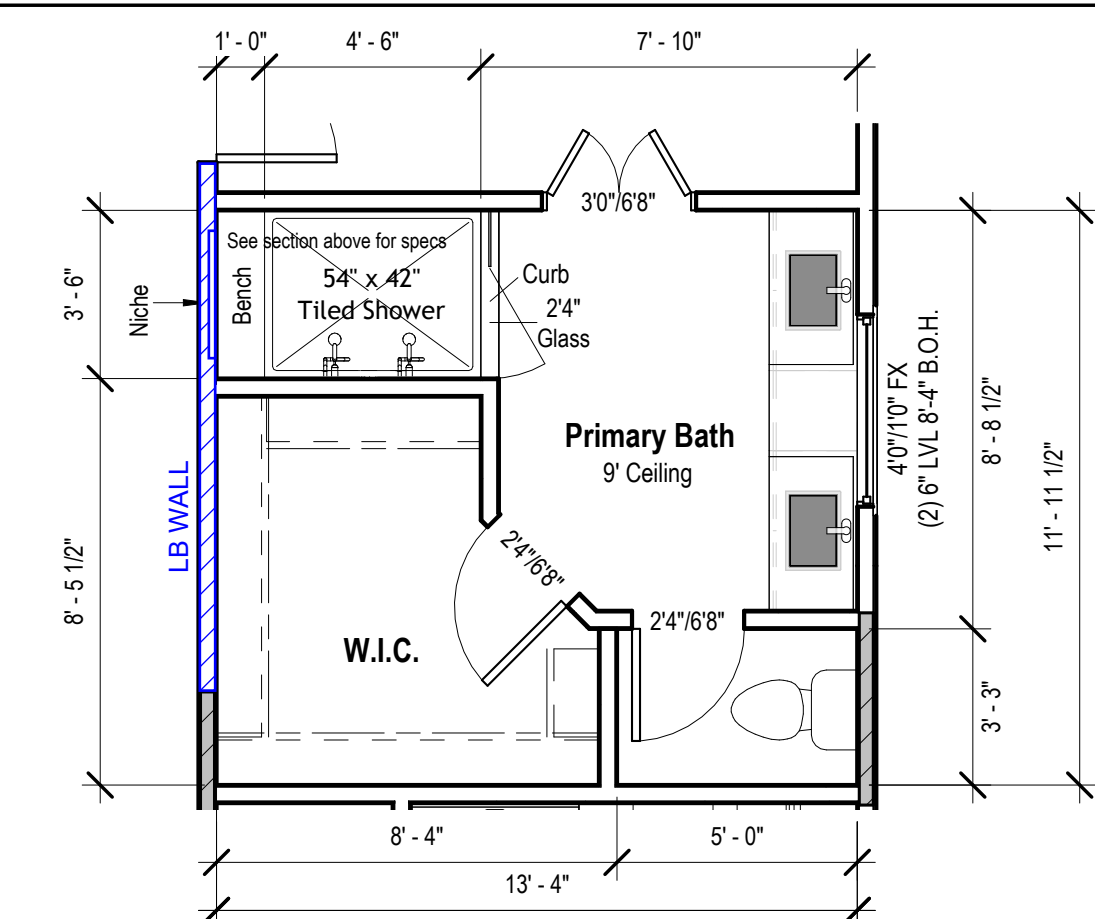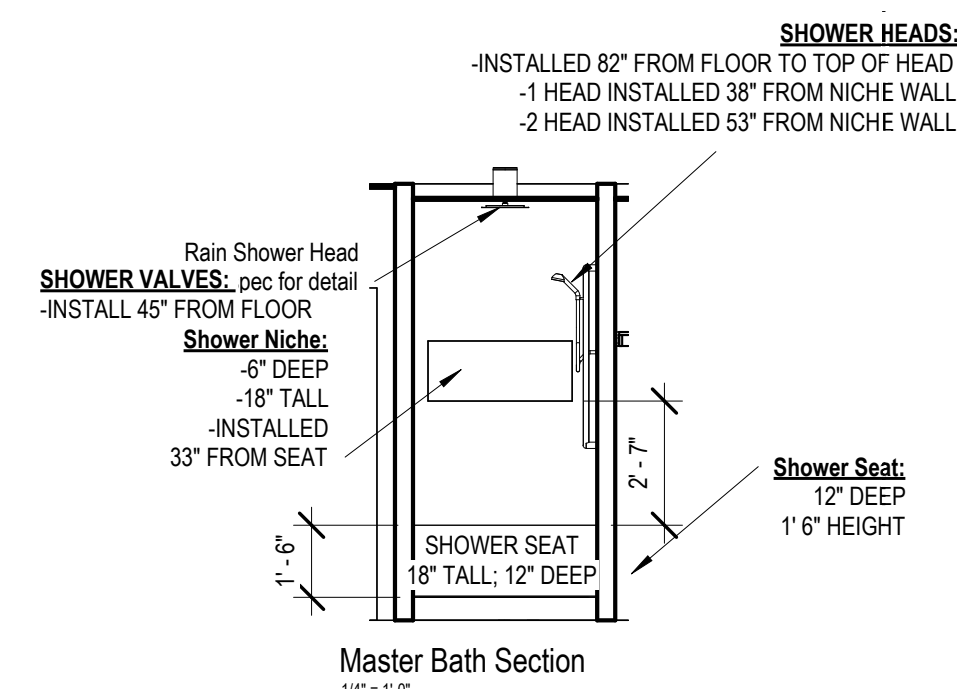


10 Main Level - Primary Bath - Design
1/4" = 1'-0"

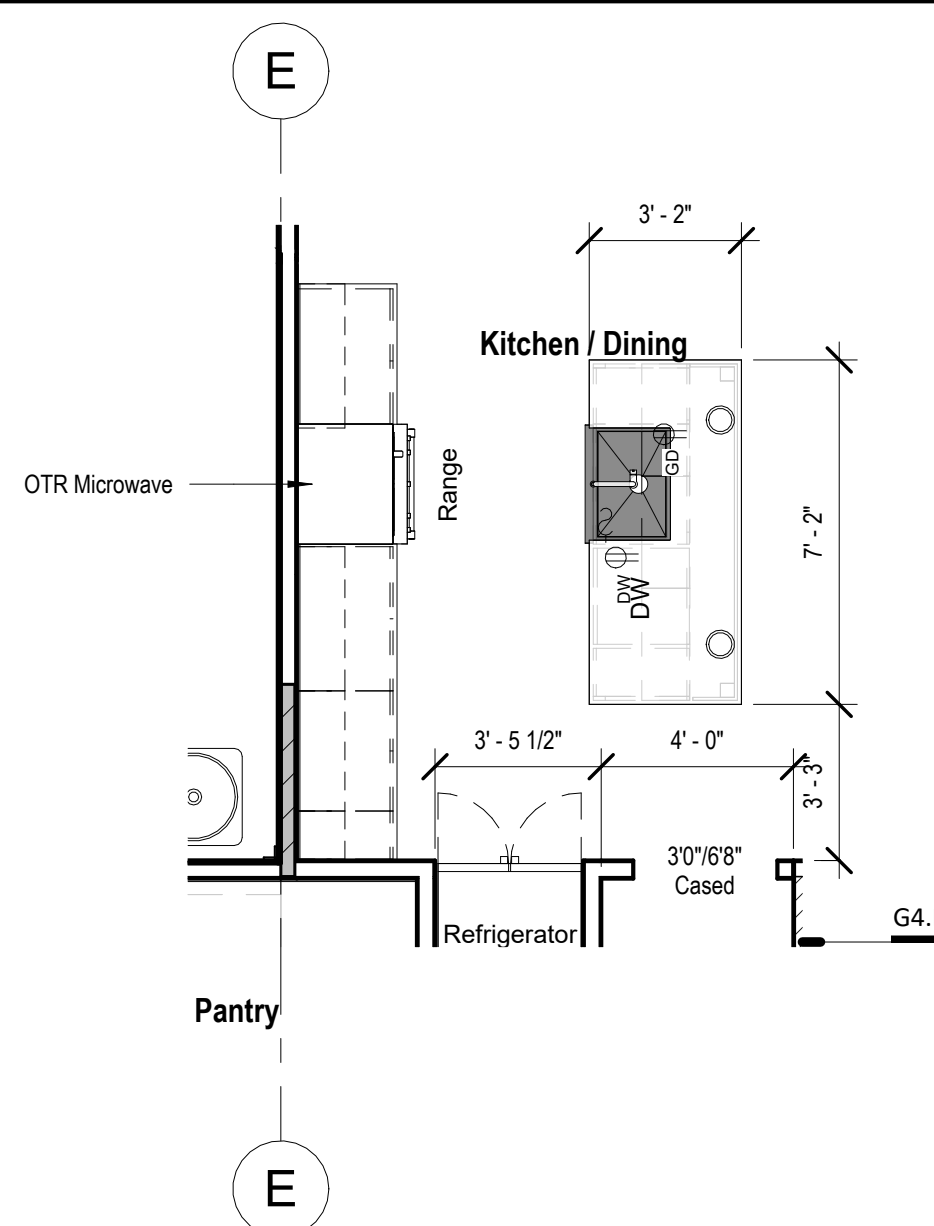


5 Floor Plan - Kitchen - W/ 3 Car Garage - W/ Extended Pantry
1/4" = 1'-0"




4 Floor Plan - Main Level - Living area - Box Vault & Fire Place Option
1/4" = 1'-0"

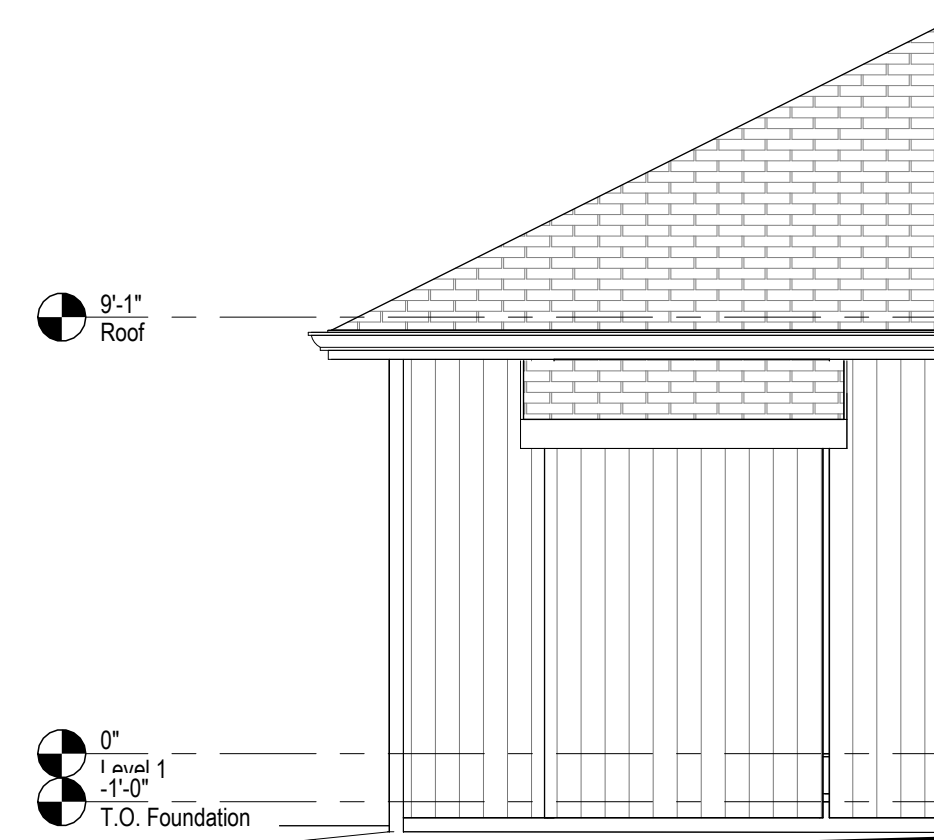


14 Front Elevation - Main Level - Dining - Bumpout Option
1/4" = 1'-0"

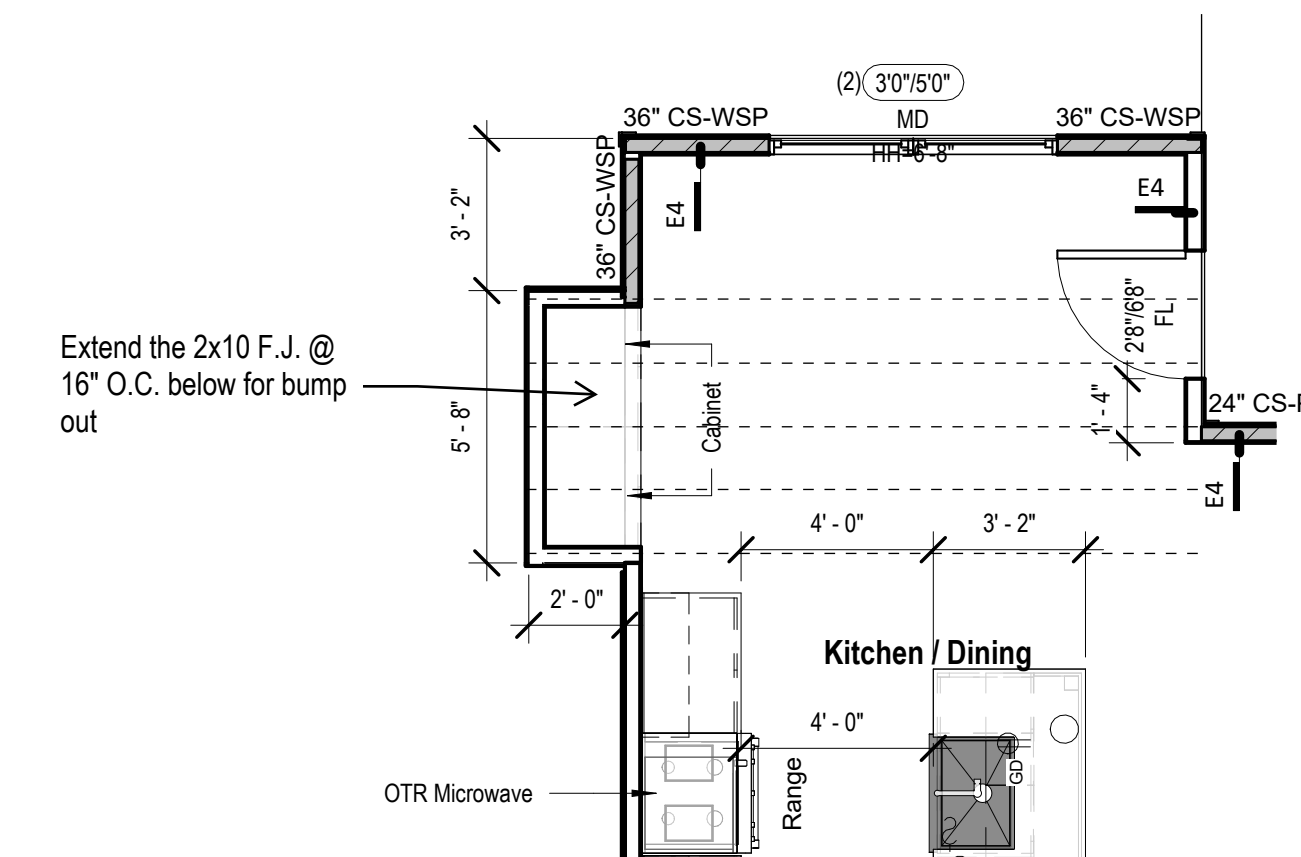

⑥ Front Elevation - Main Level - Dining - Bumpout Option
1/4" = 1'-0"

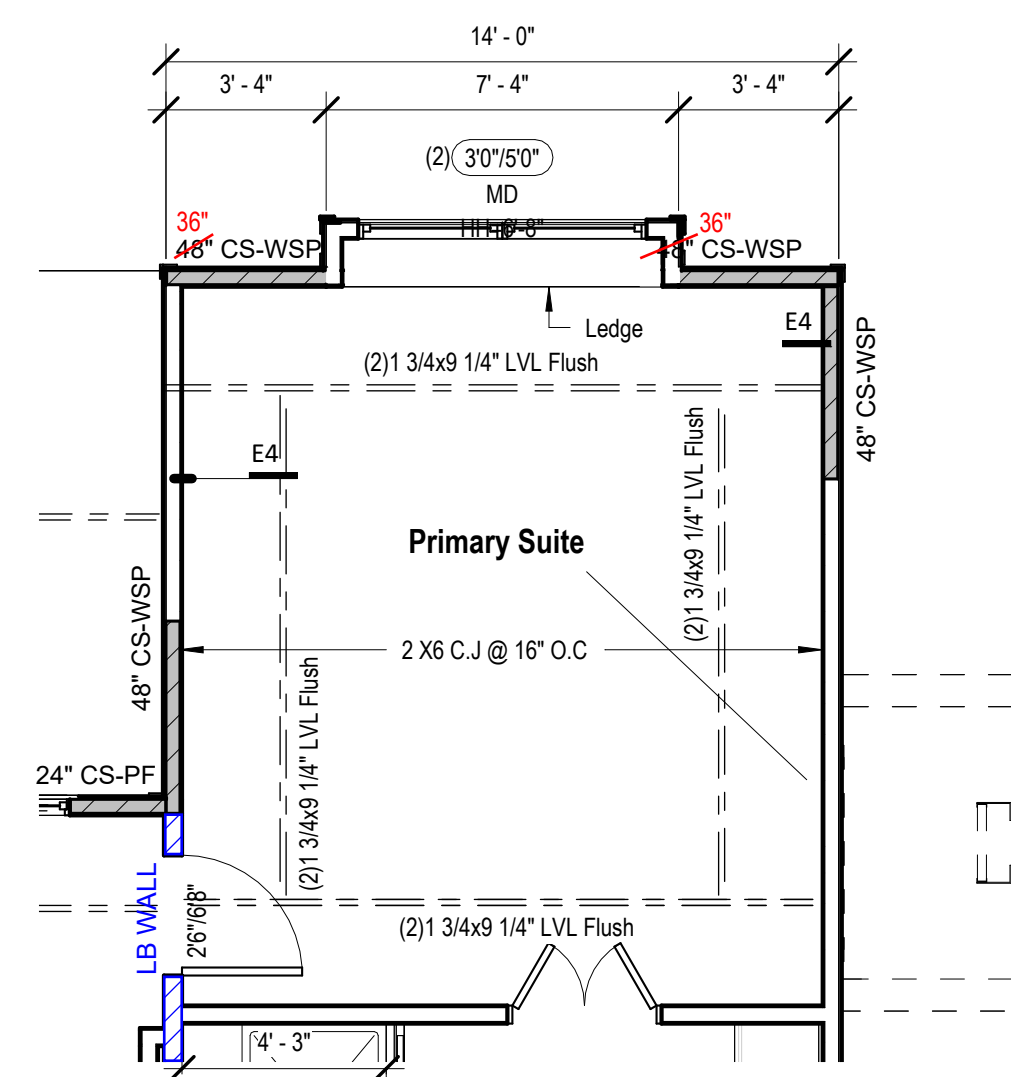

2 Floor Plan - Main Level - Primary Suite - Box Vault
1/4" = 1'-0"

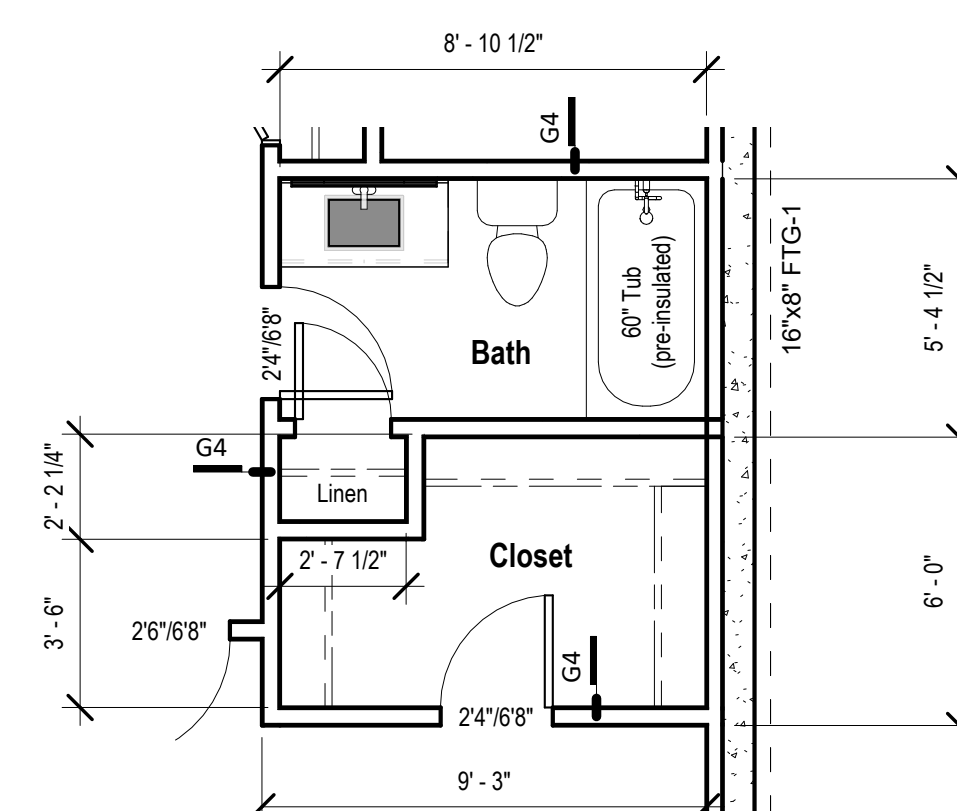

① Basement Floor Plan - Closet POD Option
1/4" = 1'-0"






PROJECT

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Lot: 168 Hook Farms 2nd Plat

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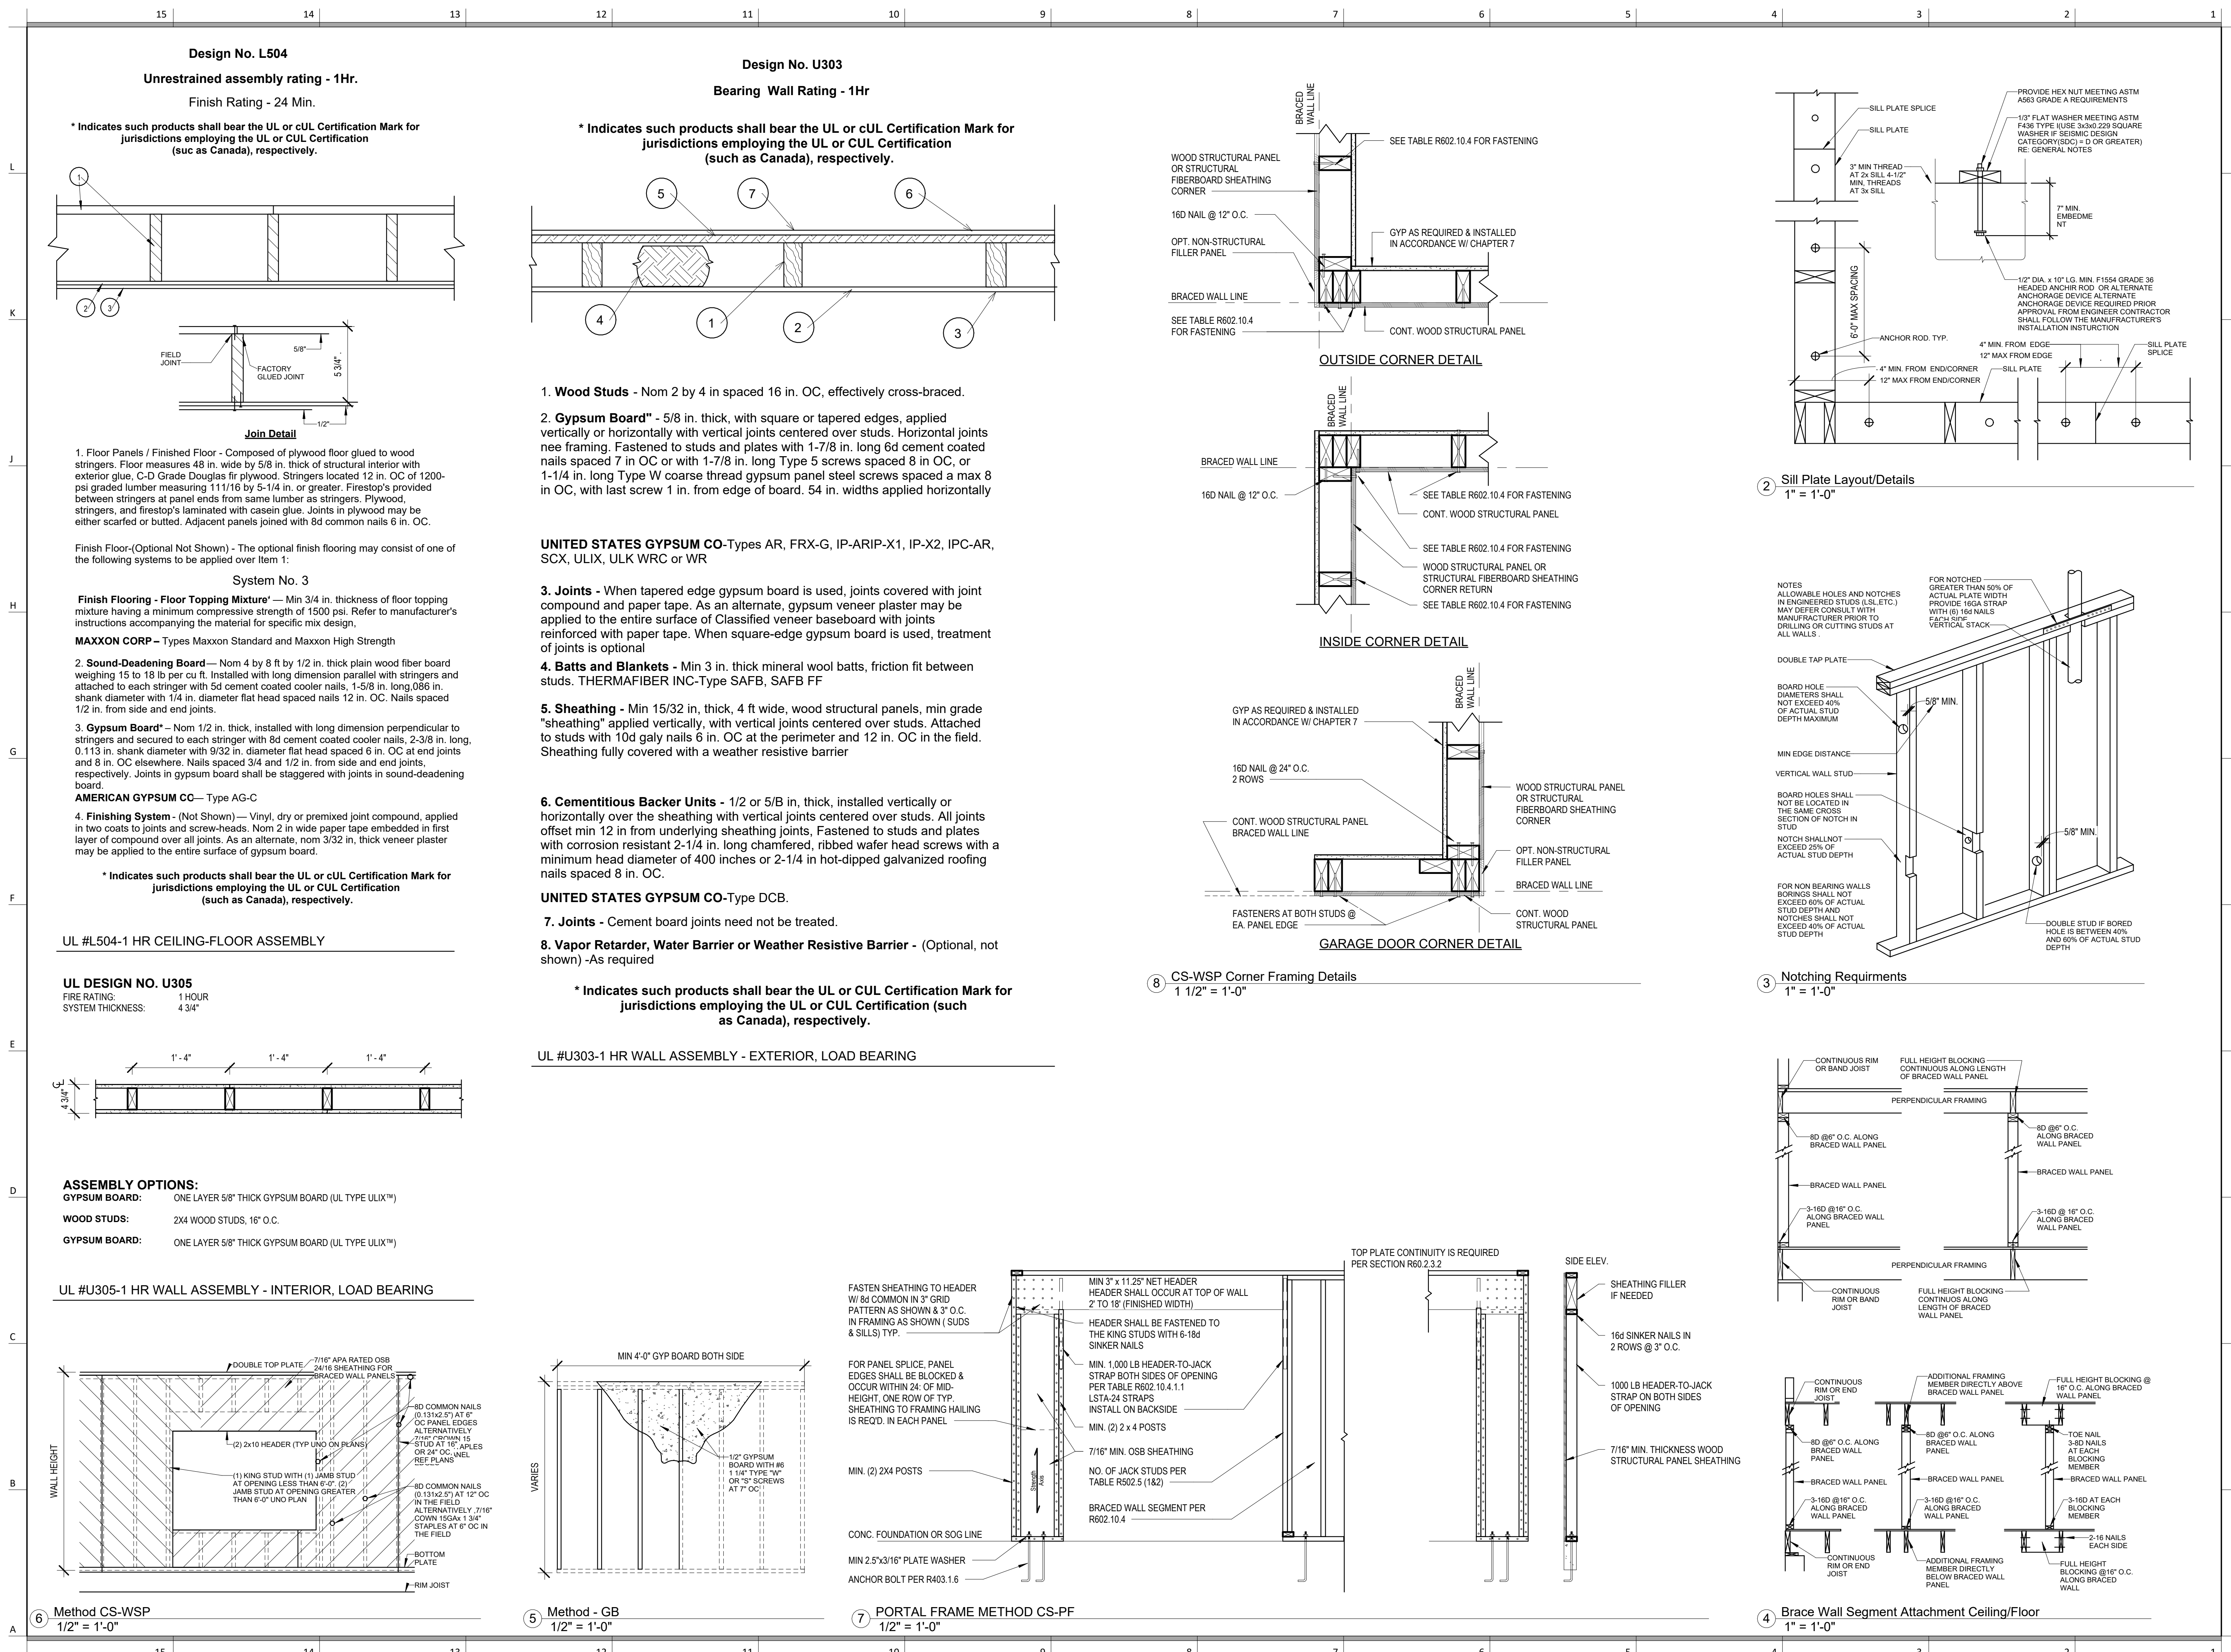
A801

Greystone - Masterplan

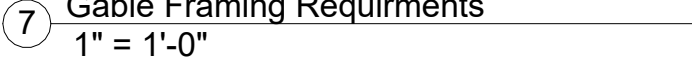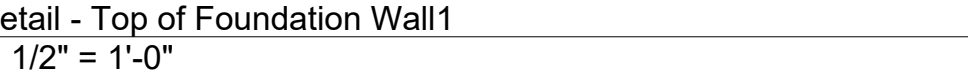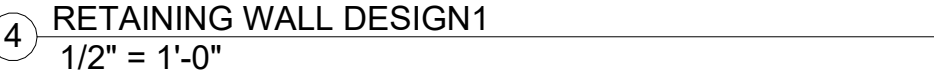

11 Deck Railing
1/2" = 1'-0"





architect:
Elevate Design + Build
350 SW Longview Blvd
Lee's Summit, MO 64081
816.622.8826 voice
www.elevatedesignbuildkc.com

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REVISIONS

Number	DESCRIPTION	DATE
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PROJECT

Address: 2623 SW Firefly Lane,
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Lot: 168 Hook Farms 2nd Plat

DRAWING TITLE

Details

DATE ISSUED

DRAWING NUMBER

A803

COLUMN/PAD DETAIL

N.T.S.

ENERGY CONSERVATION CODE THE FOLLOWING
VALUES ARE NEEDED.

R-15 IN WALLS

R-49 IN ATTICS

R-38 IN VAULTS

R-30 REDUCTION FOR VAULTS IS ONLY FOR 505SF PF AREA

R-19 IN FLOORS OVER UNCONDITIONED SPACES

R-10 IN CRAWL SPACE WALLS

BASEMENT WALLS R-13 CAVITY OR R-10 CONTINUOUS

SLABS SHALL BE R-10 FOR A DEPTH OF 2 FEET

A WINDOW U-FACTOR OF .35 OR BETTER

DUCTWORK NEEDS TO HAVE AN R-8 VALUE

VAULT INSULATION DETAIL

1" AIR SPACE WITH
FOAM AIR CHUTES

2 X 10 VAULT RAFTER

2 X 2 NAILED TO BOTTOM OF
RAFTERS 12" O.C. WITH 12 D
NAILS

R-38 HIGH DENSITY
INSULATION

INTERCONNECTED HARD WIRED SMOKE DETECTORS SHALL
BE INSTALLED IN EACH BEDROOM

ALL PLUMBING IF EXISTING SHALL BE
CAPPED AND AIR TESTED PRIOR TO ROUGH-
IN INSPECTION FOR LEAK VERIFICATION

ICE AND WATER SHIELD REQUIRED ON ALL ROOFS

ROOF IS DESIGNED FOR 25 P.S.F.
SNOW LOAD MIN.

RIDGE BOARDS AND HIPs ARE TO BE 2X
MATERIAL, AND NOT LESS THAN THE END
CUT OF THE RAFTER

2 X 6 DF NO 2 AT 16"
O.C.

7/16" APA
RATED ROOF
SHEATHING

RAFTERS AND CEILING JOISTS
CONNECTIONS IN ACCORDANCE
IRC 802.3

1 X 8 FASCIA OVER 2 X 6
SUBFASCIA

SOFFIT WITH
VENTS

7/16 APA RATED SIDING OVER WATER
RESISTIVE HOUSE WRAP IN COMPLIANCE
WITH SECTION 703.2 OF THE IRC

12" ANCHOR BOLTS AT 5'-0" OC MIN. AND BE LOCATED
WITHIN 12" FROM THE ENDS OF EACH PLATE SECTION.
SHALL EXTEND A MIN. OF 7" INTO CONCRETE

2 X 4 TREATED PLATE OVER SILL
SEALER

SUPPLEMENTAL
REINFORCEMENT AT
CORNERS OF OPENINGS
AND STEP DOWNS REQUIRE
1 #4 BAR 48" LONG AT 45
DEGREE ANGLE AT
CORNERS, WITHIN 6" OF THE
EDGE OF INSIDE CORNERS

7.5" CONCRETE WALL WITH NO 4 BARS HORT. EVERY 18" OF WALL HEIGHT WITH #4
BAR WITHIN 6" OF TOP AND BOTTOM OF WALL. HORT. REBAR SHALL BE INSTALLED
ON SOIL SIDE OF VERTICAL REINFORCEMENT.
VERTICAL REBAR SHALL BE WITHIN 8" OF THE TOP OF THE WALL, AND POSITIONED
2" FROM THE INSIDE FACE OF WALL
VERTICAL REBAR SPACING
WALL HEIGHT IN FEET
6'-0" OR LESS #4 @ 24" O.C.
8'-0" #4 @ 16" O.C.
9'-0" #4 @ 12" O.C.
10'-0" #4 @ 8" O.C.
10'-0" WALL 9.5" #4 @ 12" O.C.

4" DRAIN TILE IN WITH MIN. 6" CRUSHED
ROCK OVER PIPE, DRAIN TO DAYLIGHT,
OR SUMP PUMP IN ACCORDANCE TO
R-405

ASSUMED SOIL
PRESSURE
2,000 PSI

ALL REBAR
GRADE 40
TYP.

MIN. CONCRETE STRENGTH
2,500 PSI BASEMENT FLOOR SLABS UNDISTURBED GRADE
3,000 PSI FOR FOOTINGS, FOUNDATION WALLS AND OTHER VERTICAL CONCRETE
3,500 PSI FOR CARPORT AND GARAGE FLOOR SLABS ON UNDISTURBED GRADE,
AND STRUCTURAL FLOOR SLABS

SPREAD FOOTING MIN.
8" DEEP X 16" WIDE WITH
TWO NO 4 REBAR

4" CONCRETE SLAB WITH NO 4
BARS AT 2'-0" O.C. EACH WAY,
OVER 6 ML VAPOR BARRIER
OVER CRUSHED ROCK

INTERIOR DRAIN TILE MIN. 1 1/2"
MIN. DRAIN TO DAYLIGHT, OR SUMP
PUMP IN ACCORDANCE TO R-405

8 X 16 FOOTING WITH TWO NO 4
BARS HORIZONTAL 3" FROM THE
BOTTOM, ALL FOOTINGS TO EXCEED
MIN. FROST DEPTH OF 36"

MIN. STAIR HEADROOM 6'-8"

ALL STAIRS
MAX. RISE 7-3/4"
MIN. RUN 10"

WINDOW SAFETY GLAZING PER 308

SAFETY GLAZING REQUIRED ALONG WALKING SURFACES AND STAIRS
LOCATED WITHIN 36" HORIZONTALLY OF THE STEPS.
SAFETY GLAZING REQUIRED IF EXPOSED SINGLE PANELS IS IN EXCESS OF 9
SQUARE FEET OR THE BOTTOM EDGE OF THE GLAZING IS LESS THAN 18
INCHES ABOVE THE FINISHED FLOOR.

SAFETY GLAZING REQUIRED WHERE THE NEAREST EXPOSED EDGE OF THE
GLAZING IS WITHIN 24 INCHES OF EITHER VERTICAL EDGE OF THE DOOR IN
A CLOSED POSITION AND WHERE THE BOTTOM EXPOSED EDGE OF THE
GLAZING IS LESS THAN 60 INCHES ABOVE A WALKING SURFACE. SAFETY OR
TEMPERED GLAZING IS REQUIRED.

WINDOWS ARE TO HAVE FALL
PROTECTION PER IRC 312.2

WINDOW EGRESS
REQUIREMENTS

BEDROOM WINDOW EGRESS MINIMUM FOR A DOULE HUNG
WINDOW IS 34" CLEAR WIDTH MIN. AND 24" CLEAR HEIGHT MIN.
WITH A CLEAR OPENABLE AREA OF 5.7 SQUARE FEET MIN.
A CASEMENT OR SLIDER WINDOW MIN. IS 20" CLEAR WIDTH MIN.
AND 41" CLEAR HEIGHT MIN. WITH A MIN. 5.7 SQUARE FOOT OF
OPENABLE AREA.
OPENING OF EGRESS WINDOW NOT MORE THAN 42" FROM THE
FLOOR

ALL POINT LOADS SHALL HAVE A MINIMUM OF 2 STUDS UNLESS NOTED OTHERWISE

BEAM POCKET DETAIL

N.T.S.

1. DWELLING / GARAGE OPENINGS BETWEEN GARAGE AND SLEEPING PURPOSES SHALL NOT BE PERMITTED.
OTHER OPENINGS SHALL BE EQUIPPED WITH SOLID WOOD OR STEEL DOORS NOT LESS THAN 1-3/8" THICK
OR 20 MIN. RATED DOORS, WITH SELF CLOSING DEVICES REQUIRED FOR GARAGE / DWELLING SEPARATION
DOORS R302.5.1

2. WHOLE HOUSE MECHANICAL VENTILATION SYSTEM IS REQUIRED FOR ANY DWELLING IN COMPLIANCE
WITH IRC M 1505

3. CARBON MONOXIDE DETECTORS REQUIRED IRC R 315

4. STEEL COLUMNS SHALL BE MINIMUM SCHEDULE 40 R407.3

5. DECK SHALL BE BUILT PER TABLES 507.2, 507.2.1, 507.3, 507.6, 507.5.1(2) & (2), 507.5, AND 507.6

6. STUDS SHALL BE CONTINUOUS BETWEEN FLOOR, CEILING AND OR ROOF DIAGRAMS R602.3

7. ADDED REQUIREMENTS FOR WINDOW FALL PROTECTION R312.2

8. NEW PROVISIONS FOR ATTACHMENT OF RAFTERS, TRUSSES AND ROOF BEAMS R802.3.1 AND R802.11

9. INSULATION REQUIRED FOR ALL BASEMENT WALLS (INCLUDING UNFINISHED BASEMENTS) N1102.1

10. EXTERIOR WINDOWS / DOORS SHALL HAVE U-FACTOR 0.35 AND GALZING SHALL HAVE SOLAR HEIGHT
GAIN FACTOR OF 0.40 N1102.1

11. HOUSE LEAKAGE AND DUCT LEAKAGE PERFORMANCE STANDARDS EFFECTIVE JANUARY 1, 2014. A
SAMPLE TESTING PROGRAM WILL BE IMPLEMENTED OCTOBER 1, 2012 KCBRC N1102.4.1.2 AND N1103.2.2

12. LIGHTING FIXTURES PENETRATING THE THERMAL ENVELOPE (E.G. CAN LIGHTS IN ATTIC) SHALL BE IC-
RATED, LEAKAGE-RATED AND SEALED TO THE GYPSUM WALLBOARD N1102.4.4

13. PROGRAMMABLE THERMOSTAT REQUIRED N1103.1.1

14. AIR HANDLERS SHALL BE RATED FOR MAXIMUM 2% AIR LEAKAGE RATE N1103.2.2.1

15. BUILDING CAVITIES USED AS RETURN AIR PLENUMS SHALL BE SEALED TO PREVENT LEAKAGE ACROSS
THE THERMAL ENVELOPE KCBRC N1103.2.2

16. CERTAIN HOT WATER PIPES SHALL BE INSULATED N1103.4

17. ALL EXHAUST FANS SHALL TERMINATE TO BUILDING EXTERIOR M1507.2


18. MAKEUP AIR SYSTEM REQUIRED FOR KITCHEN EXHAUST HOODS THAT EXCEED 400CFM M1503.4

19. BUILDING CAVITIES IN A THERMAL ENVELOPE WALL (INCLUDING THE WALL BETWEEN THE HOUSE AND
THE GARAGE) SHALL NOT BE USED AS RETURN AIR PLENUMS

20. AN AIR HANDLING SYSTEM SHALL NOT SERVE BOTH THE LIVING SPACE AND THE GARAGE M1601.6

21. A CONCRETE - ENCASED GROUNDING ELECTRODE ('UFER' GROUND) CONNECTIONS SHALL BE PROVIDED
TO THE ELECTRICAL SERVICE E3608.1

22. COMPLIANCE WITH THE REQUIREMENT AND SHOW CONNECTION AS NEEDED FOR ROOF BEAM, TRUSS,
RAFTER AND GROUND CONNECTION FOR UP LIFT PER IRC 802.11. ALL RAFTERS MUST BE IN COMPLIANCE WITH
IRC 802.11. AMENDED RAYMORE CODE

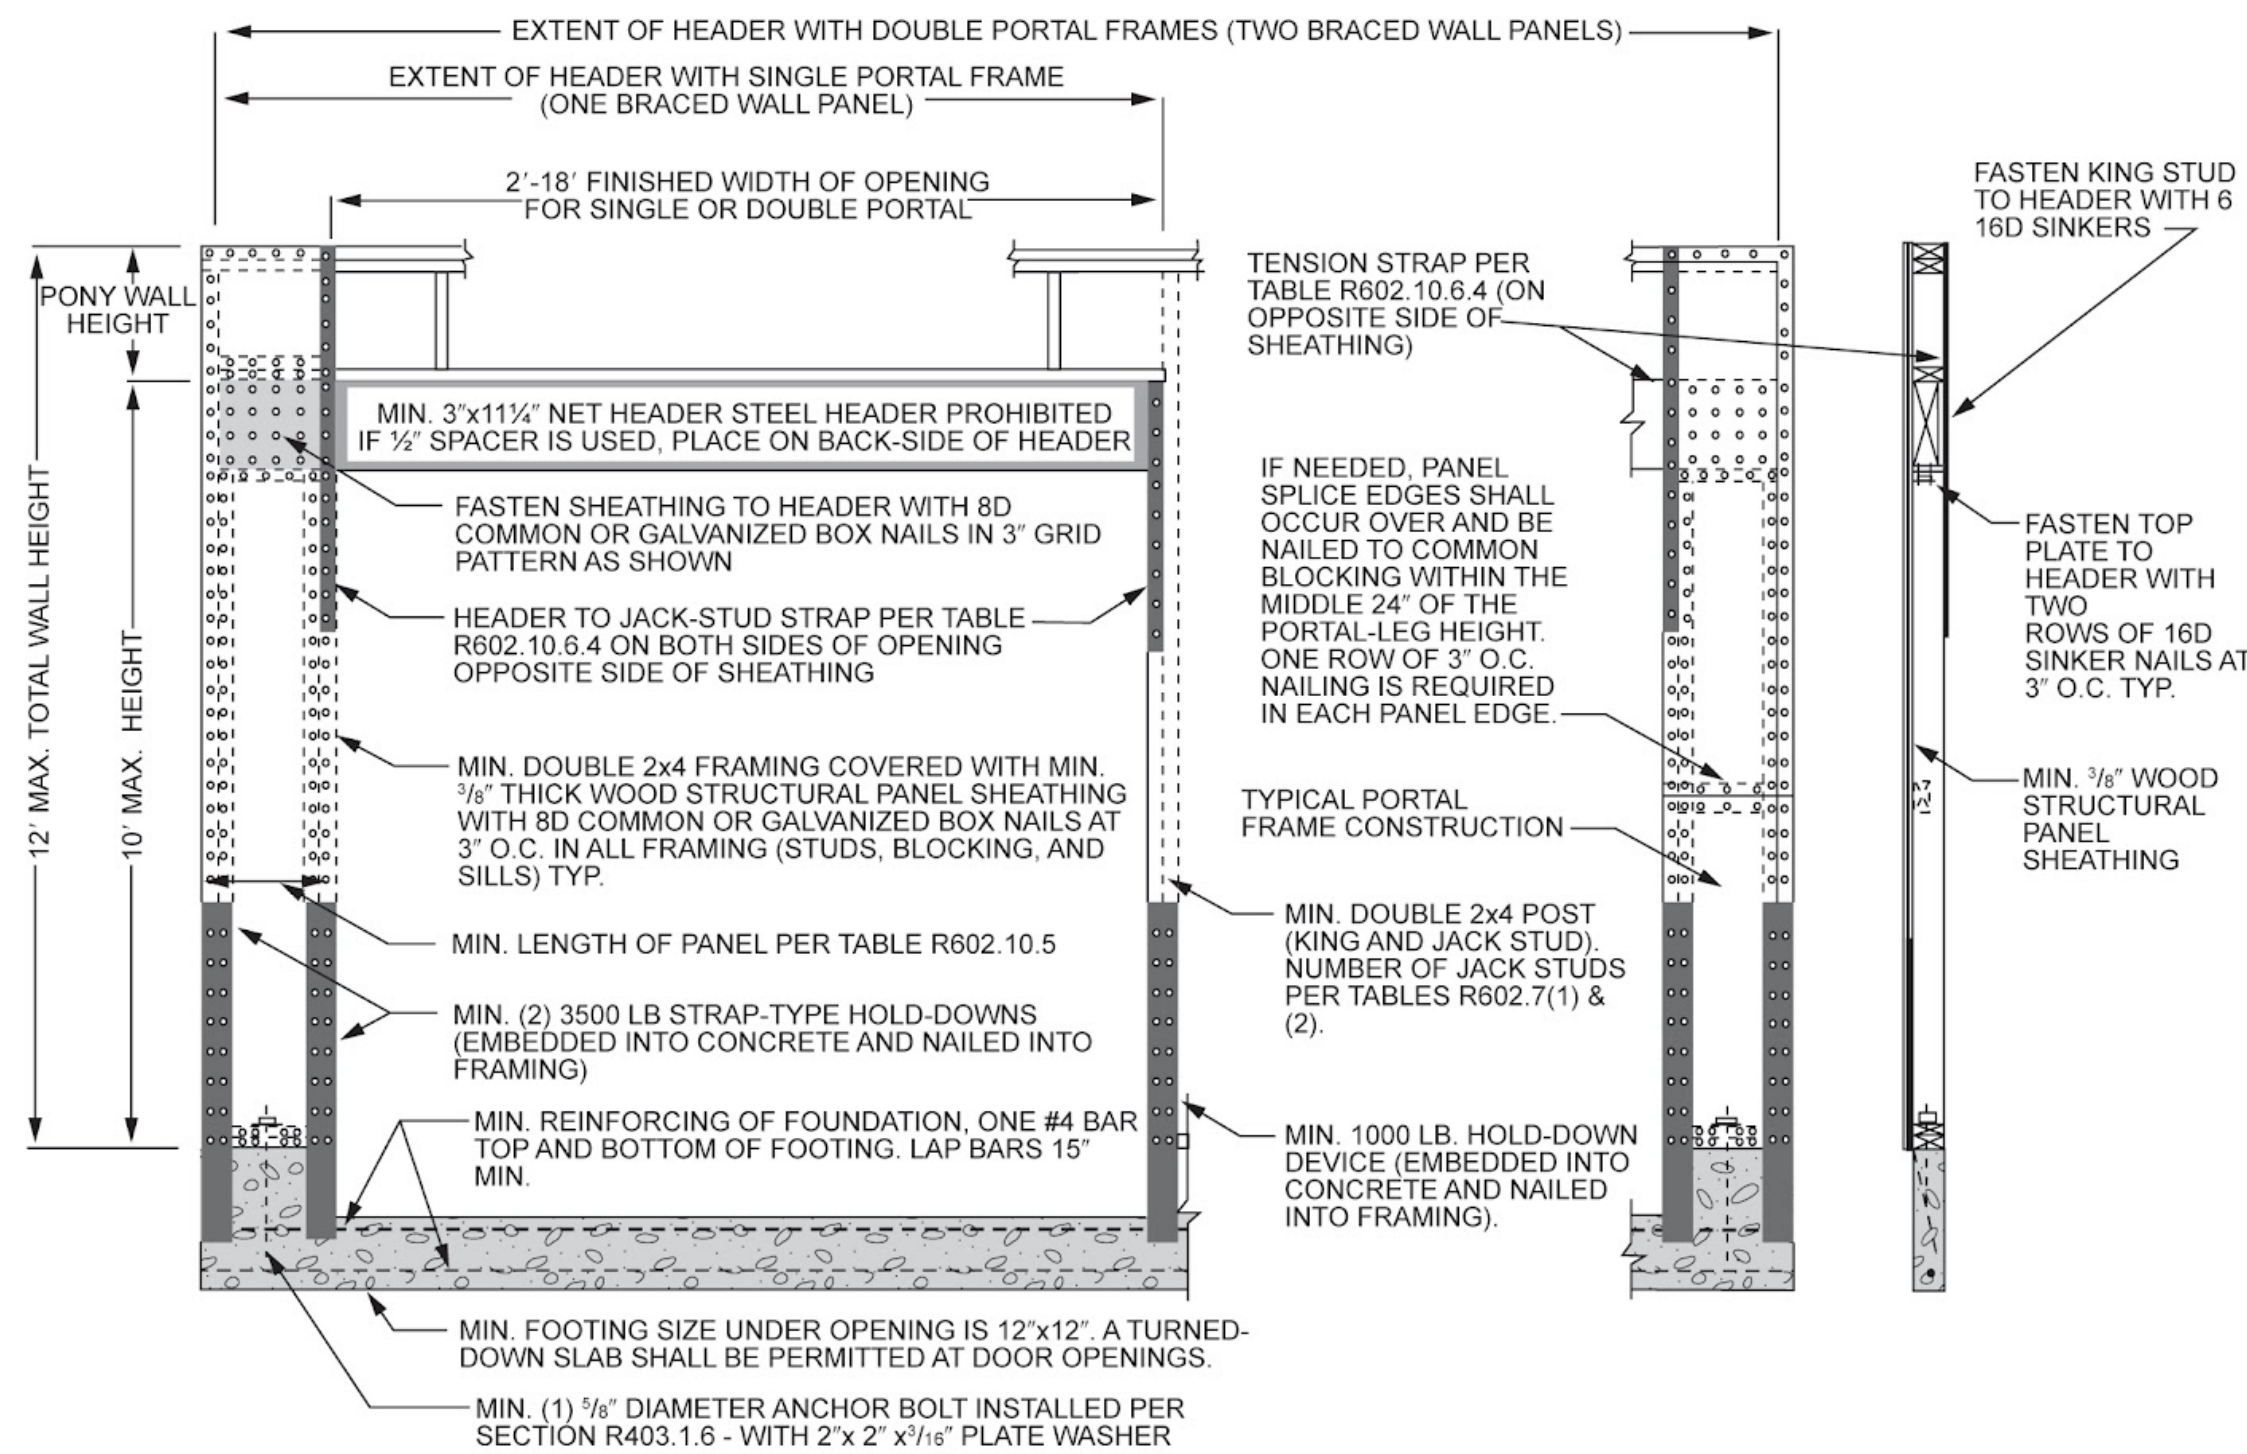

FRONT ELEVATION

SECTION

PORTAL FRAME WITH HOLD DOWN

CEILING JOISTS AND RAFTER CONNECTIONS
CEILING JOISTS AND RAFTERS SHALL BE TED TO ONE ANOTHER PER TABLES R602.3(1)
AND R802.5.1(9) AND THE ASSEMBLY SHALL BE NAILED TO THE TOP PLATE PER R602.3(1)
CEILING JOIST NOT PARALLEL TO RAFTERS USE SUBFLOORING OR METAL STRAPS ATTACHED
TO END OF THE RAFTERS TO PROVIDE A CONT. TIE ACROSS THE STRUCTURE

TIE DOWN REQUIREMENTS (R802.11)
FOR RAFTER SPANS OVER 20'-0" INTERPOLATING TABLE 802.11 PROVIDE
RATER TIE-DOWNS CAPABLE OF RESISTING OVER 228 POUNDS AT EACH RAFTER
PER TABLE R802.5.1(2) THE MAX RAFTER SPAN FOR D.F.L. 2 x 6 RAFTERS
#2 GRADE = 14'-1" AND IS THE BASIS OF DESIGN FOR PURLIN PLACEMENT

RAFTERS TIES:
1. REQUIRED AT ALL RAFTERS
2. MIN. OF 2 X 4 AND SPACED
NO GREATER THAN 48" O.C.

FOR FULL VAULT

WHERE NO COLLAR TIES CAN BE INSTALLED,
PROVIDE AT EA. RAFTER A SIMPSON STRONG TIE
LRU28Z HANGER OR EQUIVALENT TO RIDGE BEAM
W/ (6) 10D NAILS TO RIDGE & (5) 10D NAILS
TO EACH RAFTER

PURLINS:
1. PURLINS NO SMALLER THAN
THE RAFTERS THEY SUPPORT
2. PURLINS TO BE CONTINUOUS
3. BRACES SPACED NO MORE THAN
4'-0" O.C.
4. UNBRACED LENGTH OF BRACES
SHALL NOT > 8'-0"

RAFTERS TIE SAME
SIZE AS JOIST AT OP

PER TABLE
R802.5.1(9)
REQUIRES (3)
16d NAILS

CEIL'G JOISTS

SUBFLOORING OR METAL STRAPS
TO END OF THE RAFTERS TO PROVIDE
CONT. TIE ACROSS THE STRUCTURE

JOISTS PERP. TO RAFTERS

MIN. (3) 10D NAILS

2 X 4 COLLAR TIE

2 X 4 BRACE @ 48" O.C.
MAX LENGTH = 8'-0"

RAFTERS TIE REQUIRED
AT EVERY RAFTER

CEIL'G JOISTS

TOENAIL BRACE TO PLATE
W/ 16d-ONE PER SIDE

DOUBLE TOP PLATES

1'-4"

45-d

MIN. (3) 10D NAILS

CONT. PURLIN BETWEEN
BRACES-NOTCH BRACE
3/4" MIN-ATTACHED W/
(5) 16d

1/2 RAFTER SPAN

1/2 RAFTER SPAN

COLLAR TIE
EVERY 3RD
RAFTER @ 48" O.C.

1/2 RAFTER SPAN

1/2 RAFTER SPAN

1/2 RAFTER SPAN

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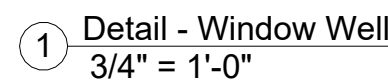
1/2 RAFTER SPAN

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DRAWING NUMBER

A804



PARTITION SYSTEM:
GYPSUM WALL BOARD PARTITION

PARTITION SYSTEM:
GYPSUM FURING PARTITION

PARTITION SYSTEM:
Exterior Partition

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