

Greystone Modern - Lennard

Lot :167, Hook Farms
 Address: 2619 SW Firefly Ln., Lee's Summit, MO

General Information

2018 Interior Energy Cons. Code (Table N1102.1.2)	
Doors & Windows:	U-0.32 MAX
Glazing SHGF:	0.40
Skylights:	U-0.55 MAX
Roof	
Attic Ceilings:	R-49 MIN
Vaults:	R-38 MIN
Vaults < 500sf:	R-30 MIN
Wood Frame Walls:	R-20 or R-13 + 5 MIN
Basement Walls:	R-13 or R-10 Continuous
Floor (over unconditioned):	R-19 MIN
Slab on Grade:	R-10 for 24" MIN
Ductwork:	R-8 MIN
Fuel Fired Furnace:	90% AFUE MIN
Electric Furnace:	No Minimum
Cooling System:	13 SEER MIN
Water Heater	
Gas Fired Storage:	0.67 EF MIN
Gas Fired Instant:	0.62 EF MIN
Electric Storage:	0.97 EF MIN
Electric Instant:	0.93 EF MIN

An energy efficient certificate is required to be posted in or on the electrical panel before the final inspection. The certificate will be provided with all new residential permits. It is the permit holder/contractor's responsibility to ensure the certificate has accurate information and is posted before final inspection - Owner/Contractor is responsible for meeting the prescriptive requirements of IRC chapter 11 unless a HER Index Analysis for Performance Compliance based on the plans is submitted to the AHJ for approval.

IRC 2018	
Ground Snow Load:	20PSF
Wind Speed:	115mph
Topography Effects:	No
Seismic Design Category:	A
Damage From Weather:	Severe
Frost Line Depth:	36 inches
Termite:	Moderate to Heavy
Winter Design Temperature:	6 F
Ice Barrier Underlayment:	Yes
Flood Hazard:	
Air Freezing Index:	927 or less
Mean Annual Temperature:	55.5 F

- Whole House Mechanical Ventilation System is required for any dwelling with air infiltration at a rate of less than 5 air changes per hour (at ACH50 standard R303.4).
- Carbon monoxide detectors required (R315)
- Steel columns shall be minimum schedule 40 (R507.2)
- Deck Ledger attachment to house shall be per Tables 507.9.1.3.
- New provisions for attachment of rafters, trusses and roof beams. (R802.3 and R802.11)
- Programmable thermostat required (N1103.1.1)
- Air handlers shall be rated for Maximum 2% air leakage rate (N1103.2.2.1)
- Building cavities used as return air plenums shall be sealed to prevent leakage across the thermal envelope. (N1103.2.3)
- Certain hot water pipes shall be insulated (N1103.4)
- All exhaust fans shall terminate to the building exterior (M1507.2)
- Makeup air system required for kitchen exhaust hoods that exceed 400 CFM M1503.4
- Building cavities in a thermal envelope wall (including the wall between the house and garage) shall not be used as return air plenums (unless the required insulation and air barrier are maintained) (M1601.1.1.#7.5)
- An air handling system shall not serve both the living space and the garage (M1601.6)
- A concrete-Encased grounding electrode (UFER Ground) connection complies with the requirements of the 2018 IRC Section E3608.1.2 in providing a connection with no less than the required minimum of steel.
- Compliance with the requirements and show connection as needed for roof beam, trus, rafter, and girder connections for uplift per IRC 802.11
- Garage Door Rating: DASMA 115 MPH Rated



2018 IRC BUILDING CODE COMPLIANCE
 THESE DRAWINGS HAVE BEEN PREPARED WITH RESPECT TO COMPLIANCE OF THE 2018 IRC AND NEC 2017 ANY REFERENCES FOUND NOT CORRECTLY IDENTIFIED TO THESE CODES SHALL BE BROUGHT TO THE ATTENTION OF SSIONAL THE DESIGN PROFESSIONAL



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Sheet List - HF167	
Sheet No	Sheet Name
00	Cover Sheet
A101	Front Elevation
A301.1	Side Elevations - Full Basement - Shed
A401.1	Foundation Plan - Full Basement
A402.1	Floor Plan - Full Basement
A501	Floor Plan - Main Level
A502.1	Floor Plan - Main Level Deck & Pato - shed
A601.1	Roof Plan - Shed
A708	Floor Plan - W/ 3 Car Garage - W/ Extended Pantry
A715	POD Options
A801	Details
A802	Details
A803	Details



11 Basement Area - W/ Extended pantry 1/16" = 1'-0"
 5 Main Level Area - W/ Extended pantry 1/16" = 1'-0"

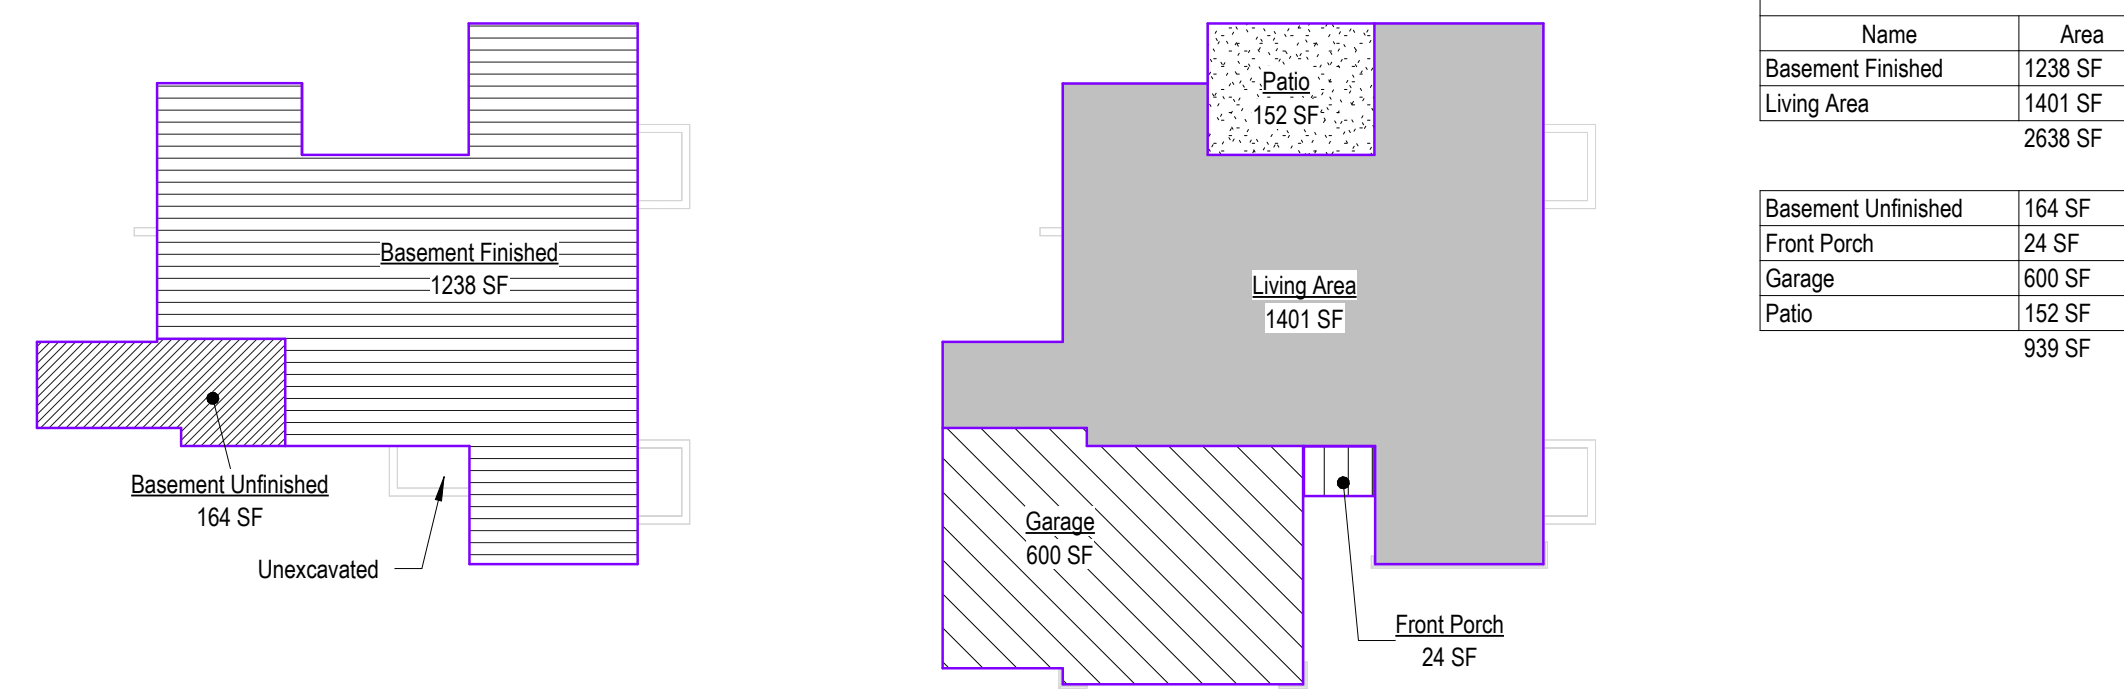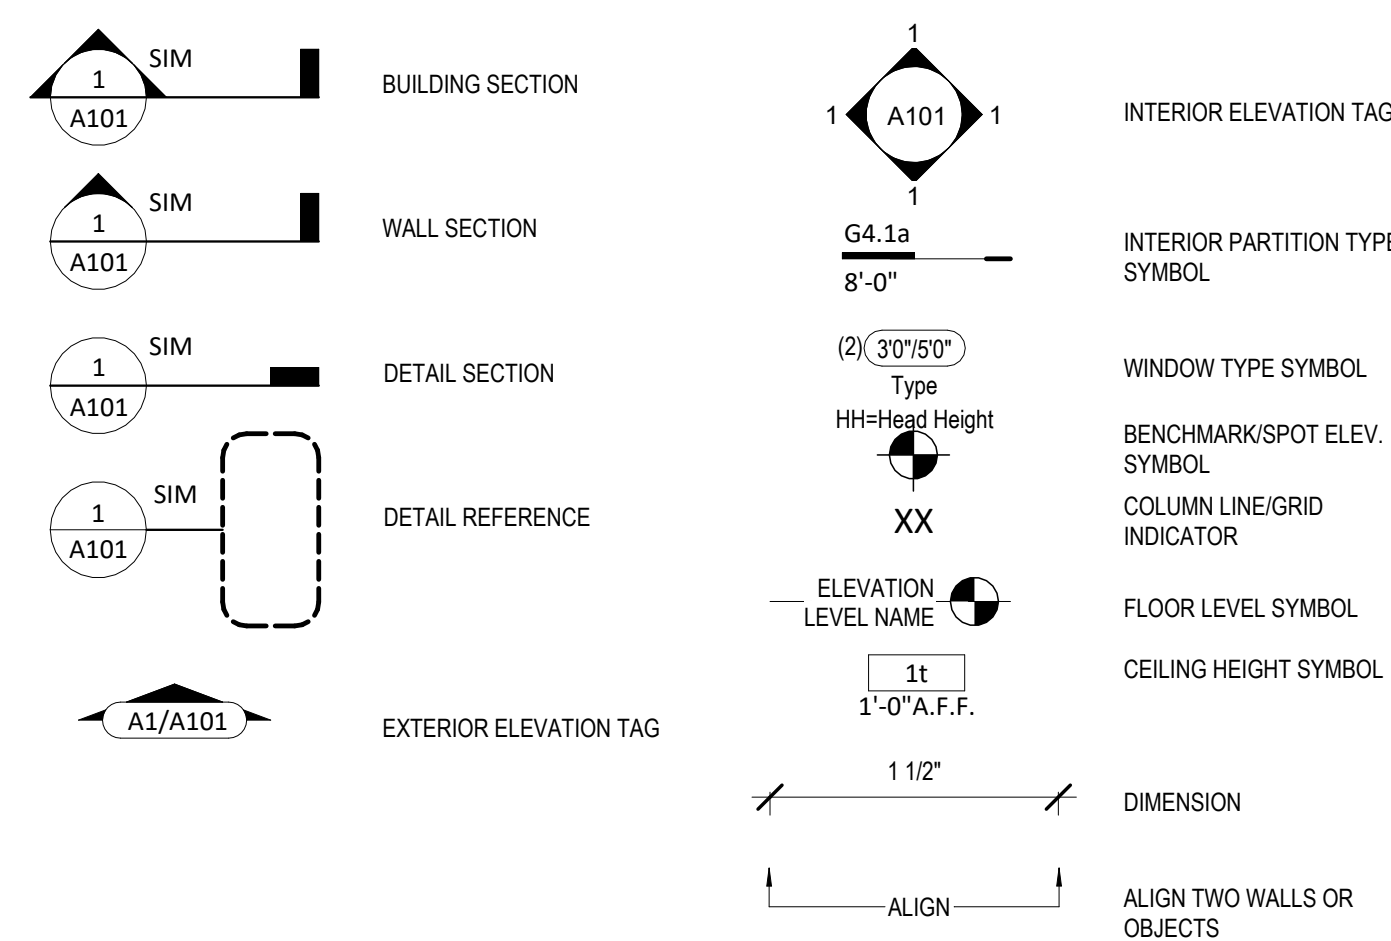RELEASE FOR CONSTRUCTION
 AS NOTED FOR PLAN REVIEW
 DEVELOPMENT SERVICES
 LEE'S SUMMIT, MISSOURI
 04/11/2025

REVISIONS		Permit Set
Original Issue Date:		10/1/2021
Number	Description	Date



Permit Set

PLAN DESCRIPTION: Cover Sheet

00

Project No.

Slab Schedule	
Type	Description
S4.1	4" MIN CONC SLAB REINF. W/ #4'S E.W. @ 12" O.C. OVER COMPACTED FILL AND GRAVEL
S8.1	8" MIN CONC SLAB REINF. W/ #4'S E.W. @ 12" O.C. OVER COMPACTED FILL AND GRAVEL

Structural Foundation Schedule				
Type	Width	Length	Depth	Comments
Footings				
F1	3'-0"	3'-0"	1'-0"	Reinf w/ (6) #4's, rebar count is each way, equal centers
F2	4'-0"	4'-0"	1'-4"	Reinf w/ (8) #4's, rebar count is each way, equal centers. (8) #4's, vertical rebar count in ped column. 16" pd below gar. door block-down and/or bottom of slab.
Foundation - Round				
F3	1'-4"	1'-4"	3'-0"	ABA662 Post Base. Refer to Detail for Reinforcing.
Wall Foundation				
FTG-1	1'-4"	<varies>	0'-8"	Reinf w/ (2) #4 bot. eq. spaced. Dowel into wall w/ (1) #4 turned up @ 12" o.c. <varies>

Foundation Wall Schedule		
Type	Width	Comments
C8	0'-8"	Reinf. w/ #4 vert. @ 12" oc / (3) #4 hor. equally spaced.

Foundation Notes:

- FOOTINGS FOUNDATION & CONCRETE NOTES
1. TO ADDRESS DIFFERENTIAL SETTLEMENT, ALL INTERIOR BEARING AND EXTERIOR FOOTINGS & PADS TO BE EXCAVATED & PLACED MIN. 18 INCHES INTO UNDISTURBED NATURAL SOIL.
2. EXT. FOOTING TO BE PLACED MIN. 36-INCHES BELOW FIN. GRADE
3. DESIGN IS BASED ON MIN. OF 2,500 PSF. CONCRETE STRENGTHS TO ACHIEVE THE FOLLOWING BASED UPON:
 - 3,000 PSF FOR FOOTINGS, FOUND WALLS & VERT. SUPPORTS
 - 3,500 PSF FOR GARAGE FLOOR
4. CONC. EXPOSED TO WEATHER TO HAVE 6% (+/-1%) AIR ENTRAINMENT
5. PROVIDE 4" MIN. CONC. SLAB REINF. W/ #4 @ 12" O.C. E.W. TOP REINF. OVER PEDESTALS AS INDICATED IN F.T. @ 8" O.C. E.W. PLACE OVER 6 MIL VAPOR BARRIER
6. REINFORCE EXTERIOR FOOTINGS W/ #4 @ 24" E.W., REINFORCE W/ (2) #4 CONT. AT BOTTOM
7. PROVIDE #4 X 4" (L) @ 45 DEGREES @ REINFRANT CORNERS
8. 17" FULL ASTM A829 ANCHOR BOLTS @ 48" O.C. @ EXT. WALLS
9. ANCHOR PRESSURE TREATED PLATE @ INT. BEARING WALLS W/ 1/2" X 4-1/2" H/LTI WEDGE PLATE @ 12" O.C. MAX. 12" FROM ENDS
10. PROVIDE 2" LAPS MIN. INCLUDING CORNERS
11. INSTALL HOLDOWN BOLT ANCHORAGE AS INDICATED ON PLAN
12. PROVIDE RETURNED DAMP-PROOFING AT FOUNDATION WALLS
13. SOIL BEARING CAPACITY IS NOT ASSUMED TO BE GREATER THAN 2,000 PSF IN THE CURRENT FOUNDATION DESIGN. ALL COMPACTED FILL AREAS REQUIRE A SPECIAL INSPECTION.

STEEL COLUMNS & OTHER BASEMENT FOUNDATION NOTES


1. ALL STEEL PIPE COLUMNS TO BE 3" OR 1 1/2" (SCHEDULE 40) GRADE
2. INTER. BEARING WALLS & COLUMNS SHALL BE ISOLATED FROM THE BASEMENT FLOOR SLAB
3. INTER. NON-BEARING WALLS, OTHER THAN THOSE RESTING DIRECTLY ON THE FOOTING, SHALL BE ISOLATED FROM THE FLOOR FRAMING ABOVE
4. AT WALKOUT FOUNDATION AREAS, REINFORCE THE SLAB FROM THE FOUNDATION WALL TO 2 FEET BEYOND THE OVERCURE AREA WITH #4 BARS AT 24 INCHES O.C. PERPENDICULAR AND HORIZONTAL TO THE WALL, MAXIMUM 4 FOOT OVERCURE.
5. AT WALKOUTS THE FOUNDATION WALL SHALL BE INSULATED WITH A MINIMUM R-6 INSULATION FOR A MIN. OF 3 FEET BELOW THE BOTTOM OF THE SLAB.
6. WHERE FLOOR JOISTS ARE PARALLEL TO THE FOUNDATION WALL, THE WALL SHALL BE SUPPORTED LATERALLY AT THE TOP BY SOLID BLOCKWORK FOR MINIMUM OF TWO JOIST SPACES, SPACED NOT MORE THAN 4 FEET O.C.

Deck Ledger Attachment

- (2) Lags required at EA end & 2' from ends.
- Provide 1x4 treated spaced behind EA. lag.
- Provide lags in EA. joist space w/ (2) every other space, 2' from edges.
- Min. size lag is 1/2" diam x 6" length
- Provide flashing between rim joist and ledger.

Escape opening-44" A.F.F. Max. to lowest portion.

- Min. 5.7sqft of window opening.
- Net clear height 24" Min
- Net clear width 20" Min.

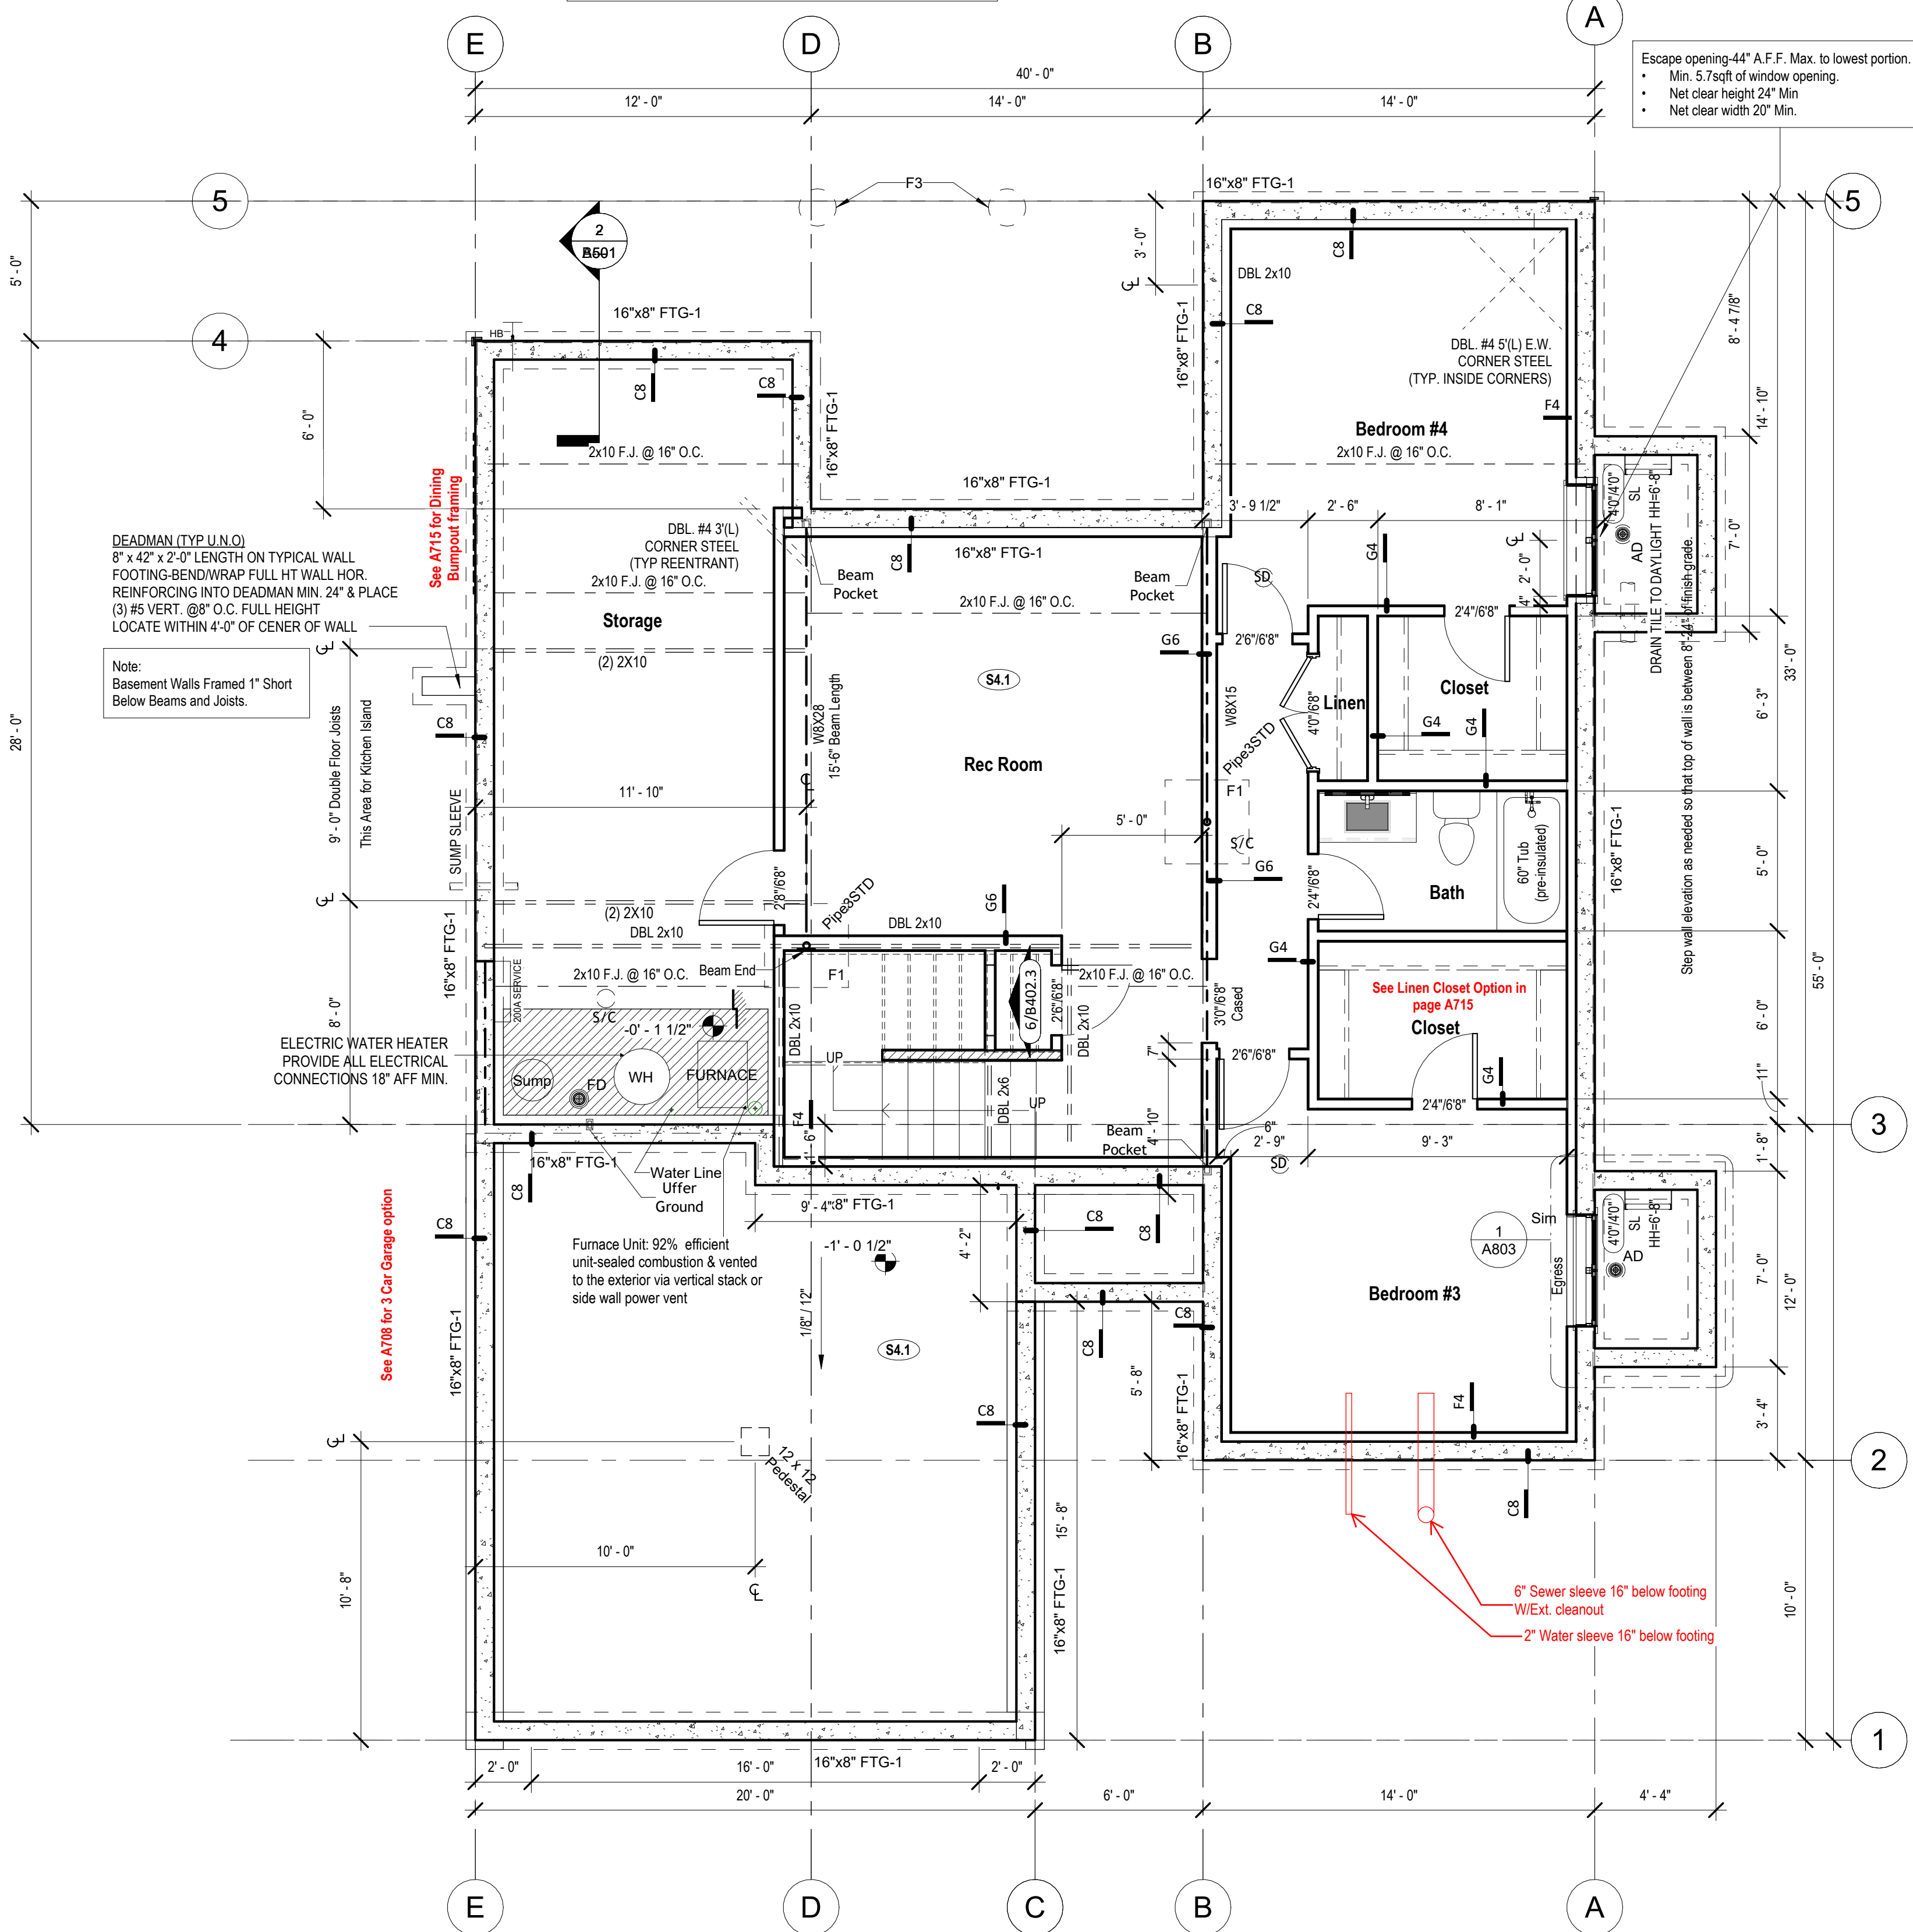


DEADMAN (TYP. U.N.O)
8" x 42" x 2'-0" LENGTH ON TYPICAL WALL
FOOTING-BEND/WRAP FULL HT WALL HOR.
REINFORCING INTO DEADMAN MIN. 24" & PLACE
(3) #5 VERT. @ 8" O.C. FULL HEIGHT
LOCATE WITHIN 4'-0" OF CENTER OF WALL

Note:
Basement Walls Framed 1" Short
Below Beams and Joists.

ELECTRIC WATER HEATER
PROVIDE ALL ELECTRICAL
CONNECTIONS 18" AFF MIN.

See A108 for 3 Cor Garage option

1 Basement Floor Plan - Full Basement
1/4" = 1'-0"

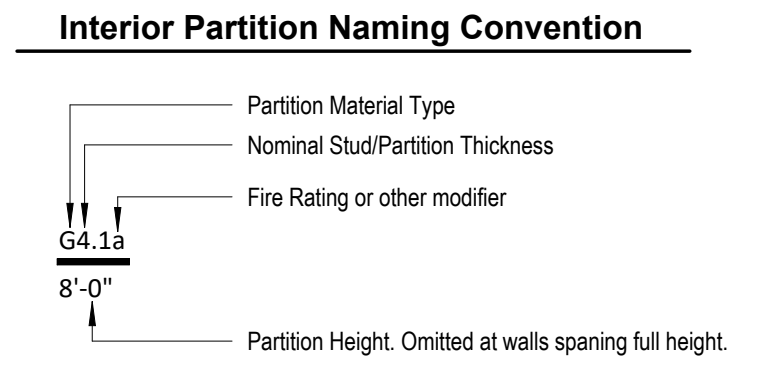

Greystone - Masterplan



MARCH 31, 2025

architect:
Elevate Design + Build
1040 SW Luttrell Road
Blue Springs, MO 64015
816.622.8826 voice
www.elevatedesignbuildkc.com

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REVISIONS

NO.	DESCRIPTION	DATE

PROJECT


DRAWING TITLE
Floor Plan - Full Basement

DATE ISSUED

DRAWING NUMBER

A402.1

Greystone - Masterplan

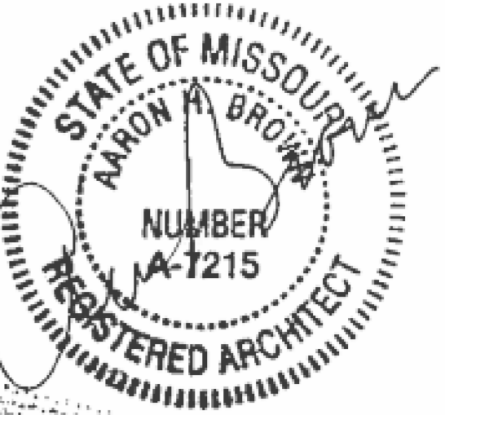

MARCH 31, 2025

architect:
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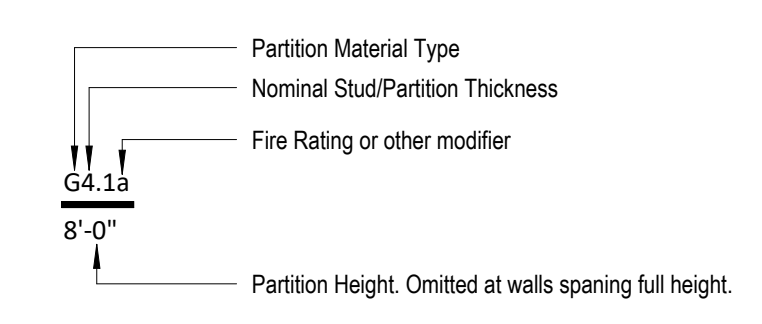
DRAWING TITLE
Floor Plan - Main Level

DATE ISSUED

DRAWING NUMBER

A501

Interior Partition Naming Convention



Door and Window Headers
All Headers are (2) 2x10 boards at 6" 10" to bottom of header, U.N.O.
Fall protection meeting IRC R312.2 shall be provided for windows w/ sills < 24" AFF & EXT. Grade > 72" below window.

Escape opening-44" A.F.F. Max. to lowest portion.
• Min. 5.7sqft of window opening.
• Net clear height 24" Min
• Net clear width 20" Min.

General Notes:

- DOORS AND WINDOW**
- ALL GLAZING WITHIN 12" OF THE FINISHED FLOOR, ADJACENT TO DOORS-0" AND WITHIN DOORS, ABOVE BATHTUBS TO BE SAFETY TYPE GLASS AND LABELED SUCH AS IN COMPLIANCE W/ SECTION 308 OF THE IRC.
 - SHOWER DOORS SHALL HAVE SAFETY GLAZING. HINGED SHOWER DOORS SHALL SWING OUTWARD.
- GARAGES:**
- GARAGE SEPARATION WALL TO BE 1/4" CONCR. MIN. 5/8" TYPE X GWS. EXTEND TO BOTTOM OF ROOF. DOOR TO BE 2x10 MIN. RATED, 1/2" CS-F.C. & EQUIPPED W/ CLOSURE & LATCH.
 - 1/2" CS-IMP RECEPTACLES SHALL HAVE GFCI PROTECTION.
 - TYPE X 5/8" GB REQUIRED ON GARAGE CEILING BELOW LIVING AREAS.
- LIGHT AND VENTILATION:**
- PROVIDE STAIRWAY ILLUMINATION PER R303.7.9
 - CABLE VENT & MECH ROOM VENTS TO PROVIDE A MIN. OF 10 S.F. NET-FREE OF ATTIC VENTILATION.
 - FURNACES ENCLOSED IN A ROOM LESS THAN 100 S.F. SHALL BE PROVIDED WITH A MEANS OF COMBUSTION MAKE-UP AIR AS DETERMINED/CALCULATED AND PROVIDED BY MECH. CONTRACTOR.
 - VENTILATE KITCHENS AND LAUNDRY ROOMS PER R303.3
 - PROVIDE MIN. 16" x 10" SOFFIT VENTS ALONG EAVE SPACED EVENLY W/ NO MORE THAN 6" O.C.
- GYPSUM BOARD:**
- GWB APPLIED TO CEILINGS SHALL BE 1/2" WHEN FRAMING MEMBERS ARE 16" O.C. OR 5/8" WHEN MEMBERS ARE 24" O.C. OR USE 1/2" SAG-RESISTANT GYP. CEILING BOARD.
- MECHANICAL SYSTEMS**
- FURNACE & WATER HEATER SHALL BE ON 18" PLATFORMS IN CEILING IN A GARAGE OR ROOM W/ DIRECT ACCESS TO A GARAGE.
 - PROVIDE MIN. 75% AFUE FOR WEATHERIZED GAS HEATING EQUIP. 80% FOR NON-WEATHERIZED.
 - PROVIDE MIN. 14 SEER FOR AIR CONDITIONING EQUIPMENT.
 - SUPPLY AND RETURN DUCTS SHALL BE INSULATED TO MIN. R-8.
- ELECTRICAL SYSTEMS**
- PROVIDE UFER GROUND ENCASED IN CONCRETE FOOTING.
 - ALL ELECTRICAL CONDUCTORS SHALL BE COPPER.
 - RECEPT. IN THE FOLLOWING LOCATIONS SHALL BE GFCI PROTECTED:
 - BEDROOM, KITCHEN (W/IN 6 FEET OF SINK), GARAGE, SHED, EXTERIOR, UNFINISHED BASEMENT & HEATED FLOOR.
 - ALL BRANCH CIRCUITS THAT SUPPLY 120-V. SINGLE PHASE, 15 & 20 AMP OUTLETS INSTALLED IN:
 - BEDROOMS, SUNROOMS, REC ROOMS, CLOSETS, HALLWAYS & SIM. ROOMS SHALL BE PROTECTED BY A COMBINATION TYPE ARC-FULT CIRCUIT INTERRUPTER INSTALLED TO PROVIDE PROTECTION OF THE BRANCH CIRCUIT.
 - ALL 15 & 20 A RECEPT. SHALL BE LISTED TAMPER-RESISTANT.
 - EXCEPTION: RECEPTACLES IN THE FOLLOWING LOCATIONS SHALL NOT BE REQUIRED TAMPER-RESISTANT:
 - RECEPTACLES LOCATED MORE THAN 5 FEET AFF.
 - WHERE SUCH RECEPTACLES ARE LOCATED IN SPACES DEDICATED FOR THE APPLIANCE SERVED & UNDER CONDITIONS OF NORMAL USE, THE APPLIANCE ARE NOT EASILY MOVED. APPLIANCES TO BE CORD-PLUG CONNECTED TO RECEPT.
- EXTERIOR WALL FRAMING**
- BOTTOM SILL PLATES SHALL BE PRESSURE TREATED OR EQUAL.
 - SILL PLATES SHALL BE FASTENED TO MIN. 6 INCHES ABOVE GRADE.
 - ALL EXT. STUDS TO BE SECURED TO THEIR DOUBLE TOP PLATES W/ (2) 16-G NAILS (MIN. 4" LONG) AT 16" O.C. W/ GALLY SPACER CLIPS ALONG ALL EDGES. SECURE SHEATHING W/ COMMON NAILS TO RAFTERS AT 16" O.C. ALL EDGES.
 - ALL EXTERIOR CORNERS TO BE BRACED WITH 7/16" OSB NAILING SCHEDULE SHALL BE COMMON @ 16" O.C. ALONG EDGES & COMMON @ 12" O.C. @ INTERMEDIATE STUDS.
- ROOF FRAMING**
- ALL ROOF EAVE OVERHANGS TO BE 16" LONG.
 - ALL JOISTS & RAFTERS TO BE ALIGNED OVER SLUGS.
 - ROOF SHEATHING SHALL BE 7/16" OSB LAY W/ LONG DIMENSION PERPENDICULAR TO RAFTER LINE & STAGGERED 48" O.C. W/ LONG DIMENSION PERPENDICULAR TO RAFTER LINE & STAGGERED 48" O.C. W/ GALLY SPACER CLIPS ALONG ALL EDGES. SECURE SHEATHING W/ COMMON NAILS TO RAFTERS AT 16" O.C. ALL EDGES.
- UNFINISHED BASEMENT REQUIREMENTS**
- FIRE PROTECTION OF FLOORS: FLOOR ASSEMBLIES CONSTRUCTED W/ JOISTS LESS THAN 2X10 DIMENSIONAL LUMBER.
 - JOISTS OR OPEN WEB JOISTS OVER UNFINISHED BASEMENTS SHALL BE PROVIDED WITH 5/8" GWB.
 - UNFINISHED BASEMENTS SHALL BE MIN. R-13 INSULATED WALL OR INSULATED OH FLOORCEILING (MIN R-19).
 - ALL EXPOSED HVAC DUCTING IN UNFINISHED BASEMENTS TO BE MIN R-8 INSULATED OR ENCLOSED INSIDE A FLOORCEILING.
 - UNFINISHED BASEMENTS SHALL HAVE NO CONDITIONED AIR OUTLETS.
- EROSION CONTROL**
- EROSION CONTROL MEASURES SHALL BE IN PLACE & IN GOOD WORKING ORDER AT ALL TIMES DURING INSPECTIONS. IN THE EVENT THAT THEY ARE NOT, THE INSPECTOR MAY CANCEL THE INSPECTION UNTIL SUCH TIME THE EROSION CONTROL MEASURES ARE IN PLACE. A FINE OR INSPECTION FEE & STOP WORK ORDER MAY BE ISSUED IF EROSION CONTROL IS NOT ADDRESSED. MINIMUM INCLUDE:
 - SOIL FENCE OR STRAW BATTLE AROUND ALL DISTURBED SOIL. SHALL BE IN PLACE BEFORE ANY EXCAVATION BEGINS.
 - TEMPORARY GRAVEL CONSTRUCTION ENTRANCE. THIS ENTRANCE SHOULD BE THE ONLY ENTRANCE & EXIT USED FOR VEHICLES INTO & OUT OF THE SITE.
 - STREETS SHALL BE MAINTAINED FREE OF ALL SOIL & GRAVEL IN A BROOM CLEAN CONDITION AT ALL TIMES.
- PHYSICAL SECURITY ORDINANCE**
- OWNER/BUILDER IS RESPONSIBLE FOR COMPLIANCE OF PHYSICAL SECURITY ORDINANCE FOR THEIR LOCAL JURISDICTION.

Framer to provide the 3/4" plywood gussets for living room collar tie connections - one per every other rafter.

ASPHALT SINGLES OVER 15# FELT PAPER ON MIN. 9/16" PLYWD. OR OSB BOARD W/ SPACER CLIPS EDGES NAILED @ 6" O.C. W/ 8d COMMON

INSULATION BATTLE @ RAFTERS
FASCIA W/ GALV. FLASHING
GUTTER

PER IRC 703.2 WEATHER RESISTANT SHEATHING PAPER, ASPHALT SATURATED FELT NO. 15-COMPLYING WITH ASTM D 226 APPLIED OVER THE SUDS OR SHEATHING OF ALL EXT. WALLS

RAFTERS D.F. #2 OR BETTER
SEE CEILING JOIST SCHEDULE & DENOTED ON PLANS
ALL JOISTS TO D.G. #2 OR BETTER

BATT INSULATION
1/2" GWB CEILING
DOUBLE TOP PLATE

2 x 4 (OR 6) STUDS @ 16" O.C. D.F. #2 OR BETTER
1/2" GWP INTERIOR PAINT

ALL FLOOR JOISTS TO BE D.F. #2 OR BETTER

BATT INSULATION OR BLOWN FIBERGLASS INSULATION W/ 4 MIL VAPOR BARRIER

Cast-in-Place Concrete Wall, RE Foundation Plan
Wall Footing - RE Foundation Plan

Basement
Basement
T.O. Footing

Section 3
1/2" = 1'-0"

Floor Plan - Living Space
1/4" = 1'-0"

