
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LEE'S SUMMIT LOGISTICS BUILDING B LOT 2 1220 NW MAIN ST. LEE'S SUMMIT, MO 64086

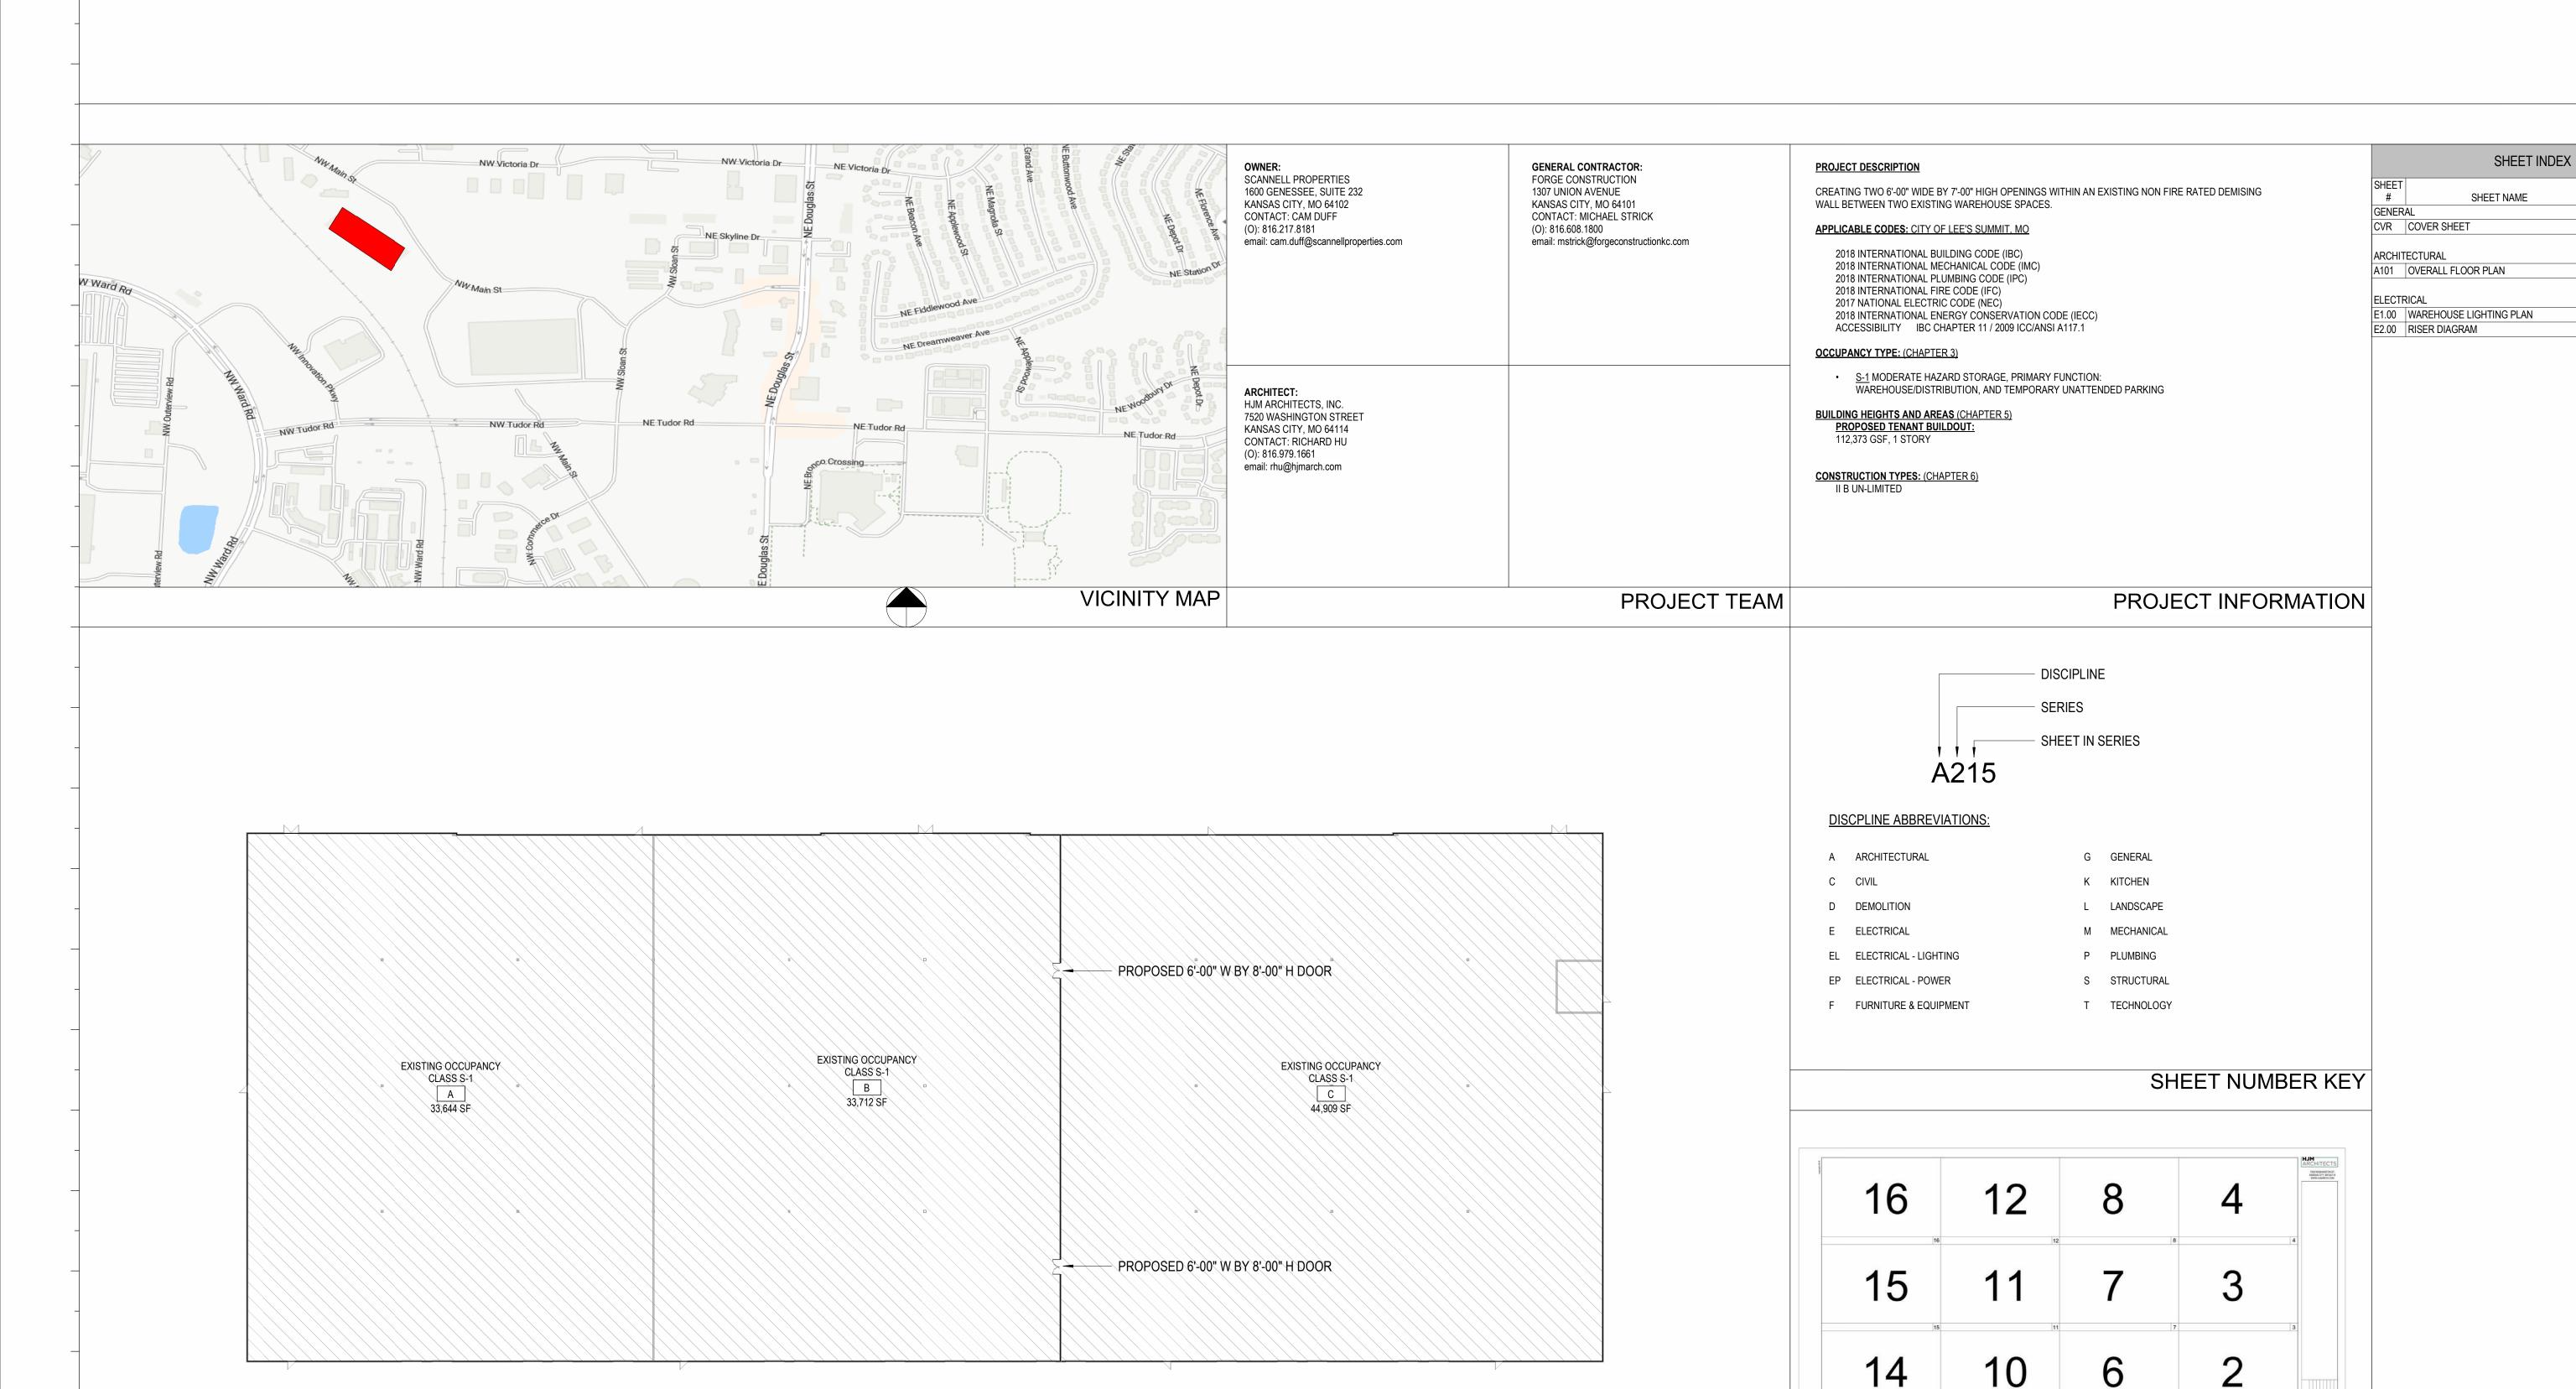

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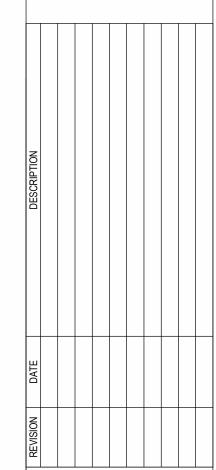
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REVISION REVISION

DATE

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MIDV



FOR PERMIT

5

KEY PLAN 1/32" = 1'-0"


SHEET GUIDE

DRAWING NUMBER KEY

PROJ. # | SCALE: 2509.1 As indicated DRAWING TITLE

COVER SHEET

DRAWING NUMBER **CVR**

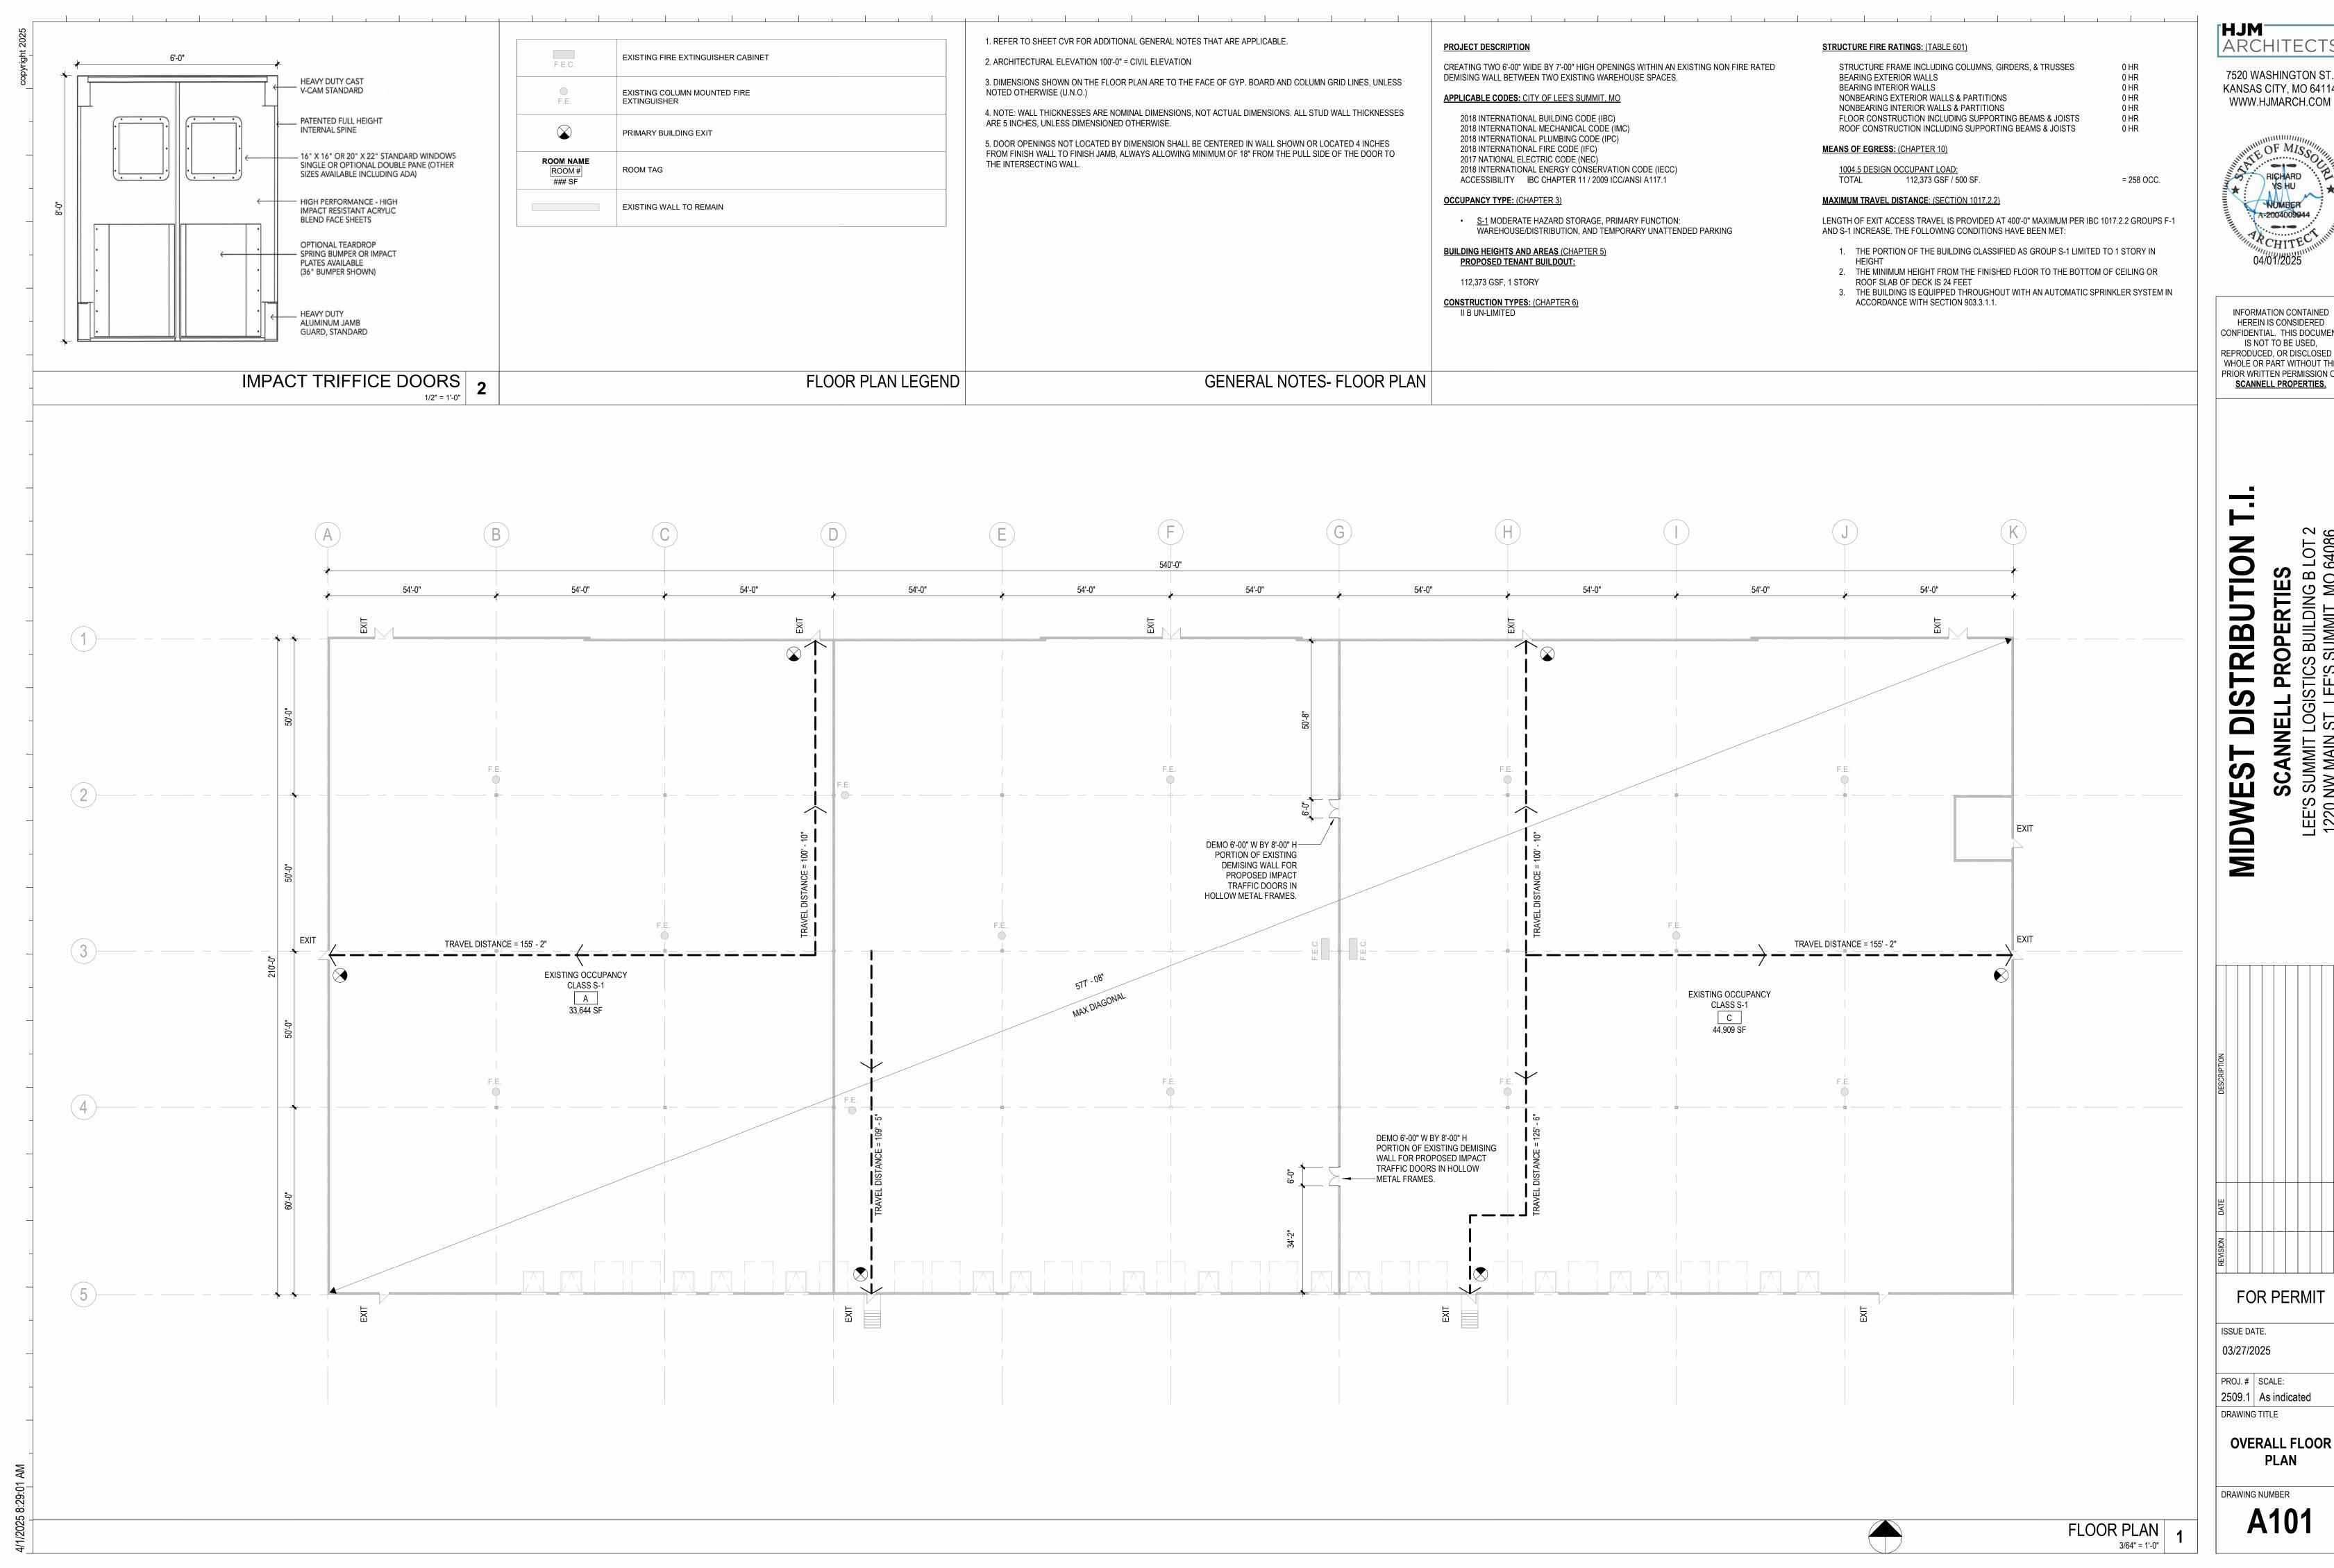

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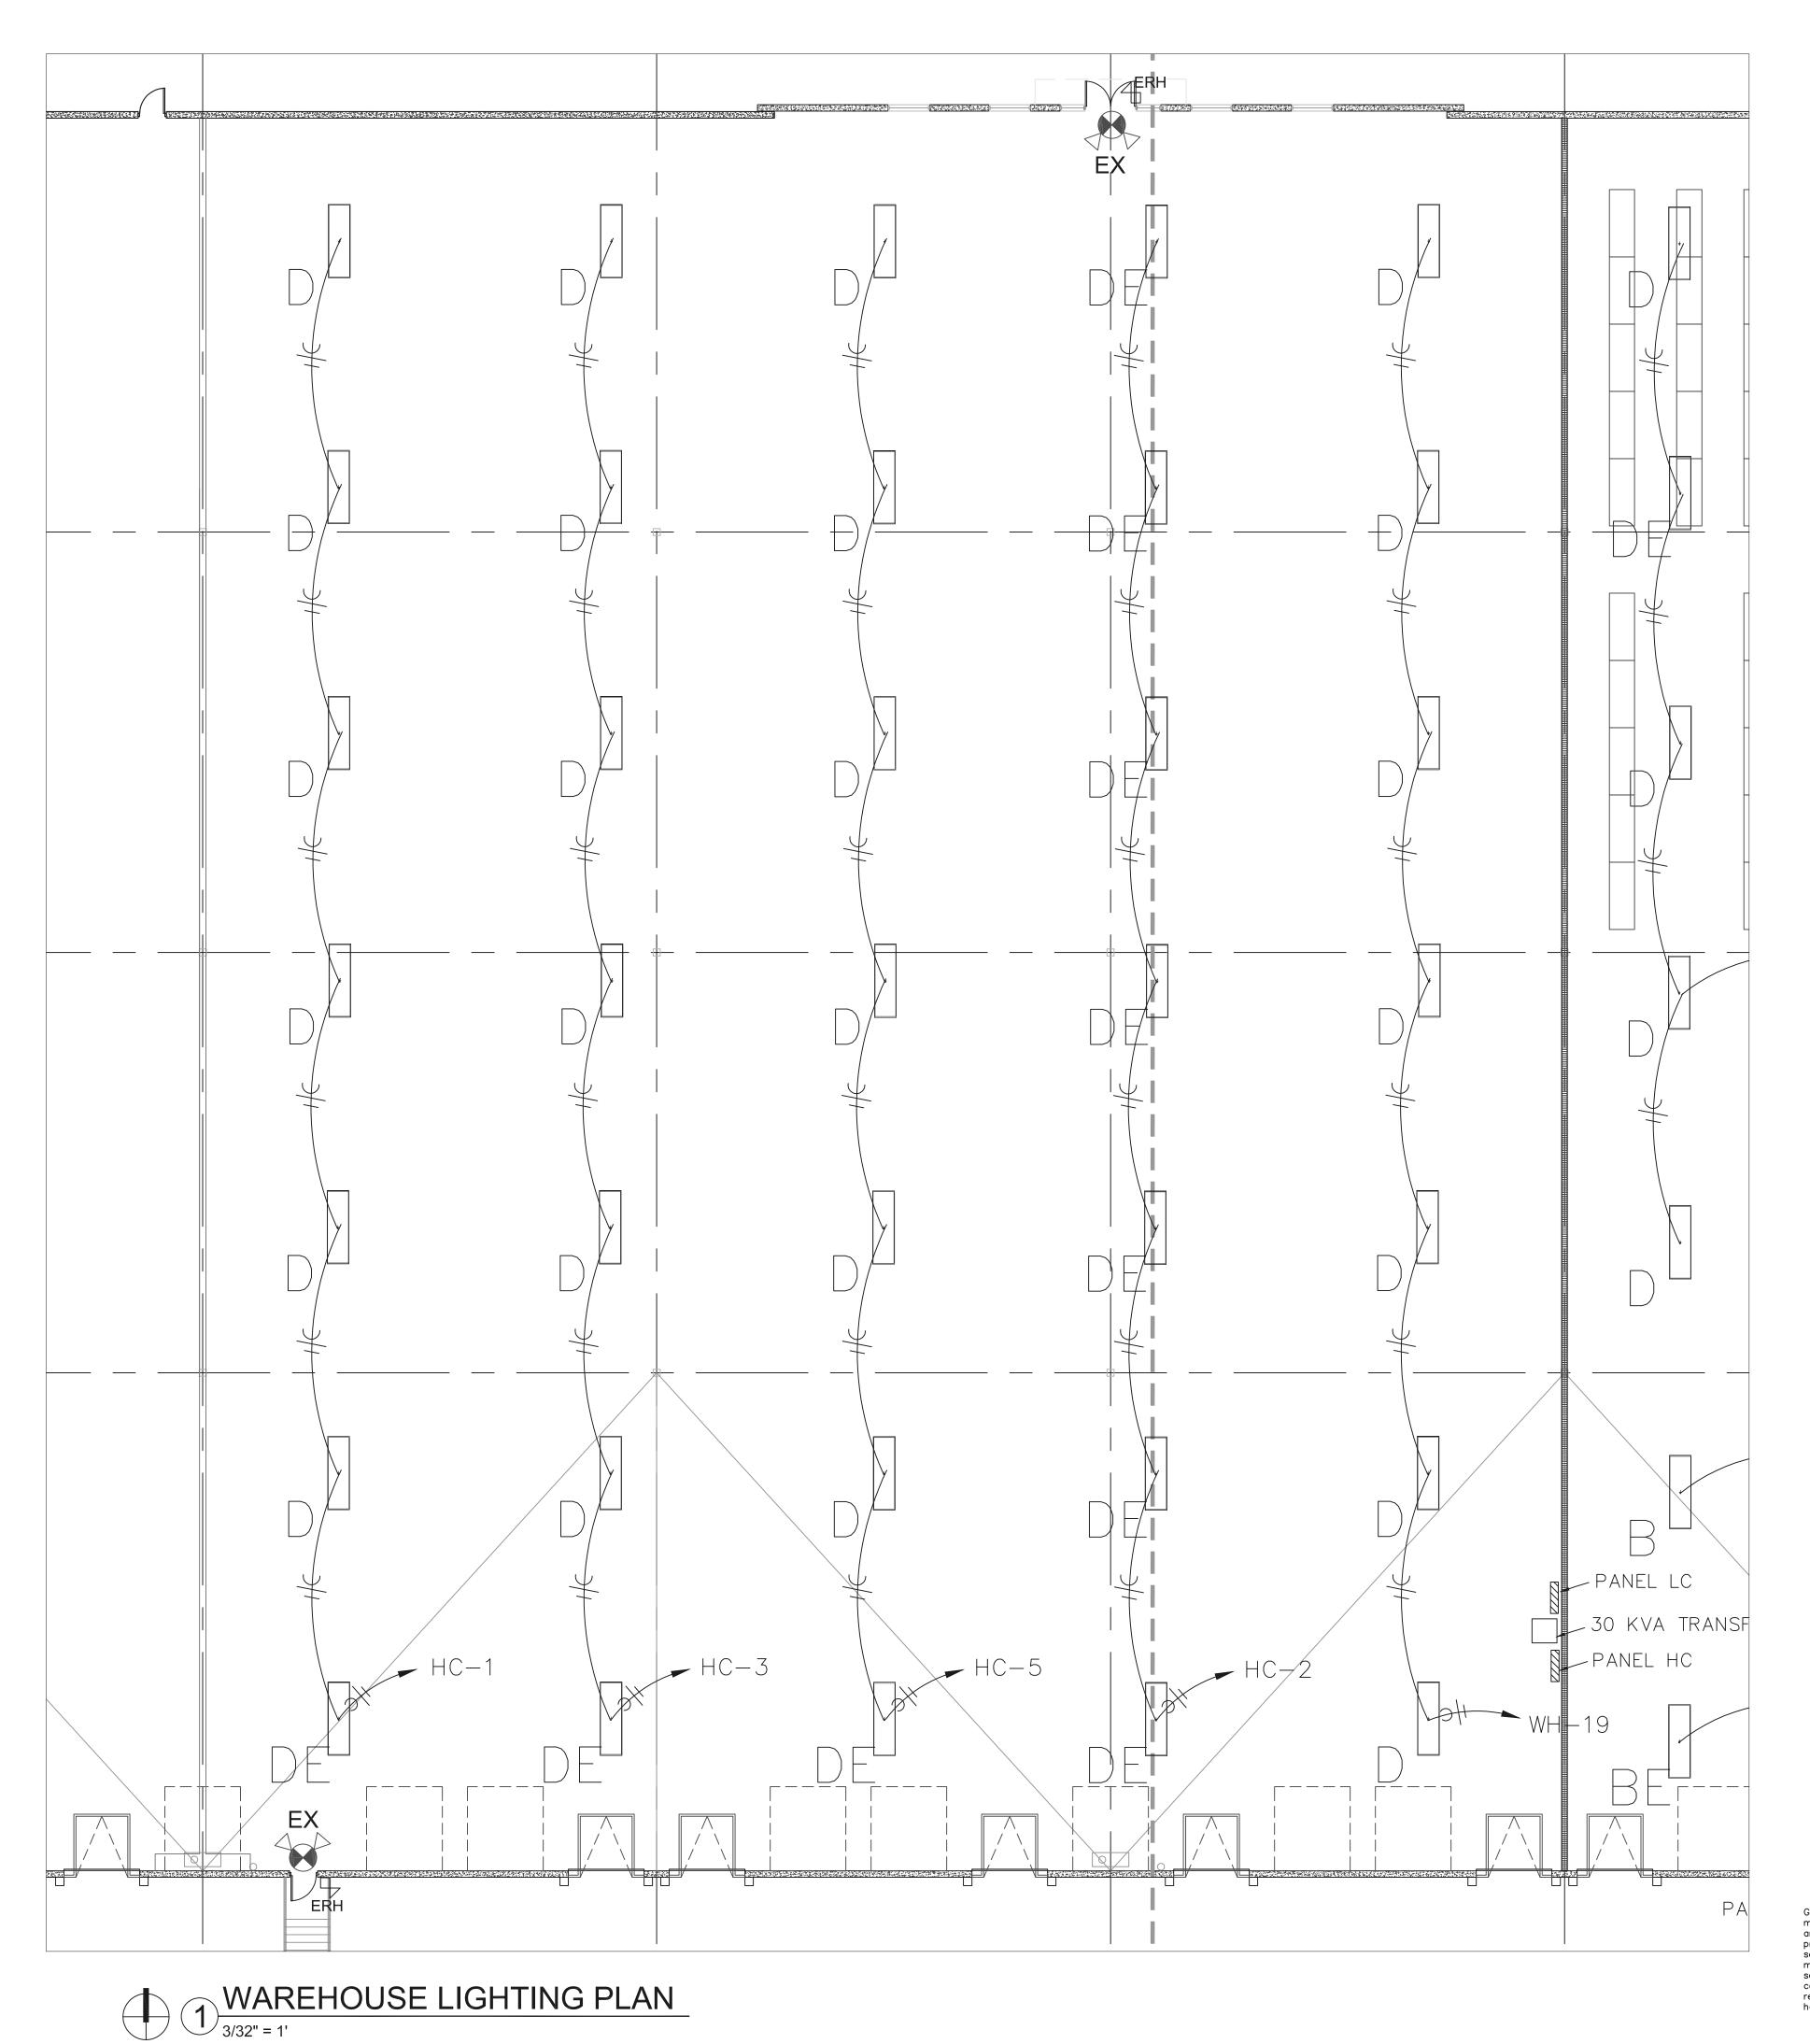
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PLAN






CERTIFICATION


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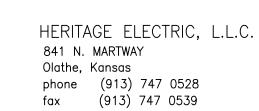
LEE'S SUMMIT LOGISTICS BUILDING B

Midwest Distributors I 220 NW Main Street LEE'S SUMMIT, MO 64086



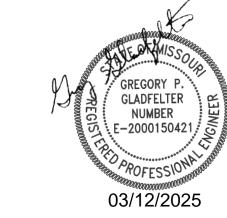

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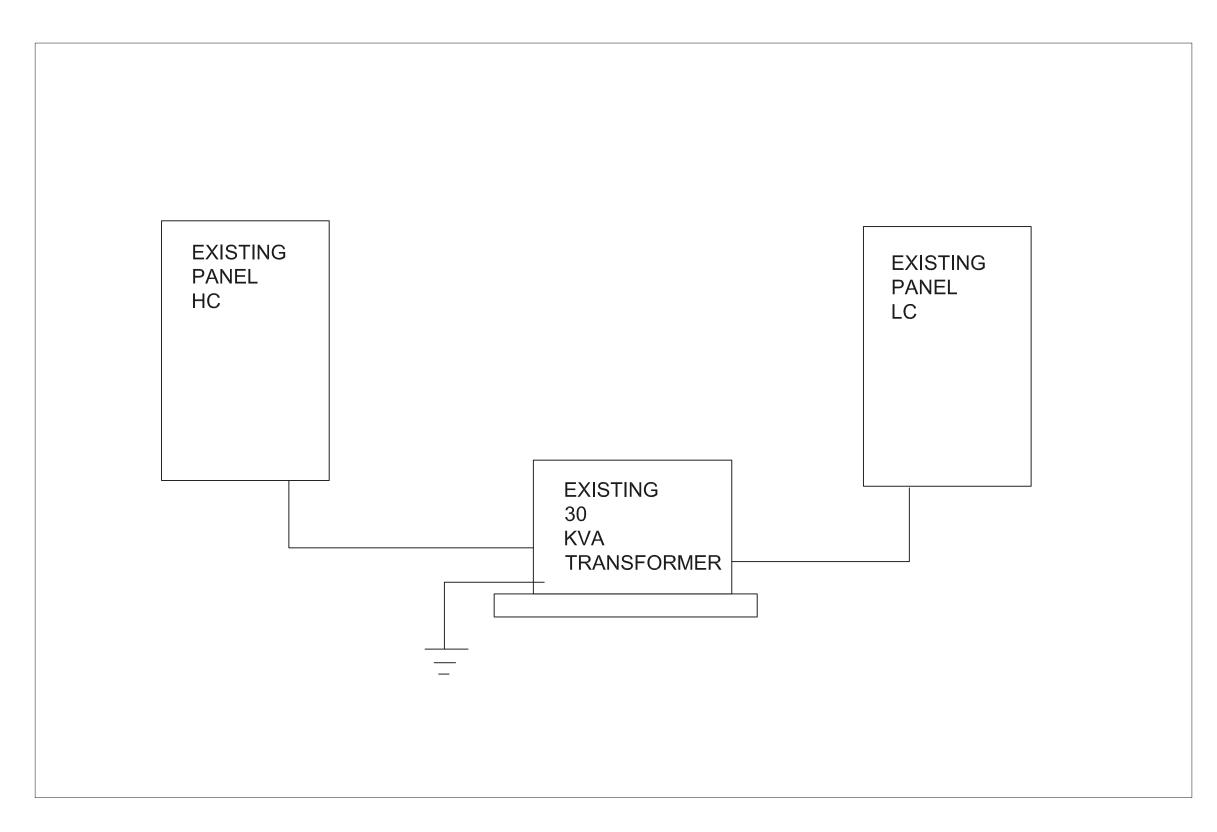
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ISSU	JE DATES	
PERMIT SET		08.29.23
	220018	

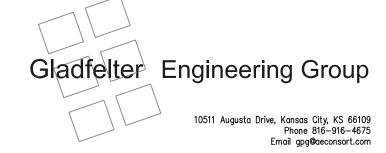WAREHOUSE LIGHTING PLAN

EI.00





LIGHT FIXTURE SCHEDULE										
TYPE	MANUFACTURER	CATALOG NO.	LAMPS	MOUNTING	VOLTS	REMARKS				
D	HE WILLIAMS	GH-2-L300-840-FA-DIM-UN	LED	CEILING	277	PROVIDE WITH INTEGRAL MOTION SENSOR				
DE	HE WILLIAMS	GH-2-L300-840-FA-DIM-UN V	LED	CEILING	277	SAME AS TYPE D ONLY WITH EM BALLAST				
EX	COMPASS	CCR	LED	WALL	UNV	EXISTING				
ERH	COMPASS	CUWZ-PC	LED	WALL	UNV	EXISITNG				

PANEL	.: HC	100A	MLO	277/	480 V, 3PH,	4W.+GRND.				NEW P	PANEL	
ССТ	SERVES		VA	ОСР	WIRE	PHASE	WIRE		ОСР	VA	SERVES	ССТ
1	WAREHOUSE LIGHTS		1596	20/1	2#12,1#12G	A	2-#12,1-#12G		20/1	1596	WAREHOUSE LIGHTS	2
3	WAREHOUSE LIGHTS		1596	20/1	2-#12-1-#12G	В	3-#8-1-#10G		50/3	6925	MAU1	4
5	WAREHOUSE LIGHTS		1596	20/1	2-#12-1-#12G	С				6925		6
7	OVERHEAD DOOR		200	20/3	4-#10-1-#12G	A				6925		8
9			200			В	2-#12,1-#12G		20/1	1596	WAREHOUSE LIGHTS	10
11			200			С						12
13						A						14
15						В						16
17						С						18
19						A						20
21						В						22
23						С						24
25						A						26
27						В						28
29						С						30
31						A						32
33						В						34
35						С	3-#8,1#10G		50/3	1000	TRANSFORMER	36
37						A			-	800	TRANSFORMER	38
39						В			-	600	TRANSFORMER	40
41						С			-			42
NOTES:						LOAD SU	MMADV	CONN	NEC	DEM	LOAD BALANCE PER PHASE	
	NEMA 1 ENCLOSURE					1-LIGHTIN		7980			5 PHASE A	1111
	PROVIDE BOLT ON BREAKERS	•				2-RECEPT					0 PHASEB	1091
		5						2400			1	
3	1					3-KITCHE 4-HVAC	N	20775	0.65		0 PHASE C 5 LOWEST PHASE PLUS 10%	972
							MIT	20775	1			40000
						5-NON-CO		600		60		10693.
						LARGEST		0	0.25		0 REBALANCE LOADS	
						TOTAL V		31755		3375		
						TOTALA	MPS	38.2	!!	40	61	

PANE	L: LC 100	MB	120)/ 208 V, 3PH,	4W.+GRND.					NEW PANEL	
ССТ	SERVES	VA	ОСР	WIRE	PHASE	WIRE		OCP	VA	SERVES	CCT
1	DOCK POWER	800	20/1	2-#12,1-#12G	A	2-#12,1-#12G		20/1	200	GFCI RECEP	2
3	DOCK POWER	800	20/1	2-#12,1-#12G	В	2-#12,1-#12G		20/1		SPARE	4
5	SPARE		20/1		С	2-#12,1-#12G		20/1		SPARE	6
7	SPARE		20/1		A	2-#12,1-#12G		20/1		SPARE	8
9	SPARE		20/1		В	2-#12,1-#12G		20/1		SPARE	10
11	SPARE		20/1		С	2-#12,1-#12G		20/1		SPARE	12
13	SPACE				A					SPACE	14
15	SPACE				В	-				SPACE	16
17	SPACE				С	-				SPACE	18
19	SPACE				A	-				SPACE	20
21	SPACE				В	-				SPACE	22
23	SPACE			-	С	-				SPACE	24
25	SPACE				A					SPACE	26
27	SPACE				В					SPACE	28
29	SPACE				С					SPACE	30
31	SPACE				A	-				SPACE	32
33	SPACE			-	В					SPACE	34
35	SPACE			-	С				1	SPACE	36
37	SPACE		1		A	-			1	SPACE	38
39	SPACE				В					SPACE	40
41	SPACE			-	С					SPACE	42
IOTES:					LOAD SUM		CONN	NEC	DEM	LOAD BALANCE PER PHASE	
	1 NEMA 1 ENCLOSURE				1-LIGHTIN		0	1.25		PHASE A	
	2 PROVIDE BOLT ON BREAKERS				2-RECEPT		1800	NEC		PHASE B	
	3				3-KITCHEN	l .	0	0.65		PHASE C	
					4-HVAC		0	1		LOWEST PHASE PLUS 10%	
					5-NON-CO		0	1		0 + 10%	
					LARGEST		0	0.25		REBALANCE LOADS	
					TOTAL VA		1800		180		
					TOTAL AN	MD C	5.0		5.	ni	

BRANCH CIRCUIT COPPER CONDUCTOR AND CONDUIT SIZING CHART*

OVERCURRENT PROTECTION DEVICE RATING (AMPS)	REQUIRED CONDUCTOR SIZE	EQUIPMENT GROUNDING CONDUCTOR SIZE	SINGE PHASE 2 WIRE + GND CONDUIT SIZE	SINGLE PHASE 3 WIRE + GND, CONDUIT SIZE	THREE PHASE 3 WIRE + GND CONDUIT SIZE	THREE PHASE 4 WIRE + GND CONDUIT SIZE
15	12 AWG	12 AWG	3/4"	3/4"	3/4"	3/4"
20	12 AWG	12 AWG	3/4"	3/4"	3/4"	3/4"
25	10 AWG	10 AWG	3/4"	3/4"	3/4"	3/4"
30	10 AWG	10 AWG	3/4"	3/4"	3/4"	3/4"
35	8 AWG	10 AWG	3/4"	3/4"	3/4"	3/4"
40	8 AWG	10 AWG	3/4"	3/4"	3/4"	3/4"
45	8 AWG	10 AWG	3/4"	3/4"	3/4"	1"
50	8 AWG	10 AWG	3/4"	3/4"	3/4"	1"
60	6 AWG	10 AWG	1"	1"	1″	1-1/4"
70	4 AWG	8 AWG	1"	1"	1"	1-1/4"
80	4 AWG	8 AWG	1"	1-1/4"	1-1/4"	1-1/4"
90	3 AWG	8 AWG	1"	1-1/4"	1-1/4"	1-1/4"
100	3 AWG	8 AWG	1-1/4"	1-1/2"	1-1/2"	1-1/2"

- 1. UNLESS OTHERWISE NOTED ON THE DRAWINGS
- 2. UNLESS OTHERWISE NOTED ON THE DRAWINGS, ALL BRANCH CIRCUITS AND FEEDERS TO BE PROVIDED WITH A NEUTRAL WIRE.
- 3. ALL SIZING BASED ON 3 CURRENT CARRYING CONDUCTORS IN A RACEWAY OR CABLE CONDUCTORS SHALL BE DERATED IN ACCORDANCE WITH THE NEC IF 4 OR MORE CONDUCTORS ARE PLACED IN A RACEWAY OR CABLE

Provide electrical for new TI in existing warehouse

- All Electrical work shall be as per NEC 2017.
- All work shall be done by qualified electricians.
- All branch wiring shall be copper.

Devices shall be 20a commercial grade and color shall be by architect.

SPECIFICATIONS

- 1. CONDUIT ABOVE GRADE SHALL BE EMT UNLESS OTHERWISE NOTED
- 2. CONDUIT BELOW GRADE SHALL BE RIGID PVC UNLESS OTHERWISE NOTED 3. CONNECTIONS SHALL BE MADE USING SET SCREW CONNECTORS
- 4. MC CABLE IS ACCETABLE FOR FINAL CONNECTIONS TO LIGHT FIXTURES PROVIDE WITH 10' WHIP ON ALL HIGHBAYS 5. BRANCH WIRING SHALL BE #12 THHN COPPER UNLESS OTHERWISE NOTED
- 6. WIRING SHALL BE AS PER CURRENT NEC 2017
- 7. WIRING DEVICES SHALL BE OF COMMERCIAL GRADE RATED AT 20 AMP
- 8. INSTALLATION SHALL ADHERE TO ADA STANDARDS
- 9. ALUMINUM XHHW-#2 CABLE MAY BE USED FOR FEEDERS LARGER THEN #2 OTHERWISE COPPER
- 10. REFER TO KCP&L STANDARDS MANUAL FOR 480 SERVICES
- 11. ALL LIGHTING/EQUIPMENT IN WAREHOUSE SHALL BE MOUNTED TO PROVIDE A MIN OF 36' CLEAR HEIGHT



Energy Code:

Project Title: Project Type: 90.1 (2016) Standard Midwest Distributors New Construction

Construction Site: 1220 NW Main Street Lee's Summit, MO 64086 Owner/Agent:

Designer/Contractor: Jeremy Hansen Heritage Electric 841 N. Martway Driv Olathe, KS 66061 913-747-0528 jhansen@heritage-electric.com

Allowed Interior Lighting Power

Area Category	Floor Area (ft2)	Allowed Watts / ft2	Allowed Watt
1-Warehouse:Medium Bulky/Pallet Material Storage	34200	0.35	11970
		Total Allowed Watts	= 11970


Proposed Interior Lighting Power

Fixture ID : Description / Lamp / Wattage Per Lamp / Ballast	Lamps/ Fixture	# of Fixtures	Fixture Watt.	(C X D)
1-Warehouse:Medium Bulky/Pallet Material Storage				

LED 1: Other:

iterior Lighting PASSES: Design 24% better than code **Interior Lighting Compliance Statement**

Compliance Statement: The proposed interior lighting design represented in this document is consistent with the building plans, specifications, and other calculations submitted with this permit application. The proposed interior lighting systems have been designed to meet the 90.1 (2016) Standard requirements in COMcheck Version 4.1.5.5 and to comply with any applicable

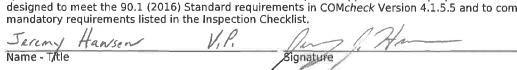



Total Proposed Watts =









Phone 816-916-4675

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PROJECT INFORMATION

SCANNELL

CERTIFICATION

LEE'S SUMMIT LOGISTICS **BUILDING B**

> Midwest Distributors 1220 NW Main Street LEE'S SUMMIT, MO 64086





ELECTRICAL GENERAL NOTES

1. WORK INCLUDED. FURNISH ALL LABOR, MATERIAL, SERVICES AND SKILLED

2. CONTRACT DRAWINGS THE CONTRACT DRAWINGS ARE SHOWN IN PART

3. MINIMUM SIZE OF CONDUIT SHALL BE 1/2" UNLESS NOTED OTHERWISE.

THE OWNER COMPLETE IN ALL RESPECTS READY FOR USE.

ARCHITECT/ENGINEER BEFORE PROCEEDING WITH WORK.

UNLESS NOTED OTHERWISE, WITH CIRCUITS AS SHOWN.

PERMITTED IN ALL AREAS PER NEC REQUIREMENTS.

OF THE SPACE AVAILABLE. AND WITHOUT INTERFERENCES.

PENETRATIONS SHALL BE FIRE-CAULKED AS REQUIRED.

AND LOCAL CODE REQUIREMENTS.

TO STRUCTURE.

SUPERVISION NECESSARY FOR THE CONSTRUCTION, ERECTION, INSTALLATION CONNECTIONS, TESTING AND ADJUSTMENTS OF ALL CIRCUITS AND ELECTRICAL

DIAGRAMMATIC, INTENDED TO CONVEY THE SCOPE OF WORK. INDICATING THE

FOR THE INSTALLATION OF THE MATERIALS BASED ON ACTUAL DIMENSIONS OF EQUIPMENT FURNISHED. IF A QUESTION EXISTS AS TO THE EXACT INTENDED

LOCATION OF OUTLETS OR EQUIPMENT, OBTAIN INSTRUCTIONS FROM THE

EQUIPMENT SPECIFIED HEREIN, OR NOTED ON THE DRAWINGS, AND ITS DELIVERY TO

GENERAL ARRANGEMENT OF EQUIPMENT, CONDUIT AND OUTLETS. VERIFY SPACES

4. ALL WIRING FOR LIGHTING, RECEPTACLE AND POWER CIRCUITS WHERE NOT SHOWN ON DRAWINGS SHALL BE WITH #12 CONDUCTORS, NUMBER AS REQUIRED IN CONDUIT SIZED PER N.E.C. PROVIDE EQUIPMENT GROUNDING CONDUCTOR FOR ALL BRANCH CIRCUITS AND FEEDERS. HOMERUNS TO PANEL SHALL BE IN INDIVIDUAL CONDUITS,

5. THE USE OF TYPE 'MC' AND TYPE 'AC' CABLE IS PERMITTED IN ALL AREAS PER NEC

6. THE USE OF ALUMINUM CONDUCTORS WITH AMPACITY EQUIVALENT TO COPPER IS

8. COORDINATE ALL WORK WITH OTHER TRADES AND EXISTING CONDITIONS AS

SURFACE MOUNTED CONDUIT, BOXES, ETC. WILL BE PERMITTED WITHOUT PERMISSION OF THE ENGINEER PRIOR TO INSTALLATION. ALL CONDUIT

7. ALL JUNCTION BOXES, PULL BOXES, AND PANELBOARDS SHALL BE RIGIDLY ATTACHED

REQUIRED TO PROPERLY INSTALL ALL SYSTEMS AS INTENDED, WITHIN THE CONFINES

9. ALL CONDUIT, BOXES, ETC. SHALL BE CONCEALED OR MOUNTED FLUSH WITH CEILING OR WALL CONSTRUCTION, CONDUITS SHALL BE MOUNTED AS HIGH AS POSSIBLE. NO

Gladfelter Engineering Group (GEG) assumes design responsibility for this project for only the

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220018 RISER DIAGRAM