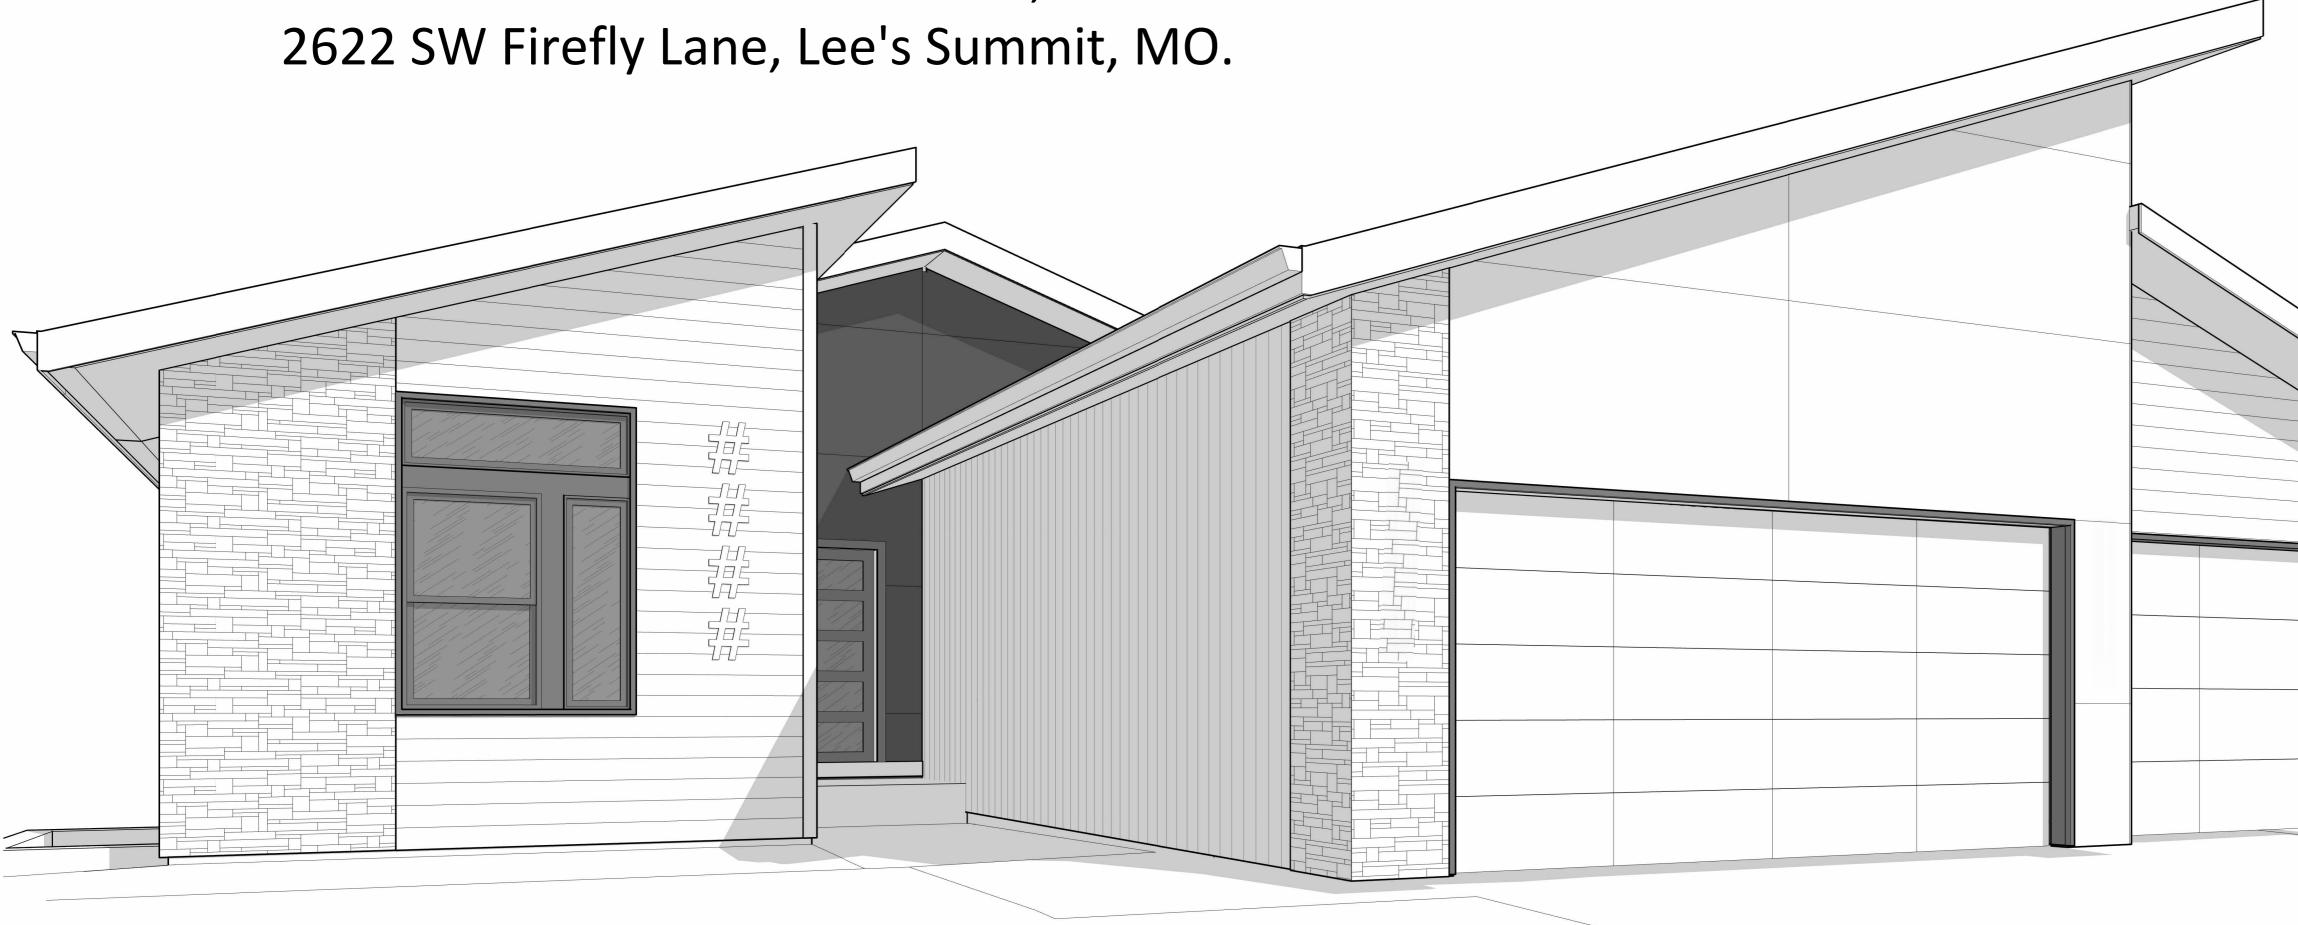
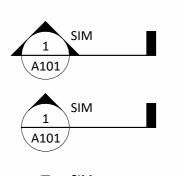
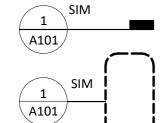
Greystone - Masterplan - SURBER

Lot 142 Hook Farms Second Plat,



-	Sheet List -HF 142
00	Cover Sheet
A707.4	Front Elevation
A707.5	Side and Rear Elevations
A708.1	Foundation Plan
A708.2	Basement Plan
A708.3	Floor Plan - Main Level
A708.5	Roof Plan
A715	POD Options
E101	RCP/Electrical Plan
P101 Plumbing Plan	





A1/A101

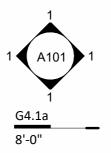
BUILDING SECTION

WALL SECTION

DETAIL SECTION

DETAIL REFERENCE

EXTERIOR ELEVATION TAG



(2)(3'0"/5'0" Туре HH=Head Height XX

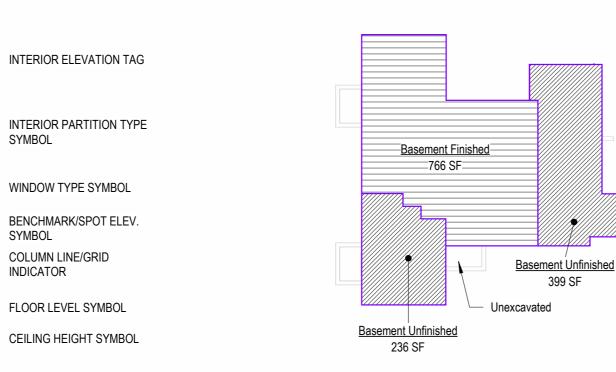
___ELEVATION____ 1t 1'-0"A.F.F. 1 1/2"

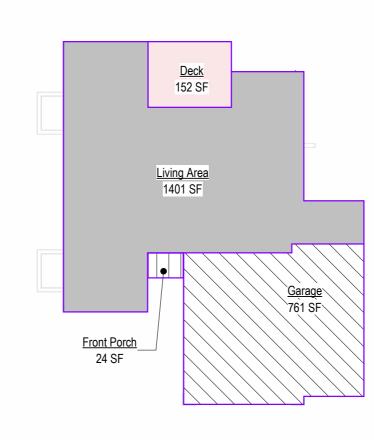
ALIGN ALIGN TWO WALLS OR

 \prec

DIMENSION

SYMBOL





Area - W/ Extended pantry Name

Area

766 SF

1401 SF

2168 SF

399 SF

152 SF

24 SF

761 SF

1336 SF

Basement Finished Living Area

Basement Unfinished Deck Front Porch Garage

- 11 Basement Area W/ Extended pantry 1/16" = 1'-0"
- Main Level Area W/ Extended pantry 1/16" = 1'-0"



2018 Interior Energy Cons. Code (Table N1102.1.2)

Doors & Windows: Glazing SHGF: Skylights: Roof	U-0.32 MAX 0.40 U-0.55 MAX
Attic Ceilings:	R-49 MIN
Vaults:	R-38 MIN
Vaults < 500sf:	R-30 MIN
Wood Frame Walls:	R-20 or R-13 + 5 MIN
Basement Walls:	R-13 or R-10 Continuous
Floor (over unconditioned):	R-19 MIN
Slab on Grade:	R-10 for 24" MIN
Ductwork:	R-8 MIN
Fuel Fired Furnace: Electic Furnace:	90% AFUE MIN No Minimum
	13 SEER MIN
Cooling System:	13 SEEK WIIN
Water Heater	
Gas Fired Storage:	0.67 EF MIN
Gas Fired Instant:	0.62 EF MIN
Electic Storage:	0.97 EF MIN
Electic Instant:	0.93 EF MIN

An energy efficient certificate is required to be posted in or on the electrical panel before the final nspection. The certificate will be provided with all new residential permits. It is the permit nolder/contractor's responsibility to ensure the certificate has accurate information and is posted before final inspection -- Owner/Contractor is esponsibile for meeting the prescriptive requirments of IRC chapter 11 unless a HER ndex Analysis for Performance Compliance based on the plans is submitted to the AHJ for approval.

<u>IRC 2018</u>

Ground Snow Load: Wind Speed: Topography Effects: Seismic Design Category: Damage From Weather: Frost Line Depth: 36 inches Fermite: Winter Design Temperature: Ice Barrier Underlayment: Flood Hazard: Air Freezing Index: Mean Annual Temperature: 55.5 F

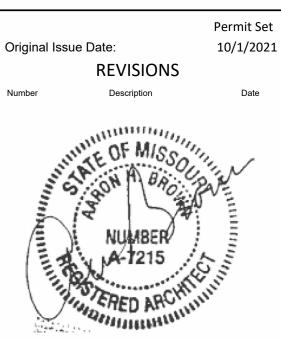
- Moderate to Heavy 6 F 927 or less
- 1. Whole House Mechanical Ventilation System is required for any dwelling with air infiltration at a rate of less than 5 air changes per hour (at ACH50 standard R303.4). 2. Carbon monoxide detectors required (R315
- 3. Steel columns shall be minimum schedule 40 (R507.2) 4. Deck Ledger attachment to house shall be per
- Tables 507.9.1.3. 5. New provisions for attachment of rafters,
- trusses and roof beams. (R802.3 and R802 11) 6. Programmable thermostat required
- (N1103.1.1)
- 7. Air handlers shall be rated for Maximum 2% air leakage rate (N1103.2.2.1) 8. Building cavities used as return air plenums
- shall be sealed to prevent leakage across the thermal envelope. (N1103.2.3) 9. Certain hot water pipes shall be insulated
- (N1103.4) 10. All exhaust fans shall terminate to the building
- exterior (M1507.2) 11. Makeup air system required for kitchen exhaust hoods that exceed 400 CFM M1503.4
- 12. Building cavities in a thermal envelope wall (including the wall between the house and garage) shall not be used as return air plenums (unless the required insulation and air
- barrier are maintained) (M1601.1.1,#7.5) 13. An air handling system shall not serve both the living space and the garage (M1601.6) 14. A concrete-Encased grounding electrode
- ('UFER' Ground) connection complies with the requirments of the 2018 IRC Section E3608.1.2 in providing a connection with no less than the required minimum of steel. 15. Compliance with the requirments and show connection as needed for roof beam, trus,
- rafter, and girder connections for uplift per IRC 802 11 16. Garage Door Rating: DASMA 115 MPH Rated

2018 IRC BUILDING CODE COMPLIANCE THESE DRAWINGS HAVE BEEN PREPARED WITH RESPECT TO COMPLIANCE OF THE 2018 IRC AND NEC 2017 ANY REFERENCES FOUND NOT CORRECTLY IDENTIFIED TO THESE CODES SHALL BE BROUGHT TO THE ATTENTION OF THE DESIGN PROFESSIONAL



ELEVATE DESIGN + BUILD

1 - SURBER Masterplan Hook Farms Second Pl Sumr **LONG - IVIASTEr** Lot 142 Hook Farms S 2622 SW Firefly Lane, Lee eystone G

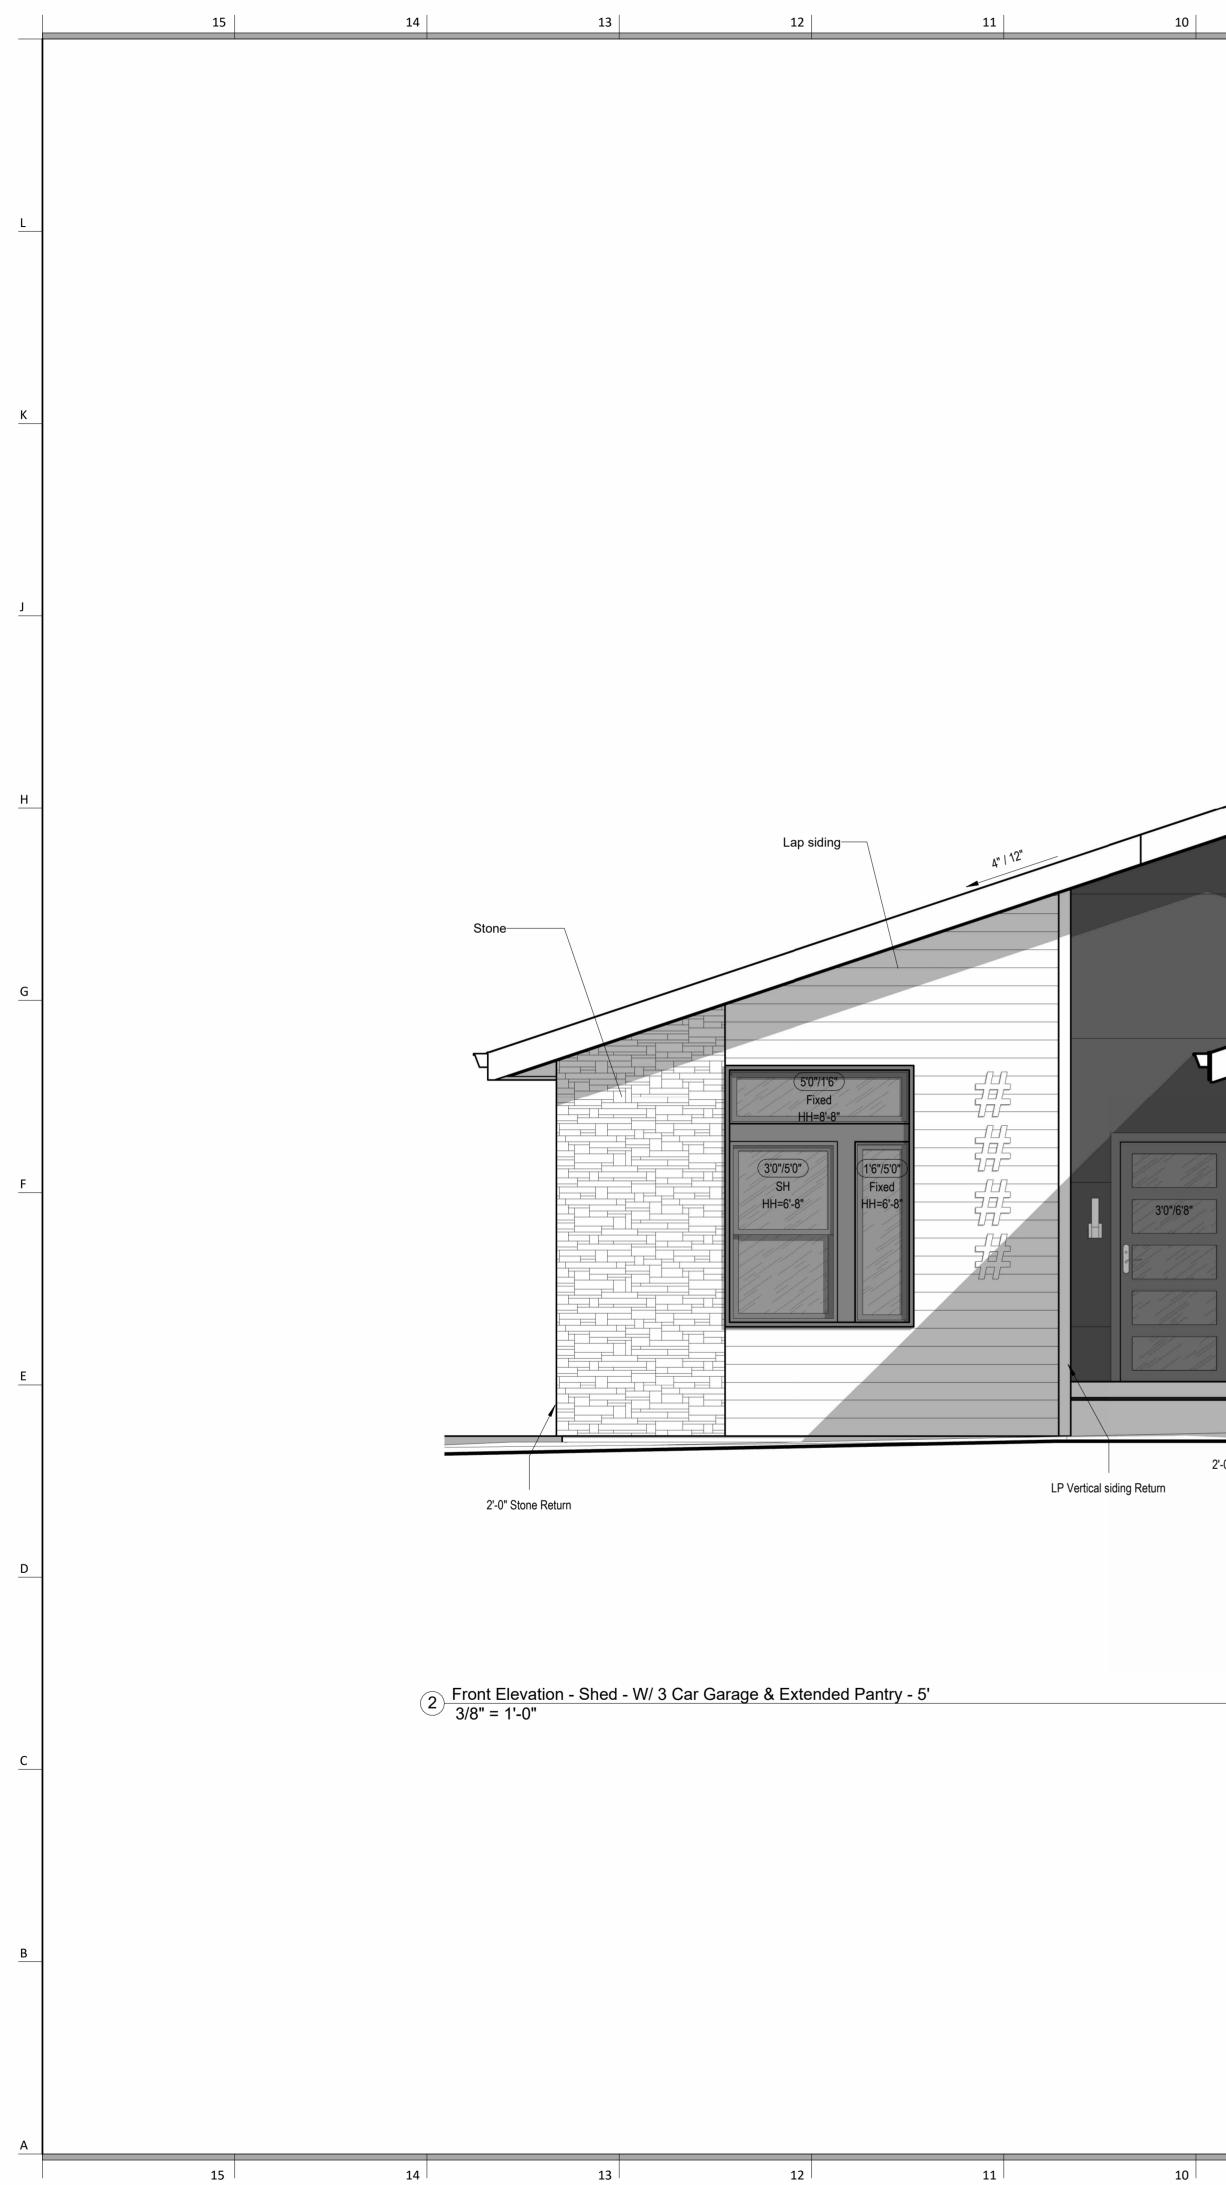


MARCH 11, 2025

Permit Set

PLAN DESCRIPTION: Cover Sheet

Project No.



		Stucco		/	Stucco	I
		4"/12"		4" 12"		
						4"/12"
3'0"/6'8"		16	0"/7'0" O/H			8'0"/7'0" O/H
2'-0" Sto	one Return					

8

7

8

6

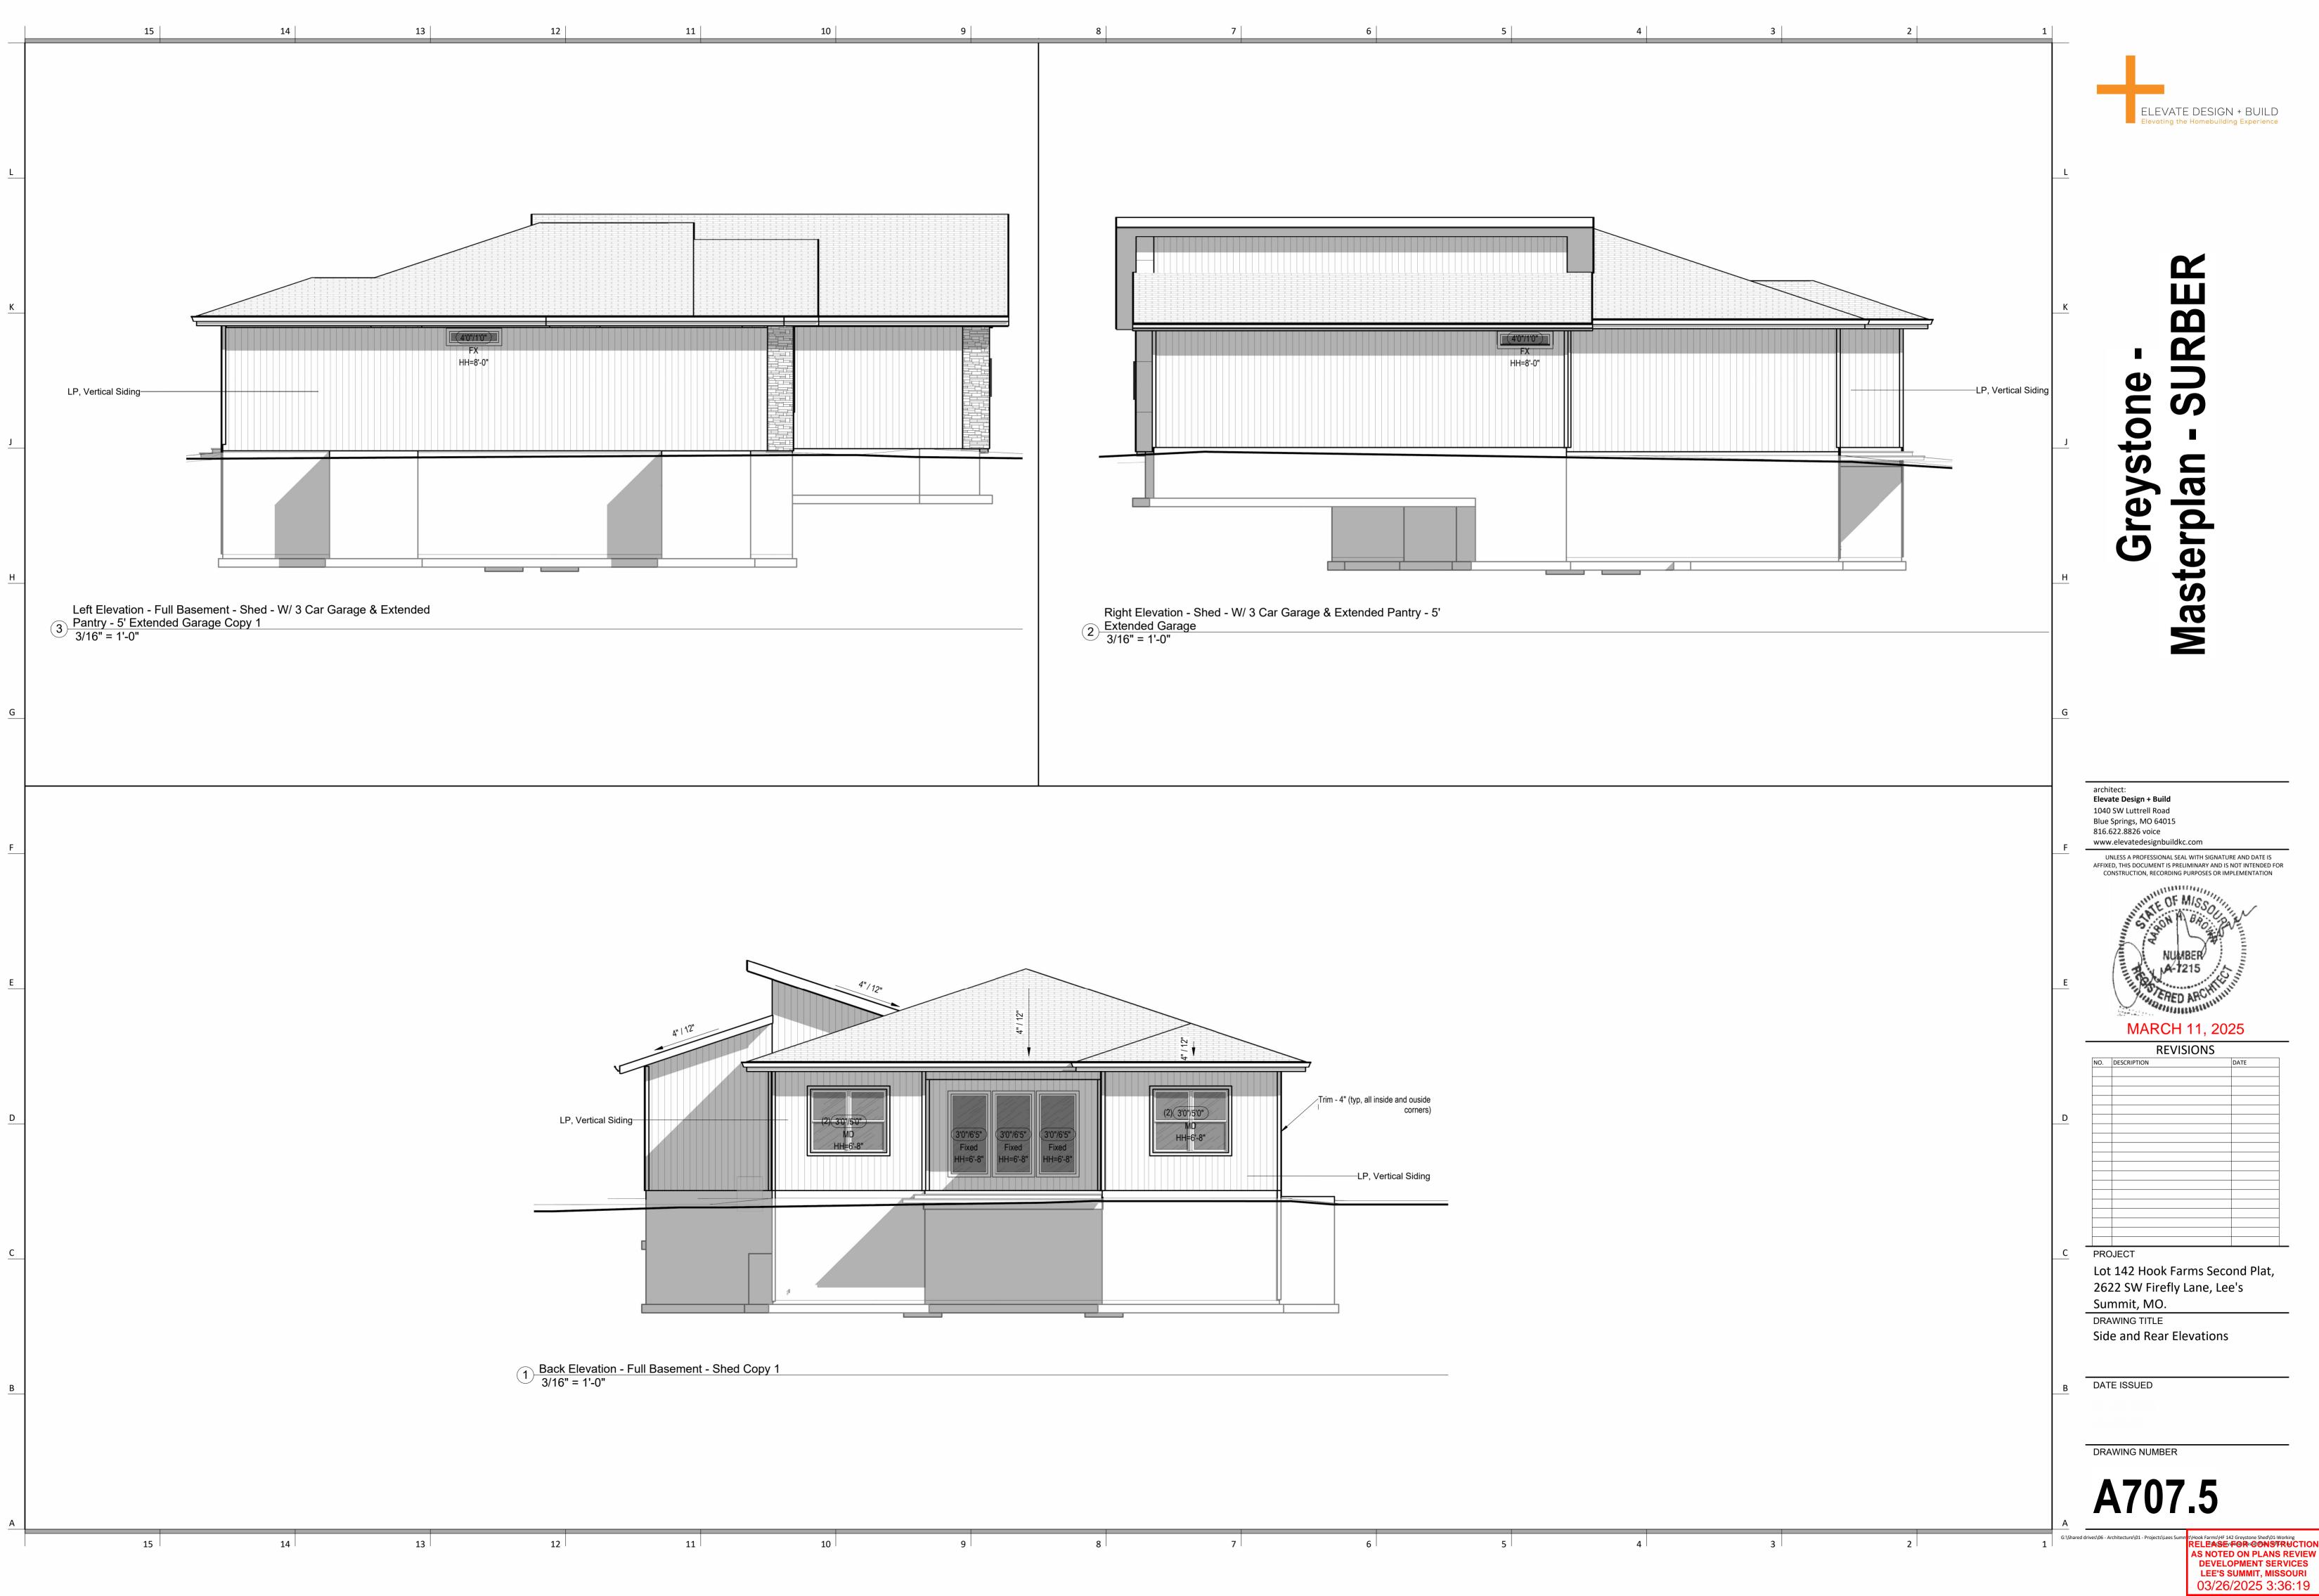
LP Vertical siding Return

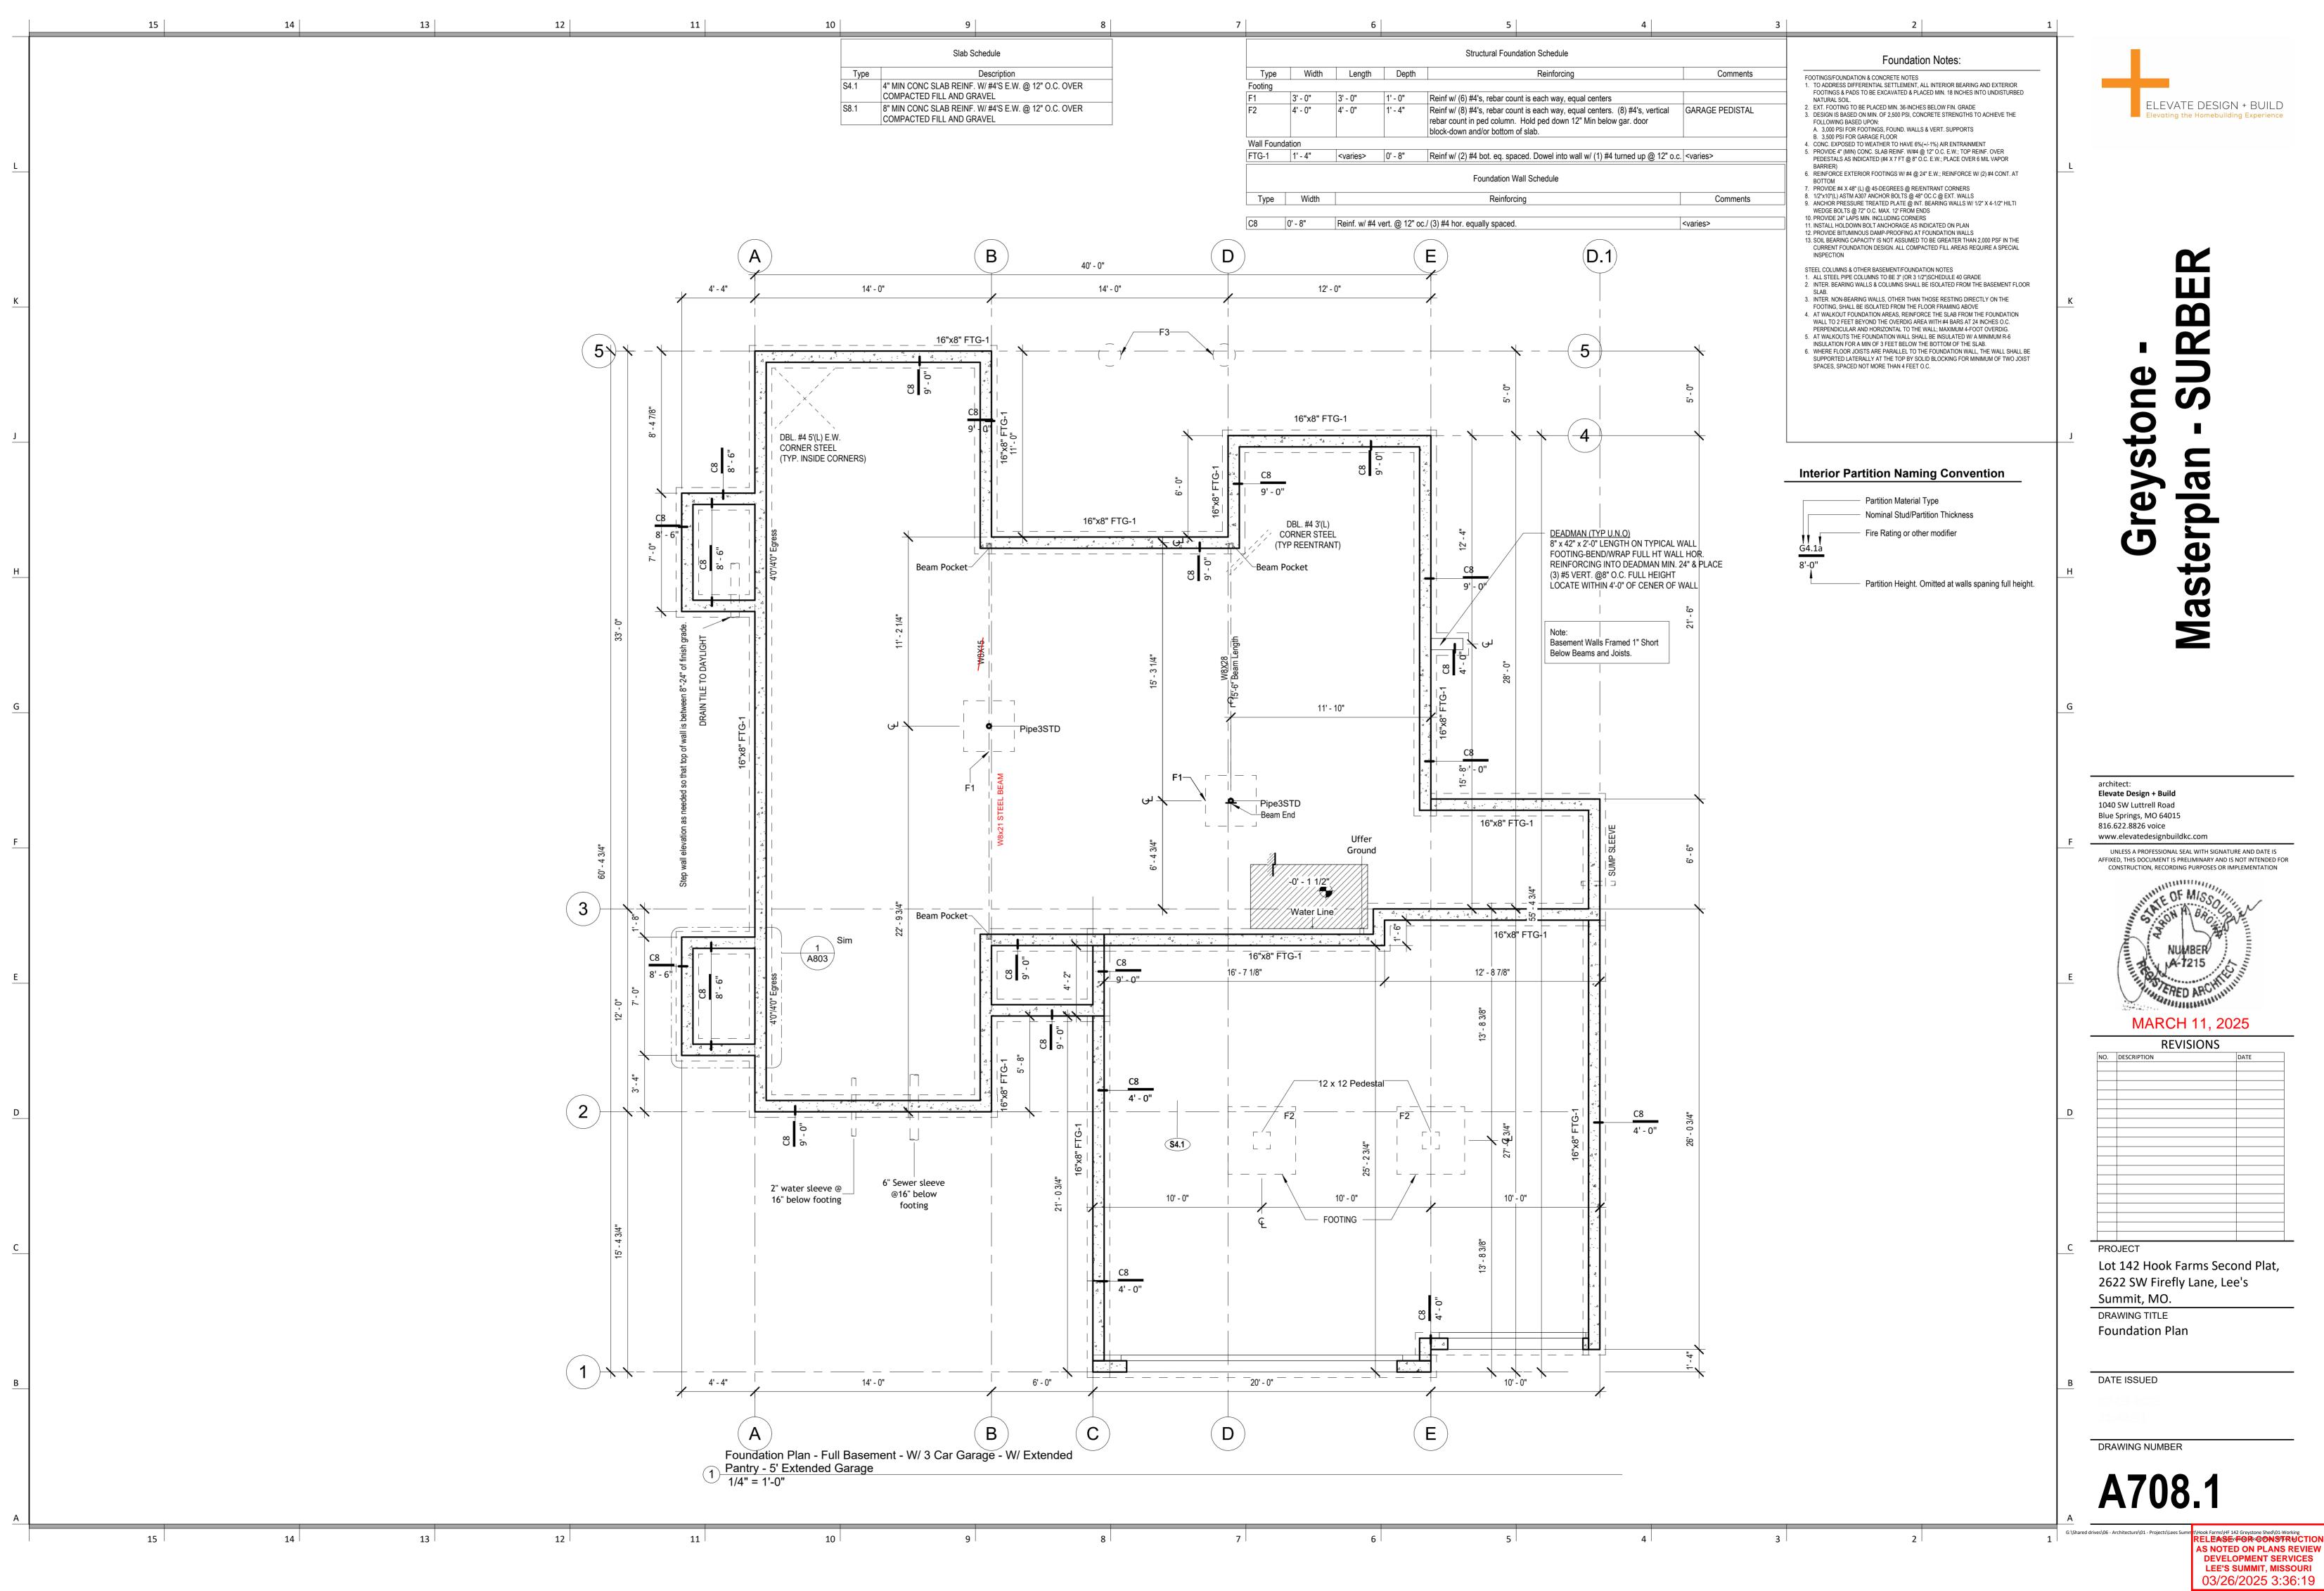
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	Stucco				L K J H	Greystone - Masterplan - SURBER
						chitect: evate Design + Build M40 SW Luttrell Road ue Springs, MO 64015 .6.622.8826 voice ww.elevatedesignbuildkc.com UNLESS A PROFESSIONAL SEAL WITH SIGNATURE AND DATE IS FIXED, THIS DOCUMENT IS PRELIMINARY AND IS NOT INTENDED FOR CONSTRUCTION, RECORDING PURPOSES OR IMPLEMENTATION NUMBER NU
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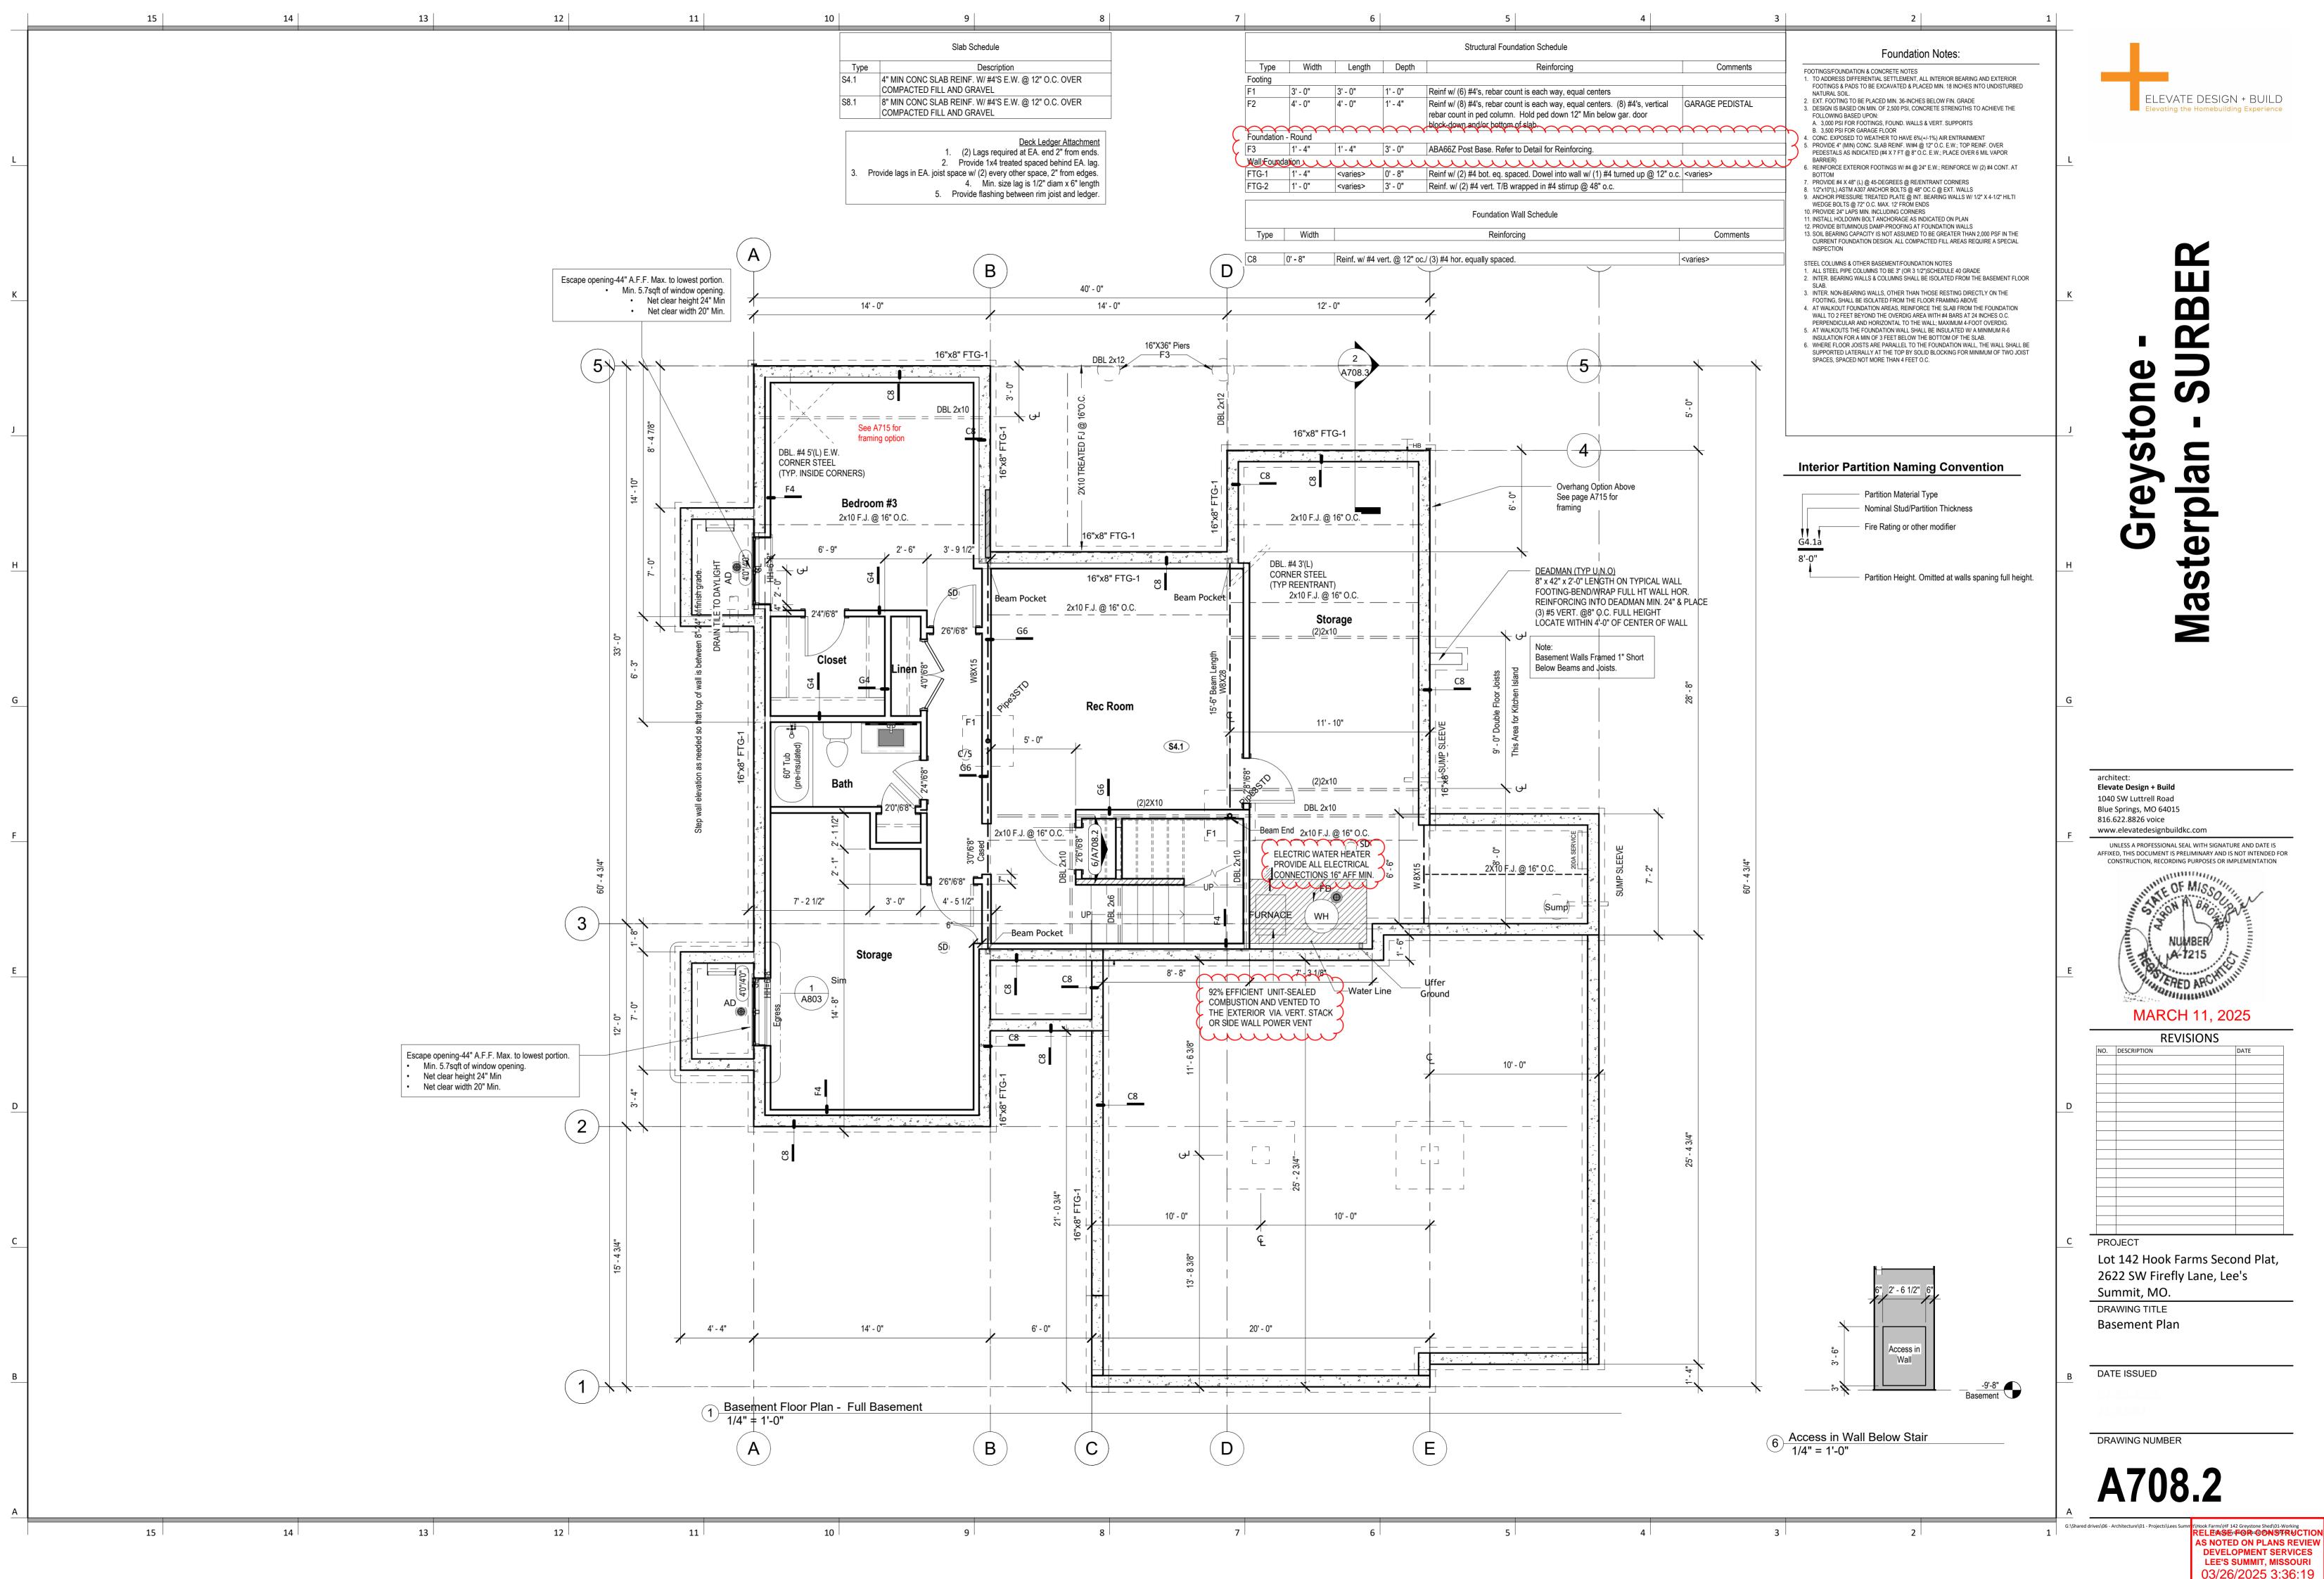
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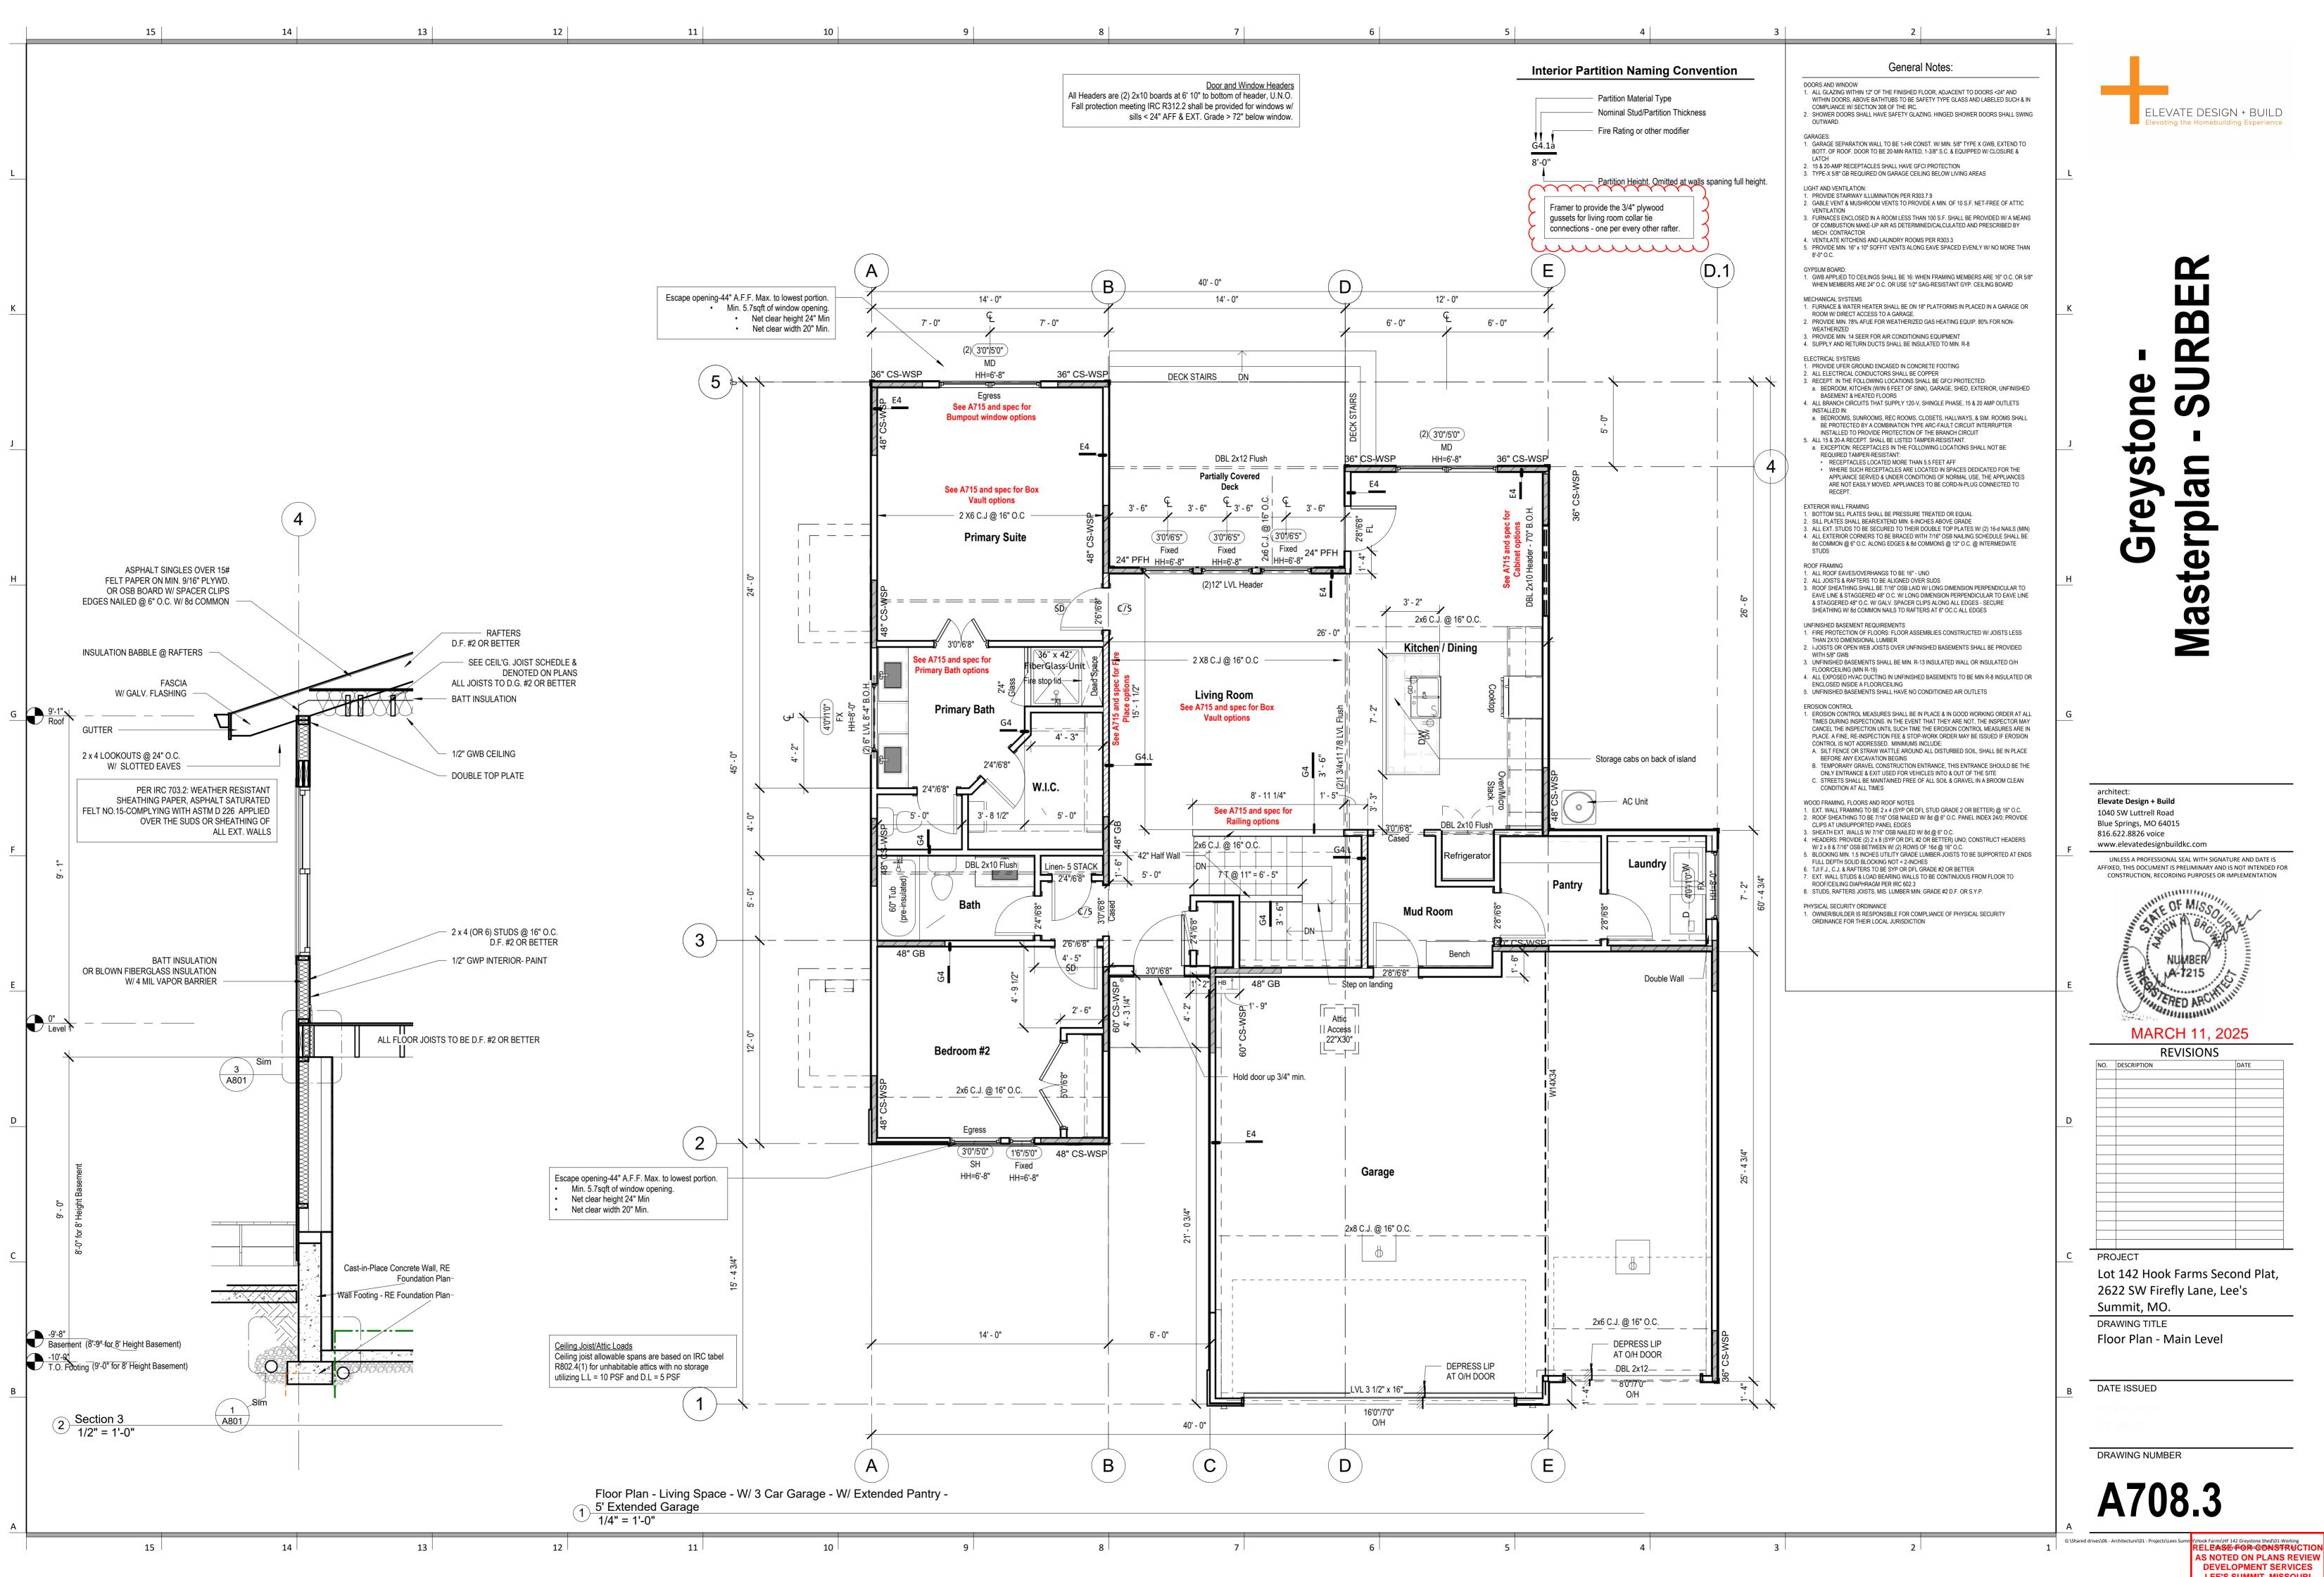




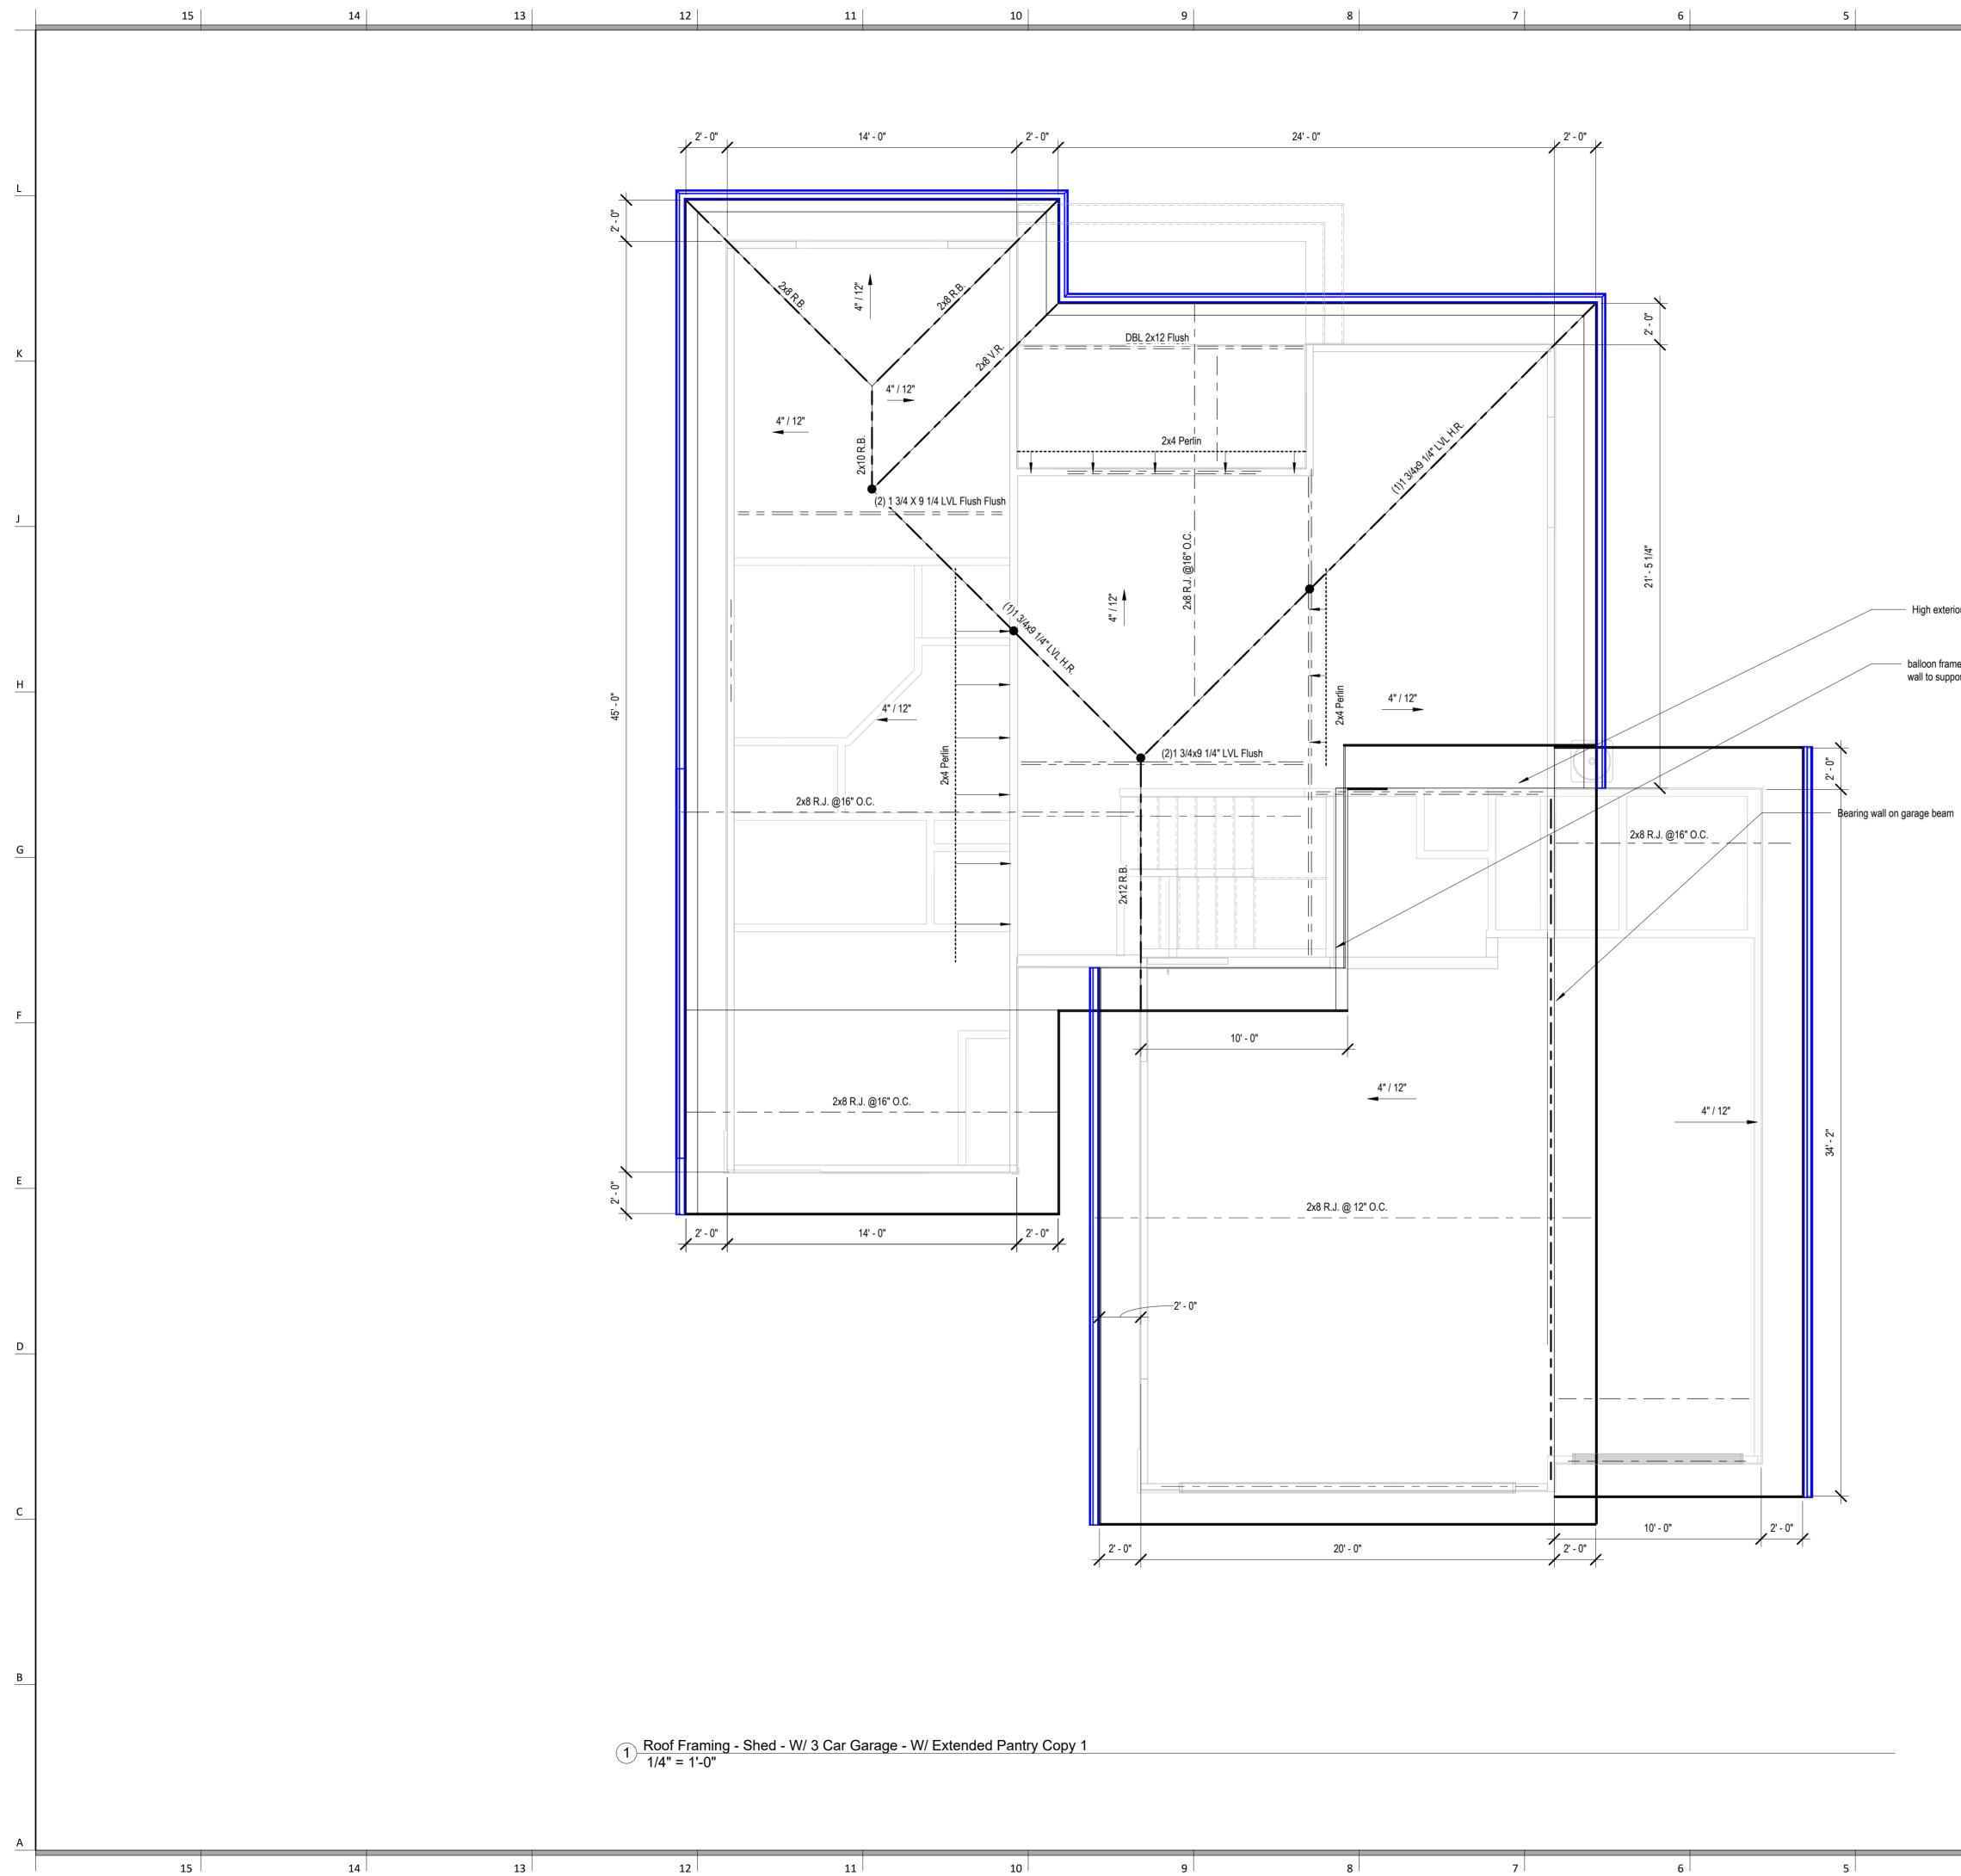
Iualion Flan - I uli Dasement - W/ 5 Gai	Galage - M
ry - 5' Extended Garage	
- 11 0"	

10	9	8	7	6	



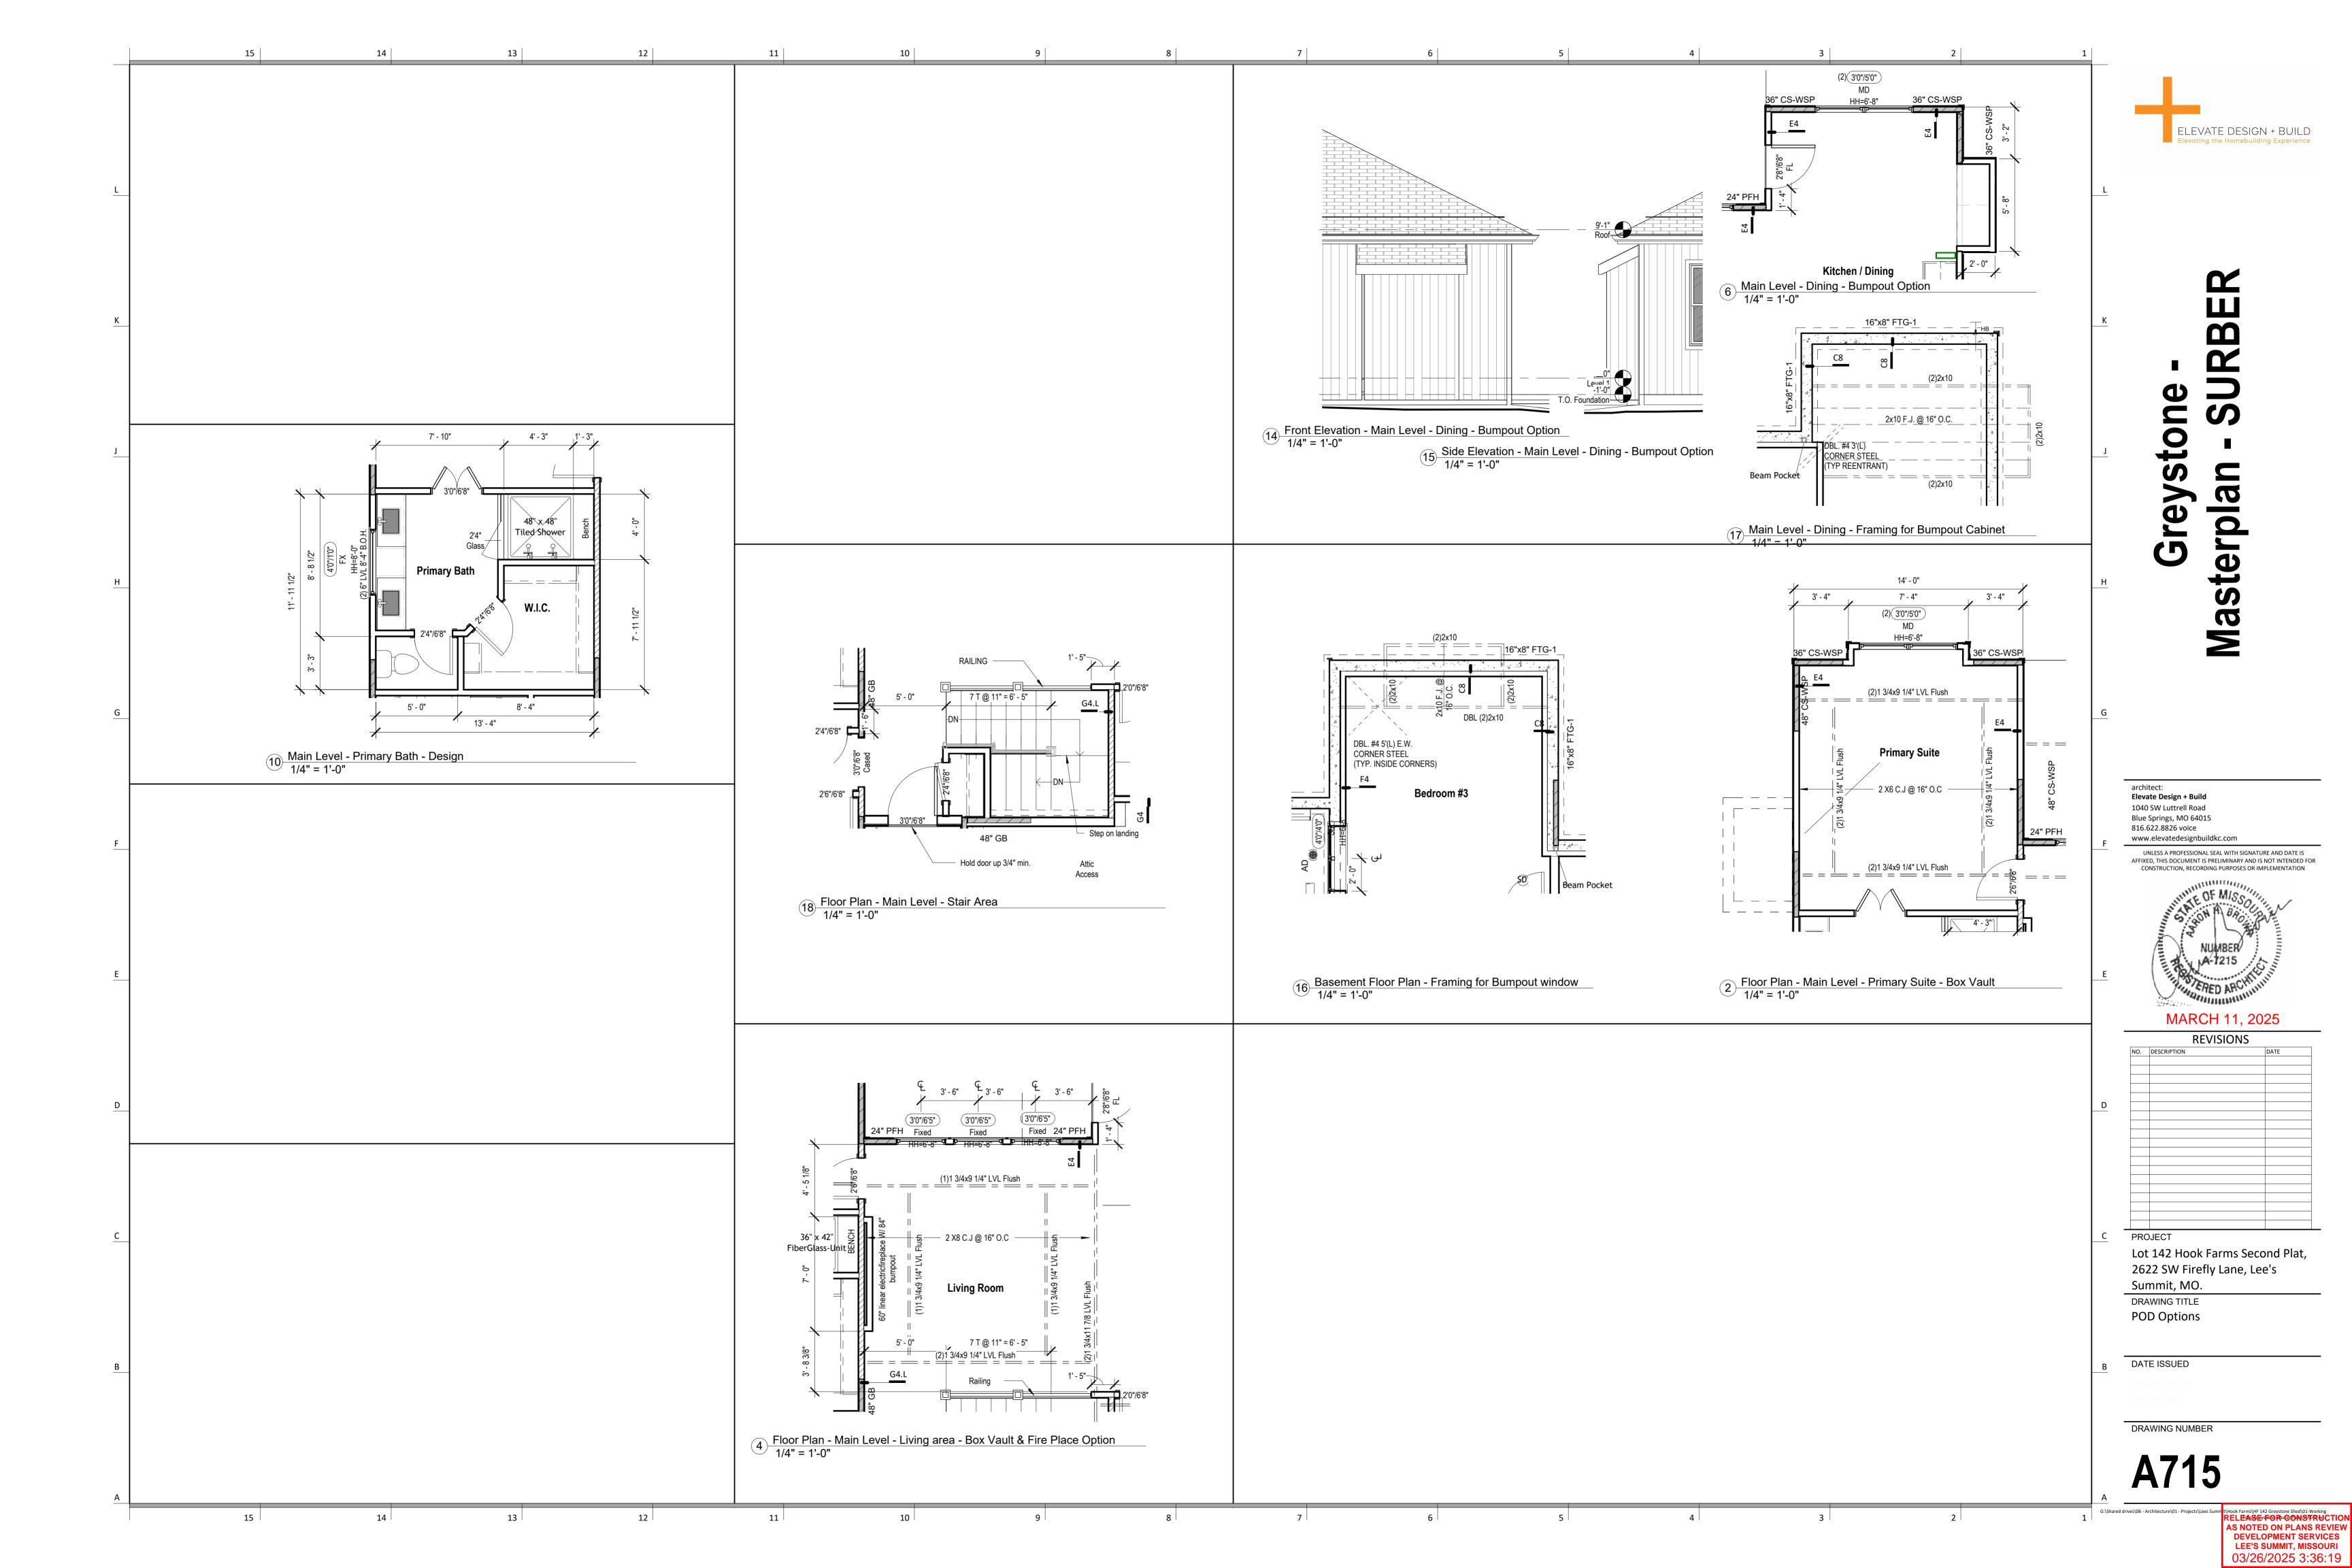


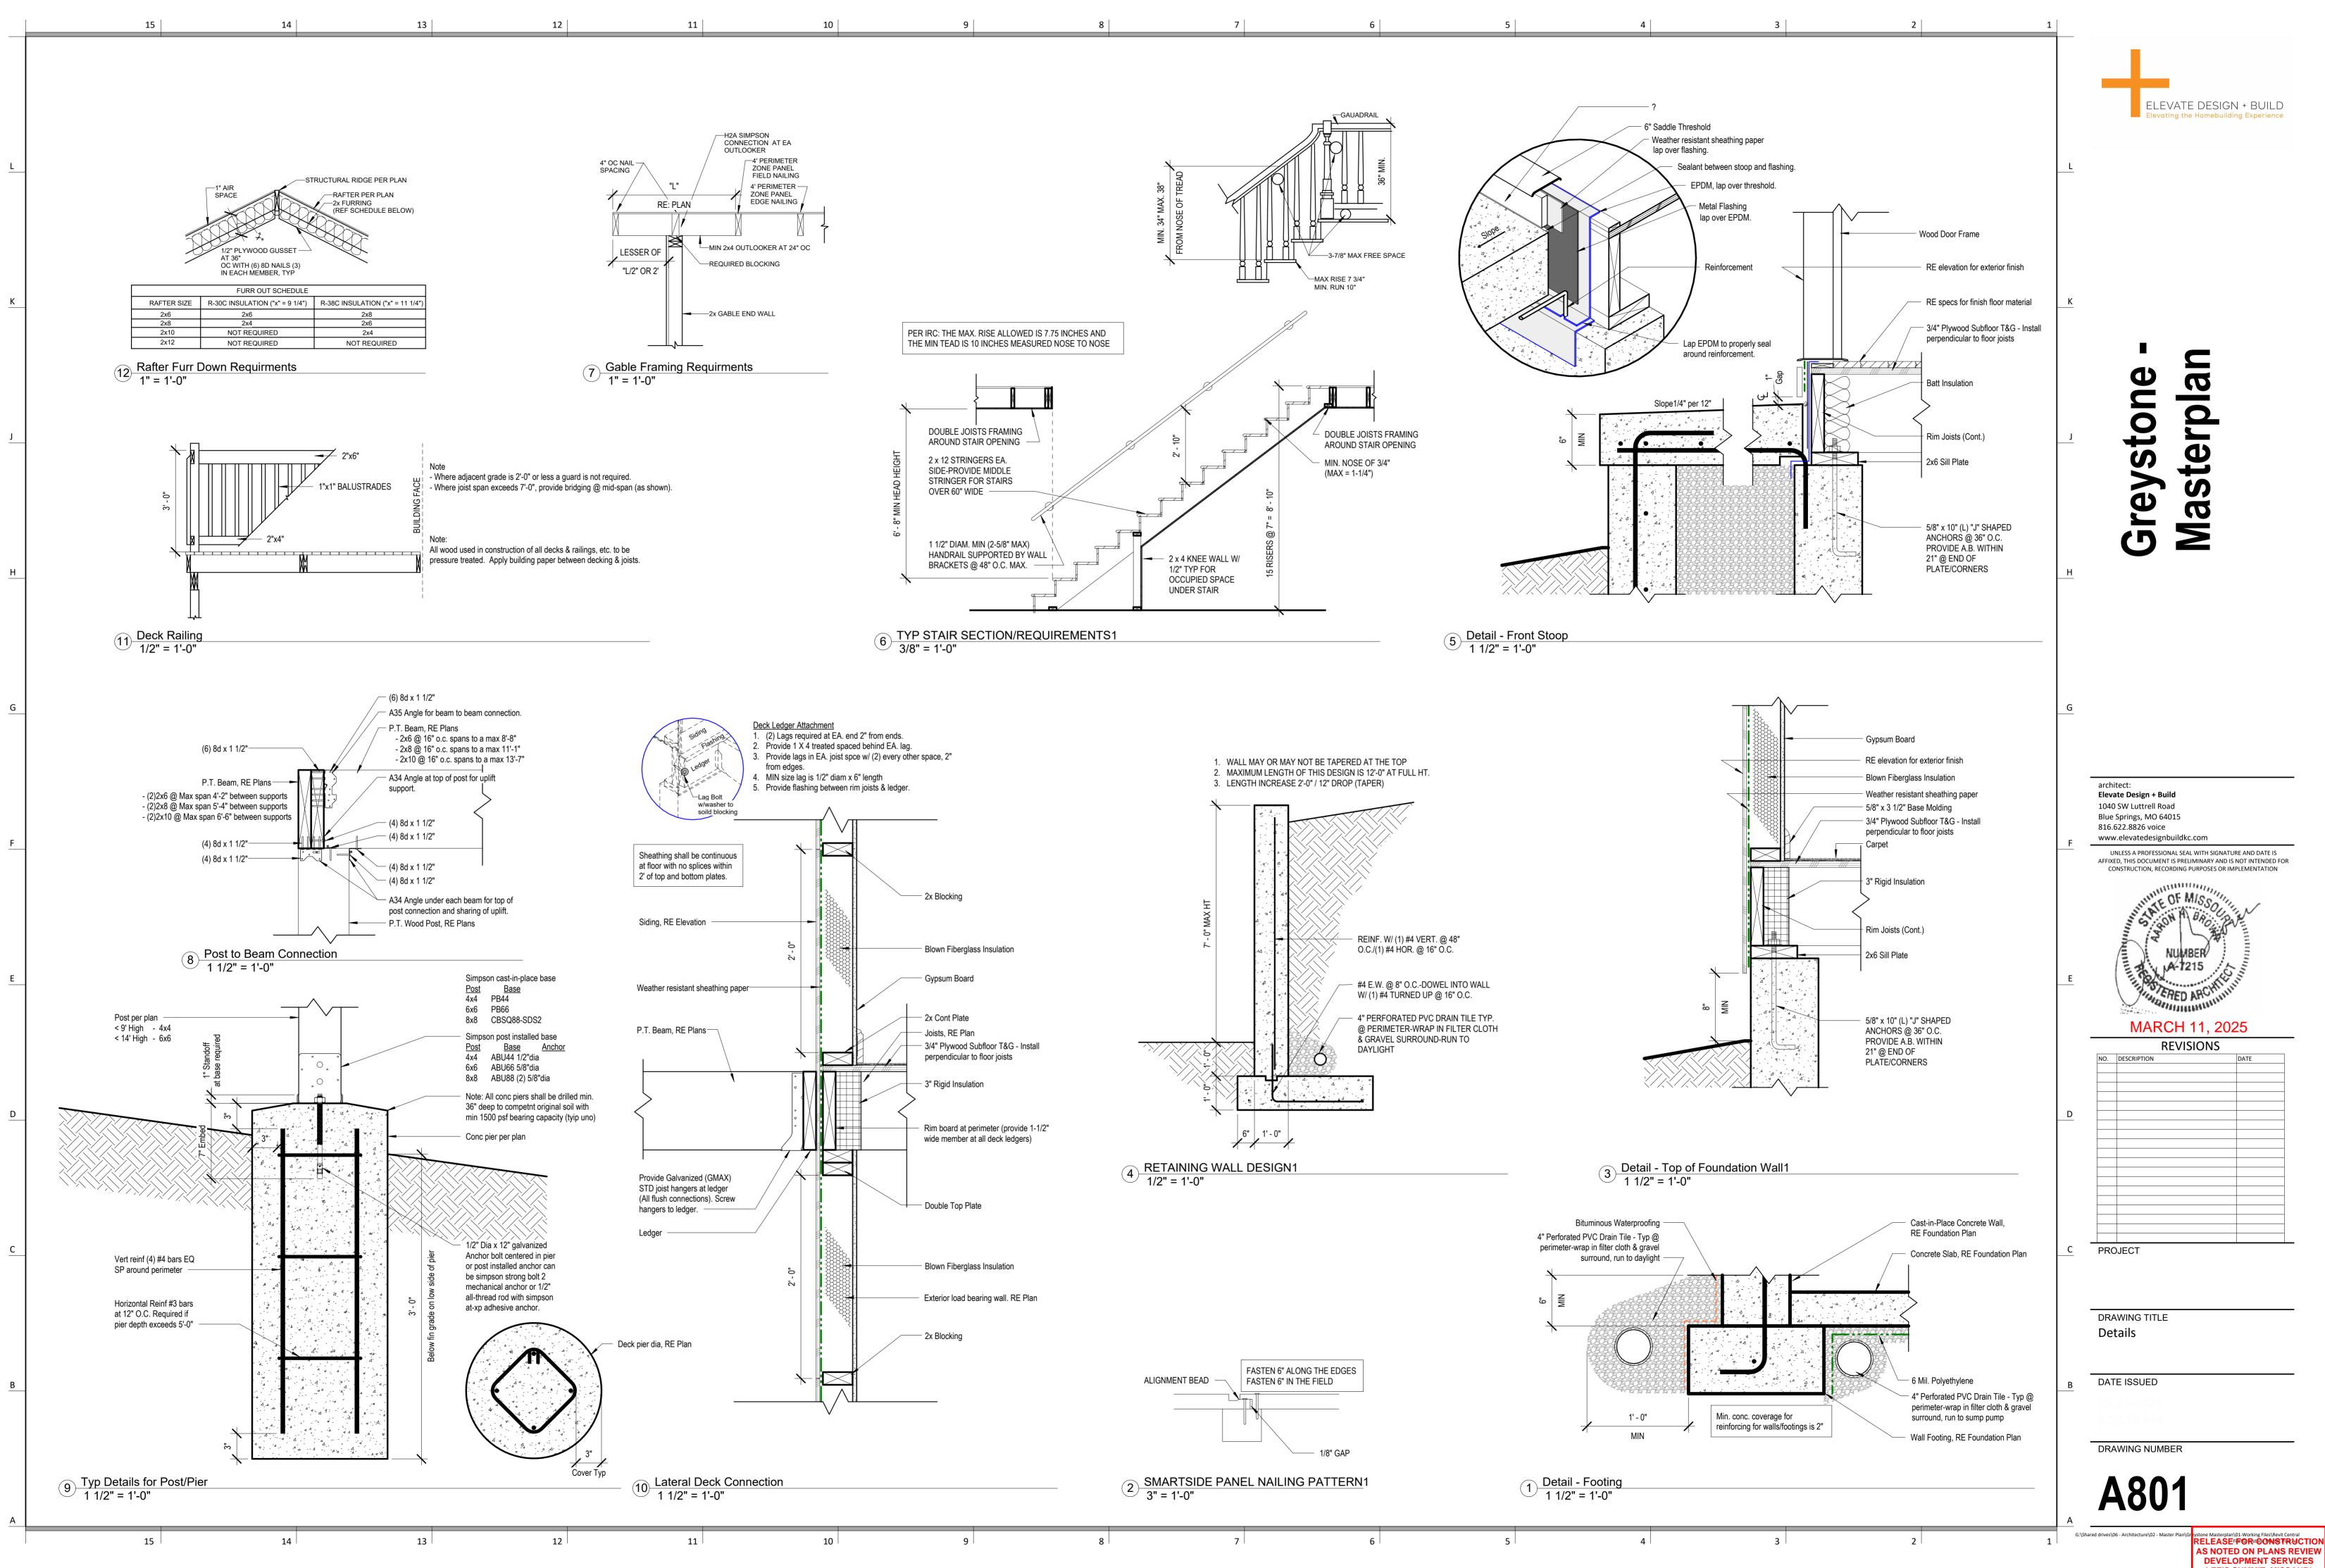
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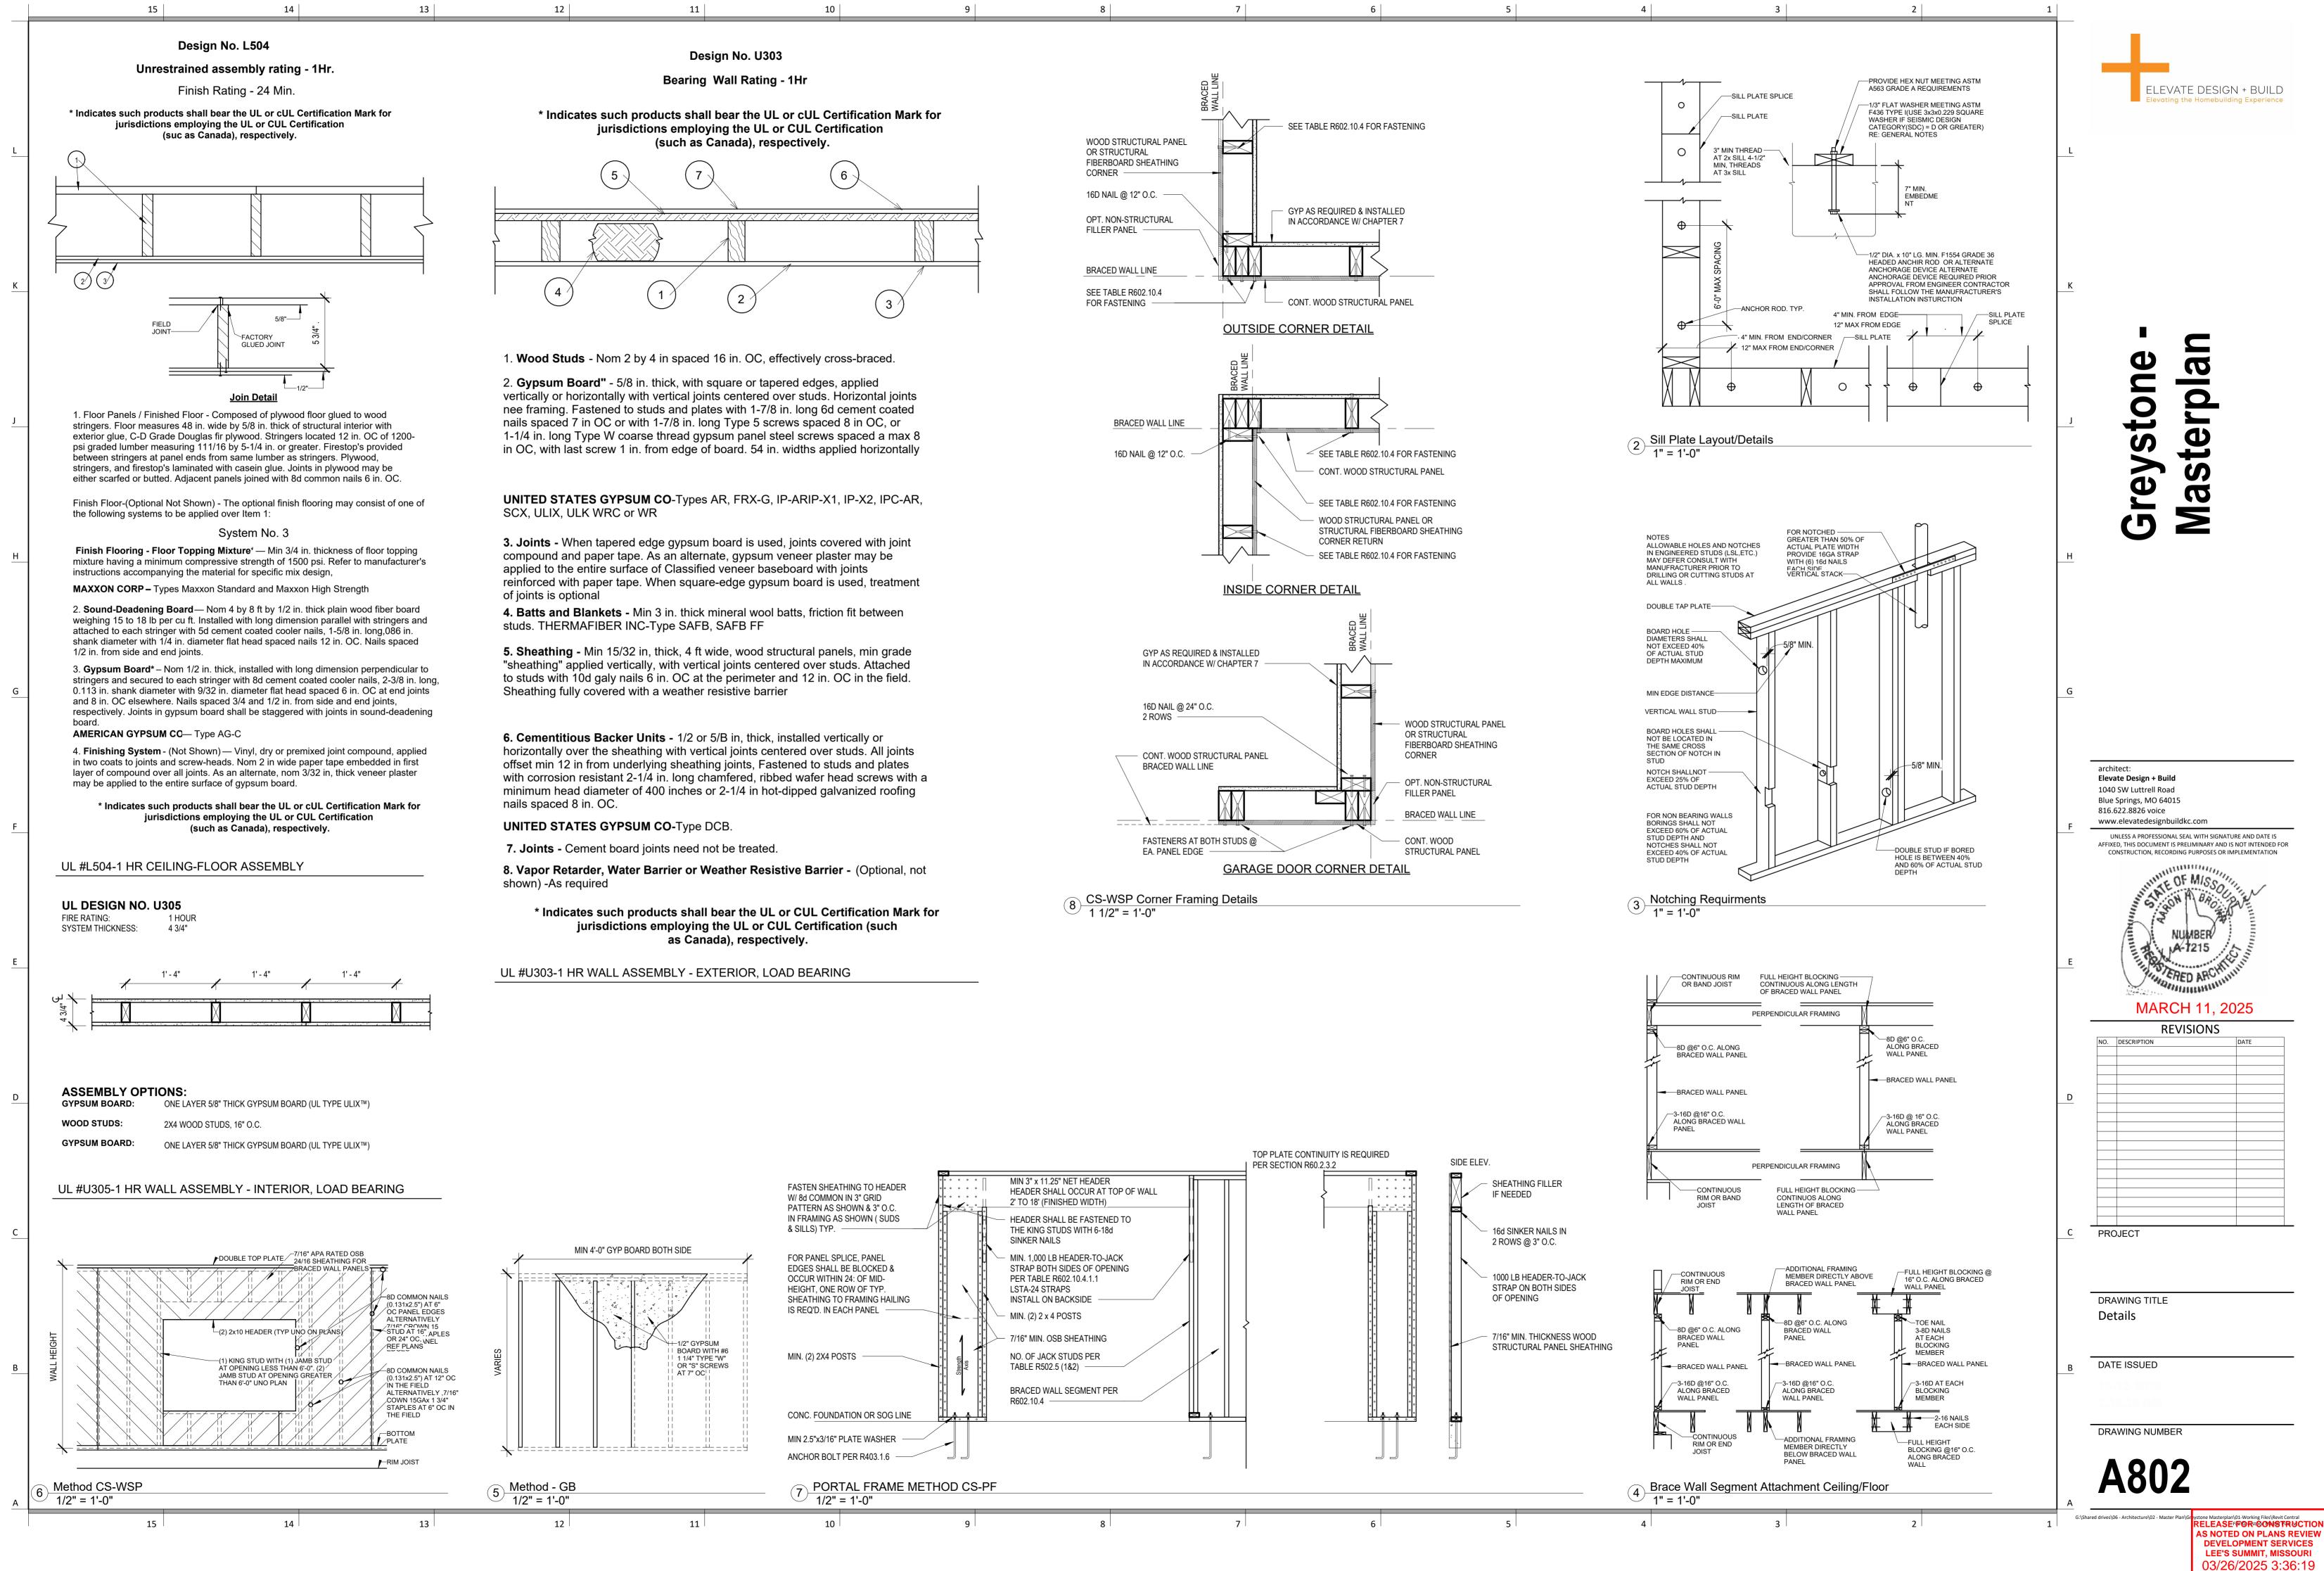
4	3	2	1	
			<u>L</u>	ELEVATE DESIGN + BUILD Elevating the Homebuilding Experience
erior wall sits on beam below ame interior pport roof split			K 	Greystone - Masterplan - SURBER
			E 1 B 8 F	rchitect: levate Design + Build 040 SW Luttrell Road lue Springs, MO 64015 16.622.8826 voice www.elevatedesignbuildkc.com UNLESS A PROFESSIONAL SEAL WITH SIGNATURE AND DATE IS FFIXED, THIS DOCUMENT IS PRELIMINARY AND IS NOT INTENDED FOR CONSTRUCTION, RECORDING PURPOSES OR IMPLEMENTATION
				MARCH 11, 2025 REVISIONS
			L 2 5 C F B	PROJECT Ot 142 Hook Farms Second Plat, 2622 SW Firefly Lane, Lee's 50mmit, MO. PRAWING TITLE Roof Plan DATE ISSUED PRAWING NUMBER

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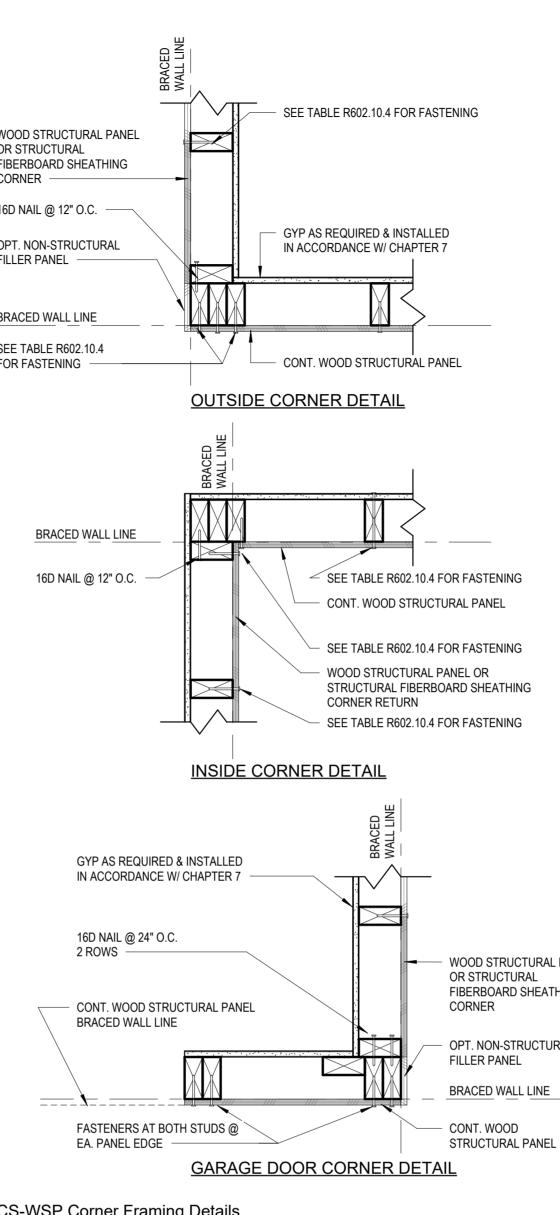


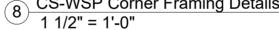


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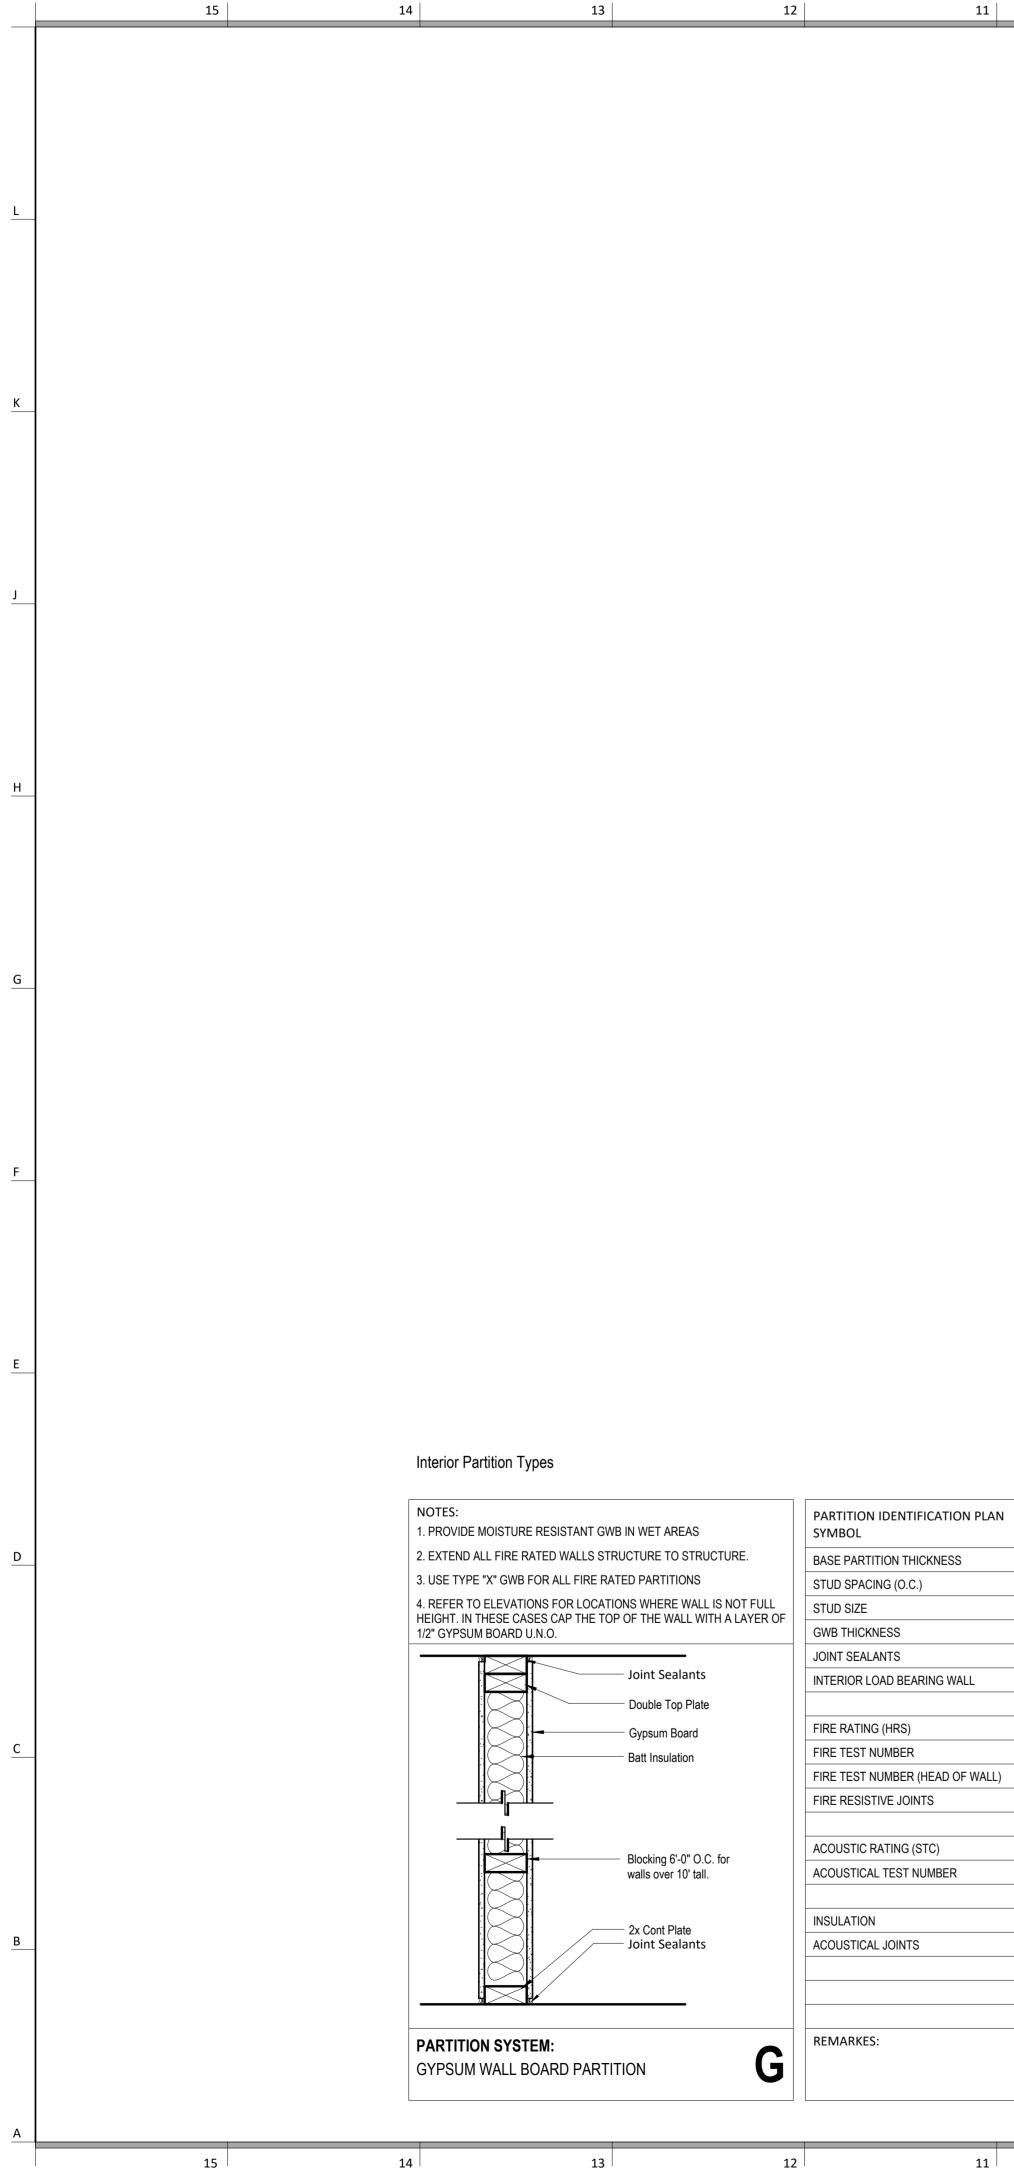


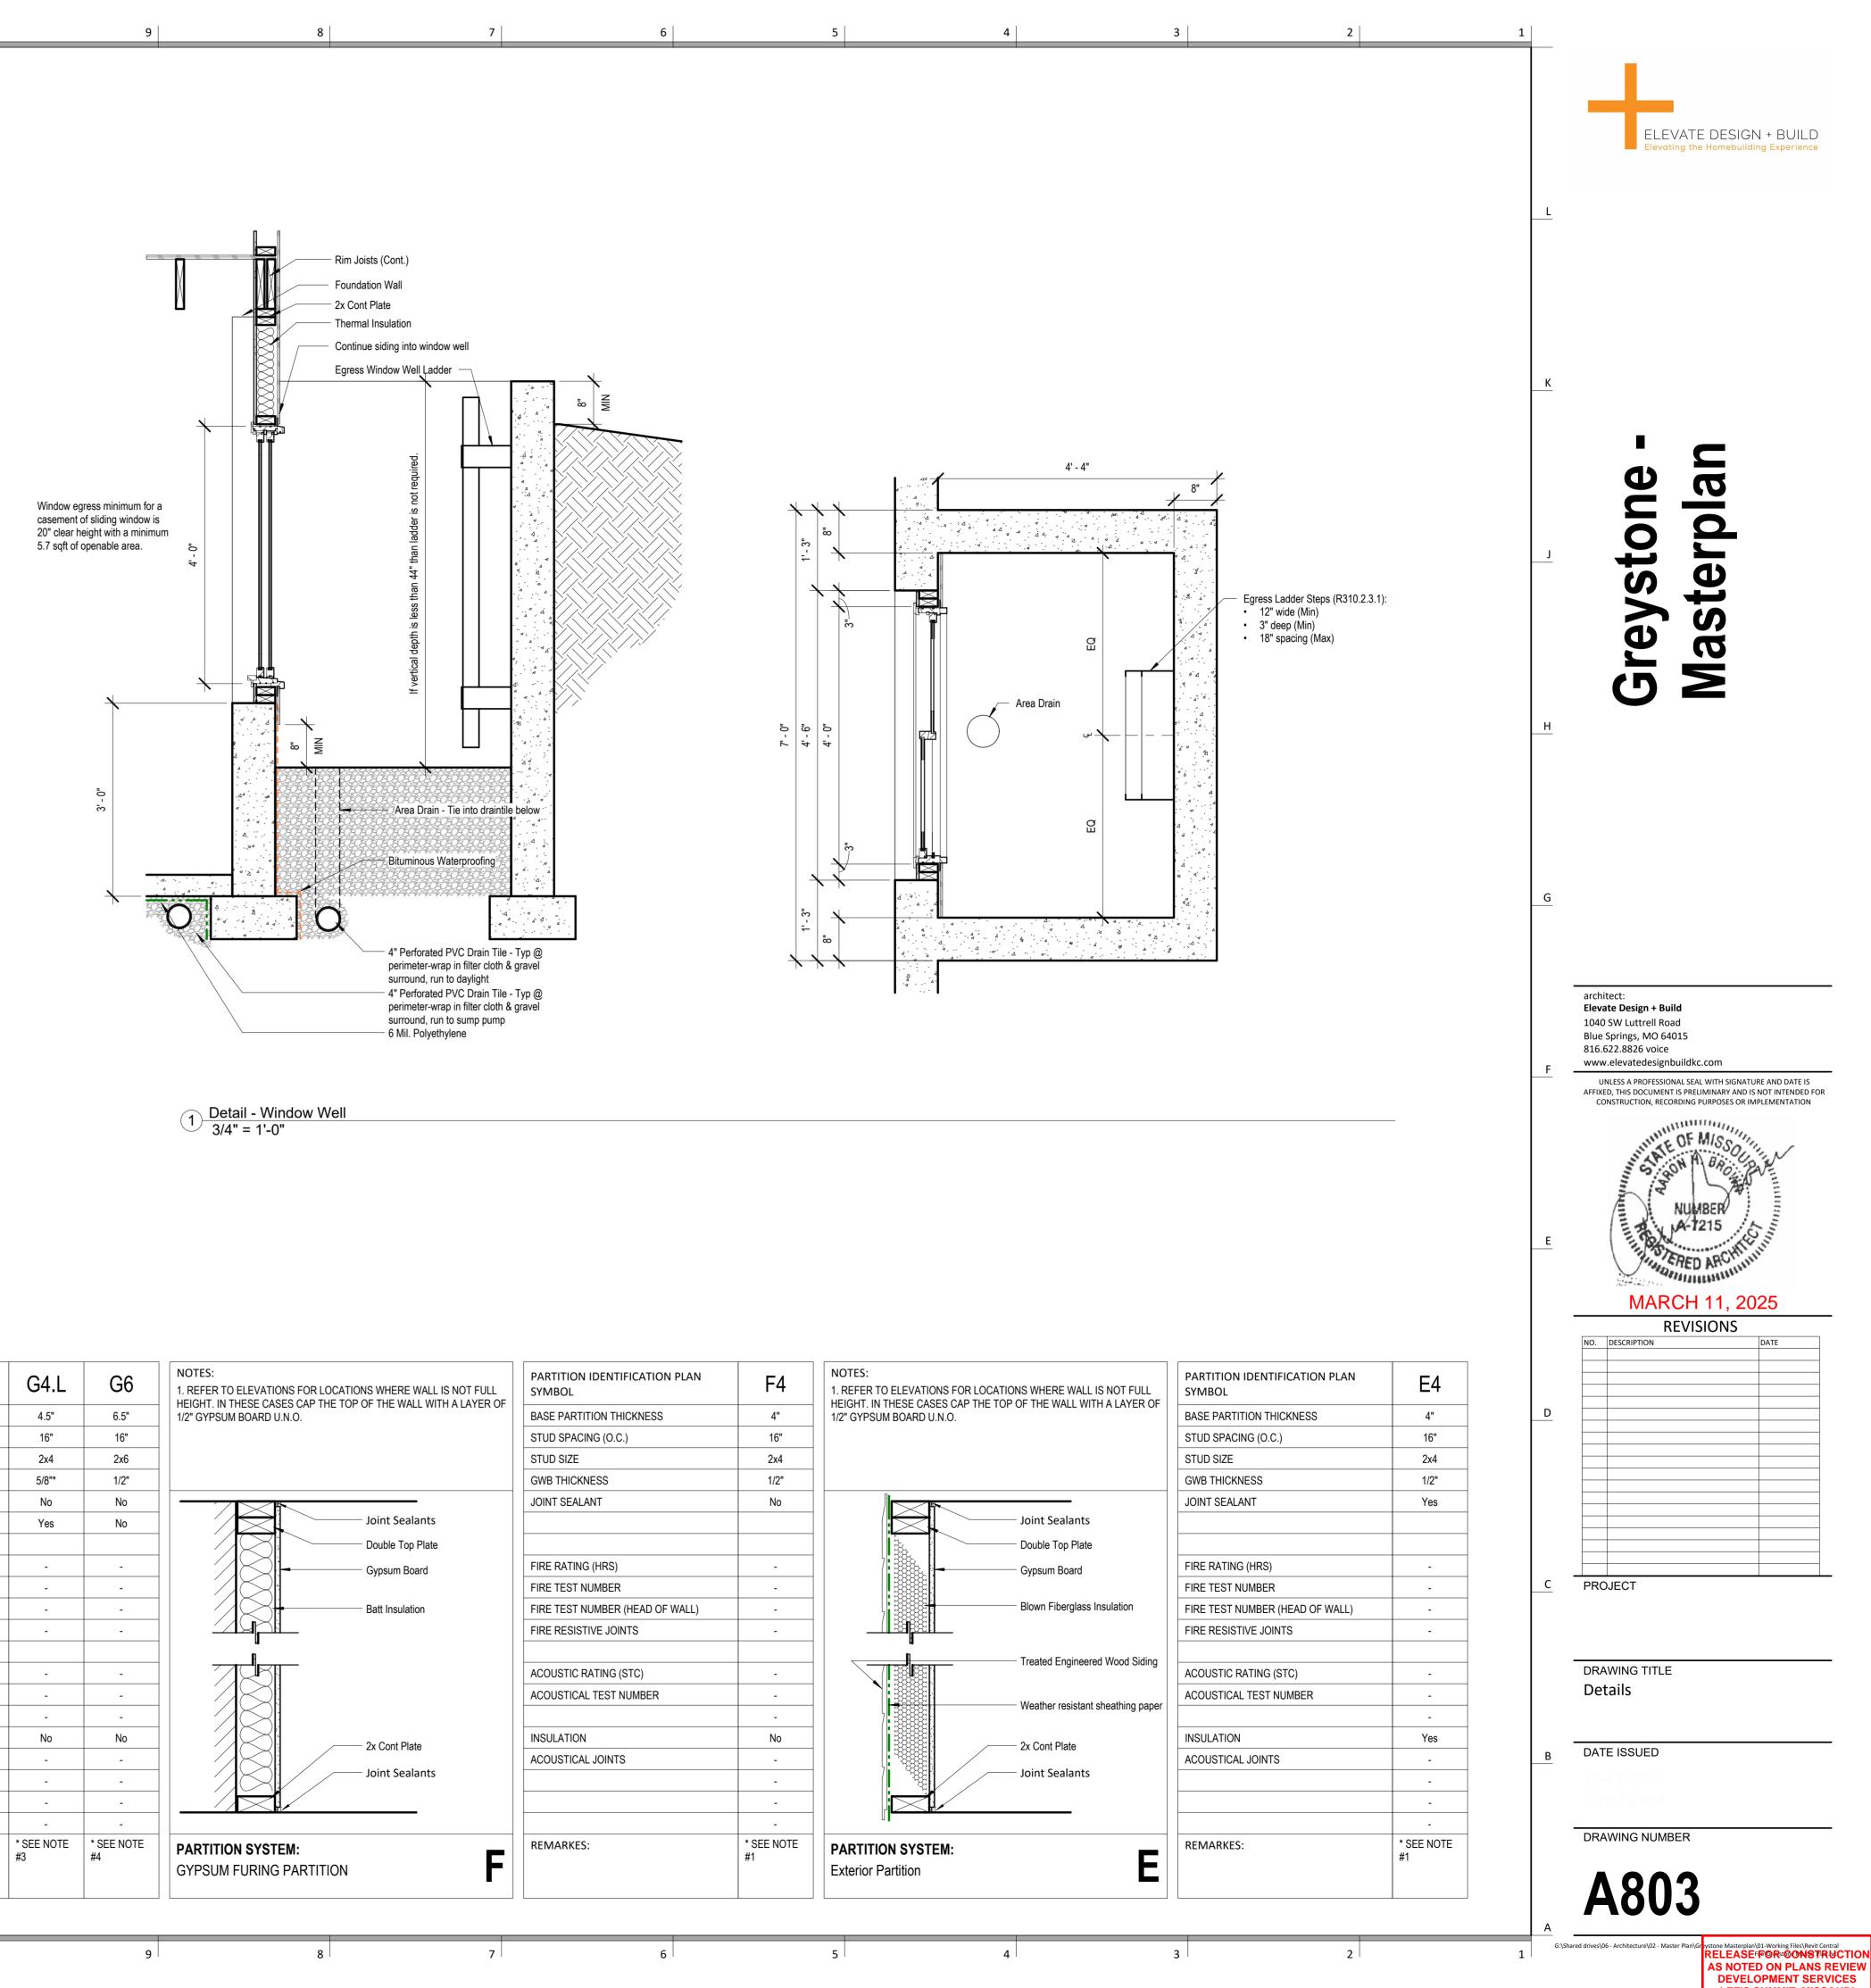






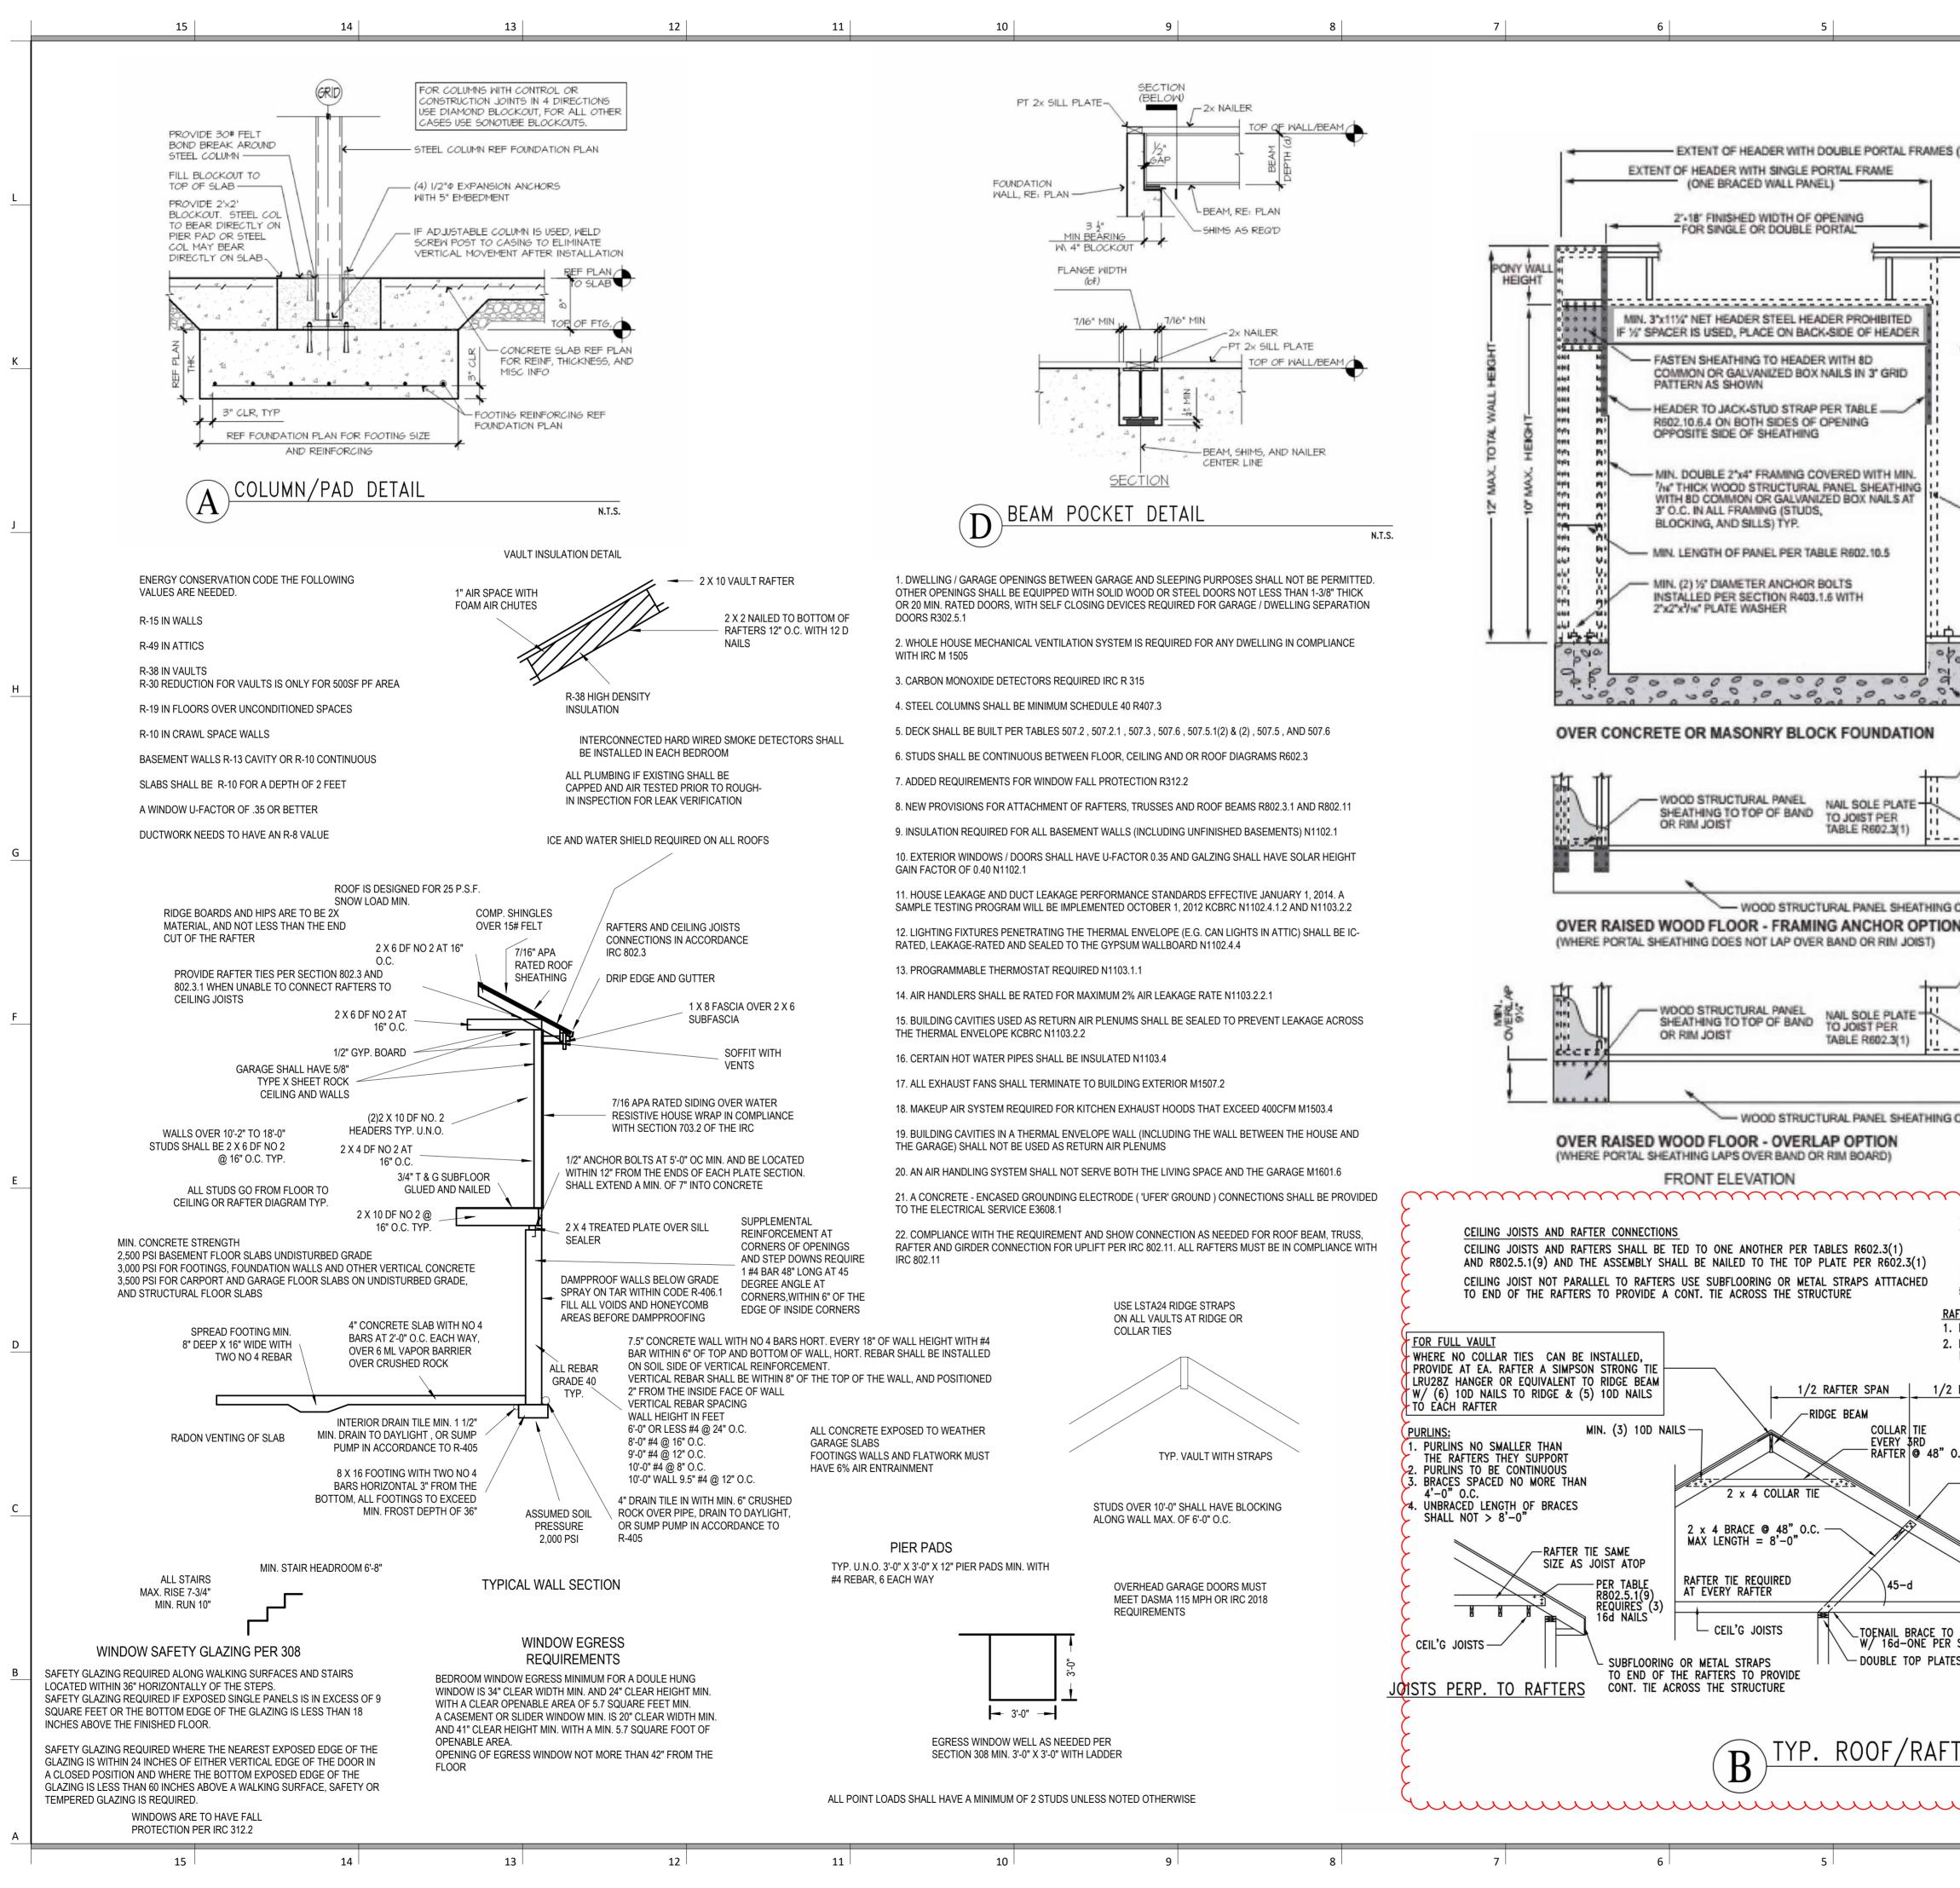
ELEVATE DESIGN + BUILD





G4	G4.1	G4.L	G6	NOTES: 1. REFER TO ELEVATIONS FOR LOCATIONS WHERE WALL IS NOT FULL HEIGHT. IN THESE CASES CAP THE TOP OF THE WALL WITH A LAYER OF	PARTITION IDENTIFICATION PLAN SYMBOL	F4	NOTES: 1. REFER TO ELEVATI HEIGHT. IN THESE CA
4.5"	4.5"	4.5"	6.5"	1/2" GYPSUM BOARD U.N.O.	BASE PARTITION THICKNESS	4"	1/2" GYPSUM BOARD
16"	16"	16"	16"		STUD SPACING (O.C.)	16"	
2x4	2x4	2x4	2x6		STUD SIZE	2x4	
1/2"	5/8"*	5/8"*	1/2"		GWB THICKNESS	1/2"	
No	No	No	No		JOINT SEALANT	No	
No	No	Yes	No	Joint Sealants			
				Double Top Plate			
-	1	-	-	Gypsum Board	FIRE RATING (HRS)	-	
-	U314	-	-		FIRE TEST NUMBER	-	
-	-	-	-	Batt Insulation	FIRE TEST NUMBER (HEAD OF WALL)	-	
-	-	-	-		FIRE RESISTIVE JOINTS	-	
 -	-	-	-		ACOUSTIC RATING (STC)		
 -	-	-	-		ACOUSTICAL TEST NUMBER	-	
 -	-	-	-			-	
No	Yes	No	No	2x Cont Plate	INSULATION	No	
-	-	-	-		ACOUSTICAL JOINTS	-	
-	-	-	-	Joint Sealants		-	
-	-	-	-			-	
-	-	-	-			-	
* SEE NOTE #4	* SEE NOTE #3	* SEE NOTE #3	* SEE NOTE #4	PARTITION SYSTEM: GYPSUM FURING PARTITION	REMARKES:	* SEE NOTE #1	PARTITION SYST Exterior Partition

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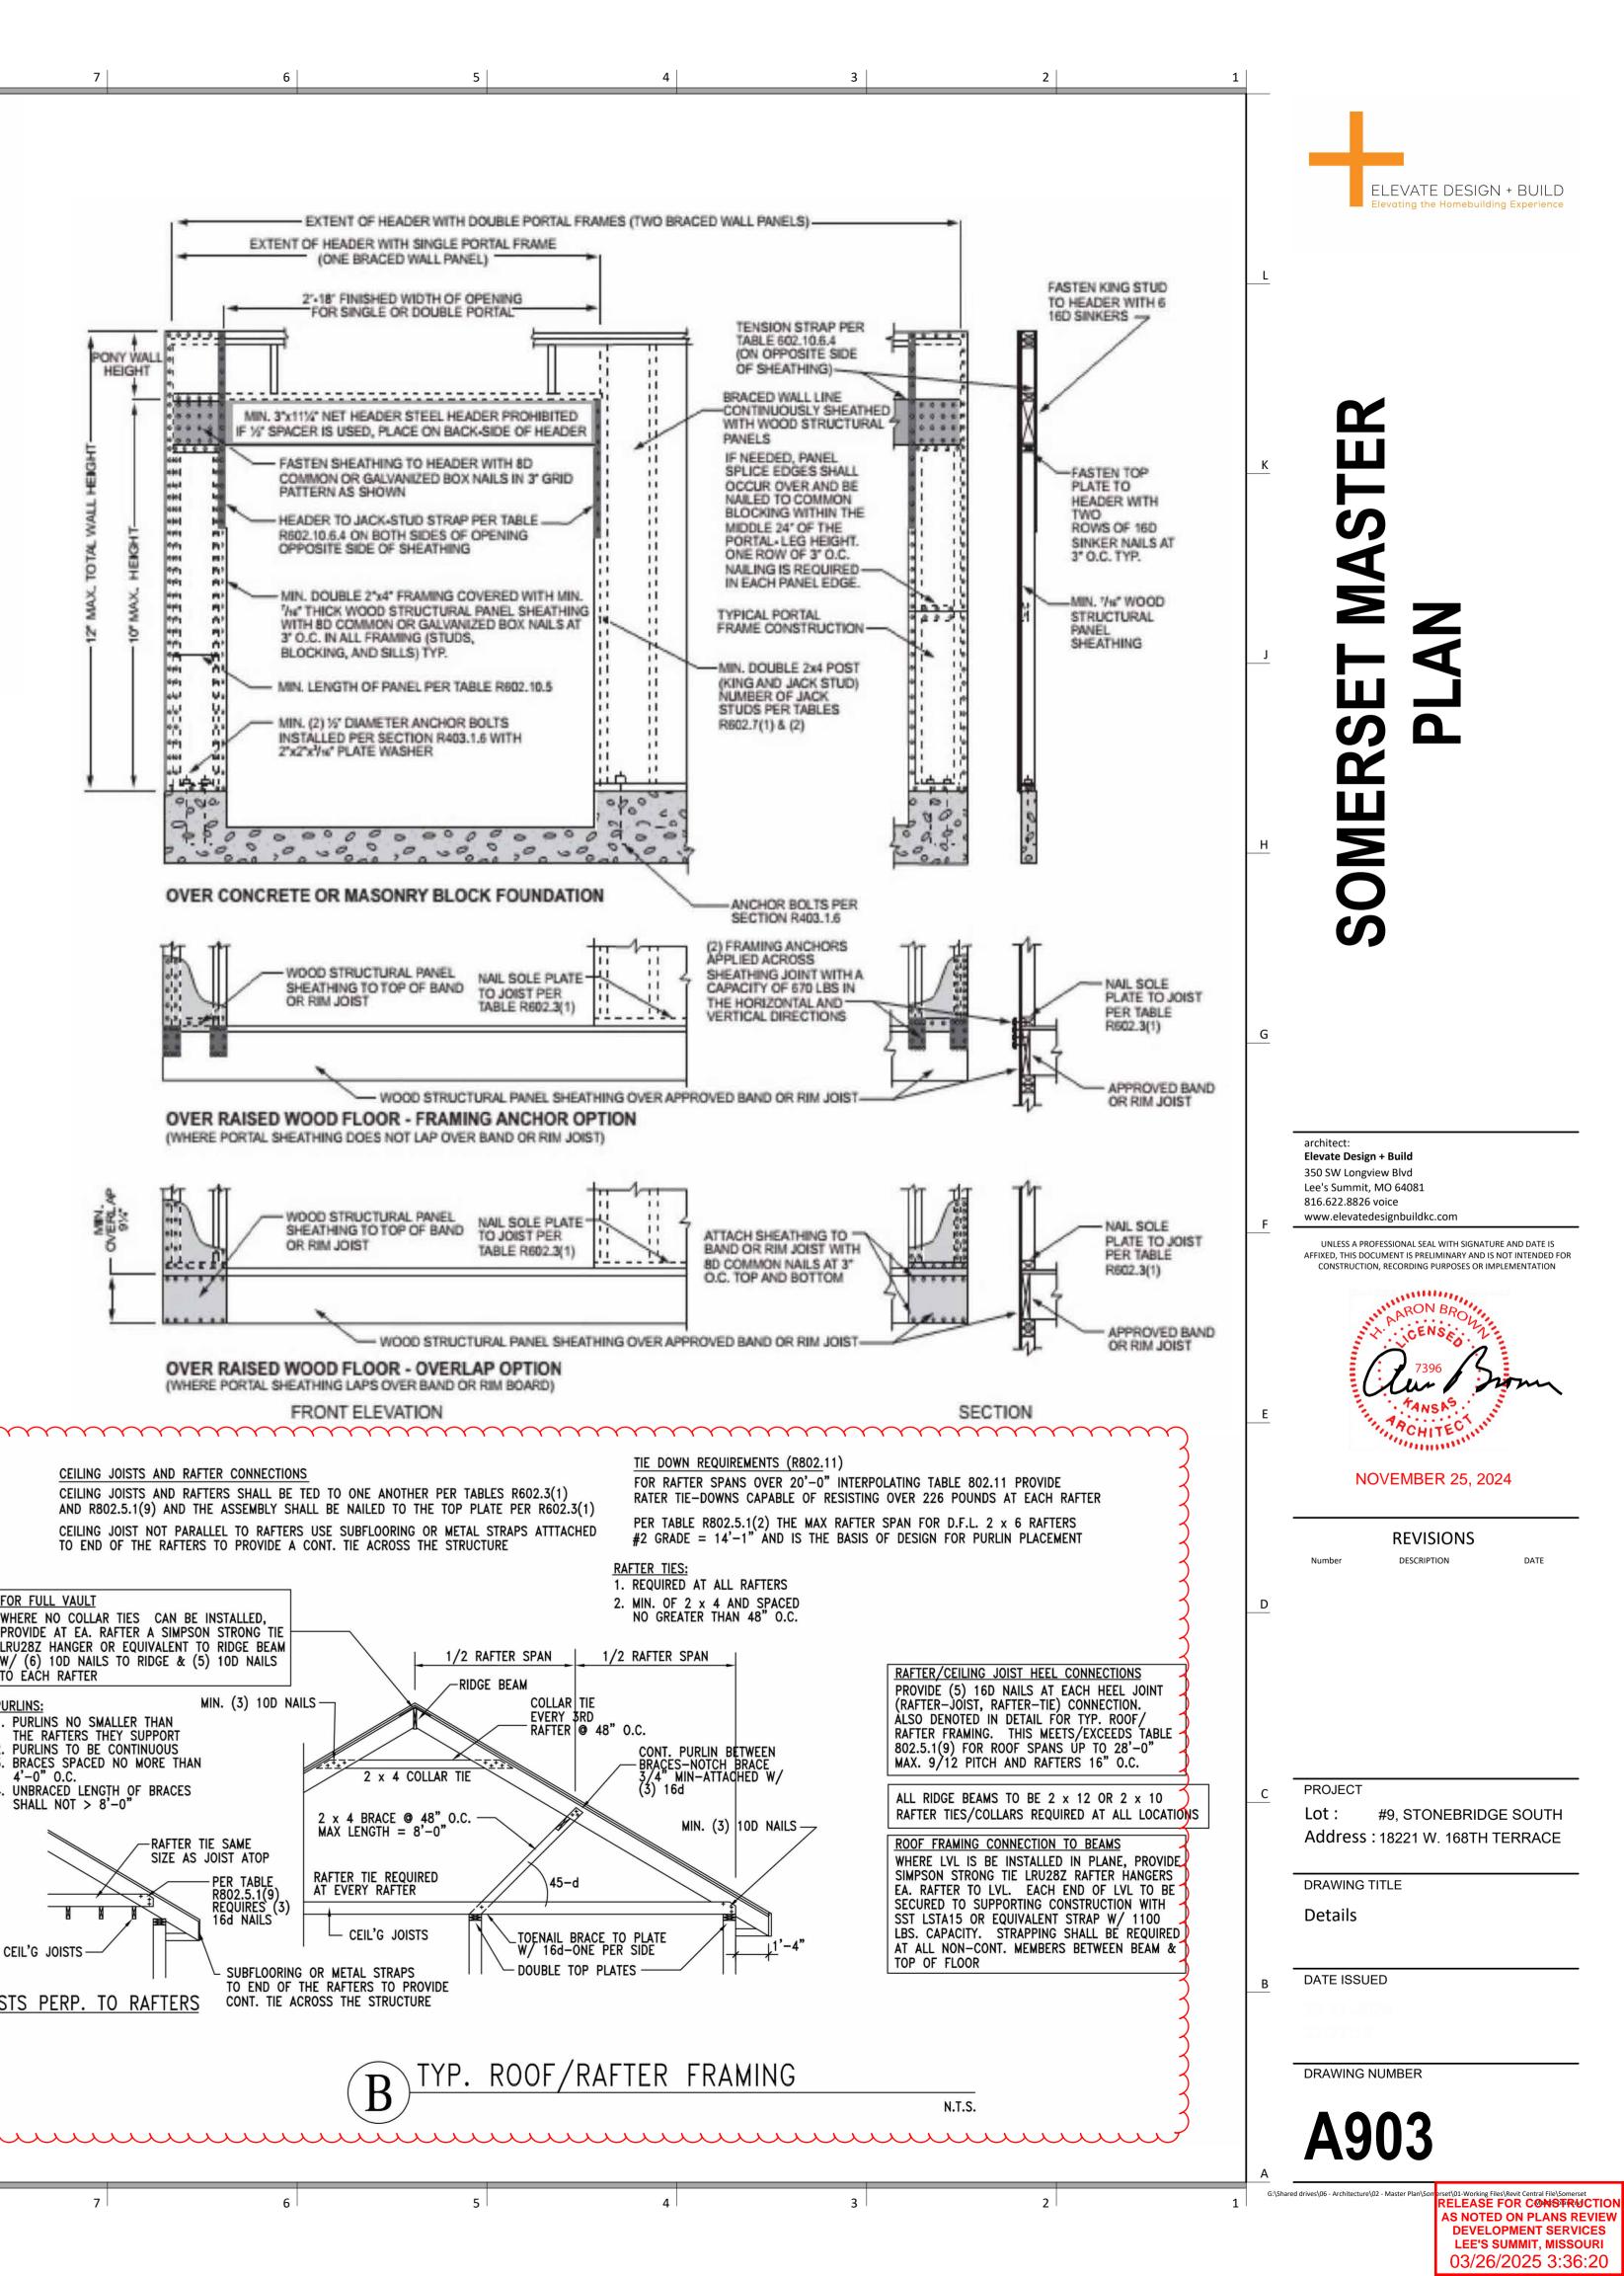


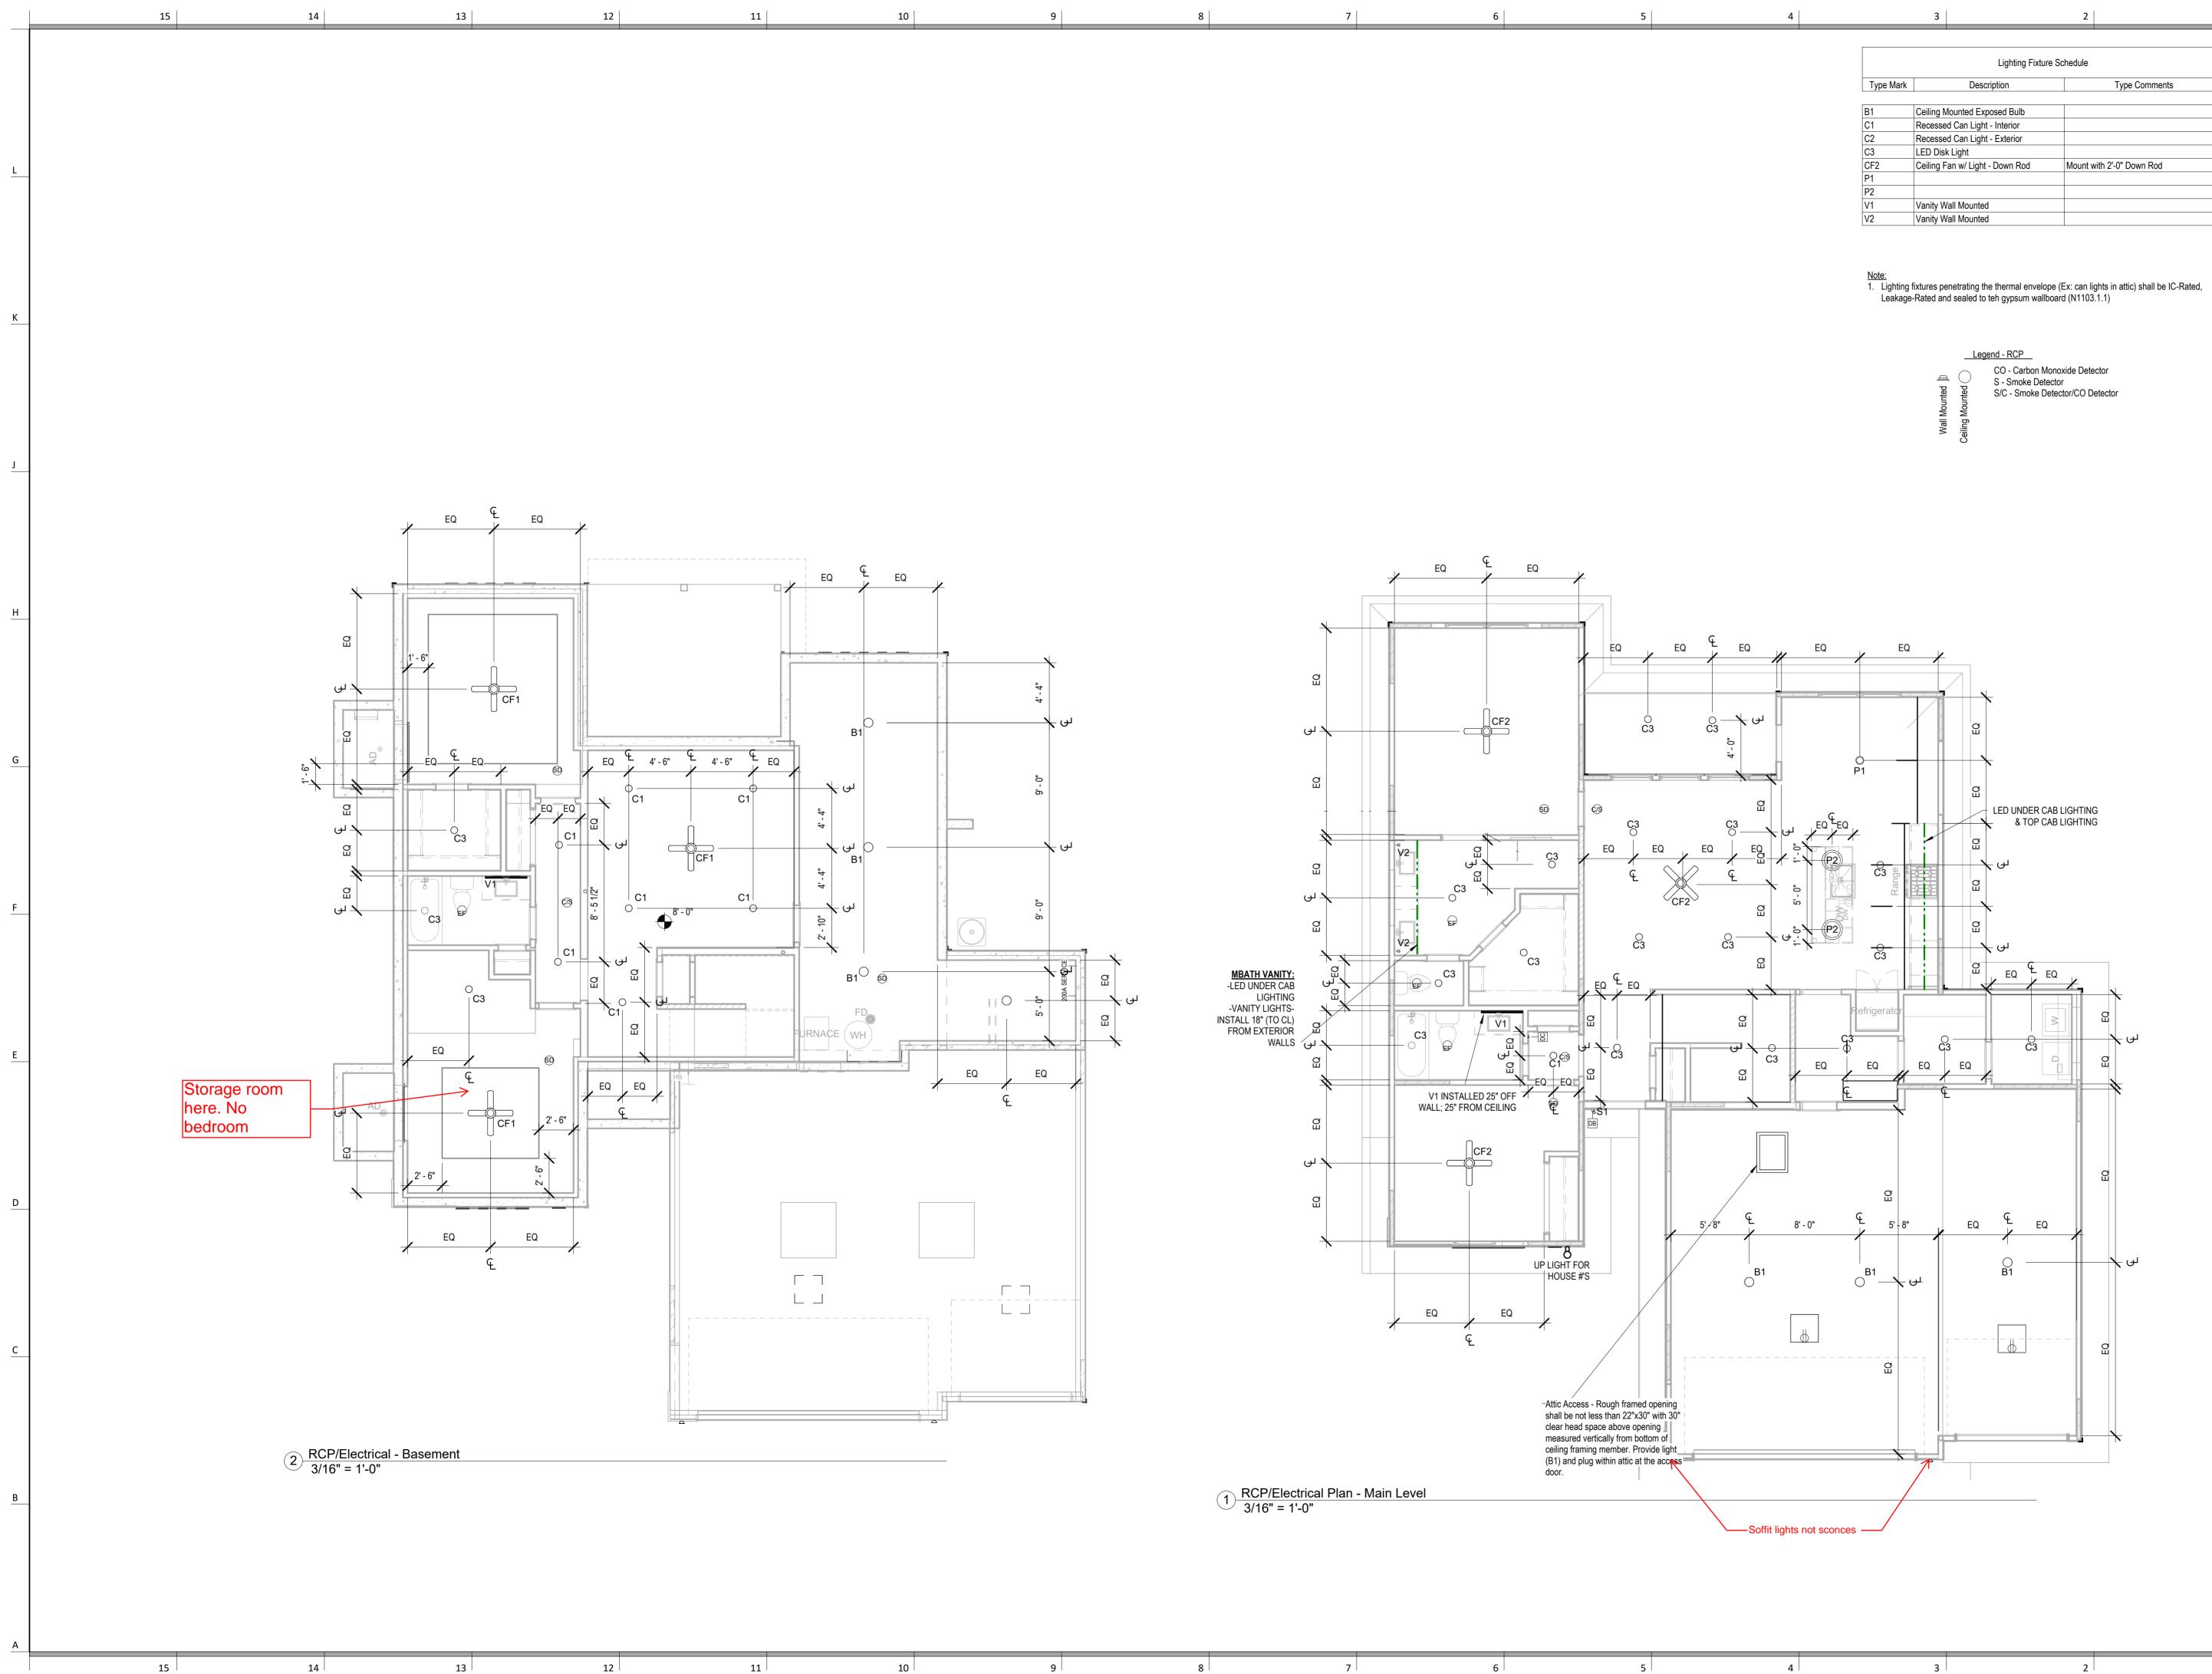
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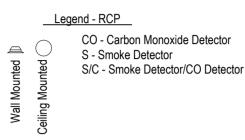






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Lighting Fixture Schedule						
Type Mark	Description	Type Comments				
31	Ceiling Mounted Exposed Bulb					
C1	Recessed Can Light - Interior					
C2	Recessed Can Light - Exterior					
C3	LED Disk Light					
CF2	Ceiling Fan w/ Light - Down Rod	Mount with 2'-0" Down Rod				
21						
2						
/1	Vanity Wall Mounted					
/2	Vanity Wall Mounted					

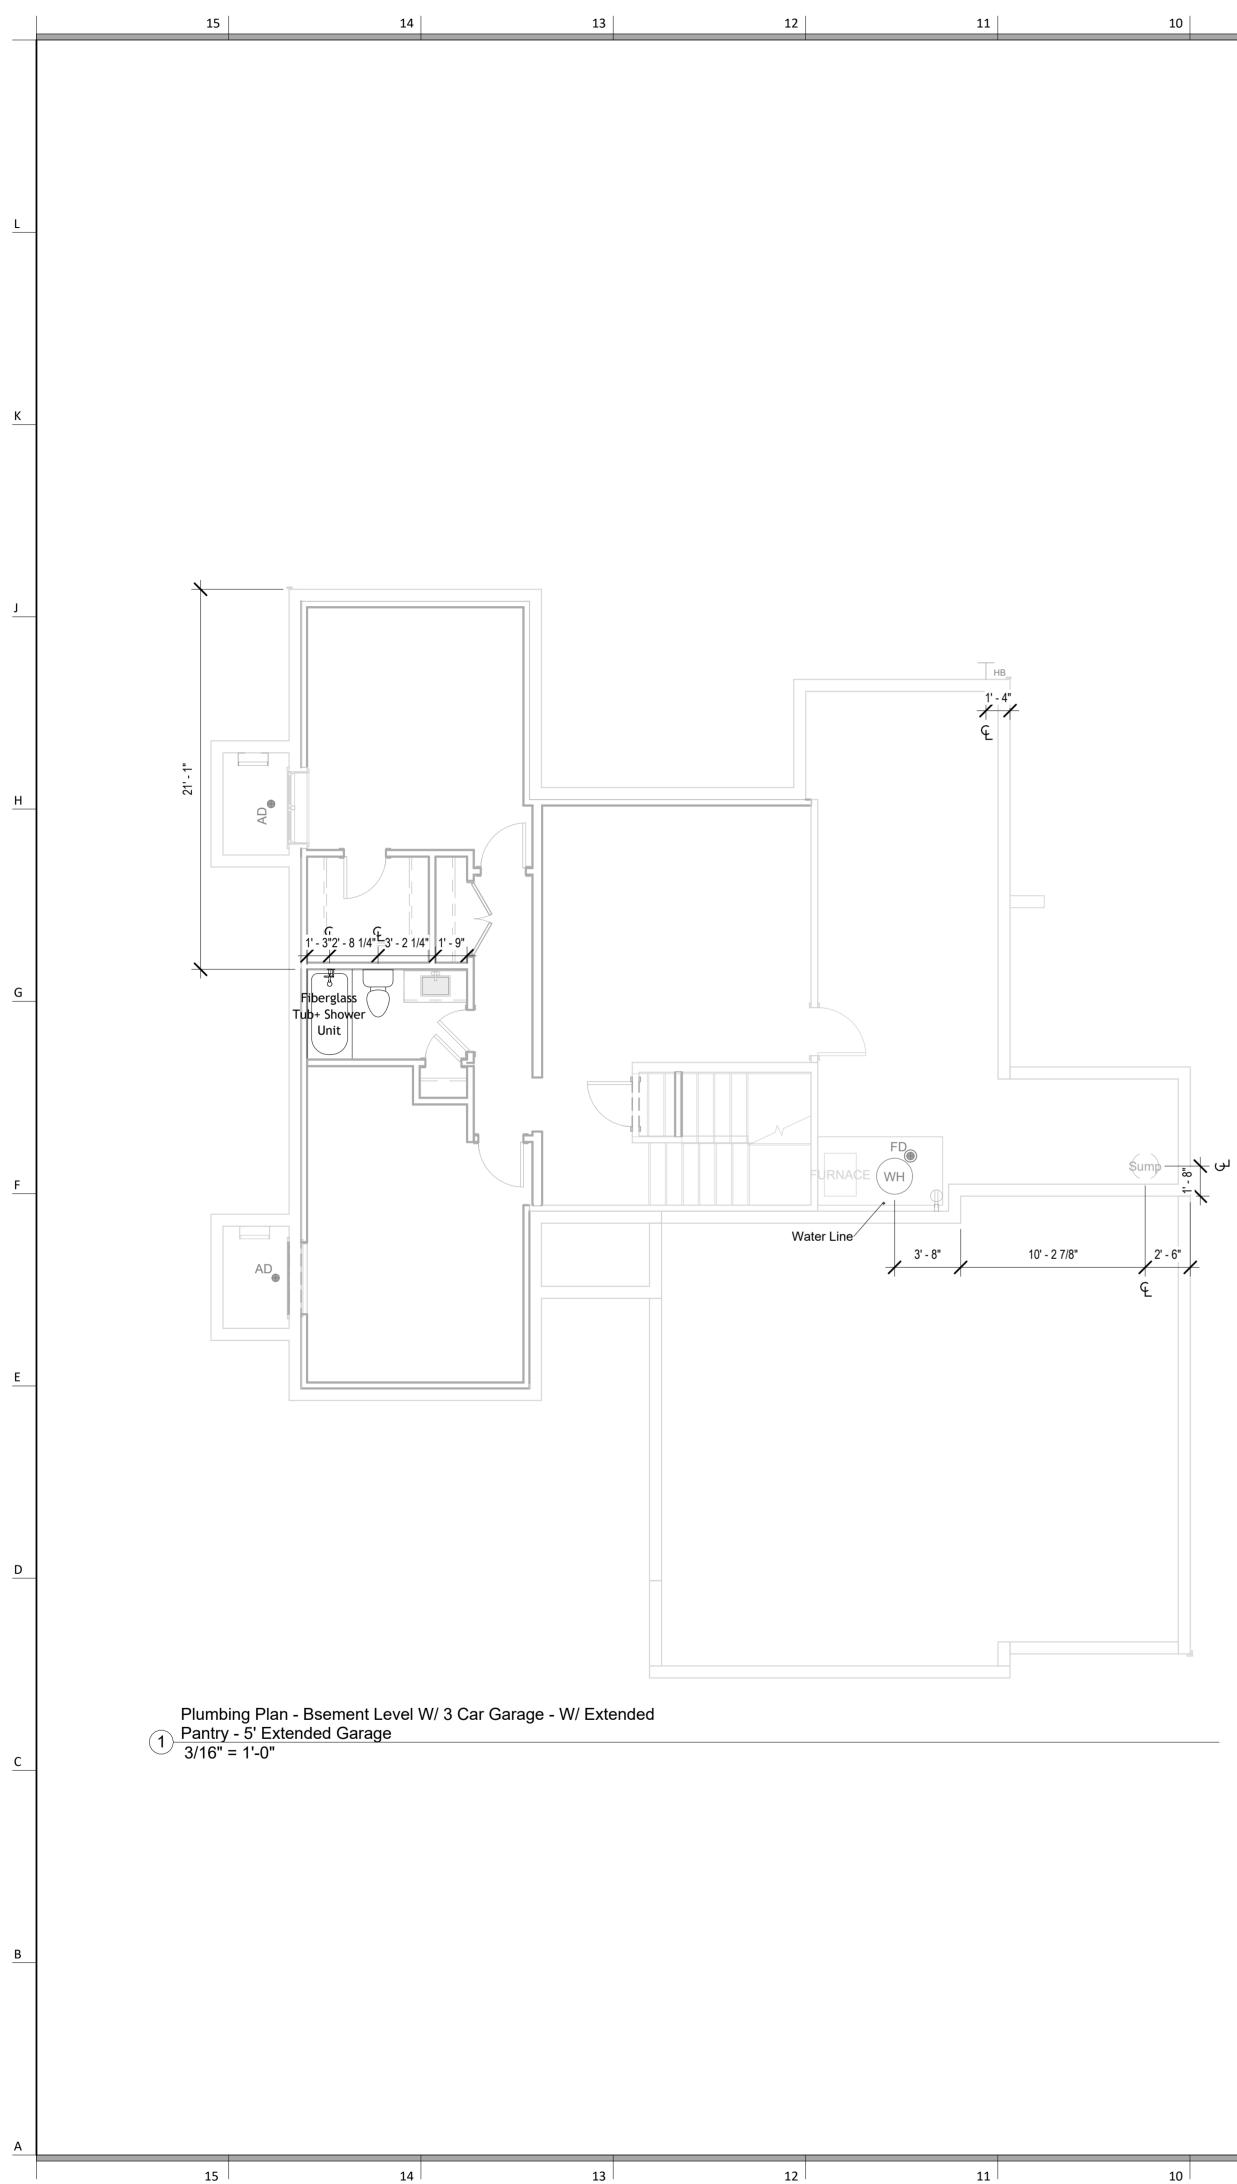


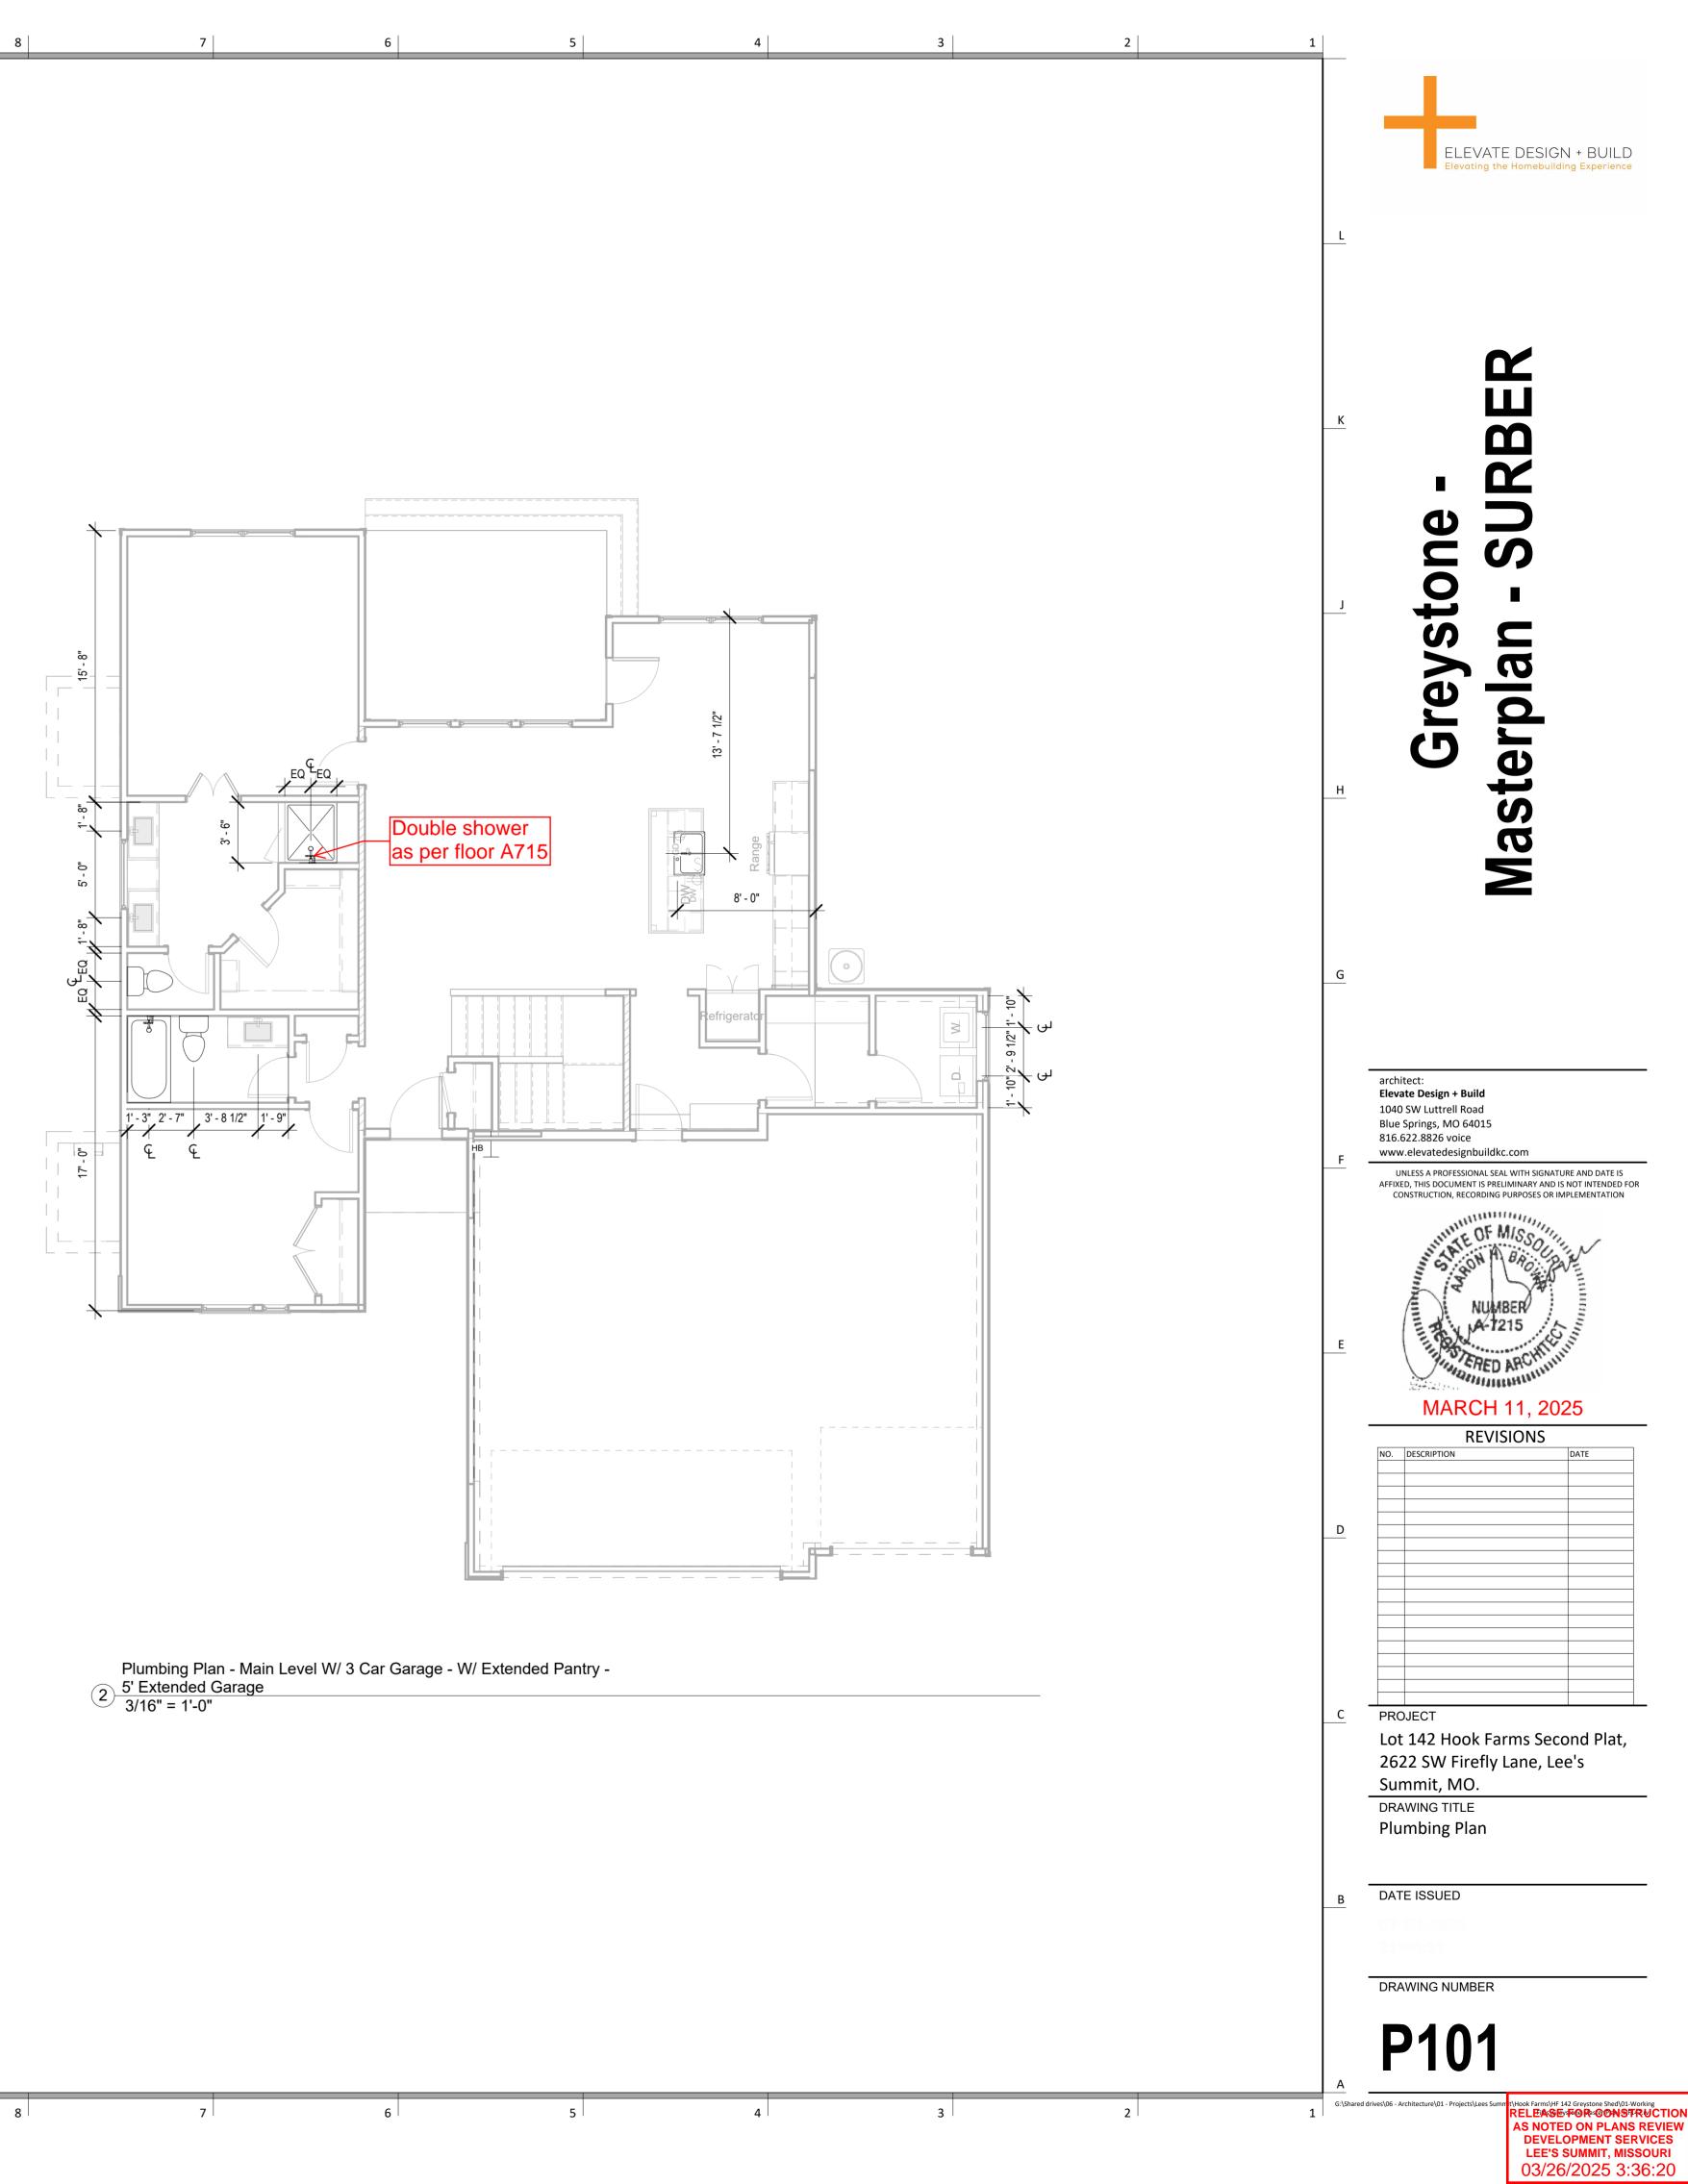
R В **U**R U S **t**0 () Grev Masterpla architect: Elevate Design + Build 1040 SW Luttrell Road Blue Springs, MO 64015 816.622.8826 voice www.elevatedesignbuildkc.com UNLESS A PROFESSIONAL SEAL WITH SIGNATURE AND DATE IS AFFIXED, THIS DOCUMENT IS PRELIMINARY AND IS NOT INTENDED FOR CONSTRUCTION, RECORDING PURPOSES OR IMPLEMENTATION MARCH 11, 2025 REVISIONS NO. DESCRIPTION D PROJECT Lot 142 Hook Farms Second Plat, 2622 SW Firefly Lane, Lee's Summit, MO. DRAWING TITLE RCP/Electrical Plan DATE ISSUED В DRAWING NUMBER E101

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