

BUILDER/CONTRACTOR IS RESPONSIBLE TO
CHECK ALL DIMENSIONS FOR ACCURACY
BETWEEN FLOORS, FOUNDATION, AND ELEVATIONS.
ALSO VERIFY ALL BEAM, HEADERS, PAD LOCATIONS,
AND COLUMN SIZES.

FRONT ELEVATION

1/4" = 1'0"


ALL NOTES, SECTIONS, AND DRAWINGS
ARE IN ACCORDANCE WITH THE 2018 IRC

NOTE:
ACTUAL ELEVATIONS MAY VARY FROM ARCHITECTURAL
DRAWINGS, DUE TO TERRAIN/BACKFILL PROCESS
FRONT ELEVATION IS ARCHITECTURAL DRAWING AND
MAY VARY DUE TO MATERIALS AVAILABILITY

RELEASE FOR CONSTRUCTION
AS NOTED FOR PLAN REVIEW
DEVELOPMENT SERVICES
LEE'S SUMMIT, MISSOURI
02/27/2025


SQUARE FOOTAGE

LIVING AREA
FIRST FLOOR = 1406
BEDROOM #4 = 166
BASEMENT = 797
COVERED REAR PATIO = 172
UNFINISHED AREA
GARAGE = 600
STORAGE = 412
UNDER STOOP = 40

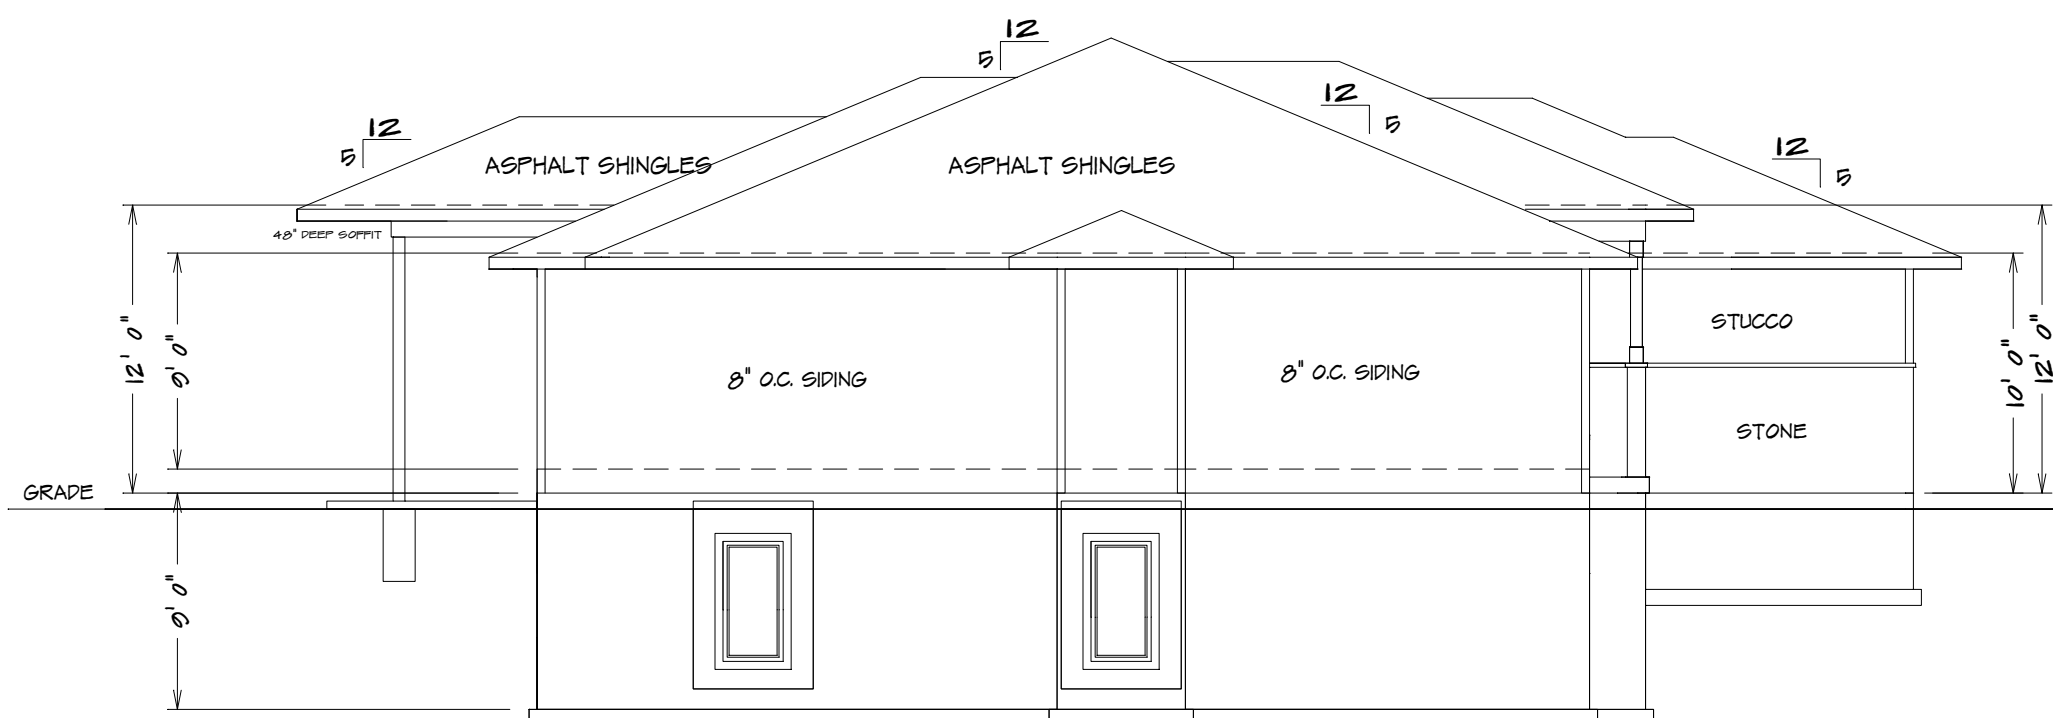


LEFT ELEVATION

1/8" = 1'0"

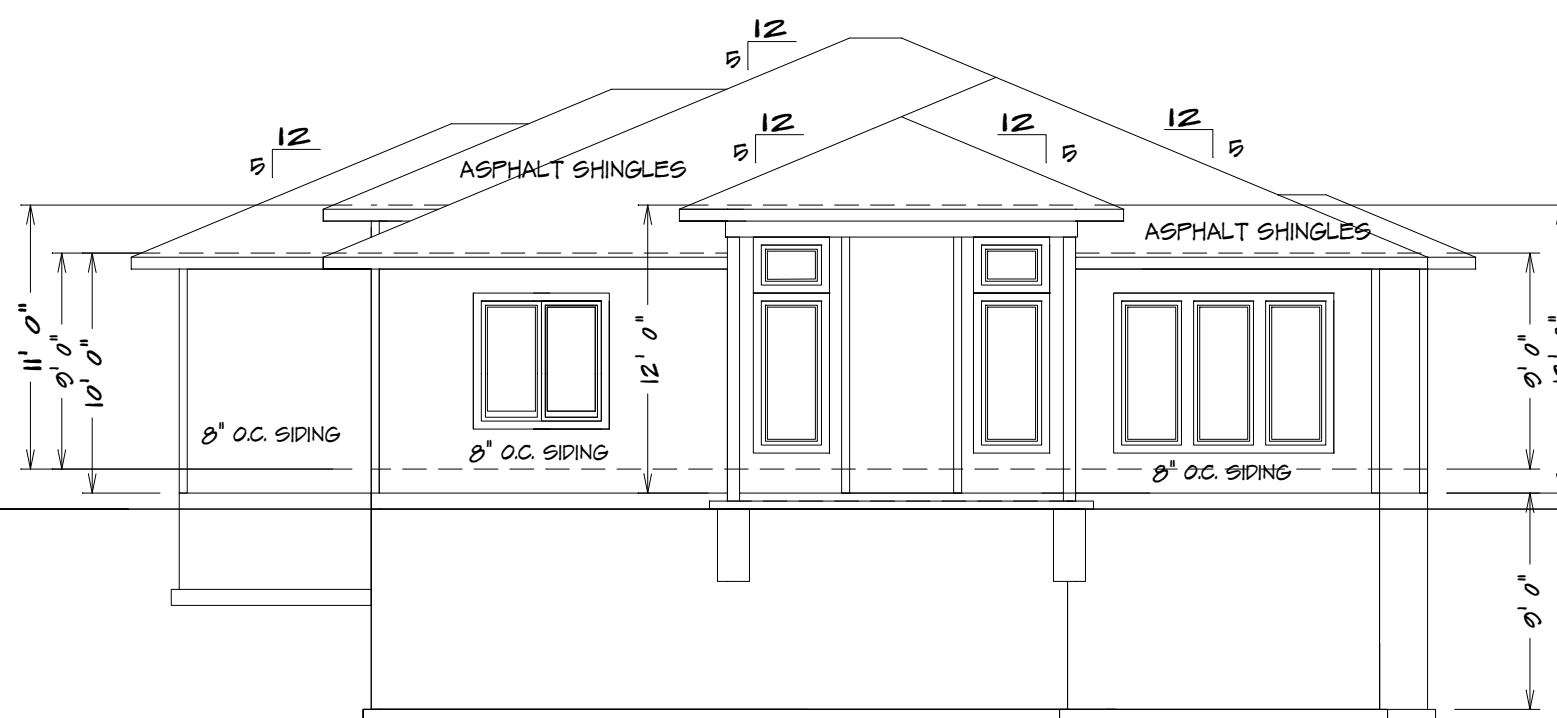

REAR ELEVATION

1/8" = 1'0"

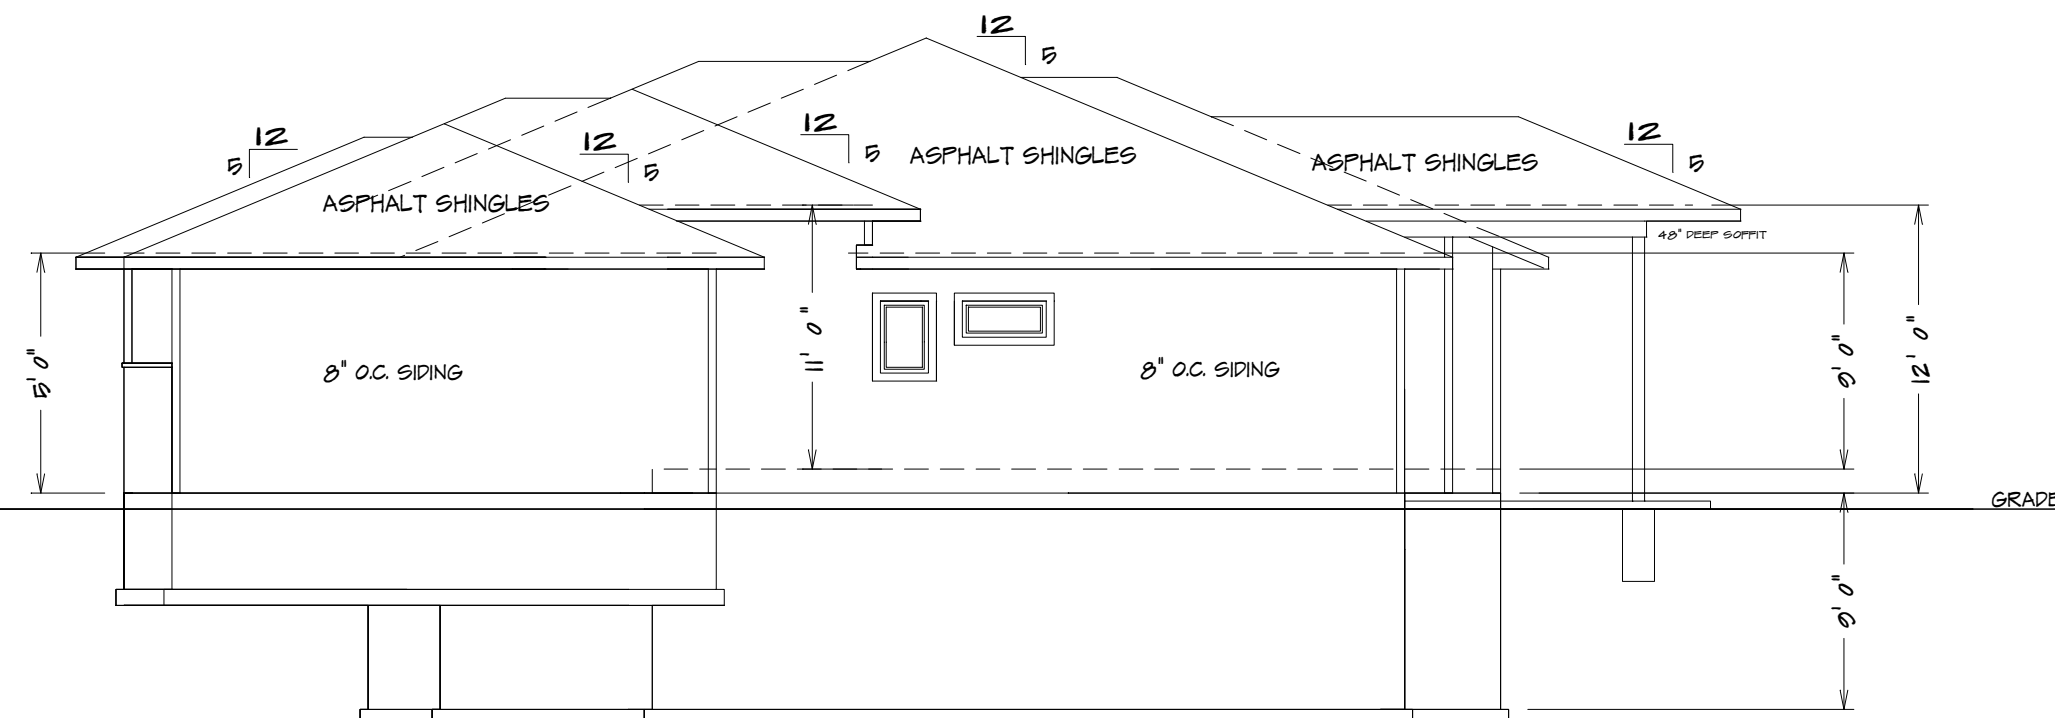

RIGHT ELEVATION

1/8" = 1'0"

STRUCTURAL MEMBER REVIEW AND CERTIFICATION:



ENGINEERING, P.C.
CIVIL ENGINEERING CONSULTANTS
1824 WATERS ROAD, HARRISONVILLE, MISSOURI 64701
PH: (816) 380-5150 FAX: (816) 884-3250 EMAIL: MAIL@RECEENGINEERING.COM
MO. CERTIFICATE OF AUTHORITY #3002002197

AARON D. OBERMILLER, P.E.
MISSOURI PROFESSIONAL ENGINEER
CERTIFICATION IS PROVIDED HEREON FOR STRUCTURAL ITEMS NOT OTHERWISE ADDRESSED IN THE REQUIREMENTS OF THE 2018
INTERNATIONAL RESIDENTIAL CODE. ALL CONSTRUCTION, MATERIALS, FASTENING NOT SPECIFICALLY DENOTED SHALL COMPLY
WITH THE REQUIREMENTS OF THE 2018 IRC AND THEREIN REFERENCED STANDARDS. ANY REQUIRED CLARIFICATIONS OR
MODIFICATIONS TO STRUCTURAL ITEMS SHALL BE APPROVED BY THE ENGINEER OF RECORD OR OTHER LICENSED PROFESSIONAL
CAPABLE OF CERTIFYING COMPLIANCE WITH THE MINIMUM STANDARDS OF THE APPLICABLE CODE. ENGINEER SHALL NOT BE HELD
RESPONSIBLE FOR DRAWING ERRORS AND OMISSIONS IN PLAN OR ELEVATION OF PROVIDED PLANS.

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TO STRUCTURE.



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DESIGNER:

PROJECT ADDRESS:
LOT 188 NAPA VALLEY
3932 SW FLINTROCK RD
LEES SUMMIT MO.




PLAN NO.:

KH-6114-G

FILE NAME:

6114 ELEV

SHEET NO. :

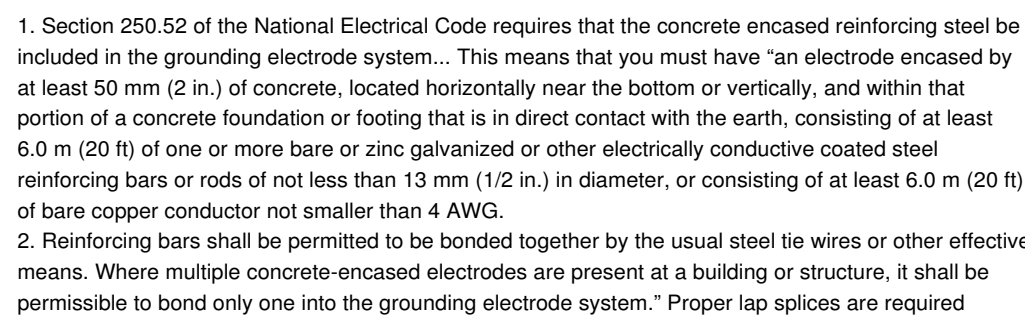


STEEL COLUMNS TO BE
3" DIAMETER SCHEDULE 40 PIPE MANUFACTURED
IN ACCORDANCE WITH ASTM A53 GRADE B OR
APPROVED EQUIVALENT UNLESS NOTED

CONCRETE SUPPORT PADS TO BE
42" X 42" X 12" CONCRETE PADS WITH (6)
#4 REBARS EACH WAY (UNLESS NOTED)

REQUIRED FOOTING:			
BUILDING HEIGHT	MINIMUM FOOTING	HORIZONTAL REBAR	LOCATION OF REBAR
1 OR 2 STY.	8" x 16" W	2-#4	3" FROM BTM.
3 STORY	8" x 24" W	2-#4	3" FROM BTM.
ACC. STR.	8" x 12" W	2-#4	3" FROM BTM.

FOOTING FOR 12" THICK WALL TO BE
DESIGNED BY OTHERS

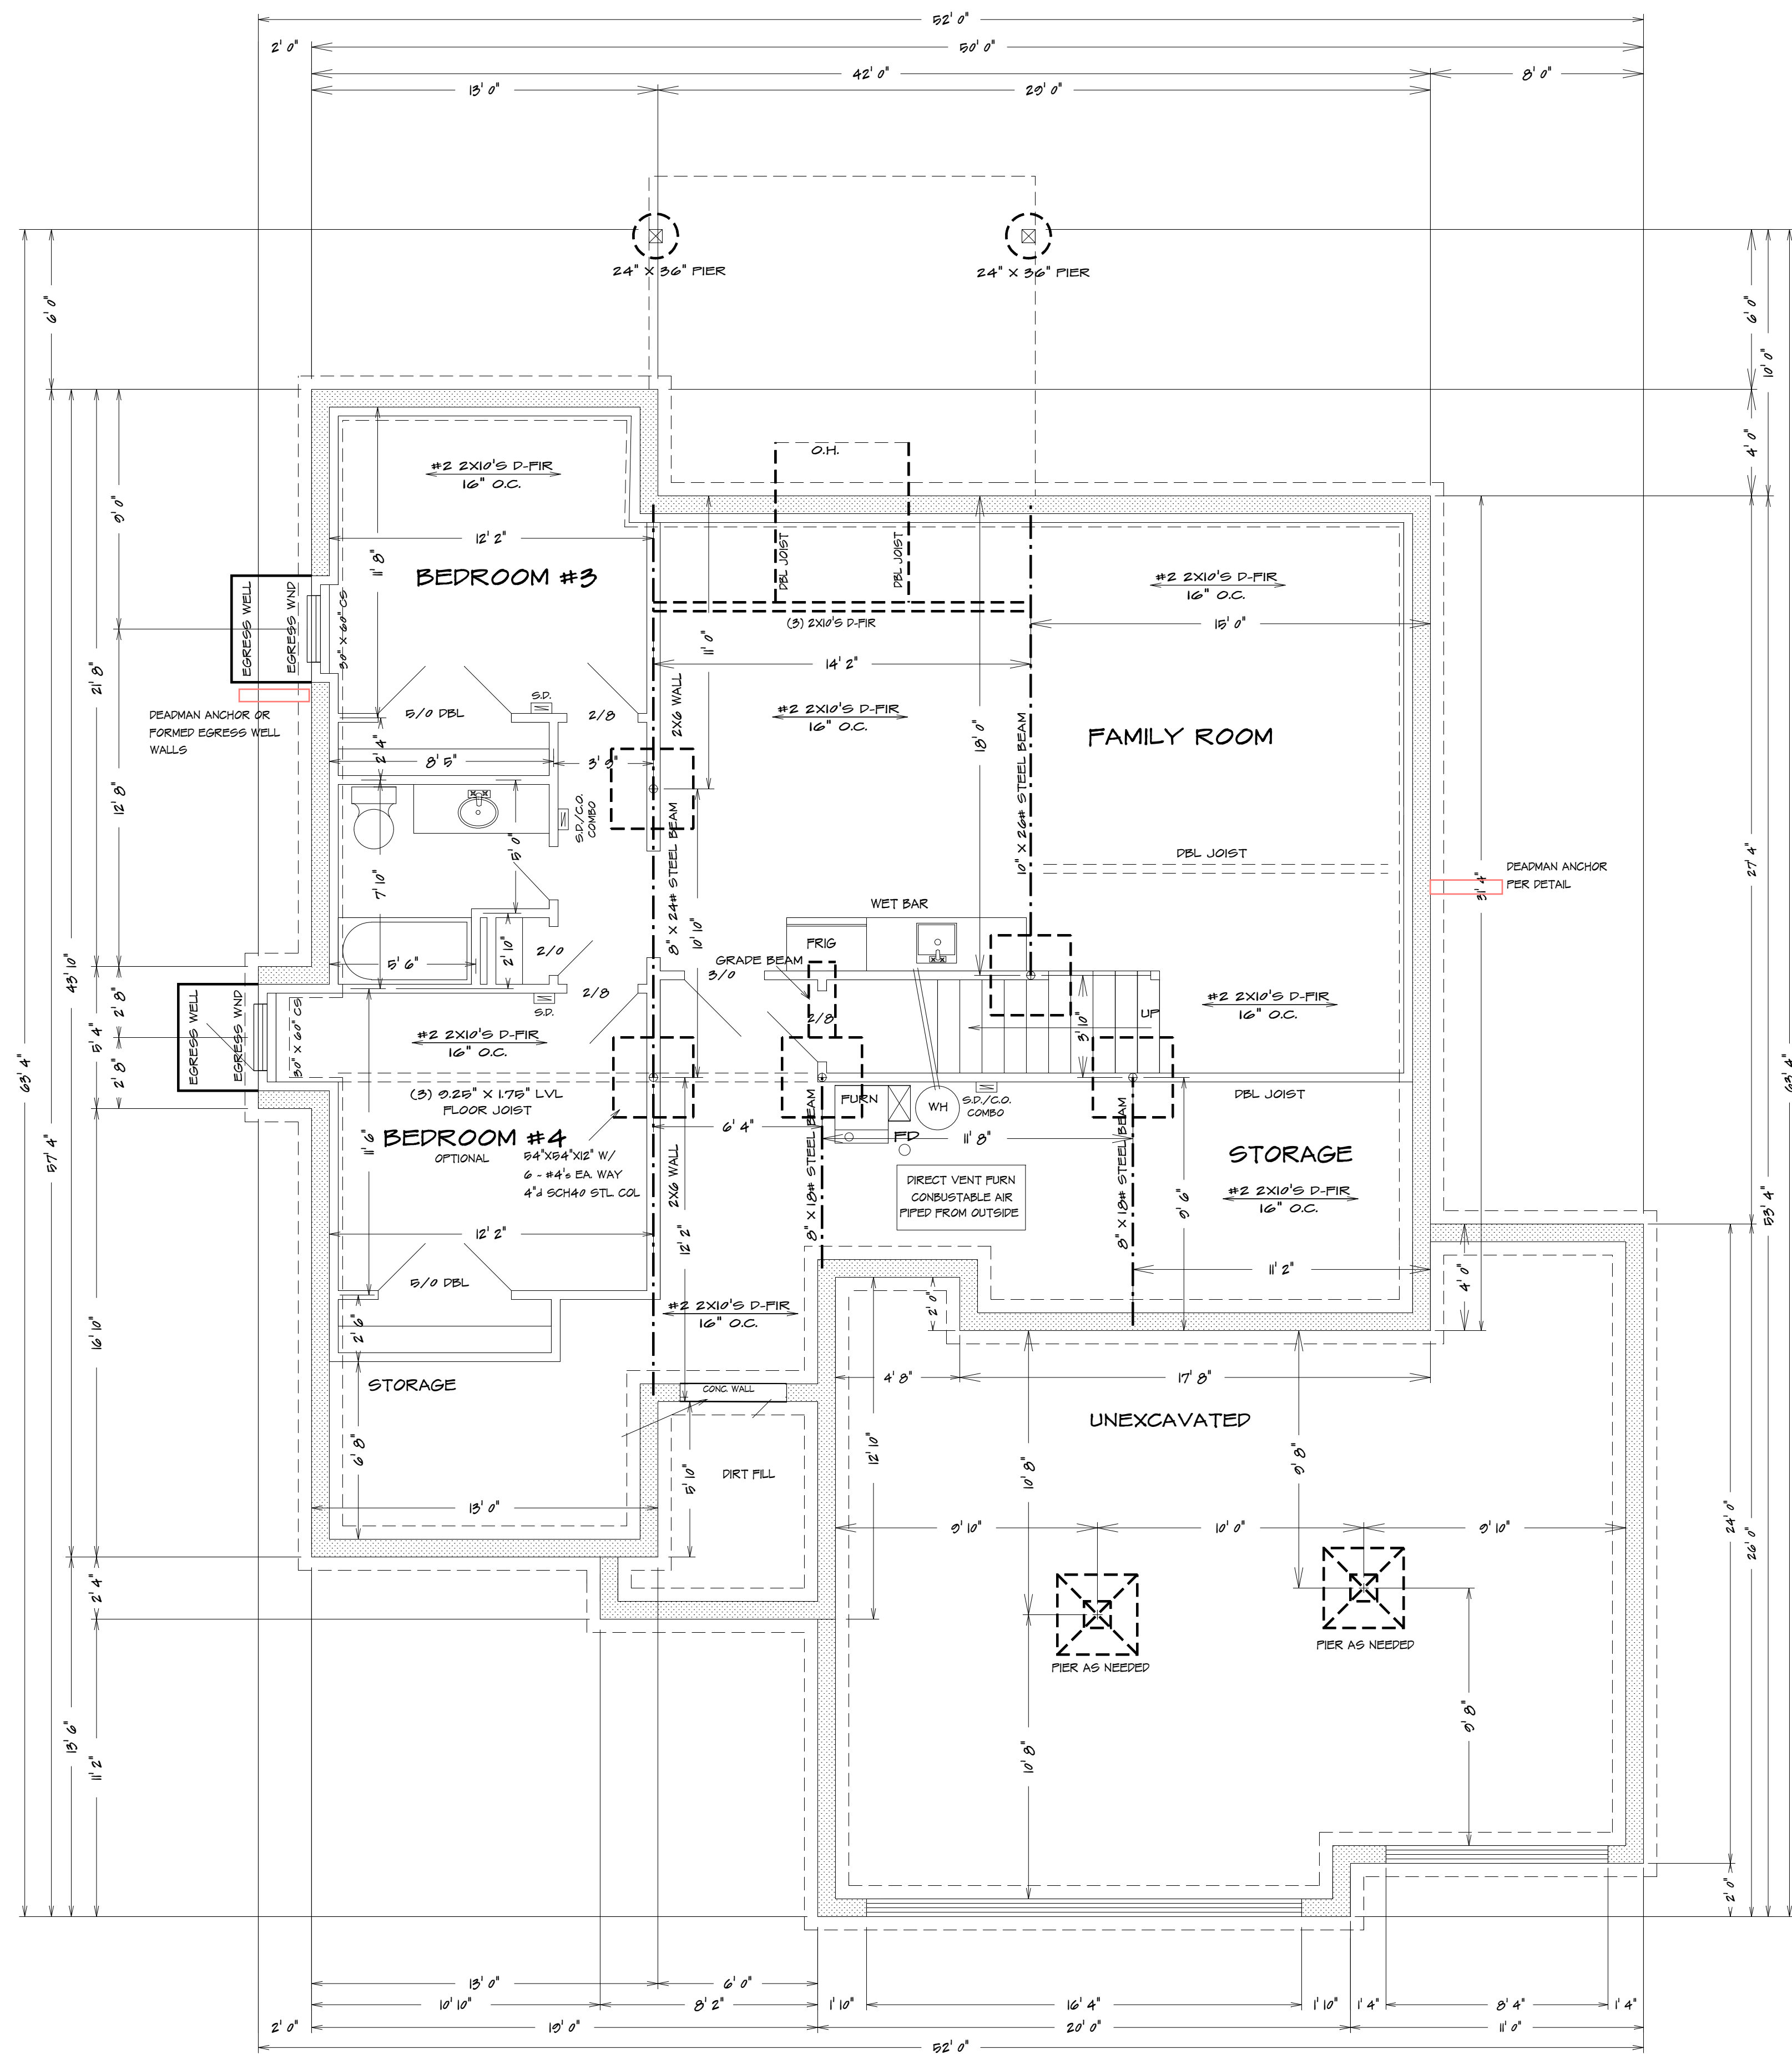

BASEMENT PLAN

$$1/4'' = 1'0''$$

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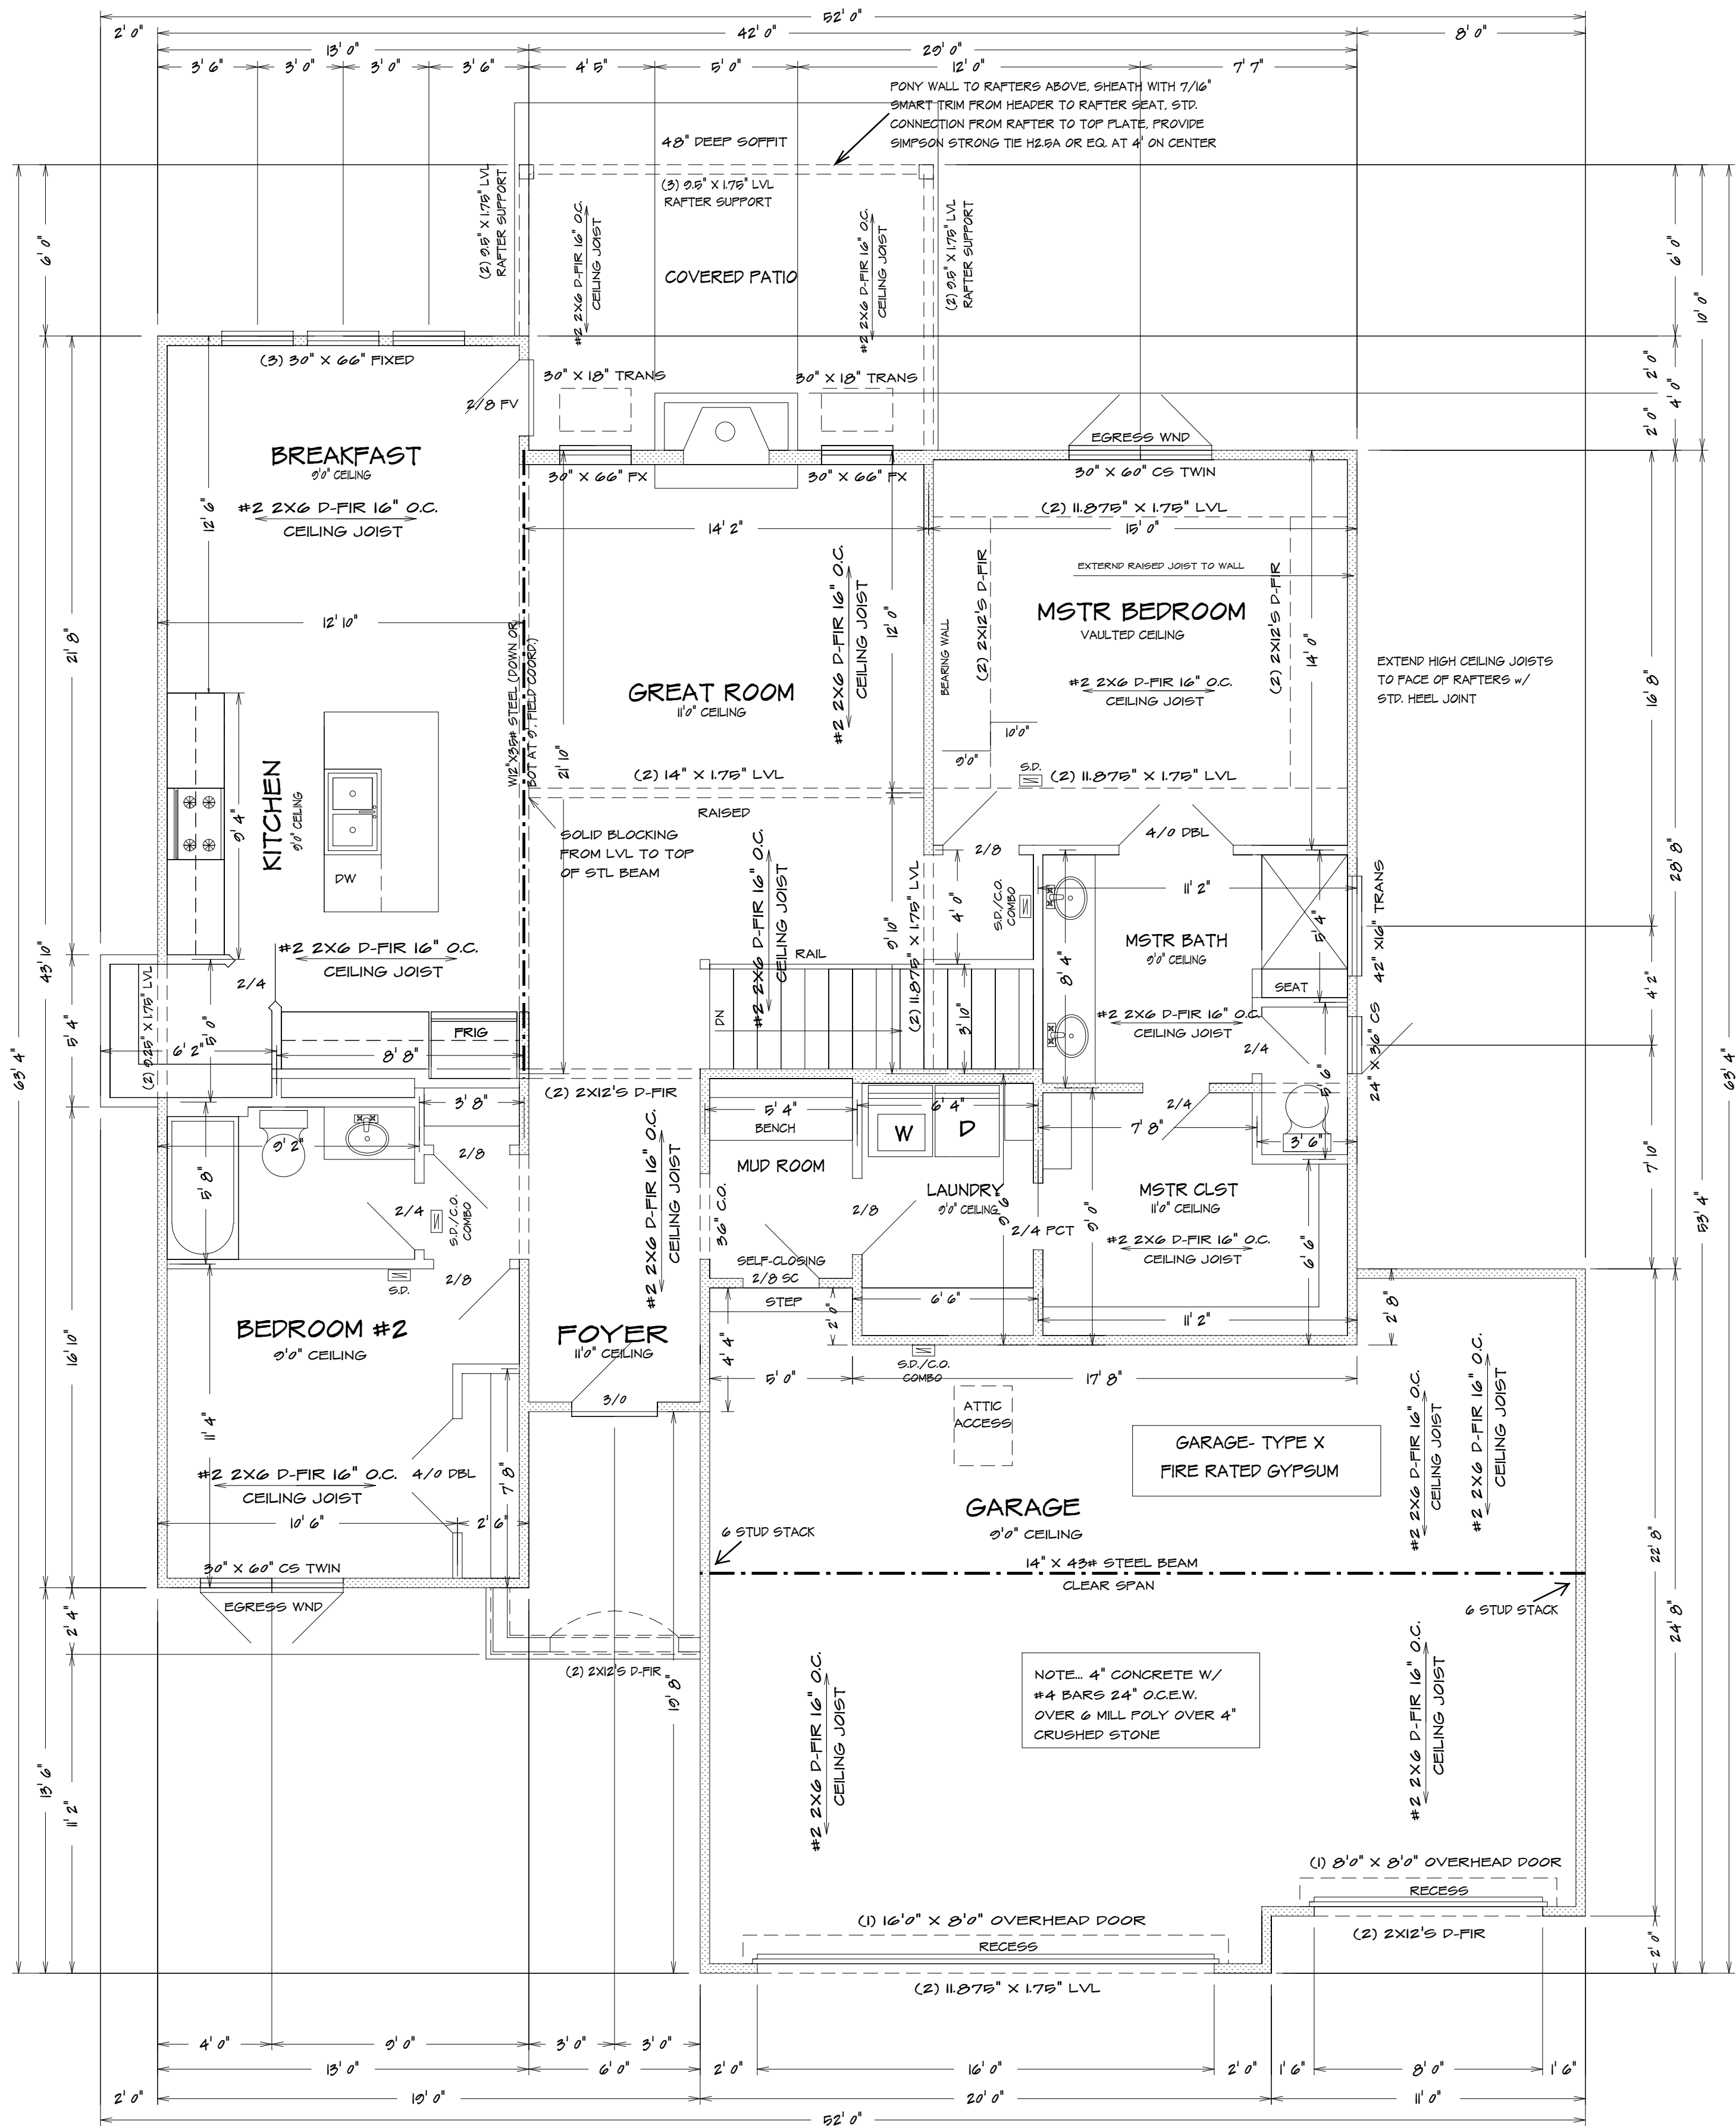
KH-6114-G

FILE NAME:

6114 BSMT

SHEET NO. :

2



ALL NOTES, SECTIONS, AND DRAWINGS
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BEARING WALL

FIRST FLOOR PLAN
1/4" = 1'0"

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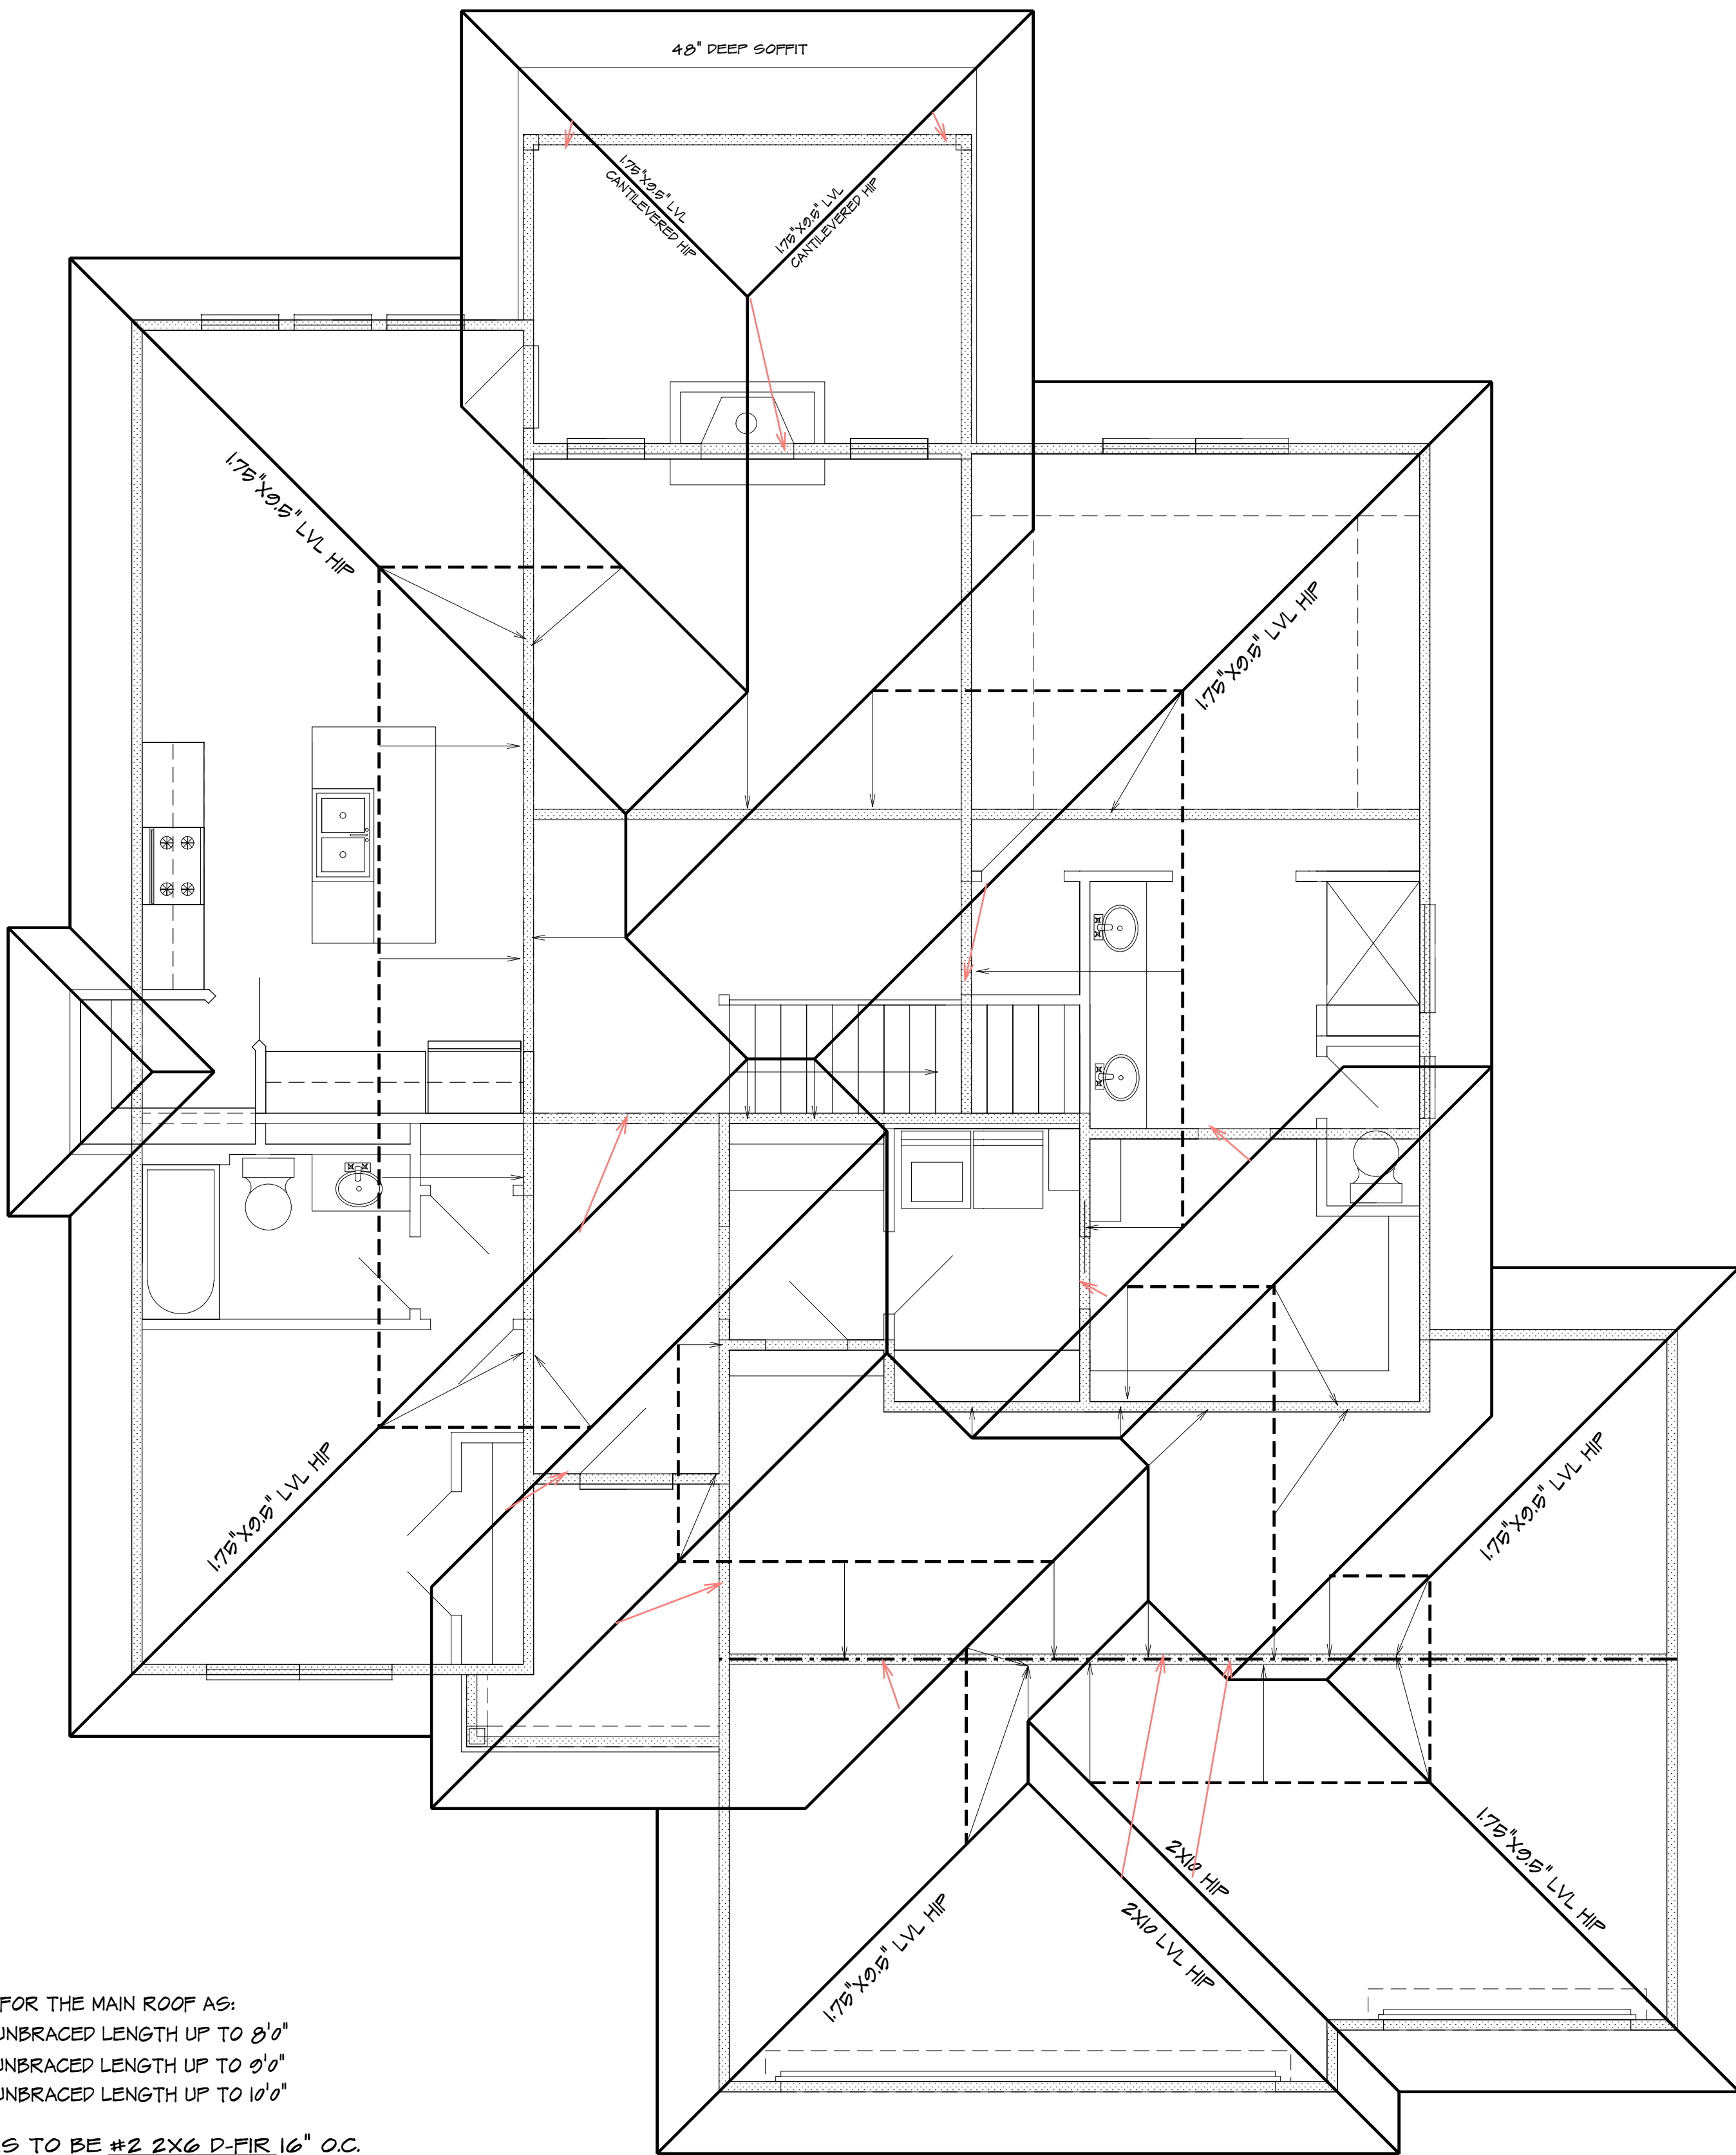
6114 FLR1

SHEET NO. :

3

STATE OF MISSOURI
ARON DELANEY
Professional Engineer
License No. 13246-25
Mechanical Engineering

RELEASE FOR CONSTRUCTION
AS NOTED FOR PLAN REVIEW
DEVELOPMENT SERVICES
LEE'S SUMMIT, MISSOURI
02/27/2025



NOTE... HIP RIDGE FOR THE MAIN ROOF AS:
2X8 FOR UNBRACED LENGTH UP TO 8'0"
2X10 FOR UNBRACED LENGTH UP TO 9'0"
2X12 FOR UNBRACED LENGTH UP TO 10'0"

ALL RAFTERS TO BE #2 2X6 D-FIR 16" O.C.
UNLESS OTHER WISE NOTED
PURLING RAFTERS TO BEARING WALL LINES
CONNECT RAFTERS TO CEILING JOIST W (4) 16d GALV. NAILS
CONNECT RAFTERS TO RIDGE, VALLEY, AND HIP RIDGE
WITH (4) 16d GALV. NAILS
VERT. RIDGE AND RAFTER SUPPORTS TO BE EQUAL TO OR GREATER
THAN THE DEPTH OF RAFTERS

BEARING WALL LINES

**COMPOSITE ROOF
ROOF ELEVATION**
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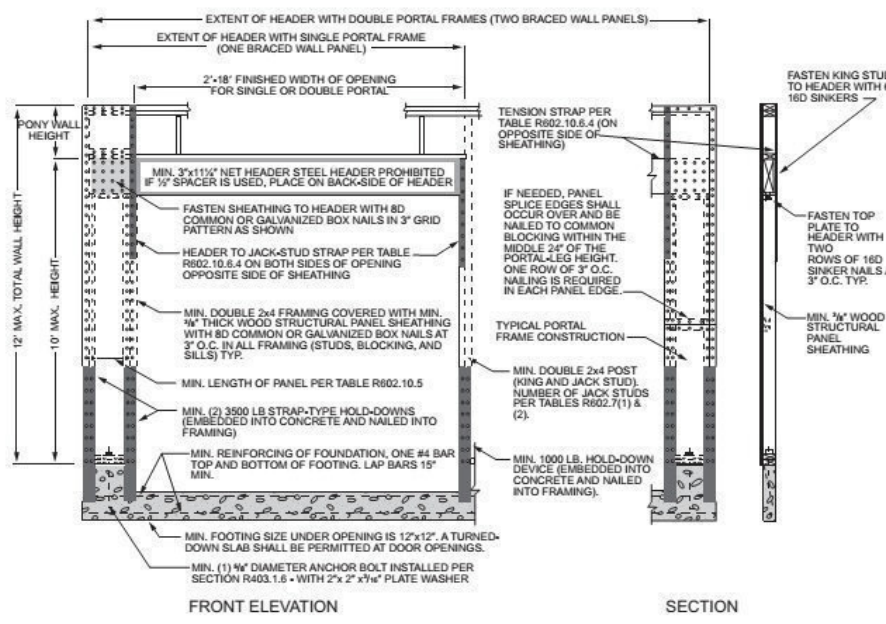
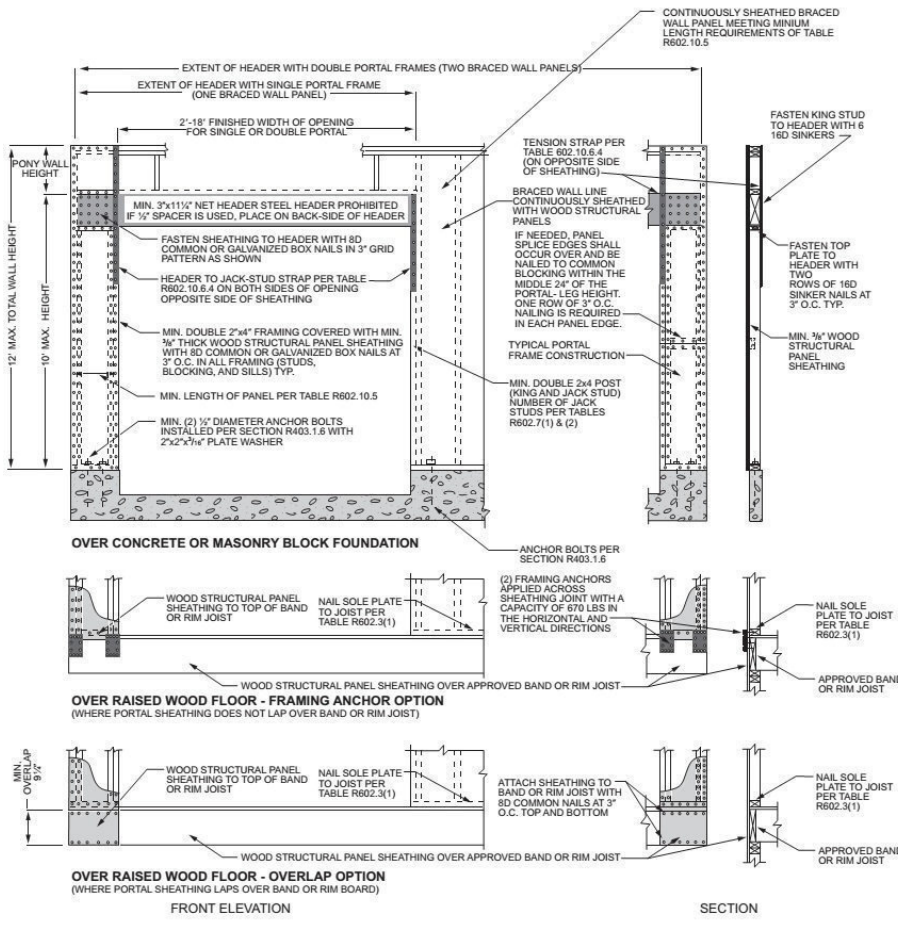
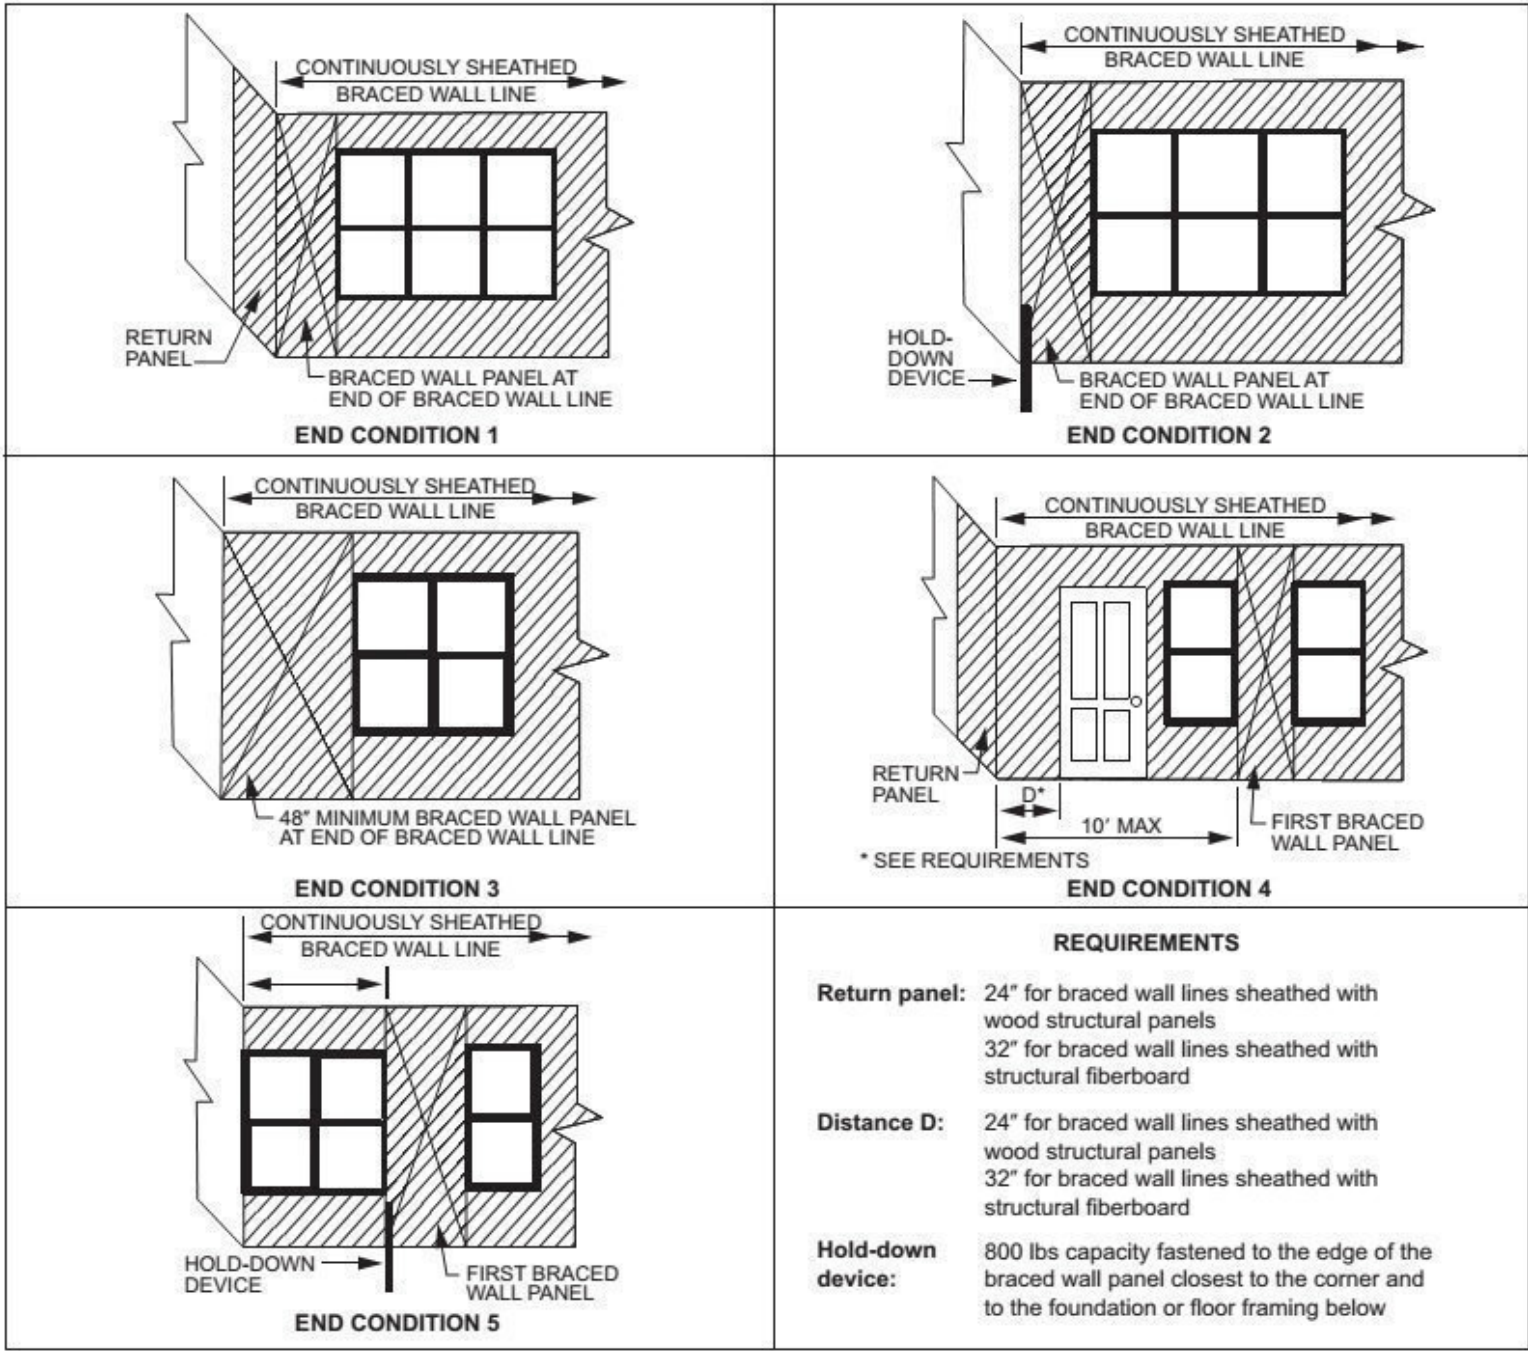
PLAN NO.:
KH-6114-G

FILE NAME:
6114 ROOF

SHEET NO. :

4






ALTERNATE BRACED WALL PANEL
Method PPH: Portal frame with hold-downs

ALTERNATE BRACED WALL PANEL
Method CS-PP: Continuously sheathed portal frame

BRACED WALLS:

- ***** METHOD WSP OR LB (2x8 IRC):
MIN 8/16\"/>

BRACED WALL LINES				
WALL	SPACING	TYPE	REQ'D	PROVIDED
1	11' 6"	WSP	6' 6"	16' 0"
2	25' 0"	WSP/SB	0' 6"	16' 0"
3	11' 6"	WSP	6' 6"	16' 0"
A	16' 0"	WSP/CS-WSP	6' 6"	12' 0"
B	20' 0"	WSP/LB/SB	0' 6"	16' 0"
C	11' 6"	PPH	4' 0"	7' 0"

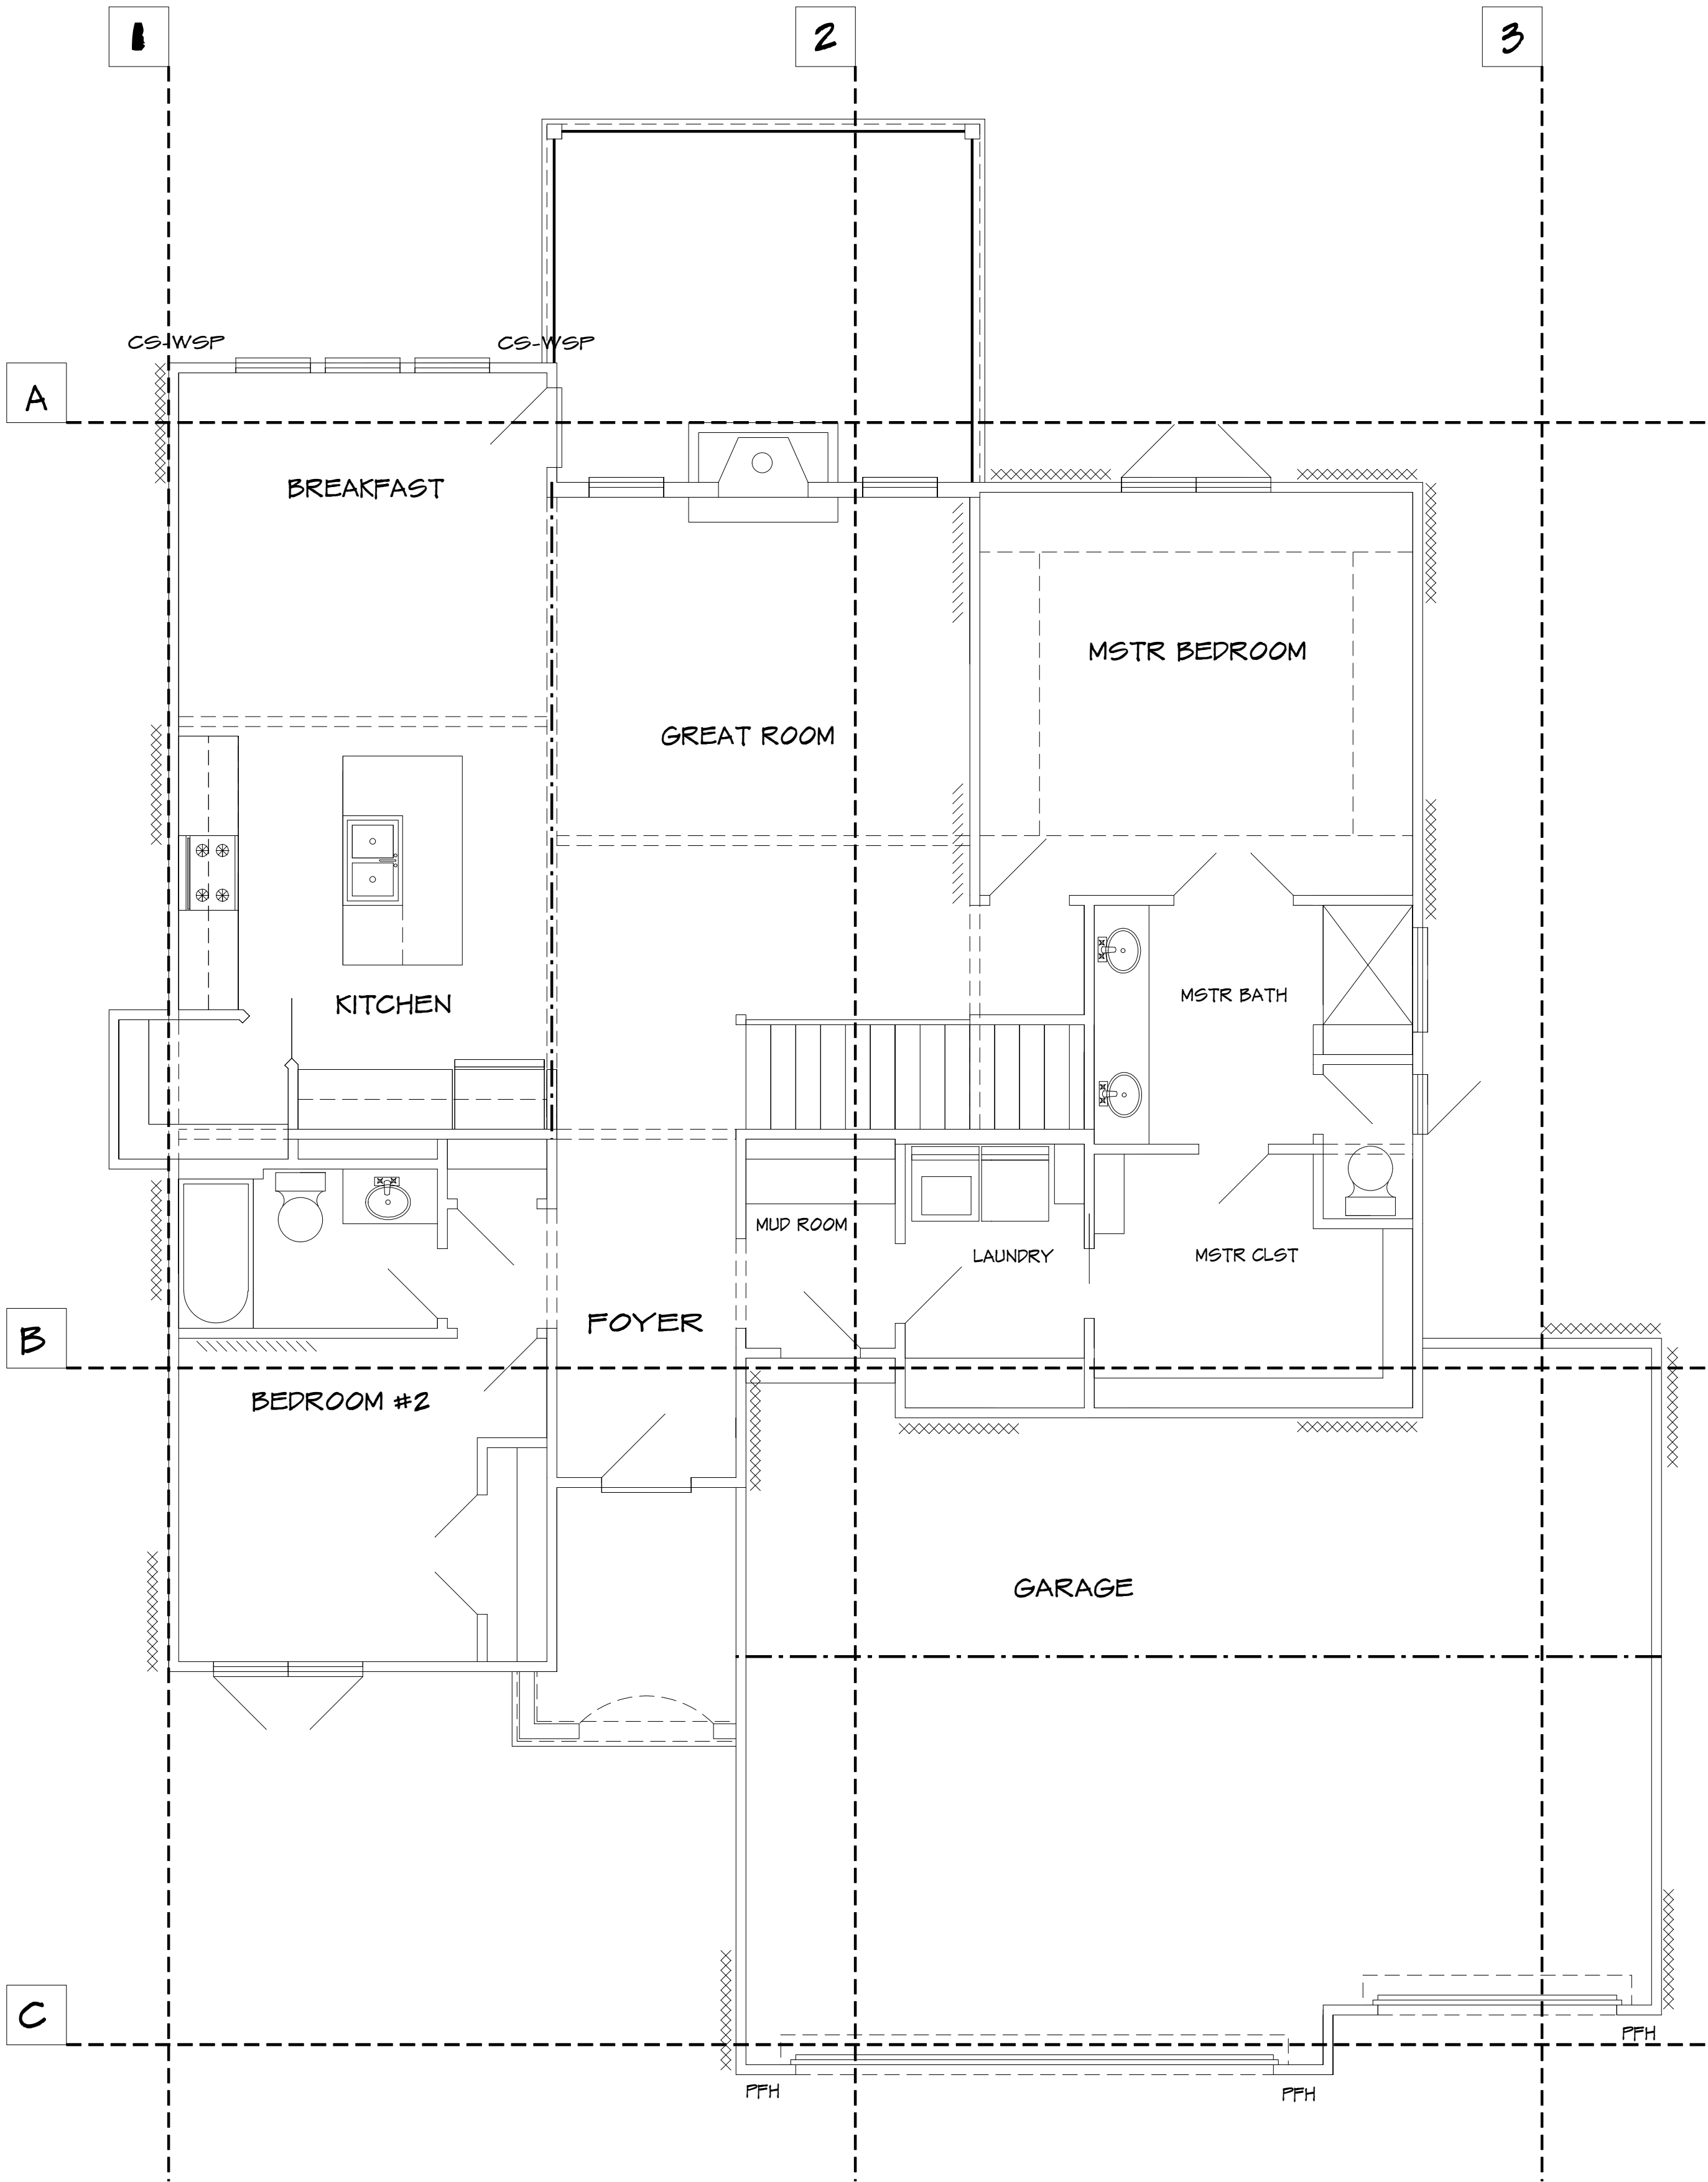

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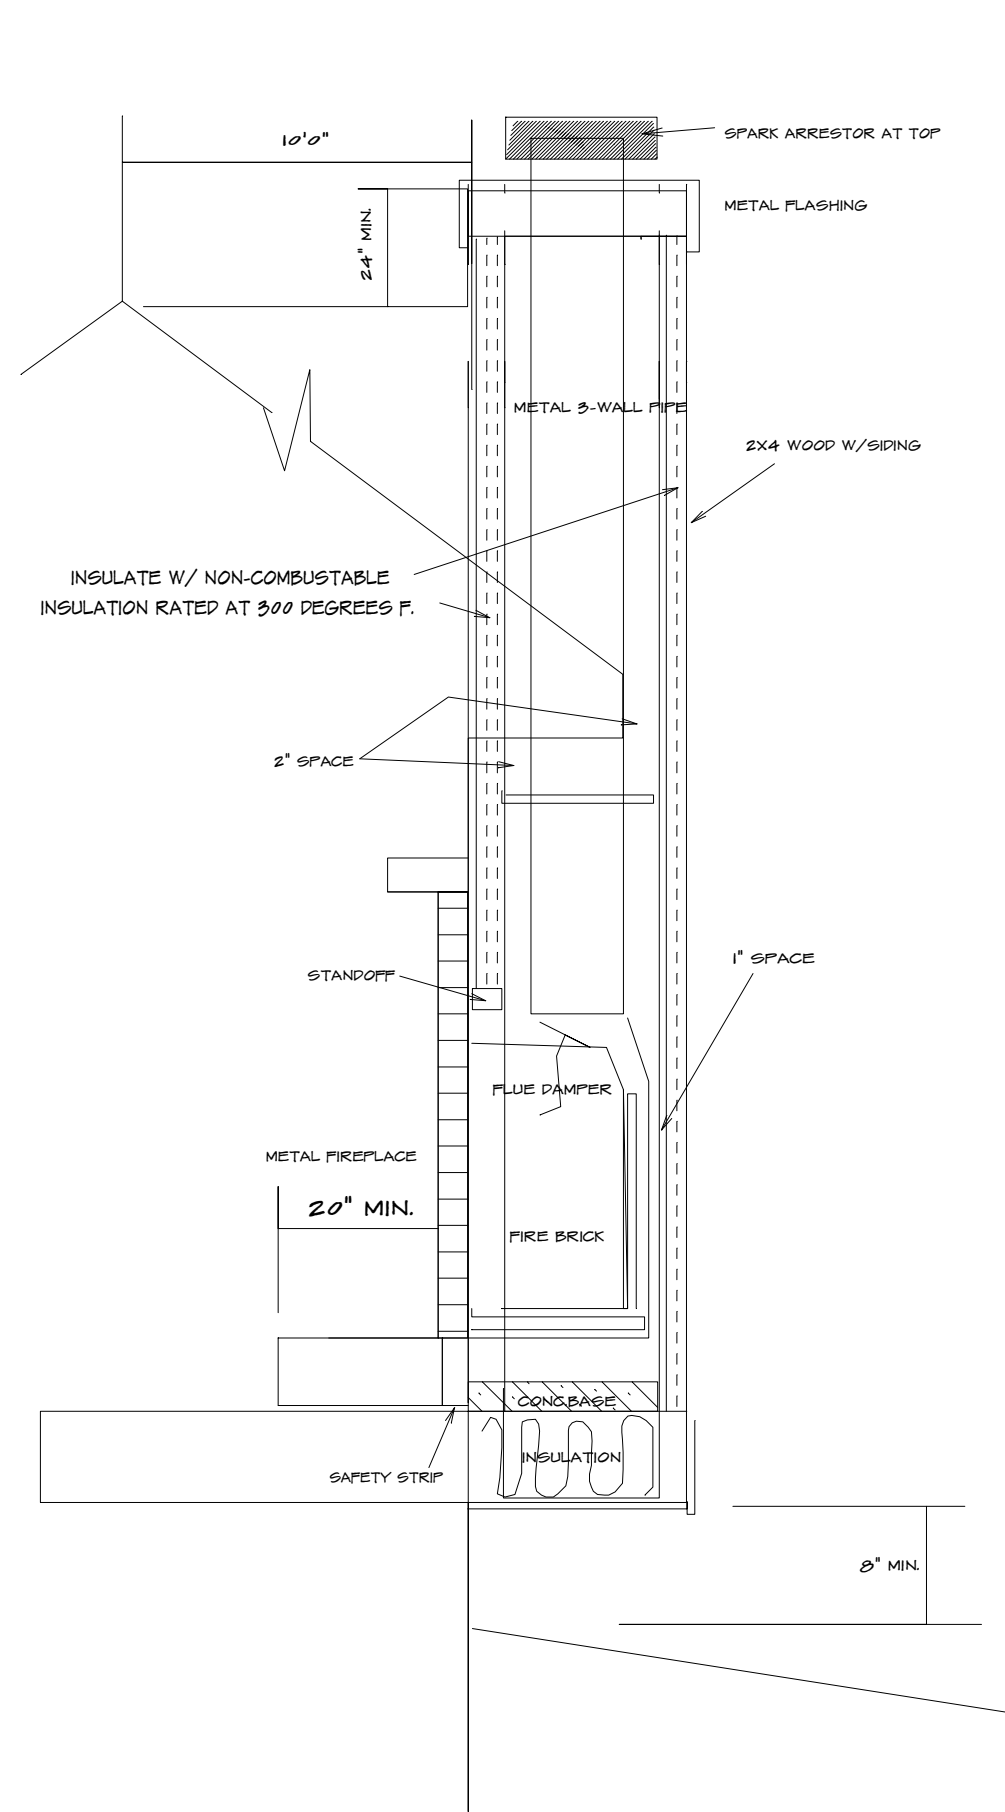
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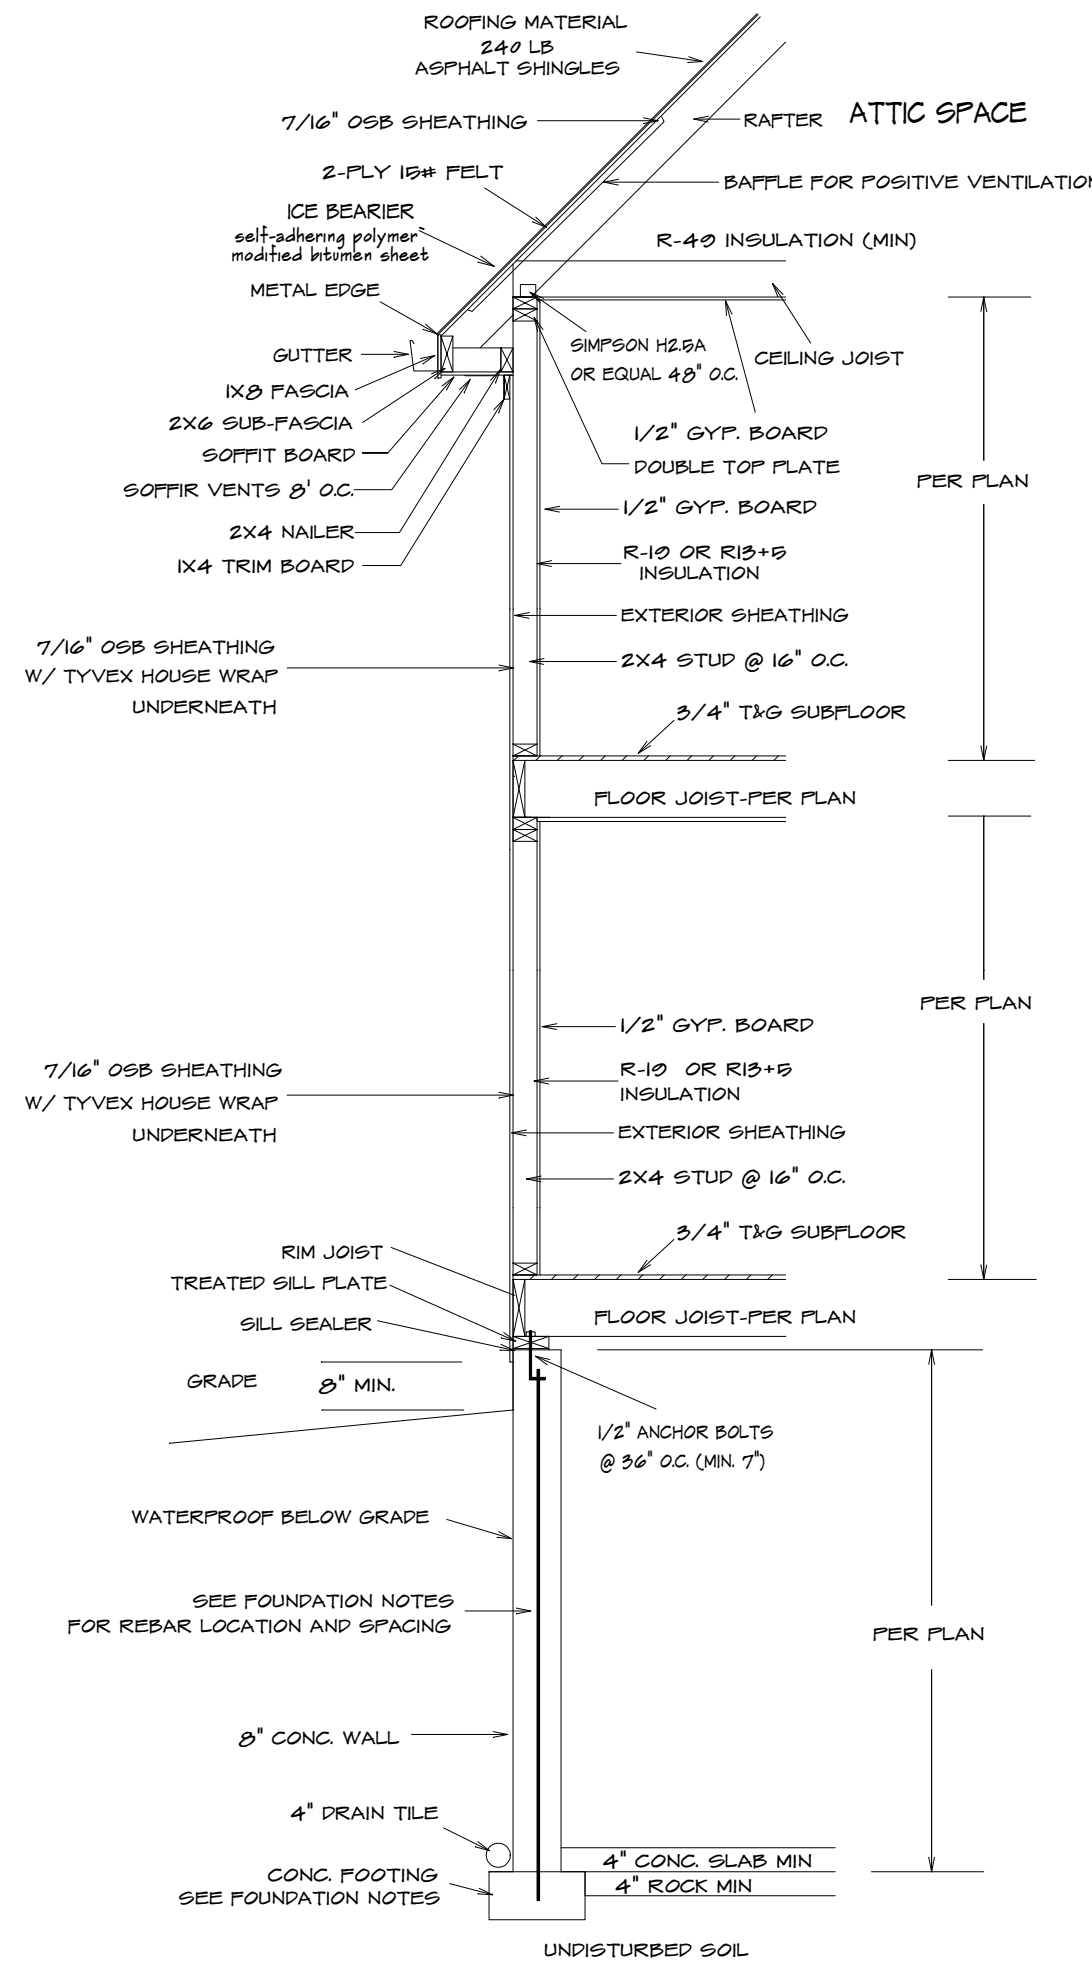
6114 WBS

SHEET NO. :




TYPICAL METAL FIRE PLACE


NOTE:SEE SPECS FOR SPECIFIC APPLICATIONS.




TYPICAL WALL SECTION

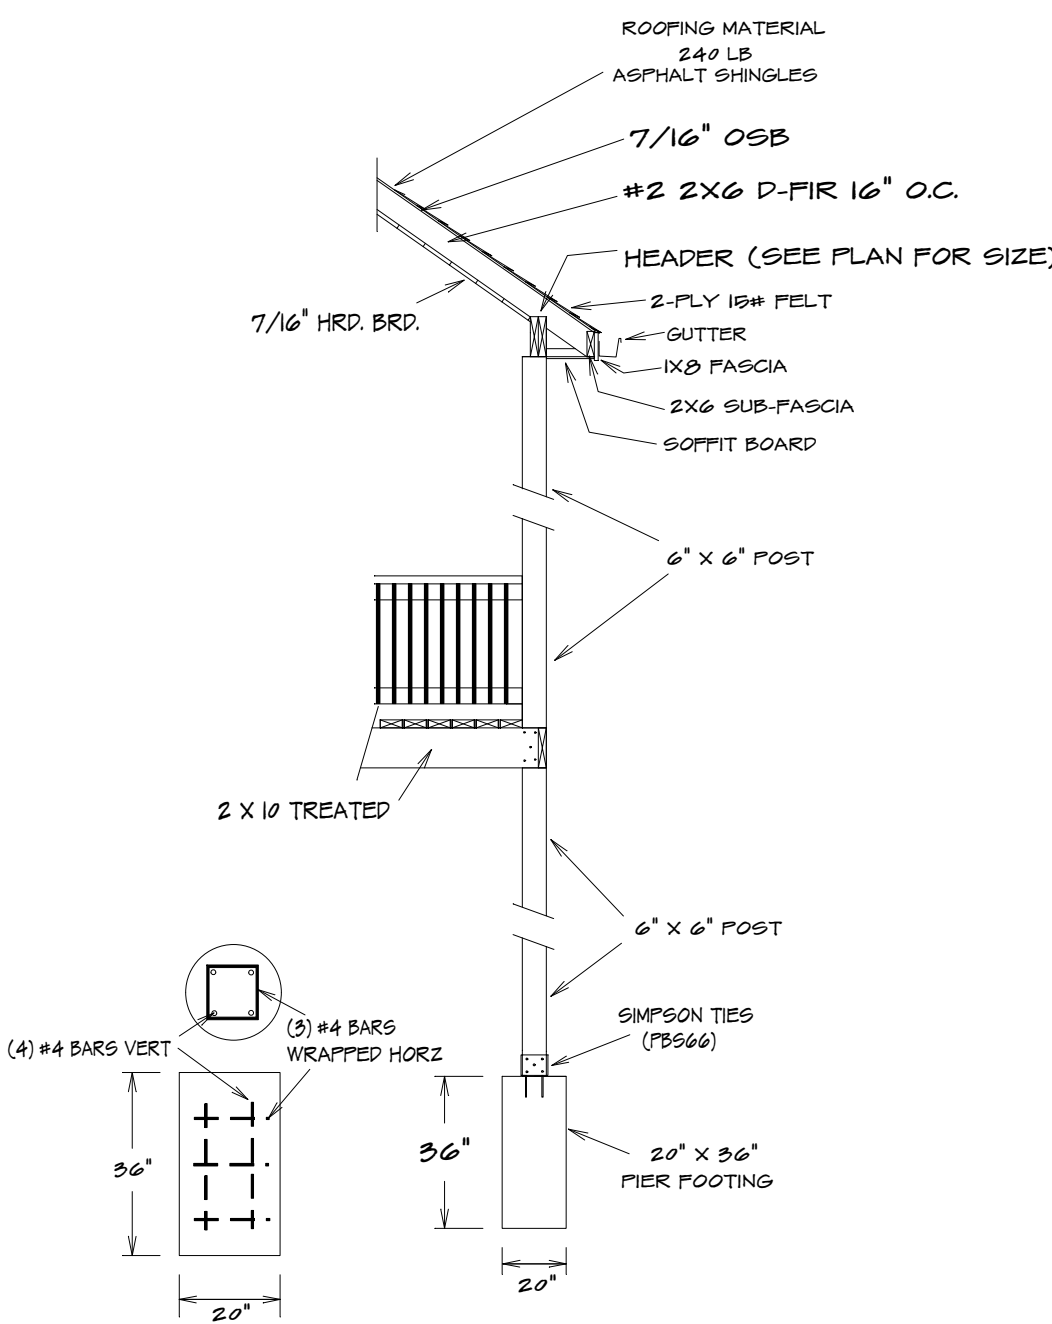


DECK SECTION

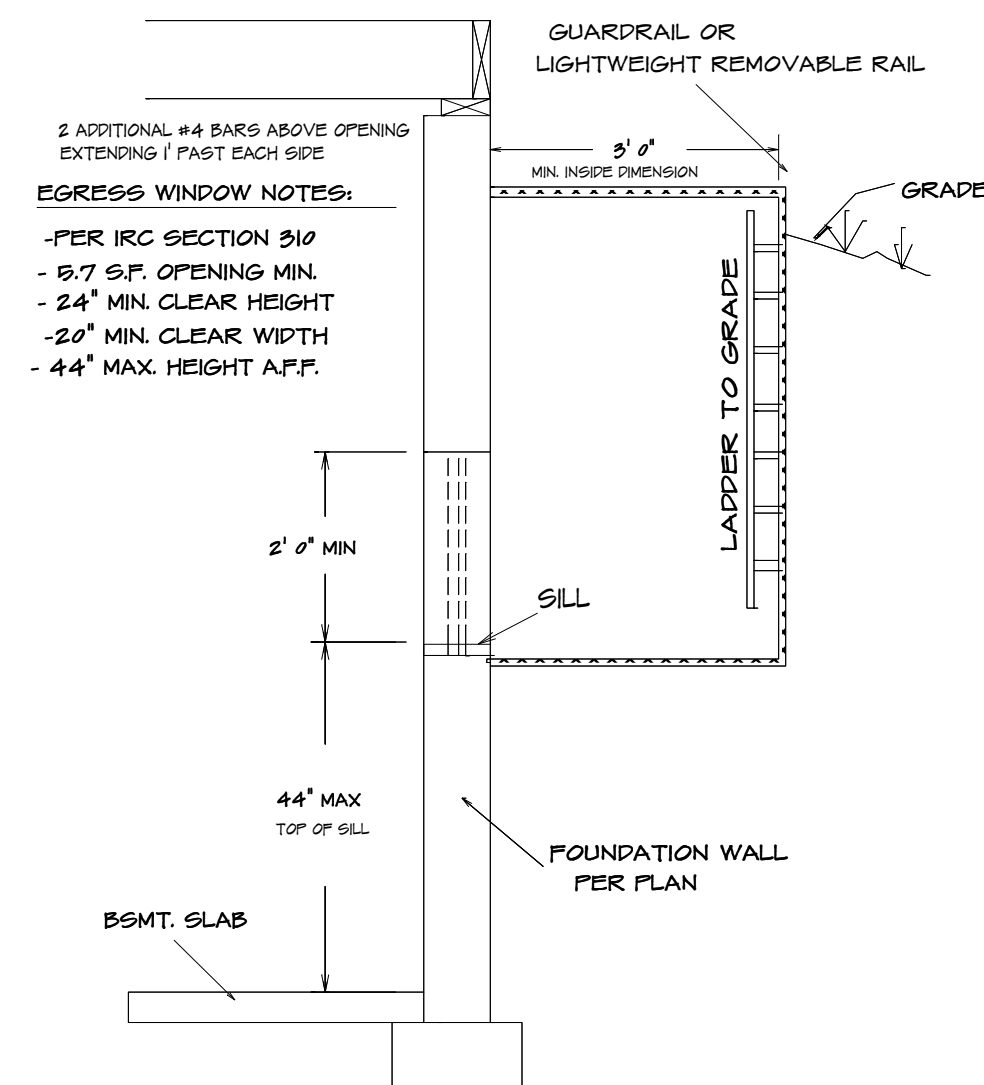


TYPICAL EGRESS WINDOW SECTION DETAIL

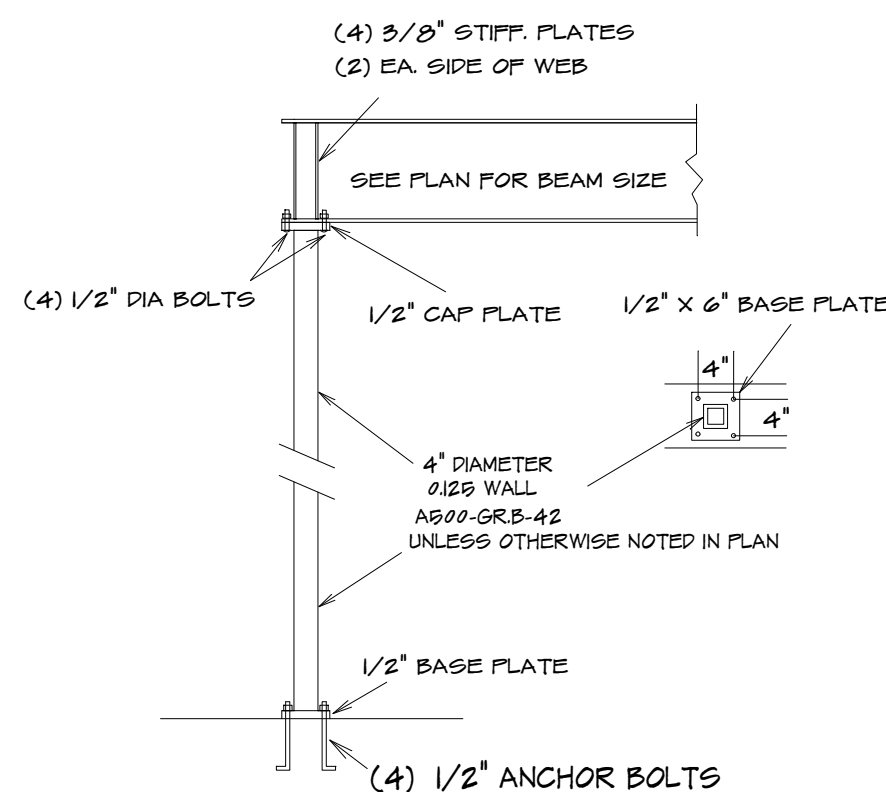


HSS COLUMN DETAIL

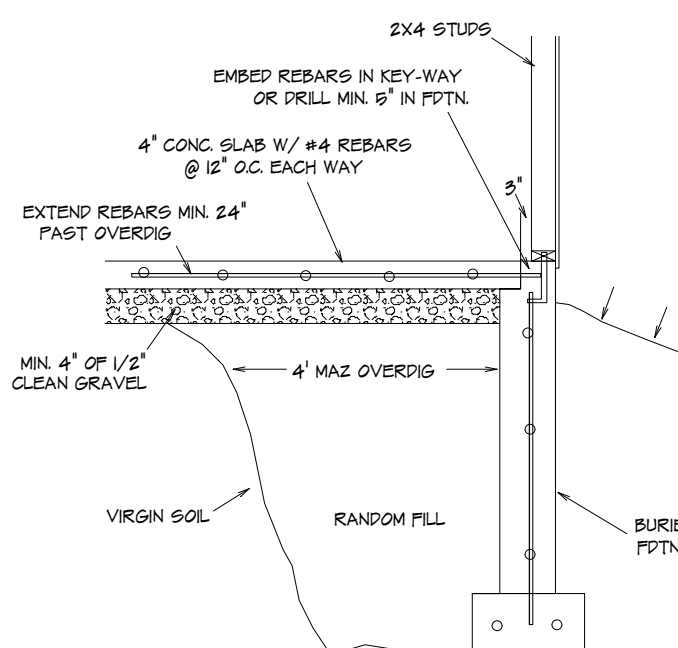


TYPICAL OVERDIG @ SLAB

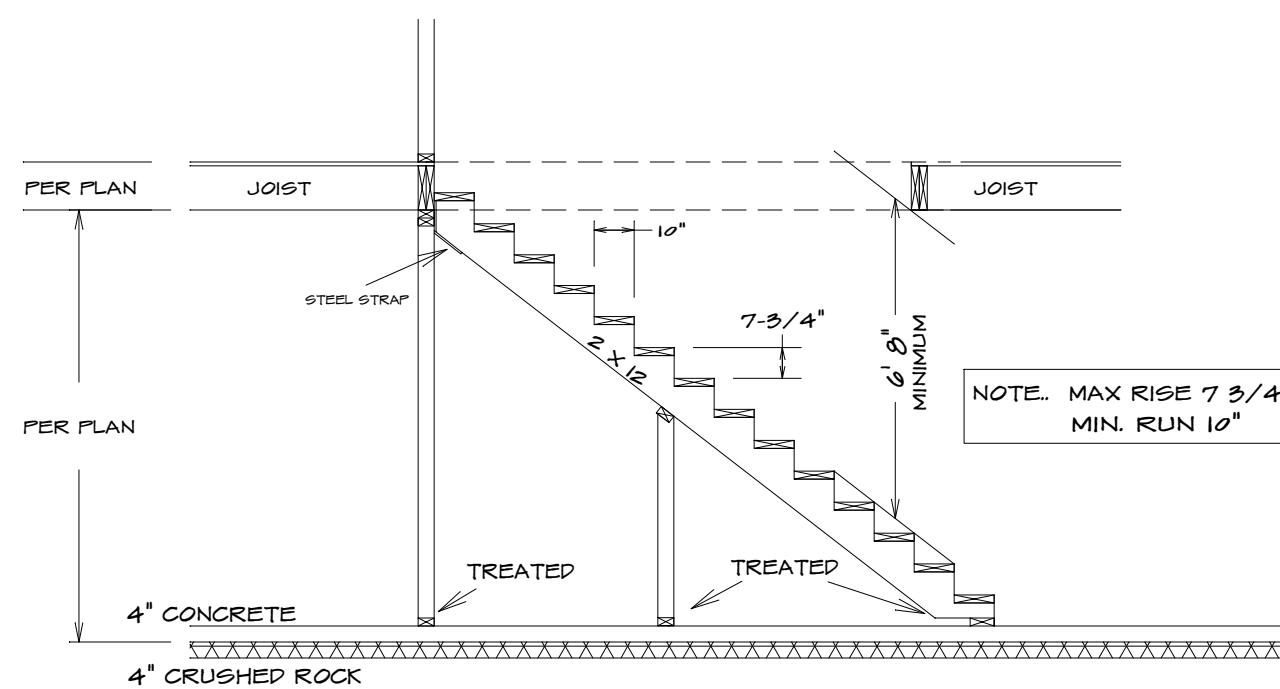


STAIR SECTION (TYP)

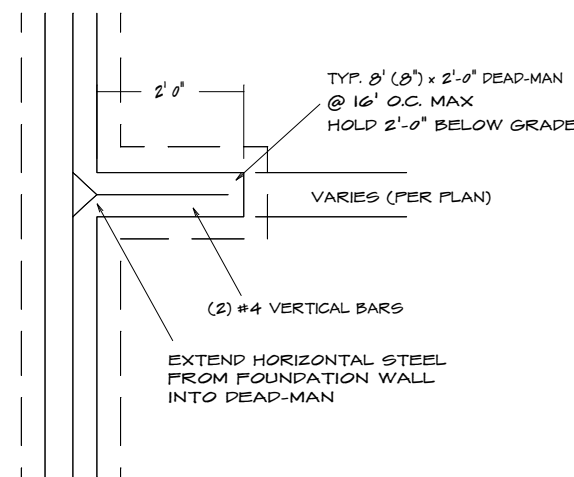


TYPICAL DEAD-MAN SECTION

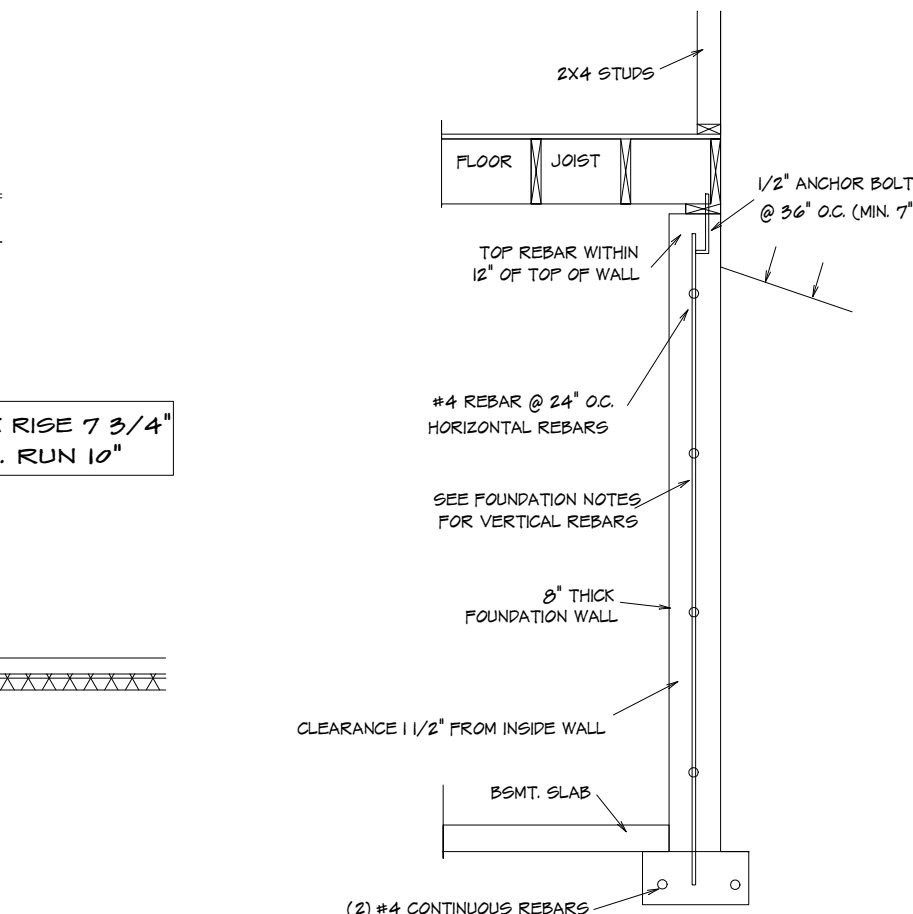

TYPICAL FOUNDATION WALL

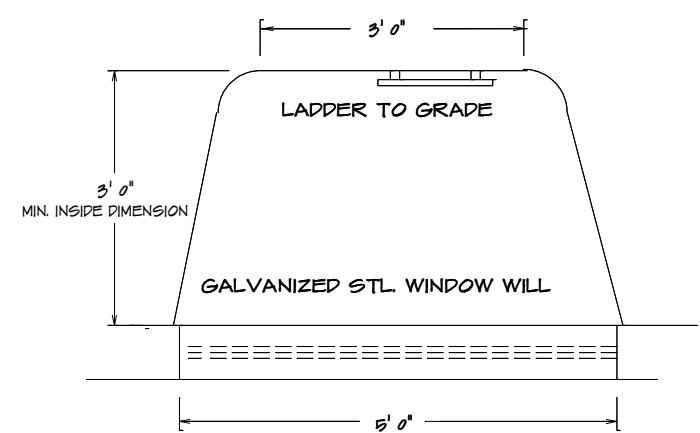


TYPICAL EGRESS WINDOW PLAN SECTION

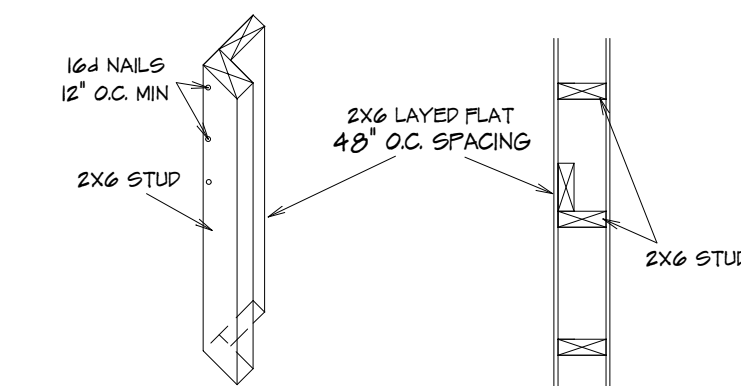


EXTERIOR TALL WALL SECTION


10' TRU 18" TALL WALLS UNINTERRUPTED TO BE CONSTRUCTED WITH 2X6 STUDS 16" O.C. WITH STIFF BACK EVERY 48" O.C.

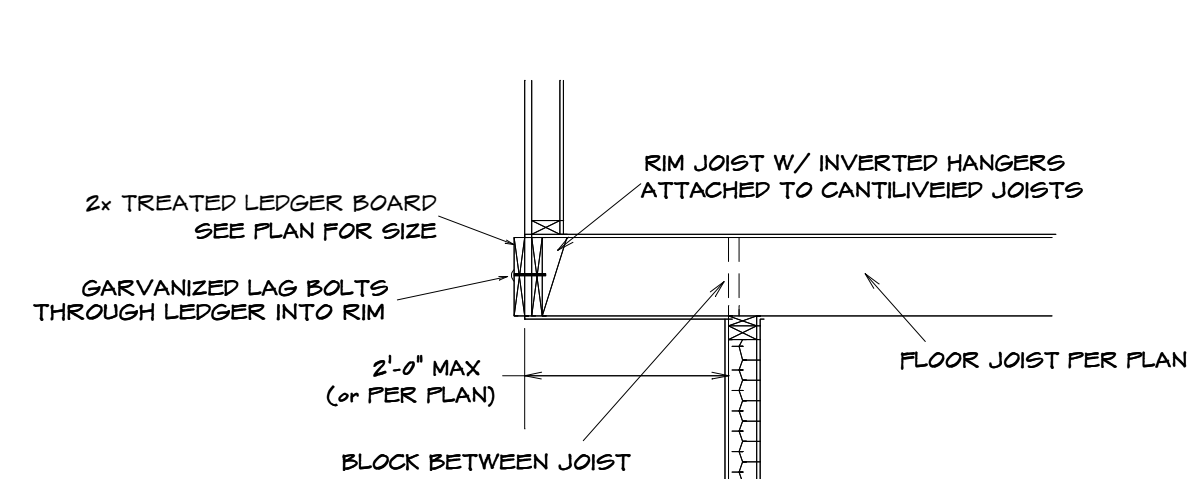


TYPICAL CANTILEVER FRAMING W/ DECK ATTACHMENT

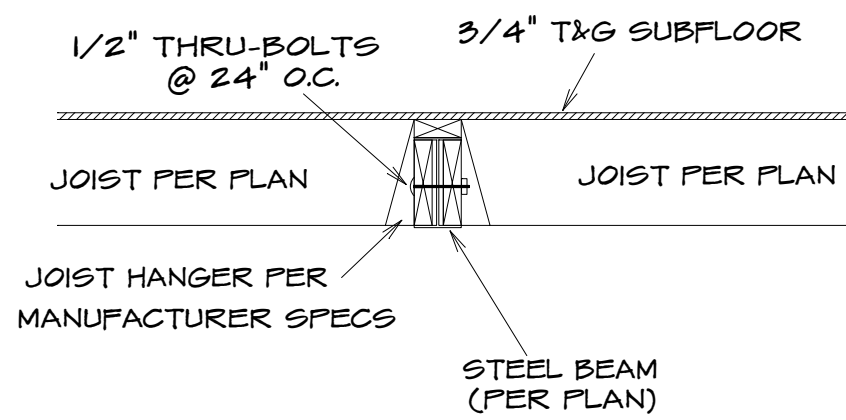


UPSET STEEL BEAM/JOIST CONNECTION

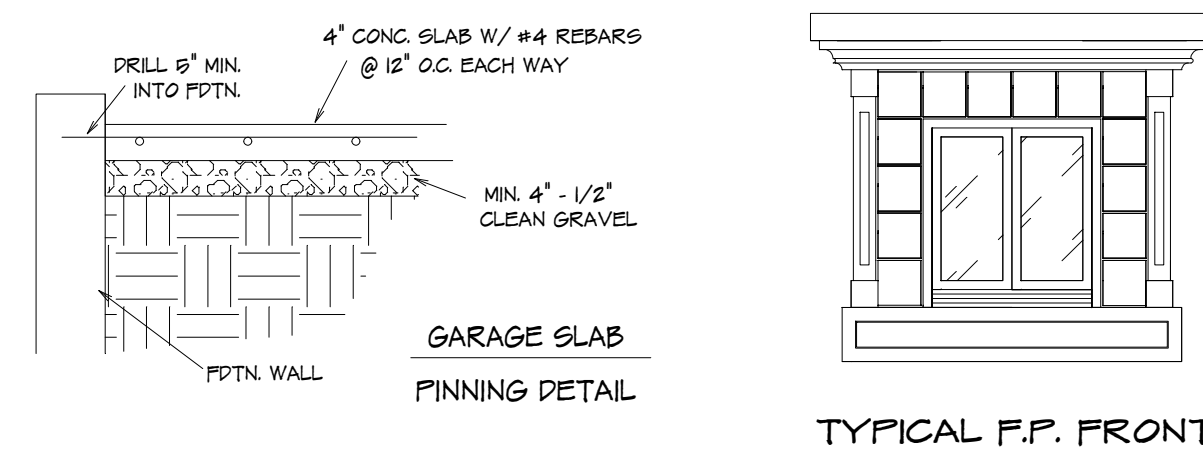


TYPICAL F.P. FRONT

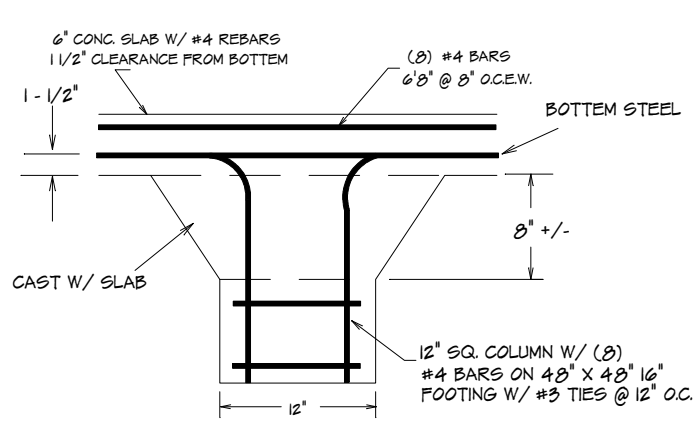

SLAB AT PEDESTAL

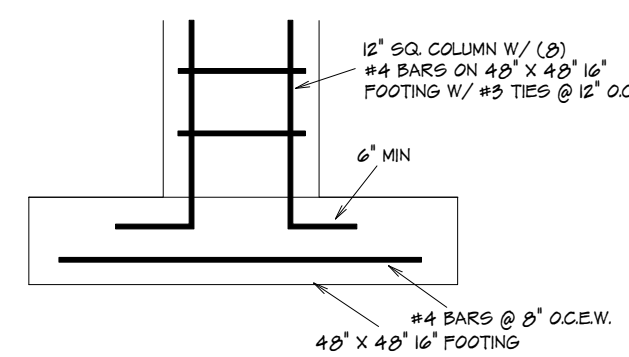

PEDESTAL AT FOOTING

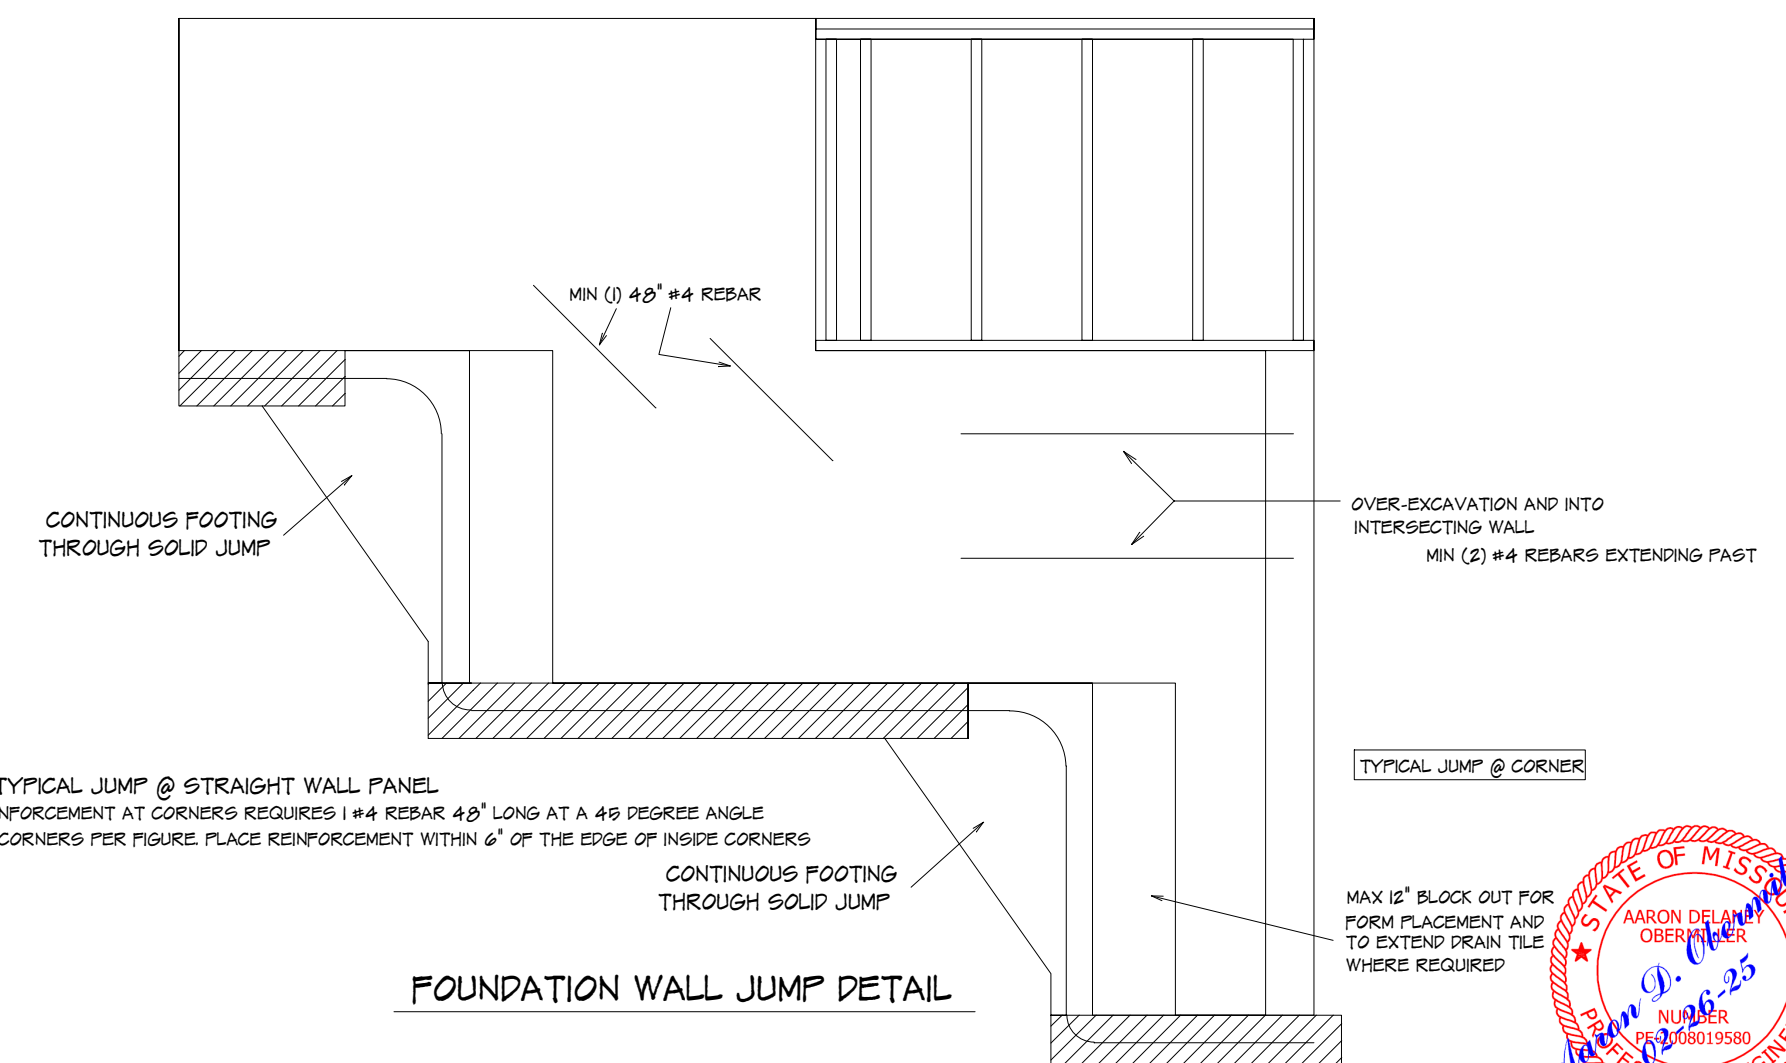

FOUNDATION WALL JUMP DETAIL

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FILE NAME:

6114 SEC2

SHEET NO. :

7