Greystone - Masterplan

Lot: 136 Hook Farms

Address: 2623 SW Tracker Lane Lees Summit, MO

RELEASE FOR CONSTRUCTION AS NOTED ON PLANS REVIEW **DEVELOPMENT SERVICES** LEE'S SUMMIT, MISSOURI 01/22/2025 11:51:45

Area W/ 3rd Car Garage

Basement Finished

Basement Unfinished

Front Porch

1238 SF

1317 SF

2556 SF

24 SF

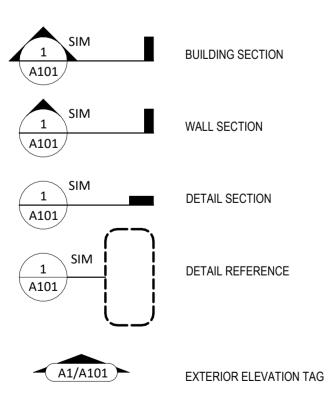
611 SF

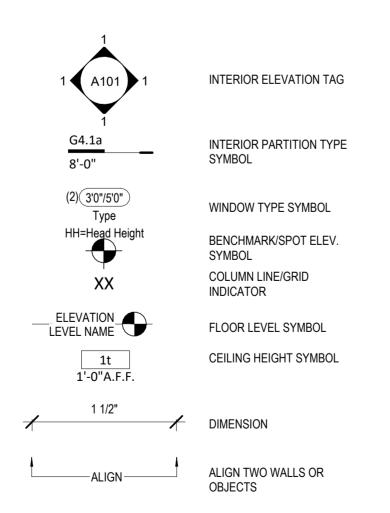
152 SF

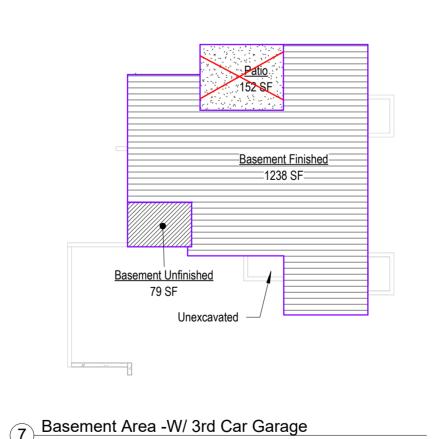
1018 SF

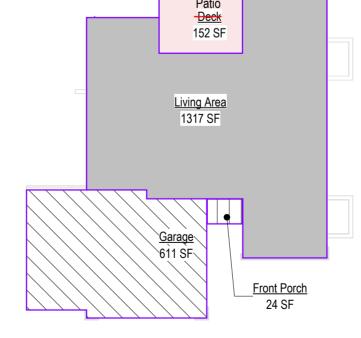
866 SF

Sheet List			
Sheet No	Sheet Name		
00	Cover Sheet		
A101	Front Elevations		
A301	Side Elevations - Full Basement		
A302	Side Elevations - Daylight Basement		
A303	Side Elevations - Walkout Basement		
A401	Floor Plan - Main Level		
A501	RCP/Electrical Plan		
A601	Roof Plan		
A602	Roof Plan		
A701	POD Options		
A702	Floor Plan - Basement		
A801	Details		
A802	Details		
A803	Details		









Main Level Area W/ 3rd Car Garage

6 Nam LC. 1/16" = 1'-0"

Patio Deck 152 SF		
Living Area 1317 SF		
1017 01		
Garage 611 SF		
	Front Porch 24 SF	

General Information

Basement Walls: R-13 of Floor (over unconditioned): R-19 M Slab on Grade: R-10 fm Ductwork: R-8 M Fuel Fired Furnace: 90% A Electic Furnace: No Min	MAX
Roof Attic Ceilings: R-49 M Vaults: R-38 M Vaults < 500sf: R-20 M Wood Frame Walls: R-20 G Basement Walls: R-13 G Floor (over unconditioned): R-19 M Slab on Grade: R-10 f Ductwork: R-8 M Fuel Fired Furnace: 90% A Electic Furnace: No Min	
Attic Ceilings: R-49 M Vaults: R-38 M Vaults < 500sf: R-30 M Wood Frame Walls: R-20 G Basement Walls: R-13 G Floor (over unconditioned): R-19 M Slab on Grade: R-10 f Ductwork: R-8 M Fuel Fired Furnace: 90% A Electic Furnace: No Min	MAX
Vaults: R-38 M Vaults < 500sf: R-30 M Wood Frame Walls: R-20 c Basement Walls: R-13 c Floor (over unconditioned): R-19 M Slab on Grade: R-10 fc Ductwork: R-8 M Fuel Fired Furnace: 90% A Electic Furnace: No Min	
Vaults < 500sf: R-30 M Wood Frame Walls: Basement Walls: Floor (over unconditioned): Slab on Grade: Ductwork: R-8 M Fuel Fired Furnace: 90% A Electic Furnace: No Min	ΛIN
Wood Frame Walls: R-20 of Basement Walls: R-13 of Floor (over unconditioned): R-19 M Slab on Grade: R-10 fr Ductwork: R-8 M Fuel Fired Furnace: 90% A Electic Furnace: No Min	ΛIN
Basement Walls: R-13 of Floor (over unconditioned): R-19 M Slab on Grade: R-10 fm Ductwork: R-8 M Fuel Fired Furnace: 90% A Electic Furnace: No Min	ΛIN
Floor (over unconditioned): Slab on Grade: Ductwork: R-8 M Fuel Fired Furnace: Power A Electic Furnace: R-19 for A R-10 for A R-1	or R-13 + 5 MIN
Slab on Grade: R-10 fi Ductwork: R-8 M Fuel Fired Furnace: 90% A Electic Furnace: No Mir	r R-10 Continuous
Ductwork: R-8 M Fuel Fired Furnace: 90% A Electic Furnace: No Mir	ΛIN
Fuel Fired Furnace: 90% A Electic Furnace: No Mir	or 24" MIN
Electic Furnace: No Mir	N
	FUE MIN
Cooling System: 13 SE	nimum
	ER MIN
Water Heater	
Gas Fired Storage: 0.67 E	F MIN
Gas Fired Instant: 0.62 E	

An energy efficient certificate is required to be posted in or on the electrical panel before the final inspection. The certificate will be provided with all new residential permits. It is the permit holder/contractor's responsibility to ensure the before final inspection -- Owner/Contractor is responsibile for meeting the prescriptive requirments of IRC chapter 11 unless a HER Index Analysis for Performance Compliance based on the plans is submitted to the AHJ for

Ground Snow Load: Wind Speed: Topography Effects: Seismic Design Category: Damage From Weather: Frost Line Depth: Winter Design Temperature: 6 F Ice Barrier Underlayment: Yes Flood Hazard: Air Freezing Index: Mean Annual Temperature: 55.5 F

 Whole House Mechanical Ventilation System is required for any dwelling with air infiltration at a rate of less than 5 air changes per hour (at ACH50 standard R303.4).

2. Carbon monoxide detectors required (R315) 3. Steel columns shall be minimum schedule 40

4. Deck Ledger attachment to house shall be per Tables 507.9.1.3. 5. New provisions for attachment of rafters,

trusses and roof beams. (R802.3 and

Programmable thermostat required

7. Air handlers shall be rated for Maximum 2% air leakage rate (N1103.2.2.1) 8. Building cavities used as return air plenums

shall be sealed to prevent leakage across the thermal envelope. (N1103.2.3) 9. Certain hot water pipes shall be insulated

10. All exhaust fans shall terminate to the building exterior (M1507.2) 11. Makeup air system required for kitchen

exhaust hoods that exceed 400 CFM M1503.4 12. Building cavities in a thermal envelope wall (including the wall between the house and garage) shall not be used as return air plenums (unless the required insulation and air

barrier are maintained) (M1601.1.1,#7.5) 13. An air handling system shall not serve both the living space and the garage (M1601.6) 14. A concrete-Encased grounding electrode ('UFER' Ground) connection complies with the

requirments of the 2018 IRC Section

E3608.1.2 in providing a connection with no less than the required minimum of steel. 15. Compliance with the requirments and show connection as needed for roof beam, trus, rafter, and girder connections for uplift per IRC

16. Garage Door Rating: DASMA 115 MPH Rated



Greystone

		Permit Se
Original Issue Date:		10/1/20
	REVISIONS	
Number	Description	Date

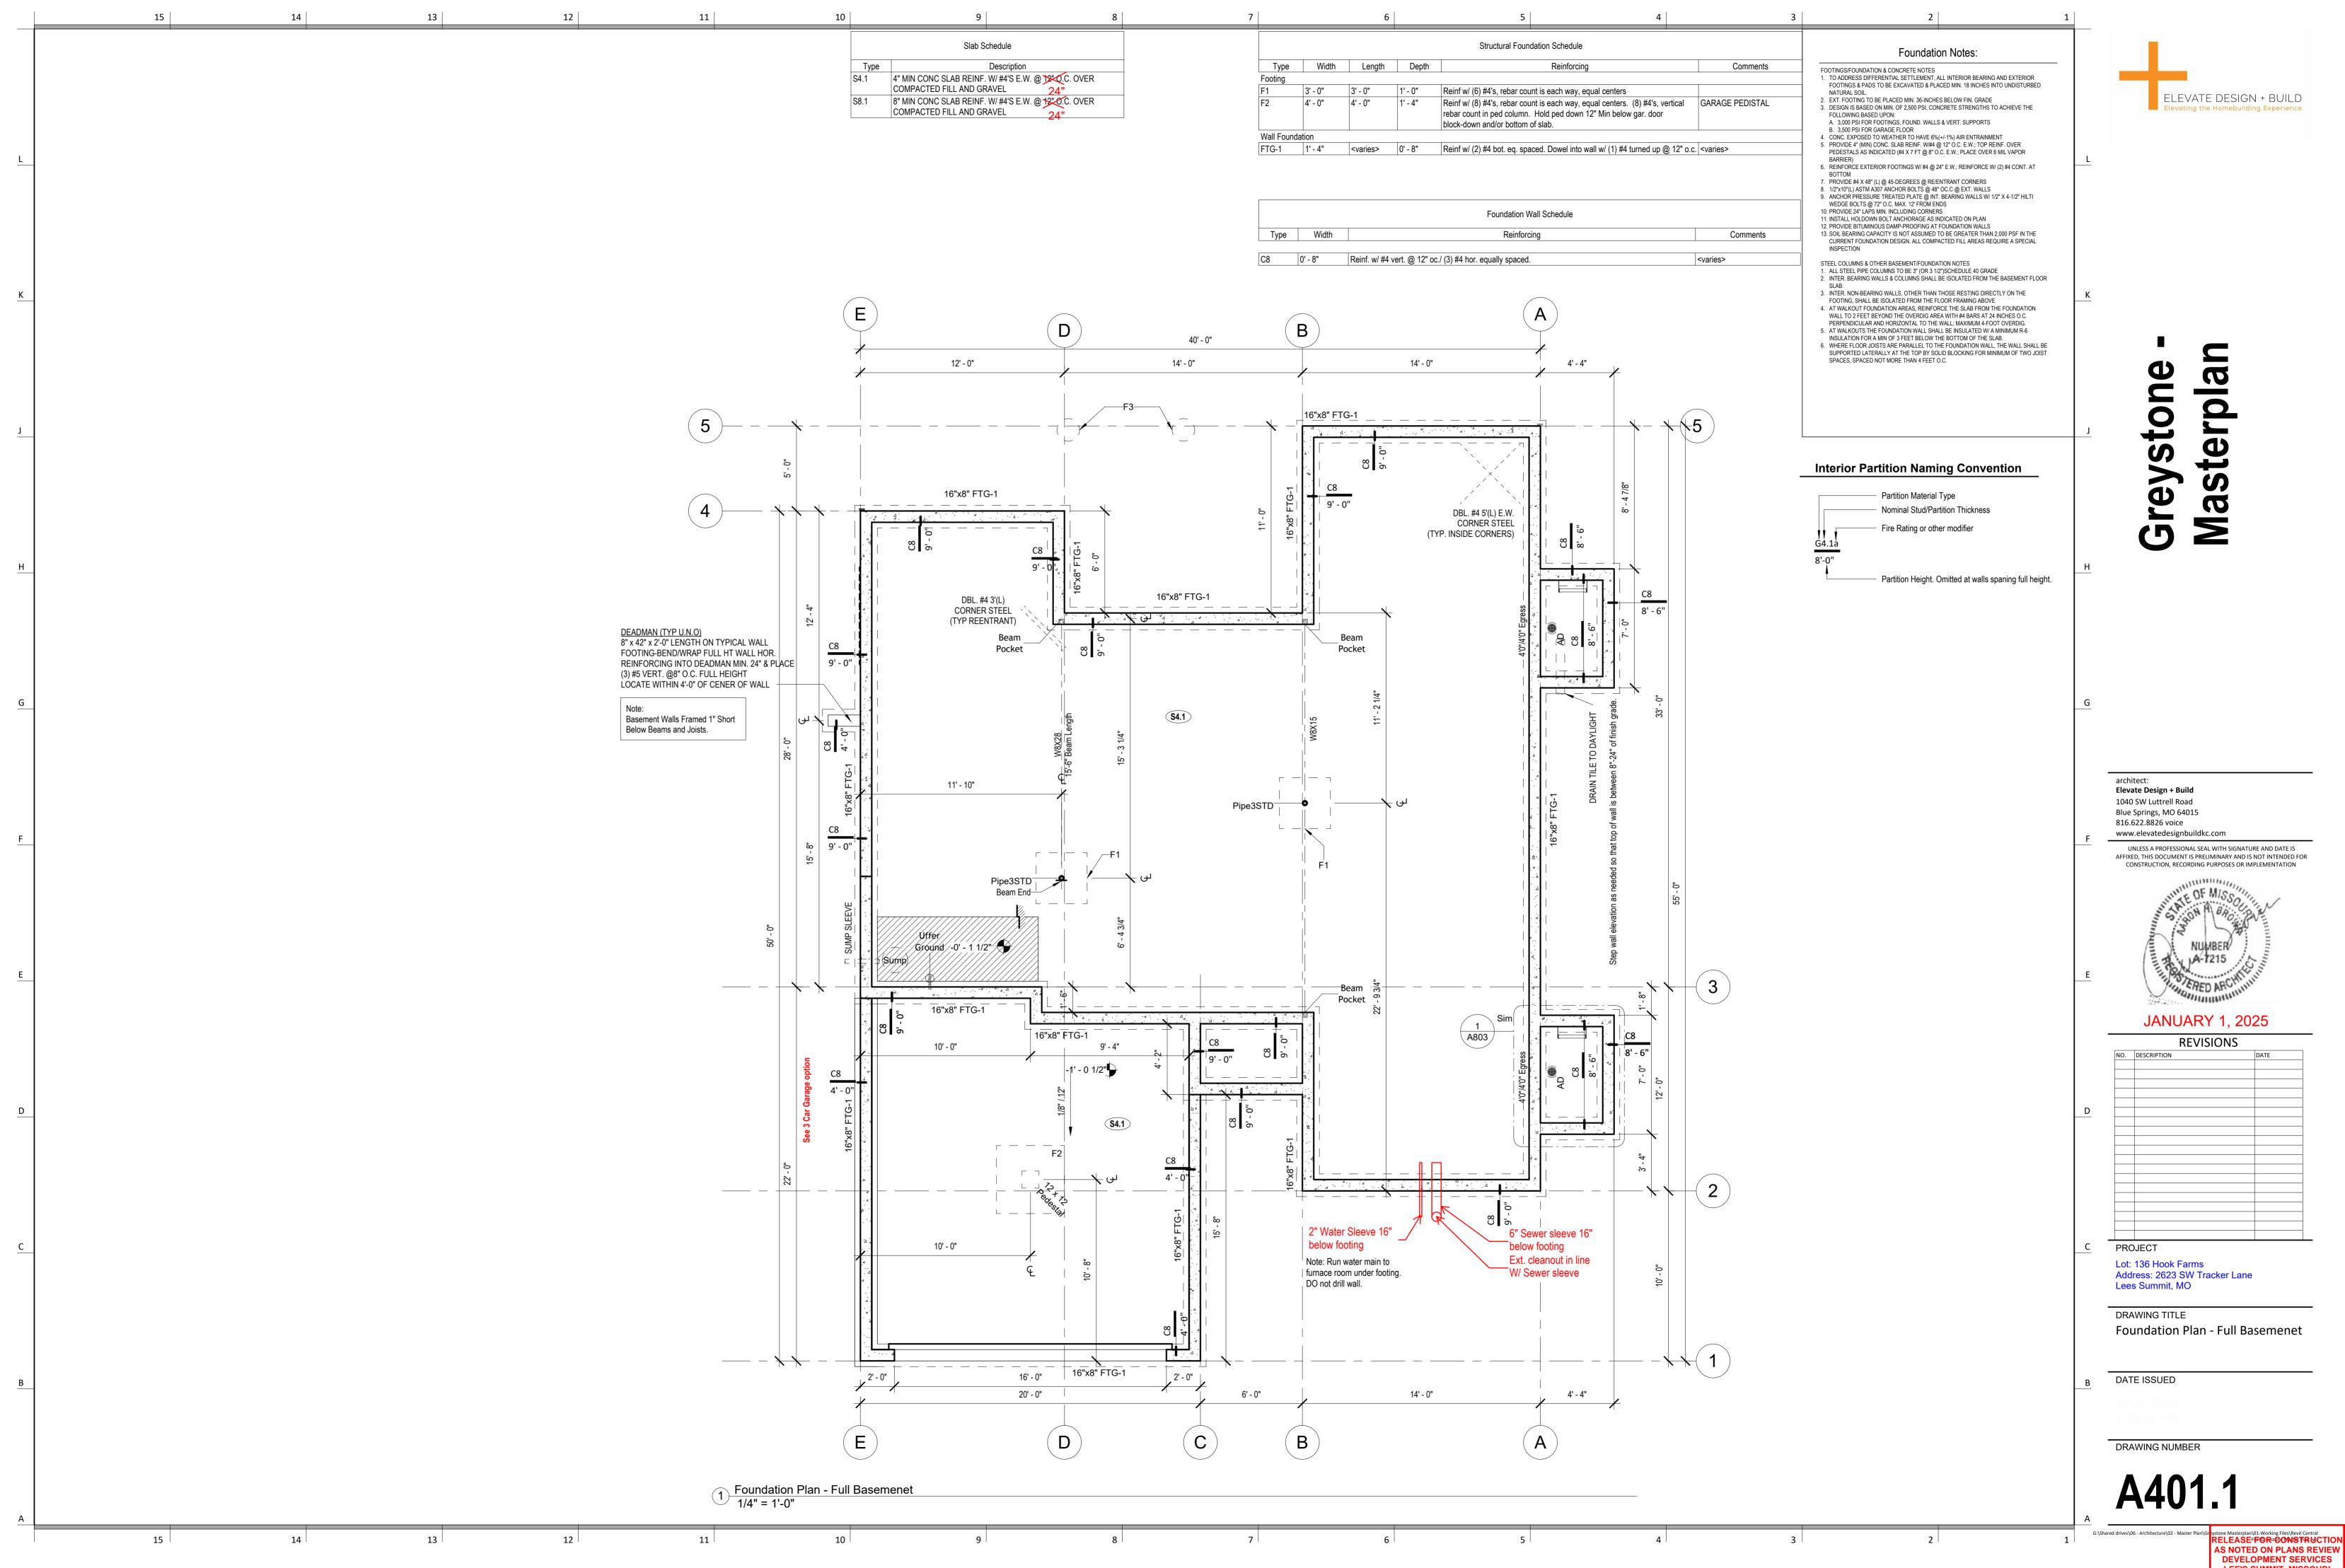


Permit Set

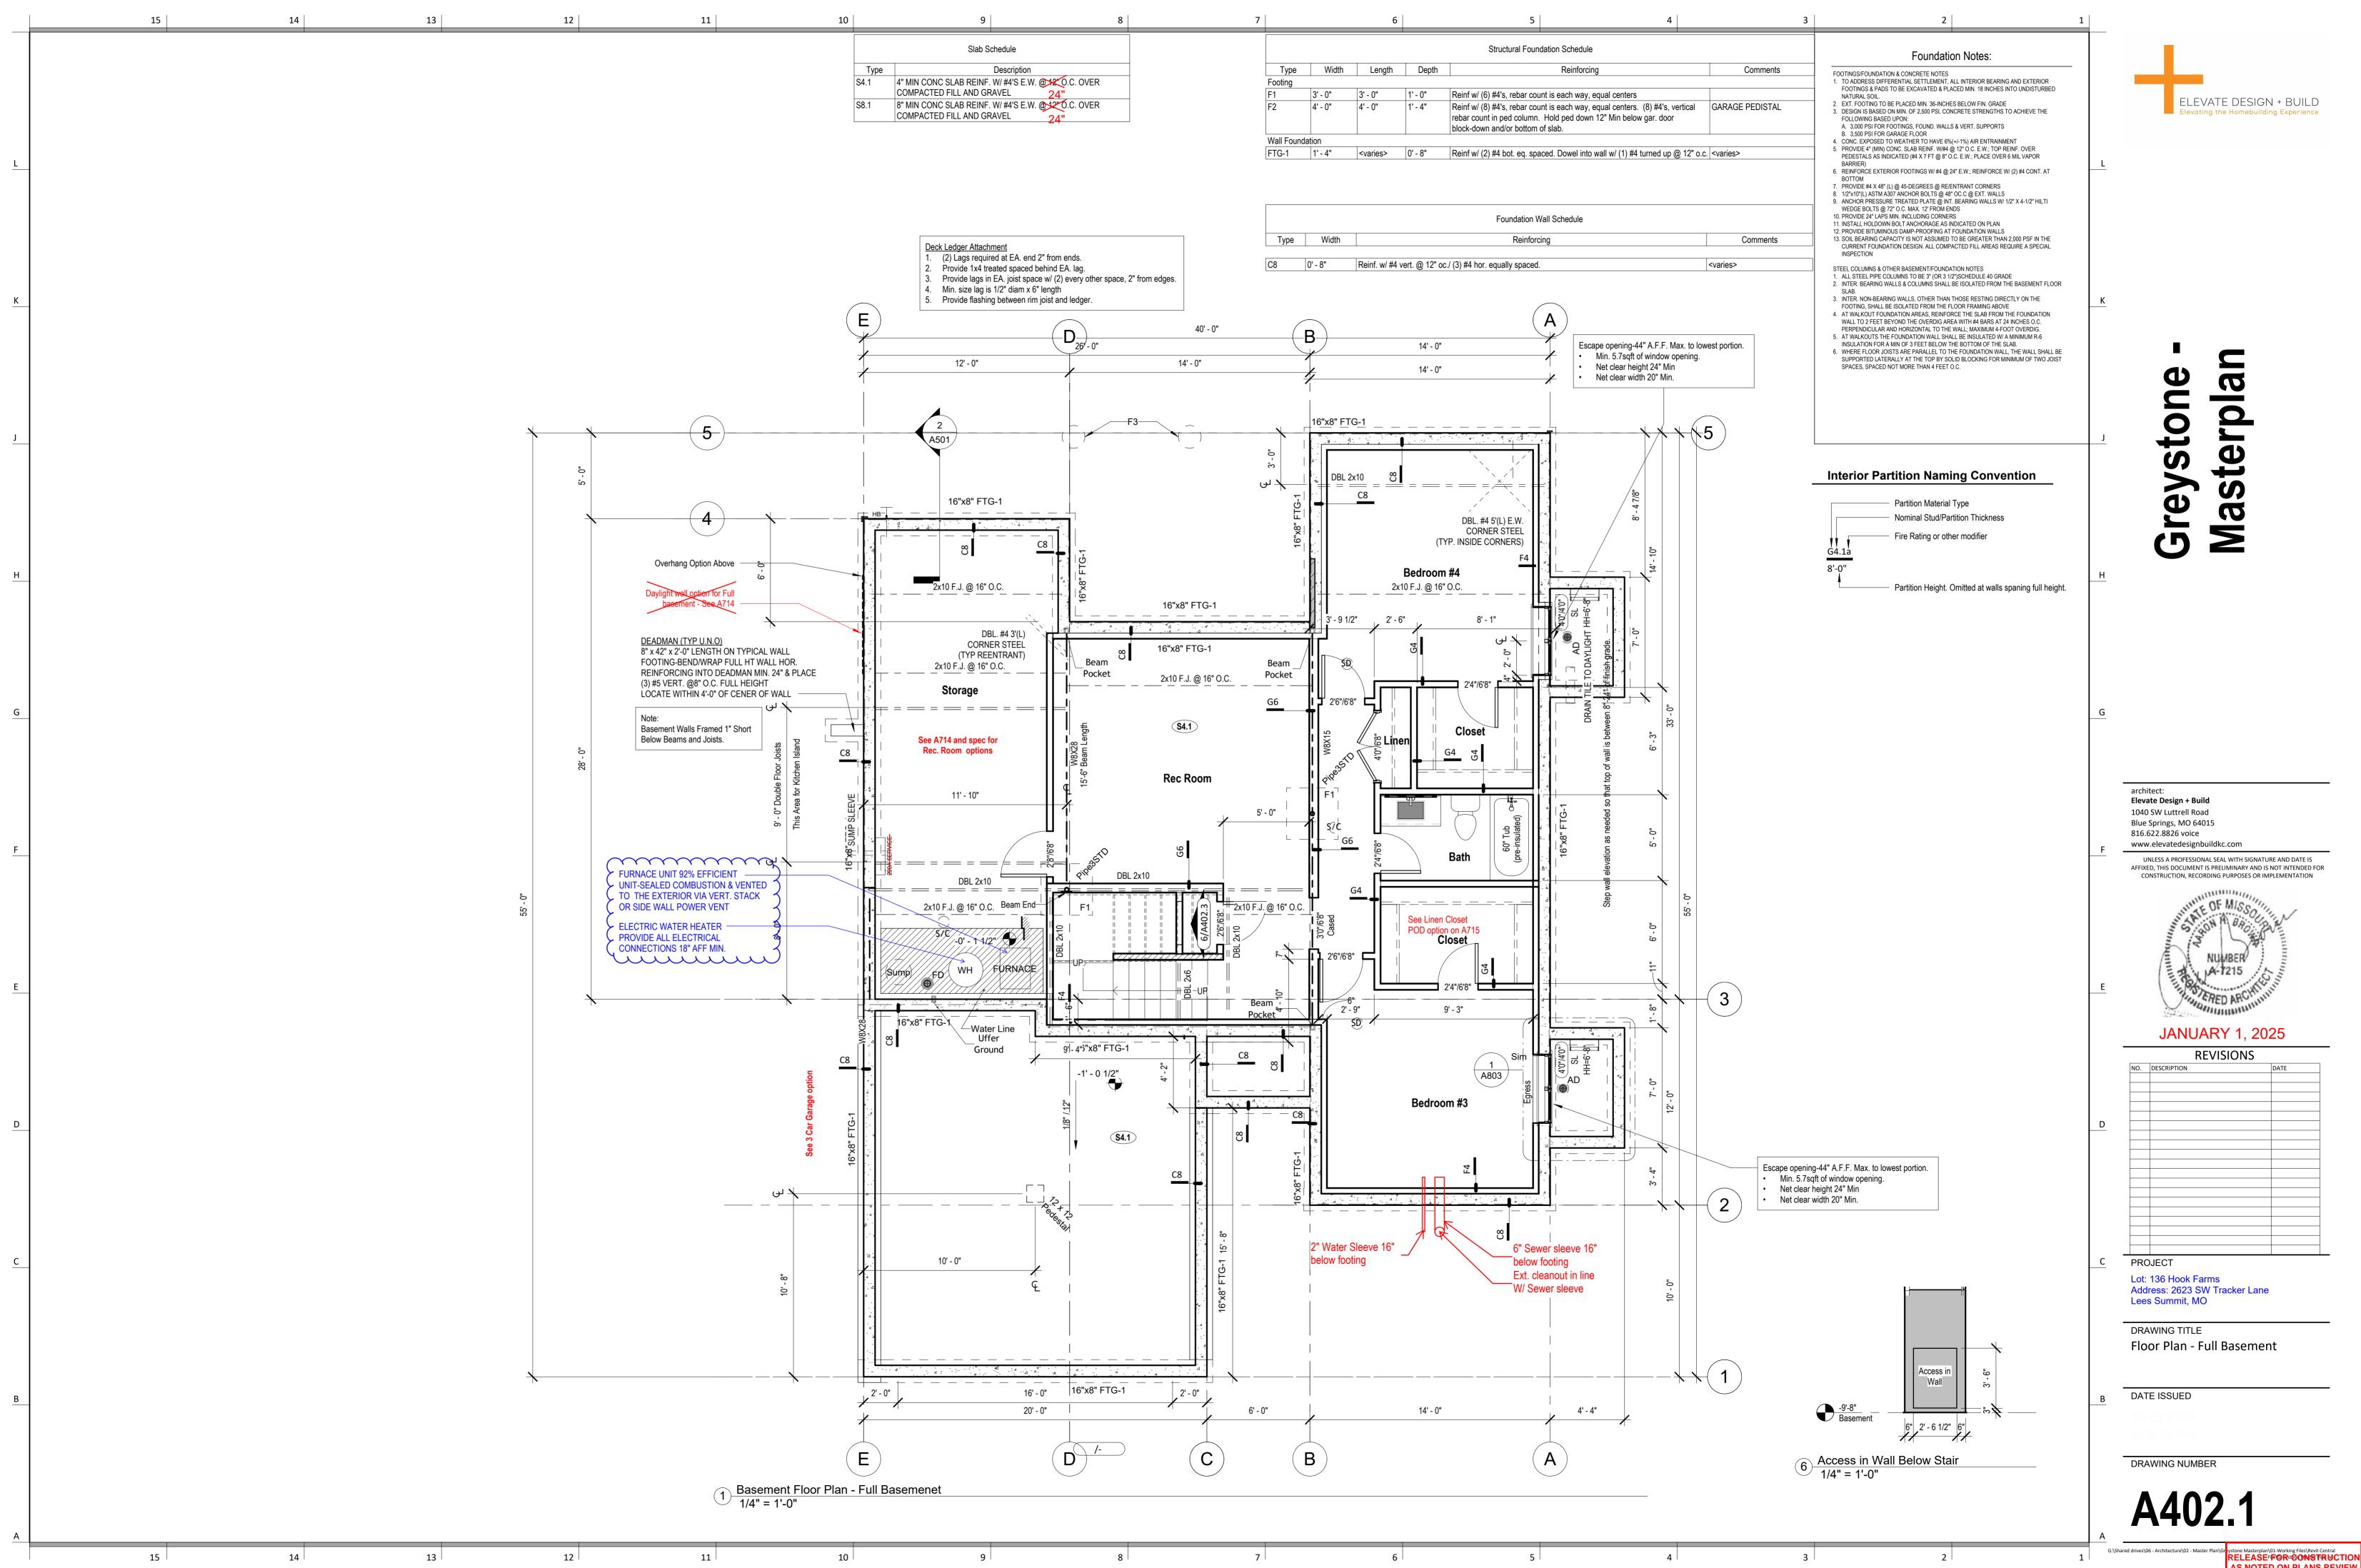
PLAN DESCRIPTION: Cover Sheet



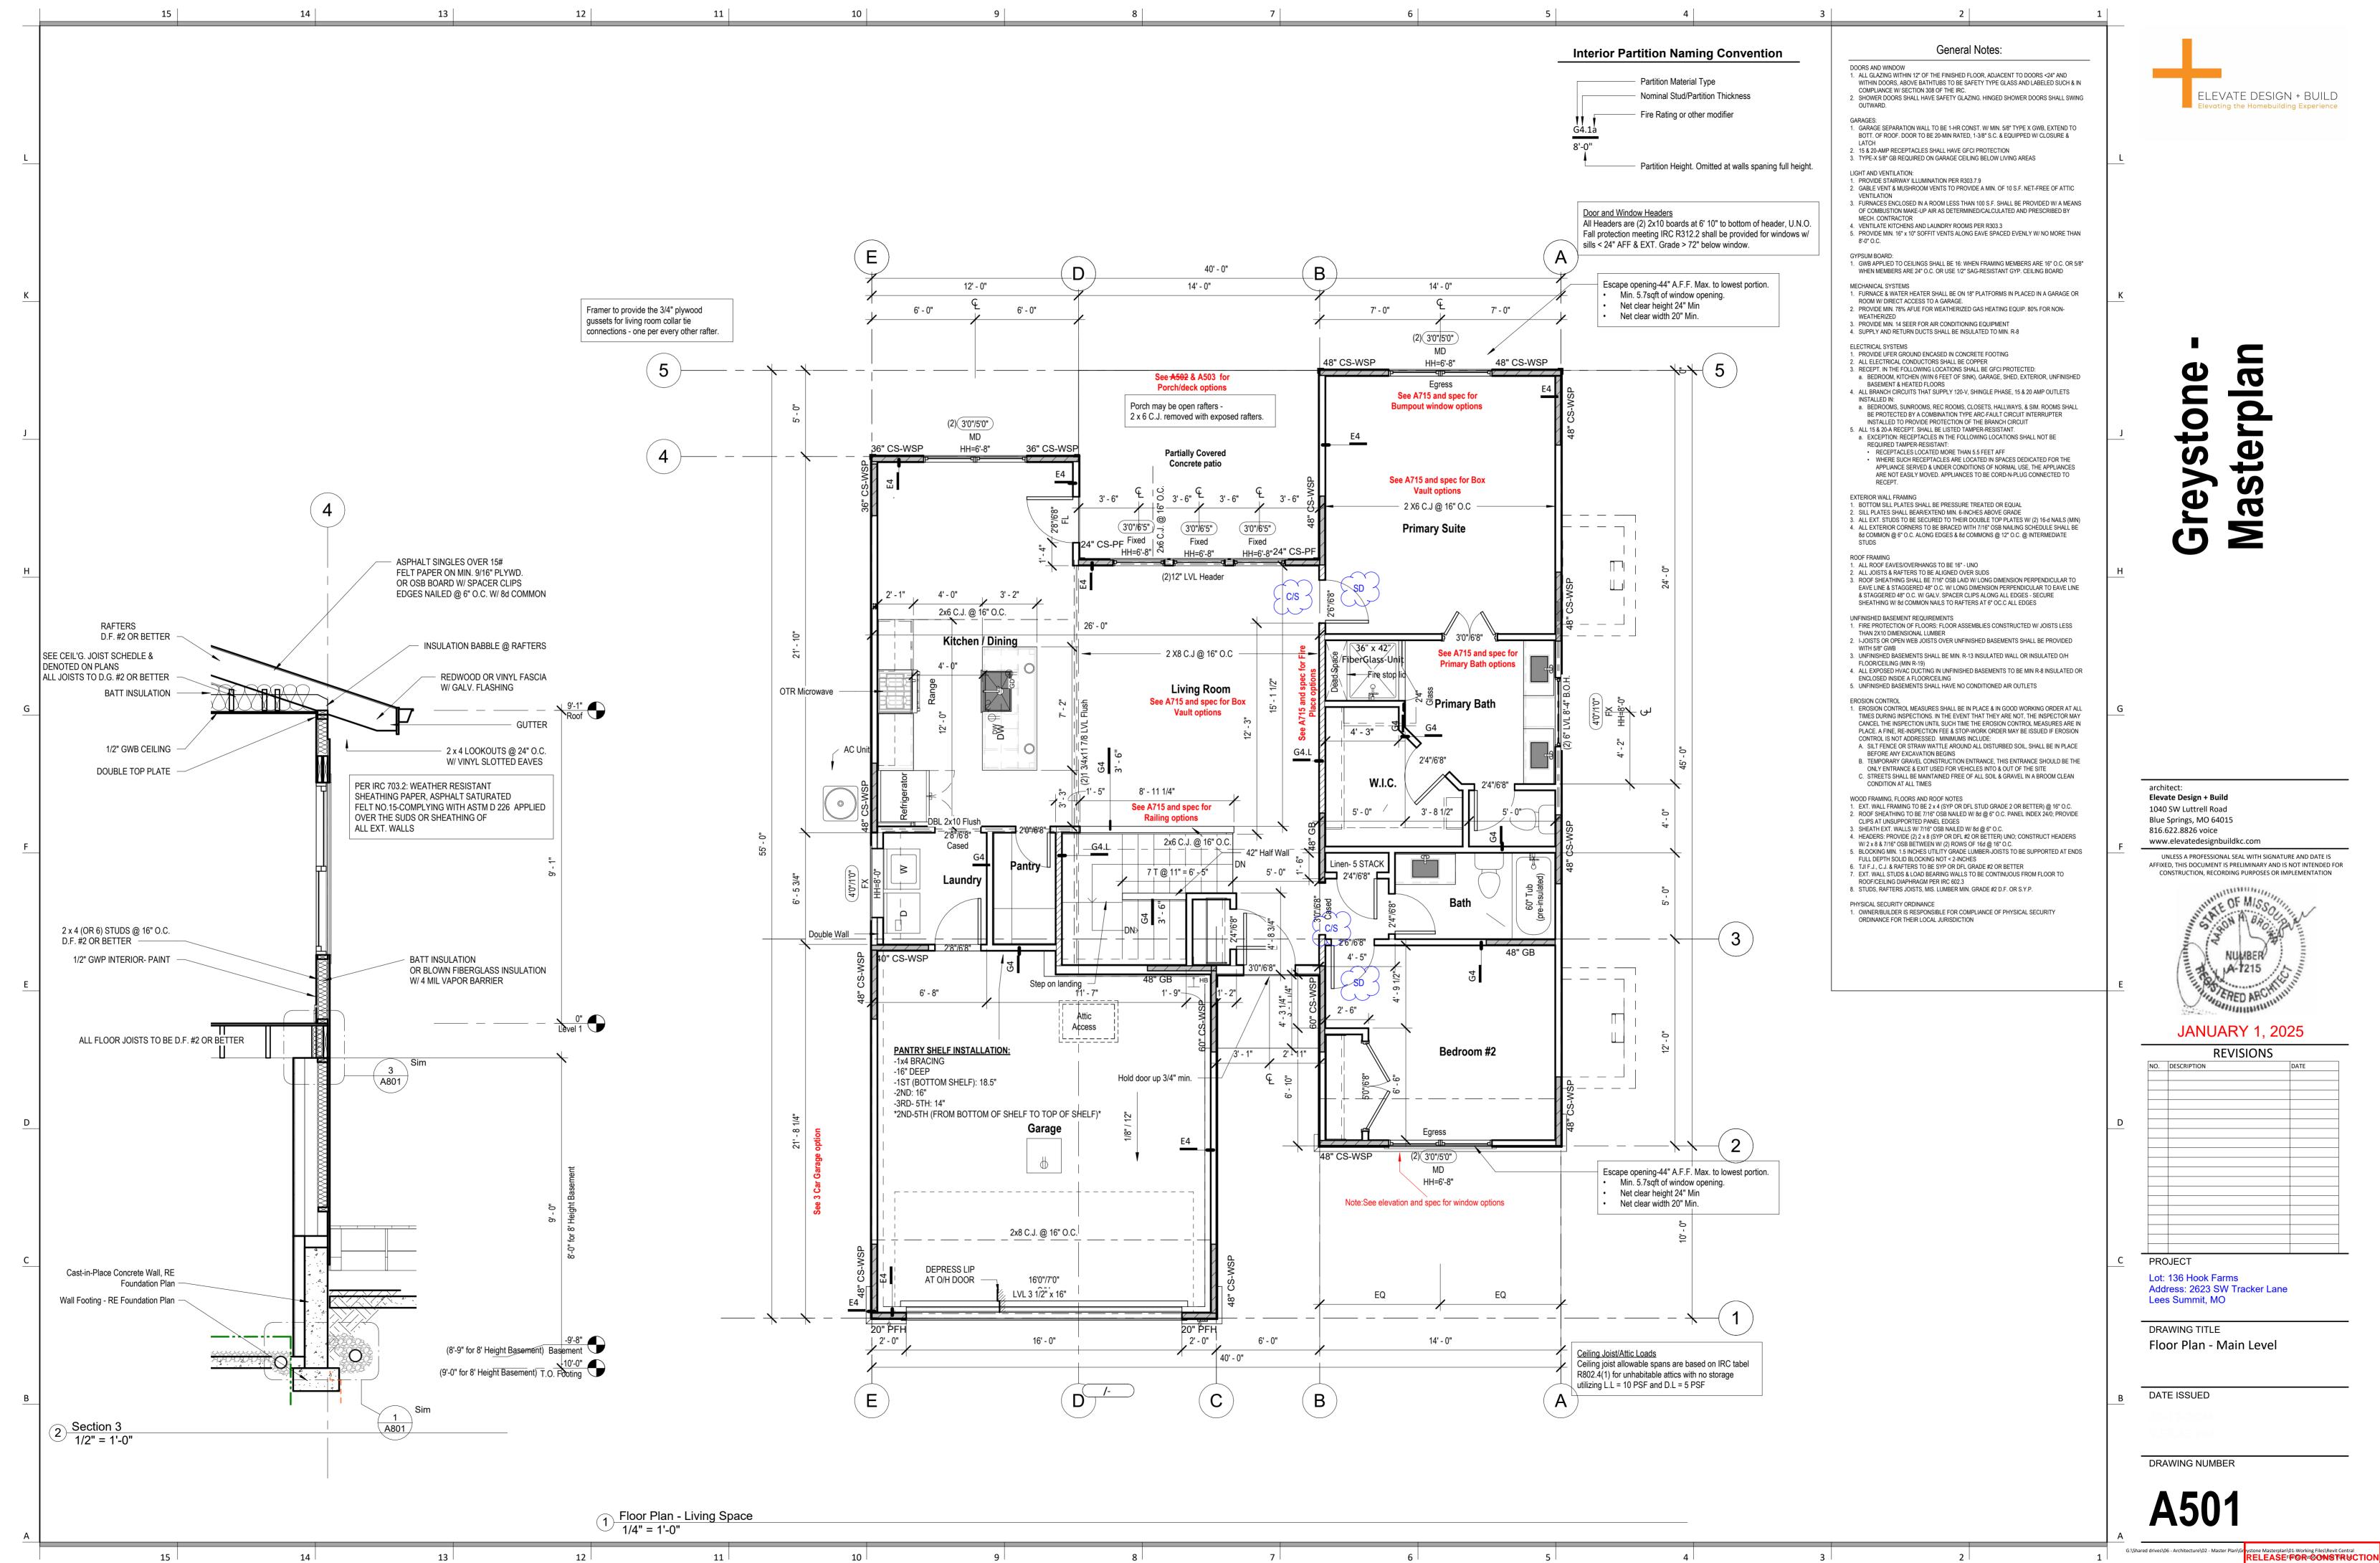




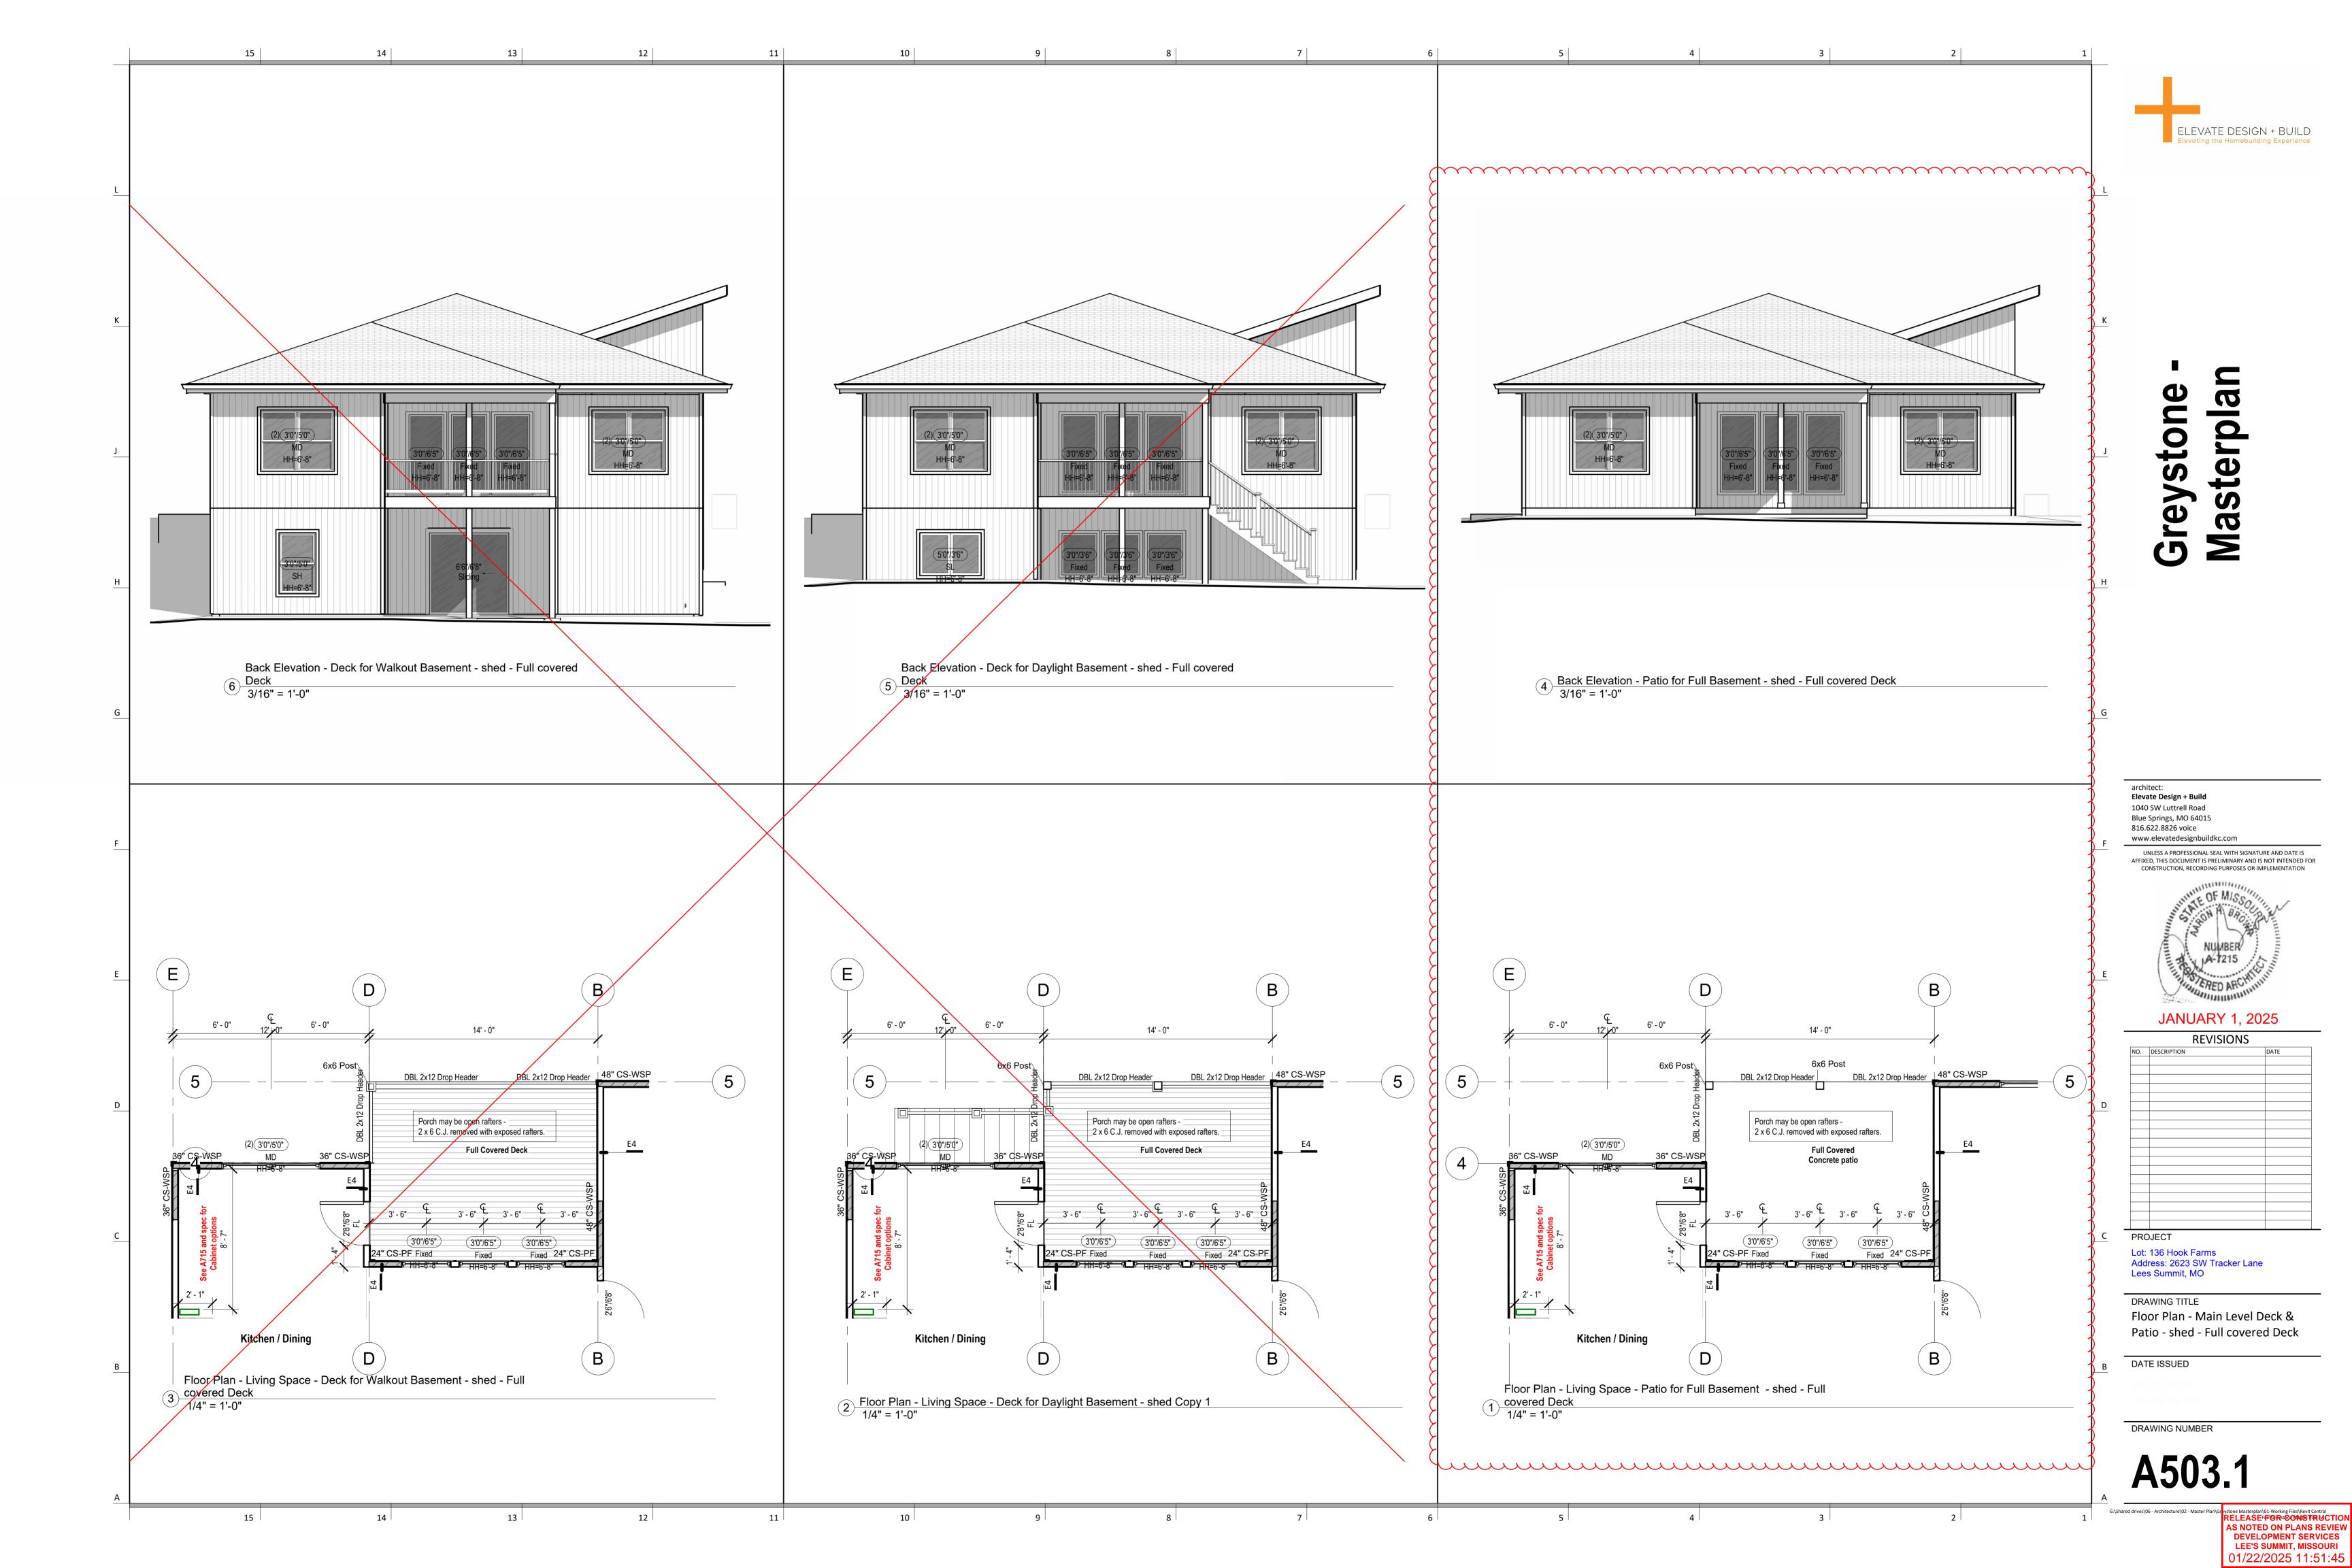
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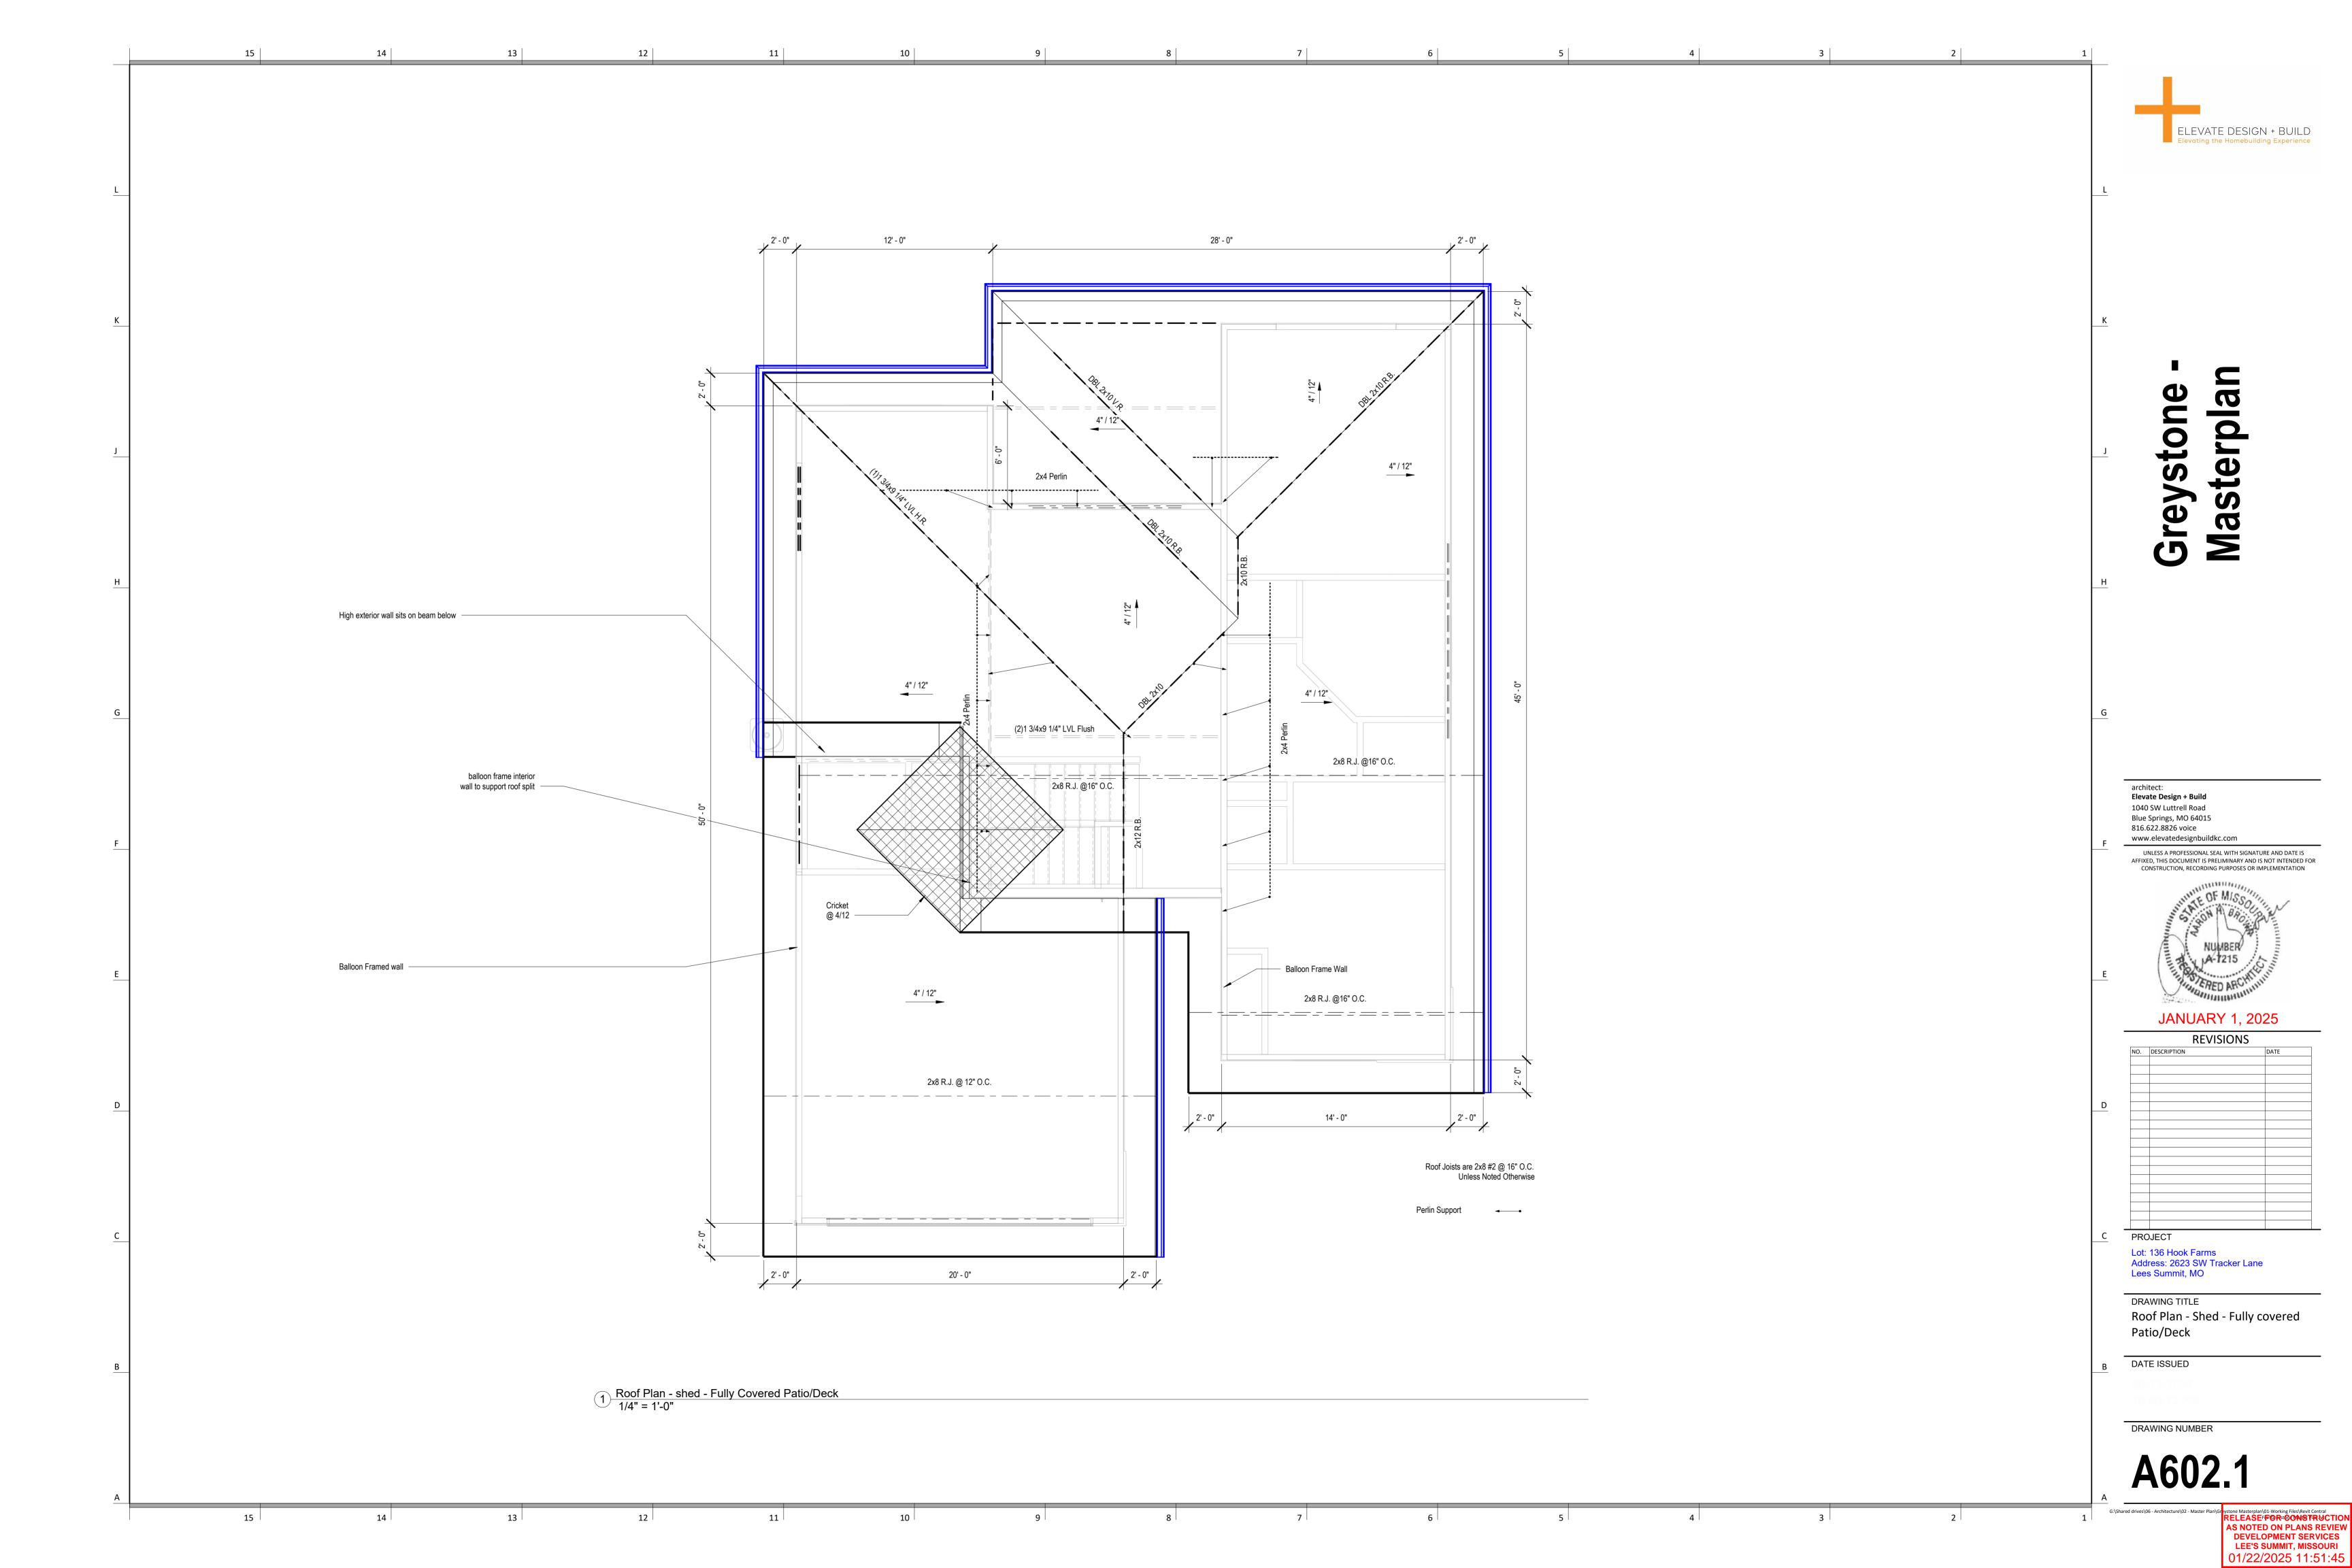


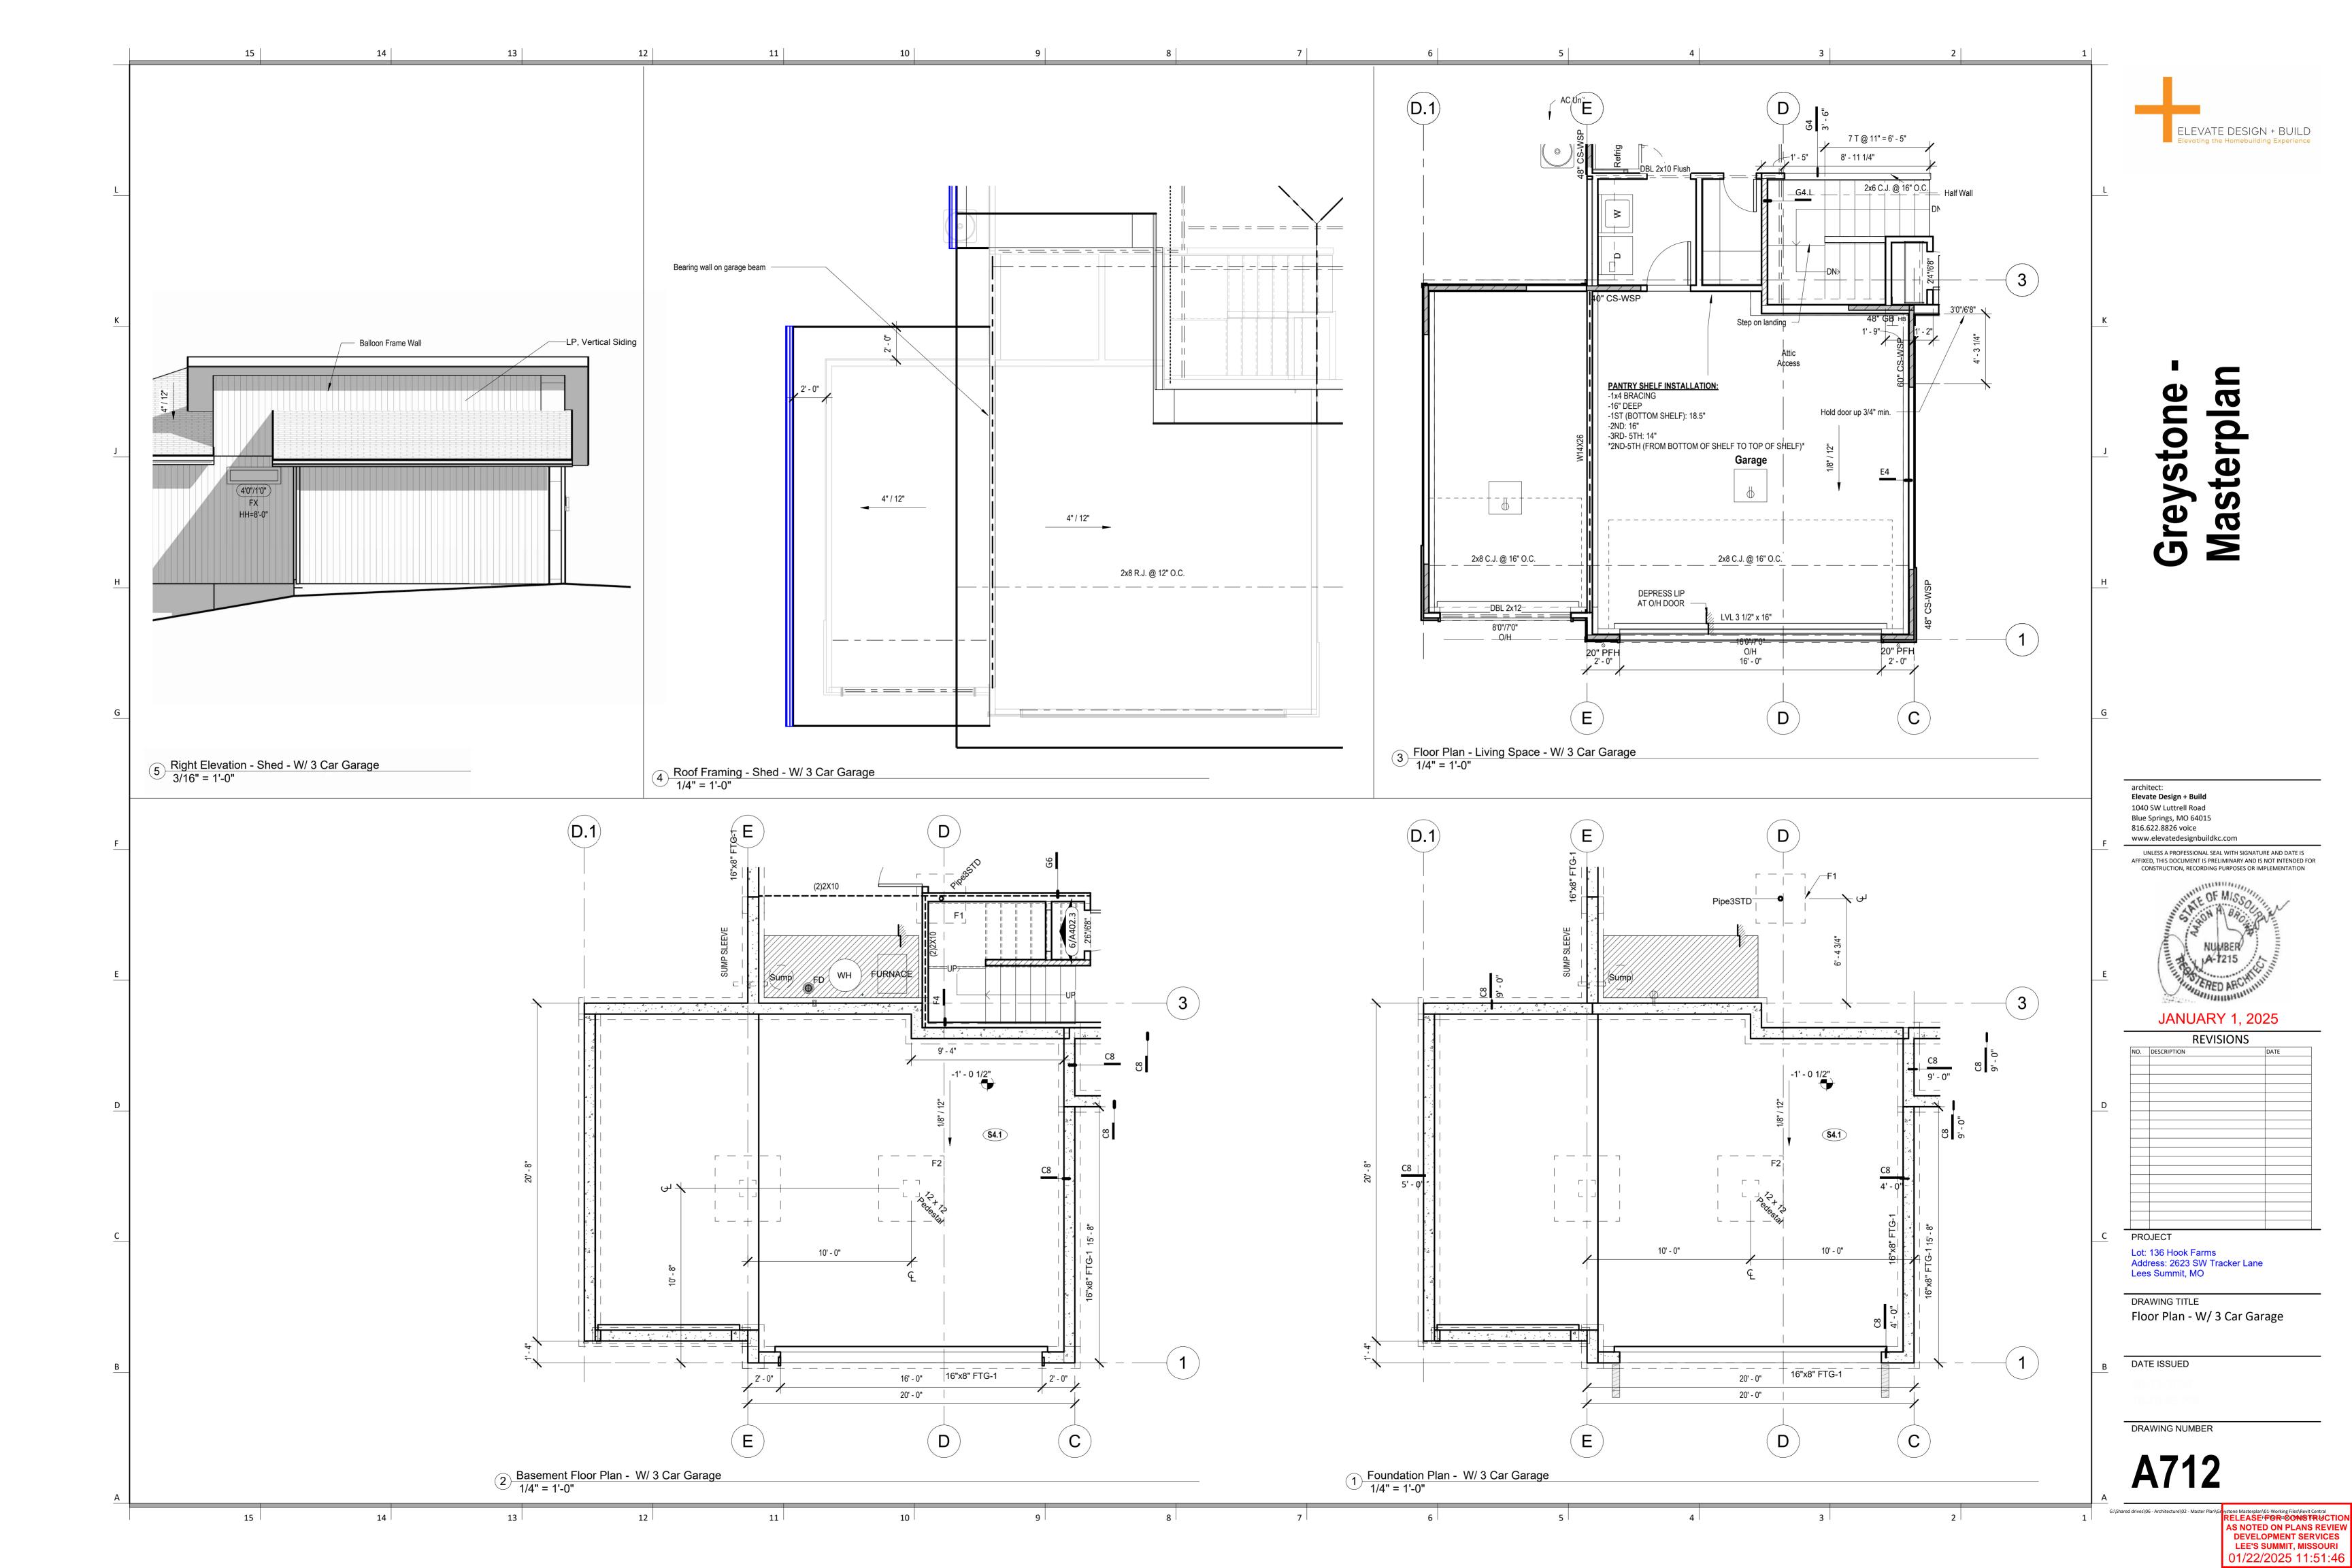
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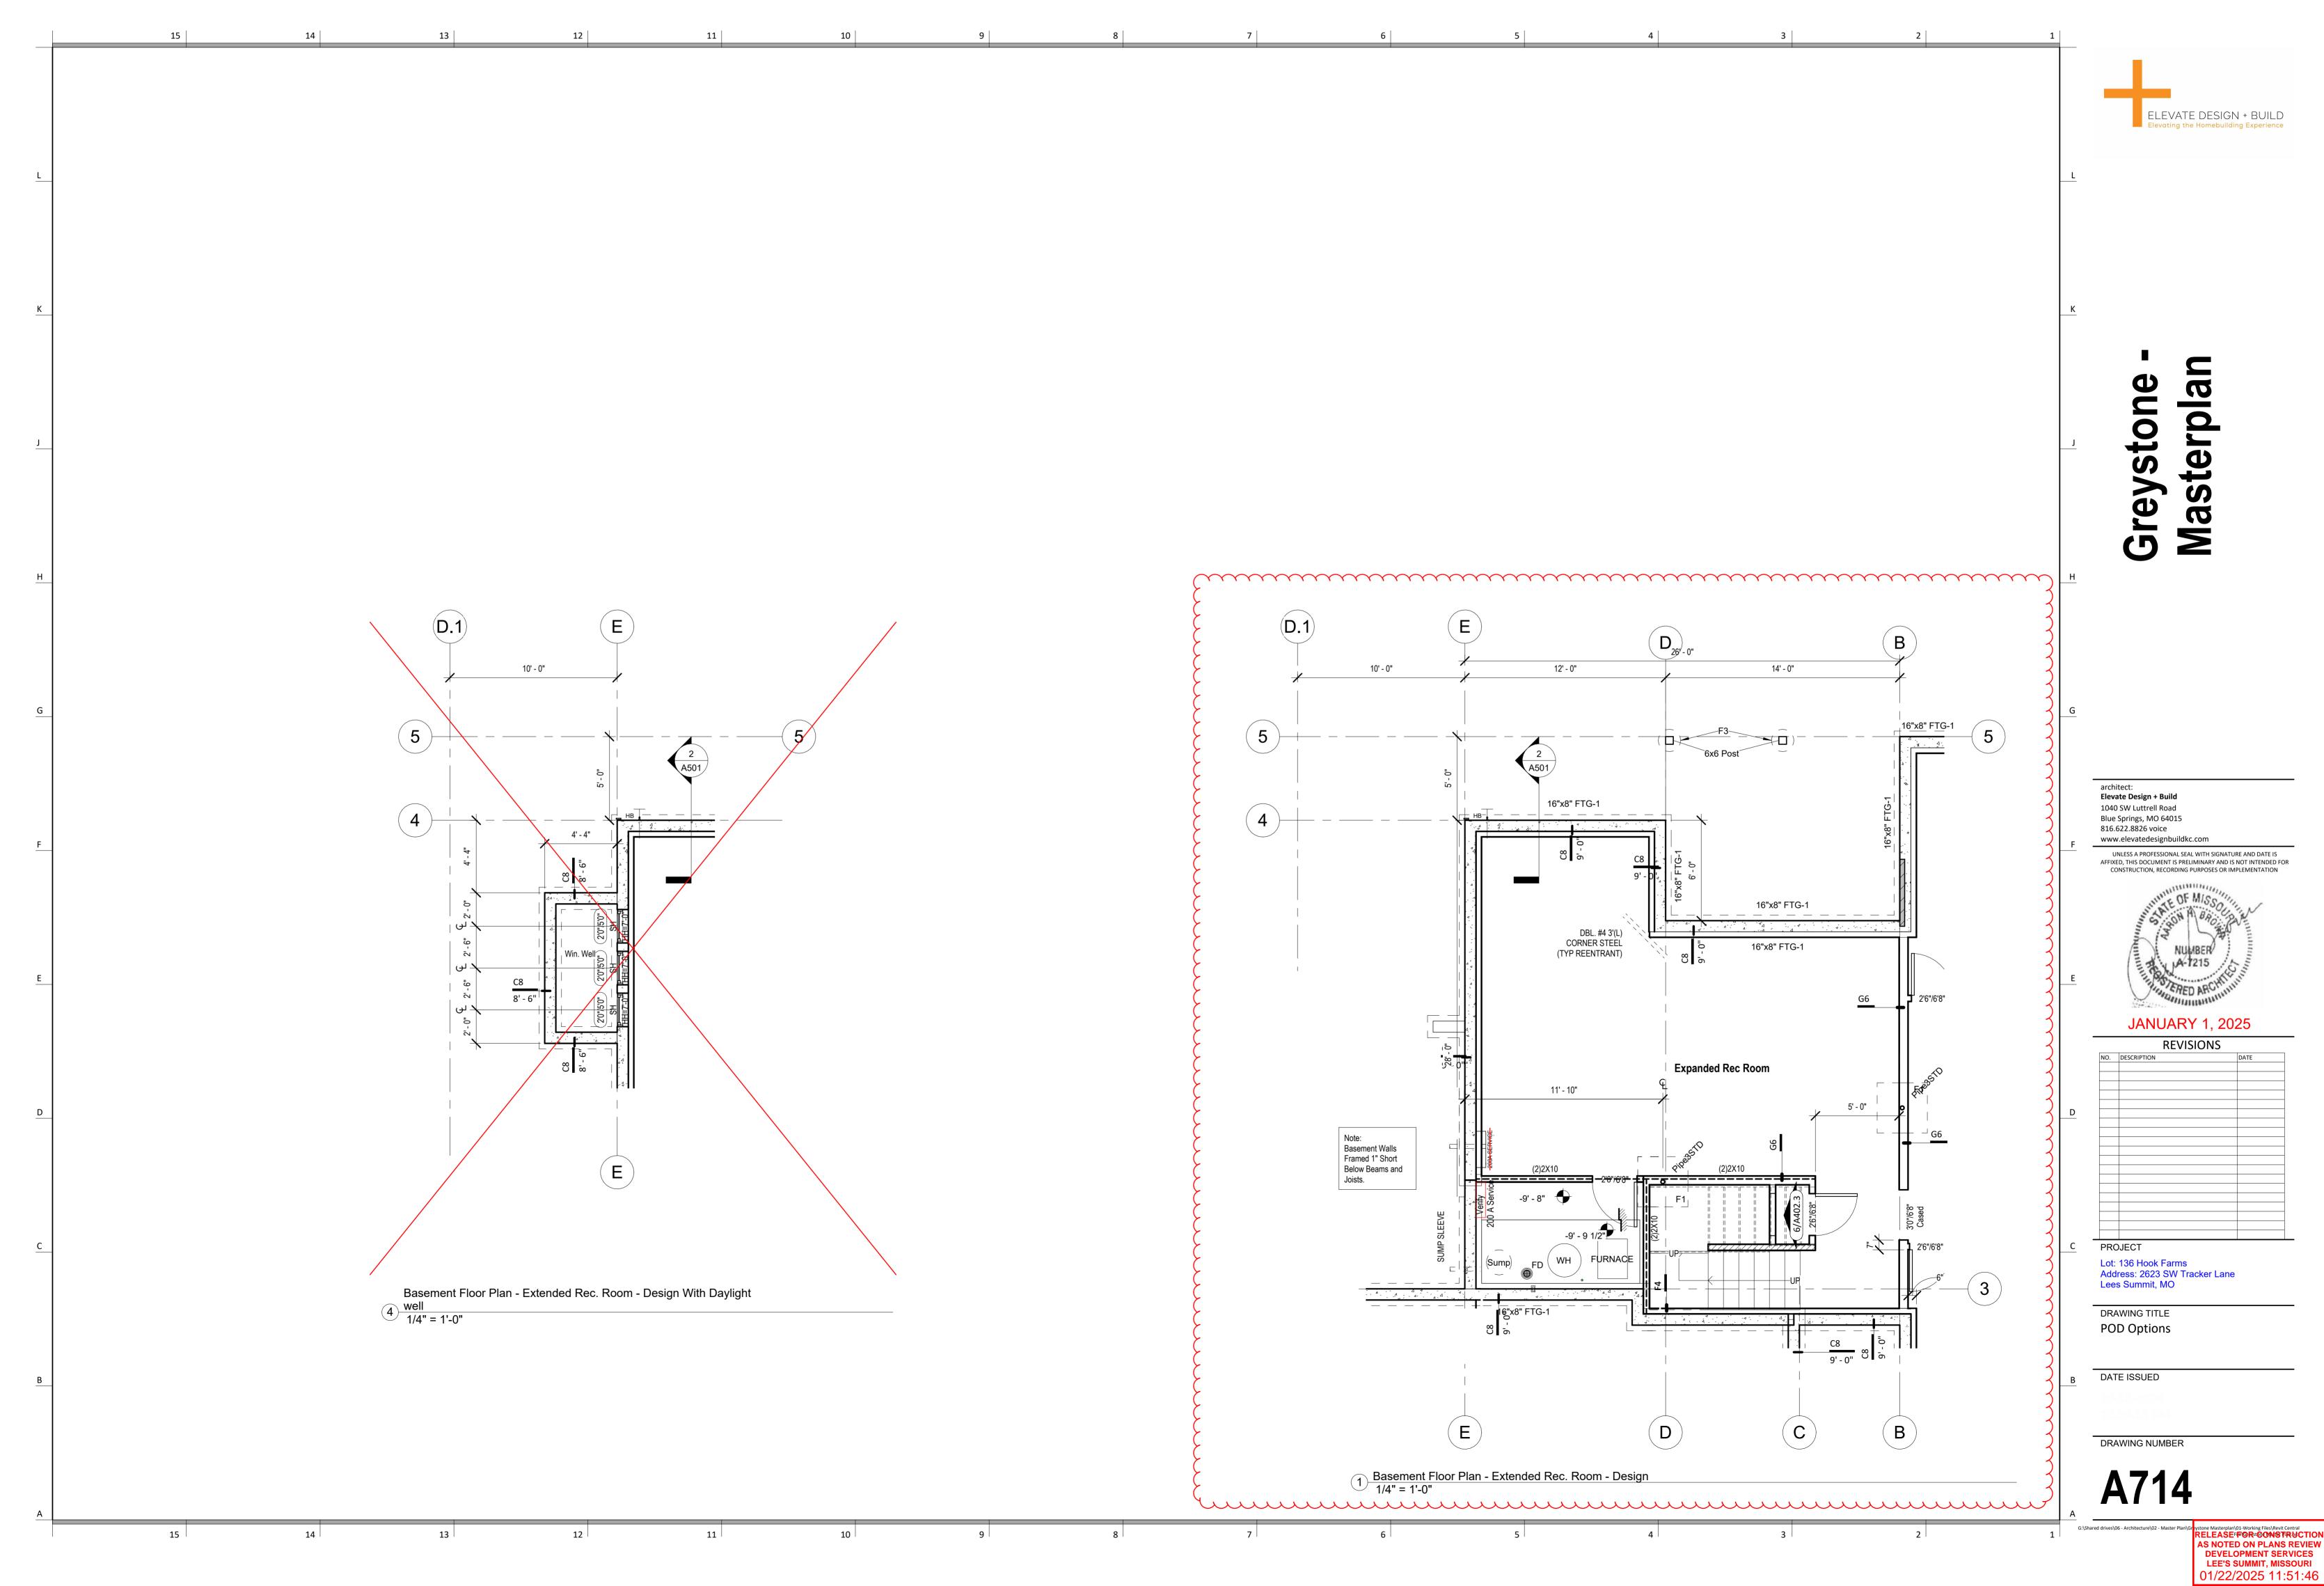


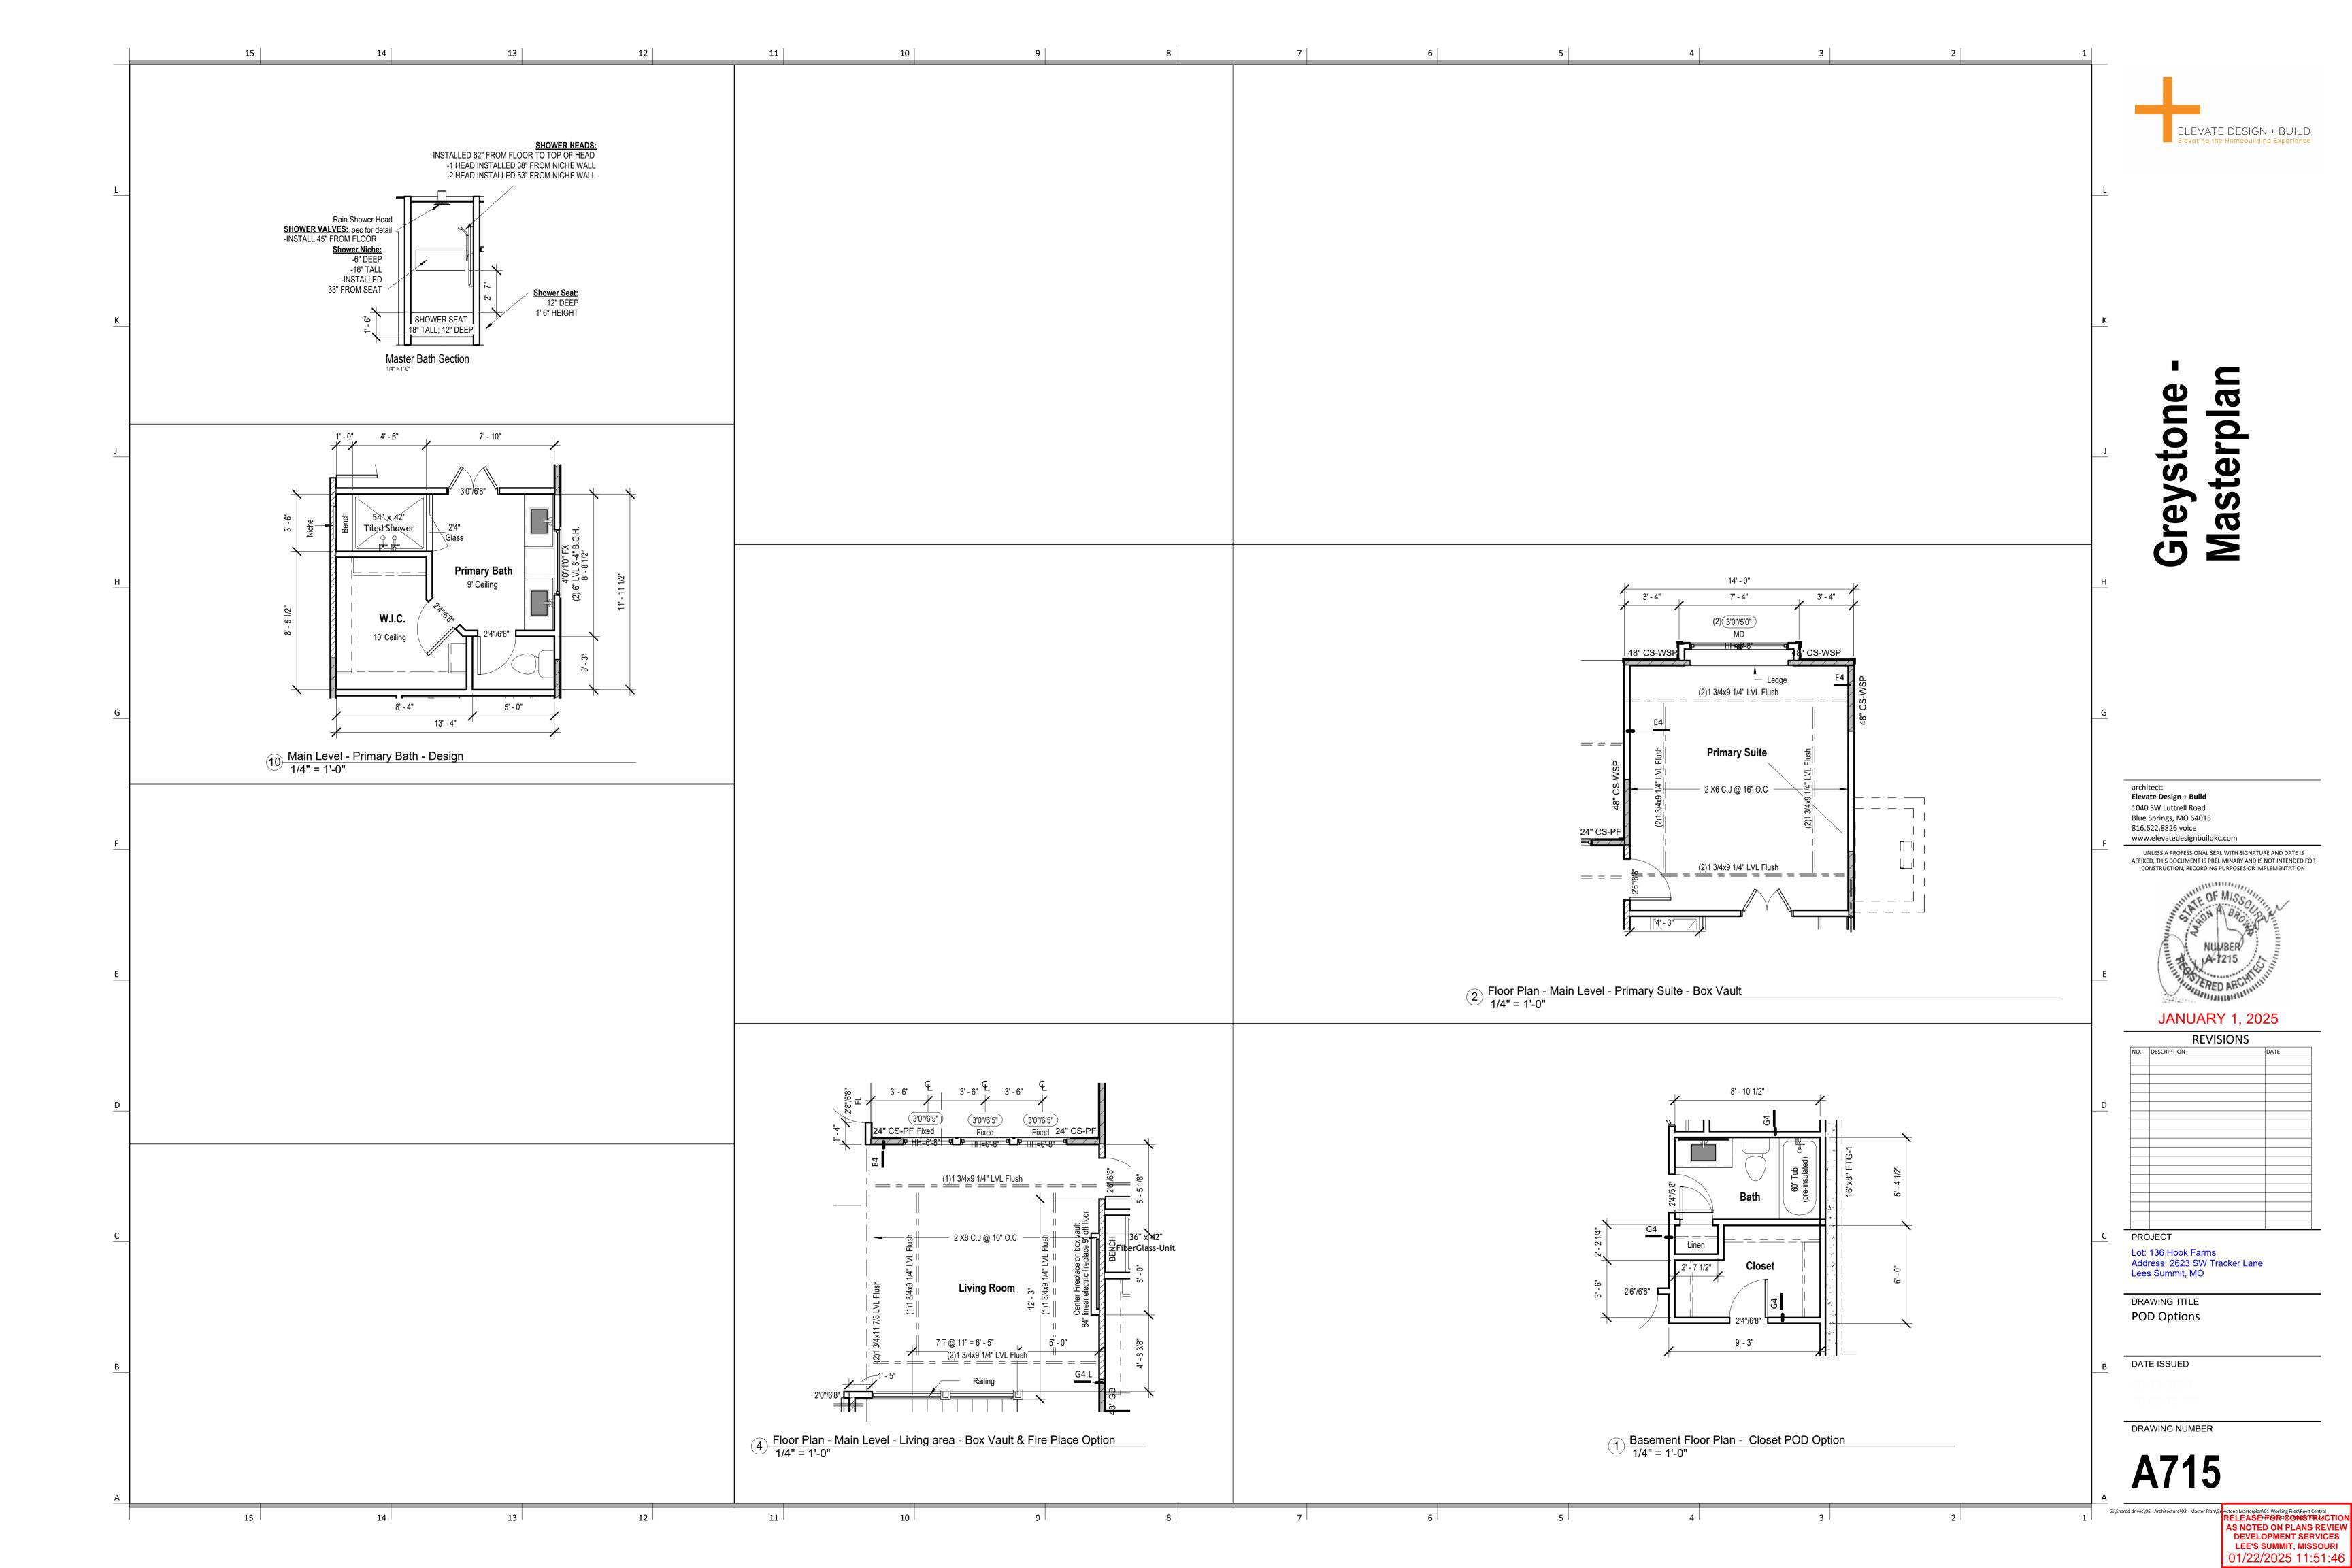
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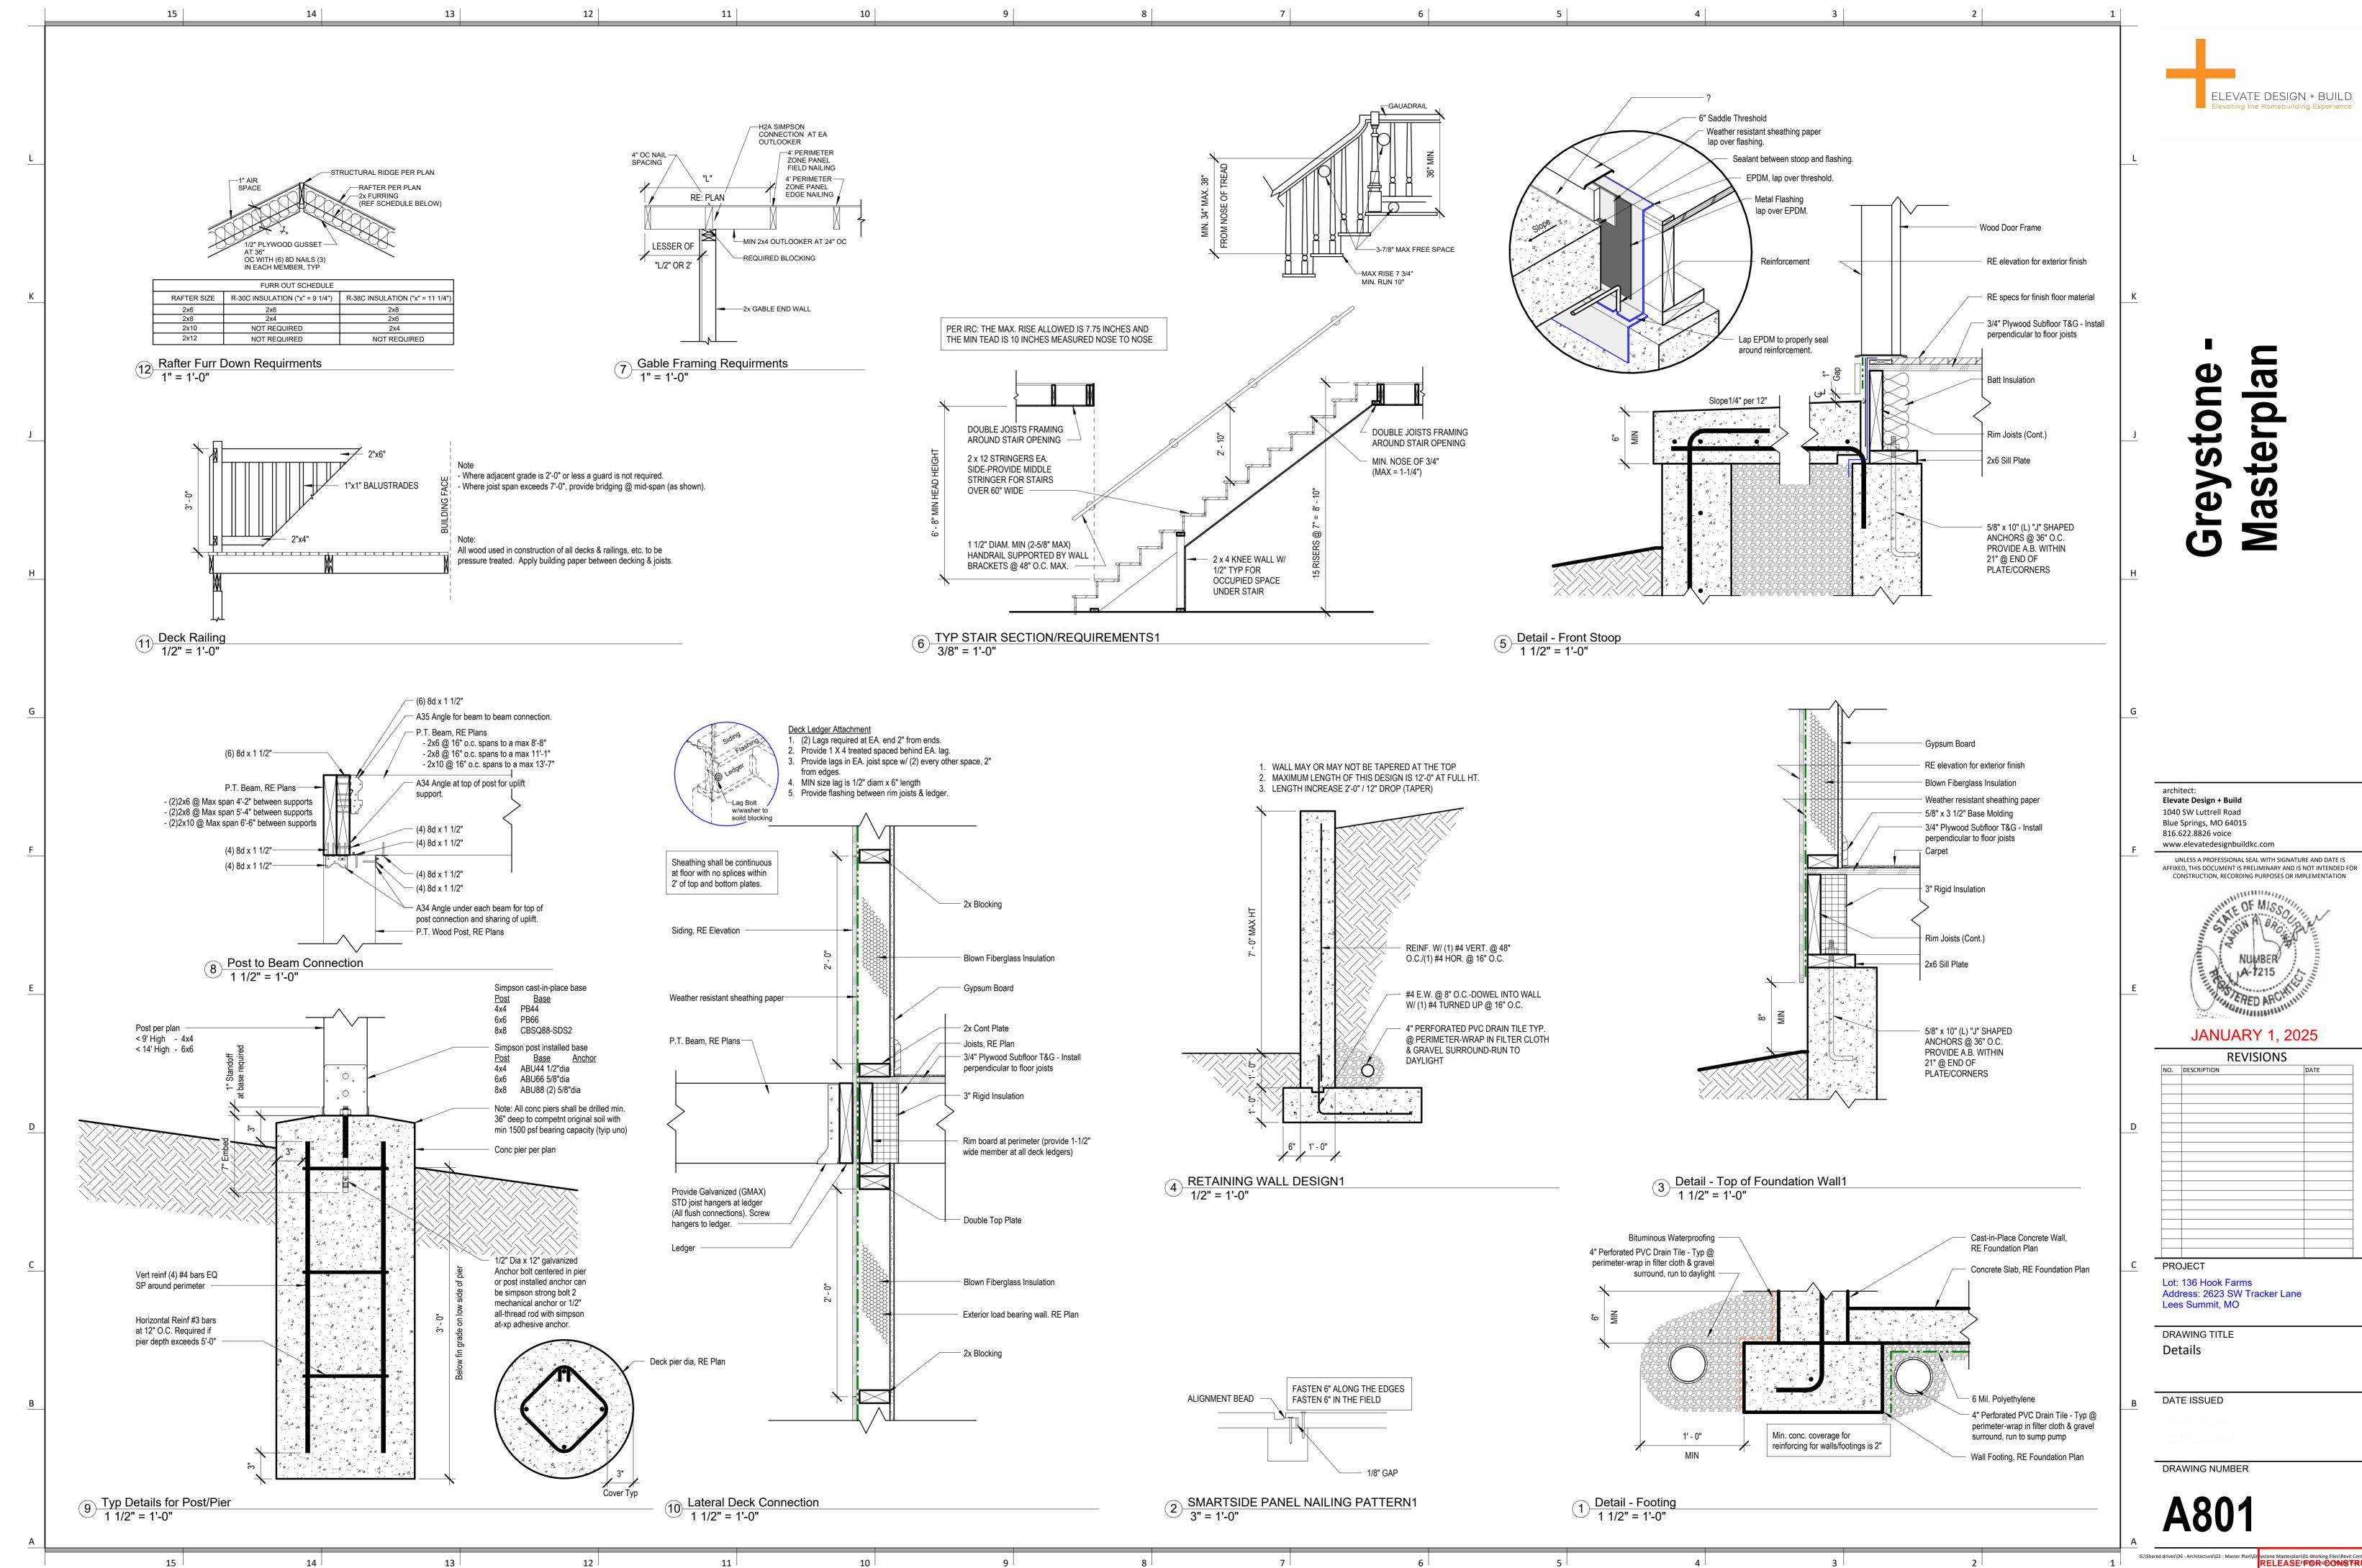










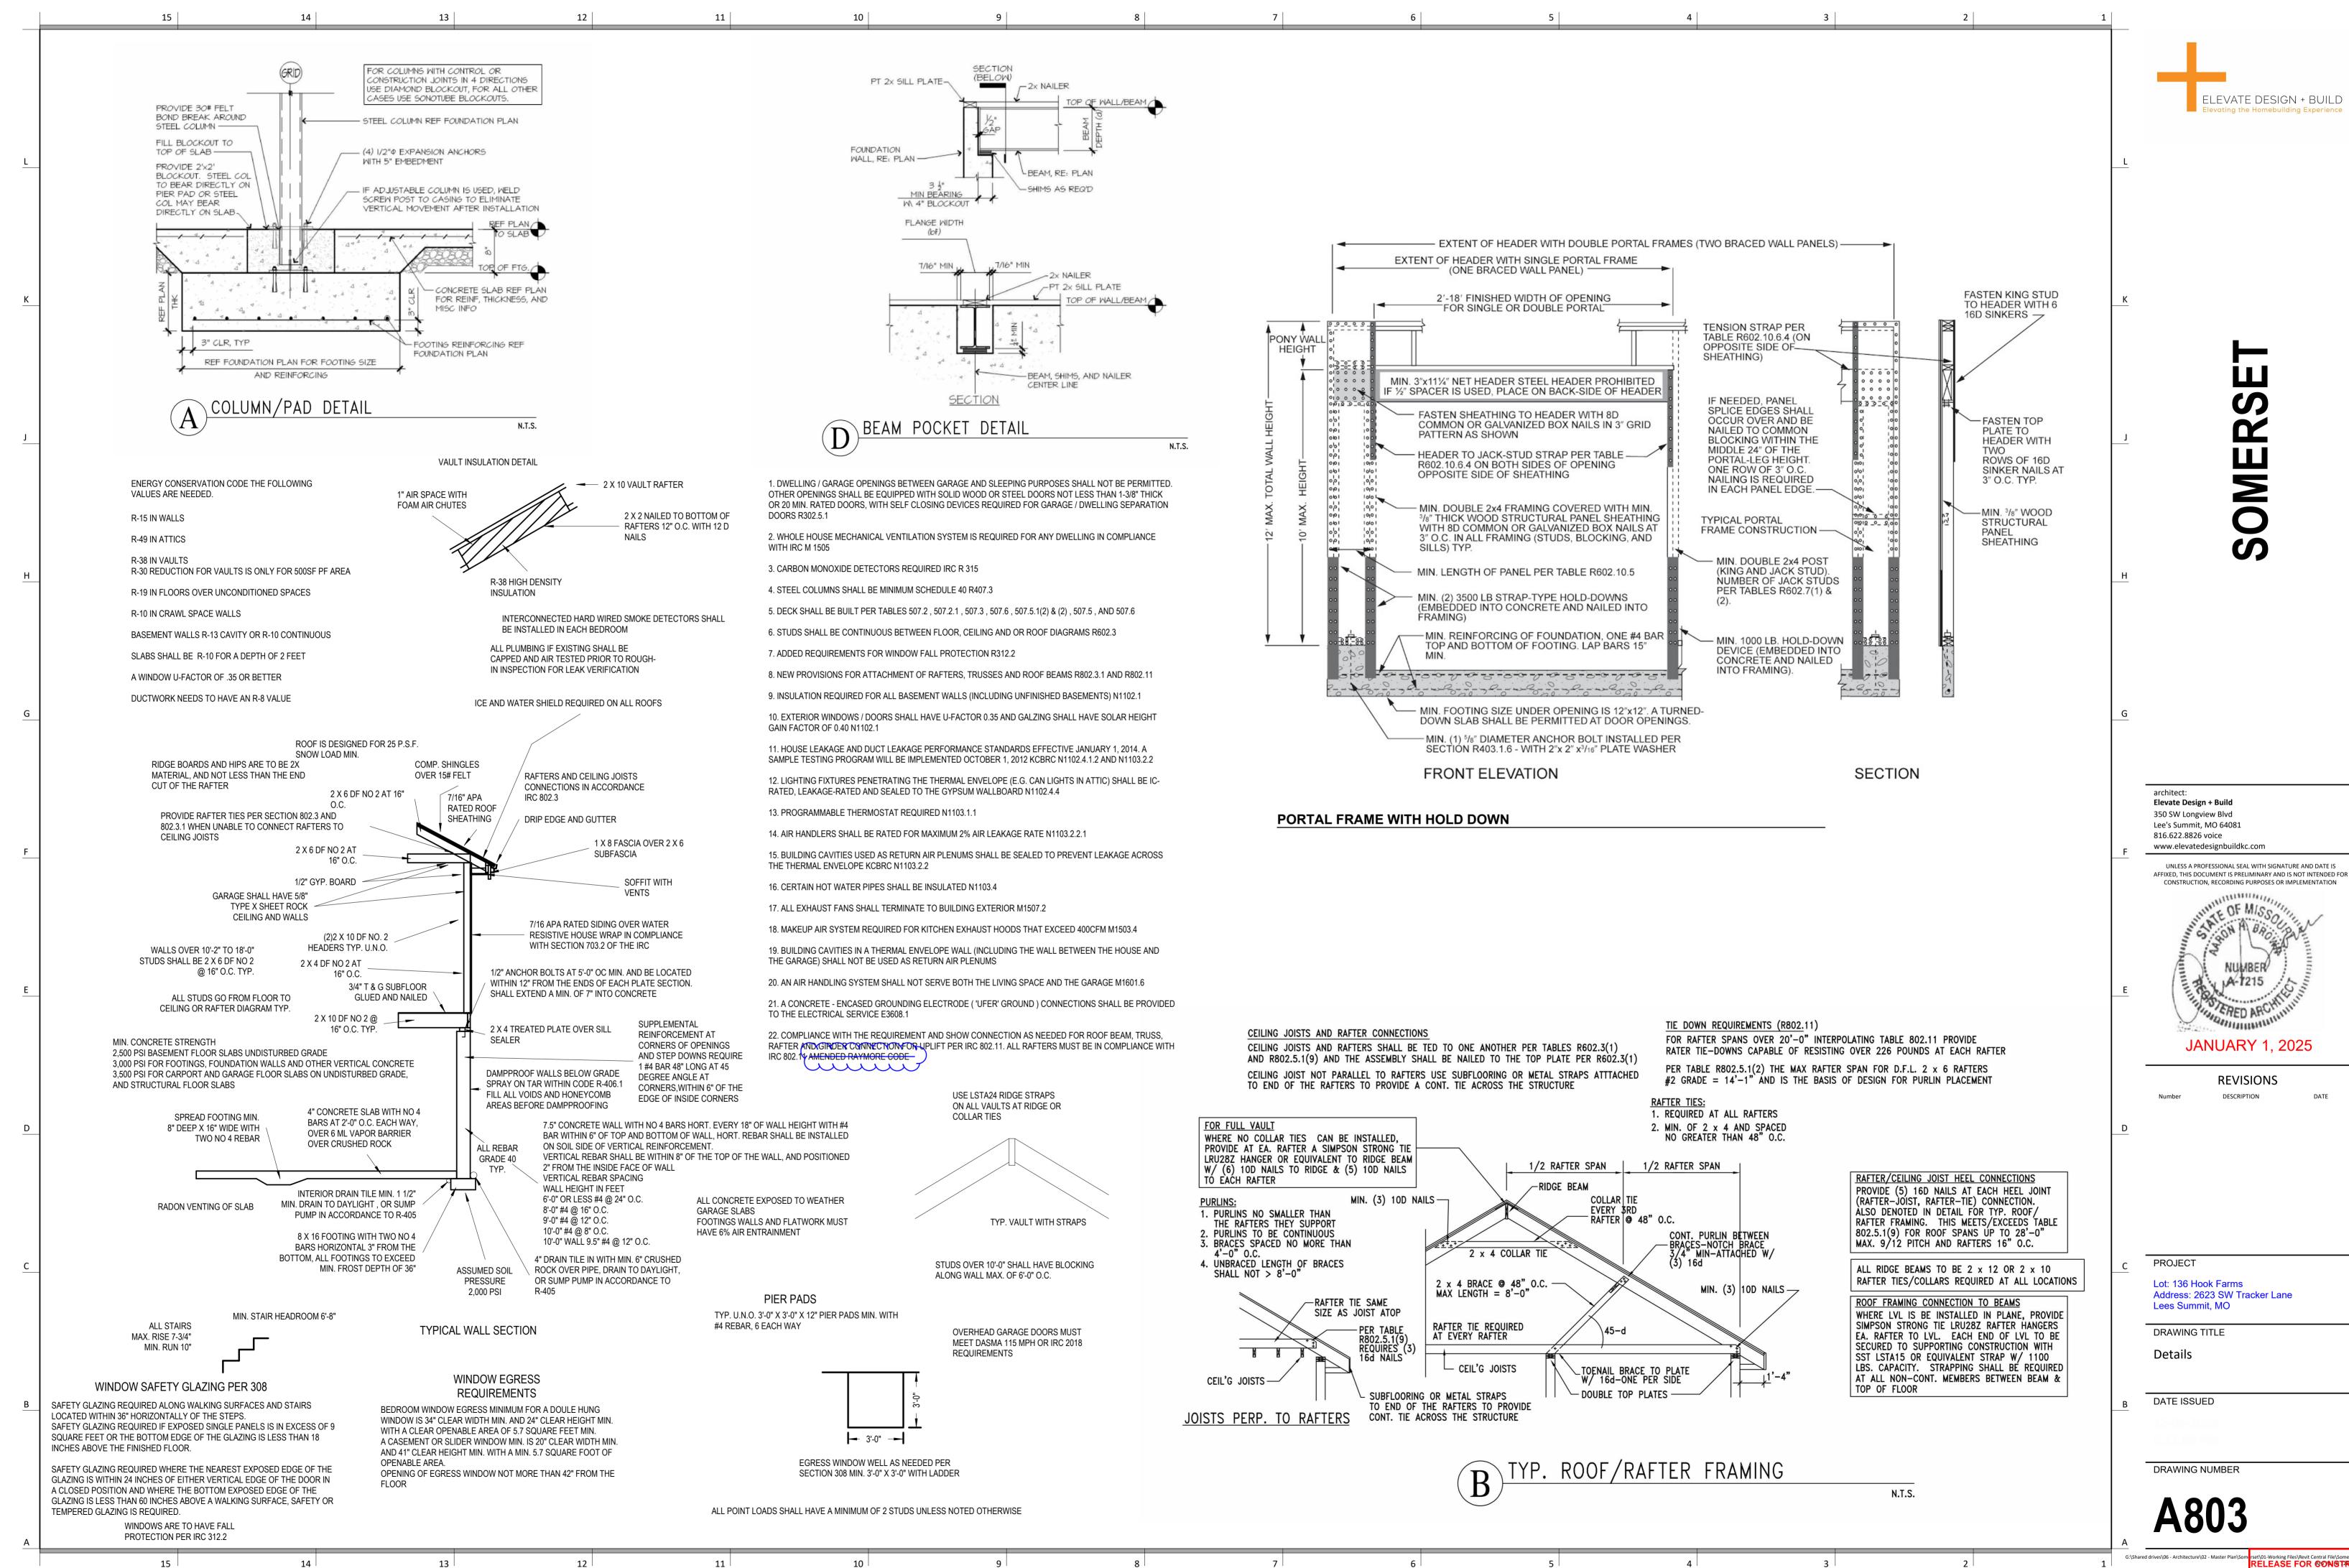


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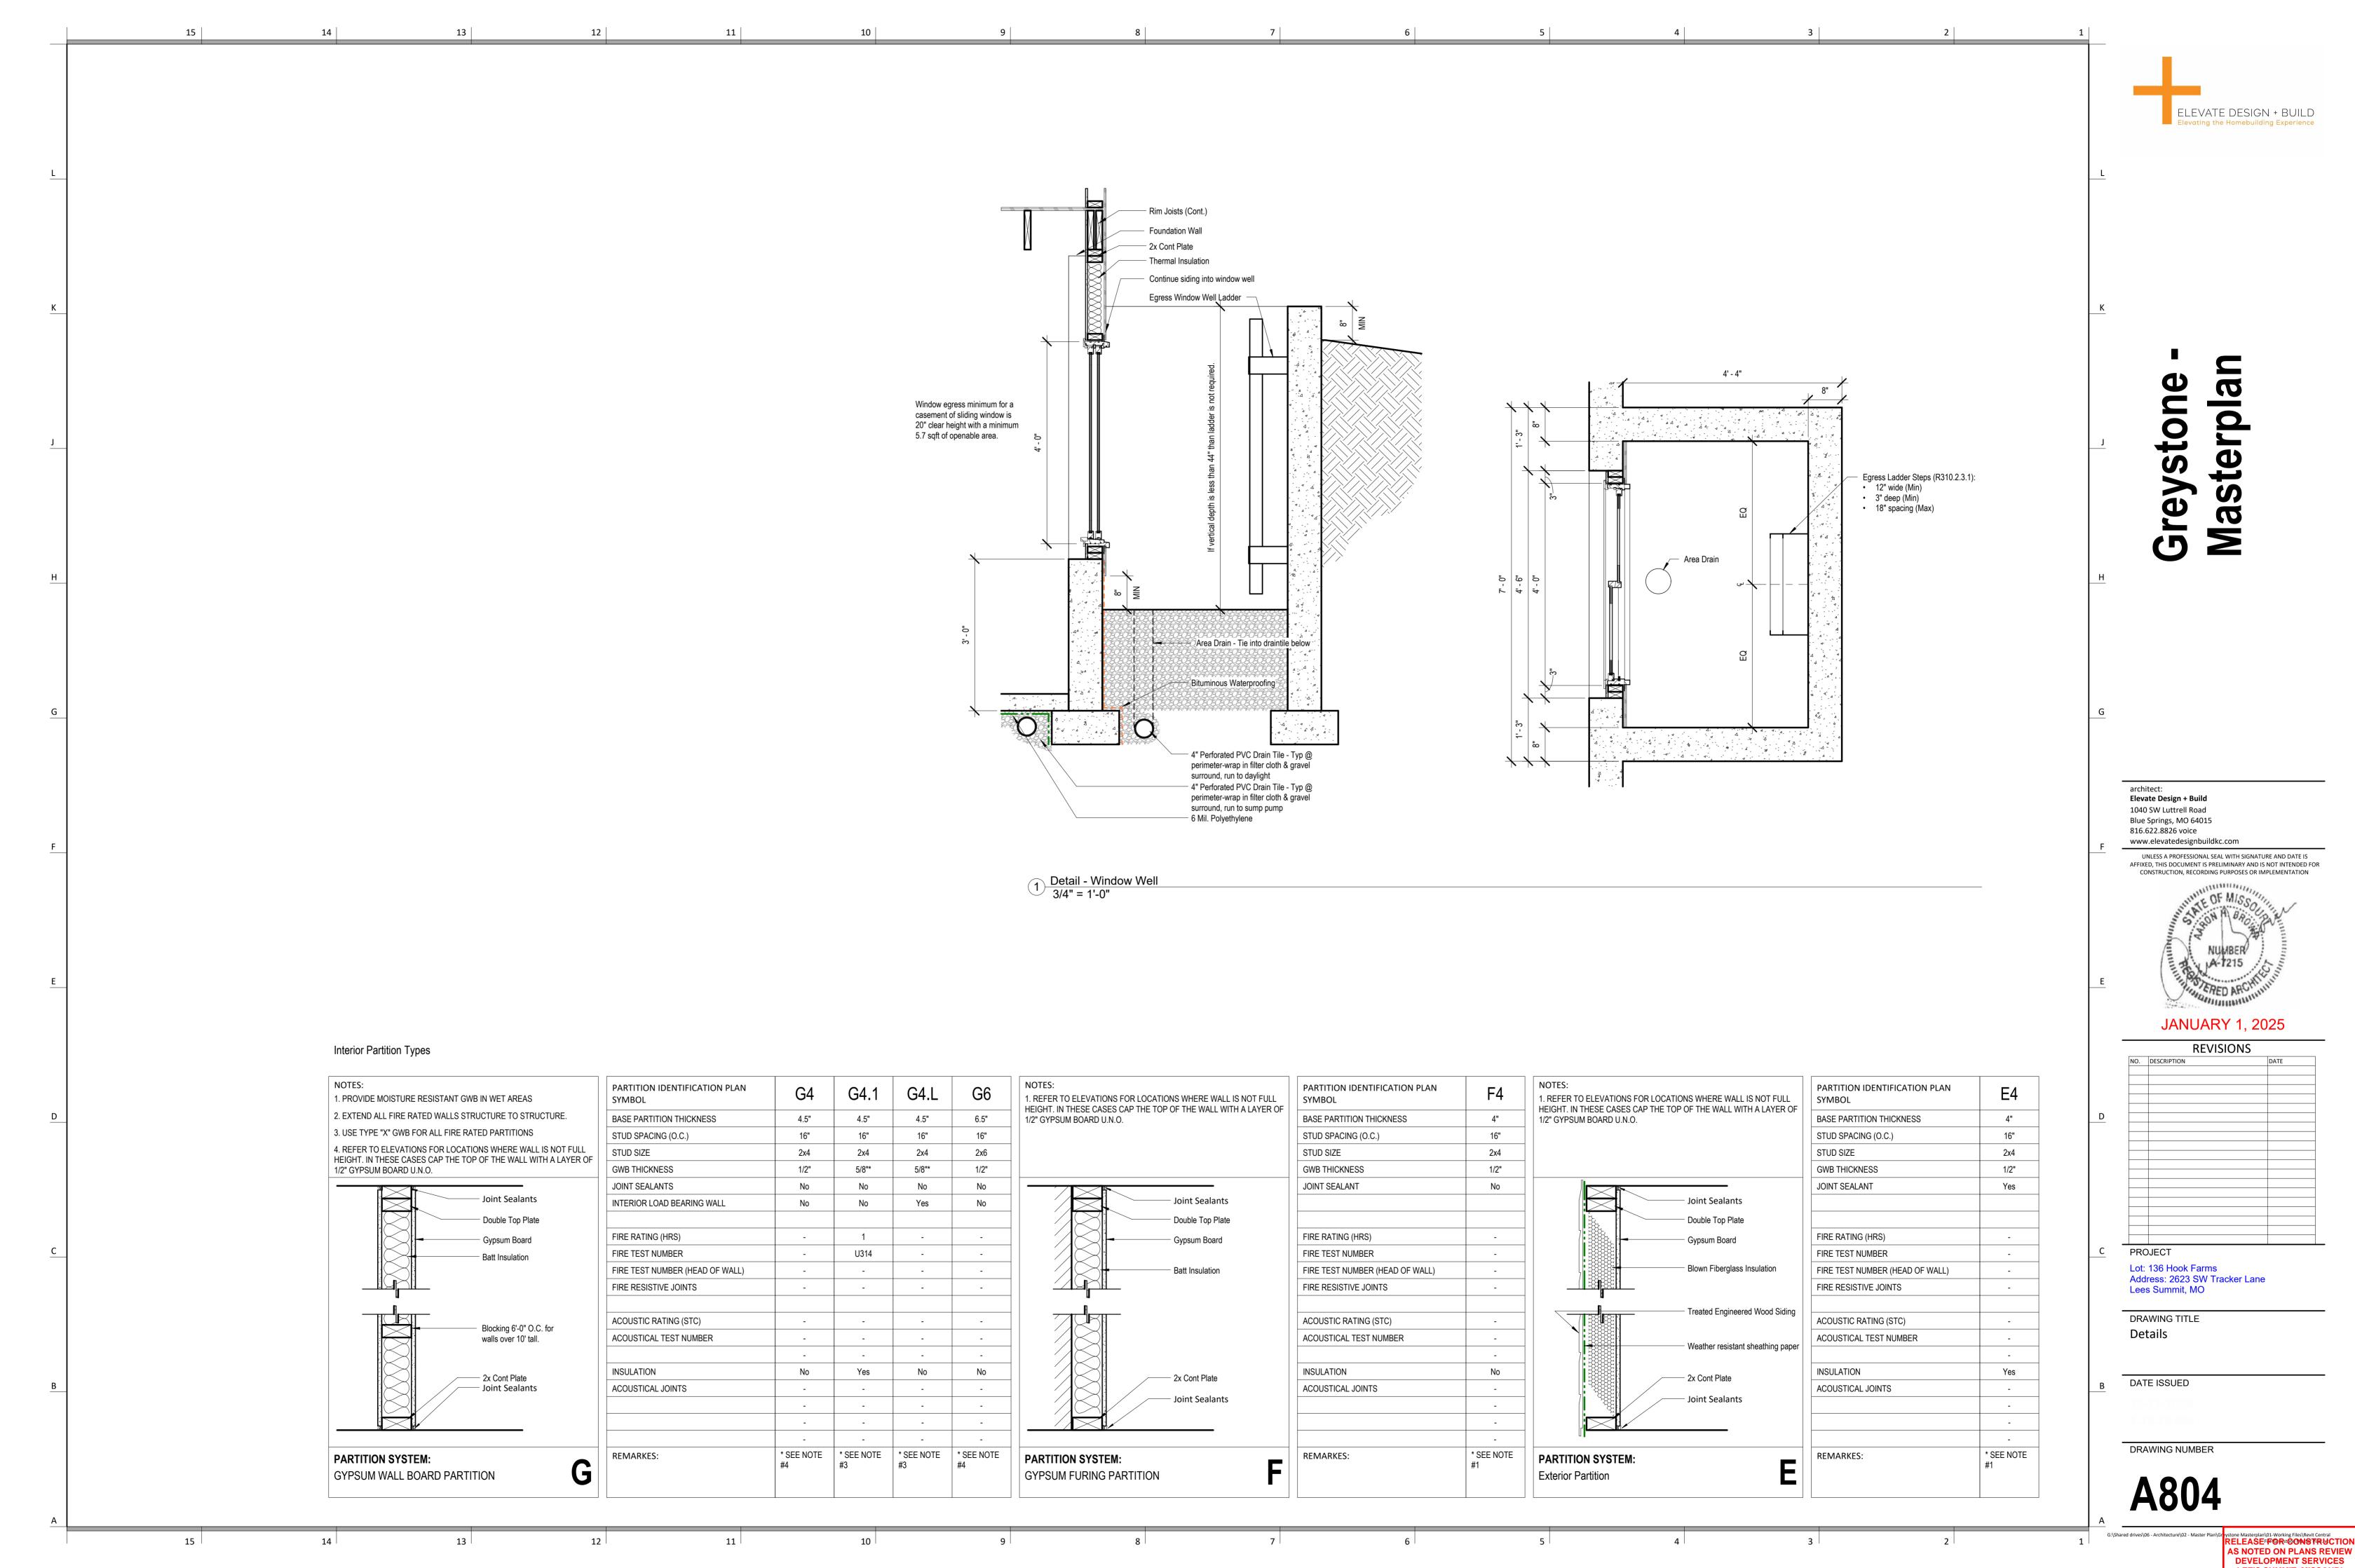
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