REVISIONS:

1 05/17/2024 CITY RESPONSE 2 06/14/2024 CITY & BRAND RESPONSE 4 09/13/2024 BRAND RESPONSE

HOME2 SUITES BY HILTON LEE'S SUMMIT, MO

PROJECT CERTIFICATION

I, (David E. Hendrikse), hereby specify pursuant to the governing requirements of the state, that the documents intended to be authenticated by my seal are

G-00 I	G-201	G-30 I	A-105	A-202	A-40 I	A-30 I	A-702
G-002	G-202	G-302	A-106	A-203	A-402	A-502	A-703
G-003	G-203	G-303	A-107	A-300	A-403	A-503	A-704
G-004	G-204	AS-100	A-120	A-301	A-404	A-504	A-705
G-005	G-205	AS-101	A-121	A-302	A-405	A-600	A-706
G-006	G-206	AS-102	A-122	A-303	A-406	A-601	A-707
G-007	G-207	AS-103	A-123	A-304	A-407	A-602	A-708
G-100	G-208	A-101	A-124	A-305	A-408	A-603	A-710
G-101	G-209	A-102	A-125	A-306	A-410	A-604	A-711
G-102	G-210	A-103	A-200	A-307	A-415	A-700	A-715
G-103	G-300	A-104	A-201	A-400	A-500	A-701	

and I hereby disclaim any responsibility for all other plans, specifications, reports or other documents or instruments relating to or intended to be used for any part or parts of the architectural or engineering project or survey.

SEAL




DAVID E. HENDRIKSE, AIA

REGIONAL MAP



VICINITY MAP

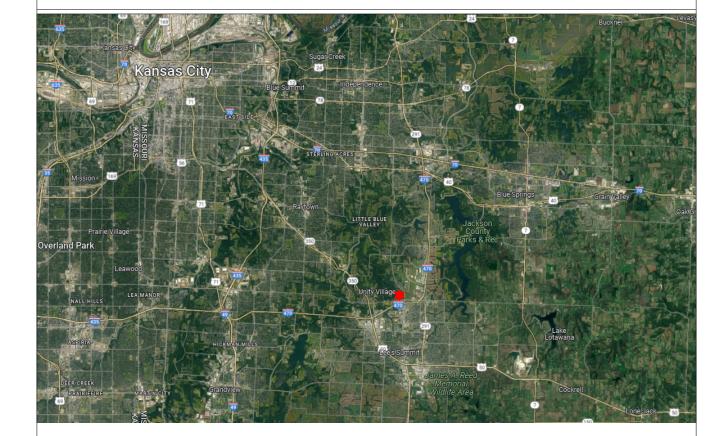

HOME2 SUITES BY HILTON 251 NE ALURA WAY LEE'S SUMMIT, MISSOURI 64064

GENERAL					
	Sheet Issue Date	Sheet Number	Sheet Name	Rev.	Current Revision Date
•	04/17/24	G-001	TITLE SHEET	4	09/13/2024
•	04/17/24	G-002	GENERAL INFORMATION		
	04/17/24	G-003	PLAN GENERAL NOTES & KEYNOTES		
•	04/17/24	G-004	GENERAL INFORMATION		
•	04/17/24	G-005	GENERAL INFORMATION		
•	04/17/24	G-006	GENERAL INFORMATION		
	04/17/24	G-007	GENERAL INFORMATION		
	04/17/24	G-100	CODE ANALYSIS	1	05/17/2024
	04/17/24	G-101	CODE ANALYSIS		
•	04/17/24	G-102	PARTITION ASSEMBLIES		
	04/17/24	G-103	ASSEMBLIES - FLOOR/CEILING		
•	04/17/24	G-201	UL ASSEMBLIES - D916 / G566		
•	04/17/24	G-202	UL ASSEMBLIES - L546		
•	04/17/24	G-203	UL ASSEMBLIES - L546		
	04/17/24	G-204	UL ASSEMBLIES - P545		
•	04/17/24	G-205	UL ASSEMBLIES - P545 / U301		
	04/17/24	G-206	UL ASSEMBLIES - U301 / U305		
•	04/17/24	G-207	UL ASSEMBLIES - U305		
	04/17/24	G-208	UL ASSEMBLIES - U415		
•	04/17/24	G-209	UL ASSEMBLIES - U415 / X790		
	04/17/24	G-210	UL ASSEMBLIES - U905		
	04/17/24	G-300	ACCESSIBILITY STANDARDS		
	04/17/24	G-301	ACCESSIBILITY STANDARDS		
	04/17/24	G-302	ACCESSIBILITY STANDARDS		
	04/17/24	G-303	ACCESSIBILITY STANDARDS		
	04/17/24	AS-100	AMENITIES PLAN		
	04/17/24	AS-101	ARCHITECTURAL SITE AMENITIES		
-	04/17/24		ARCHITECTURAL SITE AMENITIES	3	06/27/2024
	04/17/24	AS-103	ARCHITECTURAL SITE AMENITIES		

IVIL UNDER SEPARATE REVIEW,	REFERENCE FDP
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		Cl	VIL UNDER SEPARATE REVIEW, REFERENCE FDP		
			STRUCTURAL		
	Sheet Issue Date	Sheet Number	Sheet Name	Rev.	Current Revision
•	04/17/24	S001	GENERAL NOTES	1	05/17/202
	04/17/24	S002	GENERAL NOTES	1	05/17/202
•	04/17/24	S003	GENERAL NOTES		
•	04/17/24	S004	STRUCTURAL SPECIAL INSPECTIONS	1	05/17/202
•	04/17/24	S005	SCHEDULES	1	05/17/202
•	04/17/24	S099	EXTERIOR FOUNDATION WALL AND SLAB-ON-GRADE DIMENSION PLAN		
•	04/17/24	S100	FOUNDATION PLAN	1	05/17/202
•	04/17/24	S101	LEVEL 2 FRAMING PLAN	2	06/14/202
•	04/17/24	S102	LEVEL 3 FRAMING PLAN	2	06/14/202
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•	04/17/24	S402	ENLARGED VIEWS	2	06/14/202
	04/17/24	S501	TYPICAL FOUNDATION DETAILS		
•	04/17/24	S502	FOUNDATION DETAILS	1	05/17/202
•	04/17/24	S503	FOUNDATION DETAILS	2	06/14/202
•	04/17/24	S504	FOUNDATION DETAILS		
•	04/17/24	S505	FOUNDATION PEDESTAL DETAILS	1	05/17/202
•	04/17/24	S510	STEEL DETAILS	1	05/17/202
•	04/17/24	S511	STEEL DETAILS	1	05/17/202
	04/17/24	S512	ENTRY CANOPY SECTIONS	1	05/17/202
•	04/17/24	S520	MASONRY DETAILS	1	05/17/202
•	04/17/24	S531	TYPICAL WOOD DETAILS	1	05/17/202
•	04/17/24	S532	FLOOR FRAMING DETAILS		
•	04/17/24	S533	FLOOR FRAMING DETAILS	2	06/14/202
•	04/17/24	S534	FLOOR FRAMING DETAILS	2	06/14/202
•	04/17/24	S535	FLOOR FRAMING DETAILS	2	06/14/202
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•	04/17/24	S541	ROOF DETAILS	1	05/17/202
	04/17/24	S542	ROOF DETAILS	2	06/14/202
•	04/17/24	S550	SHEAR WALL DETAILS	1	05/17/202

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_	04/17/24	A-101	FIRST FLOOR PLAN	1	05/17/2024
-	04/17/24	A-102	SECOND FLOOR PLAN	1	05/17/2024
	04/17/24	A-103	THIRD FLOOR PLAN	2	06/14/2024
-	04/17/24	A-104	FOURTH FLOOR PLAN	2	06/14/2024
_	04/17/24	A-105	ROOF PLAN	+-	
-	04/17/24	A-106	ROOF VENT CALCULATIONS & DETAILS	+	
	04/17/24	A-107	ROOFING & FLASHING DETAILS	+	
_	04/17/24	A-120	FIRST FLOOR REFLECTED CEILING PLAN	2	06/14/2024
_	04/17/24	A-121	SECOND FLOOR REFLECTED CEILING PLAN	2	06/14/2024
-	04/17/24	A-122	THIRD FLOOR REFLECTED CEILING PLAN	2	06/14/2024
_	04/17/24	A-123	FOURTH FLOOR REFLECTED CEILING PLAN	2	06/14/2024
-	04/17/24	A-123	ENLARGED REFLECTED CEILING PLAN - INDOOR POOL	2	06/14/2024
-	04/17/24	A-124	CEILING DETAILS	-	00/14/2024
_	04/17/24	A-123	EXTERIOR ELEVATIONS	+	
	04/17/24	A-200	EXTERIOR ELEVATIONS	+	
-	04/17/24	A-201	EXTERIOR COLOR ELEVATIONS	2	06/14/2024
_	04/17/24	A-202 A-203	EXTERIOR COLOR ELEVATIONS	2	06/14/2024
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_	04/17/24	A-300	BUILDING SECTIONS	_	
	04/17/24	A-301	BUILDING SECTIONS	_	
_	04/17/24	A-302	WALL SECTIONS	_	
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_	04/17/24	A-304	ELEVATOR SECTIONS & DETAILS	1	05/17/2024
_	04/17/24	A-305	STAIR #1 SECTION & DETAILS	2	06/14/2024
_	04/17/24	A-306	STAIR #2 SECTION & DETAILS	2	06/14/2024
	04/17/24	A-307	FRONT CANOPY PLAN / ELEV. / SECTION / & DETAILS	1	05/17/2024
	04/17/24	A-400	KING ONE BEDROOM SUITE	2	06/14/2024
	04/17/24	A-401	KING ONE BEDROOM SUITE - ACCESSIBLE	2	06/14/2024
_	04/17/24	A-402	KING ONE BEDROOM SUITES - ELEVATIONS	2	06/14/2024
	04/17/24	A-403	KING STUDIO SUITE	2	06/14/2024
	04/17/24	A-404	KING STUDIO SUITE - CONNECTOR	2	06/14/2024
•	04/17/24	A-405	KING STUDIO SUITE - ACCESSIBLE	2	06/14/2024
•	04/17/24	A-406	QUEEN QUEEN STUDIO SUITE	2	06/14/2024
•	04/17/24	A-407	QUEEN QUEEN STUDIO SUITE - CONNECTOR	2	06/14/2024
	04/17/24	A-408	QUEEN QUEEN STUDIO SUITE - ACCESSIBLE	2	06/14/2024
	04/17/24	A-410	ENLARGED FLOOR PLAN - COMMON AREAS	2	06/14/2024
	04/17/24	A-415	UNIT DETAILS		
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	04/17/24	A-501	DETAILS	1	05/17/2024
	04/17/24	A-502	DETAILS		
_	04/17/24	A-503	DETAILS	_	
•	04/17/24	A-504	ELEVATOR & CMU DETAILS	_	
-	04/17/24	A-600	WINDOW / DOOR / FINISH SCHEDULES	2	06/14/2024
_	04/17/24	A-601	STOREFRONT ELEVATIONS	2	06/14/2024
-	04/17/24	A-602	DOOR DETAILS	2	06/14/2024
	04/17/24	A-603	DOOR DETAILS	+-	00/11/2021
-	04/17/24	A-604	WINDOW DETAILS	+-	
-	04/17/24	A-700	GUESTROOM BATHROOMS	+	
-	04/17/24	A-700	GUESTROOM BATHROOMS	2	06/14/2024
	04/17/24	A-701	PUBLIC RESTROOMS	2	06/14/2024
_	04/17/24	A-702 A-703	INTERIOR ELEVATIONS	+-	00/14/2024
-				-	06/44/2024
_	04/17/24	A-704	INTERIOR ELEVATIONS	2	06/14/2024
	04/17/24	A-705	ENLARGED INTERIOR ELEVATIONS	4	09/13/2024
_	04/17/24	A-706	ENLARGED INTERIOR ELEVATIONS	₩	
_	04/17/24	A-707	ENLARGED INTERIOR ELEVATIONS		
	04/17/24	A-708	ENLARGED INTERIOR ELEVATIONS	_	
	04/17/24	A-710	FINISH PLANS-COMMON SPACES	2	06/14/2024
	04/17/24	A-711	FINISH PLANS-COMMON SPACES	2	06/14/2024
_	04/17/24	A-715	FINISH TRANSITION DETAILS		

ARCHITECTURAL

■ 04/17/24 MEP2 SITE UTILITIES PLAN 1 05/17/2024 ■ 04/17/24 MEP3 SITE LIGHTING PLAN ■ 04/17/24 | MEP4 | MEP PLAN - ROOF 2 06/14/2024 ■ 04/17/24 M101 HVAC PLAN - FIRST FLOOR 2 06/14/2024

	04/17/24	M104	HVAC PLAN - FOURTH FLOOR		
•	04/17/24	M501	HVAC DETAILS		
•	04/17/24	M601	HVAC SCHEDULES	2	06/14/2024
			ELECTRICAL		
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•	04/17/24	EP101	POWER PLAN - FIRST FLOOR	2	06/14/2024
•	04/17/24	EP102	POWER PLAN - SECOND FLOOR	2	06/14/2024
	04/17/24	EP103	POWER PLAN - THIRD FLOOR	2	06/14/2024
	04/17/24	EP104	POWER PLAN - FOURTH FLOOR	2	06/14/2024
•	04/17/24	EP401	ENLARGED POWER PLAN - GUEST ROOMS	4	09/13/2024
•	04/17/24	EL101	LIGHTING PLAN - FIRST FLOOR	2	06/14/2024
•	04/17/24	EL102	LIGHTING PLAN - SECOND & THIRD FLOORS	2	06/14/2024
	04/17/24	EL103	LIGHTING PLAN - FOURTH FLOOR	2	06/14/2024
•	04/17/24	EL401	ENLARGED LIGHTING PLAN - GUEST ROOMS	2	06/14/2024
•	04/17/24	FS101	FIRE ALARM AND SECURITY PLAN - FIRST FLOOR	4	09/13/2024
•	04/17/24	FS102	FIRE ALARM AND SECURITY PLAN - SECOND FLOOR		
•	04/17/24	FS103	FIRE ALARM AND SECURITY PLAN - THIRD FLOOR		
•	04/17/24	FS104	FIRE ALARM AND SECURITY PLAN - FOURTH FLOOR		
•	04/17/24	E501	ELECTRICAL DETAILS & SCHEDULES	2	06/14/2024
•	04/17/24	E601	ELECTRICAL SCHEDULES		

■ 04/17/24 M102 HVAC PLAN - SECOND FLOOR ■ 04/17/24 M103 HVAC PLAN - THIRD FLOOR

■ 04/17/24 E602 ELECTRICAL SCHEDULES

■ 04/17/24 E603 ELECTRICAL SCHEDULES

■ 04/17/24 E604 ELECTRICAL SCHEDULES

PROJECT DATA

NEW CONSTRUCTION:	
ZONING:	PMIX - PLANNED MIXED USE DISTRICT
CODE:	
	2018 INTERNATIONAL BUILDING CODE
	2018 INTERNATIONAL PLUMBING CODE
	2018 INTERNATIONAL MECHANICAL CODE
	2018 INTERNATIONAL FUEL GAS CODE
	2018 INTERNATIONAL FIRE CODE
	2017 NATIONAL ELECTRIC CODE
	2009 ACCESSIBILITY CODE ICC/ANSI 117-1

LEE'S SUMMIT AMENDMENTS TO ENERGY CODE

CEILINGS AS PART OF BLDG ENVELOPE R-30

NFPA 72 & NFPA 13 / 13R R-1, HOTEL TRANSIENT OCCUPANCY GROUP: A-2, UNCONCENTRATED A-4, SWIMMING POOL

PROJECT DESIGN INFORMATION

	B, BACK OF HOUSE	
TYPE OF CONSTRUCTION:	TYPE VA	
ENERGY CONSERVATION:	WALLS AS PART OF BLDG ENVELOPE FLOORS AS PART OF BLDG ENVELOPE	R-11 R-19
	ROOFS AS PART OF BLDG ENVELOPE	R-19

BUILDING SUMMARY:

DING SUMMARY:		
NUMBER: HEIGHT:	1 TOTAL BUIL 4 STORIES, 4	
ARE FOOTAGES:	<u>GROSS</u>	<u>NET</u>
FIRST ELOOP	16 402 S E	16 070 C E

SECOND FLOOR 14,828 S.F. 14,828 S.F. 14,529 S.F. THIRD FLOOR FOURTH FLOOR 14,828 S.F. 14,529 S.F.

107 TOTAL UNITS

ACCESSIBLE UNITS

UNIT SUMMARY:

(2) UN	NITS - ACC. KIN NITS - ACC KINO NITS - ACC. QUI	STUDIO	
(4) UN	NITS - KING STU	JDIO	
	NITS - KING STU		TING
	NITS - KING ONI		
(3) UN	NITS - QUEEN C	UEEN STUDIC)
	NITS - QUEEN C		

TYPE 'B' UNITS

(4) UNITS - (3) UNITS - (9) UNITS -	S - KING STUDIO - KING STUDIO CONNECTING - KING ONE BEDROOM - QUEEN QUEEN STUDIO - QUEEN QUEEN CONNECTING S
CBOSS	NET

TOTAL UNITS

SQUARE FOOTAGE:	<u>GROSS</u>	<u>NET</u>
KING STUDIO KING STUDIO CON. ACC. KING STUDIO KING ONE BED ACC. KING ONE BED QUEEN QUEEN STUDIO	380 S.F. 380 S.F. 600 S.F. 576 S.F. 628 S.F. 474 S.F.	350 S.F. 350 S.F. 555 S.F. 534 S.F. 581 S.F. 439 S.F.
QUEEN QUEEN CON.	456 S.F.	422 S.F.
ACC. QUEEN QUEEN	600 S.F.	562 S.F.

SITE SUMMARY:

REFERENCE CIVIL FOR SITE INFORMATION

NOTE: SQUARE FOOTAGE

■ 04/17/24 P501 PLUMBING DETAILS ■ 04/17/24 P601 PLUMBING SCHEDULES

2 06/14/2024

-GROSS - COMMON SPACE CALCULATION: OUTSIDE PERIMETER OF STUD (ENTIRE <u>-GROSS - UNIT CALCULATION:</u> CENTERLINE OF PARTY WALL TO OUTSIDE OF EXTERIOR STUD WALL AND/OR OUTSIDE OF CORRIDOR STUD WALL. -NET - PAINT-TO-PAINT AT PERIMETER, TAKEN FROM INSIDE OF DEMISING, EXTERIOR, AND CORRIDOR WALLS.

PROJECT TEAM

	OWNER	
INTRINSIC DEVELOPMENT		/ELOPMENT
	ADDRESS:	3622 ENDEAVOR AVE., STE. 101
		COLUMBIA, MO 65201
	CONTACT:	BRIAN MAENNER
	EMAIL:	bpmaenner@intrinsicdevelopment.co
	PHONE:	573.881.0280

ARCHITECT

CONTRACTOR

INTRINSIC DEVEL	OPMENT
ADDRESS:	3622 ENDEAVOR AVE., STE.

	COLUMBIA, MO 65201
ONTACT: MAIL: HONE:	BRIAN MAENNER bpmaenner@intrinsicdevelopment.com 573.881.0280

STRUCTURAL ENGINEER

ADDRESS: CONTACT:	1901 PENNSYLVANIA DRI COLUMBIA MO 65202 CELESTE SPICKERT
EMAIL:	cspickert@mcclurevision.co

MECHANICAL, ELECTRICAL, PLUMBING **ENGINEER**

2400 BLUFF CREEK DRIVE, SUITE 101

	COLUMBIA, MO 65201
CONTACT:	ANDREW WHITE
EMAIL:	andrew@j-squaredeng.com
PHONE:	573.234.4492

CIVIL ENGINEER

CROCKETT ENGINEERING CONSULTANTS 1000 W NIFONG BLVD., BLDG 1 COLUMBIA, MO 65203

CONTACT: TIM CROCKETT tim@crockettengineering.com EMAIL: PHONE: 573.447.0292


LANDSCAPE ARCHITECT

CROCKETT ENGINEERING CONSULTANTS	
ADDRESS:	1000 W NIFONG BLVD., BLDG 1
	COLUMBIA, MO 65203
CONTACT:	TIM CROCKETT

CONTACT:	TIM CROCKET I
EMAIL:	tim@crockettengineering.com
PHONE:	573.447.0292

PLUMBING 4 09/13/2024 ■ 04/17/24 PS101 SANITARY SEWER PLAN - FIRST FLOOR ■ 04/17/24 PS102 SANITARY SEWER PLAN - SECOND FLOOR ■ 04/17/24 PS103 SANITARY SEWER PLAN - THIRD FLOOR 2 06/14/2024 ■ 04/17/24 PS104 SANITARY SEWER PLAN - FOURTH FLOOR 2 06/14/2024 ■ 04/17/24 PW101 WATER & GAS PLAN - FIRST FLOOR 2 06/14/2024 ■ 04/17/24 PW102 WATER & GAS PLAN - SECOND FLOOR 2 06/14/2024 ■ 04/17/24 PW103 WATER & GAS PLAN - THIRD FLOOR ■ 04/17/24 PW104 WATER & GAS PLAN - FOURTH FLOOR 2 06/14/2024

2 06/14/2024

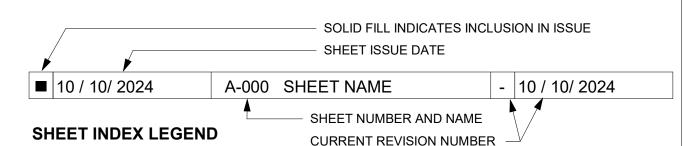


& REVISION DATE ON SHEET

 \Box HOME2

TITLE SHEET

PROJECT NUMBER: 22023

SHEET NUMBER:

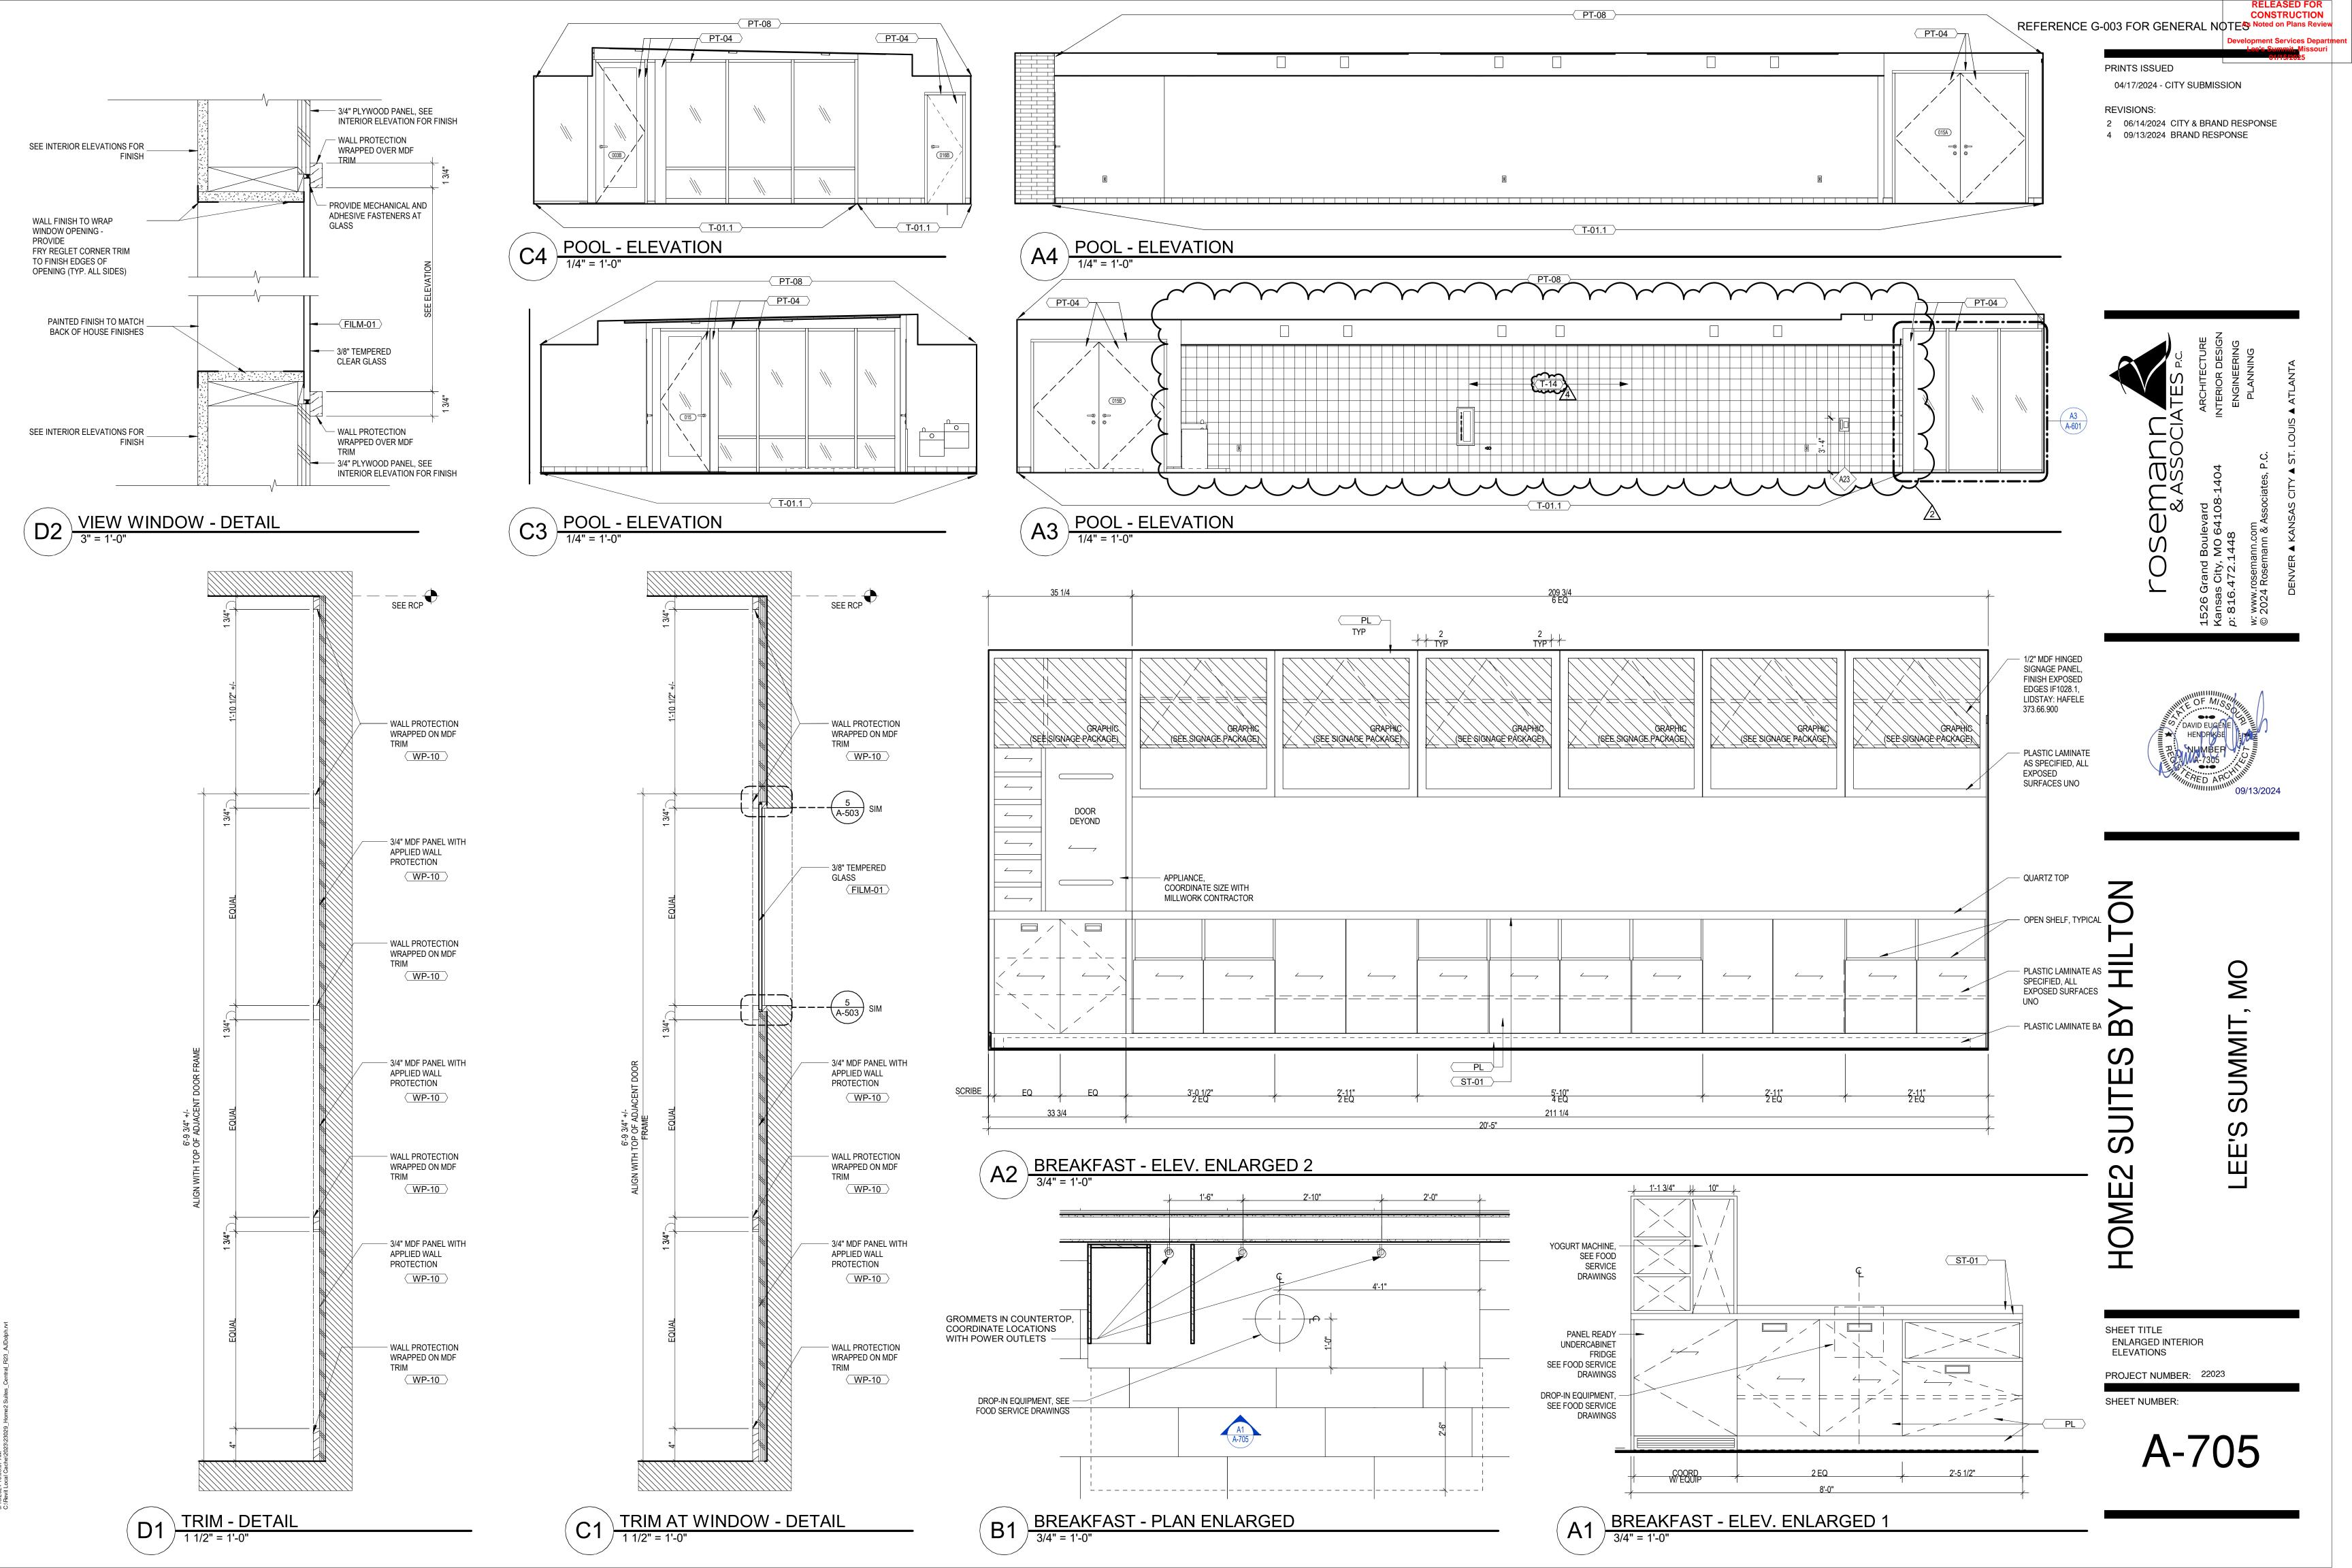

JUNCTION BOX RECEPTACLE

─ "WP" = WEATHERPROOF OUTDOOR RECEPTACLE

"AW" = ABOVE WINDOW RECEPTACLE "AC" = ABOVE CEILING RECEPTACLE "IG" = ISOLATED GROUND

GFCI DUPLEX CONVENIENCE RECEPTACLE

WITH USB-A & USB-C CHARGING PORT

DATA / PHONE JACK BOX WITH 1" CONDUIT WITH CAT-6

WIRELESS ACCESS POINT, CEILING MOUNTED

WIRELESS ACCESS POINT, WALL MOUNTED

DISCONNECT FUSED DISCONNECT ADDRESSABLE SMOKE DETECTOR WITH SOUNDER BASE;

CIRCUIT WIRING —> PX-XX CIRCUIT TAG

INDICATES MOUNTING HEIGHT TO BOTTOM OF BOX (STANDARD @ 18" AFF UNLESS NOTED OTHERWISE)

208V RECEPTACLE

QUADPLEX CONVENIENCE RECEPTACLE

(STANDARD @ 18" AFF UNLESS NOTED OTHERWISE)

FLOOR RECEPTACLE

FLOOR DATA

(ALARM SIGNAL MAY BE SUPERVISORY)

POWER PLAN GENERAL NOTES:

SEE E500 & E600 SERIES SHEET FOR ADDITIONAL ELECTRICAL NOTES, DETAILS, & SCHEDULES.

COMPLETE (1) UNIT OF EACH TYPE & OBTAIN OWNER'S APPROVAL BEFORE PROCEEDING TO OTHERS. DO NOT INSTALL OUTLETS BACK-TO-BACK EVEN IF ASSOCIATED WITH DIFFERENT SYSTEM. OFFSET BOXES TO

PREVENT SOUND PASS-THRU AT ADJACENT UNIT WALLS. 4. COORDINATE LOCATION OF SWITCH & RECEPTACLES IN GUEST ROOM BATHROOMS WITH MIRROR, VANITY

BACK-SPLASH, TOWEL HOLDER, ETC.

COORDINATE ALL ELECTRICAL DEVICE MOUNTING HEIGHTS & LOCATIONS WITH ARCHITECTURAL PLANS. 6. DOORBELL AND FIRE ALARM STROBES ARE ONLY REQUIRED IN HEARING IMPAIRED ROOMS.

POWER PLAN KEY NOTES:

1) TV CONNECTIONS FOR FREE-TO-GUEST CONTENT: COAX CABLE BEHIND TV, CAT6 RJ-45 JACK BEHIND TV (RUN IN SMURF TUBE IN WALL TO WAP UNDER DESK), & PATCH CORD TO EDGE CONTROLLER FOR CONNECTED ROOM (MIN. 6" CLEARANCE FROM WALL BOXES). VISIT HILTONHDTV.COM FOR ADDITIONAL INFORMATION.

(2) EACH CABLE MUST HOMERUN BETWEEN THE GUESTROOM AND THE IDF ON EACH FLOOR. VISIT CONNECTEDROOM.HILTON.COM FOR CURRENT REQUIREMENTS AND OPTIONS.

) Wired data connection for guest use: Patch cable terminated above desk from Wap Port; COORDINATE ROUTING & DETAILS WITH G.C.

(4) WAP IN 3-GANG BOX MOUNTED VERTICALLY UNDER DESK. MAINTAIN 6" BETWEEN ALL BOXES, TYP ALL GUESTROOMS. COORDINATE WAP LOCATION WITH CASEGOODS TO AVOID CONFLICTS. VISIT CONNECTEDROOM.HILTON.COM FOR CURRENT WIRELESS INTERNET REQ'S AND LIST OF APPROVED

(5) WIRED THERMOSTAT FOR PTAC. MOUNTED 48" MAX TO TOP OF DEVICE. COMMUNICATION BETWEEN THERMOSTAT AND PTAC MAY BE WIRELESS.

6 SWITCH CONTROLLING GARBAGE DISPOSAL GANGED WITH DUPLEX - REFER TO HADG FOR ACCESSIBLE ROOM REQUIREMENTS.

7) DEDICATED CIRCUIT FOR DISHWASHER

(8) EXTEND J-BOX, DEVICE & COVER PLATE FLUSH W/ MILLWORK BACK PANEL.

9 DEDICATED CIRCUIT FOR GARBAGE DISPOSAL.

ARCHITECTURAL PLANS FOR LOCATIONS.

(10) OUTLET FOR MICROWAVE. REFER TO ARCHITECTURAL PLAN ROOM ELEVATIONS FOR MOUNTING HEIGHT. MOUNT DEVICE HORIZONTALLY (EXCEPT IN ACCESSIBLE UNITS); FACE PLATE TO BE WHITE.

(11) DOORBELL ON/OFF SWITCH (COMMUNICATION FEATURES ROOMS ONLY) SIGNAGE AS REQ'D.

(12) ADDITIONAL HORN STROBE: LOCATED IN COMMUNICATION FEATURES BATHROOMS ONLY. REFER TO


(13) FIRE HORN IN STANDARD ROOMS. FIRE HORN/STROBE IN COMMUNICATION FEATURES ROOMS. REFER TO ARCHITECTURAL PLANS FOR LOCATIONS.


(14) SWITCHES CONTROLLING MECHANICAL SHADES - REFER TO FFE MANUAL.


(15) REFER TO OVERALL ELECTRICAL PLANS FOR PANEL DETAILS ('PXXX').


(16) RECEPTACLE MOUNTED HORIZONTALLY ABOVE CLOSET.

(17) QUAD RECEPTACLE WITH A MINIMUM (1) USB RECEPTACLE(S) (EITHER -A OR -C).

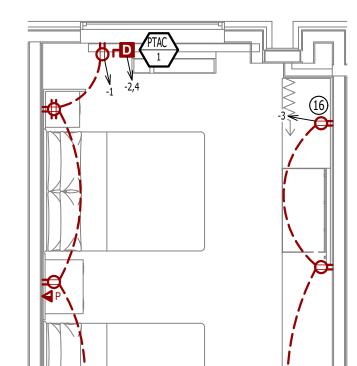

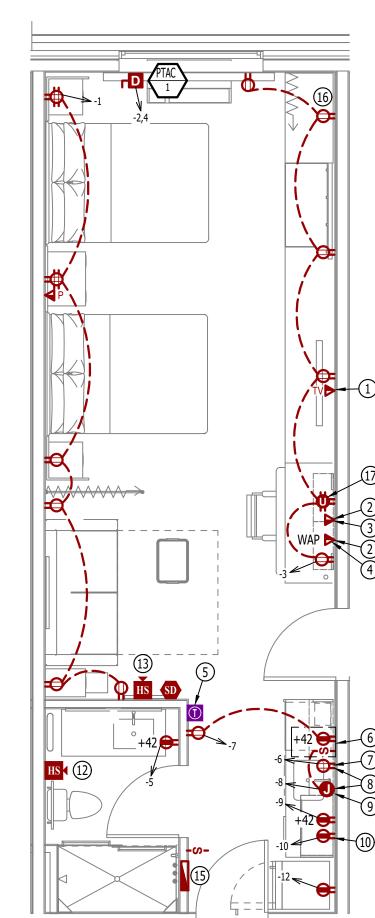

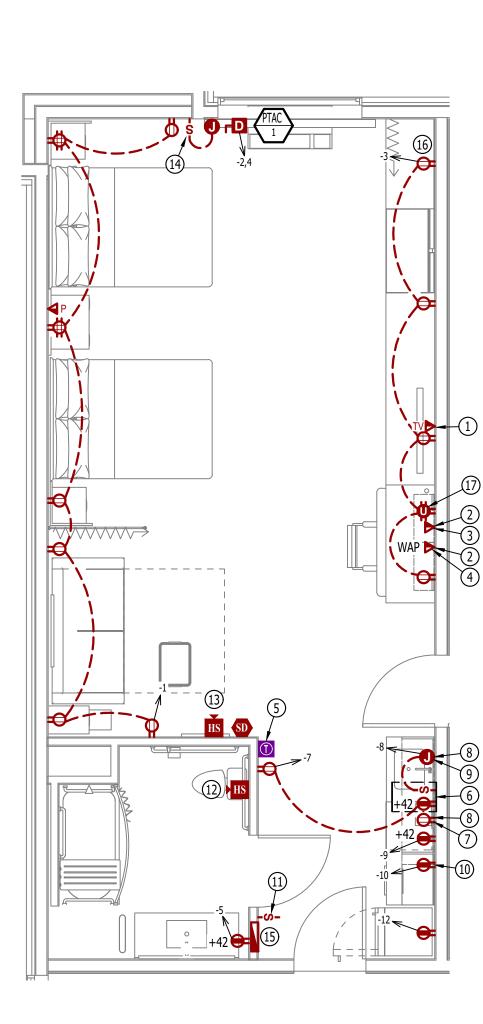

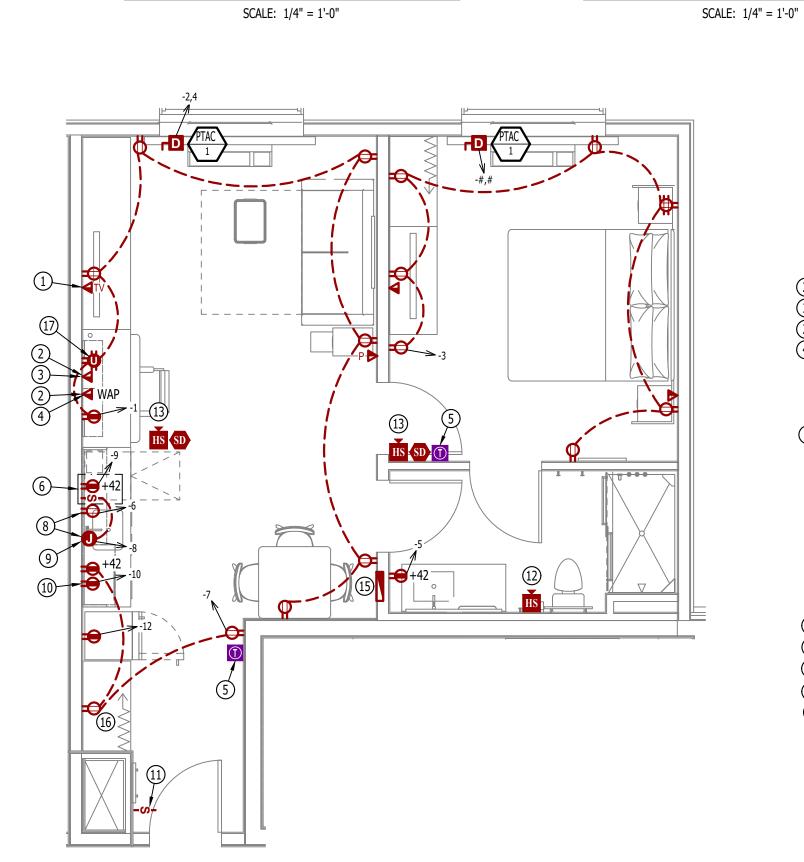

POWER PLAN - ONE BEDROOM SUITE

SCALE: 1/4" = 1'-0"

POWER PLAN - KING STUDIO

POWER PLAN - KING STUDIO - CONNECTOR



POWER PLAN - ONE BEDROOM SUITE - ACCESSIBLE SCALE: 1/4" = 1'-0"

POWER PLAN - QUEEN QUEEN STUDIO

SCALE: 1/4" = 1'-0"

POWER PLAN - QUEEN QUEEN STUDIO - ACCESSIBLE

EP401

ENLARGED POWER PLAN - GUEST ROOMS

CONSTRUCTION As Noted on Plans Review

James Watson, P.E. September 13, 2024

MO Certificate of Authority # 2018029680

ENGINEERING

2400 Bluff Creek Drive, Suite 101

Columbia, Missouri 65201

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09 / 13 / 2024

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J2 DESIGN:

ISSUE TITLE

CITY SUBMISSION

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POWER PLAN - KING STUDIO - ACCESSIBLE SCALE: 1/4" = 1'-0"

SCALE: 1/4" = 1'-0"

POWER PLAN - QUEEN QUEEN STUDIO - CONNECTOR

SCALE: 1/4" = 1'-0"

- 1. FIRE ALARM SYSTEM SHALL BE AN ADDRESSABLE SYSTEM THAT IS NONCODED, UL-LISTED, WITH MULTIPLEX SIGNAL TRANSMISSION AND HORN/STROBE EVACUATION.
- 2. EVERY FIRE ALARM SYSTEM COMPONENT SHALL BE UL-LISTED AND UL-CERTIFIED, TESTED BY
- MANUFACTURERS AS A COMPLETE SYSTEM, AND MEET ALL APPLICABLE REQUIREMENTS OF NFPA 72.
- 3. ALL FIRE ALARM WIRING TO BE PLENUM RATED. 4. ALL INITIATING DEVICES INSTALLED IN UNCONDITIONED SPACES SHALL BE CONVENTIONAL DEVICES SUITABLE FOR USE IN EXTREME HIGH AND LOW TEMPERATURES AND HIGH HUMIDITY. SUCH DEVICES SHALL
- BE SUPERVISED BY ADDRESSABLE MONITOR MODULES LOCATED IN CONDITIONED SPACES.
- 5. QUANTITIES, TYPES, AND LOCATIONS OF INITIATING DEVICES AND OUTPUT MODULES FOR INTERCONNECTION WITH FIRE SUPPRESSION MUST BE COORDINATED WITH CONTRACTORS THAT ARE
- RESPONSIBLE FOR THOSE SYSTEMS. ALL SECURITY CAMERA MONITORS SHALL BE LOCATED OUT GUEST'S VIEW. SEE SHEET EP401 FOR GUESTROOM FIRE ALARM SYSTEM DETAILS/REQUIREMENTS.

FIRE ALARM DEVICE TYPICAL LOCATIONS:

WALL MOUNTED SMOKE / HEAT DETECTORS:

- VERIFY EXACT LOCATIONS WITH LATEST NFPA REQUIREMENTS;
- CEILING MOUNTED SMOKE / HEAT DETECTORS:
- 2.1. MUST BE MOUNTED AT LEAST 36" FROM HVAC GRILLES / DIFFUSERS 2.2. MUST BE LOCATED AT LEAST 4" FROM WALL/CEILING INTERSECTIONS (MEASURED FROM EDGE OF

3.1. MUST BE LOCATED AT LEAST 4" FROM WALL/CEILING INTERSECTIONS (MEASURED FROM EDGE OF

- 3.2. MUST BE LOCATED WITHIN AT LEAST 12" FROM WALL/CEILING INTERSECTION (MEASURED FROM EDGE
- OF DEVICE) MANUAL PULL STATIONS
- 4.1. MUST BE LOCATED WITHIN 5' OF EXTERIOR DOORWAY (MEASURED FROM CENTER OF PULL STATION
- 4.2. MUST BE LOCATED BETWEEN 42" AND 54" A.F.F. (MEASURED FROM FINISH FLOOR TO CENTER OFF PULL STATION)
- MAGNETIC DOOR HOLDER: 5.1. MUST BE LOCATED 6" BELOW TOP OF DOOR (MEASURED FROM TOP OF DOOR TO TOP OF DOOR
- MUST BE LOCATED DOOR WIDTH MINUS THREE INCHES FROM DOOR (MEASURED FROM NEAREST EDGE OF HOLDER TO NEAREST EDGE OF DOOR). FIRE ALARM CONTROL PANEL:
- 6.1. MUST BE LOCATED AT MAXIMUM OF 72" A.F.F. (MEASURED FROM FINISH FLOOR TO TOP OF FIRE ALARM CONTROL PANEL)
- FIRE ALARM ANNUNCIATOR:

INDOOR POOL

005A

AAAAAAA

4\ -COORDINATE ELECTRIC STRIKE/READER 🟅

LOCATIONS WITH ARCHITECT & DOOR

HARDWARE SETS (TYP.)

012 DISCHARGE LAUNDRY

I OR A

CIRCULATION

024 FITNESS ROOM

- 7.1. MUST BE LOCATED AT MAXIMUM OF 60" A.F.F. (MEASURED FROM FINISH FLOOR TO TOP OF FIRE ALARM ANNUNCIATOR PANEL)
- 8. WALL MOUNTED STROBE DEVICES (VISUAL ONLY):
- 8.1. MUST BE LOCATED AT 84" A.F.F. (MEASURED FROM FINISH FLOOR TO BOTTOM OF BACK BOX) MUST BE LOCATED AT MOST 24" FROM WALL/CEILING INTERSECTION WITHIN HANDICAP BEDROOMS

POOL EQUIP.

HD-

SD

023 SALES

BREAKFAST

AAA

129

EMPLOYEE BREAK

HD SD CO

- (MEASURED FROM WALL/CEILING INTERSECTION TO BOTTOM OF BACK BOX)
- WALL-MOUNTED HORN / STROBE DEVICES (AUDIBLE & VISUAL): 9.1. MUST BE LOCATED AT 84" A.F.F. (MEASURED FROM FINISH FLOOR TO BOTTOM OF BACK BOX)

FIRE ALARM PLAN SYMBOL LEGEND

- MANUAL PULL STATION
- MODULE
- OUTPUT MODULE
- SMOKE DETECTOR
- HEAT DETECTOR
- CARBON MONOXIDE DETECTOR
- STROBE CEILING MOUNT
- STROBE WALL MOUNT HORN STROBE - WALL MOUNT
- HORN STROBE CEILING MOUNT
- SPEAKER STROBE WALL MOUNT
- SPEAKER STROBE CEILING MOUNT
- TAMPER SWITCH
- WATER FLOW SWITCH
- FIRE ALARM CONTROL PANEL
- FIRE ALARM ANNUNCIATOR

M M T WF


ENGINEER

SECURITY PLAN SYMBOL LEGEND

- READER
- MOTION DETECTOR
 - ALARM KEYPAD
 - DOOR CONTACT

- GLASS BREAK SENSOR ELECTRIC STRIKE
- INTERCOM
- DOOR RELEASE
- DURESS ALARM BUTTON (WITH SILENT ALARM IN ACCORDANCE WITH HILTON DESIGN STANDARD 2514.09.I.2.B) 4
- BURGLAR PANEL
- WALL MOUNT CAMERA (ARROW INDICATES VIEW DIRECTION)
- CEILING MOUNT CAMERA

(ARROW INDICATES VIEW DIRECTION)

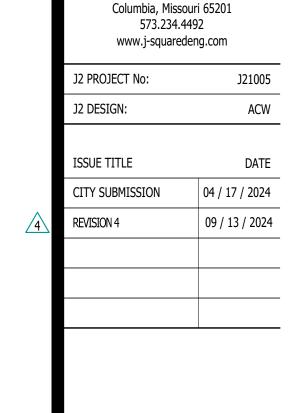

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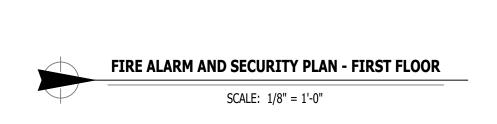
SHEET TITLE

- PROVIDE NOTIFICATION DEVICE(S) IN AUDIO/VISUALLY IMPAIRED ROOMS

(VERIFY EXACT LOCATIONS WITH ARCHITECTURAL PLANS)


> **FIRE ALARM AND SECURITY PLAN - FIRST FLOOR**


FS101



GUEST CORRIDOR

(8) 6" Sanitary with $\frac{1}{2}$ " per foot downward slope.

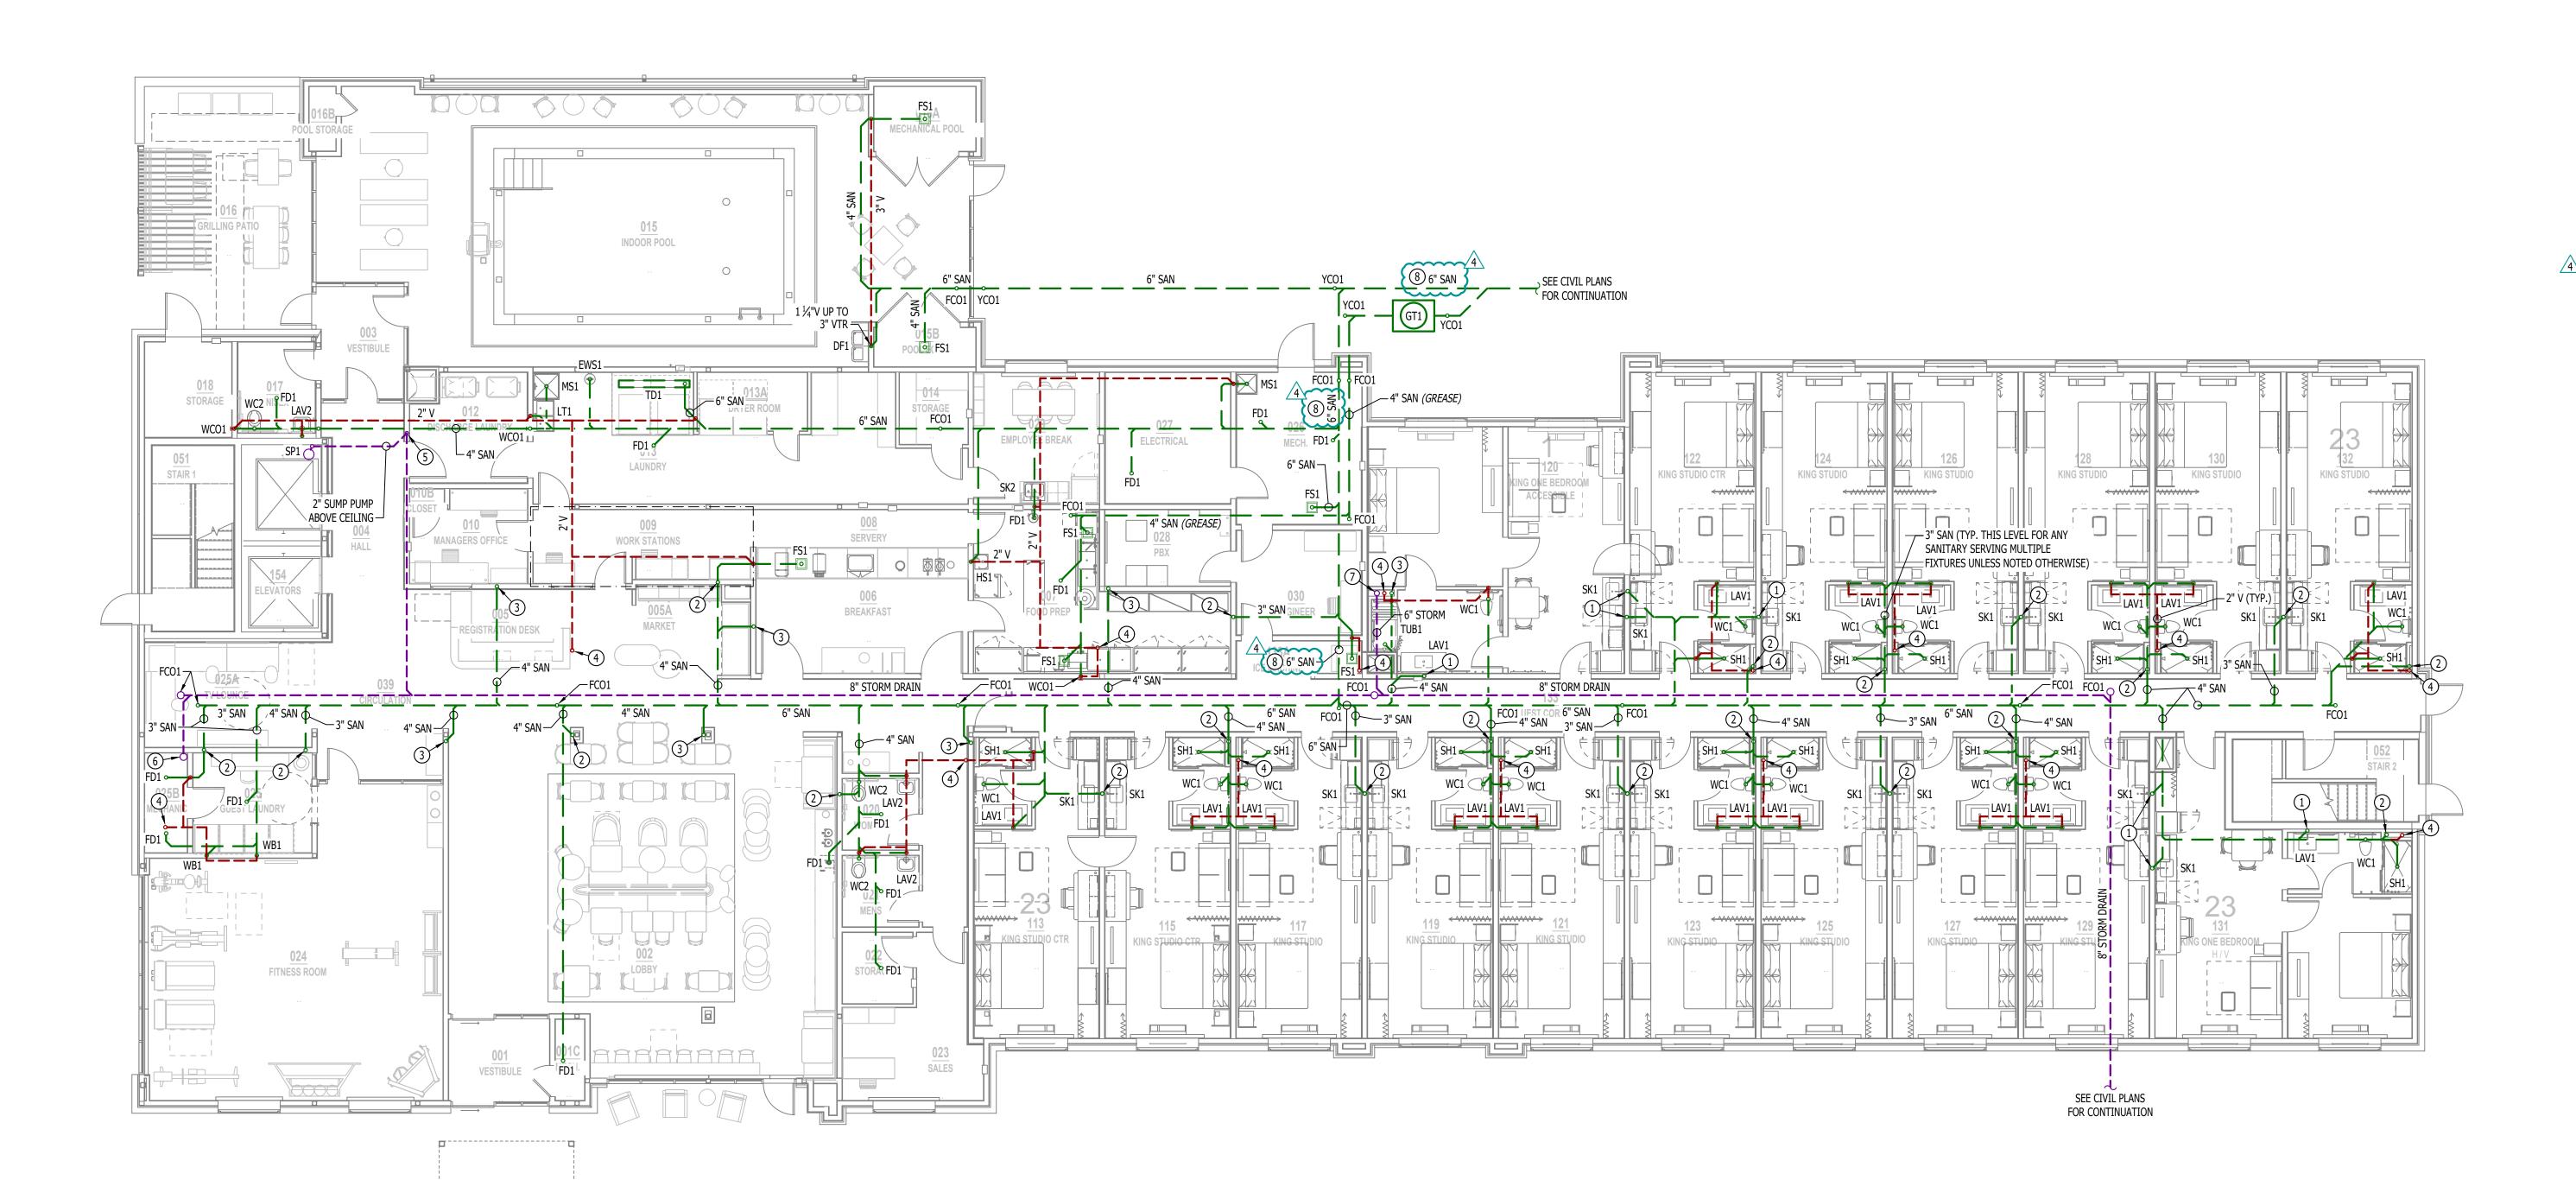

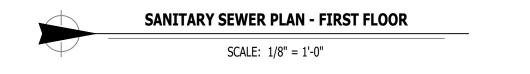

CONSTRUCTION
As Noted on Plans Review

Development Services Department Missouri
Ontice Services Depart

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ISSUE TITLE	DATE	
CITY SUBMISSION	04 / 17 / 2024	
REVISION 1 - CITY RESPONSE	05 / 17 / 2024	
CITY & BRAND RESPONSE	06 / 14 / 2024	

09 / 13 / 2024

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SANITARY SEWER PLAN
- FIRST FLOOR

SHEET NUM

PS101