# DISCOVERY PARK - LOT #9 - A LEE'S SUMMIT, MO

PRINTS ISSUED

11/27/2024 - CITY SUBMISSION

**REVISIONS:** 

1 12/18/24 ADDENDUM #1

## PROJECT CERTIFICATION

I, **David E. Hendrikse**, hereby specify pursuant to the governing requirements of the state, that the documents intended to be authenticated by my seal are limited G-001 A-506 A-507 G-001.1 G-202

G-002 G-203 A-408 A-508 G-003 A-600 A-306 G-300 A-601 A-602 G-005 G-206 G-302 G-006 G-207 G-303 A-201 A-400 A-603 G-007 A-700 G-208 AS-100 A-401 G-100 G-209 A-502 G-101 A-503 A-504


and I hereby disclaim any responsibility for all other plans, specifications, reports or other documents or instruments relating to or intended to be used for any part or parts of the architectural or engineering project or survey.

SEAL



David E. Hendrikse, AIA

## **REGIONAL MAP**

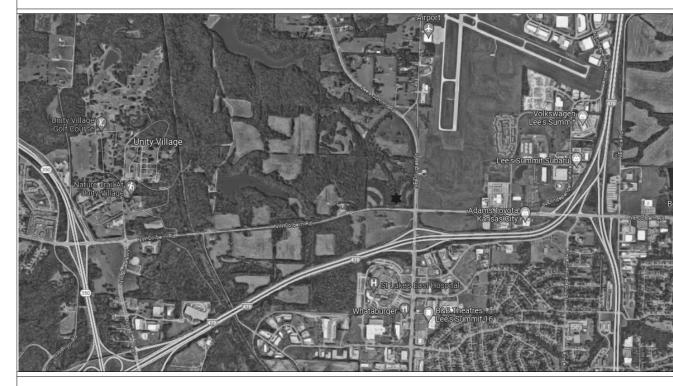

**VICINITY MAP** 



**DISCOVERY PARK - LOT #9 - A 200 NE ALURA WAY** LEE'S SUMMIT, MISSOURI 64064

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•	11/27/24	G-302	ACCESSIBILITY STANDARDS		
•	11/27/24	G-303	ACCESSIBILITY STANDARDS		
		CIVIL	UNDER SEPARATE REVIEW, REFERENCE	FDF	)

	Sheet Issue Date	Sheet Number	Sheet Name	Rev.	Rev
•	11/27/24	S001	GENERAL NOTES		
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•	11/27/24	S101A	LEVEL 2 BROWNSTONES ZONE A FRAMING PLAN		
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	11/27/24	S533	PODIUM DETAILS		
•	11/27/24	S534	FRAMING AT TYPICAL GARAGE WALL OPENING		L
	11/27/24	S540	SHEAR WALL DETAILS		
	11/27/24	S550	FRAMING DETAILS		
	11/27/24	S551	FRAMING DETAILS		
•	11/27/24	S560	TYPICAL BALCONY PLANS & DETAILS - LEVEL 2		
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•	11/27/24	S562	ADDITIONAL BALCONY PLANS		

#### SOLID FILL INDICATES INCLUSION IN ISSUE SHEET ISSUE DATE **1**0 / 10/ 2020 A-000 SHEET NAME - 10 / 10/ 2020 SHEET NUMBER AND NAME SHEET INDEX LEGEND CURRENT REVISION NUMBER $\rightarrow$ & REVISION DATE ON SHEET

# **ARCHITECTURAL**

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•	11/27/24	A-103	SECOND FLOOR PLAN
•	11/27/24	A-104	THIRD FLOOR PLAN
•	11/27/24	A-105	ROOF PLAN
-	11/27/24	A-106	ROOFING & FLASHING DETAILS
•	11/27/24	A-110	ENLARGED PLAN - 1ST FLOOR GARAGE
•	11/27/24	A-120	REFLECTED CEILING PLANS
•	11/27/24	A-125	CEILING DETAILS
•	11/27/24	A-200	EXTERIOR ELEVATIONS
•	11/27/24	A-201	EXTERIOR ELEVATIONS
•	11/27/24	A-202	COLORED EXTERIOR ELEVATIONS
•	11/27/24	A-203	COLORED EXTERIOR ELEVATIONS
•	11/27/24	A-300	BUILDING SECTION
•	11/27/24	A-301	BUILDING SECTION
•	11/27/24	A-302	BUILDING SECTIONS
•	11/27/24	A-303	WALL SECTIONS
•	11/27/24	A-304	WALL SECTIONS
•	11/27/24	A-305	ELEVATOR SECTION & DETAILS
•	11/27/24	A-306	STAIR 1 SECTION & DETAILS
•	11/27/24	A-307	STAIR 2 SECTION & DETAILS
•	11/27/24	A-308	FRONT CANOPY PLAN / ELEV. / SECTION / & DETAILS
•	11/27/24	A-400	ABERDEEN (2 BR) - TYPE A
-	11/27/24	A-401	ABERDEEN (2 BR) - TYPE B
-	11/27/24	A-402	ADRIAN (1 BR) - TYPE B
•	11/27/24	A-403	ADRIAN LRG (1 BR) - TYPE B
•	11/27/24	A-404	CONWAY (1 BR) - TYPE B
•	11/27/24	A-405	CONWAY II (1 BR) - TYPE B
•	11/27/24	A-406	DRAKE (1 BR) - TYPE B
•	11/27/24	_	LANA (2 BR) - TYPE B
•	11/27/24	A-408	TOWNHOME (2 BR)
•	11/27/24	A-409	TOWNHOME (2 BR)
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•	11/27/24	A-415	UNIT DETAILS
•	11/27/24	A-500	WALL DETAILS
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•	11/27/24	A-503	BRICK PENETRATION DETAILS
•	11/27/24	A-504	ELEVATOR DETAILS
•	11/27/24	A-505	STAIR DETAILS
•	11/27/24	A-506	BALCONY WATERPROOFING DETAILS
•	11/27/24	A-507	BALCONY DETAILS

■ 11/27/24 A-508 BALCONY DETAILS AT BROWNSTONES

■ 11/27/24 A-600 WINDOW / DOOR / FINISH SCHEDULES

■ 11/27/24 A-601 STOREFRONT / FACADE ELEVATIONS

■ 11/27/24 A-602 DOOR DETAILS

■ 11/27/24 A-710 FINISH PLANS

■ 11/27/24 | A-603 | WINDOW DETAILS

■ 11/27/24 A-700 FINISH TRANSITION DETAILS

## PROJECT TEAM PROJECT DATA

#### PROJECT DESIGN INFORMATION

ZONING: PMIX - PLANNED MIXED USE DISTRICT CODE: 2018 INTERNATIONAL BUILDING CODE 2018 INTERNATIONAL PLUMBING CODE

2018 INTERNATIONAL MECHANICAL CODE 2018 INTERNATIONAL FUEL GAS CODE 2018 INTERNATIONAL FIRE CODE 2017 NATIONAL ELECTRIC CODE 2009 ACCESSIBILITY CODE ICC/ANSI 117-1 LEE'S SUMMIT AMENDMENTS TO THE ENERGY CODE

OCCUPANCY GROUP: A-2, UNCONCENTRATED S-2, OPEN PARKING GARAGE

TYPE OF CONSTRUCTION: R-2 & A-2, TYPE VA S-2, TYPE IIA **ENERGY CONSERVATION:** 

WALLS AS PART OF BLDG ENVELOPE R-13 FLOORS AS PART OF BLDG ENVELOPE R-19 ROOFS AS PART OF BLDG ENVELOPE R-19 CEILINGS AS PART OF BLDG ENVELOPE R-30

**BUILDING SUMMARY:** 

THIRD FLOOR

1 12/18/24

NUMBER: (1) TOTAL BUILDINGS HEIGHT: 3 STORIES, 46'-0" **SQUARE FOOTAGES** 

FIRST FLOOR SECOND FLOOR 18,347 S.F. 17,973 S.F.

# **UNIT SUMMARY**: OVERALL UNIT TOTAL = (40) UNITS

TYPE "A" UNITS (2% OF TOTAL) (1) UNITS - ABERDEEN "A" HI/VI UNITS (2% OF TOTAL) (1) UNITS - ADRIAN "HI/VI" STANDARD UNITS (3) UNITS - ABERDEEN (17) UNITS - ADRIAN (2) UNITS - ADRIAN - LRG (2) UNITS - CONWAY I (2) UNITS - CONWAY II

18,347 S.F.

(2) UNITS - LANA (8) UNITS - BROWNSTONES **TOTAL UNITS** (40) UNITS SQUARE FOOTAGE: GROSS NET 1,338 S.F. 1,269 S.F. ABERDEEN "A" 1,338 S.F. 1,269 S.F. ABERDEEN "B" 832 S.F. 1,078 S.F. 1,021 S.F. ADRIAN - LRG CONWAY 1,024 S.F. 962 S.F. CONWAY II DRAKE 903 S.F. 821 S.F. 1.082 S.F. 1.020 S.F.

(2) UNITS - DRAKE

SEE CIVIL FOR SITE SUMMARY

**BROWNSTONE 1ST** 

BROWNSTONE 2ND

## NOTE: SQUARE FOOTAGE

<u>-GROSS - COMMON SPACE CALCULATION:</u> OUTSIDE PERIMETER OF STUD (ENTIRE BUILDING) LESS THE TOTAL OF THE GROSS UNIT SQUARE FOOTAGE PER FLOOR. <u>-GROSS - UNIT CALCULATION:</u> CENTERLINE OF PARTY WALL TO OUTSIDE OF EXTERIOR STUD WALL AND/OR OUTSIDE OF CORRIDOR STUD WALL. <u>-NET</u> - PAINT-TO-PAINT AT PERIMETER, TAKEN FROM INSIDE OF DEMISING, EXTERIOR, AND CORRIDOR WALLS.

619 S.F. 563 S.F.

#### **OWNER**

INTRINSIC DEVELOPMENT 3622 ENDEAVOR AVE. STE. 101 COLUMBIA, MO 65201 CONTACT: **BRIAN MAENNER** 

PHONE: 573.881.0280

bpmaenner@intrinsicdevelopment.com

#### **ARCHITECT**

EMAIL:

**ROSEMANN & ASSOCIATES, P.C.** 1526 Grand Boulevard Kansas City, MO 64108

CONTACT A.J. DOLPH ajdolph@rosemann.com PHONE: 816.472.1448

#### CONTRACTOR

INTRINSIC DEVELOPMENT ADDRESS: 3622 ENDEAVOR AVE. STE. 101

COLUMBIA, MO 65201 EMAIL: bpmaenner@intrinsicdevelopment.com PHONE:

#### STRUCTURAL ENGINEER

**MCCLURE** ADDRESS: 1901 PENNSYLVANIA DRIVE COLUMBIA MO 65202 CONTACT: **CELESTE SPICKERT** cspickert@mcclurevision.com PHONE: 573.234.2609

#### MECHANICAL, ELECTRICAL, PLUMBING **ENGINEER**

## J-SQUARED ENGINEERING

2400 BLUFF CREEK DRIVE, SUITE 101 ADDRESS: COLUMBIA, MO 65201 **ANDREW WHITE** CONTACT: EMAIL: andrew@j-squaredeng.com PHONE: 573.234.4492

## **CIVIL ENGINEER**

ADDRESS: 8455 COLLEGE BOULEVARD OVERLAND PARK, KS 66210 CONTACT: JEFF BARTZ EMAIL: jbartz@weareown.com 816.777.0400 PHONE:

## LANDSCAPE ARCHITECT

ADDRESS: 8455 COLLEGE BOULEVARD CONTACT: JEFF BARTZ EMAIL: bartz@weareown.com PHONE: 816.777.0400

SHEET TITLE TITLE SHEET

PROJECT NUMBER: 24017

SHEET NUMBER:

200 NE SUMMI

Sheet Issue Date Sheet Number Sheet Number Sheet Name


■ 11/27/24 MEP1 MECHANICAL ELECTRICAL PLUMBING COVER SHEET ■ 11/27/24 MEP2 SITE UTILITIES PLAN ■ 11/27/24 MEP3 MEP PLAN - ROOF ■ 11/27/24 M101 HVAC PLAN - 1ST FLOOR - AREA A ■ 11/27/24 M102 HVAC PLAN - 2ND FLOOR - AREA A ■ 11/27/24 M103 HVAC PLAN - 3RD FLOOR - AREA A ■ 11/27/24 M111 HVAC PLAN - 1ST FLOOR - AREA B ■ 11/27/24 M112 HVAC PLAN - 2ND FLOOR - AREA B ■ 11/27/24 M113 HVAC PLAN - 3RD FLOOR - AREA B ■ 11/27/24 M501 HVAC DETAILS & SCHEDULES ■ 11/27/24 M601 HVAC SCHEDULES

			ELECTRICAL		
	Sheet Issue Date	Sheet Number	Sheet Name	Rev.	Curren Revision [
•	11/27/24	EP101	POWER PLAN - 1ST FLOOR - AREA A		
•	11/27/24	EP102	POWER PLAN - 2ND FLOOR - AREA A		
	11/27/24	EP103	POWER PLAN - 3RD FLOOR - AREA A		
•	11/27/24	EP111	POWER PLAN - 1ST FLOOR - AREA B		
•	11/27/24	EP112	POWER PLAN - 2ND FLOOR - AREA B		
•	11/27/24	EP113	POWER PLAN - 3RD FLOOR - AREA B		
	11/27/24	EL101	LIGHTING PLAN - 1ST FLOOR - AREA A	1	12/18/
•	11/27/24	EL102	LIGHTING PLAN - 2ND FLOOR - AREA A		
•	11/27/24	EL103	LIGHTING PLAN - 3RD FLOOR - AREA A		
•	11/27/24	EL111	LIGHTING PLAN - 1ST FLOOR - AREA B		
	11/27/24	EL112	LIGHTING PLAN - 2ND FLOOR - AREA B		
-	11/27/24	EL113	LIGHTING PLAN - 3RD FLOOR - AREA B		
•	11/27/24	EL201	EXTERIOR BUILDING MOUNTED LIGHTING PLAN		
•	11/27/24	E501	ELECTRICAL DETAILS & SCHEDULES		
•	11/27/24	E601	ELECTRICAL SCHEDULES		
•	11/27/24	FS101	FIRE ALARM & SECURITY PLAN - 1ST FLOOR - AREA A		
•	11/27/24	FS102	FIRE ALARM & SECURITY PLAN - 2ND FLOOR - AREA A		
-	11/27/24	FS103	FIRE ALARM & SECURITY PLAN - 3RD FLOOR - AREA A		
•	11/27/24	FS111	FIRE ALARM & SECURITY PLAN - 1ST FLOOR - AREA B		
-	11/27/24	FS112	FIRE ALARM & SECURITY PLAN - 2ND FLOOR - AREA B		
•	11/27/24	FS113	FIRE ALARM & SECURITY PLAN - 3RD FLOOR - AREA B		

	PLUMBING						
	Sheet Issue Date	Sheet Number	Sheet Name	Rev.	Current Revision Date		
•	11/27/24	PS101	SANITARY SEWER PLAN - 1ST FLOOR - AREA A				
	11/27/24	PS102	SANITARY SEWER PLAN - 2ND FLOOR - AREA A				
•	11/27/24	PS103	SANITARY SEWER PLAN - 3RD FLOOR - AREA A				
•	11/27/24	PS111	SANITARY SEWER PLAN - 1ST FLOOR - AREA B				
•	11/27/24	PS112	SANITARY SEWER PLAN - 2ND FLOOR - AREA B				
	11/27/24	PS113	SANITARY SEWER PLAN - 3RD FLOOR - AREA B				
•	11/27/24	PW101	WATER& GAS PLAN - 1ST FLOOR - AREA A				
	11/27/24	PW102	WATER& GAS PLAN - 2ND FLOOR - AREA A				
•	11/27/24	PW103	WATER& GAS PLAN - 3RD FLOOR - AREA A				
•	11/27/24	PW111	WATER& GAS PLAN - 1ST FLOOR - AREA B				
•	11/27/24	PW112	WATER& GAS PLAN - 2ND FLOOR - AREA B				
•	11/27/24	PW113	WATER& GAS PLAN - 3RD FLOOR - AREA B				
	11/27/24	P501	PLUMBING DETAILS & SCHEDULES	1	12/18/24		

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			UMEP		
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	Sheet Issue Date	Sheet Number	Sheet Name	Rev.	Current Revision Date
	<b>1</b> 1/27/24	UMEP1.1	MEP PLAN - UNIT TYPE ADRIAN-A		
	<b>1</b> 1/27/24	UMEP1.2	MEP PLAN - UNIT TYPE ADRIAN-B		
	<b>1</b> 1/27/24	UMEP1.3	MEP PLAN - UNIT TYPE CONWAY-A		
	<b>1</b> 1/27/24	UMEP1.4.1	HVAC & PLUMBING PLAN - UNIT TYPE CONWAY-B		
	<b>1</b> 1/27/24	UMEP1.4.2	POWER & LIGHTING PLAN - UNIT TYPE CONWAY-B		
	<b>1</b> 1/27/24	UMEP1.5.1	HVAC & PLUMBING PLAN - UNIT TYPE DRAKE	1	12/18/24
	<b>1</b> 1/27/24	UMEP1.5.2	POWER & LIGHTING PLAN - UNIT TYPE DRAKE	1	12/18/24
	<b>1</b> 1/27/24	UMEP2.1.1	HVAC & PLUMBING PLAN - UNIT TYPE LANA		
	<b>1</b> 1/27/24	UMEP2.1.2	POWER & LIGHTING PLAN - UNIT TYPE LANA		
	<b>1</b> 1/27/24	UMEP2.2.1	HVAC & PLUMBING PLAN - UNIT TYPE ABERDEEN-A		
	<b>1</b> 1/27/24	UMEP2.2.2	POWER & LIGHTING PLAN - UNIT TYPE ABERDEEN-A		
	<b>1</b> 1/27/24	UMEP2.3.1	HVAC & PLUMBING PLAN - UNIT TYPE ABERDEEN-B		
	<b>1</b> 1/27/24	UMEP2.3.2	POWER & LIGHTING PLAN - UNIT TYPE ABERDEEN-B		
	<b>1</b> 1/27/24	UMEP2.4.1	HVAC & PLUMBING PLAN - UNIT TYPE BROWNSTONE		
	11/27/24	UMEP2.4.2	POWER & LIGHTING PLAN - UNIT TYPE BROWNSTONE	1	12/18/24

MECHANICAL

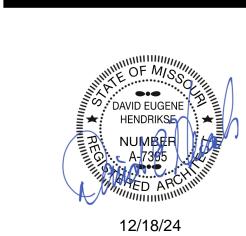

PRINTS ISSUED

REVISIONS:

11/27/2024 - CITY SUBMISSION

1 12/18/24 ADDENDUM #1

SHEET TITLE SHEET INDEX (CONT.)

PROJECT NUMBER: 24017

SHEET NUMBER:

- SOLID FILL INDICATES INCLUSION IN ISSUE - SHEET ISSUE DATE A-000 SHEET NAME - 10 / 10/ 2020 10 / 10/ 2020

SHEET INDEX LEGEND

- SHEET NUMBER AND NAME CURRENT REVISION NUMBER & REVISION DATE ON SHEET



PRINTS ISSUED 11/27/2024 - CITY SUBMISSION

**REVISIONS:** 

REFERENCE G-003 FOR GENERAL NOTES REFERENCE A-400 FOR UNIT PLAN LEGEND

REFERENCE A-120 FOR RCP LEGEND


FRAME TYPES

PER SCHED

DOOR VIEWER AT APT. ENTRY, TYP.

DOOR VIEWER AT TYPE A APT. ENTRY,

**DOOR TYPES** 1 12/18/24 ADDENDUM #1

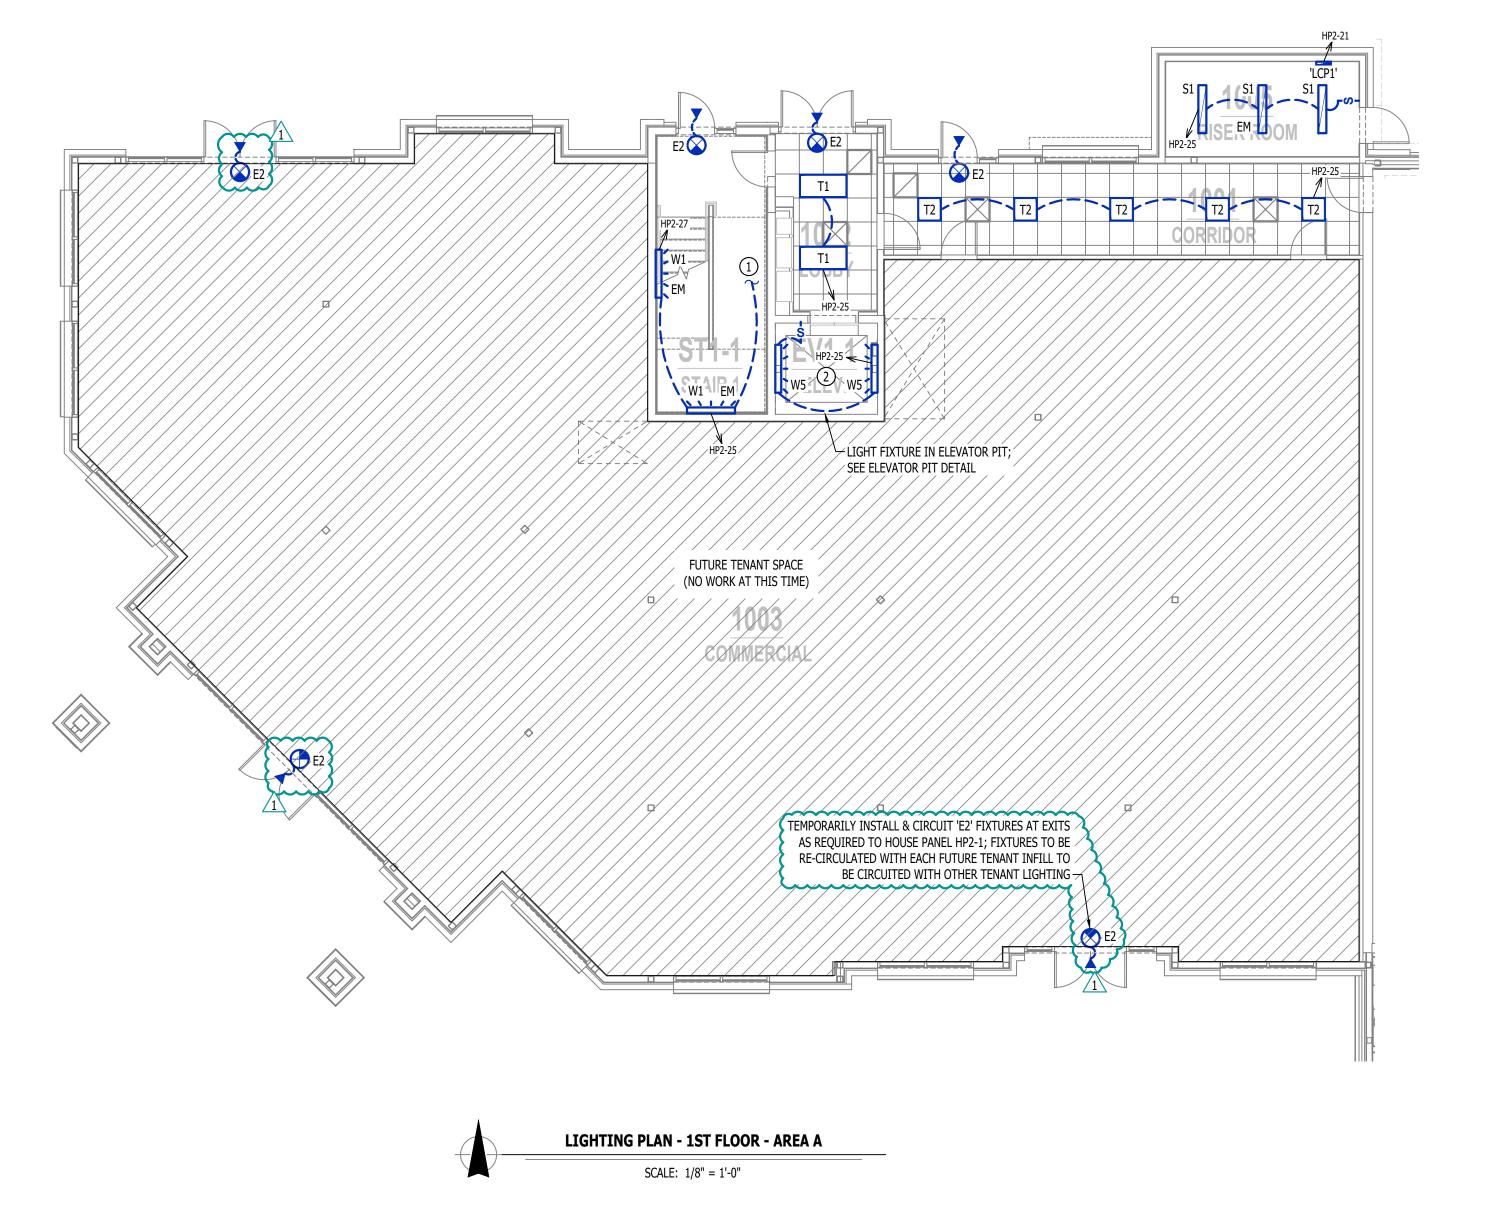

#### **LIGHTING PLAN GENERAL NOTES:**


- REFER TO E500 AND/OR E600 SERIES SHEETS FOR ADDITIONAL LIGHTING NOTES, DETAILS, REQUIREMENTS, AND SCHEDULES. SEE SHEET EL201 FOR ALL EXTERIOR BUILDING MOUNTED LIGHTING LOCAITONS AND DETAILS.
- 2. OCCUPANCY / VACANCY SENSOR QUANTITIES AND GENERAL LOCATIONS SHOWN FOR REFERENCE ONLY.
  CONTRACTOR TO PROVIDE AND INSTALL SENSOR WITH SPACING PER MANUFACTURER SPECIFICATIONS AND
  INCLUDE ADDITIONAL SENSORS IF NECESSARY. CEILING-MOUNTED SENSORS SHALL BE INSTALLED WITHIN
  MANUFACTURE'S ACCEPTABLE MOUNTING HEIGHT RANGE.


#### LIGHTING PLAN KEY NOTES:


1) CIRCUIT CONTINUES TO LEVEL ABOVE.

2) ORIENT LIGHT FIXTURE(S) TO PROVIDE MINIMUM 10FC AT ALL POINTS ON FLOOR OF ELEVATOR PIT.


#### LIGHTING PLAN SYMBOL LEGEND

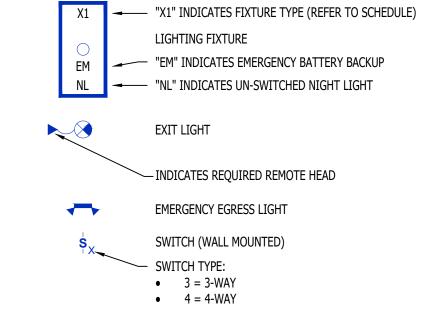

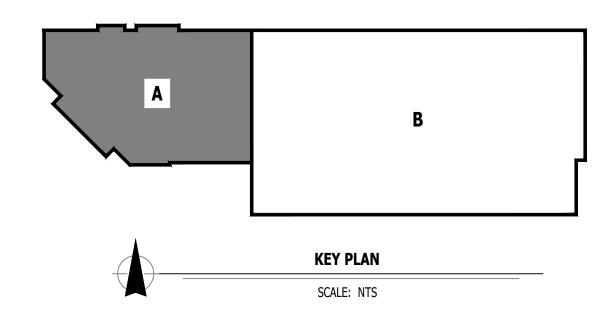

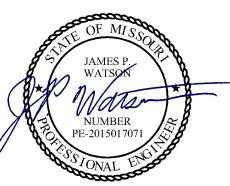

James Watson, P.E. December 18, 2024 PE-2015017071 MO Certificate of Authority # 2018029680

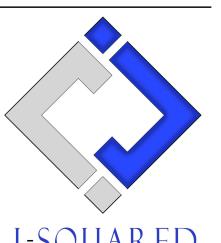

ENGINEERING

2400 Bluff Creek Drive, Suite 101
Columbia, Missouri 65201

573.234.4492 www.j-squaredeng.com

J2 PROJECT No:	J21012
J2 DESIGN:	ACW
ISSUE TITLE	DATE
CITY SUBMITTAL	11 - 27 - 2024

ISSUE TITLE DATE

CITY SUBMITTAL 11 - 27 - 2024

ADDENDUM #1 12 - 18 - 2024

at Discovery Lot 9A

MECHANICAL - ELECTRICAL - PLUMBING

VIllage at Discove

AHJ APPROVAL STAMP

LIGHTING PLAN - 1ST FLOOR - AREA A

SHEET NUMI

**EL101** 

#### PLUMBING SPECIFICATIONS

#### 1. GENERAL

- 1.1. PLUMBING CONTRACTOR IS RESPONSIBLE TO PROVIDE ALL ESCUTCHEONS, ¼ TURN STOPS, P-TRAPS, AND SUPPLY LINES TO PROVIDE A COMPLETE SYSTEM AT EACH FIXTURE INDICATED ON PLANS UNLESS NOTED OTHERWISE.
- 1.2. ALL PLUMBING SYSTEMS SHALL BE INSTALLED LEVEL, PLUMB, AND PARALLEL/PERPENDICULAR TO BUILDING ORIENTATION WHERE POSSIBLE.
- 1.3. COORDINATE ALL PIPING INSTALLATIONS WITH STRUCTURAL GRADE BEAMS, FOOTINGS, COLUMN PIERS, ETC. SLEEVE PIPING THRU STRUCTURAL ELEMENTS AS NECESSARY, VERIFY WITH STRUCTURAL ENCINEED.
- 1.4. VERIFY ALL UTILITY CONNECTION POINTS WITH PROPOSED PLUMBING LAYOUTS PRIOR TO BEGINNING WORK.
- 1.5. CLEAN ALL PLUMBING FIXTURES AND CHANGE FAUCET AERATORS AND SINK STRAINERS AT PROJECT COMPLETION PRIOR TO TURNING OVER TO OWNERSHIP.

#### 2 FOLITOMENT / FIXTURES

- 2.1. ALL EQUIPMENT AND/OR FIXTURES MUST MEET OR EXCEED THE PERFORMANCE, FUNCTIONAL INTENT, AND AESTHETICS AS MODELS SPECIFIED ON PLANS. WHERE SPECIFIC MANUFACTURERS AND/OR MODELS ARE INDICATED ON PLANS OR WITHIN SCHEDULES, CONTRACTOR TO PROVIDE MODEL INDICATED OR APPROVED EQUAL. VERIFY SUBSTITUTION APPROVAL PRIOR TO PURCHASE OR
- INSTALLATION OF EQUIPMENT.

  2.2. CONTRACTOR TO SUPPLY SUBMITTALS FOR ALL EQUIPMENT FOR REVIEW BY ARCHITECT AND ENGINEER. FORMAL APPROVAL SHALL BE RECEIVED BY CONTRACTOR PRIOR TO EQUIPMENT PURCHASE.
- 2.3. CONTRACTOR TO SHARE APPROVED EQUIPMENT SUBMITTALS WITH ANY PERTINENT ELECTRICAL REQUIREMENTS WITH ELECTRICAL CONTRACTORS WITHIN TWO WEEKS OF RECEIVING APPROVED SUBMITTALS FROM ARCHITECT/ENGINEER.

#### 3 SANITARY

- 3.1. BELOW AND ABOVE GRADE WASTE AND VENT PIPING IN BUILDING TO BE SOLID CORE SCHEDULE 40 PVC
- LISTED FOR DWV APPLICATIONS.

  3.2. NO WASTE OR VENT PIPING INSTALLED BELOW GRADE SHALL BE SMALLER THAN 2".
- 3.3. MINIMUM SLOPES FOR WASTE PIPING (UNLESS NOTED OTHERWISE ON PLANS):
- 3.3.1.  $2\frac{1}{2}$ " OR LESS DIAMETER:  $\frac{1}{4}$ " PER FOOT
- 3.3.2. 3" TO 6" DIAMETER: 1/8" PER FOOT
- 3.3.3. 8" OR LARGER DIAMETER: ½6" PER FOOT
   3.4. ACCESSIBLE FULL PIPE SIZE CLEANOUTS SHALL BE PROVIDED & INSTALLED ON BUILDING SANITARY LINES AT LOCATIONS SHOWN ON PLANS, AT INTERVALS OF NO MORE THAN 100', AT EVERY CHANGE IN DIRECTION GREATER THAN 45°, AND AT THE BASE OF EACH WASTE STACK.
- 3.5. WASTE AND VENT PIPING IN PLENUMS SHALL BE CAST IRON, PLENUM-RATED CPVC, OR PVC WITH AN INSULATION WRAP LISTED FOR USE AS SUCH AN ASSEMBLY.
- ALL VENT PIPE TERMINATIONS SHALL BE LOCATED EITHER 10' HORIZONTALLY OR 3' ABOVE MECHANICAL AIR INTAKE LOCATIONS. TERMINATIONS SHALL NOT BE INSTALLED UNDER ANY OPERABLE BUILDING OPENING OR OPERABLE ADJACENT BUILDING OPENING. CONTRACTOR TO OFFSET VENT PIPING AS NECESSARY TO MEET THESE REQUIREMENTS.

#### 4. **DOMESTIC WATER**

- 4.1. ALL DOMESTIC WATER PIPING TO BE EITHER COPPER OR PEX, SHALL CONFORM TO NSF 61 AND BE LISTED FOR USE IN POTABLE WATER SYSTEMS.
- 4.1.1. WHERE PEX PIPING IS USED, IT SHALL BE INCREASED ONE PIPE SIZE FROM WHAT IS INDICATED ON PLANS FOR ALL PORTIONS OF DISTRIBUTION SYSTEM.
- 4.1.2. PEX-A MAY BE INSTALLED AT SIZES INDICATED ON PLANS ONLY IF AN ENGINEERED PLAN IS SUBMITTED SHOWING ACCEPTABLE PRESSURE DROPS AND FLUID VELOCITIES, APPROVAL MUST
- BE GRANTED PRIOR TO PURCHASE AND INSTALLATION.

  4.1.3. COPPER WATER PIPING BELOW GRADE SHALL BE TYPE "K". BELOW GRADE JOINTS SHALL BE SILVER SOLDERED. THERE SHALL BE NO JOINTS IN WATER PIPING LOCATED BENEATH BUILDING
- 4.1.4. COPPER WATER PIPING ABOVE GRADE SHALL BE TYPE "L".
- 4.2. PROVIDE WATER HAMMER ARRESTORS AT ALL QUICK-CLOSE VALVES. FIXTURES REQUIRING WATER HAMMER ARRESTORS INCLUDE BUT ARE NOT LIMITED TO FLUSH VALVES, SENSOR FAUCETS, AND
- WASHING MACHINE BOXES. AIR CHAMBERS SHALL NOT BE PERMITTED.

  4.3. ALL DOMESTIC WATER PIPING SHALL BE ROUTED WITHIN BUILDING THERMAL ENVELOPE AND WITHIN WALL CAVITIES, ABOVE FINISHED CEILINGS, OR BELOW SLAB TO REMAIN CONCEALED UNLESS OTHERWISE NOTED. NOTIFY ENGINEER OF ANY NECESSARY ADJUSTMENTS THAT REQUIRE PIPING TO BE

## EXPOSED. 4.4. DOMESTIC WATER PIPING INSULATION

- 4.4.1. DOMESTIC WATER PIPING INSULATION
  4.4.1. ALL HW PIPING, WHETHER COPPER OR PEX, SHALL BE INSULATED WITH PLENUM RATED CLOSED
  - CELL ELASTOMERIC INSULATION.

    5.1.1. FOR PIPING LESS THAN  $1\frac{1}{2}$ ", INSULATION THICKNESS TO BE 1".
- 4.4.1.2. FOR PIPING  $1\frac{1}{2}$ " OR GREATER, INSULATION THICKNESS SHALL BE  $1\frac{1}{2}$ ".
- 4.4.2. CW COPPER PIPING TO INSULATED WITH  $\frac{1}{2}$ " PLENUM RATED CLOSED CELL ELASTOMERIC INSULATION. CW PEX NEED NOT BE INSULATED UNLESS NOTED OTHERWISE ON PLANS.


## 5. GAS PIPING


- 5.1. GAS PIPING SHALL BE INSTALLED LEVEL, PLUMB, AND PARALLEL OR PERPENDICULAR TO BUILDING ORIENTATION WHERE POSSIBLE.
- 5.2. QUARTER-TURN FULL-PORT SHUTOFF VALVES SHALL BE INCLUDED AT EACH APPLIANCE CONNECTION, AS WELL AS AN IN-LINE REGULATOR FROM DELIVERY PRESSURE TO APPLIANCE OPERATING PRESSURE IF REQUIRED. INCLUDE SEDIMENT TRAPS PER IFGC REQUIREMENTS.
- 5.1. NATURAL GAS AND LIQUID PROPANE (LP) PIPING TO SHALL BE SCHEDULE 40 BLACK STEEL.
   5.2. PIPE JOINTS SHALL BE THREADED WITH CLASS 150 FITTINGS, OR WELDED. NOTIFY OWNER/GC OF ANY
- NECESSARY HOT-WORK ASSOCIATED WITH WELDED CONNECTIONS.

  5.3. WHERE PIPING IS EXPOSED ON EXTERIOR FACE OF BUILDING, PAINT TO MATCH BUILDING. PAINT
- YELLOW IN ALL OTHER LOCATIONS.
  5.4. ON ROOFTOPS, INSTALL GAS PIPE WITH "ROOFTOP BLOX" PER MANUFACTURER'S INSTRUCTION.

## 6. STORM DRAIN PIPIN

- .1. ABOVE AND BELOW GRADE STORM PIPING SHALL BE SOLID CORE SCHEDULE 40 PVC.
  2. ALL PRIMARY & SECONDARY STORM DRAIN PIPING & FITTINGS SHALL BE INSULATED WITH
- ½" FIBERGLASS INSULATION WITH ASJ JACKET.
- 6.3. STORM DRAIN PIPING IN PLENUMS SHALL BE CAST IRON, PLENUM-RATED CPVC, OR PVC WITH AN INSULATION WRAP LISTED FOR USE AS SUCH AN ASSEMBLY.

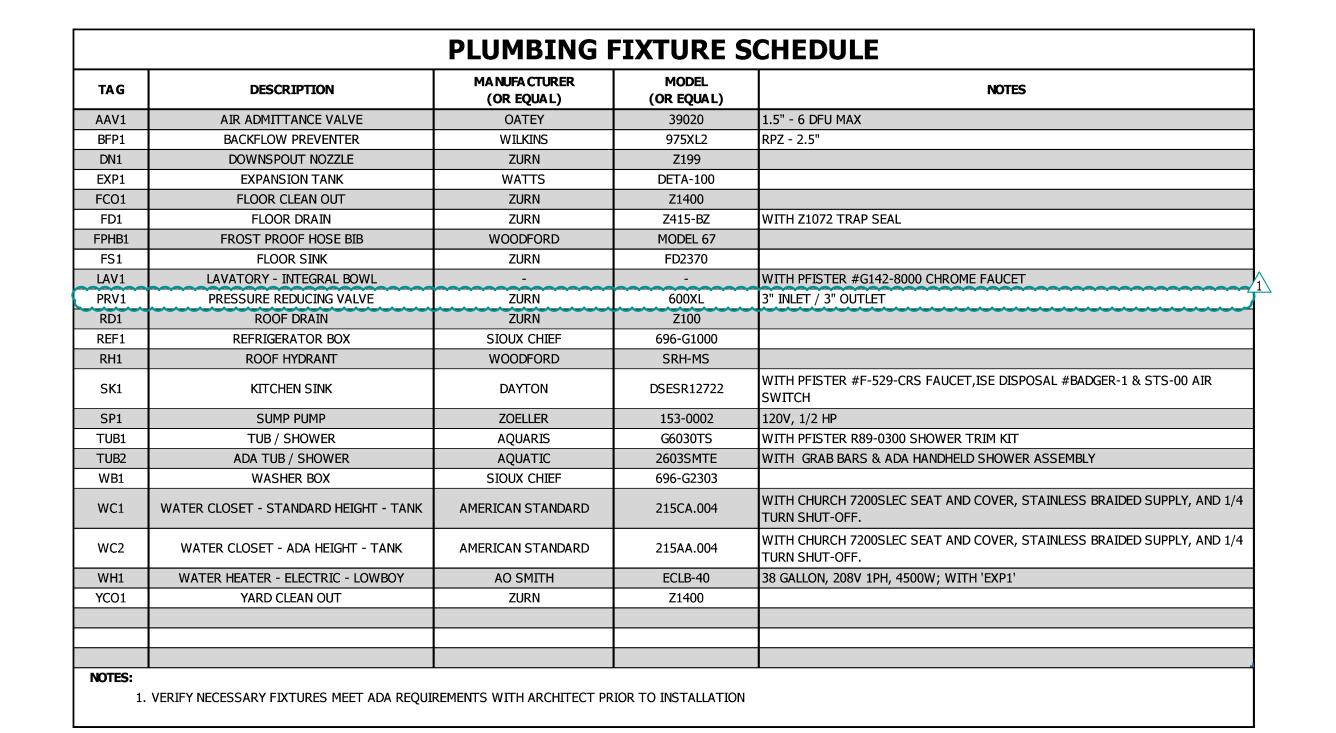


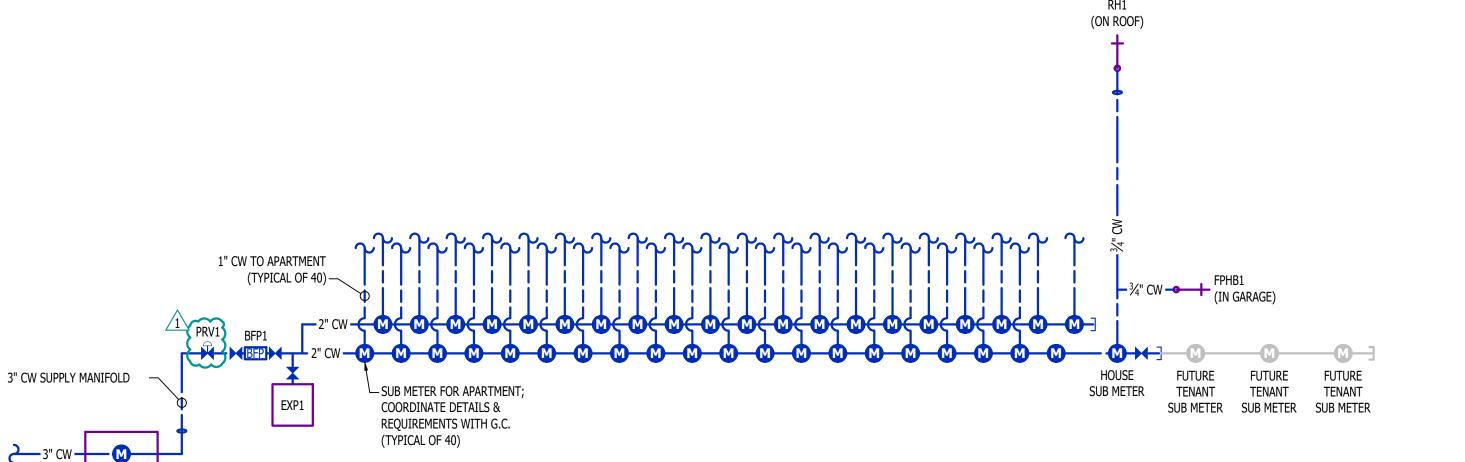

**WATER RISER** 

FIXTURE		SANITAR	Y PIPING	SUPPLY PIPING		
ТҮРЕ	TYPICAL ABBREVIATION	WASTE CONNECTION	VENT CONNECTION	COLD WATER CONNECTION	HOT WATER CONNECTION	
DRINKING FOUNTAIN	DF	1-1/2"	1-1/4"	1/2"	-	
FLOOR DRAIN	FD	3"	2"	-	-	
HAND / HAIR SINK	HS / SK	2"	1-1/4"	1/2"	1/2"	
HOSE BIBB	НВ	-	-	3/4"	-	
LAVATORY	LAV	1-1/2"	1-1/4"	1/2"	1/2"	
MOP SINK	MS	3"	1-1/2"	1/2"	1/2"	
ICE MAKER OUTLET BOX	REF	-	-	1/2"	-	
SHOWER	SH	3"	1-1/2"	1/2"	1/2"	
URINAL	UR	2"	1-1/4"	3/4"	-	
WATER CLOSET (FLUSH TANK)	WC	3"	2"	1/2"	-	
WATER CLOSET (FLUSH VALVE)	WC	3"	2"	1"	-	

1. SIZES SHOWN ABOVE ARE TYPICAL UNLESS NOTED OTHERWISE ON PLANS

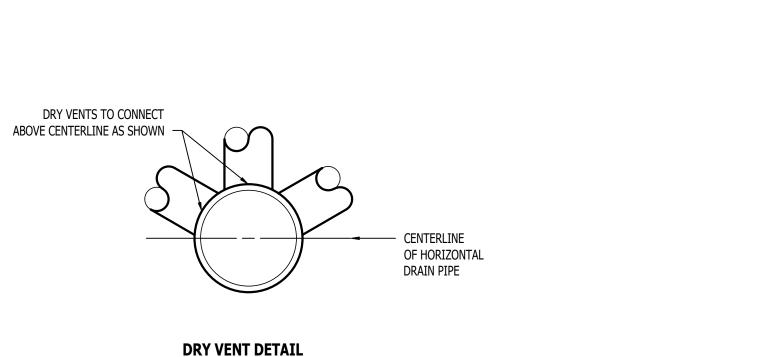

-2" WATER METER IN METER VAULT PER CITY OF

LEE'S SUMMIT STANDARDS (337.6 WFUs)

SANITARY VENT PIPING
(TERMINATE A MIN. OF 24" ABOVE ROOF)

ADJUSTABLE STAINLESS STEEL
CLAMPS / SCREWS (TYP.)


PATE OR EQUAL
STEPPED POLYVINYLCHLORIDE BOOT
CLAMPED TO BASE

PATE OR EQUAL
SPUN ALUMINUM BASE
SET IN MASTIC / SEAL

ROOF INSULATION

REFER TO ARCHITECTURAL
/ STRUCTURAL DRAWINGS FOR
ROOF CONSTRUCTION ASSEMBLY

SEE PLANS FOR PIPE SIZING

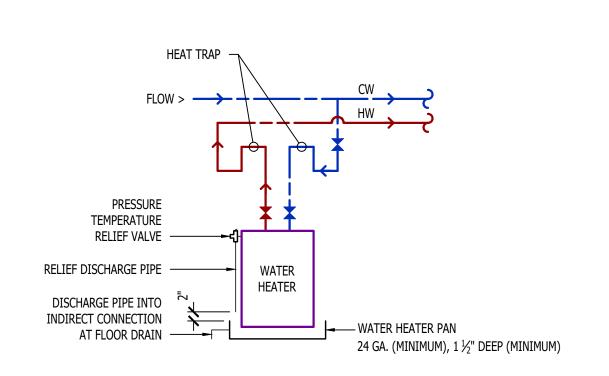

SANITARY VENT THRU ROOF DETAIL WATER HEATER DETAIL

James Watson, P.E. December 18, 2024
PE-2015017071
MO Certificate of Authority # 2018029680

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 J2 PROJECT No:
 J21012

 J2 DESIGN:
 ACW

 ISSUE TITLE
 DATE

 CITY SUBMITTAL
 11 - 27 - 2024

 ADDENDUM #1
 12 - 18 - 2024

scovery Lot 9A

Village at Discove

AHJ APPROVAL STAMP

SHEET TITLE

PLUMBING DETAILS & SCHEDULES

SHEET NUMBER

P501

#### **HVAC PLAN SYMBOL LEGEND**

EQUIPMENT TYPE (REFER TO EQUIPMENT SCHEDULE)

# EQUIPMENT REFERENCE NUMBER

DIFFUSER/GRILLE TYPE (REFER TO SCHEDULE)

CUBIC FEET PER MINUTE (CFM) / FACE SIZE

SUPPLY DUCTWORK

RETURN DUCTWORK

EXHAUST DUCTWORK

FLEX DUCT

SUPPLY DIFFUSER (HATCH INDICATES "NO FLOW ZONE")

RETURN DIFFUSER

BALANCE DAMPER

MOTORIZED DAMPER

CEILING RADIATION DAMPER

BACK DRAFT DAMPER


THERMOSTAT

#### **HVAC PLAN GENERAL NOTES:**

- SEE M500 & M600 SERIES SHEETS FOR HVAC SCHEDULES, DETAILS, REQUIREMENTS, ETC.
- SEE SHEET MEP4 FOR CONDENSING UNIT LOCATIONS. REFRIGERANT PIPING SHALL ROUTE IN SPACES ABOVE FINISHED CEILINGS AND WITHIN WALL CAVITIES TO REMAIN CONCEALED.
- 3. SUPPLY DUCTWORK FROM AHU AT FLOOR/CEILING PENETRATION SHALL BE PROTECTED BY A FIRE DAMPER.
- INSTALL PER MANUFACTURER'S SPECIFICATIONS.
  4. WRAP ALL DRYER DUCTS WITH FIREMASTER (OR EQUAL) DUCT WRAP.
- TOTAL DEVELOPED LENGTH OF EXHAUST DUCT SHALL BE INDICATED ON A PERMANENT LABEL WITHIN 6' OF DRYER VENT CONNECTION. DRYER DUCT ROUTING SHOWN IS FOR REFERENCE ONLY. OVERALL DUCT LENGTH SHALL BE CALCULATED BY HVAC CONTRACTOR PER 2018 IMC 504.8.4.
- 6. LOCATE ALL EXHAUST / DRYER VENT TERMINATIONS AT LEAST 36" FROM OPERABLE OPENINGS INTO APARTMENTS (WINDOWS, DOORS, ETC.).
- 7. ALL DUCTWORK SHOWN SHALL ROUTE IN SPACE BETWEEN / THRU TRUSSES UNLESS NOTED OTHERWISE. SEE STRUCTURAL DRAWINGS FOR DETAILS.

#### **HVAC PLAN KEY NOTES:**

- 1) TERMINATE 4" DRYER EXHAUST WITH VENT EQUAL TO DRYER WALL VENT #DWV4.
- 2) AHU WALL MOUNTED ABOVE WATER HEATER, COORDINATE WITH PLUMBING CONTRACTOR. CONDENSATE TO DISCHARGE IN FLOOR DRAIN WITHIN CLOSET.
- (3) HI/LOW TRANSFER GRILLE (12" A.F.F. ON BEDROOM SIDE OF WALL; 84" A.F.F ON OPPOSITE SIDE OF WALL).
- (4) RESIDENTIAL RECIRCULATION HOOD TO BE SUPPLIED & INSTALLED BY GC.

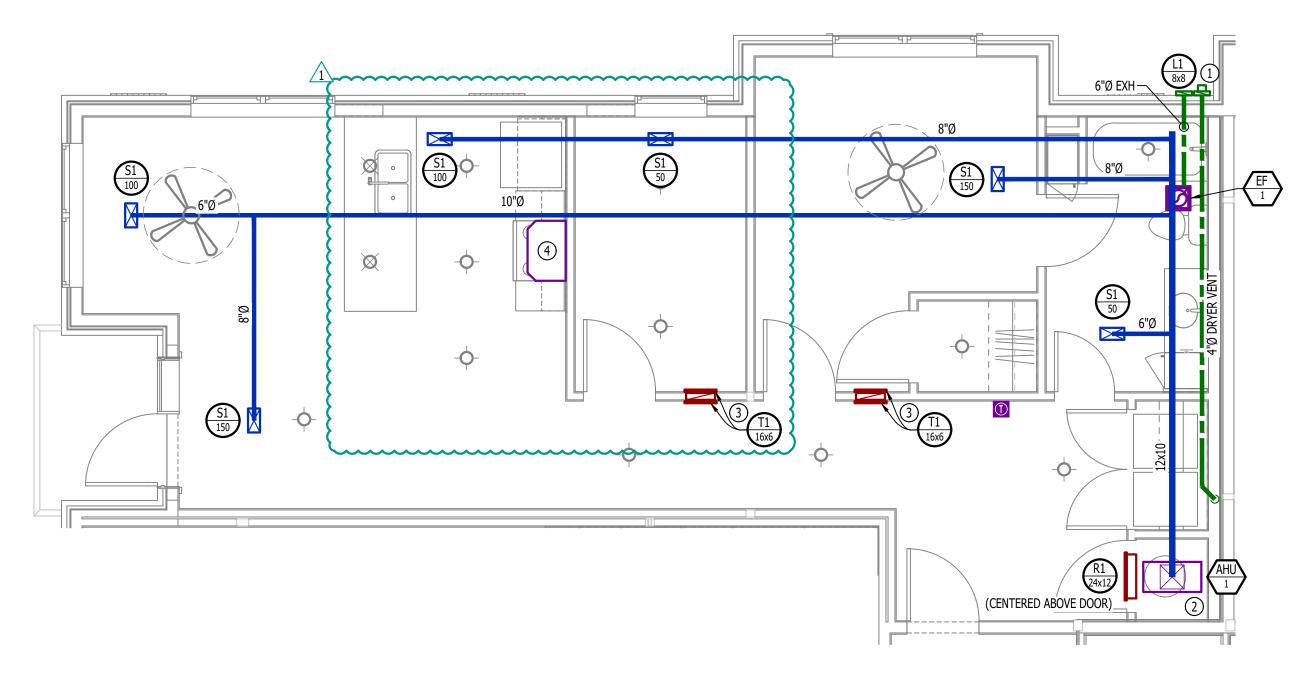

**HVAC PLAN** 

SCALE: 1/4" = 1'-0"

#### PLUMBING PLAN SYMBOL LEGEND

COLD WATER LINE

HOT WATER LINE

VALVE


PIPING TURNED DOWN / TURNED UP

#### **WATER PLAN GENERAL NOTES:**

- 1. SEE SHEET P501 FOR ADDITIONAL PLUMBING NOTES, DETAILS, & SCHEDULES.
- ALL PLUMBING LOCATED ON EXTERIOR WALLS SHALL ROUTE WITHIN INSULATION BARRIER.
   ALL DOMESTIC SUPPLY LINES SERVING MORE THAN (1) FIXTURE SHALL BE ¾" UNLESS NOTED OTHERWISE.

#### **WATER PLAN KEY NOTES:**


 $\bigcirc$  3/4" CW PIPE UP FROM BELOW WITH SHUT-OFF VALVE IN ACCESSIBLE LOCATION. SEE OVERALL PLUMBING PLANS FOR DETAILS.

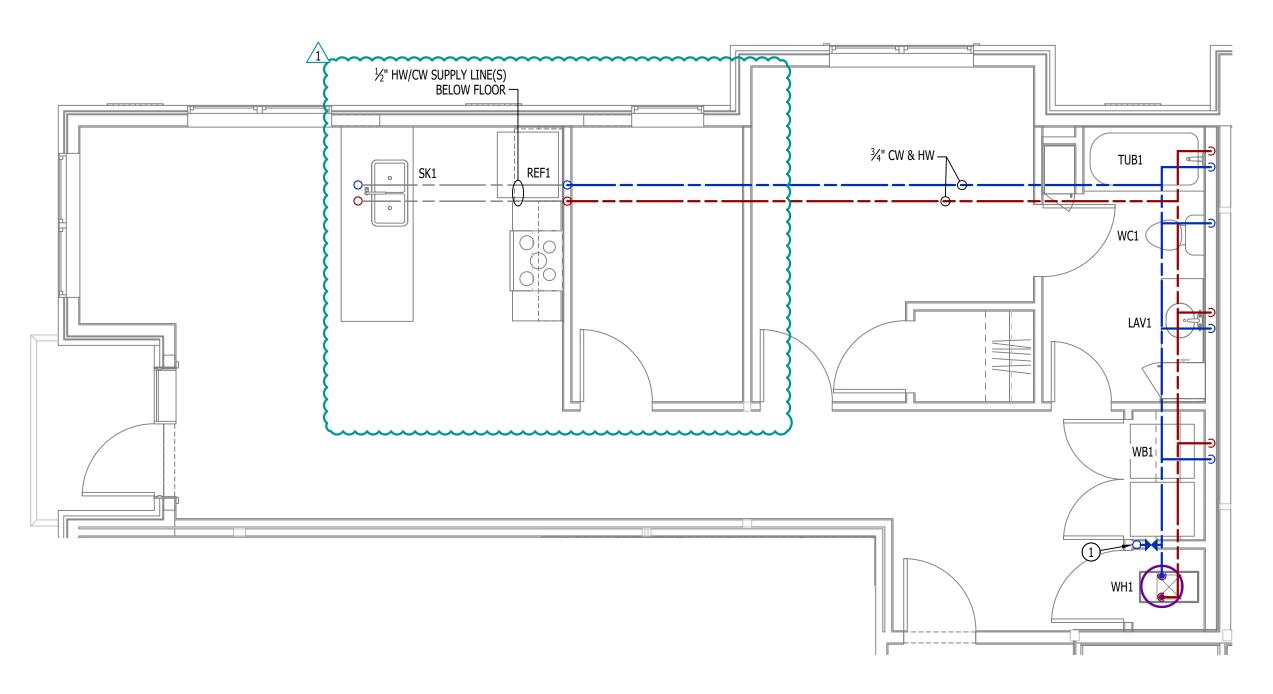

WATER PLAN

SCALE: 1/4" = 1'-0"

James Watson, P.E. December 18, 2024 PE-2015017071 MO Certificate of Authority # 2018029680

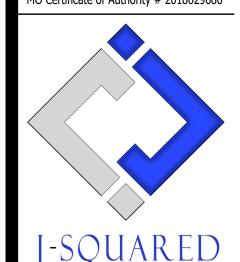

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DESIGN:	ACW			
UE TITLE	DATE			
Y SUBMITTAL	11 - 27 - 2024			
DENDUM #1	12 - 18 - 2024			

at Discovery Lot 9A

MECHANICAL - ELECTRICAL - PLUMBING DES
VIllage at Discovery

AHJ APPROVAL STAMP

SHEET TIT

HVAC &
PLUMBING
PLAN - UNIT
TYPE DRAKE

SHEET NUMBER

**UMEP1.5.1** 

#### POWER PLAN SYMBOL LEGEND

CIRCUIT WIRING

→ PX-XX CIRCUIT TAG

JUNCTION BOX

- INDICATES MOUNTING HEIGHT TO BOTTOM OF BOX (STANDARD @ 18" AFF UNLESS NOTED OTHERWISE)

"WP" = WEATHERPROOF OUTDOOR RECEPTACLE

GFCI DUPLEX CONVENIENCE RECEPTACLE

208V RECEPTACLE

QUADPLEX CONVENIENCE RECEPTACLE

DATA / PHONE JACK; BOX WITH 1" CONDUIT & CAT6 CABLE BACK TO MEDIA PANEL LOCATION

(STANDARD @ 18" AFF UNLESS NOTED OTHERWISE)

DISCONNECT


120V IONIZATION SMOKE 520Hz LOW FREQUENCY ALARM WITH SILENCING CAPABILITIES & LOW-VOLTAGE CONTACTS WIRED TO SHUT DOWN AHU UPON FIRE DETECTION. COORDINATE WITH HVAC CONTRACTOR. SMOKE DETECTOR MUST BE LOCATED AT LEAST 3' FROM CEILING FAN BLADES AND AT LEAST 10' FROM ANY COOKING APPLIANCE (FIELD-COORDINATE)

#### **POWER PLAN GENERAL NOTES:**

- 1. SEE E500 & E600 SERIES SHEETS FOR POWER SCHEDULES, DETAILS, REQUIREMENTS, ETC.
- 2. SEE SHEET MEP3 FOR CONDENSING UNIT LOCATIONS. 3. VERIFY EACH DATA/RECEPTACLE LOCATION WITH OWNER PRIOR TO INSTALLATION.
- 4. REFER TO "TYPICAL ADA MOUNTING HEIGHTS DETAIL", E500 & E600 SERIES SHEETS, OR MOUNTING HEIGHTS OF DEVICES IN "ANSI A" UNITS.

#### **POWER PLAN KEY NOTES:**

1 MEDIA PANEL LOCATION; DATA/TV WIRING TO TERMINATE AT THIS LOCATION. DETERMINE EXACT LOCATION & DETAILS WITH OWNER PRIOR TO INSTALLATION.

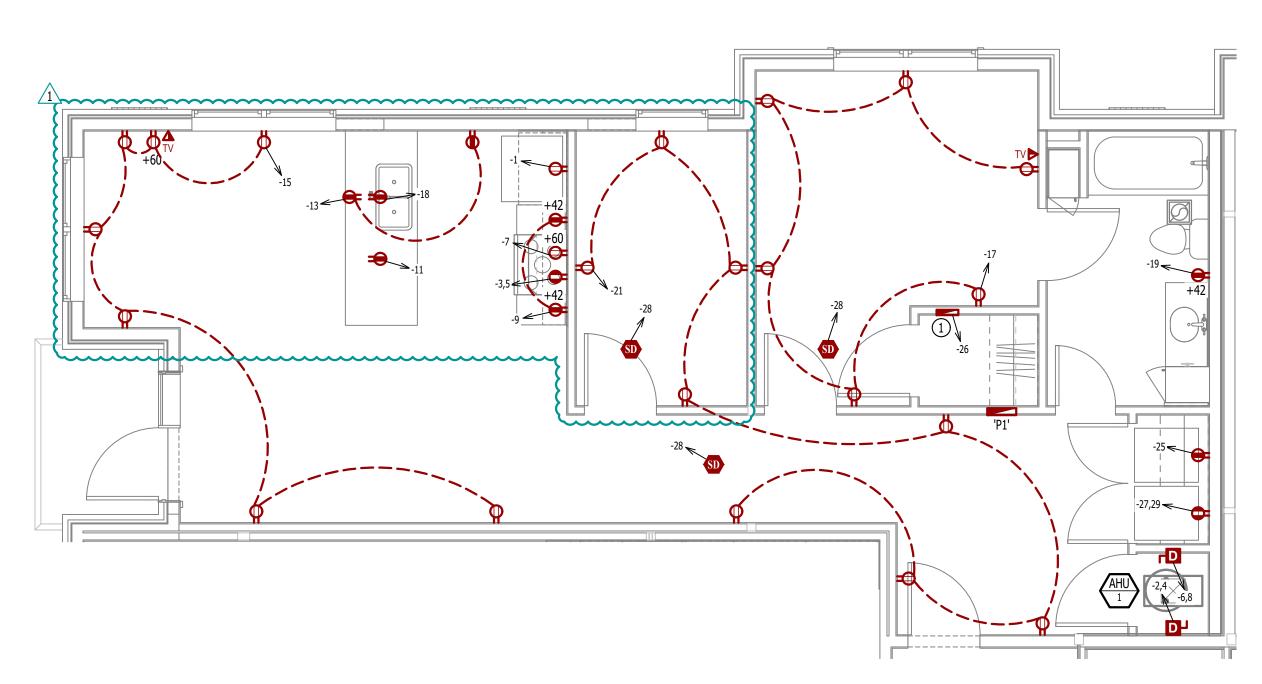

**POWER PLAN** 

SCALE: 1/4" = 1'-0"

#### LIGHTING PLAN SYMBOL LEGEND

LIGHTING FIXTURE

"X1" INDICATES FIXTURE TYPE (REFER TO SCHEDULE)


DIMMER SWITCH

TOGGLE SWITCH SWITCH TYPE

#### **LIGHTING PLAN GENERAL NOTES:**

SEE E500 & E600 SERIES SHEETS FOR ADDITIONAL ELECTRICAL NOTES, DETAILS, & SCHEDULES.

2. ALL LIGHTING SHOWN SHALL BE ON CIRCUIT 16 UNLESS NOTED OTHERWISE.

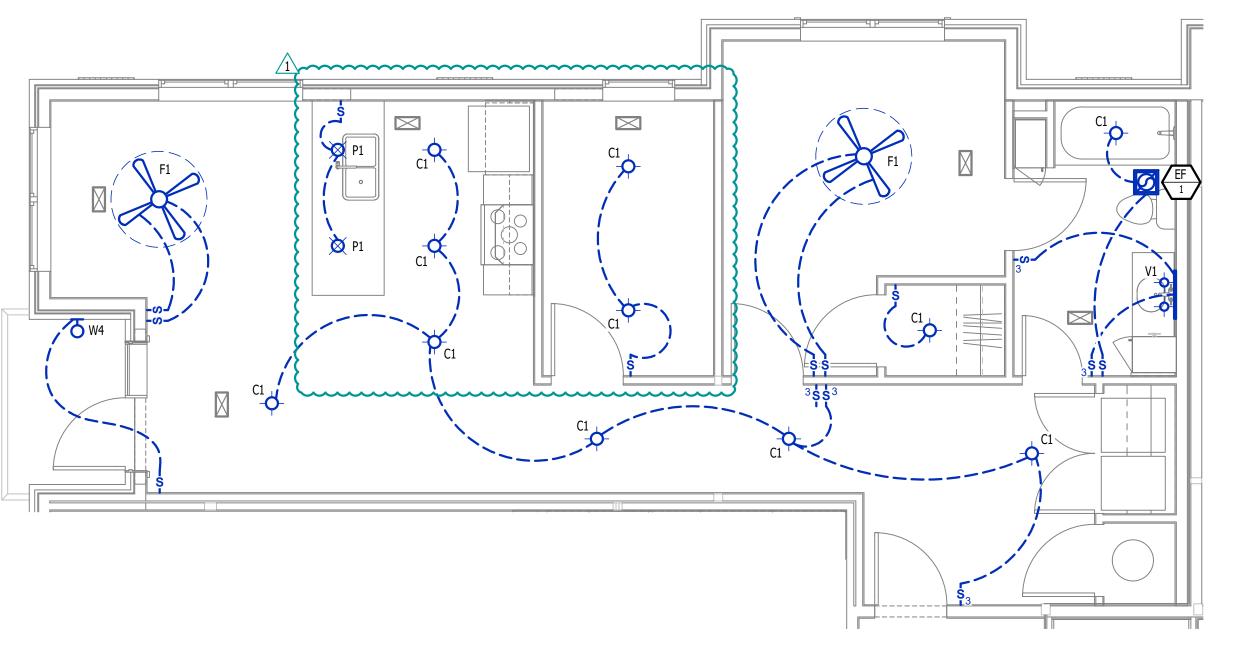

LIGHTING PLAN

SCALE: 1/4" = 1'-0"

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J2 DESIGN:	ACW
ISSUE TITLE	DATE
CITY SUBMITTAL	11 - 27 - 2024
ADDENDUM #1	12 - 18 - 2024

ANICAL - ELECTI

AHJ APPROVAL STAMP

POWER & LIGHTING PLAN - UNIT TYPE DRAKE

**UMEP1.5.2** 

## **POWER PLAN SYMBOL LEGEND**

CIRCUIT WIRING

→ PX-XX CIRCUIT TAG JUNCTION BOX

RECEPTACLE

 INDICATES MOUNTING HEIGHT TO BOTTOM OF BOX (STANDARD @ 18" AFF UNLESS NOTED OTHERWISE) ─ "WP" = WEATHERPROOF OUTDOOR RECEPTACLE

GFCI DUPLEX CONVENIENCE RECEPTACLE

208V RECEPTACLE

QUADPLEX CONVENIENCE RECEPTACLE

**POWER PLAN - FIRST FLOOR** 

SCALE: 1/4" = 1'-0"

DATA / PHONE JACK; BOX WITH 1" CONDUIT & CAT6 CABLE BACK TO MEDIA PANEL LOCATION (STANDARD @ 18" AFF UNLESS NOTED OTHERWISE)

DISCONNECT

120V IONIZATION SMOKE 520Hz LOW FREQUENCY ALARM WITH SILENCING CAPABILITIES & LOW-VOLTAGE CONTACTS WIRED TO SHUT DOWN AHU UPON FIRE DETECTION. COORDINATE WITH HVAC CONTRACTOR. SMOKE DETECTOR MUST BE LOCATED AT LEAST 3' FROM CEILING FAN BLADES AND AT LEAST 10' FROM ANY COOKING APPLIANCE (FIELD-COORDINATE)

#### **POWER PLAN GENERAL NOTES:**

- SEE E500 & E600 SERIES SHEETS FOR POWER SCHEDULES, DETAILS, REQUIREMENTS, ETC.
- SEE SHEET MEP3 FOR CONDENSING UNIT LOCATIONS.
- 3. VERIFY EACH DATA/RECEPTACLE LOCATION WITH OWNER PRIOR TO INSTALLATION.
- 4. REFER TO "TYPICAL ADA MOUNTING HEIGHTS DETAIL", E500 & E600 SERIES SHEETS, OR MOUNTING HEIGHTS OF DEVICES IN "ANSI A" UNITS.

#### **POWER PLAN KEY NOTES:**

1 MEDIA PANEL LOCATION; DATA/TV WIRING TO TERMINATE AT THIS LOCATION. DETERMINE EXACT LOCATION & DETAILS WITH OWNER PRIOR TO INSTALLATION.

**POWER PLAN - SECOND FLOOR** SCALE: 1/4" = 1'-0"

## LIGHTING PLAN SYMBOL LEGEND

(REFER TO SCHEDULE)

LIGHTING FIXTURE "X1" INDICATES FIXTURE TYPE

TOGGLE SWITCH SWITCH TYPE

DIMMER SWITCH

#### **LIGHTING PLAN GENERAL NOTES:**

SEE E500 & E600 SERIES SHEETS FOR ADDITIONAL ELECTRICAL NOTES, DETAILS, & SCHEDULES.
 ALL LIGHTING SHOWN SHALL BE ON CIRCUIT 16 UNLESS NOTED OTHERWISE.

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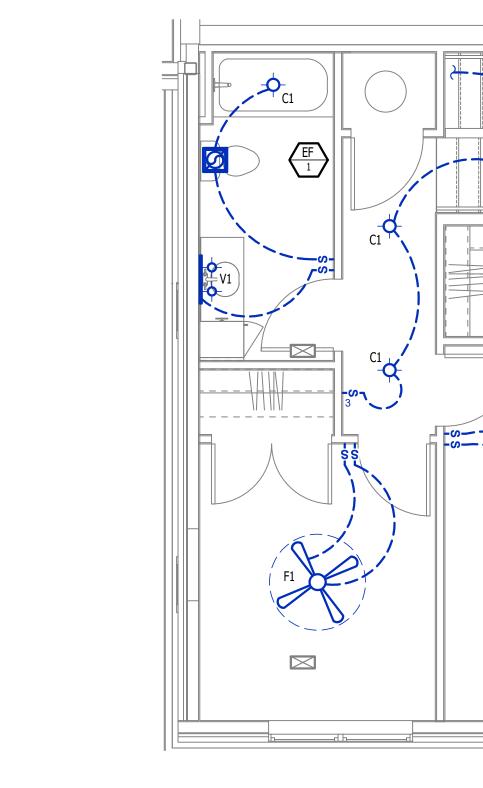
ANICAL - ELECTI
VIIIAGE

AHJ APPROVAL STAMP

POWER & LIGHTING PLAN - UNIT TYPE **BROWNSTONE** 

**UMEP2.4.2** 

SCALE: 1/4" = 1'-0"



SCALE: 1/4" = 1'-0"

**LIGHTING PLAN - FIRST FLOOR LIGHTING PLAN - SECOND FLOOR**