

BUILD IN ACCORDANCE WITH
2018 INTERNATIONAL
RESIDENTIAL CODE AND
LOCAL CODES.



PLAN SERVICES

715 SE 4th St.
Topeka, KS 66607
P: 785.357.0321
F: 785.233.4755

These drawings have been prepared by John Roe, to meet top design practices and standards. Although great care has been taken in the design of this structure, the builder is solely responsible to review plans, details and all dimensions in order to insure the drawings are free of errors, omissions, defects and are in code compliance. Consultation with an engineer may be required. Any form of direct reproduction of this drawing is prohibited. All rights reserved.

A New Home For:
Trumark Homes
Lot 169 Woodside Ridge Reserve- Bosley Residence
2117 NW O'Brien Rd
LEE SUMMIT MO

DRAWN
J. L. ROE
DATE
11/4/24
JOB NO.
242040
REVISIONS
11/5/24
11/12/24

SCALE
1/4" = 1'-0"

PLAN NO.
4341

DATE
11-20-24

SHEET NO.
1 OF 5


SHEET

1

OF 4

NOTE: J.L. ROE IS NOT A REGISTERED ARCHITECT

RELEASE FOR CONSTRUCTION
AS NOTED FOR PLAN REVIEW
DEVELOPMENT SERVICES
LEE'S SUMMIT, MISSOURI
11/26/2024

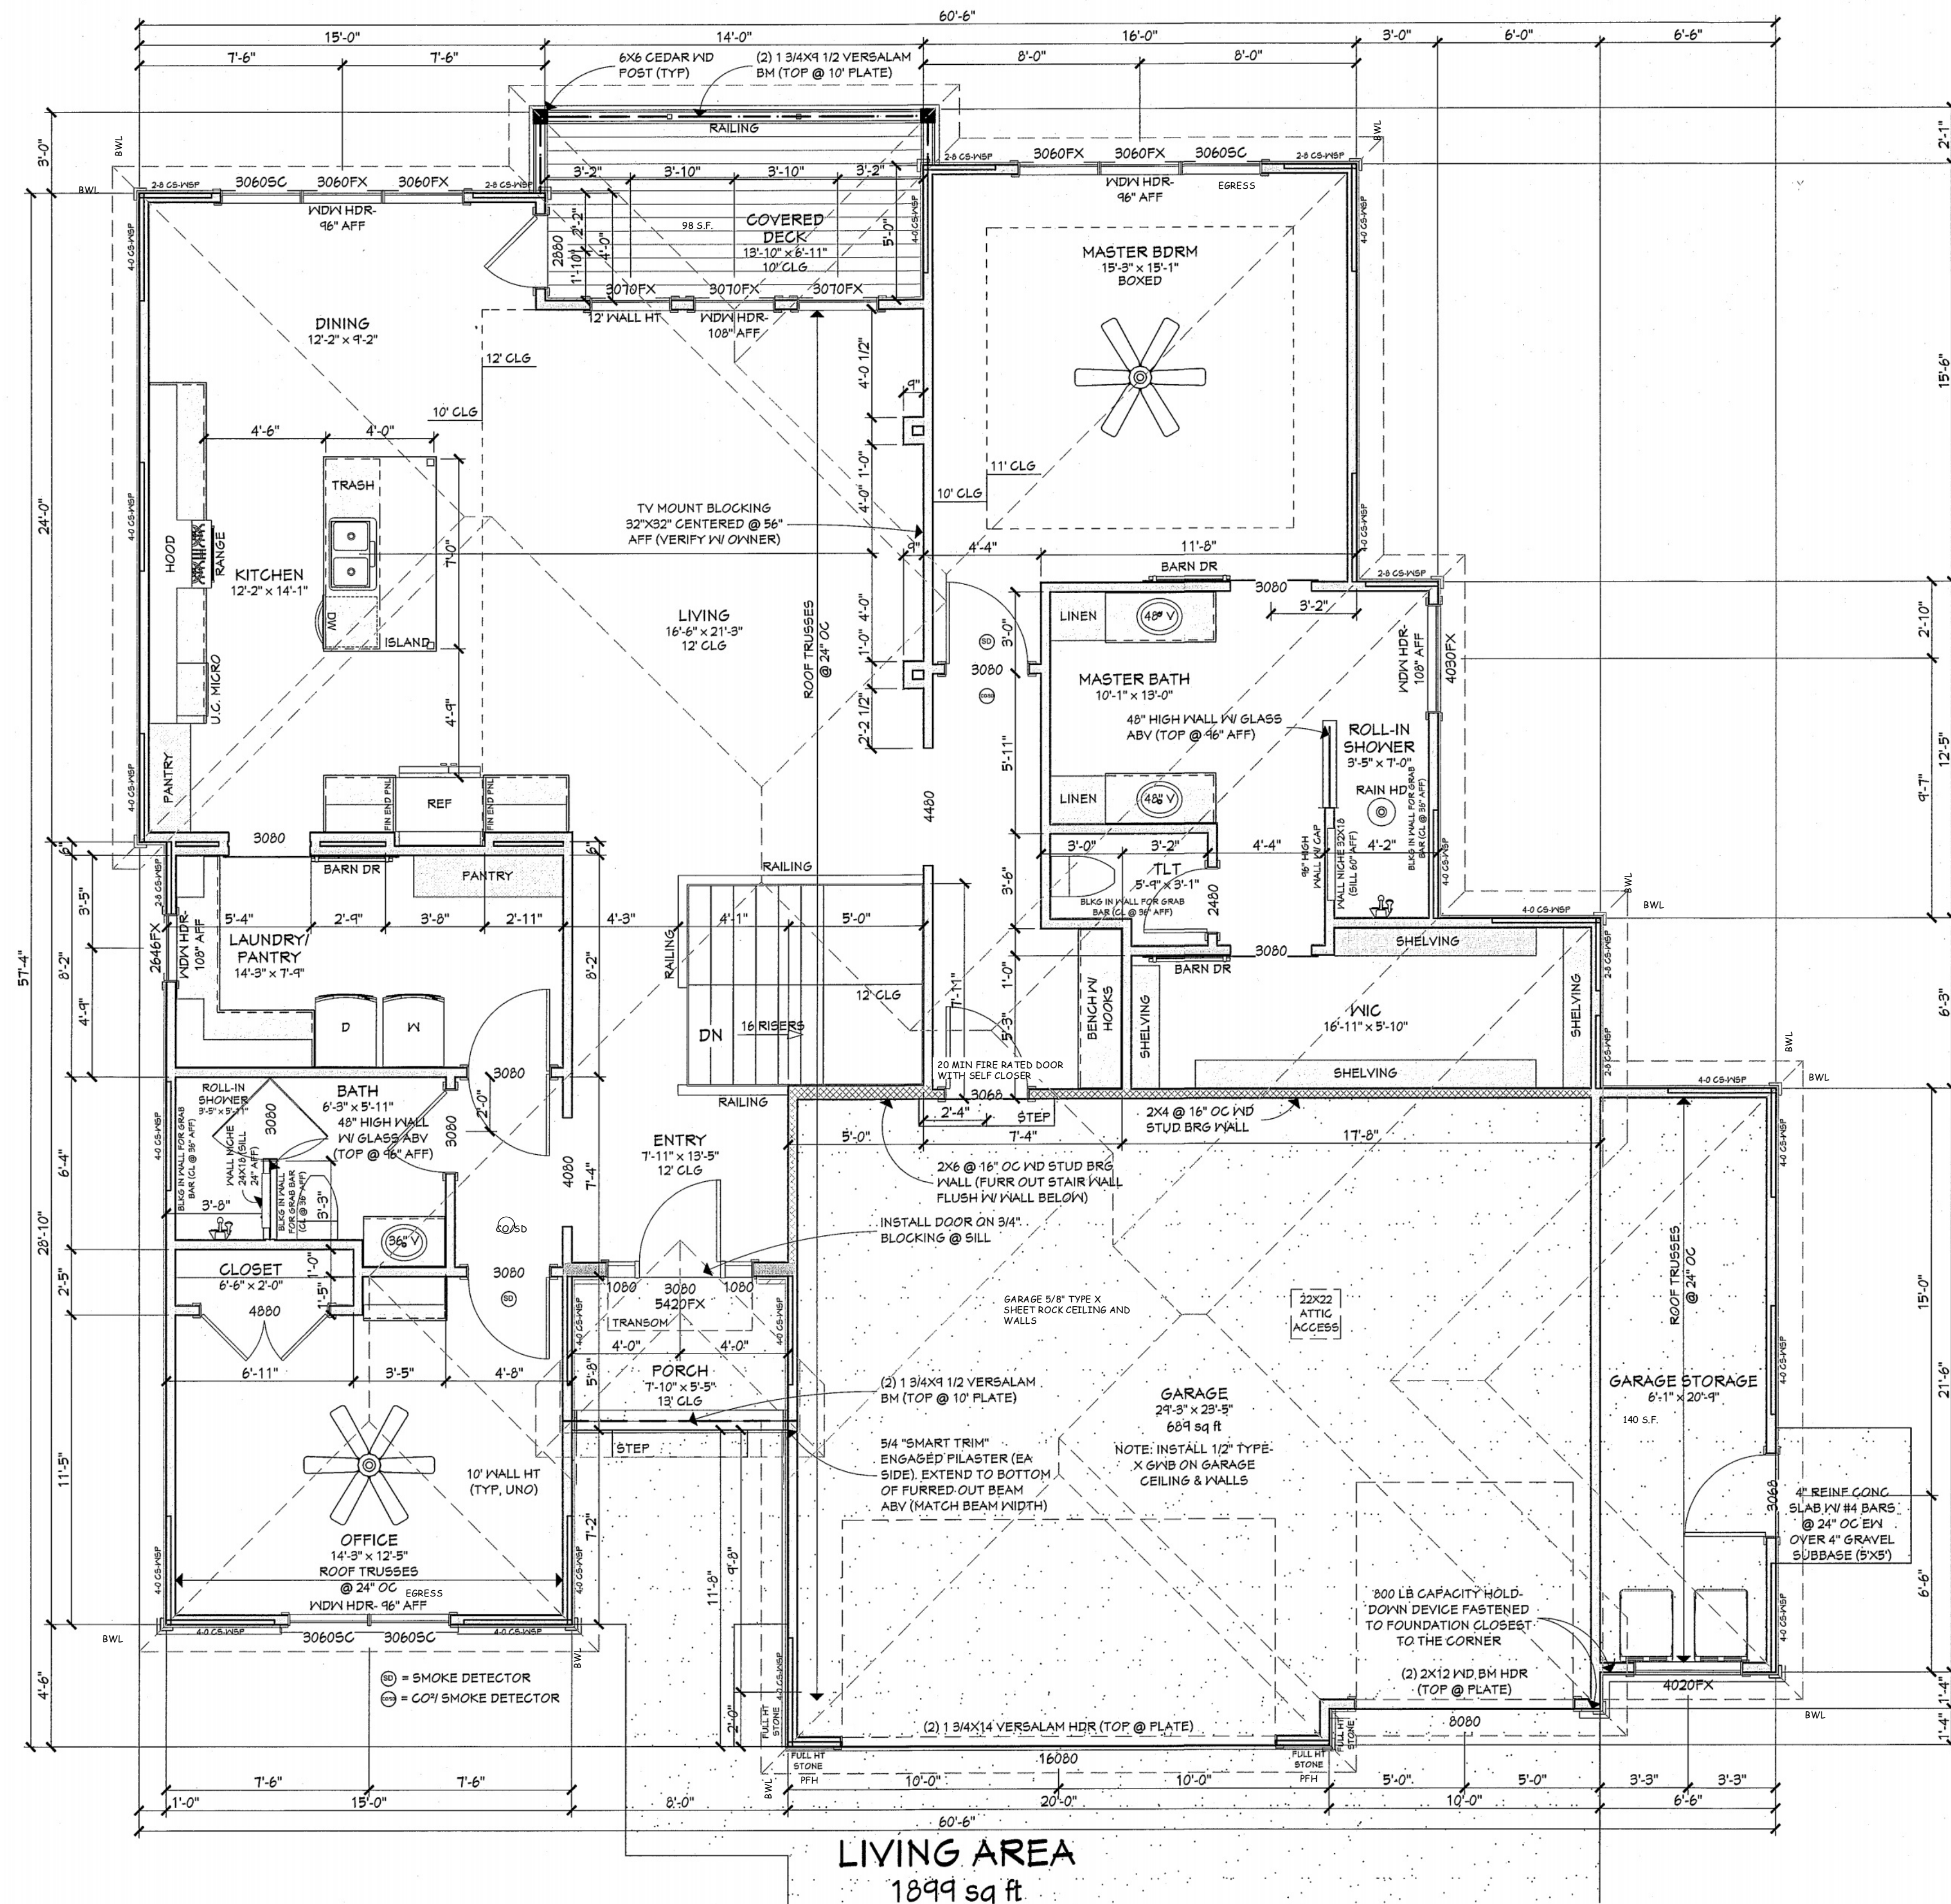

FIRST FLOOR PLAN

SCALE: 1/4"=1'-0"

GENERAL NOTES:

- CEILINGS SHALL BE 10'-1 1/8" UNO.
- ROOF TRUSSES (CANTILEVER TYPE) SHALL BE @ 24" OC & DESIGNED BY TRUSS MFR (SEE ROOF PLAN FOR SLOPE)
- ROOF OVERHANGS SHALL BE 12" @ GABLES & 12" @ EAVES, UNO.

Review and Approval
Structural Only

David Mezger Engineering LLC
212 NE Circle Dr.
Kansas City, MO 64116



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McCray

Lumber

Serving the Professional Builder

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LEE SUMMIT MO


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11/12/24

SHEET

2

OF 4

NOT FOR CONSTRUCTION
NOT FOR PLAN REVIEW
NOT FOR PERMIT SERVICES
LEE SUMMIT, MISSOURI
11/26/2024

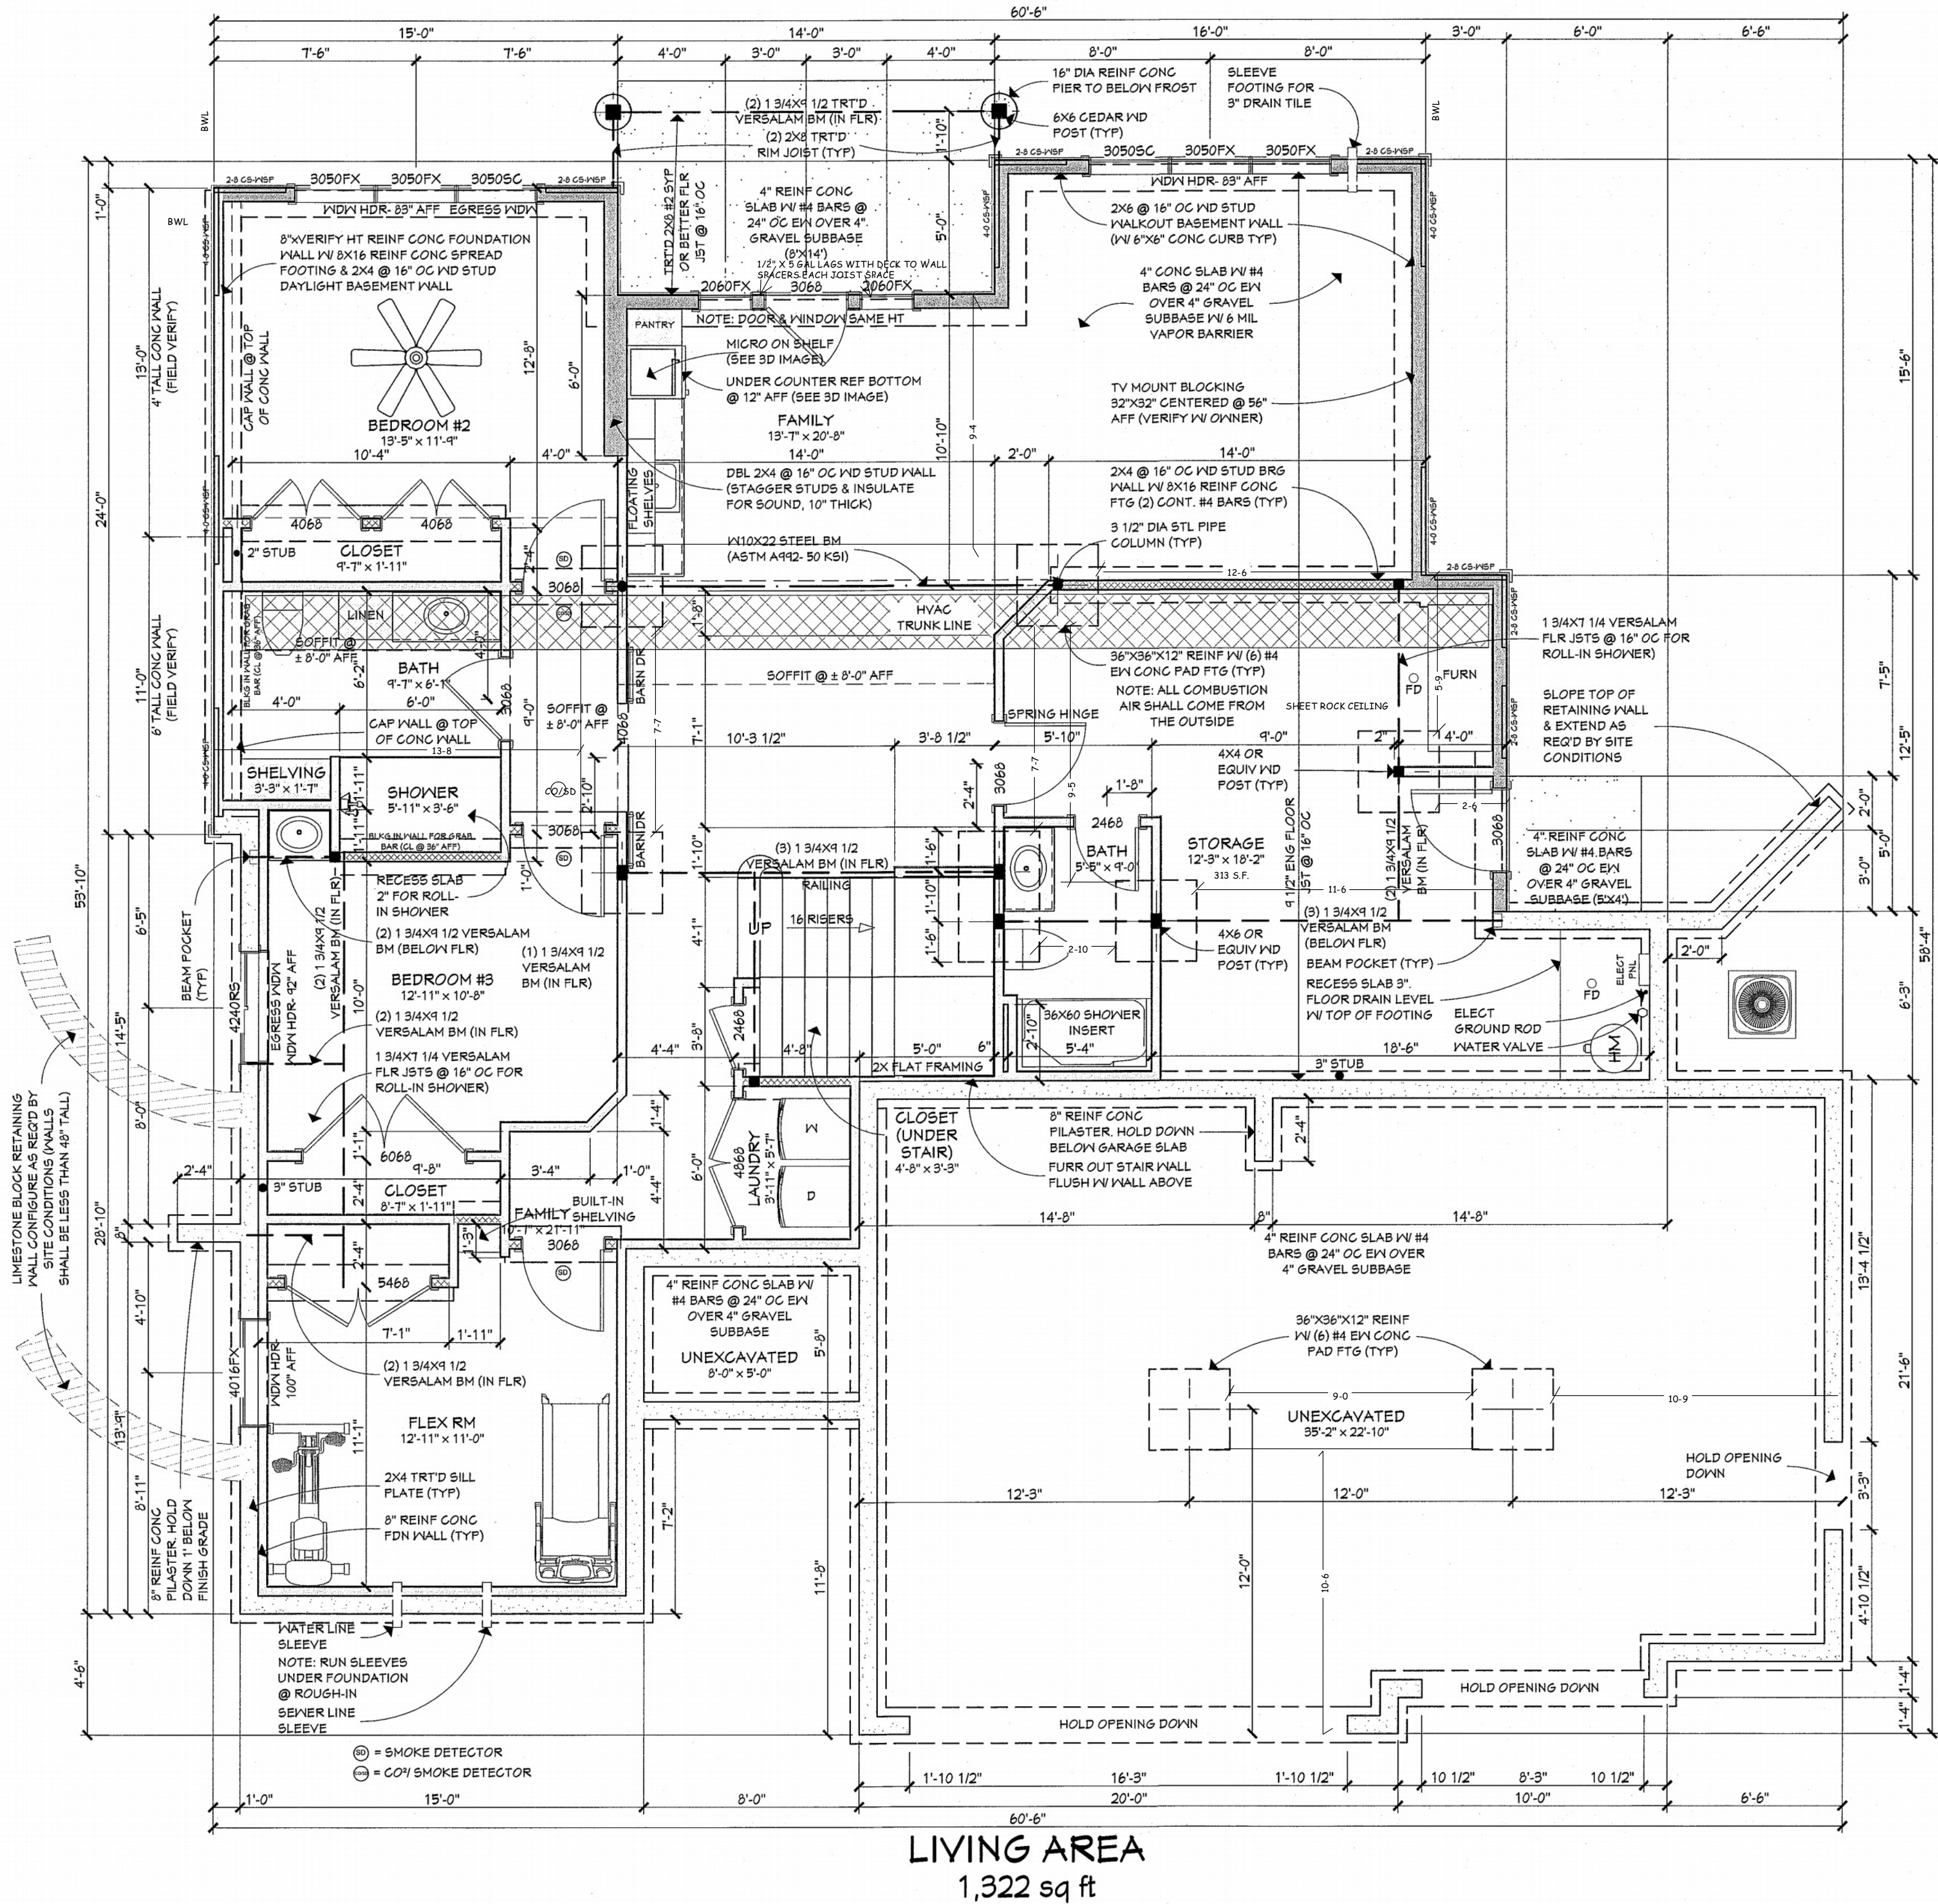


FOUNDATION PLAN
SCALE: 1/4"=1'-0"

GENERAL NOTES:
1. FOUNDATION WALLS SHALL BE 9'-0" UNO.

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212 NE Circle Dr.
Kansas City, MO 64116

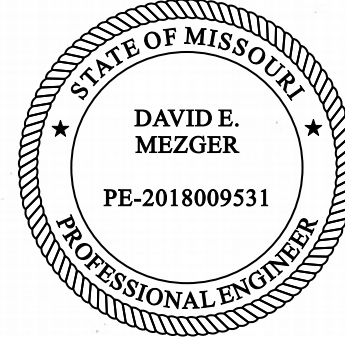


SCALE 1/4" = 1-0	PLAN NO. 4341
DATE 11-20-24	SHEET NO. 2 OF 5

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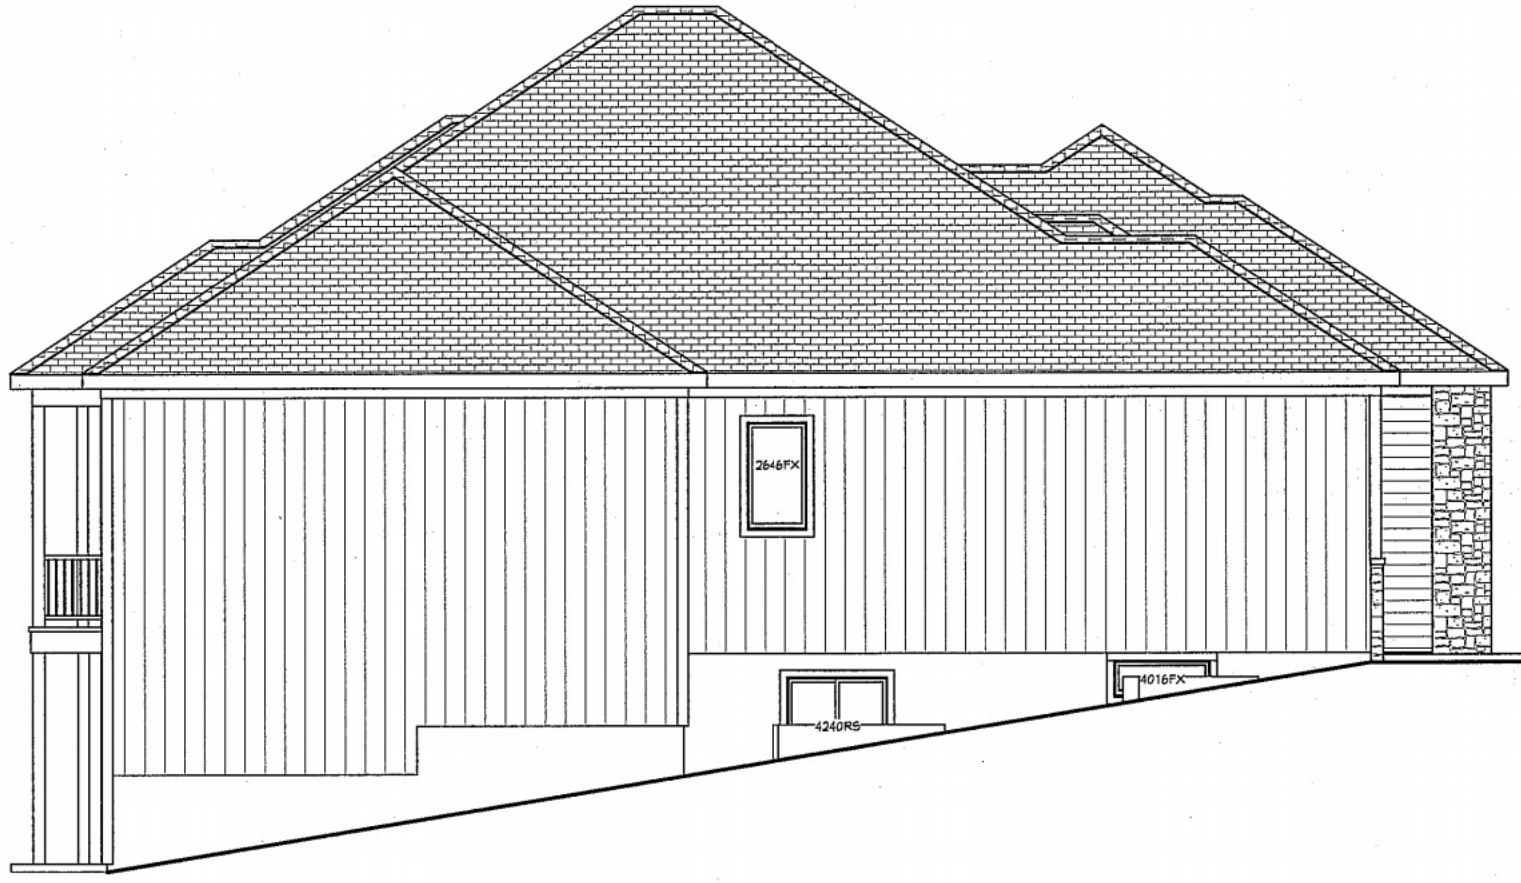
RIGHT SIDE ELEVATION
SCALE: 1/8"=1'-0"

NOTE:
SIDING ON BACK & SIDES SHALL BE LP SMART SIDING-
SHEET SIDING W/ 8" GROOVES




REAR ELEVATION
SCALE: 1/8"=1'-0"

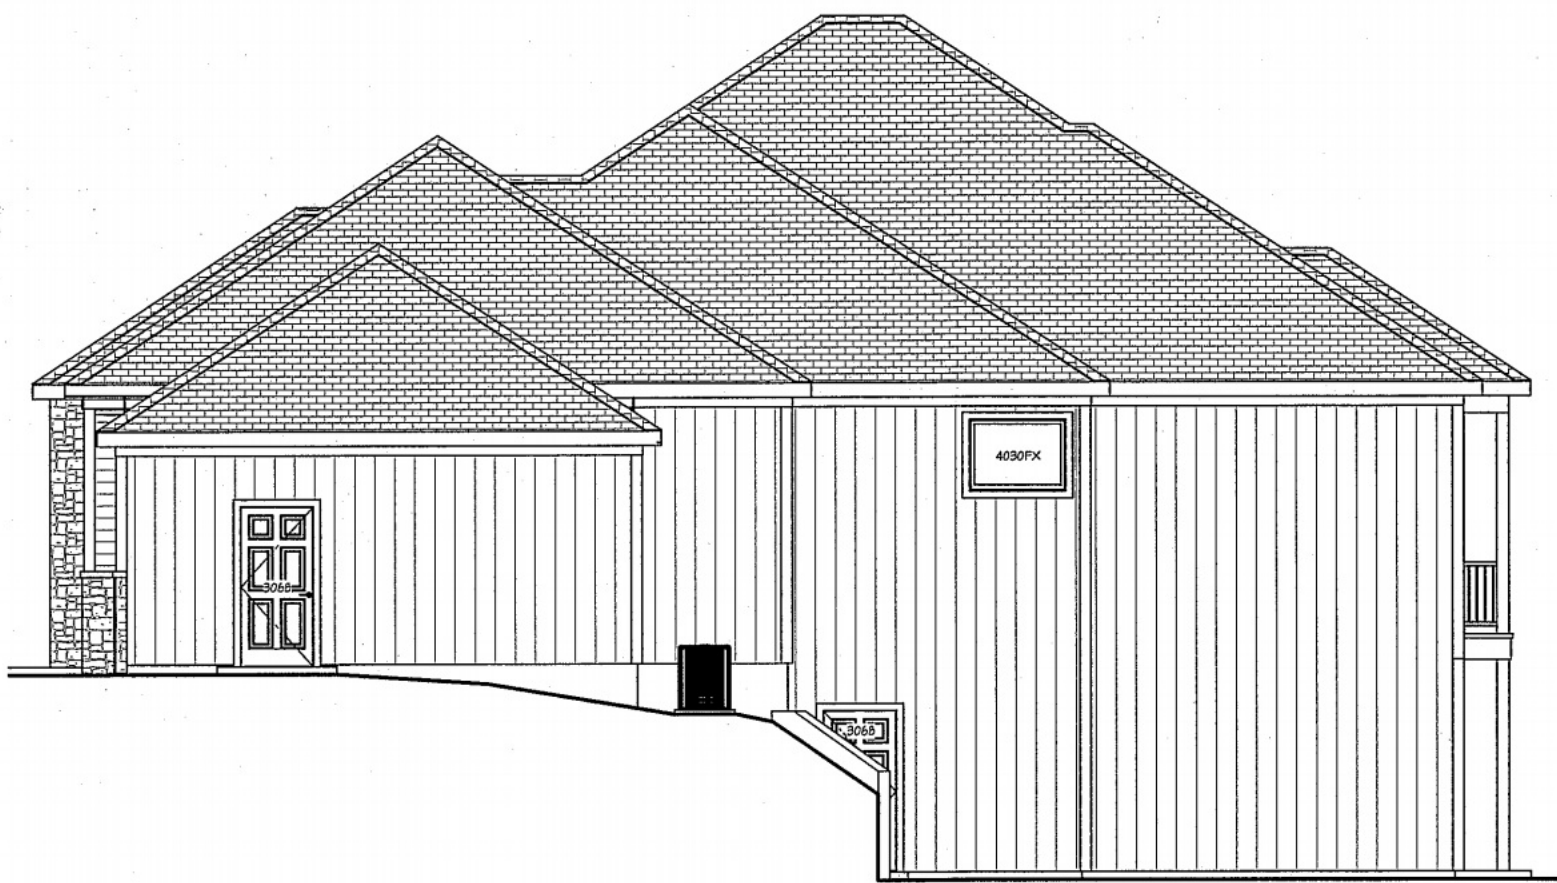NOTE:
SIDING ON BACK & SIDES SHALL BE LP SMART SIDING-
SHEET SIDING W/ 8" GROOVES



LEFT SIDE ELEVATION
SCALE: 1/8"=1'-0"

NOTE:
SIDING ON BACK & SIDES SHALL BE LP SMART SIDING-
SHEET SIDING W/ 8" GROOVES

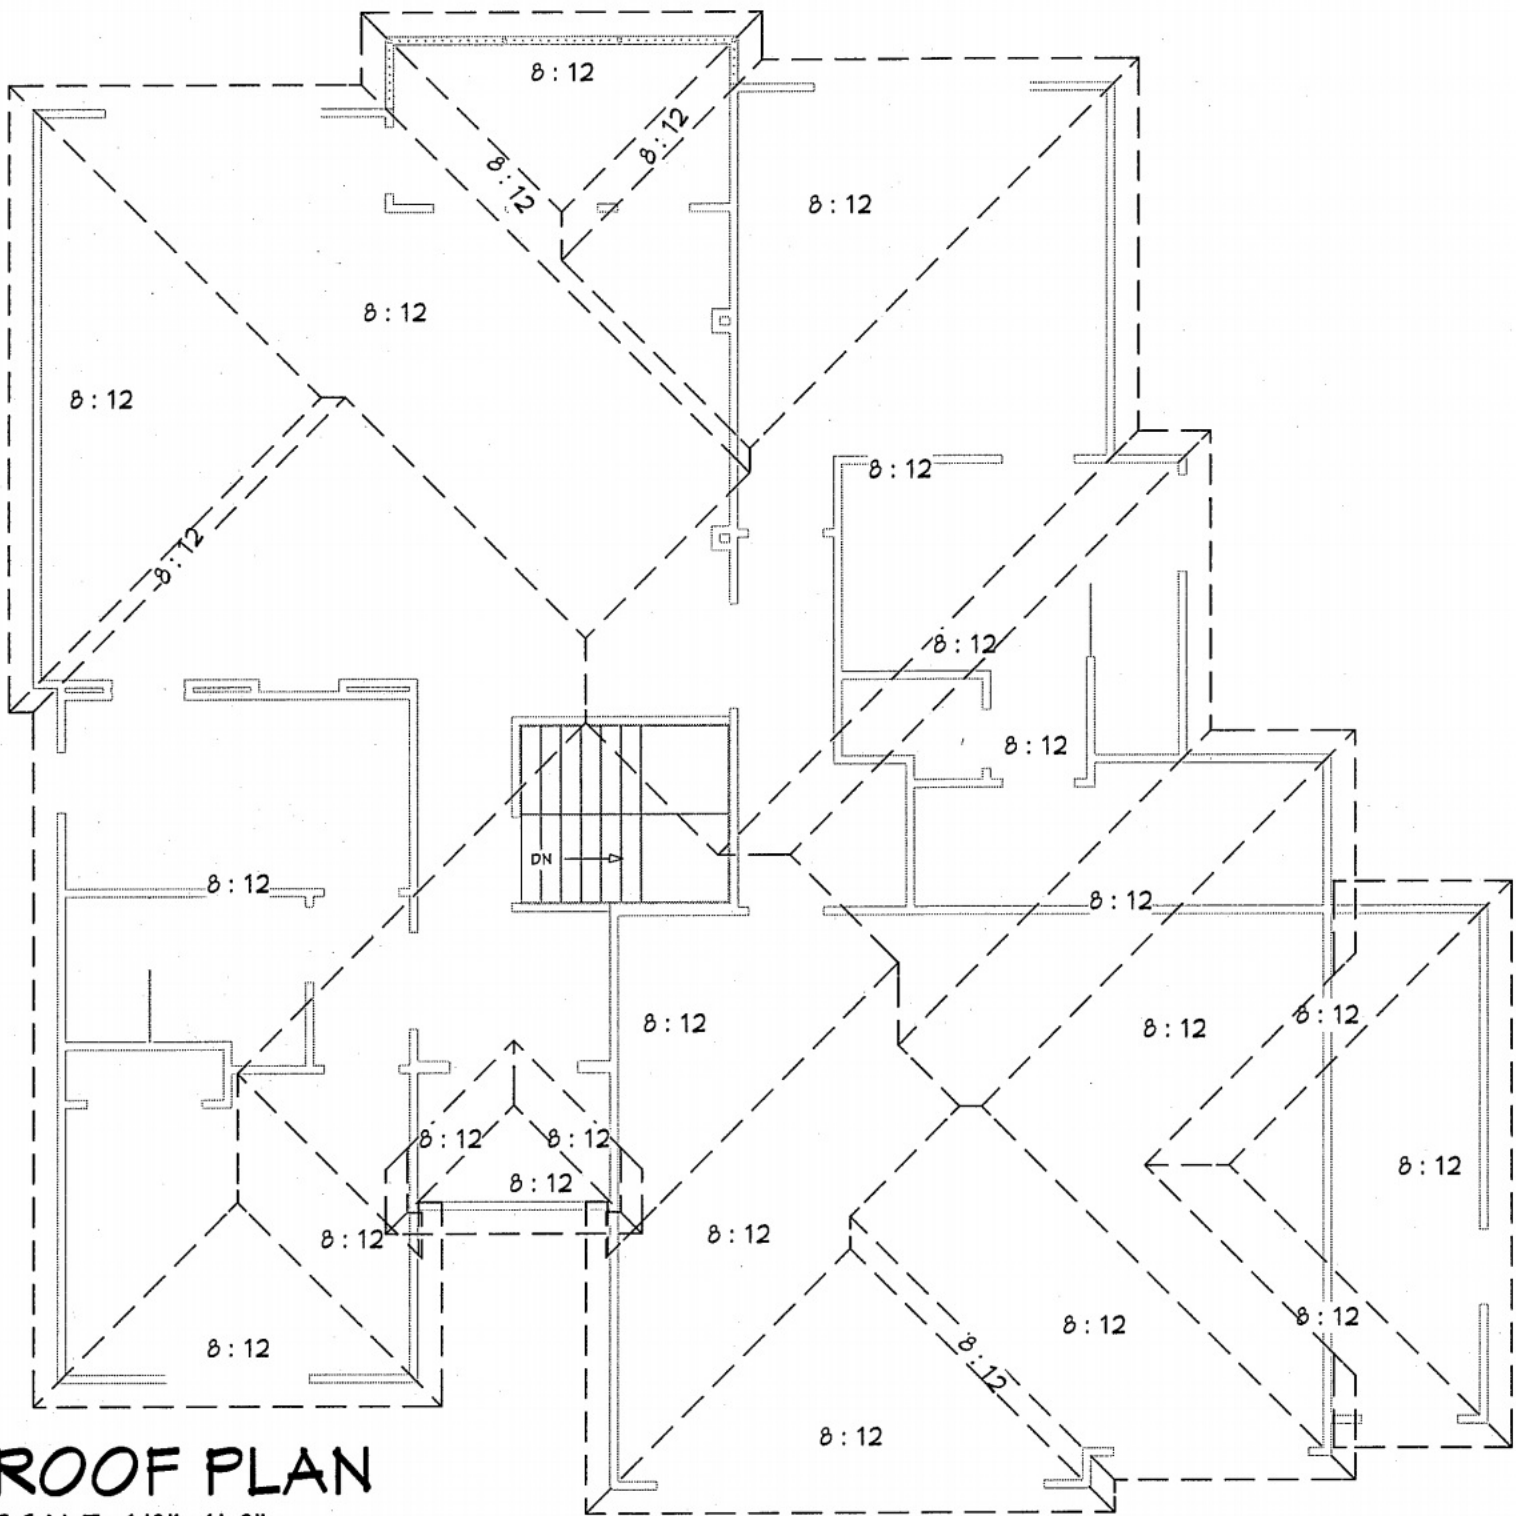

ROOF PLAN
SCALE: 1/8"=1'-0"




FRONT ELEVATION
SCALE: 1/4"=1'-0"

NOTE:
SIDING SHALL BE LP SMART SIDING-
NICKEL GAP LAP SIDING- ON THE FRONT & RETURNS
THIN STONE VENEER- ON THE FRONT & RETURNS AS SHOWN ON THE PLAN

GARAGE DOORS SHALL BE "LONG BEAD BOARD STYLE"

Review and Approval
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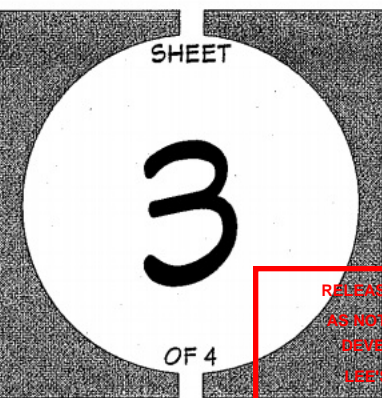
David Mezger Engineering LLC
212 NE Circle Dr.
Kansas City, MO 64116

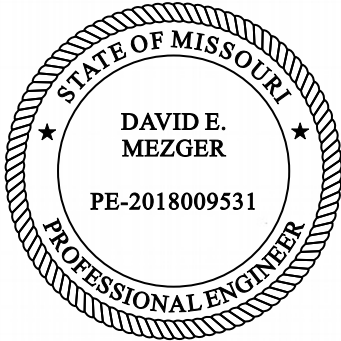

SCALE 1/4" = 1-0	PLAN NO. 4341
DATE 11-20-24	SHEET NO. 3 OF 5

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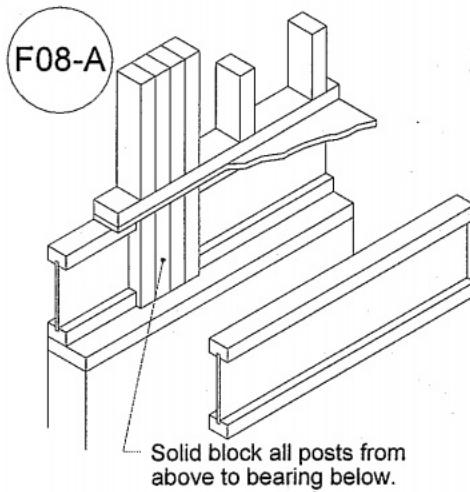
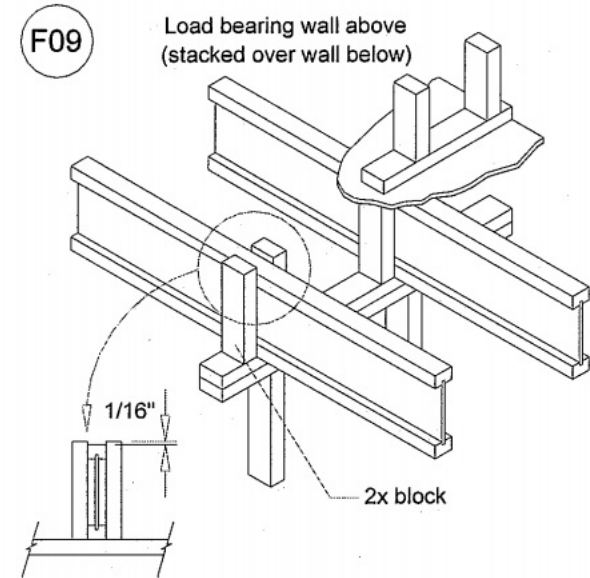


FOR CONSTRUCTION
FOR PLAN REVIEW
FOR PERMITS
LEE SUMMIT, MISSOURI
11/26/2024

Trumark Homes LLC
Bosley Residence

Recommended 1st Floor Placement Plan



Joist Spacing 16" O.C



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Products					
PlotID	Net Qty	Product	Length	Plies	
FJ1	10	9-1/2" BCI@ 4500s-1.8	36' 0"	1	
FJ2	3	9-1/2" BCI@ 4500s-1.8	30' 0"	1	
FJ3	4	9-1/2" BCI@ 4500s-1.8	28' 0"	1	
FJ4	8	9-1/2" BCI@ 4500s-1.8	26' 0"	1	
FJ5	4	9-1/2" BCI@ 4500s-1.8	24' 0"	1	
FJ6	11	9-1/2" BCI@ 4500s-1.8	22' 0"	1	
FJ7	2	9-1/2" BCI@ 4500s-1.8	16' 0"	1	
FJ8	8	9-1/2" BCI@ 4500s-1.8	14' 0"	1	
FJ9	13	9-1/2" BCI@ 4500s-1.8	8' 0"	1	
FJ10	2	1-3/4" x 7-1/4" VERSA-LAM® LVL 2.1E 3100 SP	8' 0"	1	
FJ11	9	1-3/4" x 7-1/4" VERSA-LAM® LVL 2.1E 3100 SP	6' 0"	1	
BM1-3	3	1-3/4" x 9-1/2" VERSA-LAM® LVL 2.1E 3100 SP	20' 0"	3	
BM2-2	2	1-3/4" x 9-1/2" VERSA-LAM® LVL 2.1E 3100 SP	18' 0"	2	
BM3-3	3	1-3/4" x 9-1/2" VERSA-LAM® LVL 2.1E 3100 SP	16' 0"	3	
BM4-2	2	1-3/4" x 9-1/2" VERSA-LAM® LVL 2.1E 3100 SP	14' 0"	2	
BM5-2	2	1-3/4" x 9-1/2" VERSA-LAM® LVL 2.1E 3100 SP	10' 0"	2	
BM6	1	1-3/4" x 9-1/2" VERSA-LAM® LVL 2.1E 3100 SP	8' 0"	1	
BM7-2	2	1-3/4" x 9-1/2" VERSA-LAM® LVL 2.1E 3100 SP	4' 0"	2	
Ca1	21	1-1/8" x 9-1/2" BC RIM BOARD OSB	12' 0"	1	
Bk1	40	9-1/2" BCI@ 4500s-1.8	2' 0"	1	
Bk2	2	1-3/4" x 7-1/4" VERSA-LAM® LVL 2.1E 3100 SP	2' 0"	1	

Accessories				
PlotID	Net Qty	Product	Length	Plies
60		3/4" 4x8 OSB		1
Connector Summary				
PlotID	Qty	Manuf	Product	Skew
H1	1	Simpson	HHUS410	-
H2	17	Simpson	IUS1.81/9.5	-
H3	11	Simpson	HU7	-
H4	1	Simpson	HU9	-

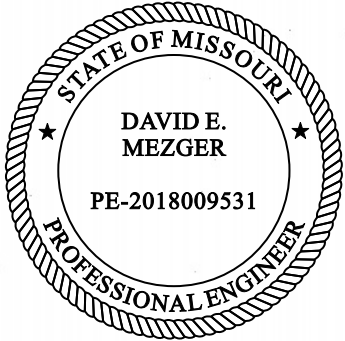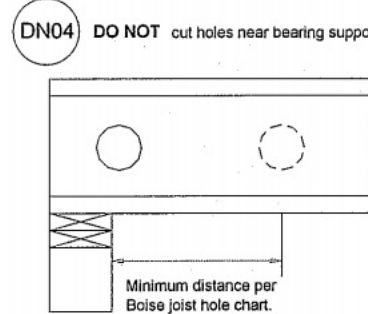

Review and Approval
Structural Only

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212 NE Circle Dr.
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See Boise Specifier Guide For Filler Block Detail And Table
In Regard To Double Joist Installation

DESIGN LOAD
Live Load 40 PSF
Dead Load 15 PSF
Total Load 55 PSF

SCALE 1/4" = 1-0	PLAN NO. 4341
DATE 11-20-24	SHEET NO. 5 OF 5



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11/26/2024



Trumark Homes LLC
Bosley Residence
Mc C R A Y L U M B E R
Edwardsville, Keith Tally, 9134221300

Scale: 1/4" = 1'-0"
DWG: BC FRAMER
File: 24000166
By: Keith Tally
Date: 11/14/2024
Sheet 1 of 1

USER NOTES
This design is provided as a courtesy to the builder and does NOT guarantee a complete structural review of the project. Neither Lateral nor Seismic Analysis has been considered. All bearing locations and product usages shall be verified by the builder and engineer of record. This design shall be reviewed, verified, and approved by the builder, engineer of record, and local building department prior to ordering materials.

NOTE:
ALL MEASUREMENTS
TO BE VERIFIED
IN THE FIELD.

Boise Cascade

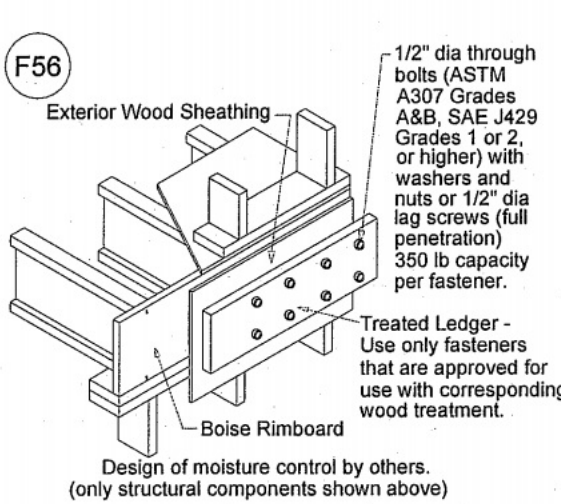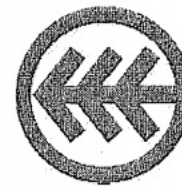

Typical Deck Attachment

DN01 DO NOT cut, notch or drill flanges

