


Discovery Animal Hospital 1901 NE Trails Edge Boulevard Lee's Summit, Jackson County, Missouri

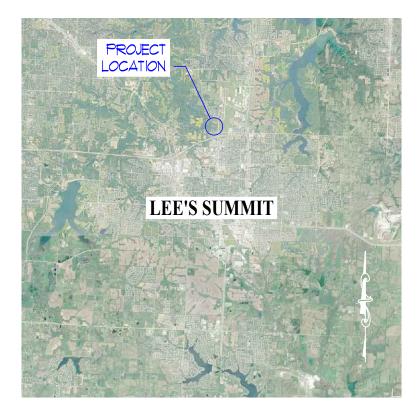



OWNER: DPLS P1 LLC

3622 Endeavor Avenue, Suite 101 Columbia, Missouri 65201

CLIENT: INTRINSIC DEVELOPMENT

3622 Endeavor Avenue, Suite 101 Columbia, Missouri 65201 573.881.0280 phone intrinsicdevelopment.com

ARCHITECT: PORTER, BERENDZEN & ASSO



CIVIL ENGINEERING: **CROCKETT ENGINEERING CO**



STRUCTURAL ENGINEERING: **CROCKETT ENGINEERING CO**



MECHANICAL-ELECTRICAL-PLUMBING ENGINEERING **J-SQUARED ENGINEERING**



2400 Bluff Creek Drive Columbia, Missouri 65201 573.234.4492 phone j-squaredeng.com

ZONING & CODE REVIEW

<u>PROJECT SCOPE:</u> NEW CONSTRUCTION OF AN APPROXIMATELY 6,442 SF SINGLE STORY BUILDING LOCATED ACCOMMODATING A B-BUSINESS USE AND LOCATED WITHIN THE CITY JACKSON COUNTY, MISSOURI AND SUBJECT TO ALL STATE AND LOCAL DESIGN	LIMITS OF LEE'S SUMMIT,
<u>BUILDING CODES IN EFFECT:</u> IBC/2018, IPC/2018, IMC/2018, IFGC/2018, IFC/2018, NEC/2017, ICC/ANSI A117.1-2009 AS AMENDED AND ADOPTED BY THE CITY OF LEE'S SUMMIT, MISSOURI	
ADMINISTRATION • DESIGN PROFESSIONAL IN RESPONSIBLE CHARGE JAY D. BERENDZEN, ARCHITECT PORTER, BERENDZEN & ASSOCIATES, P.C. 305 EAST BROADWAY, SUITE A ASHLAND, MISSOURI 65010 573.657.2022 PHONE	(CHAPTER I)
USE & OCCUPANCY CLASSIFICATION • B - BUSINESS GENERAL BUILDING HEIGHTS & AREAS • (USE GROUP B, CONSTRUCTION TYPE VB - SPRINKLERED)	(CHAPTER 3) (CHAPTER 5)
HEIGHTS • TABULAR ALLOWABLE BUILDING HEIGHT • B-BUSINESS USE: • ACTUAL BUILDING HEIGHT:	3 STORIES, 60 FEET 1 STORIES, 23 FEET
 AREA TABULAR ALLOWABLE BUILDING AREA PER FLOOR: B BUSINESS USE: FRONTAGE INCREASE = 75% = 9,000SF(0.75) = TOTAL ALLOWABLE AREA = ACTUAL BUILDING AREAS: 	36,000 SF <u>6,750 SF</u> 42,750 SF 6,442 SF NET
<u>TYPES OF CONSTRUCTION</u> • TYPE VB - SPRINKLERED	(CHAPTER 6)

LC		SHEET IN	DEX	
Avenue, Suite 101 souri 65201	Brian P. Maenner bpmaenner@intrinsicdevelopment.com	CVR	-	COVER SHEET / ARCHITECTURAL CODE REVIEW
		CIVIL ENG	GINEERIN	IG DRAWINGS UNDER SEPARATE COVER
DEVELOPMENT		S100	-	COVER / GENERAL STRUCTURAL DATA
		S200	-	FOUNDATION PLAN
Avenue, Suite 101	Brian P. Maenner	S210	-	FOUNDATION DETAILS
souri 65201 bhone	bpmaenner@intrinsicdevelopment.com	S300	-	ROOF FRAMING PLAN
oment.com		S310	-	ROOF FRAMING DETAILS
		A100	_	FLOOR PLAN / LIFE SAFETY
		A200	_	DIMENSIONAL PLAN
		A300	_	REFLECTED CEILING PLAN
		A400	_	ROOF PLAN
		A500	-	EXTERIOR ELEVATIONS / RENDERINGS
BERENDZEN & ASSOCIATES, P.C.		A501	-	EXTERIOR ELEVATIONS / RENDERINGS
		A600	-	BUILDING SECTIONS / DETAILS
		A601	_	BUILDING SECTIONS / DETAILS
200 South Henry Clay Blvd.	Jay D. Berendzen, AIA	A602	_	BUILDING SECTIONS / DETAILS
Ashland, Missouri 65010 573.657.2022 phone	jay@pba-architecture.com Jon D. Berendzen, AIA	A700	_	INTERIOR ELEVATIONS
pba-architecture.com	jon@pba-architecture.com	A700	-	INTERIOR ELEVATIONS
	Jon@pou uromeetare.com	A701 A702	-	INTERIOR ELEVATIONS
6:		A702 A800	-	SITE DETAILS
T ENGINEERING CONSULTANTS		A900	-	SCHEDULES
1000 West Nifong Boulevard, Bldg. 1	Nathan Eckhoff, PE			
Columbia, Missouri 65203	nathan@andersonengineeringinccom	MEP1	-	MECHANICAL ELECTRICAL PLUMBING COVER SHEET
573.447.0292 phone www.crockettengineering.com	Nolan Dixon, EIT NDixon@crockettengineering.com	MEP2	-	SITE UTILITY / SITE LIGHTING PLAN
www.crockettengineering.com	NDIX01@crockettengmeering.com	MEP3	-	SITE LIGHTING PLAN
		M101	-	HVAC PLAN
INEERING: T ENGINEERING CONSULTANTS		M501	-	HVAC DETAILS & SCHEDULES
		EP101	-	POWER PLAN
1000 West Nifer & Devleyand Dide 1	Crea Linnamon DE	EL101	-	LIGHTING PLAN
1000 West Nifong Boulevard, Bldg. 1 Columbia, Missouri 65203	Greg Linneman, PE GLinneman@crockettengineering.com	E501	-	ELECTRICAL SCHEDULES
573.447.0292 phone	Jared Verslues, PE	E601	-	ELECTRICAL DETAILS
www.crockettengineering.com	JVerslues@crockettengineering.com	PS101	-	SANITARY SEWER PLAN
		PW101	-	WATER & GAS PLAN
CTRICAL-PLUMBING: ENGINEERING: DENGINEERING		P501	-	PLUMBING DETAILS & SCHEDULES
2400 Bluff Creek Drive #101	JP Watson, PE			
Calumbia Missouri (5001	in @i sayaradana aam	1		

jp@j-squaredeng.com Jeremy Patrick jeremy@j-squaredeng.com

INTERIOR FINISHES	(CHAPTER <u>8)</u>	<u>PLUMBING FIXTU</u>
TABLE 803.13 INTERIOR WALL & CEILING FINISH REQUIREMENTS, SPRINK	(LERED, GROUP B)	
• EXIT ENCLOSURES & EXIT PASSAGEWAYS:		MINIMUM NUMBER
• CLASS B - (FLAME SPREAD 26-75, SMOKE DEVELOPED 0-45	0)	
• CORRIDORS:		OCCUPANT LOAI
•• CLASS C - (FLAME SPREAD 76-200, SMOKE DEVELOPED 0-4	150)	
 ROOMS & ENCLOSED SPACES: 		FIXTURE COUNT
• CLASS C - (FLAME SPREAD 76-200, SMOKE DEVELOPED 0-4	150)	
		• WATER CLO
		•• WATER
FIRE PROTECTION SYSTEM	(CHAPTER <u>9)</u>	•• WATER
 AN AUTOMATIC FIRE SPRINKLER SYSTEM IS NOT REQUIRED, HOWE 	VER IS PROVIDED FOR THIS BUILDING,	
 A MANUAL FIRE ALARM SYSTEM IS NOT REQUIRED FOR THIS BUIL 	DING (907.2.2)	 LAVATORIES
		•• LAVATO
THE GENERAL CONTRACTOR SHALL PROVIDE & INSTALL PORTABLE F		
75 FEET OF TRAVEL DISTANCE TO FIRE EXTINGUISHERS LOCATED AS 1	DIRECTED BY THE FIRE MARSHAL,	
		• DRINKING F
A KNOX BOX IS REQUIRED AT 6'-0" ABOVE SIDEWALK IN THE LOCAT	ION AS DIRECTED BY THE FIRE MARSHAL.	•• DRINKI
		•• DRINKI
MEANS OF EGRESS	(CHAPTER 10)	• SERVICE SIN
SEE LIFE SAFETY / EGRESS PLAN ON FOLLOWING SHEET A100 FOR DI		•• SERVIC

ACCESSIBILITY (CHAPTER 11) ACCESSIBLE ROUTES WITHIN THE SITE SHALL BE PROVIDED FROM PUBLIC TRANSPORTATION STOPS; ACCESSIBLE PARKING: ACCESSIBLE PASSENGER LOADING ZONES; AND PUBLIC STREETS OR SIDEWALKS TO THE ACCESSIBLE BUILDING ENTRANCE SERVED (SECTION 1104,1) AT LEAST 60% OF ALL PUBLIC ENTRANCES SHALL BE MADE ACCESSIBLE. • AT LEAST 2 PERCENT, BUT NOT LESS THAN ONE, OF EACH TYPE OF PARKING SPACE PROVIDED SHALL BE AN

ACCESSIBLE SPACE. • THIS BUILDING SHALL CONFORM TO: THE AMERICAN NATIONAL STANDARD FOR ACCESSIBLE AND USABLE BUILDINGS AND FACILITIES (ICC/ANSI A117,1-2017) AND THE LATEST EDITION OF THE AMERICANS WITH DISABILITIES ACT.

ER OF PLUMBING FACILITIES 4D:

DSETS:

- CLOSETS REG CLOSETS PRO S:
- ORIES REQUIR ORIES PROVI
- FOUNTAINS: ING FOUNTAINS ING FOUNTAINS
- INKS: E SINKS REQUIRED • SERVICE SINK PROVIDED =

GENERAL NOTES

IT IS THE RESPONSIBILITY OF THE GENERAL CONTRACTOR AND EACH OF HIS SUBCONTRACTORS TO REVIEW THE DRAWINGS TO ASSURE COORDINATION OF ALL WORK AFFECTING EACH TRADE. FAILURE TO REVIEW ALL CONTRACT DOCUMENTS FOR APPLICABLE ITEMS OF WORK SHALL NOT RELIEVE THE RESPONSIBLE PARTY FORM PERFORMING ALL WORK REQUIRED.

- CIVIL, STRUCTURAL, MECHANICAL, ELECTRICAL, PLUMBING NOTIFY THE DESIGN TEAM & INTRINSIC
- DEVELOPMENT OF ALL CONFLICTS WITHIN THE WORK. DRAWINGS - THESE DRAWINGS SHALL NOT BE SCALED. REFER TO DIMENSIONS INDICATED, ACTUAL SIZES OF CONSTRUCTION ITEMS, OR OTHER METHODS OF LOCATING CONSTRUCTION. WHERE NO DIMENSION OR METHOD OF DETERMINING A LOCATION IS GIVEN, VERIFY CORRECT LOCATION WITH THE DESIGN TEAM & INTRINSIC DEVELOPMENT PRIOR TO INSTALLATION.
- DIMENSIONS DIMENSIONS ON PLANS ARE FROM FACE OF CONCRETE, MASONRY, OR FRAMING UNLESS OTHERWISE NOTED. DIMENSIONS INDICATED AS "CLEAR" SHALL BE A MINIMUM DIMENSION, (FACE TO FACE) OF FINISH MATERIALS.
- COORDINATION GENERAL CONTRACTOR SHALL COORDINATE REQUIREMENTS OF ALL TRADES TO ALLOW FOR TIMELY INCLUSION IN THE WORK SO AS NOT TO DELAY THE WORK OR THE WORK OF ANY SUBCONTRACTOR. EQUIPMENT - REFER TO EQUIPMENT SCHEDULE FOR ADDITIONAL INFORMATION. VERIFY ANY REQUIREMENTS FOR ROUGH-IN OR CONNECTION PRIOR TO CONSTRUCTION TO ASSURE CORRECT INSTALLATION, OPENINGS,
- ELECTRICAL, MECHANICAL, BLOCKING, ETC. DUCTS, PIPE, CONDUIT, ETC. - ALL VERTICAL AND HORIZONTAL DUCTS, PIPES, CONDUIT, ETC. (WHETHER SHOWN OR NOT) IN FINISHED ROOMS SHALL BE LOCATED WITHIN WALLS OR ABOVE FINISHED CEILINGS. ITEMS THAT CANNOT BE LOCATED WITHIN WALLS OR CEILINGS SHALL BE FURRED IN AND FINISHED TO MATCH ADJACENT SURFACES AND ANY REQUIRED WALL OR CEILING RATINGS. VERIFY ACCEPTABILITY WITH THE DESIGN TEAM & INTRINSIC DEVELOPMENT PRIOR TO ENCASEMENT.
- FIXTURES LAVATORIES AND SINKS SHALL BE INSTALLED A MINIMUM OF 4" FROM FINISHED SIDE WALLS. FAUCETS SHALL BE INSTALLED WITH A MINIMUM OF 5" FROM THE OUTLET TO THE FLOOD RIM OF SINKS, INCLUDING THOSE EQUIPPED WITH VACUUM BREAKERS. WATER CLOSETS SHALL BE INSTALLED A MINIMUM OF 16" FROM FINISHED SIDE WALLS TO CENTERLINE OF FIXTURES.
- BLOCKING BLOCKING OUTSIDE THE BUILDING ENVELOPE OR SUBJECT TO MOIST OR HUMID CONDITIONS SHALL BE PRESSURE TREATED AND USE CORROSION RESISTANT FASTENERS.
- ACCESS DOORS FURNISH AND INSTALL ACCESS DOORS IN WALLS AND NON-ACCESSIBLE TYPE CEILINGS WHERE SERVICE OR ADJUSTMENT TO MECHANICAL, FIRE PROTECTION, PLUMBING, ELECTRICAL, OR OTHER EQUIPMENT IS REQUIRED. WHERE WALL OR CEILING IS REQUIRED TO BE RATED, PROVIDE ACCESS DOORS OF FIRE RATING EQUAI TO THE ASSEMBLY IN WHICH THEY OCCUR.
- EXISTING CONDITIONS THE EXISTING CONDITIONS SHOWN ON THESE DRAWINGS ARE BASED ON INFORMATION PROVIDED TO THE DESIGN TEAM & INTRINSIC DEVELOPMENT. THE CONTRACTOR SHALL VERIFY ALL EXISTING CONDITIONS ON THE JOB SITE, AND NOTIFY THE DESIGN TEAM & INTRINSIC DEVELOPMENT OF DEVIATIONS FROM THESE DRAWINGS PRIOR TO FABRICATION AND INSTALLATION OF THE WORK.
- PRECAUTIONS IF UNFORESEEN CONDITIONS ARE DISCOVERED WHICH COULD RESULT IN DAMAGE TO THE STRUCTURE OR INJURY TO ITS OCCUPANTS, REPORT ANY SUCH CONDITION IMMEDIATELY TO THE DESIGN TEAM & INTRINSIC DEVELOPMENT. TAKE PRECAUTIONS TO PROPERLY SUPPORT THE STRUCTURE. HAZARDOUS MATERIALS - CONTRACTOR SHALL IMMEDIATELY REPORT THE DISCOVERY OF ANY HAZARDOUS
- MATERIALS TO THE DESIGN TEAM & INTRINSIC DEVELOPMENT. • SITE USAGE - USE OF THE SITE FOR ANY CONSTRUCTION STAGING OR OTHER OPERATIONS SHALL BE COORDINATED WITH THE DESIGN TEAM & INTRINSIC DEVELOPMENT. TAKE CARE NOT TO BLOCK OR ADVERSELY
- AFFECT ANY PUBLIC OR ADJACENT OWNER AREAS. • EXIT ACCESS - MAINTAIN FREE, SAFE, AND APPROVED MEANS OF EGRESS IN AND OUT OF PROJECT LOCATION IN ACCORDANCE WITH REQUIREMENTS OF APPLICABLE REGULATORY AGENCIES.

JRES, FAUCETS, & FIXTURE FITTINGS ~ (IPC 2018)

6,443 SF @ 1 OCCUPANT/150 SF = 43 OCCUPANTS

TO BE DESIGNED WITH A 50/50 DISTRIBUTION BETWEEN SEXES (22 MEN / 22 WOMEN)

EQUIRED: ROVIDED =		(1) MEN'S	/	(1)WOMEN'S	ING 50 OCCUPANTS (1) STAFF UNI-SEX	
RED: (IDED =	1 LAV / 40	FOR 1st 80, THEN (1) MEN'S (1) MEN'S	/	(1)WOMEN'S	EEDING 80 OCCS	
16 REQUIRED: 16 PROVIDED						
QUIRED =		I REQUIRED				

2 PROVIDED

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THE PROFESSIONAL ARCHITECTS SEAL AFFIXED TO THIS SHEET APPLES ONLY TO THE MATERIAL		CONSIDERED PREPARED BY THIS ARCHITECT, AND THIS ARCHITECT EXPRESALY DISCLAIMS, ANY AND	ALL RESPONSIBILITY FOR SUCH PLAN DRAWINGS OR DOCUMENTS NUCL ESTIBILITY EAST	
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PORTER, BEREND	& Associates, A R C H I T E C	573 657 2	jay@pba-architecture.com	
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		OILTH TENIB.	P.O. BOX 446 ASHLAND, MISSOURI 65010	
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	Discovery Animal Hospital	1901 NE Trails Edge Boulevard	Lee's Summit, Jackson County, Missouri	
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Discovery Animal Hospital

Lee's Summit, Jackson County, Missouri

GENERAL NOTES

ELEVATION DATUM

SEE ARCHITECTURAL DRAWINGS OR SITE PLAN FOR FINISH FLOOR ELEVATIONS

DESIGN SPECIFICATIONS 2018 INTERNATIONAL BUILDING CODE

EARTHWORK

EARTHWORK OPERATIONS SHALL BE PERFORMED UNDER THE DIRECTION OF A PROFESSIONAL TESTING AGENCY TO ASSURE COMPLIANCE WITH THE RECOMMENDATIONS OF THE SOILS REPORT BY OWN ENGINEERING APRIL 4, 2024.

CONCRETE

CONCRETE WORK SHALL CONFORM TO ALL REQUIREMENTS OF THE CURRENT ACI 301, SPECIFICATIONS FOR STRUCTURAL CONCRETE FOR BUILDINGS, ACI 318 BUILDING CODE REQUIREMENTS FOR STRUCTURAL CONCRETE, ACI 305 SPECIFICATIONS FOR HOT WATER CONCRETE, AND ACI 306 SPECIFICATIONS FOR COLD WEATHER CONCRETE, WITH THE FOLLOWING ADDITIONAL REQUIREMENTS:

1	. CONCRETE SHALL DEVELOP	THE FOLLOWING	28-DAY	MINIMUM COMPRESSIVE STRENGTH:
	FOUNDATIONS		-	3,000 PSI
	CAST-IN-PLACE WALLS		-	3,500 PSI
	FLOOD SLAD		_	

- EXTERIOR SLABS, WALLS AND CURBS 4,000 PSI 2. ALL FOOTINGS SHALL BEAR ON UNDISTURBED SOIL OR ENGINEERED FILI
- 3. CHLORIDE— BASED ADMIXTURES ARE PROHIBITED IN ALL REINFORCED CONCRETE.
- 4. REINFORCING STEEL SHALL CONFORM TO ASTM A615, A616, OR A617, GRADE 60.
- 5. ALL CONTINUOUS REINFORCING STEEL THAT MEETS AT A CORNER SHALL BE TIED TOGETHER WITH A CORNER BAR THAT HAS SUFFICIENT LAP DISTANCE IN EACH DIRECTION 6. CONTINUOUS REINFORCING BARS LAP LENGTH SHALL BE A MINIMUM OF 48 BAR DIAMETERS UNLESS
- NOTED OTHERWISE 7. CONCRETE SLUMP SHALL BE A MAXIMUM OF $4^{"} + / - 1^{"}$ (ASTM C- 143) AS DELIVERED IN THE FIELD.
- CONTRACTOR MAY USE CHEMICAL ADMIXTURES TO ATTAIN A MAXIMUM SLUMP OF 8" FOR WORKABILITY NO WATER MAY BE ADDED TO THE CONCRETE MIX ON SITE UNLESS WATER IS WITHHELD AT THE BATCHING FACILITY. IF WATER IS WITHHELD AT THE BATCHING FACILITY IT SHOULD BE REFLECTED ON THE LOAD TICKET. THE TOTAL AMOUNT OF WATER IN THE MIX SHALL NOT EXCEED WHAT IS NOTED ON THE APPROVED MIXED. THIS SHALL BE NOTED IN THE SPECIAL INSPECTOR'S RECORDS.
- 8. CONCRETE EXPOSED TO WEATHER, VEHICLES, AND/OR DEICING CHEMICALS SHALL BE AIR-ENTRAINED WITH 6% (+/-) 1.5% ENTRAINED AIR BY VOLUME AT POINT OF DISCHARGE. DO NOT ALLOW AIR CONTENT OF TROWELED FINISHED FLOORS TO EXCEED 3%. 9. SUBMIT CONCRETE MIX PROPORTIONS PRIOR TO START OF WORK. DO NOT BEGIN CONCRETE

PRODUCTION UNTIL MIXES HAVE BEEN REVIEWED AND ARE ACCEPTABLE TO THE ENGINEER. 10.READY MIX CONCRETE SHALL COMPLY WITH REQUIREMENTS OF ASTM C94. 11.CONCRETE WORK EXECUTION

- A. CONSTRUCT FORMS TO CORRECT SIZE, SHAPE, ALIGNMENT, ELEVATION AND POSITION; AND TO SUPPORT VERTICAL AND LATERAL LOADS.
- B. POSITION, SUPPORT, AND SECURE REINFORCEMENT AGAINST DISPLACEMENT. MINIMUM CONCRETE COVER FOR REINFORCEMENT SHALL BE, UNLESS NOTED OTHERWISE ON THE DRAWINGS:

 - NOT EXPOSED TO WEATHER OR IN CONTACT WITH EARTH......1 ½ INCHES
- C. PROVIDE CONTROL JOINTS IN SLABS-ON-GRADE AT NOT GREATER THAN 15 FEET ON CENTER IN EACH DIRECTION. SAW CUT CONTROL JOINTS MINIMUM 1/4 OF SLAB DEPTH, AS SOON AFTER SLAB FINISHING WITHOUT DISLODGING AGGREGATE.
- D. STEEL TROWEL FINISH ALL INTERIOR CONCRETE SLABS, BROOM FINISH ALL EXTERIOR CONCRETE E. CURE ALL CONCRETE IN COMPLIANCE WITH ACI 301, USING A LIQUID TYPE MEMBRANE,
- NON-RESIDUAL, CURING COMPOUND COMPLYING WITH ASTM C309. ASSURE COMPATIBILITY WITH FINISH FLOOR COVERING.

STRUCTURAL STEEL

- 3. BOLTS, UNLESS OTHERWISE SHOWN, SHALL CONFORM TO ASTM A325-N,
- SIZE AS PER PLAN.
- 4. ANCHOR BOLTS, UNLESS OTHERWISE SHOWN, SHALL CONFORM TO ASTM F1554 GRADE 36.
- 5. SPLICING OF STRUCTURAL STEEL IS PROHIBITED EXCEPT AS DETAILED.

POST-INSTALLED ANCHORS

- OTHERWISE
- MASONRY, UNLESS NOTED OTHERWISE.
- CONFERENCE OF BUILDING OFFICIALS (ICBO).
- HOLE BUT NOT YET EXPANDED.
- 6. ADHESIVE ANCHORS SHALL BE ACCEPTABLE FOR LONG-TERM LOADING. WHEN BASE MATERIAL
- MANUFACTURER'S SPECIFICATIONS.

TIMBER

TIMBER WORK SHALL CONFORM TO ALL REQUIREMENTS OF THE CURRENT ANSI/AF&PA NATIONAL DESIGN SPECIFICATION (NDS) FOR WOOD CONSTRUCTION, WITH THE FOLLOWING SUPPLEMENTAL REQUIREMENTS: 1. FOR COMMON MEMBER SIZES, THE SPECIES AND GRADES SHALL BE AS FOLLOWS, UNLESS NOTED

OTHERWISE:

UTILINI	L.	
Α.	2X4	SPF No.1/No.2
В.	2X6	SPF No.1/No.2
С.	2X8	DF-L No.2
D.	2X10	DF-L S.S.
E.	2X12	DF-L S.S.

EQUIVALENT (OR BETTER) GRADES & SPECIES MAY BE SUBMITTED FOR THE ENGINEER'S APPROVAL.

- 2. SIZES SHOWN FOR LUMBER ARE NOMINAL SIZES.
- PRESSURE-IMPREGNATED BY AN APPROVED PROCESS AND PRESERVATIVE.
- 4. SPLICING OF JOISTS, STUDS, OR HEADERS IS PROHIBITED EXCEPT AS SHOWN.
- 2005 ANSI/AF&PA NDS FOR WOOD CONSTRUCTION.
- RESPECTIVELY, OF THE 2005 ANSI/AF&PA NDS FOR WOOD CONSTRUCTION.
- 11.1.5.4 OF THE 2005 ANSI/AF&PA NDS FOR WOOD CONSTRUCTION.
- OTHERWISE.

1. FABRICATION AND ERECTION OF STRUCTURAL STEEL SHALL BE IN ACCORDANCE WITH THE CURRENT EDITION OF THE AISC SPECIFICATIONS FOR STRUCTURAL STEEL BUILDINGS, THE AISC CODE OF STANDARD PRACTICE FOR STEEL BUILDINGS AND BRIDGES AND CURRENT OSHA STANDARDS. 2. WIDE FLANGE SHAPES SHALL CONFORM TO ASTM A992. STRUCTURAL TUBES SHALL CONFORM TO ASTM A500 GRADE B. ALL OTHER STRUCTURAL STEEL SHALL CONFORM TO ASTM A36.

6. ALL STRUCTURAL AND MISCELLANEOUS STEEL ITEMS SHALL RECEIVE ONE COAT OF "IRONCLAD RETARDO RUST INHIBITIVE PAINT 163" (BENJAMIN MOORE) OR APPROVED EQUAL UNLESS OTHERWISE INDICATED IN THE SPECIFICATIONS. ALL STEEL SURFACES EMBEDDED IN CONCRETE SHALL NOT BE PAINTED. PREPARATION OF STEEL SURFACES SHALL MEET THE REQUIREMENTS OF THE STEEL STRUCTURES PAINTING COUNCIL (SSPC-SP1) AND THE REMOVAL OF GREASE AND OIL BY SOLVENT CLEANING (SSPC-SP1) AND THE REMOVAL OF MILL SCALE, RUST, WELD FLUX AND SLAG BY HAND TOOL CLEANING (SSPC-SP2). PRIMER SHALL BE APPLIED AT THE MANUFACTURER'S RECOMMENDED RATE BUT NOT LESS THAN ONE GALLON PER 400 SQ.FT. THEREBY DEPOSITING A DRY FILM THICKNESS OF NOT LESS THAN 1.5 MILS. ANY SCARRED AREAS SHALL BE TOUCHED UP WITH THE SAME PAINT AFTER ERECTION. 7. ALL WELDING SHALL BE DONE BY QUALIFIED WELDERS IN ACCORDANCE WITH THE CURRENT EDITION OF THE AWS STRUCTURAL WELDING CODE. WELDING ELECTRODES SHALL BE E70XX.

1. ALL POST-INSTALLED ANCHORS SHALL MEET THE REQUIREMENTS OF THE CODE-CITED EDITION OF ACI 318, APPENDIX "D", AND SHALL BE ACCEPTABLE FOR BOTH CRACKED AND UNCRACKED CONCRETE. 2. EXPANSION ANCHORS HAVE BEEN DESIGNED AS HILTI KWIK BOLT TZ ANCHORS, UNLESS NOTED

3. ADHESIVE ANCHORS HAVE BEEN DESIGNED TO USE HILTI HIT HY 200 ADHESIVE IN CONCRETE OR SOLID 4. EQUIVALENT ANCHORS MAY BE SUBMITTED FOR THE ENGINEER'S APPROVAL. SUBMITTALS ARE THE

CONTRACTOR'S RESPONSIBILITY AND MUST INCLUDE EVALUATION REPORTS FROM THE INTERNATIONAL

5. EMBEDMENT DEPTH IS DEFINED AS THE DISTANCE FROM THE SURFACE OF THE LOAD-BEARING BASE MATERIAL TO THE DEEPEST PART OF THE ANCHOR AFTER THE ANCHOR HAS BEEN DRIVEN INTO THE

TEMPERATURES ARE BELOW 40 DEG F, ONLY NON-EPOXY-BASED ADHESIVES SHALL BE USED. 7. POST-INSTALLED ANCHORS SHALL ONLY BE USED WHERE SPECIFIED ON THE DRAWINGS. THE CONTRACTOR SHALL OBTAIN APPROVAL FROM THE ENGINEER PRIOR TO USING POST-INSTALLED ANCHORS FOR MISSING OR MISPLACED CAST-IN-PLANE ANCHORS. CARE SHALL BE TAKEN TO AVOID CONFLICTS WITH EXISTING REINFORCING BARS. HOLES SHALL BE DRILLED AND CLEANED PER ANCHOR

8. STAINLESS STEEL ANCHORS ARE REQUIRED AT ALL PERMANENTLY EXPOSED WEATHER CONDITIONS.

3. TIMBER EXPOSED TO WEATHER OR GROUND, OR IN CONTACT WITH CONCRETE OR MASONRY SHALL BE

5. BOLTS SHALL CONFORM TO ASTM A307. HOLES SHALL BE DRILLED PER SECTION 11.1.2 OF THE

6. LAG SCREWS AND WOOD SCREWS SHALL BE INSTALLED PER SECTIONS 11.1.3 AND 11.1.4,

7. COMMON NAILS SHALL BE USED, UNLESS NOTED OTHERWISE. IN ADDITION, NAILS SHALL BE GALVANIZED, IF EXPOSED TO WEATHER OR MOISTURE. TOE-NAILS SHALL BE DRIVEN PER SECTION

8. FASTENING SHALL BE PER THE IBC MINIMUM FASTENING SCHEDULE, TABLE 2304.9.1, UNLESS NOTED

9. CONNECTIONS/CONNECTORS SHALL BE INSTALLED PER MANUFACTURER'S SPECIFICATIONS.

PREFABRICATED WOOD TRUSSES

- 1. FLOOR & ROOF TRUSSES SHALL BE DESIGNED IN ACCORDANCE WITH THE TRUSS PLATE INSTITUTE (TPI) DESIGN SPECIFICATION FOR METAL PLATE CONNECTED WOOD TRUSSES, AND THE ANSI/NF&PA NATIONAL DESIGN SPECIFICATION (NDS) FOR WOOD CONSTRUCTION.
- 2. PROVIDE TEMPORARY AND PERMANENT BRACING ON ALL TRUSSES, AS REQUIRED TO PROVIDE MEMBER AND TRUSS STABILITY
- 3. FLOOR & ROOF TRUSSES SHALL BE DESIGNED AND CONSTRUCTED FOR A MAXIMUM TOTAL LOAD DEFLECTION OF L/360 AND TO SAFELY SUPPORT THE FOLLOWING LOADS: A. DEAD, LIVE, SNOW, WIND, EARTHQUAKE: SEE PROJECT DESIGN DATA ON COVER SHEET.
- B. MECHANICAL PIPE LOAD: TRUSSES SHALL BE DESIGNED FOR A CONCENTRATED LOAD OF 250 LBS HUNG ANYWHERE ALONG THE BOTTOM CHORD.
- C. OVER-FRAMING LOAD: TRUSSES SHALL ALSO BE DESIGNED TO SUPPORT ADDITIONAL OVERBUILD FRAMING, SUCH AS THAT WHICH FORMS VALLEYS AND HIPS ON ROOFS.
- D. DRIFTED SNOW LOAD: TRUSSES SHALL BE DESIGNED TO SUPPORT DRIFTED SNOW LOADS IN ACCORDANCE WITH THE APPROPRIATE BUILDING CODE.
- E. IN-PLANE LATERAL LOADS: TRUSSES SHALL BE DESIGNED TO SUPPORT ANY LATERAL LOADS CARRIED AXIALLY IN THE PLANE OF THE TRUSS, AS SHOWN ON THE PLANS.
- 4. GABLED END TRUSSES SHALL HAVE VERTICAL MEMBERS SPACED AT 16" O.C. MAXIMUM.
- 5. SUBMITTALS SHALL INCLUDE THE FOLLOWING: A. SHOP DRAWINGS PREPARED UNDER THE SUPERVISION OF, AND SIGNED AND SEALED BY, A PROFESSIONAL ENGINEER REGISTERED IN THE STATE WHERE THE PROJECT IS BUILT. THESE DRAWINGS SHALL INDICATE SPECIES, GRADE, AND SIZES OF LUMBER TO BE USED; PITCH, SPAN, CAMBER, CONFIGURATION, AND SPACING FOR EACH TYPE OF TRUSS REQUIRED; TYPE, SIZE, MATERIAL, FINISH, AND LOCATION OF METAL CONNECTOR PLATES; AND BEARING DETAILS. SHOW TRUSS LAYOUT AND ALL REQUIRED TEMPORARY AND PERMANENT BRACING AFFECTING THE STRUCTURAL CAPACITY OF THE TRUSSES.

PROVIDE COMPLETE ENGINEERING DESIGN CALCULATIONS THAT INCLUDE DESIGN VALUES, DESIGN ANALYSIS INDICATING LOADING, ASSUMED ALLOWABLE STRESSES, STRESS DIAGRAMS, AND CALCULATIONS, AND ANY OTHER INFORMATION NEEDED FOR REVIEW. THE CALCULATIONS SHALL HAVE BEEN SIGNED AND SEALED BY A QUALIFIED PROFESSIONAL ENGINEER WHO IS REGISTERED IN THE STATE WHERE THE PROJECT IS BUILT AND WHO IS RESPONSIBLE FOR PREPARATION OF THE CALCULATIONS.

SPECIAL INSPECTIONS

THE FOLLOWING ITEMS REQUIRE SPECIAL INSPECTION IN ACCORDANCE WITH CHAPTER 17 OF THE INTERNATIONAL BUILDING CODE.


- a. CONCRETE GROUT DESIGN MIX (PERIODIC)
- b. PLACING OF CONCRETE AND REINFORCING STEEL (CONTINUOUS OF CONCRETE SAMPLING / PERIODIC OF REINFORCING)
- c. BOLTS & ANCHORS EMBEDDED IN CONCRETE (PERIODIC) d. STRUCTURAL STEEL FABRICATIONS (UNLESS AISC APPROVED)
- (PERIODIC)
- e. STRUCTURAL STEEL BOLTING & WELDING (PERIODIC)
- f. POST INSTALLED ANCHORS IN CONCRETE (CONTINUOUS)
- q. IN-SITU SOILS, EXCAVATIONS, FILLING & COMPACTION (PERIODIC)
- h. WOOD FRAMING:
- h.g. SHEAR WALLS; WALL SIZE, CONFIGURATION, BLOCKING, PANEL GRADE, PANEL THICKNESS, AND FASTENING. (PERIODIC)
- h.b. DIAPHRAGMS (FLOOR AND ROOF SHEATHING); SIZE, CONFIGURATION, BLOCKING, PANEL GRADE, PANEL THICKNESS, AND FASTENING. (PERIODIC)
- h.c. FRAMING MEMBERS AND DETAILS (PERIODIC)
- h.d. MATERIAL GRADE (PERIODIC)
- h.e. CONNECTIONS; HANGERS, HOLD DOWNS, BUILT-UP COLUMNS, BUILT-UP BEAMS (PERIODIC)
- h.f. PRE-ENGINEERED TRUSSES; FRAMING, CONNECTIONS, BRIDGING (PERIODIC)

THE CONTRACTOR SHALL REQUEST SPECIAL INSPECTION OF THE ITEMS LISTED ABOVE PRIOR TO THOSE ITEMS BECOMING INACCESSIBLE AND UNOBSERVABLE DUE TO PROGRESSION OF THE WORK.


DESIGN DATA 2018 INTERNATIONAL BUILDING CODE / ASCE 7-16 BUILDING OCCUPANCY CATEGORY ROOF LOAD LIVE LOAD TOP CHORD SOLAR LOAD TOP CHORD DEAD LOAD 10 BOTTOM CHORD DEAD LOAD TOTAL TO JOISTS 45 lbs/sq.ft (*UNBALANCED & DRIFTING SNOW TO BE DETERMINED ROOF SNOW LOAD* IN ADDITION TO UNIFORM LOAD, WHERE APPLICABLE) 20 lbs/sq.ft p_a = C_e = 10 |₅ = 10 C+ = 1.0 20 lbs/sq.ft D_f = 20 lbs/sq.ft p. = BASIC DESIGN WIND LOAD 109 M.P.H. (3-SECOND GUST) Vult = |... = 10 EXPOSURE INTERNAL PRESSURE COEFFICIENT = ± 0.18 MAXIMUM COMPONENTS & CLADDING WIND ± 33.18 lbs/sq.ft EARTHQUAKE DESIGN DATA S_S= 0.100 S₁= 0.068 S_{DS}= 0.107 S_{D1}= 0.109 SITE CLASS D SEISMIC DESIGN CATEGORY B BASIC SEISMIC-FORCE-RESISTING SYSTEM = LIGHT-FRAMED WALLS WITH SHEAR PANELS R = 6.50 Ω_o = 3.00 $C_{d} = 4.00$ l_E = 1.0 EQUIVALENT LATERAL FORCE PROCEDURE V = .016W NET ALLOWABLE SOIL BEARING 2,500 lbs/sq.ft** (**PER GEOTECHNICAL REPORT BY OWN ENGINEERING DATED APRIL 4, 2024)

INDEX OF SHEETS	
COVER / GENERAL STRUCTURAL DATA	S100
FOUNDATION PLAN	S200
FOUNDATION DETAILS	S210
ROOF FRAMING PLAN	
ROOF FRAMING DETAILS	S310

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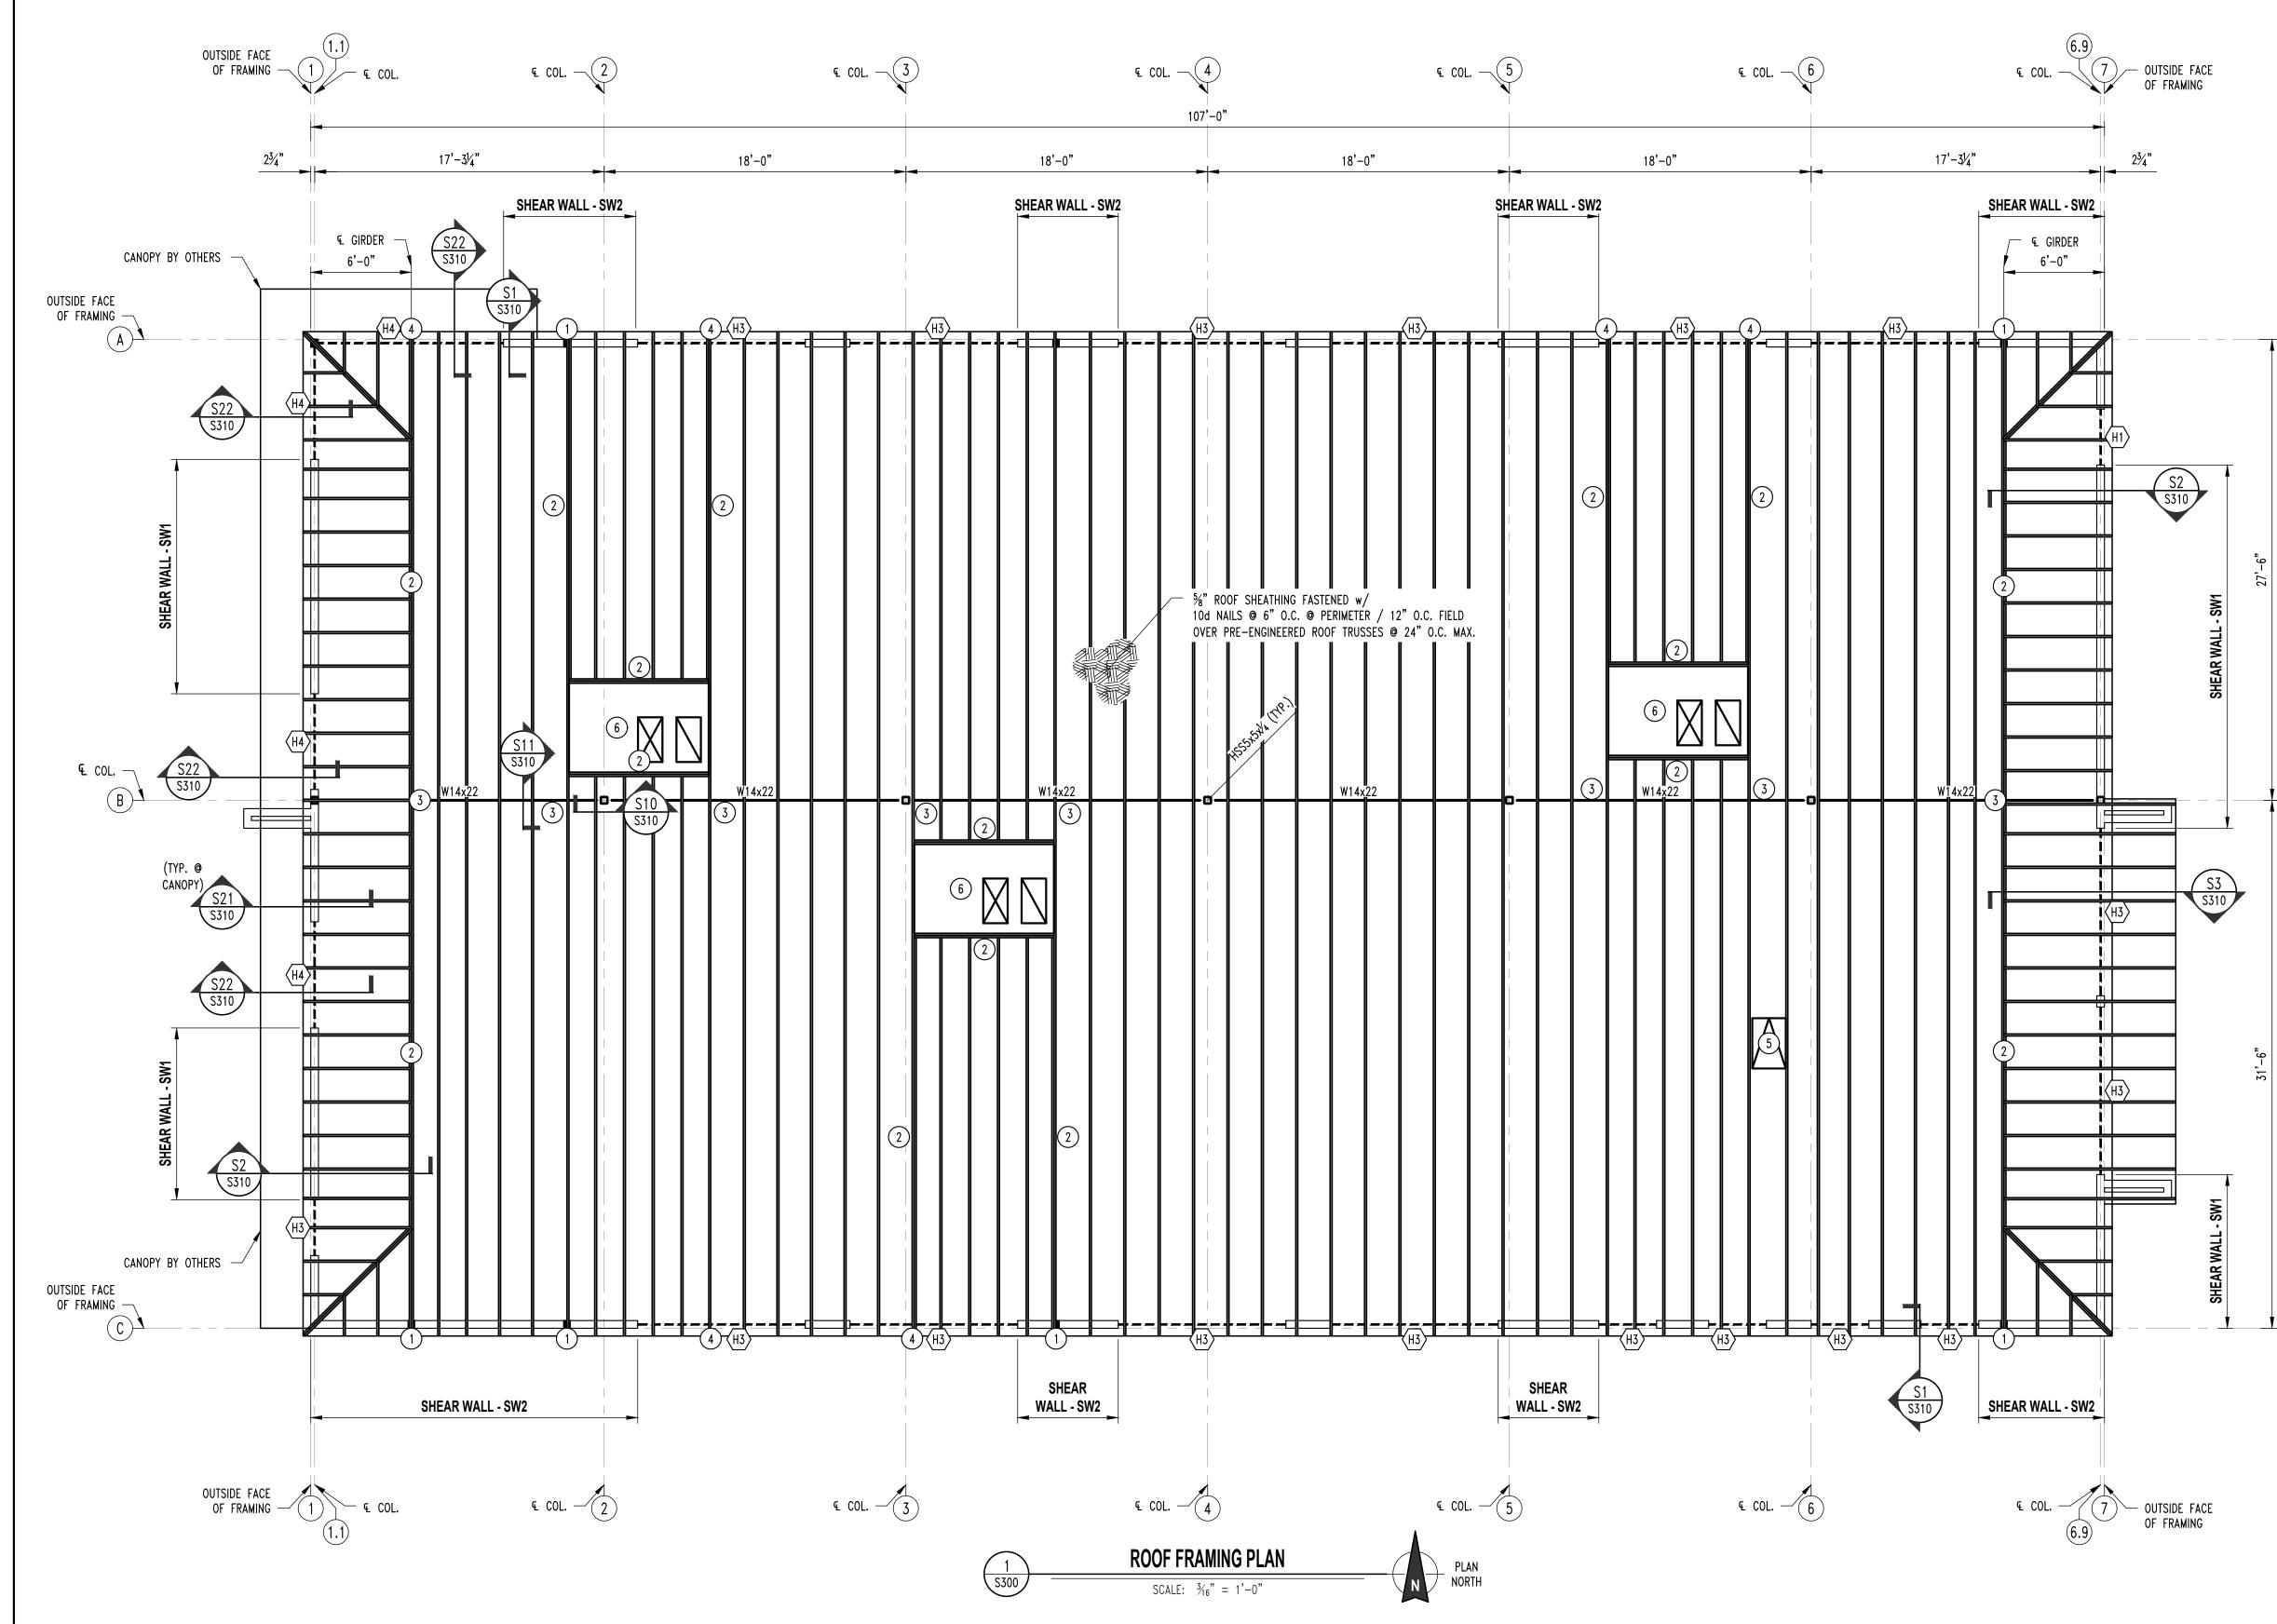


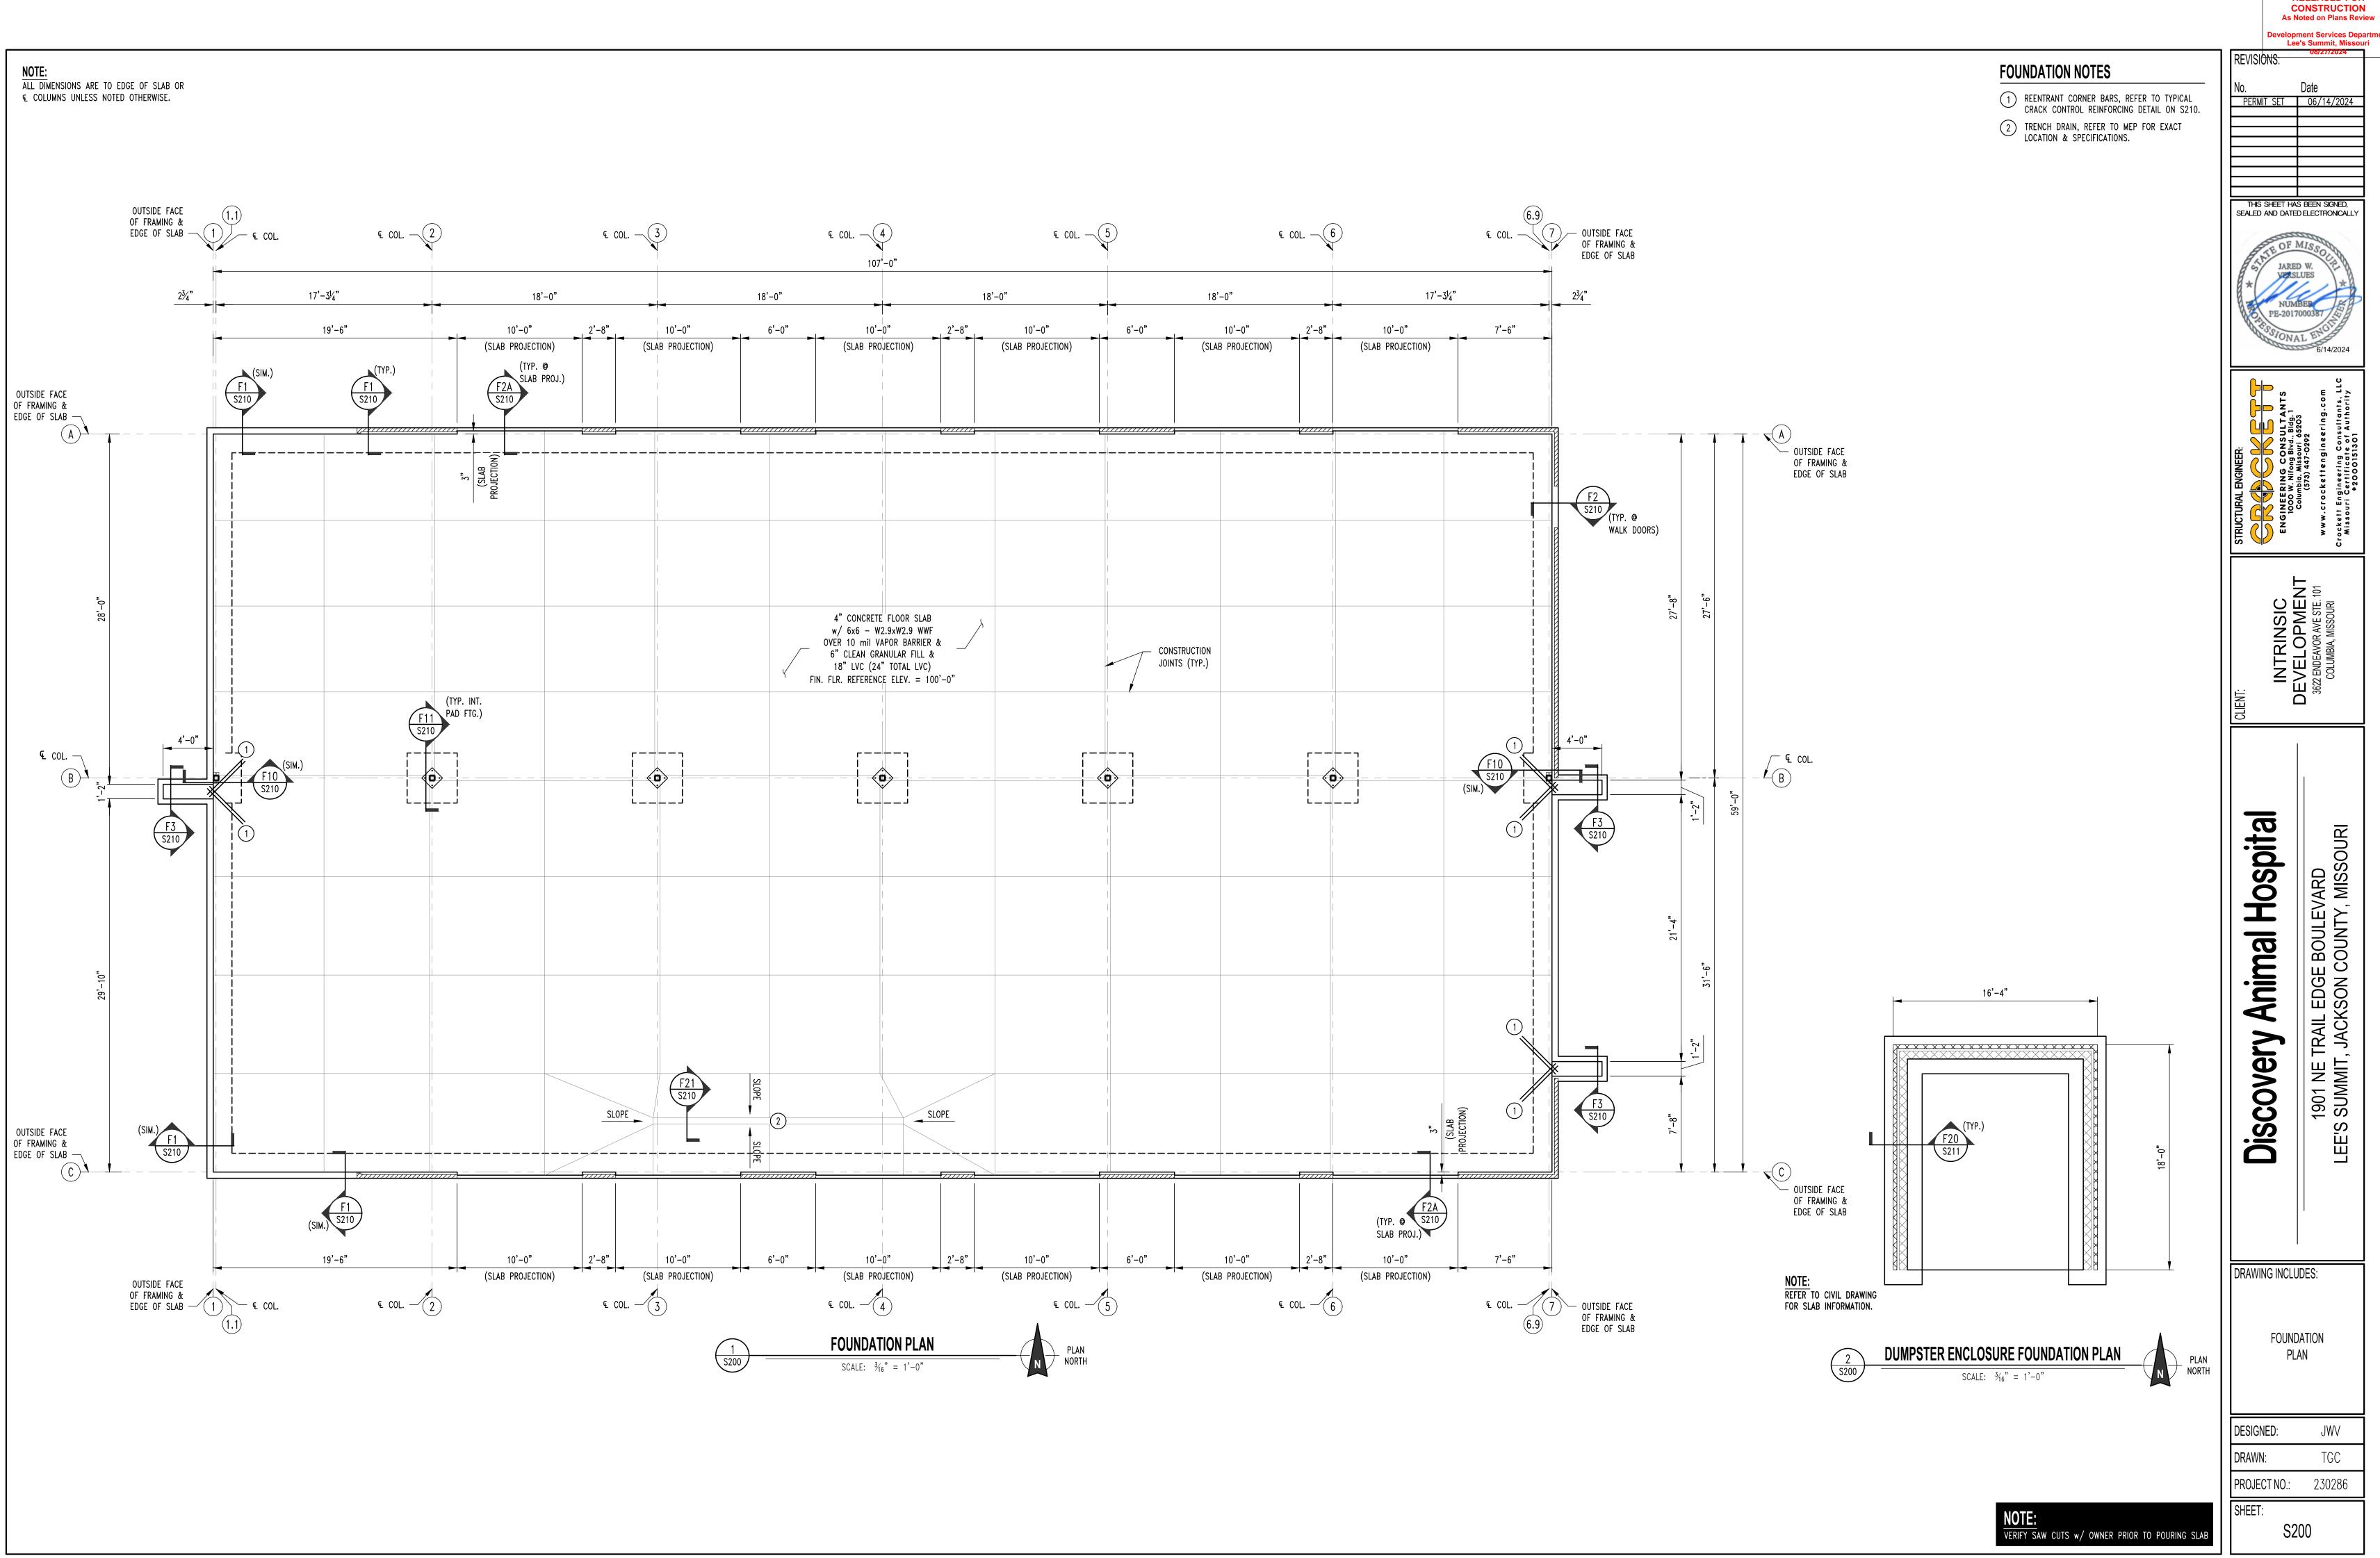RELEASED FOR

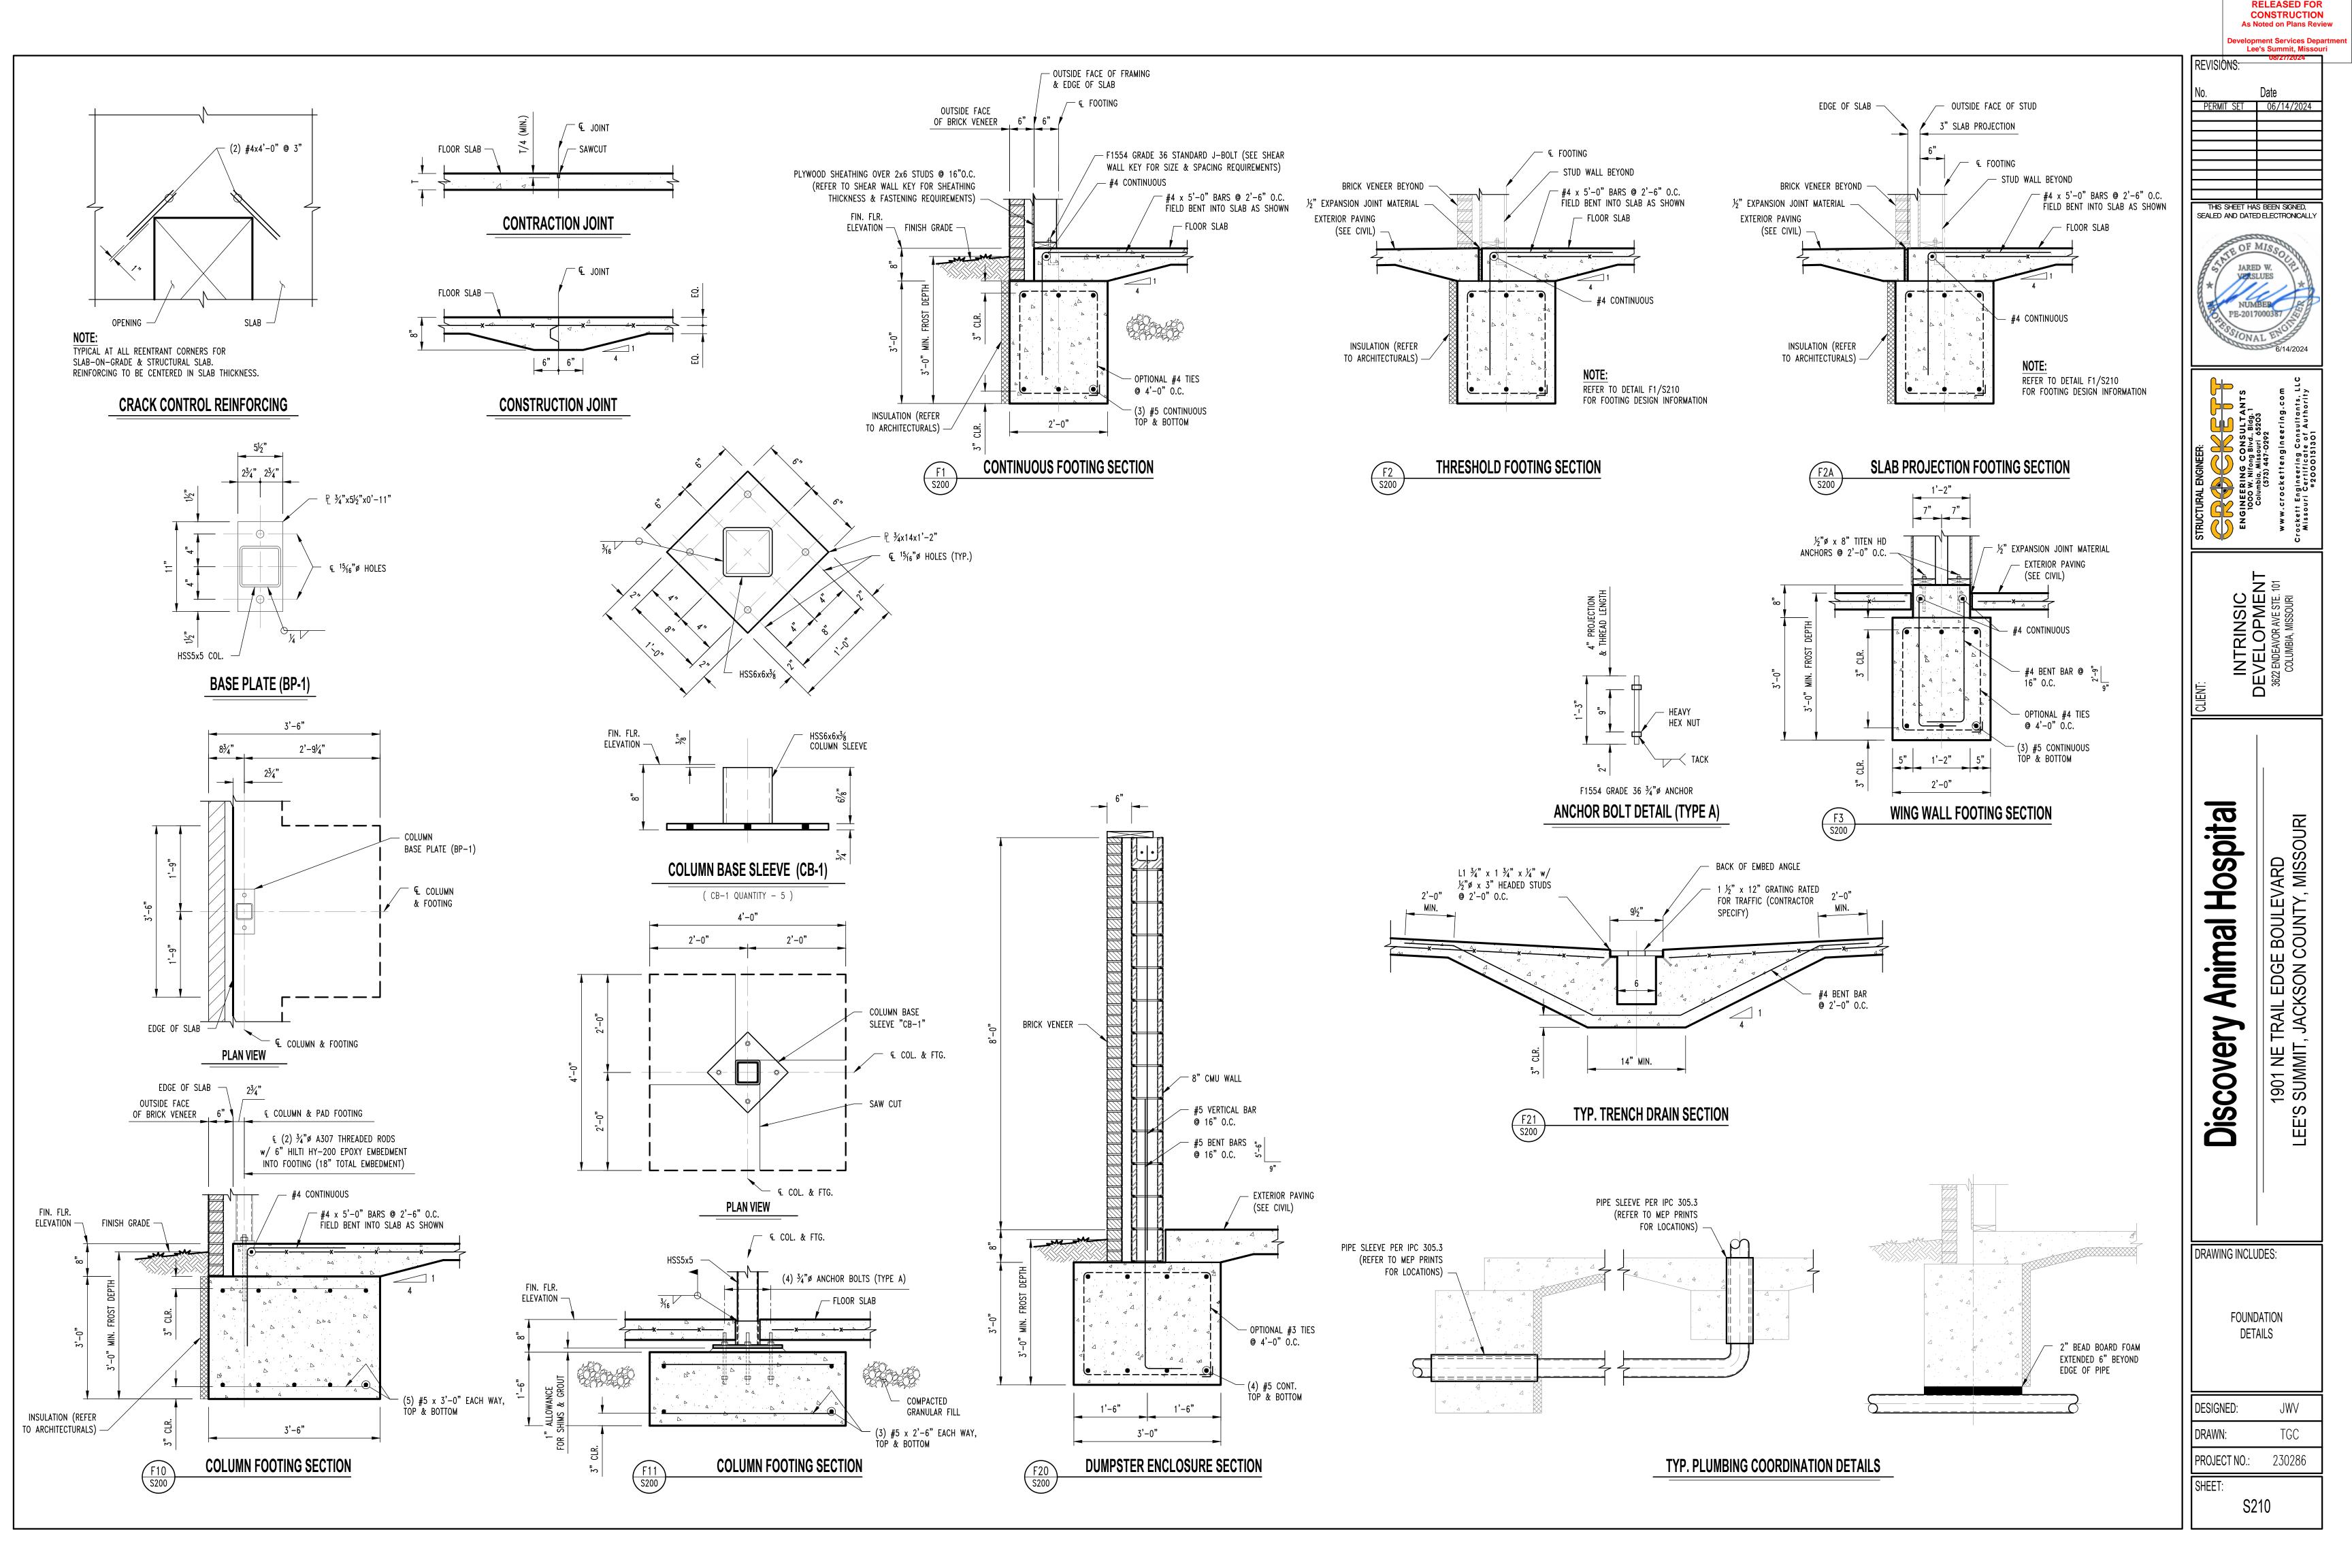

NOTE:

 $\overrightarrow{\text{ALL DIMENSIONS}}$ ARE TO OUTSIDE FACE OF FRAMING OR \P COLUMNS UNLESS NOTED OTHERWISE.



	BRICK LINTEL SCHEDULE
LENGTH	MEMBER SIZE (GALVANIZE
L ≤ 4'-0"	L4x4x3/8 WTH 6" BEARING EACH
L ≤ 6'-6"	L6x4x3/8 (LLV) WITH 6" BEARING EA
L ≤ 10'-0"	L8x4x7/16 (LLV) WITH 10" BEARING E

				Le	e's Summit, Missouri
	ROOF	FRAMING NOTES		REVISIONS:	08/27/2024
		STALL 3 PLY STUD BENEATH GIRDI / SIMPSON LGT3 TIEDOWN & (16)		No. permit set	Date 06/14/2024
	č. W	STUDS & SIMPSON HTT4 HOLDDO (18) 10d NAILS TO STUDS & $\frac{5}{8}$	WN @ THE BASE FASTENED		
		/ 18" EPOXY EMBEDMENT RDER TRUSS			
	(3) SI	MPSON LGT3 TIEDOWN & (16) 160			
	2	OCKING INSTALLED IN WEB OF BEA			AS BEEN SIGNED, ED ELECTRONICALLY
		DOF HATCH (REFER TO ARCHITECTU		STE OF	MISSOL
	\sim	U. REFER TO MEP FOR EXACT SIZ		JARI	ED W.
				NUN PE-201	1BER 100 7000387
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OUTSIDE FAC	CE				
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OUTSIDE FAC	CE			Discovery Animal Hos	1901 NE TRAIL EDGE BOULEVARD -EE'S SUMMIT, JACKSON COUNTY, MISSOURI
OF FRAMING)iS	II S I
<u>SHEA</u> <u>sw-1</u>	R WALL KEY				
7/	<u>T FLOOR</u> (16" OSB SHEATHING FASTENED W/ 8D				
2X	○ ANCHORS @ 2'-6" O.C. W/ SIMPSON 36 STUDS AND A 5/8" A307 THREADED TAL EMBEDMENT) AT EACH END OF THE	ROD W/ 6" SIMPSON SET-XP EPOXY			
<u>SW-2</u>	Emplomenty at LAUL END OF THE	STERN HALL		DRAWING INCL	UDE2:
	<u>T FLOOR</u> '16" OSB SHEATHING FASTENED W/ 8D		2 ⁷ ∩ C @ ΕΙΕΙ D & 5 /8"V8" TITEN	R	DOF
HD	ANCHORS @ 3'-0" O.C. W/ SIMPSON 5/8" A307 THREADED ROD W/ 6" SIMP	HTT4 HOLDOWN FASTENED W/ (18)	10D NAILS TO (2) 2X6 STUDS AND	FRA	MING
EM	BEDMENT) AT EACH END OF THE SHEAF			PL PL	AN
	IS NOT LABELED AS A SHEAR WALL TH	-	-		
@ 6"0. 	C. @ PERIMETER & 12" O.C. @ FIELD &	c ο/διλό iiien hd anchors @ 4'-(J U.L.	DESIGNED:	JWV
		EADER SCHEDULE		DRAWN:	TGC
MARK "H1"	(2) Southern Pine Sel. Str. 2x6's	CRIPPLE Southern Pine Sel. Str. 2x6	JAMB Southern Pine Sel. Str. 2x6	PROJECT NO.:	230286
"H2" "H3"	(2) Doug Fir Larch Sel. Str. 2x10's(3) Doug Fir Larch Sel. Str. 2x10's	Southern Pine Sel. Str. 2x6 (2) Southern Pine Sel. Str. 2x6's	(2) Southern Pine Sel. Str. 2x6's(3) Southern Pine Sel. Str. 2x6's	SHEET:	

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(2) Southern Pine Sel. Str. 2x6's (2) Southern Pine Sel. Str. 2x6's


(3) Doug Fir Larch Sel. Str. 2x10's

(3) Microlam 2.0E 1.75x16's


"H4"

(3) Southern Pine Sel. Str. 2x6's (3) Southern Pine Sel. Str. 2x6's

S300

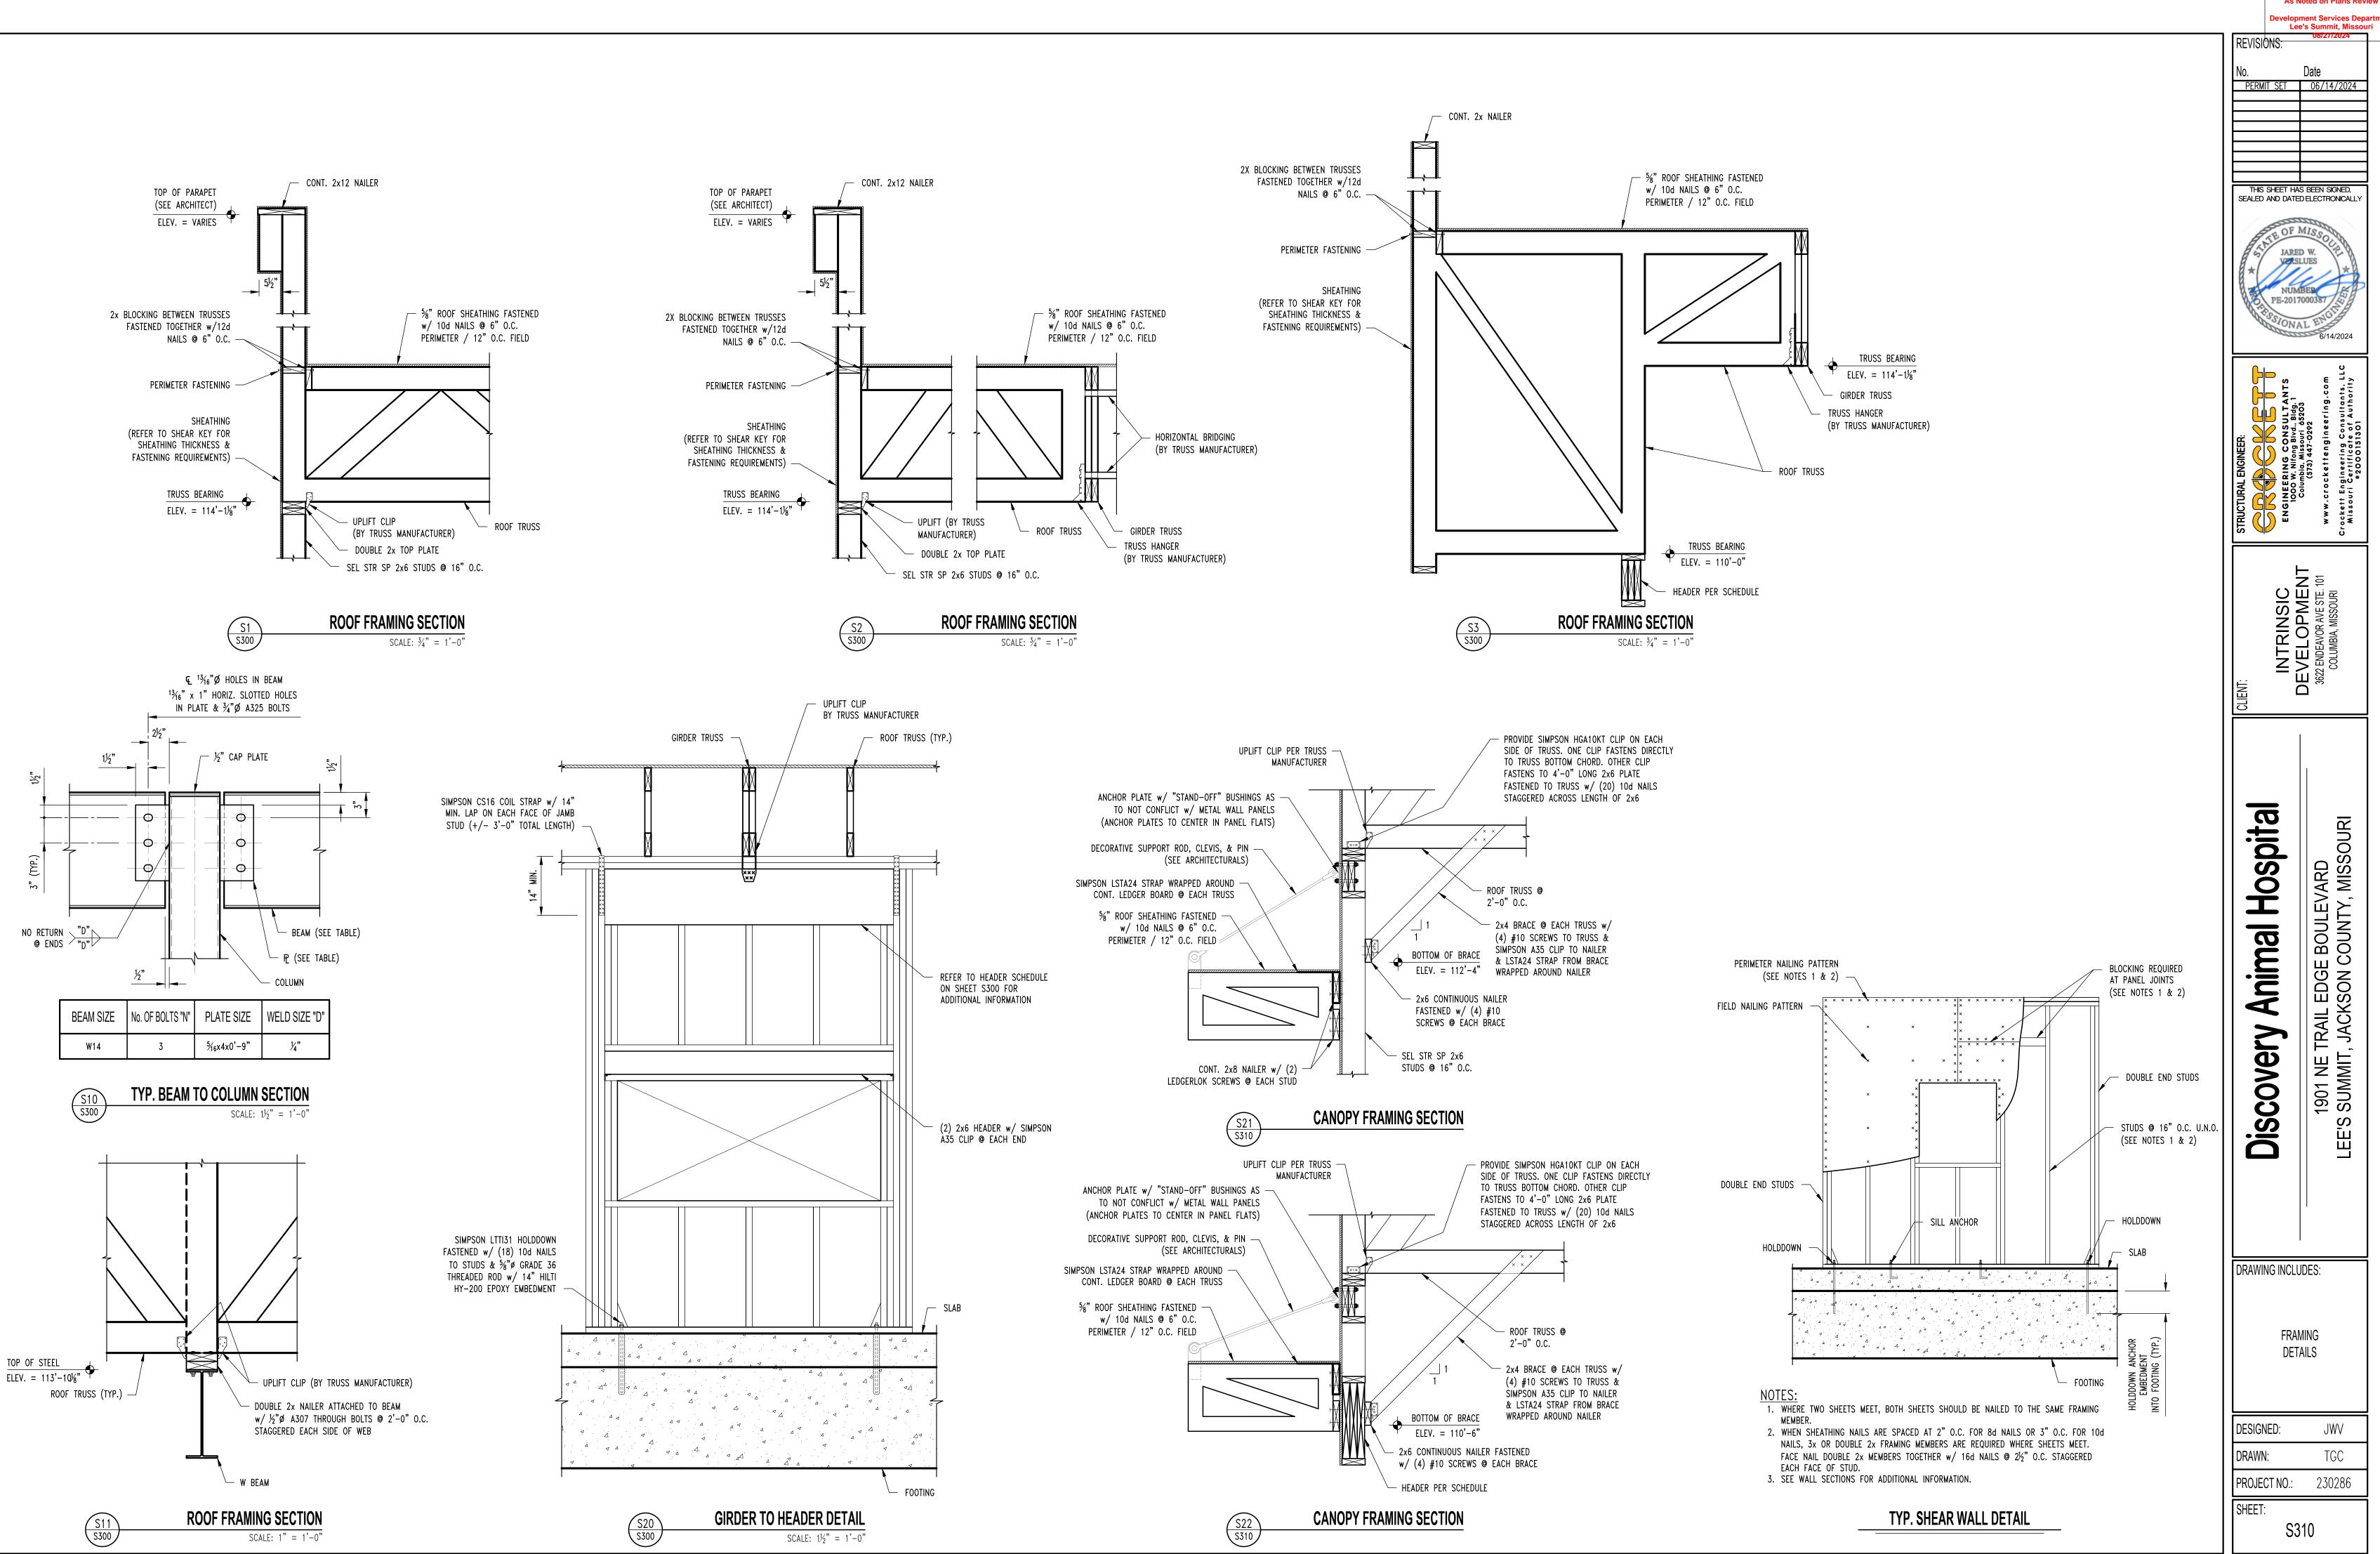


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CONSTRUCTION TYPE:	TYPE VB - SPRINKLERED	MINIMUM NUMBER OF EXITS REQUIRED: 2 (TRAVEL DISTANCE FACTOR) PROPOSED EXITS PROVIDED = 5
OCCUPANCY:	BUSINESS USE OCCUPANCY	
		EXIT ACCESS TRAVEL DISTANCE: 300 FEET
MINIMUM OCCUPANT LOAD:		
6,442 SF / 150 =	43 OCCUPANTS	EGRESS WIDTH:
		REQUIRED = $43 \times 0.15'' = 6.45''$
CORRIDOR FIRE-RESISTANCE RATI	ING REQUIRED =	PROVIDED = (5) 34" = 170"
	O HOURS (SPRINKLERED)	
		EGRESS DOORS SHALL HAVE A MINIMUM CLEAR OPENING WIDTH OF NOT
MINIMUM CORRIDOR WIDTH =	44 INCHES	LESS THAN 32"
DEAD END CORRIDORS SHALL NO		
		EVERY EXIT DOOR GUALL BE OPERARIE EROM THE INGIDE WITHOUT THE

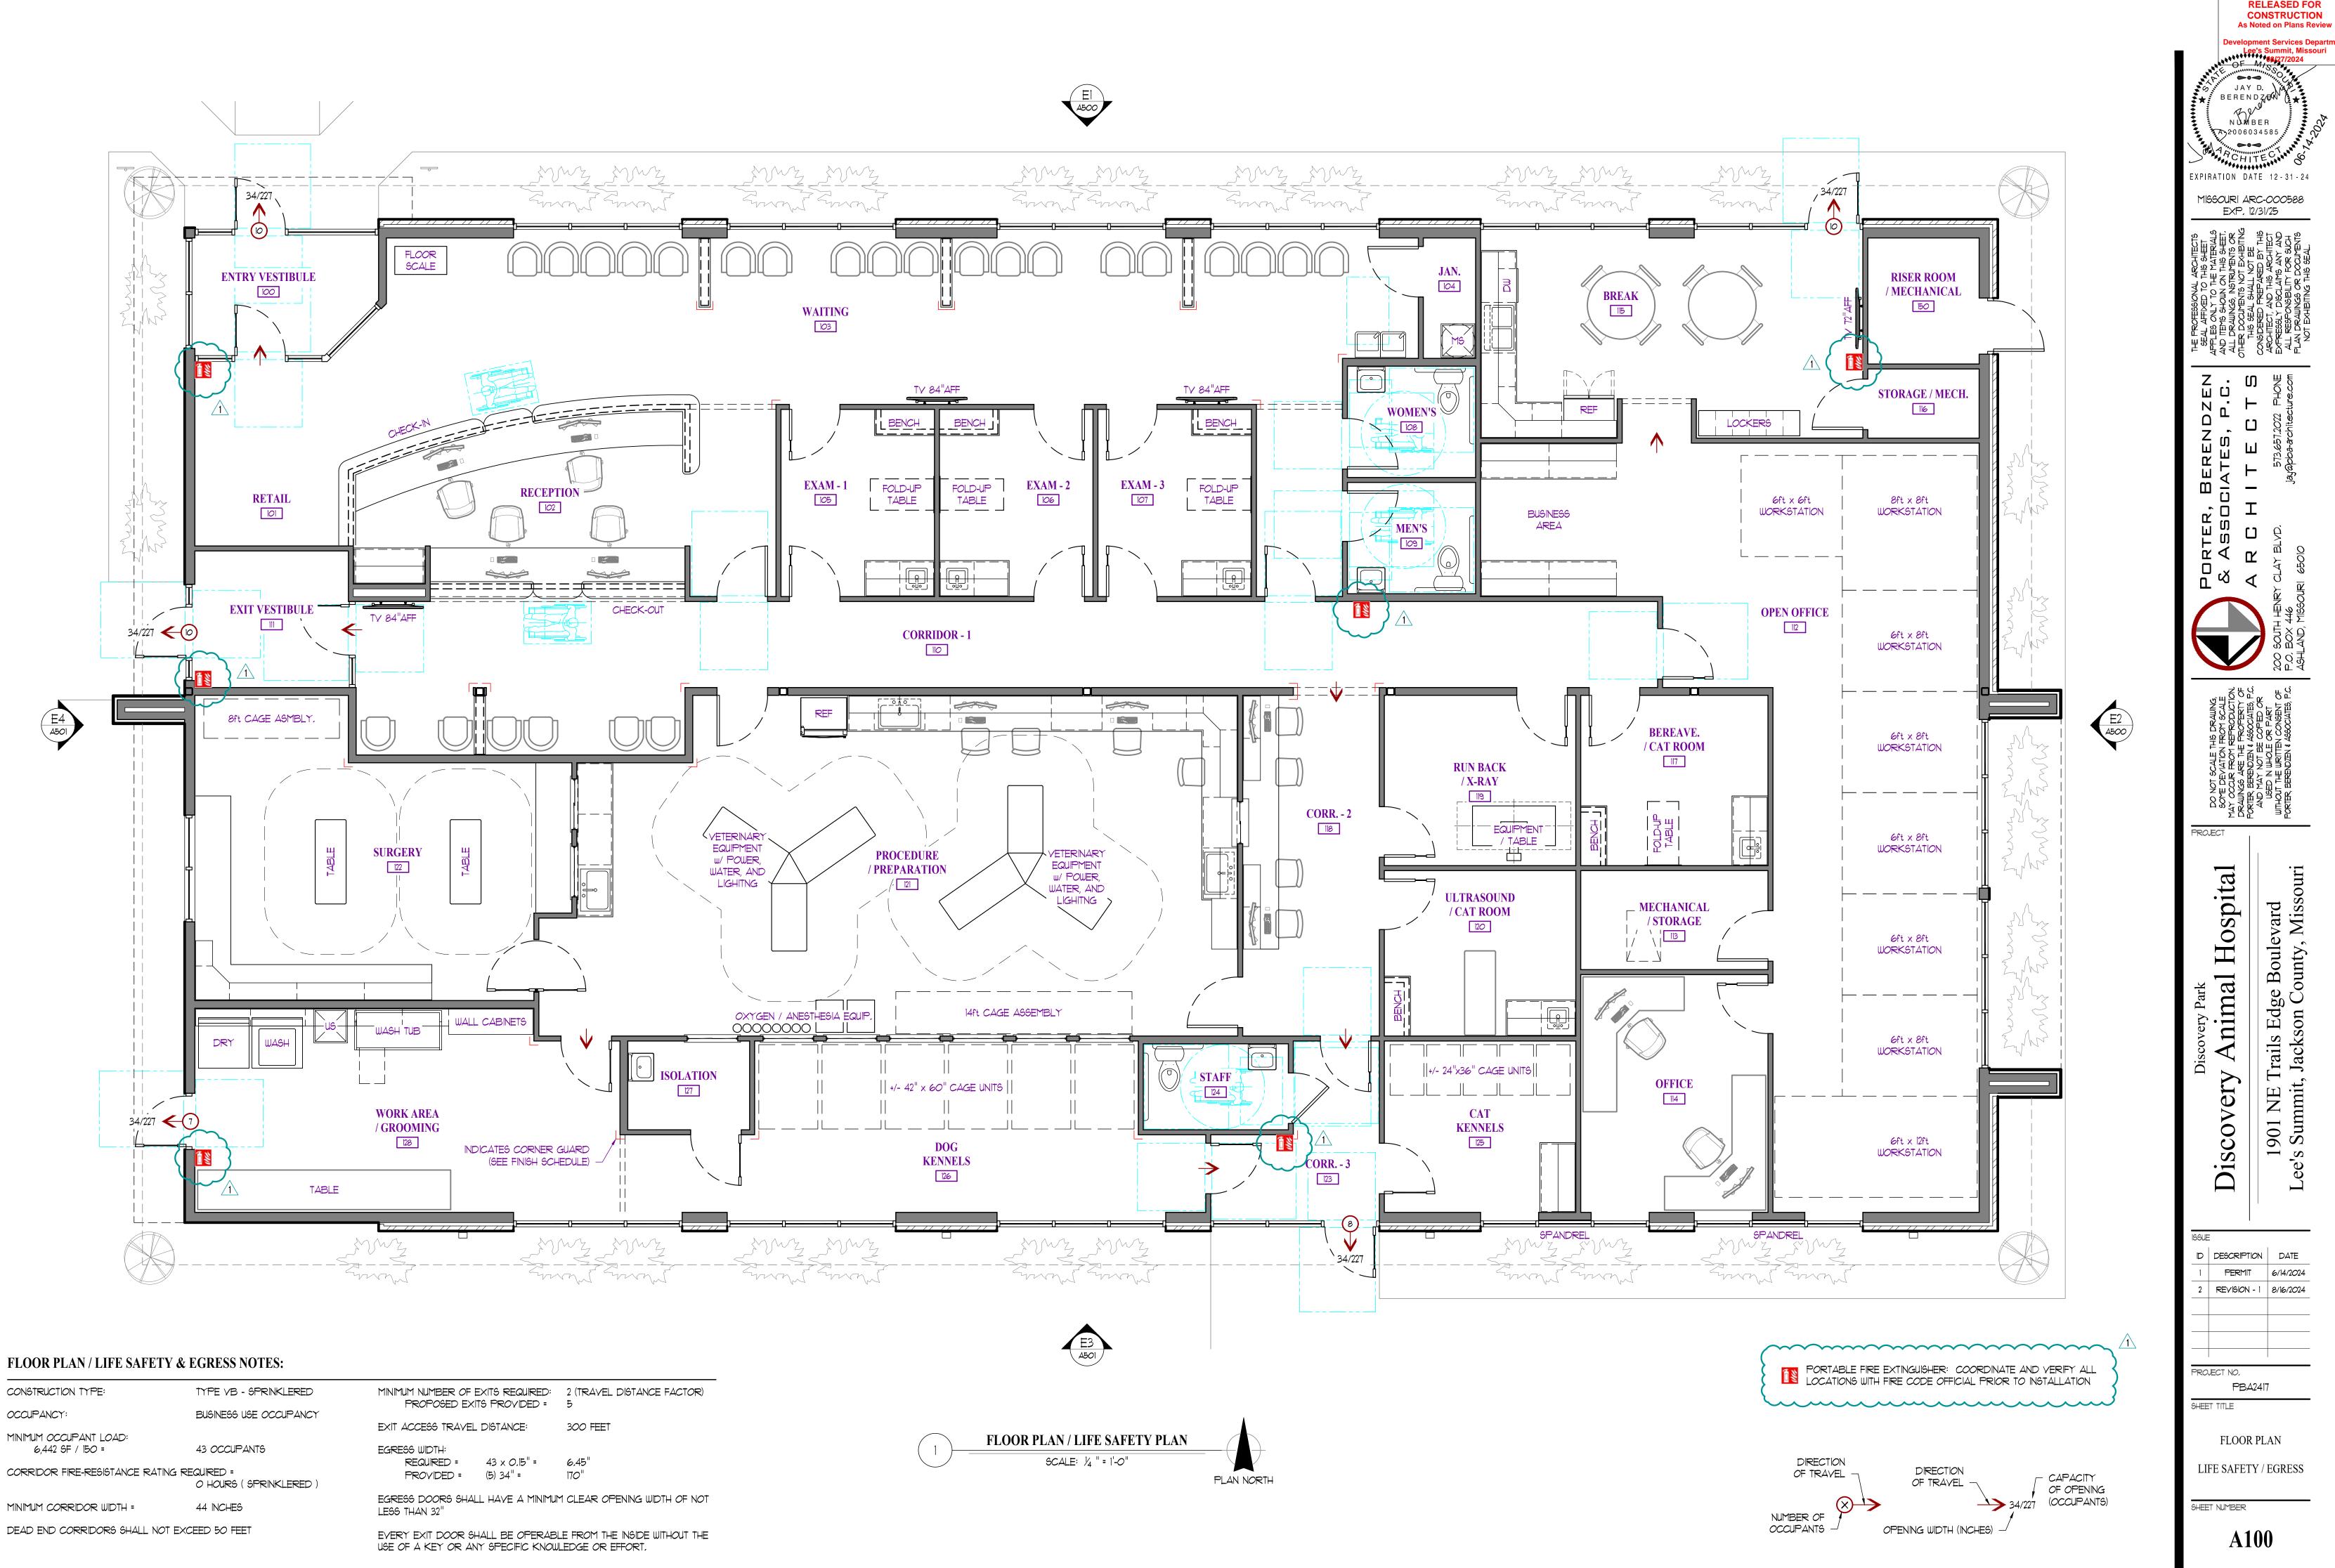






- 1. ALL WORK SHALL CONFORM TO ALL STATE, LOCAL, AND/OR ANY
- AUTHORITY HAVING JURISDICTION.
- 2. ALL DIMENSIONS SHOWN ARE TO FACE OF MASONRY / STUD OR
- CENTERLINE OF COLUMN / BEAM UNLESS NOTED OTHERWISE, 3. ALL INTERIOR WALL PARTITIONS ARE TO BE 2x4 WOOD STUD FRAMING @ 16" O.C. MAX. $w/ \frac{5}{8}$ " GYPSUM BOARD ON EACH SIDE UNLESS NOTED
- OTHERWISE, 4, INTERIOR WALLS & GYPSUM BOARD TO EXTEND A MIN. OF 6" ABOVE
- FINISH CEILING, (SEE A300 FOR WALL HEIGHT DIAGRAM)
- 5. CONTRACTOR TO PROVIDE TEMPORARY & PERMANENT BRACING AS REQUIRED, INTERIOR PARTITIONS TO HAVE DIAGONAL BRACING TO STRUCTURE @ 4'-0" O.C. WHERE APPLICABLE.
- 6. ALL DOORS TO HAVE A MIN. OF 6" FROM HINGE JAMB TO ADJACENT WALL UNLESS NOTED OTHERWISE,
- 7. INSTALL 4" ACOUSTICAL BATT INSULATION ON CEILING A MIN. OF 24" FROM COMMON WALLS FOR ADDITIONAL SOUND DEADENING AS NECESSARY, (COORDINATE LOCATIONS WITH OWNER / TENANT)
- 8. ALL EQUIPMENT, APPLIANCES, & FURNITURE SHOWN FOR REFERENCE ONLY. (VERIFY & COORDINATE EQUIPMENT PRIOR TO ANY WORK)
- 9, SEE STOREFRONT DETAILS ON SHEET A602 FOR REMAINING INFO.
- 10, SEE ROOM FINISH SCHEDULE ON SHEET A900 FOR REMAINING INFO.

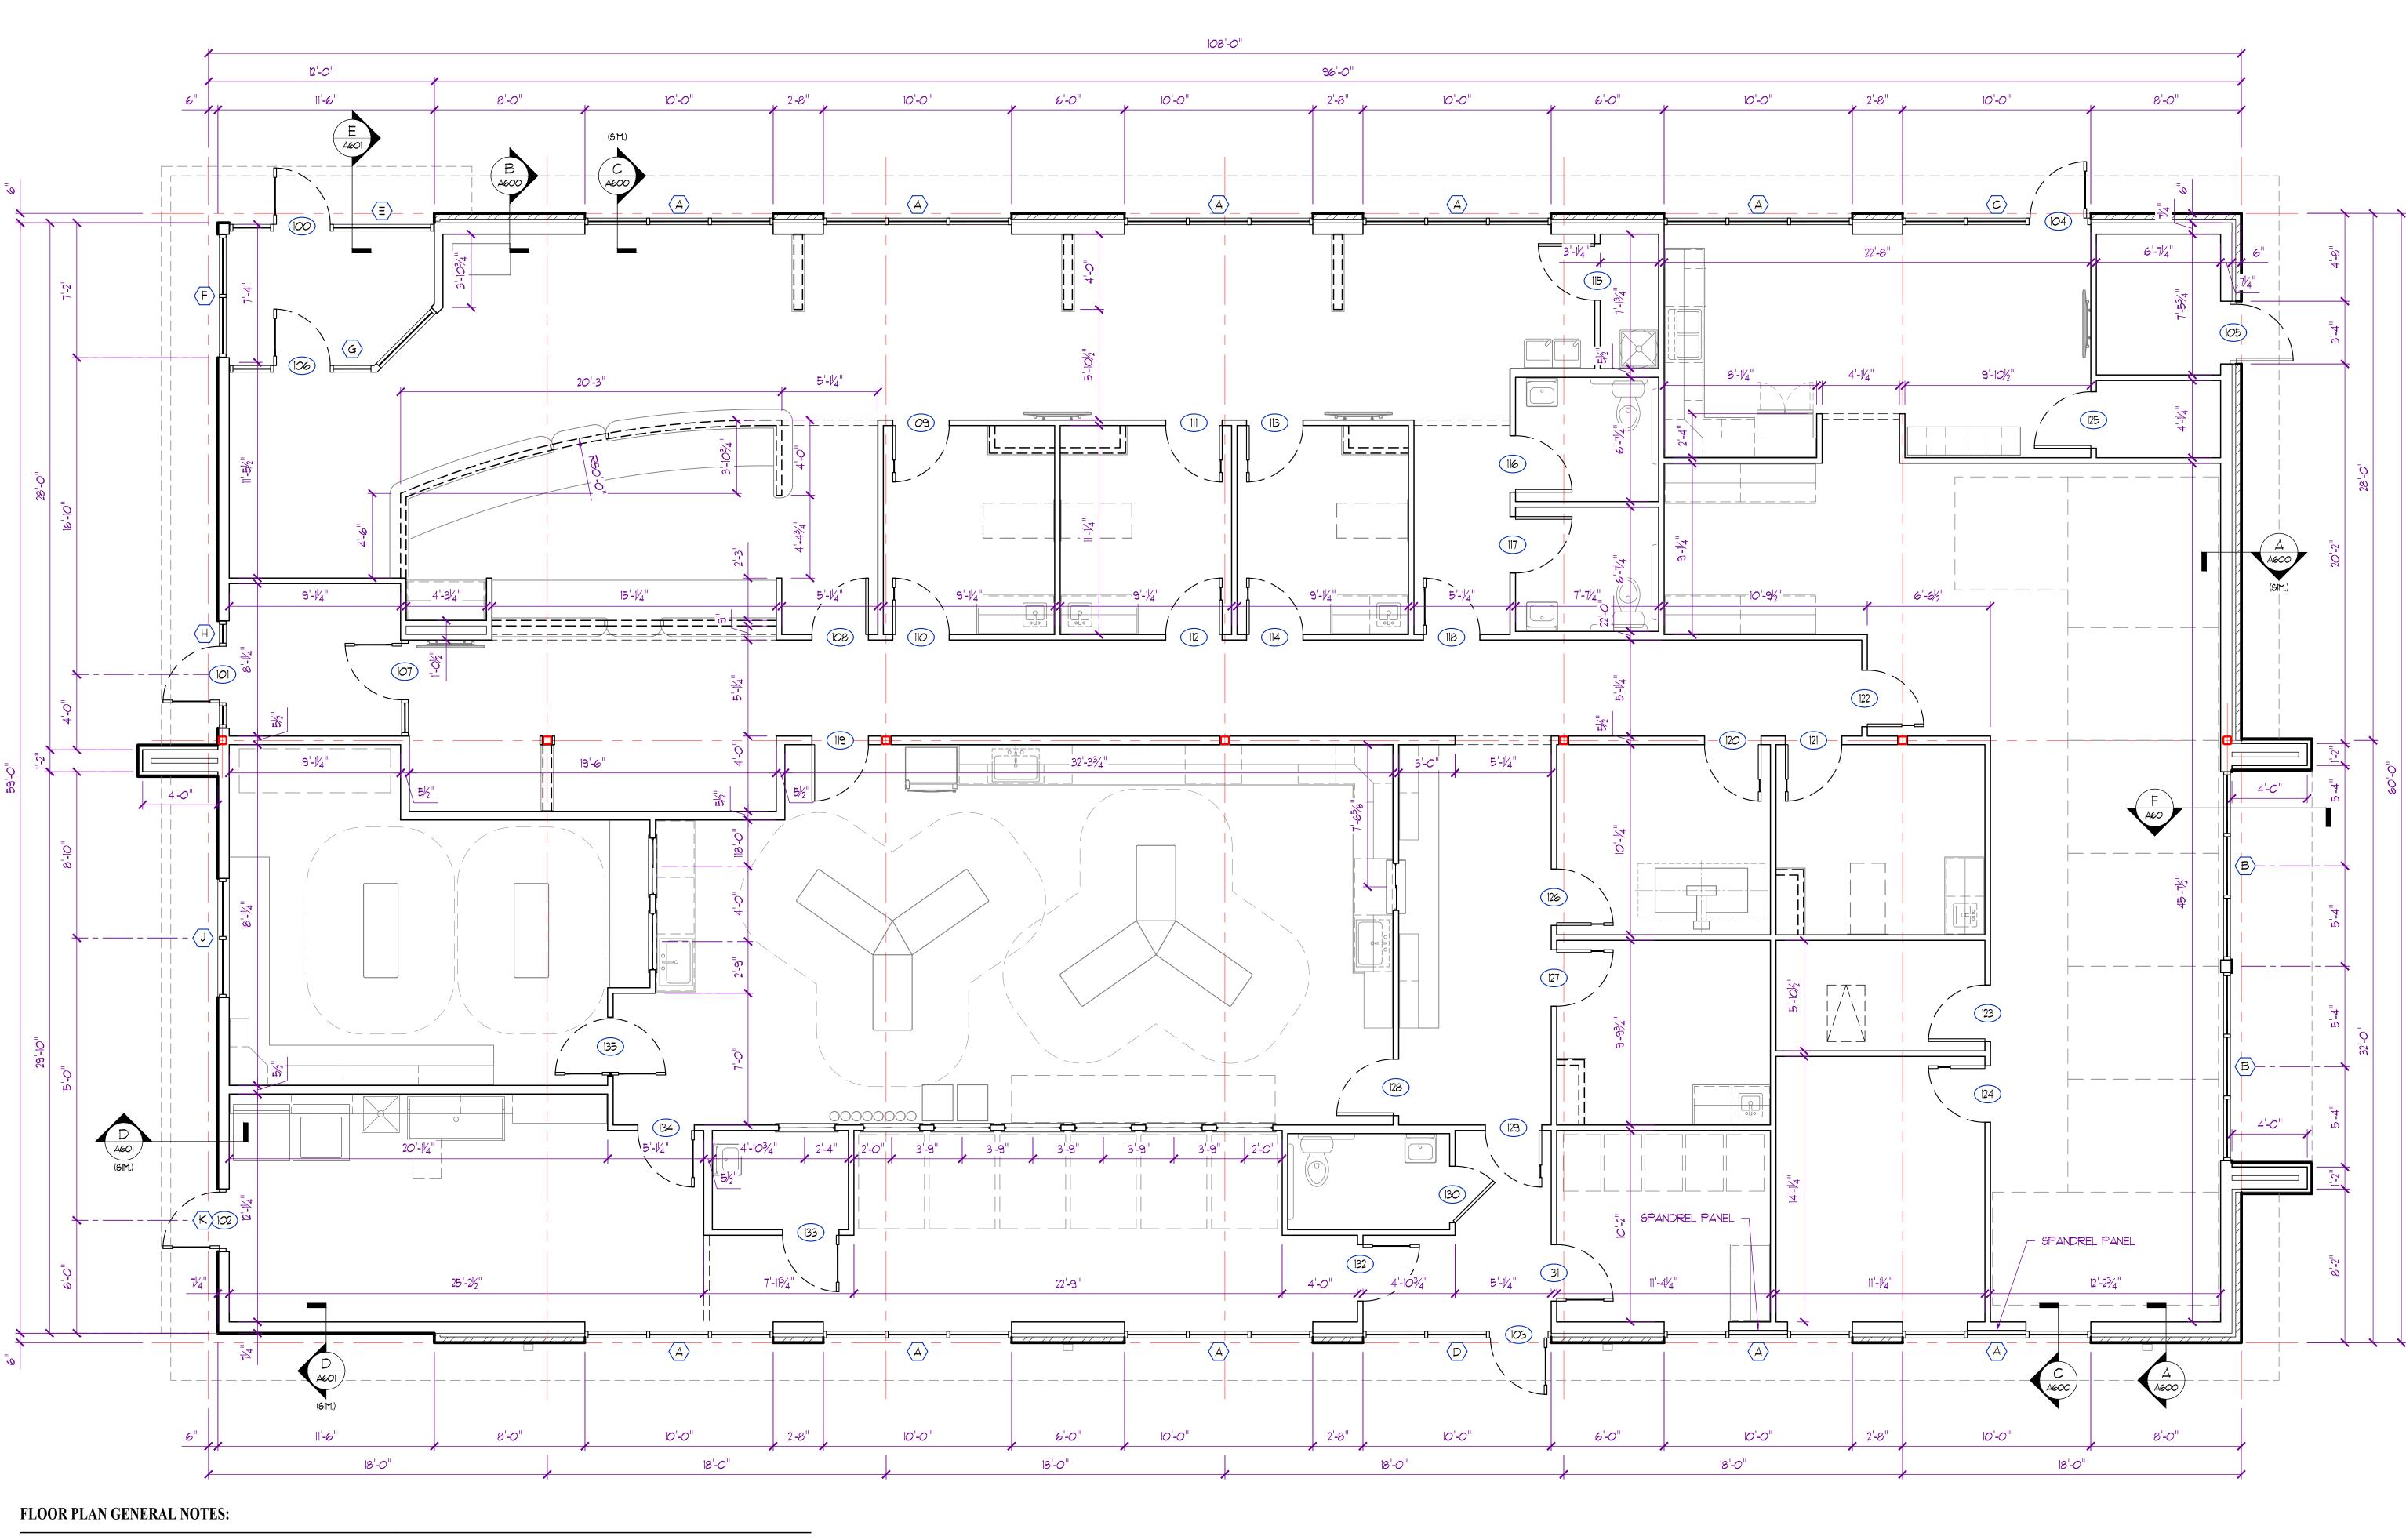DIMENSIONAL PLAN SCALE: 1/4 " = 1'-0"

PLAN NORTH

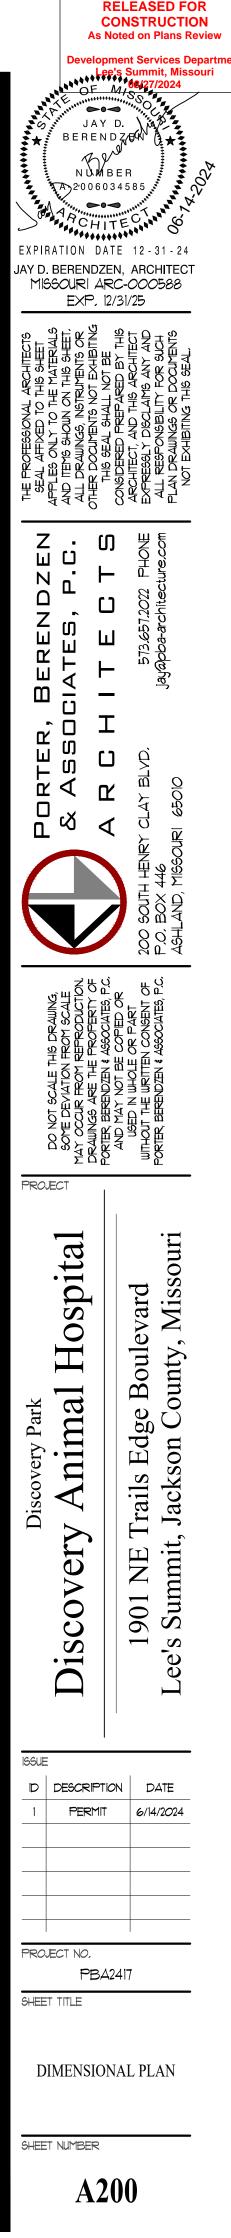

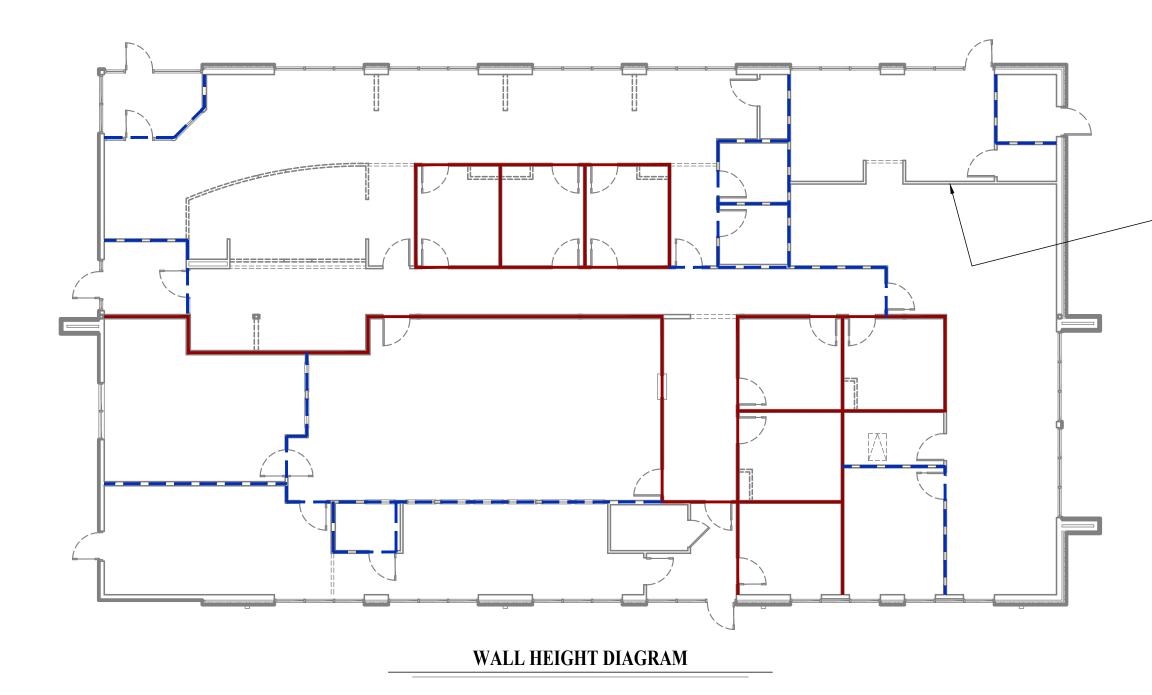

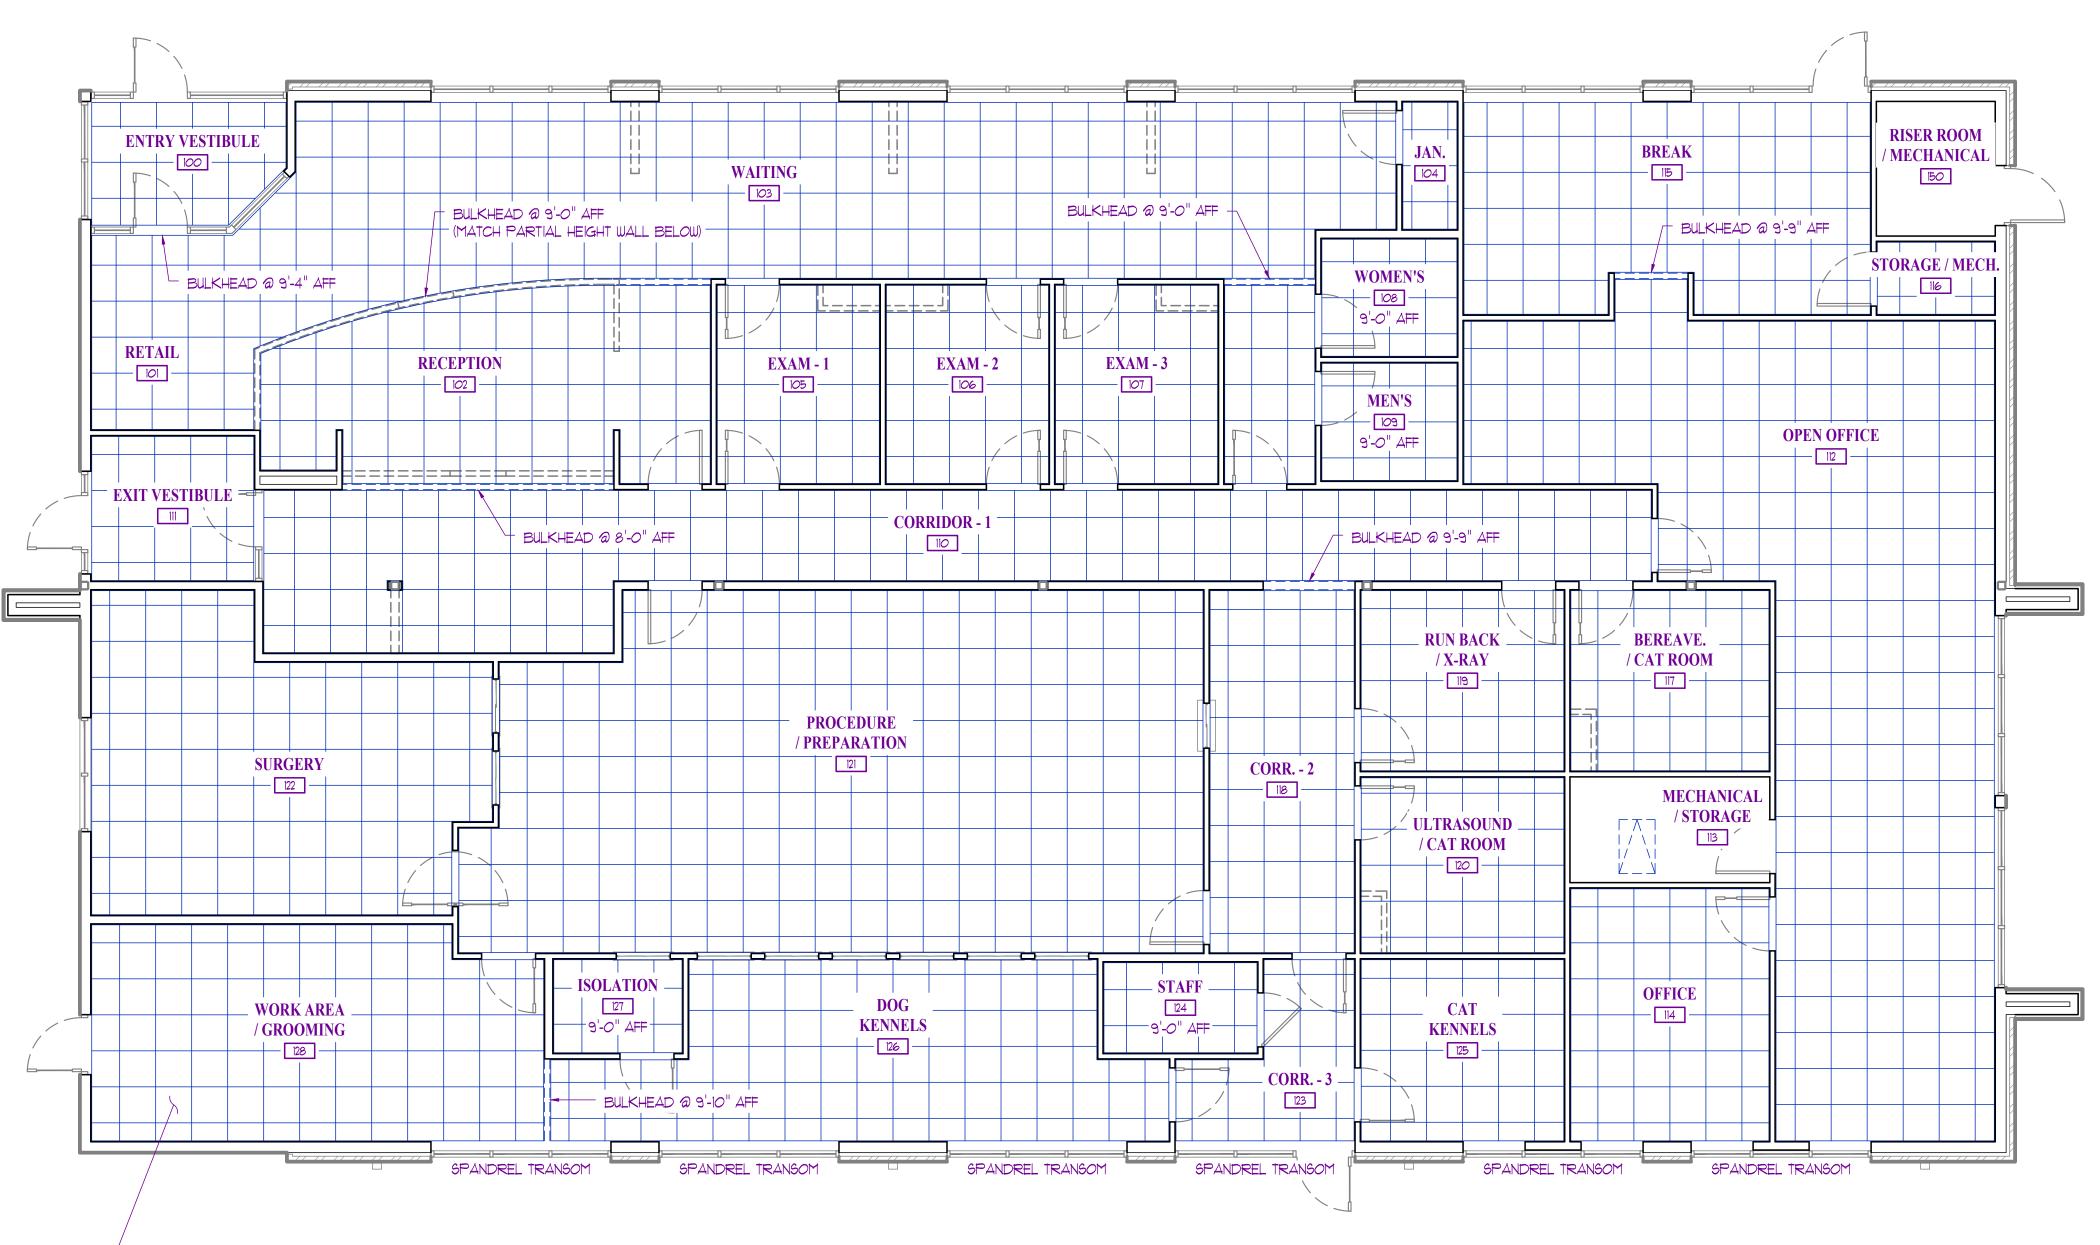

SCALE: 3/6" = 1'-0"


3

ALL CEILINGS TO BE $24" \times 24"$ ACOUSTICAL TILE INSTALLED AT 9'-11" AFF UNLESS NOTED OTHERWISE (SEE FINISH SCHEDULE ON A900 FOR REMAINING INFO) -

STANDARD INTERIOR WALL PARTION:
2x WOOD STUDS W/ $\frac{5}{8}$ " GYPSUM BOARD EACH SIDE
A MINIMUM OF 6" ABOVE ADJACENT CEILING HEIGHT
(BRACE TOP OF WALL WITH 2x @ 45° TO STRUCTURE @ 4'-O" O.C. MAX.)

INDICATES FRAMING & GYPSUM BOARD TO TERMINATE AT LONG LEG DEFLECTION TRACK BELOW ROOF LID / STRUCTURE INSTALL SOUND BATT FULL HEIGHT OF WALL


INDICATES FRAMING & GYPSUM BOARD TO TERMINATE ____ AT LONG LEG DEFLECTION TRACK BELOW ROOF LID / STRUCTURE

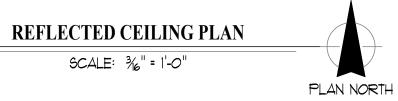


REFLECTED CEILING PLAN GENERAL NOTES:

1. SEE ROOM FINISH SCHEDULE ON SHEET A900 FOR ADDITIONAL INFORMATION,

- 2. FOR REFERENCE ONLY. TRADE CONTRACTOR TO VERIFY LOCATION OF <u>ALL</u> CEILING FEATURES AND CEILING MOUNTED EQUIPMENT & FIXTURES.
- 3. REFER TO MECHANICAL-ELECTRICAL-PLUMBING DRAWINGS FOR EXACT EQUIPMENT AND LIGHTING PLACEMENT AND SPECIFICATIONS.
- 4. METAL SUSPENSION SYSTEMS AND ACOUSTICAL TILE CEILING SHALL BE INSTALLED IN ACCORDANCE WITH IBC 2018.
- 5. GENERAL CONTRACTOR SHALL VERIFY & COORDINATE CEILING HEIGHTS WITH ALL TRADES PRIOR TO INSTALLATION, ANY ADJUSTMENTS SHALL BE COORDINATED WITH OWNER AND GENERAL CONTRACTOR.
- 6. CEILING TILES AND GRIDWORK TO BE CENTERED IN BOTH DIRECTIONS FOR EVERY ROOM OR SPACE UNLESS OTHERWISE DIMENSIONED.
- 7. LIGHTING FIXTURES AND AIR DIFFUSERS SHALL BE SUPPORTED DIRECTLY BY WIRES TO THE STRUCTURE ABOVE.
- 8. ALL DIMENSIONS TO THE FINISHED FACE OF WALL OR CENTERLINE OF CEILING GRID UNLESS NOTED OTHERWISE.

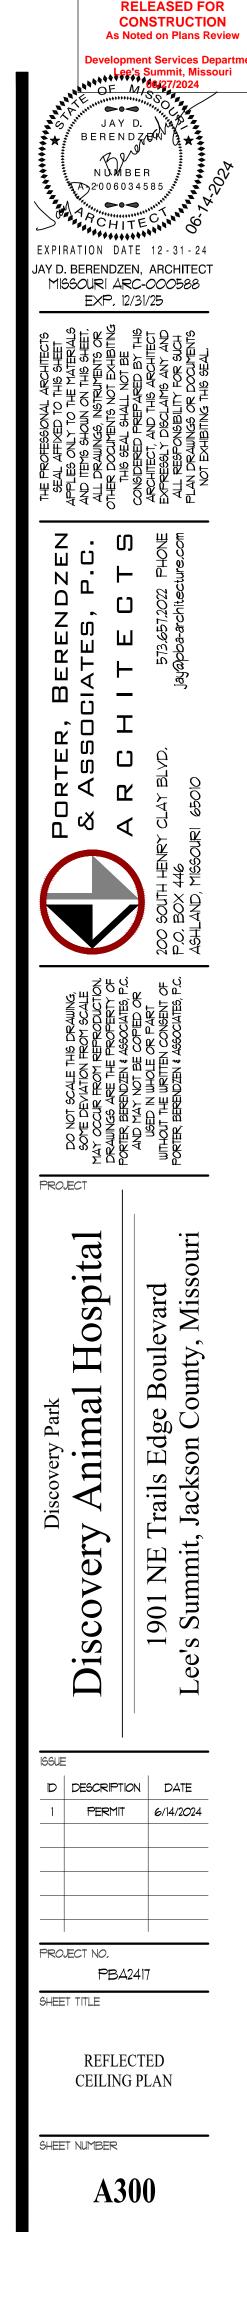


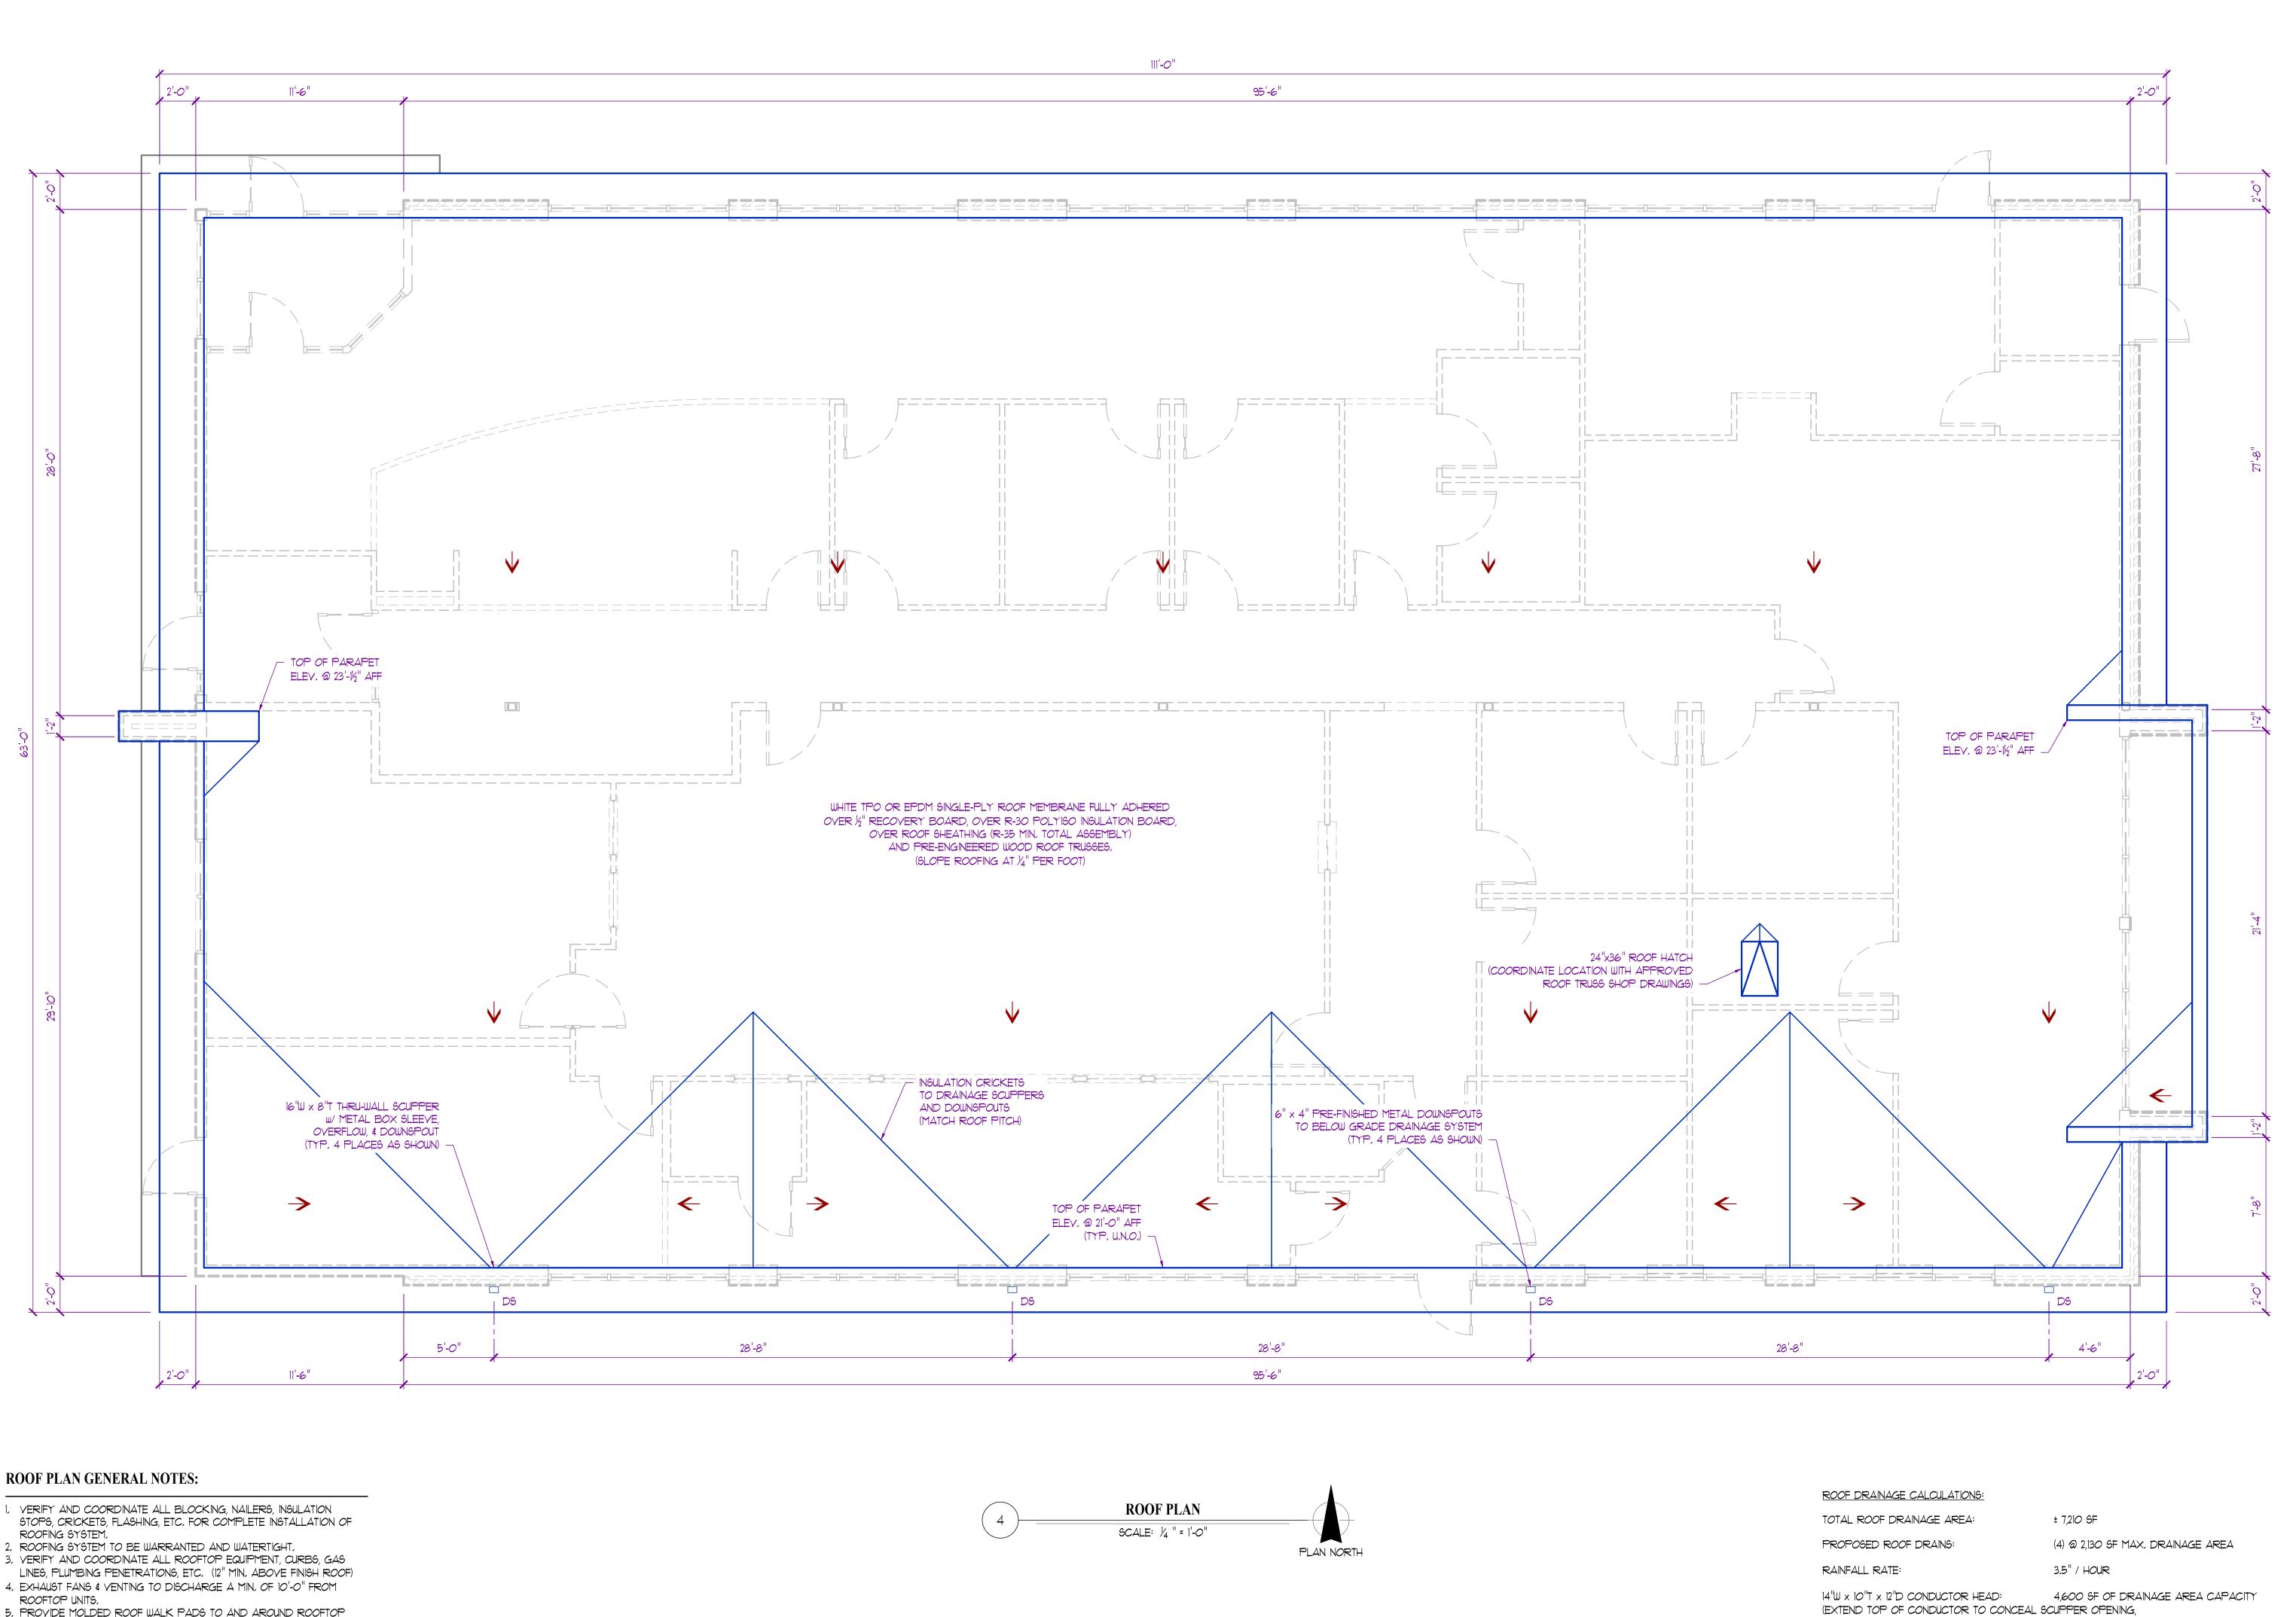

ROOF PLAN GENERAL NOTES:

- 2. ROOFING SYSTEM TO BE WARRANTED AND WATERTIGHT.
- 3. VERIFY AND COORDINATE ALL ROOFTOP EQUIPMENT, CURBS, GAS
- 5. PROVIDE MOLDED ROOF WALK PADS TO AND AROUND ROOFTOP
- UNITS & OTHER EQUIPMENT AS NECESSARY.

INSTALL OVERFLOW IN CONDUCTOR AT SCUPPER ELEVATION)

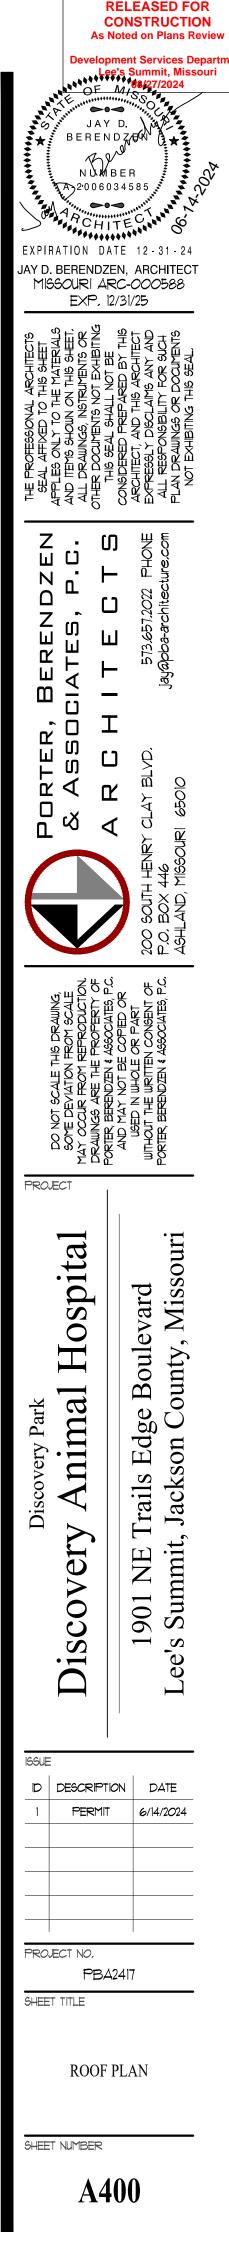



RECESSED LIGHTING IN CANOPY SOFFIT \dashv

E2 Aloo

EAST ELEVATION SCALE: 3/6" = 1'-0"

TO MATCH STOREFRONT

ELEVATOIN GENERAL NOTES:

- 1, FOR REFERENCE ONLY, VERIFY AND COORDINATE ALL MATERIALS AND FINISHES WITH OWNER PRIOR TO ANY WORK.
- 2. DO NOT SCALE THIS DRAWING, REFER TO DIMENSIONS AND MEMBER SIZES GIVEN AS INDICATED ON FLOOR PLANS, SECTIONS, & DETAILS.

A PERENT BERENT NUMB 200603 A PCHT EXPIRATION DAT JAY D. BERENDZE MISSOURI AR	TE 12 - 31 - 24
PORTER, BERENDZEN & ASSOCIATES, P.C. A R C H I T E C T S	573.657.2022 PHC Jayapba-architecture.c
DO NOT SCALE THIS DRAUING, SOME DEVIATION FROM SCALE MAY OCCUR FROM REPROPUCTION, DRAUINGS ARE THE PROPERTY OF PORTIR, BERENDZIN & ASSOCIATES, P.C.	AND MAY NOT BE COPIED OR USED N WHOLE OR PART WITHOUT THE WRITTEN CONSENT OF PORTER, BERENDZEN & ASSOCIATES, P.C. F.O. E AGHLA
Discovery Park Discovery Animal Hospital	1901 NE Trails Edge Boulevard Lee's Summit, Jackson County, Missouri
ID DESCRIPTIO	DN DATE 6/14/2024
PROJECT NO. PBA2 SHEET TITLE EXTER ELEVAT	RIOR
SHEET NUMBER	



SOUTH ELEVATION SCALE: 3/6" = 1'-0"


E3 A100


METAL OVER HEADER TO MATCH FRAME


ELEVATOIN GENERAL NOTES:

- 1, FOR REFERENCE ONLY, VERIFY AND COORDINATE ALL MATERIALS AND FINISHES WITH OWNER PRIOR TO ANY WORK.
- 2. DO NOT SCALE THIS DRAWING, REFER TO DIMENSIONS AND MEMBER SIZES GIVEN AS INDICATED ON FLOOR PLANS, SECTIONS, & DETAILS.


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	TION DATE ERENDZEN	ECT 4 4 4 6
THE PROFESSIONAL ARCHITECTS SEAL AFFIXED TO THIS SHEET APPLES ONLY TO THE MATERIAL	AND ITEMS SHOUN ON THIS SHEET ALL DRAUNGS, INSTRUMENTS OF OTHER DOCUMENTS NOT EXHIBITIN THIS SEAL SHALL NOT BE TONGINEDED FORED APPEN DEY THI	\vee \mapsto \angle \angle \square
PORTER, BERENDZEN	& ASSOCIATES, P.C. A R C H I T E C T S	573.657.2022 PHONE Jay@pba-architecture.com
PORTER		200 SOUTH HENRY CLAY BLVD. P.O. BOX 446 ASHLAND, MISSOURI 65010
لَمَ م		
DO NOT SCALE THIS DRAWING,	 ™AY OCCUR FROM FROM SCALE MAY OCCUR FROM REPRODUCTION. DRAUINGS ARE THE PROPERIY OF PORTER, BERENDZEN & ASSOCIATES, P.C. AND MAY NOT RE COREED OF 	NUEED N WHOLE OF PART WITHOUT THE WRITTEN CONSENT OF PORTER, BERENDZEN & ASSOCIATES, P.C.
Discovery Park	Discovery Animal Hospital	1901 NE Trails Edge Boulevard Lee's Summit, Jackson County, Missouri
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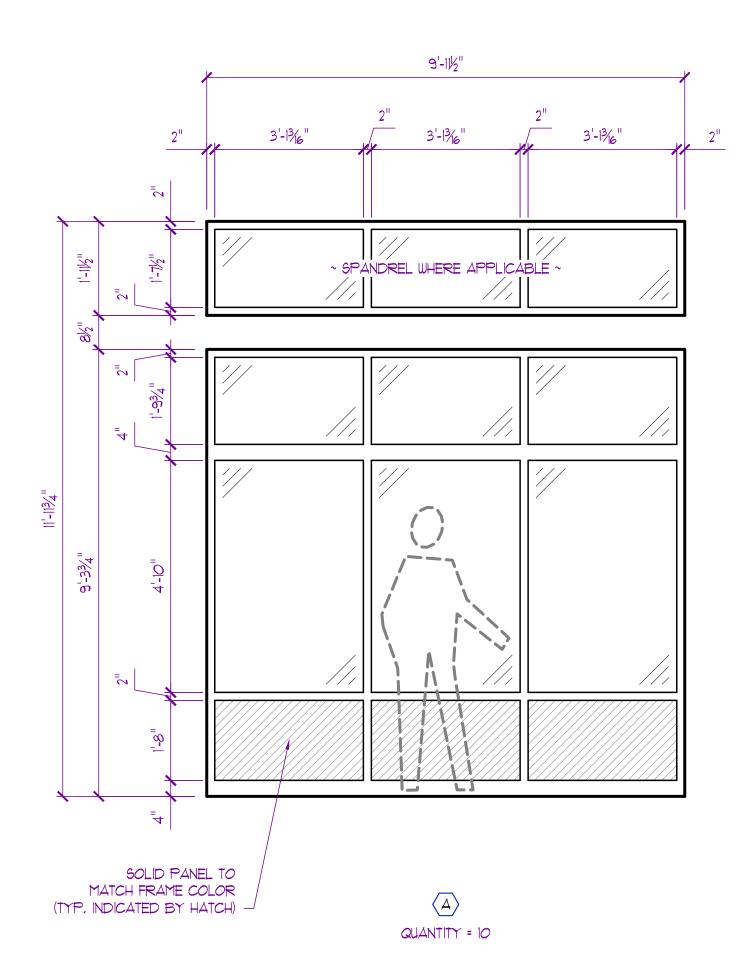


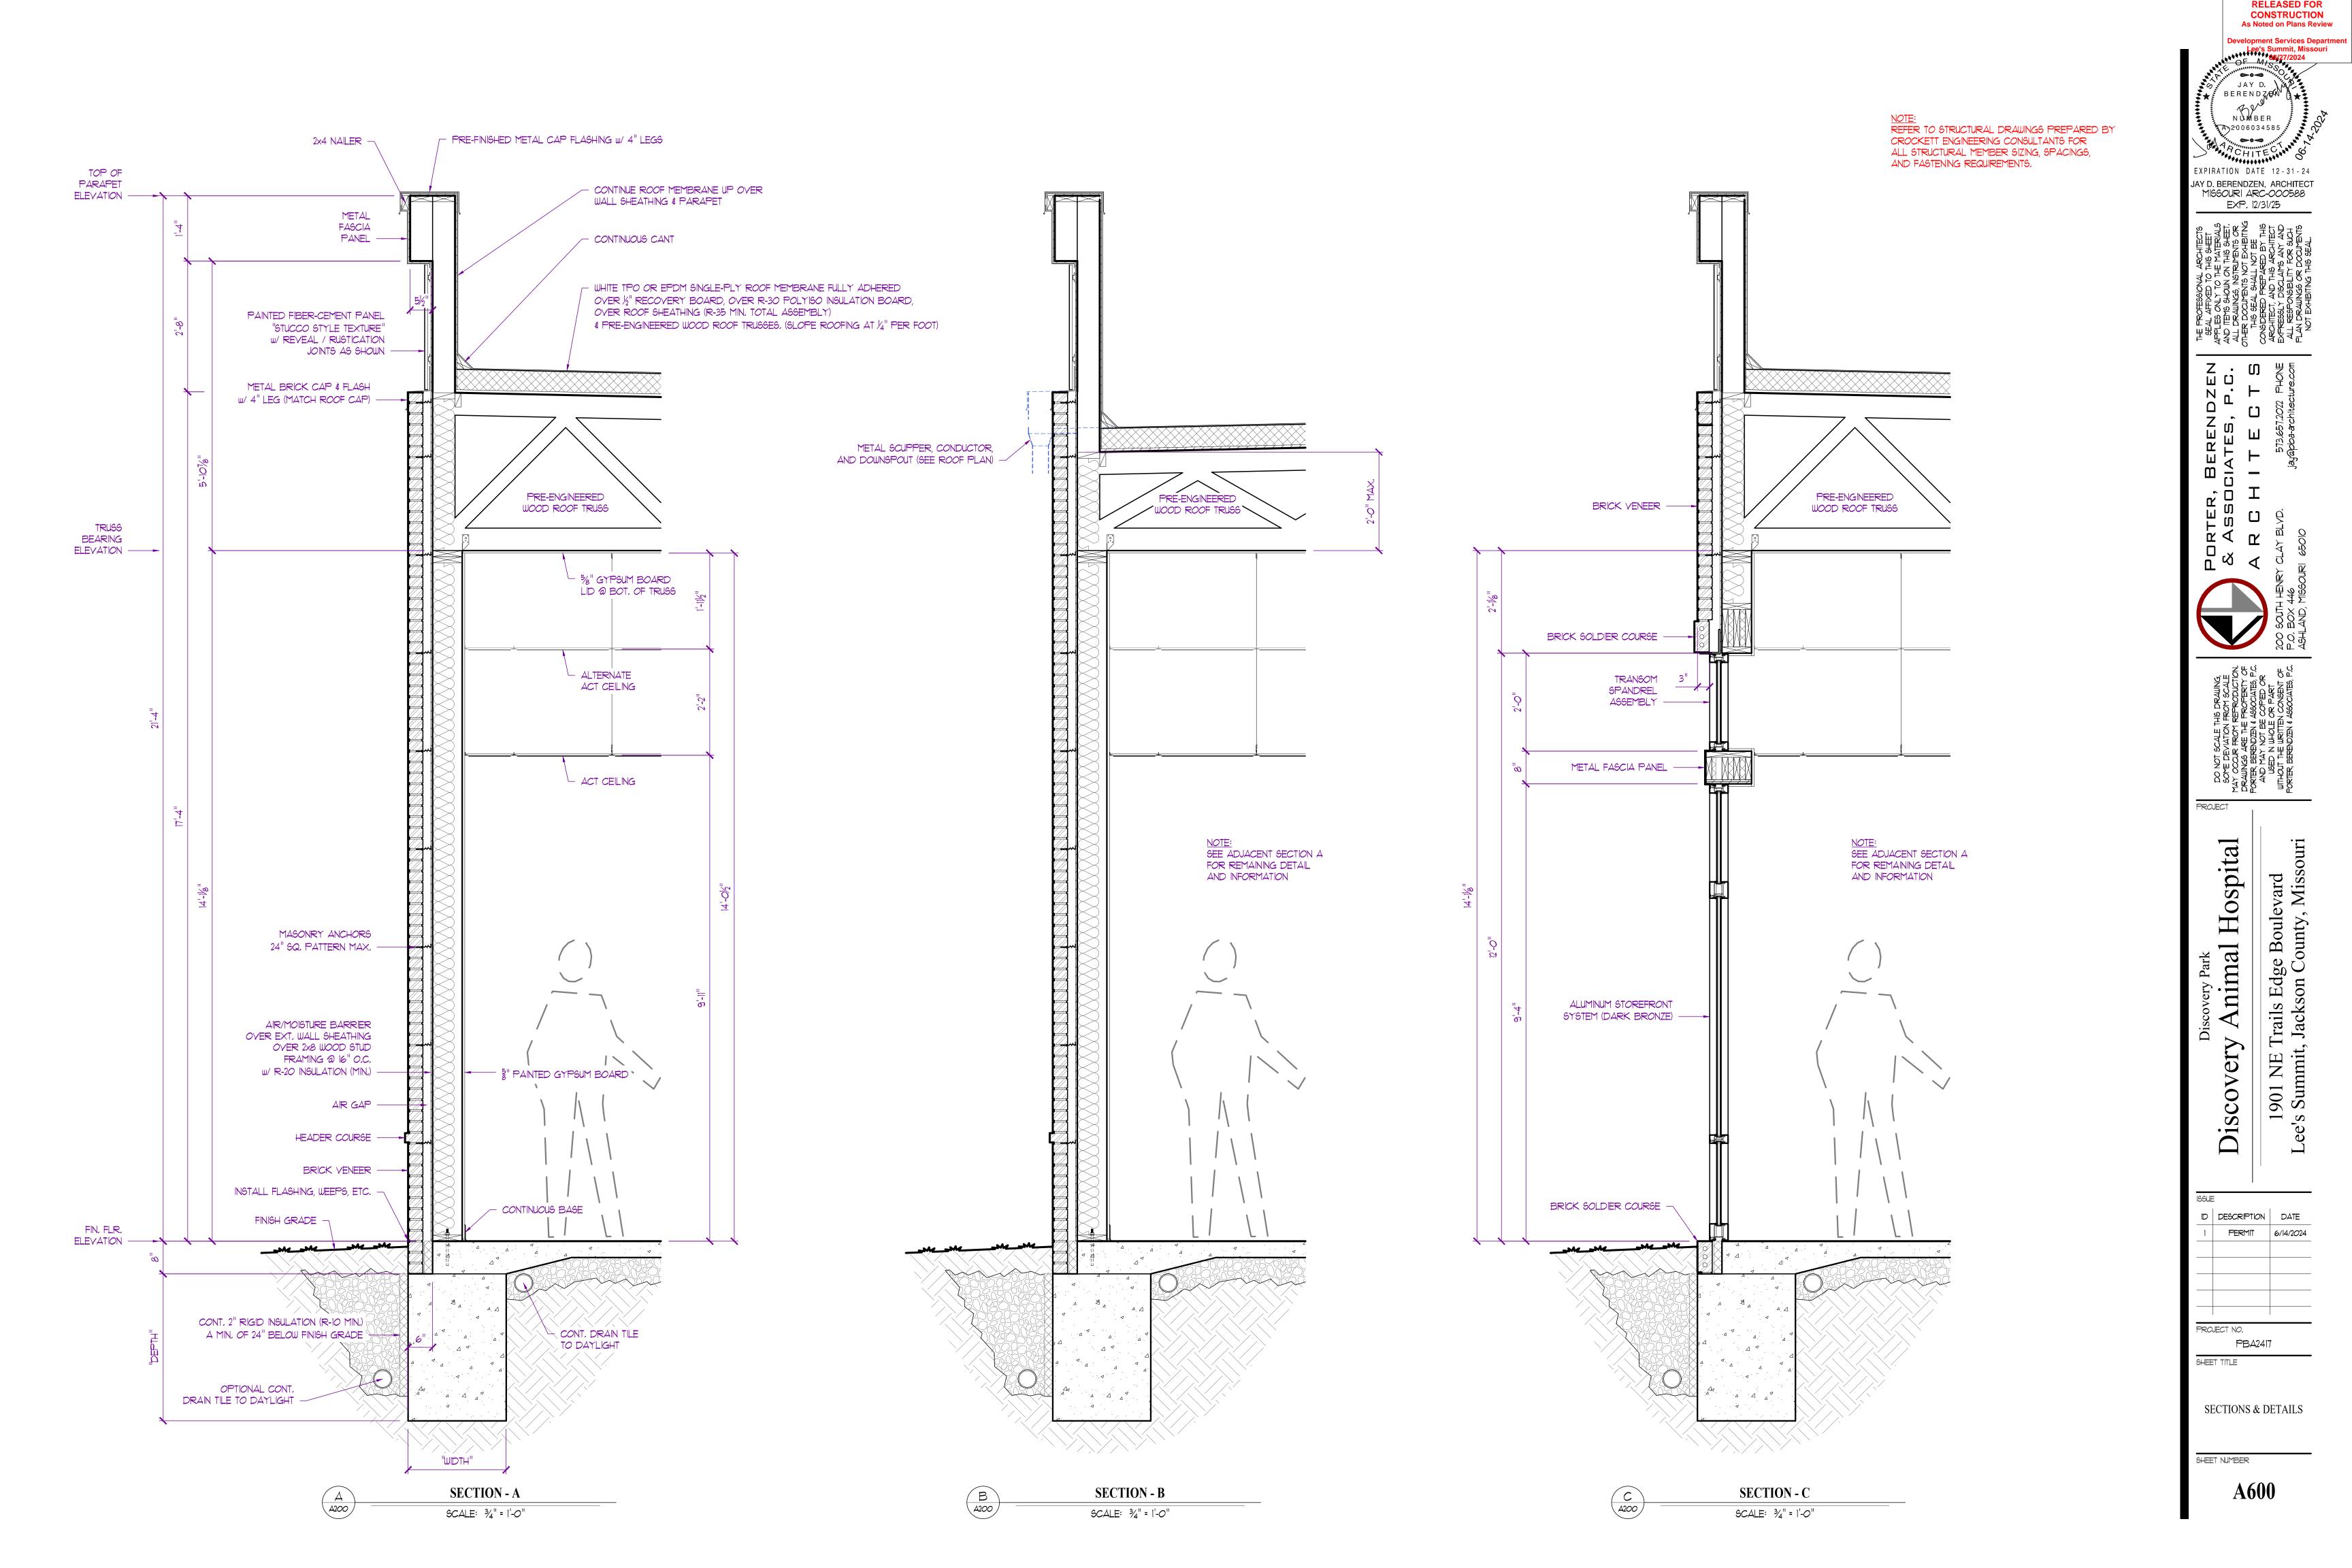


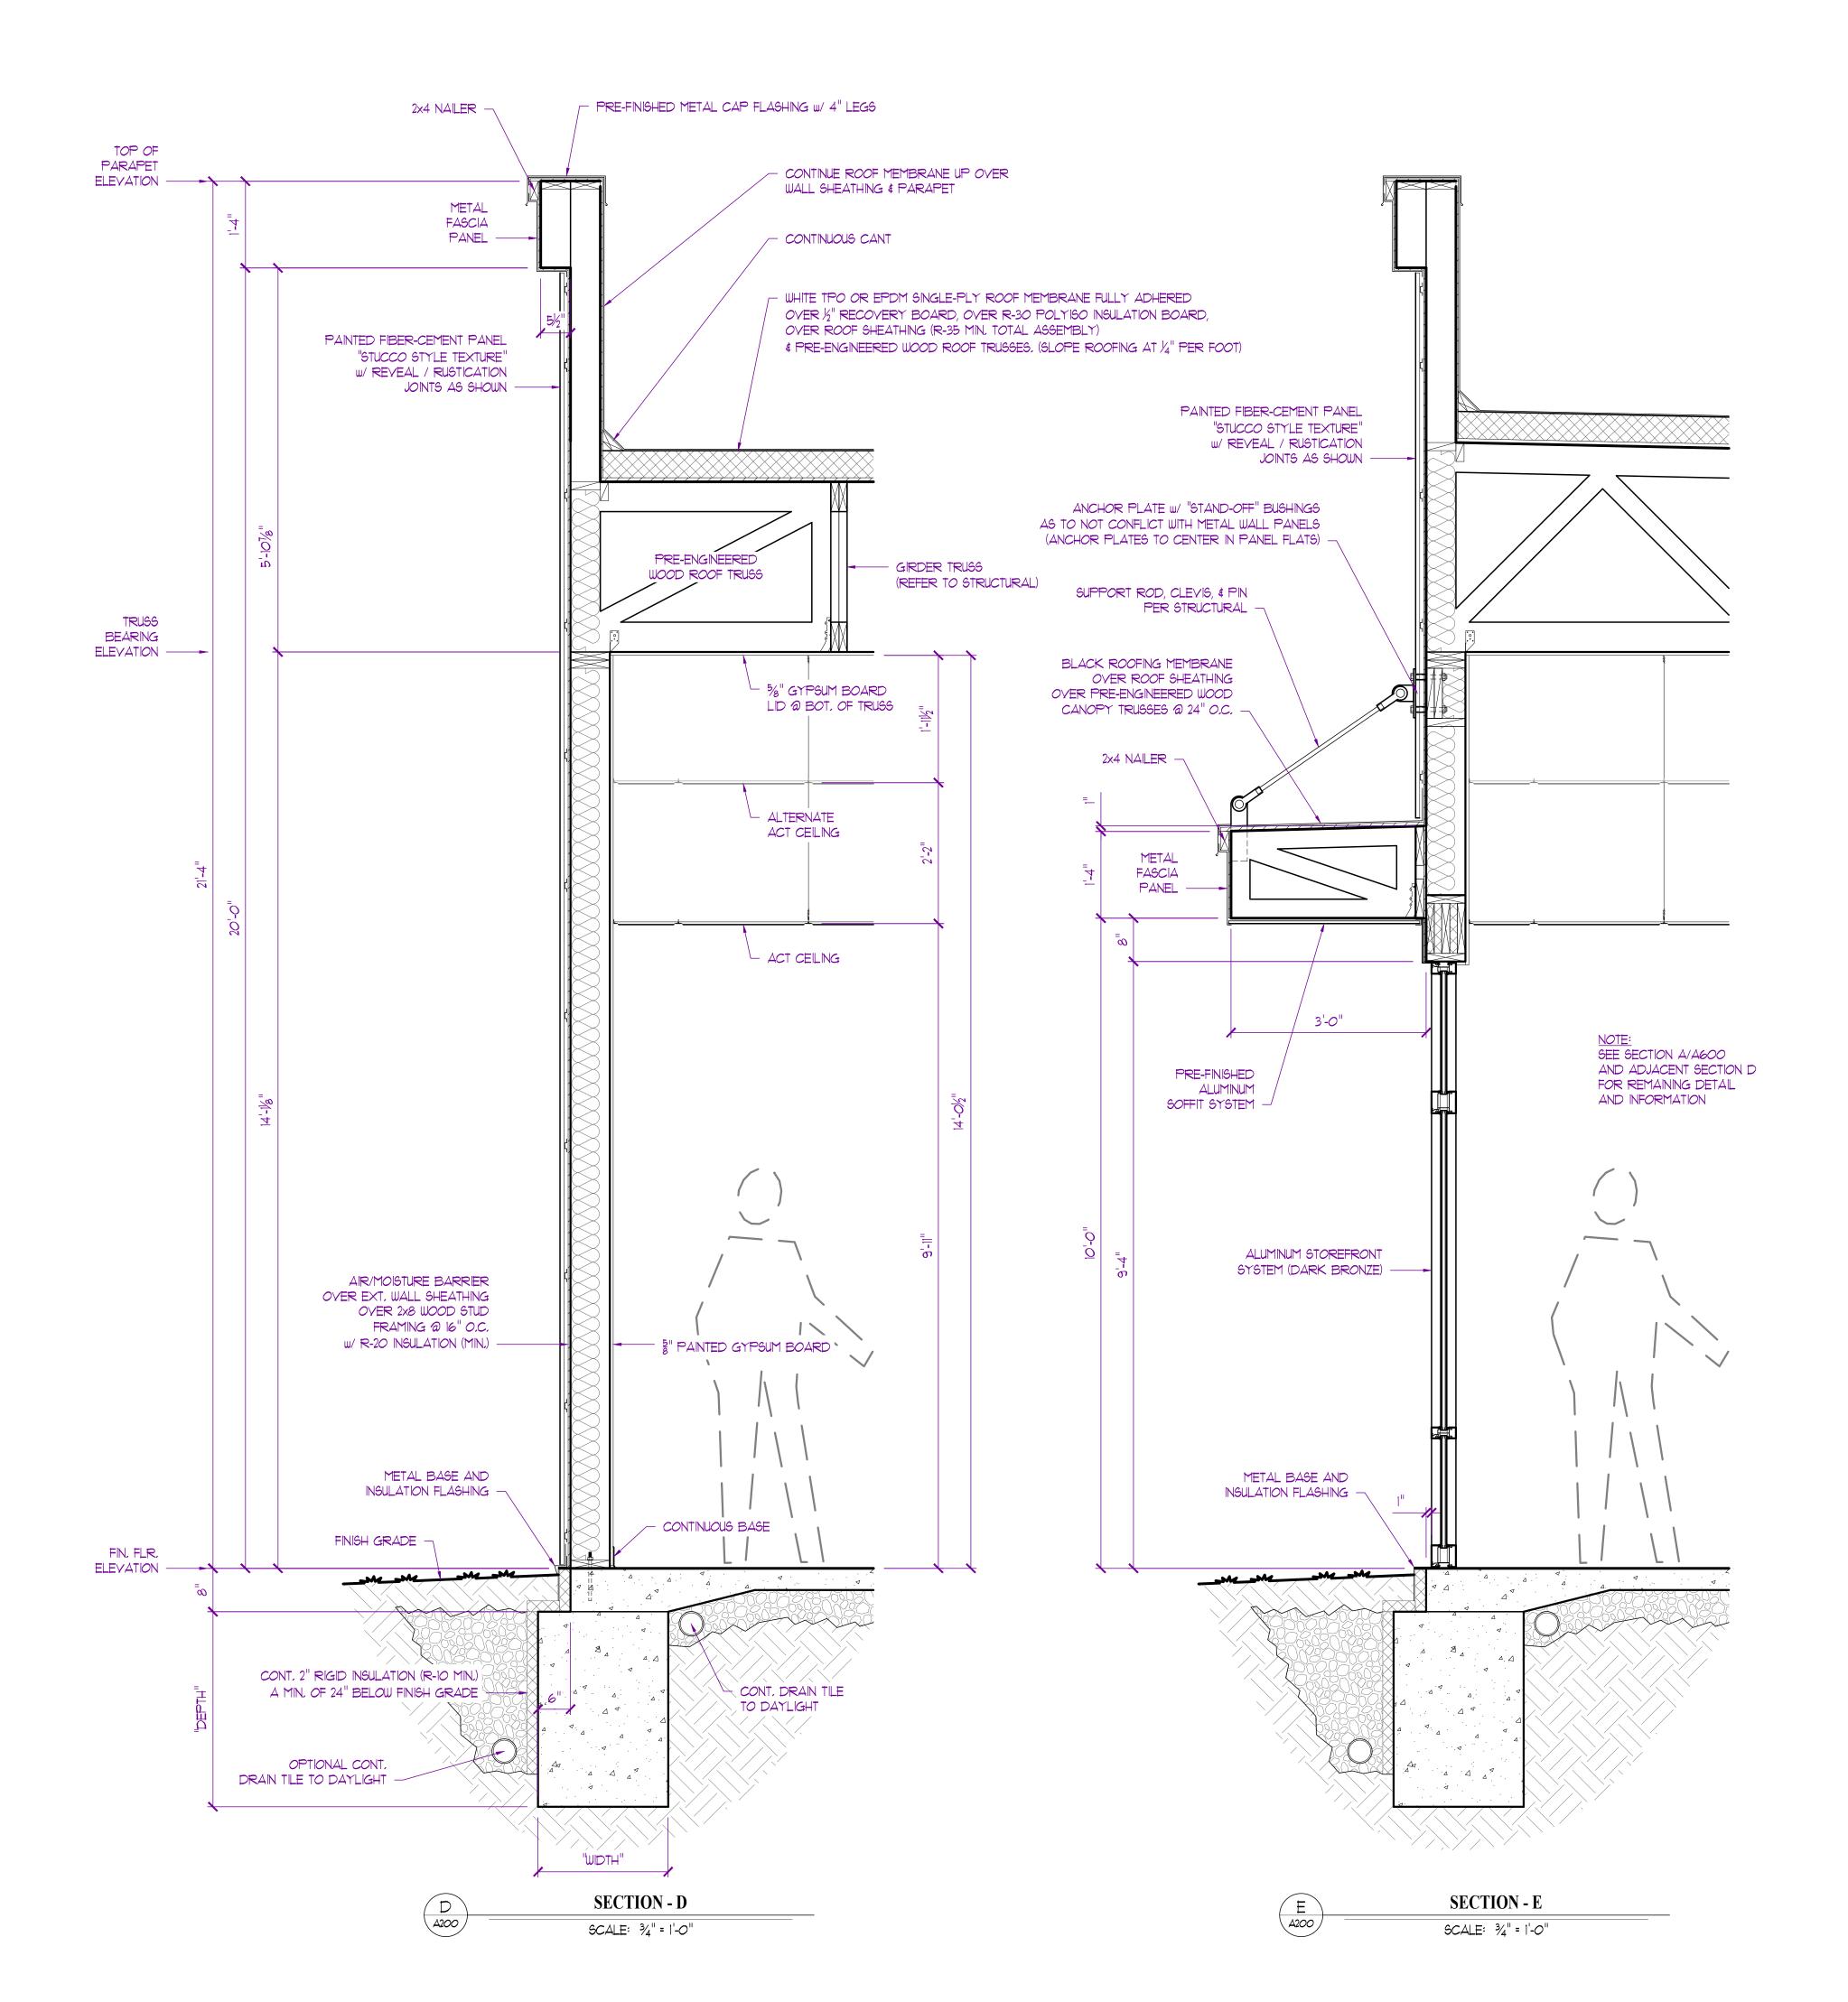


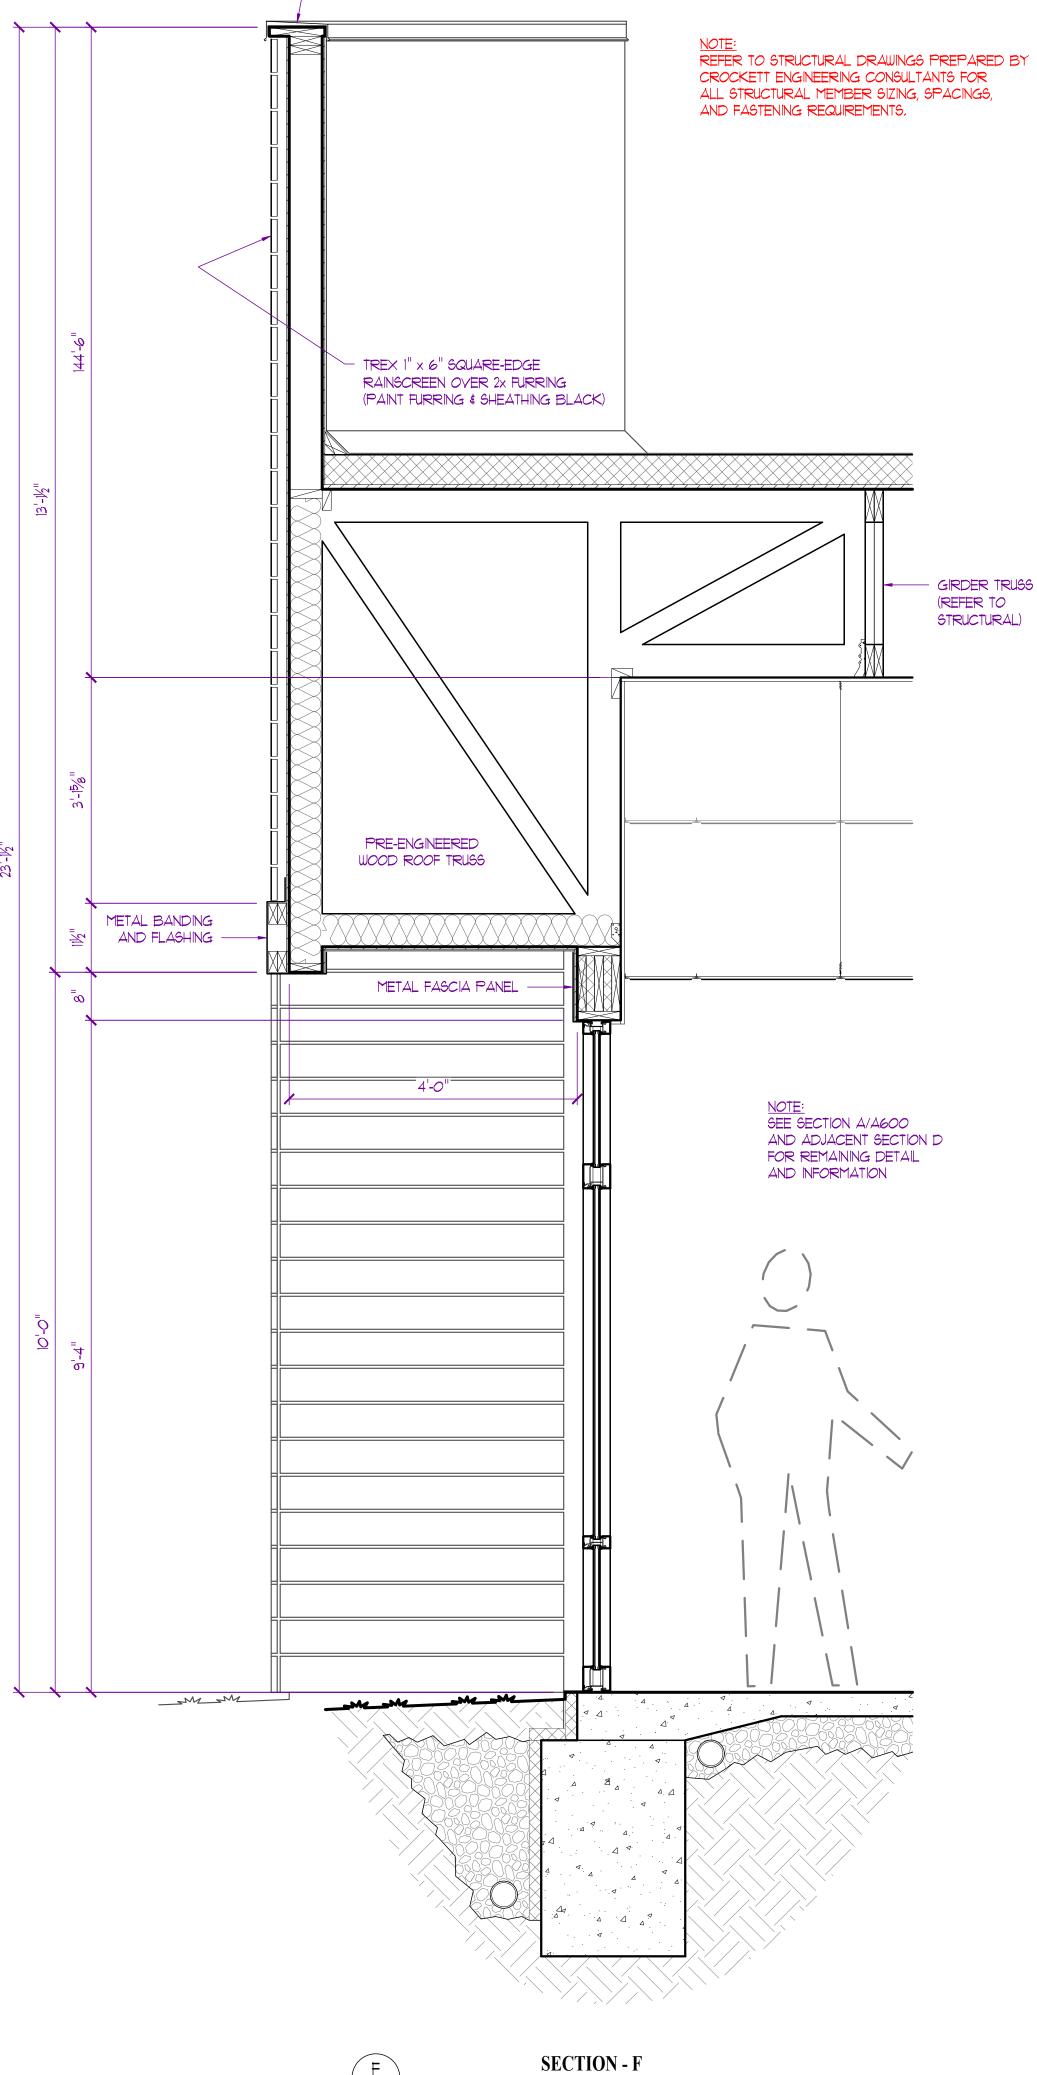
SCALE: 3/4" = 1'-0"


(A200)

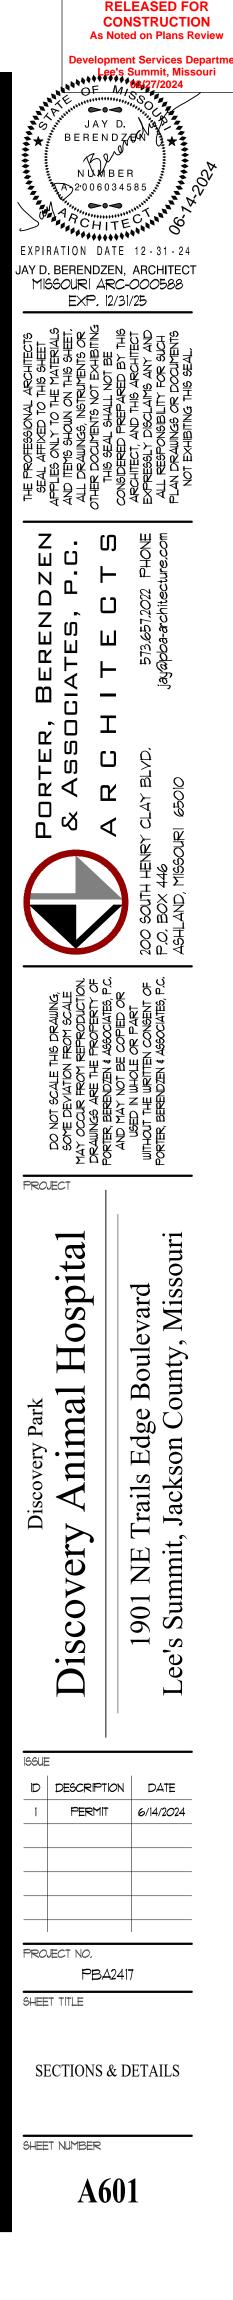

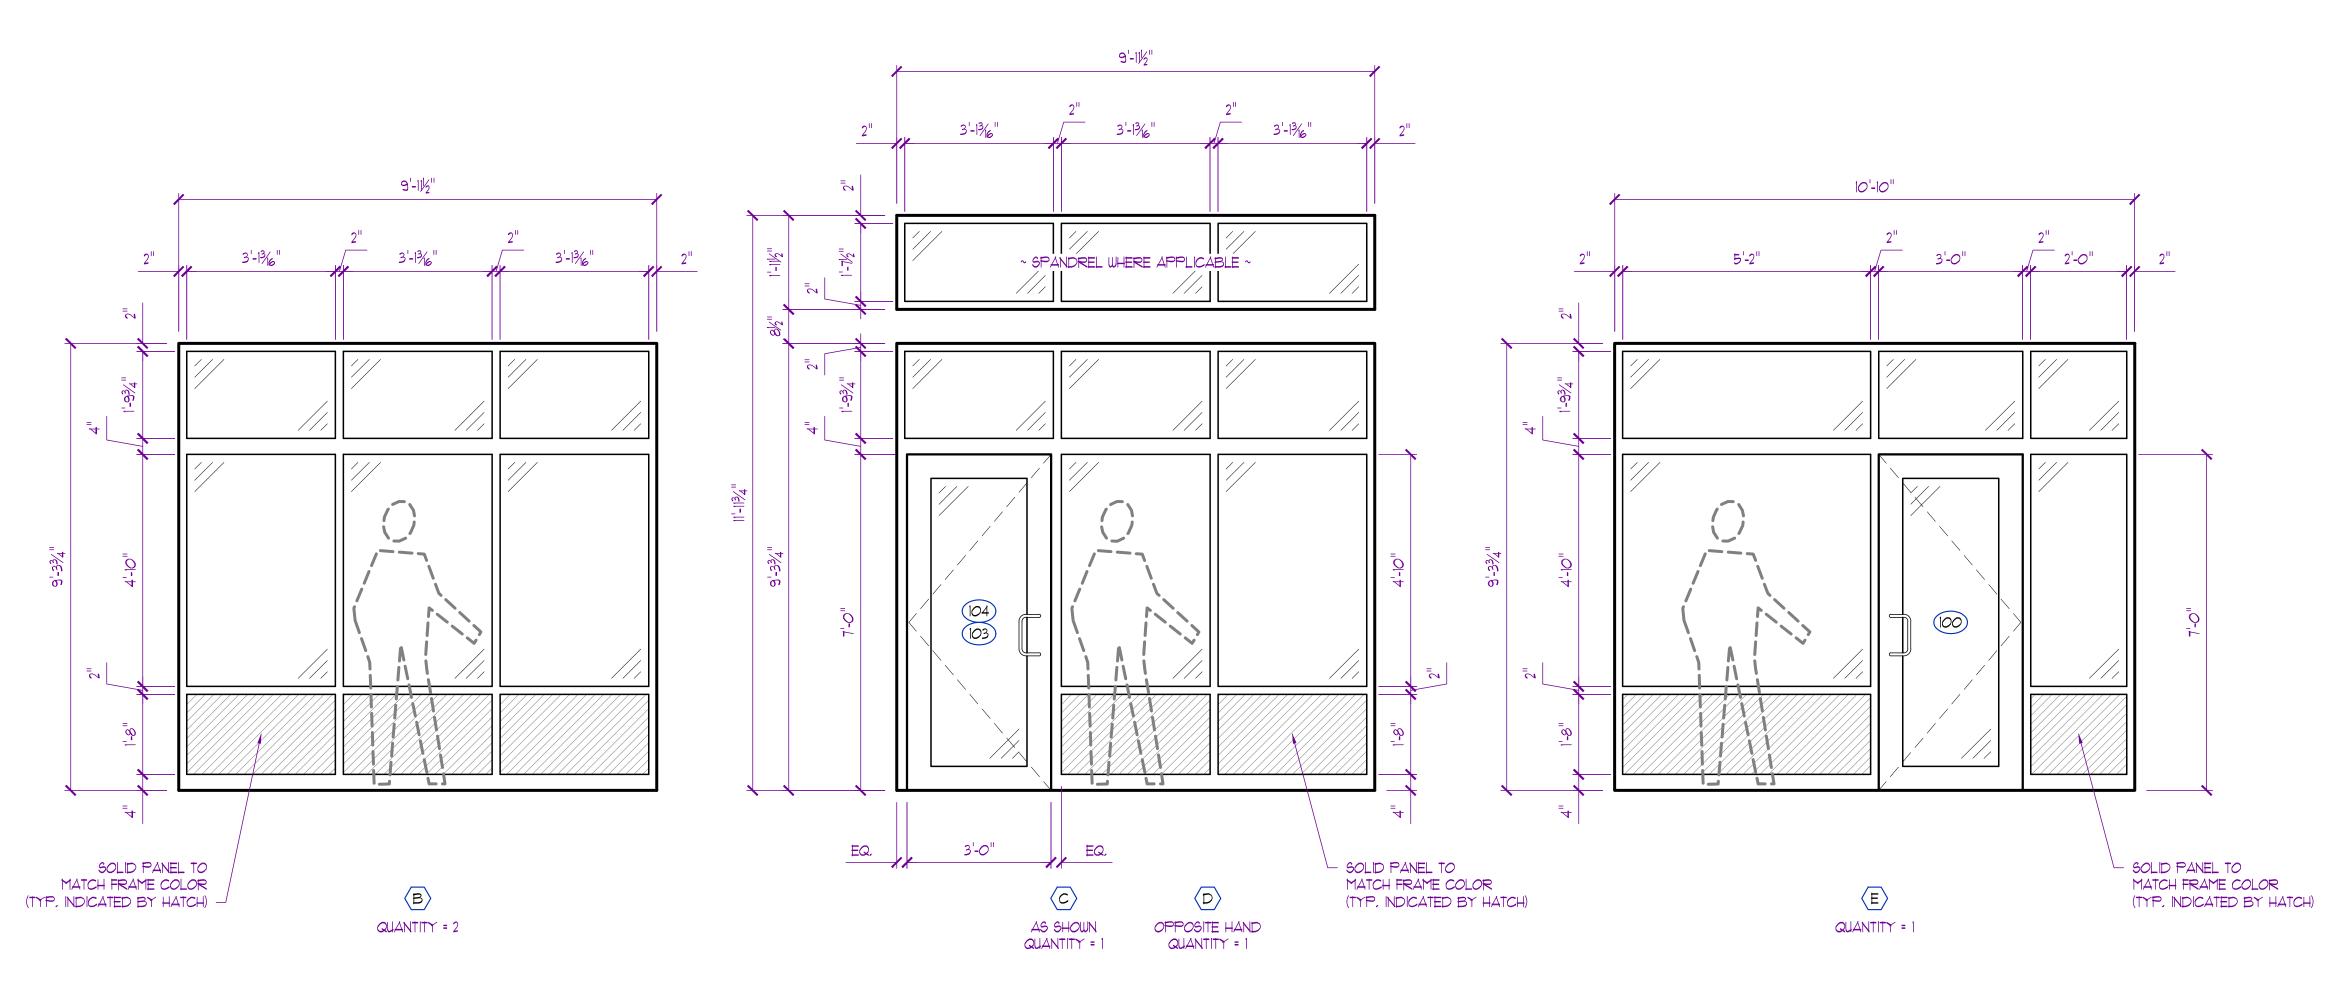

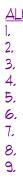

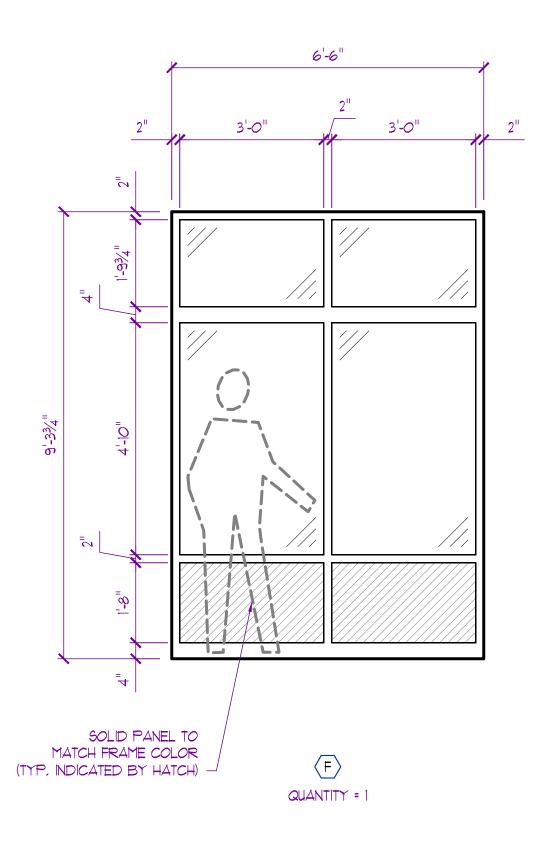

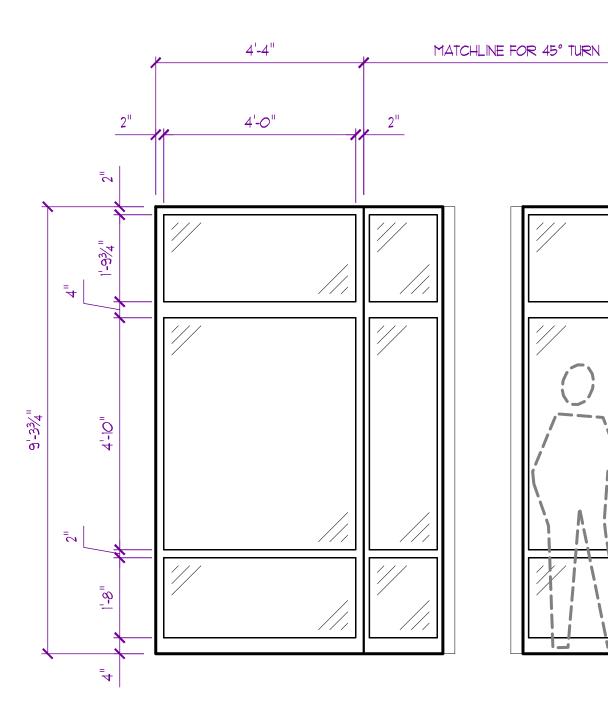

ALUMINUM STOREFRONT NOTES:

ALL ASSEMBLIES SHOWN ARE FROM EXTERIOR VIEW UNLESS NOTED OTHERWISE GENERAL CONTRACTOR TO FIELD VERIFY ALL DOOR / WINDOW ROUGH OPENINGS PRIOR TO FABRICATION


3. PROVIDE SEALANT AT JOINTS AND OPENINGS FOR WEATHER TIGHT INSTALLATION


4. ALL STOREFRONT ASSEMBLIES TO MEET U-FACTOR VALUES AS INDICATED IN BUILDING ENVELOPE REPORT 5. ALL STOREFRONT DOORS / WINDOWS, TRIM, ACCESSORIES, BREAK METAL, ETC. PROVIDED BY SAME MANUFACTURER


6. ALL STOREFRONT FRAMES TO BE DARK BRONZE OR EQUAL

7. ALL EXTERIOR GLAZING TO BE LOW E INSULATED GLASS W/ GRAY TINT (SAFETY GLASS WHERE INDICATED OR REQUIRED BY CODE)


8. ALL INTERIOR GLAZING TO BE 1/4" SINGLE PANE FLOAT GLASS (SAFETY GLASS WHERE INDICATED OR REQUIRED BY CODE) 9. SEE DOOR SCHEDULE ON SHEET A900 FOR REMAINING DOOR INFORMATION

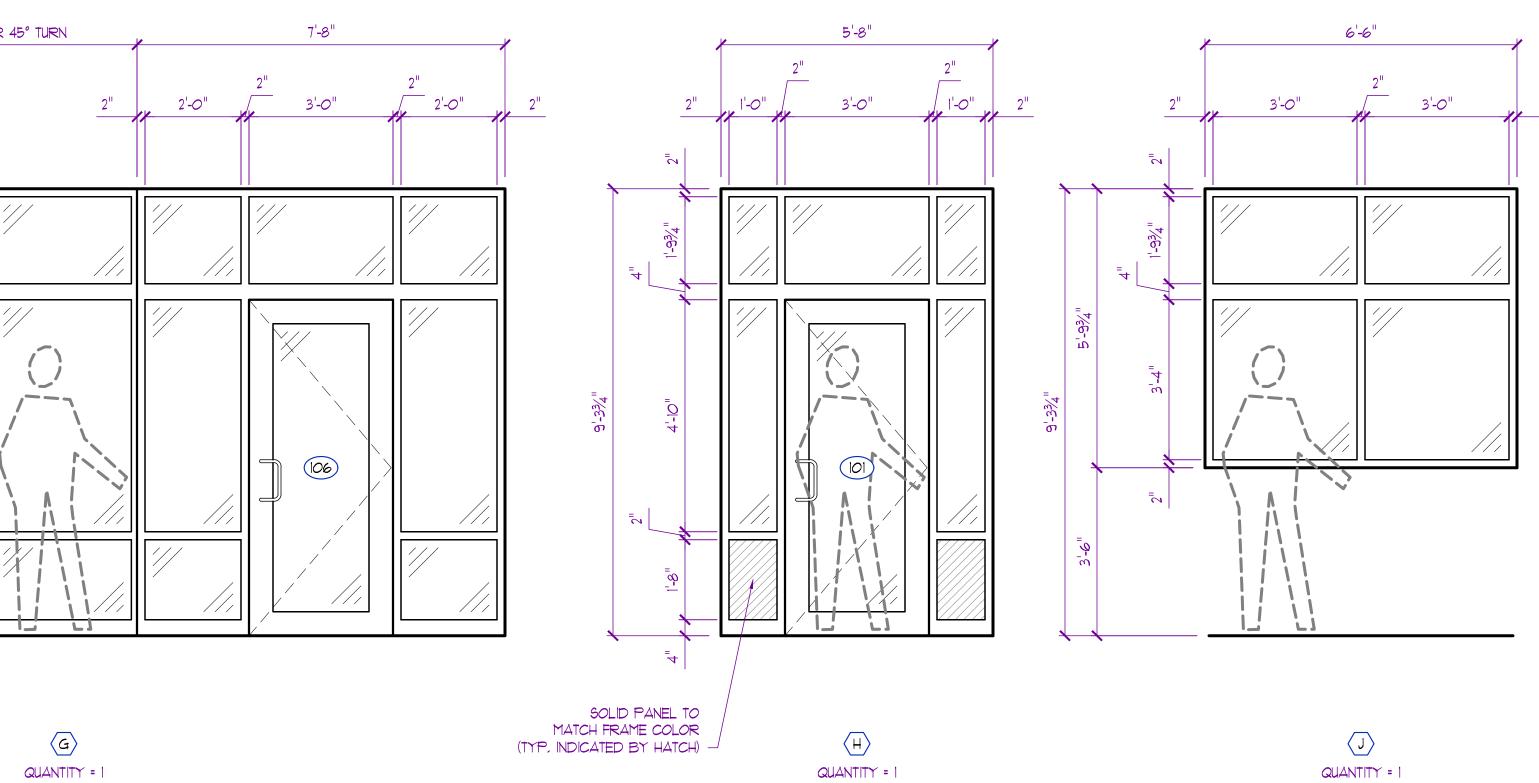

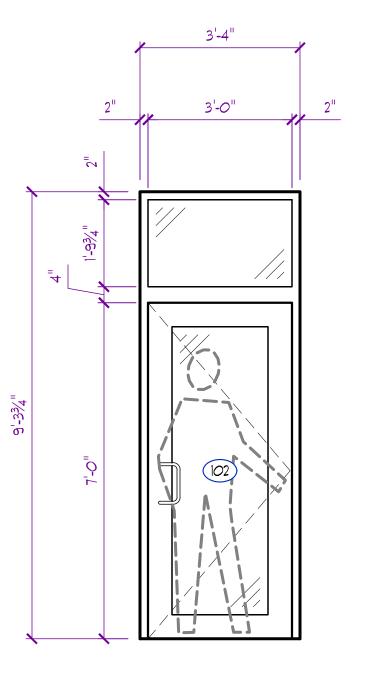


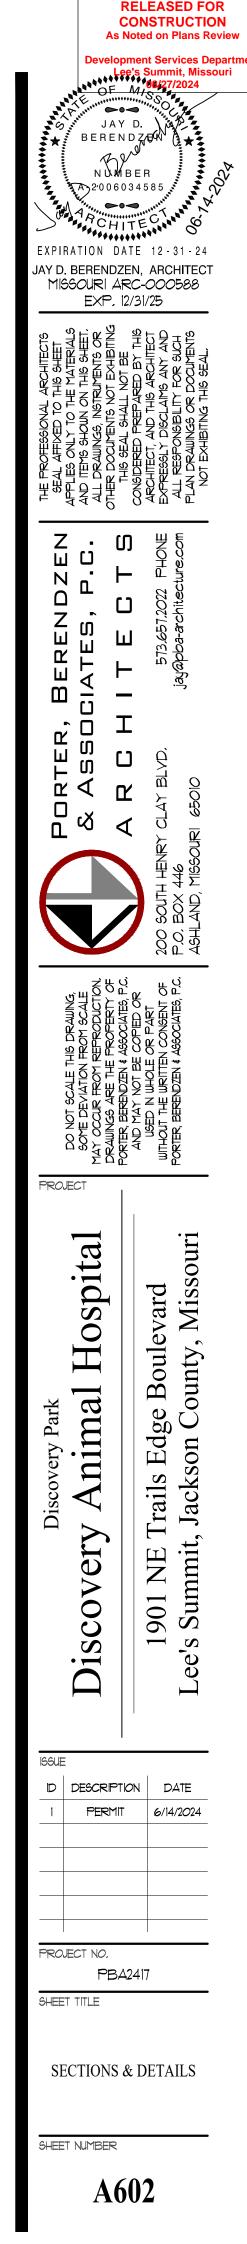

K QUANTITY = 1

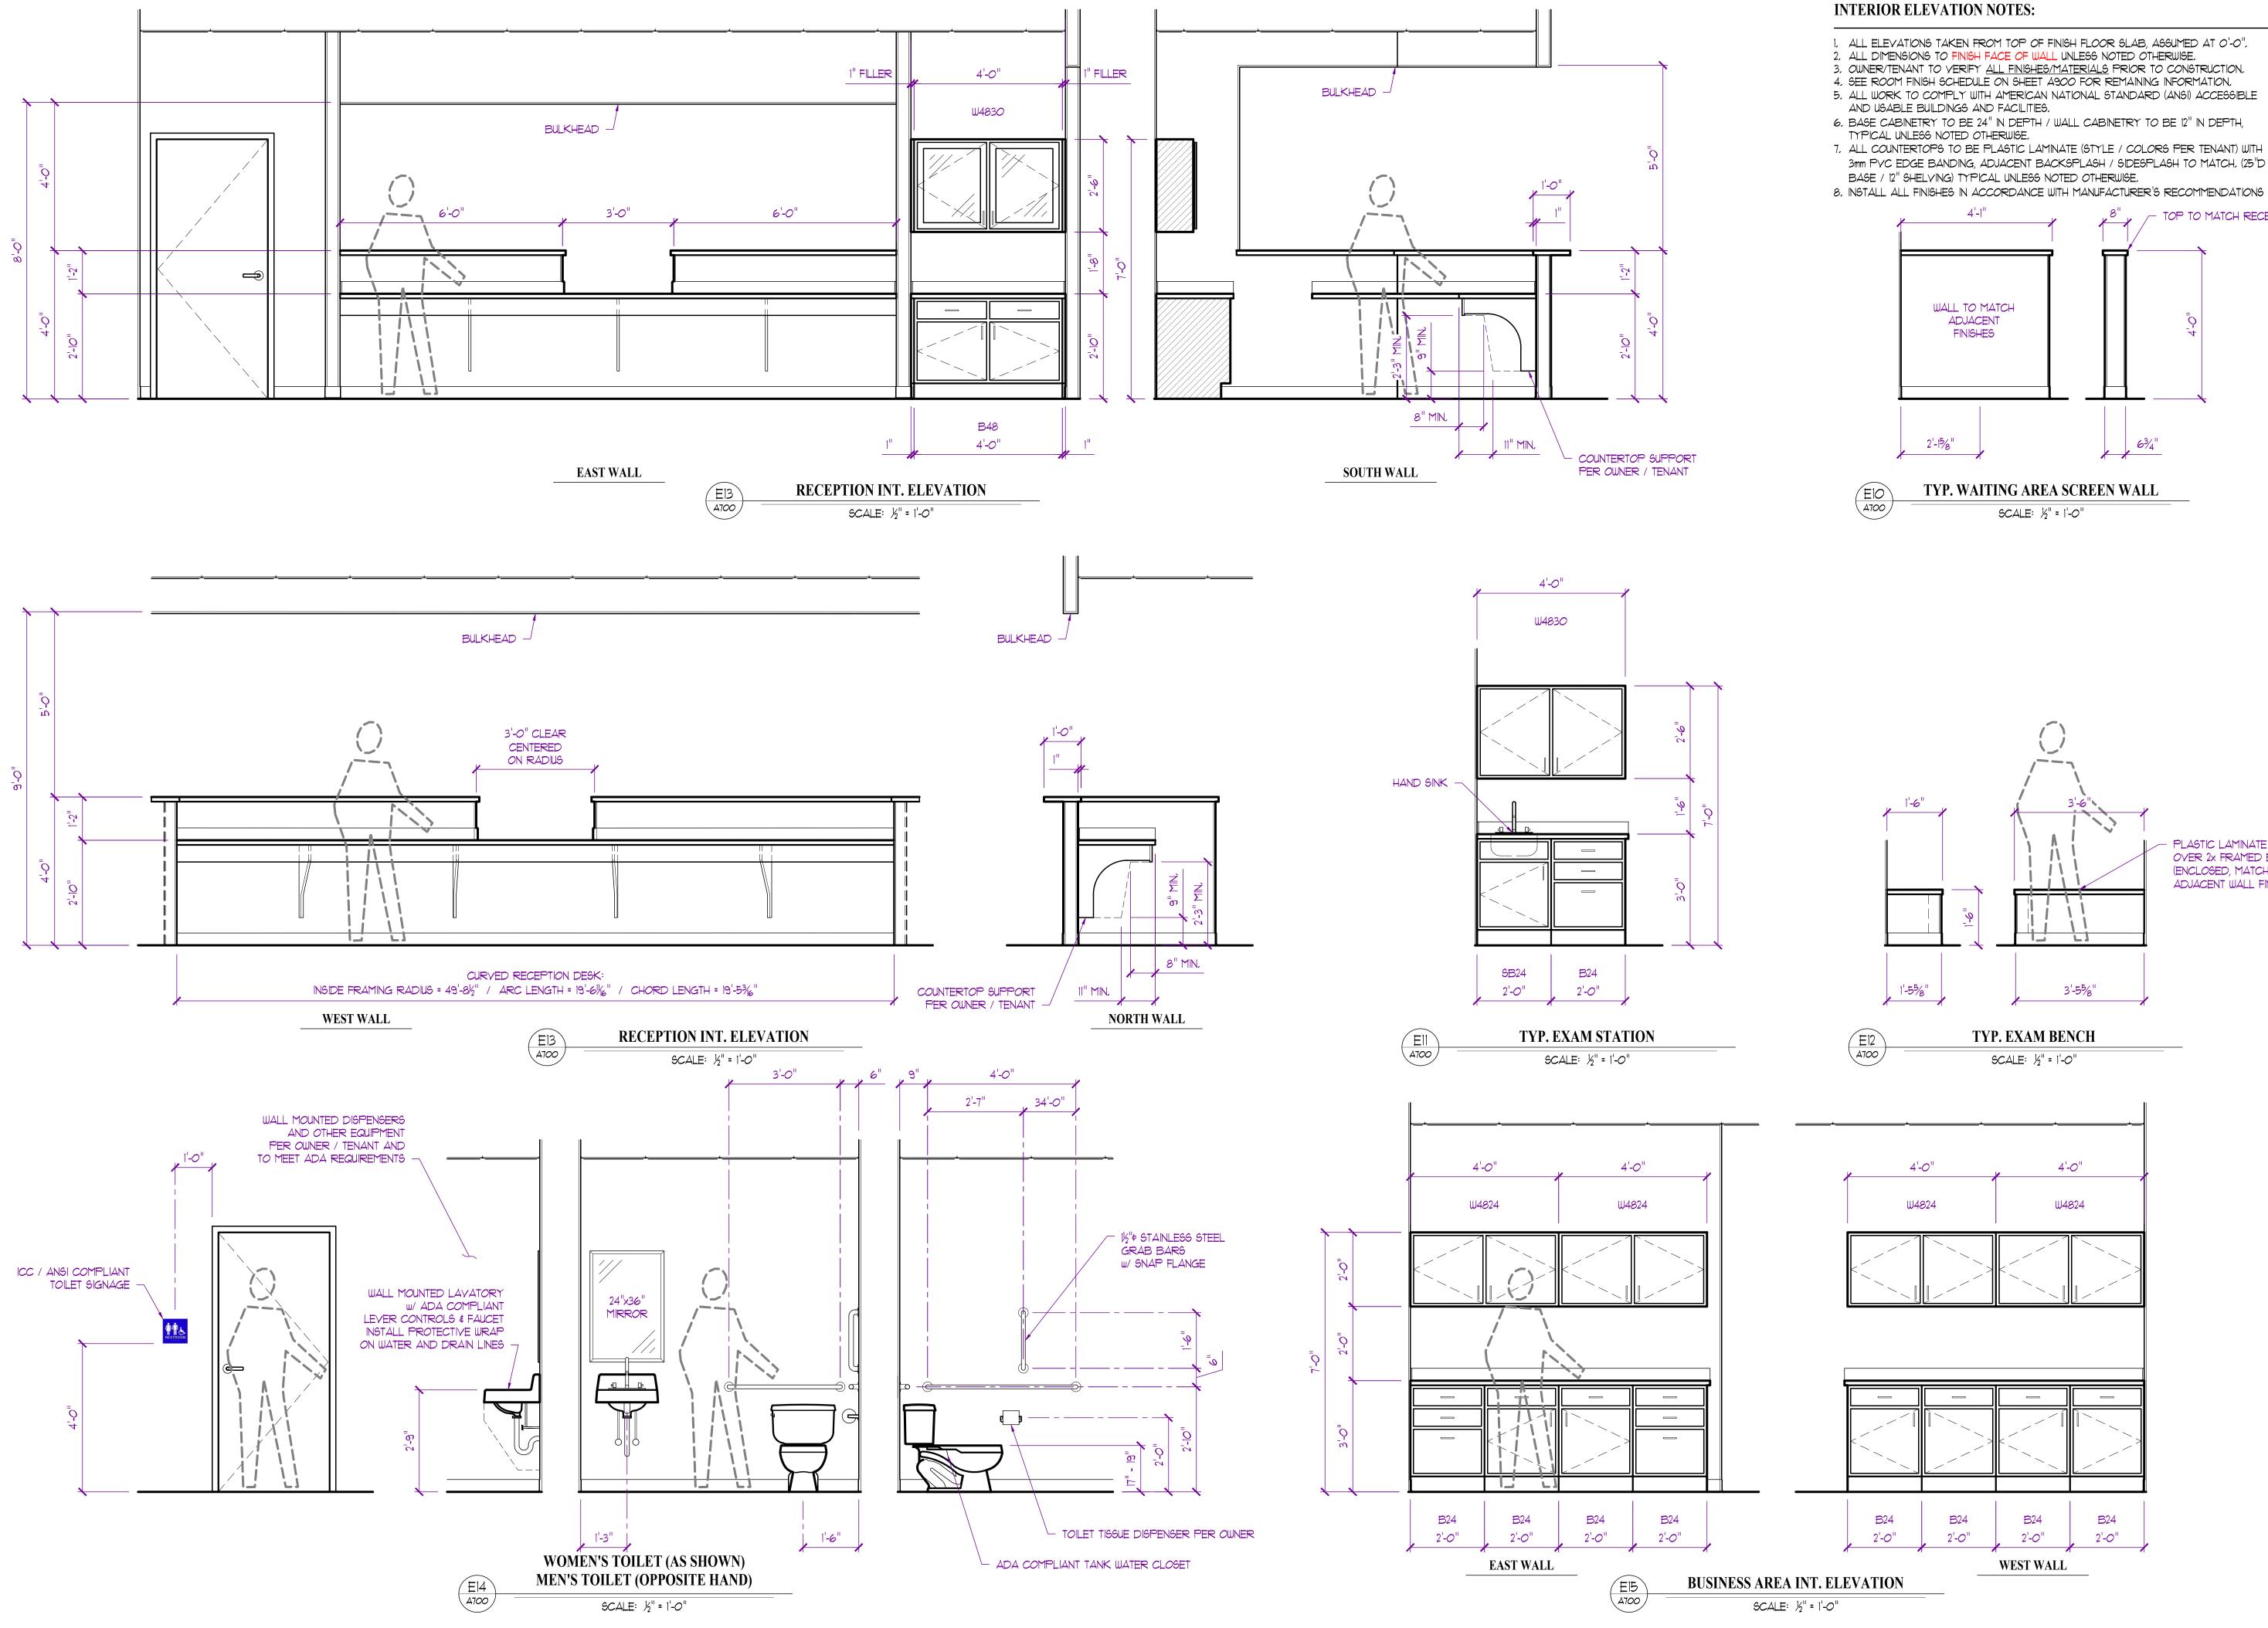


- 1. ALL ELEVATIONS TAKEN FROM TOP OF FINISH FLOOR SLAB, ASSUMED AT O'-O".
- 4, SEE ROOM FINISH SCHEDULE ON SHEET A900 FOR REMAINING INFORMATION, 5. ALL WORK TO COMPLY WITH AMERICAN NATIONAL STANDARD (ANSI) ACCESSIBLE
- 6. BASE CABINETRY TO BE 24" IN DEPTH / WALL CABINETRY TO BE 12" IN DEPTH,
- 7. ALL COUNTERTOPS TO BE PLASTIC LAMINATE (STYLE / COLORS PER TENANT) WITH 3mm PVC EDGE BANDING, ADJACENT BACKSPLASH / SIDESPLASH TO MATCH. (25"D

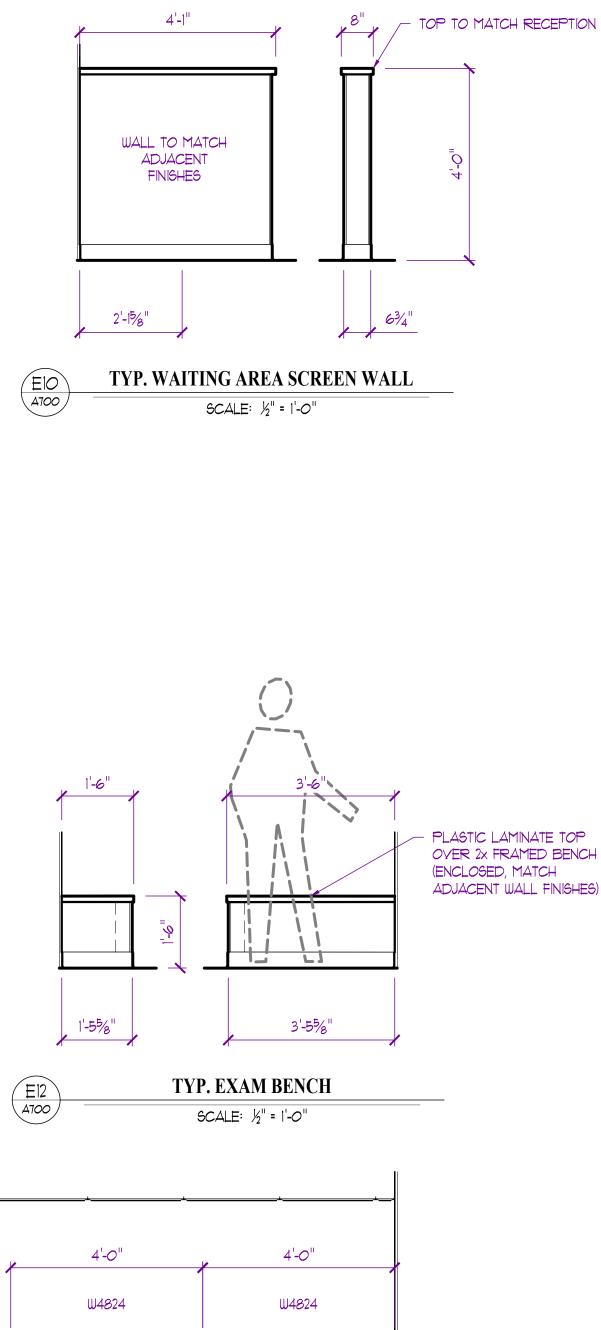



JAY D. BERENDZ/64 NÙMBER A 2'006034585 EXPIRATION DATE 12-31-24 JAY D. BERENDZEN, ARCHITECT MISSOURI ARC-000588 EXP, 12/31/25 Ŋ Шΰ Nn Δ ٢٦ Щ Л С О С ш E R A T E Ш ٢٦ TER, SSO C **₽** ₹ Ľ · لَمَ ا PROJECT 1901 NE Trails Edge Boulevard Lee's Summit, Jackson County, Missouri Hospital Animal പ overy Ð Discovery ISSUE ID DESCRIPTION DATE 6/14/2024 PERMIT PROJECT NO. PBA2417 SHEET TITLE INTERIOR ELEVATIONS SHEET NUMBER A700


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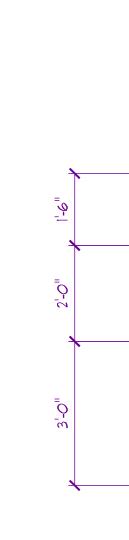
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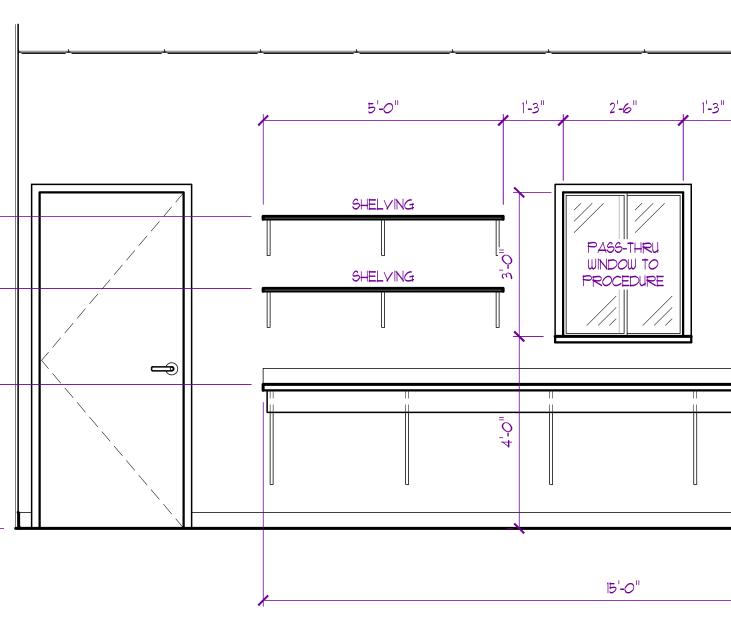




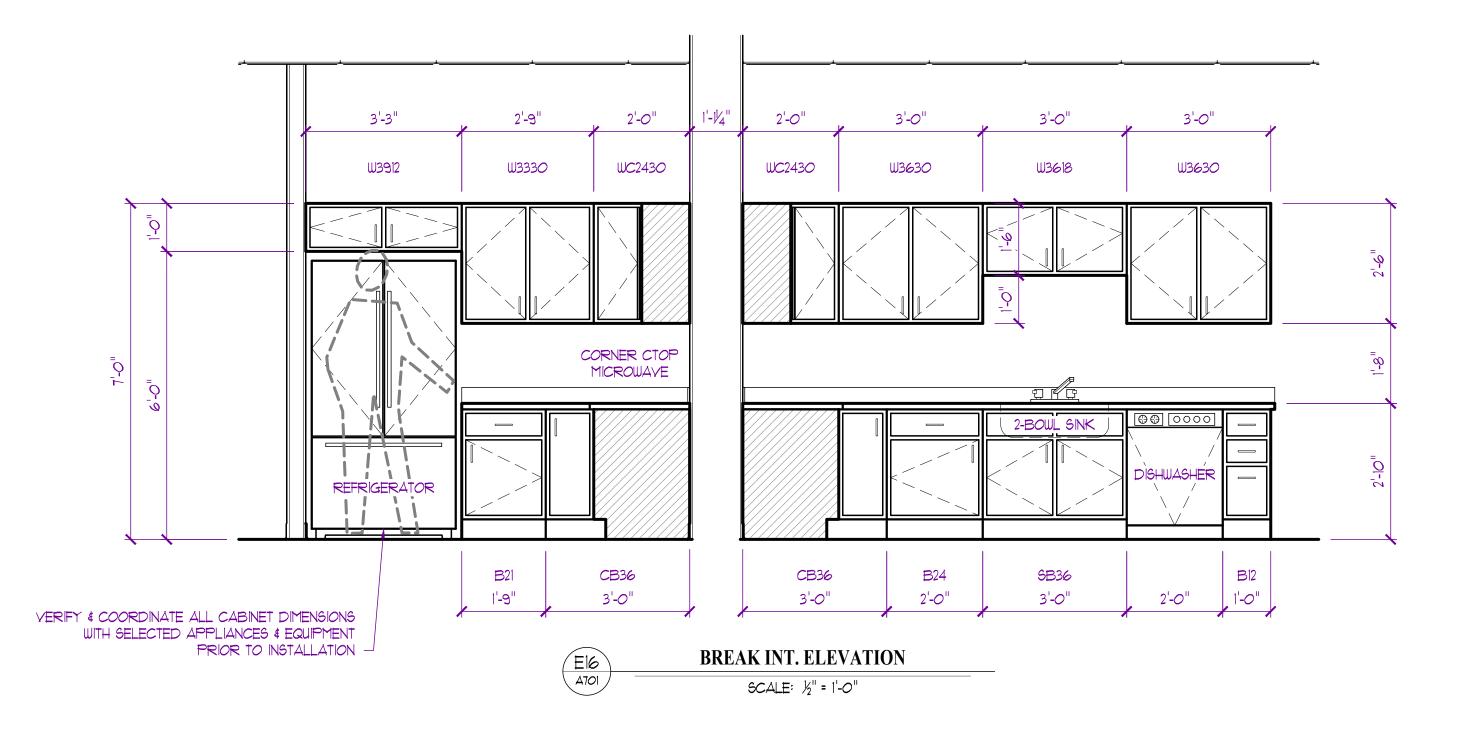


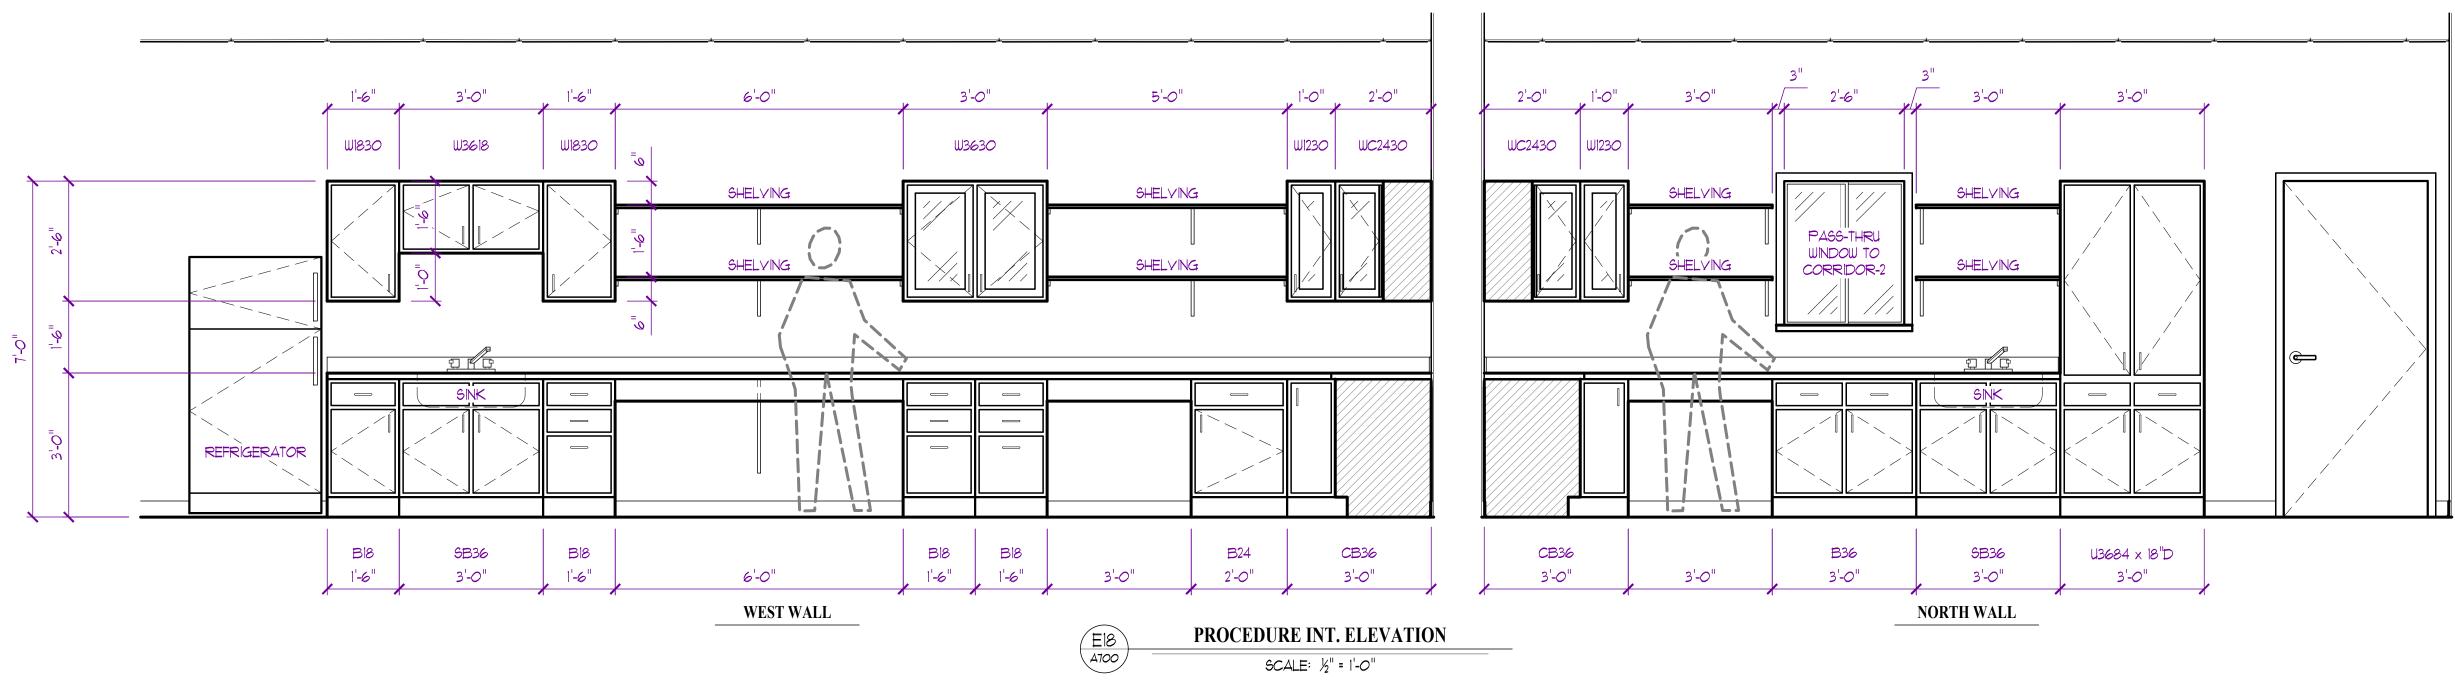

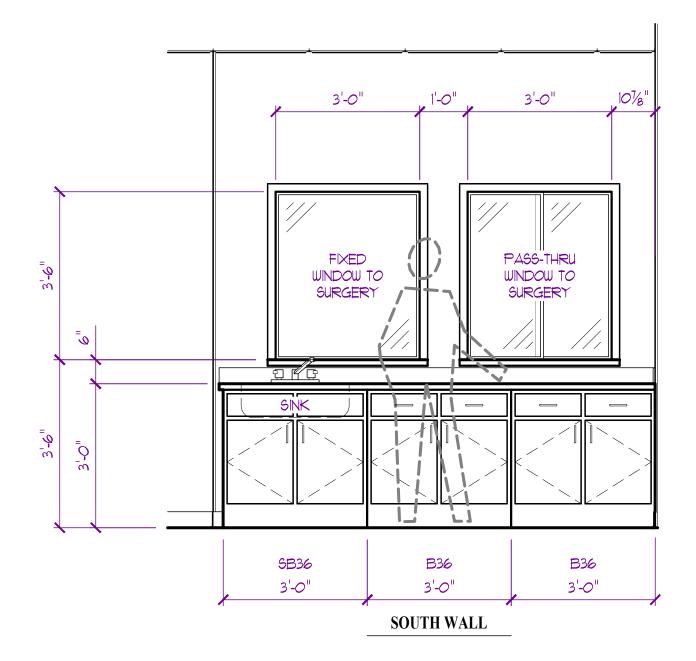


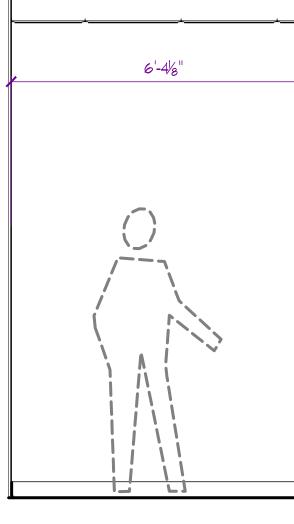




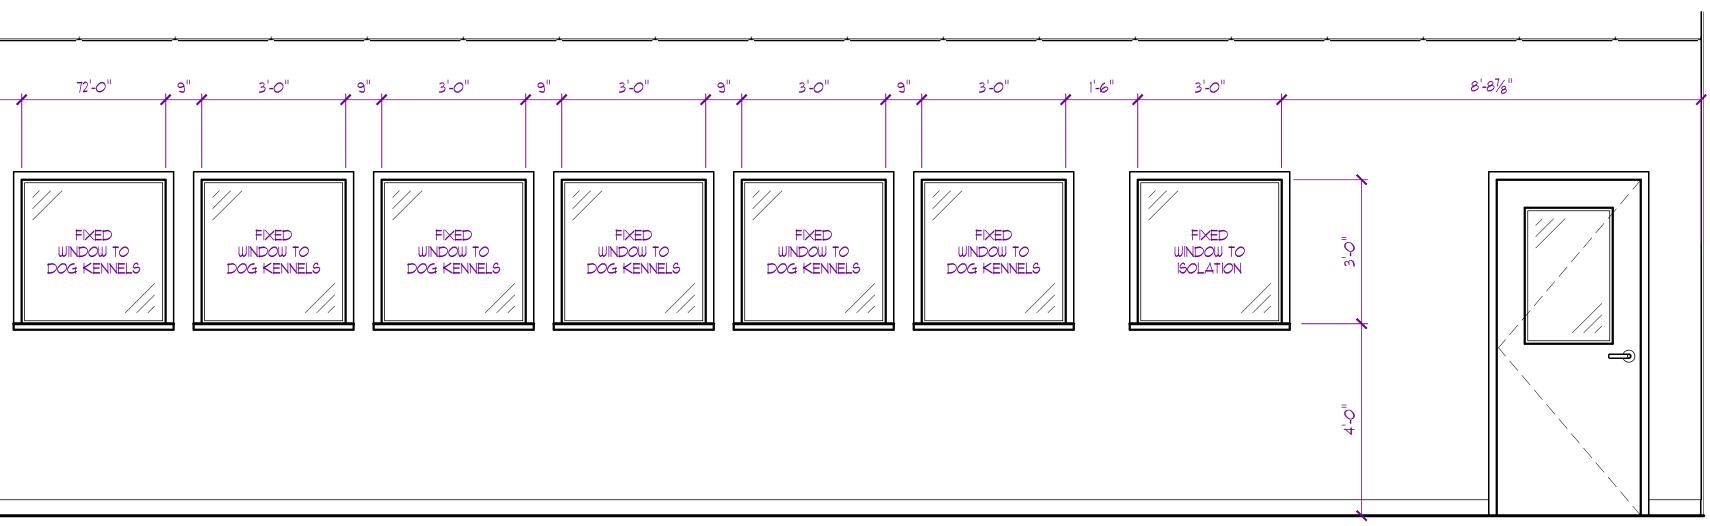



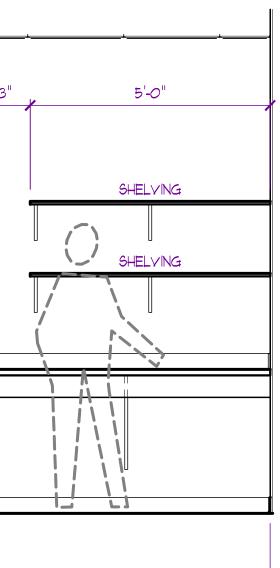

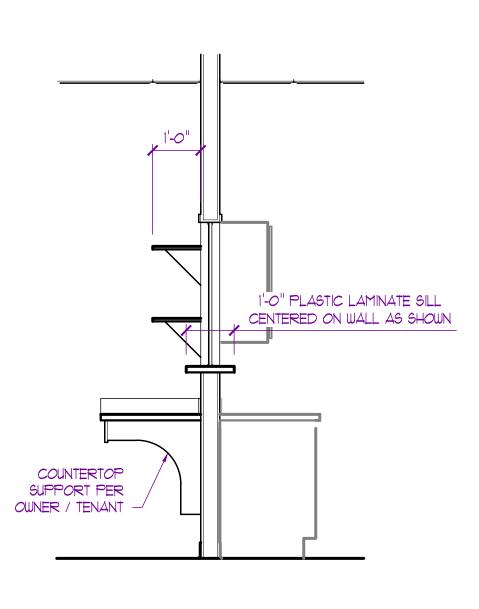





SCALE: ½" = 1'-0"

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	TE 12-31-24
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PORTER, BERENDZEN & Associates, p.c.	573.657.2022 PHONE Jay@pba-architecture.com
Porter, Berer & Associates	573.05 jay@pba-a
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DO NOT SCALE THIS DRAWING, SOME DEVIATION FROM SCALE MAY OCCUR FROM REPRODUCTION. DRAWINGS ARE THE PROPERTY OF PORTER PERFINJFN & ASSOCIATES P.C.	AND MAY NOT BE COPIED OR UBED N WHOLE OR PART WITHOUT THE WRITTEN CONSENT OF PORTER, BERENDZEN & ASSOCIATES, P.C.
PROJECT	
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Discovery Animal Hospital	1901 NE Trails Edge Boulevard Lee's Summit, Jackson County, Missouri
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Discovery Park 7 Anima	rails E Jackso
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ID DESCRIPTION	ON DATE 6/14/2024
PROJECT NO. PBA	.2417
SHEET TITLE	
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SHEET NUMBER	/01
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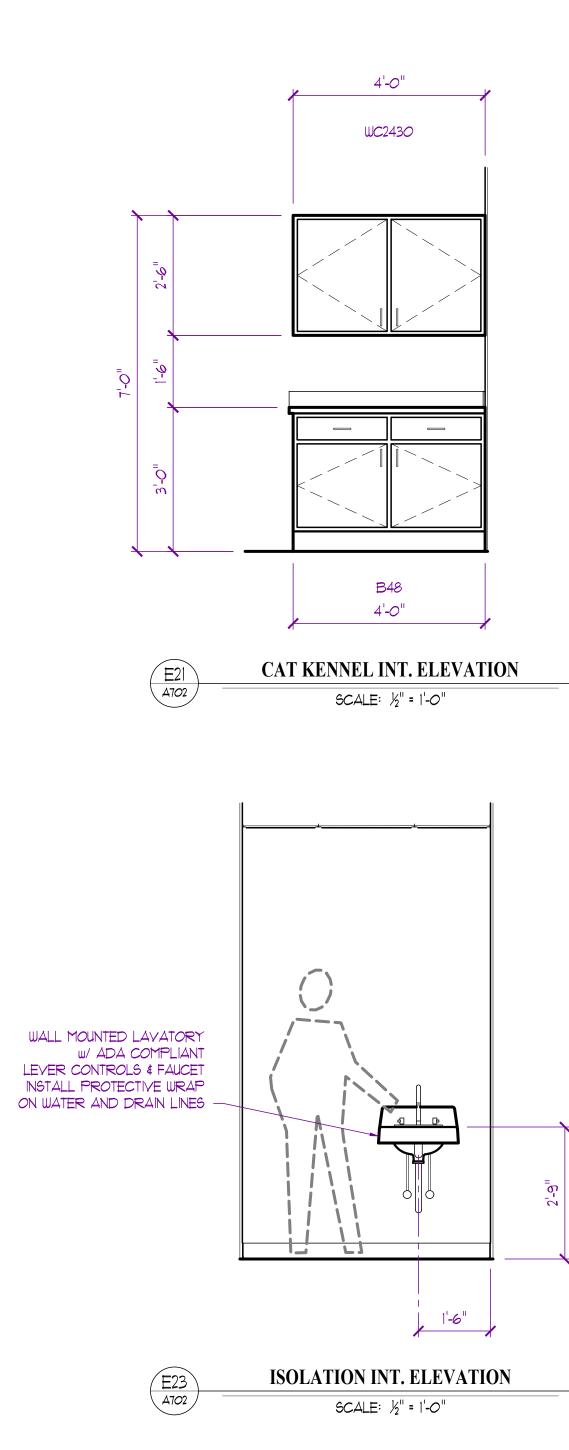


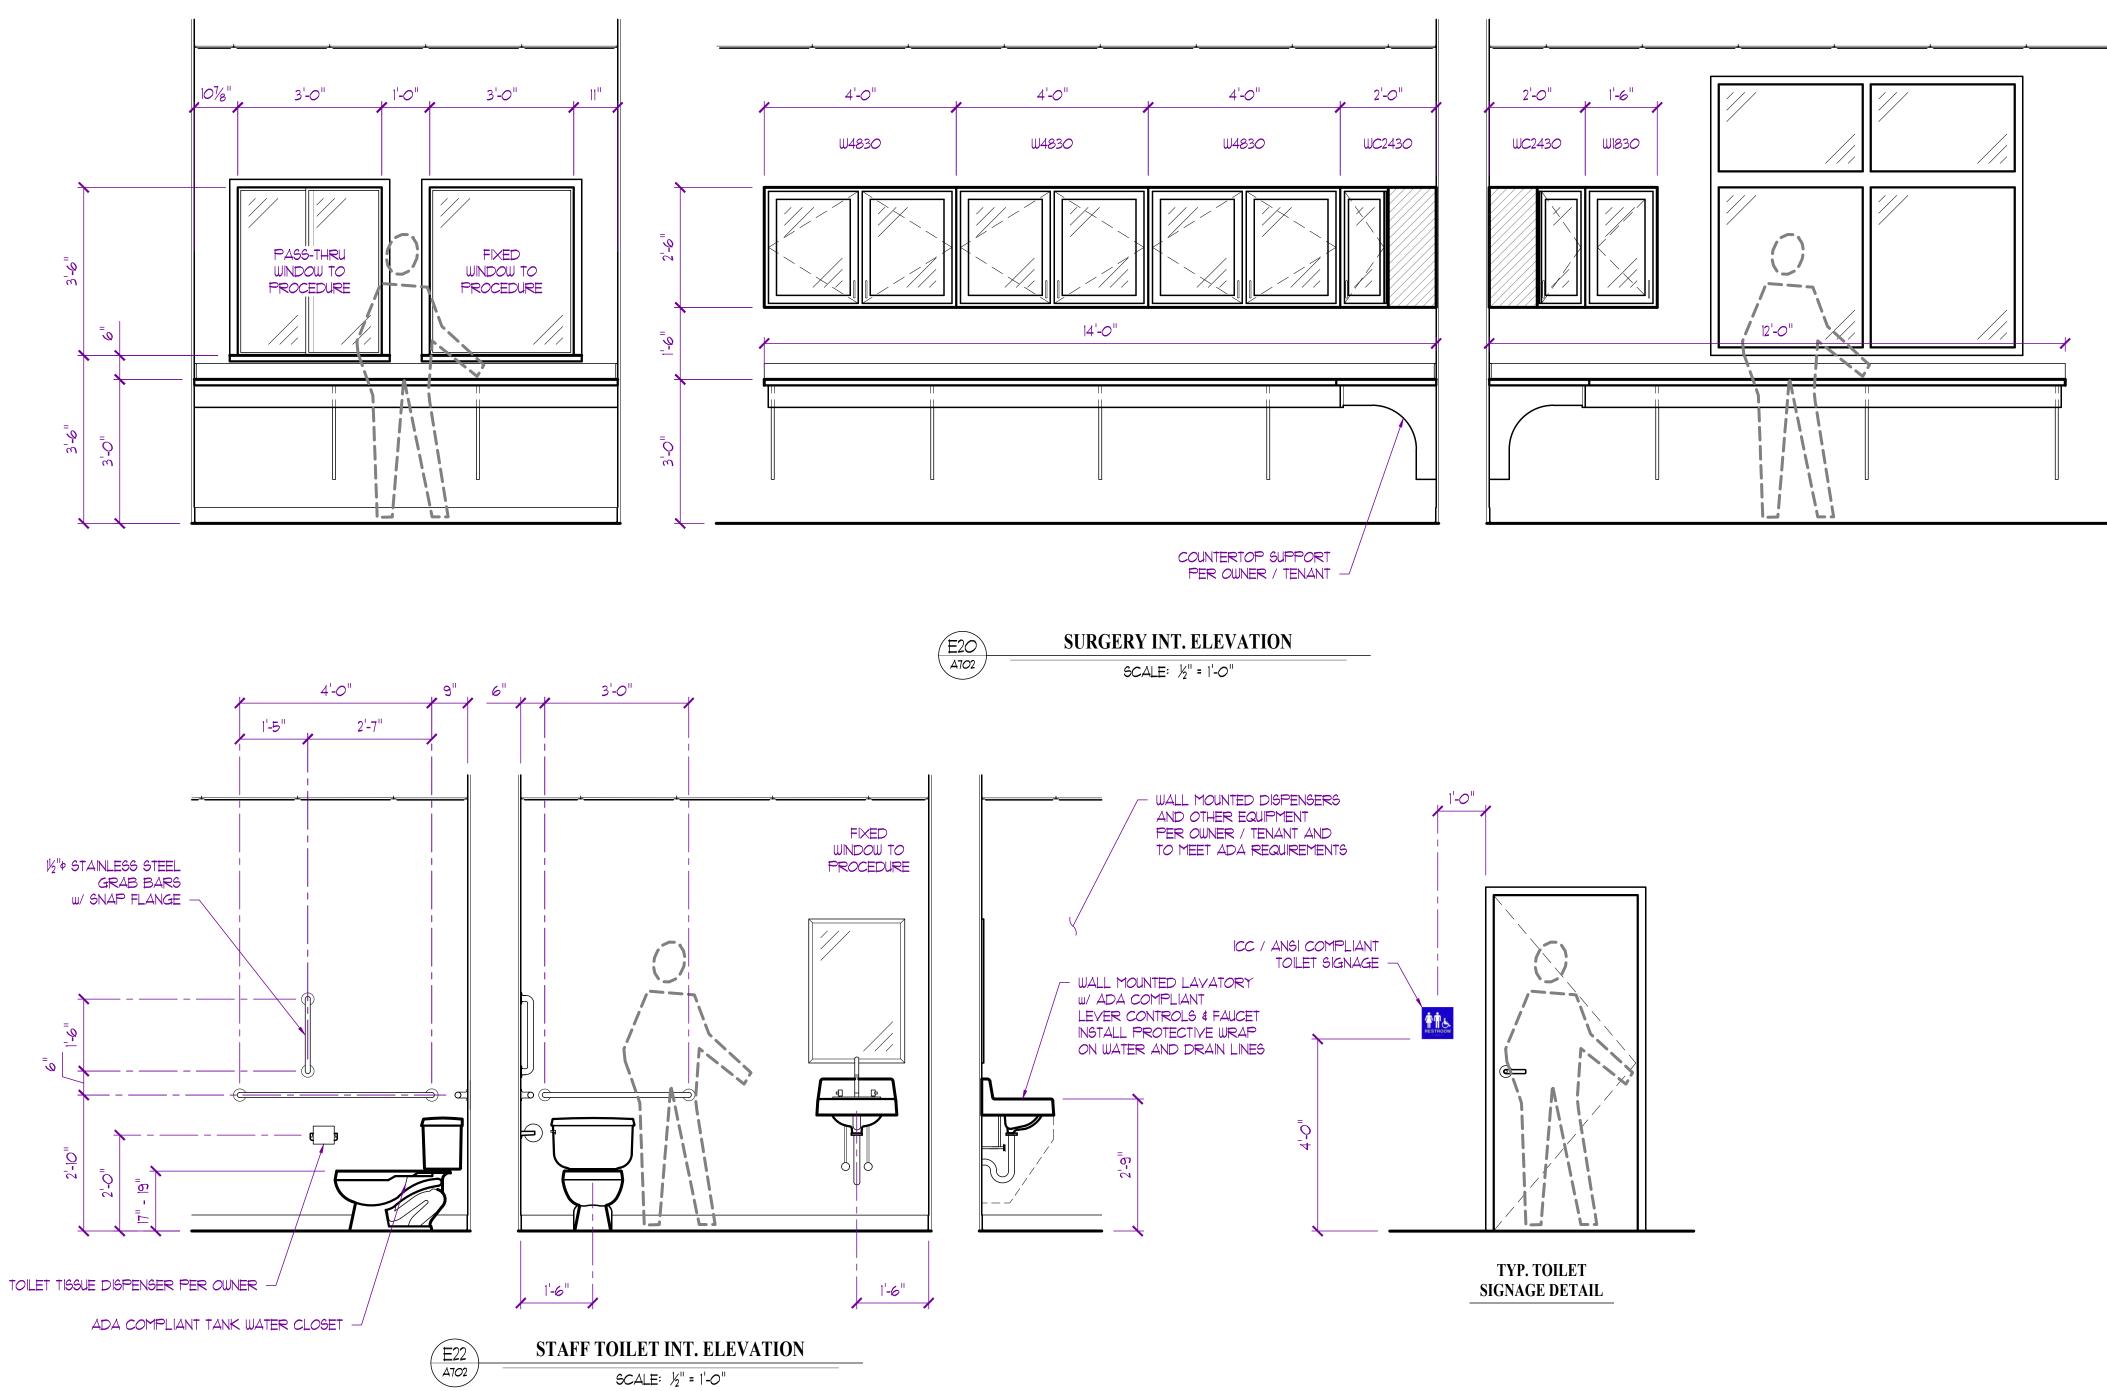


SCALE: ½" = 1'-0"

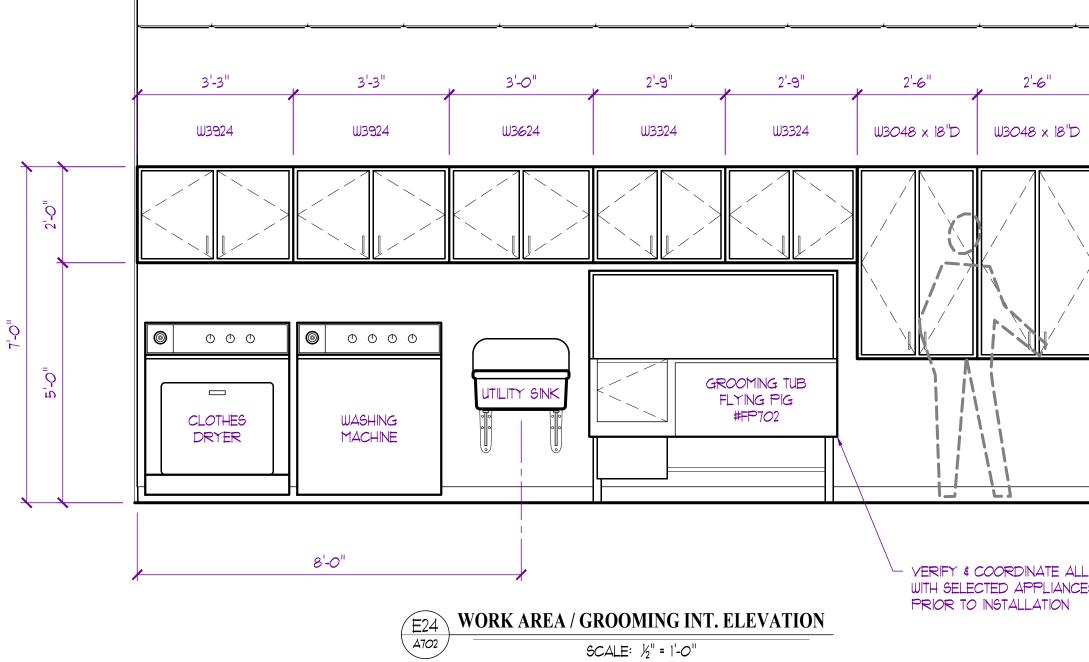
2'-6"

- VERIFY & COORDINATE ALL CABINET DIMENSIONS WITH SELECTED APPLIANCES & EQUIPMENT PRIOR TO INSTALLATION



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	DE JAY BEREN NUME A20060 9 CHI	BER 34585
	ERENDZE	EN, ARCHITECT RC-000588
THE PROFESSIONAL ARCHITECTS SEAL AFFIXED TO THIS SHEET APPLIES ONLY TO THE MATERIALS	AND ITEMS SHOWN ON THIS SHEET. ALL DRAWINGS, INSTRUMENTS OR OTHER DOCUMENTS NOT EXHIBITING THIS SEAL SHALL NOT BE	CONSIDERED PREPARED BY THIS ARCHITECT, AND THIS ARCHITECT EXPRESSLY DISCLAIMS ANY AND ALL RESPONSIBILITY FOR SUCH PLAN DRAWINGS OR DOCUMENTS NOT EXHIBITING THIS SEAL.
PORTER, BERENDZEN	& Associates, P.C.	573.657.2022 PHONE Jay@pba-architecture.com
PORTE		200 SOUTH HENRY CLAY BLVD. P.O. BOX 446 ASHLAND, MISSOURI (S5010
DRAWING,	M SCALE RODUCTION. COPERTY OF SOCIATES, P.C.	
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	Discovery Animal Hospital	1901 NE Trails Edge Boulevard Lee's Summit, Jackson County, Missouri
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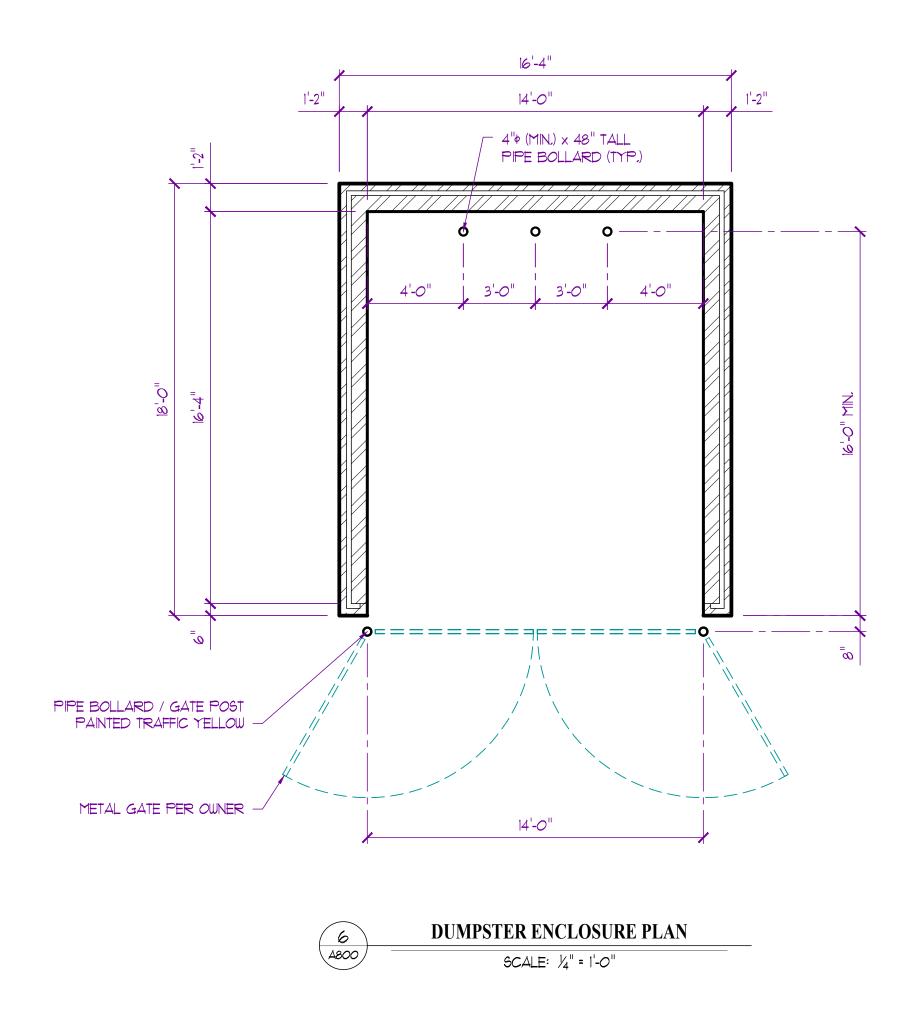


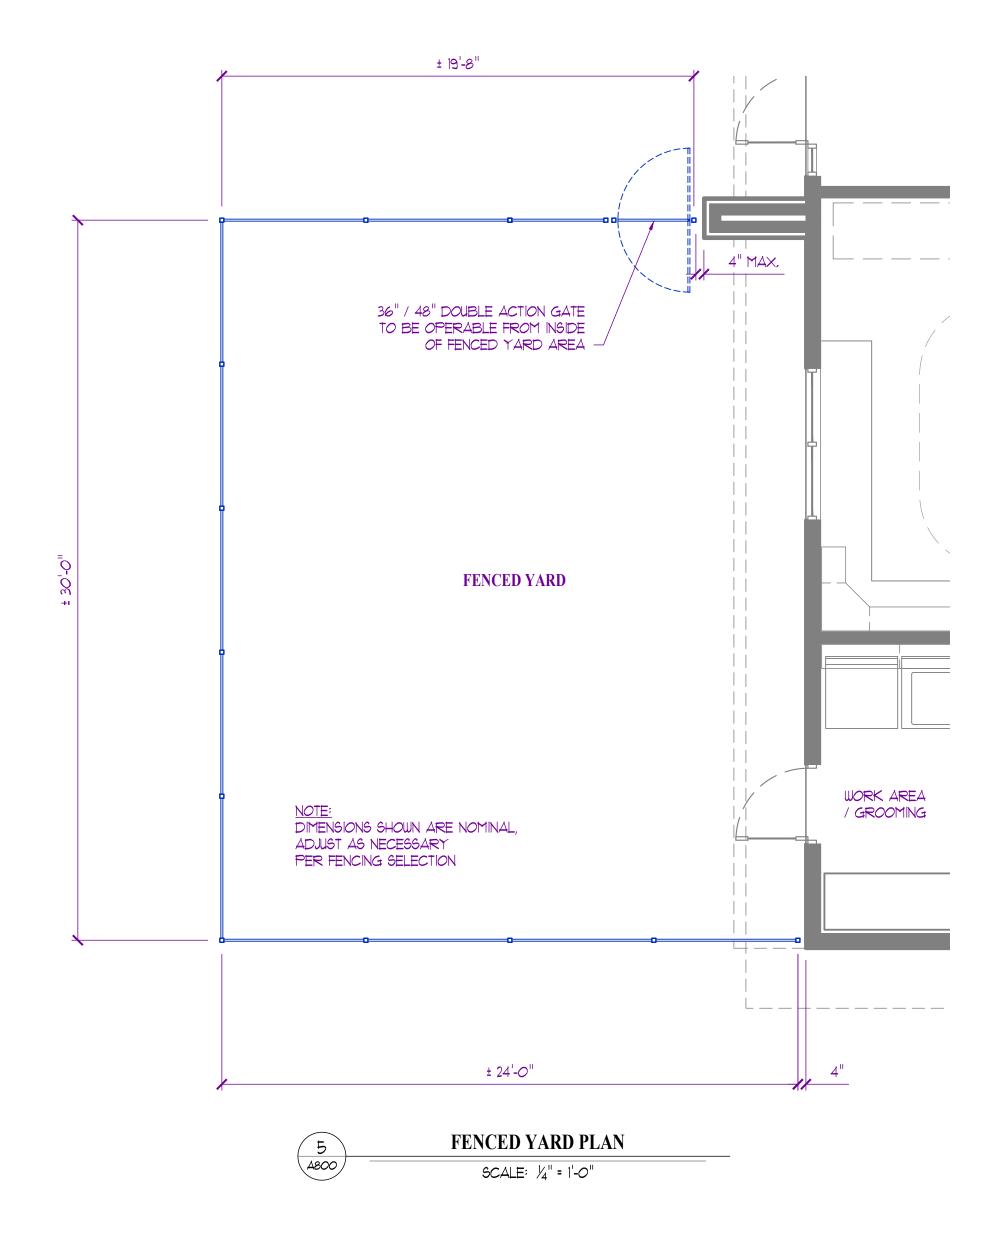- PRE-MANUFACTURED ALUMINUM FENCE PANEL & POSTS (BLACK)

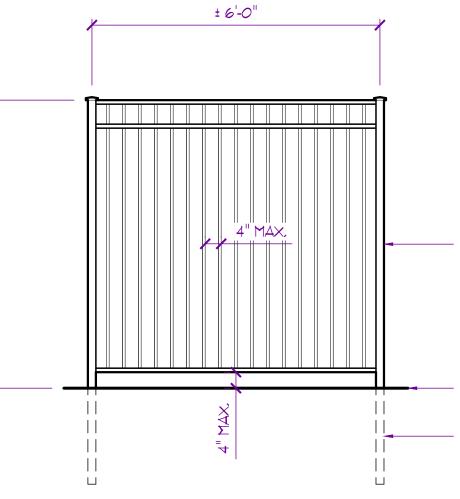- FINISH GRADE ELEVATION

- POST SUPPORT / ANCHOR PER MANUFACTURER RECOMMENDATIONS


TYP. FENCE PANEL



"O-'9



 FOR REFERENCE ONLY. REFER TO CIVIL DRAWINGS FOR LOCATIONS
 ALL MATERIALS & FINISHES TO BE SELECTED AND APPROVED BY OWNER / TENANT PRIOR TO ANY WORK

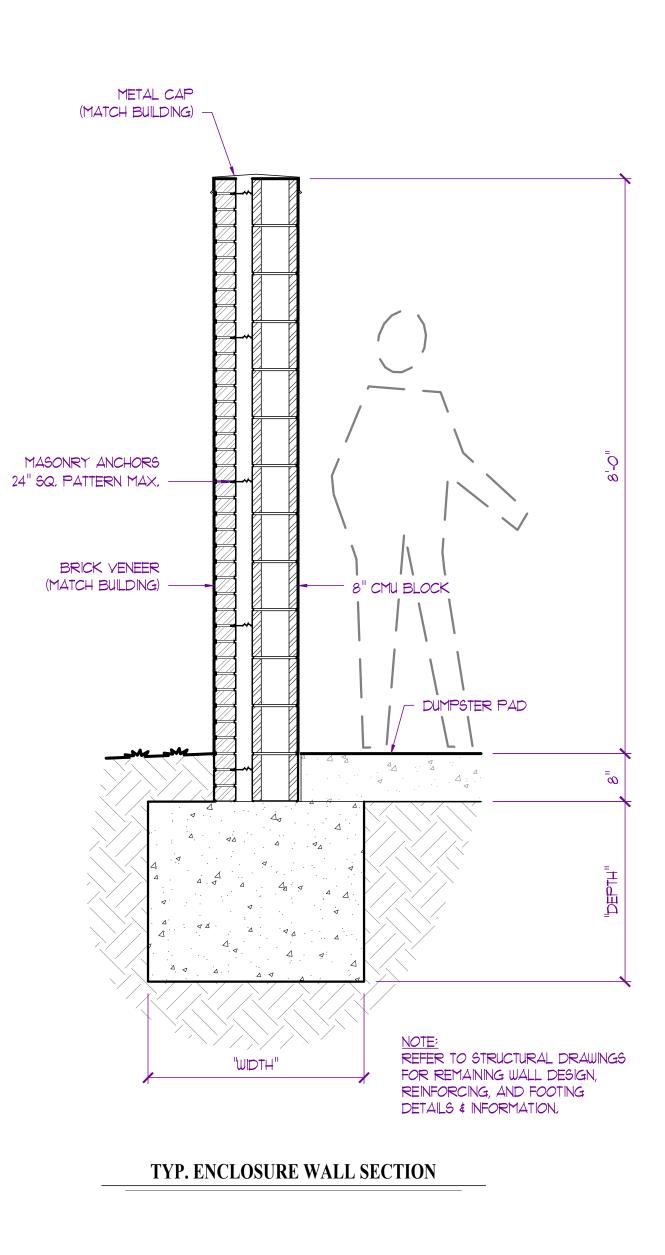

	RELEASED FOR CONSTRUCTION As Noted on Plans Review lopment Services Department Lee's Summit, Missouri
EXPIRATION JAY D. BEREN MISSOURI EXF	E M 68/27/2024 AY D. ENDZEW BER 06034585 HITEC DATE 12 31 24 DATE 12 31 24 DZEN, ARCHITECT ARC-000588 2. 12/31/25 BELLEN DATE 12 31 24 DZEN, ARCHITECT ARC-000588
THE PROFESSIONAL ARCHITECTS SEAL AFFIXED TO THIS SHEET APPLES ONLY TO THE MATERIALS AND ITEMS SHOWN ON THIS SHEET ALL DRAWINGS, INSTRUMENTS OR	CITHER DOCUTENTS NOT EXHBUTING THIS SEAL SHALL NOT BE CONSIDERED PREPARED BY THIS ARCHITECT, AND THIS ARCHITECT EXPRESSLY DISCLAINS ANY AND ALL RESPONSIBILITY FOR SUCH PLAN DRAUINGS OR DOCUMENTS NOT EXHIBITING THIS SEAL.
PORTER, BERENDZEN & Associates, p.c.	A R C H I T E C T S r CLAY BLVD. 573.657.2022 PHONE jay@pba-architecture.com RI 65010
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Discovery Park Discovery Animal Hospital	1901 NE Trails Edge Boulevard Lee's Summit, Jackson County, Missouri
IBGUE ID DESCRI 1 PER	
PROJECT NO. PROJECT NO. PROJECT NO.	BA2417
SITE	DETAILS
A	800

				ROC	DM FIN	ISH SC	HEDU	L.E		
	ROOM	FLOC	ORING		WA	LLS		CEIL	INGS	
No.	NAME	TYPE	BASE	NORTH	EAST	SOUTH	WEST	FINISH	HT.	
100	ENTRY VESTIBULE	SSC-1	B-1	PGB-1	PGB-1	PGB-1	PGB-1	ACT-1	9'-11"	
101	RETAIL	SSC-1	B-1	PGB-1	PGB-1	PGB-1	PGB-1	ACT-1	12'-1"	
102	RECEPTION	SSC-1	B-1	PGB-1	PGB-1	PGB-1	PGB-1	ACT-1	9'-11"	
103	WAITING	SSC-1	B-1	PGB-1	PGB-1	PGB-1	PGB-1	ACT-1	12'-1"	
104	JANITOR	SSC-1	B-1	PGB-E	PGB-E	PGB-E	PGB-E	ACT-1	9'-0"	
105	EXAM-1	SSC-1	B-1	PGB-1	PGB-1	PGB-1	PGB-1	ACT-1	9'-11"	
106	EXAM-2	SSC-1	B-1	PGB-1	PGB-1	PGB-1	PGB-1	ACT-1	9'-11"	
107	EXAM-3	SSC-1	B-1	PGB-1	PGB-1	PGB-1	PGB-1	ACT-1	9'-11"	
108	WOMEN'S TOILET	SSC-1	B-1	PGB-E	PGB-E	PGB-E	PGB-E	ACT-1	9'-0"	
109	MEN'S TOILET	SSC-1	B-1	PGB-E	PGB-E	PGB-E	PGB-E	ACT-1	9'-0"	
110	CORRIDOR-1	SSC-1	B-1	PGB-1	PGB-1	PGB-1	PGB-1	ACT-1	9'-11"	
111	EXIT VESTIBULE	SSC-1	B-1	PGB-1	PGB-1	PGB-1	PGB-1	ACT-1	9'-11"	
112	OPEN OFFICE	LVT-1	B-1	PGB-1	PGB-1	PGB-1	PGB-1	ACT-1	9'-11"	
113	MECH. / STORAGE	SC-1	B-1	PGB-1	PGB-1	PGB-1	PGB-1			
114	OFFICE	LVT-1	B-1	PGB-1	PGB-1	PGB-1	PGB-1	ACT-1	9'-11"	
115	BREAK	LVT-1	B-1	PGB-1	PGB-1	PGB-1	PGB-1	ACT-1	12'-1"	
116	STORAGE / MECH.	SC-1	B-1	PGB-1	PGB-1	PGB-1	PGB-1	ACT-1	9'-11"	
117	BEREAVE. / CAT RM.	SSC-1	B-1	PGB-1	PGB-1	PGB-1	PGB-1	ACT-1	9'-11"	
118	CORRIDOR-2	SSC-1	B-1	PGB-1	PGB-1	PGB-1	PGB-1	ACT-1	9'-11"	
119	RUN BACK / X-RAY	SSC-1	B-1	PGB-1	PGB-1	PGB-1	PGB-1	ACT-1	9'-11"	
120	ULTRASOUND / CAT RM.	CPT-1	B-1	PGB-1	PGB-1	PGB-1	PGB-1	ACT-1	9'-11"	
121	PROCEDURE / PREP	SVF-1	B-2	PGB-1	PGB-1	PGB-1	PGB-1	ACT-1	9'-11"	FF
122	SURGERY	SVF-1	B-2	PGB-1	PGB-1	PGB-1	PGB-1	ACT-1	9'-11"	FF
123	CORRIDOR-3	SSC-1	B-1	PGB-1	PGB-1	PGB-1	PGB-1	ACT-1	9'-11"	
124	STAFF TOILET	SSC-1	B-1	PGB-E	PGB-E	PGB-E	PGB-E	ACT-1	9'-0"	_
125	CAT KENNELS	SSC-1	B-1	PGB-1	PGB-1	PGB-1	PGB-1	ACT-1	9'-11"	
126	DOG KENNELS	SSC-1	B-1	PGB-1	PGB-1	PGB-1	PGB-1	ACT-1	9'-11"	FR
127	ISOLATION	SSC-1	B-1	PGB-1	PGB-1	PGB-1	PGB-1	ACT-1	9'-0"	FF
128	WORK / GROOMING	SSC-1	B-1	PGB-1	PGB-1	PGB-1	PGB-1	ACT-1	9'-11"	FF
150	RISER / MECH.	EXST	B-1	PGB-1	PGB-1	PGB-1	PGB-1			
LEGENI EXST SC-1 SSC-1 LVT-1 B-1 B-2	D: FLOORING Existing Flooring to Remain Sealed Concrete Floor Stained & Sealed Concrete F Luxury Vinyl Tile Wall Base Wall Base	4" Vinyl Bas		Base for Seam	iless Vinyl	EXST PGB-1 PGB-E FRP-1	Painted G Painted G Fiberglass	to Remain Crysum Board Typsum Board Reinforced P	Epoxy Base	ed in
CRNR	Corner Guard					ACT-1 PGB-10		il Tile & Grid iyp. Board	24x24 Teg Color per C	

<u>NOTE:</u> SCHEDULES ARE FOR REFERENCE ONLY. <u>ALL</u> FINISHES, COLORS, MATERIALS, SPECIES, HARDWARE, ETC. TO BE SELECTED AND/OR APPROVED BY OWNER/TENANT PRIOR TO CONSTRUCTION.

•	REMARKS	
1"		
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24	NO CEILING, EXPOSED TO LID ABOVE	
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1"	FRP-1 APPLIED TO ALL WALLS w/o CABINET	
1"	FRP-1 APPLIED TO ALL WALLS w/o CABINET	
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1" "	FRP-1 APPLIED TO ALL WALLS w/o CABINET	
1"	FRP-1 APPLIED TO ALL WALLS w/o CABINET FRP-1 APPLIED TO ALL WALLS w/o CABINET	
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	NO CEILING, EXPOSED TO LID ABOVE	
	NO CELENCE ENFORED TO EID ABOVE	
er Qr	spar/Tenant	
	d in compliane with IBC 2018 1209.2.1 thru 1209.2.4	Λ
inel,	Sft Height	
Tegu	lar Edge (Colors per Owner / Tenant)	
100 C 100 C 100 C		

er Owner / Tenant

	D				DOOD				R SCH			III DIDIT	1 DE		DEL CADICA ALOTTO
No.		OOR SIZ	CE		DOOR			FRA ME				HA RDW	AKE		REMARKS / NOTES
	HLDM	HEIGHT	THICKNESS	MATERIAL	FINISH	ACTION	MATERIAL	HSINIA	WALL THICKNESS	HINGES	LOCKSEIS	CLOSER	DOOR STOP	ACCESSORIES	
100	3'-0"	7'-0"	BM	ASF	PF	RHR	ASF	PF		BM	DB-1	CL-1			ACCESS CONTROLS
101	3'-0"	7'-0"	BM	ASF	PF	RHR	ASF	PF		BM	DB-1	CL-1			ACCESS CONTROLS
102	3'-0"	<mark>7"-0</mark> "	BM	ASF	PF	RHR	ASF	PF		BM	DB-1	CL-1			ACCESS CONTROLS
103	3'-0"	7'-0"	BM	ASF	PF	RHR	ASF	PF		BM	DB-1	CL-1			ACCESS CONTROLS
104	3'-0"	7'-0"	BM	ASF	PF	LHR	ASF	PF		BM	DB-1	CL-1			ACCESS CONTROLS
105	3'-0"	7'-0"	1 3/4 "	IHM-1	PT	LHR	HMF	PT	MSRY	H-2	SL-1	CL-1			
106	3'-0"	7'-0"	BM	ASF	PF	RHR	ASF	PF		BM	PL-1	CL-1			
107	3'-0" 3'-0"	7'-0" 7'-0"	BM 1 3/4"	ASF WD-1	PF STN	LHR LHR	ASF HMF	PF PT	4.75"	BM H-1	PL-1 PL-1	CL-1 CL-1	D8-2	10	
108	3'-0"	7'-0"	1 3/4"	WD-1 WD-1	SIN STN	RH	HMF	PT PT	4.75"	H-1 H-1	PL-1 PL-1	CL-I	D8-2 D8-2	AC AC	NARROW LITE
110	3'-0"	7'-0"	1 3/4"	WD-1	STN	LH	HMF	PT	4.75"	H-1	PL-1 PL-1		DS-2 DS-2	AC	NARROW LITE
111	3'-0"	7'-0"	1 3/4"	WD-1	STN	LH	HMF	PT	4.75"	H-1	PL-1		D8-2	AC	NARROW LITE
112	3'-0"	7"-0"	1 3/4"	WD-1	STN	RH	HMF	PT	4.75"	H-1	PL-1		DS-2	AC	NARROW LITE
113	3'-0"	7'-0"	1 3/4"	WD-1	STN	RH	HMF	PT	4.75"	H-1	PL-1		DS-2	AC	NARROW LITE
114	3'-0"	7'-0"	1 3/4"	WD-1	STN	LH	HMF	PT	4.75"	H-1	PL-1		D8-2	AC	NARROW LITE
115	3'-0"	7"- <mark>0</mark> "	1 3/4"	WD-1	STN	LHR	HMF	PT	4.75"	H-l	PL-1		DS-2		
116	3'-0"	7'-0"	1 3/4"	WD-1	STN	RH	HMF	PT	4.75"	H-1	PV-1	CL-1	DS-2		
117	3'-0"	7'-0"	1 3/4"	WD-1	STN	LH	HMF	PT	4.75"	H-1	PV-1	CL-1	DS-2		
118	3'-0"	7'-0"	1 3/4 "	WD-1	ST N	RHR	HMF	PT	4.75"	H-l	PL-1	CL-1	DS-2	AC	HALF LITE
119	3'-0"	7"-0"	1 3/4"	WD-1	STN	RH	HMF	PT	6.75"	H-l	PL-1	CL-1	DS-2	AC	
120	3'-0"	7'-0"	1 3/4"	WD-1	STN	LH	HMF	PT	6.75"	H-1	PL-1		D8-2	AC	NARROW LITE
121	3'-0"	7'-0"	1 3/4"	WD-1	STN	RH	HMF	PT	6.75"	H-1	PL-1	100000 M	DS-2	AC	NARROW LITE
122	3'-0"	7"-0"	1 3/4 "		STN	RH	HMF	PT	4.75"	H-1	PL-1	CL-1	DS-1	AC	NARROW LITE
123	3'-0"	7'-0"	1 3/4"	WD-1	STN	LH	HMF	PT	4.75"	H-1	PL-1		DS-1		NARDOWLERS
124 125	3'-0" 3'-0"	7'-0" 7'-0"	1 3/4" 1 3/4"	WD-1 WD-1	STN STN	RH RHR	HMF HMF	PT PT	4.75" 4.75"	H-1 H-1	PV-1 PL-1		DS-1		NARROW LITE
125	3'-0"	7'-0"	1 3/4"	WD-1 WD-1	STN STN	RH	HMF	PT	4.75"	H-1 H-1	PL-1 PL-1		DS-1 DS-2		NARROW LITE
126	3'-0"	7-0"	1 3/4	WD-1 WD-1	STN	LH	HMF	PI	4.75	н-1 Н-1	PL-1 PL-1		D8-2 D8-2		NARROW LITE
127	3'-0"	7'-0"	1 3/4"	WD-1	STN	LH	HMF	PT	4.75"	H-1	PL-1		D3-2 D8-2	AC	MARCOW LITE
129	3'-0"	7'-0"	1 3/4"	WD-1	STN	LH	HMF	PT	4.75"	H-1	PL-1		DS-2 DS-2	AC	NARROW LITE
130	3'-0"	7'-0"	1 3/4"	WD-1	STN	RH	HMF	PT	4.75"	H-1	PV-1		DS-3	d4-08085508	at en anna 2000 anna
131	3'-0"	7'-0"	1 3/4"	WD-1	STN	RH	HMF	PT	4.75"	H-1	PL-1	CL-1	DS-2	AC	HALF LITE
132	3'-0"	7"-0"	1 3/4"	WD-1	STN	LH	HMF	PT	4.75"	H-l	PL-1	CL-1	DS-2	AC	HALF LITE
133	3'-0"	7'-0"	1 3/4"	HM-1	PT	RHR	HMF	PT	4.75"	H-l	PL-1	CL-1		AIR	HALFLITE
134	3'-0"	7'-0"	1 3/4"	WD-1	\$TN	LH	HMF	PT	4.75"	H-l	PL-1	CL-1	DS-2	AC	HALF LITE
135	3'-0"	7"- <mark>0</mark> "	BM	BM	PF	DA	HMF	PT	4.75"	BM	PPL-1	CL-2	DS-2	SD	HALF LITE

BM By Manufacturer

DOORS:	
ASF	Aluminum Glass Storefront
WD-1	Solid Core Wood Door

IHM-I	Insulated Hollow Metal D	oor
HM-1	Hollow Met al Door	
FRAMES:		

LOCKS & OPERATORS: PL-1 Passage Lockset

PL-I	Passage Lockset
PV-1	Office / Privacy Lockset
DB-1	Dead Bolt
PPL-1	Push / Pull Plates

HARDWARE:

	H-1	Hinge	1 1/2" Pair Full Mortise Template Ball Bearing Standard
	H-2	Hinge	3 Pair Full Mortise Template Ball Bearing Heavy Weigh
	C-1	Closer	Surface Closer (Finish to Match Adjacent Hardware)
	C-2	Closer	Double Action Adjustable Surgical Door Closer by Door
	DS-1	Door Stop	Wall Mounted Door Stop
	DS-2	Door Stop	Floor Mounted Door Stop
	DS-3	Door Stop	Hinge Mounted Door Stop
FT	ISHES:		
	PF	Pre-Finished By Man	ufacturer (per Owner / Tenant)

Keyed Deadbolt w/ Deadlatch Push Paddle

Acoustical Sweep & Gasketing

PT Paint (per Owner / Tenant)

ACCESSORIES: AC A coust ic Set

Laboratory Door, Gasketing to Stop Air Transfer AIR Lab Door SD Surgical Door Double Action Surgical Door w/ Closer

NOTES: 1 Set all Thresholds in Sealant

2 All Doors and Hardware shall meet Accessibility Standards

4"x16" Standard Push/Pull Plates w/ Optional Kick Plates Each Side

lard Weight Hinges, Finsih Per Owner / Tenant eight Hinges, Finish Per Owner / Tenant

oor Manufacturer

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KENDZEN ES, P.C. F.C.	573.657.2022 PHONE Jay@pba-architecture.com								
PORTER, BERENDZ & Associates, P. & R. G. H. I. T. F. G. J.									
Port & A5 A5	₽₽₽								
	200 SOUTH HET P.O. BOX 446 ASHLAND, MISE								
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Discovery Park Discovery Animal Hospital	1901 NE Trails Edge Boulevard Lee's Summit, Jackson County, Missouri								
ID DESCRIPTION 1 PERMIT 2 REVISION -	6/14/2024								
PROJECT NO.									
PBA:	2417								
SCHED	ULES								
A9	00								

Mechanical - Electrical - Plumbing Design Drawings for



GENERAL MEP SPECIFICATIONS

1. <u>GENERAL</u>

- ALL WORK SHALL BE PERFORMED IN COMPLIANCE WITH LOCALLY ADOPTED CODES AND 1.1. ORDINANCES.
- 1.2. IT IS THE RESPONSIBILITY OF CONTRACTOR TO REVIEW AND UNDERSTAND ALL DRAWINGS AND SPECIFICATIONS IN CONTRACT DOCUMENTS. EACH CONTRACTOR IS RESPONSIBLE FOR ALL WORK ASSOCIATED WITH THEIR TRADE, REGARDLESS OF WHERE WORK IS DEPICTED IN PROJECT DRAWINGS OR SPECIFICATIONS.
- 1.3. LAYOUT OF SYSTEMS SHOWN ON PLANS ARE APPROXIMATE AND SCHEMATIC IN NATURE. ALL SYSTEMS WILL NEED TO BE FIELD-COORDINATED. CONTRACTOR SHALL INCLUDE THIS COORDINATION IN THEIR SCOPE AND INCLUDE ALL COSTS OF MODIFYING LAYOUT AS REQUIRED IN THEIR BID. PLANS ARE NOT INTENDED TO BE SHOP DRAWINGS FROM WHICH MATERIALS CAN BE ORDERED, FABRICATED, OR INSTALLED WITHOUT ADDITIONAL FIELD MEASUREMENTS AND COORDINATION.
- 1.4. NOT ALL SPECIFIC PIECES AND COMPONENTS OF EACH SYSTEM ARE DETAILED OR OUTLINED ON PLANS. CONTRACTOR IS RESPONSIBLE FOR PROVIDING ALL NECESSARY PARTS AND LABOR TO PRODUCE A COMPLETE AND FULLY OPERATIONAL SYSTEM UNLESS STATED OTHERWISE ON PLANS. CONTRACTOR IS TO PROVIDE AND INCLUDE ALL EQUIPMENT AND MATERIAL NEEDED TO COMPLETE WORK ASSOCIATED WITH THEIR BID UNLESS ANY ITEMS ARE SPECIFICALLY NOTED ON PLANS AS PROVIDED BY OTHERS. ALL MATERIALS TO BE NEW, FIRST CLASS, AND INSTALLED PER MANUFACTURER'S PUBLISHED INSTRUCTIONS.
- WHERE CONFLICTS EXIST BETWEEN MEP PLANS AND CIVIL, ARCHITECTURAL, OR 1.5. STRUCTURAL PLANS, NOTIFY MEP ENGINEER OF DISCREPANCIES FOR CLARIFICATION PRIOR TO PERFORMING ANY WORK THAT MAY CONTRADICT INFORMATION ELSEWHERE IN THE PROJECT PLANS.
- THESE PLANS ARE NOT TO BE SCALED. SEE ARCHITECTURAL PLANS FOR DIMENSIONS. 1.6. WHERE THERE IS A CONFLICT BETWEEN ARCHITECTURAL DIMENSIONS AND MEP DIMENSIONS, ARCHITECTURAL SHALL GOVERN.
- CONTRACTOR IS TO INCLUDE IN THEIR SCOPE THE COST OF ALL PERMITS, INSPECTIONS, 1.7. METERING, TAPS, ETC. ASSOCIATED WITH THEIR WORK.
- 1.8. CONTRACTOR IS RESPONSIBLE FOR ALL EXCAVATION, CUTTING, CORING, PATCHING, AND BACKFILL REQUIRED TO COMPLETE THEIR WORK, UNLESS NOTED OTHERWISE ON PLANS. SPECIFIC EQUIPMENT MANUFACTURERS AND/OR MODEL NUMBERS LISTED ON PLANS ARE
- 1.9. TO ESTABLISH A BASIS-OF-DESIGN FOR QUALITY AND PERFORMANCE, VERIFY THAT SUBSTITUTIONS WILL BE ACCEPTABLE PRIOR TO PURCHASE & INSTALLATION.
- NOTIFY ENGINEER OF ANY MAJOR PLAN DISCREPANCIES OR CONFLICTS PRIOR TO 1.10. PROVIDING BIDS OR COMPLETING ANY WORK.
- 1.11. SEE DISCIPLINE SHEETS FOR ADDITIONAL TRADE SPECIFIC SPECIFICATIONS.
- 1.12. WHERE SHUTDOWN OF ANY EXISTING UTILITY OR SERVICE TO BUILDING IS REQUIRED FOR COMPLETION OF WORK, COORDINATE OUTAGE WITH OWNER AS TO NOT DISRUPT TYPICAL OPERATIONS.

2. WORKMANSHIP

- SYSTEMS SHALL BE INSTALLED IN A FIRST-CLASS MANNER USING BEST ACCEPTABLE 2.1. METHODS AND PRACTICES.
- 2.2. ALL SYSTEMS SHALL BE INSTALLED PARALLEL OR PERPENDICULAR TO BUILDING ORIENTATION. COMPONENTS SHALL BE INSTALLED LEVEL AND PLUMB WITH ATTENTION GIVEN TO OVERALL AESTHETICS.
- 2.3. CONTRACTOR IS RESPONSIBLE FOR COORDINATING EQUIPMENT LOCATIONS AND SYSTEM ROUTING WITH OTHER TRADES PRIOR TO INSTALLATION.
- CONTRACTOR TO GUARANTEE ALL MATERIALS AND WORKMANSHIP FOR A PERIOD OF ONE 2.4. YEAR FROM THE DATE THE COMPLETED PROJECT IS RELEASED TO THE OWNER, UNLESS NOTED OTHERWISE ON PLANS.
- 2.5. DURING INSTALLATION OF MATERIALS OR ACTIVITIES IN NEW WORK SCOPE, AVOID DAMAGING EXISTING SURFACES AND EQUIPMENT TO REMAIN. ANY DAMAGE TO EXISTING SURFACES OR EQUIPMENT SHALL BE CORRECTED AT NO COST TO OWNER.

DEFERRED SUBMITTAL NOTES

FIRE ALARM SYSTEM

- 1.1. ALARM SYSTEM DESIGNER OF RECORD PRIOR TO ROUGH-IN. 1.2.
- 2. FIRE SPRINKLER SYSTEM 2.1. WHERE COMBINED FIRE & DOMESTIC WATER SUPPLY LINES ARE SHOWN ON PLANS, INCOMING LINE SIZE IS ADEQUATE FOR FIRE SUPPRESSION SYSTEM. 2.2.
- SPRINKLER SYSTEM. SUBMITTAL SHALL INCLUDE HYDRAULIC CALCULATIONS AND BY THE STATE.

Discovery Animal Hospital

1901 NE Trails Edge Avenue Lee's Summit, Jackson County, MO 64064

FIRE ALARM SYSTEM COMPONENTS SHOWN (IF APPLICABLE) ARE GENERAL AND SCHEMATIC IN NATURE, SHOWN FOR APPROXIMATE ROUGH-IN LOCATIONS AND QUANTITIES ONLY. CONTRACTOR TO VERIFY EXACT DEVICE LOCATIONS AND REQUIREMENTS WITH FIRE

FIRE ALARM CONTRACTOR SHALL PROVIDE DEFERRED SUBMITTAL PACKAGE FOR FIRE ALARM SYSTEM. SUBMITTAL SHALL INCLUDE BATTERY CALCULATIONS, VOLTAGE DROP CALCULATIONS, EQUIPMENT SPECIFICATIONS FOR DEVICES AND PANELS, ETC. DESIGN SHALL BE SEALED BY A QUALIFIED DESIGN PROFESSIONAL LICENSED BY THE STATE.

INSTALLING CONTRACTOR SHALL VERIFY WITH FIRE SPRINKLER CONTRACTOR THAT FIRE SPRINKLER CONTRACTOR TO PROVIDE DEFERRED SUBMITTAL PACKAGE FOR FIRE

SPRINKLER SYSTEM DRAWINGS SEALED BY A QUALIFIED DESIGN PROFESSIONAL LICENSED

REFERENCED CODES IN EFFECT

PROJECT HAS BEEN DESIGNED IN COMPLIANCE WITH THE FOLLOWING CODES LISTED BELOW, BUT THIS IS NOT AN EXHAUSTIVE LIST. PROJECT SHALL COMPLY WITH ALL APPLICABLE CODES, STANDARDS, AND LOCAL REQUIREMENTS.

- 2018 INTERNATIONAL MECHANICAL CODE
- 2018 INTERNATIONAL PLUMBING CODE • 2018 INTERNATIONAL FUEL GAS CODE
- 2018 INTERNATIONAL FIRE CODE
- 2017 NATIONAL ELECTRIC CODE

FIRE RATED PENETRATION NOTES

- THIS BUILDING CONTAINS FIRE RATED ASSEMBLIES. SEE ARCHITECTURAL PLANS FOR LOCATIONS AND DETAILS.
- A UL-LISTED FIRESTOP SYSTEM SHALL BE INSTALLED AT EACH PENETRATION OF A HORIZONTAL OR VERTICAL RATED ASSEMBLY IN ACCORDANCE WITH ASTM E814 OR UL 1479.
- EACH CONTRACTOR IS RESPONSIBLE FOR PROVIDING PROTECTION FOR THEIR PENETRATIONS THRU RATED ASSEMBLIES. • GENERAL CONTRACTOR IS RESPONSIBLE FOR PROVIDING AND MAINTAINING A CATALOG OF ALL
- UL LISTED FIRESTOP ASSEMBLIES, AND KEEPING A PHYSICAL COPY OF DETAILS FOR EACH USED FIRESTOP ASSEMBLY ON SITE FOR REFERENCE.

A	RELEASED FOR CONSTRUCTION s Noted on Plans Review
Deres C	Eels/Summit, Missouri
	ATSON JMBER 015017071
James Watson, P.E. PE-2015017071 MO Certificate of Au	June 14, 2024 thority # 2018029680
J-SQU	
E N G I N E 2400 Bluff Creek Columbia, M 573 - 234 - 4 www.j-squa	: Drive, Suite 101 issouri 65201 4492 phone
J2 PROJECT No:	J21209
J2 DESIGN:	ACW
ISSUE TITLE PERMIT SET	DATE 06 / 14 /2024

SHEET #	SHEET NAME
MEP1	MECHANICAL ELECTRICAL PLUMBING COVER SHEET
MEP2	SITE UTILITY - SITE LIGHTING PLAN
MEP3	SITE LIGHTING PLAN
M101	HVAC PLAN
M501	HVAC DETAILS & SCHEDULES
EP101	POWER PLAN
EL101	LIGHTING PLAN
E501	ELECTRICAL SCHEDULES
E601	ELECTRICAL DETAILS
PS101	SANITARY SEWER PLAN
PW101	WATER & GAS PLAN
P501	PLUMBING DETAILS & SCHEDULES

SHEET INDEX



SHEET TITLE

MECHANICAL ELECTRICAL PLUMBING **COVER SHEET**

SHEET NUMBER




SITE UTILITIES PLAN GENERAL NOTES:

1. REFER TO CIVIL PLANS FOR EXACT UTILITY LOCATIONS, CONNECTIONS, DETAILS, ETC.

SITE PLAN SYMBOL LEGEND

	SANITARY SEWER PIPING
	COLD WATER LINE
M	WATER METER
M	VALVE
	GAS LINE
G	GAS METER
$\left(\right)$	TIE INTO EXISTING
	ELECTRIC
──> PX-XX	CIRCUIT TAG

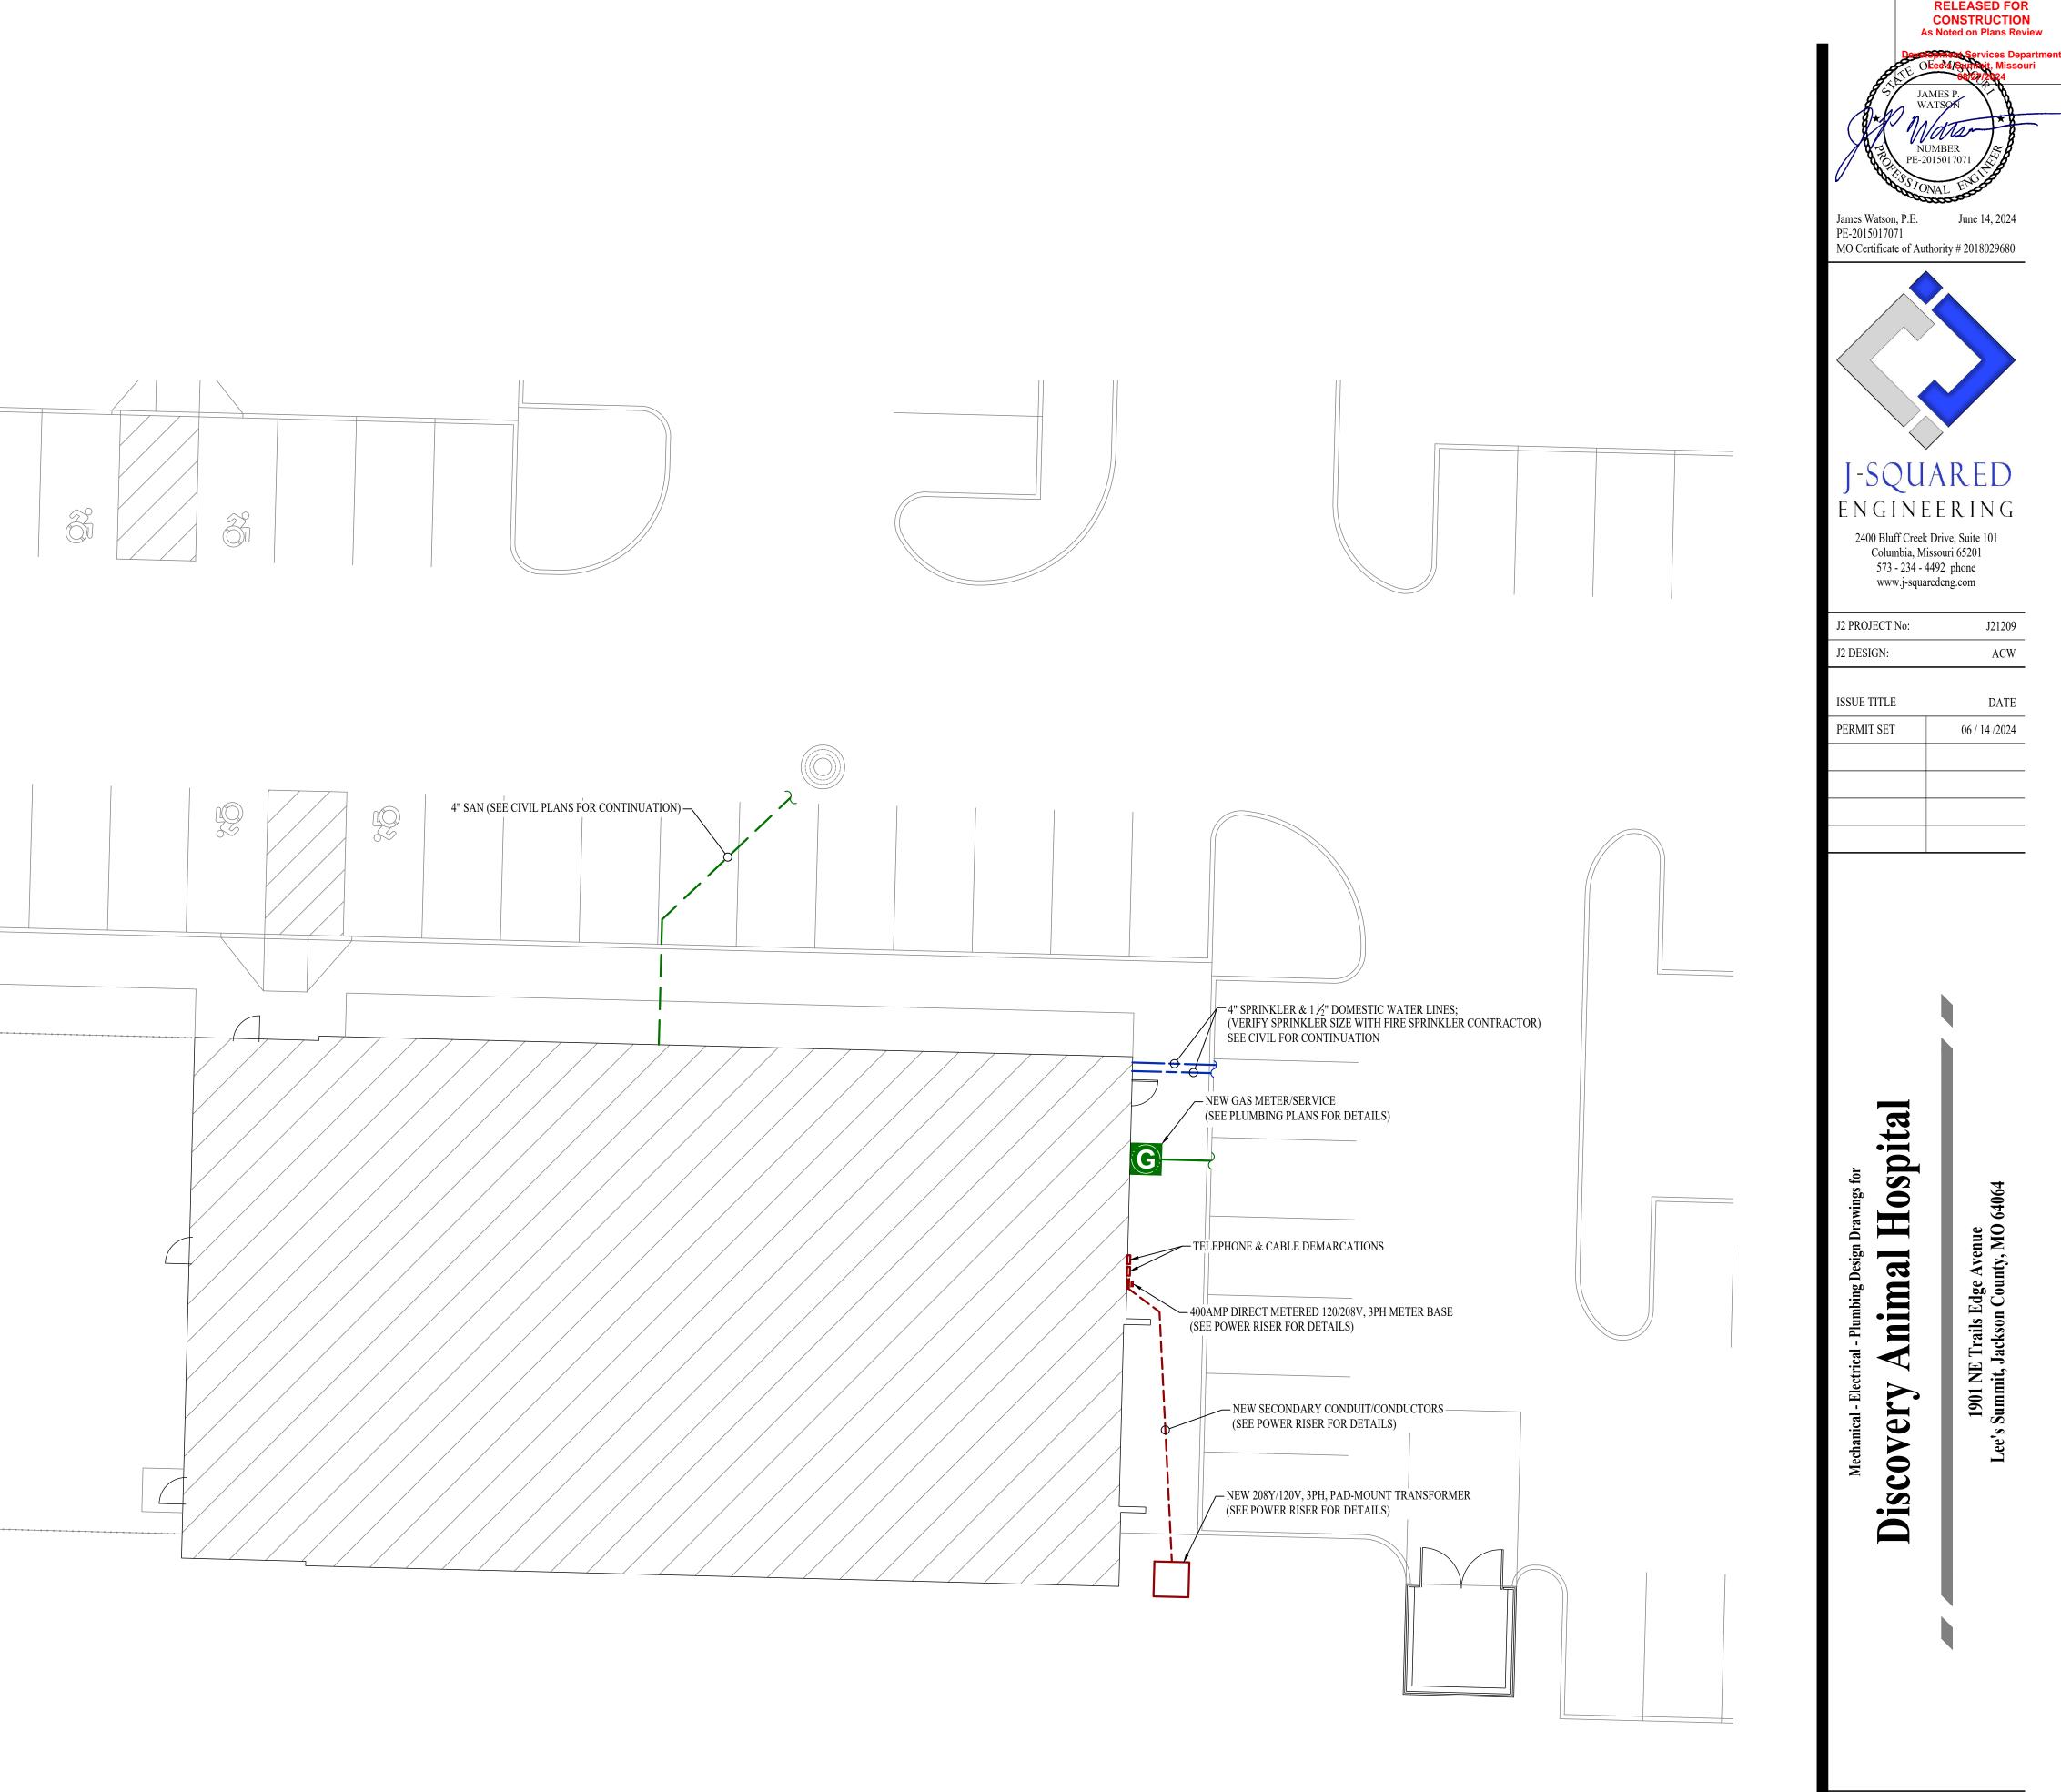

SITE UTILITIES PLAN

SCALE: 1" = 10 ft


SHEET TITLE

SITE UTILITIES PLAN

SHEET NUMBER



SITE LIGHTING PLAN SYMBOL LEGEND

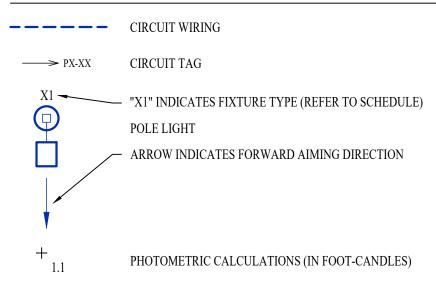



SITE LIGHTING PLAN GENERAL NOTES:


- 1. SITE PHOTOMETRIC VALUES SHOWN HAVE BEEN CALCULATED PER SPECIFIED LIGHT FIXTURES AT INDICATED MOUNTING HEIGHTS. ANY CHANGES OR ALTERATIONS TO LIGHTING LAYOUT SHOWN WILL REQUIRE RECALCULATING SITE PHOTOMETRICS AND WILL THE RESPONSIBILITY OF
- THE ELECTRICAL CONTRACTOR / EQUIPMENT SUPPLIER. 2. PHOTOMETRIC CALCULATIONS SHOWN DO NOT INCLUDE EXISTING LIGHT FIXTURE(S), ONLY NEW POLE LIGHT FIXTURE(S) SHOWN.
- 3. SEE SHEET EL101 FOR BUILDING MOUNTED EXTERIOR LIGHT FIXTURE CIRCUITING, LOCATIONS, AND ADDITIONAL DETAILS.

SITE LIGHTING PLAN KEY NOTES:

(1) 1" CONDUIT WITH (2) #10 CU. & (1) #10 CU. EQ. GRD.

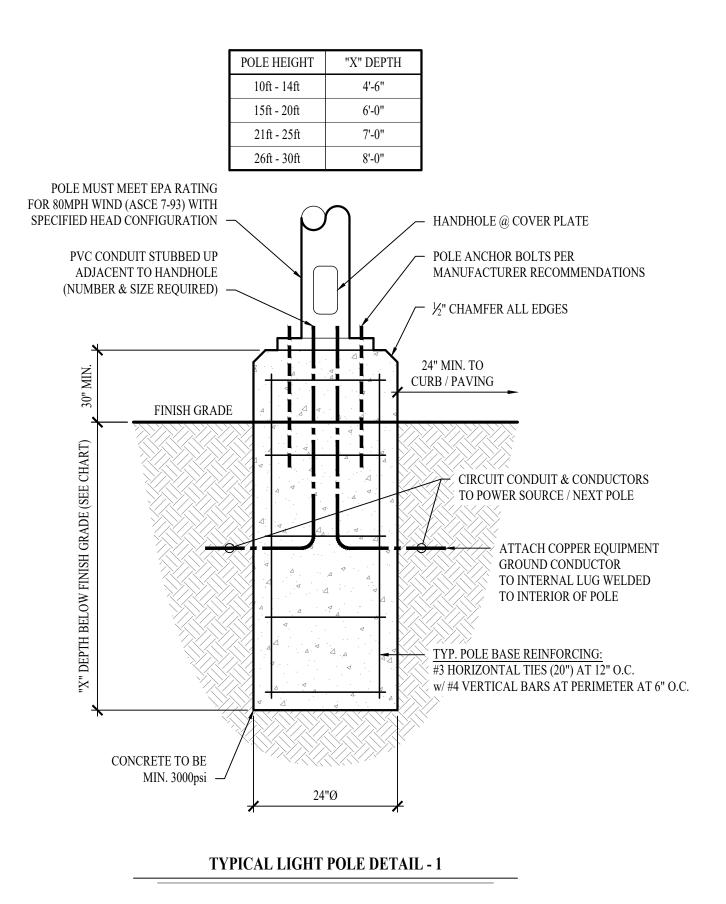

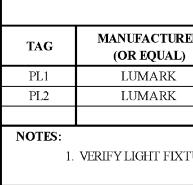

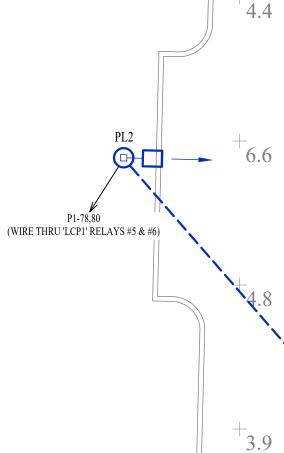

PL2

P1-78,80


NUFACTURER	MODEL NUMBER		E LIGHTING FIX						1	
OR EQUAL)	(OR EQUAL)	DESCRIPTION	MOUNTING	OUTPUT	CCT (°K)	CRI	VOLTS	WATTS		NOTES
LUMARK LUMARK	PRV-XL-PA4A-740-U-5WQ PRV-XL-PA4B-740-U-T4W-HSS	POLE LIGHT POLE LIGHT	20' POLE ON 30" BA SE 20' POLE ON 30" BA SE	35,079 28,286	4000 4000	70 70	208 208	245 303		L40W MOTION SENSING DIN L40W MOTION SENSING DIN
LIGHT FIXTURE	FINISHES WITH OWNER / ARCHITECT PI	RIOR TO INSTALLATIO	N							
					0.8		0.8		1.0	1.2
4.4	3° 4,1 3°	2.8	1.4	8	+0.7		+0.8		1.2	1.5
+	+ +	-	+ +		+		+		+	+
+ 6.6	5.7	3.0	+ + + 0.	7	+0.6		+0.9		1.4	+ 2.0
4.8	4.5	2.9	+1.3 +0.	.7	+0.6		+0.9		+1.5	+2.3
+3.9	+3.0 +	2.3	+1.3 +0.	.7	+0.6		+0.9		+1.5	+2.6
				P	ROPOSED					
					W BUILDING					


SITE LIGHTING PLAN

SCALE: 1" = 10 ft



Dense Market	RELEASED FOR CONSTRUCTION As Noted on Plans Review
	AMES P. VATSON UMBER 2015017071
James Watson, P.E. PE-2015017071 MO Certificate of Au	June 14, 2024 athority # 2018029680
ENGINI 2400 Bluff Cree Columbia, M 573 - 234 -	ARED EERING k Drive, Suite 101 fissouri 65201 4492 phone aredeng.com
J2 PROJECT No:	J21209
J2 DESIGN:	ACW
ISSUE TITLE	DATE
PERMIT SET	06 / 14 /2024

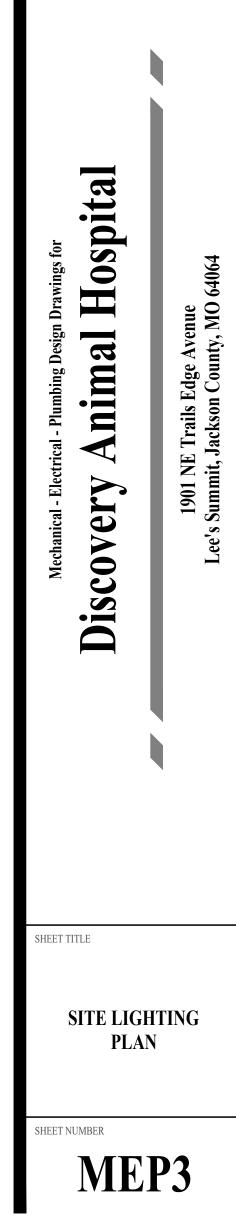

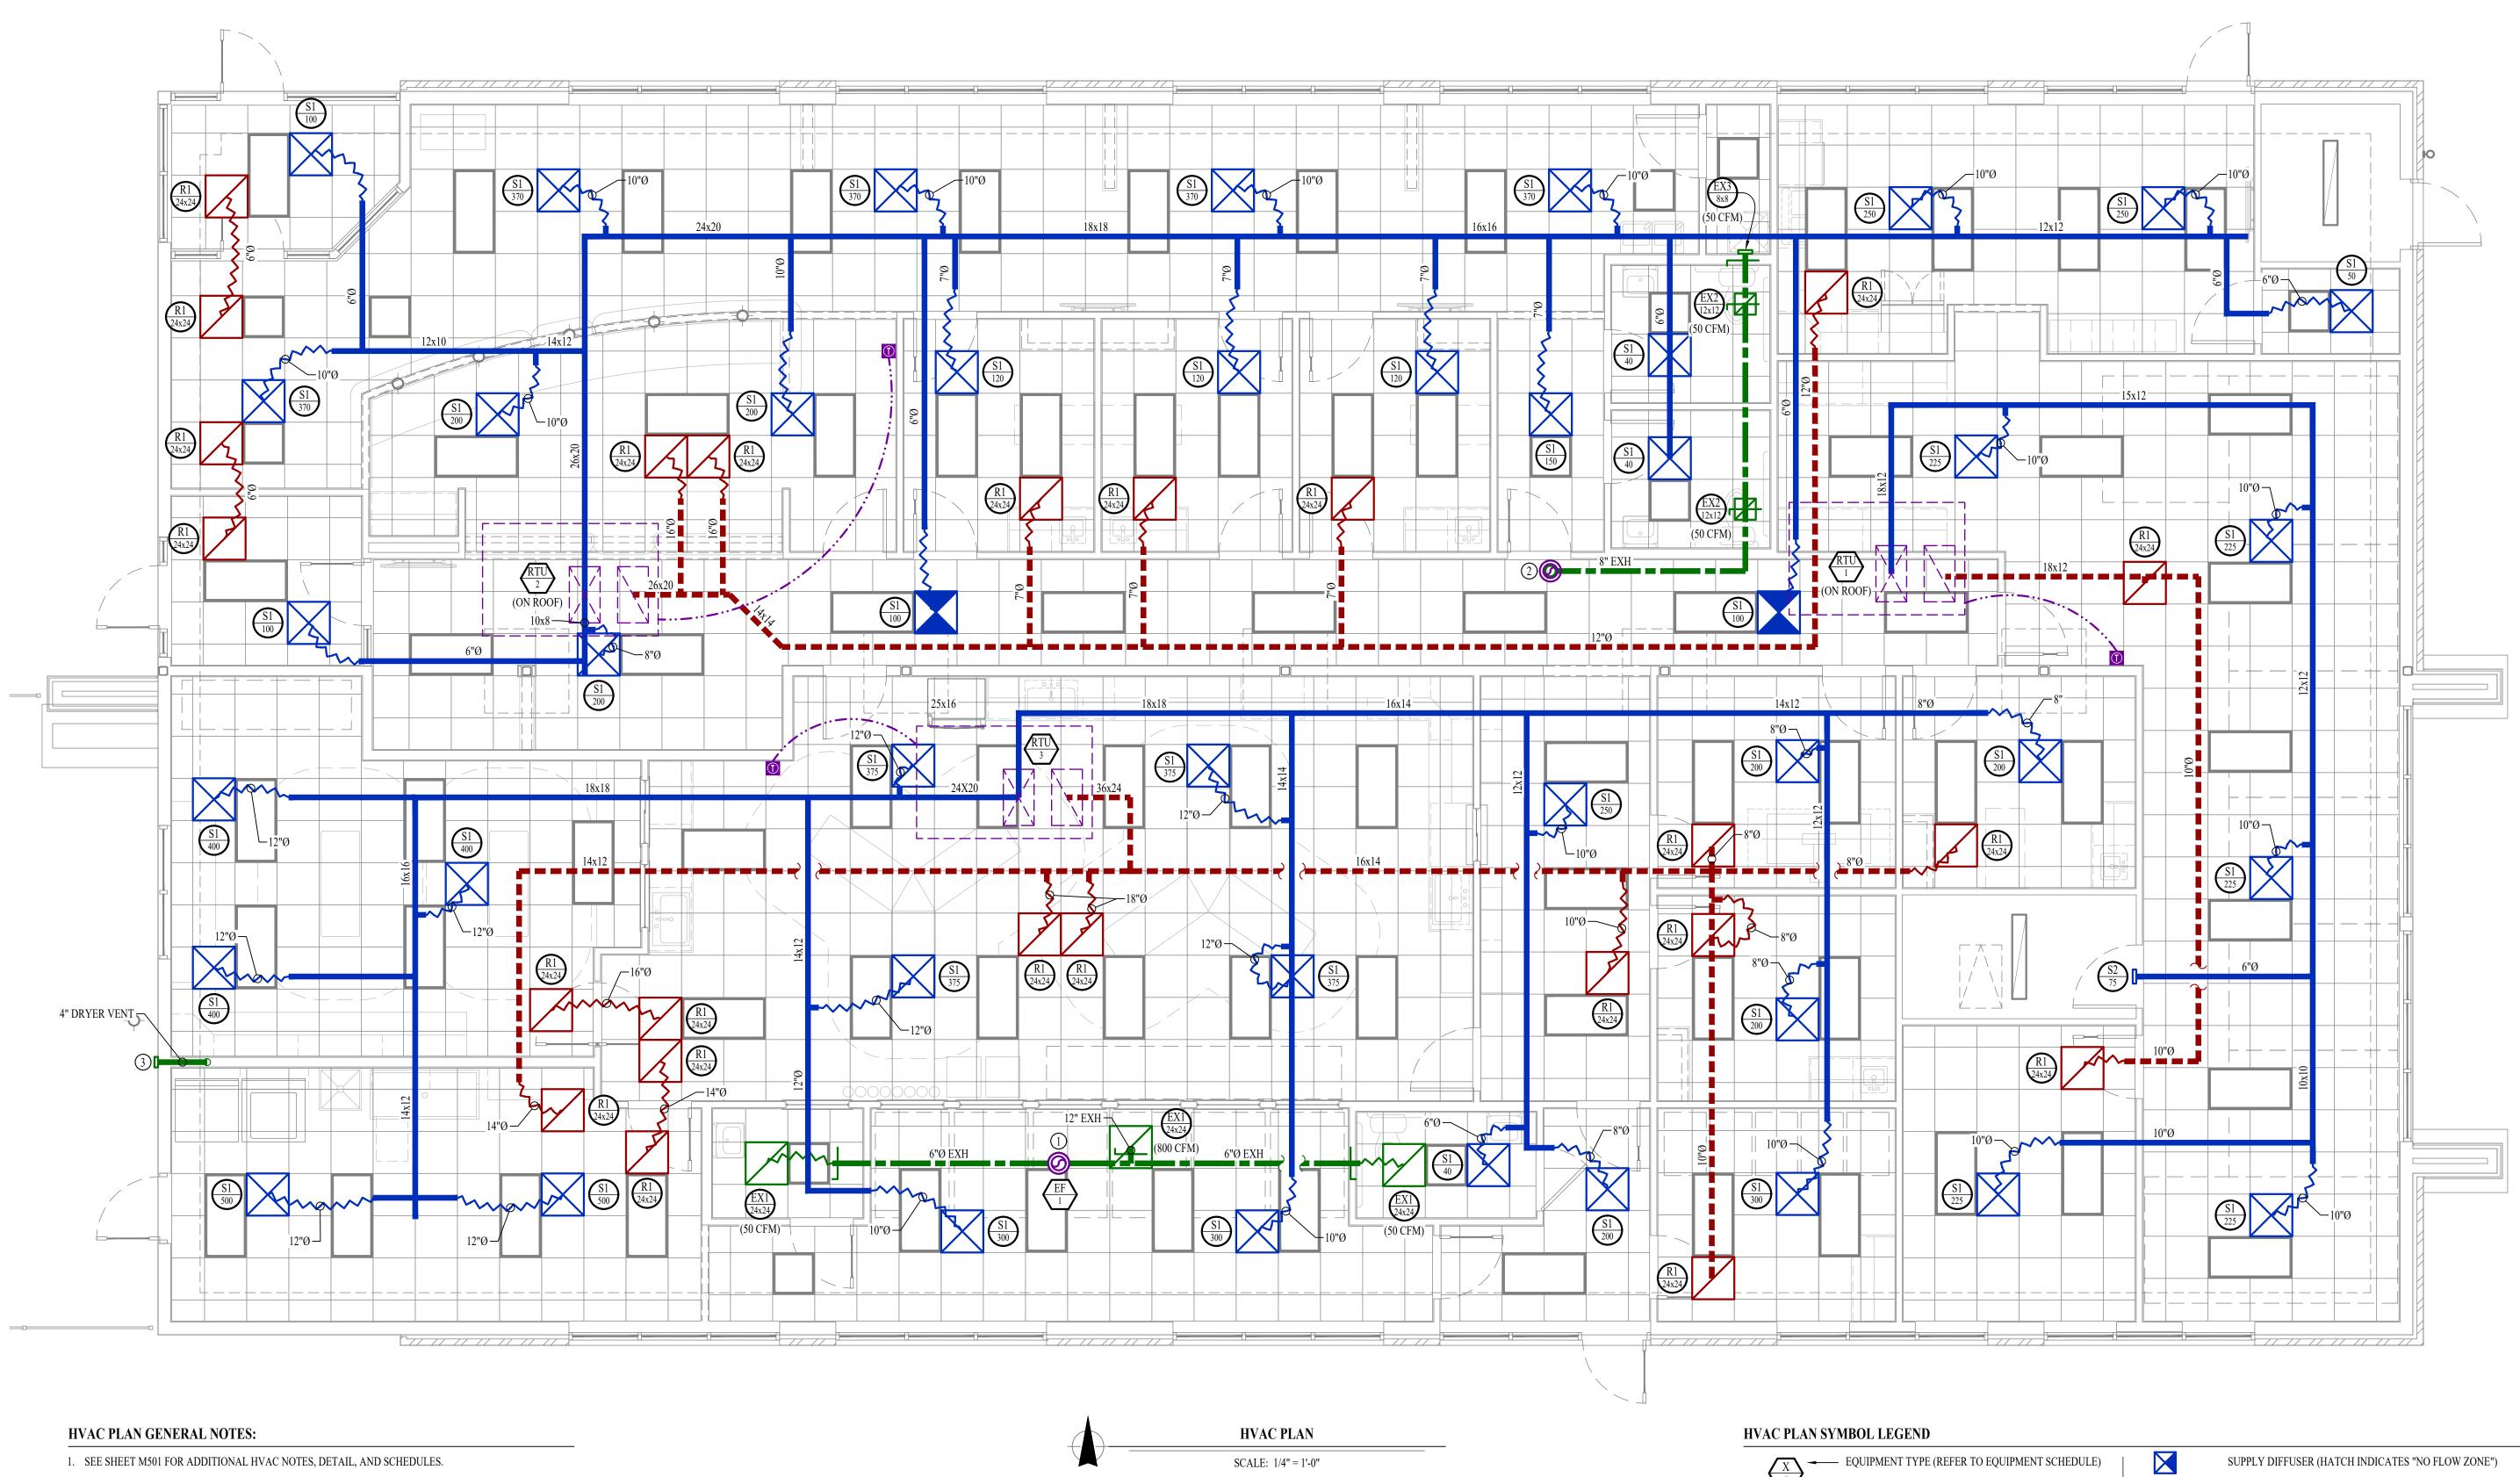

1. SEE SHEET M501 FOR ADDITIONAL HVAC NOTES, DETAIL, AND SCHEDULES.

HVAC PLAN KEY NOTES:

- 12" EXHAUST UP TO EF-1 THEN UP THRU ROOF TO GOOSENECK WITH $\frac{3}{8}$ " BIRDSCREEN.
- 2) 8" EXHAUST UP TO EF-2 THEN UP THRU ROOF TO GOOSENECK WITH ³/₈" BIRDSCREEN.
- 3 DRYER VENT. PAINT TO MATCH BUILDING.

SCALE: 1/4" = 1'-0"

X # EQUIPM EQUIPM
X DIFFUS
SUPPL

X

PLY DUCTWORK RETURN DUCTWORK

EXHAUST DUCTWORK OUTSIDE AIR DUCTWORK

FLEX DUCT

VENT / COMBUSTION AIR

CONDENSATION LINE

REFRIGERANT LINE

TIE INTO EXISTING

PMENT TYPE (REFER TO EQUIPMENT SCHEDULE) PMENT REFERENCE NUMBER USER/GRILLE TYPE (REFER TO SCHEDULE) IC FEET PER MINUTE (CFM) / FACE SIZE

	SUPPLY DIFFUSER (HATCH INDICATES "NO FLOW ZONE")
	RETURN DIFFUSER
г <u> </u>	BALANCE DAMPER
≥	MOTORIZED DAMPER
0	CEILING RADIATION DAMPER
•	FIRE RATED DAMPER
<u> က</u>	SMOKE DAMPER
	THERMOSTAT
CO2	CO2 DETECTOR
DS	RETURN DUCT SMOKE DETECTOR WIRED TO FAN STARTER TO SHUT UNIT(S) DOWN AND SEND ALARM SIGNAL TO FIRE ALARM SYSTEM (IF PRESENT) OR TO REMOTE SOUNDER LOCATED IN AN OCCUPIED SPACE (EQUAL TO SYSTEM SENSOR #D4120)
43	REMOTE SOUNDER WIRED TO RETURN DUCT SMOKE DETECTOR (EQUAL TO SYSTEM SENSOR #MHW)

Den Ster	RELEASED FOR CONSTRUCTION As Noted on Plans Review
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ISSUE TITLE	DATE
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Hospital for MO nimal Ave nty, Õ údge Com iils Ы Tr: acl Discovery 1901 Summ Mechanical - Ele SHEET TITLE HVAC PLAN SHEET NUMBER **M101**

1. GENERAL 1.1. REFER TO GENERAL MEP SPECIFICATIONS SECTION FOR ADDITIONAL REQUIREMENTS.

2. WORKMANSHIP

- 2.1. COORDINATE WITH ALL OTHER TRADES SO THAT HVAC EQUIPMENT AND DUCT WORK DOES NOT BLOCK REQUIRED ACCESS OR CLEARANCE TO ANY EQUIPMENT, ACCESS PANELS,
- ELECTRICAL JUNCTION BOXES, ELECTRICAL PANELS, ETC. 2.2. ALL HVAC EQUIPMENT IS TO BE INSTALLED PER MANUFACTURER'S PUBLISHED
- RECOMMENDATIONS AND/OR INSTALLATION INSTRUCTIONS.
- 2.3. ALL EQUIPMENT TO BE INSTALLED LEVEL AND PLUMB, PARALLEL OR PERPENDICULAR TO BUILDING ORIENTATION WHERE POSSIBLE. ROOFTOP MOUNTED RTU'S SHALL BE INSTALLED ON CURBS PER MANUFACTURER'S 2.4.
- INSTRUCTIONS. CURB HEIGHT SHALL PROVIDE A MINIMUM OF 6" BETWEEN EQUIPMENT AND TOP OF ROOF IN ALL LOCATIONS.
- 2.5. GRADE MOUNTED RTUS, CONDENSING UNITS, AND HEAT PUMPS TO BE INSTALLED ON 4" REINFORCED CONCRETE PAD EXTENDING 4" BEYOND EACH EDGE OF THE EQUIPMENT, OR A MANUFACTURER APPROVED PRE-MANUFACTURED BASE.
- APPROPRIATE ATTENTION SHALL BE GIVEN TO INDOOR AIR QUALITY THROUGHOUT 2.6. CONSTRUCTION; PROTECT INSIDE OF NEW DUCTWORK & AIR-HANDLING EQUIPMENT FROM DUST, DIRT, DEBRIS, PAINT, MOISTURE, ETC. INSULATION SHALL BE REPLACED IF EXPOSED TO MOISTURE. AN INDEPENDENT, PROFESSIONAL DUCT CLEANING COMPANY SHALL CLEAN ALL NEW DUCTWORK IF EQUIPMENT WAS USED DURING CONSTRUCTION, AND EQUIPMENT/COILS SHALL ALSO BE THOROUGHLY CLEANED.
- 2.7. FIELD COORDINATE LOCATIONS OF ALL DIFFUSERS, GRILLES, REGISTERS, ETC. WITH LIGHT FIXTURE LOCATIONS AND ADJUST AS NECESSARY.

EQUIPMENT 3.

ALL EQUIPMENT SHOWN ON MECHANICAL PLANS SHALL BE PROVIDED & INSTALLED BY 3.1. MECHANICAL CONTRACTOR UNLESS NOTED OTHERWISE. ALL EQUIPMENT MUST PROVIDE PERFORMANCE AS SPECIFIED ON PLANS. WHERE SPECIFIC 3.2.

- MANUFACTURERS AND/OR MODELS ARE INDICATED ON PLANS, CONTRACTOR TO PROVIDE MODEL INDICATED OR APPROVED EQUAL. VERIFY SUBSTITUTION APPROVAL PRIOR TO PURCHASE OR INSTALLATION OF EQUIPMENT.
- 3.3. CONTRACTOR TO SUPPLY SUBMITTALS FOR ALL EQUIPMENT FOR REVIEW BY ARCHITECT AND ENGINEER. FORMAL APPROVAL SHALL BE RECEIVED BY CONTRACTOR PRIOR TO EQUIPMENT PURCHASE.
- CONTRACTOR TO SHARE APPROVED EQUIPMENT SUBMITTALS WITH ANY PERTINENT 3.4. ELECTRICAL OR PLUMBING REQUIREMENTS WITH RESPECTIVE CONTRACTORS WITHIN TWO WEEKS OF RECEIVING APPROVED SUBMITTALS FROM ARCHITECT/ENGINEER. 3.5. ALL EQUIPMENT SHOWN ON PLANS SHALL BE INSTALLED PER MANUFACTURER'S
- SPECIFICATIONS WITH ADEQUATE ACCESS AND CLEARANCE FOR SERVICING OR REPLACEMENT 3.6.
- ALL HORIZONTAL FURNACES WITH AC COILS SHALL BE EQUIPPED WITH CORROSION RESISTANT DRAIN PAIN. DRAIN PAN TO DISCHARGE TO SANITARY WASTE VIA INDIRECT CONNECTION WITH AIR GAP. DRAIN PAN TO PROVIDE SECONDARY OVERFLOW OR FLOAT SWITCH INTERLOCKED WITH UNIT TO SHUT DOWN UNIT ON HIGH WATER SIGNAL. ALL EXTERIOR REFRIGERANT COILS TO BE PROTECTED BY FACTORY EQUIPPED HAIL 3.7.
- GUARDS.
- 3.8. REFRIGERANT PIPING TO BE ACR COPPER OR TYPE L COPPER. 3.9. ALL AIR HANDLING EQUIPMENT SHALL BE EQUIPPED WITH MERV-8 FILTRATION AT RETURN OPENING UNLESS OTHERWISE NOTED.
- 3.10. ALL AIR FILTERS SHALL BE SIZED FOR A MAXIMUM FACE VELOCITY OF 500FPM. 3.11. PROVIDE & INSTALL ALL EQUIPMENT FLUES/VENTS PER MANUFACTURER'S SPECIFICATIONS.
- TERMINATIONS SHALL BE AT LEAST 10' FROM ANY FRESH AIR INTAKE PROVIDE NEW AIR FILTERS IN ALL EQUIPMENT PRIOR TO TESTING & BALANCING AND 3.12.
- BEFORE TURNING OVER SYSTEM(S) TO OWNERSHIP. IF ANY EXISTING EQUIPMENT IS TO BE REUSED, CLEAN AND INSPECT EQUIPMENT PRIOR TO 3.13. BEGINNING WORK. VERIFY THAT EQUIPMENT IS IN GOOD WORKING CONDITION, REPORT ANY DEFICIENCIES TO ENGINEER.

- DUCTWORK TO BE GALVANIZED STEEL, SEAL CLASS B, CONSTRUCTED PER SMACNA 4.1. STANDARDS.
- DUCTWORK THICKNESS: 4.2. 4.2.1. 26 GA. MINIMUM UP TO 16" DUCT
- 4.2.2. 24 GA. UP TO 20"
- 4.2.3. 22 GA. UP TO 24"
- 4.2.4. 20 GA. UP TO 28" 4.2.5. 18 GA. UP TO 36"
- 4.3. TURNING VANES SHALL BE PROVIDED AND INSTALLED AT ALL 90° BENDS AND TEES. ALL DUCT DIMENSIONS LISTED ARE TO INTERIOR OF DUCT LINER UNLESS NOTED
- 4.4. OTHERWISE ON PLANS.
- BALANCE DAMPERS MUST BE PROVIDED TO ALLOW ADJUSTMENT AT EACH AIR TERMINAL 4.5. 4.5.1. WHERE BRANCH TAKEOFF IS ACCESSIBLE (ABOVE LAY-IN CEILING OR EXPOSED DUCT), BALANCE DAMPER IS TO BE INSTALLED AT TAKEOFF.
- 4.5.2. WHERE TAKEOFF IS INACCESSIBLE (IN ATTIC OR SOFFIT), BALANCE DAMPER IS TO BE LOCATED SUCH THAT IT IS ACCESSIBLE FROM FACE OF AIR DEVICE. 4.6. HVAC CONTRACTOR RESPONSIBLE FOR ALL DUCTWORK TRANSITIONS AND FITTINGS AS
- REQUIRED FOR FINAL CONNECTIONS TO HVAC EQUIPMENT.
- UNLESS NOTED OTHERWISE ON PLANS, FLEXIBLE DUCT CONNECTIONS MAY USED FROM 4.7. BRANCH DUCTS TO FINAL AIR DEVICES, BUT SHALL NOT EXCEED 8'-0" IN LENGTH, FLEXIBLE DUCT CONNECTORS MUST BE SUPPORTED PER PLAN DETAILS.

5. <u>INSULATION</u>

- 5.1. DUCTWORK 5.1.1. SEE "TYPICAL DUCT INSULATION DIAGRAM" FOR INSTALLATION SPECIFIC
- REQUIREMENTS. 5.1.2. INTERNAL DUCT LINER TO BE CLOSED CELL ELASTOMERIC.
- 5.1.3. EXTERNAL DUCT WRAP TO INCLUDE VAPOR BARRIER. EQUAL TO 'JOHNS MANVILLE MICROLITE' WITH FSK JACKET.
- 5.2. **REFRIGERANT PIPING** 5.2.1. SPLIT SYSTEM (SUCTION LINE ONLY) - 1" CLOSED CELL ELASTOMERIC FOAM (EQUAL TO 'ARMAFLEX AP').
- VRV/VRF SYSTEMS (BOTH SUCTION AND HOT GAS LINES) 1 ½" EPDM (EQUAL TO 'AEROFLEX 5.3. AEROCEL AC') WITHIN CONDITIONED SPACES & 2" EDPM (EQUAL TO 'AEROFLEX AEROCEL AC') IN UNCONDITIONED SPACES, AND WITH BANDED ALUMINUM SHIELDING IN EXTERIOR SPACES.


5.4. CONDENSATE PIPING

5.4.1. SPLIT SYSTEMS - WHERE CONDENSATE PIPING IS LOCATED IN UNCONDITIONED SPACE, INSULATE WITH $\frac{1}{2}$ " ELASTOMERIC. NO INSULATION REQUIRED WITHIN CONDITIONED SPACES.


5.4.2. VRV/VRF - INSULATE WITH 1/2" ELASTOMERIC.


6. TESTING AND BALANCING


- 6.1. ALL SYSTEMS MUST BE BALANCED TO WITHIN 10% OF VALUES INDICATED ON PLAN.
- HVAC CONTRACTOR TO PROVIDE WRITTEN BALANCE REPORT INCLUDING FLOW VALUES 6.2. INDICATED ON PLANS, INITIAL MEASURED FLOW VALUES, AND FINAL MEASURED VALUES.
- THIRD PARTY CERTIFIED TEST AND BALANCE NOT REQUIRED UNLESS OTHERWISE NOTED 6.3. ON PLANS OR WITHIN PROJECT MANUAL.

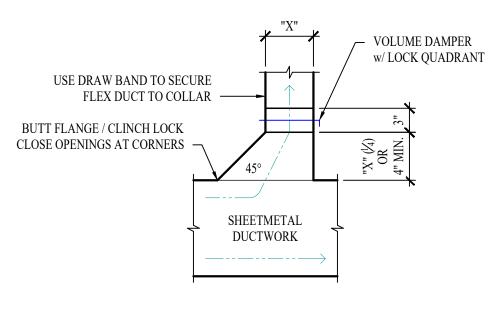

TYPICAL 45° TAKEOFF DETAIL

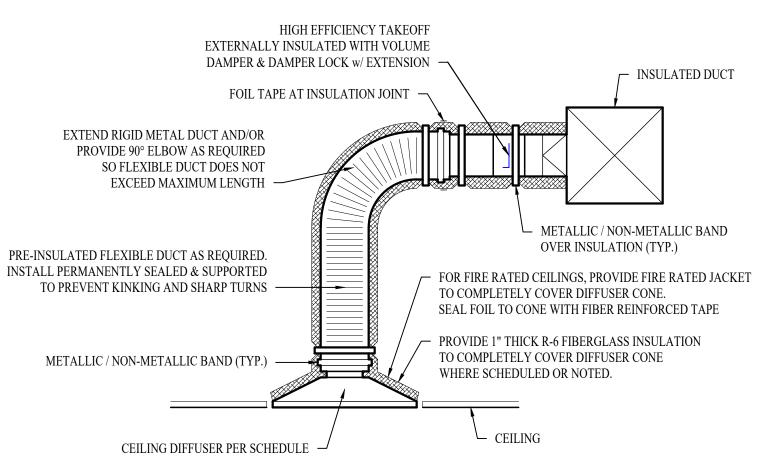

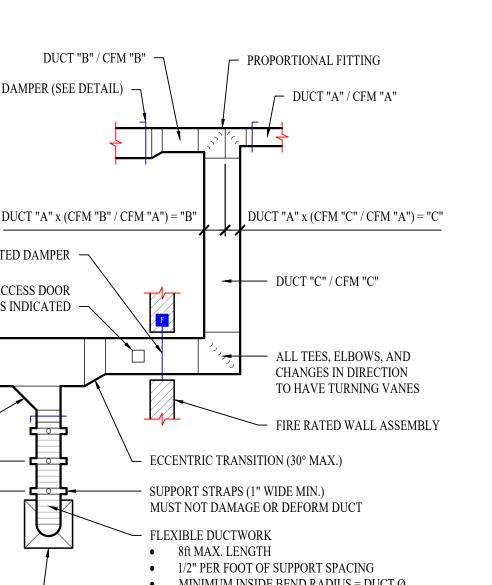

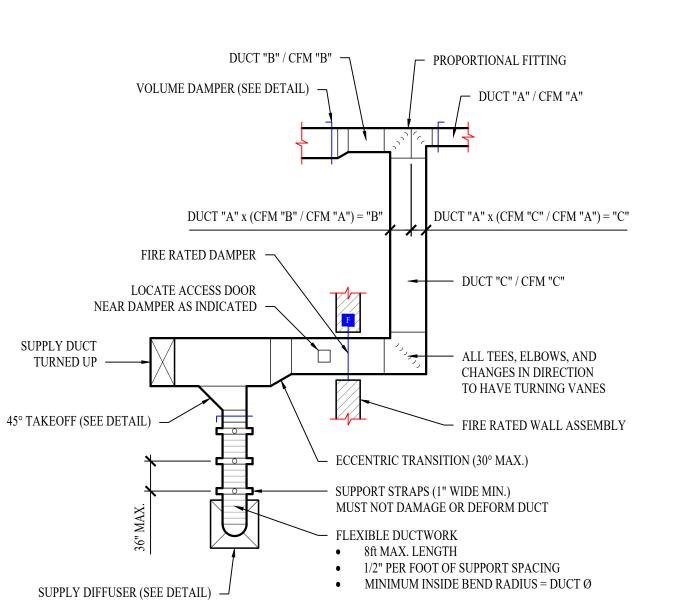

TYPICAL DUCTWORK DETAIL

TYPICAL LAY-IN DIFFUSER DETAIL

RTU SCHEDULE														
TAG	EQUIPMENT DESCRIPTION	S IZE (TONS)	ORIENTATION	TOTAL AIRFLOW (CFM)	OA AIRFLOW MAX/MIN (CFM)	GAS HEATING		COOLING (IA: 80 DB/67 WB, OA: 95 DB)			ELECTRICAL			
						INPUT (kBTU)	OUTPUT (kBTU)	SENSIBLE (KBTU)	TOTAL (KBTU)	MIN. EFFICIENCY	VOLTS / PHASE	МСА	OCP	NOTES
RTU-1	ROOF TOP UNIT	3	DOWN FLOW	1200	165 / 165	80	64.8	29.9	37.1	15.4 SEER	208/3	20	30	1, 2, 3, 4, 5, 8, 9
RTU-2	ROOF TOP UNIT	10	DOWN FLOW	4000	290 / 290	200	160	96.8	116.3	11.2 EER/12.7 IEER	208/3	49	60	1, 2, 3, 4, 5, 6, 7, 8, 9
RTU-3	ROOF TOP UNIT	15	DOWN FLOW	6000	690 / 690	350	280	139.1	186.1	11.0 EER/12.2 IEER	208/3	69	90	1, 2, 3, 4, 5, 6, 7, 8, 9
NOTES: 1. PROVIDE AND INSTALL 7 DAY PROGRAMABLE HONEYWELL THERMOSTAT. COORDINATE EXACT MOUNTING LOCATION WITH OWNER. 2. WITH FACTORY HAIL GUARD. 3. WITH FACTORY INSTALLED DISCONNECT.														

4. ECONOMIZER WITH BAROMETRIC RELIEF SIZED AT 100% OF FLOW at 1/10" WC (OR PROVIDE POWERED EXHAUST). CONTROL TO BE ADJUSTABLE FIXED POINT SET A T 65°F. ECONOMIZER TO BE IECC COMPLIANT

WITH FAULT DETECTION AND NOTIFICATION.

5. WITH POWERED WEATHERPROOF GFCI RECEPTACLE.


6. WITH HOT GAS REHEAT/DEHUMIDIFICATION OPTION.

7. WITH SMOKE DETECTOR IN RETURN AIR DUCT TO SHUT DOWN UNIT AND SEND SIGNAL TO BUILDING FIRE ALARM SYSTEM UPON DETECTION OF SMOKE. IF NO BUILDING FIRE ALARM SYSTEM IS PRESENT, PROVIDE ALARM DEVICE IN OCCUPIED AREA.

8. MOTORIZED OUTSIDE AIR / ECONOMIZER SHALL BE PROGRAMMED TO OPERATE DURING OCCUPIED HOURS. 9. WITH CURB-MOUNTED SCREENING SYSTEM EQUAL TO CURBS-PLUS NUVIEW WITH SMOOTH PANEL PROFILE, FLAT TRIM, STANDARD COLOR DETERMINED BY ARCHITECT

	AIR DEVICE SCHEDULE								
TAG	SERVICE	MANUFACTURER (OR EQUAL)	MODEL (OR EQUAL)	SIZE	COLOR / FINISH	NOTES			
S 1	SUPPLY	PRICE	SPD	24x24	WHITE				
S2	SUPPLY	PRICE	520	8x4	WHITE				
R1	RETURN	PRICE	80	24x24	WHITE				
EX1	EXHAUST	PRICE	80	24x24	WHITE				
EX2	EXHUA ST	PRICE	80	12x12	WHITE				
EX3	EXHAUST	PRICE	530	8x8	WHITE				
NOTES:									



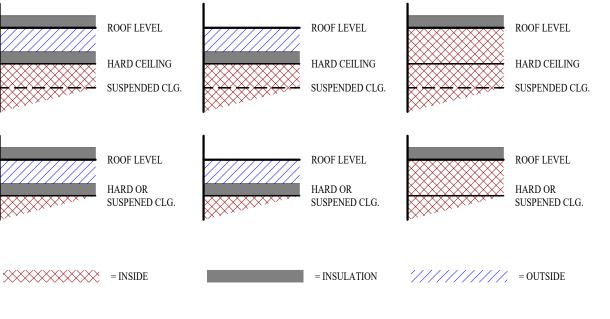

DUCT INSIDE THERMAL ENVELOPE INSULATION REQUIREMENTS

REC	TANGULAR
•	SUPPLY =
•	RETURN =
•	EXHAUST =
•	OUTSIDE AIR =

- ROUND SUPPLY =
- RETURN = EXHAUST = • OUTSIDE AIR =
- SPIRAL
- SUPPLY = RETURN =
- EXHAUST = • OUTSIDE AIR =
- 1½" WRAP NONE NONE 2" WRAP NONE

1" LINER

1" LINER

2" WRAP

NONE

- NONE NONE 2" WRAP
- SUPPLY = RETURN = • EXHAUST = • OUTSIDE AIR =
- ROUND • SUPPLY = RETURN = • EXHAUST = • OUTSIDE AIR =
- SPIRAL • SUPPLY = • RETURN = EXHAUST = OUTSIDE AIR =

1" LINER & 1½" WRAP 1" LINER & 1½" WRAP 1½" WRAP NONE

2" WRAP 2" WRAP 1½" WRAP NONE

2" WRAP 2" WRAP 1½" WRAP


NONE


TYPICAL BUILDING INTERIOR DUCT INSULATION DIAGRAM

DUCT OUTSIDE THERMAL ENVELOPE INSULATION REQUIREMENTS RECTANGULAR

1. VERIFY AIR DEVICE FINISHES WITH OWNER/ARCHITECT PRIOR TO INSTALLATION

	EF SCHEDULE								
TAG	EQUIPMENT DES CRIPTION	ORIENTATION	TOTAL AIRFLOW (CFM)	W		NOTES			
			(Crwi)	VOLTS/PH	MCA	ОСР			
EF-1	EXHAUST FAN	INLINE	900	120	2.2	20-1	2		
EF-2	EXHAUST FAN	INLINE	150	120	0.72	20-1	1		
NOTES:	NOTES:								
1.	1. EQUAL TO S&P TD-125 WITH SPEED CONTROLLER								
2.	EQUAL TO S&P TD-3	15HS WITH SPEED	CONTROLLEI	3					

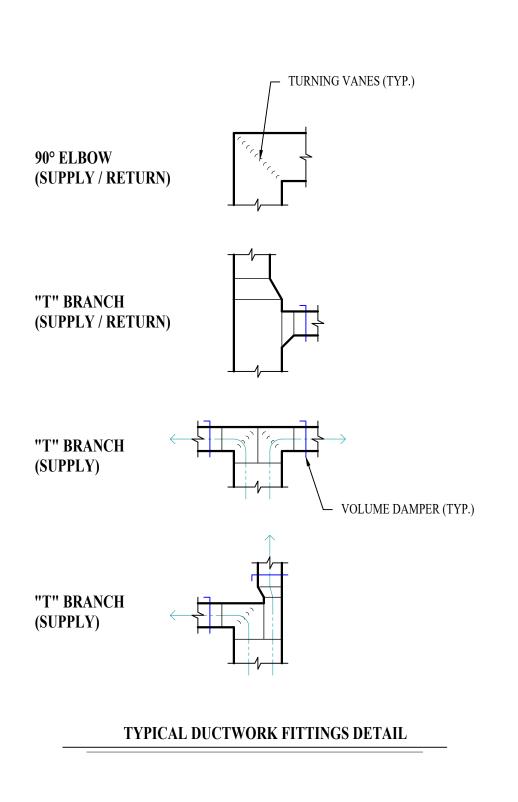

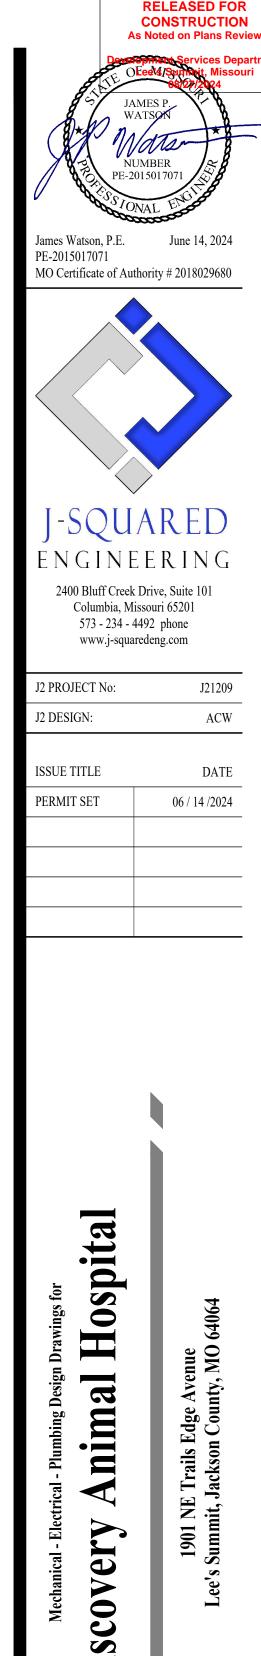


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SHEET TITLE

SHEET NUMBER

HVAC DETAILS &

SCHEDULES

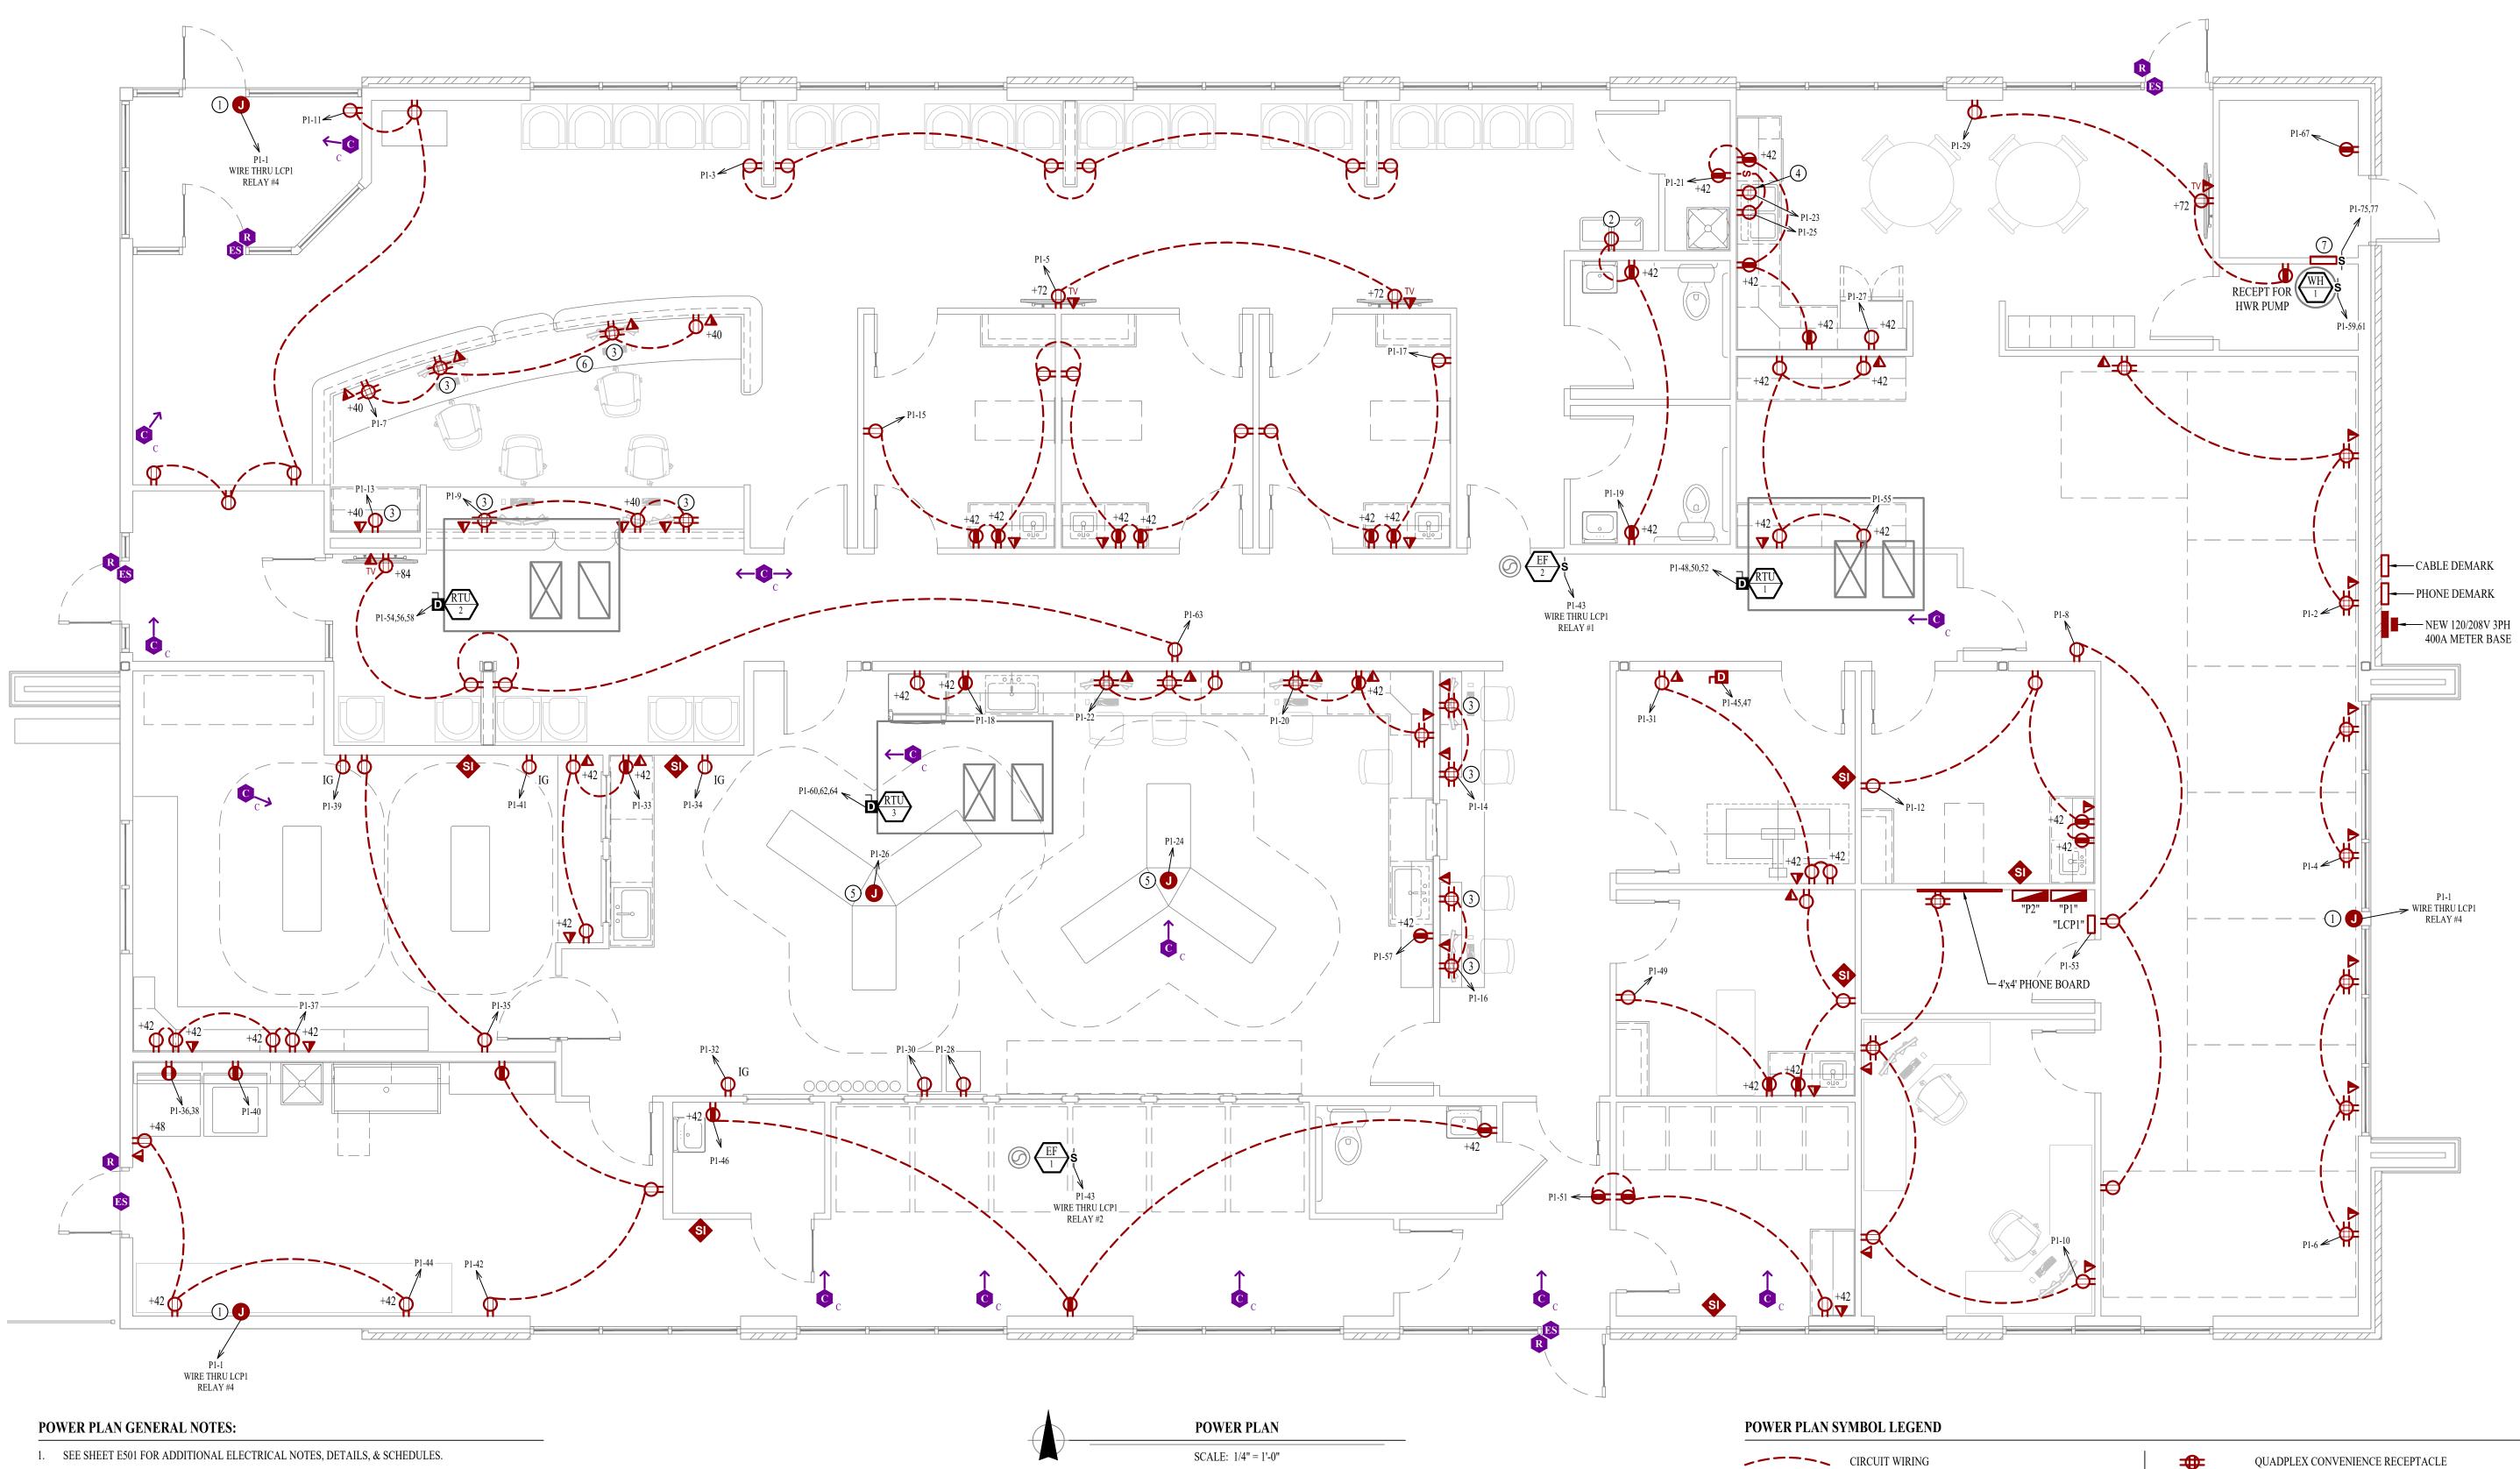

1. SEE SHEET E501 FOR ADDITIONAL ELECTRICAL NOTES, DETAILS, & SCHEDULES.

POWER PLAN KEY NOTES:


- (1) J-BOX IN INTERIOR SIDE OF WALL ABOVE CANOPY HEIGHT FOR EXTERIOR ILLUMINATED SIGNAGE. ELECTRICAL CONTRACTOR TO VERIFY EXACT HEIGHT AND LOCATION WITH OWNER/ARCHITECT PRIOR TO INSTALLATION.
- (2) CIRCUIT DRINKING FOUNTAIN RECEPTACLE DOWNSTREAM OF GFCI RECEPTACLE SO THAT DRINKING FOUNTAIN RECEPTACLE IS GFCI PROTECTED.
- (3) PROVIDE 2" BLACK DESK GROMMET.
- (4) OUTLET IN BASE CABINET FOR DISHWASHER.
- (5) CONNECT TO TENANT SUPPLIED MED TOWER.
- 6 INSTALL PUSH BUTTON OVERRIDE FOR RELEASING ELECTRIC STRIKE AT FRONT DOOR. COORDINATE LOCATION WITH TENANT.
- (7) 208V, 1PH, 3KW BERKO WALL HEATER EQUAL TO VFK404

→ PX-XX CIRCUIT TAG J JUNCTION BOX XX +42 RECEPTACLE INDICATES MOUNTING HEIGH (STANDARD @ 18" AFF UNLES └── "WP" = WEATHERPROOF OUTI "AW" = ABOVE WINDOW REC "AC" = ABOVE CEILING RECE "EX" = EXISTING RECEPTACL "IG" = ISOLATED GROUND GFCI DUPLEX CONVENIENCE 208V RECEPTACLE WALL MOUNT CAMERA C (ARROW INDICATES VIEW DIF C CEILING MOUNT CAMERA

CIRCUIT WIRING	₩	QUADPLEX CONVENIENCE RECEPTACLE
CIRCUIT TAG	Ψ	USB OUTLET
JUNCTION BOX	V	DATA / PHONE JACK
RECEPTACLE		BOX WITH 1" CONDUIT & PULL STRING) UP TO CEILING SPACE (STANDARD @ 18" AFF UNLESS NOTED OTHERWISE)
 INDICATES MOUNTING HEIGHT TO BOTTOM OF BOX (STANDARD @ 18" AFF UNLESS NOTED OTHERWISE) 	AP	WIRELESS ACCESS POINT, CEILING MOUNTED
 "WP" = WEATHERPROOF OUTDOOR RECEPTACLE "AW" = ABOVE WINDOW RECEPTACLE "AC" = ABOVE CEILING RECEPTACLE 	₽	FLOOR RECEPTACLE
"EX" = EXISTING RECEPTACLE TO REMAIN "IG" = ISOLATED GROUND	V	FLOOR DATA
GFCI DUPLEX CONVENIENCE RECEPTACLE	Dh	DISCONNECT
208V RECEPTACLE	SI	STEREO & INTERCOM CONTROL. ELECTRICAL CONTRACTOR TO INSTALL WIRING, TENANT TO SUPPLY STEREO/INTERCOM SYSTEM.
WALL MOUNT CAMERA (ARROW INDICATES VIEW DIRECTION)	R	READER
CEILING MOUNT CAMERA (ARROW INDICATES VIEW DIRECTION)	ES	ELECTRIC STRIKE

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	MES P. ATSON JMBER 015017071							
James Watson, P.E. June 14, 2024 PE-2015017071 MO Certificate of Authority # 2018029680								
J-SQU								
ENGINE 2400 Bluff Creek Columbia, M 573 - 234 - 4 www.j-squa	Drive, Suite 101 issouri 65201 4492 phone							
J2 PROJECT No:	J21209							
J2 DESIGN:	ACW							
ISSUE TITLE	DATE							
PERMIT SET	06 / 14 /2024							

[ospital \mathbf{f} H nue MO nimal Ave S Ľ Discovery 1901 nical - Ele Me SHEET TITLE **POWER PLAN** SHEET NUMBER **EP101**

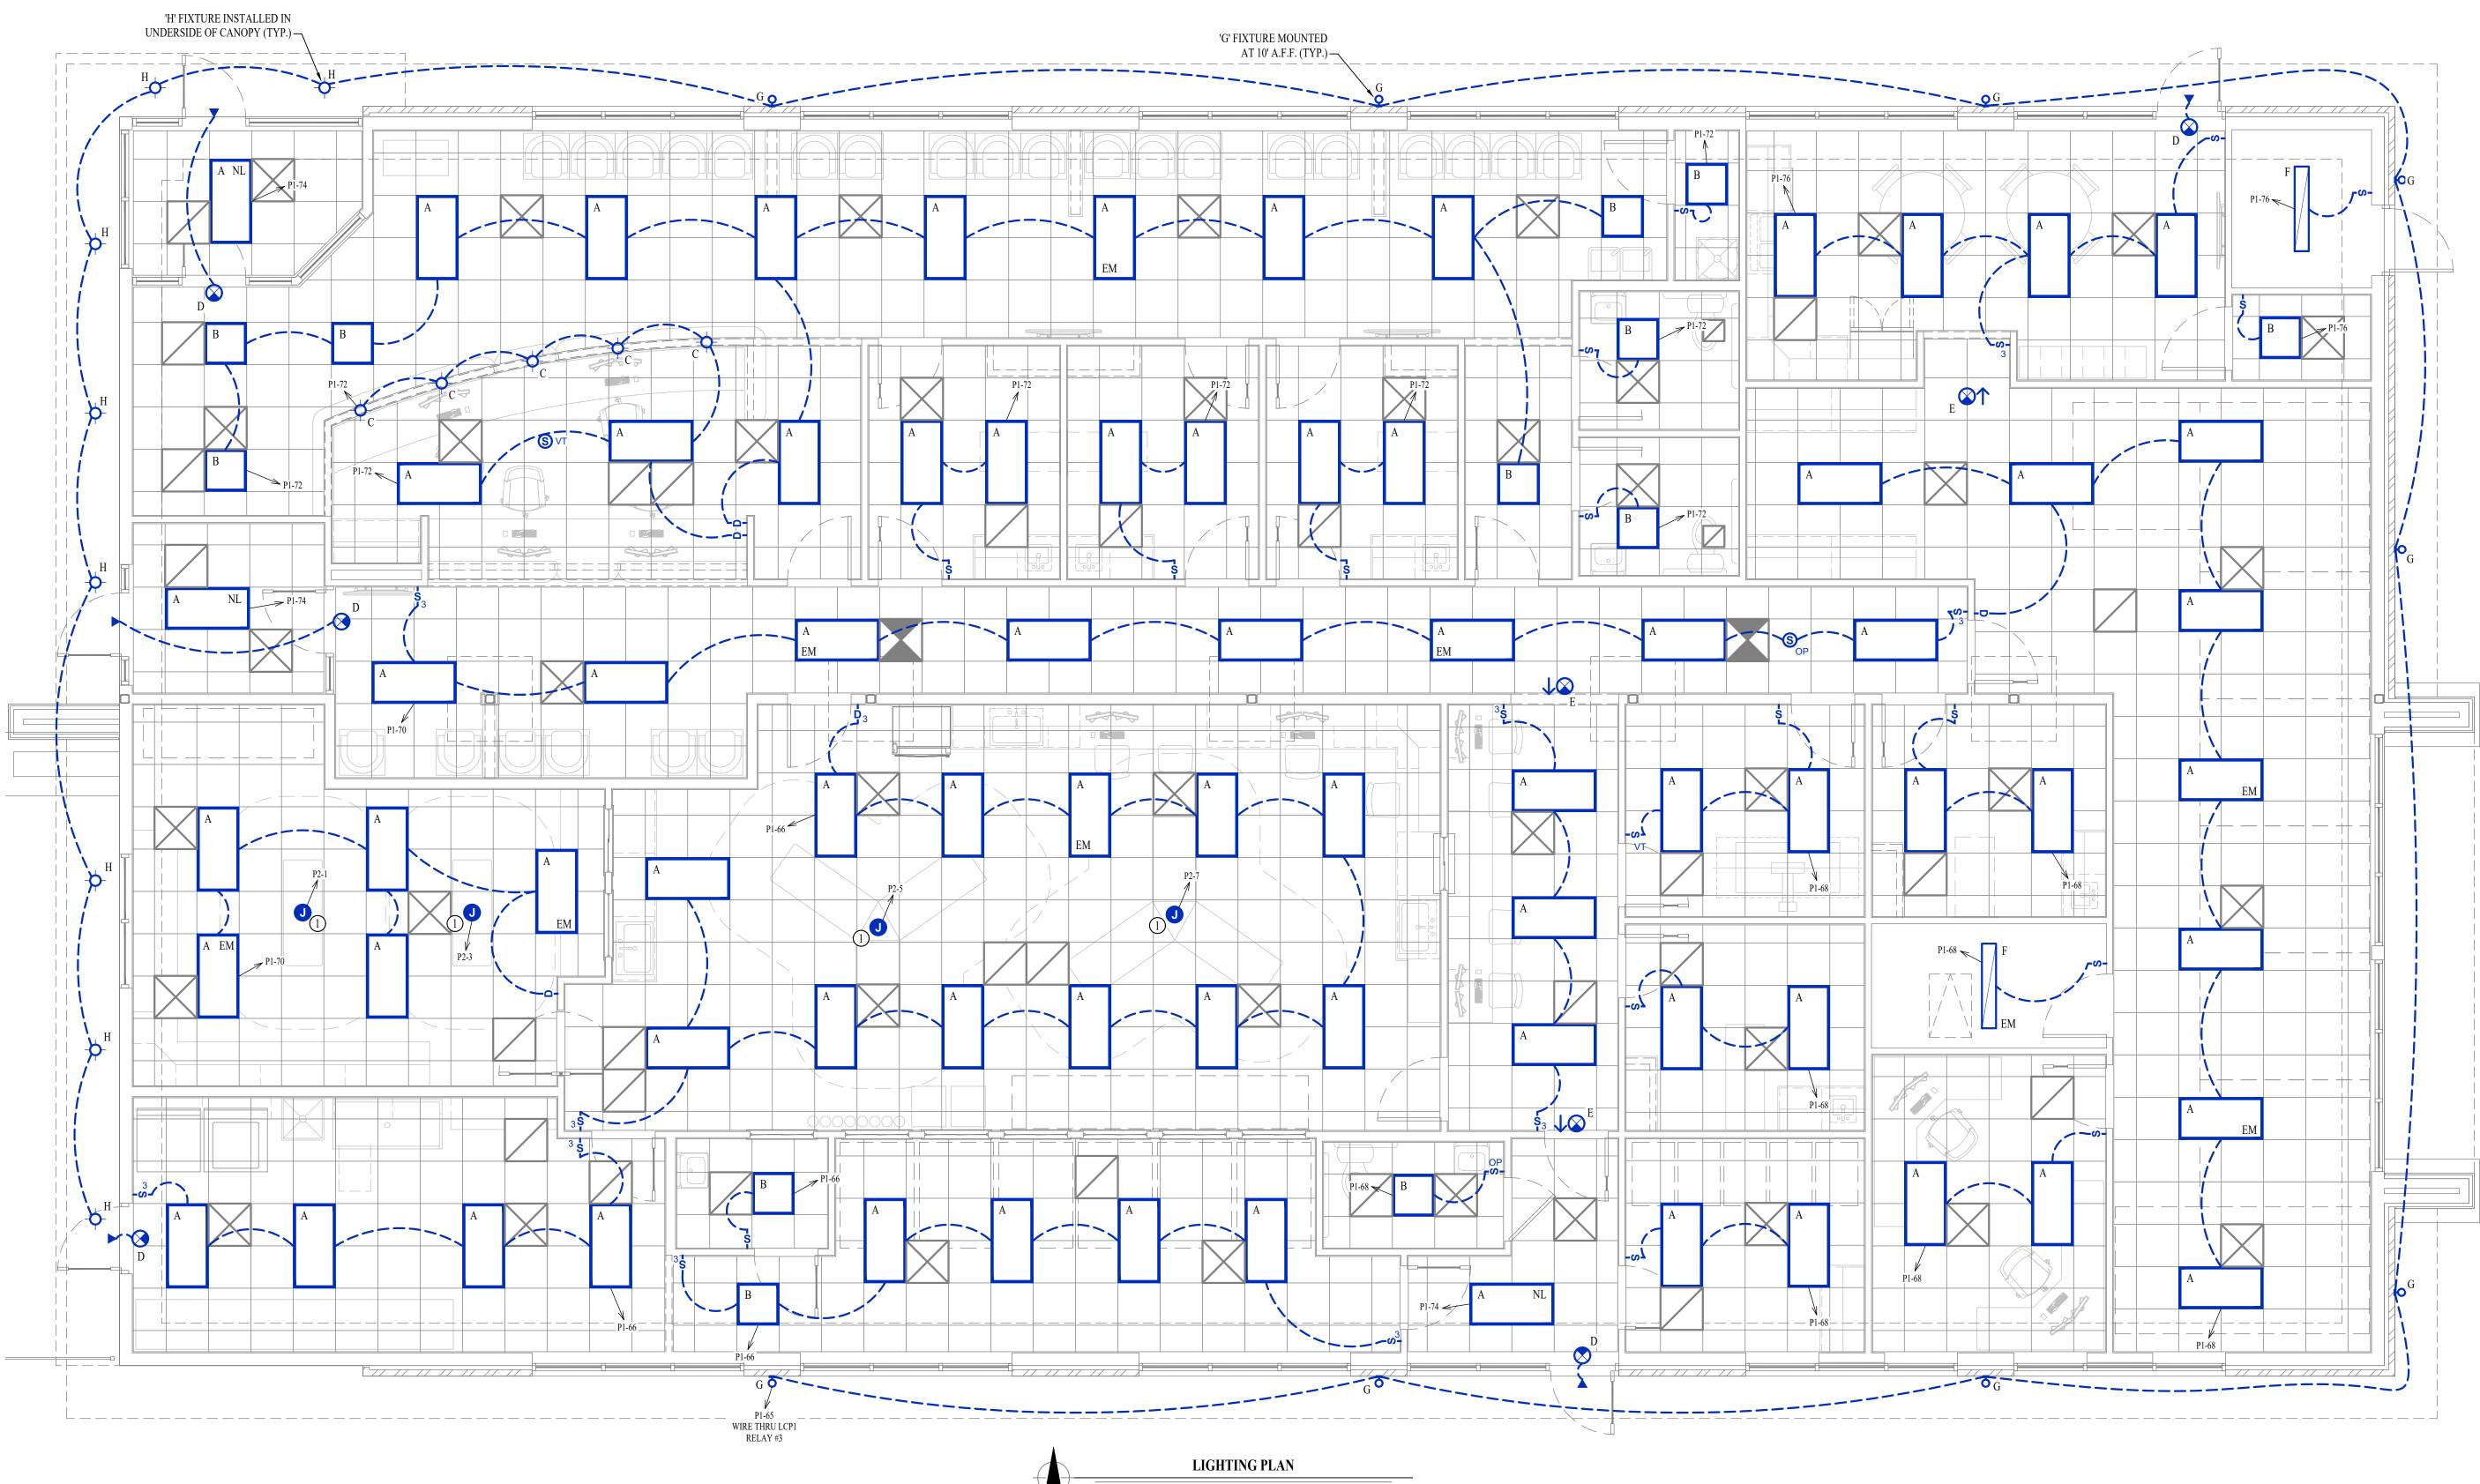

LIGHTING PLAN GENERAL NOTES:

1. SEE SHEET E501 FOR ADDITIONAL ELECTRICAL NOTES, DETAILS, & SCHEDULES.

LIGHTING PLAN KEY NOTES:

(1) POWER FOR EXAM LIGHTING; COORDINATE EXACT LOCATION & REQUIREMENTS WITH G.C.

SCALE: 1/4" = 1'-0"

LIGHTING PLAN SYMBOL LEGEND

X1 - "X1" INDICATES FIXTURE TYPE (REFER TO SCHEDULE) LIGHTING FIXTURE ----- "EM" INDICATES EMERGENCY BATTERY BACKUP EM ----- "NL" INDICATES UN-SWITCHED NIGHT LIGHT NL EXIT LIGHT └── INDICATES REQUIRED REMOTE HEAD EMERGENCY EGRESS LIGHT SWITCH (WALL MOUNTED) — SWITCH TYPE: • 3 = 3-WAY • 4 = 4-WAY • OP = PASSIVE INFRARED OCCUPANCY SENSOR

• OT = DUAL-TECHNOLOGY OCCUPANCY SENSOR • VP = PASSIVE INFRARED VACANCY SENSOR • VT = DUAL-TECHNOLOGY VACANCY SENSOR • M = MOMENTARY SWITCH

DIMMER SWITCH (WALL MOUNTED)

SWITCH TYPE: • SEE "SWITCH (WALL MOUNTED)" FOR TYPE DESIGNATIONS

- S_X SWITCH (CEILING MOUNTED)
 - SWITCH TYPE: • SEE "SWITCH (WALL MOUNTED)" FOR TYPE DESIGNATIONS

OCCUPANCY SENSOR

- AUTO FULL-ON (OR 50% IF NOTED)
- AUTOMATICALLY TURN OFF LIGHTING AFTER 20 MINUTES WITHOUT OCCUPANT DETECTION
- WITH MANUAL OVERRIDE CONTROL (IF NOTED)

VACANCY SENSOR

- MANUAL FULL-ON
- AUTOMATICALLY TURN OFF LIGHTING AFTER 20 MINUTES WITHOUT OCCUPANT DETECTION
- WITH MANUAL OVERRIDE CONTROL (IF NOTED)

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	ATSON ATSON UMBER 015017071
James Watson, P.E. PE-2015017071 MO Certificate of Au	June 14, 2024 thority # 2018029680
J-SQU ENGINE 2400 Bluff Creek Columbia, M 573 - 234 - 4 www.j-squa	E E R I N G Drive, Suite 101 issouri 65201 4492 phone
J2 PROJECT No:	J21209
J2 DESIGN:	ACW
ISSUE TITLE	DATE
PERMIT SET	06 / 14 /2024

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]	PANEL	'P2' SCH	IEDUL	E	
	VOLTAGE	PANE	L SIZE	MOUN	NTING	AIC RATING	
	208Y/120V 3-PH	100A	SURI	10,000			
	NEMA RATING: 1						
CIRCUIT NUMBER	DESCRIPTION	BREAKER SIZE	AMPS	PHASE	AMPS	BREAKER SIZE	
1	EXAM LIGHTING	20-1	5	А			
3	EXAM LIGHTING	20-1	5	В			
5	EXAM LIGHTING	20-1	5	С			
7	EXAM LIGHTING	20-1	5	А			Γ
9	SPARE	20-1		В			
11	SPARE	20-1		C			Γ
13	SPARE	20-1		А			
15	SPARE	20-1		В			Γ
17	SPARE	20-1		C			
19	SPARE	20-1		А			Γ
21	SPARE	20-1		В			
23	SPARE	20-1		С			Γ
25	SPARE	20-1		А			
27	SPARE	20-1		В			Γ
29	SPARE	20-1		С			
31	SPARE	20-1		А			
33	SPARE	20-1		В			
35	SPARE	20-1		С			
37	SPARE	20-1		А			
39	SPARE	20-1		В			1
41	SPARE	20-1		С			

A: PANEL SHALL BE EQUAL TO SQUARE D MODEL "QO"

B: ELECTRICIAN SHALL VERIFY BREAKER WITH EQUIPMENT PRIOR TO PURCHASE & INSTALL.

C: AFTER COMPLETION OF WORK, ELECTRICAN SHALL PROVIDE A TYPE WRITTEN PANEL DIRECTORY IN NEW PANEL.

	LIGHT FIXTURE SCHEDULE									
TAG	MANUFACTURER (OR EQUAL)	MODEL NUMBER (OR EQUAL)	DESCRIPTION	MOUNTING	LUMEN OUTPUT	CCT (°K)	CRI	VOLTS	WATTS	NOTES
А	METALUX	24FPSL2SCT3	2X4 LED FLAT PANEL	CEILING / GRID	6300	3500	80	120	56	WITH 'EL14W' BATTERY BACKUP WHERE INDICATED
В	METALUX	22FPSL2SCT3	2X2 LED FLAT PANEL	CEILING / GRID	3440	3500	80	120	31	
С	HALO	HLB4069FS1E	4" LED CAN	RECESSED	600	3500	80	120	12	
D	SURE LITES	APCH7R WITH APWR1	INTERIOR EXIT LIGHT WITH EXTERIOR REMOTE HEAD	CEILING	-	-	-	120	1	WITH RED LETTERS
E	SURE LITES	APC7R	INTERIOR EXIT LIGHT WITH HEADS	WALL / CEILING	-	-	-	120	1	WITH RED LETTERS
F	METALUX	4SNLED-LD5-48SL-UNV-L835LB	4' LED STRIP	SURFACE	4827	3500	80	120	35	
G	TECH LIGHTING	7000WVEX9404ZUNV	UP / DOWN SCONCE	WALL	554	4000	90	120	19	
Н	HALO	SLD612940WHUNVWITH SLD6TRMWH	SURFACE MOUNT DISK	SURFACE	1000	4000	92	120	15	FIELD PAINTED
NOTES: 1.										
	 VERIFY LIGHT FIXTURE FINISHES WITH OWNER / ARCHITECT PRIOR TO INSTALLATION CONTACT JUSTIN HATFIELD (573) 289-0880 (JHATFIELD@LAIWEB.NET) OR PAUL WARNER (314) 531-3500 (PWARNER@LAIWEB.NET) AT LIGHTING ASSOCIATES, INC. FOR NATIONAL ACCOUNT DETAILS. CONTACT TRAVIS VOGT (417) 621-5210 (TVOGT@CED1135.COM) AT CED-PHILLIPS & COMPANY FOR NATIONAL ACCOUNT DETAILS. 									


PHASE "A" LOAD	10
PHASE "B" LOAD	5
PHASE "C" LOAD	5
DESCRIPTION	CIRCUIT NUMBER
BLANK	2
BLANK	4
BLANK	6
BLANK	8
BLANK	10
BLANK	12
BLANK	14
BLANK	16
BLANK	18
BLANK	20
BLANK	22
BLANK	24
BLANK	26
BLANK	28
BLANK	30
BLANK	32
BLANK	34
BLANK	36
BLANK	38
BLANK	40
BLANK	42

		I	PANEL	'P1' SCH	IEDUL	E		
	VOLTAGE	PANEI	SIZE	MOUN	ITING	AIC RATING		
208Y/120V 3-PH				SURFACE			PHASE "A" LOAD	312.7
	2081/120V 3-PH	400A MCB				10,000	PHASE "B" LOAD	346
	NEMA RATING: 1						PHASE "C" LOAD	351
CIRCUIT NUMBER	DESCRIPTION	BREAKER SIZE	AMPS	PHASE	AMPS	BREAKER SIZE	DESCRIPTION	CIRCU NUMBI
1	EXTERIOR SIGNAGE	20-1	12	А	9	20-1	OPEN OFFICE OUTLETS	2
3	WAITING AREA OUTLETS	20-1	9	В	6	20-1	OPEN OFFICE OUTLETS	4
5	WAITING ROOM T.V.	20-1	3	С	9	20-1	OPEN OFFICE OUTLETS	6
7	CHECK IN DESK	20-1	10.5	А	4.5	20-1	OPEN OFFICE OUTLETS	8
9	CHECK IN DESK	20-1	7.5	В	9	20-1	OFFICE / STORAGE OUTLETS	10
11	WAITING ROOM OUTLETS	20-1	7.5	С	6	20-1	CAT ROOM OUTLETS	12
13	WAITING ROOM PRINTER	20-1	12	А	6	20-1	CORR-2 DESK OUTLETS	14
15	EXAM ROOM OUTLETS	20-1	12	В	6	20-1	CORR-2 DESK OUTLETS	16
17	EXAM ROOM OUTLETS	20-1	6	С	9	20-1	TREATMENT ROOM OUTLETS	18
19	BATHROOM / DRINKING FOUNTAIN OUTLETS	20-1	9	А	7.5	20-1	TREATMENT ROOM OUTLETS	20
21	BREAK ROOM OUTLETS	20-1	6	В	7.5	20-1	TREATMENT ROOM OUTLETS	22
23	DISHWASHER	20-1	6	С	3	20-1*	MED TOWER	24
25	GARBAGE DISPOSAL	20-1	6	А	3	20-1*	MED TOWER	26
27	BREAK ROOM REF.	20-1	6	В	1.5	20-1	TREATMENT ROOM OUTLET	28
29	BREAK ROOM OUTLETS	20-1	4.5	С	1.5	20-1	TREATMENT ROOM OUTLET	30
31	X-RA Y ROOM OUTLETS	20-1	4.5	А	1.5	20-1	TREATMENT ROOM OUTLET	32
33	SURGERY ROOM OUTLETS	20-1	4.5	В	1.5	20-1	TREATMENT ROOM OUTLET	34
35	SURGERY ROOM OUTLETS	20-1	3	С	20	30-2	DRYER	36
37	SURGERY ROOM OUTLETS	20-1	6	А	20	-	-	38
39	SURGERY ROOM OUTLET	20-1	1.5	В	12	20-1	WASHER	40
41	SURGERY ROOM OUTLET	20-1	1.5	С	3	20-1	WORK AREA OUTLETS	42
43	EXHAUST FANS	20-1	3	Α	4.5	20-1	WORK AREA OUTLETS	44
45	X-RA Y EQUIPMENT	80-2	64	В	4.5	20-1	DOG KENNEL OULETS	46
47	-	_	64	C	20	30-3	RTU#1	48
49	ULTRA SOUND CAT ROOM OUTLETS	20-1	7.5	A	20	-	-	50
51	OUTLETS	20-1	4.5	В	20	_	<u>-</u>	52
53	LCP1	20-1	1.5	C	49	60-3	RTU#2	54
55	BUSINESS AREA OUTLETS	20-1	6	A	49	-	-	56
57	TREA TMENT ROOM OUTLETS	20-1	1.5	B	49		_	58
59	WATER HEATER	25-2	1.5	C	69	90-3	RTU#3	60
61	-	-	19	A	69	-	-	62
63	HALLWAYOUTLETS	20-1	6	B	69	-		64
65	EXTERIOR LIGHTING	20-1	2.5	C	10	20-1	LIGHTING	66
67	MECH. ROOM OUTLETS	20-1	1.5	A	10.7	20-1	LIGHTING	68
69	PANEL "P2"	100-3	1.0	В	8.5	20-1	LIGHTING	70
71	-	-	5	C	10	20-1	LIGHTING	72
73	-	-	5	A	2	20-1	VESTIBULE LIGHTS	72
75	- WALL HEATER	25-2	16	B	3	20-1	LIGHTING	74
77	-	-	10	C	4	20-2	POLE LIGHTS	70
79	- SPARE	- 20-1	14	A	4	-		80
81	SPARE	20-1		B	+	-	- OPEN	80
83	SPARE	20-1		C B			OPEN	84
NOTES:	UT AINL	20-1					UT LAN	L 04

B: ELECTRICIAN SHALL VERIFY BREAKER WITH EQUIPMENT PRIOR TO PURCHASE & INSTALL.

C: AFTER COMPLETION OF WORK, ELECTRICAN SHALL PROVIDE A TYPE WRITTEN PANEL DIRECTORY IN NEW PANEL. D: *INDICATES GFCI BREAKER

	RELEASED FOR CONSTRUCTION As Noted on Plans Review							
CALLER AND	OEeels/Summit, Missouri 98/07/2024							
NUMBER PE-2015017071								
James Watson, P.E. June 14, 2024 PE-2015017071 MO Certificate of Authority # 2018029680								
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Columbia, 573 - 234	eek Drive, Suite 101 Missouri 65201 - 4492 phone juaredeng.com							
J2 PROJECT No:	J21209							
J2 DESIGN:	ACW							
ISSUE TITLE	DATE							
PERMIT SET	06 / 14 /2024							

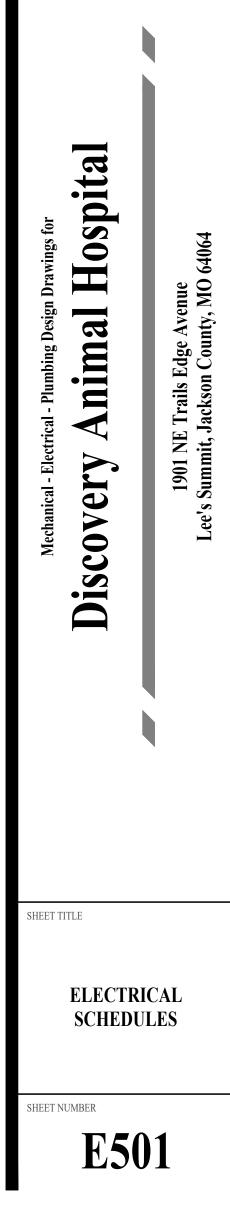

ELECTRICAL SPECIFICATIONS

1. <u>GENERAL</u>


- CONTRACTOR IS RESPONSIBLE TO PROVIDE ALL NECESSARY PIECES AND COMPONENTS TO 1.1. PROVIDE A COMPLETE AND COMPLIANT ELECTRICAL SYSTEM UNLESS OTHERWISE NOTED ON PLANS.
- 1.2. THE ENTIRE ELECTRICAL SYSTEM SHALL BE CONTINUOUSLY GROUNDED. EVERY BRANCH CONDUIT SHALL INCLUDE A GREEN GROUND CONDUCTOR SIZED PER NEC.
- ARC-FAULT CIRCUITS SHALL BE RUN WITH A DEDICATED NEUTRAL AS REQUIRED BY 1.3. MANUFACTURER.
- PROVIDE PERMANENT ARC-FLASH LABEL AFFIXED TO EVERY DISCONNECT AND PANEL. 1.4. PROVIDE TYPE WRITTEN PANEL SCHEDULE FOR EACH PANEL. 1.5.


2. WORKMANSHIP

- ALL ELECTRICAL SYSTEM COMPONENTS SHALL BE INSTALLED LEVEL, PLUMB, AND 2.1. PARALLEL/PERPENDICULAR TO BUILDING ORIENTATION WHERE POSSIBLE.
- 2.2. ALL ELECTRICAL DEVICES AND LIGHT FIXTURES SHALL BE INSTALLED IN A SAFE, FIRST-CLASS MANNER WITH ATTENTION GIVEN TO OVERALL AESTHETICS.
- CARE SHOULD BE TAKEN TO ALLOW FOR FUTURE REPLACEMENT AND ACCESS FOR SERVICE.
- 3. MATERIALS 3.1. CONDUIT & CONDUCTORS
- ALL CONDUCTORS SIZES INDICATED ARE COPPER UNLESS NOTED OTHERWISE ON 3.1.1. PLANS.
- 3.1.2. ABOVE GRADE CONDUCTORS SHALL BE TYPE THHN.
- BELOW GRADE CONDUCTORS SHALL BE TYPE XHHW-2. MINIMUM CONDUCTOR SIZE SHALL BE #12 AWG UNLESS NOTED OTHERWISE. 120-VOLT, 3.1.3. 20-AMP CIRCUITS WITH CONDUCTOR LENGTHS GREATER THAN 100' SHALL BE #10 AWG MINIMUM. ELECTRICAL CONTRACTOR IS RESPONSIBLE FOR MEASURING ACTUAL CONDUCTOR LENGTH AND INCREASING CONDUCTOR SIZE TO COMPENSATE FOR VOLTAGE DROP AS REQUIRED BY NEC.
- 3.1.4. RIGID GALVANIZED OR SCHEDULE 40 PVC CONDUIT SHALL BE USED FOR SERVICE WIRING, BELOW GRADE INSTALLATIONS, OR WHERE EXPOSED TO WEATHER.
- IN APPLICATIONS OTHER THAN THOSE LISTED IN 3.1.4, EMT OR MC CABLE IS 3.1.5. ACCEPTABLE. WHERE CONDUCTORS ARE PROTECTED FROM DAMAGE, ENCLOSED IN BUILDING MATERIALS, AND CONSTRUCTION IS OF A PERMITTED TYPE, NM CABLE MAY BE USED.
- FOR CAST-IN-PLACE CONCRETE, TILT-UP WALL CONSTRUCTION, OR 3.1.6. PRE-MANUFACTURED WALL SYSTEMS, COORDINATE EXACT LOCATIONS OF ALL DEVICES WITHIN WALLS WITH WALL SUPPLIER. CONDUIT EMBEDDED IN WALLS SHALL BE SCHEDULE 80 PVC OR LFMC, OR OTHER SYSTEM APPROVED BY WALL MANUFACTURER.
- 3.1.7. EXPOSED CONDUIT SHALL BE PAINTED TO MATCH ADJACENT SURFACES, VERIFY COLOR WITH ARCHITECT/OWNER.
- 3.2. DEVICES CONTRACTOR TO PROVIDE J-BOXES, COVER PLATES, AND ANY ACCESSORIES REQUIRED 3.2.1. TO PROVIDE A COMPLETE SYSTEM. SEE ARCHITECTURAL PLANS FOR DEVICE COLORS. 3.2.1. DUPLEX RECEPTACLES SHALL BE TAMPER RESISTANT, 20-AMP, EQUAL TO LEVITON #TBR-20.
- 3.2.2. SINGLE POLE TOGGLE WALL SWITCHES SHALL BE EQUAL TO LEVITON CS120-2. THREE-WAY TOGGLE WALL SWITCHES SHALL BE EQUAL TO LEVITON CS320-2.
- 3.2.3. DIMMER SWITCHES SHALL BE TESTED WITH FIXTURES AND LAMPS FOR
- COMPATIBILITY. SEE LIGHTING PLANS FOR DETAILS. 3.2.4.
- WHERE GFCI PROTECTION IS SHOWN ON PLANS AND UNLESS OTHERWISE NOTED, PROVIDE A LISTED GFCI-PROTECTED RECEPTACLE WHERE THE RECEPTACLE IS ACCESSIBLE ON PLANS. IF THE RECEPTACLE LOCATION IS NOT ACCESSIBLE AS DEFINED BY NEC, PROVIDE GFCI PROTECTION AT CIRCUIT BREAKER. 3.2.5. DO NOT INSTALL OCCUPANCY/VACANCY SENSORS WITH 48" OF HVAC
- DIFFUSERS/GRILLES OR SIMILAR OBSTRUCTION THAT MAY AFFECT SENSOR FUNCTIONALITY. ALL SENSORS SHALL BE INSTALLED PER MANUFACTURER'S SPECIFICATIONS.
- ALL APPLICABLE SWITCHES, RECEPTACLES, CONTROLS, ETC. SHALL BE MOUNTED AT 3.2.6. ADA-ACCESSIBLE HEIGHTS.
- WIRING DEVICES SHOWN ON PLANS NEXT TO ONE ANOTHER SHALL UTILIZE A SINGLE 3.2.7. COVER PLATE UNLESS NOTED OTHERWISE.
- WIRING DEVICES SHOWN BACK-TO-BACK ON EACH SIDE OF A WALL SHALL BE OFFSET 3.2.8. TO REDUCE SOUND TRANSMISSION.
- 3.2.9. EACH RECEPTACLE COVER SHALL BE NEATLY AND LEGIBLY LABELED WITH CORRESPONDING PANEL AND CIRCUIT NUMBER FOR CIRCUIT IDENTIFICATION.

4. EMERGENCY LIGHTING

- BRANCH CIRCUIT FEEDING EMERGENCY FIXTURE(S) SHALL BE SAME BRANCH CIRCUIT AS 4.1. THAT SERVING NORMAL LIGHTING IN SAME AREA AND CONNECTED AHEAD OF ANY LOCAL SWITCHES.
- 4.2. EMERGENCY LIGHTING SYSTEM SHALL PROVIDE 1FC AVERAGE AND 0.1FC MINIMUM ALONG EGRESS PATHS. ADJUST ANY EMERGENCY FIXTURES AS NECESSARY TO PROVIDE PROPER ILLUMINATION WITHOUT OBSTRUCTION FROM FURNITURE OR OBSTACLES.

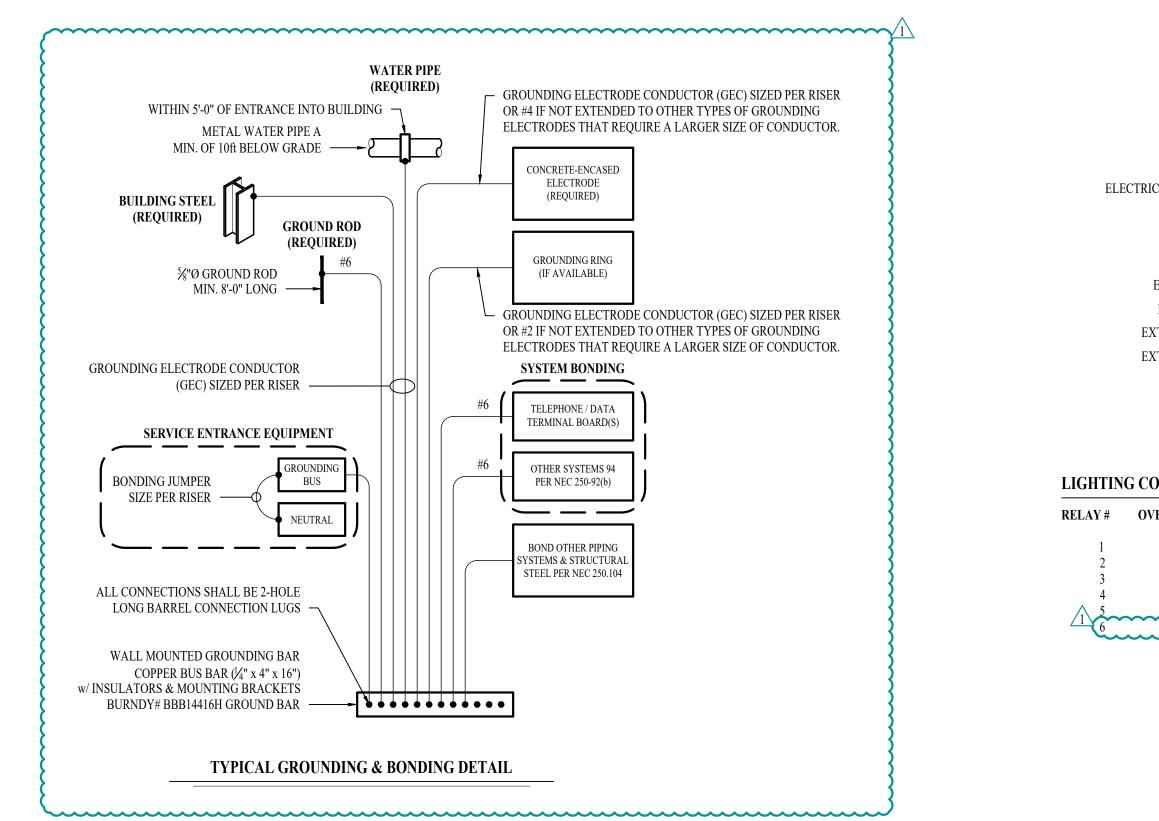

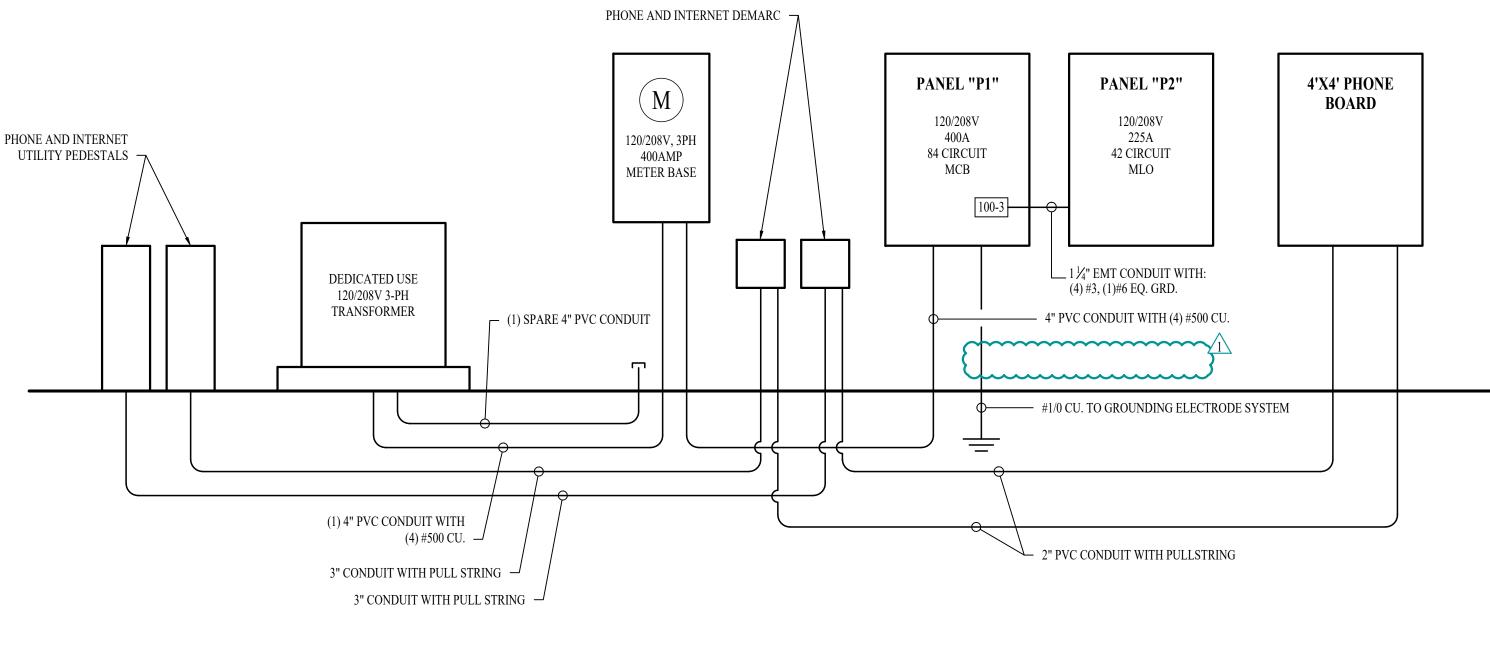

POWER RISER

POWER RISER NOTES:

- COORDINATE DETAILS & REQUIREMENTS OF NEW ELECTRIC SERVICE WITH EVERGY. ALL NEW METERING EQUIPMENT MUST BE APPROVED BY EVERGY. EACH METER MUST BE PERMANENTLY LABELED.
- 4. AIC-RATINGS BASED ON:
- SHOWN ON PLANS. 4.2. METER LOCATION INSTALLED APPROXIMATELY WHERE SHOWN ON PLANS.
- RATING CALCULATIONS IF NECESSARY.

IC PANEL TO CIRCUIT #	LCP1	
EXHAUST FAN #2 P1-43 EXHAUST FAN #1 P1-43 EXTERIOR LIGHTING P1-65 EXTERIOR SIGNAGE P1-1 XTERIOR LIGHTING P1-78,80 XTERIOR LIGHTING P1-78,80 SPARE SPARE	1 2 3 4 5 6 7 8	• PHOTOCELL INPUT • 8 RELAY LIGHITNG CONTROL PANEL EQUAL TO WATTSTOPPER LP-8

LIGHTING CONTROL PANEL SCHEDULE

VERRIDE SWITCH	OPERATIONAL SCHEDULE
NO	ON VIA TIME CLOCK DURING OCCUPIED HOURS.
NO	ON VIA TIME CLOCK 24/7.
NO	ON VIA TIME CLOCK & PHOTOCELL DURING NIGHT HOURS.
NO	ON VIA TIME CLOCK & PHOTOCELL DURING NIGHT HOURS.
NO	ON VIA TIME CLOCK & PHOTOCELL DURING NIGHT HOURS.
NO	ON VIA TIME CLOCK & PHOTOCELL DURING NIGHT HOURS.


LIGHTING CONTROL PANEL "LCP1"


4.1. TRANSFORMER: 75kVA, 100% POWER FACTOR, 3.50% Z, LOCATED APPROXIMATELY WHERE

4.3. ELECTRICAL PANEL LOCATION INSTALLED APPROXIMATELY WHERE SHOWN ON PLANS. 4.4. CONTRACTOR TO FIELD VERIFY FINAL EQUIPMENT LOCATIONS AND PERFORM ADDITIONAL AIC

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J2 DESIGN:	ACW
ISSUE TITLE	DATE
PERMIT SET	06 / 14 /2024
REVISION #1	08 / 16 /2024

RELEASED FOR

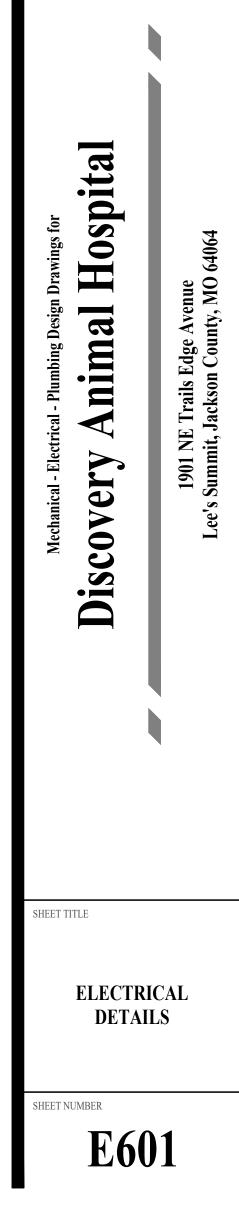

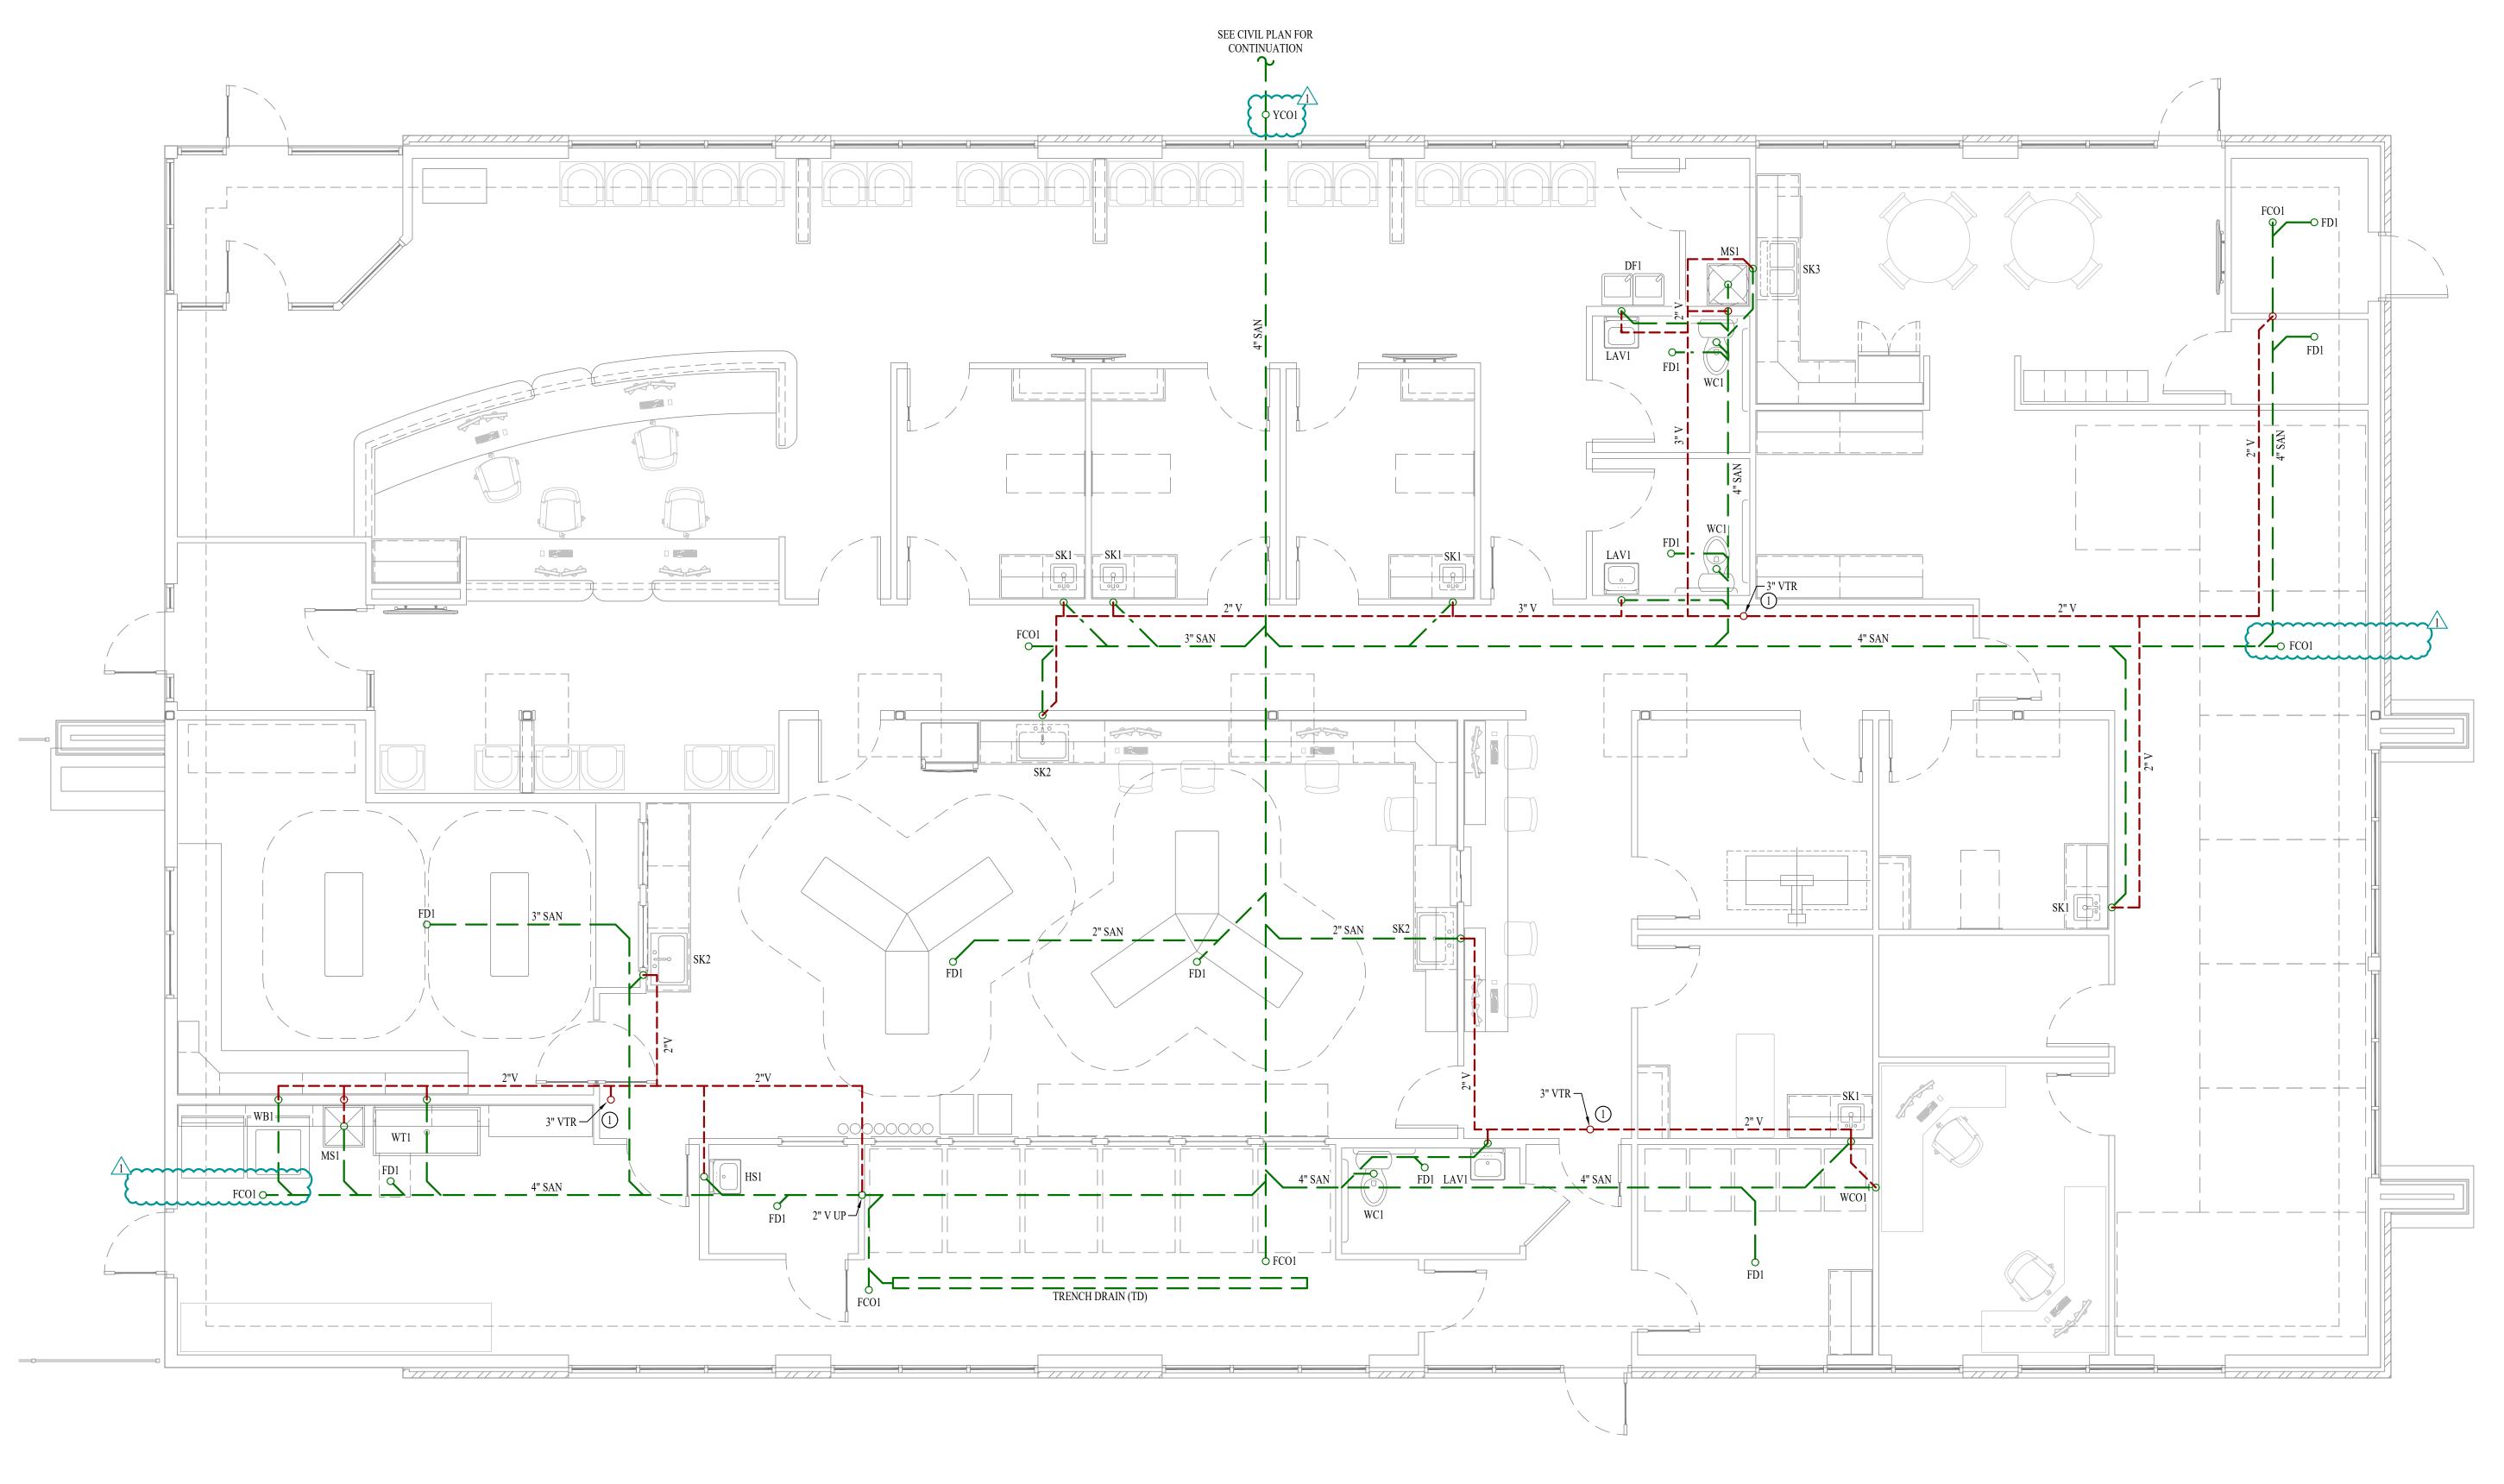

SANITARY SEWER PLAN
SCALE: 1/4" = 1'-0"

SANITARY SEWER PLAN SYMBOL LEGEND

	SANITARY SEWER PIPING
	VENT PIPING
o	PIPING TURNED DOWN / TURNED UP
\succ	TIE INTO EXISTING

SANITARY SEWER PLAN GENERAL NOTES:

1. SEE SHEET P501 FOR ADDITIONAL PLUMBING NOTES, DETAILS, & SCHEDULES.

SANITARY SEWER PLAN KEY NOTES:

1 LOCATE VENT-THRU-ROOF (VTR) AT LEAST 10' FROM MECHANICAL FRESH AIR INTAKE LOCATIONS ON ROOF; COORDINATE WITH HVAC CONTRACTOR.

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Mechanical - Electrical - Plumbing Design Drawings for Discovery Animal Hospital

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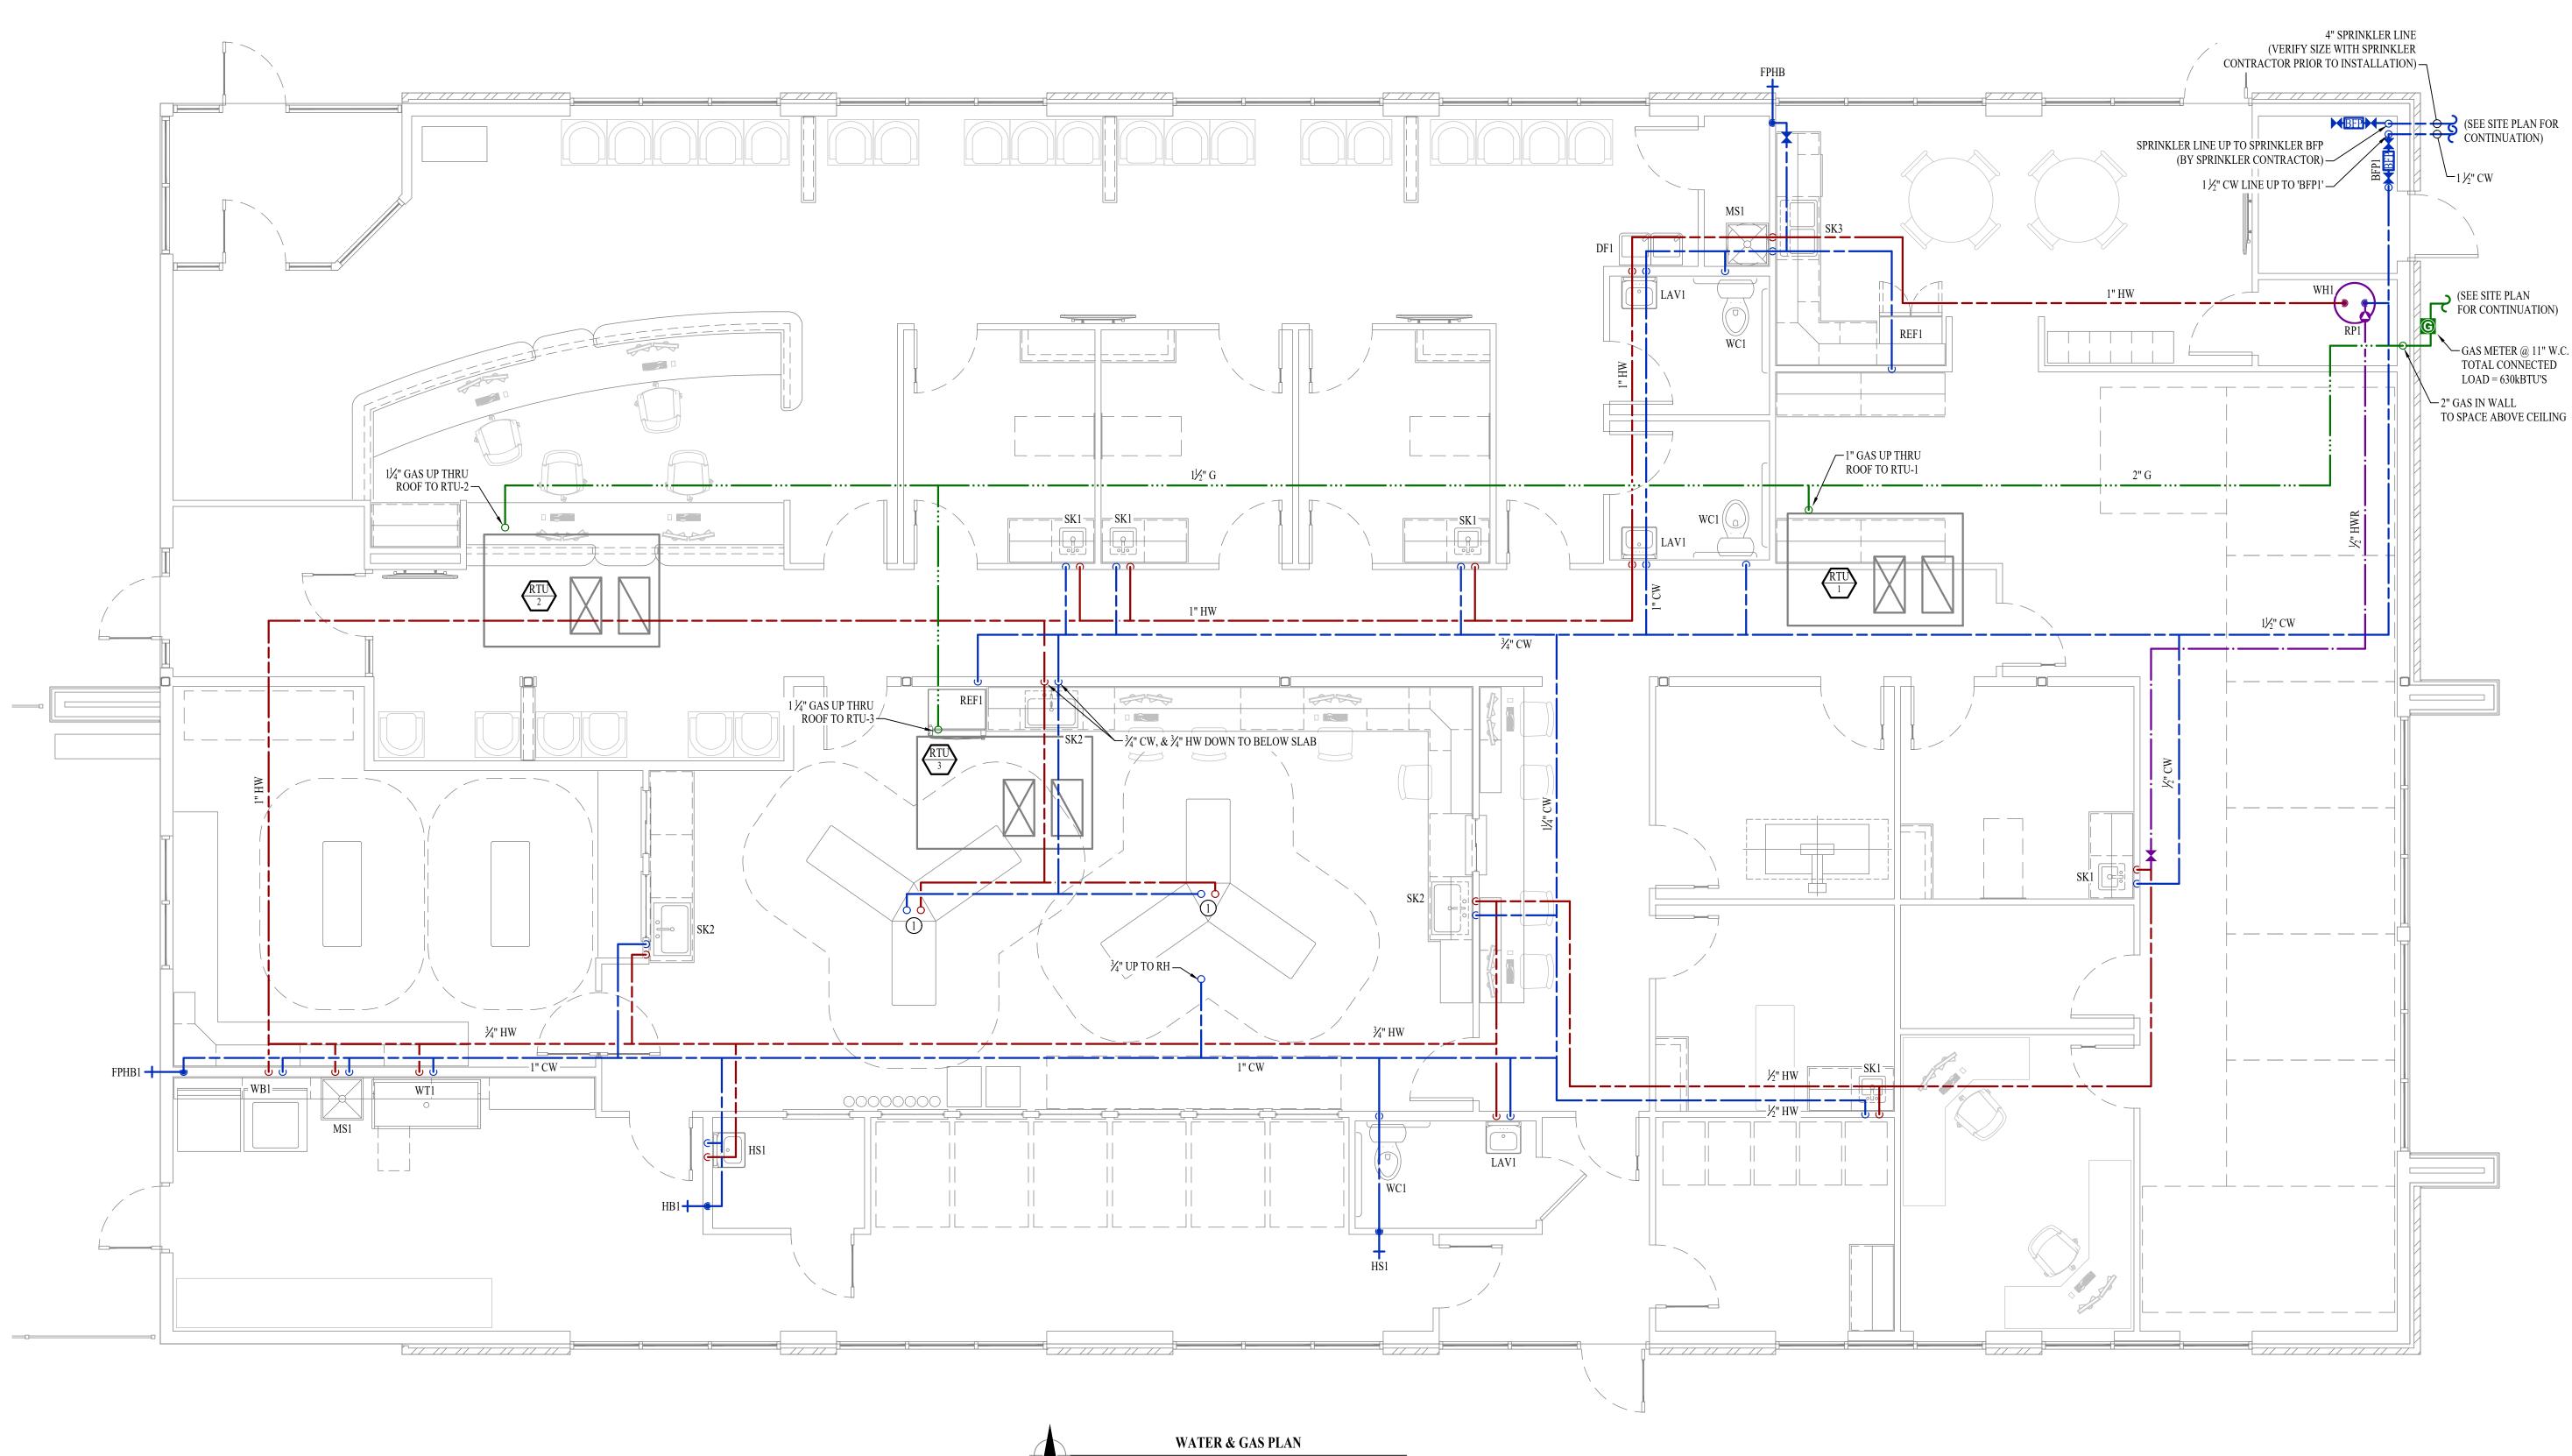
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SHEET TITLE

SANITARY SEWER PLAN

SHEET NUMBER





SCALE: 1/4" = 1'-0"

WATER & GAS PLAN SYMBOL LEGEND

	COLD WATER LINE
	HOT WATER LINE
<u> </u>	HOT WATER RECIRCULATION LINE
	FILTERED WATER LINE
M	WATER METER
M	VALVE
0	PUMP
	GAS LINE
G	GAS METER
o	PIPING TURNED DOWN / TURNED UP


WATER & GAS PLAN GENERAL NOTES:

1. SEE SHEET P501 FOR ADDITIONAL PLUMBING NOTES, DETAILS, & SCHEDULES.

WATER & GAS PLAN KEY NOTES:

(1) CONNECT TO OWNER PROVIDED MED TOWER; COORDINATE EXACT LOCATION & REQUIREMENTS WITH G.C.

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James Watson, P.E. PE-2015017071 MO Certificate of Au	June 14, 2024 thority # 2018029680
J-SQU ENGINE 2400 Bluff Creek Columbia, M 573 - 234 - 4 www.j-squa	E E R I N G Drive, Suite 101 issouri 65201 4492 phone
J2 PROJECT No:	J21209
J2 DESIGN:	ACW
ISSUE TITLE PERMIT SET	DATE 06 / 14 /2024

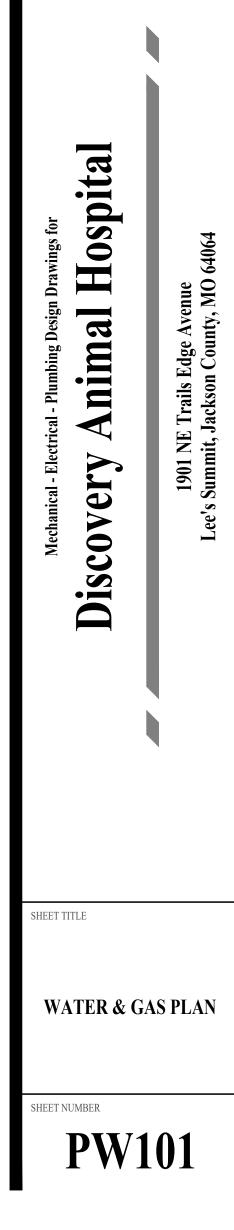

PLUMBING SPECIFICATIONS

1. <u>GENERAL</u>

- 1.1. PLUMBING CONTRACTOR IS RESPONSIBLE TO PROVIDE ALL ESCUTCHEONS, ¼ TURN STOPS, P-TRAPS, AND SUPPLY LINES TO PROVIDE A COMPLETE SYSTEM AT EACH FIXTURE INDICATED ON PLANS UNLESS NOTED OTHERWISE.
- 1.2. ALL PLUMBING SYSTEMS SHALL BE INSTALLED LEVEL, PLUMB, AND
- PARALLEL/PERPENDICULAR TO BUILDING ORIENTATION WHERE POSSIBLE.
- 1.3. COORDINATE ALL PIPING INSTALLATIONS WITH STRUCTURAL GRADE BEAMS, FOOTINGS, COLUMN PIERS, ETC. SLEEVE PIPING THRU STRUCTURAL ELEMENTS AS NECESSARY, VERIFY WITH STRUCTURAL ENGINEER.
- VERIFY ALL UTILITY CONNECTION POINTS WITH PROPOSED PLUMBING LAYOUTS PRIOR TO 1.4. BEGINNING WORK.
- CLEAN ALL PLUMBING FIXTURES AND CHANGE FAUCET AERATORS AND SINK STRAINERS AT 1.5. PROJECT COMPLETION PRIOR TO TURNING OVER TO OWNERSHIP.

2. EQUIPMENT / FIXTURES

- ALL EQUIPMENT AND/OR FIXTURES MUST MEET OR EXCEED THE PERFORMANCE, 2.1. FUNCTIONAL INTENT, AND AESTHETICS AS MODELS SPECIFIED ON PLANS. WHERE SPECIFIC MANUFACTURERS AND/OR MODELS ARE INDICATED ON PLANS OR WITHIN SCHEDULES, CONTRACTOR TO PROVIDE MODEL INDICATED OR APPROVED EQUAL. VERIFY SUBSTITUTION APPROVAL PRIOR TO PURCHASE OR INSTALLATION OF EQUIPMENT.
- 2.2. CONTRACTOR TO SUPPLY SUBMITTALS FOR ALL EQUIPMENT FOR REVIEW BY ARCHITECT AND ENGINEER. FORMAL APPROVAL SHALL BE RECEIVED BY CONTRACTOR PRIOR TO EQUIPMENT PURCHASE.
- CONTRACTOR TO SHARE APPROVED EQUIPMENT SUBMITTALS WITH ANY PERTINENT 2.3. ELECTRICAL REQUIREMENTS WITH ELECTRICAL CONTRACTORS WITHIN TWO WEEKS OF RECEIVING APPROVED SUBMITTALS FROM ARCHITECT/ENGINEER.

3. <u>SANITARY</u>

- BELOW AND ABOVE GRADE WASTE AND VENT PIPING IN BUILDING TO BE SOLID CORE 3.1. SCHEDULE 40 PVC LISTED FOR DWV APPLICATIONS.
- NO WASTE OR VENT PIPING INSTALLED BELOW GRADE SHALL BE SMALLER THAN 2". 3.2. 3.3. MINIMUM SLOPES FOR WASTE PIPING (UNLESS NOTED OTHERWISE ON PLANS): 3.3.1.
- $2\frac{1}{2}$ " OR LESS DIAMETER: $\frac{1}{4}$ " PER FOOT 3.3.2. 3" TO 6" DIAMETER: 🔏 " PER FOOT
- 3.3.3. 8" OR LARGER DIAMETER: $\frac{1}{16}$ " PER FOOT
- ACCESSIBLE FULL PIPE SIZE CLEANOUTS SHALL BE PROVIDED & INSTALLED ON BUILDING 3.4. SANITARY LINES AT LOCATIONS SHOWN ON PLANS, AT INTERVALS OF NO MORE THAN 100', AT EVERY CHANGE IN DIRECTION GREATER THAN 45°, AND AT THE BASE OF EACH WASTE STACK.
- WASTE AND VENT PIPING IN PLENUMS SHALL BE CAST IRON, PLENUM-RATED CPVC, OR PVC 3.5.
- WITH AN INSULATION WRAP LISTED FOR USE AS SUCH AN ASSEMBLY. ALL VENT PIPE TERMINATIONS SHALL BE LOCATED EITHER 10' HORIZONTALLY OR 3' ABOVE 3.6. MECHANICAL AIR INTAKE LOCATIONS. TERMINATIONS SHALL NOT BE INSTALLED UNDER ANY OPERABLE BUILDING OPENING OR OPERABLE ADJACENT BUILDING OPENING. CONTRACTOR TO OFFSET VENT PIPING AS NECESSARY TO MEET THESE REQUIREMENTS.

DOMESTIC WATER 4.

- ALL DOMESTIC WATER PIPING TO BE EITHER COPPER OR PEX, SHALL CONFORM TO NSF 61 4.1. AND BE LISTED FOR USE IN POTABLE WATER SYSTEMS.
- 4.1.1. WHERE PEX PIPING IS USED, IT SHALL BE INCREASED ONE PIPE SIZE FROM WHAT IS INDICATED ON PLANS FOR ALL PORTIONS OF DISTRIBUTION SYSTEM.
- 4.1.2. PEX-A MAY BE INSTALLED AT SIZES INDICATED ON PLANS ONLY IF AN ENGINEERED PLAN IS SUBMITTED SHOWING ACCEPTABLE PRESSURE DROPS AND FLUID VELOCITIES, APPROVAL MUST BE GRANTED PRIOR TO PURCHASE AND INSTALLATION. 4.1.3. COPPER WATER PIPING BELOW GRADE SHALL BE TYPE "K". BELOW GRADE JOINTS
- SHALL BE SILVER SOLDERED. THERE SHALL BE NO JOINTS IN WATER PIPING LOCATED BENEATH BUILDING SLAB. 4.1.4. COPPER WATER PIPING ABOVE GRADE SHALL BE TYPE "L".
- 4.2. PROVIDE WATER HAMMER ARRESTORS AT ALL QUICK-CLOSE VALVES. FIXTURES REQUIRING WATER HAMMER ARRESTORS INCLUDE BUT ARE NOT LIMITED TO FLUSH VALVES, SENSOR FAUCETS, AND WASHING MACHINE BOXES. AIR CHAMBERS SHALL NOT BE
- PERMITTED. 4.3. ALL DOMESTIC WATER PIPING SHALL BE ROUTED WITHIN BUILDING THERMAL ENVELOPE AND WITHIN WALL CAVITIES, ABOVE FINISHED CEILINGS, OR BELOW SLAB TO REMAIN
- CONCEALED UNLESS OTHERWISE NOTED. NOTIFY ENGINEER OF ANY NECESSARY ADJUSTMENTS THAT REQUIRE PIPING TO BE EXPOSED. DOMESTIC WATER PIPING INSULATION 4.4.
- 4.4.1. ALL HW PIPING, WHETHER COPPER OR PEX, SHALL BE INSULATED WITH PLENUM RATED CLOSED CELL ELASTOMERIC INSULATION.
- FOR PIPING LESS THAN $1\frac{1}{2}$ ", INSULATION THICKNESS TO BE 1". 4.4.1.1. FOR PIPING $1\frac{1}{2}$ " OR GREATER, INSULATION THICKNESS SHALL BE $1\frac{1}{2}$ ". 4.4.1.2.
- 4.4.2. CW COPPER PIPING TO INSULATED WITH ½" PLENUM RATED CLOSED CELL ELASTOMERIC INSULATION. CW PEX NEED NOT BE INSULATED UNLESS NOTED OTHERWISE ON PLANS.

GAS PIPING 5.

- GAS PIPING SHALL BE INSTALLED LEVEL, PLUMB, AND PARALLEL OR PERPENDICULAR TO 5.1. BUILDING ORIENTATION WHERE POSSIBLE.
- 5.2. QUARTER-TURN FULL-PORT SHUTOFF VALVES SHALL BE INCLUDED AT EACH APPLIANCE CONNECTION, AS WELL AS AN IN-LINE REGULATOR FROM DELIVERY PRESSURE TO APPLIANCE OPERATING PRESSURE IF REQUIRED. INCLUDE SEDIMENT TRAPS PER IFGC REQUIREMENTS.
- NATURAL GAS AND LIQUID PROPANE (LP) PIPING TO SHALL BE SCHEDULE 40 BLACK STEEL. 5.1. PIPE JOINTS SHALL BE THREADED WITH CLASS 150 FITTINGS, OR WELDED. NOTIFY 5.2.
- OWNER/GC OF ANY NECESSARY HOT-WORK ASSOCIATED WITH WELDED CONNECTIONS. WHERE PIPING IS EXPOSED ON EXTERIOR FACE OF BUILDING, PAINT TO MATCH BUILDING. 5.3.
- PAINT YELLOW IN ALL OTHER LOCATIONS.
- ON ROOFTOPS, INSTALL GAS PIPE WITH "ROOFTOP BLOX" PER MANUFACTURER'S 5.4. INSTRUCTION.

6. STORM DRAIN PIPING


- ABOVE AND BELOW GRADE STORM PIPING SHALL BE SOLID CORE SCHEDULE 40 PVC. 6.1. 6.2. ALL PRIMARY & SECONDARY STORM DRAIN PIPING & FITTINGS SHALL BE INSULATED WITH
- $\frac{1}{2}$ " FIBERGLASS INSULATION WITH ASJ JACKET. STORM DRAIN PIPING IN PLENUMS SHALL BE CAST IRON, PLENUM-RATED CPVC, OR PVC 6.3. WITH AN INSULATION WRAP LISTED FOR USE AS SUCH AN ASSEMBLY.
- SANITARY VENT PIPING (TERMINATE A MIN. OF 24" ABOVE ROOF) -

ADJUSTABLE STAINLESS STEEL CLAMPS / SCREWS (TYP.)

ROOF INSULATION -

REFER TO ARCHITECTURAL / STRUCTURAL DRAWINGS FOR ROOF CONSTRUCTION ASSEMBLY -

SANITARY VENT THRU ROOF DETAIL

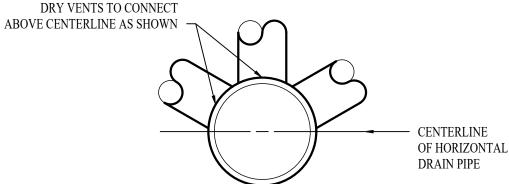


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TAG	DESCRIPTION	MANUFACTURER (OR EQUAL)	MODEL (OR EQUAL)	NOTES
BFP1	BACKFLOW PREVENTER	WILKINS	9758XL2	RPZ - 1.25"
DF1	DRINKING FOUNTAIN	ELKAY	EZSTL8LC	HI/LOW
EXP1	EXPANSION TANK	WATTS	PLT-5	
FCO1	FLOOR CLEANOUT	ZURN	1400	
FD1	FLOOR DRAIN	ZURN	Z415-BZ	WITH Z1072 TRAP SEAL
FPHB1	FROST PROOF HOSE BIB	WOODFORD	MODEL 67	
HB1	HOSE BIB	JR SMITH	5670-Н	INTEROR HOSE BIB WITH VACUUM BREAKER
HS1	HAND SINK	ELKAY	CHS1716LRSC	
LAV1	LA VATORY (WALL HUNG W/MANUAL FAUCET)	AMERICAN STANDARD	0355.012	WITH ZURN Z81104-XL FAUCET, 1/4 TURN STOPS, BRAIDED STAINLESS STEEL SUPPLIES, AND TRUBRO LAV GUARD 2
MS1	MOP SINK	FIAT	MSB2424	WITH ZURN Z843M1 FAUCET WITH WALL HOOK
REF1	REFRIGERA TOR BOX	SOUIX CHIEF	696-G1000	
RH1	ROOF HYDRANT	WOODFORD	SRH-MS	
RP1	RECIRCULA TION PUMP	GRUNDFOS	UP10-15BUA/TLC	
SK1	SINGLE COMPARTMENT SINK (15x15x6)	ELKA Y	BCR15	WITH TWO HANDLED ZURN Z871C4-XL FAUCET
SK2	SINGLE COMPARTMENT SINK (22x19x7)	ELKA Y	LR2219	WITH TWO HANDLED ZURN Z871C4-XL FAUCET
SK3	DOUBLE COMPARTMENT SINK W/DISPOSAL (33x22x7)	ELKA Y	CR3322	WITH TWO HANDLED ZURN Z871C4-XL FAUCET AND INSINKERATOR BADGER 1 DISPOSAL WITH POWER CORD
TD1	TRENCH DRAIN	ZURN	Z886-HPS	
WB1	WA SHER BOX	OATEY	CENTRO II	
WC1	WATER CLOSET - ADA HEIGHT - TANK	AMERICAN STANDARD	215AA.004	WITH CHURCH 7200SLEC SEAT AND COVER, STAINLESS BRAIDED SUPPLY, AND 1/ TURN SHUT-OFF.
WCO1	WALL CLEAN OUT			
WH1	WATER HEATER	AO SMITH	DEL50	50 GALLON, 208V, 4000W
WT1	FAUCET FOR WASH TUB	ZURN	Z842X1-XL-AF	
YCO1	YARD CLEAN OUT	ZURN	Z1400	

FIXTURE	SANITAF	RY PIPING	SUPPLY PIPING		
ТҮРЕ	TYPICAL ABBREVIATION	WASTE CONNECTION	VENT CONNECTION	COLD WATER CONNECTION	HOT WATER CONNECTION
DRINKING FOUNTAIN	DF	1-1/2"	1-1/4"	1/2"	-
FLOOR DRA IN	FD	3"	2"	-	-
HAND / HAIR SINK	HS / SK	2"	1-1/4"	1/2"	1/2"
HOSE BIBB	HB	-	-	3/4"	-
LAVATORY	LAV	1-1/2"	1-1/4"	1/2"	1/2"
MOP SINK	MS	3"	1-1/2"	1/2"	1/2"
ICE MAKER OUTLET BOX	REF	-	-	1/2"	-
SHOWER	SH	3"	1-1/2"	1/2"	1/2"
URINAL	UR	2"	1-1/4"	3/4"	-
WATER CLOSET (FLUSH TANK)	WC	3"	2"	1/2"	-
WATER CLOSET (FLUSH VALVE)	WC	3"	2"	1"	-

DRY VENT DETAIL

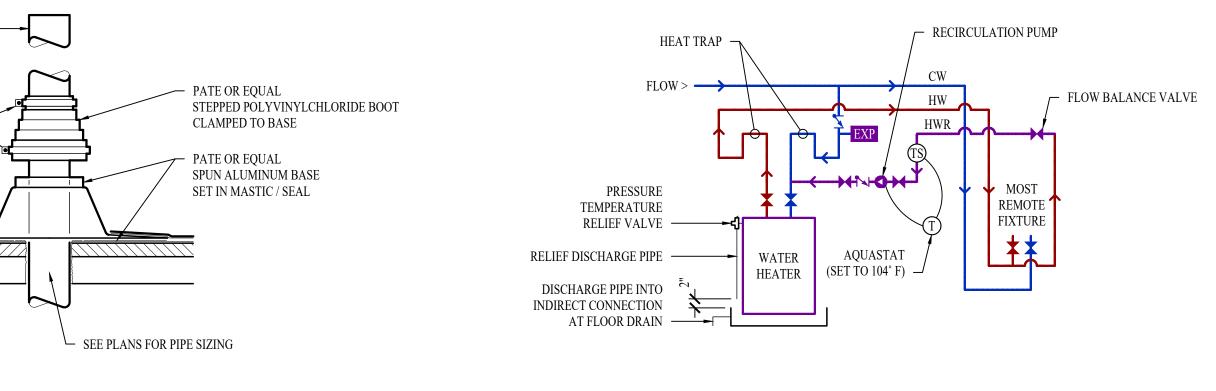

HOT WATER RECIRCULATION DETAIL

