
SUMMIT FAIR, LOT 10D-10F PUBLIC SANITARY SEWER IMPROVEMENTS

IN THE CITY OF LEE'S SUMMIT, JACKSON COUNTY, MO

GENERAL NOTES:

THE DESIGN AND CONSTRUCTION OF THE PUBLIC SANITARY SEWER FACILITIES SHALL BE GOVERNED BY THE CITY OF LEE'S SUMMIT, MISSOURI DESIGN CRITERIA AND TECHNICAL SPECIFICATIONS, LATEST EDITIONS.

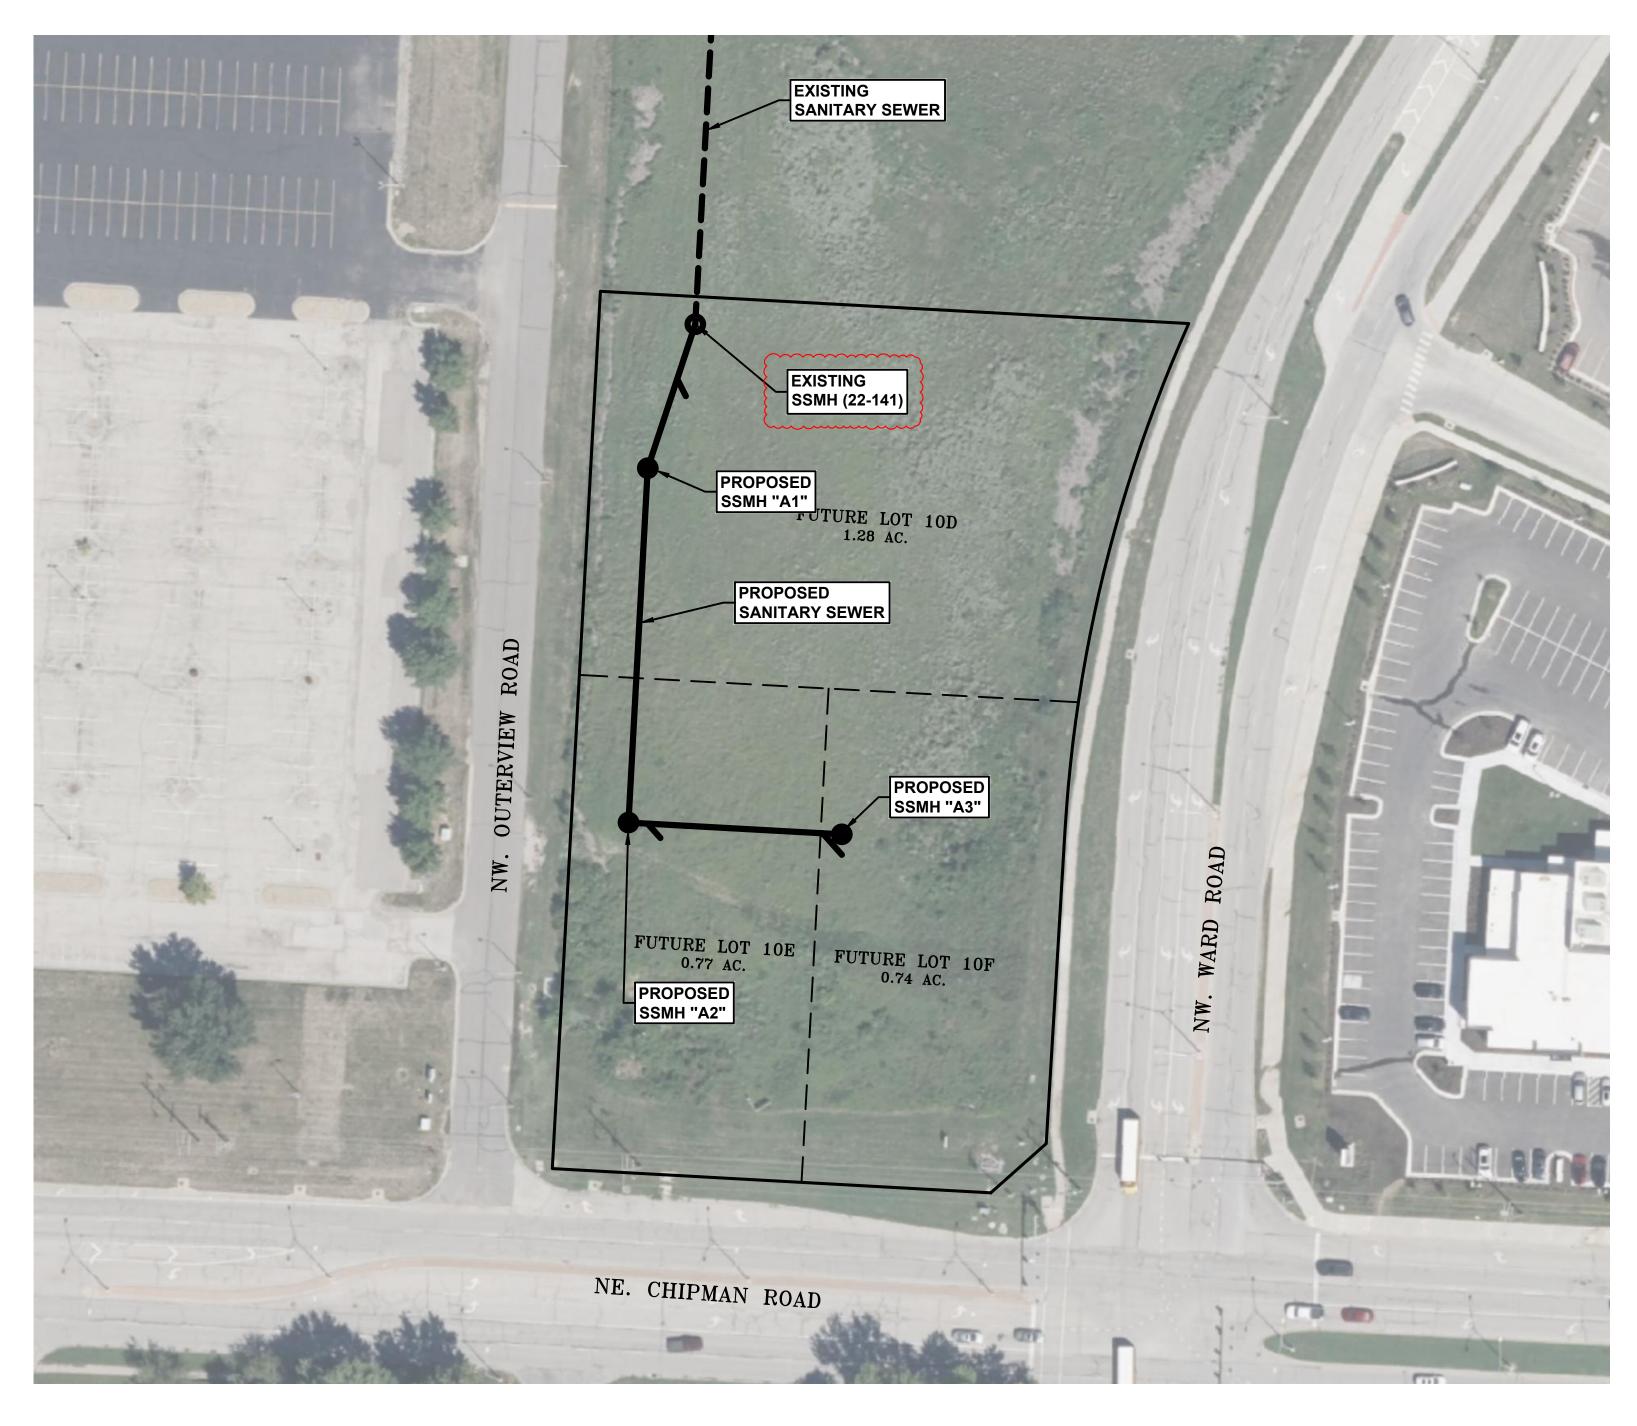

INDEX

COVER SHEET

SANITARY SEWER PLAN & PROFILE **EROSION CONTROL & RESTORATION**

SANITARY SEWER DETAILS

RELEASED FOR CONSTRUCTION

SCALE: 1"=100'

LEE'S SUMMIT, MO 64082

UTILITY COMPANIES: (816) 969-2218 MISSOURI GAS ENERGY LUCAS WALLS (LUCAS.WALLS@SUG.COM) 3025 SOUTHEAST CLOVER DRIVE

(816) 347-4339 EVERGY PHILLIP INGRAM (PHILLIP.INGRAM@KCPL.COM) (816) 347-4316 RON DEJARNETTE (RON.DEJARNETTE@KCPL.COM) 1300 HAMBLEN ROAD

LEE'S SUMMIT, MO 64081 (816) 969-1800 STORM SEWER (PUBLIC WORKS DEPARTMENT) 220 SE GREEN STREET


SANITARY SEWER & WATER (WATER UTILITIES DEPT.) (816)-969-1900 1200 SE HAMBLEM ROAD, LEE'S SUMMIT, MO 64081

AT&T (913) 383-4929

LEE'S SUMMIT, MO 64063

MR. CLAYTON ANSPAUGH (CA4089@ATT.COM) (913) 383-4849-FAX OVERLAND PARK, KANSAS 66207

9444 NALL AVENUE

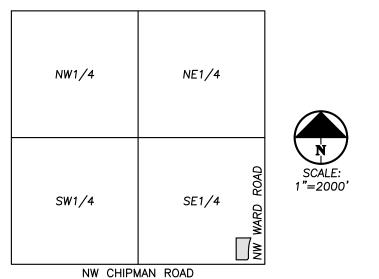

VICINITY MAP SEC. 36-48-32



UTILITY NOTES:
VISUAL INDICATIONS OF UTILITIES ARE AS SHOWN.
UNDERGROUND LOCATIONS SHOWN, AS FURNISHED BY THEIR LESSORS, ARE APPROXIMATE AND SHOULD BE VERIFIED IN THE FIELD AT THE TIME OF CONSTRUCTION. FOR ACTUAL FIELD LOCATIONS OF UNDERGROUND UTILITIES CALL 811.

NOTE: FLOWABLE FILL IS REQUIRED AROUND ALL STORM STRUCTURES.


LEGEND OF SYMBOLS Proposed Sanitary Sewer
Existing Sanitary Sewer PREPARED & SUBMITTED BY: PHELPS ENGINEERING, INC. 1270 N. WINCHESTER OLATHE, KANSAS 66061





JUDD D. CLAUSSEN, MISSOURI P.E.#29850

DATE

SHEET

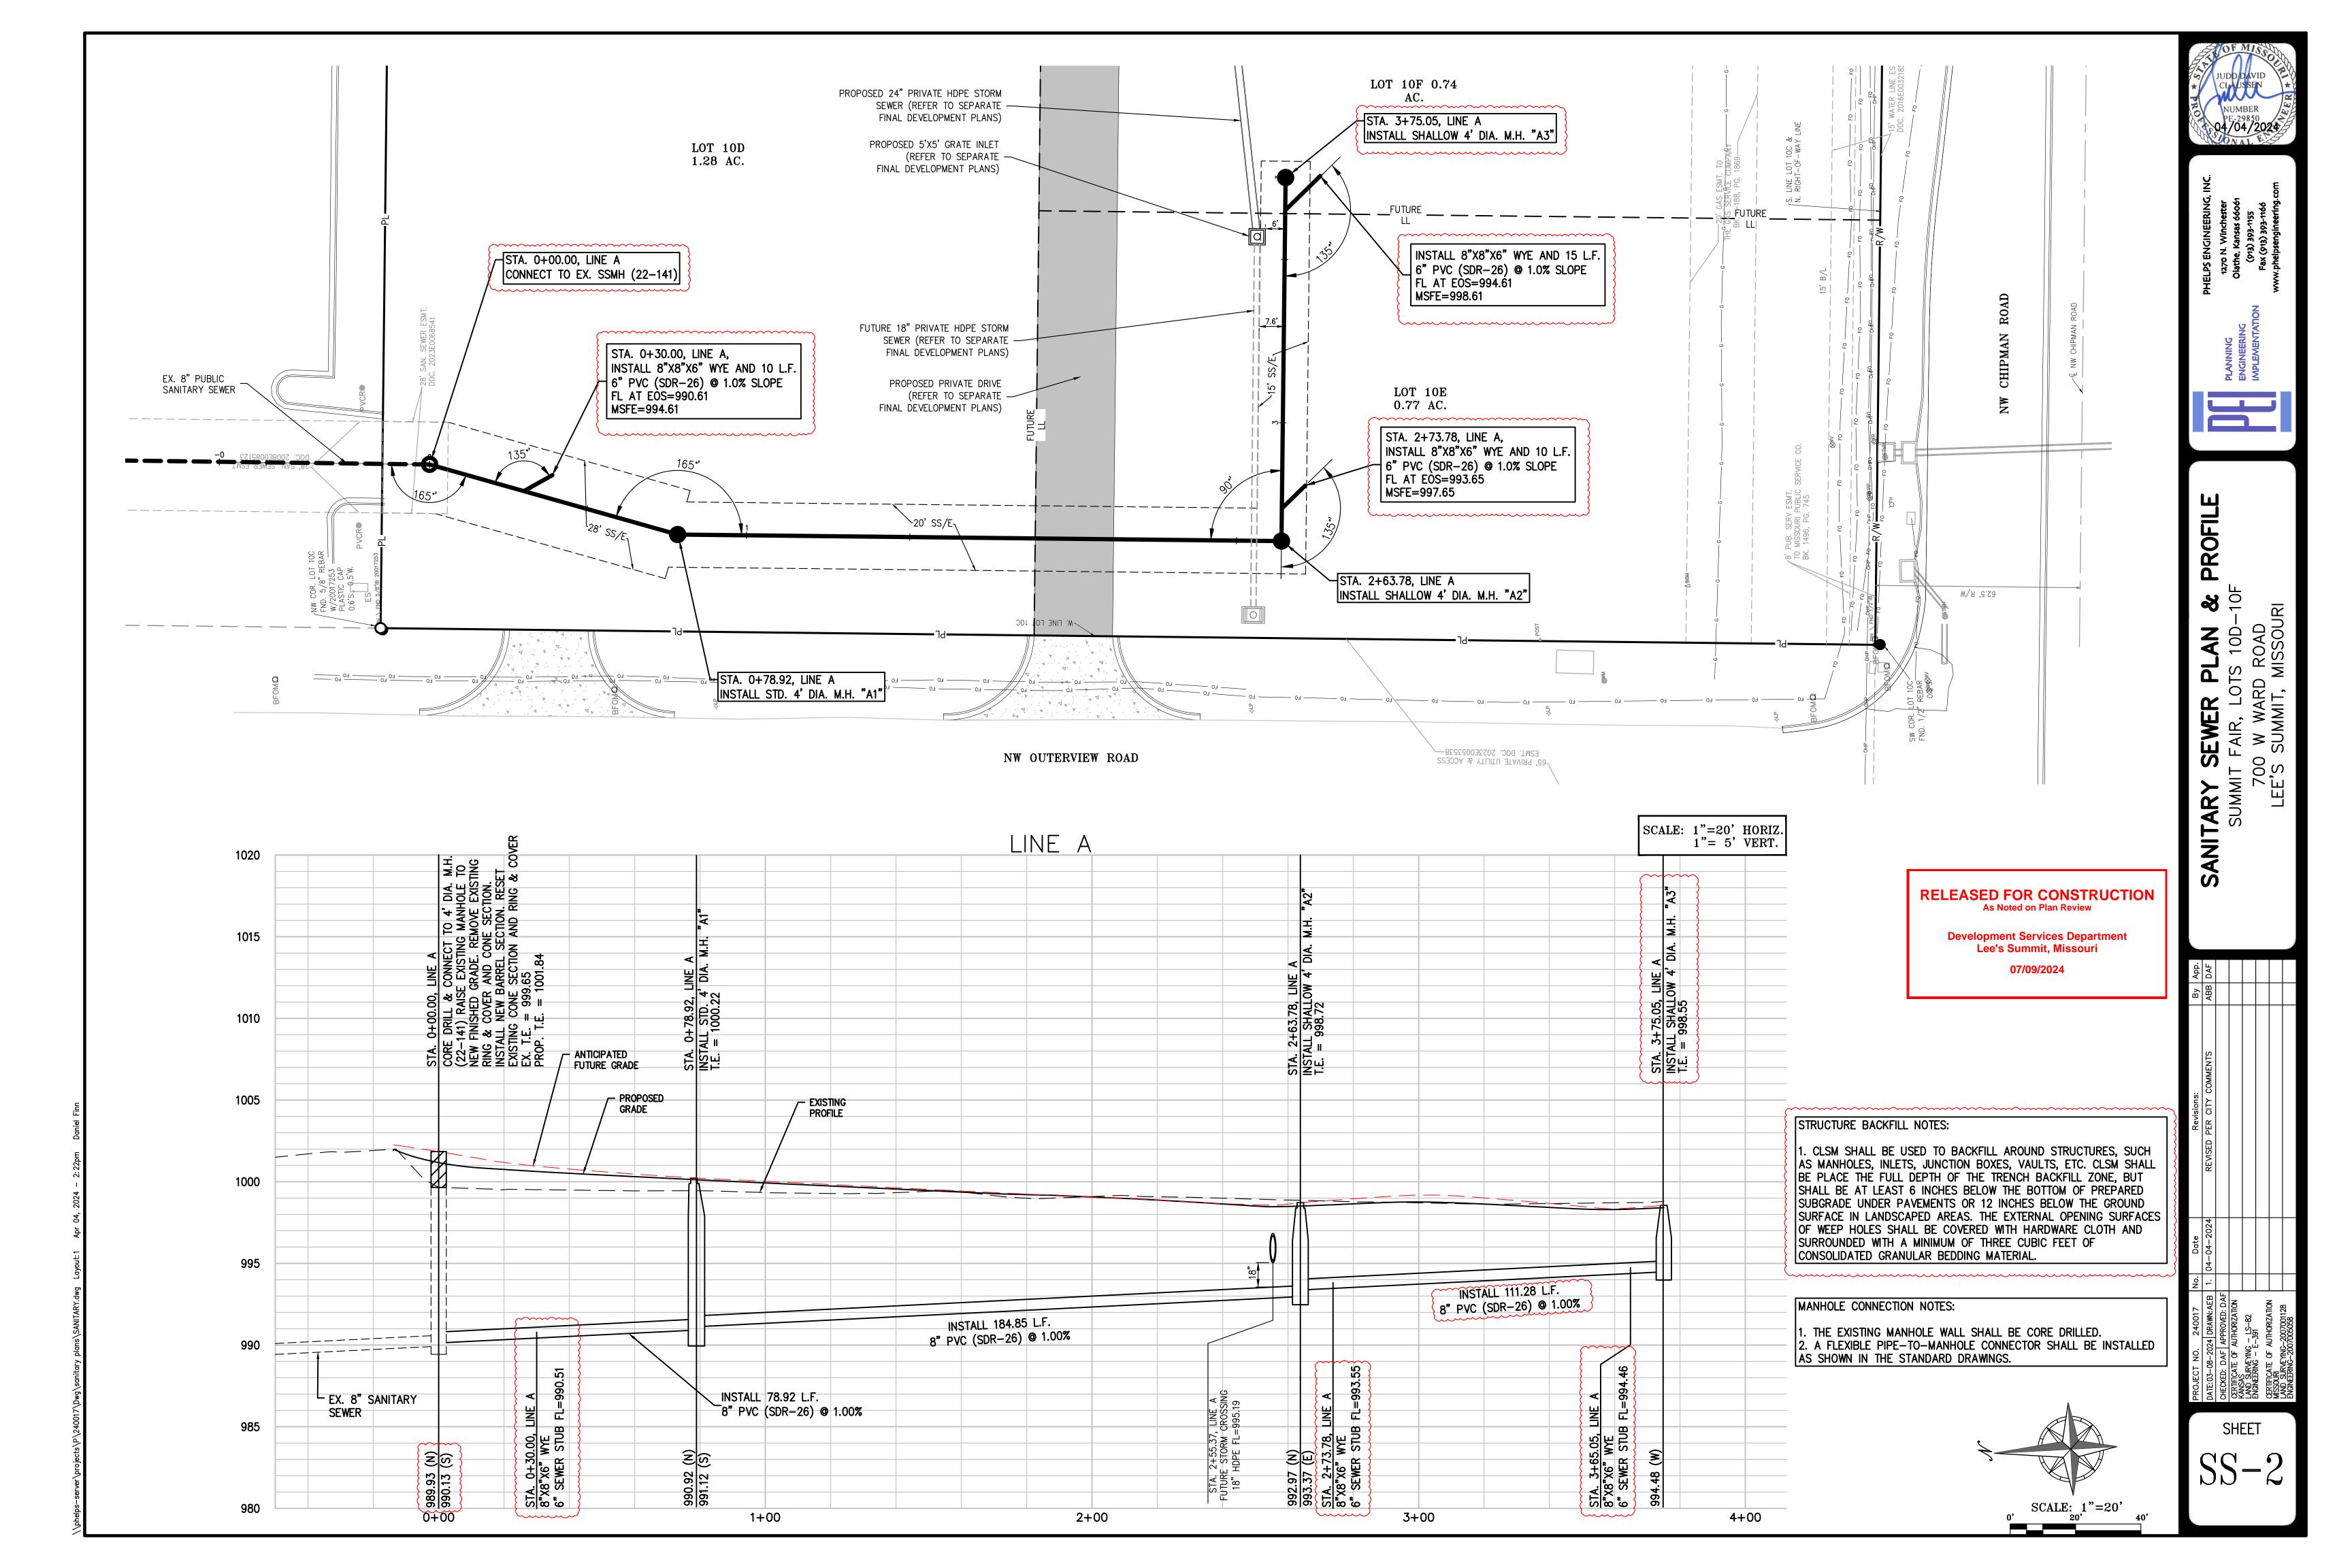

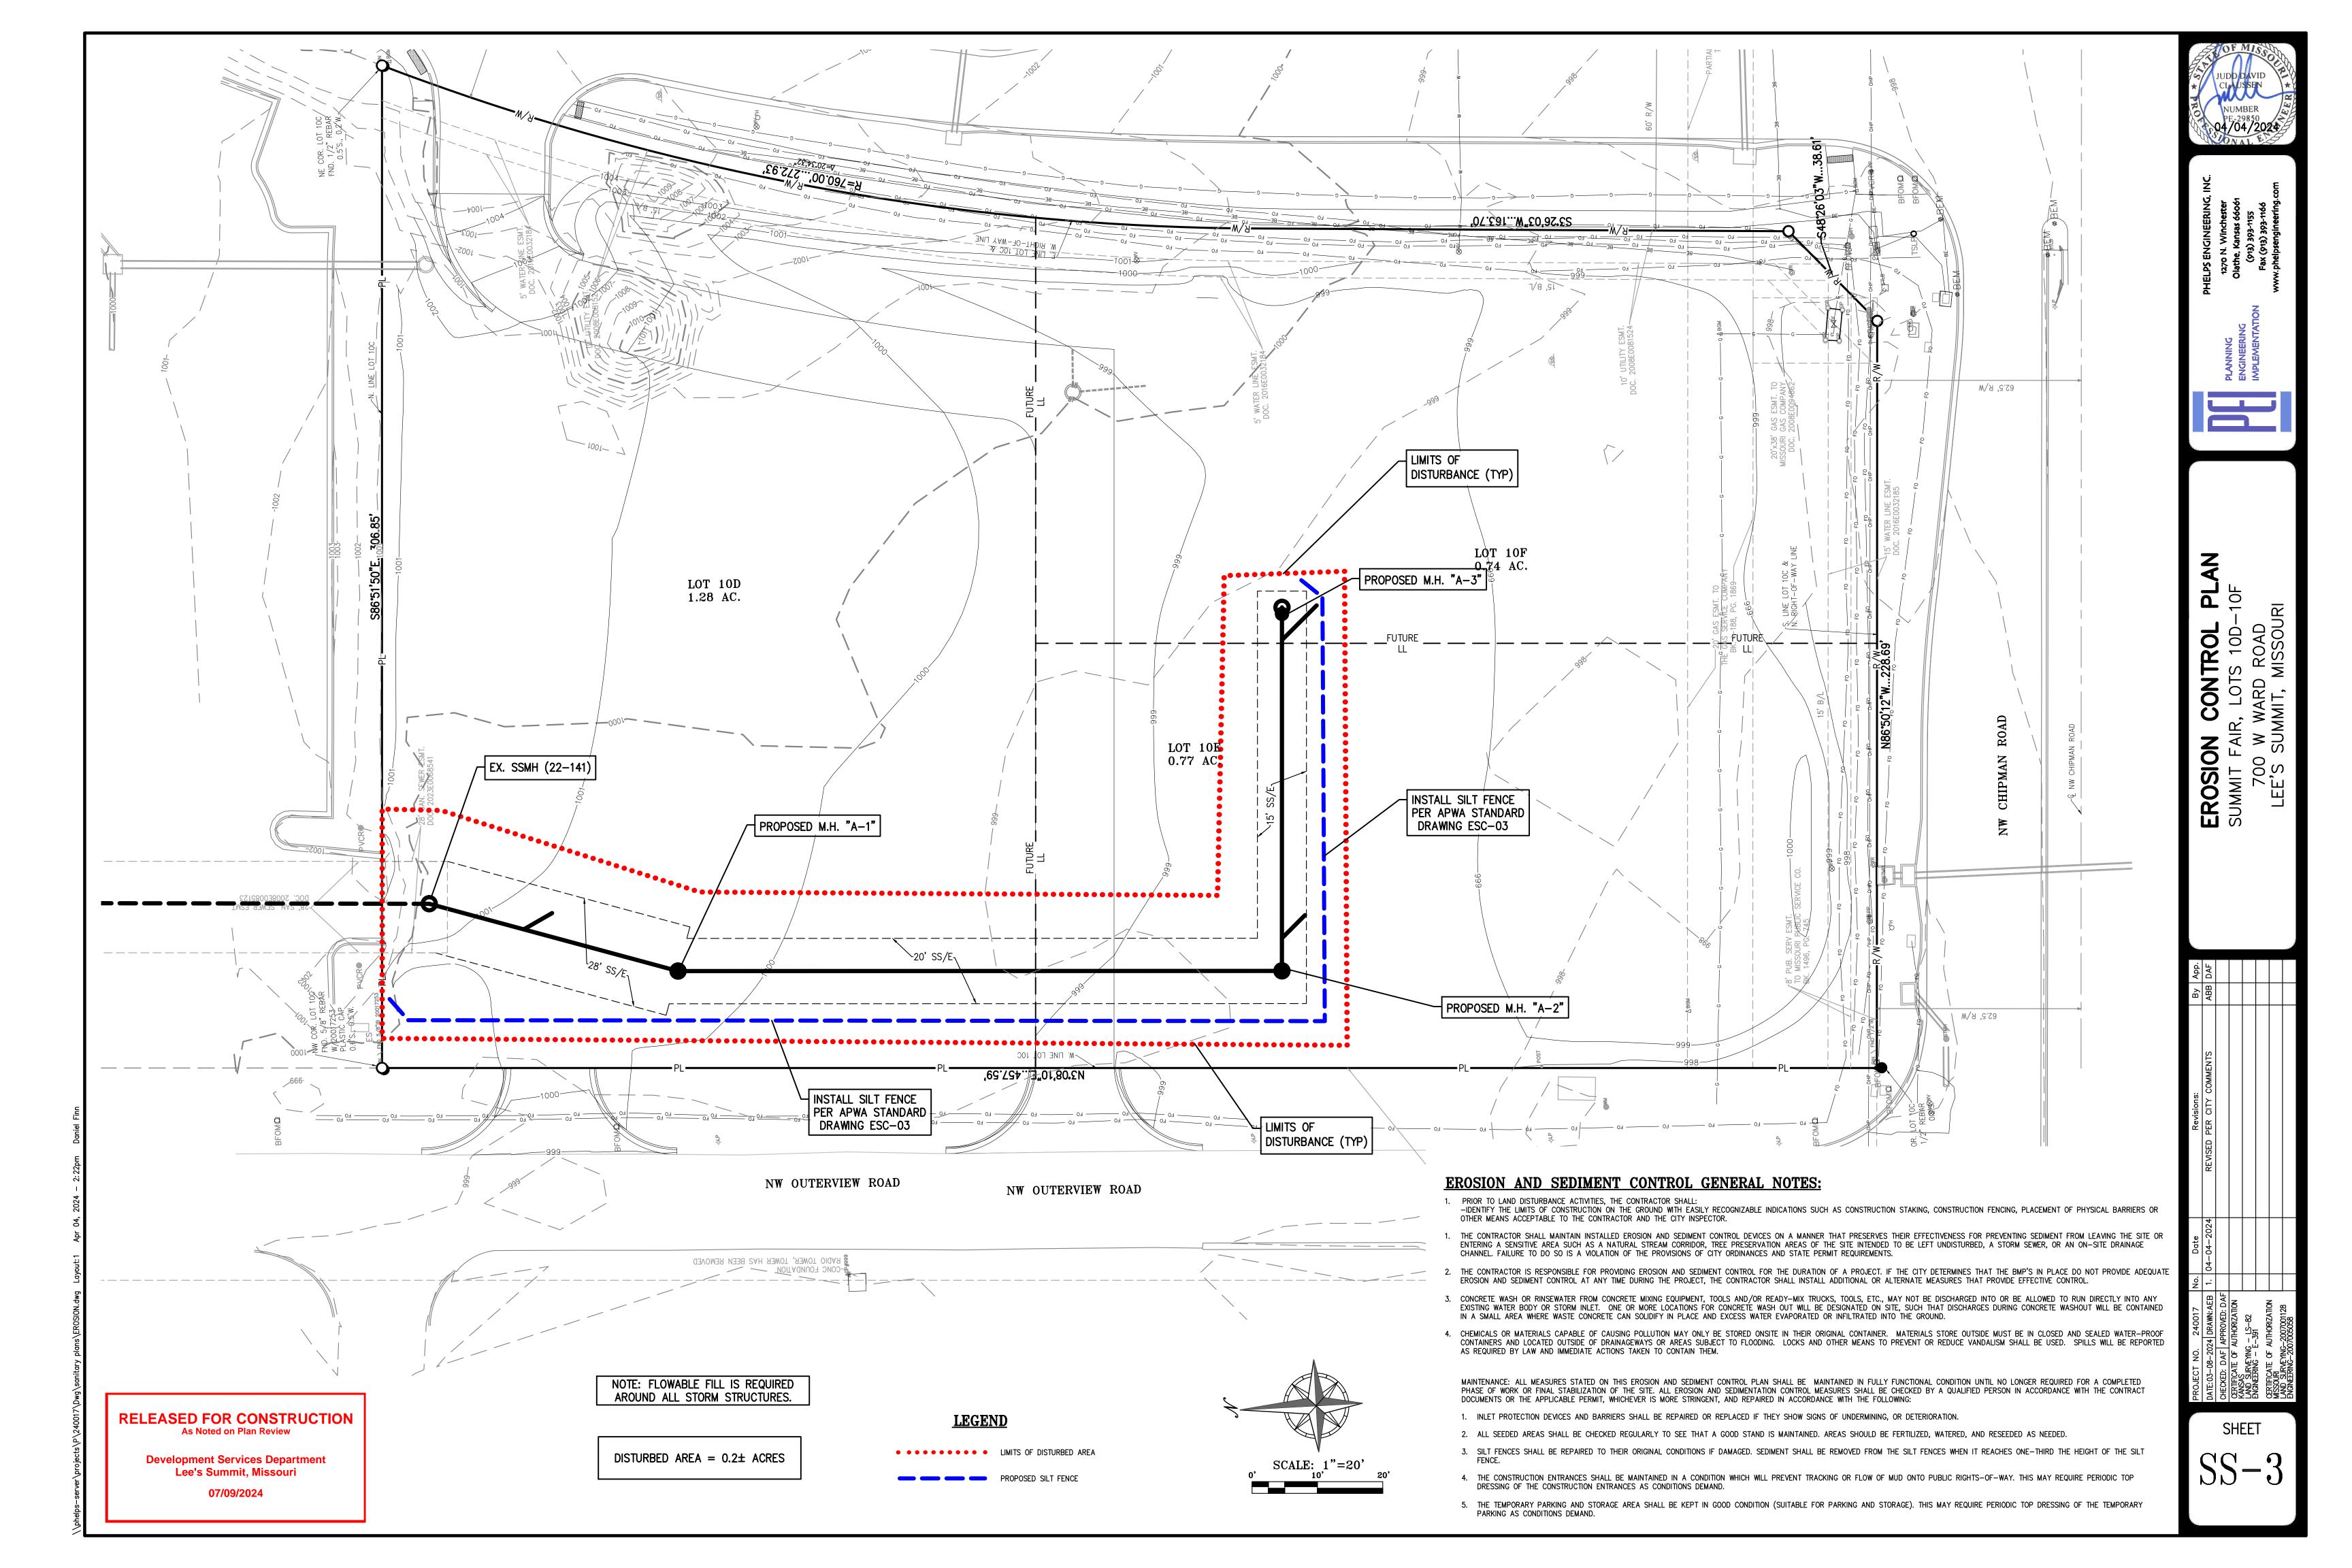


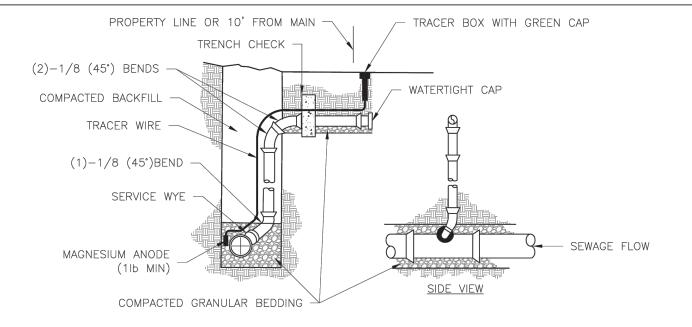

. ALL SEWER STUBS SHALL BE CONSTRUCTED TO PROPERTY LINE OR 10' MINIMUM FROM THE MAIN, WHICHEVER IS GREATER. WHERE SIDEWALKS ARE PRESENT, CONTRACTOR SHALL EXTEND SERVICE LINE UNDER EXISTING SIDEWALK TO 2. IMPERVIOUS TRENCH CHECKS SHALL BE PLACED ON BUILDING SEWER STUBS (AT LEAST 5' AWAY FROM THE SANITARY

- SEWER MAIN). 3. TRENCH CHECKS ON THE BUILDING SEWER STUBS SHALL EXTEND 6" BELOW THE BOTTOM OF THE PIPE. LENGTH SHALL BE A MINIMUM OF 12". THE HEIGHT OF THE TRENCH CHECK SHALL EXTEND 12" ABOVE THE TOP OF THE PIPE. THE WIDTH OF THE TRENCH CHECK SHALL BE THE WIDTH OF THE TRENCH. 4. SEE SPECIFICATION SECTION 2100 FOR SEWER MAIN BEDDING AND BACKFILL.
- 5. #12 GAUGE GREEN INSULATED COPPER TRACER WIRE SHALL BE INSTALLED. TRACER WIRE TERMINAL BOXES SHALL BE INSTALLED DIRECTLY ABOVE THE SEWER SERVICE OR AS DETERMINED BY THE ENGINEER. 6. FOR SERVICES, TRACER WIRE SHALL RUN FROM THE WYE AND TERMINATE IN A FLUSH MOUNTED TRACER BOX WITH A GREEN CAST IRON LOCKABLE TOP. WIRE SHALL BE TAPED OR TIED TO THE PIPE AT 5' INTERVALS.
- 7. TRACER WIRE BOX SHALL BE INSTALLED WITHIN 1.0' OF PROPERTY LINE.
 8. THE TRACER WIRE SHALL REMAIN CONTINUOUS TO THE GREATEST EXTENT POSSIBLE. SPLICES IN THE TRACER WIRE SHOULD BE MADE WITH SPLIT BOLT CONNECTORS. WIRE NUTS SHALL NOT BE USED. A WATER-PROOF CONNECTION IS


NECESSARY TO PREVENT CORROSION. **LEE'S SUMMIT** rawn By: MJF MISSOURI necked By: DL SANITARY SEWER STUB DETAIL

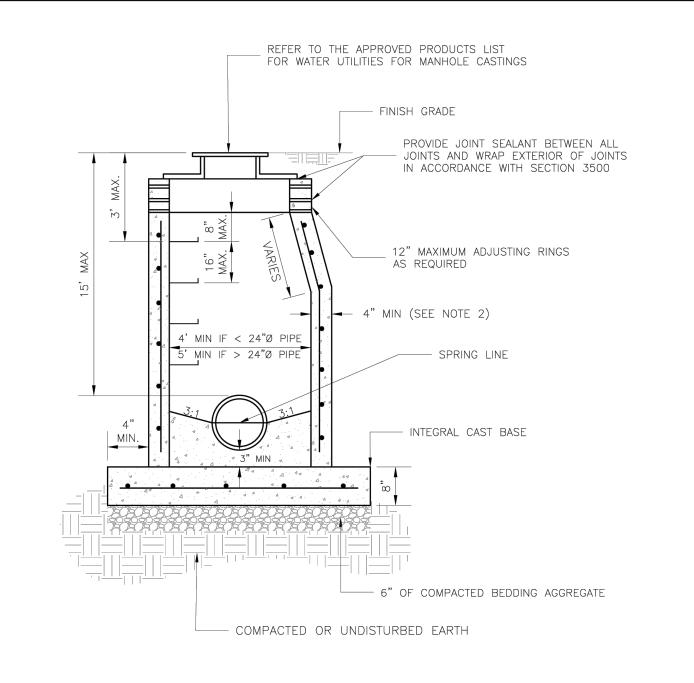


- . PRECAST CONCRETE MANHOLES SHALL CONFORM TO ASTM C478 EXCEPT AS MODIFIED BY THE SPECIFICATIONS. . A WALL THICKNESS NOT LESS THAN ONE—TWELFTH $(rac{1}{12})$ OF THE INSIDE DIAMETER OR 4", WHICHEVER IS GREATER, SHALL BE USED WHEN THE MANHOLE DEPTH IS LESS THEN 15'.
- 3. WATERPROOFING SHALL BE REQUIRED ON THE OUTSIDE OF MANHOLES. THE WATERPROOFING SHALL CONSIST OF A TOTAL DRY FILM THICKNESS OF NOT LESS THAN 14 MILS OF BITUMINOUS COATING.

 4. ONLY ECCENTRIC MANHOLE CONES WILL BE ALLOWED UNLESS OTHERWISE APPROVED BY THE CITY ENGINEER. THE FILL CONCRETE FLOW CHANNEL FOR SIDE BRANCHES SHALL BE PLACED TO PROVIDE A SMOOTH TRANSITION
- INTO THE FLOW LINE. 6. REFER TO THE APPROVED PRODUCTS LIST FOR WATER UTILITIES FOR APPROVED MANHOLE GASKET MODELS.
 7. REFER TO THE APPROVED PRODUCTS LIST FOR APPROVED STEPS.

	LEE'C CLIMANAIT	Date: 08/2023
	LEE'S SUMMIT	Drawn By: MF
	MISSOURI	Checked By: AB
	PUBLIC WORKS ENGINEERING DIVISION 220 SE GREEN STREET LEE'S SUMMIT, MO 64063	
4	STANDARD SANITARY PRECAST MANHOLE	SAN-2

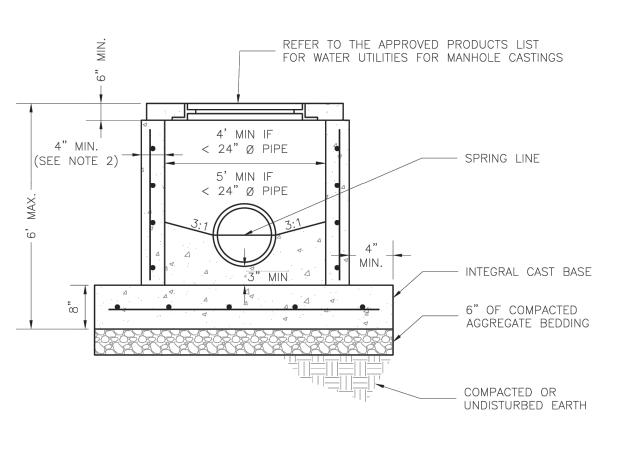

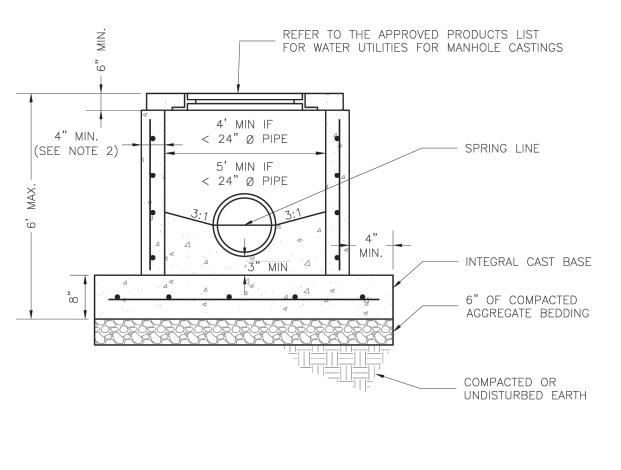

PRECAST CONCRETE MANHOLES SHALL CONFORM TO ASTM C478 EXCEPT AS MODIFIED BY THE

2. A WALL THICKNESS NOT LESS THAN ONE-TWELFTH (1/12) OF THE INSIDE DIAMETER OR 4", WHICHEVER

WATERPROOFING SHALL BE REQUIRED ON THE OUTSIDE OF MANHOLES. THE WATERPROOFING SHALL CONSIST OF A TOTAL DRY FILM THICKNESS OF NOT LESS THEN 14 MILS OF BITUMINOUS COATING.

4. THE FILL CONCRETE FLOW CHANNEL FOR SIDE BRANCHES SHALL BE PLACED TO PROVIDE A SMOOTH

6. PROVIDE STEPS AS SHOWN ON THE APPROVED PRODUCTS LIST FOR MANHOLE DEPTHS GREATER THAN 4'.

LEE'S SUMMIT

STANDARD SHALLOW SANITARY PRECAST MANHOLE

MISSOURI

Date: 12/2015

Drawn By: MJF

Checked By: DL


SAN-3


. REFER TO THE APPROVED PRODUCTS LIST FOR WATER UTILITIES FOR MANHOLE GASKET MODELS.


SPECIFICATIONS.

IS GREATER SHALL BE USED.


TRANSITION INTO THE FLOW LINE.

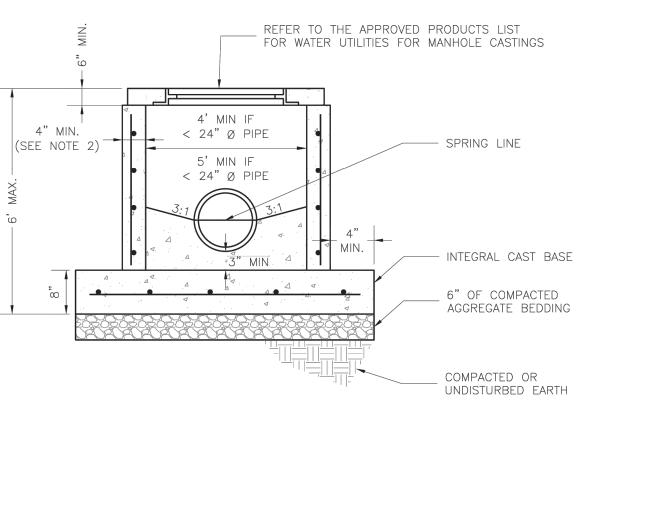

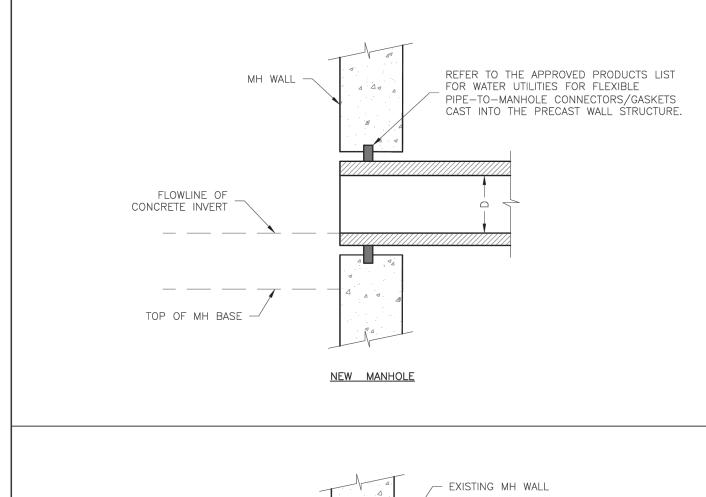

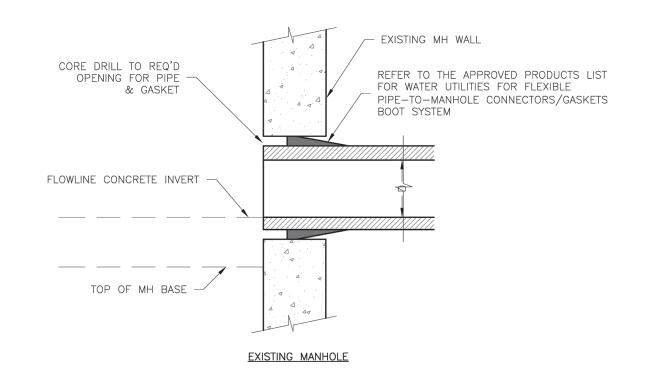

	LEE'S SUMMIT	Date: 02/2013
	LEE 3 30 MINIT	Drawn By: MJF
	MISSOURI	Checked By: DL
	PUBLIC WORKS ENGINEERING DIVISION 220 SE GREEN STREET LEE'S SUMMIT, MO 64063	
	MANHOLE WALL CONNECTION	SAN-

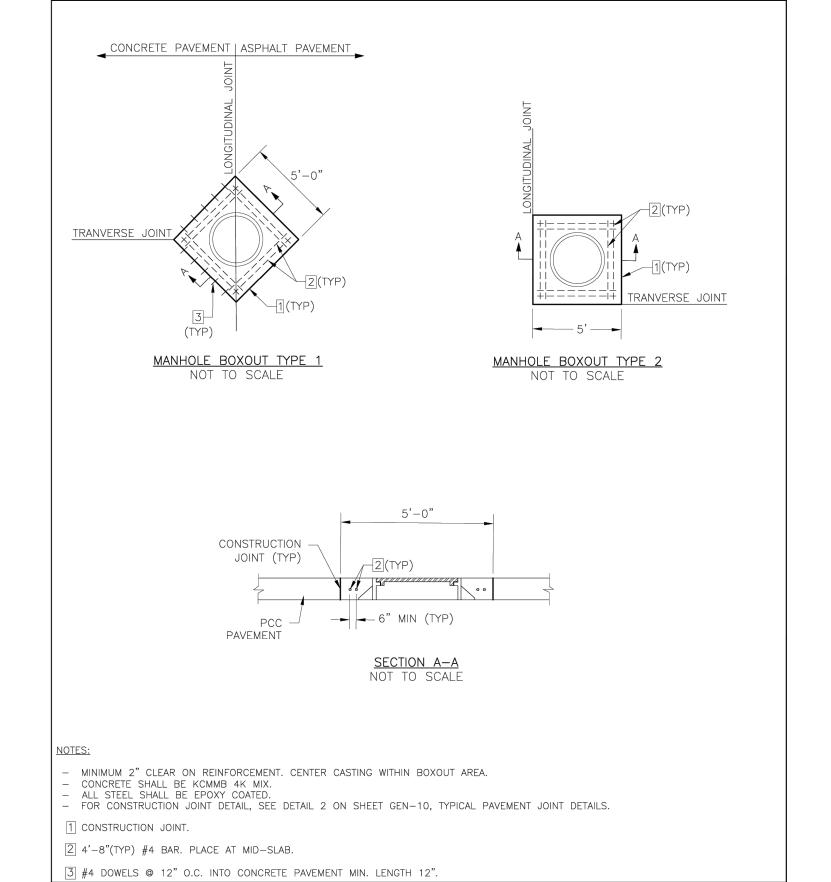


LEE'S SUMMIT

MISSOURI

MANHOLE BOXOUT IN PAVEMENT DETAIL

Checked By: AB

SAN-9

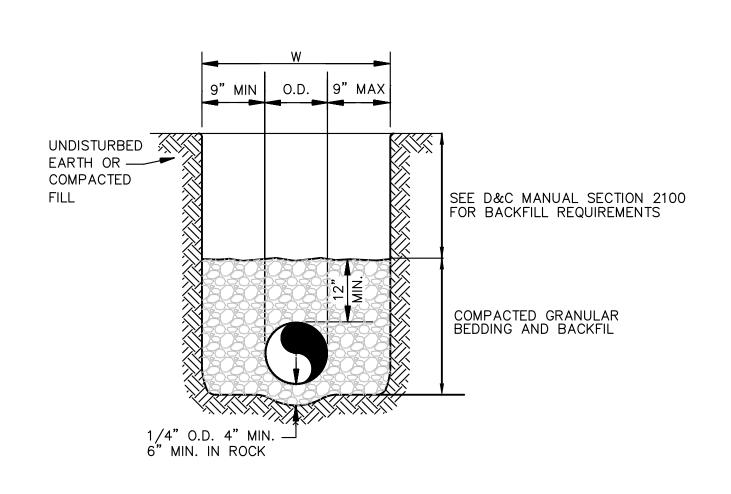

SANITARY SEWER - PVC (SDR-26) SCALE: NOT TO SCALE

PIPE INSTALLATION DETAIL

RELEASED FOR CONSTRUCTION As Noted on Plan Review

> **Development Services Department** Lee's Summit, Missouri 07/09/2024

