

- THE SYSTEM DESIGN CRITERIA COMPLIES WITH THE REQUIREMENTS OF NIFPA 13 2016EDITION.
- 2. ALL PIPING SHALL CONFORM WITH THE REQUIREMENTS OF NFPA 13 2016 EDITION.
- 3. ALL FITTINGS SHALL CONFORM WITH THE REQUIREMENTS OF NFPA 13 2016 EDITION.
- 4. ALL HANGERS SHALL CONFORM TO THE REQUIREMENTS OF NFPA 13 2016 EDITION.
- 5. FITTINGS FOR 1" THRU 2" SHALL BE CAST IRON THREADED. FITTINGS FOR 2 1/2" THRU 4" PIPING ARE TO BE GROOVED OR WELDED OUTLETS.
- 6. LENGTHS OF PIPING I" THRU 2" ARE SHOWN AS THREAD TO THREAD UNLESS NOTED AS: G- GROOVE OR C- CENTER. 2 1/2" THRU 4" PIPE LENGTHS ARE SHOWN AS CENTER TO CENTER UNLESS NOTED AS: G - GROOVE, W - WELD, F -FACE OR FLANGE OR T - THREAD.
- 7. ALL SECTIONS OF TRAPPED PIPING SHALL HAVE AUXILIARY DRAINS WHERE REQUIRED.
- 9. ALL SWITCHBOARDS, PANEL BOARDS, DISTRIBUTION BOARDS AND MOTOR CONTROL CENTERS SHALL BE PROTECTED FROM DAMAGE BY OTHERS.

CONSTRUCTION: EXISTING CONSTRUCTION

EXISTING PIPING NEW PIPING

HANGER SPACING TABLE HANGER SPACING FOR STEEL PIPE (SCH. 40)

HANGER SPACING

NEW OFFICES ARE LIGHT HAZARD NO NEW CALCULATIONS PROVIDED

NEW OFFICE PIPING FED FROM EXISTING OVERHEAD BRANCHLINES

1/2" 4 LARGER

PIPE TYPE: SCREUED 2" AND SMALLER TO BE SCH. 40 PIPE. WELDED 2" AND LARGER TO BE SCH. 10 PIPE.

HANGER SPACING FOR STEEL PIPE (THINWALL)

HANGER SPACING

l" - 3"

4" 4 LARGER

DESIGN CRITERIA: PER NFPA 43, LIGHT HAZARD, 0.10 GPM/SQFT FOR 1500 SQFT. OPERATING

MAX 225 SOFT/HEAD SPACING + 100 GFM FOR HOSE ALLOWANCE. NOTE: REDUCE OPERATING AREA FOR QUICK RESPONSE SPRINKLER HEADS PER NFPA 13. ALL SPRINKLERS TO BE QUICK RESPONSE TYPE, APPROVED FOR SPECIFIC OCCUPANCY.

1					
		(N)		
1	\				
				/	

	Symbols						Sprink	der He	ead Summary			
Symbol	Description	Symbol	Count	NPT	Orif.	Make	Model	Finish	Style	Temp.	K=	SIN
\circ	Hydraulic Reference Points	0							EXISTING ESFR PENDANT TO REMAIN			
⊈ =0′−0 ″	Elev. Below Top of Steel	8	8	3/4"	3/4"	VIKING	QREC	CHROME	QR EC PENDANT W/ CHR REC ESC	200°	11.2K	VK534
EL=0'-0"	Elev. Above Finished Floor	0	6	1/2"	1/2"	VIKING	MICROFAST	CHROME	OR PENDANT W/ CHR REC ESC	200°	5.6K	VK3Ø21
+ (TOS 0'-0"	Elev. of Top of Steel											
Ø'-Ø"	Ceiling Height					XY 55						
	Denotes Hanger Location											
0	Rise up or down											
ALL PIPE CUTS ARE CENTER TO CENTER												


NOTICE OF NONRESPONSIBILITY

SCALE 1/8"=1'-0"

THIS DRAWING SHALL BE USED AS A CONSTRUCTION GUIDE ONLY.
ADVANTAGE FIRE PROTECTION SYSTEMS, INC. ASSUMES NO RESPONSIBILITY FOR UNAUTHORIZED USE OF THESE DRAWINGS.
THE USE OF THIS DRAWING FOR STRUCTURAL OR ARCHITECTURAL DURBOSES IS NOT OR ARCHITECTURAL PURPOSES IS NOT AUTHORIZED. THIS PRINT IS THE EXCLUSIVE PROPERTY OF;

ADVANTAGE FIRE PROTECTION SYSTEMS, INC

AREA OF WORK

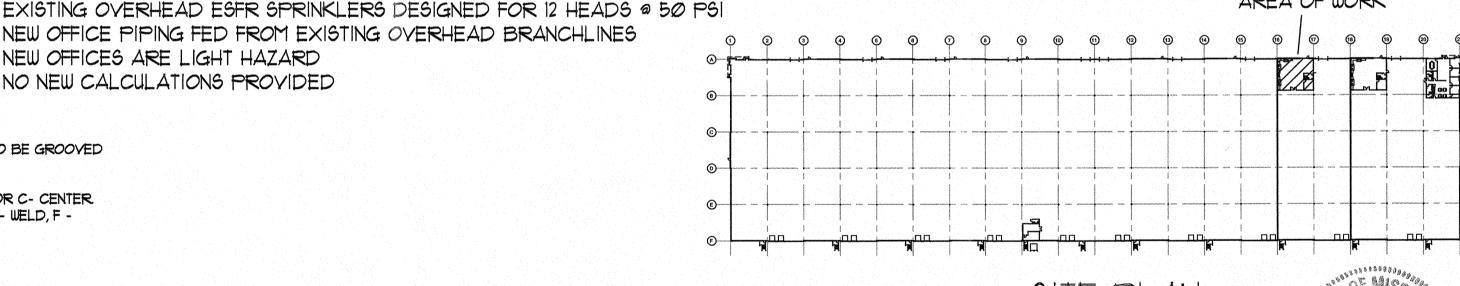

SITE PLAN NO SCALE



TENANT FINISH PLAN

WALLFLOWER 2229 NW TOWN CENTRE BLYD. LEE'S SUMMIT, MISSOURI 64064



FIRE PROTECTION SYSTEMS INC.

404B N.W. 11th Street Blue Springs, MO. 64015 Tel. (816) 224-3400

"We are your Advantage"

	LEE'S SUMMIT FIRE DEPT
	HEADS THIS SHEET
	14 (1) (1) (1) (1) (1) (1) (1) (1
	TOTAL HEADS FOR JOB
	14
	SCALE
7	1/8" = 1'-0"
	DRAWN BY
	MATT KNOX
	REVISION DATE

REVIEWING AUTHORITY

DATE DRAWN 4/18/24 CONTRACT NUMBER J-2396 DRAWING NUMBER OF