GENERAL NOTES


- 1. PETROLEUM PIPING TO BE DUALOY DOUBLE WALL PIPING WITH 2" DUALOY 3000 XL FRP PRIMARY PIPING, AND DUALOY XL 3" SECONDARY CONTAINMENT PIPING
- 2. VENT LINES TO BE 2" FIBERGLASS, BELOW GROUND TO CANOPY COLUMN, AND 2" SCHEDULE 40 GALVANIZED STEEL ABOVE GROUND, TO 2' ABOVE CANOPY FASCIA.
- 3. ELECTRICAL CONTRACTOR TO USE ENVIROFLEX BULKHEAD FITTINGS AT ALL CONDUIT PENETRATIONS THRU SUMPS AND TURBINES.
- 4. ALL PENETRATIONS THRU SUMPS AND TURBINES TO BE SEALED WITH POLYURETHANE SEALANT.
- 5. ALL DIPENSERS TO BE WIRED ON SAME PHASE WITH NEUTRAL TRIP BREAKERS.
- 6. SEE ADDITIONAL NOTES ON ON ELECTRICAL DRAWING.
- 7. ALL ELECTRICAL WORK TO BE IN ACCORDANCE WITH PREVAILING NEC CODES.
- 8. ALL PETROLEUM WORK TO BE IN ACCORDANCE WITH CURRENT EPA TECHNICAL STANDARDS, STATE REGULATIONS, AND NFPA-30.
- 9. ELECTRICAL AND PETROLEUM CONTRACTORS TO VERIFY THAT SPECIFIED WIRING IS PER MANUFACTURERS SPECIFICATIONS FOR EQUIPMENT DELIVERED TO PROJECT. ON TIME.
- 10. THE FIRE MARSHALL OR APPROPRIATE JURISDICTION WILL BE NOTIFIED 48 HOURS IN ADVANCE OF ANY AND ALL INSPECTIONS RELATED TO THE UNDERGROUND TANKS AND PIPING.
- 11. THE FUEL STORAGE TANKS AND DISPENSERS WILL BE IN ACCORDANCE WITH ALL APPLICABLE SECTIONS OF THE CURRENT INTERNATIONAL BUILDING CODE,
- 12. THE DISPENSING DEVICES WILL BE EQUIPPED WITH 3/4" BREAK-A-WAY DEVICES DESIGNED TO MAINTAIN FUEL ON BOTH SIDES OF THE BREAK-A-WAY POINT.
- 13. THE "EMERGENCY PUMP SHUT-OFF" WILL BE LOCATED AT THE CASHIER AND FUEL ISLANDS IF REQUIRED. SIGNS ON CANOPY COLUMNS WILL CLEARLY IDENTIFY THE LOCATION.
- 14. THE MASTER SWITCH ON ALL INDIVIDUAL PUMP CIRCUITS SWITCHES SHALL BE TURNED OFF BEFORE CLOSING THE DISPENSING STATION FOR BUSINESS.
- 15. PROVIDE MINIMUM (2A-20BC) FIRE EXTINGUISHERS ON CANOPY COLUMNS NOT TO EXCEED 75'-0" OF DISTANCE BETWEEN THEM.
- 16. ALL THE DISPENSING DEVICES WILL BE BOLTED TO ISLAND FORMS AS SPECIFIED BY MANUFACTURES SPECS.
- 17. ALL SUBMERSIBLE PUMPS WILL HAVE FULL PORT BALL VALVES INSTALLED

DISPENSING EQUIPMENT

GILBARCO


TANK MONITOR AND LEAK DETECTION

GILBARCO/VEEDER ROOT TLS-450

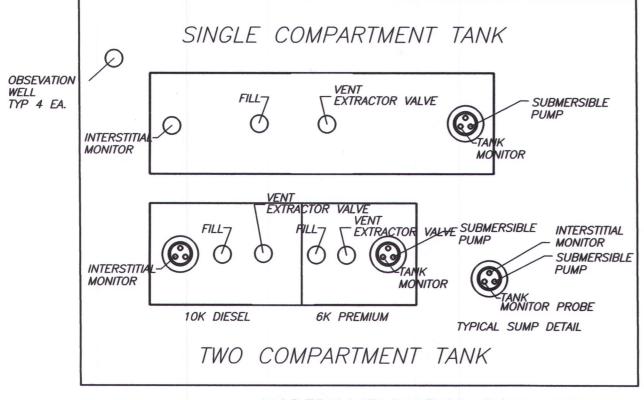





MODERN WELDING COMPANY, INC. GLASTEEL II JACKETED UNDERGROUND TANK

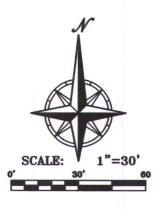

NOTE: TANKS & PIPING SHOWN AS REFERENCE ONLY

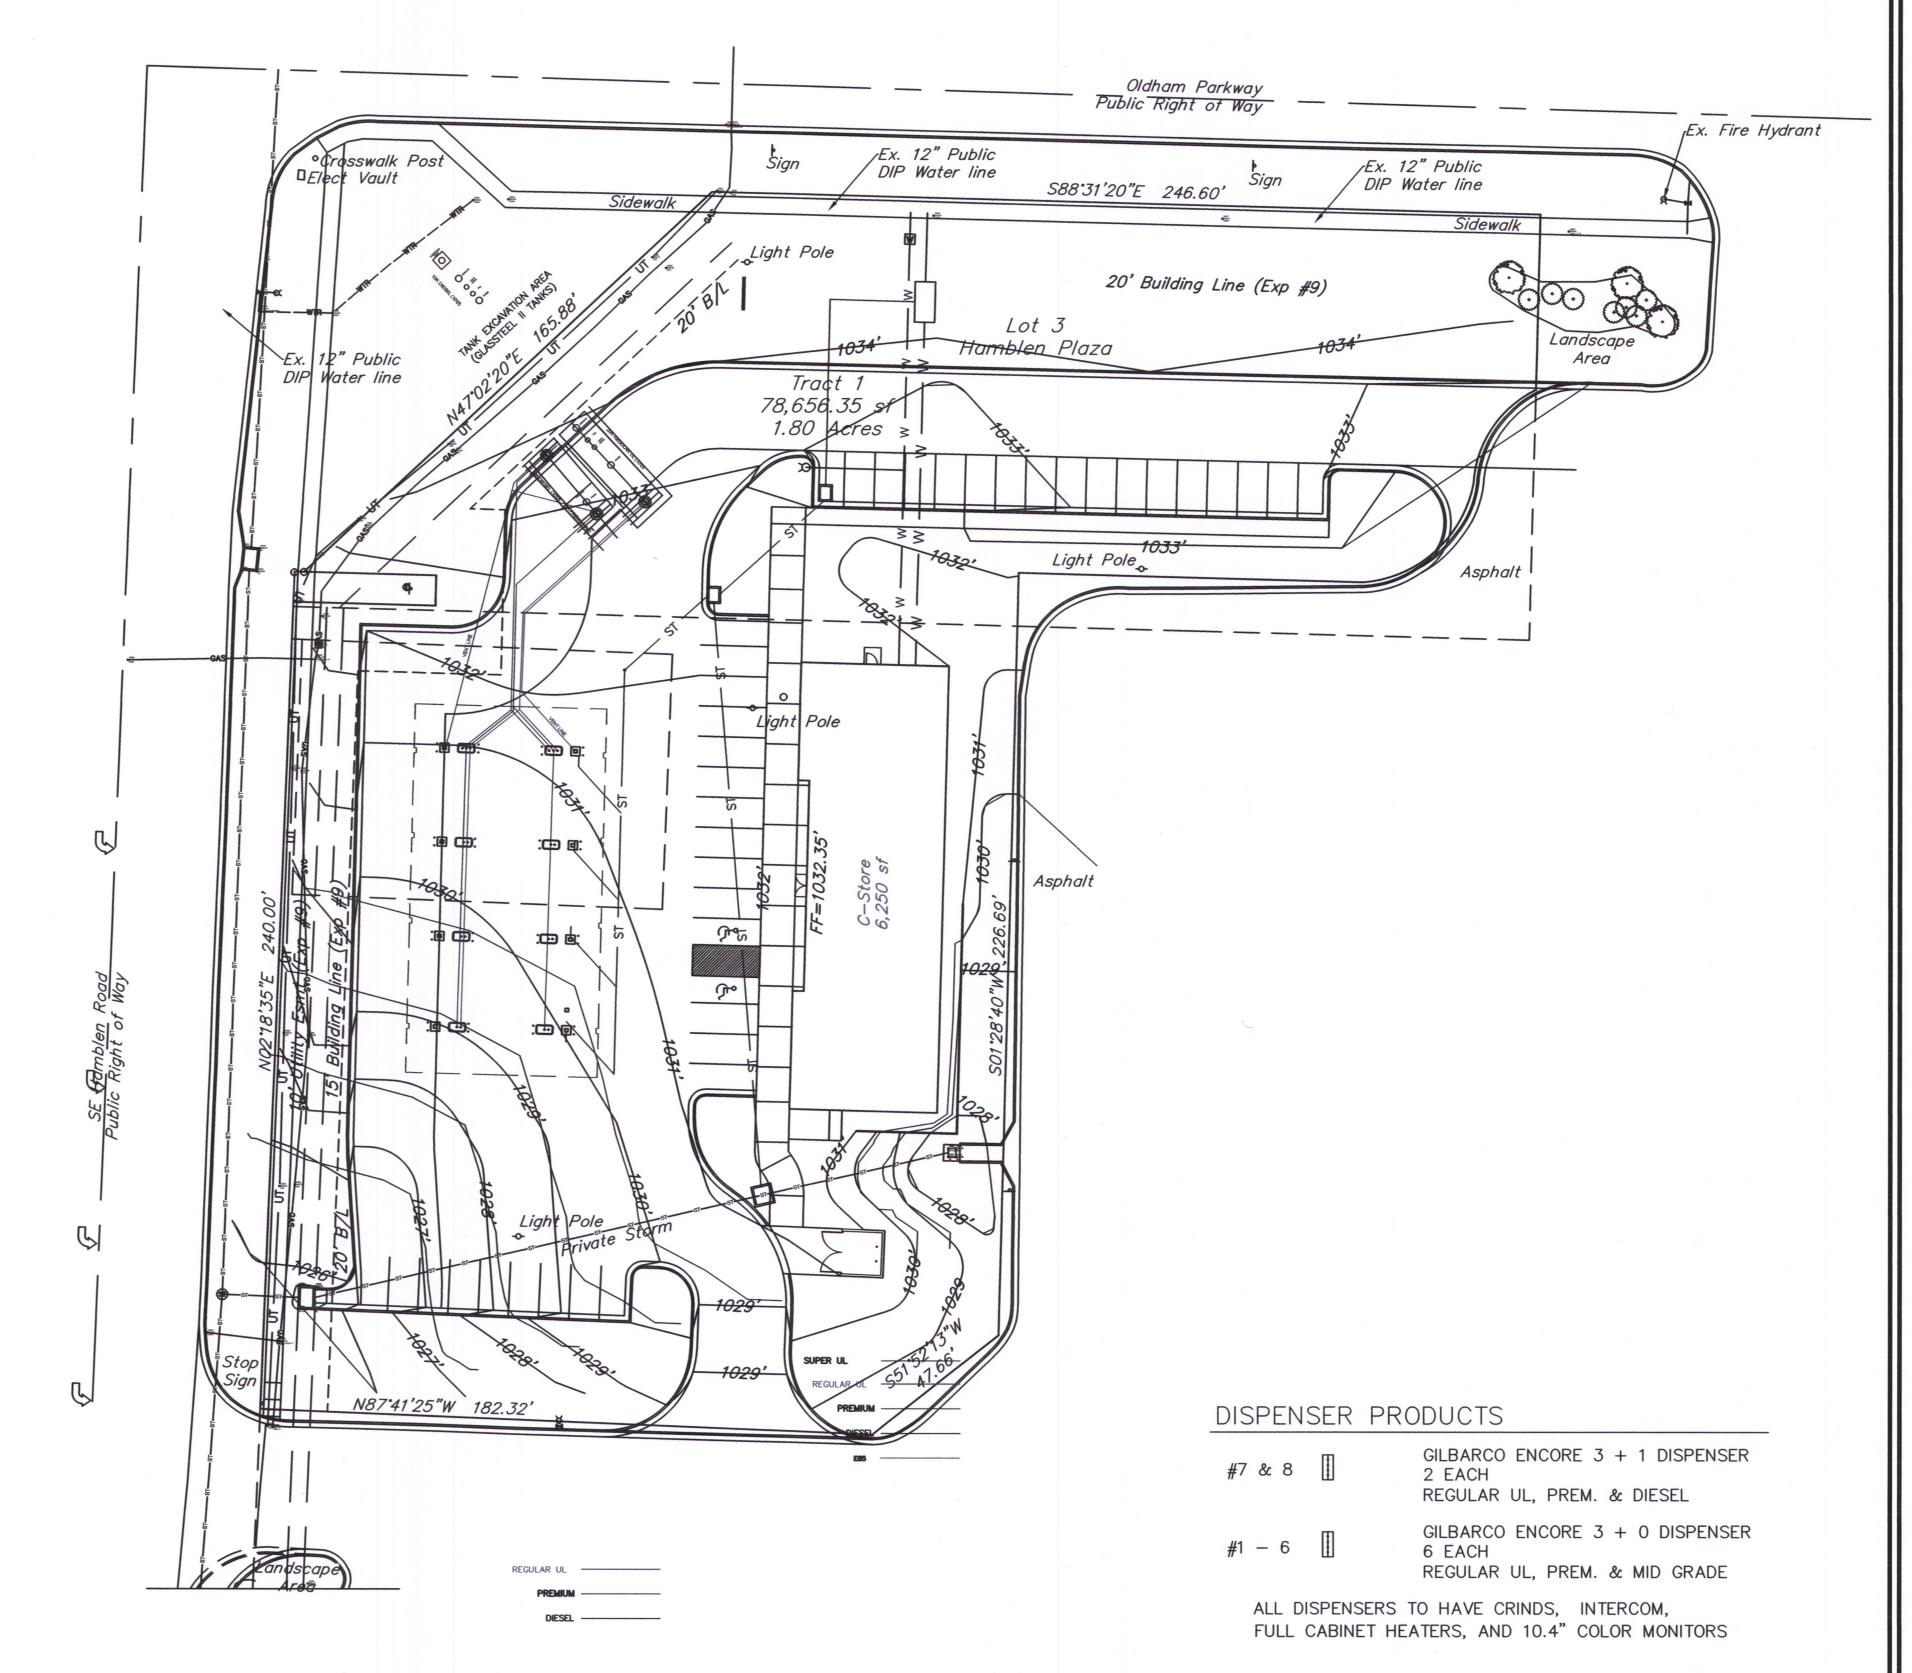

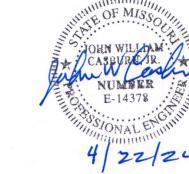

TANK PIPING PLAN

SCALE: 1" = 30'-0"

SEALED:

STORE CONVENIENCE OLEUM PETR HAMBLEIN S E LION 601

LEE'S

SHEET NO: