

RIGID INSULATION

DRYWALL, CUT STONE

GROUT TILE (LARGE SCALE)

WOOD BLOCKING

MEMBER

(CONTINUOUS)

WOOD STUDS

**FINISHED** 

**ELEVATION** 

HOLLOW METAL

HORESEPOWER

HORIZONTAL

DIAG

DIA

DIAGONAL

DIAMETER

DIMENSION

SAND, GRAVEL, PLASTER,

**MATERIAL LEGEND** 

BATT INSULATION

ACOUSTIC TILE (SECTION)

CONCRETE MASONRY UNITS

CONCRETE.

PLASTER CUT

STONE, STUCCO

PLAN OR SECTION

BRICK


\_\_\_\_ CARPET

CONCRETE

# CORE & SHELL BUILDING

# STREETS OF WEST PRYOR LOT 13

# 1020 NW PRYOR ROAD, LEES SUMMIT, MISSOURI

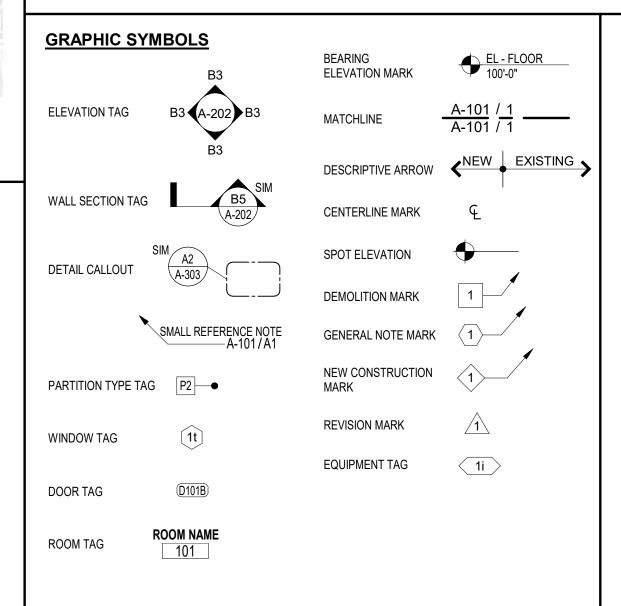

	CODE SUMMARY		
	PROJECT SCOPE:		
	CORE & SHELL DOCUMENTS. DRAWINGS IMPROVEMENT WILL BE ISSUED A SEPAR PROVIDED BY OTHERS.	-	ND
÷	JURISDICTIONAL BUILDIN	IG CODES	<u>S:</u>
•	INTERNATIONAL BUILDING CODE INTERNATIONAL MECHANICAL CODE	2018 2018	

#### BUILDING CODES 2018 NATIONAL ELECTRICAL CODE INTERNATIONAL PLUMBING CODE 2018 INTERNATIONAL FIRE CODE 2018 INTERNATIONAL FUEL GAS CODE

#### ICC/ANSI A117.1 ACCESSIBLE AND USABLE BUILDINGS AND FACILITIES **CONSTRUCTION INFORMATION:** BUILDING TYPE: NEW CONSTRUCTION OCCUPANCY TYPES: CONSTRUCTION TYPE:

ALLOWABLE HEIGHT:	40 FT
ACTUAL HEIGHT:	26 FT
ALLOWABLE STORIES:	1
ACTUAL STORIES:	1
GROSS BUILDING AREA:	13,989 SF
ALLOWABLE FLOOR	<u>AREA:</u>
ALLOWARIE FLOOR AREA (M):	9.000 SE

2-HR SEPARATION •••••

2-HR SEPARATION WALL WILL BE

CONSTRUCTED AS A FIRE BARRIER, UL #U301,

3041 SF

FIRST FLOOR

(A3) FII ... SCALE: 1" = 20'-0"

EXTENDING FROM FOUNDATION TO UNDERSIDE

#### TENANT B (M): IBC TABLE 1004.5 TOTAL NET SF 13,989 SF MERCANTILE OCCUPANTS **EXITS REQUIRED:** TENANT A (M): IBC TABLE 1006.2.1 EXITS REQUIRED EXITS PROVIDED 3 EXITS TENANT C (M): IBC TABLE 1006.2.1 1 EXIT EXITS REQUIRED EXITS PROVIDED 2 EXITS TENANT E (M): IBC TABLE 1006.2.1 EXITS REQUIRED 1 EXIT EXITS PROVIDED 2 EXITS TENANT G (M): IBC TABLE 1006.2.1 EXITS REQUIRED 2 EXITS 3 EXITS

**GROSS BUILDING AREA:** 

**OCCUPANT LOAD CALCS** 

1,999 SF

2,499 SF 6,997 SF

TENANT A:

TENANT C:

TENANT E

117

6997 SF

TOTAL GROSS AREA:

# STRUCTURAL FIRE PROTECTION (IBC TABLE 601)

<u>OTTROOFORKET INCET NOTEOTI</u>	<u> </u>
PRIMARY STRUCTURAL FRAME	(0) HOUR
EXTERIOR BEARING WALLS INTERIOR BEARNING WALLS	(0) HOUR (0) HOUR
EXTERIOR NON-BEARING WALLS & PARTITIONS	N/A
INTERIOR NON-BEARING WALLS & PARTITIONS	(0) HOUR
STRUCTURAL FRAME	(0) HOUR
FLOOR CONSTRUCTION ROOF CONSTRUCTION	(0) HOUR (0) HOUR
TOOL CONSTRUCTION	(0)110011

# STRUCTURAL FIRE PROTECTION (IBC TABLE 601)


1. AUTOMATIC SPRINKLER SYSTEM (YES) 2. EXIT LIGHTING PROVIDED

**TENANT E** 


42

1999 SF

MECHANICAL

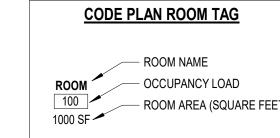

# M (MERCANTILE) V-B (SPRINKLERED) \*FRONTAGE INCREASE N/A DUE TO ACTUAL AREA LESS THAN ALLOWABLE FLOOR AREA EXITS PROVIDED

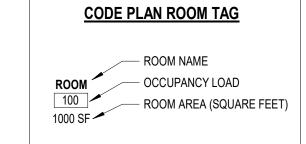

42

# **DESIGN TEAM**

ARCHITECTURAL DESIGN CONTACT: MICHAEL HAMPTON & RYMAN KINNEY SCHWERDT DESIGN GROUP 2231 SW WANAMAKER RD SUITE 303 PHONE: 785-273-7540 TOPEKA, KANSAS 66614 DIRECT: 785-730-0914

MECHANICAL & ELECTRICAL DESIGN

PKMR ENGINEERS CONTACT: BRYAN LEINWETTER PE 13300 WEST 98TH STREET PHONE: 913-492-2400 LENEXA, KANSAS, 66215 E-MAIL: BRYAN.LEINWETTER@PKMRENG.COM

E-MAIL: MKH@SDGARCH.COM

RAK@SDGARCH.COM


STRUCTURAL DESIGN

CERTUS STRUCTURAL ENGINEERS CONTACT: AARON SCOTT PE PHONE: 785-291-0400 900 S KANSAS AVENUE SUITE 400 E-MAIL: AARON.SCOTT@CERTUSSE.COM TOPEKA, KANSAS, 66612

SM ENGINEERING CONTACT: SAM MALINOWSKI, PE 919 W STEWART ROAD PHONE: 785-341-9747 COLUMBIA, MISSOURI 65203 E-MAIL: SMCIVILENGR@GMAIL.COM

**SHEET INDEX** 

**ARCHITECTURAL** G-001 COVER SHEET

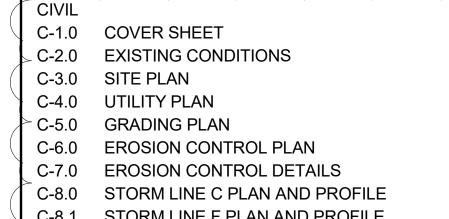

STORM LINE F PLAN AND PROFILE WATERLINE A PLAN AND PROFILE WATERLINE B & C PLAN AND PROFILE

C-11 DETAILS

C-12 DETAILS C-13

LANDSCAPE PLAN

# **ARCHITECTURAL**

A-100 SITE PLAN & DETAILS

FIRST FLOOR PLAN A-102 ROOF PLAN

A-201 EXTERIOR ELEVATIONS

A-202 EXTERIOR ENLARGED ELEVATION & FENCE DTLS

A-301 WALL SECTIONS

A-302 WALL SECTIONS A-501 BUILDING DETAILS

A-502 BUILDING DETAILS A-503 BUILDING DETAILS

A-601 GLASS & DOOR SCHEDULES

STRUCTURAL

S-001 GENERAL NOTES

S-101 FOUNDATION PLAN

S-102 CANOPY FOUNDATION & FRAMING PLANS

WALL FRAMING PLAN

S-104 ROOF FRAMING PLAN S-201 NW FRAMING ISOMETRIC

S-202 SE FRAMING ISOMETRIC

**CONCRETE DETAILS & SECTIONS 1** FRAMING DETAILS & SECTIONS 1

S-602 FRAMING DETAILS & SECTIONS 2

S-603 FRAMING DETAILS & SECTIONS 3

MECHANICAL. ELECTRICAL. PLUMBING ME-101 MEP NOTES & SPECIFICATIONS

MECHANICAL

M-101 PLUMBING PLAN

M-201 HVAC PLAN

M-301 MECHANICAL DETAILS & SCHEDULES

**ELECTRICAL** 

E-101 POWER PLAN

E-102 ELECTRICAL DETAILS & SCHEDULES

E-201 LIGHTING PLAN

E-202 SITE LIGHTING PLAN

E-203 SITE PHOTOMETRIC PLAN

ES MES  $\mathbf{m}$ 

schwerdt design grou

500 north broadway oklahoma city, ok 73102 phone: 405.231.3105 fax: 405.231.3115

MICHAEL K HAMPTON

ARCHITECT (MO# A-2008027042

SCHWERDT DESIGN GROUP INC

MISSOURI STATE CERTIFICATE


OF AUTHORITY #F00353876

architecture | interiors | plannin

UBMISSION DATES 12-27-2023 JAN 19TH, 2024

**COVER SHEET** 

235008

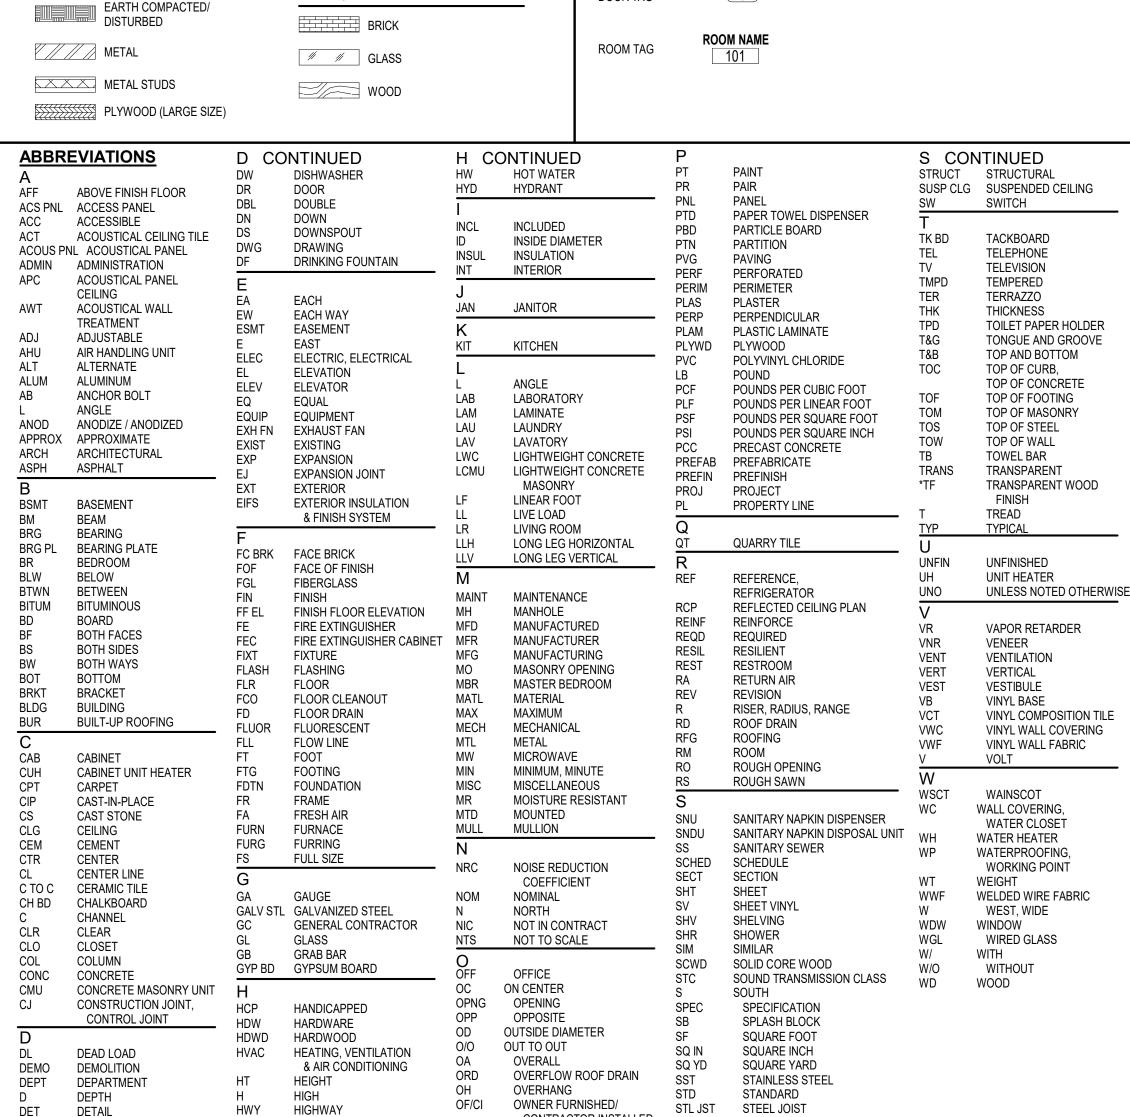

CONTRACTOR INSTALLED

OWNER FURNISHED/

OWNER INSTALLED

STORAGE

STREET

STORM DRAIN

# FINAL DEVELOPMENT PLANS LOT 13A OF WEST PRYOR

UTILITIES
Electric Service
EVERGY
Nathan Michael
913-347-4310
Nathan.michael@kcpl.com

Gas Service
Spire
Katie Darnell
816-969-2247
Katie.darnell@spireenergy.com


Water/Sanitary Sewer
Water Utilities Department
1200 SE Hamblen Road
Lee's Summit, Mo 64081
Jeff Thorn
816-969-1900
jeff.thorn@cityofls.net

Communication Service AT&T Carrie Cilke 816-703-4386 cc3527@att.com

Time Warner Cable
Steve Baxter
913-643-1928
steve.baxter@charter.com

Comcast
Ryan Alkire
816-795-2218
ryan.alkire@cable.comcast.com

Google Fiber
Becky Davis
913-725-8745
rebeccadavis@google.com

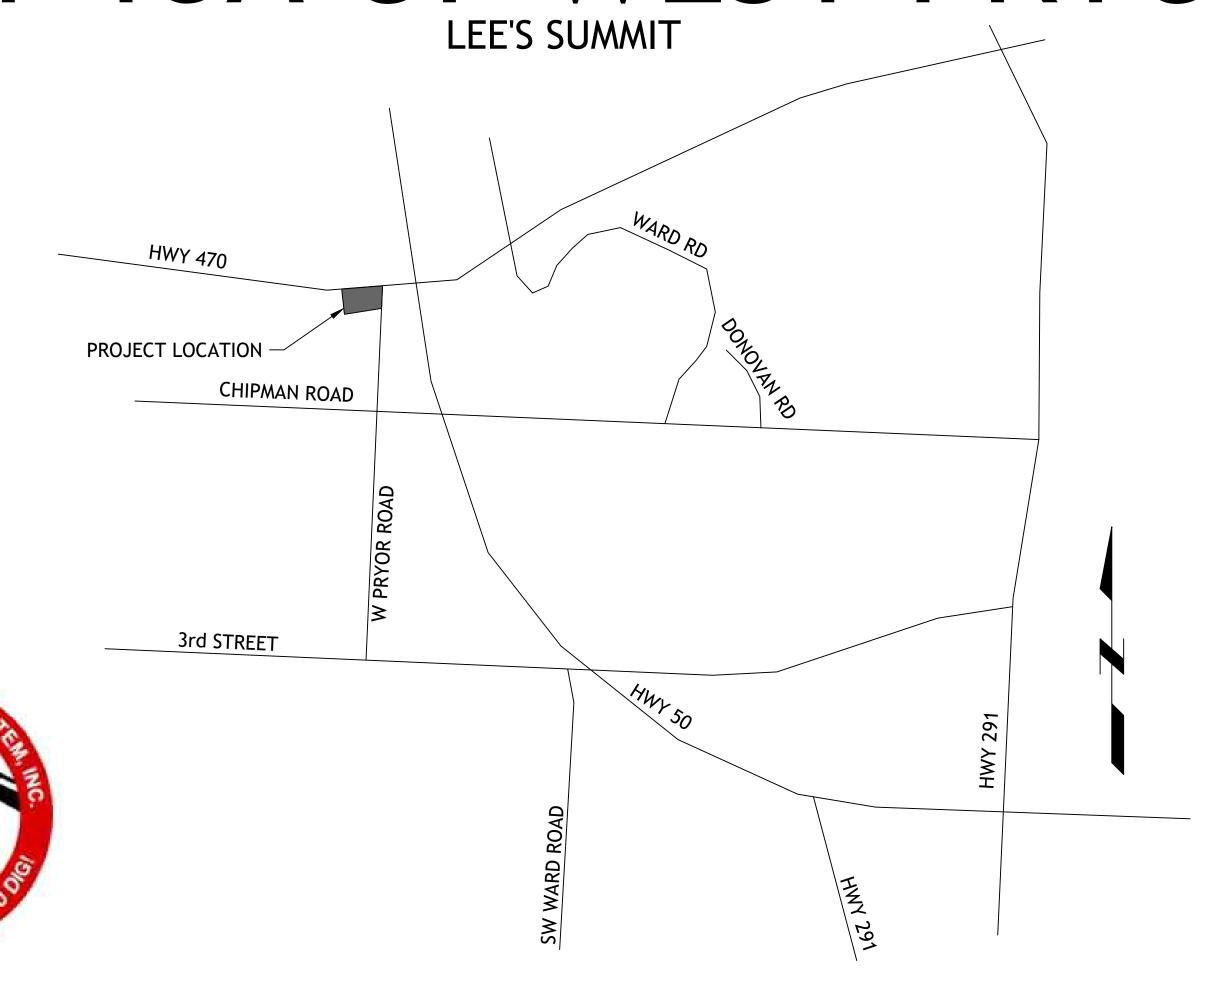

## **UTILITY STATEMENT:**

THE UNDERGROUND UTILITIES SHOWN HEREON ARE FROM FIELD SURVEY INFORMATION OF ONE-CALL LOCATED UTILITIES, FIELD SURVEY INFORMATION OF ABOVE GROUND OBSERVABLE EVIDENCE, AND/OR THE SCALING AND PLOTTING OF EXISTING UTILITY MAPS AND DRAWINGS AVAILABLE TO THE SURVEYOR AT THE TIME OF SURVEY. THE SURVEYOR MAKES NO GUARANTEE THAT THE UNDERGROUND UTILITIES SHOWN COMPRISE ALL SUCH UTILITIES IN THE AREA, EITHER IN SERVICE OR ABANDONED. FURTHERMORE, THE SURVEYOR DOES NOT WARRANT THAT THE UNDERGROUND UTILITIES SHOWN ARE IN THE EXACT LOCATION INDICATED ALTHOUGH HE DOES CERTIFY THAT THEY ARE LOCATED AS ACCURATELY AS POSSIBLE FROM INFORMATION AVAILABLE. THE SURVEYOR HAS NOT PHYSICALLY LOCATED THE UNDERGROUND UTILITIES BY EXCAVATION UNLESS OTHERWISE NOTED ON THIS SURVEY.

SAFETY NOTICE TO CONTRACTOR

IN ACCORDANCE WITH GENERALLY ACCEPTED CONSTRUCTION PRACTICE, THE CONTRACTOR WILL BE SOLELY AND COMPLETELY RESPONSIBLE FOR CONDITIONS OF THE JOB SITE, INCLUDING SAFETY OF ALL PERSONS AND PROPERTY DURING PERFORMANCE OF THE WORK. THIS REQUIREMENT WILL APPLY CONTINUOUSLY AND NOT BE LIMITED TO NORMAL WORKING HOURS.

# WARRANTY/DISCLAIMER

THE DESIGNS REPRESENTED IN THESE PLANS ARE IN ACCORDANCE WITH ESTABLISHED PRACTICES OF CIVIL ENGINEERING FOR THE DESIGN FUNCTIONS AND USES INTENEDED BY THE OWNER AT THIS TIME. HOWEVER, NEITHER SM ENGINEERING NOR ITS PERSONNEL CAN OR DO WARRANTY THESE DESIGNS OR PLANS AS CONSTRUCTED, EXCEPT IN THE SPECIFIC CASES WHERE SM ENGINEERING PERSONNEL INSPECT AND CONTROL THE PHYSICAL CONSTRUCTION ON A CONTEMPORARY BASIS AT THE SITE.

## CAUTION- NOTICE TO CONTRACTOR

THE CONTRACTOR IS SPECIFICALLY CAUTIONED THAT THE LOCATION AND/OR ELEVATION OF EXISTING UTILITIES AS SHOWN ON THESE PLANS IS BASED ON RECORDS OF THE VARIOUS UTILITY COMPANIES AND, WHERE POSSIBLE, MEASUREMENTS TAKEN IN THE FIELD. THE INFORMATION IS NOT TO BE RELIED ON AS BEING EXACT OR COMPLETE. THE CONTRACTOR MUST CALL THE APPROPRIATE UTILITY COMPANY AT LEAST 72 HOURS BEFORE ANY EXCAVATION TO REQUEST EXACT FIELD LOCATION OF UTILITIES. IT SHALL BE THE RESPONSIBILITY OF THE CONTRACTOR TO RELOCATE ALL EXISTING UTILITIES WHICH CONFLICT WITH PROPOSED IMPROVEMENTS SHOWN ON THE PLANS. THE CONTRACTOR SHALL EXPOSE EXISTING UTILITIES AT LOCATIONS OF POSSIBLE CONFLICTS PRIOR TO ANY CONSTRUCTION.

# **LOCATION MAP**

LEGAL DESCRIPTION:

LOT 13A, STREETS OF WEST PRYOR, LEE'S SUMMIT, JACKSON COUNTY MISSOURI

BENCHMARKS:

#1 CHISELED "SQUARE" ON TOP OF CURB POINT OF INTERSECTION OF WEST PARK PARKING LOT AT EAST DRIVE ENTRANCE ELEVATION 985.05

#2 CHISELED "SQUARE" ON NORTHWEST CORNER AREA INLET, 25' EAST OF CURB LINE AND ON-LINE WITH SOUTH CURB OF LOWENSTEIN DRIVE AT 90° BEND IN ROAD ELEVATION 971.06

## NOTE

- 1. ALL CONSTRUCTION SHALL FOLLOW THE CITY OF LEE'S SUMMIT DESIGN AND CONSTRUCTION MANUAL AS ADOPTED BY ORDINANCE 5813. WHERE DISCREPANCIES EXIST BETWEEN THESE PLANS AND THE DESIGN AND CONSTRUCTION MANUAL, THE MORE STRINGENT SHALL PREVAIL.
- 2. THERE ARE NO GAS/OIL WELLS PER MDNR DATABASE OF OIL & GAS PERMITS
- SITE IS LOCATED WITHIN FEMA ZONE X, AREAS OF MINIMAL FLOODING PER FEMA 29095C0416G DATED 1-20-17.

# **INDEX OF SHEETS**


- C-1 COVER SHEET
- C-2 EXISTING CONDITIONS
- C-3 SITE PLAN
- C-4 UTILITY PLAN C-5 GRADING PLAN
- C-6 EROSION CONTROL PLAN
- C-7 EROSION CONTROL DETAILS
- C-8 STORM LINE C PLAN AND PROFILE
- C-8.1 STORM LINE F PLAN AND PROFILE
- C-9 WATERLINE A PLAN AND PROFILE
- C-10 WATERLINE B & C PLAN AND PROFILE
- C-11 DETAILS C-12 DETAILS
- C-13 DETAILS
- L-1 LANDSCAPE PLAN

# DEVELOPER

STREETS OF WEST PRYOR, LLC DAVID N. OLSON 7200 W 133rd ST, SUITE 150 CELL: OVERLAND PARK, KS 66213 314-413-3598

# **ENGINEER**

SM ENGINEERING
5507 High Meadow Circle
Manhattan Kansas, 66503
smcivilengr@gmail.com
785.341.9747

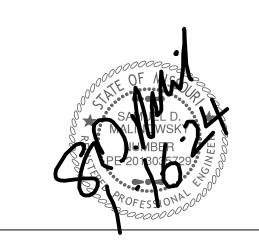

SAMUEL D. MALINOWSKY PROFESSIONAL ENGINEEER

5507 High Meadow Circle Manhattan Kansas, 66503 smcivilengr@gmail.com 785.341.9747


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Revisions 11-29-23 CITY COMMENTS 1-4-24 PER CLIENT 1-16-24 PER EVERGY

shee Civil COVER SHEET


permit 19 OCTOBER 2023



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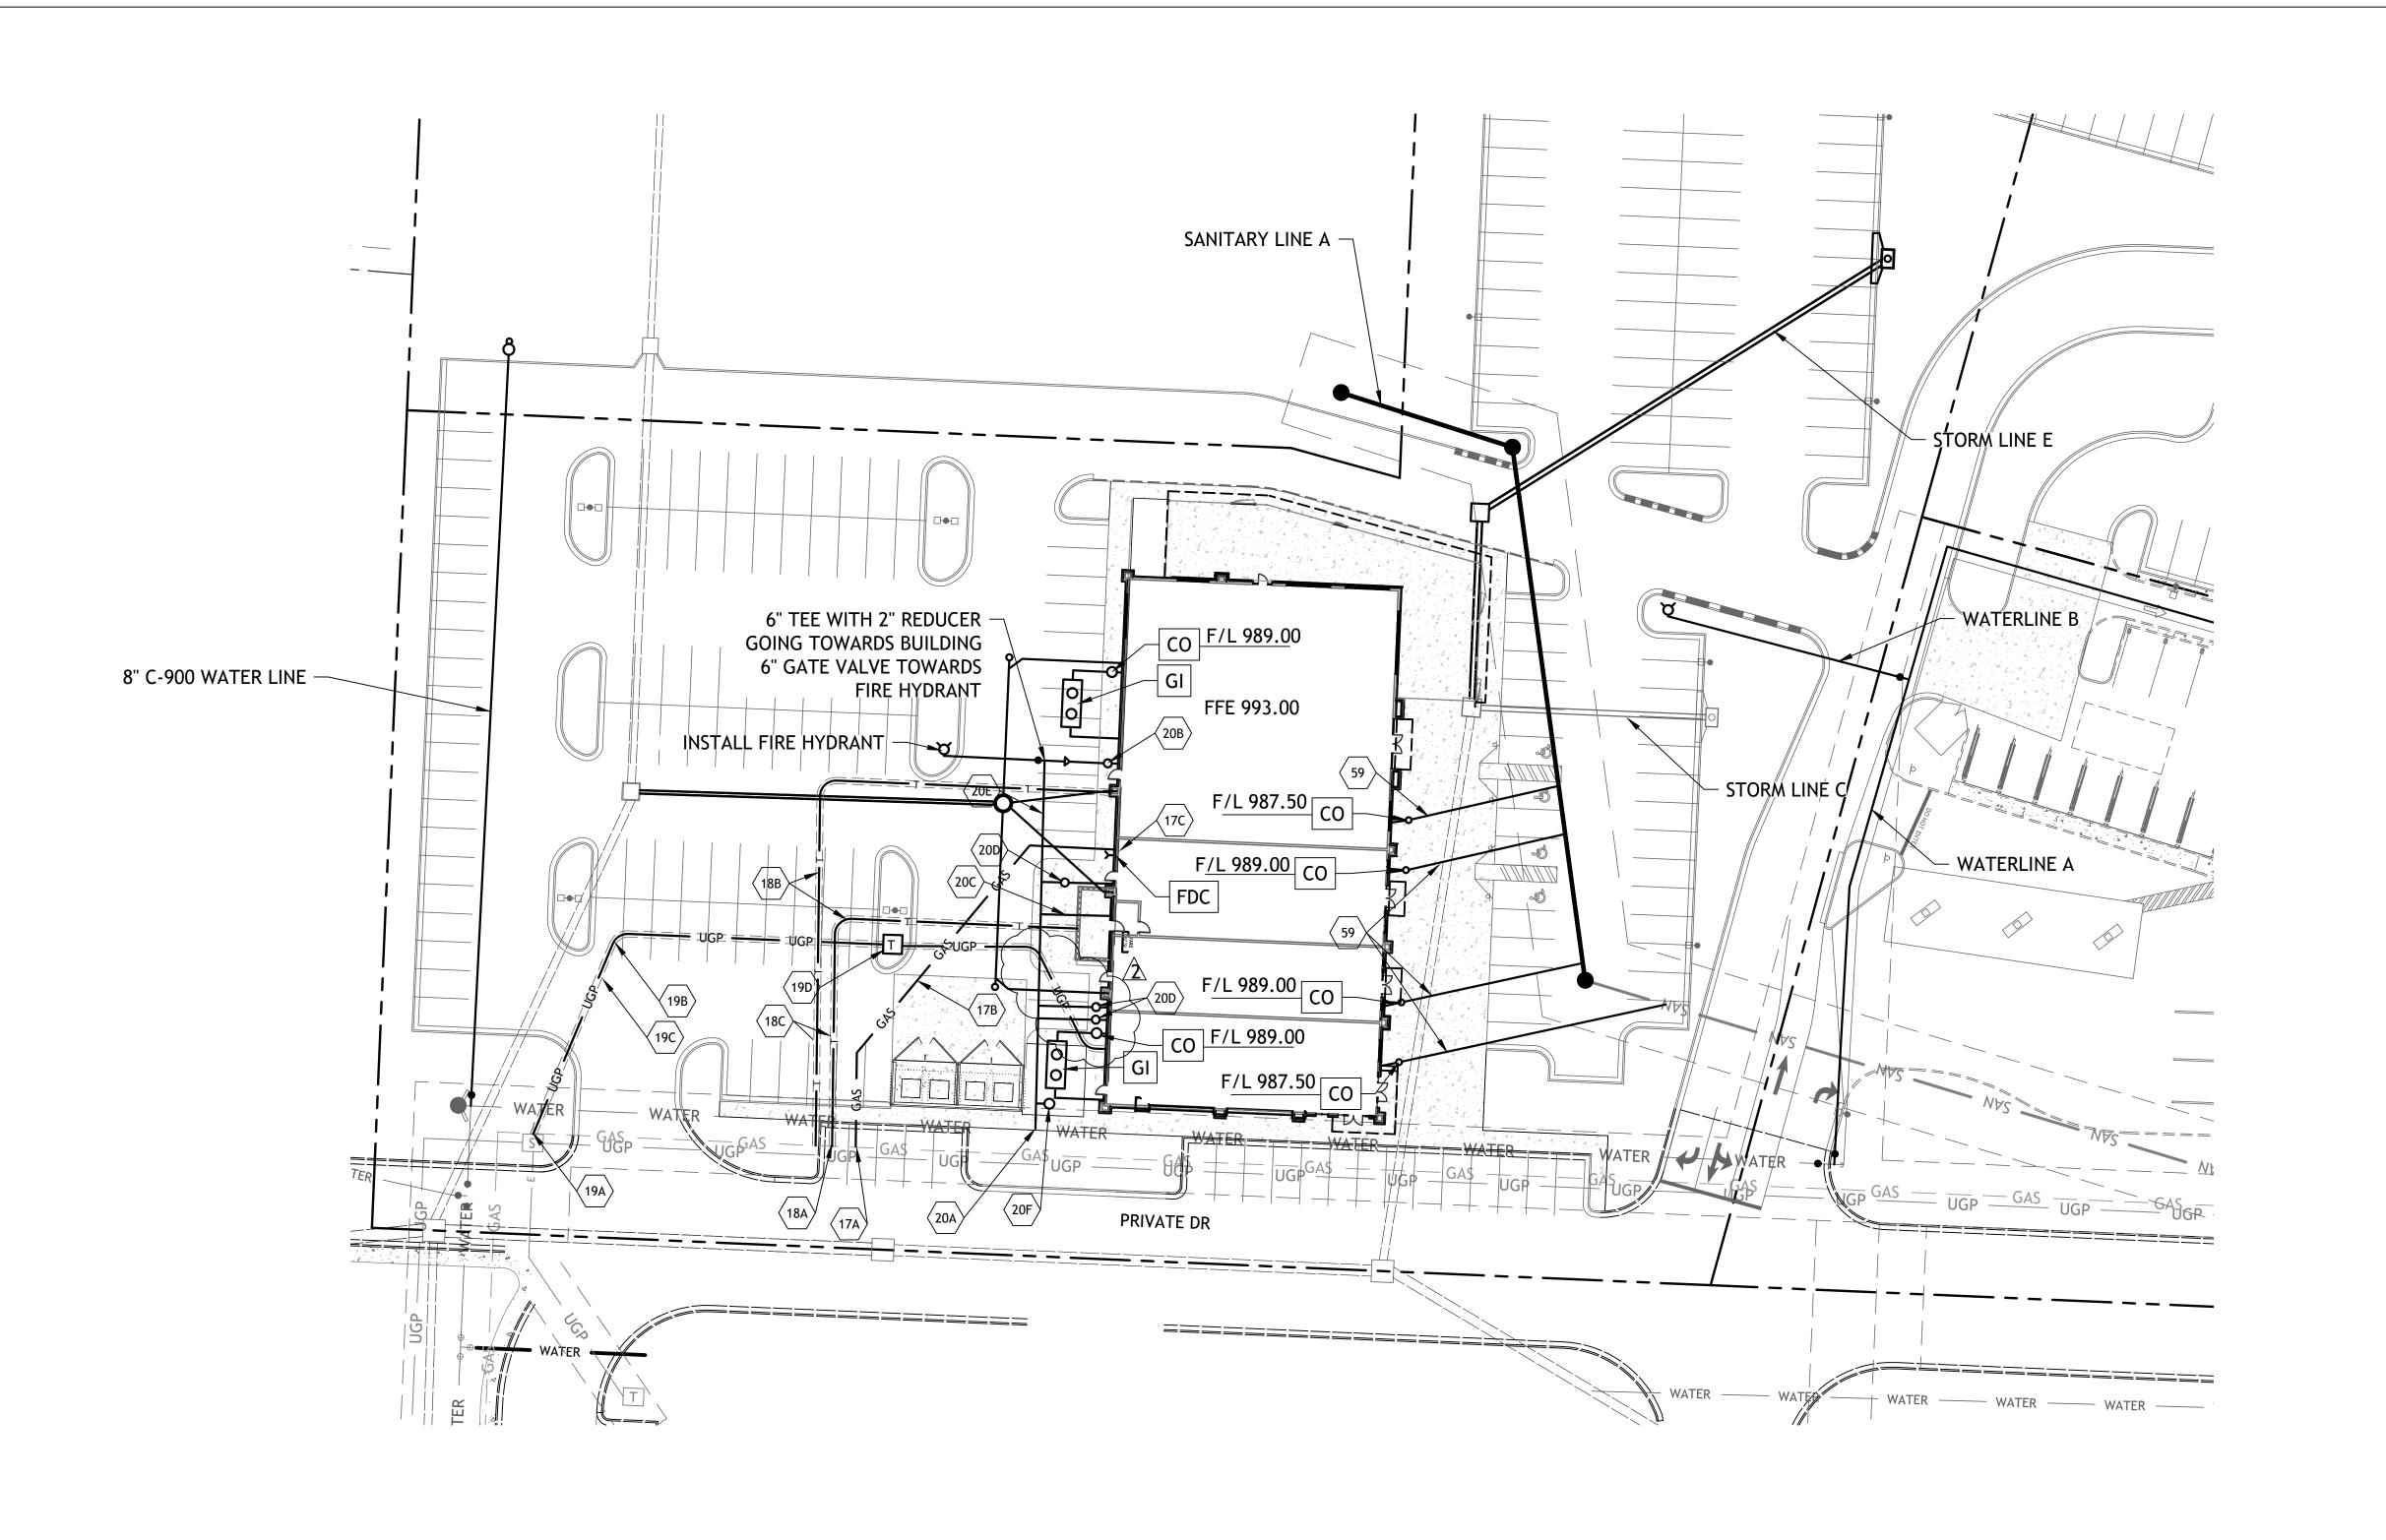
11-29-23 CITY COMMENTS

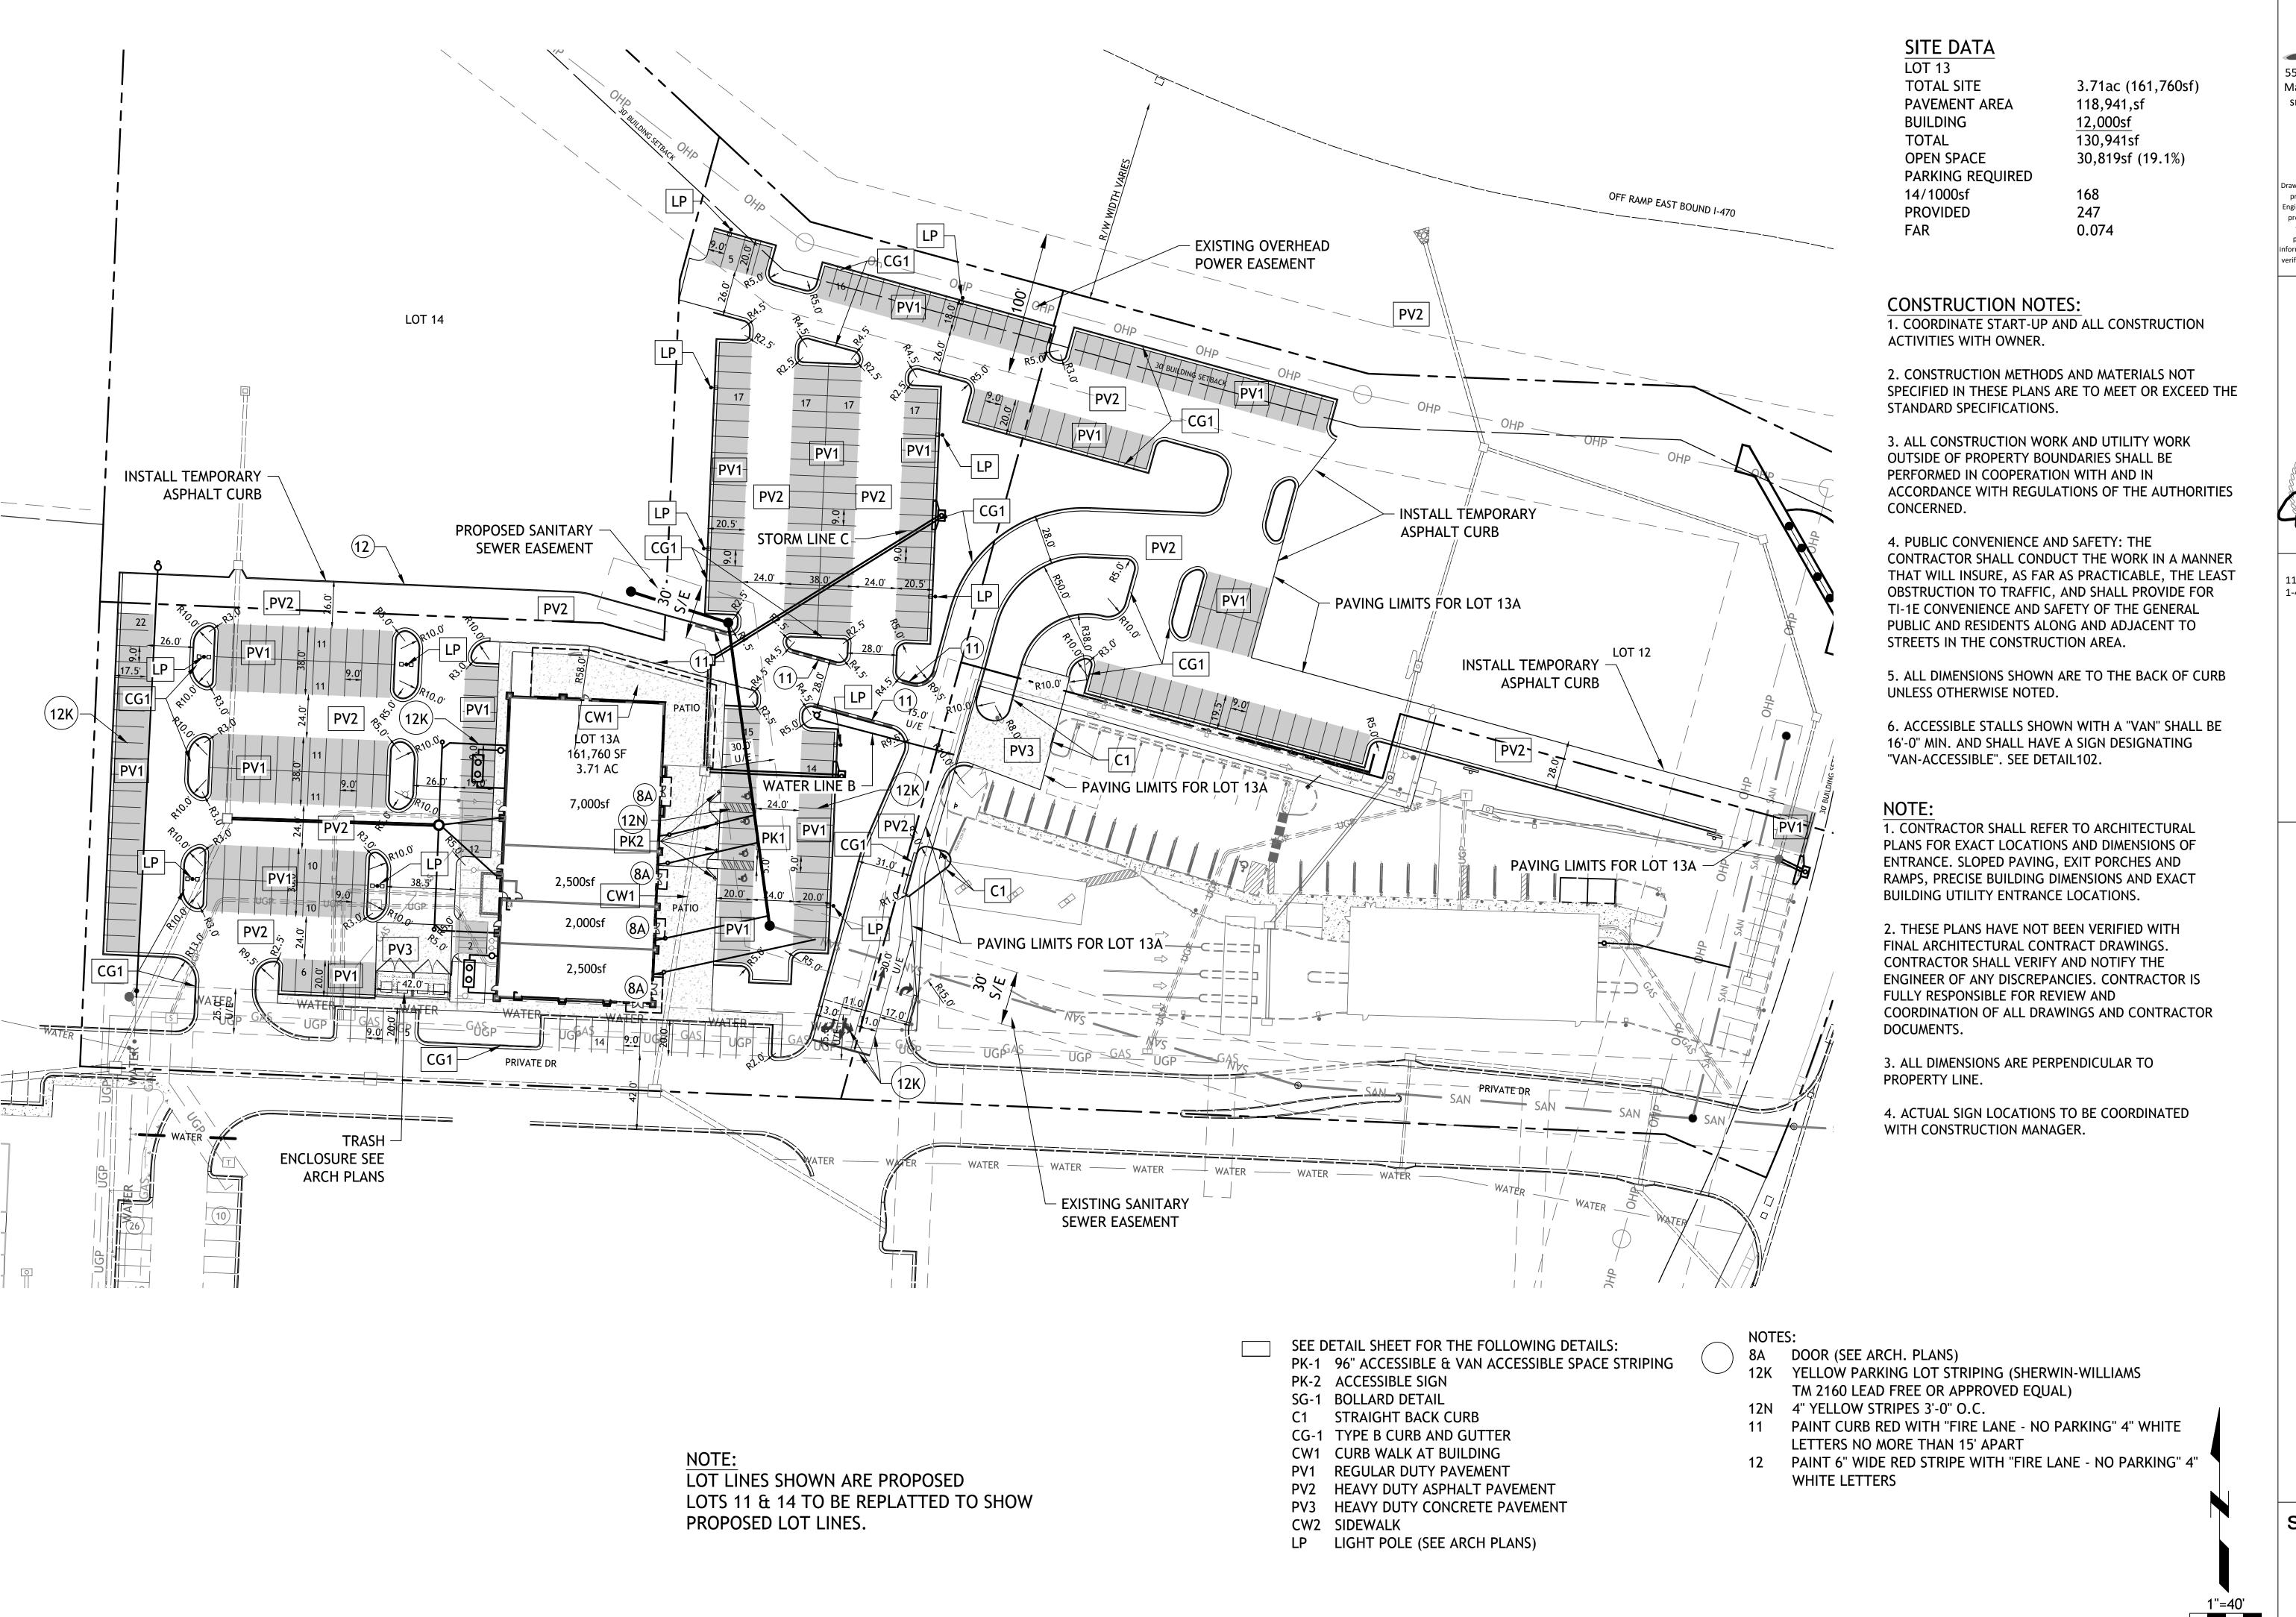1-4-24 PER CLIENT

sheet

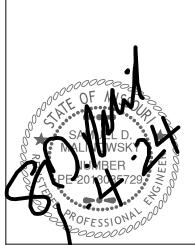SITE PLAN

permit 19 OCTOBER 2023



#### **UTILITY NOTES:**

- 1. ALL UTILITY AND STORM SEWER TRENCHES CONSTRUCTED UNDER AREAS THAT RECEIVE PAVING SHALL BE BACKFILLED TO 18 INCHES ABOVE THE TOP OF THE PIPE WITH SELECT GRANULAR MATERIAL PLACED ON EIGHT-INCH LIFTS, AND COMPACTED TO 95% MODIFIED PROCTOR DENSITY.
- 2. CONTRACTOR SHALL NOT OPEN, TURN OFF, INTERFERE WITH, OR ATTACH ANY PIPE OR HOSE TO OR TAP ANY WATER MAIN BELONGING TO THE CITY UNLESS DULY AUTHORIZED TO DO SO BY THE CITY. ANY ADVERSE CONSEQUENCE OF ANY SCHEDULED OR UNSCHEDULED DISRUPTIONS OF SERVICE TO THE PUBLIC ARE TO BE THE LIABILITY OF THE CONTRACTOR. SM ENGINEERING AND OWNER ARE TO BE HELD HARMLESS.
- 3. ALL WATER AND SANITARY SEWER SYSTEMS THAT ARE TO BE PUBLIC LINES SHALL BE CONSTRUCTED IN ACCORDANCE WITH SPECIFICATIONS PREVIOUSLY APPROVED BY THE CITY OF LEE'S SUMMIT AND THE STATE OF MISSOURI AND SHALL BE INSPECTED BY THE CITY. IT IS THE CONTRACTOR'S RESPONSIBILITY TO ASSURE THAT THIS INSPECTION OCCURS.
- 4. LOCATIONS SHOWN FOR PROPOSED WATER LINES ARE APPROXIMATE. VARIATIONS MAY BE MADE, WITH APPROVAL OF THE ENGINEER, TO AVOID CONFLICTS.
- 5. CONTRACTOR TO INSTALL TRACING TAPE ALONG ALL NON-METALLIC WATER MAINS AND SERVICE LINES PER SPECIFICATIONS.
- 6. CONTRACTOR SHALL EXPOSE EXISTING UTILITIES AT LOCATIONS OF POSSIBLE CONFLICT AND POINTS OF CONNECTION PRIOR TO ANY CONSTRUCTION OF NEW UTILITIES.
- 7. WATER LINES SHALL HAVE A MINIMUM COVER OF 42 INCHES. ALL VALVES ON MAINS AND FIRE HYDRANT LEADS SHALL BE WITH VALVE BOX ASSEMBLIES. THE SIZE OF VALVE BOX ASSEMBLY TO BE INSTALLED IS DETERMINED BY THE TYPE AND SIZE OF VALVE. VALVE BOX CAPS SHALL HAVE THE WORD "WATER".
- 8. A MINIMUM HORIZONTAL DISTANCE OF 10 FEET SHALL BE MAINTAINED BETWEEN PARALLEL WATER AND SANITARY SEWER LINES. WHEN IT IS NECESSARY FOR ANY WATER LINE TO CROSS A SANITARY SEWER LINE, THE SEWER LINE SHALL BE CONSTRUCTED OF DUCTILE IRON PIPE AT LEAST 10 FEET EITHER SIDE OF THE WATER LINE UNLESS THE WATER LINE IS AT LEAST 2 FEET CLEAR DISTANCE ABOVE THE SANITARY SEWER LINE.
- 9. INSTALL 2" TYPE "K" COPPER FROM THE MAIN TO 10' BEYOND METER AND EITHER TYPE "K" OR POLYETHYLENE PLASTIC TUBING (PE 3608) TO STOP AND WASTE VALVE INSIDE BUILDING.
- 10. CONTRACTOR RESPONSIBLE FOR PROVIDING CASEMENT FOR ELECTRICAL SERVICE PER KCP&L
- 11. SANITARY SEWER SERVICE CONNECTIONS WILL BE MADE WITH A CUT IN WYE

# NOTES

**DETAILS** 

CO

TRENCH AND BEDDING DETAILS

GREASE INTERCEPTOR (1,500 GAL)

2-WAY CLEAN-OUT

FIRE HYDRANT

CLEANOUT

17A POINT OF CONNECTION - GAS SERVICE

17B GAS SERVICE (BY GAS COMPANY) 17C

GAS METER

18A POINT OF CONNECTION - TELEPHONE SERVICE - COORDINATE WITH TELEPHONE COMPANY

UNDERGROUND TELEPHONE SERVICE PER LOCAL TELEPHONE COMPANY

2-2" CONDUITS INSTALLED BY CONTRACTOR - TELEPHONE SERVICE

19A POINT OF CONNECTION - ELECTRICAL SERVICE

4" CONDUIT WITH STEEL SWEEPS INSTALLED BY CONTRACTOR -

ELECTRIC SERVICE

TRANSFORMER PAD

20A POINT OF CONNECTION - WATER SERVICE

2" TAP AND METER WITH 2" SERVICE LINE

20C 6" FIRE LINE

20D 1" TAP AND METER WITH 1"


20E 6" C-900 WATERLINE

4" SANITARY SEWER SERVICE LINE

20F 1" TAP AND METER WITH 1" SERVICE LINE FOR IRRIGATION


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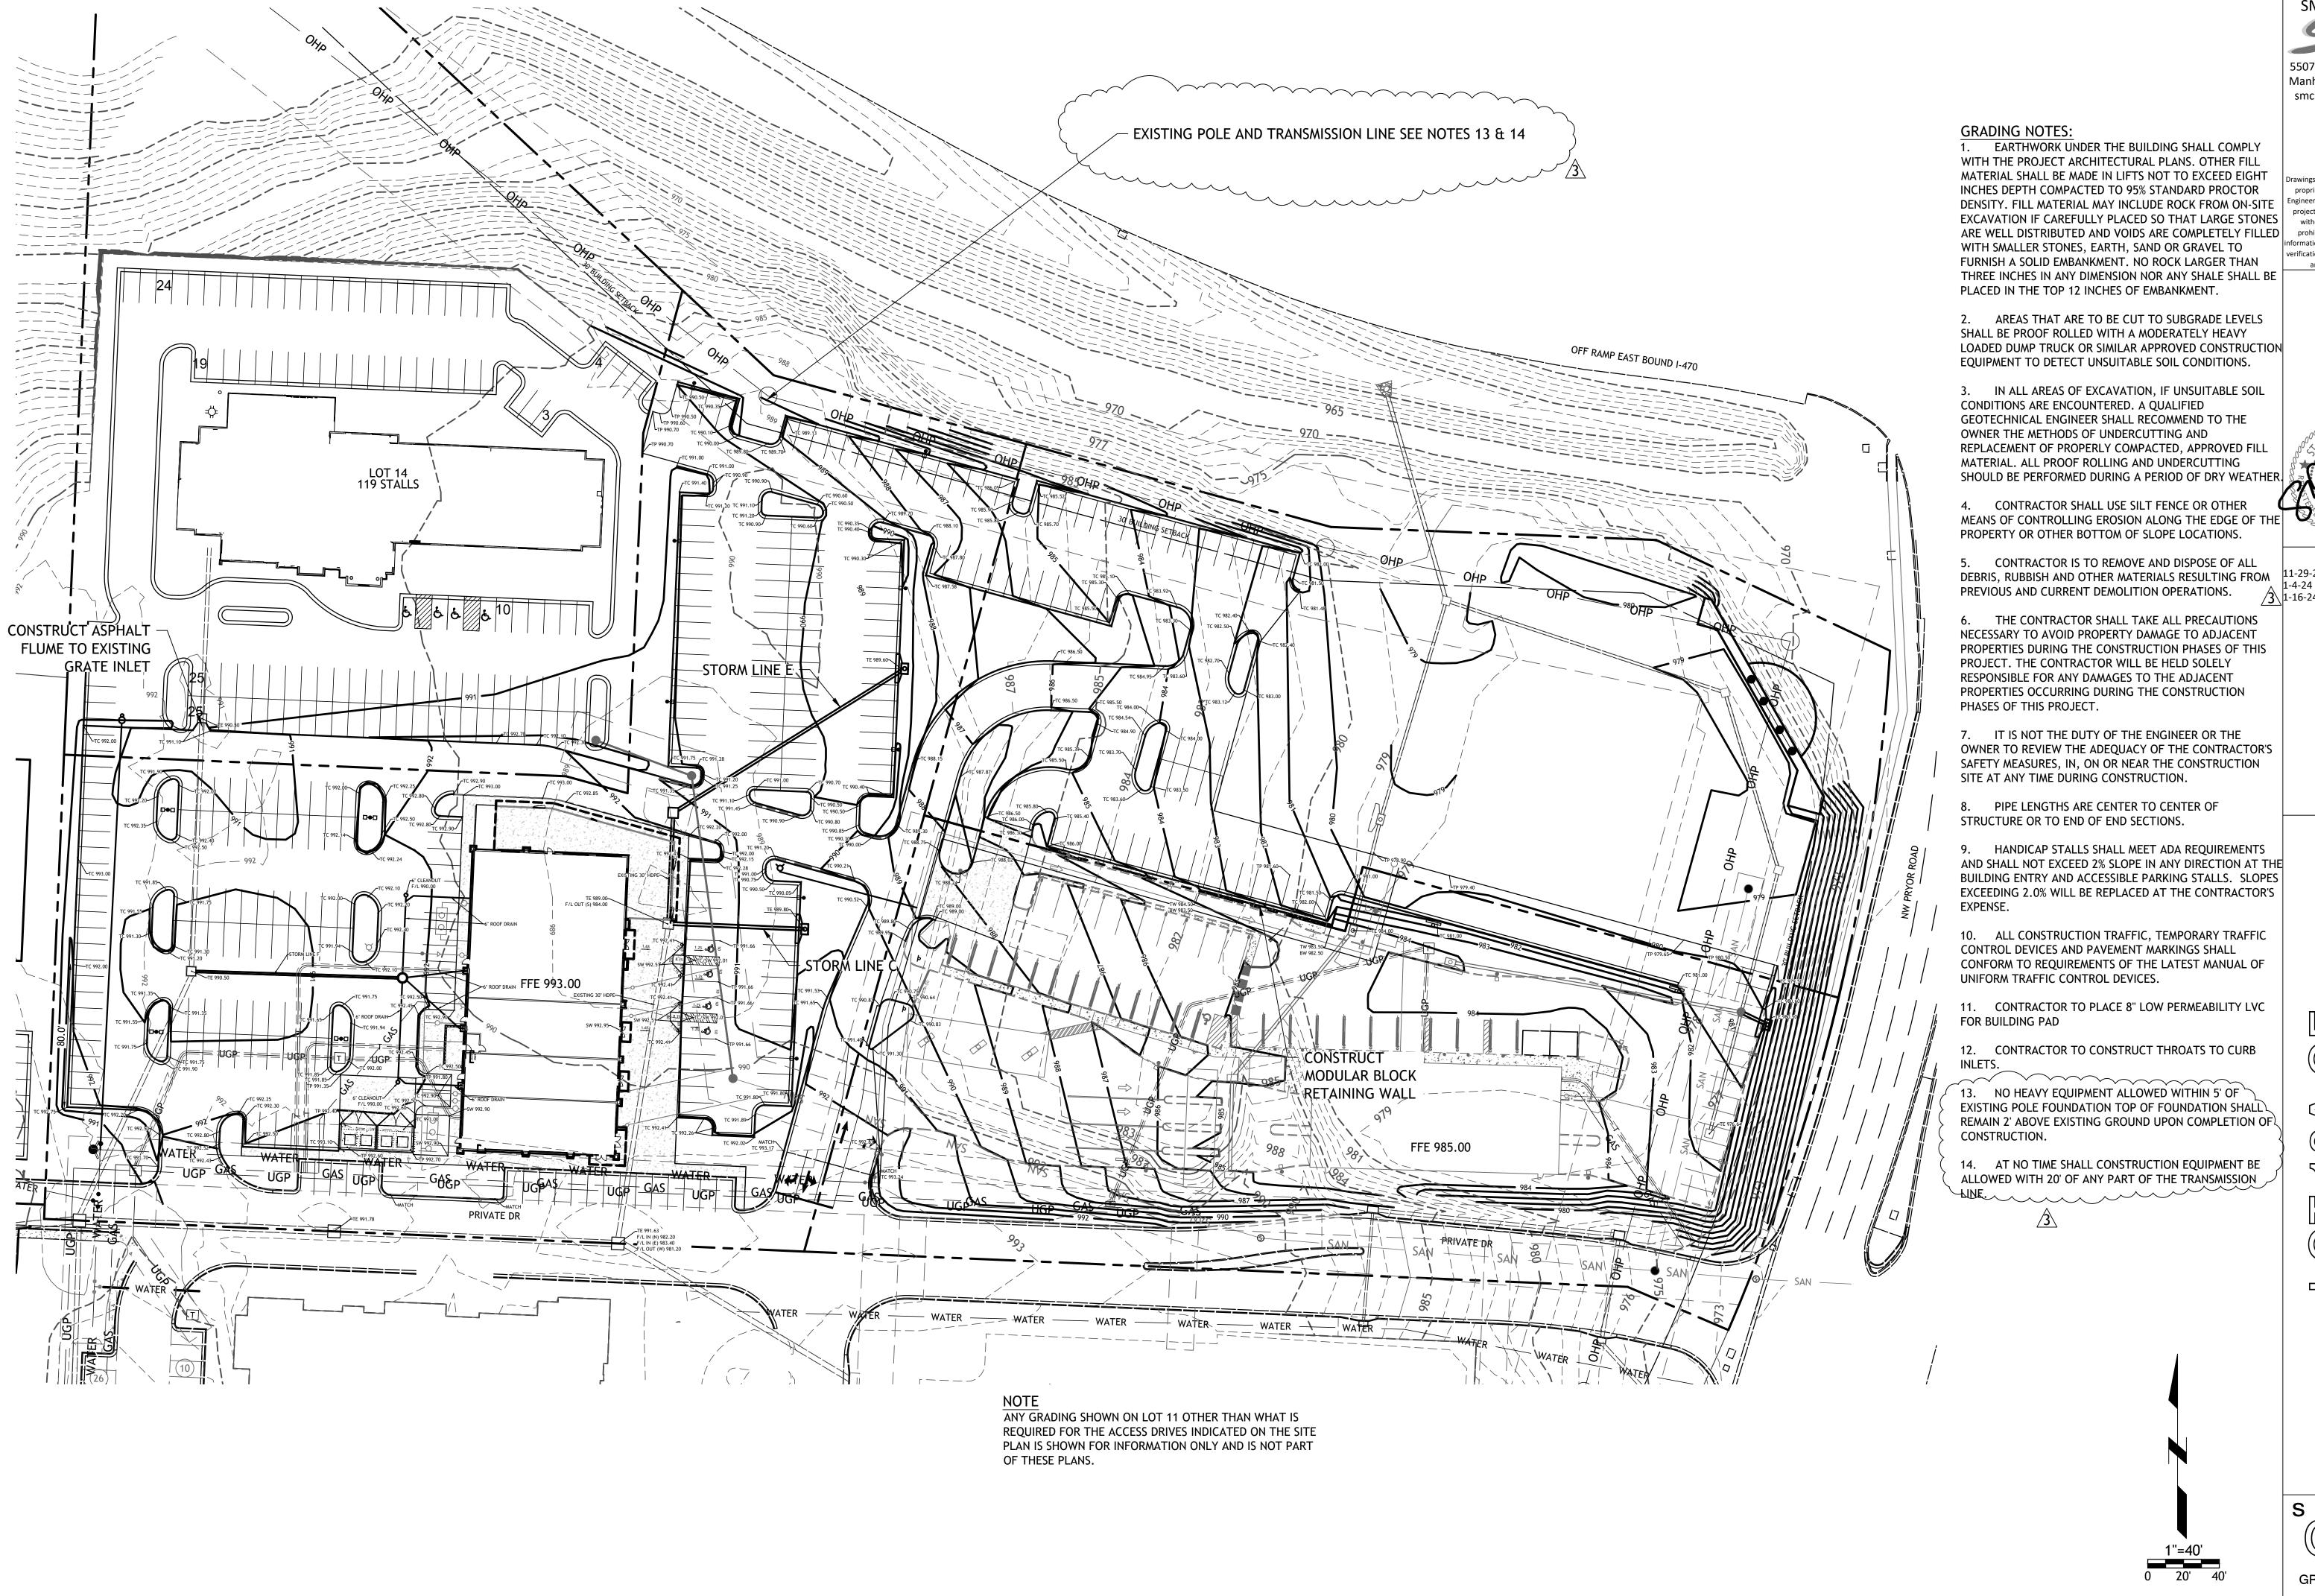


11-29-23 CITY COMMENTS 1-4-24 PER CLIENT
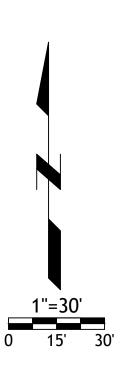
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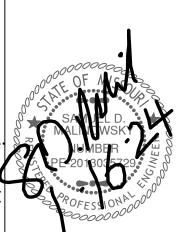
UTILITY PLAN permit 19 OCTOBER 2023



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7. IT IS NOT THE DUTY OF THE ENGINEER OR THE OWNER TO REVIEW THE ADEQUACY OF THE CONTRACTOR'S SAFETY MEASURES, IN, ON OR NEAR THE CONSTRUCTION

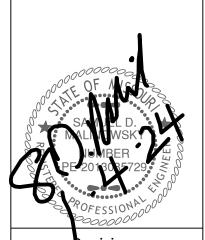8. PIPE LENGTHS ARE CENTER TO CENTER OF

9. HANDICAP STALLS SHALL MEET ADA REQUIREMENTS AND SHALL NOT EXCEED 2% SLOPE IN ANY DIRECTION AT THE BUILDING ENTRY AND ACCESSIBLE PARKING STALLS. SLOPES EXCEEDING 2.0% WILL BE REPLACED AT THE CONTRACTOR'S

10. ALL CONSTRUCTION TRAFFIC, TEMPORARY TRAFFIC CONTROL DEVICES AND PAVEMENT MARKINGS SHALL CONFORM TO REQUIREMENTS OF THE LATEST MANUAL OF

11. CONTRACTOR TO PLACE 8" LOW PERMEABILITY LVC


12. CONTRACTOR TO CONSTRUCT THROATS TO CURB

13. NO HEAVY EQUIPMENT ALLOWED WITHIN 5' OF ` EXISTING POLE FOUNDATION TOP OF FOUNDATION SHALL REMAIN 2' ABOVE EXISTING GROUND UPON COMPLETION OF

14. AT NO TIME SHALL CONSTRUCTION EQUIPMENT BE ALLOWED WITH 20' OF ANY PART OF THE TRANSMISSION

sheet **GRADING PLAN &** 


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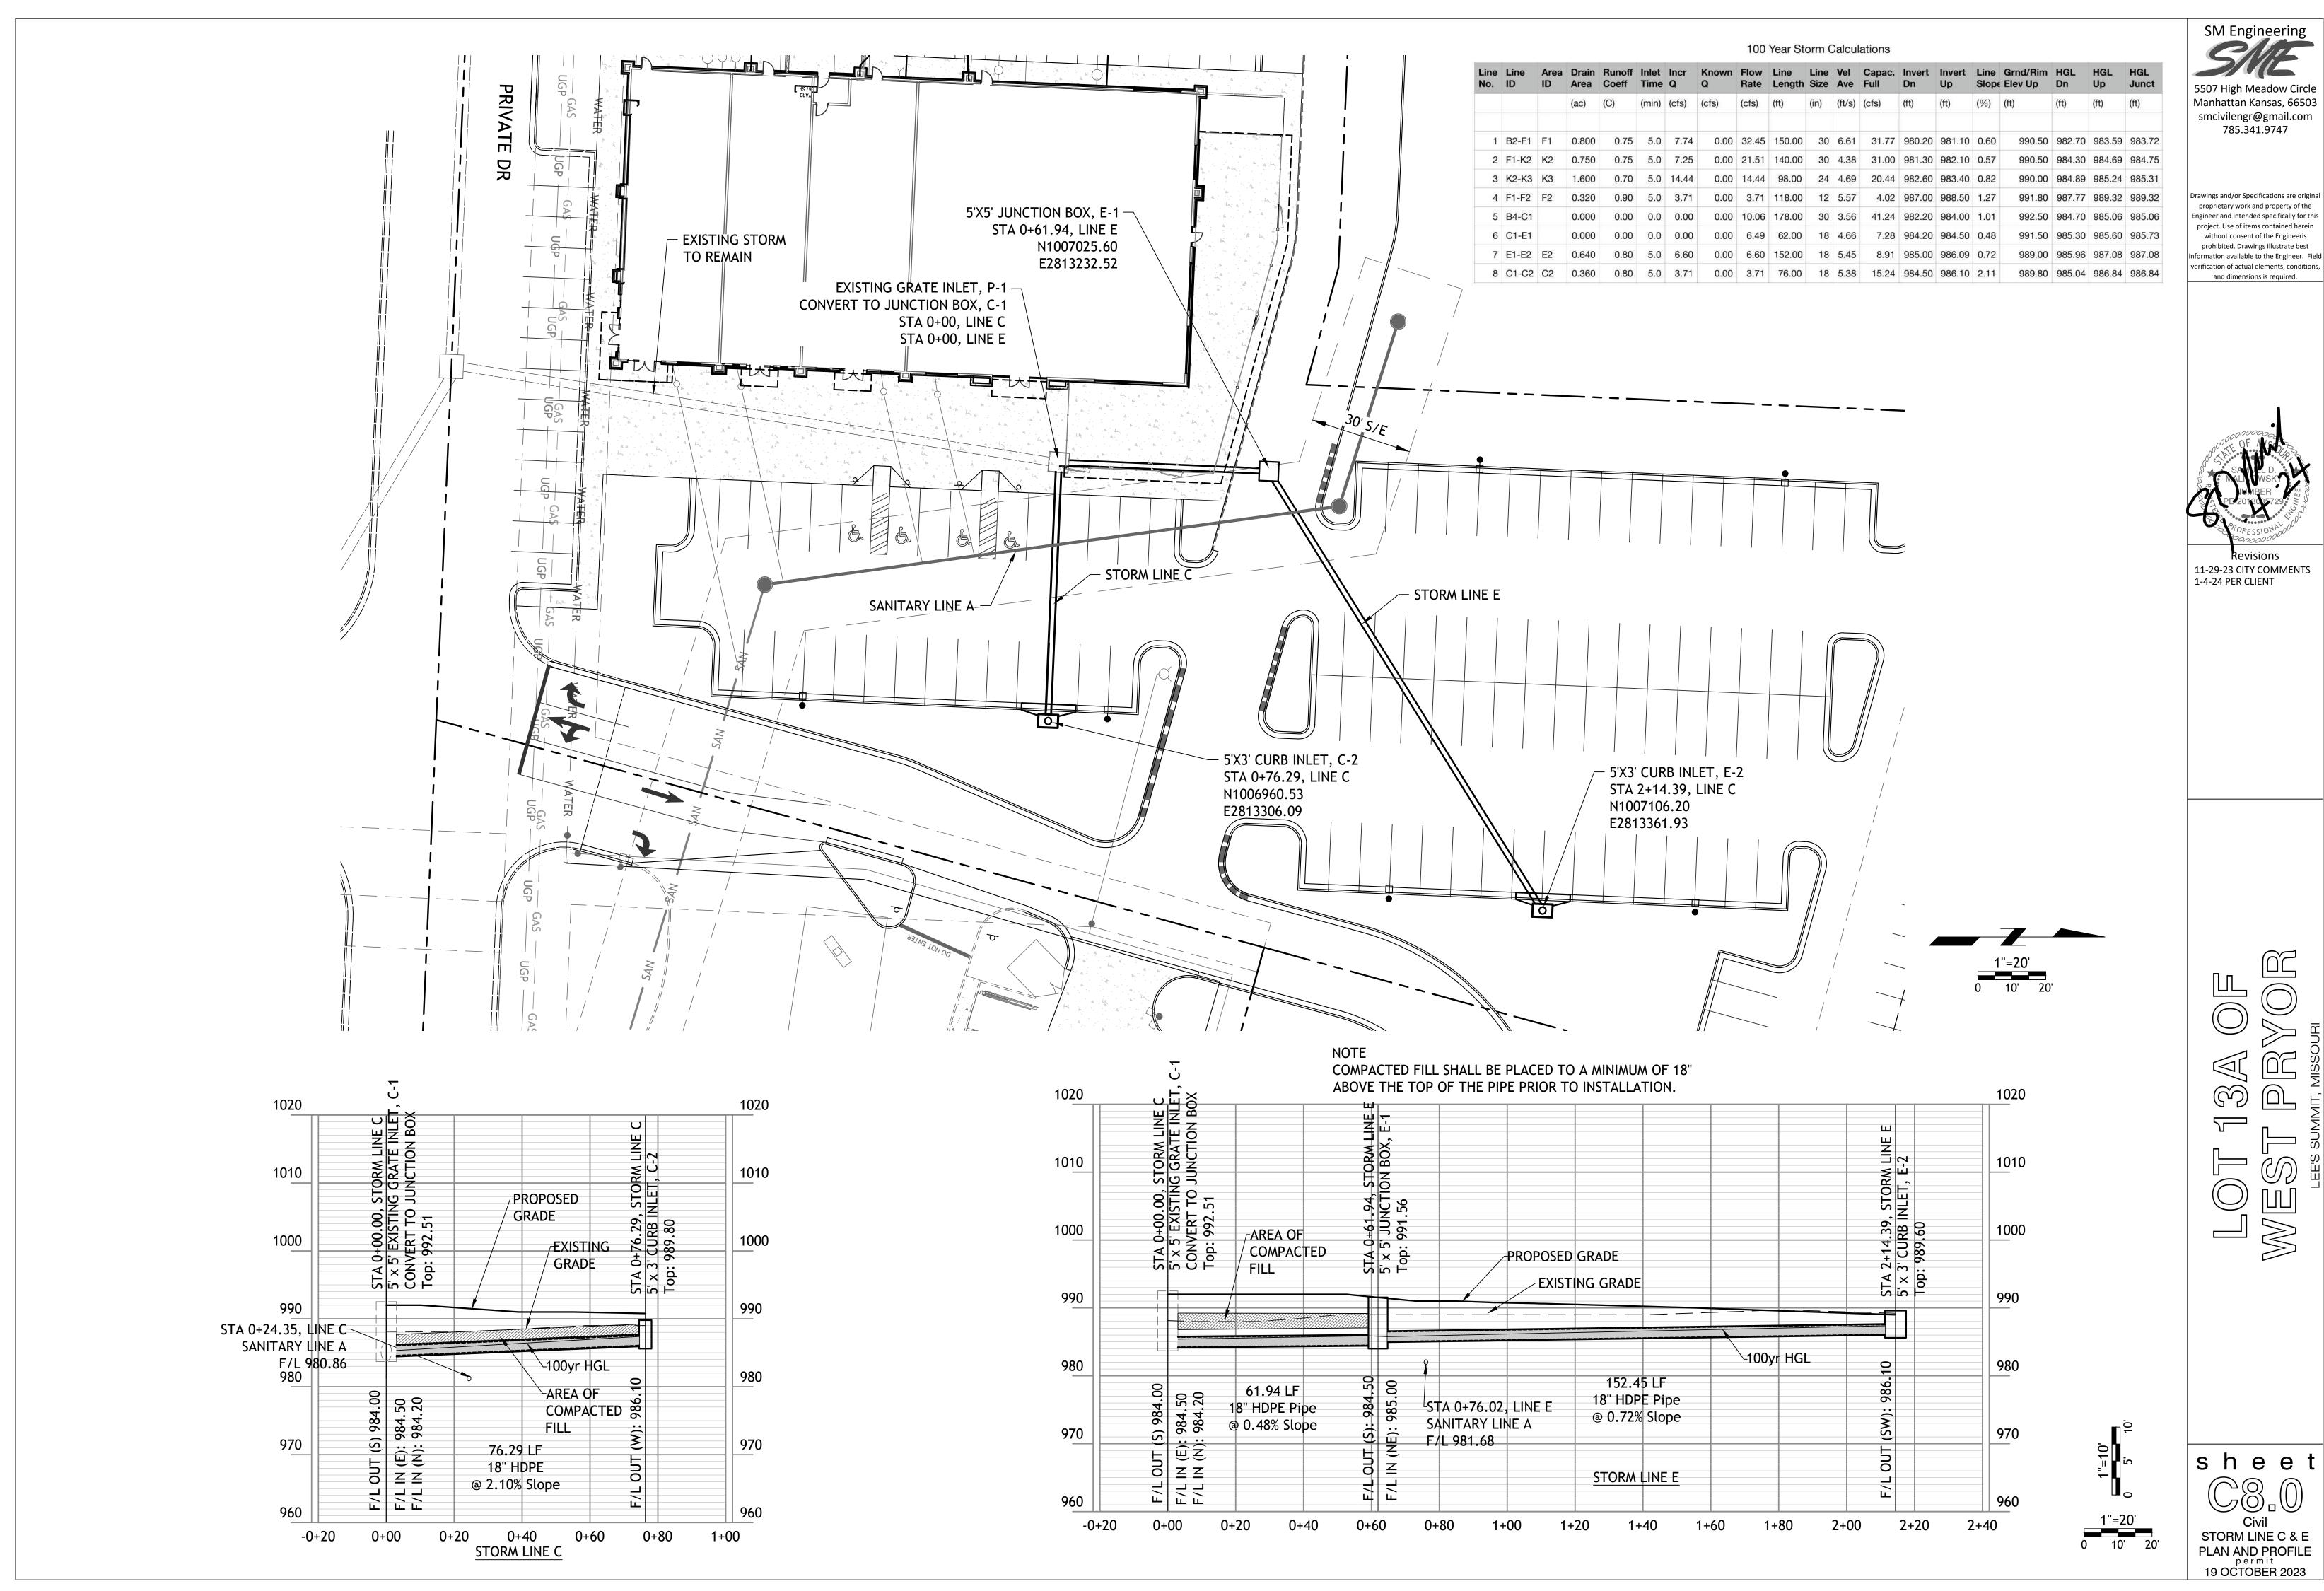
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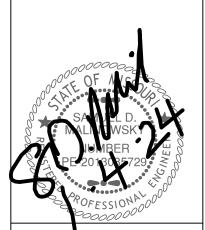
11-29-23 CITY COMMENTS

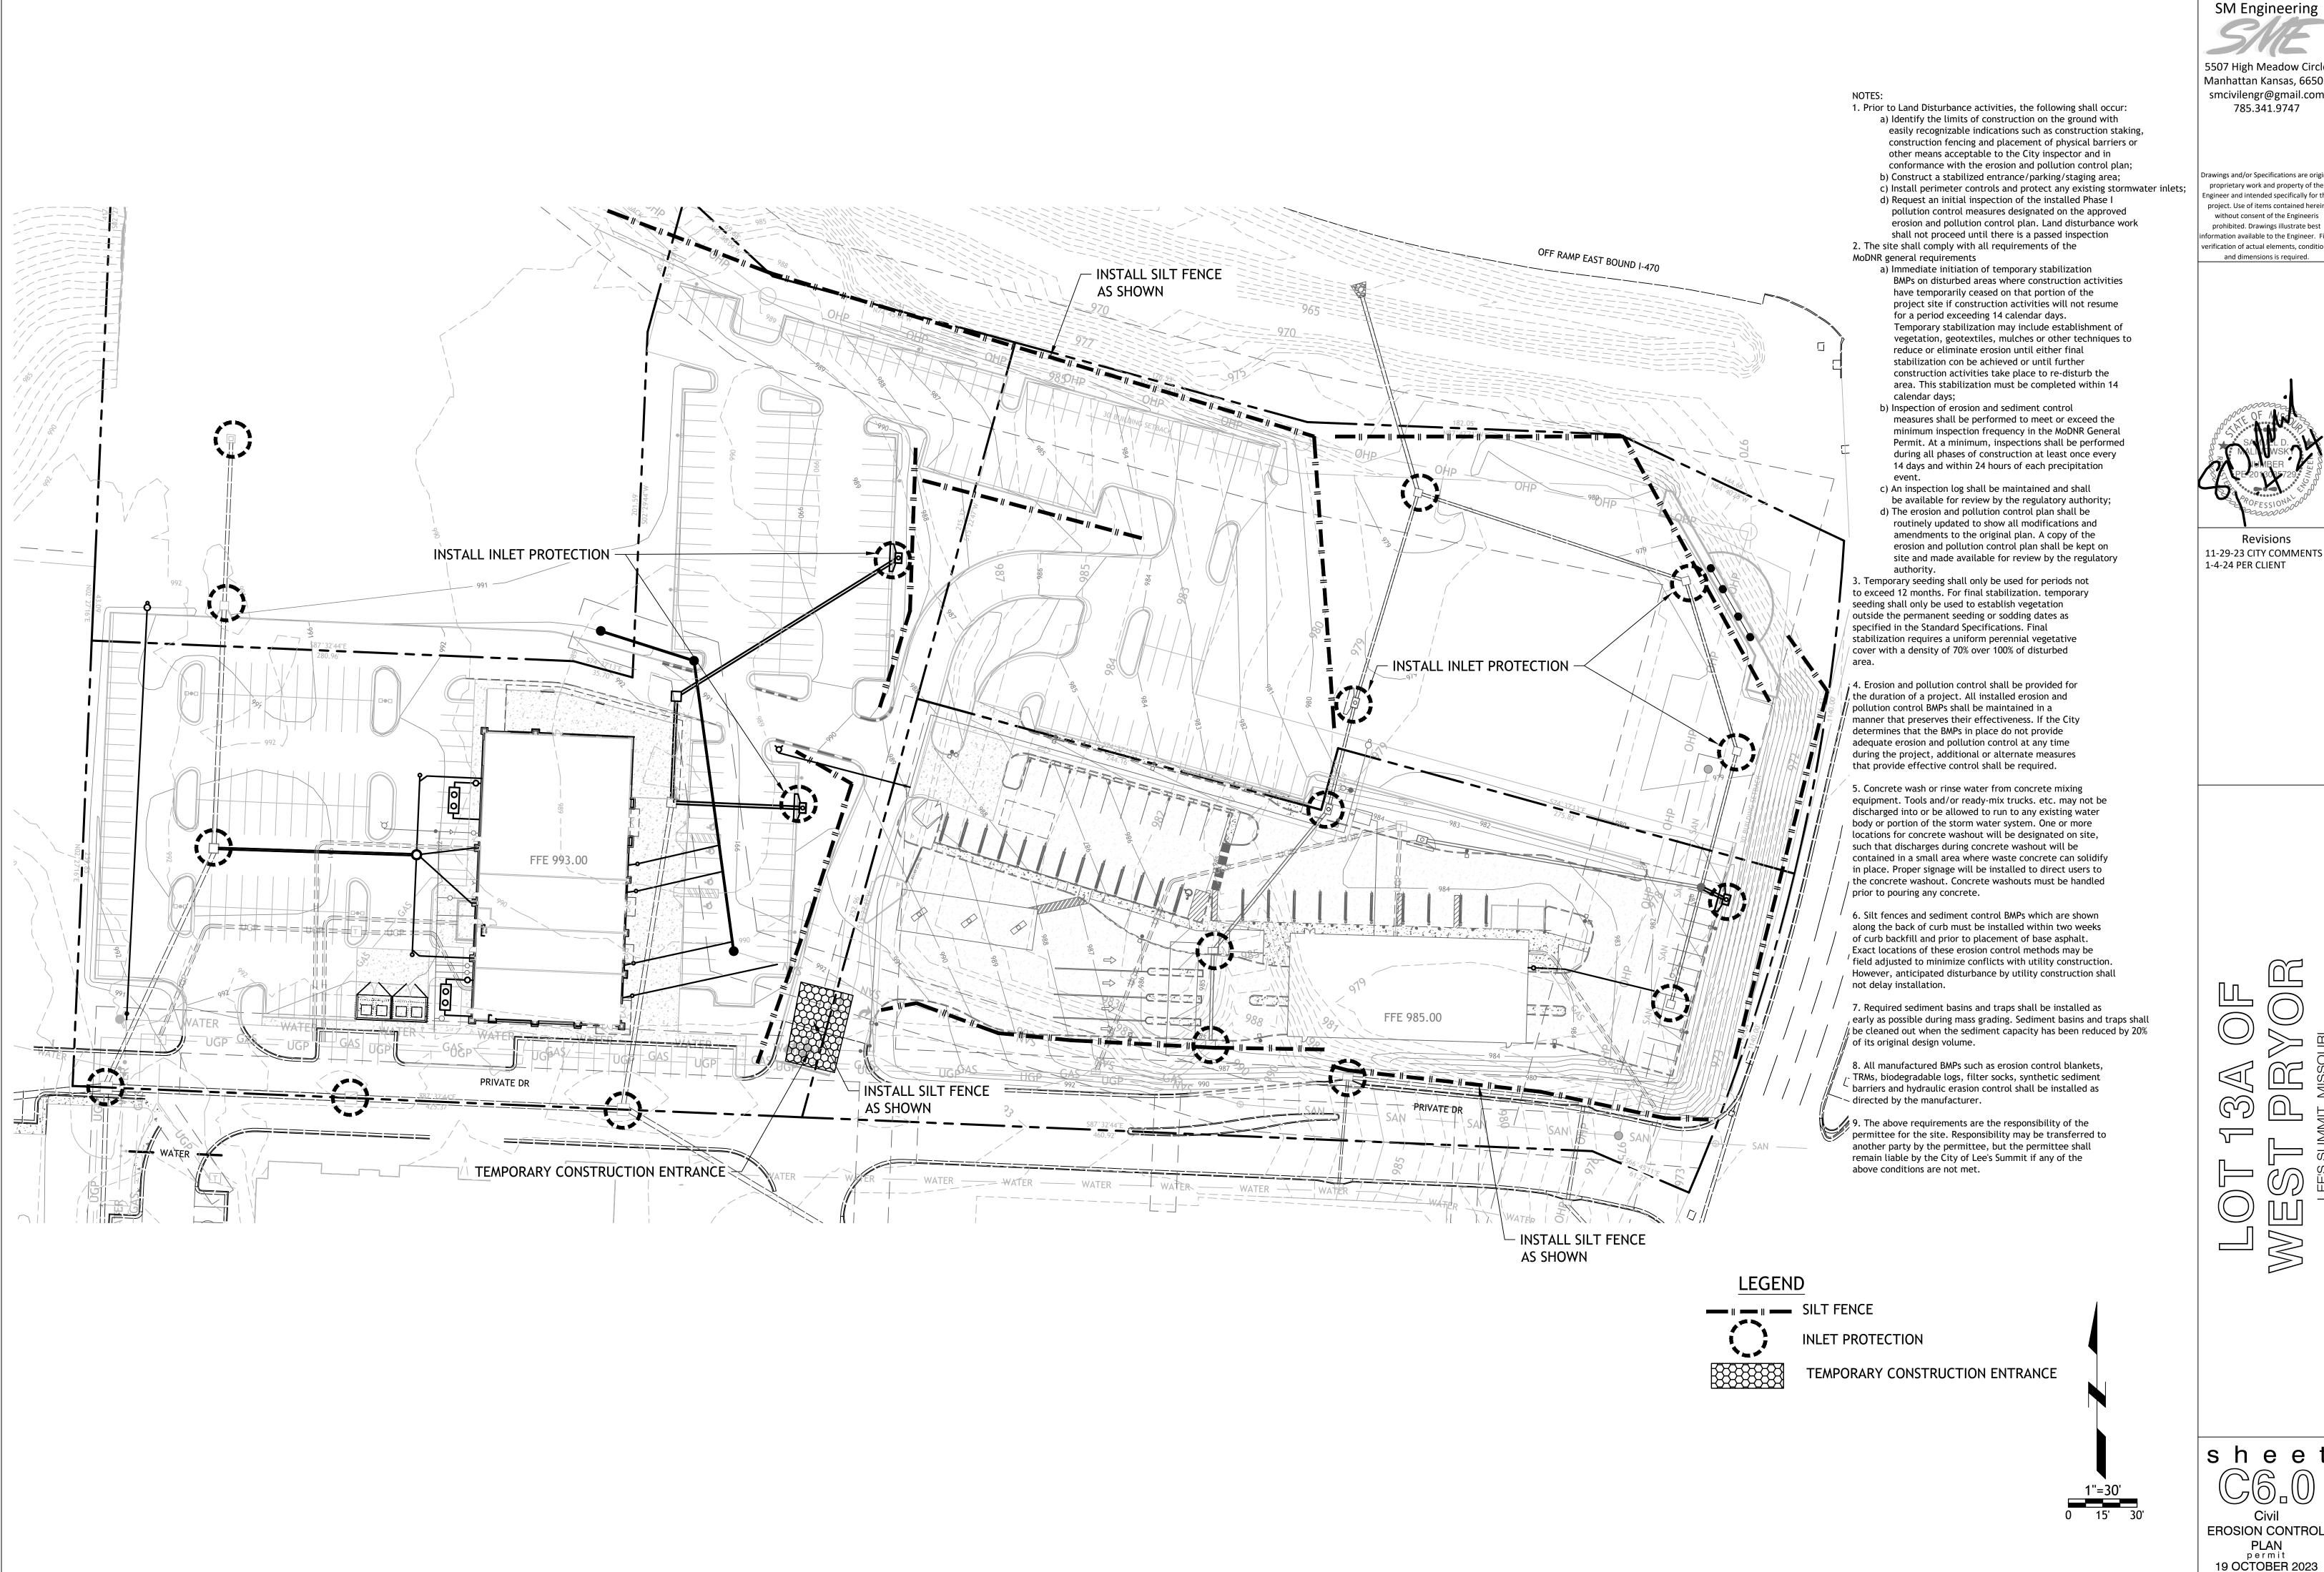sheet **EROSION CONTROL** 





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mation available to the Engineer. Field

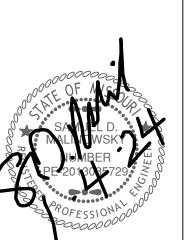


STORM LINE C & E



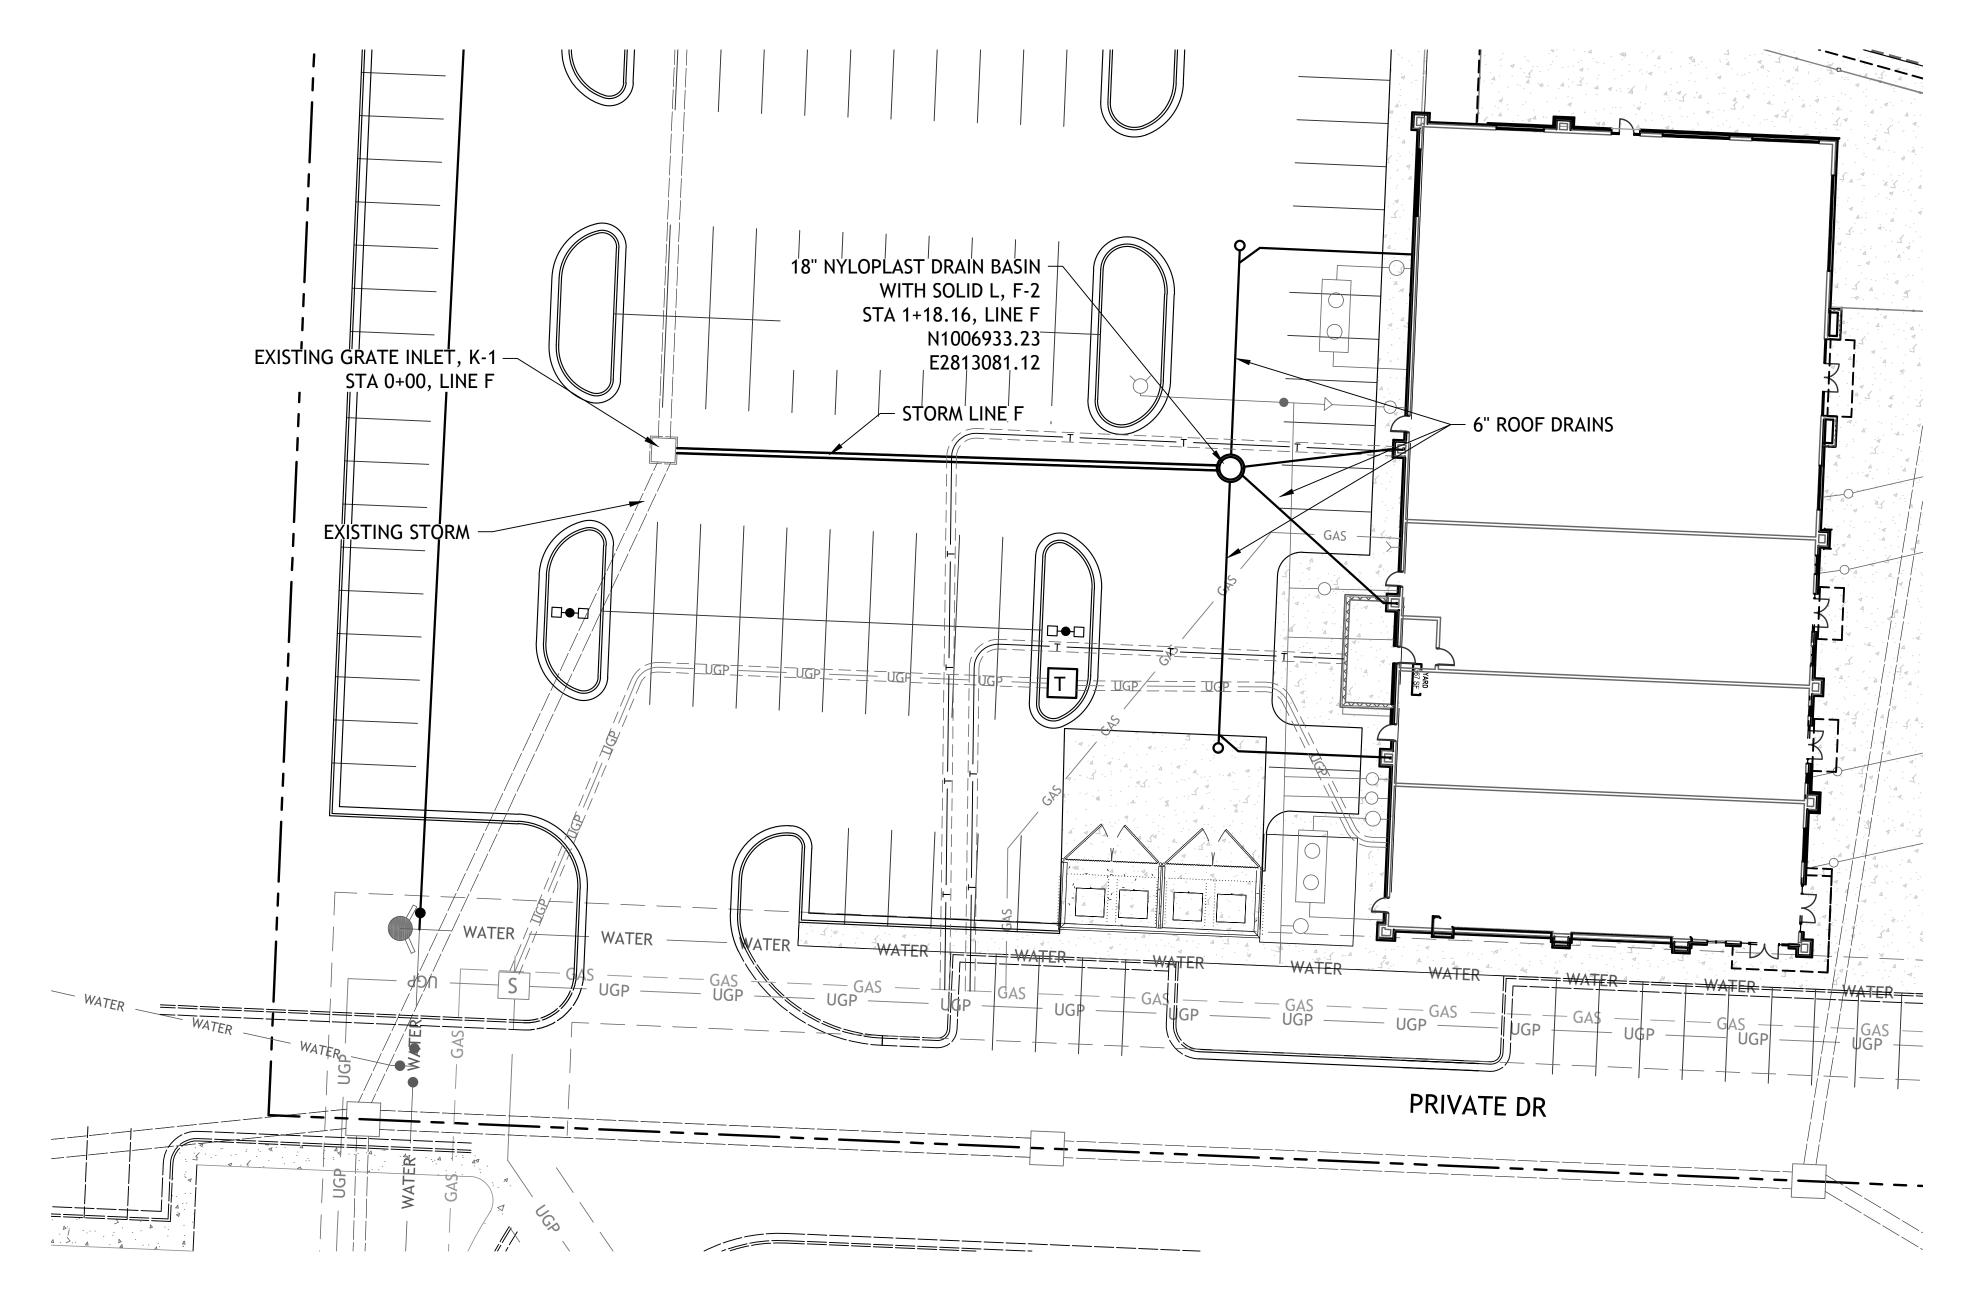

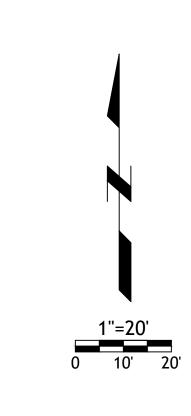
# NOTE COMPACTED FILL SHALL BE PLACED TO A MINIMUM OF 18" ABOVE THE TOP OF THE PIPE PRIOR TO INSTALLATION.

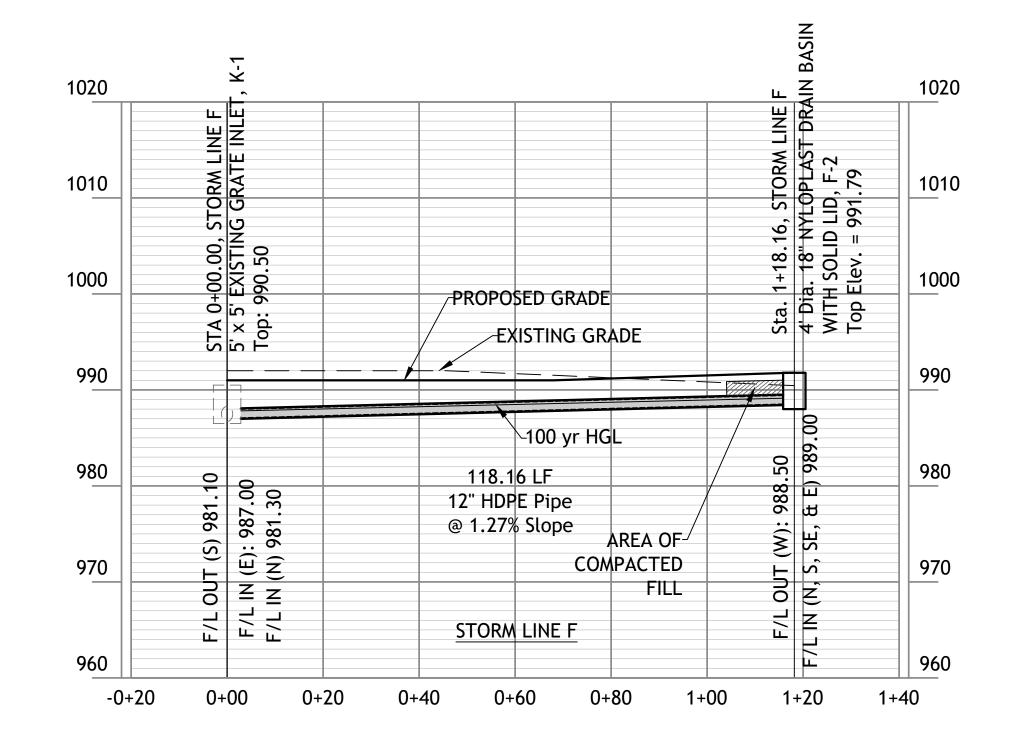

# 100 Year Storm Calculations


	Line ID	Area ID	Drain Area	Runoff Coeff	Inlet Time		Known Q	Flow Rate	Line Length	Line Size	Vel Ave	Capac. Full	Invert Dn	Invert Up		Grnd/Rim Elev Up	HGL Dn	HGL Up	HGL Junct
			(ac)	(C)	(min)	(cfs)	(cfs)	(cfs)	(ft)	(in)	(ft/s)	(cfs)	(ft)	(ft)	(%)	(ft)	(ft)	(ft)	(ft)
1	B2-F1	F1	0.800	0.75	5.0	7.74	0.00	32.45	150.00	30	6.61	31.77	980.20	981.10	0.60	990.50	982.70	983.59	983.72
2	F1-K2	K2	0.750	0.75	5.0	7.25	0.00	21.51	140.00	30	4.38	31.00	981.30	982.10	0.57	990.50	984.30	984.69	984.75
3	K2-K3	КЗ	1.600	0.70	5.0	14.44	0.00	14.44	98.00	24	4.69	20.44	982.60	983.40	0.82	990.00	984.89	985.24	985.31
4	F1-F2	F2	0.320	0.90	5.0	3.71	0.00	3.71	118.00	12	5.57	4.02	987.00	988.50	1.27	991.80	987.77	989.32	989.32
5	B4-C1		0.000	0.00	0.0	0.00	0.00	10.06	178.00	30	3.56	41.24	982.20	984.00	1.01	992.50	984.70	985.06	985.06
6	C1-E1		0.000	0.00	0.0	0.00	0.00	6.49	62.00	18	4.66	7.28	984.20	984.50	0.48	991.50	985.30	985.60	985.73
7	E1-E2	E2	0.640	0.80	5.0	6.60	0.00	6.60	152.00	18	5.45	8.91	985.00	986.09	0.72	989.00	985.96	987.08	987.08
8	C1-C2	C2	0.360	0.80	5.0	3.71	0.00	3.71	76.00	18	5.38	15.24	984.50	986.10	2.11	989.80	985.04	986.84	986.84

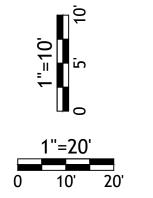

5507 High Meadow Circle Manhattan Kansas, 66503 smcivilengr@gmail.com

785.341.9747

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Revisions 11-29-23 CITY COMMENTS 1-4-24 PER CLIENT
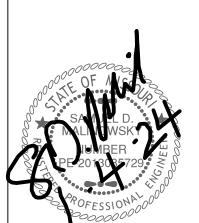
> 138 0F VEST PRVOR

sheet


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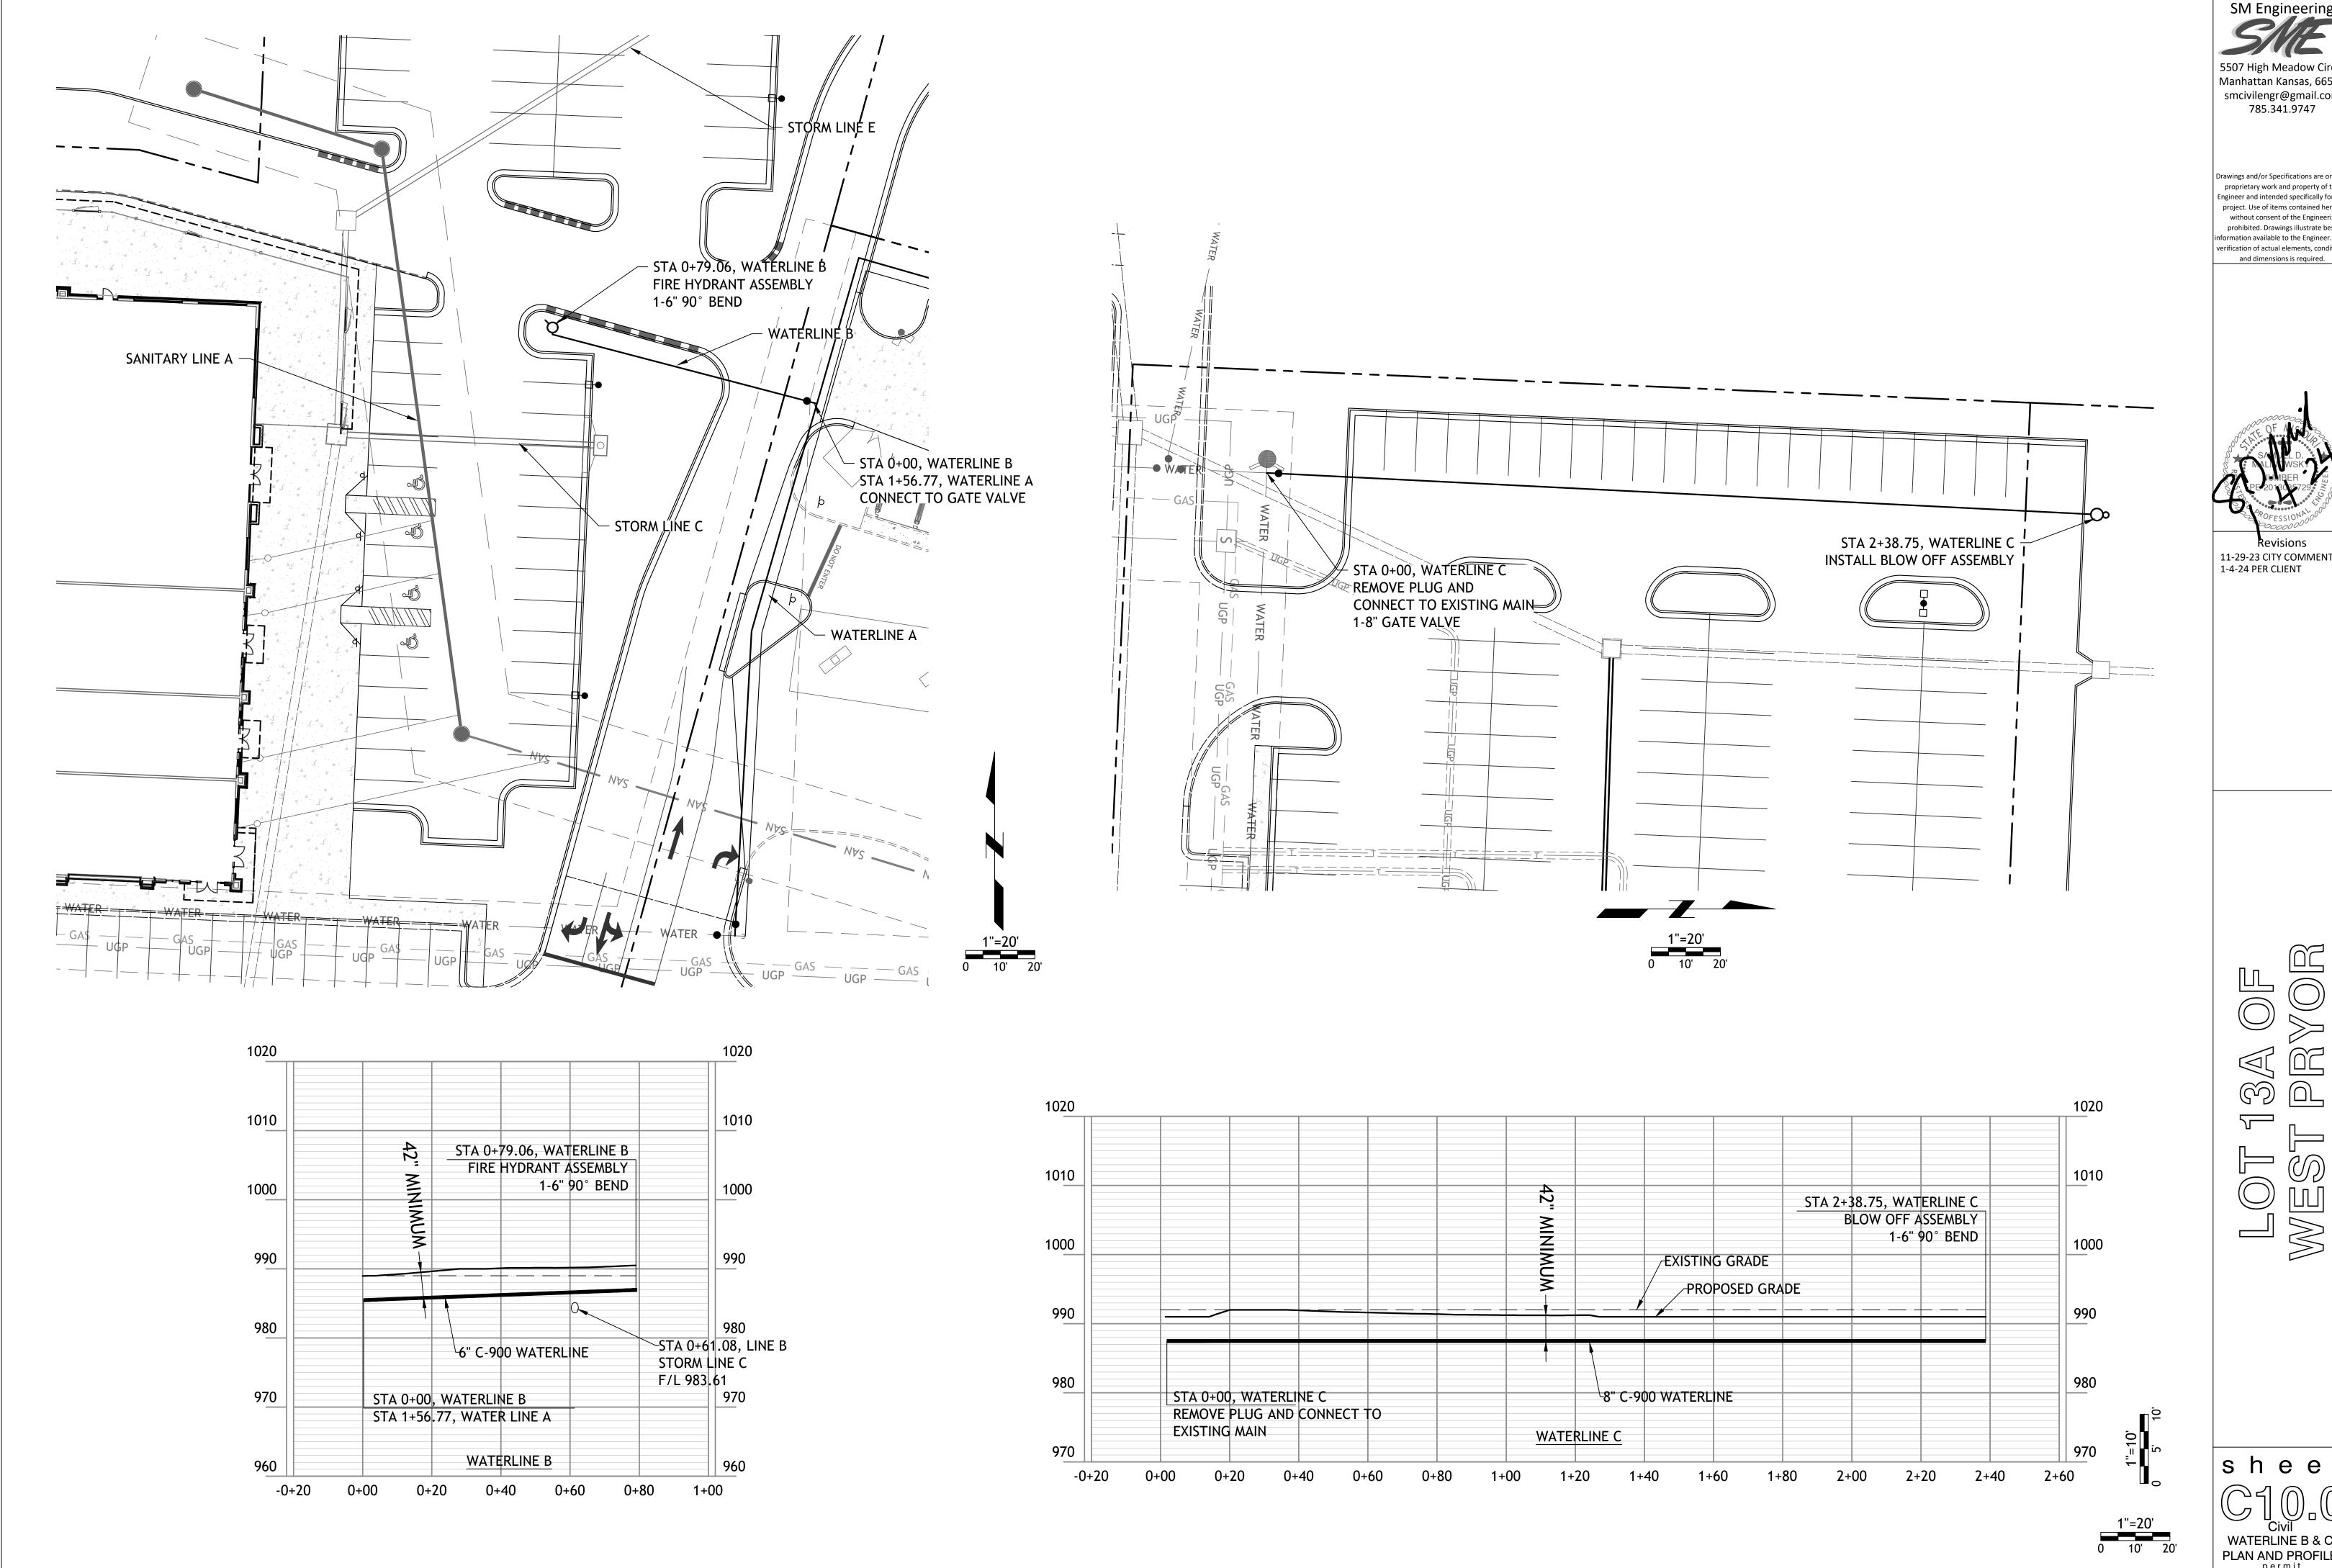
STORM LINE F

PLAN AND PROFILE

permit

19 OCTOBER 2023




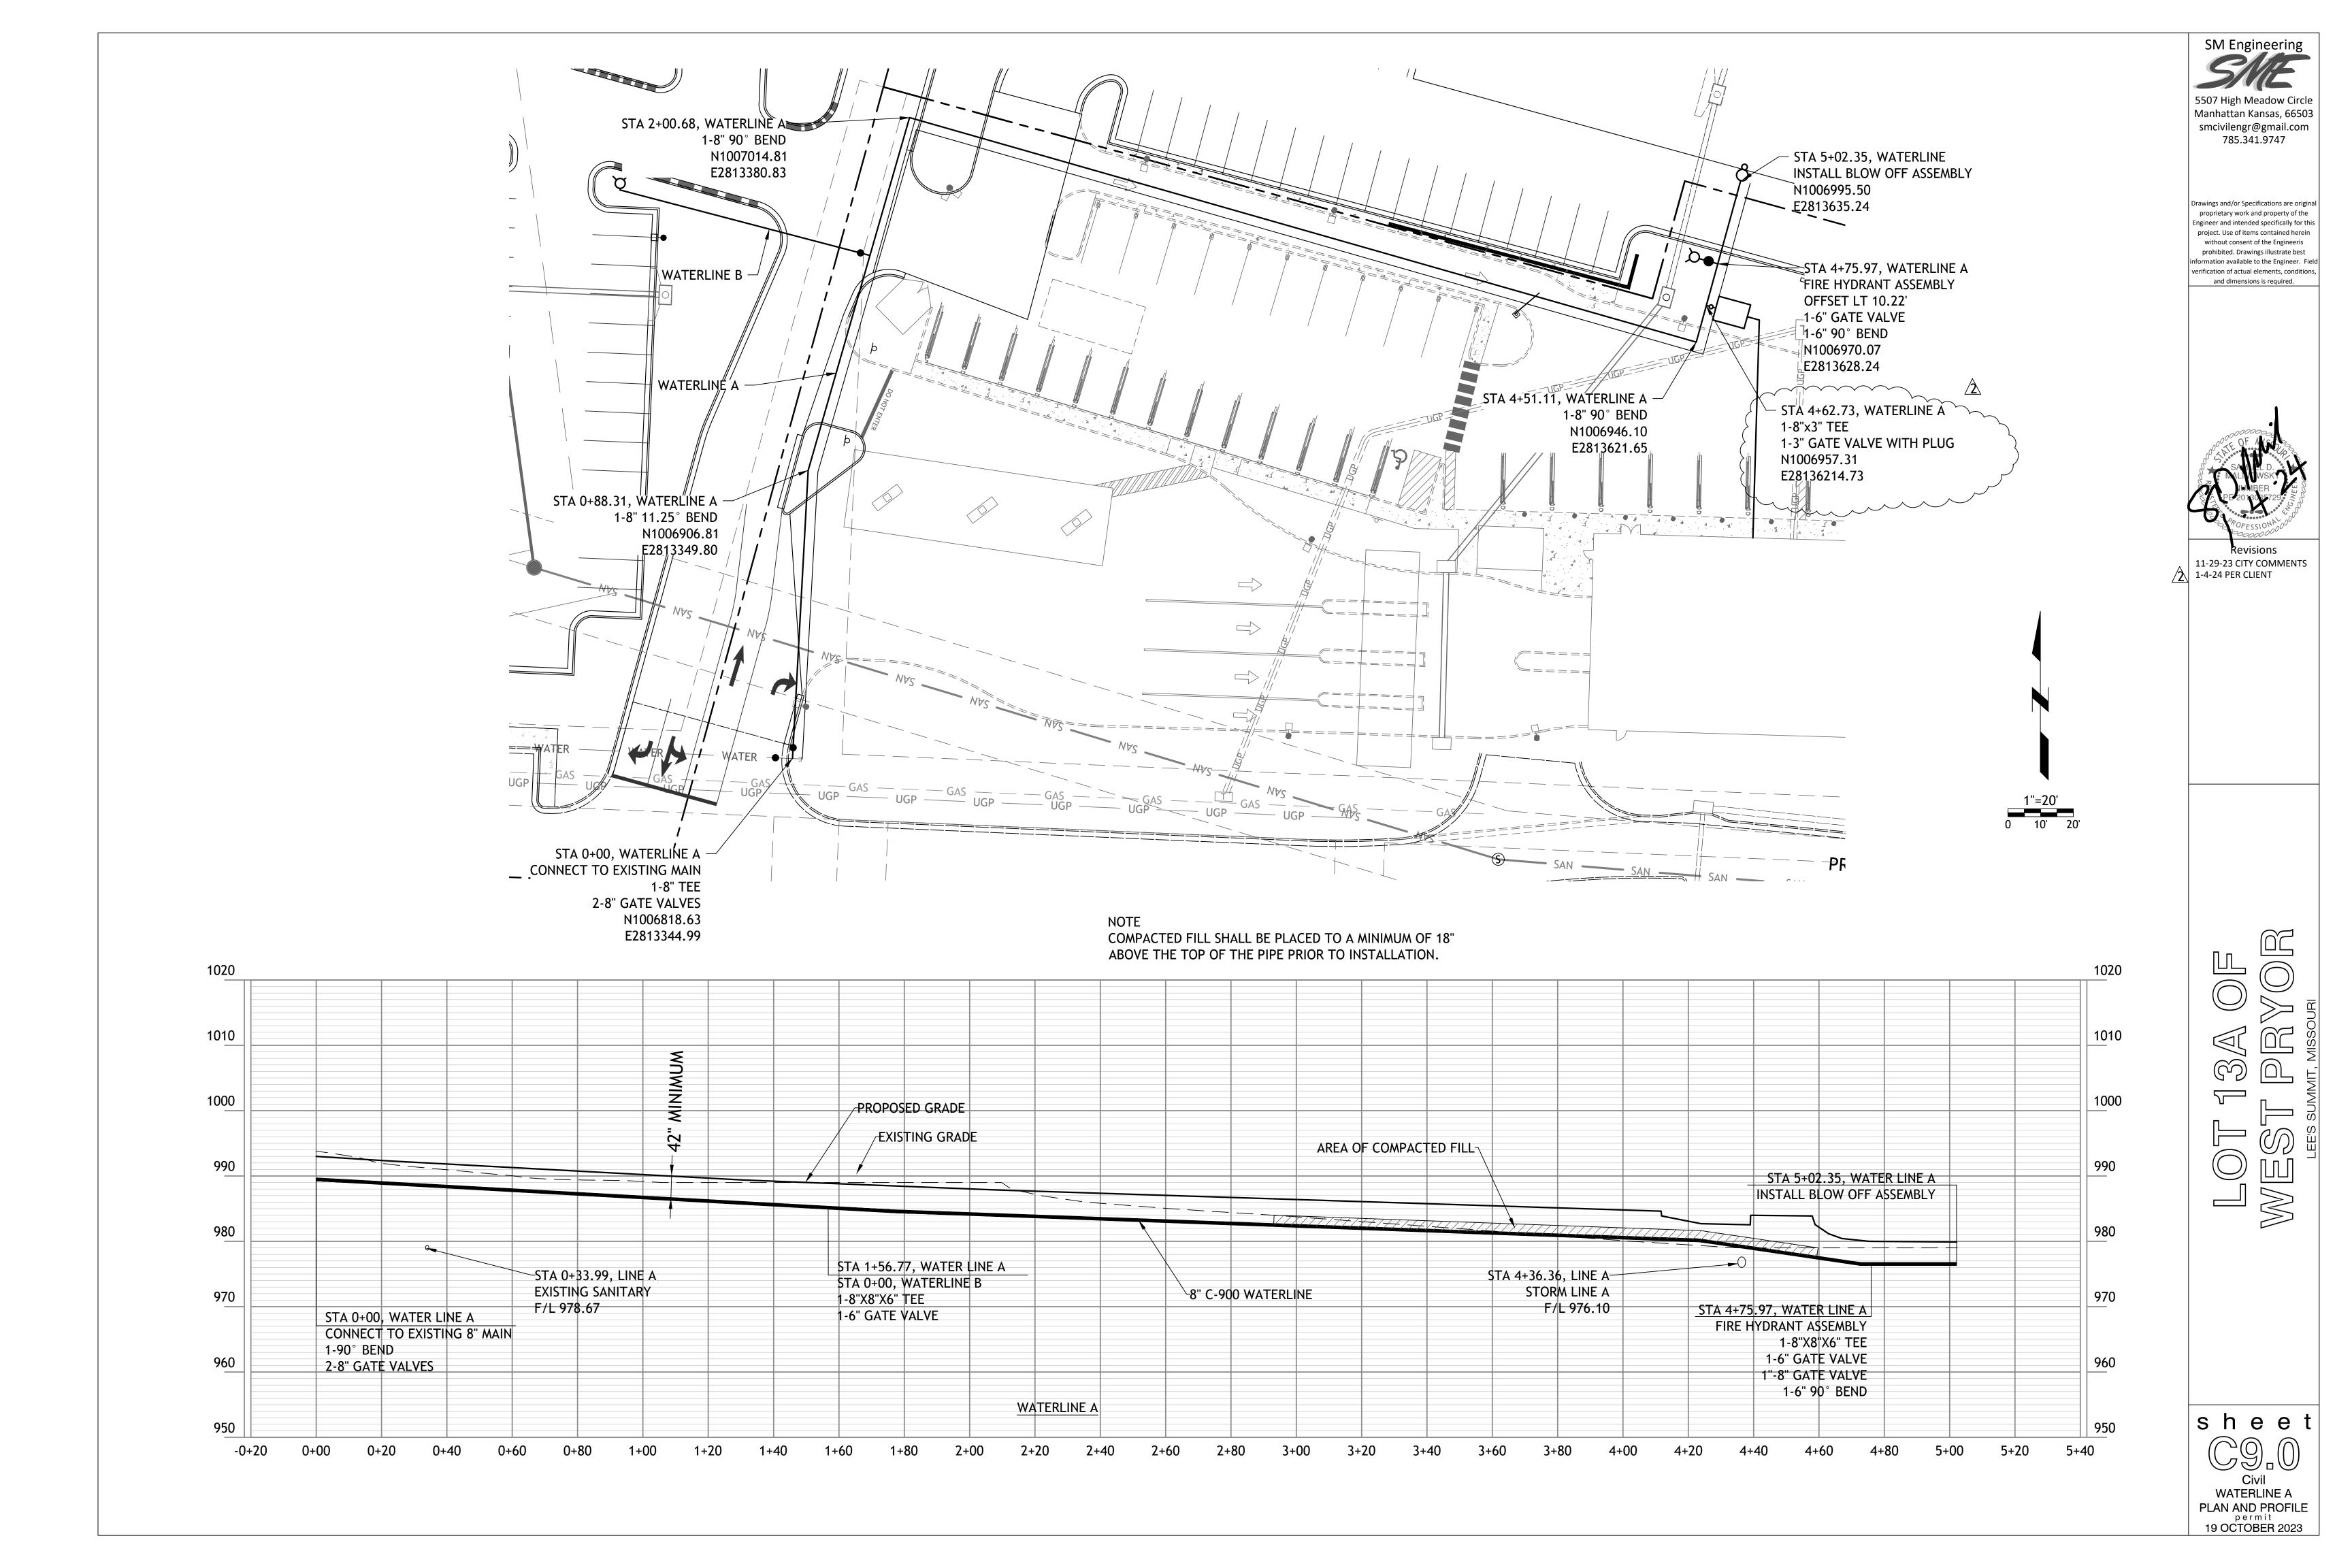

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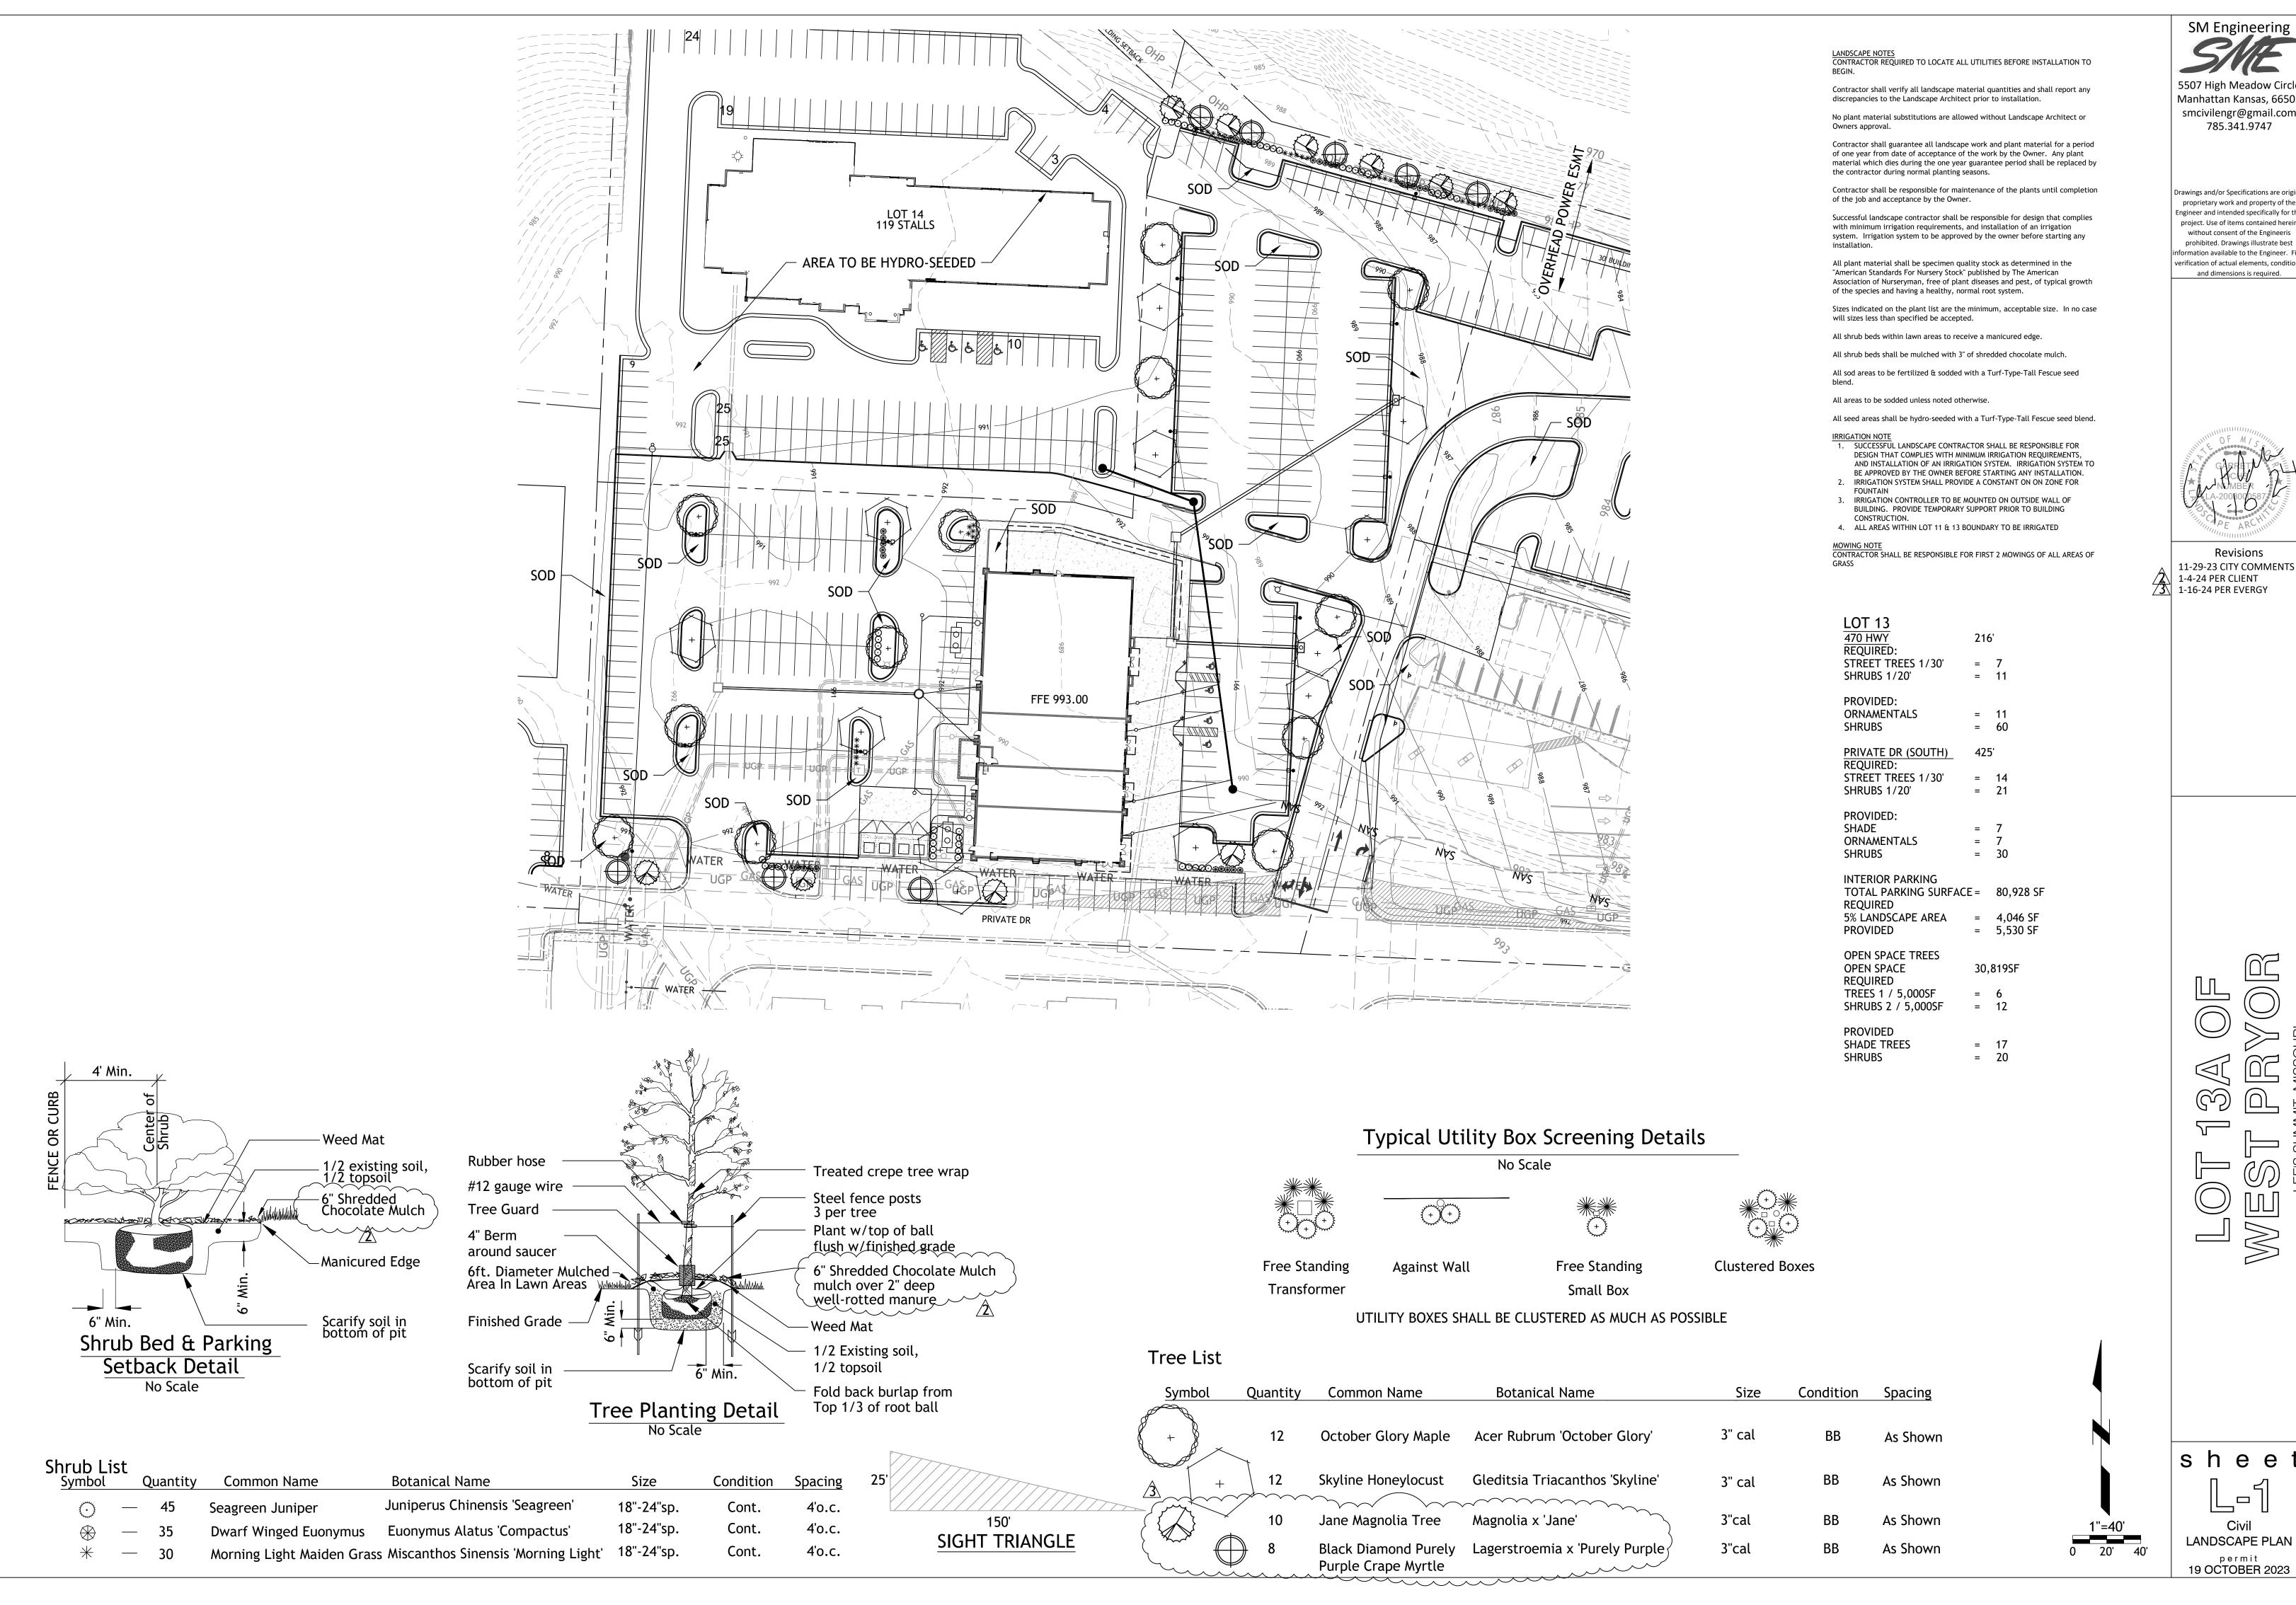
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WATERLINE B & C
PLAN AND PROFILE
permit
19 OCTOBER 2023



SM Engineering
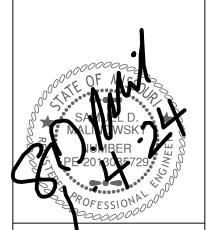
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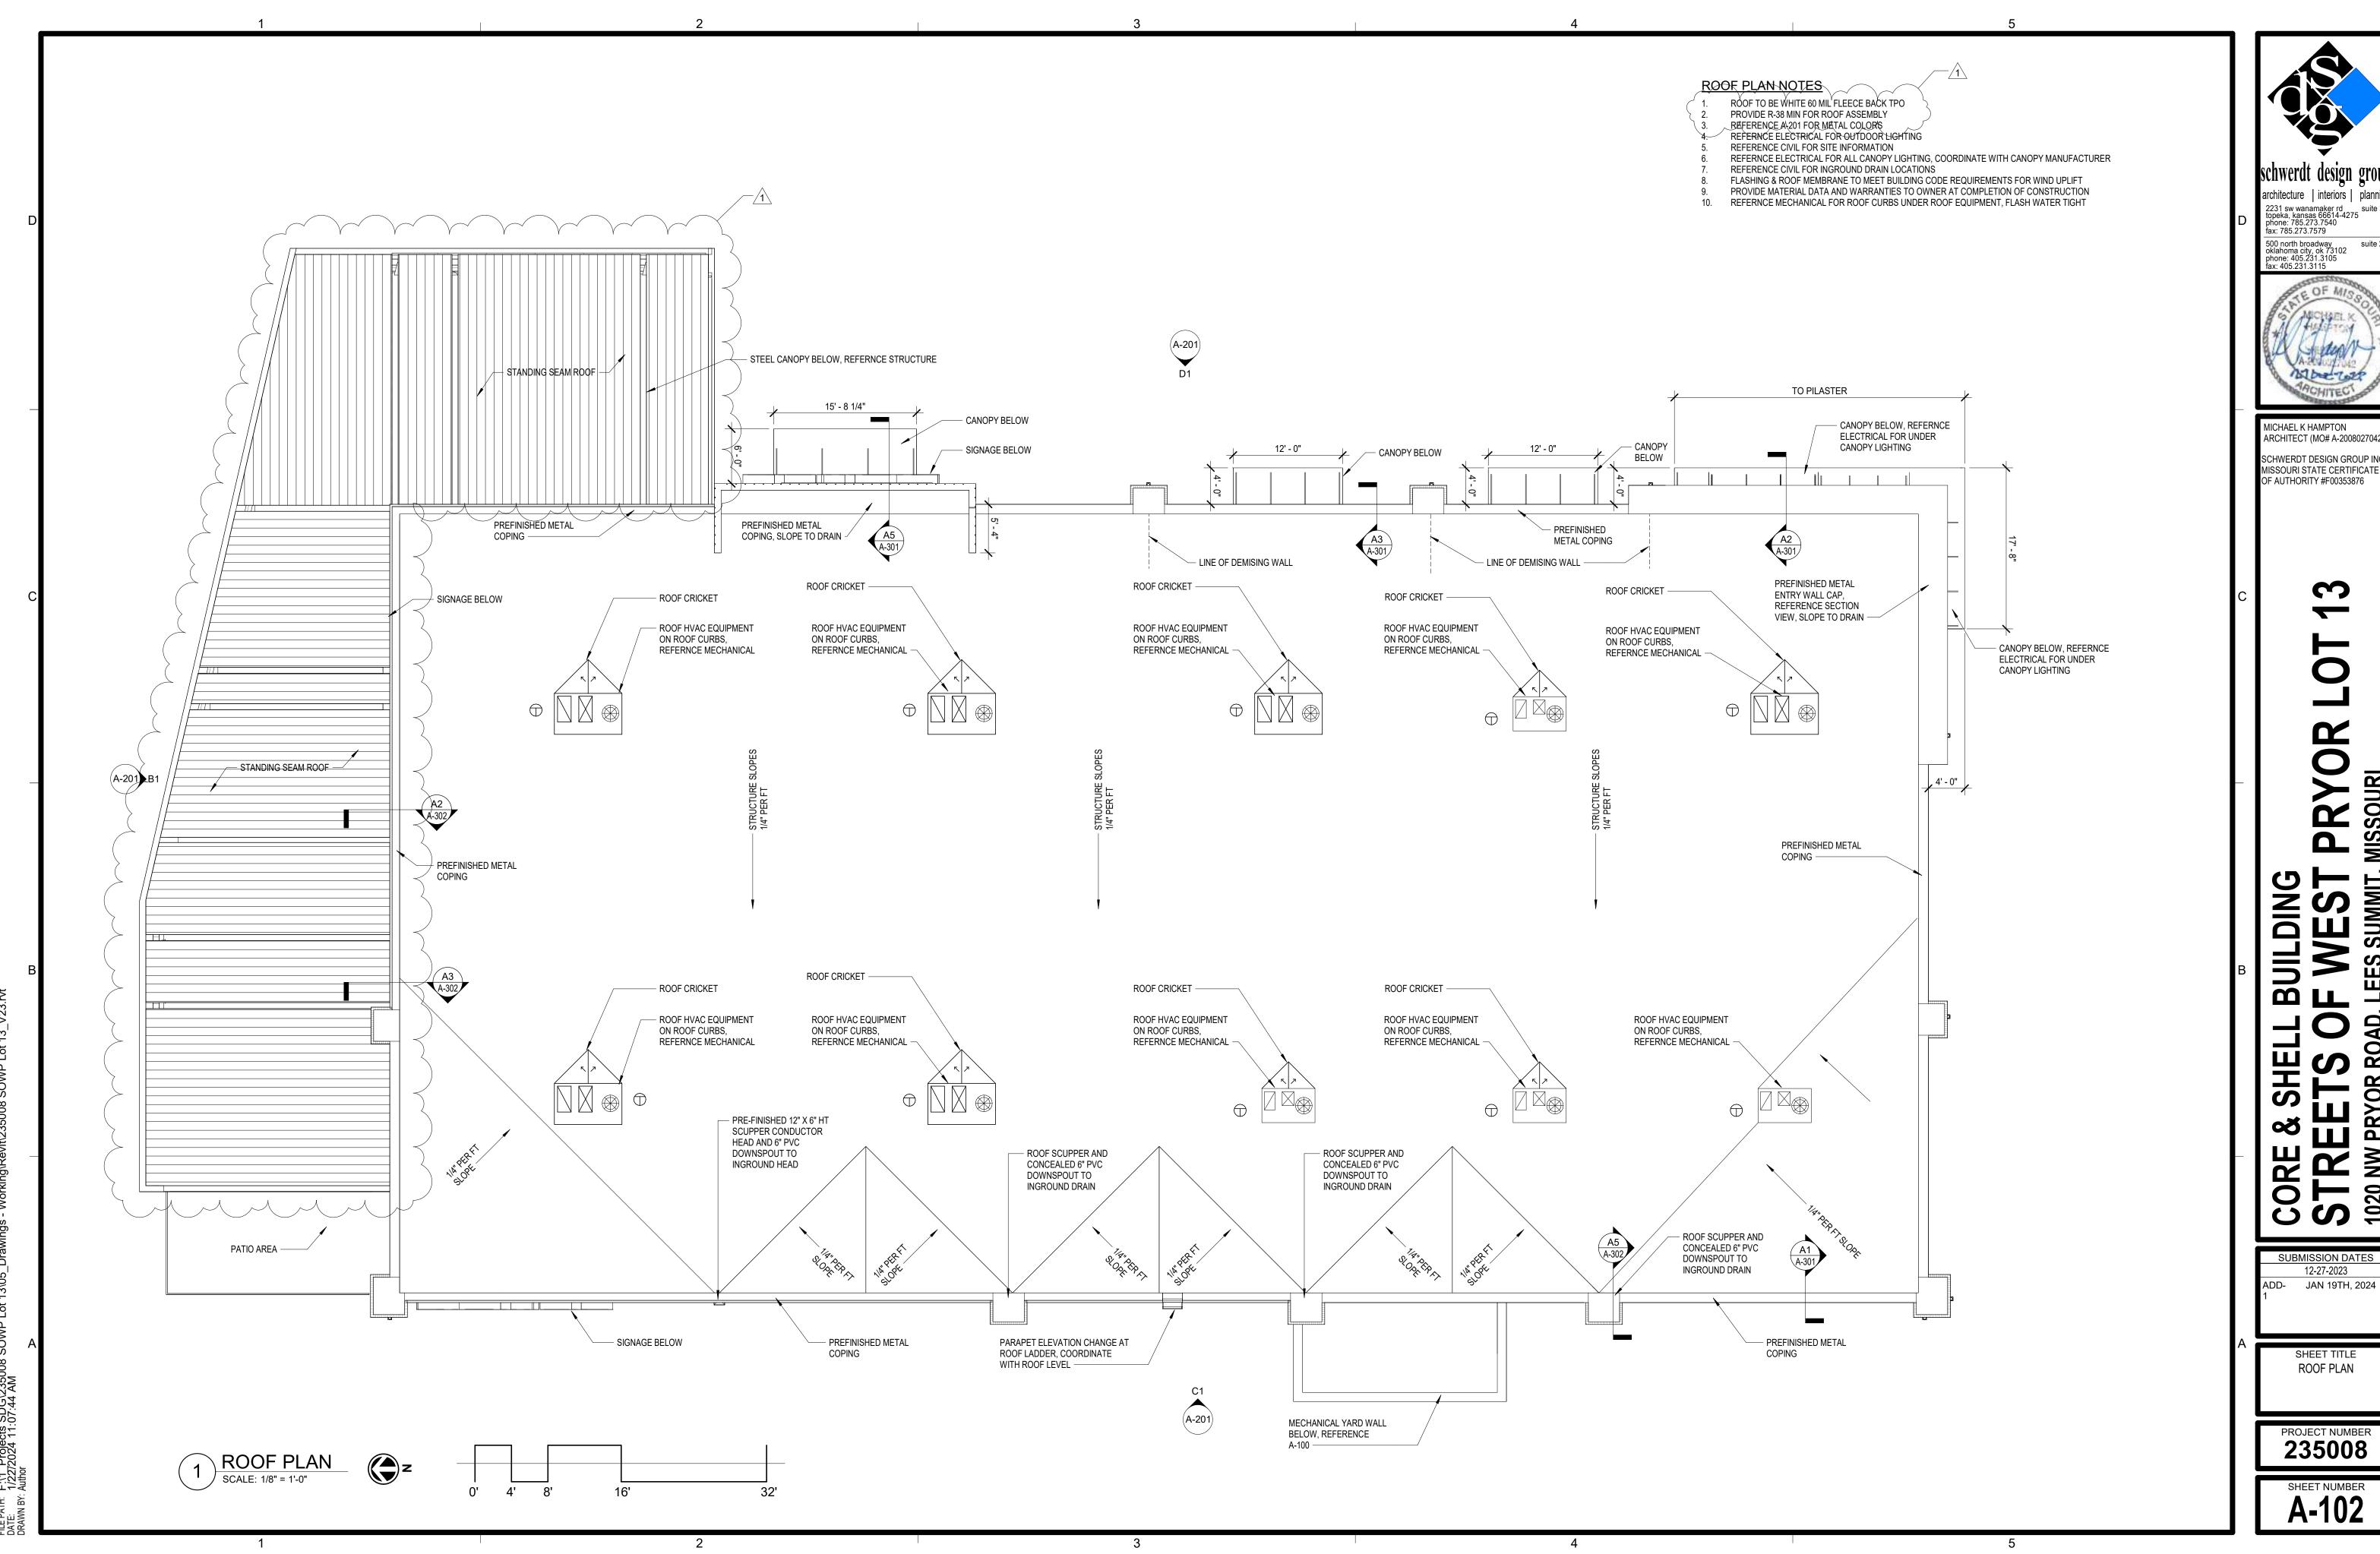
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Revisions 11-29-23 CITY COMMENTS

**2** 1-4-24 PER CLIENT 73 1-16-24 PER EVERGY

shee ا تا Civil



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MICHAEL K HAMPTON ARCHITECT (MO# A-2008027042)

SCHWERDT DESIGN GROUP INC MISSOURI STATE CERTIFICATE OF AUTHORITY #F00353876

12-27-2023

TPO MEMEBRANE TO WRAP UP BACK OF PARAPET WALL AND EXTEND OVER TOP OF *\_*-----WALL, SECURE UNDER FRONT OF COPING PARAPET MEMBER -PARAPET MEMBER -TPO ROOF SYSTEM: TPO ROOF SYSTEM: 60 MIL FLEECE BACK TPO OVER 1/2" 60 MIL FLEECE BACK TPO OVER 1/2" COVERBOARD OVER R-30 COVERBOARD OVER R-30 INSULATION OVER ROOF INSULATION OVER ROOF SHEATHING, SHEATHING, CRICKET AS REQ. TO SLOPE TO CRICKET AS REQ. TO SLOPE TO DRAIN, REF PLAN; TYP. DRAIN, REF PLAN; TYP. - RUSTICATION JOINT, REF - RUSTICATION JOINT, REF **ELEVATIONS FOR LOCATIONS** ELEVATIONS FOR LOCATIONS AND DETAIL TYP. AND DETAIL TYP. FIBERGLASS BATT - FIBERGLASS BATT INSUL TO EXTEND INSUL TO EXTEND 2x NAILER, REF STRUCTURAL PAST ROOF PAST ROOF TPO ROOF STRUCTURE -TPO ROOF SYSTEM -2 X 8 STUD FRAMING WITH R 19 BATT INSULATION, REFERNCE \_\_\_ - \_\_\_ \$TRUCTURE STEEL CANOPY CONNECTION, STEEL CANOPY CONNECTION, PRE-ENGINEERED ROOF TRUSS REFERENCE STRUCTURE - WOOD BRACING, REFERNCE REFERENCE STRUCTURE REF STRUCTURAL STRUCTURE STEEL CANOPY STRUCTURE, NOTE: STEEL PATIO CANOPY ROOF TO BE - FLUID APPLIED WEATHER REFERENCE STRUCTURE STANDING SEAM METAL ROOF OVER PATIO BARRIER OVER 1/2" STRUCTURAL CANOPY SYSTEM. PREFINISHED STANDING WOOD ZIP SHEATHING SEAM METAL ROOF OVER, SPRAY APPLIED A-503 VAPOR BARRIER, 1 1/2" METAL DECK, STEEL - AIR CAVITY STEEL CANOPY CONNECTION, STEEL CANOPY CONNECTION, TUBE JOIST, STEEL TUBE BEAM CANOPY REFERENCE STRUCTURE REFERENCE STRUCTURE STRUCTURE. REFERENCE STRUCTURE 2 X 8 WOOD STUD FRAMING, DESIGN FOR FRAMING & METAL DECK REFERNCE STRUCTURE -INFORMATION. EXPOSED UNDERSIDE OF - FULL WYTHE BRICK WITH BRICK CANOPY AND STRUCTURE TO BE PAINTED. 2x8 STUD FRAMING / R-19 (MIN) 2x8 STUD FRAMING / R-19 (MIN) -TIES @ 16" OC VERT, REFERENCE BATT INSUL BATT INSUL 1/2" STRUCTURAL WOOD **ELEVATION A-201** SHEATHING — - EIFS SYSTEM, EIFS-2 - EIFS/SYSTEM, EIFS-2 - FULL WYTHE BRICK, REFERENCE - REFERENCE A-503 FOR - REFERENCE A-503 FOR ELEVATION A-201, MATCH GENERAL FLASHING GENERAL FLASHING 6" PVC DOWNSPOUT TO INGROUND REQUIREMENTS REQUIREMENTS WINDOW HEIGHT DRAIN TYP, REFERENCE CIVIL - WOOD/ FIBER CEMENT PLANK WINDOW, REFERNCE A-601 SIDING, FC-1 FULL WYTHE BRICK WITH BRICK TIES @ 16" OC VERT, REFERENCE ELEVATION A-201 - FINISH EDGES AS RECOMENDED BY MANUFACTURER REINFORCED CONCRETE SLAB REF. STRUCTURAL STRUCTURAL SHEATHING AND WEATHER BARRIER SYSTEM REINFORCED CONCRETE SLAB \_ REF. STRUCTURAL \_ REINFORCED CONCRETE SLAB \_ REF. STRUCTURAL \_ FULL WYTHE BRICK WITH BRICK
TIES @ 16" OC VERT, REFERENCE
ELEVATION A-201 VAPOR BARRIER VAPOR BARRIER VAPOR BARRIER - REFERENCE CIVIL/ STRUCTURE FOR DOWNSPOUT TIE IN **GRANULAR FILL** GRANULAR FILL GRANULAR FILL REF GEOTECHNICAL REPORT REF GEOTECHNICAL REPORT REF GEOTECHNICAL REPORT 2" PERIMETER \_ INSULATION 2" PERIMETER \_ INSULATION 2" PERIMETER \_ INSULATION A2 TENANT A NORTH WALL SECTION @ WINDOWS

SCALE: 1/2" = 1'-0" TEANAT A NORTH WALL SECTION

SCALE: 1/2" = 1'-0" TENANT C WEST WALL SECTION

SCALE: 1/2" = 1'-0"

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MICHAEL K HAMPTON ARCHITECT (MO# A-2008027042) SCHWERDT DESIGN GROUP INC

SCHWERDT DESIGN GROUP INC MISSOURI STATE CERTIFICATE OF AUTHORITY #F00353876

OF AUTHORITY #F00353876

LOT 13

WEST PRYOR LOT


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SUBMISSION DATES 12-27-2023 ADD- JAN 19TH, 2024

SHEET TITLE
WALL SECTIONS

PROJECT NUMBER 235008

A-302

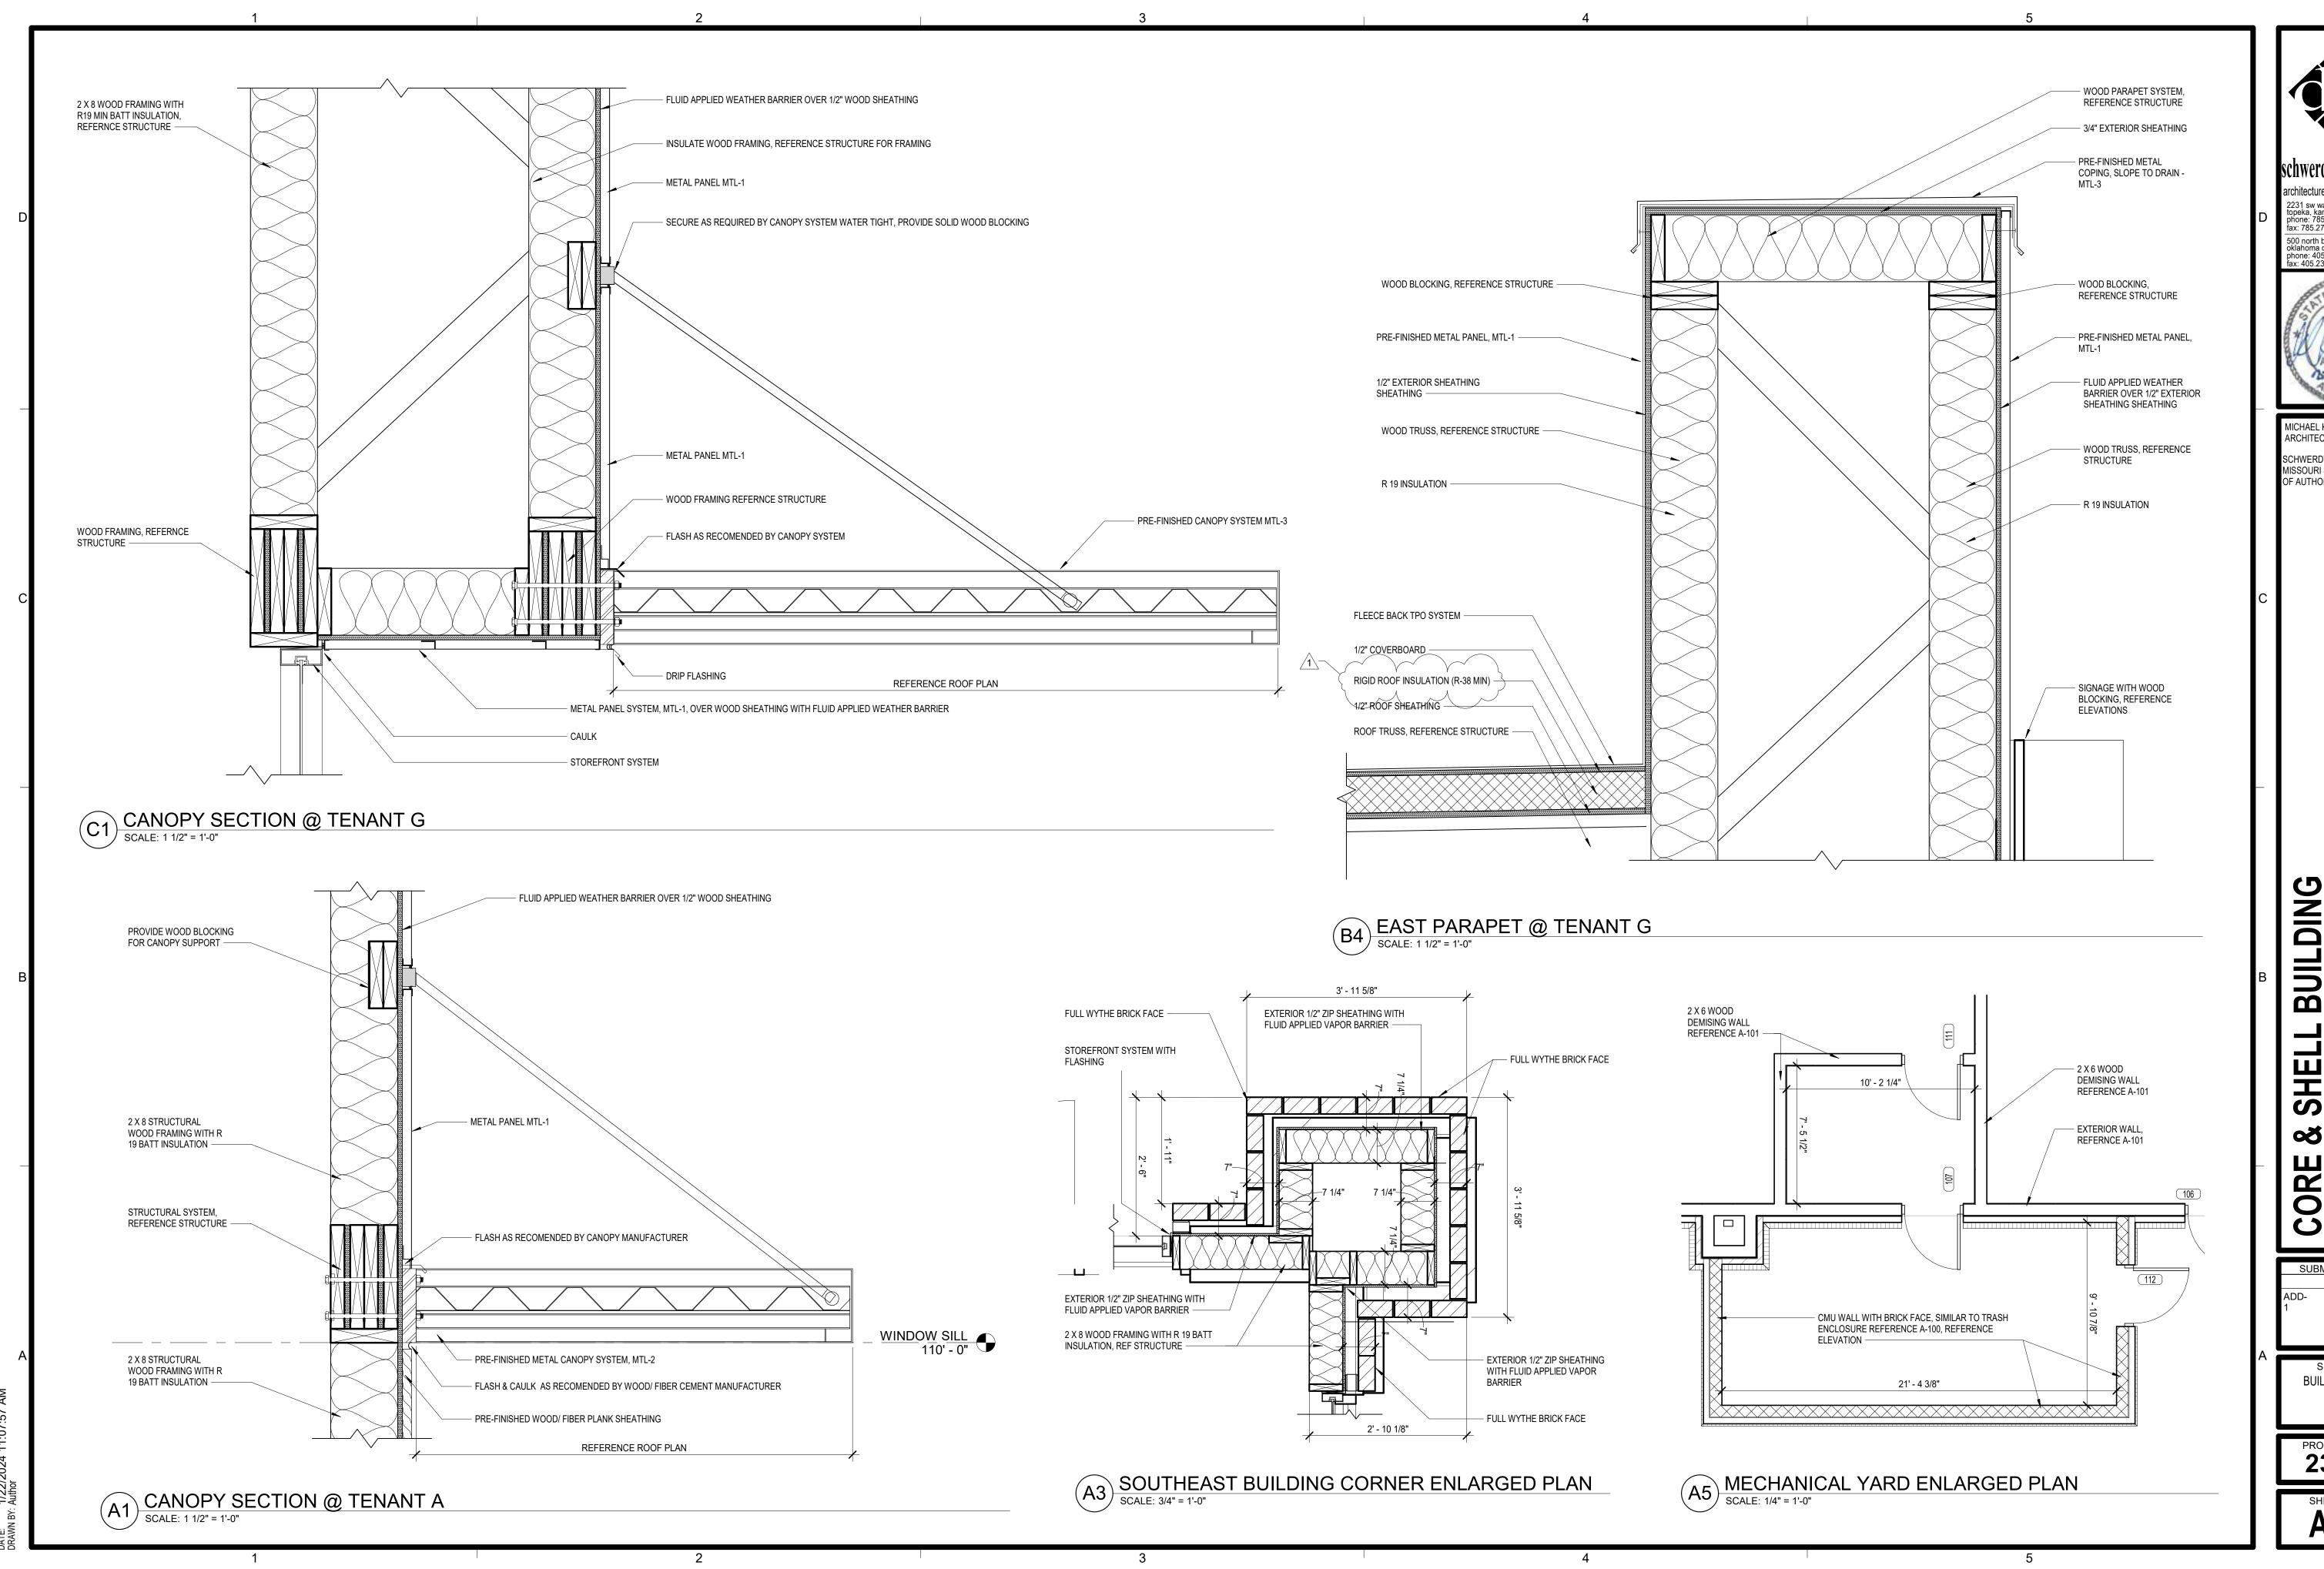

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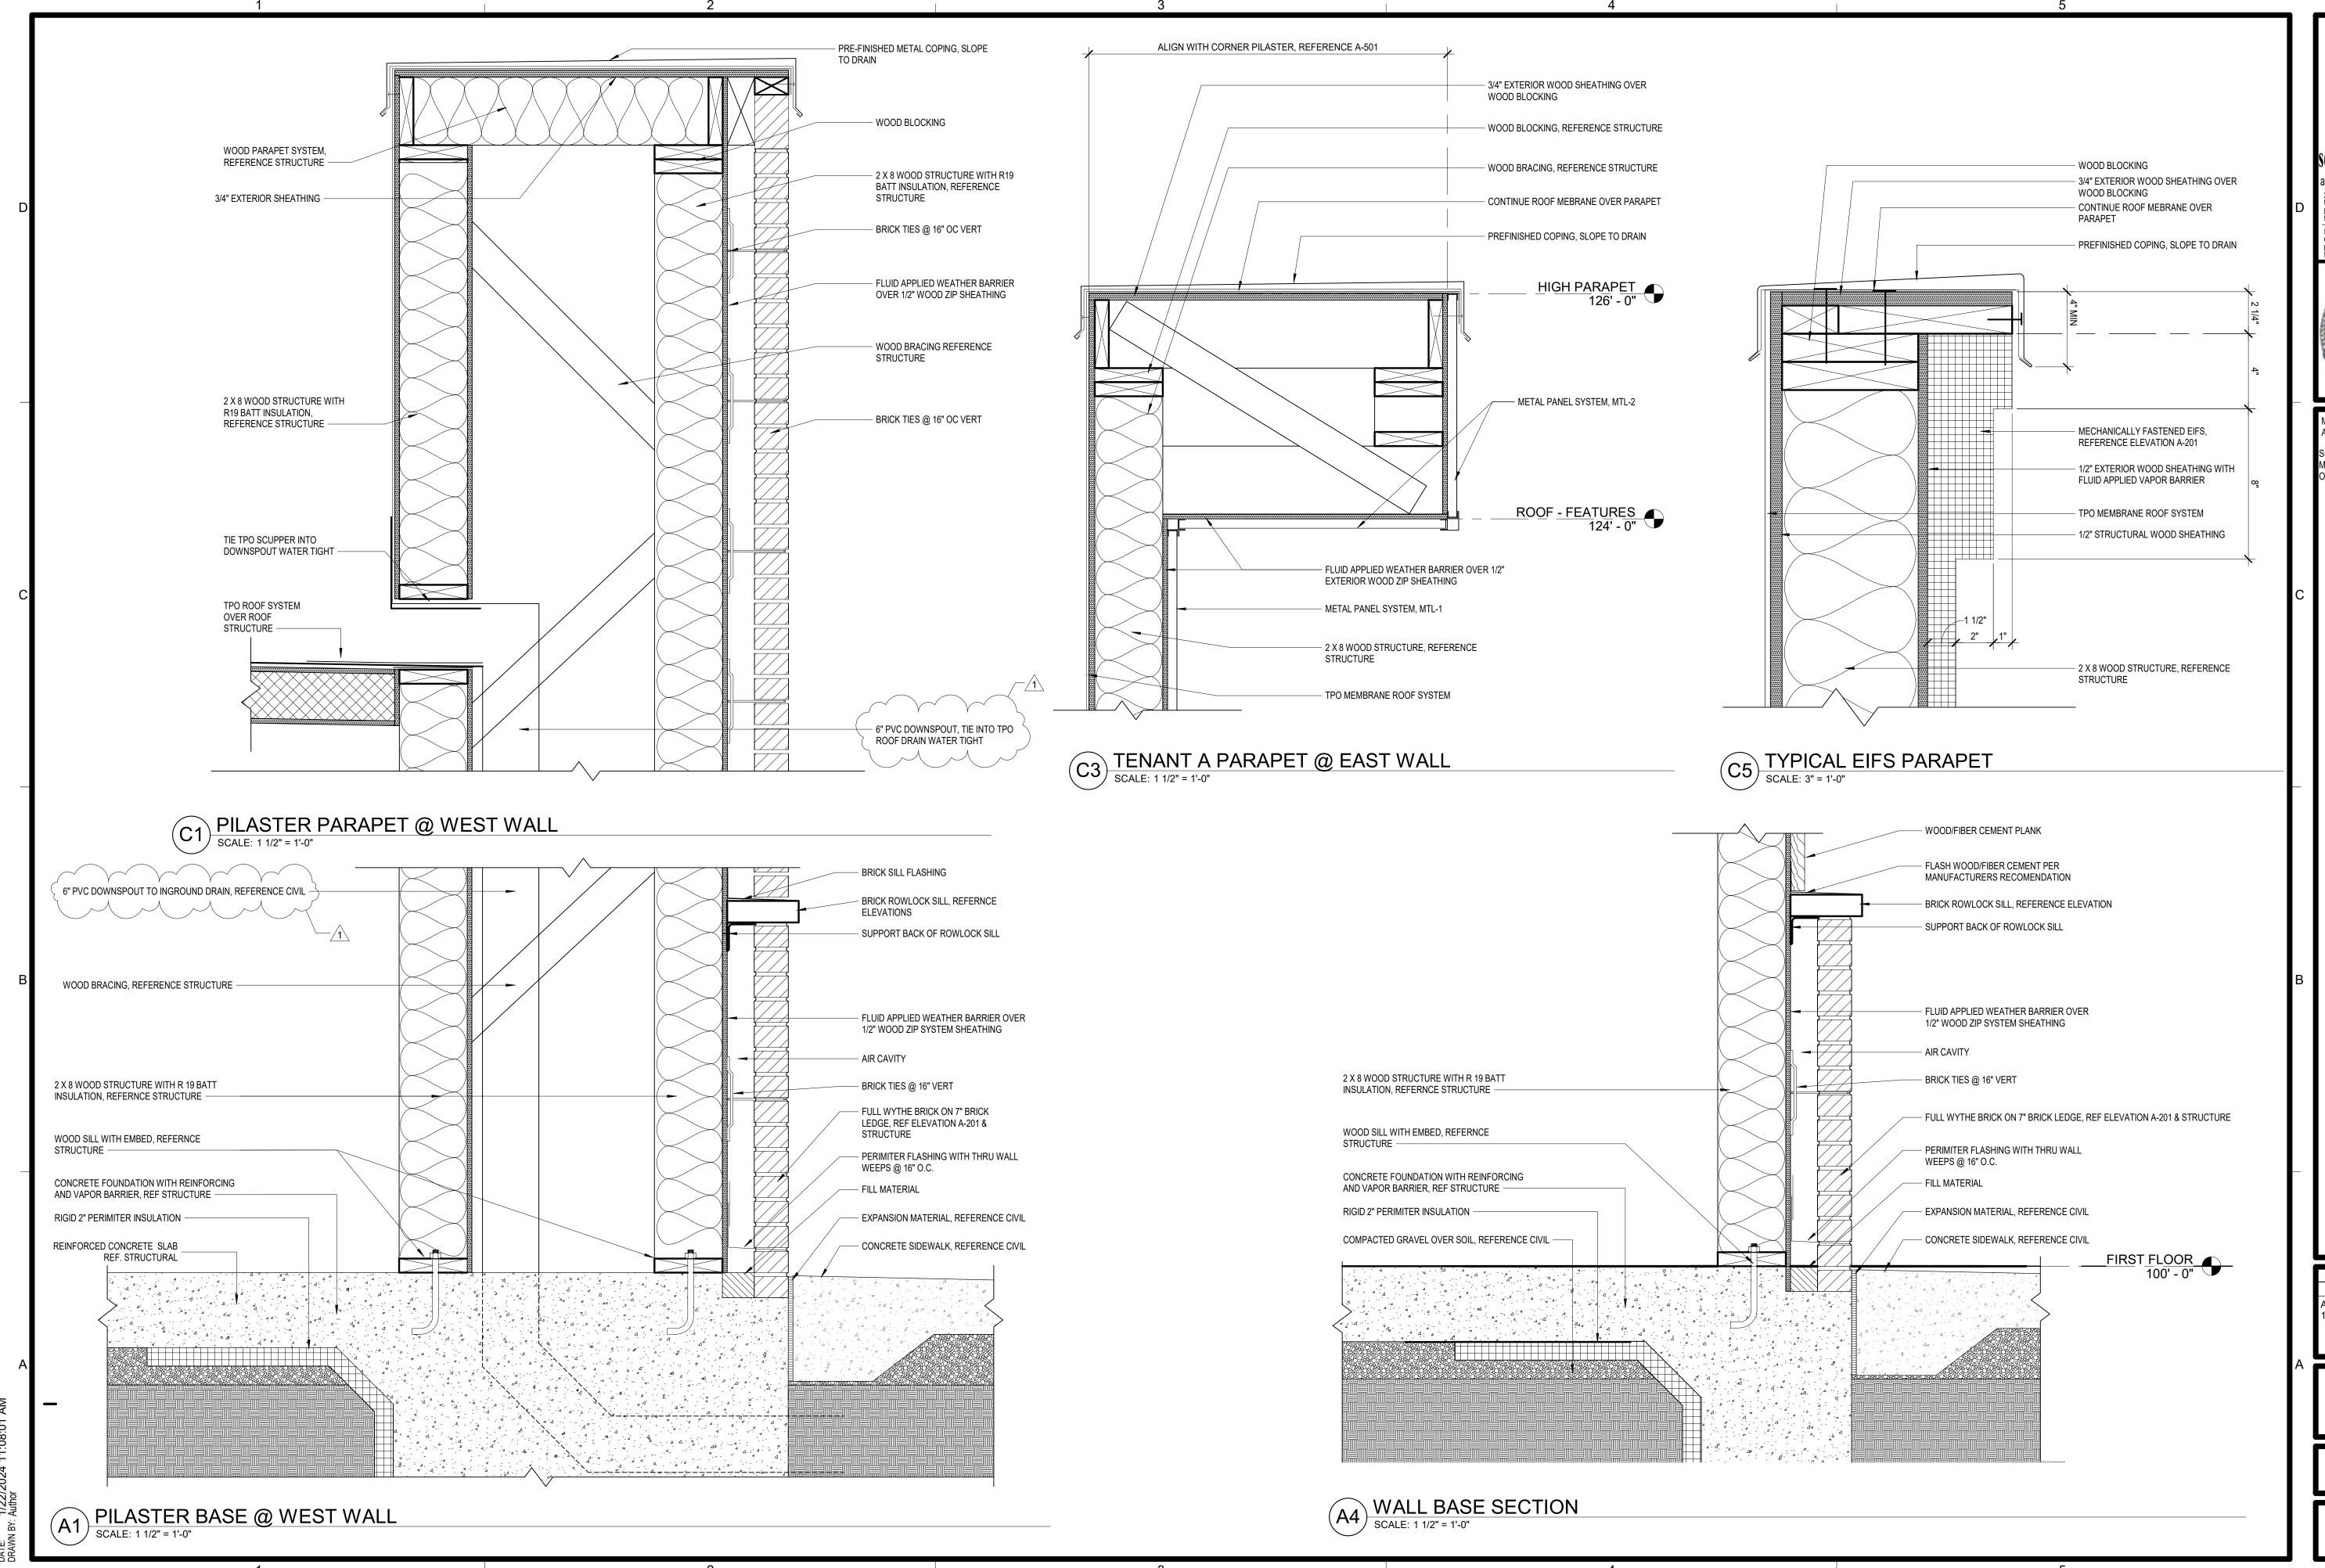
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SUBMISSION DATES 12-27-2023 ADD- JAN 19TH, 2024

**BUILDING DETAILS** 



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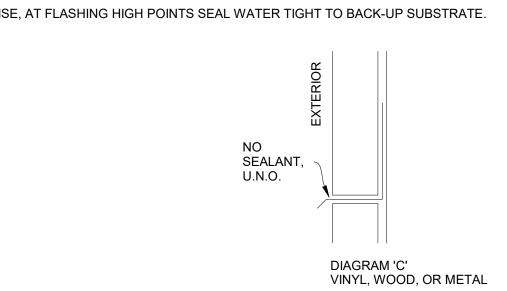
**BUILDING DETAILS** 

EXTERIOR 1/2" ZIP SHEATHING WITH FLUID APPLIED VAPOR BARRIER — FULL WYTHE BRICK FACE INTERIOR FINISH BY 2 X 8 WOOD FRAMING WITH R 19 BATT INSULATION, REF STRUCTURE EXTERIOR 1/2" ZIP SHEATHING WITH FLUID APPLIED VAPOR BARRIER - FULL WYTHE BRICK FACE

\ ENLARGED NORTH/ EAST/ SOUTH PILASTER PLAN SCALE: 3/4" = 1'-0"

**GENERAL FLASHING REQUIREMENTS** 

- A. PROPERLY WEEP FLASHING POINTS AND NORMAL DRAINAGE POINTS WITH WEEPS @ 1'-4" O.C. MAX. SPACING. WEEP POINTS ARE TO BE LOCATED DIRECTLY ON TOP OF FLASHING.
- B. WHERE FLASHING IS LOCATED TERMINATE AND/OR SEPARATES MATERIALS, DO NO SEAL (U.N.O.) -REFER TO DIAGRAM "C" WHERE IT IS DETERMINED BY THE MATERIAL MANUFACTURER OR OTHERWISE THAT SEALING IS REQUIRED (TO PREVENT WATER PENETRATION BEYOND FLASHING DUE TO WIND DRIVEN RAIN), THEN SEALANT MUST BE WEEPED IN ACCORDANCE WITH NOTE "A" ABOVE.
- C. UNLESS NOTED OTHERWISE, TURN FLASHING UP A MIN. OF 4" BEHIND APPROPRIATE MATERIALS.
- D. FLASHING CONDITIONS, WHETHER DETAILED OR NOT, ARE TO BE IN ACCORDANCE WITH S.M.A.C.N.A. SPECIFICATIONS. WHERE ATYPICAL CONDITIONS OCCUR THAT ARE NOT DETAILED, FLASHING IS TO BE INSTALLED AS CLOSELY AS POSSIBLE TO THE S.M.A.C.M.A. DETAIL THAT IS MOST CLOSELY APPROXIMATES THE ACTUAL CONDITION.
- E. UNLESS NOTED OTHERWISE, AT FLASHING HIGH POINTS SEAL WATER TIGHT TO BACK-UP SUBSTRATE.



GENERAL FLASHING DETAIL


SCALE: 12" - 41 0" SCALE: 12" = 1'-0"

3' - 11 5/8"

B3 ENLARGED WEST PILASTER PLAN

SCALE: 3/4" = 1'-0" EXTERIOR INSULATION FINISHING SYSTEM COUNTER FLASHING; CAULK AT TOP PREFINISHED METAL FLASHING - Z - ENCLOSURE METAL 1 1/2"X 22GA STEEL DECKING; REF. STRUCT EXTERIOR WALL SYSTEM SHOWN BEHIND 8 X 4 X 1/4" STEEL TUBE JOIST; REF. STRUCT 6 X 6 X 1/4" STEEL TUBE 12 X 6 X 1/4" STEEL TUBE COLUMN; REF. STRUCT BEAM; REF. STRUCT NOTE: STRUCTURE AND STANDING SEAM TO HAVE A 1/4" SLOPE; REF. STRUCT (A3) STANDING SEAM WALL CONNECTION


SCAL F: 1 1/2" = 1'-0"

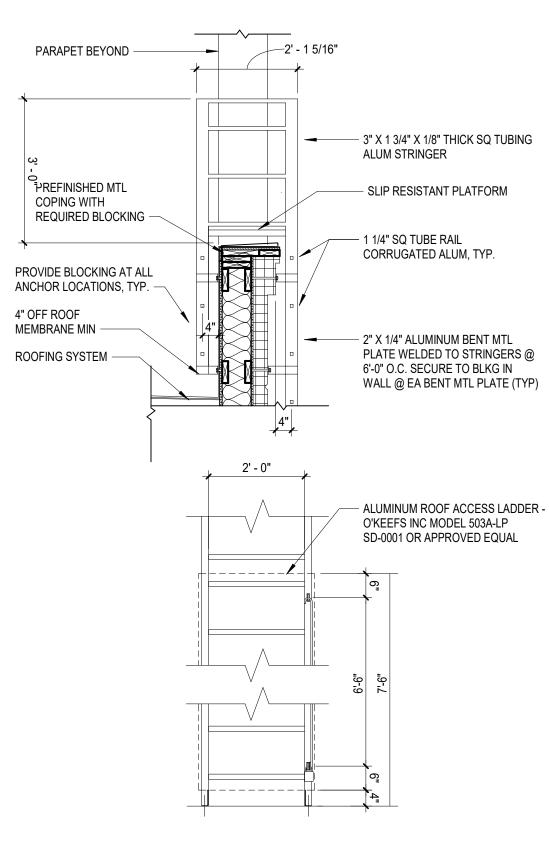

B5) ROOF ACCESS LADDER SCALE: 1/2" = 1'-0"

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SUMM

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SUBMISSION DATES

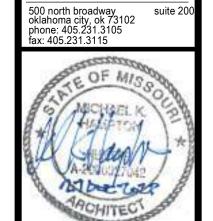12-27-2023

ADD- JAN 19TH, 2024


**BUILDING DETAILS** 

235008

FIRE RATING: 2 HOURS STC RATING: 42 THICKNESS: ALL DEMISING WALL DEMISING WALL PLAN - COMBUSTIBLE STUDS TO CONDITION BE FIRE BLOCKED 1' - 4" 1' - 4" NAIL PATTERN DETAILS GYPSUM PANELS: TWO LAYERS 5/8" SHEETROCK GYPSUM PANEL (UL TYPE SCX) WOOD STUDS: 2" X 6" WOOD STUDS, 16" O.C. 1. Nailheads — Exposed or covered with joint compound. INSULATION: 5 1/2" FIBERGLASS INSULATION 2. Joints — Exposed joints covered with joint compound TWO LAYERS 5/8" SHEETROCK GYPSUM PANEL (UL TYPE SCX) GYPSUM PANELS: and paper tape. Joint compound and paper tape may be omitted when square edge boards are used. As an alternate, nom 3/32 in. thick gypsum veneer plaster may be applied to the entire surface of Classified veneer baseboard with the joints reinforced with paper tape. 3. Nails — 6d cement coated nails 1-7/8 in. long, 0.0915 in. shank diam, 1/4 in. diam heads, and 8d cement coated < ROOF SYSTEM ABOVE nails 2-3/8 in. long, 0.113 in. shank diam, 9/32 in. diam - ROOF SHEATHING 4. Gypsum Board\* — 5/8 in. thick, two layers applied ALL DEMSING WALL GYPSUM either horizontally or vertically. Inner layer attached to SHEATHING TO MEET FROM studs with the 1-7/8 in. nails spaced 6 in. OC. Outer layer TOP OF FLOOR SLAB TO attached to studs over inner layer with the 2-3/8 in. long BOTTOM OF ROOF SHEATHING nails spaced 8 in. OC. Vertical joints located over studs. All joints in face layers staggered with joints in base - 2X WOOD TRUSS; REF. STRUCT layers. Joints of each base layer offset with joints of base layer on opposite side. When used in widths other than 48 in., gypsum board to be installed horizontally. WALL PENETRATION DETAILS TOP OF 2 X 6 DOUBLE PLATE 1. Any penetrations made in a fire rated wall are to be closed and sealed with firestop material to prevent any - 2 X 6 WOOD STUD potential fire hazards. For specific details see section XHEZ (Through Penetration Firestop System) of the UL UL U301 product performance data. **DEMISING WALL** SECTION CONDITION


FIRE BARRIER DETAILS

SCALE: 1" = 1'-0"

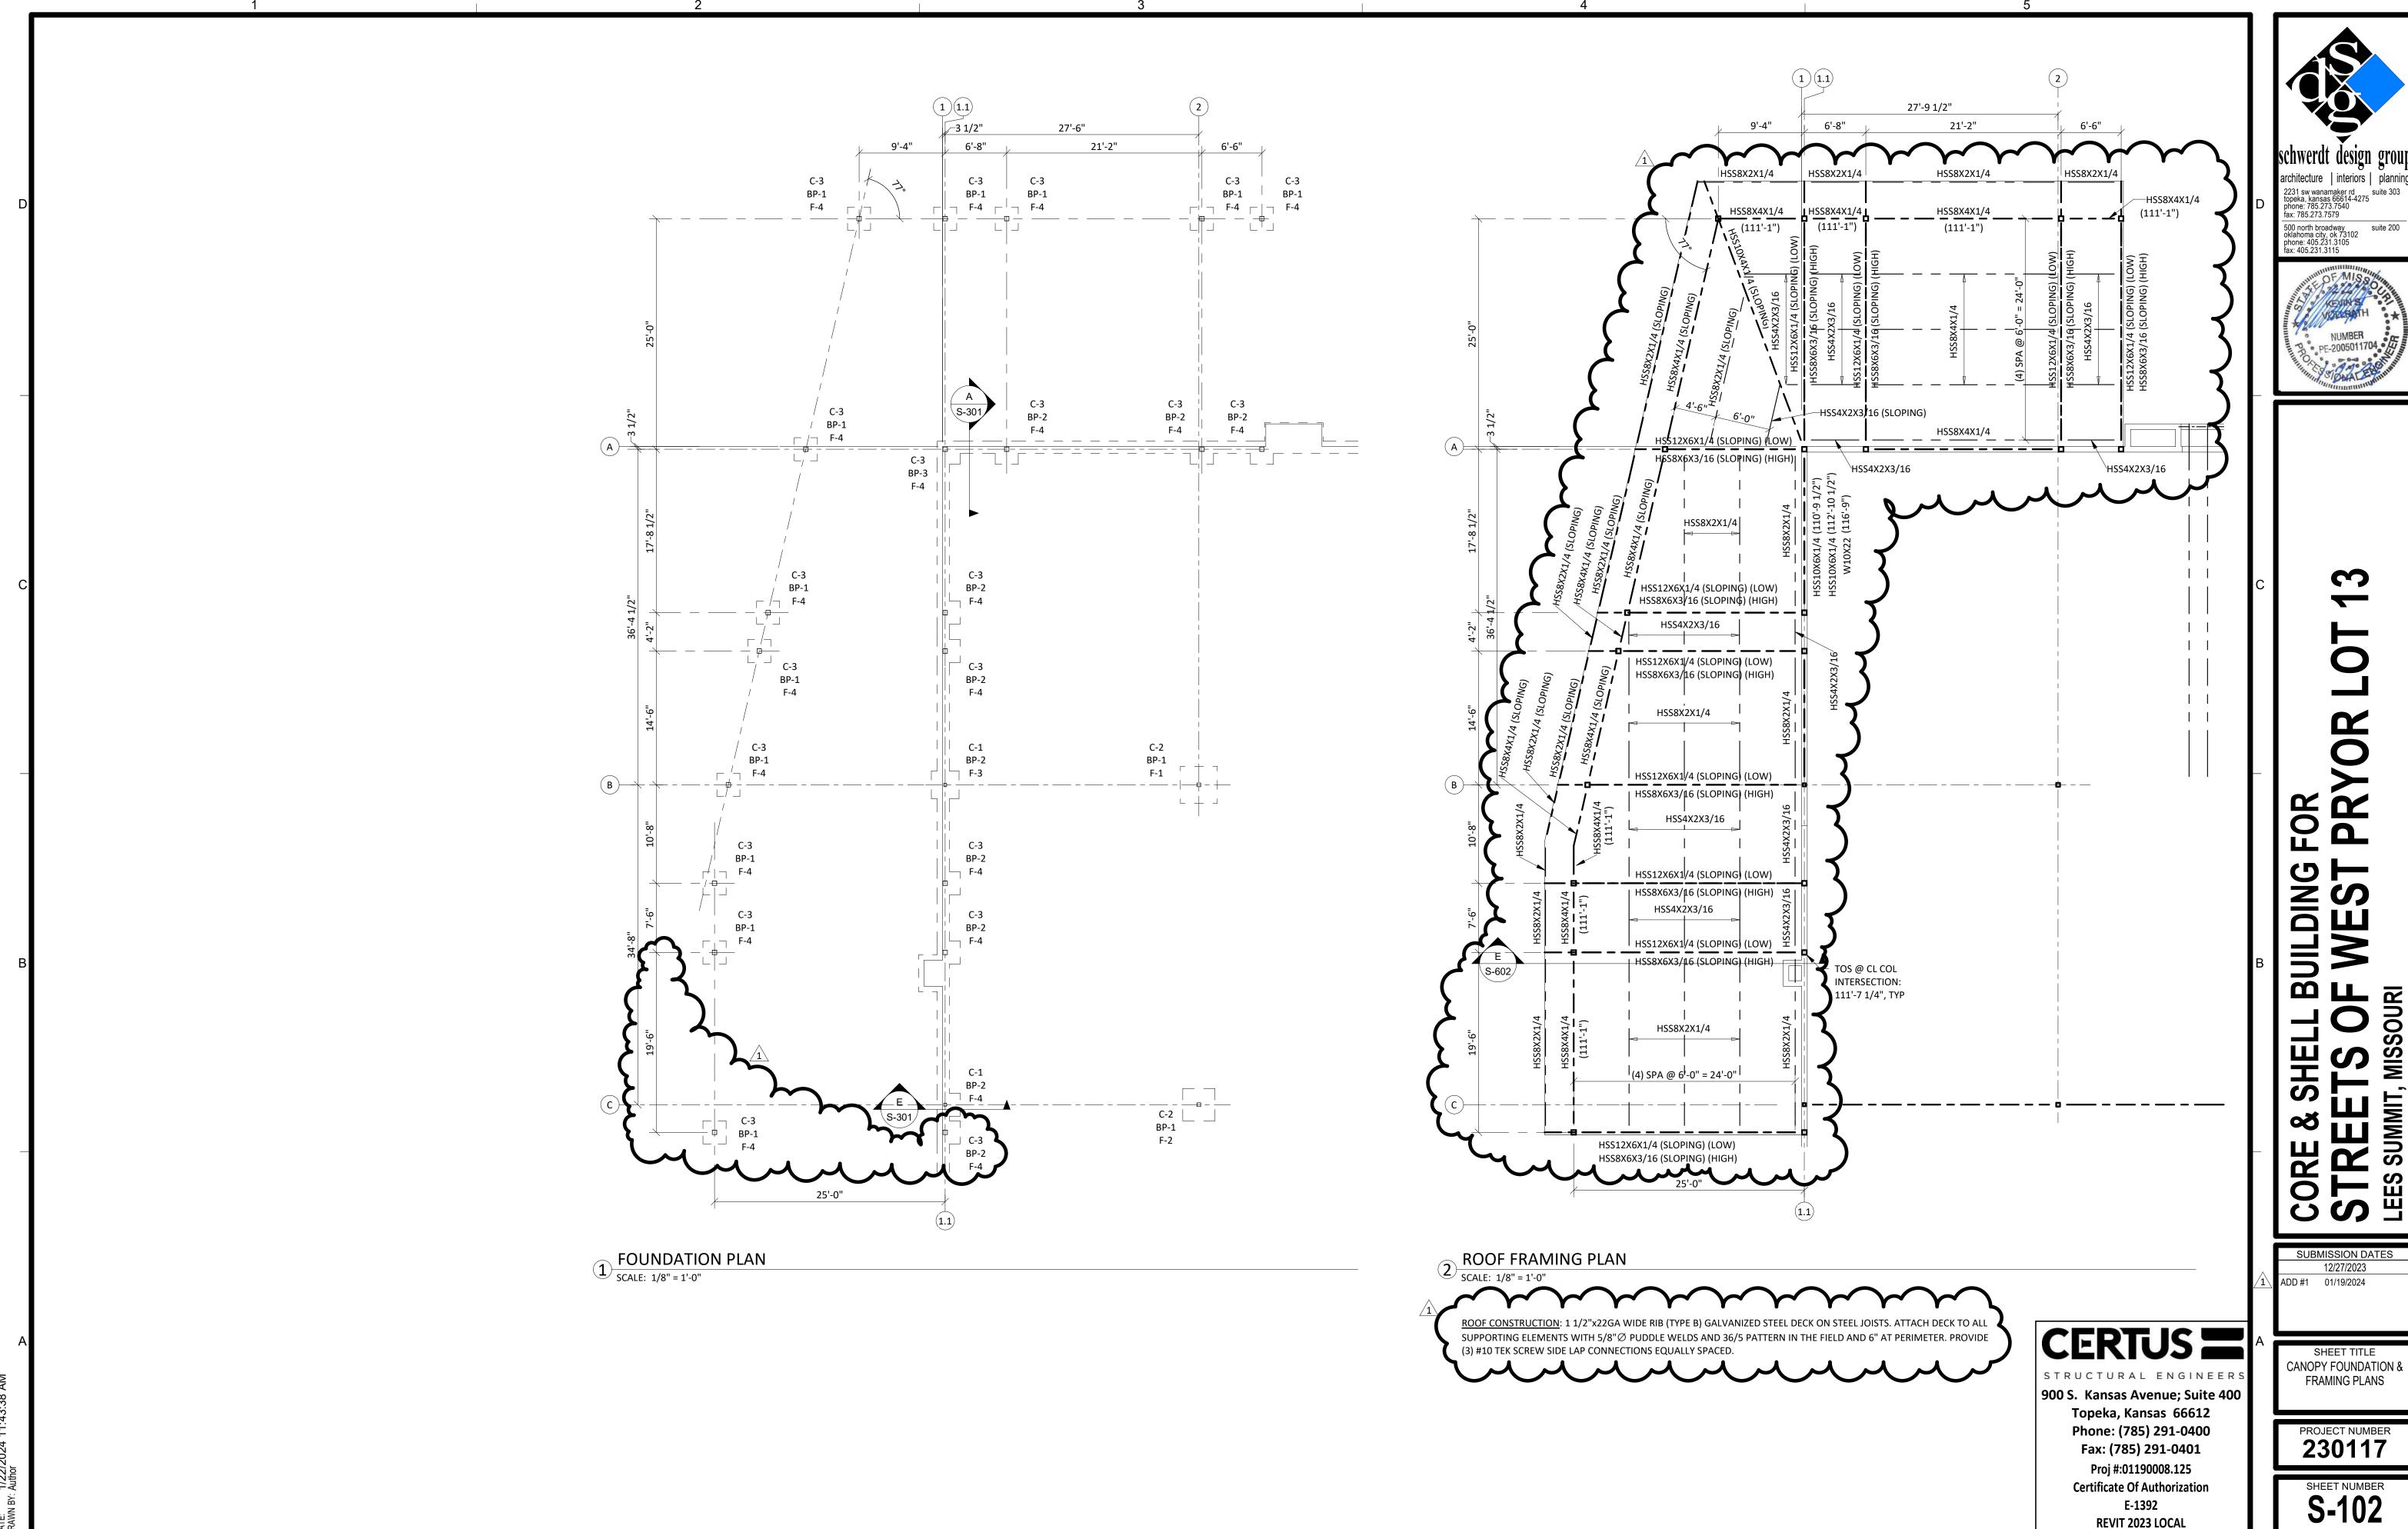

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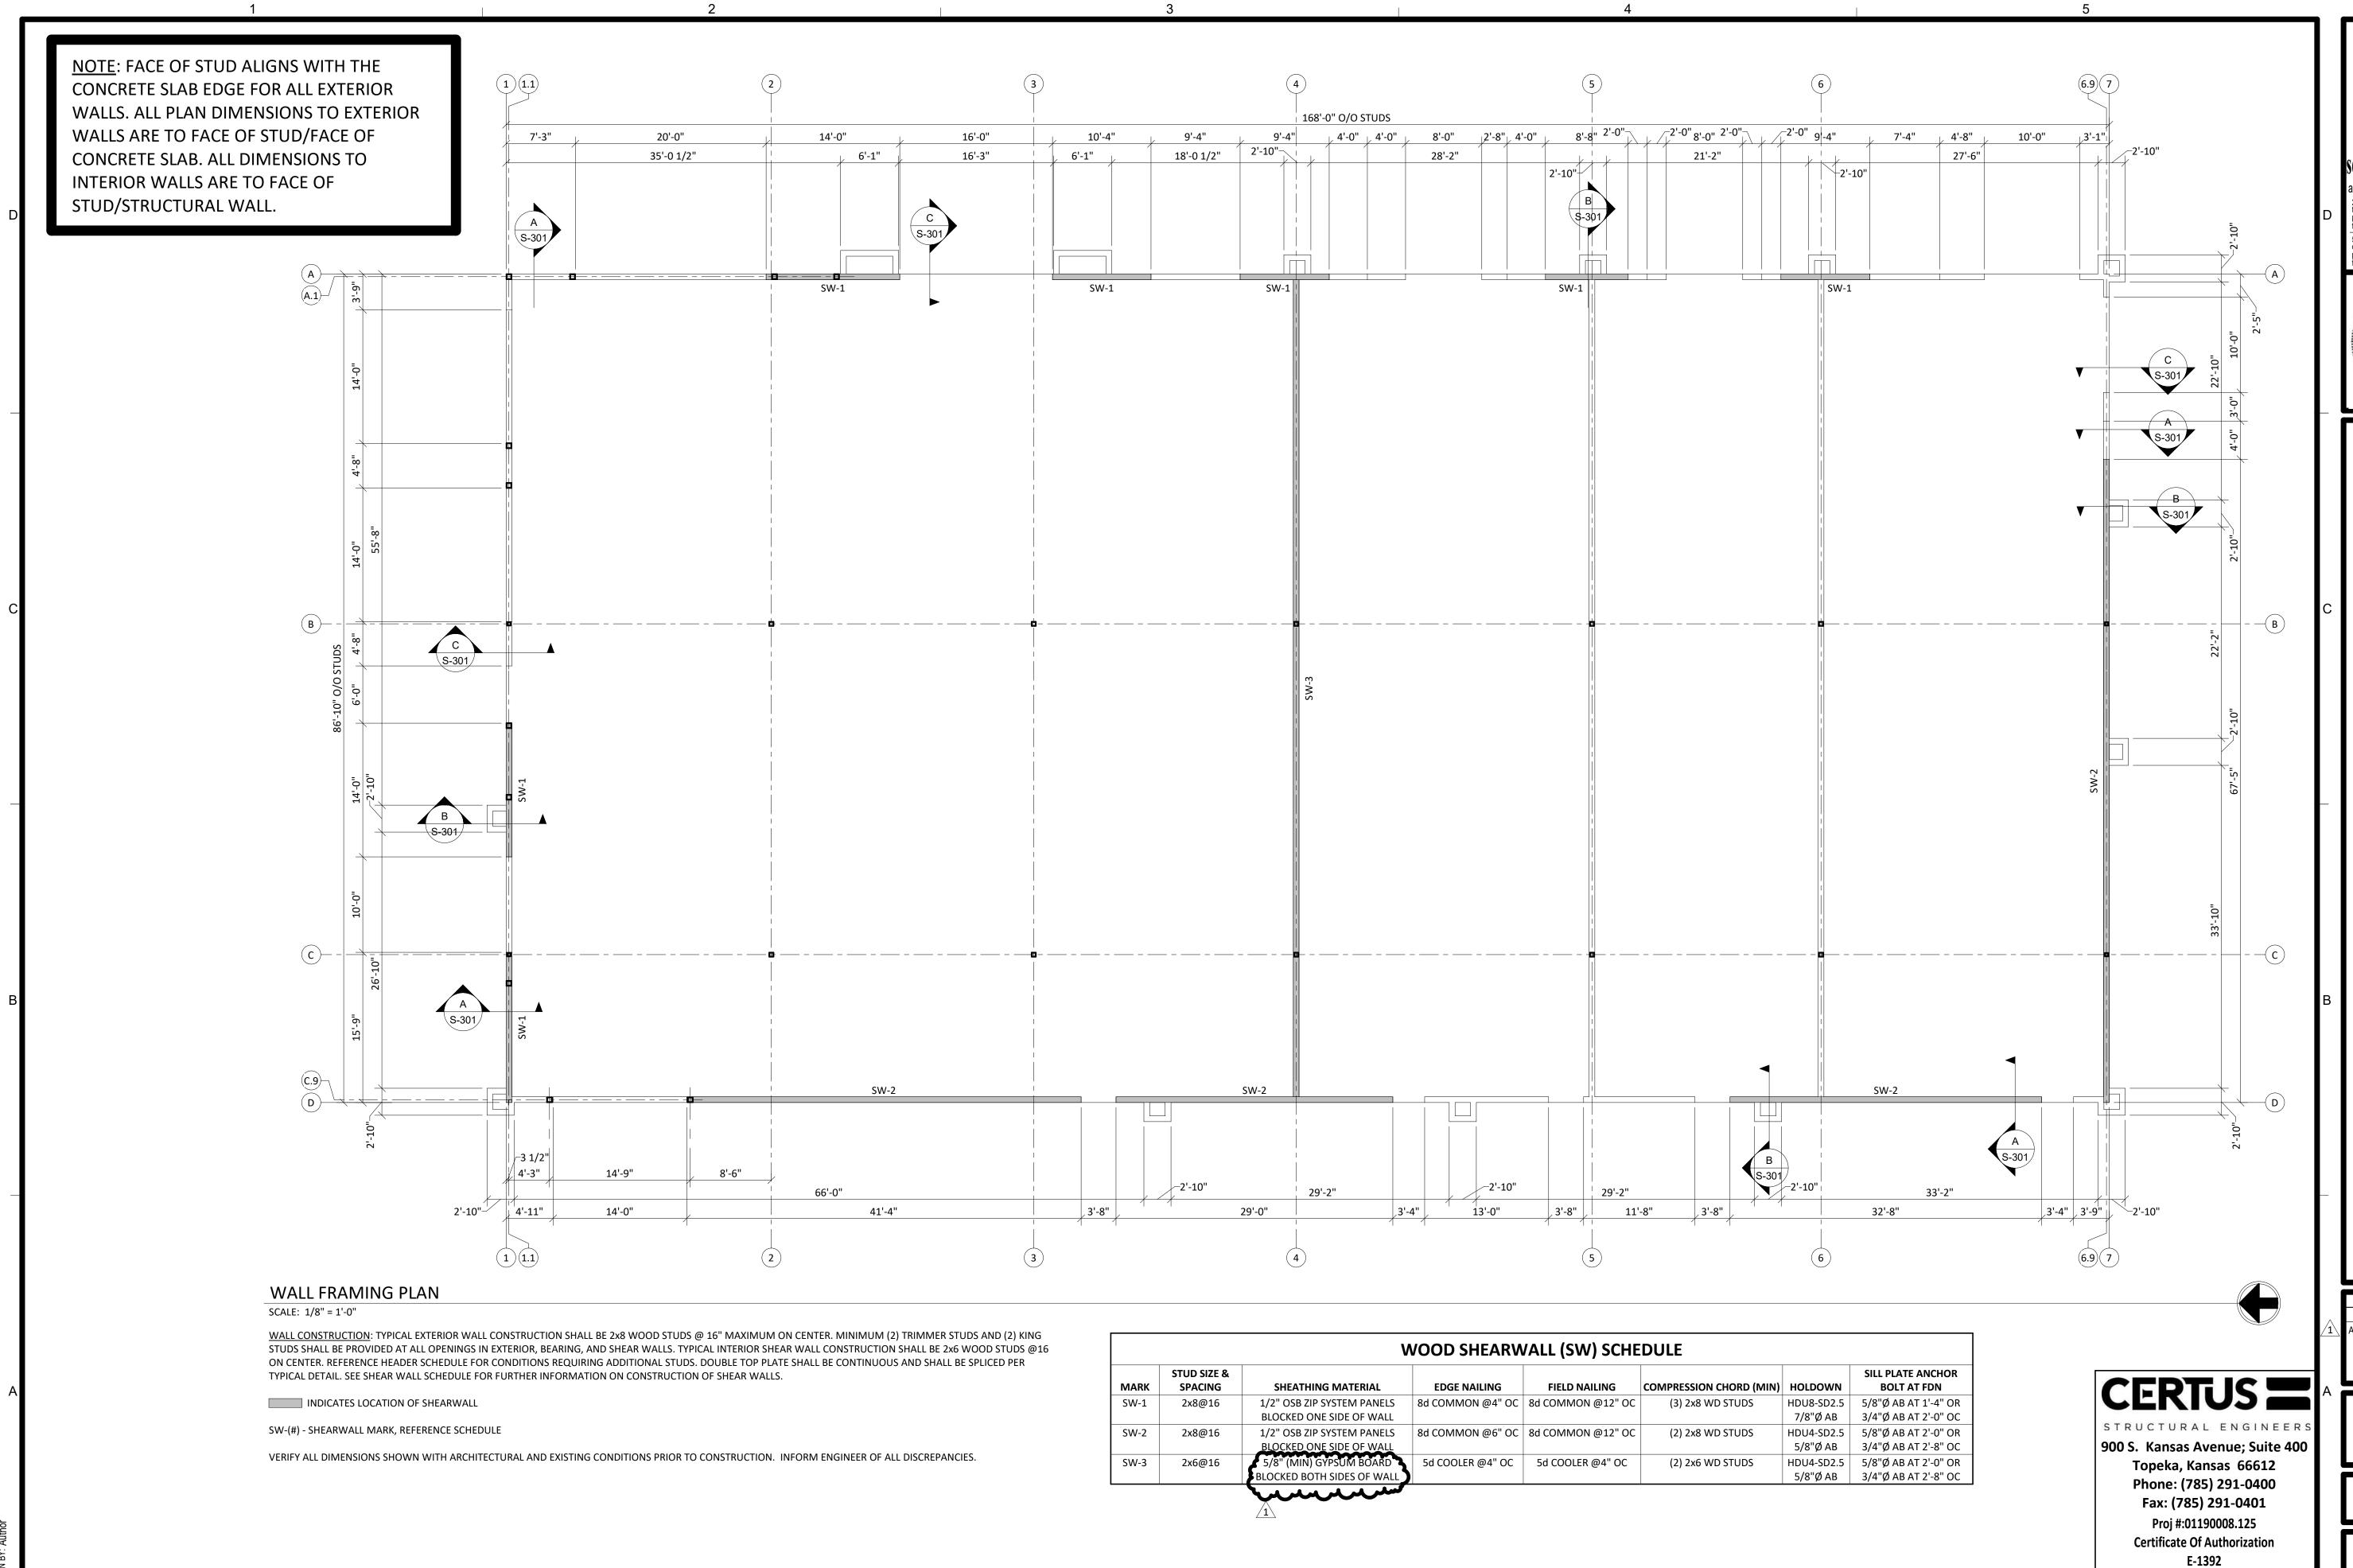


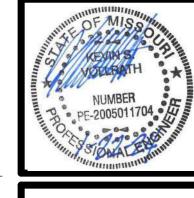

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SUBMISSION DATES 12/27/2023

CANOPY FOUNDATION & FRAMING PLANS




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3

SHELL BUILDING FOR TS: TS OF WEST PRYOR LO


SUBMISSION DATES 12/27/2023 ADD #1 01/19/2024

SHEET TITLE WALL FRAMING PLAN

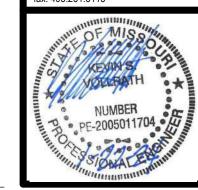PROJECT NUMBER **230117** 

S-103

**REVIT 2023 LOCAL** 

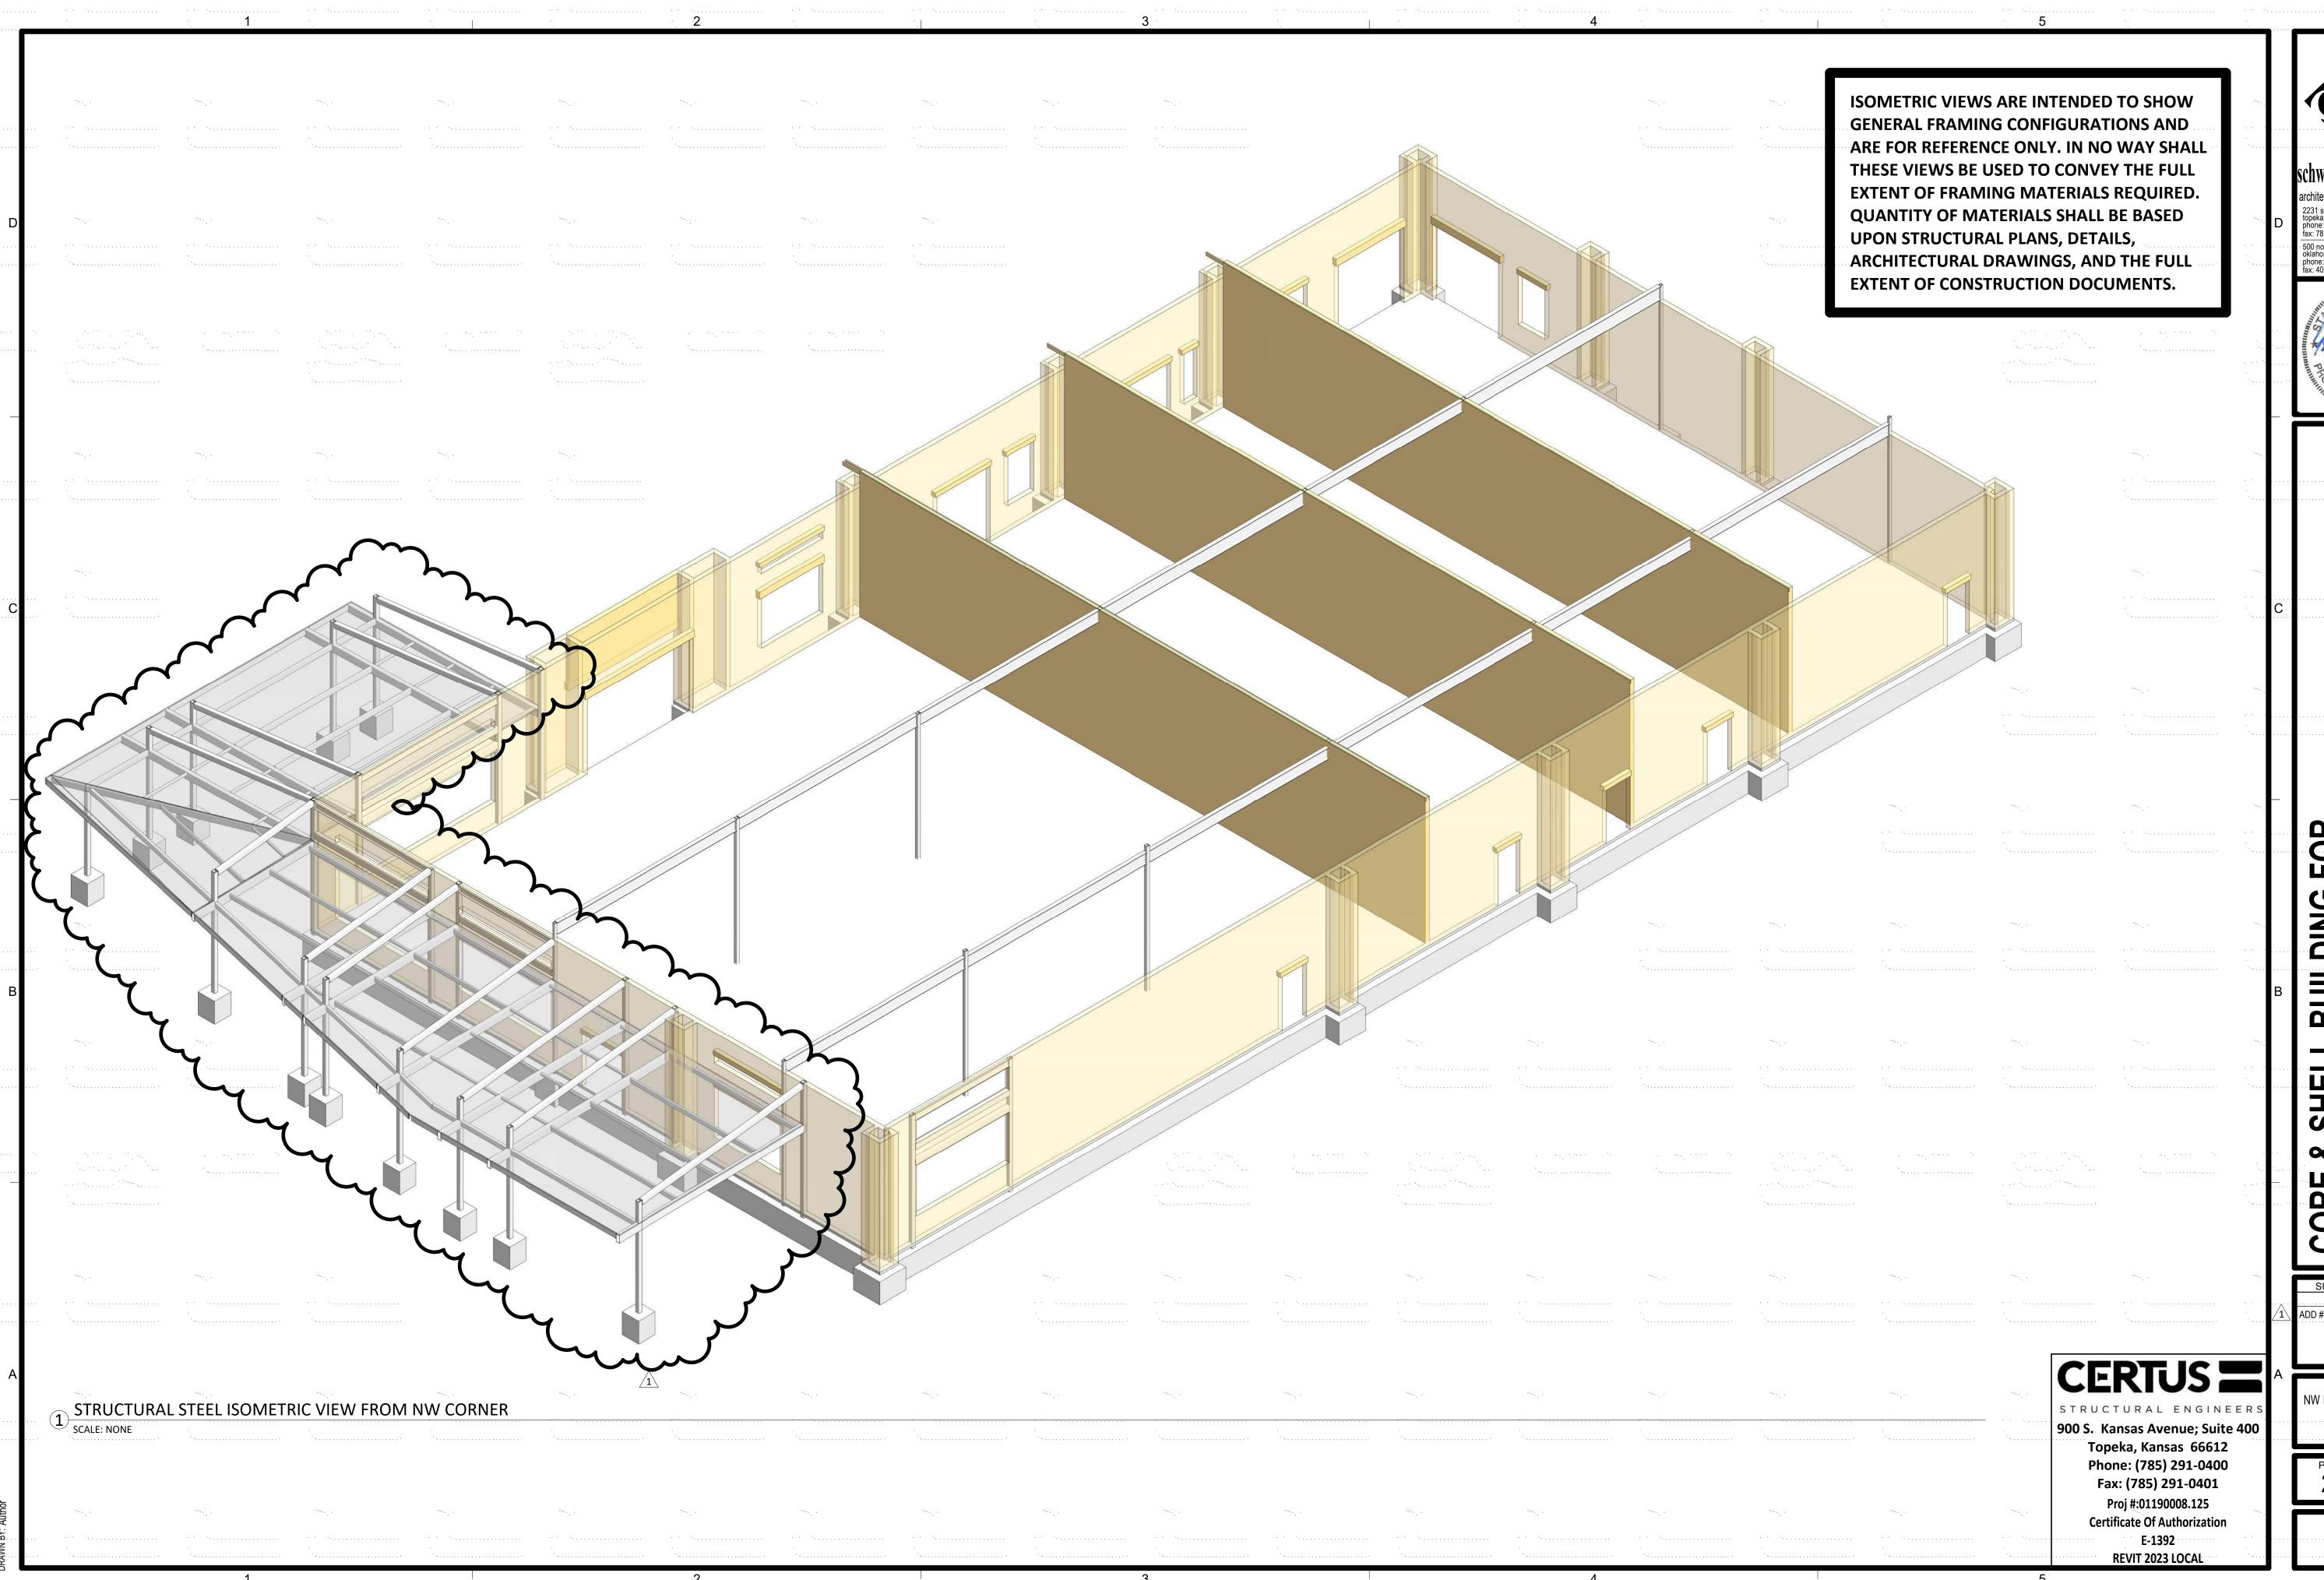







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PROJECT NUMBER **230117** 

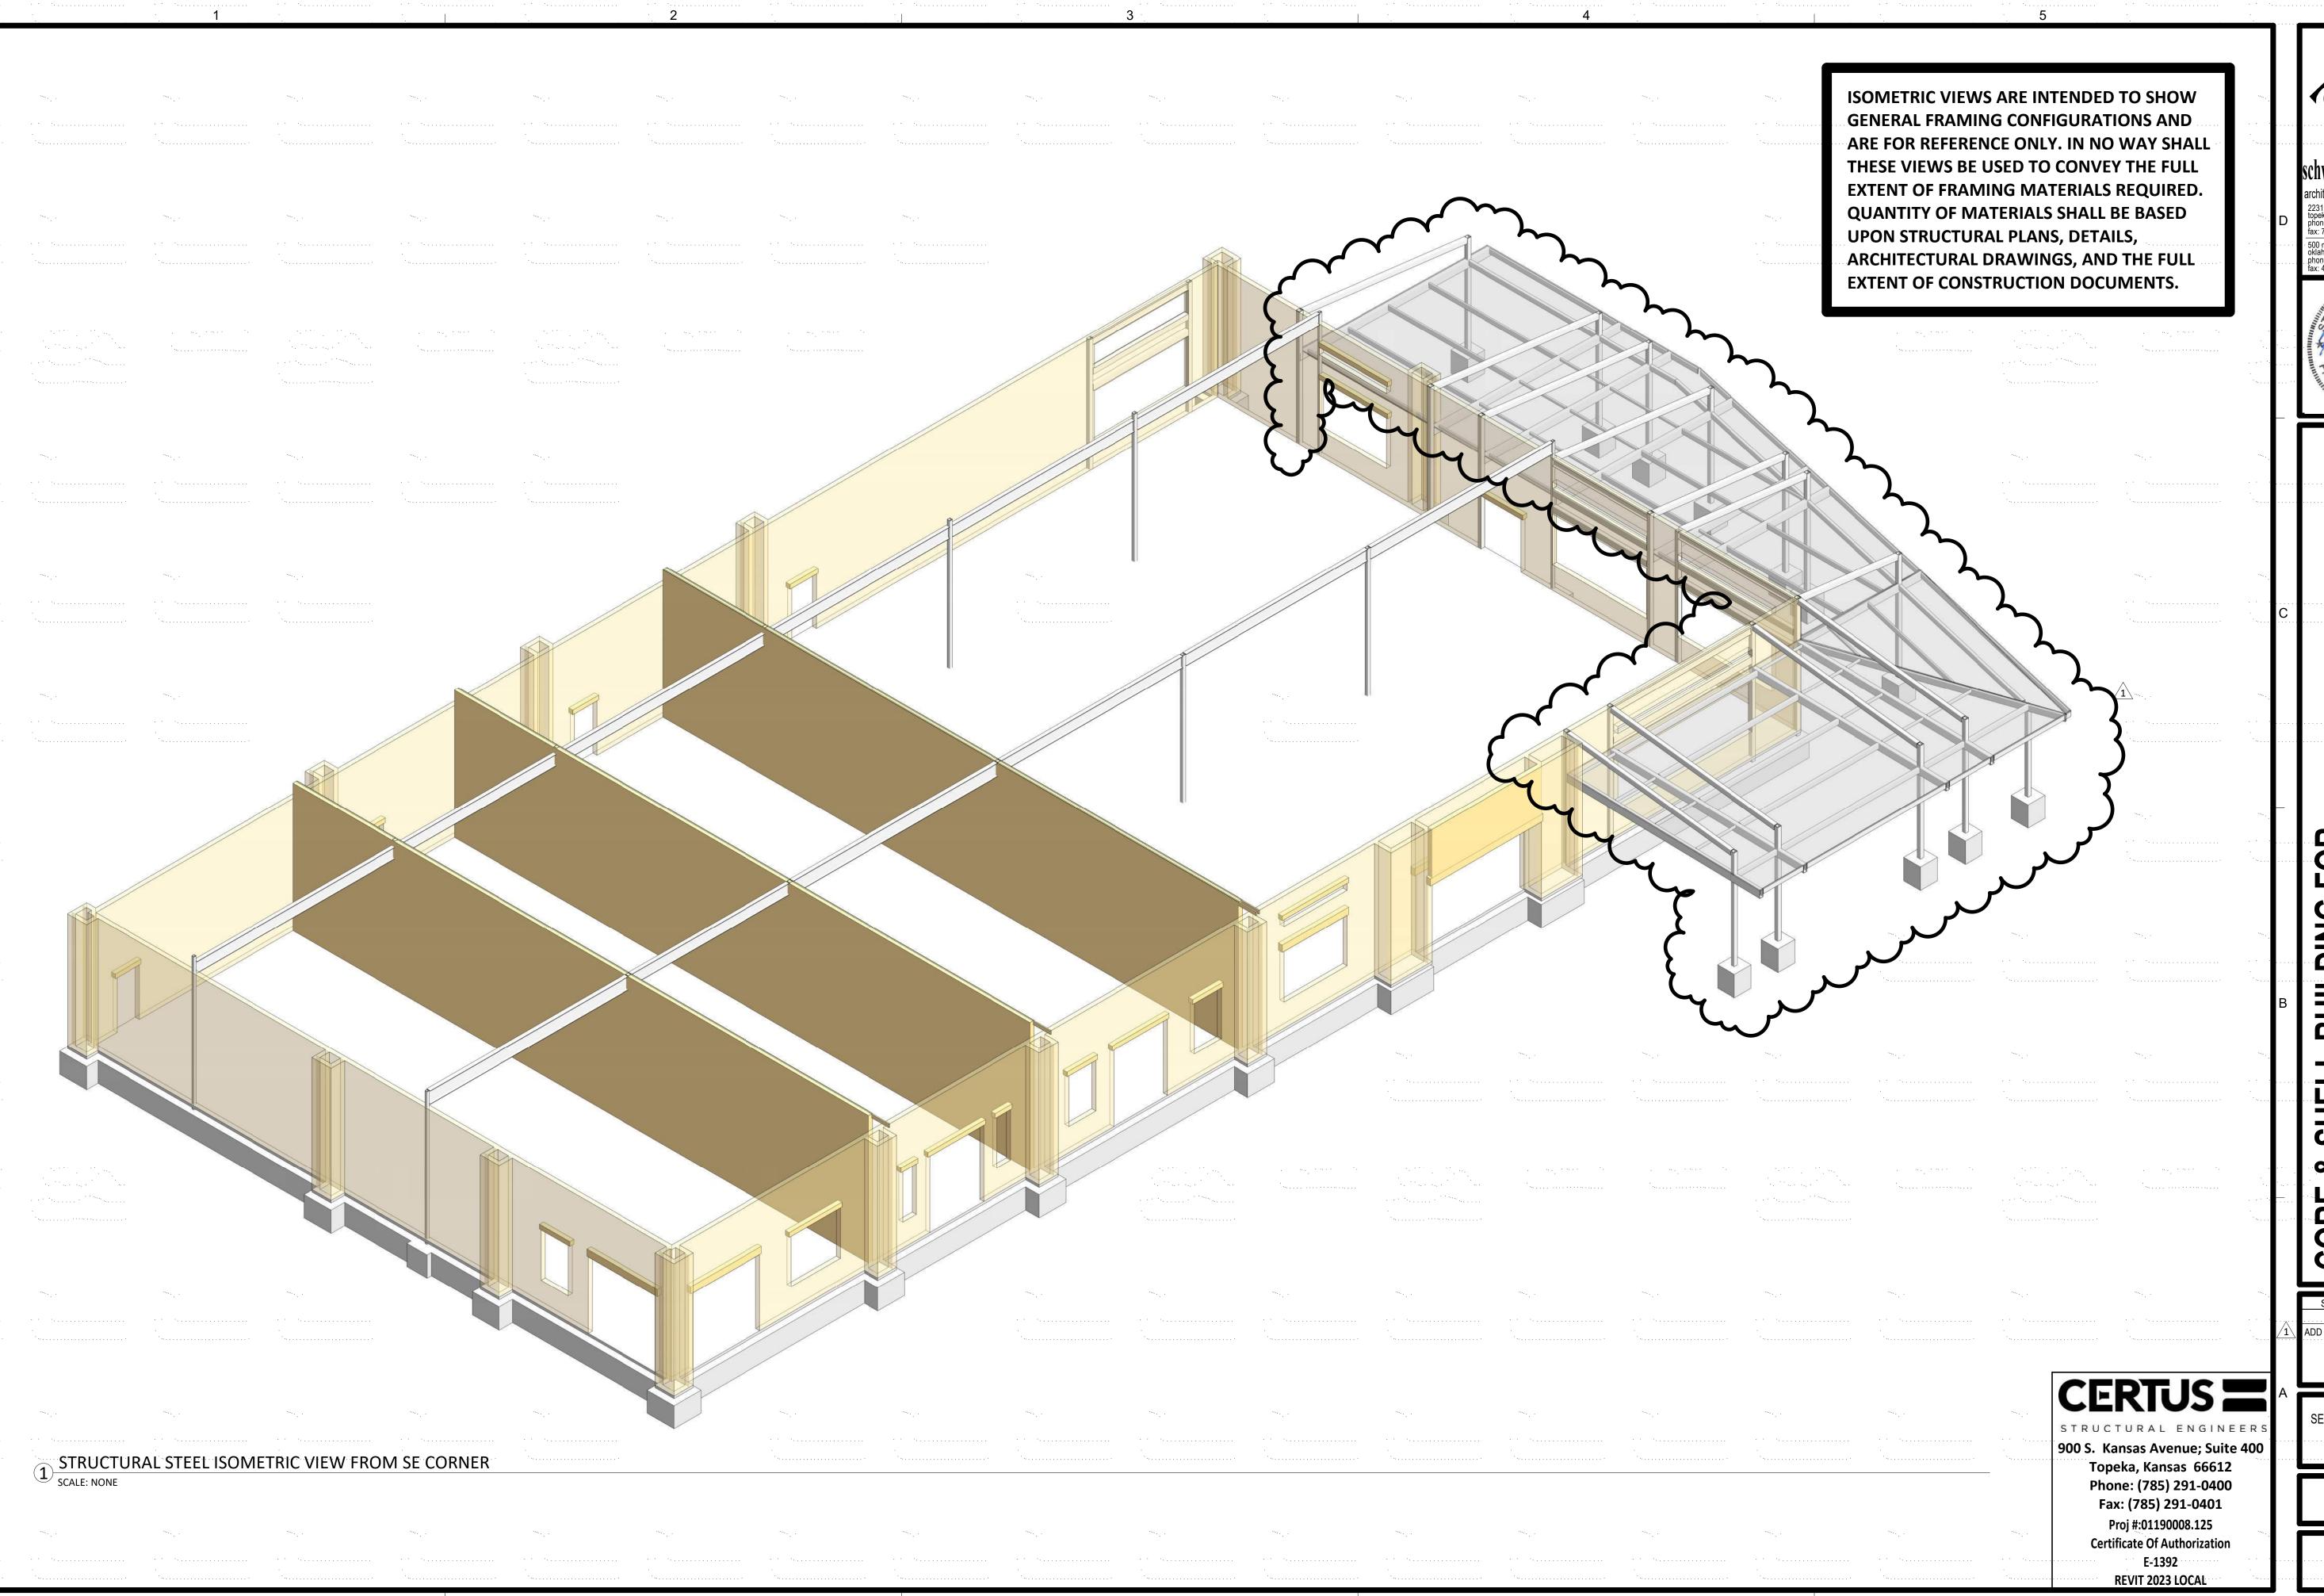

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EST PRYOR LOT 13


SUBMISSION DATES 12/27/2023

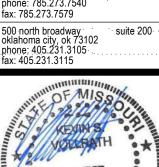SHEET TITLE SE FRAMING ISOMETRIC


ROJECT NUMBER

PROJECT NUMBER **230117** 

S-202

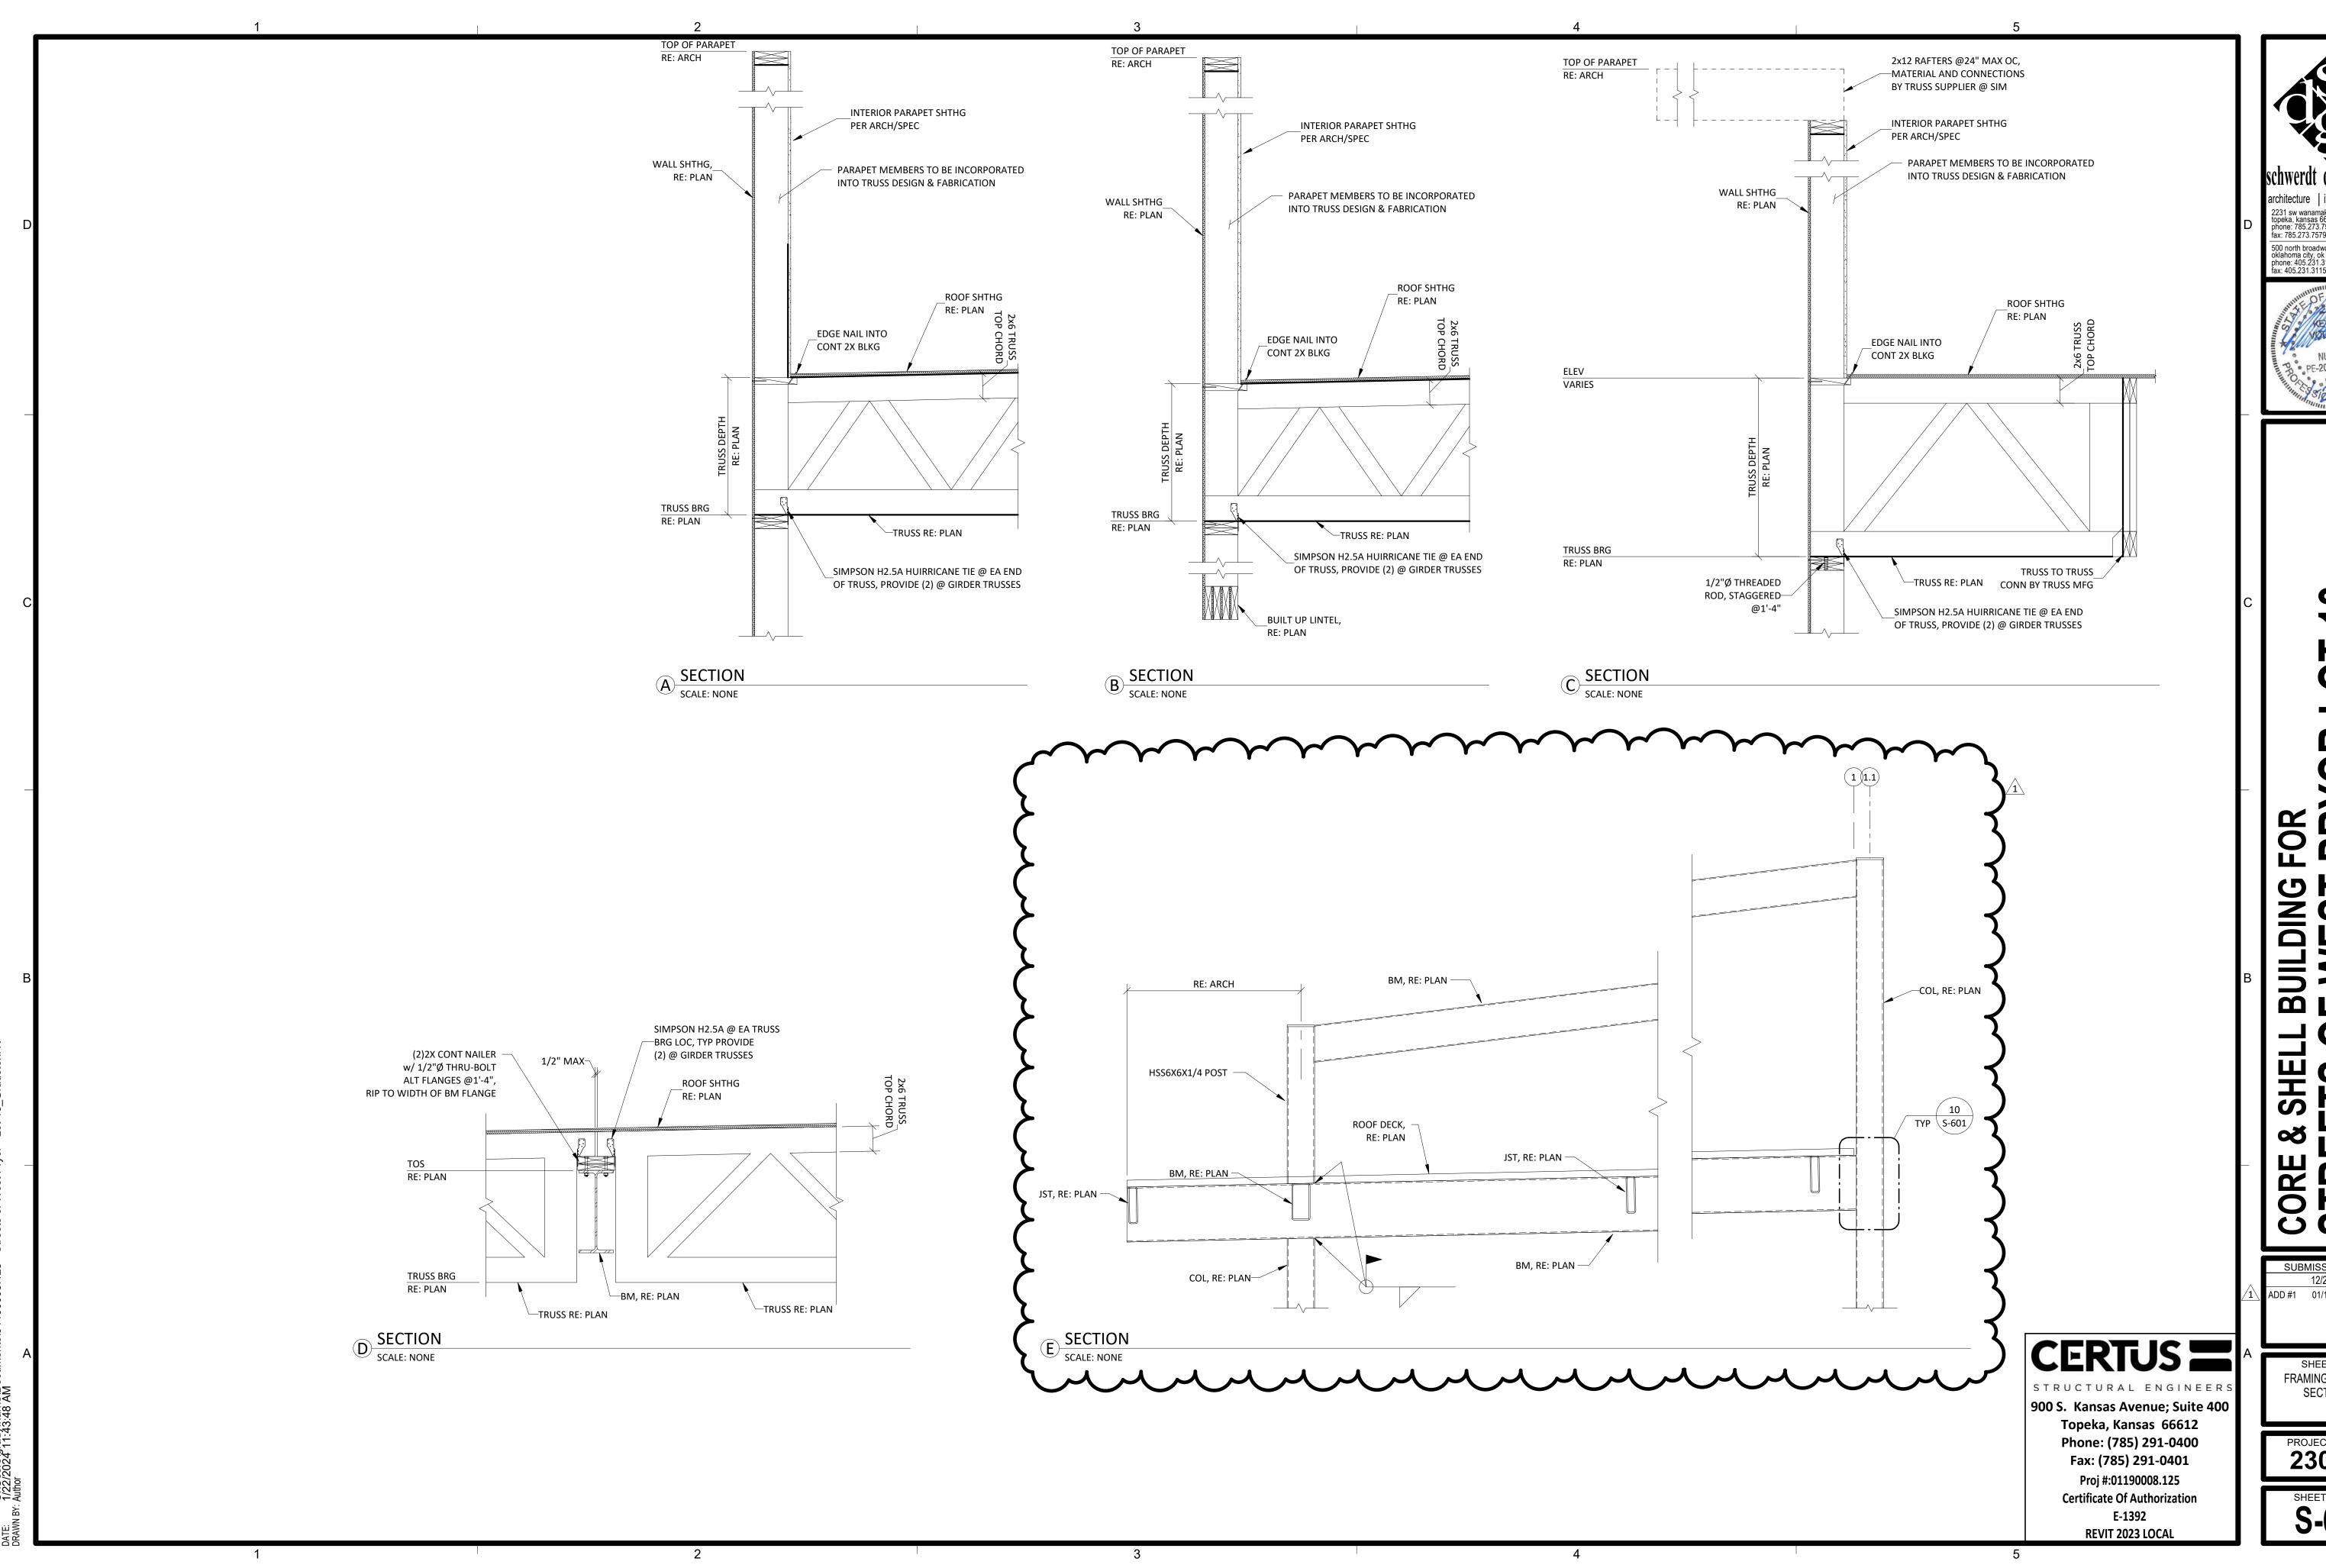

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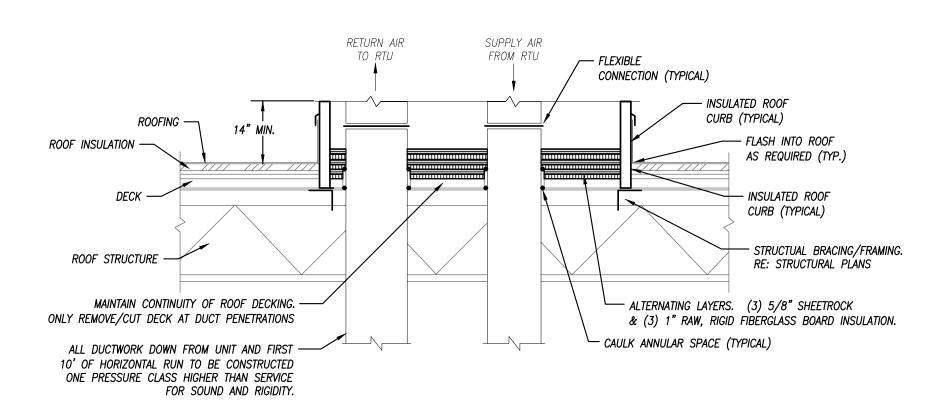


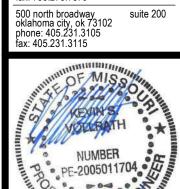FOR PRYOR

ULDIN SOURI SUMMIT,

SUBMISSION DATES 12/27/2023 ADD #1 01/19/2024

FRAMING DETAILS & SECTIONS II



### ROOFTOP UNIT CURB DETAIL NOT TO SCALE

INSULATED -

CURB CAP

24"ø HEAVY DUTY

CAST IRON FRAME -

& COVER (TYP)

44 44 4 44 44

\_ BAFFLES

**GREASE TRAP DETAIL** 

CLEANOUT CAP -

4" X 4"

SANITARY TEE

8'-6" LONG X 4'-6" WIDE - REINFORCED PRECAST 1000 GALLON GREASE INTERCEPTOR


ROOF INSULATION CANT,

STRUCTURE

CONCRETE

ADJUSTMENT -

NOT TO SCALE

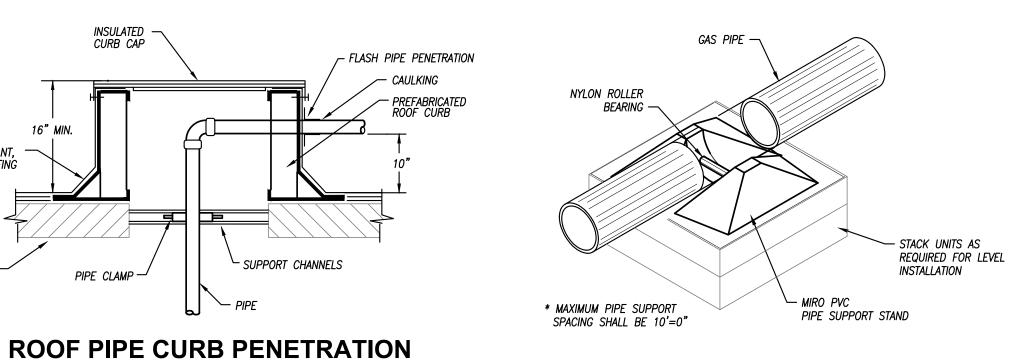

# **ROOF SUPPORT FOR GAS LINE** NOT TO SCALE

MALLEABLE BLACK

WALKING PAD

IRON GAS PIPE

GALV. METAL

PITCH PAN \

ANCHOR STRAP

#### **ROOF TOP UNIT SCHEDULE - THREE PHASE ELECTRIC WITH GAS HEAT** EXTERNAL OA PLAN MODEL MINIMUM COOLING HEATING MANUFACTURER SIZE REFRIGERANT AIRFLOW COMPRESSORS CFM ELECTRICAL WEIGHT FILTER NOTES MARK NUMBER **EFFICIENCY** CAPACITY STATIC CFM CAPACITY TRANE YSC 120 E3 10 TON R-410A 14.6 IEER DOWN OR HORIZONTAL (2) SCROLLS 119,000 BTUH 4,000 1.5" 400 150 MBH 208 V., 3 PH, 60 AMP 1300 LBS 1,2,3 RTU-2 (2) SCROLLS 119,000 BTUH 4,000 1.5" 208 V., 3 PH, 60 AMP 1,2,3 TRANE YSC 120 E3 10 TON R-410A 14.6 IEER DOWN OR HORIZONTAL 400 150 MBH 1300 LBS MERV 13 YSC 092 E3 (2) SCROLLS 94,000 BTUH 3,000 1.2" 208 V., 3 PH, 50 AMP 1100 LBS 1,2,3 7.5 TON R-410A 14.6 IEER DOWN OR HORIZONTAL 300 120 MBH MERV 13 14.6 IEER 94,000 BTUH 3,000 1.2" 208 V., 3 PH, 50 AMP RTU-4 TRANE YSC 092 E3 7.5 TON R-410A DOWN OR HORIZONTAL (2) SCROLLS 300 120 MBH 1100 LBS MERV 13 1,2,3 208 V., 3 PH, 50 AMP YSC 092 E3 7.5 TON R-410A 14.6 IEER DOWN OR HORIZONTAL (2) SCROLLS 94,000 BTUH 3,000 1.2" 1100 LBS MERV 13 60,100 BTUH 2,000 1.0" 208 V., 3 PH, 40 AMP 1,2,3 YSC 060 E3 5 TON R-410A 14 SEER DOWN OR HORIZONTAL (1) SCROLL 200 80 MBH 800 LBS MERV 13 R-410A 60,100 BTUH 2,000 1.0" 1,2,3 YSC 060 E3 (1) SCROLL 200 208 V., 3 PH, 40 AMP RTU-7 TRANE 5 TON 14 SEER DOWN OR HORIZONTAL 80 MBH 800 LBS MERV 13 208 V., 3 PH, 40 AMP TRANE YSC 060 E3 5 TON R-410A 14 SEER DOWN OR HORIZONTAL (1) SCROLL 60,100 BTUH 2,000 1.0" 200 800 LBS MERV 13 1,2,3 RTU-9 YSC 092 E3 7.5 TON R-410A DOWN OR HORIZONTAL (2) SCROLLS 94,000 BTUH 3,000 1.2" 300 120 MBH 208 V., 3 PH, 50 AMP 1100 LBS 1,2,3 TRANE 14.6 IEER 1,2,3 60,100 BTUH 2,000 1.0" RTU-10 TRANE YSC 060 E3 5 TON R-410A 14 SEER DOWN OR HORIZONTAL (1) SCROLL 200 208 V., 3 PH, 40 AMP 800 LBS MERV 13


NOTES LEGEND

- 1. PROVIDE ROOF CURB, DISCONNECT SWITCH, HAIL GUARDS, AND ECONOMIZER
- 2. PROVIDE WALL MOUNTED 7-DAY PROGRAMMABLE THERMOSTAT
- 3. PROVIDE INTERNAL VIBRATION ISOLATION FOR THE RTU FAN AND COMPRESSORS
- 4. PROVIDE ROOF CURB WITH VIBRATION ISOLATION RAILS


PIPING					FIELD TEST	ALLOWABLE IN	INSULA	TION
SYSTEM	SIZE	TYPE/SCHED	MATERIAL	ACCEPTABLE FITTINGS	PRESSURE/TIME	PLENUMS	TYPE	THICKNESS
DOMESTIC COLD WATER	1/2"-2-1/2"	L	COPPER	SOLDER, PRO-PRESS	130 PSI - 1/2HR	YES	FIBERGLASS W/ ASJ	1/2"
DOMESTIC HOT WATER & HW RETURN	1/2"-2-1/2"	L	COPPER	SOLDER, PRO-PRESS	130 PSI - 1/2HR	YES	FIBERGLASS W/ ASJ	1"
NATURAL GAS — ABOVE GRADE	2-1/2 & Up	SCH. 40	STEEL- SEEMED	WELDED	75 PSI – 1HR	YES		
NATURAL GAS — ABOVE GRADE	1/2"-2"	SCH. <b>4</b> 0	STEEL- SEEMLESS	THREADED IRON	75 PSI – 1HR	YES		
SOIL & WASTE BELOW GRADE	2"-8"	SCH. 40	PVC	SOLVENT JOINED	10 FT - 1/2HR	NO		
DOM. WATER SERVICE BELOW GRADE	4"-8"	AWWA C151	DUCTILE IRON	AWWA C111. MECH JOINTS	130 PSI - 1/2HR	YES		
DOM. WATER SERVICE BELOW GRADE	1"-3"	К	COPPER	CONTINUOUS TUBING, BRAZED	130 PSI - 1/2HR	YES		
DOM. WATER SERVICE BELOW GRADE	1"-3"	DR 9	HDPE	CONTINUOUS TUBING, FUSED	130 PSI - 1/2HR	NO		

ROOF TOP UNIT

- 1. ALL PIPING AND MATERIALS IN PLENUMS MUST MEET ASTM E84 FLAME/SMOKE RATING OF 25/50.
- 2. ALL INSULATION THICKNESSES SHALL MEET ASHRAE 90.1 2007 REQUIREMENTS AT A MINIMUM.
- 3. REFER TO SPECIFICATIONS FOR MORE DETAILED INFORMATION.

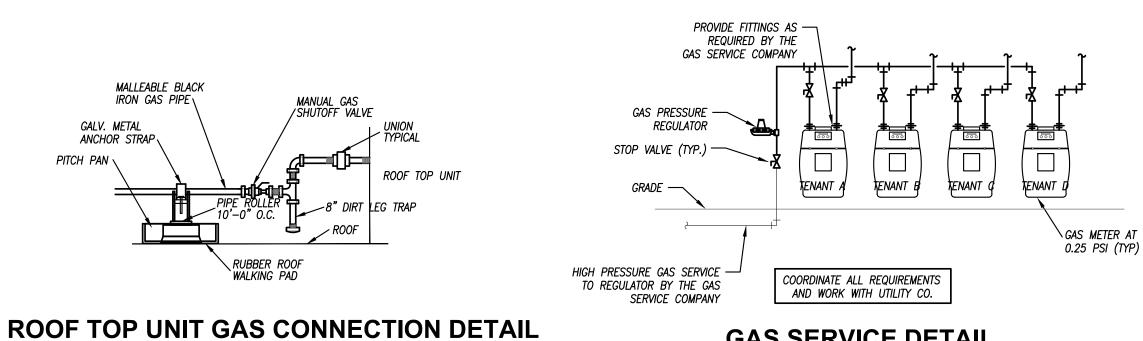


# **GAS SERVICE DETAIL**

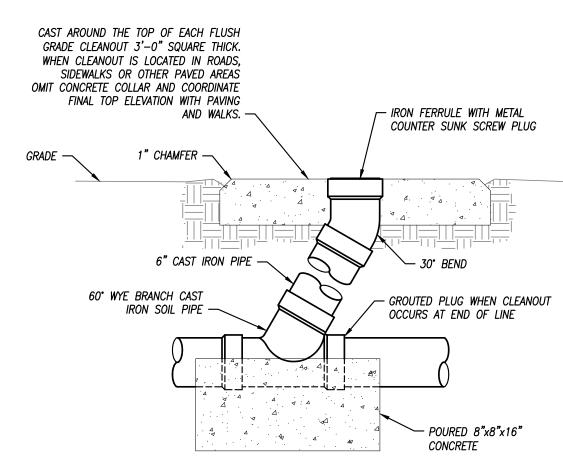

**FLUSH GRADE CLEANOUT DETAIL** NOT TO SCALE

PLAN MARK	MANUFACTURER	MODEL NUMBER	SERVICE	TOP/GRATE SIZE	WASTE SIZE	REMARKS
FD-1	WADE	1100	FLOOR DRAIN	6 <b>"</b> Ø	3"	1
FS-1	WADE	9100	FLOOR SINK	12"x12"	4"	2

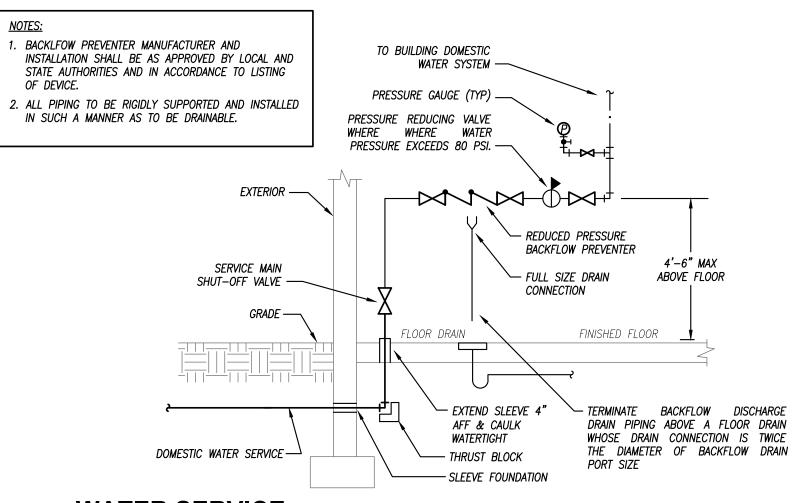

# **WATER SERVICE** REDUCED PRESSURE BACKFLOW PREVENTER DETAIL

NOT TO SCALE KCMO STANDARDS



schwerdt design group architecture interiors planning 2231 sw wanamaker rd suite 303 topeka, kansas 66614–4275 phone: 785.273.7540 ax: 785.273.7579 500 north broadway oklahoma city, ok 73102 phone: 405.231.3105

fax: 405.231.3115 BRYAN LEINWETTER NUMBER PE-2020020297

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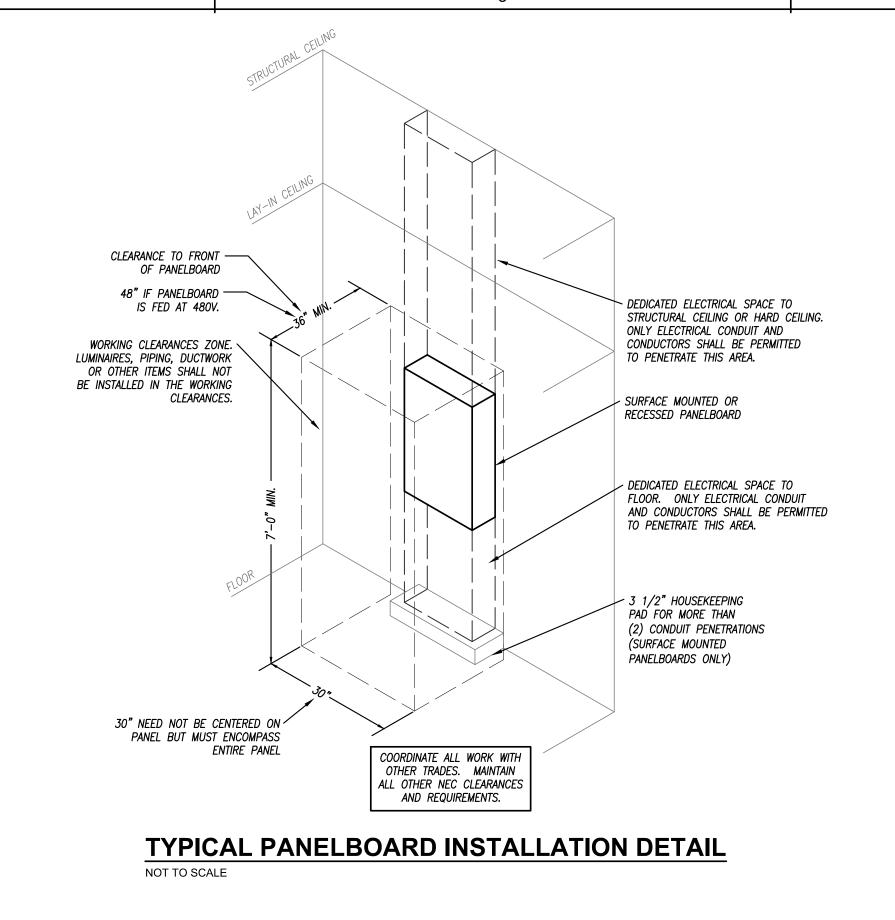
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U U SUBMISSION DATES DECEMBER 27, 2023 **A** JANUARY 19, 2024

SHEET TITLE MECHANICAL DETAILS & SCHEDULES

PROJECT NUMBER 235008

SHEET NUMBER M-301



PANELBOARD SCHEDULE MOUNTING: SURFACE PANEL DESIGNATION | MAIN BUS AMPS: 100 VOLTAGE: 120/240V MAIN BREAKER: 100 PHASE/WIRE: 3PH/4W LOCATION: EXTERIOR PANEL TYPE: NEMA 3R MINIMUM AIC: 22K CKT. BKR. CKT. CKT. CKT. BKR. CIRCUIT DESCRIPTION CIRCUIT DESCRIPTION P AMP NO. NO. AMP P IRRIGATION CONTROLLER EXTERIOR LIGHTING RECEPTACLES & LIGHTS 20 3 EGRESS LIGHTING ROOFTOP RECEPTACLES SITE LIGHTING ROOFTOP RECEPTACLES 20 9 10 20 2 SITE LIGHTING FACP EUH-1 30 | 13 | 14 | 20 | ELECTRIC UNIT HEATER (VERIFY) SPARE SPARE SPARE ELECTRIC UNIT HEATER (VERIFY) 19 20 **20** SPARE ELECTRIC UNIT HEATER (VERIFY) SPARE ELECTRIC UNIT HEATER (VERIFY) SPACE SPACE SPACE SPACE

NEMA 3R RATED PANEL WITH LOCKABLE COVER VERIFY BREAKER SIZES FOR ELECTRIC UNIT HEATERS WITH OWNER

#### **ELECTRIC UNIT HEATER SCHEDULE** MODEL MANUFACTURER NOTES ELECTRICAL MARK NUMBER (WATTS) EUH-1 **BERKO** FRA1512F 1500 WATTS 120V., 1ø, 20 AMP 208V., 1ø, 30 AMP BY OWNER 5000 WATTS 208V., 1ø, 30 AMP 5000 WATTS 208V., 1ø, 30 AMP 5000 WATTS BY OWNER 5000 WATTS 208V., 1ø, 30 AMP BY OWNER

FAN SHUTDOWN RELAY IN RTU

DUCT SMOKE

RETURN AIR ,

NOT TO SCALE

VERIFY ALL WIRING

, WITH FIRE ALARM

SYSTEM SUPPLIER

— REMOTE ANNUNCIATOR

LOCATED IN AN ACCESSIBLE

AND TEST SWITCH


LOCATION


TO FIRE ALARM

CONTROL PANEL

1. PROVIDE SURFACE WALL MOUNTED HEATER WITH ADJUSTABLE THERMOSTAT AND DISCONNECT 2. FURNISHED BY OWNER, INSTALLED BY CONTRACTOR. VERIFY ALL ELECTRICAL REQUIREMENTS WITH OWNER.

**DUCT SMOKE DETECTOR DIAGRAM** 

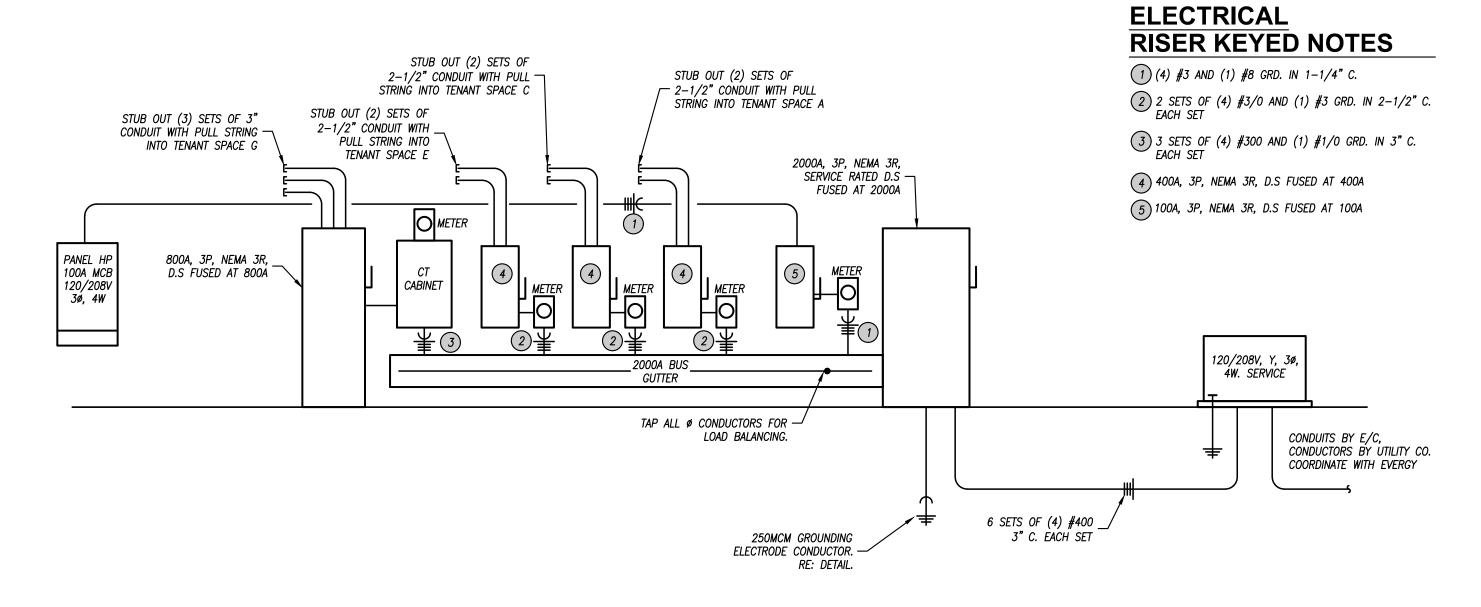

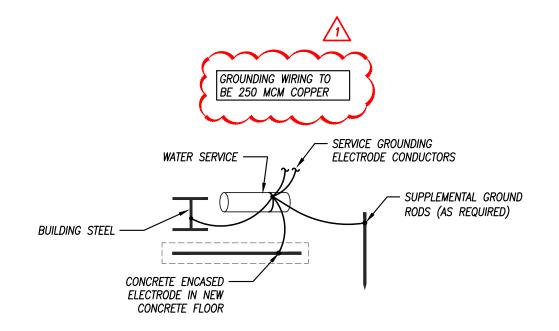

## **GROUNDING ELECTRODE SYSTEM** N.T.S

**ELECTRICAL RISER DIAGRAM** NO SCALE

> 2949 SW WANAMAKER DR., TOPEKA, KANSAS 66614 785.273.2447 WWW.PKMRENG.COM

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500 north broadway suite 200 oklahoma city, ok 73102 phone: 405.231.3105 fax: 405.231.3115 BRYAN LEINWETTER NUMBER PE-2020020297


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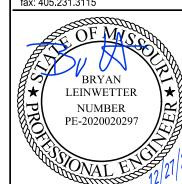
ELECTRICAL DETAILS & SCHEDULES

PROJECT NUMBER 235008

> SHEET NUMBER E-102



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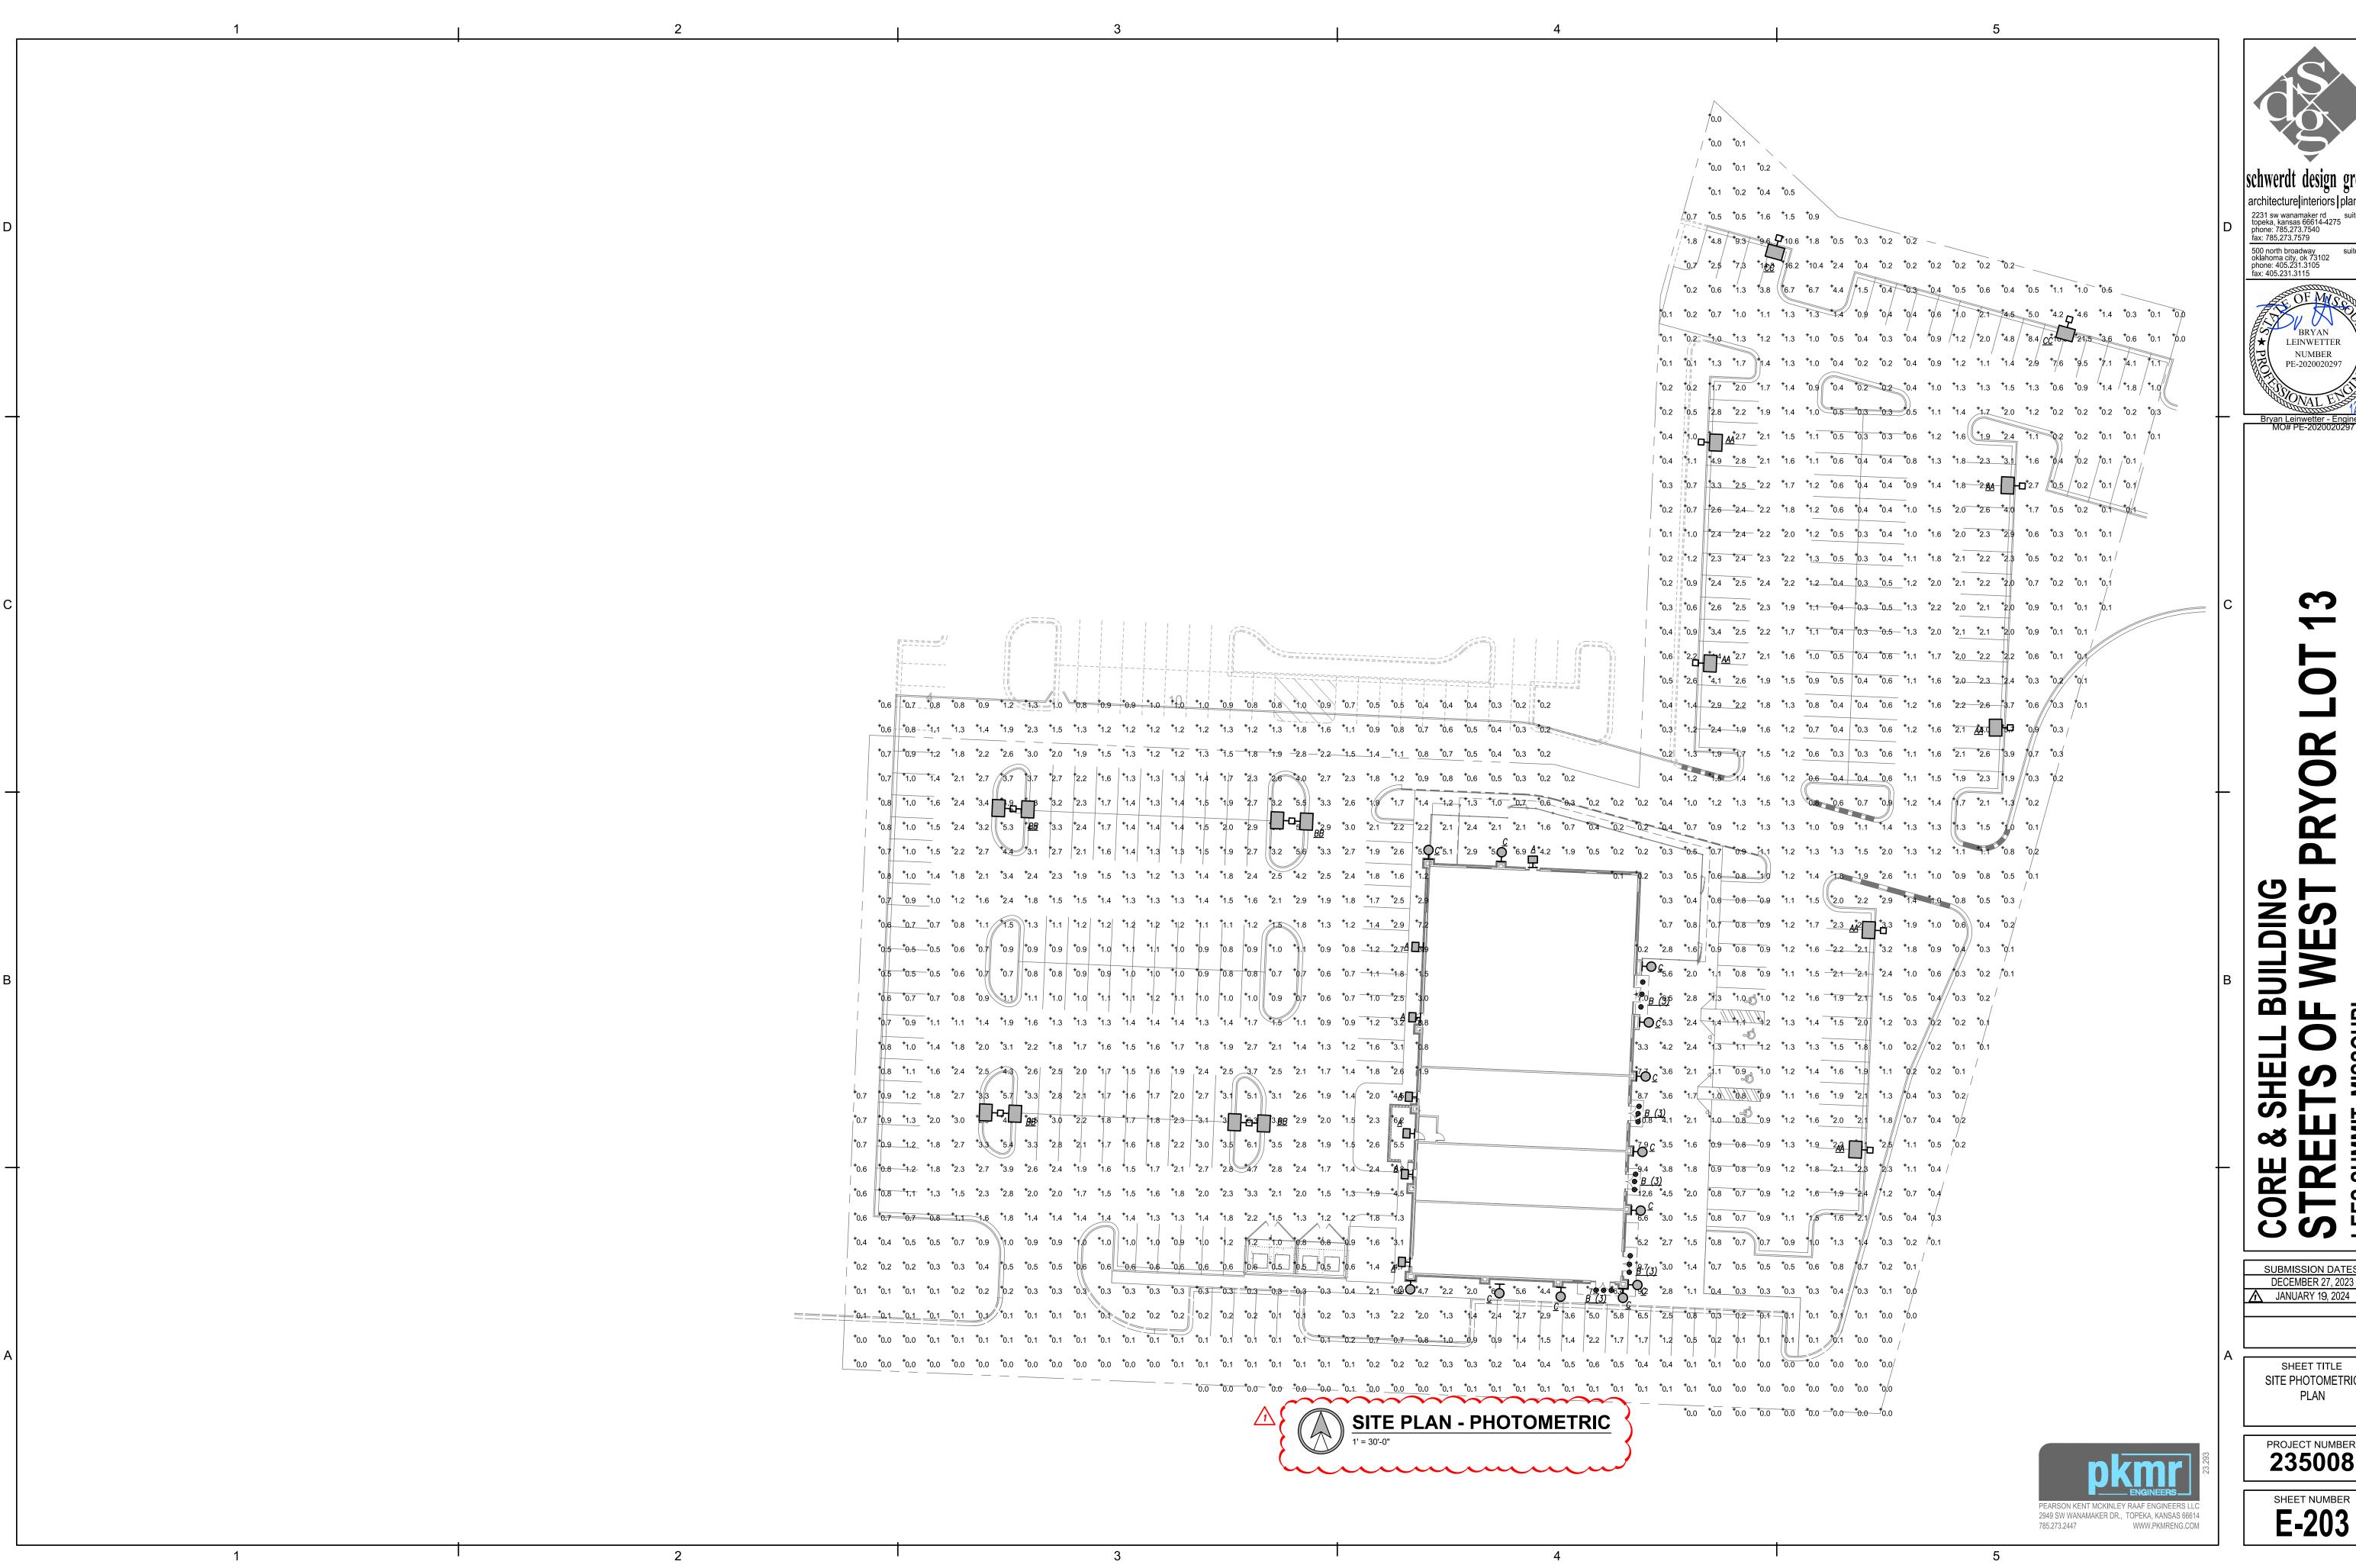
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CORE & S STREE LEES SUMMIT, SUBMISSION DATES DECEMBER 27, 2023 **1** JANUARY 19, 2024
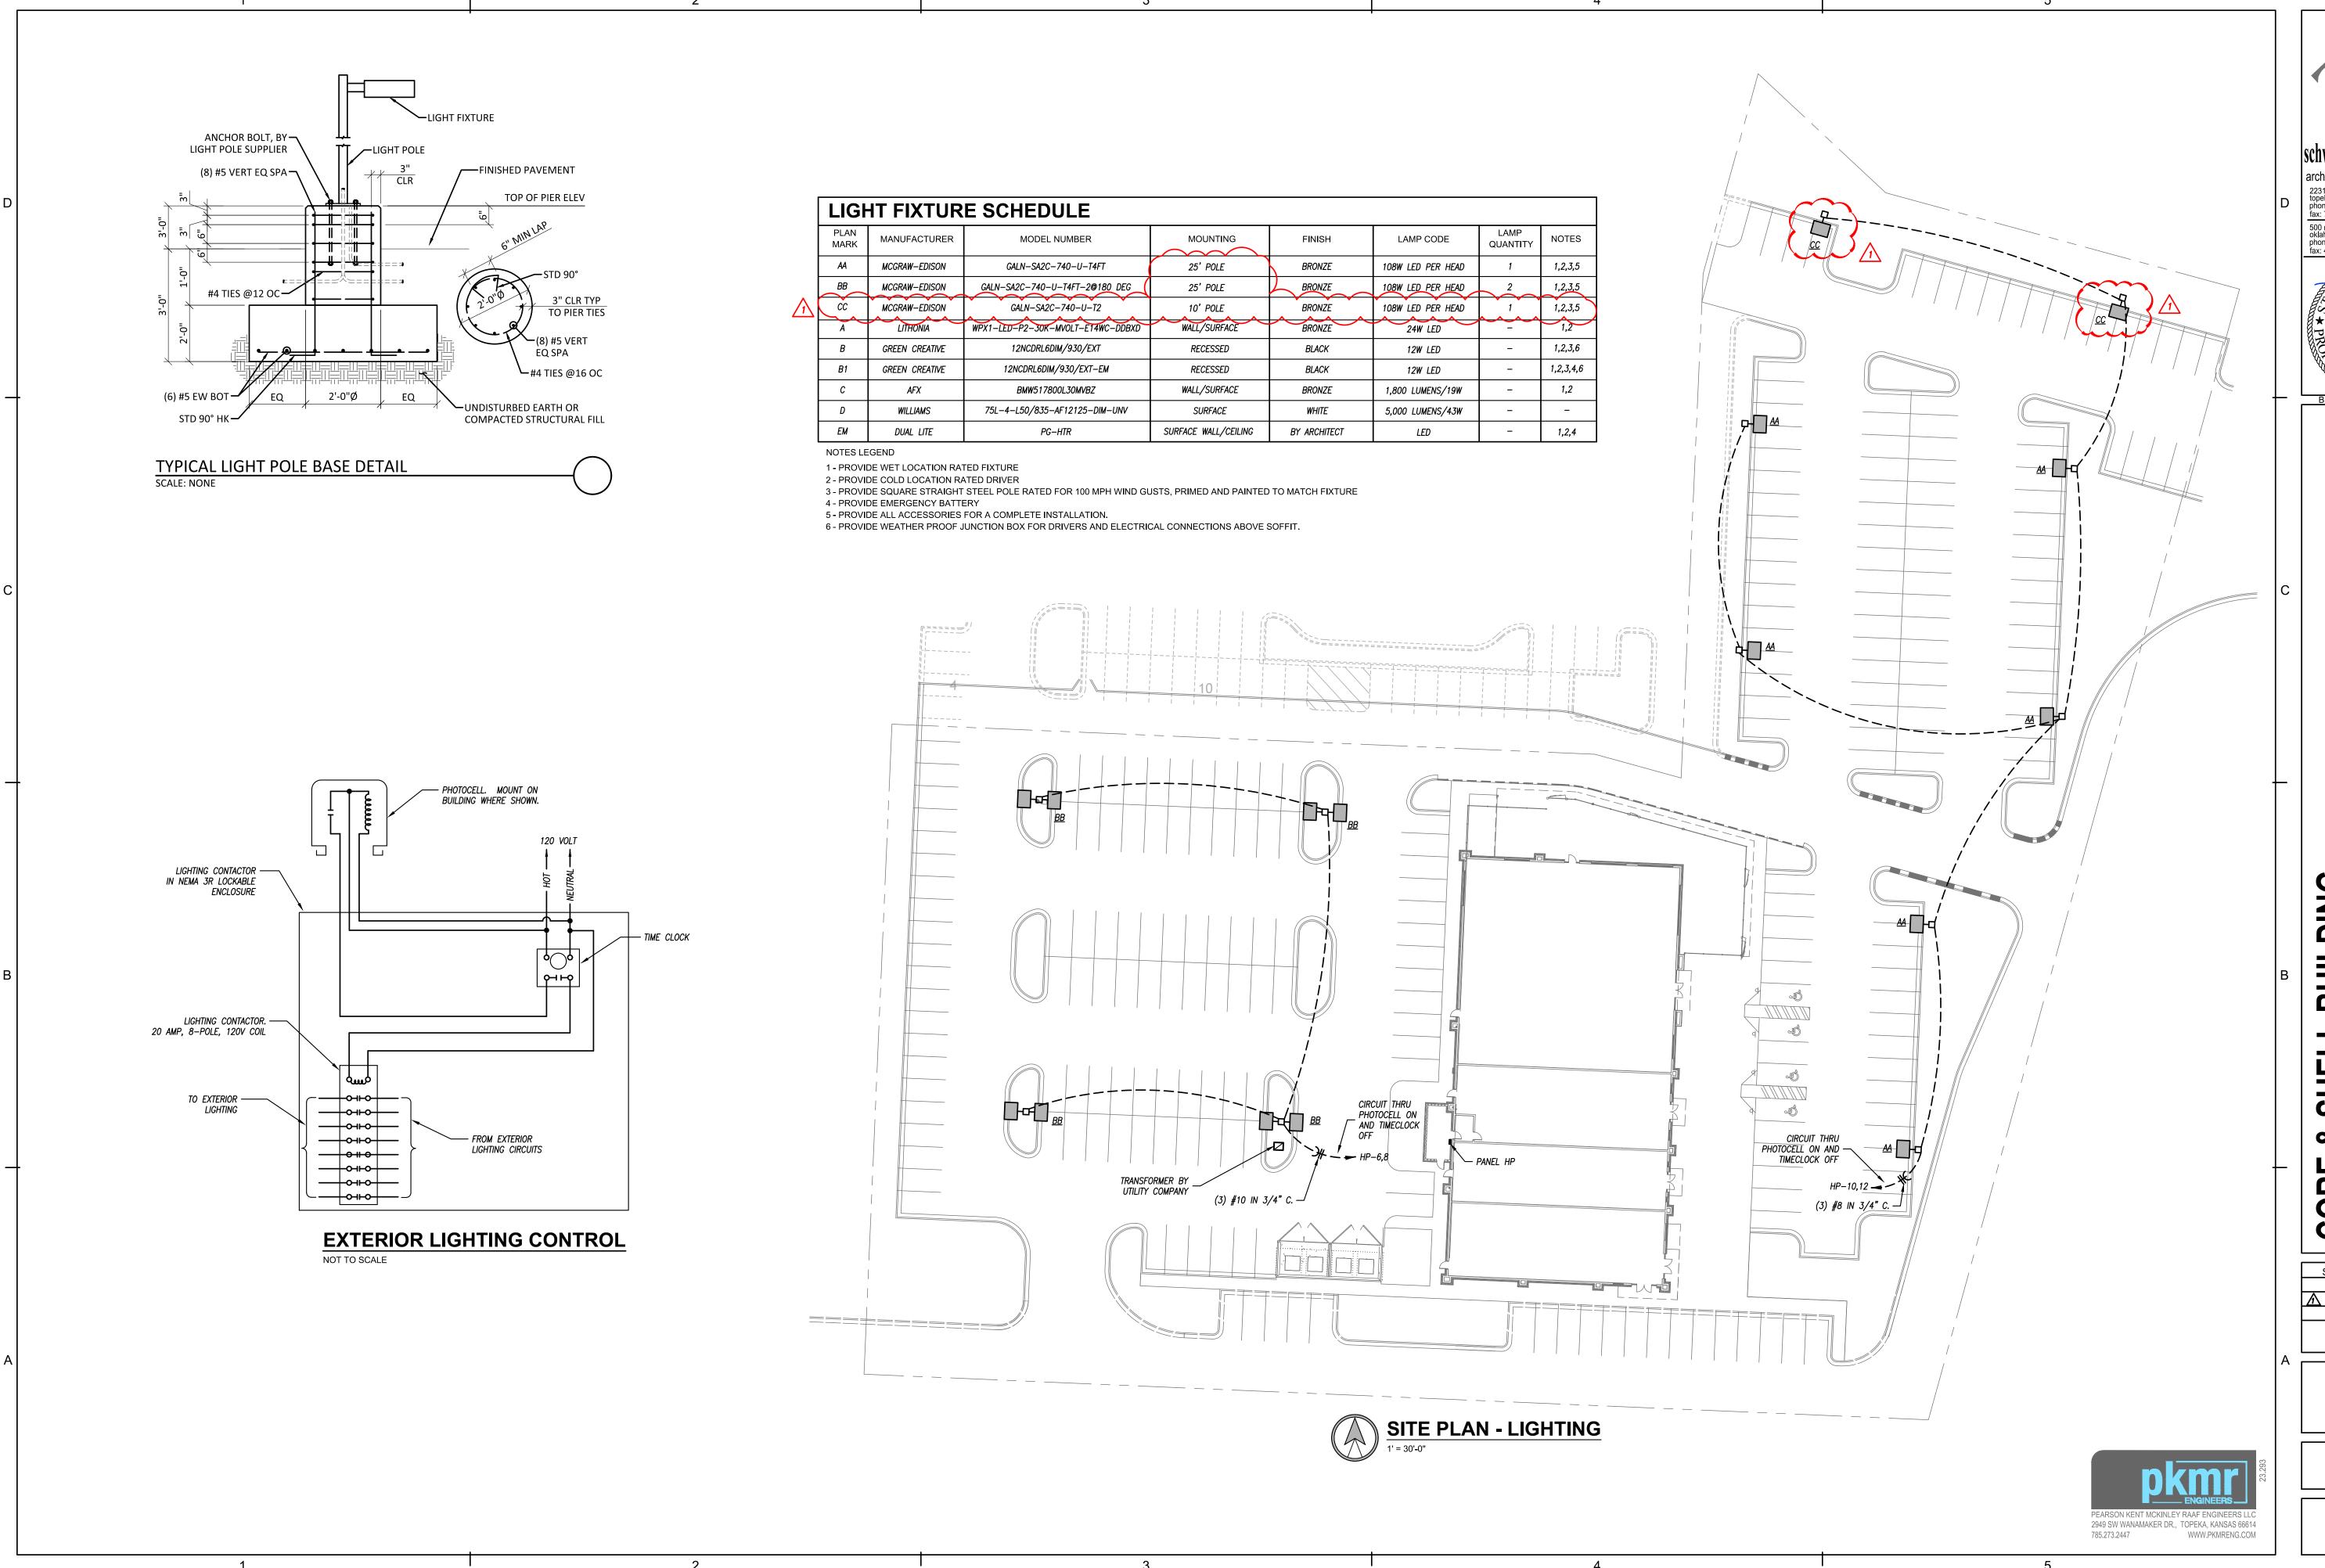
> SITE LIGHTING PLAN

PROJECT NUMBER 235008

> SHEET NUMBER E-202



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500 north broadway oklahoma city, ok 73102 phone: 405.231.3105 fax: 405.231.3115 LEINWETTER NUMBER PE-2020020297

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> SHEET TITLE SITE PHOTOMETRIC PLAN

PROJECT NUMBER 235008

SHEET NUMBER E-203