LIGHT - EXISTING **EXISTING MANHOLE** CLEANOUT EXISTING SANITARY MANHOLE PROPOSED SANITARY MANHOLE **EXISTING AREA INLET EXISTING CURB INLET** EXISTING GRATE INLET **EXISTING JUNCTION BOX EXISTING STORM MANHOLE**

S.E. Bailey Road **PROJECT** LOCATION NW1/4 SW1/4

SECTION 16-47-31

LOCATION MAP SCALE 1" = 2000' **BASIS OF BEARINGS** MISSOURI COORDINATE **SYSTEM 1983**, **WEST ZONE**

UTILITY CONTACTS:

MISSOURI DEPARTMENT OF TRANSPORTATION (MODOT) Steve Holloway 600 NE Colbern Road Lee's Summit, MO 64086 (816) 607-2186

MISSOURI GAS ENERGY (MGE) Brent Jones 3025 SE Clover Drive Lee's Summit, MO 64082 (816) 399-9633

brent.jones@spireenergy.com **EVERGY**

Ron Dejarnette 1300 SE Hamblin Road Lee's Summit, MO 64081 Office: (816) 347-4316 Cell: (816) 810-5234 ron.dejarnette@evergy.com

CITY OF LEES SUMMIT PUBLIC WORKS Dena Mezger 220 SE Green Street

Lee's Summit, MO 64063 (816) 969-1800

500 E. 8th Street, Room 370 Kansas City, MO 64106 (816) 275-2341 or (816) 275-1550

Mark Manion or Marty Loper

John Meadows 4700 Little Blue Parkway Independence, MO 64057 (816) 795-2257

(816) 969-1900

CITY OF LEE'S SUMMIT WATER UTILITIES Mark Schaufler 1200 SE Hamblen Road Lee's Summit, MO 64081

SUMMARY OF QUANTITIES QUANTITY UNITS 2 8" PVC SDR-26 989 LF 3 6" PVC SDR-26 1,632 LF 5 8" x 6" WYES EΑ 6 STD. 4' DIAMETER MANHOLE EΑ CONNECT TO EXISTING MANHOLE EΑ 8 EXTRA DEPTH IN MANHOLE VF 9 TRACER WIRE AND BOXES EΑ 10 ROCK EXCAVATION (ESTIMATED) 250 CY 11 MANHOLE BARREL ADJUSTMENT EΑ 12 MANHOLE RING ADJUSTMENT EΑ 13 EROSION CONTROL LS 14 BONDS LS

SANITARY MAIN EXTENSION PLANS RETREAT AT BAILEY FARMS, FIRST PLAT

IN THE CITY OF LEE'S SUMMIT JACKSON COUNTY, MO

GENERAL NOTES:

- 1. ALL CONSTRUCTION TO FOLLOW THE CITY OF LEE'S SUMMIT DESIGN AND CONSTRUCTION MANUAL AS **ADOPTED BY ORDINANCE 5813.**
- ALL WORKMANSHIP AND MATERIALS SHALL BE SUBJECT TO THE INSPECTION AND APPROVAL OF THE ENGINEERING DEPARTMENT OF THE CITY OF LEE'S SUMMIT, MISSOURI.
- LINEAL FOOT MEASUREMENTS SHOWN ON THE PLANS ARE HORIZONTAL MEASUREMENTS. NOT SLOPE MEASUREMENTS. ALL PAYMENTS SHALL BE MADE ON HORIZONTAL MEASUREMENTS
- THE UTILITY LOCATIONS SHOWN ON THESE PLANS ARE TAKEN FROM UTILITY COMPANY RECORDS AND
- THE CONTRACTOR SHALL ADHERE TO THE PROVISIONS OF THE SENATE BILL NUMBER 583, 78TH GENERAL ASSEMBLY OF THE STATE OF MISSOURI. THE BILL REQUIRES THAT ANY PERSON OR FIRM DOING EXCAVATION ON PUBLIC RIGHT OF WAY DO SO ONLY AFTER GIVING NOTICE TO, AND OBTAINING INFORMATION FROM, UTILITY COMPANIES. STATE LAW REQUIRES 48 HOURS ADVANCE NOTICE. THE CONTRACTOR MAY ALSO UTILIZE THE FOLLOWING TOLL FREE PHONE NUMBER PROVIDED BY "MISSOURI ONE CALL SYSTEM, INC.": 1-800-DIG-RITE. THIS PHONE NUMBER IS APPLICABLE ANYWHERE WITHIN THE STATE OF MISSOURI. PRIOR TO COMMENCEMENT OF WORK, THE CONTRACTOR SHALL NOTIFY ALL THOSE COMPANIES WHICH HAVE FACILITIES IN THE NEAR VICINITY OF THE CONSTRUCTION TO BE PERFORMED
- PRIOR TO ORDERING PRECAST STRUCTURES, SHOP DRAWING SHALL BE SUBMITTED TO THE DESIGN ENGINEER FOR APPROVAL.
- THE CONTRACTOR SHALL PROTECT ALL MAJOR TREES FROM DAMAGE. NO TREE SHALL BE REMOVED WITHOUT PERMISSION OF THE OWNER, UNLESS SHOWN OTHERWISE.
- CLEARING AND GRUBBING OPERATIONS AND DISPOSAL OF ALL DEBRIS THEREFROM SHALL BE PERFORMED
- BY THE CONTRACTOR IN STRICT ACCORDANCE WITH ALL LOCAL CODES AND ORDINANCES. ALL WASTE MATERIAL RESULTING FROM THE PROJECT SHALL BE DISPOSED OF OFF-SITE BY THE
- CONTRACTOR, OR AS DIRECTED BY THE OWNER AT NO ADDITIONAL COST. ALL EXCAVATIONS SHALL BE UNCLASSIFIED. NO SEPARATE PAYMENT WILL BE MADE FOR ROCK
- THE CONTRACTOR SHALL CONTROL THE EROSION AND SILTATION DURING ALL PHASES OF CONSTRUCTION AND SHALL KEEP THE STREETS CLEAN OF MUD AND DEBRIS
- THE CONTRACTOR SHALL CONTACT THE CITY'S DEVELOPMENT SERVICES ENGINEERING INSPECTION TO
- THE CONTRACTOR SHALL CONTACT THE RIGHT OF WAY INSPECTOR AT 816-969-1800 PRIOR TO ANY LAND DISTURBANCE ACTIVITIES WITHIN THE RIGHT OF WAY. THESE ACTIVITIES MAY REQUIRE A PERMIT.
- THE CONTRACTOR SHALL PROVIDE AND MAINTAIN ALL TRAFFIC HANDLING MEASURES NECESSARY TO ENSURE THAT THE GENERAL PUBLIC IS PROTECTED AT ALL TIMES. TRAFFIC CONTROL SHALL CONFORM TO THE MANUAL ON UNIFORM TRAFFIC CONTROL DEVICES (MUTCD-LATEST EDITION)
- ALL SANITARY SEWER LATERALS SHALL HAVE A TRENCH CHECK, CONSISTING OF FLOWABLE BACKFILL INSTALLED DURING CONSTRUCTION. TRENCH CHECK SHALL EXTEND TO BOTTOM OF TRENCH, TO WIDTH OF TRENCH, TO 12 INCHES ABOVE PIPE, FOR A MINIMUM LENGTH OF 12 INCHES. TRENCH CHECK SHALL BE LOCATED AT LEAST 5 FEET FROM SANITARY MAIN.

UTILITIES:

- Existing utilities have been shown to the greatest extent possible based upon information provided to the Engineer. The contractor is responsible for contacting the respective utility companies and field locating utilities prior to construction and identifying any potential conflicts. All conflicts shall immediately be brought to the attention of the Engineer.
- The contractor shall be responsible for coordinating any required utility relocations. Utilities damaged through the negligence of the contractor shall be repaired at the contractor's expense.
- Contractor shall verify flow-lines and structure tops prior to construction, and shall notify Engineer of any discrepancies. Provide shop drawings for all precast and manufactured utility structures for review by the Engineer prior to construction of
- Utility Separation: Waterlines shall have a minimum of 10 feet horizontal and 2 feet vertical separation from all sanitary sewer lines, manholes, and sanitary sewer service laterals, as measured from edge to edge. If minimum separations can not be obtained, concrete encasement of the sanitary line shall be required 10 feet in each direction of the conflict.
- Payment for trenching, backfilling, pipe embedment, flowable fill, backfill materials, clean up, seeding, sodding and any other items necessary for the construction of the utility line shall be included in the contract price for the utility installation.
- The Contractor shall be responsible for contacting respective utility companies 48-hours in advance for the inspection of any proposed utility main extension or service line or service connection to any existing main. Trench spoils shall be neatly placed onsite adjacent to the trench, and compacted to prevent saturation and excess
- sediment runoff. Unsuitable materials, excess rock and shale, asphalt, concrete, trees, brush etc. shall be properly disposed of offsite. Materials may be wasted onsite at the direction of the Owner or his appointed representative.
- All excavation is considered unclassified, unless noted otherwise. Unclassified excavation for utility trenching is subsidiary to the unit price provided for the pipe. Any quantity provided for rock excavation is estimated based on the best information provided to the Project Engineer. The Engineer has the authority to identify and define the physical characteristics to determine the classification. Unit price quantities for rock excavation will be paid at a trench width of the nominal pipe diameter of the installed main plus 18 inches. Contractor is required to dispose of excess rock from their trenches by disposing it in areas as specified by the Project Engineer.

CONTRACTOR SHALL OBTAIN ELEVATIONS AND LOCATIONS

SUPPLY THIS INFORMATION TO THE DESIGN ENGINEER FOR

FOR ALL SANITARY SEWER SERVICE LINES AND SHALL

INCLUSION IN THE AS-BUILT RECORD DRAWINGS.

RELEASED FOR CONSTRUCTION

As Noted on Plan Review

Development Services Department Lee's Summit, Missouri

12/14/2023

Sheet List Table					
Sheet Number	Sheet Title				
1	COVER SHEET				
2	GENERAL LAYOUT				
3	LINE K PLAN AND PROFILE				
4	LINE K PLAN AND PROFILE				
5	LINE M PLAN AND PROFILE				
6	SANITARY SEWER DETAILS				

E (2)

APPROVED BY

CITY ENGINEER APPROVED FOR ONE YEAR FROM THIS DATE

OWNER/DEVELOPER:

CLAYTON PROPERTIES GROUP INC., DBA SUMMIT HOMES 120 SE 30TH STREET LEE'S SUMMIT. MISSOURI p (816) 246-6700 BRADLEY@SUMMITHOMESKC.COM

PL2022050 PRSUBD2022051

New City Requirements:

structures.

Flowable fill required per City

specifications at all sanitary sewer



MISSOURI GEOGRAPHIC REFERENCE SYSTEM **BENCHMARK:**

BM JA-45, IS A KC METRO ALUMINUM GRS DISK SET IN CONCRETE AND ABOUT 3 INCHES BELOW THE PAVEMENT ON THE SHOULDER OF SE RANSON ROAD. IT IS STAMPED JA45, 1987.


ELEV. = 1046.25

COVER SHEET

PREPARED BY

JAMES L.

SCHLAGEL & ASSOCIATES, P.A

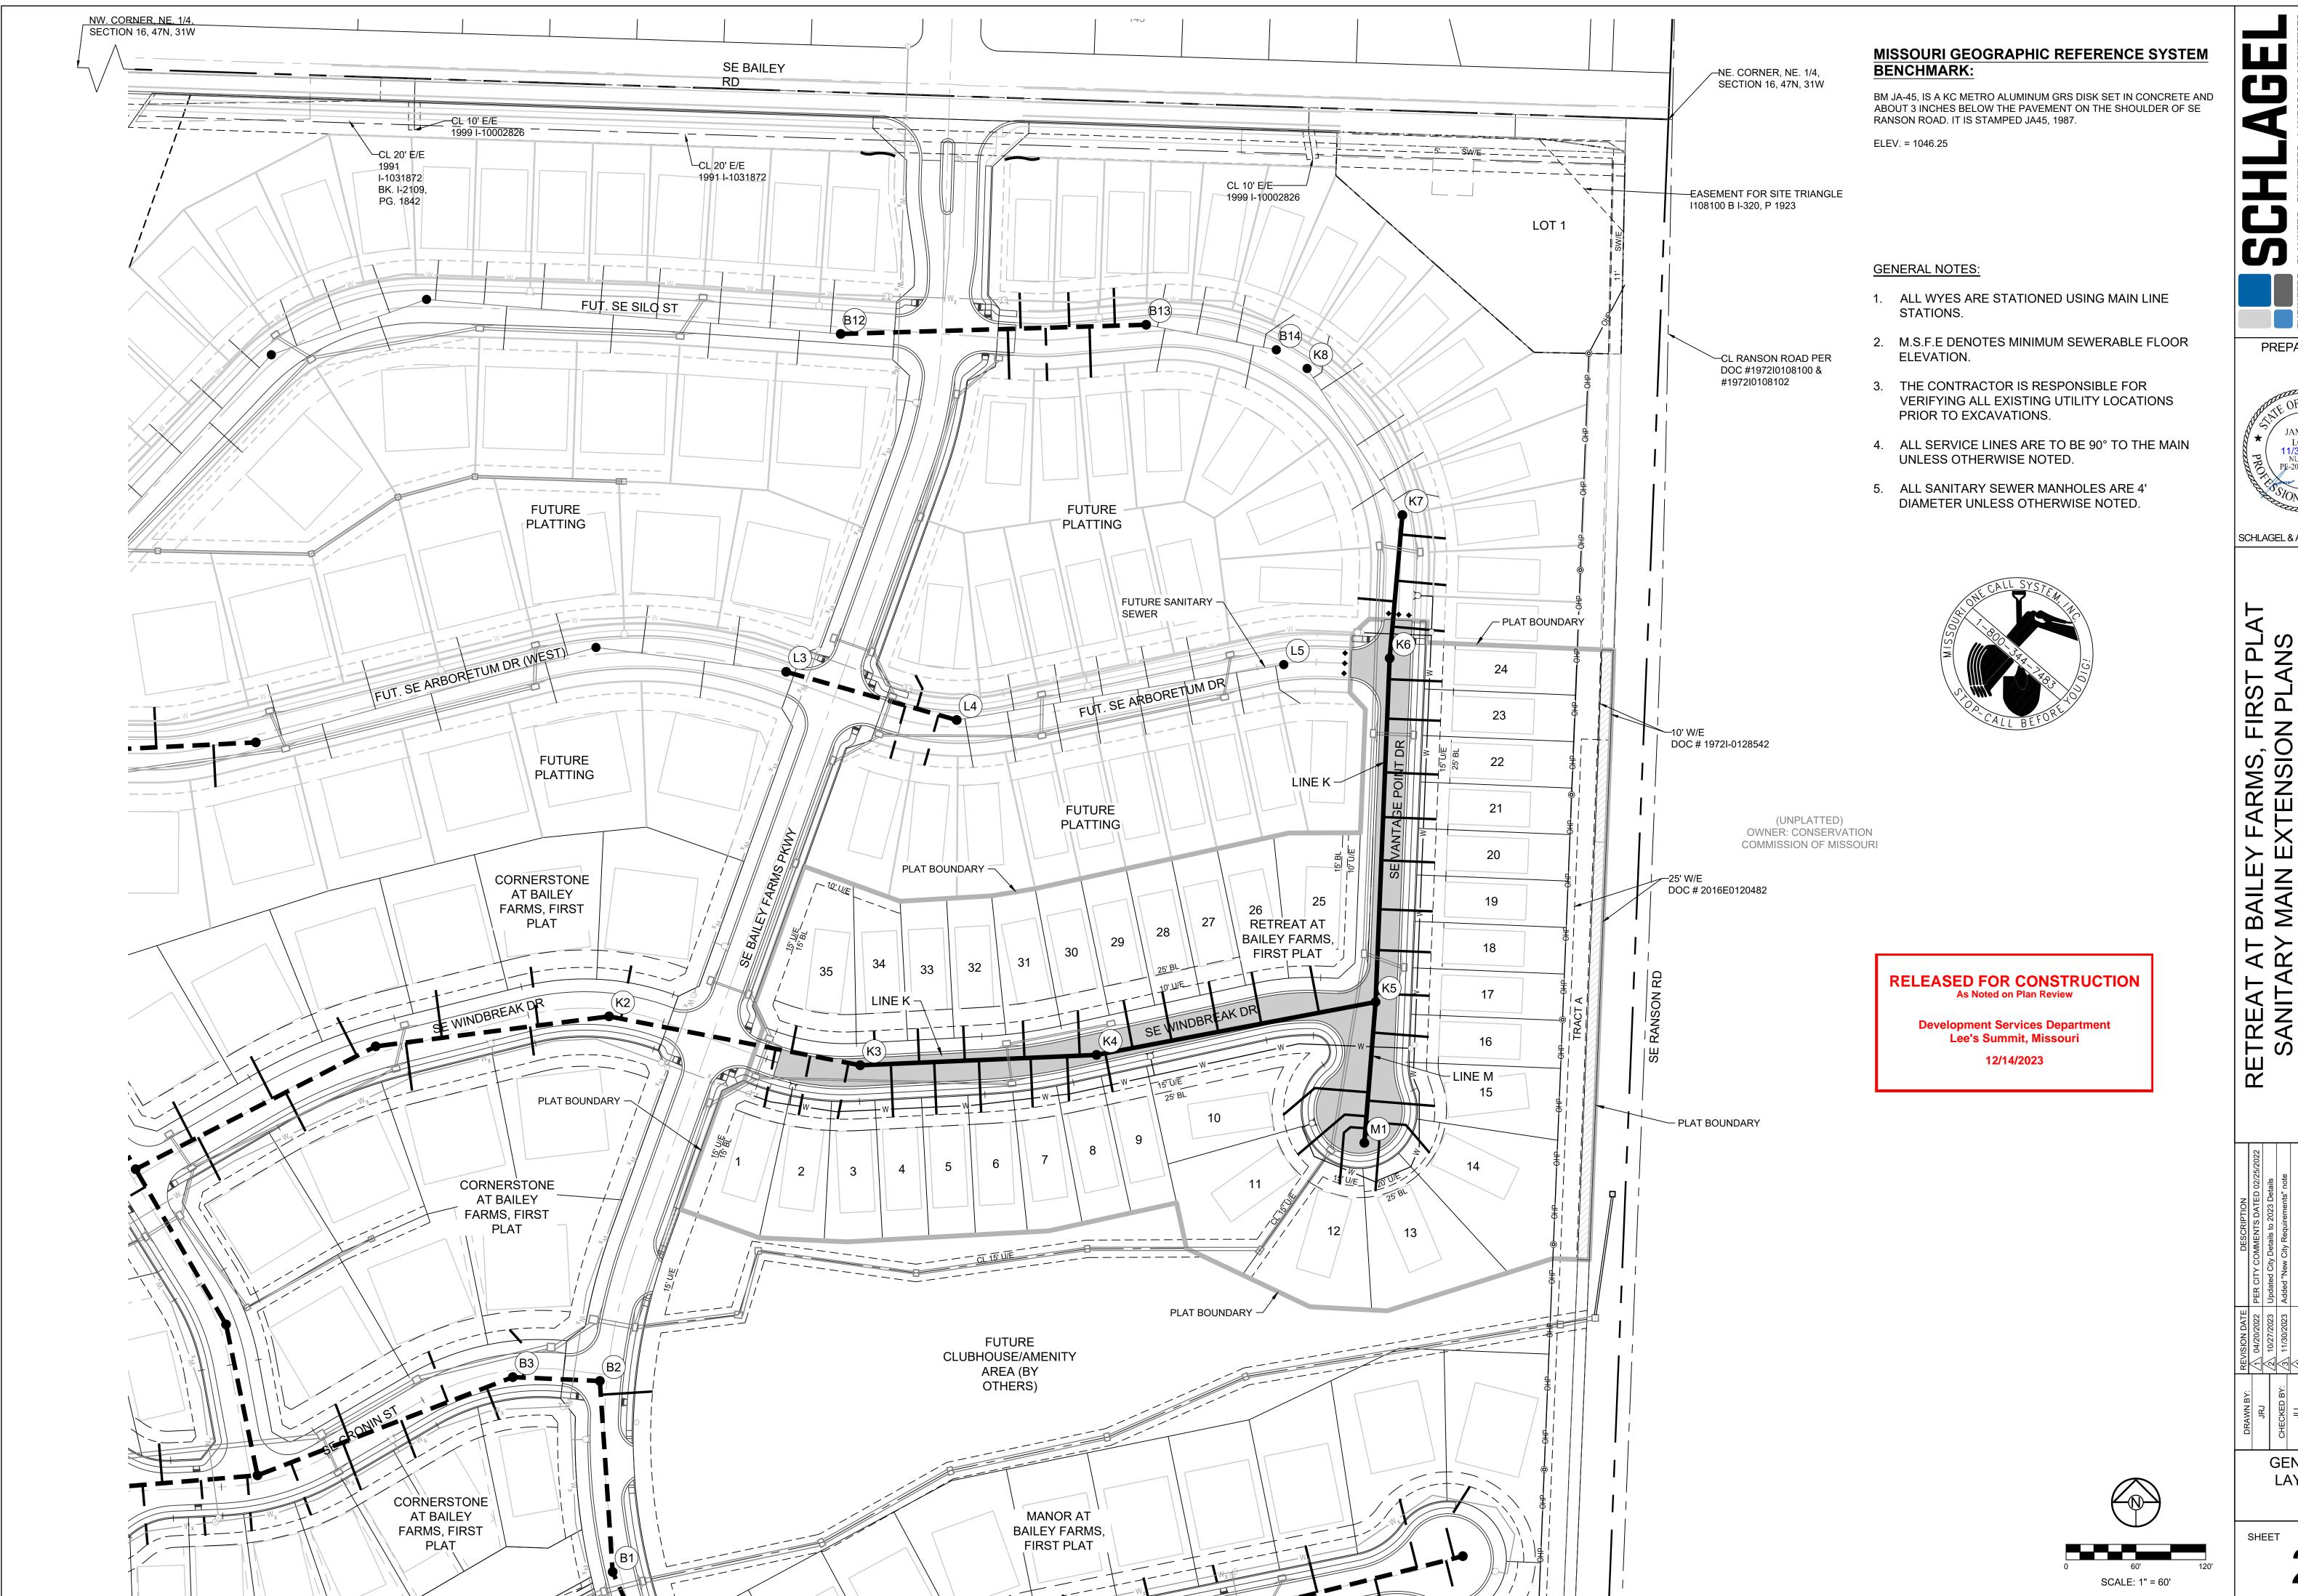

PREPARED BY:

JAMES L.

SCHLAGEL & ASSOCIATES, P.A.

BAIL

GENERAL LAYOUT

MISSOURI GEOGRAPHIC REFERENCE SYSTEM **BENCHMARK:**

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ELEV. = 1046.25

GENERAL NOTES:


(UNPLATTED)

OWNER: CONSERVATION COMMISSION OF MISSOURI

- 1. ALL WYES ARE STATIONED USING MAIN LINE STATIONS.
- 2. M.S.F.E DENOTES MINIMUM SEWERABLE FLOOR ELEVATION.
- 3. THE CONTRACTOR IS RESPONSIBLE FOR VERIFYING ALL EXISTING UTILITY LOCATIONS PRIOR TO EXCAVATIONS.
- 4. ALL SERVICE LINES ARE TO BE 90° TO THE MAIN UNLESS OTHERWISE NOTED.
- 5. ALL SANITARY SEWER MANHOLES ARE 4' DIAMETER UNLESS OTHERWISE NOTED.

CONTRACTOR SHALL OBTAIN ELEVATIONS AND LOCATIONS FOR ALL SANITARY SEWER SERVICE LINES AND SHALL SUPPLY THIS INFORMATION TO THE DESIGN ENGINEER FOR INCLUSION IN THE AS-BUILT RECORD DRAWINGS.



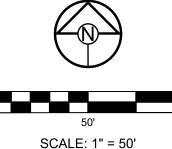

SCALE: 1" = 50'

1" = 50' HORIZ. 1" = 10' VERT. **LINE K** 1070 1070 1060 STA. 8+57.42, LI 4' DIA. MH K4 TOP = 1026.61 1060 STA. 11+01.64, 4' DIA. MH K5 TOP = 1027.35 STA. 6+54.12, L 4' DIA. MH K3 TOP = 1024.17 1050 1050 1040 1040 1030 1030 PROPOSED GRADE -EXISTING GRADE -15" HDPE FL=1024.05 18" HDPE 1020 1020 FL=1019.41 15" HDPE_ FL=1020.26 1010 1010 244.22 LF 203.30 LF 8" PVC SDR-26 RETREAT AT BAILEY @ 0.94% 8" PVC SDR-26 @ 0.77% 1000 1000 EXISTING 990 990 FL OUT (W) 1006.55, 8 FL IN (E) 1006.95, 8" P FL OUT (W) 1008.87, 8 FL IN (E) 1009.27, 8" P 980 980 970 8+00 11+00 7+00 9+00 10+00 12+00

RELEASED FOR CONSTRUCTION
As Noted on Plan Review

Development Services Department Lee's Summit, Missouri 12/14/2023

ROAD & SEE'S SUN RETREAT AT BAILEY SANITARY MAIN E BAIL


PREPARED BY:

JAMES L.

SCHLAGEL & ASSOCIATES, P.A.

<u>a</u>		$1/\sqrt{04/20/2022}$ PER CITY COMMENT
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	12/10/21/2023	Updated Oity Details to
CKED BY:	3 11/30/2023	Added "New City Regu
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PREPARED	\ \$	
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J. NUMBER:	8	
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LINE K PLAN AND PROFILE

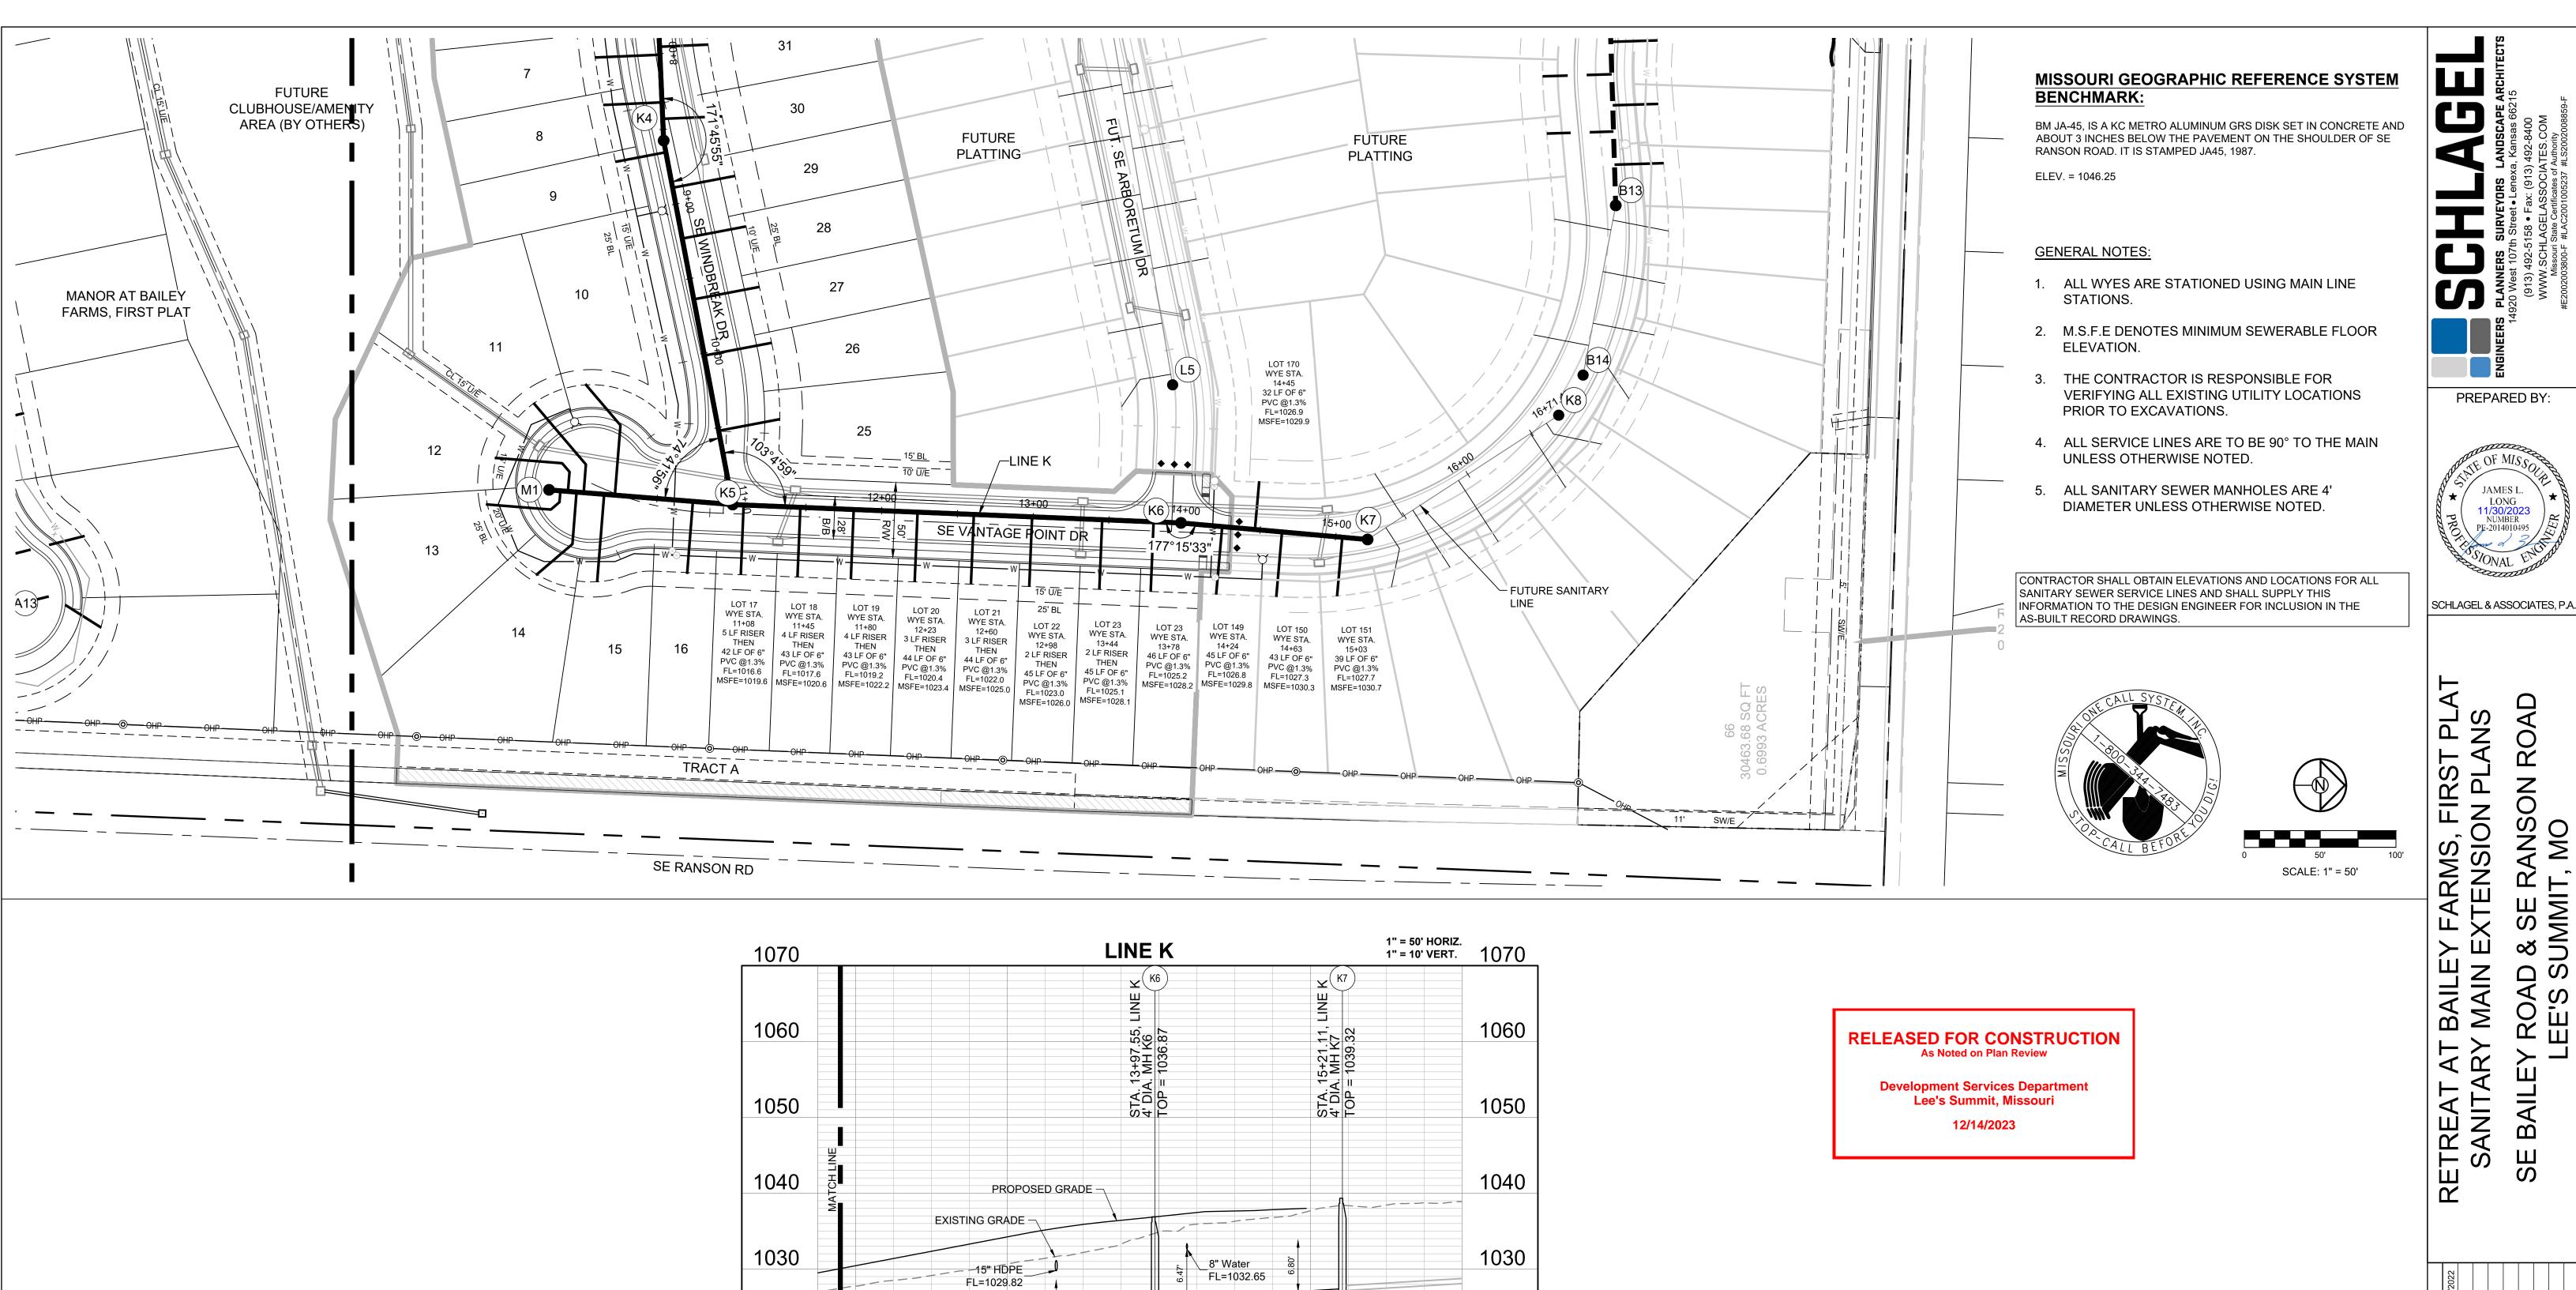

123.57 LF

8" PVC SDR-26 @ 1.21%

OUT (S) 1024.74, 8" PVC SDR-IN (N) 1025.24, 8" PVC SDR-26

14+00

RETREAT AT BAILEY FARMS, FIRST PLAT

15+00

FUTURE PLATTING

1020

1010

1000

990

980

970

16+00

1020

1010

1000

990

980

970

12+00

295.91 LF 8" PVC SDR-26

@ 4.46%

13+00

DESCRIPTION	PER CITY COMMENTS DATED 02/25/2022	Updated City Details to 2023 Details	Added "New City Requirements" note				
VISION DATE	△ 04/20/2022	10/27/2023	11/30/2023		1	1	1
	EVISION DATE DESCRIPTION						

Y ROAD & LEE'S SUN

BAILEY

PREPARED BY:

JAMES L.

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LINE K PLAN AND PROFILE (2)

MISSOURI GEOGRAPHIC REFERENCE SYSTEM BENCHMARK:

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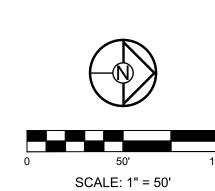
ELEV. = 1046.25

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Development Services Department Lee's Summit, Missouri 12/14/2023

1060	1" = 50' HORIZ. 1" = 10' VERT.	LINE M		1060
1050	7, K2 N N N N N N N N N N N N N N N N N N N	M1 PER ME		1050
1040	STA. 11+01.64, L 4' DIA. MH K5 TOP = 1027.35	STA. 1+21.46, L 4' DIA. MH M1 TOP = 1024.72		1040
1030	D GRADE	PROPOSED EXISTING GRADE —		1030
1020	199	8" Water FL=1022.25		1020
1010	LF.	121.46 LI 8" PVC SDF		1010
1000		@ 1.20%		000
990	9	φ.		990
980	OVC SDR-26 OVC SDR-26 8" PVC SDR-	8" PVC SDR-26		980
970	FL IN (N) 1011.55, 8" PVC SDR-26 FL IN (S) 1011.55, 8" PVC SDR-26 FL OUT (W) 1011.15, 8" PVC SDR-26	(N) 1013.01, 8		970
960	F F O F S O	FL OUT (960
	0+00	1+00	50 2+00	2+50

 Y:
 REVISION DATE
 DESCRIPTION

 A 04/20/2022
 PER CITY COMMENTS DATED 02/2

 BY:
 A 11/30/2023
 Updated City Details to 2023 Details

 BY:
 A 4 A Added "New City Requirements" note

 RED:
 A Added "New City Requirements" note

 C A A Added "New City Requirements" note

 BER:
 A Added "New City Requirements" note

 BER:
 A Added "New City Requirements" note

RETREAT AT BAILEY SANITARY MAIN E

BAILE

PREPARED BY:

JAMES L.

SCHLAGEL & ASSOCIATES, P.A.

LINE M PLAN AND
PROFILE


SHEET


5

RELEASED FOR CONSTRUCTION

As Noted on Plan Review

Development Services Department Lee's Summit, Missouri 12/14/2023

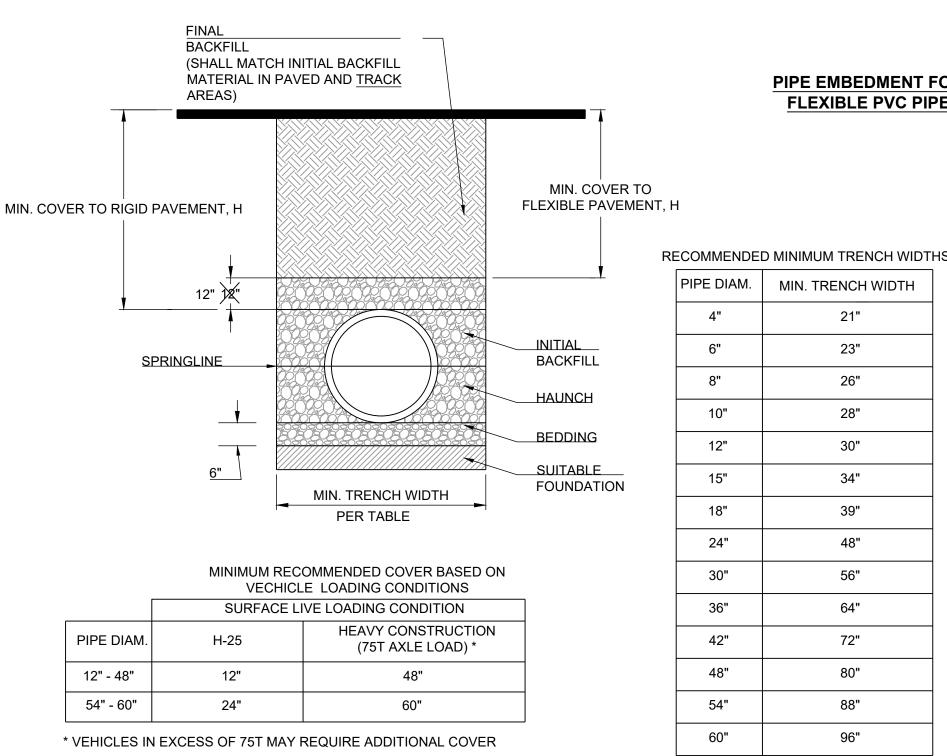

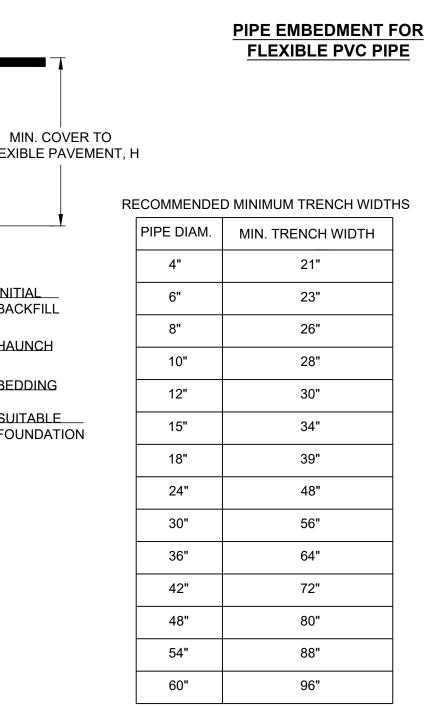


REFER TO THE APPROVED PRODUCTS LIST FOR WATER UTILITIES FOR MANHOLE CASTINGS - FINISH GRADE PROVIDE JOINT SEALANT BETWEEN ALL JOINTS AND WRAP EXTERIOR OF JOINTS IN ACCORDANCE WITH SECTION 3500 12" MAXIMUM ADJUSTING RINGS AS REQUIRED 4" MIN (SEE NOTE 2) 4' MIN IF < 24"Ø PIPE 5' MIN IF > 24"Ø PIPE --- SPRING LINE INTEGRAL CAST BASE 6" OF COMPACTED BEDDING AGGREGATE COMPACTED OR UNDISTURBED EARTH NOTES: 1. PRECAST CONCRETE MANHOLES SHALL CONFORM TO ASTM C478 EXCEPT AS MODIFIED BY THE SPECIFICATIONS. 2. A WALL THICKNESS NOT LESS THAN ONE-TWELFTH (1/12) OF THE INSIDE DIAMETER OR 4", WHICHEVER IS GREATER, SHALL BE USED WHEN THE MANHOLE DEPTH IS LESS THEN 15'. 3. WATERPROOFING SHALL BE REQUIRED ON THE OUTSIDE OF MANHOLES. THE WATERPROOFING SHALL CONSIST OF A TOTAL DRY FILM THICKNESS OF NOT LESS THAN 14 MILS OF BITUMINOUS COATING.

4. ONLY ECCENTRIC MANHOLE CONES WILL BE ALLOWED UNLESS OTHERWISE APPROVED BY THE CITY ENGINEER. 5. THE FILL CONCRETE FLOW CHANNEL FOR SIDE BRANCHES SHALL BE PLACED TO PROVIDE A SMOOTH TRANSITION

6. REFER TO THE APPROVED PRODUCTS LIST FOR WATER UTILITIES FOR APPROVED MANHOLE GASKET MODELS. 7. REFER TO THE APPROVED PRODUCTS LIST FOR APPROVED STEPS.

Date: 12/2015 **LEE'S SUMMIT** Drawn By: SC MISSOURI STANDARD SANITARY PRECAST MANHOLE

necked By: DL SAN-2

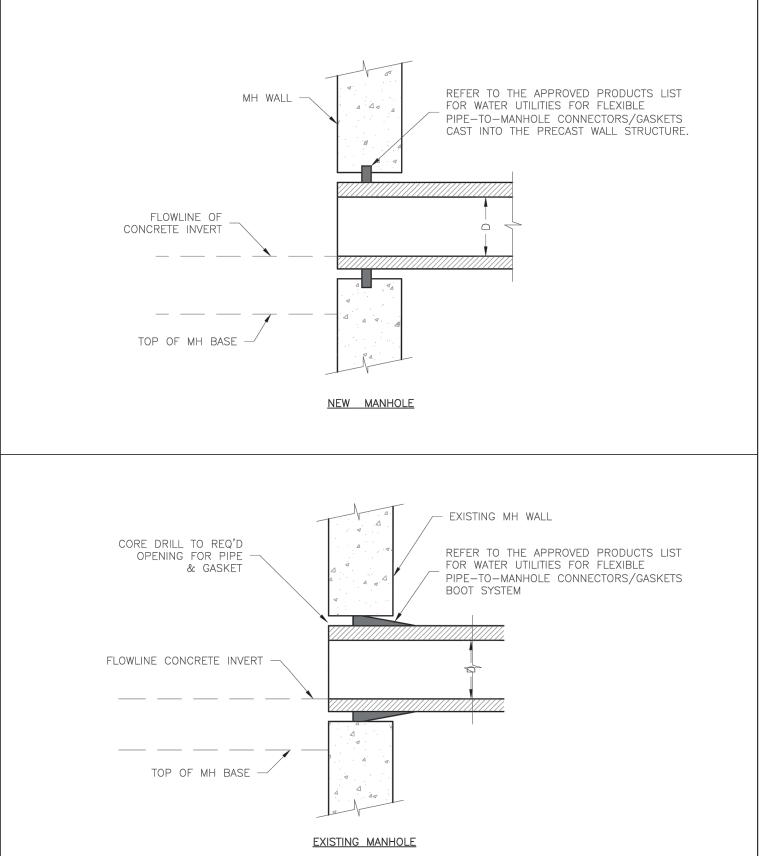

LEE'S SUMMIT


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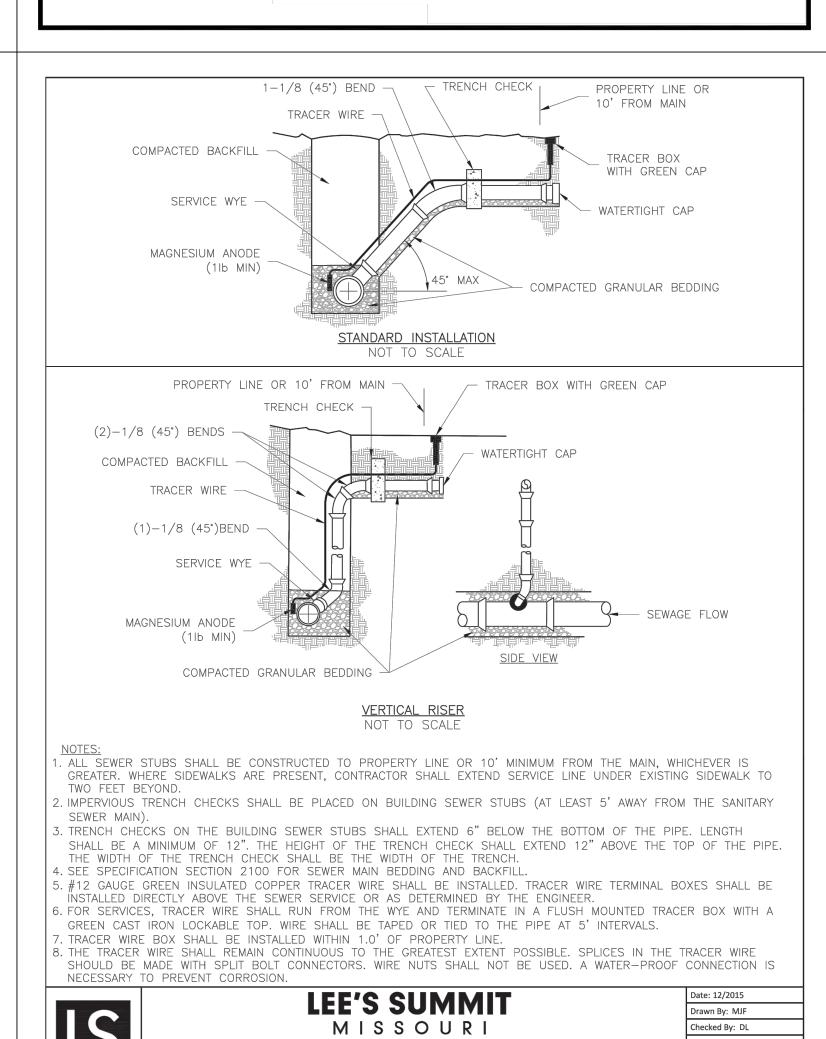
MANHOLE WALL CONNECTION

Drawn By: MJF

necked By: DL


SAN-5



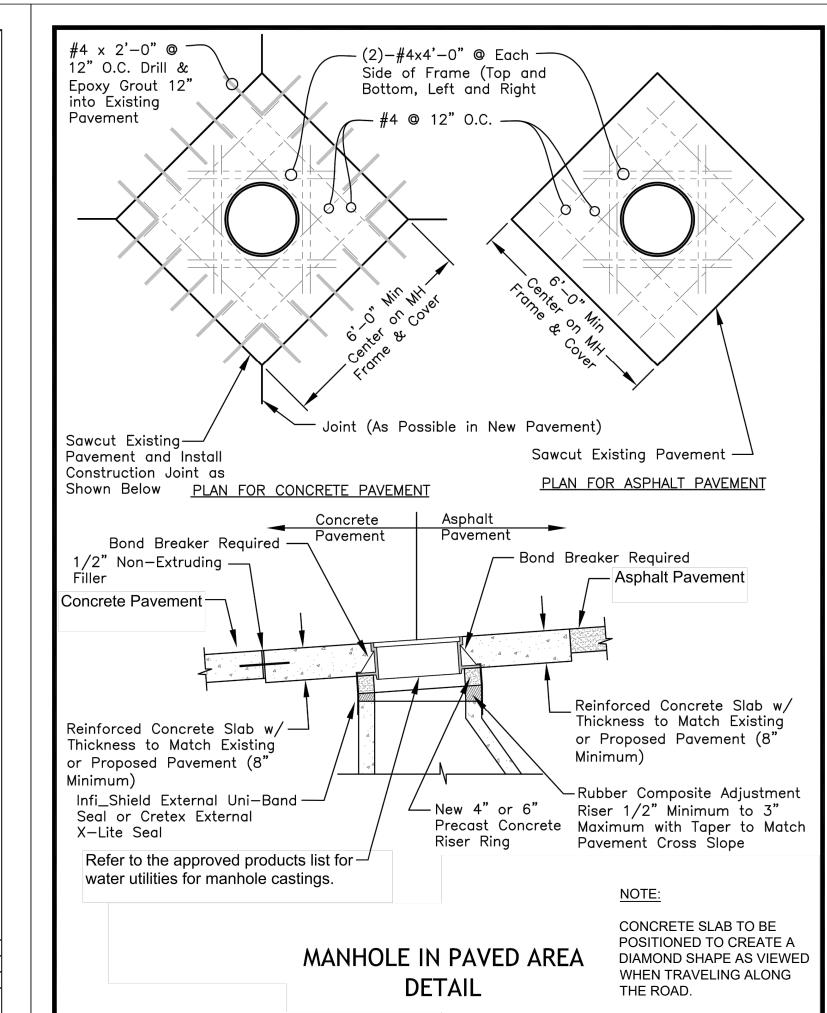

SANITARY SEWER STUB DETAIL

SAN-1

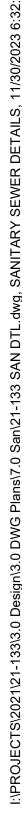

1. ALL PIPE SYSTEMS SHALL BE INSTALLED IN ACCORDANCE WITH ASTM D2321, "STANDARD PRACTICE FOR UNDERGROUND INSTALLATION OF THERMOPLASTIC PIPE FOR SEWERS AND OTHER GRAVITY FLOW APPLICATIONS", LATEST EDITION

- 2. MEASURES SHOULD BE TAKEN TO PREVENT MIGRATION OF NATIVE FINES INTO BACKFILL MATERIAL, WHEN REQUIRED.
- 3. FOUNDATION: WHERE THE TRENCH BOTTOM IS UNSTABLE, THE CONTRACTOR SHALL EXCAVATE TO A DEPTH REQUIRED BY THE ENGINEER AND REPLACE WITH SUITABLE MATERIAL AS SPECIFIED BY THE ENGINEER. AS AN ALTERNATIVE AND AT THE DISCRETION OF THE DESIGN ENGINEER, THE TRENCH BOTTOM MAY BE STABILIZED USING A GEOTEXTILE MATERIAL.
- 4. <u>BEDDING:</u> SUITABLE MATERIAL SHALL BE CLASS I, II OR III. THE CONTRACTOR SHALL PROVIDE DOCUMENTATION FOR MATERIAL SPECIFICATION TO ENGINEER. UNLESS OTHERWISE NOTED BY THE ENGINEER, MINIMUM BEDDING THICKNESS SHALL BE 6" (100mm).
- 5. INITIAL BACKFILL: SUITABLE MATERIAL SHALL BE CLASS I, II OR III IN THE PIPE ZONE EXTENDING NOT LESS THAN 6" ABOVE CROWN OF PIPE. THE CONTRACTOR SHALL PROVIDE DOCUMENTATION FOR MATERIAL SPECIFICATION TO ENGINEER. MATERIAL SHALL BE INSTALLED AS REQUIRED IN ASTM D2321, LATEST EDITION.

6 MINIMUM COVER: MINIMUM COVER. H. IN NON-TRAFFIC APPLICATIONS (GRASS OR LANDSCAPE AREAS) IS 12" FROM THE TOP OF PIPE TO GROUND.

PREPARED BY:



SCHLAGEL & ASSOCIATES, P.A.

0 FARMS, F TENSION Z $\bigcup_{i \in \mathcal{N}} \overline{\mathcal{N}}_i$

SANITARY SEWER DETAILS