

ARCHITECTURAL GENERAL NOTES: 1. ALL WORK SHALL COMPLY WITH THE CITY AND STATE'S BUILDING HEALTH RULES AND REGULATION. LOCAL ORDINANCES AND SUCH STATUTORY PROVISIONS WILL BE CONSIDERED AS MUCH AS A PART OF THESE SPECIFICATIONS. 2. CG SHALL FIELD VERIFIED ALL EXISTING DIMENSIONS AND PARTITIONS LOCATION, AND INFORM ARCHITECT. 3. THE DRAWINGS ARE COMPLIMENTARY AND WHAT IS REQUIRED BY ONE SHALL BE AS BINDING AS IF REQUIRED BY ALL. SHOULD A CONFLICT OCCUR, THE OWNER'S REPRESENTATIVE WILL DETERMINE THE INTENT OF THE DRAWINGS TO PROVIDE A COMPLETED AND FUNCTIONAL FACILITY. PERFORMANCE BY THE CONTRACTOR SHALL BE REQUIRED ONLY TO THE EXTENT CONSISTENT WITH THESE DRAWINGS AND REASONABLY INFERABLE FROM THEM AS BEING NECESSARY TO PRODUCE THE INTENDED "FINISHED" RESULTS. 4. BEFORE ORDERING ANY MATERIALS OR DOING ANY WORK EACH CONTRACTOR AND SUBCONTRACTOR SHALL VERIFY ALL MEASUREMENTS AT THE SITE AND IN THE BUILDING AND SHALL BE RESPONSIBLE FOR THE ACTUAL DIMENSIONS AND THE DIMENSIONS INDICATED ON THE DRAWINGS. ALL WORK SHALL BE LAID OUT SUFFICIENTLY IN ADVANCE OF WORKMEN TO GIVE OPPORTUNITY FOR THE ARCHITECT TO ADJUST DISCREPANCIES OR RENDER DECISIONS WITHOUT CAUSING DELAY TO THE PROJECT BUT WORK SHOULD BE STOPPED WHEN NECESSARY AND IN NO CASE ALLOWED TO PROCEED IN UNCERTAINTY. 5. THESE DRAWINGS ARE FOR THIS SPECIFIC PROJECT AND NO OTHER USE IS AUTHORIZED. 6. ALL MATERIALS ARE NOT NOTED BY WORDS. IT IS INTENDED THAT THEY ARE UNDERSTOOD BY THE MATERIAL SYMBOL DRAWN. 7. WHERE A CONDITION IS NOTED "TYPICAL", IT IS UNDERSTOOD THAT ALL SIMILAR CONDITIONS ARE TO BE CONSTRUCTED OF THE SAME MATERIALS, FINISH AND/OR DIMENSIONS. 8. ALL DIMENSIONS ARE TO THE FACE OF STUDS, THE FACE OF FINISHED WALL, OR CENTERLINE OF STRUCTURAL COLUMN AND THE AFOREMENTIONED MATERIALS. CEILING ELEVATIONS, BEAM ELEVATION, SOFFIT ELEVATIONS ARE CLEAR "FINISHED" DIMENSIONS. 9. FURNISH AND INSTALL SOLID WOOD BLOCKING IN ALL INTERIOR STUD PARTITIONS WHERE STRUCTURAL SUPPORTS ARE REQUIRED FOR VANITIES, SHELVES, GRAB BARS, BENCHES. ETC. 10. WHERE DISSIMILAR MATERIALS MEET USE CAULKED JOINTS. USE METAL EDGES CORNERS AND STOPS AS REQUIRED ON ALL GYPSUM BOARD UNITS FOR FIRST CLASS FINISHED APPEARANCE. 11. ALL GYPSUM BOARD SHALL BE 5/8" "X" TYPE THROUGHOUT EXCEPT WHERE NOTED, AND SHALL INSTALL ACCORDING TO THE SPECIFICATION OF GYPSUM ASSOCIATION. 12. NO PLUMBING SUPPLIES, WASTES, ETC. TO BE LOCATED IN EXTERIOR WALLS EXCEPT FROST PROOF HOSE BIBS. ALL EXPOSED PIPES, DUCTS, CONDUIT SHALL BE ENCLOSED WITH GYPSUM BOARD ON FURRING INCLUDING THOSE NOT SHOWN ON THE DRAWINGS. 13. SLOPE 1" IN 4' RADIUS AROUND ALL FLOOR DRAINS. 14. ALL PLUMBING CHASES TO HAVE FULL BATT INSULATION. 15. EVERY CONTRACTOR SUBCONTRACTOR AND SUPPLIER SHALL PROVIDE A NOTARIZED STATEMENT OF ASSURANCE THAT NO PRODUCTS OR MATERIALS CONTAINING ASBESTOS WERE SUPPLIED OR INSTALLED ON THIS PROJECT. 16. COMBUSTIBLE MATERIALS OF ANY NATURE ARE NOT PERMITTED ABOVE THE CEILING 17. ALL CONTRACTORS MUST BE LICENSED TO WORK IN THE CITY 18. ANY AND ALL MATERIALS AND SUBSTANCE UTILIZED WITHIN THE PREMISES MUST BE ENVIRONMENTALLY SAFE AND NON-HAZARDOUS 19. INSTALL A SIGN THAT STATE THE OCCUPANT LOAD. 20. ALL BARRIER FREE FIXTURES AND ACCESSORIES ARE TO CONFORM TO THE AMERICANS WITH DISABILITIES ACT, THE STATE BARRIER FREE CODE AND ANY LOCAL ORDINANCES 21. INSTALL HANDICAP SIGN ON RESTROOM DOOR AND PARKING LOT SPACE. ALL SIGNS SHALL BE ADA APPROVED.

FIRE PROTECTION NOTES:

1.POSTING OF OCCUPANT LOAD. EVERY ROOM OR SPACE THAT IS AN ASSEMBLY OCCUPANCY SHALL HAVE THE OCCUPANT LOAD OF THE ROOM OR SPACE POSTED IN A CONSPICUOUS PLACE, NEAR THE MAIN EXIT OR EXIT ACCESS DOORWAY FROM THE ROOM OR SPACE. POSTED SIGNS SHALL BE OF AN APPROVED LEGIBLE PERMANENT DESIGN AND SHALL BE MAINTAINED BY THE OWNER OR AUTHORIZED AGENT. 2. MAINTENANCE OF FIRE-RESISTIVE ASSEMBLY FOR THE EXISTING DEMISING WALL: GC SHALL FIELD VERIFY AND MAINTAIN THE REQUIRED ONE HOUR FIRE-RESISTANT RATING OF FIRE-RESISTANCE-RATED CONSTRUCTION. SUCH ELEMENTS SHALL BE PROPERLY REPAIRED. RESTORED OR REPLACED WHEN DAMAGED, ALTERED, BREACHED OR PENETRATED. OPENINGS MADE THEREIN FOR THE PASSAGE OF PIPES, ELECTRICAL CONDUIT, WIRES DUCTS, AIR TRANSFER OPENINGS AND HOLES MADE FOR ANY REASON SHALL BE PROTECTED WITH APPROVED METHODS CAPABLE OF RESISTING THE PASSAGE OF SMOKE AND FIRE. OPENINGS THROUGH FIRE-RESISTANCE-RATED ASSEMBLIES SHALL BE PROTECTED BY SELF- OR AUTOMATIC- CLOSING DOORS OF APPROVED CONSTRUCTION MEETING THE FIRE PROTECTION REQUIREMENTS FOR THE ASSEMBLY.

3. INSTALLATION ACCEPTANCE TESTING: FIRE DETECTION AND ALARM SYSTEMS, FIRE EXTINGUISHING SYSTEM, FIRE HYDRANT SYSTEMS, AND ALL OTHER FIRE PROTECTION SYSTEMS AND APPURTENANCES THERETO SHALL BE SUBJECT TO ACCEPTANCE TESTS AS CONTAINED IN THE INSTALLATION STANDARD AND AS APPROVED BY THE FIRE CODE OFFICIAL. THE FIRE CODE OFFICIAL SHALL BE NOTIFIED BEFORE ANY REQUIRED ACCEPTANCE TESTING. 4. PORTABLE FIRE EXTINGUISHERS FOR COMMERCIAL COOKING EQUIPMENT. PORTABLE FIRE EXTINGUISHER SHALL BE PROVIDED WITH A 30 FOOT TRAVEL DISTANCE OF COMMERCIAL TYPE COOKING EQUIPMENT. COOKING EQUIPMENT INVOLVING VEGETABLE OR ANIMAL OILS AND FATS SHALL BE PROTECTED BY A CLASS K RATED PORTABLE EXTINGUISHER. A K-CLASS EXTINGUISHER SHALL BE PROVIDED AND LOCATED UNDER THE MANUAL PULL FOR THE HOOD. 5. PORTABLE FIRE EXTINGUISHERS SHALL BE SELECTED, INSTALLED

AND MAINTAINED IN ACCORDANCE WITH THE NFPA 6. OWNER SHALL BE MAINTAIN ABC TYPE EXTINGUISHERS. 7. MAINTENANCE OF EXTERIOR DOORS AND OPENINGS: EXTERIOR DOORS AND THEIR FUNCTION SHALL NOT BE ELIMINATED WITHOUT PRIOR APPROVAL

8. THE FINAL DETERMINATION FOR THE REQUIREMENTS OF EXIT SIGNAGE AND EMERGENCY LIGHTING SHALL BE MADE IN THE FIELD. 9. THE ADDRESS SHALL BE POSTED ON FRONT AND REAR: FRONT IS MINIMUM 6" LETTERS OF CONTRASTING COLOR TO BACKGROUND AND BACK MAY BE 1" LETTERS.

10. A KNOX BOX SHALL BE PROVIDED NEAR THE MAIN ENTRANCE TO THE BUILDING (IFC-2018 § 506.1). TO ENSURE PROPER KEYING TO KANSAS CITY, MISSOURI; KNOX BOXES MAY BE ORDERED ONLINE AT WWW.KNOXBOX.COM OR ON AN OFFICIAL ORDER FORM OBTAINED THROUGH THIS OFFICE.


11. PORTABLE FIRE EXTINGUISHERS SHALL BE PROVIDED PER (IFC-2018 § 906.1;906.2). ABC AND CLASS K

SMOKING ORDINANCE IN LEE'S SUMMIT:

THE CITY OF LEE'S SUMMIT HAS AN ORDINANCE WHICH PROHIBITS SMOKING IN VIRTUALLY ALL ENCLOSED AREAS OF PUBLIC PLACES AND PLACES OF EMPLOYMENT. PER THE ORDINANCE, A "NO SMOKING" SIGN OR THE INTERNATIONAL "NO SMOKING" SYMBOL (CONSISTING OF A BURNING CIGARETTE ENCLOSED IN A RED CIRCLE WITH A RED BAR ACROSS IT) SHALL BE CLEARLY AND CONSPICUOUSLY POSTED AT EVERY ENTRANCE WHERE SMOKING IS PROHIBITED. THE PERSON WHO OWNS, MANAGES, OPERATES OR OTHERWISE CONTROLS A PUBLIC PLACE OR PLACE OF EMPLOYMENT IS RESPONSIBLE FOR COMPLIANCE WITH THE CLEAN INDOOR AIR ACT. QUESTIONS REGARDING THE CLEAN INDOOR AIR ACT MAY BE DIRECTED TO DEVELOPMENT SERVICES AT (816) 969-1200.


05 ^{KEY} XXX ROOM NAME FLOOR DRAIN/SINK PLAN NOTE ABC PORTABLE FIRE (E) EXTINGIUISHER EQUIPMENT NUMBER EMERGENCY EXIT FIXTURE WITH 90 MIN. BACK-UP RELOCATED EXIST. COMBINATION OF 280 POWER OUTLET \square EXIT & EMERGENCY LIGHT UNIT WITH 90 MIN. BACK-UP ELEC. PANEL EXISTING SECTION CUT SINGLE SWITCH 48' A.F.F. TYP. ____ RELOCATE EXISTING OR PROVIDE NEW AS NECESSARY \oplus ELECT. RECEPTACLE ELEVATION PER OWNER RELOCATE EXISTING OR PROVIDE NEW AS NECESSARY EXHAUST FAN SWITCHED WITH LIGHT DEMISING WALL VENT THROUGH ROOF TO THE EXTERIOR NEW LOW WALL/ CABINETRY PER OWNER **REVISION CLOUD** NEW WALL EXISTING WALL ///// DEMO WALL

- 11. ACCESSIBLE ROUTE SHALL HAVE A RUNNING SLOPE OF 1:20 MAX. AND A CROSS SLOPE OF 1:50 MAX.
- 9. RESTROOM SHALL BE 3'-0"X 7'-0" HOLLOW CORD DOOR W/ SELF-CLOSER AND U SHAPED HARDWARE. 10. EXHAUST FAN SHALL BE SWITCHED WITH LIGHT.
- 8. HANDICAPPED ACCESSIBLE RESTROOM SIGN SHALL MEET ALL THE STANDARDS OF ADA SIGN.
- 7. MIRROR SHALL BE MOUNTED WITH THE BOTTOM EDGE OF THE REFLECTING SURFACE 40" MAX. A.F.F.
- DRAINPIPES UNDER LAVATORIES SHALL BE INSULATED TO PROTECT AGAINST CONTACT AND SHALL BE NO ABRASIVE SURFACES. 6. FAUCET SHALL BE LEVER-OPERATED DESIGN.
- DISPENSERS THAT DO NOT PERMIT CONTINUOUS PAPER FLOW SHALL NOT BE USED. 5. LAVATORIES SHALL BE MOUNTED WITH THE RIM NO HIGHER THAN 34" ABOVE THE FINISH FLOOR. IT SHALL EXTEND 17" MIN. FROM THE WALL. CLEARANCE OF 29" MIN SHALL BE PROVIDED FROM FINISH FLOOR TO BOTTOM OF APRON. KNEE CLEARANCE OF 27" MIN. BY 8" MIN. UNDER THE EDGE OF THE LAVATORY. HOT WATER AND
- 4. TOILET PAPER DISPENSERS SHALL BE INSTALLED ON THE SIDEWALL, BELOW THE GRAB BAR, AT MIN. 19" ABOVE THE FLOOR, AND A MAX. 36" FROM THE REARWALL.
- 3. GRAB BARS @ WATER CLOSET SHALL BE 1 1/2" DIA MOUNTED 33-36" A.F.F. SIDE WALL: HORIZONTAL @42"LONG, 12" FROM BACK WALL. VERTICAL @18"LONG MIN. 39"-41" FROM BACK WALL, 39"-41" A.F.F. FROM BOTTOM OF BAR. BACK WALL: 36" LONG, WATER CLOSET ON CENTER.
- GRAB BARS ON SIDE WALLS.
- 1. WATER CLOSET SHALL BE LOCATED 18" FROM SIDEWALL. THE HEIGHT TO THE TOP OF THE TOILET SEAT SHALL BE 17" TO 19". 2. GRAB BARS SHALL BE 1 1/2" DIA. MOUNTED 33-36" A.F.F. SIDE WALL: FULL WIDTH, CONNECTING TO GRAB BAR ON BACK WALL. BACK WALL: FULL WIDTH, CONNECTING TO

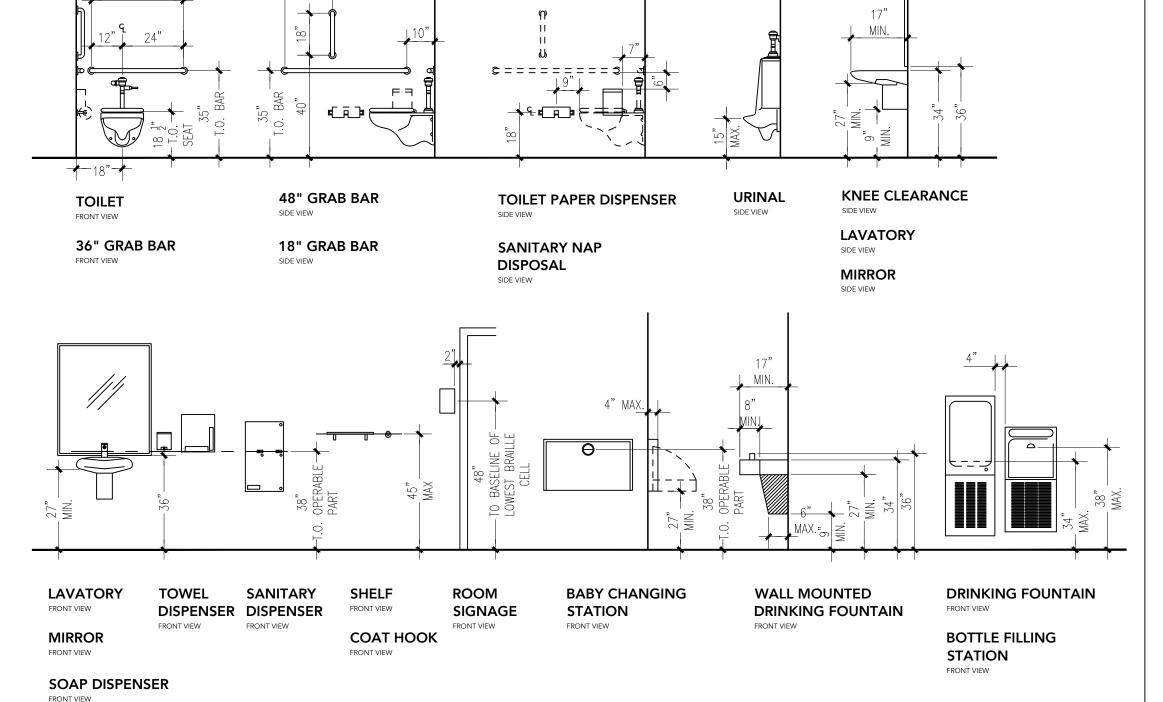

03 ADA RESTROOM MOUNTING HEIGHTS FOR BATHROOM ACCESSORIES

40"

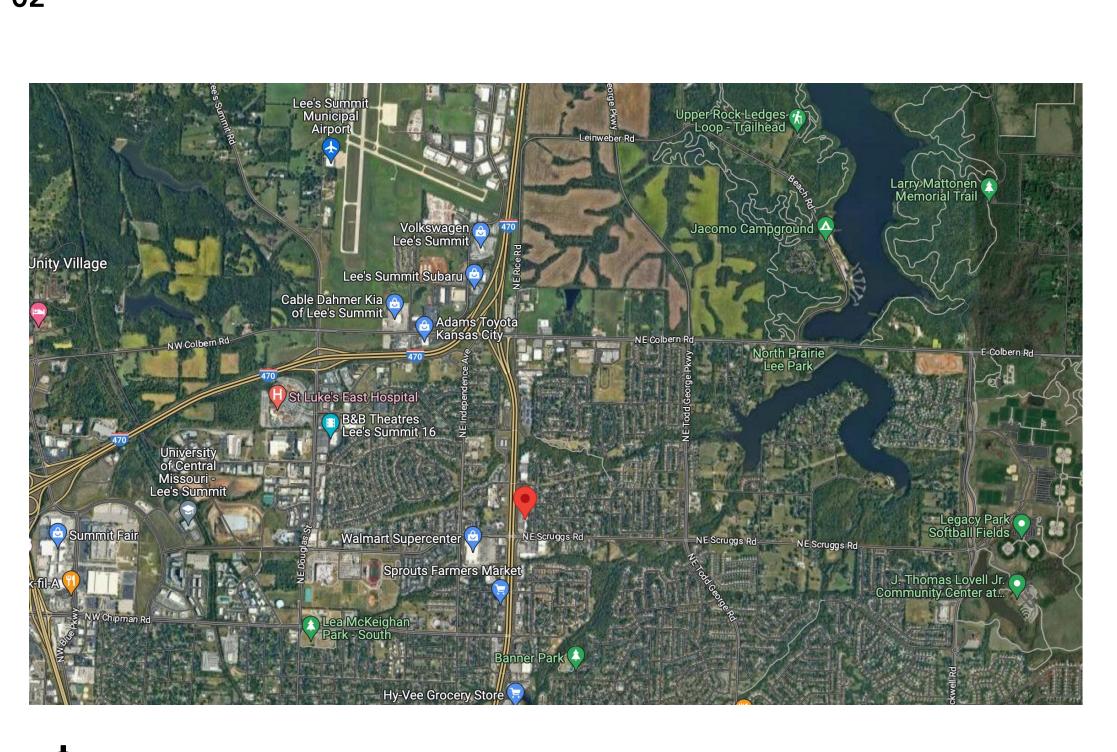

BUILDING INFORMATION 01

ON JANUARY 8, 2019, THE LEE'S SUMMIT CITY COUNCIL ADOPTED NEW BUILDING CODE REGULATIONS (ORDINANCE #8536) AND A NEW FIRE CODE (ORDINANCE #8537). THESE ORDINANCES ADOPT PROVISIONS FROM THE FOLLOWING NATIONALLY PUBLISHED CONSTRUCTION CODES:

2018 INTERNATIONAL BUILDING CODE 2018 INTERNATIONAL PLUMBING CODE 2018 INTERNATIONAL MECHANICAL CODE 2018 INTERNATIONAL FUEL GAS CODE 2018 INTERNATIONAL RESIDENTIAL CODE 2018 INTERNATIONAL FIRE CODE 2017 NATIONAL ELECTRICAL CODE ICC/ANSI A117.1-2009, ACCESSIBLE AND USABLE BUILDINGS AND FACILITIES

SCOPE OF WORK

THE REMODELING OF AN EXISTING BUSINESS INSIDE OF AN ESTABLISHED SHOPPING CENTER TO MEET THE NEEDS OF THE NEW SALON BUSINESS OPERATION UNDER THE NEW OWNERSHIP.

CODE AND OCCUPANT LOAD DATA

OCCUPANCY TYPE: B CONSTRUCTION TYPE: 2B FLOOR AREA: 2,200 SQ. FT NOT A CHANGE OF USE

MAX. OCCUPANCY LOAD: 2,200/150= 15 OCCUPANCY LOAD CALCULATIONS BASED ON: 1004.1.2

ACTUAL DESIGNED OCCUPANCY LOAD: TOTAL 24 PEOPLE. 12 MANICURIST. MAXIMUM PER SHIFT WORKING WITH CLIENT BY APPOINTMENT. 12 CLIENTS SERVED AT EITHER MANICURE, CURING STATION OR PEDICURE CHAIR

NO OF EXIT REQUIRED: 1 / PROVIDED: 2 NO OF RESTROOM REQUIRED: 1 / PROVIDED: 2 NO. OF STORIES: 1

THIS IS NOT A SPRINKLED BUILDING AND NO EXISTING FIRE ALARM IN THE BUILDING.

PLUMBING FIXTURES EXISTING TO REMAIN. NO CHANGE.

<u>REQUIRED:</u> WATER CLOSET(S): 2 LAVATORY(S): 2

PROVIDED: WATER CLOSET(S): 2 LAVATORY(S): 2

PLANNING AND DEVELOPMENT


PARKING DATA


PARKING- NO CHANGE OF USE

PARKING PROVIDED BY DEVELOPER HAS COMPLY WITH THE CITY'S STANDARDS FOR OFF-STREET PARKING. ACCESSIBLE PARKING SPACES AND RAMPS ARE LOCATED IN FRONT OF THIS FACILITY.


NO NEW/EXISTING RTU CAN BE SIGHTED FROM GROUND LEVEL. IF SO GC SHALL PROVIDE RTU SCREEN MATCHING BUILDING MATERIALS AND APPROVED BY CITY.


<section-header> COPARIER STONE COPARIER STONE CARADA SACHUECT, ARCHUECT, ARCHUECTLC@GMAILCM</section-header>
PROJECT: LAVISH NAILS & LASHES, LLC 1155 NE RICE ROAD LEE'S SUMMIT, MISSOURI 64086
VJJEH-LI JEAN SUN KAO AUMBER A-6059 09/26/2023 SHEET INDEX: T TITLE PAGE A101 EXISTING FLOOR PLAN
 A102 PROPOSED FLOOR PLAN A103 PROPOSED CEILING PLAN A104 DETAILS + SCHEDULES E200 POWER PLAN E201 LIGHTING PLAN E202 SYSTEMS POWER PLAN E300 ELECTRICAL NOTES P200 PLUMBING FLOOR PLAN M200 MECHANICAL FLOOR PLAN MP301 PLUMBING DIAGRAMS MP400 MECHANICAL NOTES
CONSULTANTS: M/E/P: NAME: GREG GLADFELTER ADDRESS: 10233 MILLSTONE DRIVE, #4112 LENEXA, KS 66220 TEL: 816-916-4675
ISSUE PACKAGE: NO: DATE
OWNER: EMAIL: DRAWN BY: JRK CHECKED BY: YJK PROJECT: NAIL SALON
DATE 08/02/2023
DRAWING
SCALE $\frac{1}{4}$ " = 1'0"

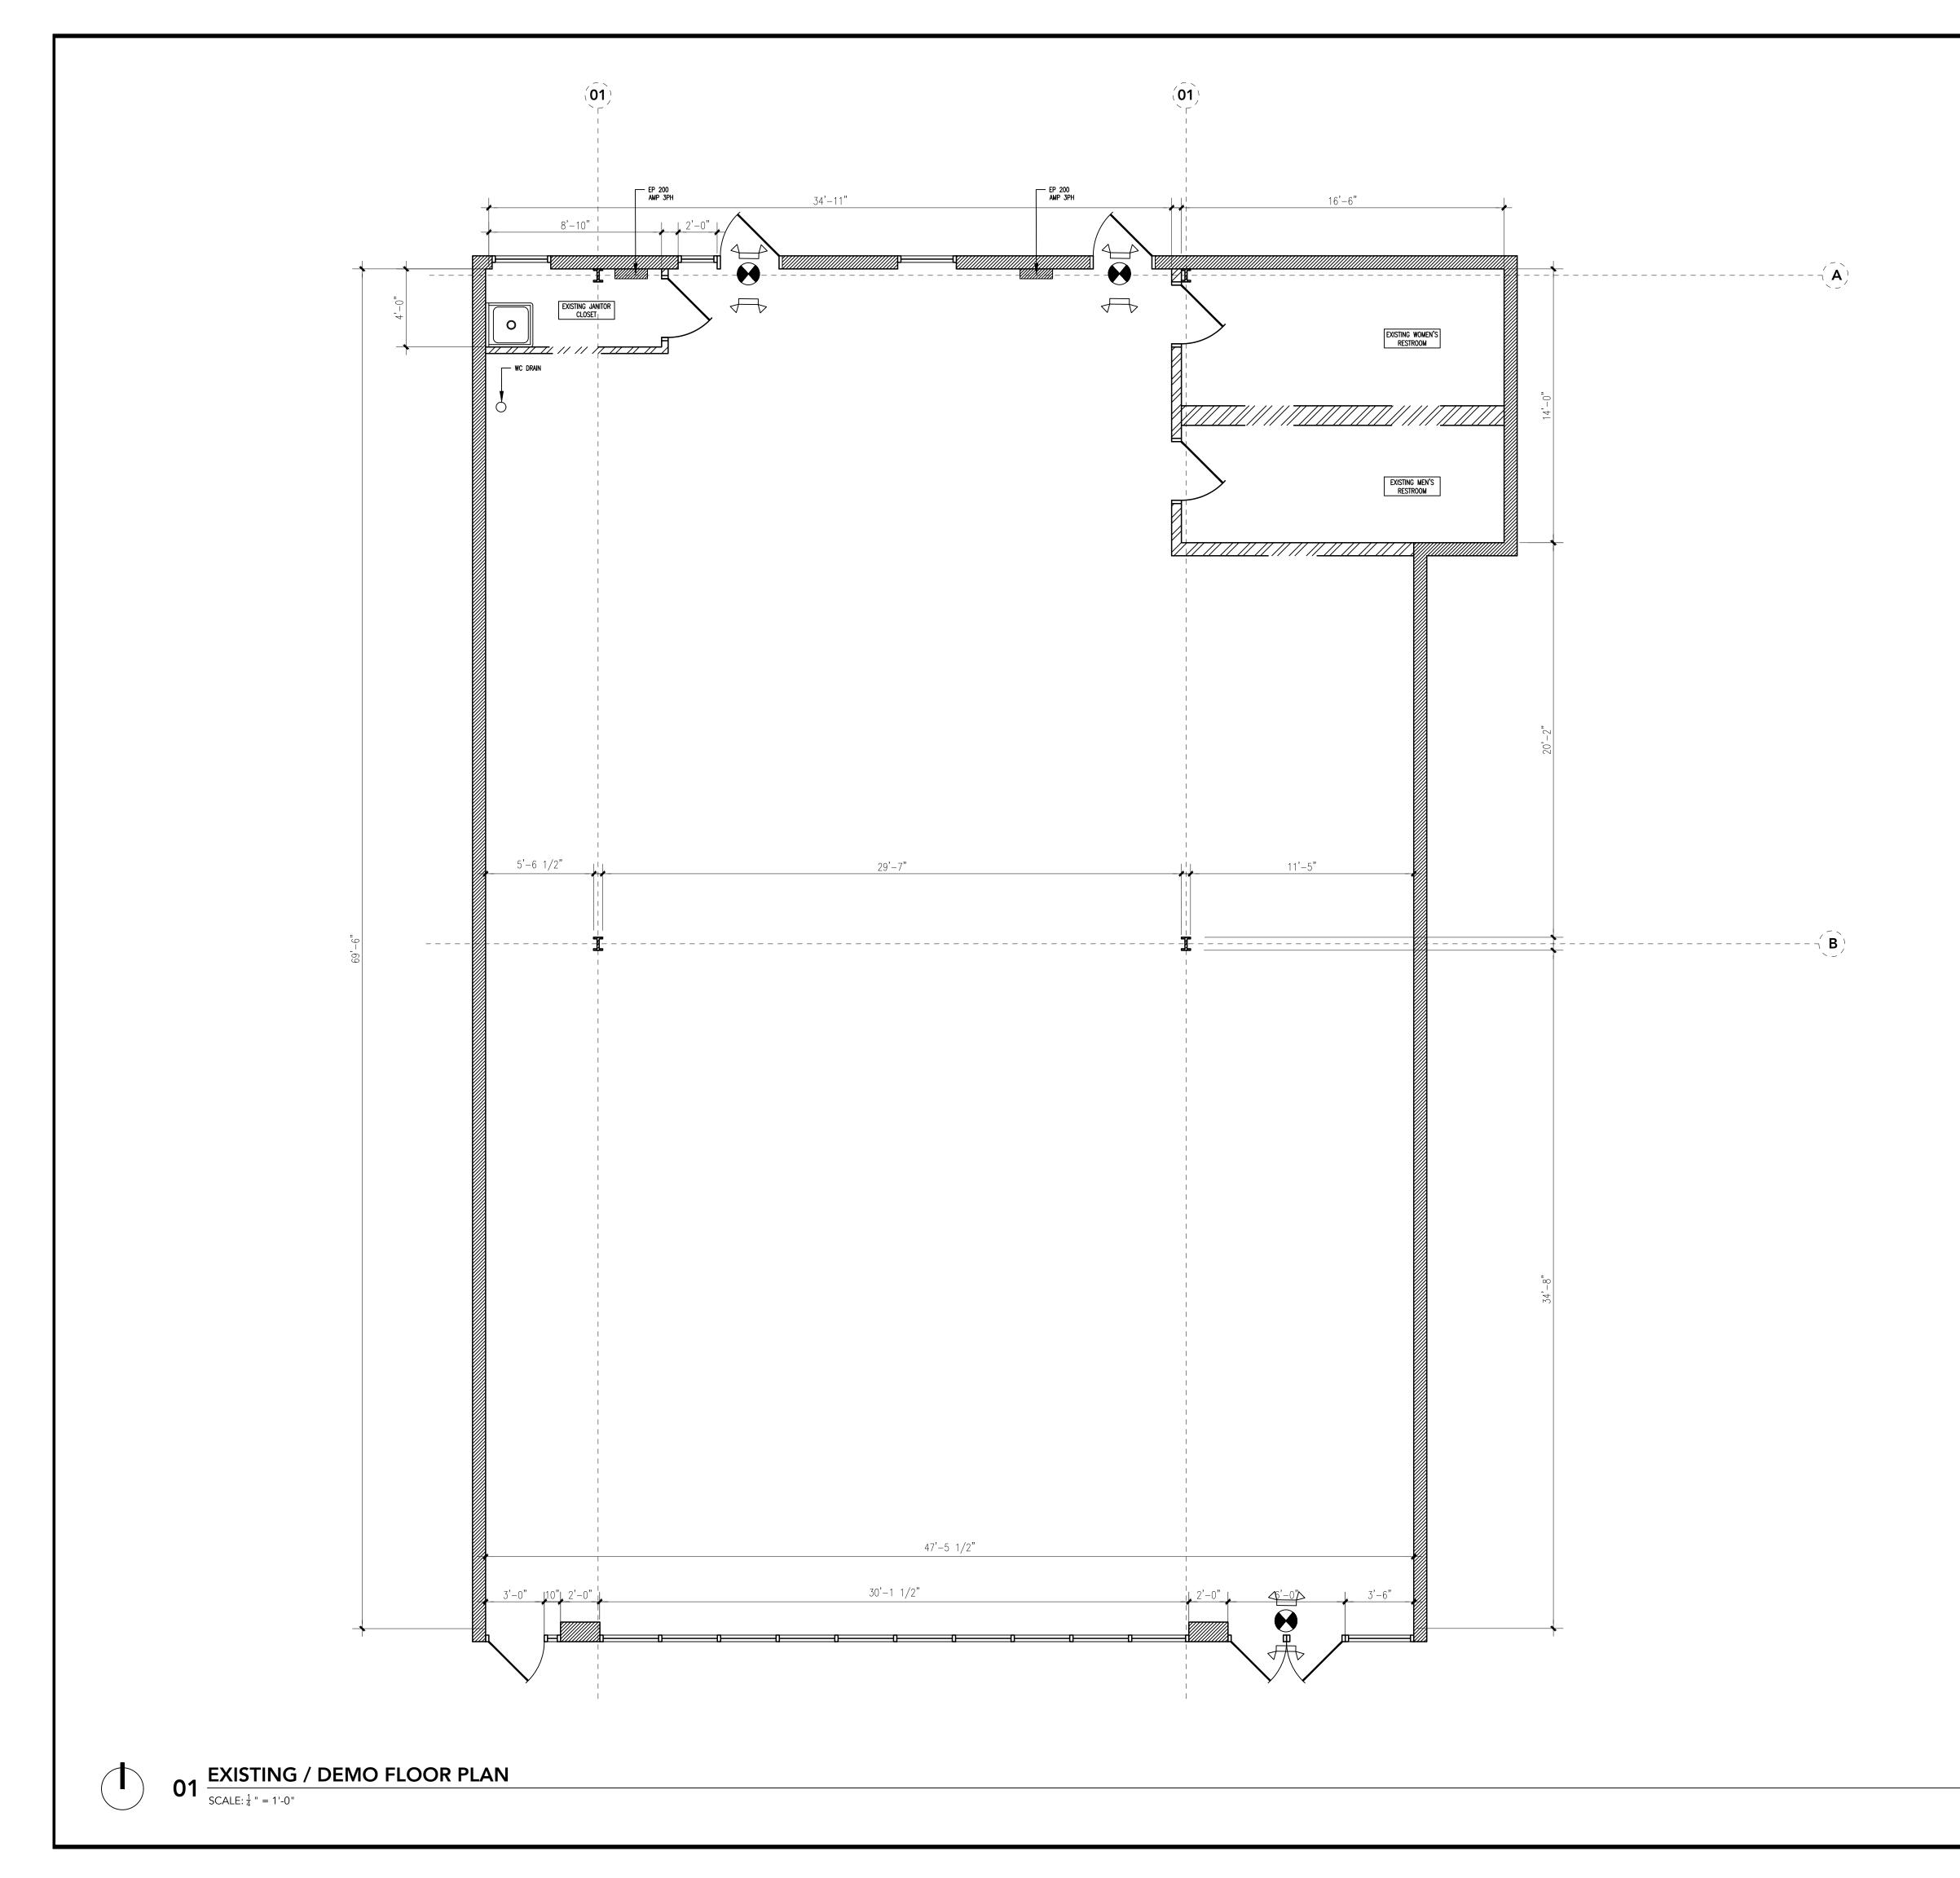

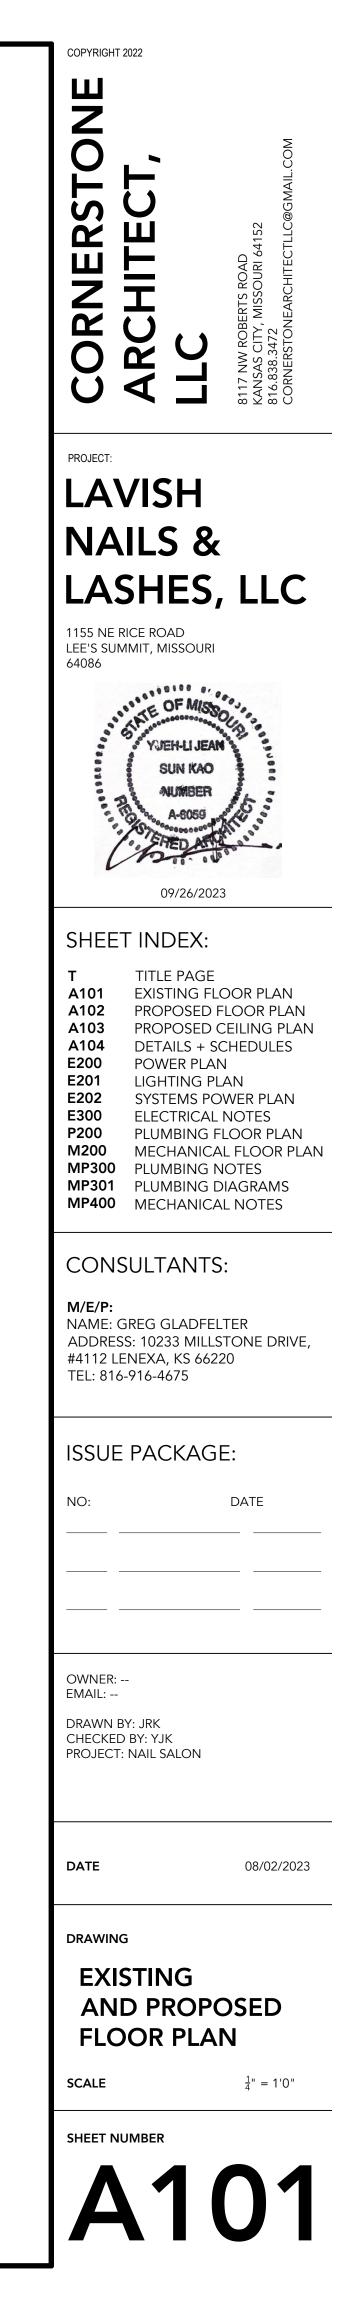


PROPOSED FLOOR PLAN $01 \frac{r}{sc}$

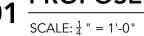

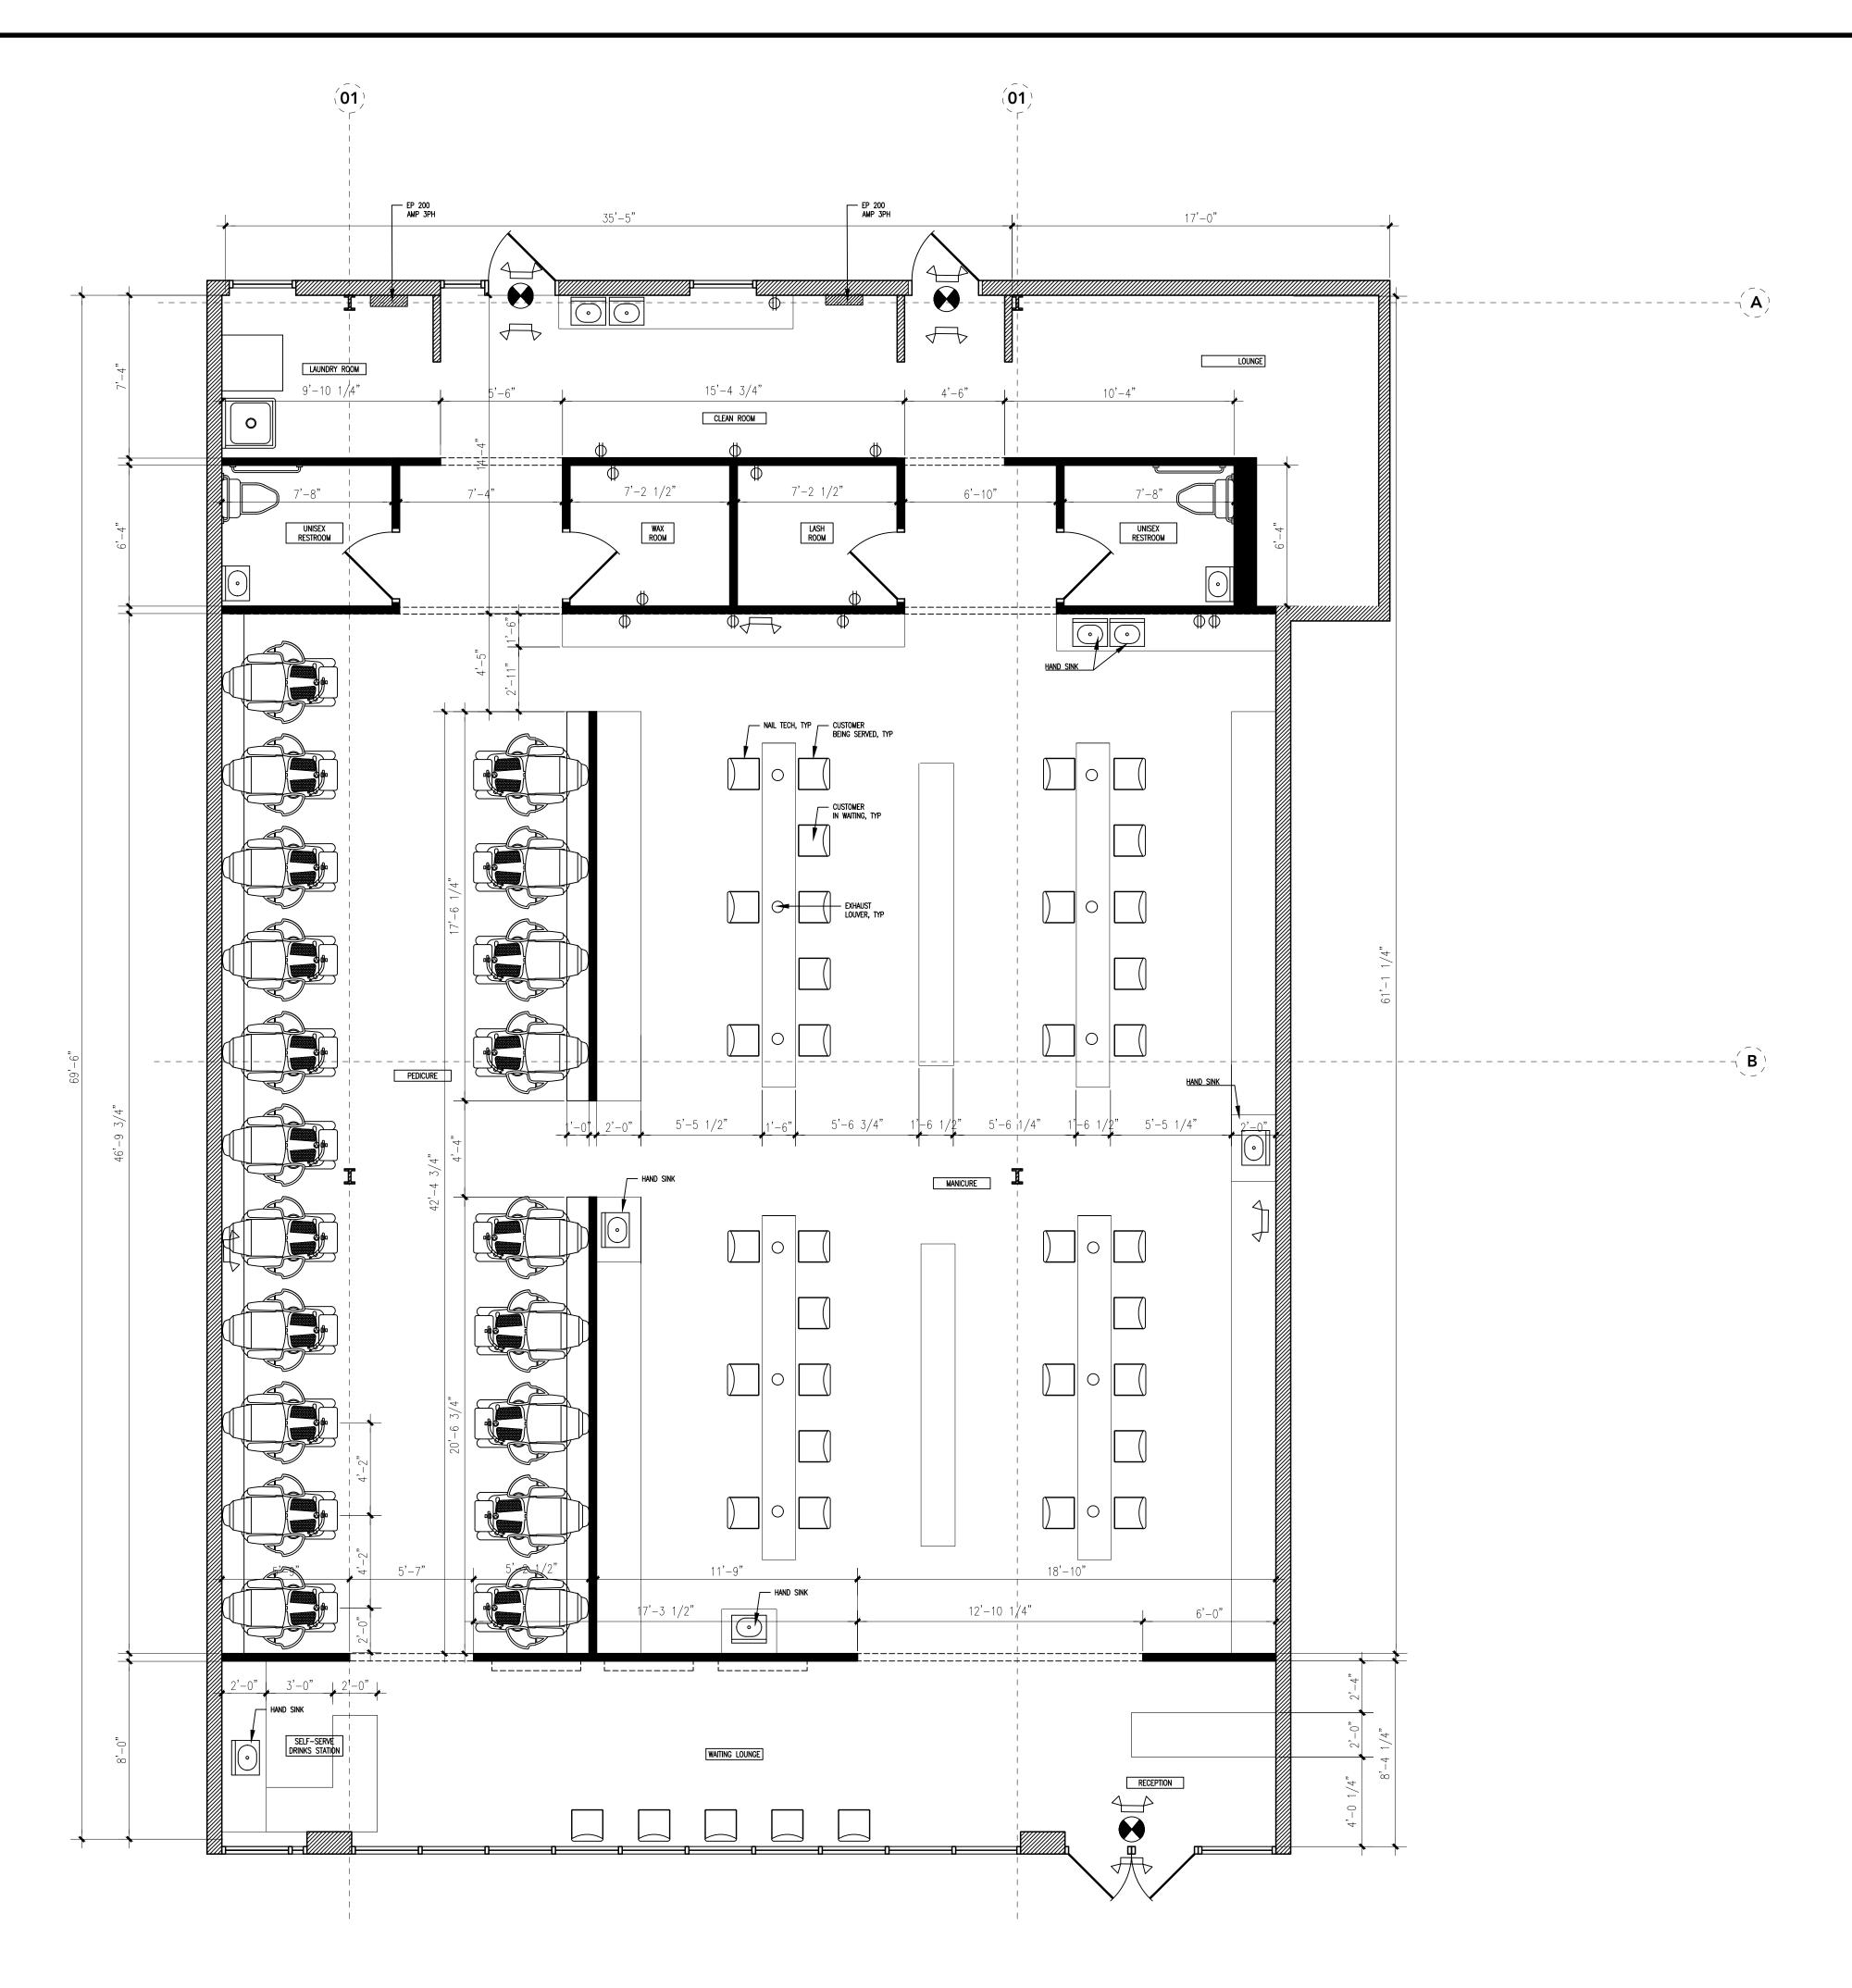


02 PLAN NOTES

- CABINETRY BY OWNERS REQUEST. TOP OF COUNTER @34" AFF ADA HAND SINK. SEE SHEET T FOR MOUNTING HEIGHT.
- EXHAUST DUCT ABOVE NAIL STATIONS AND PEDICURE STATIONS EXHAUSTING ODOR AT SOURCE 50 CFM EACH VIA EXHAUST FAN THROUGH ROOF. FINALIZED LOCATION OF CHASE WITH OWNER.
- 4. SIGN 'THIS DOOR SHALL BE REMAIN UNLOCK DURING BUSINESS HOURS' 5. NAIL DRYER BATTERY POWER, TABLE TOP MODEL

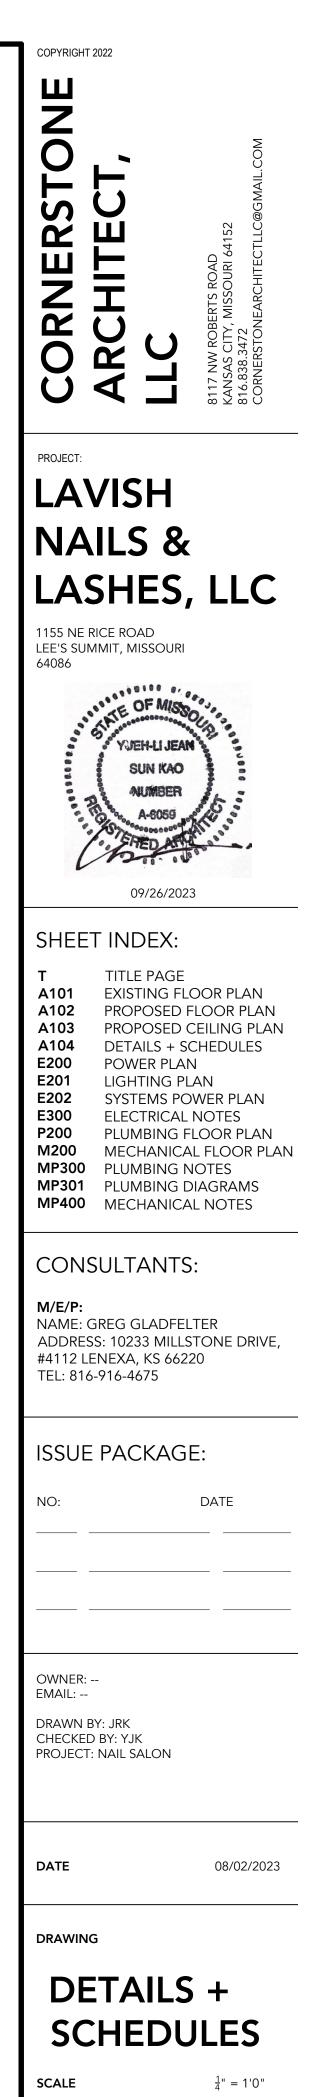


SHEET NUMBER


A102

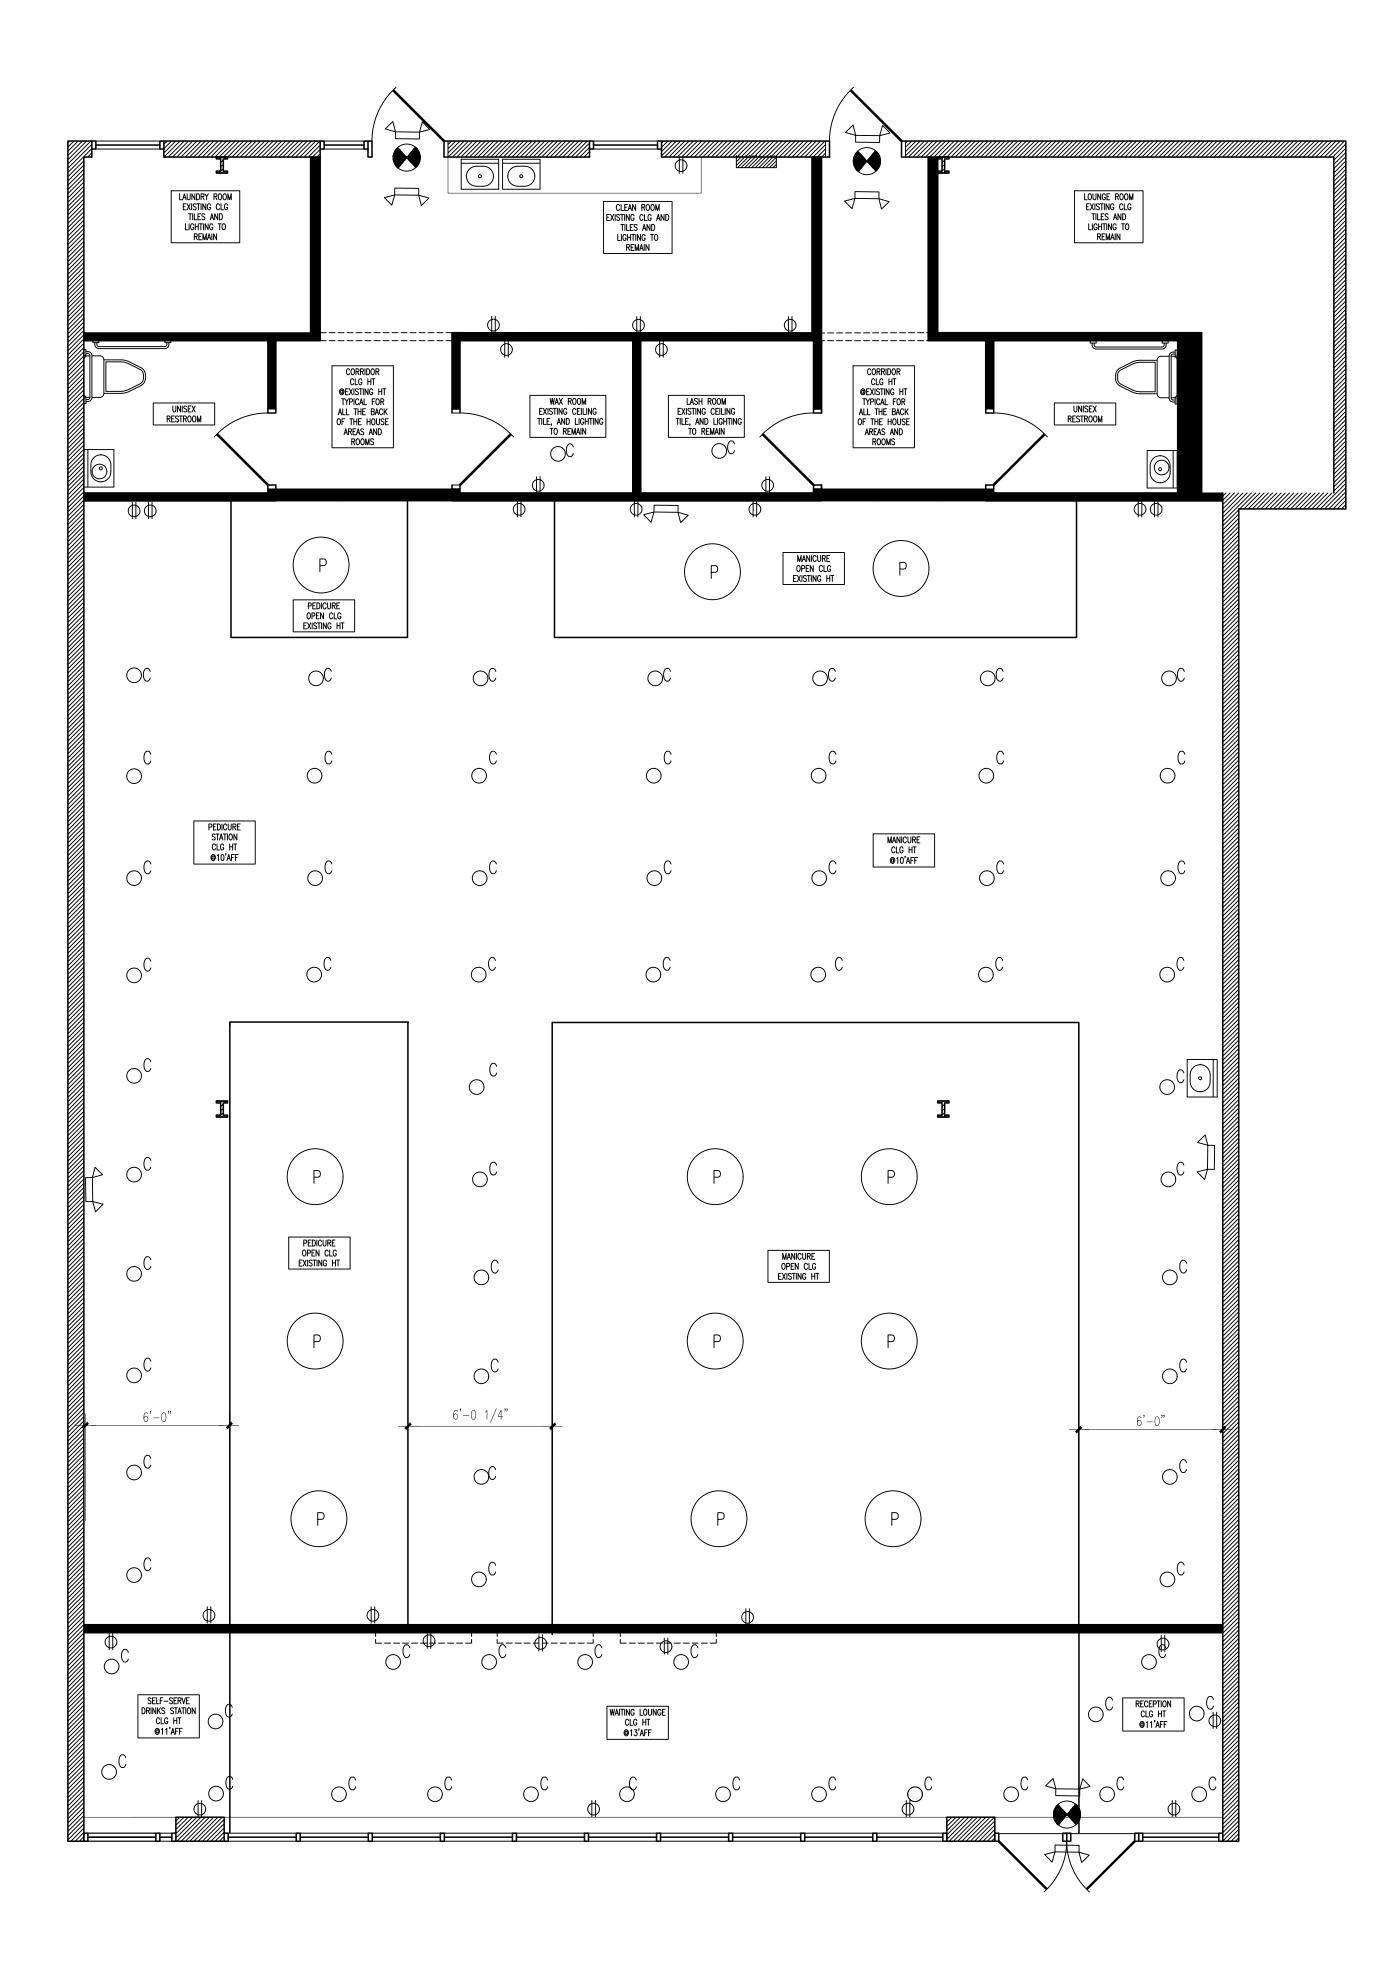

01 REFLECTIVE CEILING PLAN

SCALE: $\frac{1}{4}$ " = 1'-0"

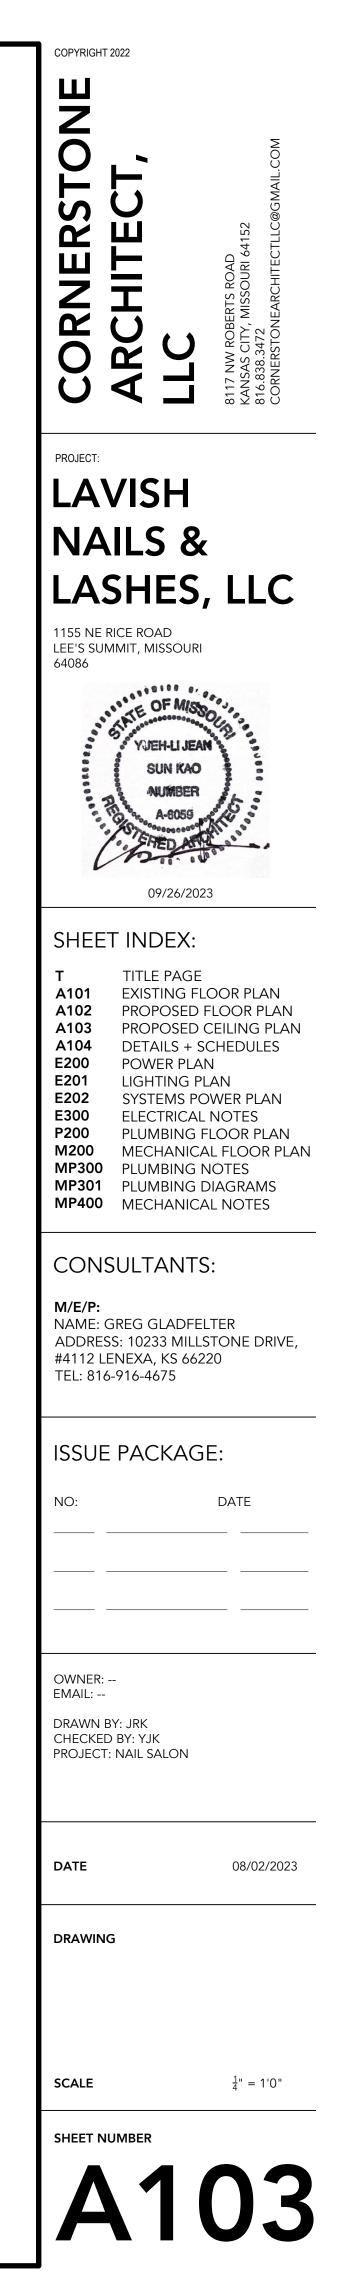

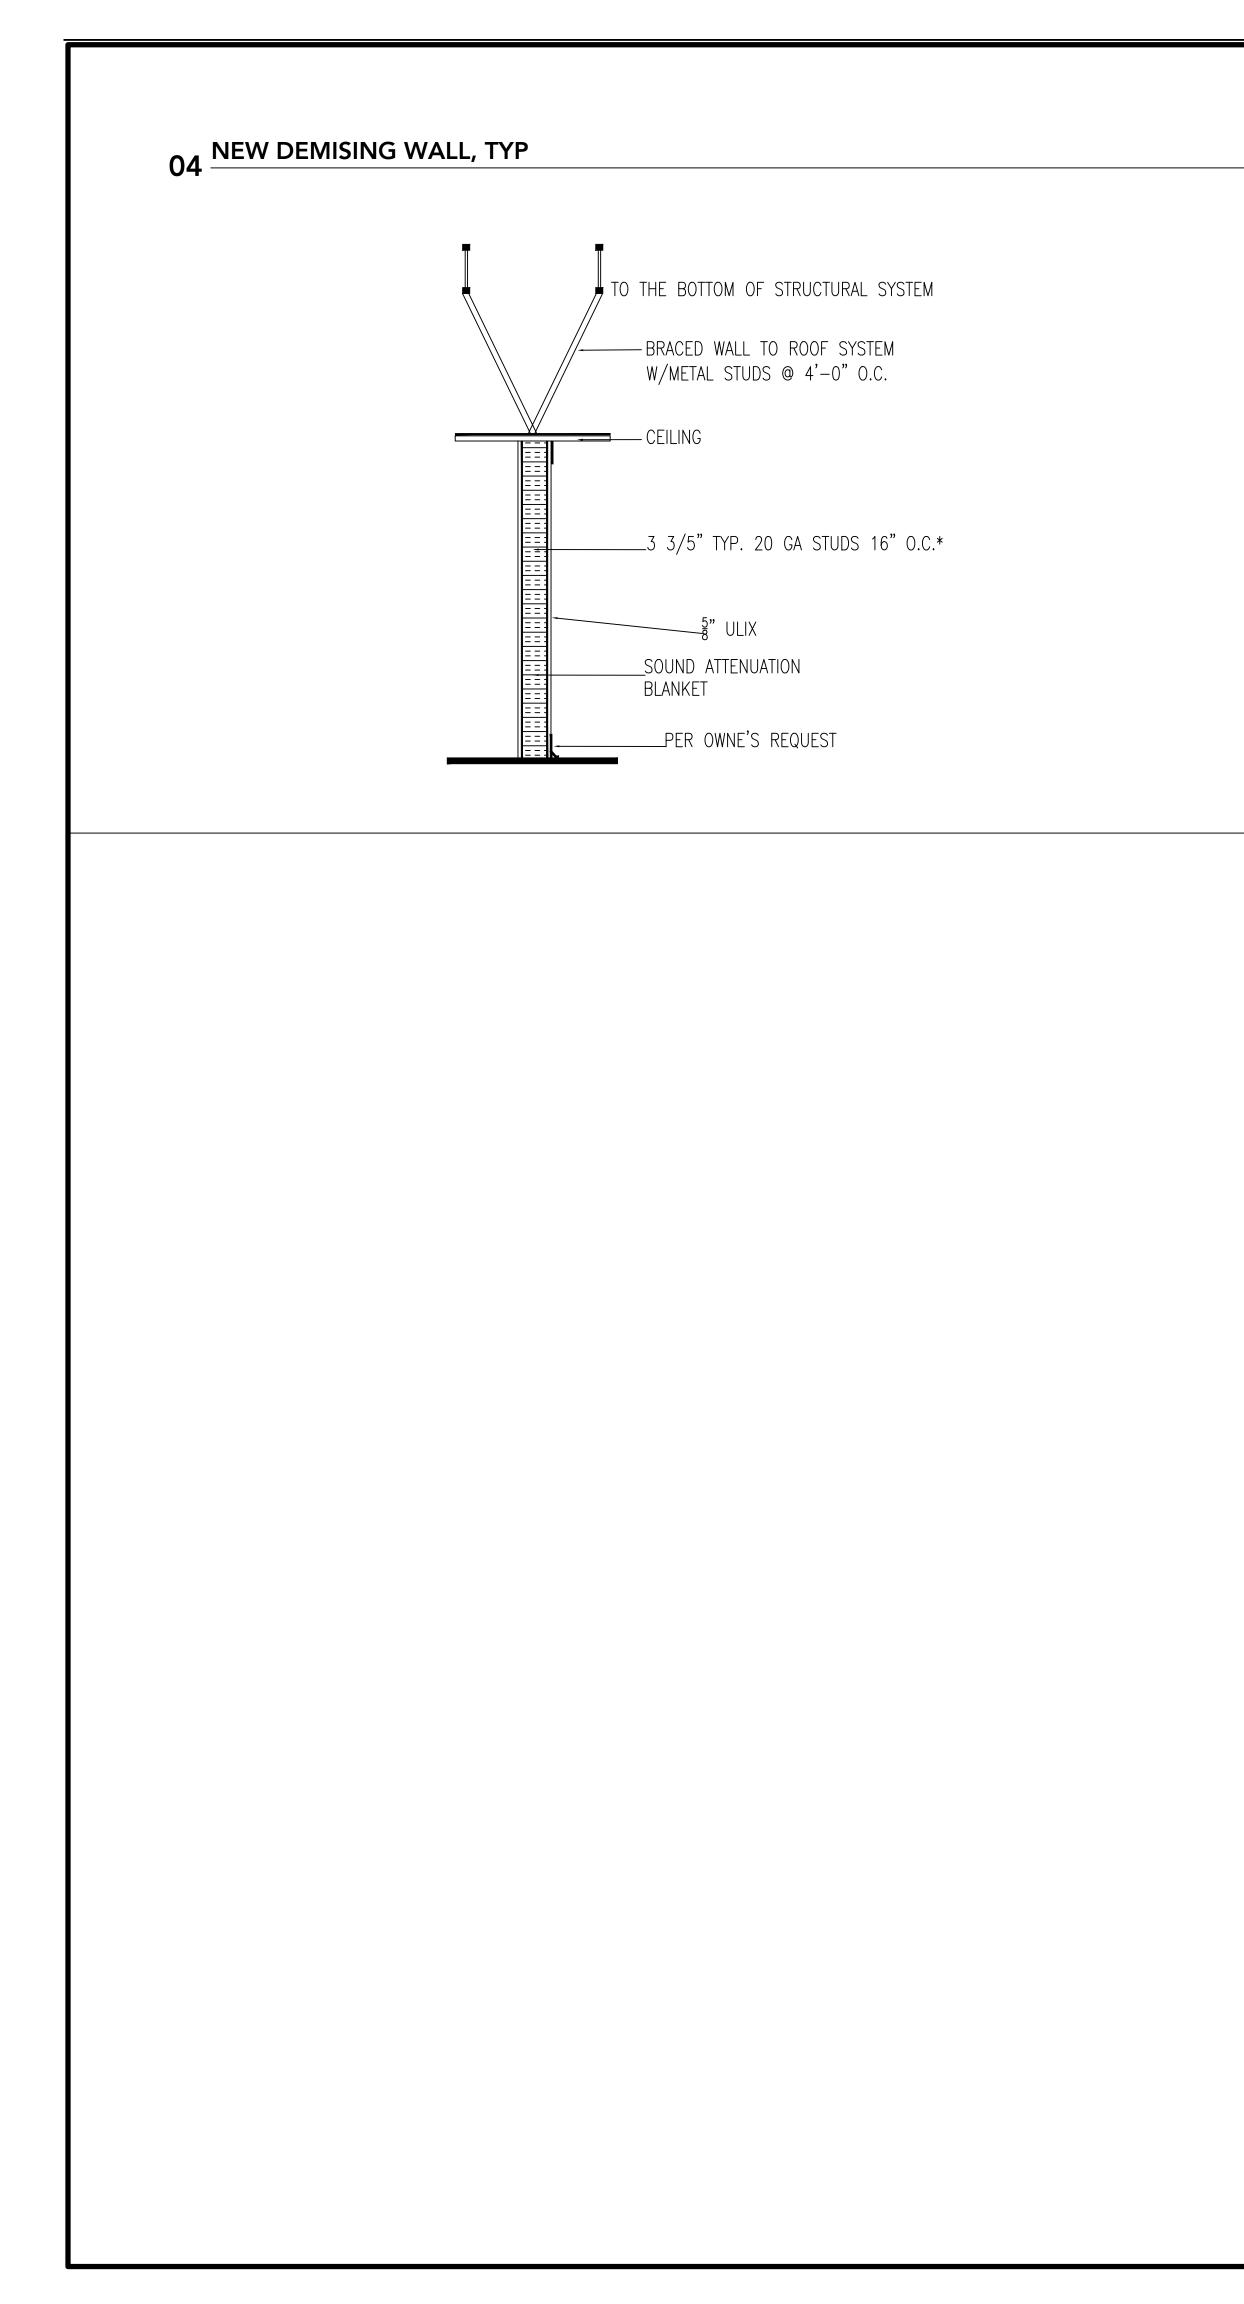

01 PEDICURE CHAIR SPECIFICATIONS

WEIGHT – 250 LBS

DIMENSIONS – 53"L X 30"W X 54"H ULTRA CLEANJET™ 1/5HP 120V 2AMP 60HZ. DISCHARGE PUMP 110V 5.5AMP 60HZ. MUST MEET LOCAL CODES. GROUND FAULT INTERRUPTER REQUIRED. TUB CAPACITY – 5 US GALLON.

CERTIFICATIONS - CSA (CANADIAN STANDARDS ASSOCIATION) APPROVED & UL LISTED.

DRAIN SOURCE – 1–1/4" DRAIN. 1/2" IF DISCHARGE INSTALLED. MUST MEET LOCAL PLUMBING CODES USING SCHEDULE 40 DRAIN PIPE AND APPROPRIATE TRAPS. WATER SOURCE – 1/2" PIPE THREAD FITTING HOT AND COLD. MUST MEET LOCAL PLUMBING CODES. NORMAL WATER PRESSURE OF 30 – 120 PSI

REQUIRED. ELECTRICAL – 2 WHIRLPOOL ULTRA CLEANJET™ 1/5HP 120V 2AMP 60HZ. DISCHARGE PUMP 110V 5.5AMP 60HZ. MUST MEET LOCAL CODES. GROUND FAULT INTERRUPTER REQUIRED. 50CFM EXHAUST BUILT-IN.

02 INTERIOR FINISH SCHEDULE

INTERIOR FINISH	SCHEDULE, EXISTING TO REMAIN	
ROOM	FLOOR	CEILING
PED/NAIL AREA	CERAMIC TILE W/MATCHING COVE BASE	GYP BOARD / OPEN C
DRINK COUNTER	CERAMIC TILE W/MATCHING COVE BASE	GYP BOARD
REST ROOM	CERAMIC TILE W/MATCHING COVE BASE	2X4 LAY-IN CLIMAPLU
WASH ROOM CLEAN ROOM BRAKE ROOM	CERAMIC TILE W/MATCHING COVE BASE	EXISTING 2X4 LAY—IN CT,

INTERIOR WALL AND CEILING FINISH MATERIALS SHALL COMPLY WITH IBC 2018 CHAPTER 803.1 AND TESTED IN ACCORDANCE WITH NFPA 286.

03 DOOR SCHEDULE

DOOR SCHEDULE, EXISTING TO	REMAIN	
ROOM	MATERIAL	SIZE
EXISTING FRONT EXIT DOOR	STORE FRONT ALUMN	6'-0" x 7'-0"
EXISTING REAR EXIT DOOR	HOLLOW MTL	6'-0" x 7'-0"
WAX DOOR	WOOD-SC, MTL FRAME, PREHUNG	3'-0" x 6'-8"
RESTROOM DOOR	WOOD-SC, MTL FRAME, PREHUNG	3'-0" x 6'-8"

DOOR NOTES:

1. LATCH SIDE CLEARANCES AT ALL DOORWAYS SHALL BE IN ACCORDANCE W/ A 117.1 AND IN COMPLIANCE WITH IBC 2018 1008 AND 1010.1.99

2. ALL EXITS TO BE LABELED.

3. INTERIOR TO BE LABELED AS TO INTENDED USE.

4. PANIC HARDWARE ON ALL EXTERIOR DOORS


5. THE OPERATING DEVICE ON ALL DOORS SHALL BE CAPABLE OF OPERATION WITH ONE HAND AND SHALL NOT REQUIRE TIGHT GRASPING, TIGHT PINCHING OR TWISTING OF THE WRIST TO OPERATE. 6. LANDING SHALL BE PROVIDED AT EVERY REQUIRED EXIT AND THEY SHALL BE A MINIMUM OF 36 INCHES


IN WIDTH AND 44 INCHES LONG IN THE DIRECTION OF TRAVEL.

	WALL
CEILING	2-COATS OF WASHABLE PAINT
	2–COATS OF WASHABLE PAINT/TILE/SS
S CT OR EQUAL	TILE TO 6' AFF & WASHABLE PAINT
	2-COATS OF WASHABLE PAINT

REMARKS-HEAVY DUTY COMMERCIAL, ANSI, ADA
CLOSER, PUSH/PULL PLATE, LOCK
CLOSER, PUSH PANIC BAR
TIGHT FITTING, CLOSER, PRIVACY LOCK SET
TIGHT FITTING, CLOSER, PRIVACY LOCK SET

<section-header> COPARIER STORMER STORM</section-header>
PROJECT: LAVISH NAILS &
LASHES, LLC
64086
09/26/2023SHEET INDEX:TTITLE PAGEA101EXISTING FLOOR PLANA102PROPOSED FLOOR PLANA103PROPOSED CEILING PLANA104DETAILS + SCHEDULESE200POWER PLANE201LIGHTING PLANE202SYSTEMS POWER PLANE300ELECTRICAL NOTESP200PLUMBING FLOOR PLANM200MECHANICAL FLOOR PLANMP300PLUMBING DIAGRAMSMP400MECHANICAL NOTES
CONSULTANTS: M/E/P: NAME: GREG GLADFELTER ADDRESS: 10233 MILLSTONE DRIVE, #4112 LENEXA, KS 66220 TEL: 816-916-4675
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DATE 08/02/2023
DETAILS + SCHEDULES
SCALE <u>1</u> " = 1'0" SHEET NUMBER Д 1 0 4

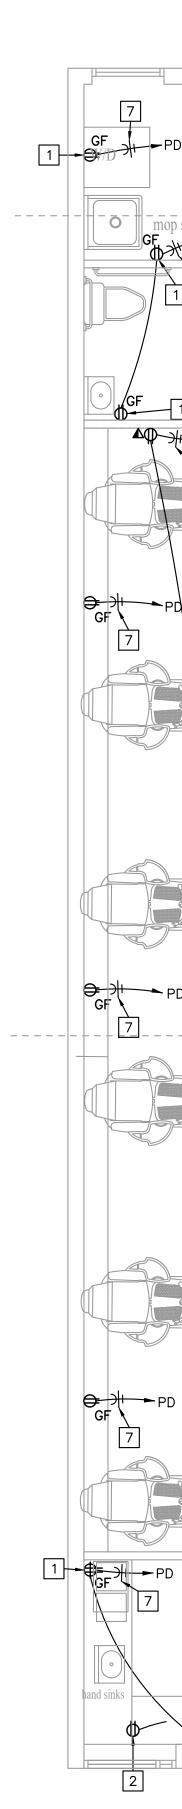

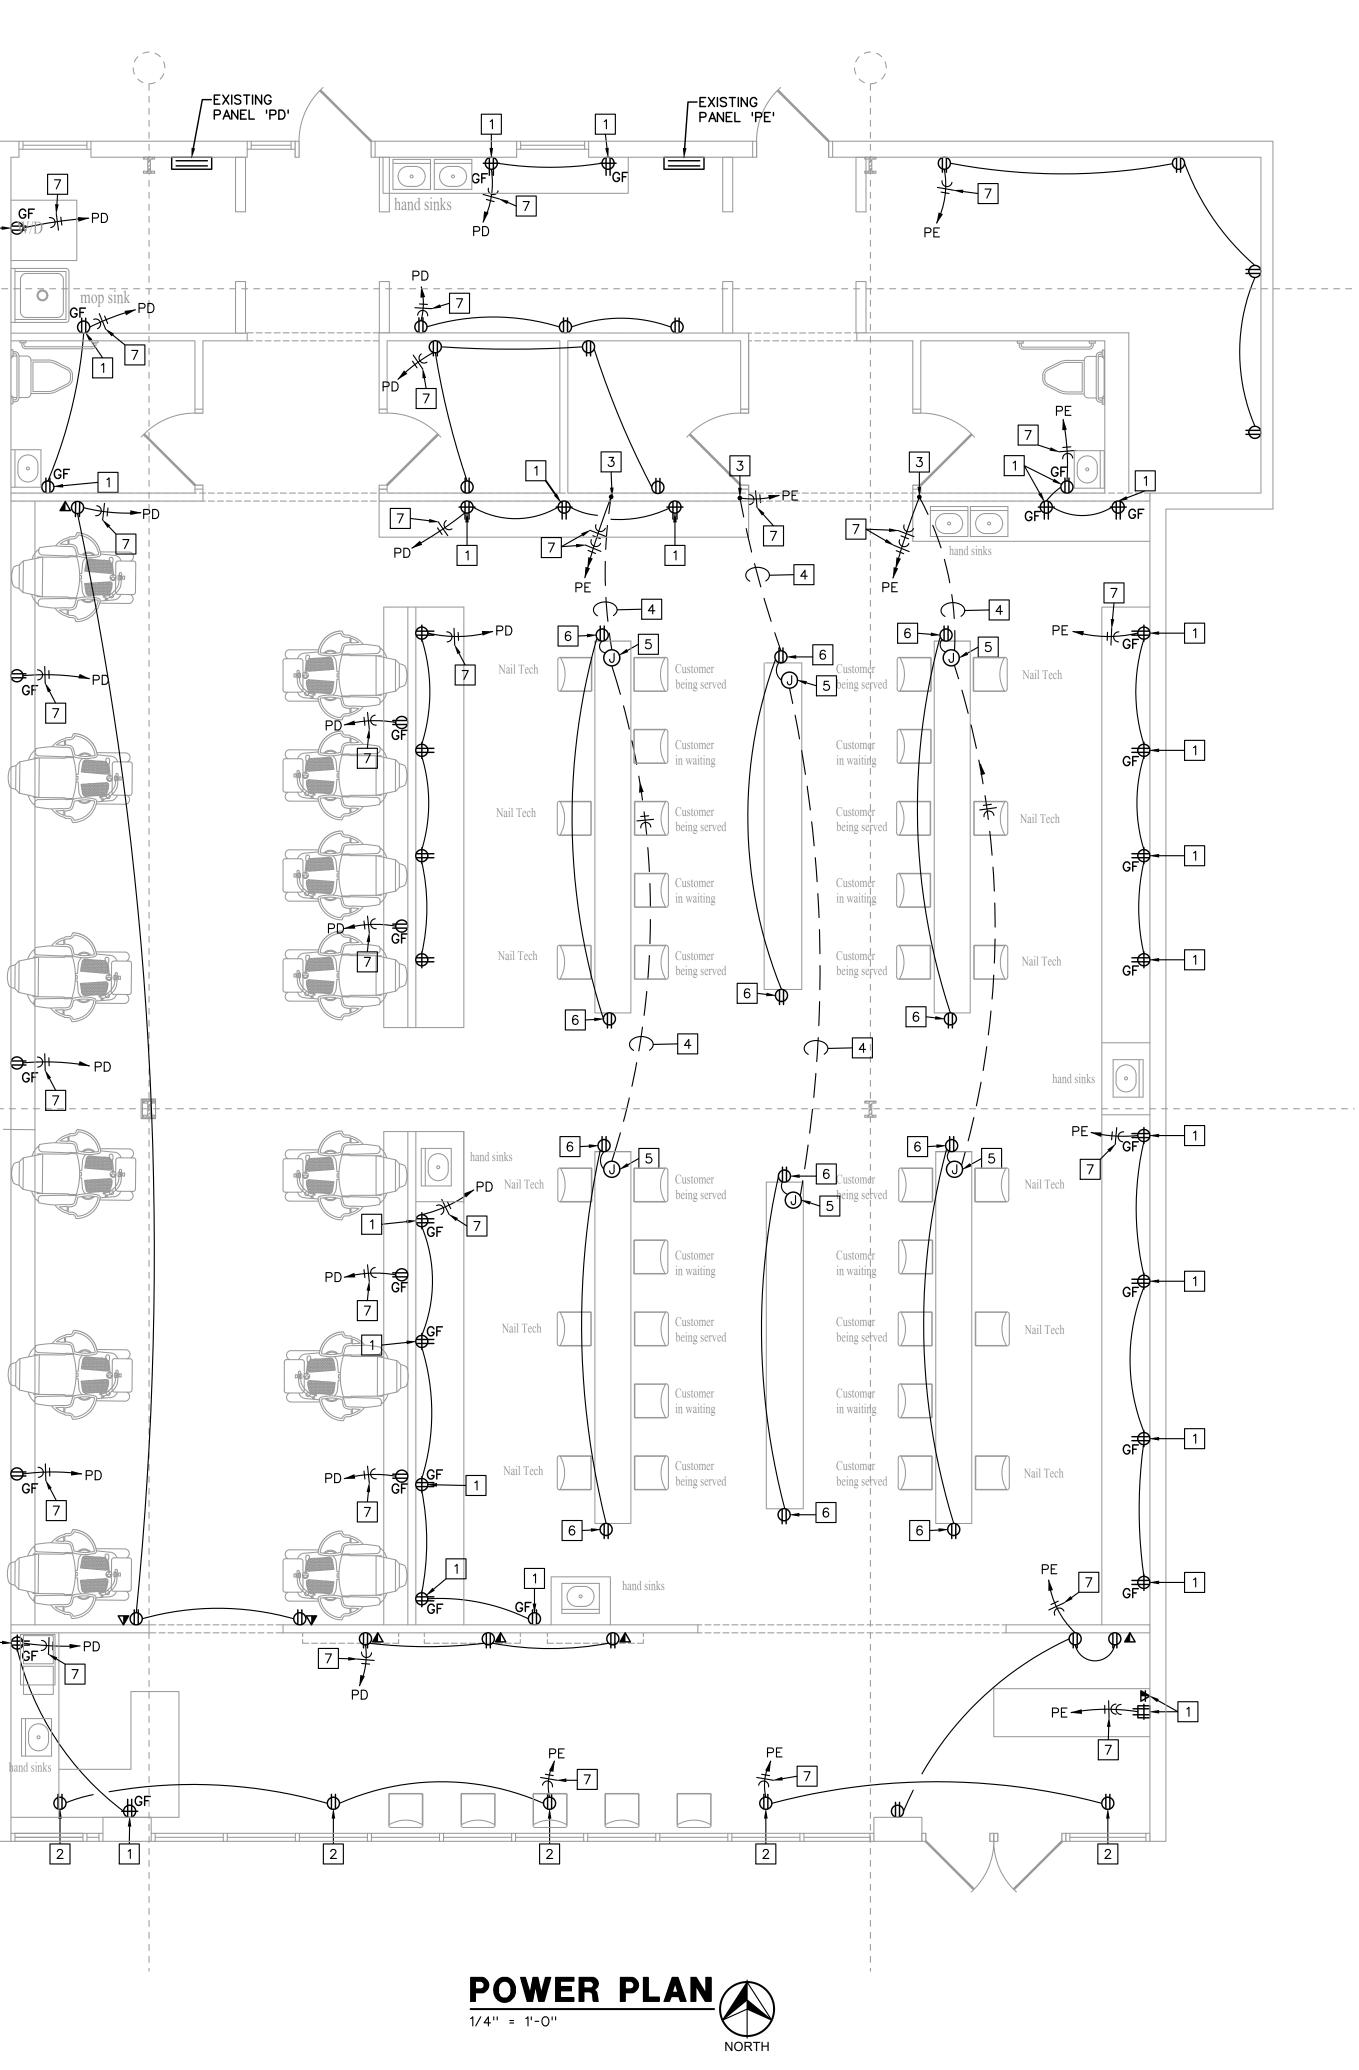


POWER PLAN NOTES 🖅 :


- 1. INSTALL OUTLET BOX FOR WIRING DEVICE AT 42" AFF.
- 2. SHOW-WINDOW RECEPTACLE INSTALLED ON WALL OR IN CEILING ABOVE WINDOW WITHIN 12" OF WINDOW OPENING PER NEC.
- 3. 3/4" CONDUIT UP IN WALL TO ABOVE ACCESSIBLE CEILING.
- 4. SAW-CUT EXISTING FLOOR AND INSTALL (1) NEW 3/4" PVC CONDUIT TO JUNCTION BOX IN COUNTER. PATCH AND REPAIR FLOOR BACK TO EXISTING CONDITIONS.
- 5. J-BOX INSTALLED IN COUNTER FOR CONNECTION OF RECEPTACLES IN COUNTER. VERIFY EXACT LOCATION WITH TENANT/ARCHITECT PRIOR TO INSTALLATION.
- 6. RECEPTACLE INSTALLED IN COUNTER. VERIFY EXACT HEIGHT AND LOCATION WITH TENANT/ARCHITECT PRIOR TO INSTALLATION.
- 7. ROUTE HOMERUN TO PANEL INDICATED AND CONNECT TO SPARE 20A/1P CIRCUIT BREAKER MADE AVAILABLE DUE TO DEMOLITION.

Gladfelter Engineering Group assumes design responsibility for this project for only the mechanical, plumbing and electrical disciplines with drawing sheet number beginning with M, P and E. All other drawings should be considered the work of others. Further, drawings in this project set may contain drawing information, including but not limited to: architectural plans, sections and elevations, site plans and surveys and other information pertinent to showing the mechanical, plumbing and electrical work which is furnished by others, generally indicated by screened or light type. Gladfelter Engineering Group assumes no responsibility or liability for the accuracy or regulatory compliance for work prepared by others even though shown on MPE drawings. Gladfelter Engineering Group assumes responsibility only for the design of mechanical, plumbing and electrical disciplines contained herein, generally indicated in bold type.





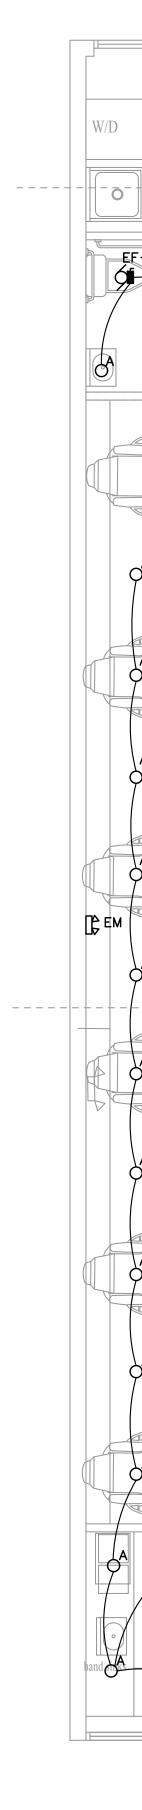


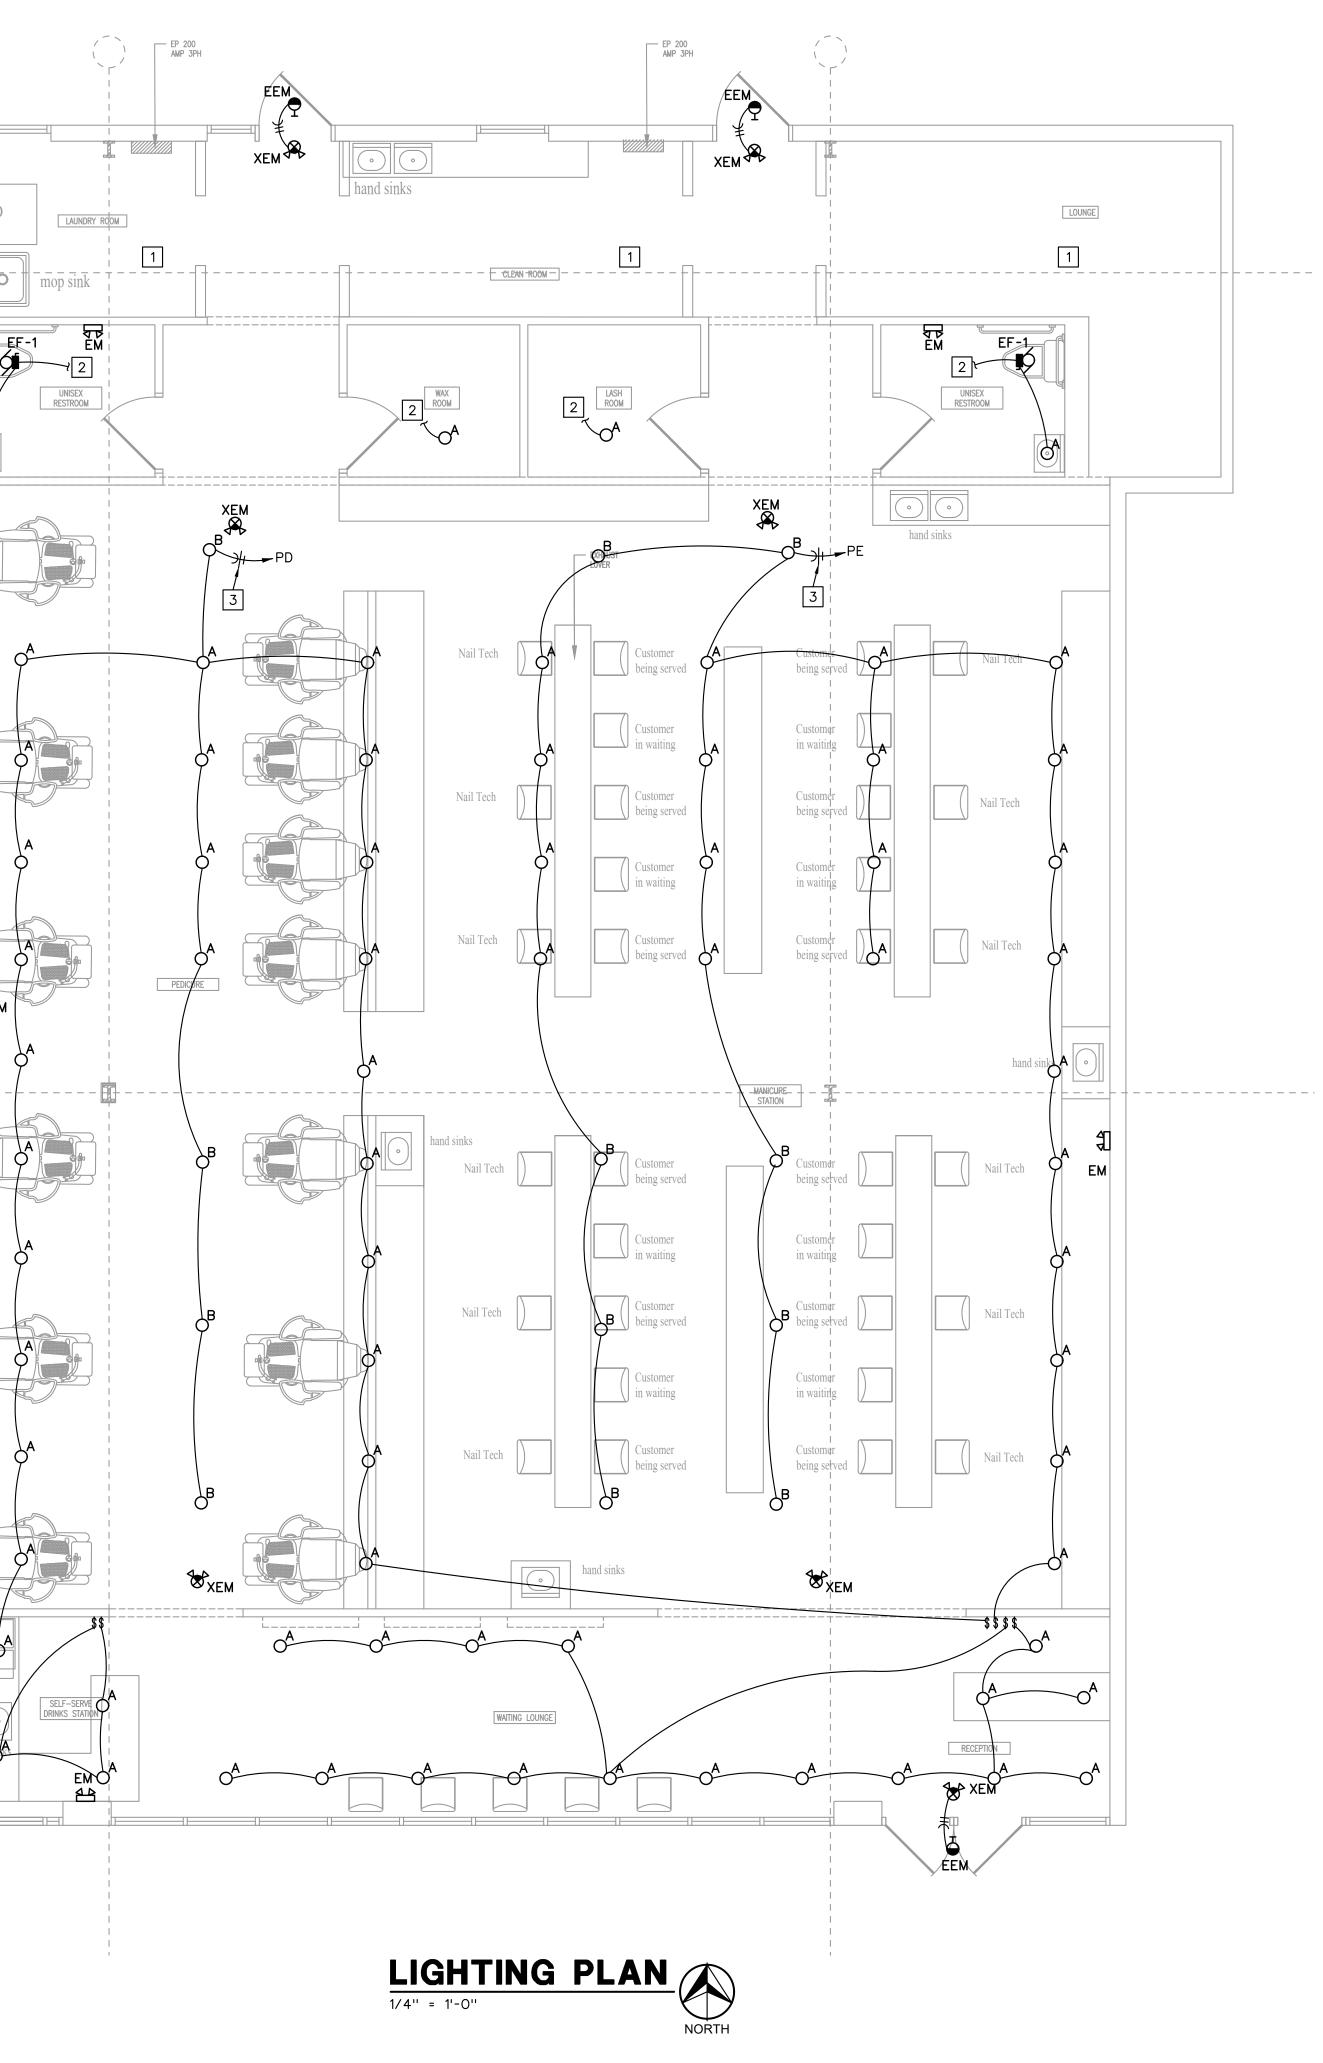

LIGHTING PLAN NOTES


- 1. ALL LIGHT FIXTURES IN THIS AREA ARE EXISTING TO REMAIN UNLESS NOTED OTHERWISE.
- 2. CONNECT TO EXISTING LIGHT FIXTURE IN THIS AREA AND CONTROL IN A SIMILAR MANNER.
- 3. ROUTE HOMERUN TO PANEL INDICATED AND CONNECT TO SPARE 20A/1P CIRCUIT BREAKER MADE AVAILABLE DUE TO DEMOLITION.

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SALO NE Rice SUMMIT

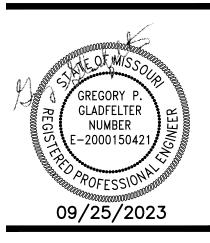LEE'S Group 3.33 Millstone Drive, #4111 Lenexa, Kansas 66220 Phone: 816-916-4675 Final ana@neconsort com Engineering ladfelter **D** Date: lssued for: 09/25/23 PERMIT Project number: 23-211 Drawn: JEE/SWB/GPG Date: 2023/09/22 Sheet Number: E201



PD LAUNDRY RCOM	H	EP 200 AMP 3PH		UNGE
mop sink	CLEAN FROOM	LASH ROOM		
	Nail Tech	EXHAUST LUVER	Customer being served	
	Nail Tech	Customer in waiting Customer being served Customer in waiting Customer in waiting Customer being served	Customer in waiting Customer being served Customer in waiting Customer in waiting Customer in waiting Customer in waiting Nail Tech Nail Tech	
	4-TON 11.3 KW FCU-3 hand sinks Nail Tech PD 4 PD		ATTON 4-TON 13.5 KW FCU-2 hand sinks Customer being selved	
	EF Nail Tech	Customer in waiting Customer being served Customer in waiting	Customer in waiting Customer being served Customer in waiting Customer in waiting	
	Nail Tech	hand sinks	Customer being selved	
	SYSTEMS P 1/4" = 1'-0"	OWER PLAN	NORTH	

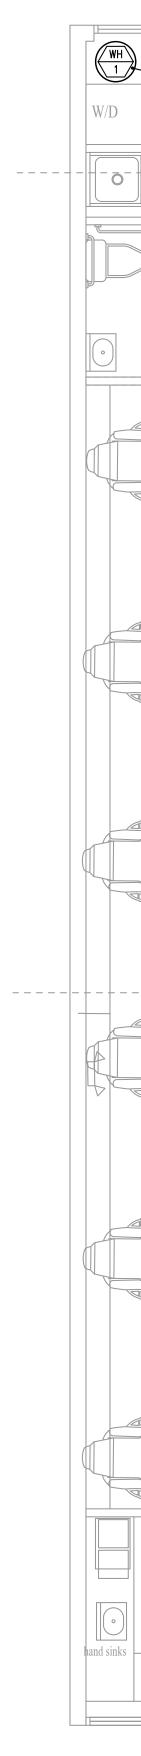SYSTEMS POWER PLAN NOTES

- 1. EXISTING DISCONNECT SWITCH TO REMAIN.
- 2. EXISTING CIRCUIT TO REMAIN.


- 20A/1P, HORSEPOWER RATED TOGGLE SWITCH INSTALLED ON UNIT FOR DISCONNECTING MEANS. DO NOT INSTALL ON ACCESS PANEL.
- 4. ROUTE HOMERUN TO PANEL INDICATED AND CONNECT TO SPARE 20A/1P CIRCUIT BREAKER MADE AVAILABLE DUE TO DEMOLITION.
- 5. ROUTE HOMERUN TO PANEL INDICATED AND CONNECT TO SPARE 30A/2P CIRCUIT BREAKER MADE AVAILABLE DUE TO DEMOLITION. 3/4'' CONDUIT WITH 2-#10 (CU) AND 1-#10 (CU) EQUIPMENT GROUNDING CONDUCTOR.

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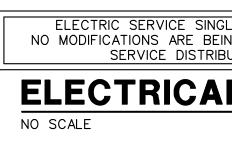


CIRCUIT	WIRE	MAXIMUM CIRCUIT LEN 2 WIRE, 1 PHASE			GTH IN F 3 WIRE,	
AMPERES	SIZE	120 V	240 V	277 V	208 V	480 V
20	#12	60	125	145	125	285
25	#10	80	160	180	160	365
30	#10	65	130	150	130	305
50	#6	95	195	225	195	450
60	#6	80	160	185	160	375
100	#3	95	195	225	195	450
125	#1	125	250	285	250	575
200	3/0	155	310	360	310	725
 NOTES: 1. ALL CONDUCTORS ARE SOLID COPPER. APPLICATION OF CONDUCTOR SIZE IS LIMITED TO CONDUCTORS WITH THE FOLLOWING INSULATION TYPES: FEPW, RH, RHW, THHW, THW, THWN, XHHW, AND USE. 75°C (167°F). 2. CIRCUIT LENGTH IS THE ONE WAY DISTANCE FROM THE OVER CURRENT PROTECTION DEVICE TO THE POINT OF 						

3. IF THE INSTALLED CIRCUIT LENGTH EXCEEDS THE INDICATED MAXIMUM CIRCUIT LENGTH INDICATED, THEN THE CONDUCTORS SHALL BE INCREASED ONE NOMINAL WIRE SIZE.

	LIGHT FIXTURE	SCHEDULE	
TYPE	MANUFACTURER	LAMP	<u>VOLTS</u> WATTS
Α	6" ROUND CAN LIGHT FIXTURE SELECTED BY TENANT/ARCHITECT	LED	<u>120</u> 20
В	CHANDELIER LIGHT FIXTURE SELECTED BY TENANT/ARCHITECT	LED	<u>120</u> 80
ЕМ	EXITRONIX #LED90	(2) LED HEADS WITH UNIT	<u>120</u> 10
EEM	EXITRONIX #MLED	WEATHERPROOF LED REMOTE	<u>6</u> 8
ХЕМ	EXITRONIX #VLED-1-WH-EL90-R	RED LED AND (2) LED HEADS WITH UNIT	<u>120</u> 15
х	EXITRONIX #VEX-U-BP-WB-WH-120	RED LED WITH UNIT	<u>120</u> 5
X2	EXITRONIX #VEX-U/2-BP-WB-WH-120	RED LED WITH UNIT	<u>120</u> 5
	<u>3:</u> ?PE 'X' AND/OR 'XEM' FIXTURES SHALL HAVE 12 ?PE 'EEM'.	WATTS OF REMOTE CAPACITY	AND POWER

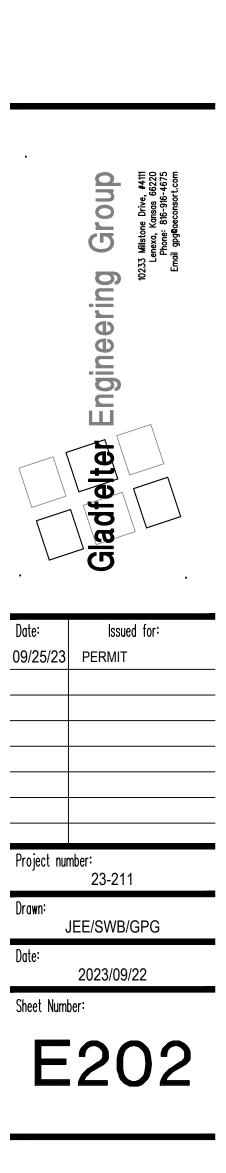 ►►►	BRANCH CIRCUIT CONCEALED IN CEILING OR WALL. ARROWS INDICATE HOMERUNS TO PANEL. ALL CONDUCTORS ARE #12 EXCEPT AS NOTED.
— III —	CONDUIT RUN UNDERGROUND OR BENEATH FLOOR SLAB.
	GROUNDING CONDUCTOR #12 EXCEPT AS NOTED.
Ю	WALL MOUNTED JUNCTION BOX.
\bigcirc	CEILING MOUNTED JUNCTION BOX.
	PANELBOARD (SURFACE MOUNTED). INSTALL W/TOP 6'-0'' AFF.
	DISCONNECT SWITCH. SIZED AS NOTED.
■ n	DISCONNECT SWITCH FURNISHED WITH EQUIPMENT.
\$	SINGLE POLE SWITCH. +3'-10" AFF.
⇔	DUPLEX RECEPTACLE. +1'-6" AFF OR AS NOTED.
+	DUPLEX RECEPTACLE INSTALLED ABOVE COUNTERTOP.
\oplus^{WP}	DUPLEX RECEPTACLE WITH WEATHERPROOF PLATE. HEIGHT AS NOTED.
€GF	DUPLEX RECEPTACLE W/GROUND FAULT PROTECTION. +1'-6'' AFF OR AS NOTED.
Ē	FOURLEX RECEPTACLE. +1'-6" AFF OR AS NOTED.
₽ E	FOURPLEX RECEPTACLE INSTALLED ABOVE COUNTERTOP.
ŧ	HEAVY DUTY RECEPTACLE. VOLTAGE, PHASE AND AMPS AS NOTED. +1'-6'' AFF OR AS NOTED.
4	COMBINATION VOICE/DATA OUTLET WITH 3/4" CONDUIT STUBBED UP OUT OF BOX TO ABOVE ACCESSIBLE CEILING. +1'-6" AFF OR AS NOTED.
4	COMBINATION VOICE/DATA OUTLET WITH 3/4" CONDUIT STUBBED UP OUT OF BOX TO ABOVE ACCESSIBLE CEILING. INSTALLED ABOVE COUNTERTOP.
+3'-10''	HEIGHT TO CENTERLINE OF OUTLET BOX ABOVE FINISHED FLOOR.
WH-1	ELECTRIC WATER HEATER AND NUMBER.
EF-1	EXHAUST FAN AND NUMBER.
CU-1	CONDENSING UNIT AND NUMBER.
F-1	FURNACE AND NUMBER.
AFF	ABOVE FINISH FLOOR.
ETR	EXISTING TO REMAIN.
ER	EXISTING RELOCATED.
EC	ELECTRICAL CONTRACTOR.
EGC	EQUIPMENT GROUNDING CONDUCTOR.
GEC	GROUNDING ELECTRODE CONDUCTOR.
MBJ	MAIN BONDING JUMPER.



E	_ECTRICAL GENERAL NOTES
1.	CONTRACTOR SHALL COORDINATE INSTALLATION REQUIREMENTS AND SCHEDULING OF ALL WORK WITH BUILDING REPRESENTATIVE AND GENERAL CONTRACTOR.
2.	INSTALLATION SHALL COMPLY WITH LATEST EDITION OF N.E.C. AND LOCAL AUTHORITY HAVING JURISDICTION.
3.	CONTRACTOR SHALL BE LICENSED TO PERFORM WORK IN MUNICIPALITY WHERE PROJECT IS LOCATED.
4.	ALL WIRING SHALL BE INSTALLED IN CONDUIT. EMT CONDUIT WITH SET SCREW FITTINGS MAY BE UTILIZED WHERE PERMITTED BY CODE. MINIMUM CONDUIT SIZE SHALL BE 1/2".
5.	ALL WIRING SHALL BE COPPER WITH 600 VOLT INSULATION AND COLOR CODED.
6.	CONTRACTOR SHALL OBTAIN AND PAY FOR ALL PERMIT AND INSPECTION FEES.
7.	MC CABLE MAY BE INSTALLED WHERE PERMITTED BY CODE CONCEALED IN WALLS AND FOR CONNECTIONS TO LIGHT FIXTURES (MAXIMUM LENGTH 6'-0''). CONDUCTORS SHALL BE MINIMUM #12 GAUGE AND COPPER. MC CABLE SHALL NOT BE USED FOR HOMERUNS.
8.	INSTALL BLANK COVER PLATE ON ALL PULL BOXES AND JUNCTION BOXES.
9.	TYPEWRITTEN PANELBOARD DIRECTORY SHALL BE PROVIDED FOR PANELBOARD AND CORRECTLY FILLED OUT.
10.	CONTRACTOR SHALL COORDINATE INSTALLATION OF ELECTRICAL WORK WITH ALL OTHER TRADES INVOLVED WITH CONSTRUCTION OF PROJECT.
11.	ALL WIRING DEVICES SHALL BE RATED 20 AMP, OR AS NOTED.
12.	ALL NEW BRANCH CIRCUIT CONDUITS SHALL BE INSTALLED CONCEALED ABOVE LAY-IN CEILING OR IN WALLS.
13.	CONTRACTOR SHALL FIELD VERIFY EXACT ROUTING OF ALL CONDUITS TO NEW EQUIPMENT.
14.	VOICE/DATA SYSTEMS, ASSOCIATED WIRING, AND DEVICES TO BE PROVIDED BY OWNER.
15.	DISCONNECT SWITCHES SHALL BE HEAVY DUTY TYPE, NEMA 1 FOR INDOOR AND NEMA 3R FOR OUTDOOR INSTALLATIONS. MANUFACTURED BY SQUARE D, ITE/SIEMENS, GE, OR CUTLER-HAMMER.
16.	FURNISH MATERIALS AND LABOR FOR A COMPLETE AND OPERATIONAL ELECTRICAL INSTALLATION.
17.	MATERIAL AND EQUIPMENT SHALL BE NEW AND SHALL BEAR THE 'UL' LABELS AS REQUIRED.
18.	E.C. SHALL VERIFY RATINGS, LOCATIONS, AND CONNECTIONS OF ALL EQUIPMENT PROVIDED BY OTHERS AND INSTALLED AND/OR CONNECTED BY THE ELECTRICAL CONTRACTOR.
19.	E.C. SHALL VERIFY ALL CONDITIONS PRIOR TO ANY ROUGH-IN.
20.	ALL CHANGES BY E.C. TO ITEMS SPECIFIED ON DRAWINGS MUST BE APPROVED IN WRITING BY ENGINEER/ARCHITECT OR OWNER AT LEAST (10) TEN DAYS PRIOR TO PROJECT BID DATE.
21.	E.C. SHALL PROVIDE AND INSTALL SMOKE AND FIRE STOPS AT ALL CONDUIT PENETRATIONS OF SMOKE AND FIRE-RATED WALLS AND CEILINGS.
22.	CAULK AND SEAL ALL RACEWAY PENETRATIONS OF EXTERIOR OR DEMISING WALLS.
23	THE CONTRACTOR SHALL TAKE CARE TO MAINTAIN THE INTEGRITY OF ALL

Z3. AINTAIN THE INTEGRITT OF ALL FIRE RATED AND SOUND RATED ASSEMBLIES.

- 24. E.C. SHALL COORDINATE LOCATIONS OF ALL DEVICES, SUCH AS LIGHT SWITCHES, CONVENIENCE RECEPTACLES, TELEVISION OUTLETS, AND TELEPHONE OUTLETS WITH ARCHITECTURAL DRAWINGS PRIOR TO ANY ROUGH-IN.
- 25. NEW PANELBOARDS SHALL BE ITE/SIEMENS TYPE 'P2', WITH BOLT-ON CIRCUIT BREAKERS, ALUMINUM BUS, NEMA 1 ENCLOSURE, GROUND, AND NEUTRAL BUS. AIC RATING TO MATCH EXISTING SYSTEM. EQUALS BY SQUARE 'D', G.E., OR CUTLER-HAMMER.


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ELECTRIC SERVICE SINGLE LINE DIAGRAM IS EXISTING TO REMAIN. NO MODIFICATIONS ARE BEING MADE TO THE SEQUENCE OF ELECTRICAL SERVICE DISTRIBUTION EQUIPMENT IN THIS SCOPE. ELECTRICAL RISER DIAGRAM



SALO NE Rice SUMMIT LS 209 E'S N

	Gladfelter Engineering Group 10233 Milstone Drive, #411 Phone: 816-916-4675 Email gggeeconsert.com	
Date:	Issued for:	-
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Project nur	nber: 23-211	
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PLUMBING PLAN NOTES (#):


- 1. 2" W DOWN, 1-1/2" V UP TO ABOVE CEILING.
- 2. 4" S DOWN, 2" V OVER TO WALL AND UP TO ABOVE CEILING.
- 3. 2" W DOWN, 1-1/2" V UP AND OVER TO 2" V FROM WATER CLOSET.
- 4. 2" W DOWN, 2" V OVER TO WALL AND UP AND OVER TO 2" V FROM WATER CLOSET.
- 5. EXTEND NEW W, S OR V TO EXISTING OF SAME OR LARGER AND MAKE CONNECTION.
- 6. 2" W UP TO 2" ED-1.
- 7. COLLECT DRAINS FROM EACH PEDICURE CHAIR AND DAYLIGHT OVER EQUIPMENT DRAIN MAINTAINING CODE REQUIRED AIR GAP.
- 8. CW, HW AND HWR DOWN IN CHASE BEHIND PEDICURE CHAIRS.
- 9. CW AND HW DOWN IN WALL TO BELOW FLOOR.
- 10. PIPING ABOVE CEILING.
- 11. PIPING BELOW FLOOR.
- 12. EXISTING DOMESTIC CW PIPING.
- 13. EXISTING CW PIPING SERVING RESTROOM BEING REMOVED.
- 14. CONNECT NEW 1" CW TO EXISTING DOMESTIC CW PIPING.
- 15. SEE "DOMESTIC WATER SCHEMATIC", SHEET MP301, FOR CONTINUATION.
- 16. CW AND HW DOWN WALL TO CHASE BEHIND PEDICURE CHAIRS. EXTEND 1/2'' CW AND HW TO EACH PEDICURE CHAIRS. EXTEND 1/2'' CW AND HW TO EACH PEDICURE CHAIR.
- 17. CW AND HW UP THRU FLOOR TO CHASE BEHIND PEDICURE CHAIRS. EXTEND 1/2" CW AND HW TO EACH PEDICURE CHAIRS. EXTEND 1/2" CW AND HW TO EACH PEDICURE CHAIR.

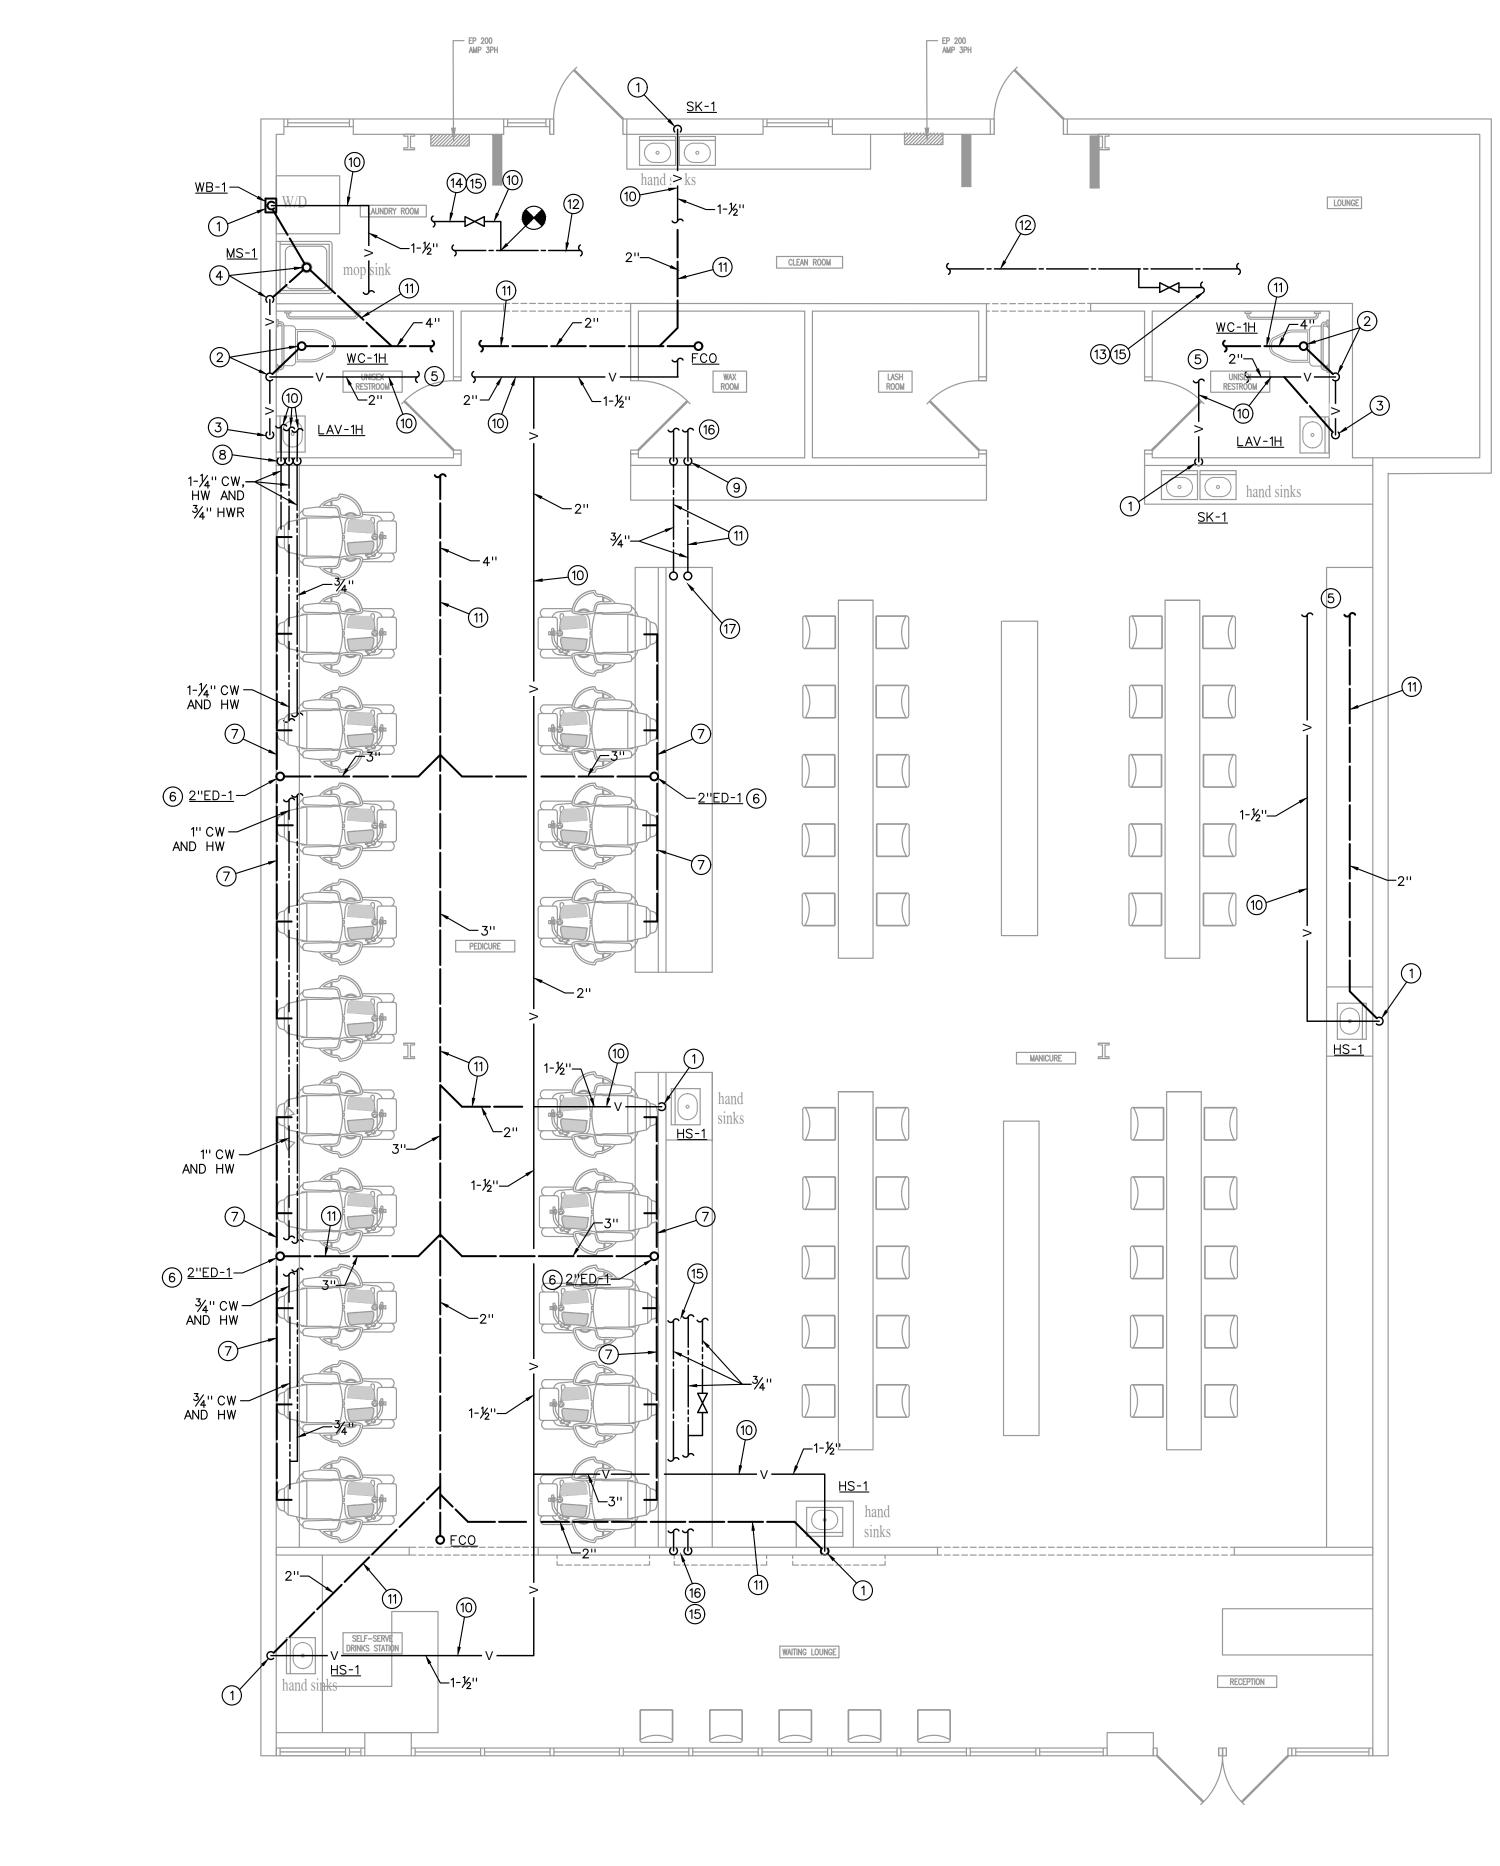

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	Gladfelter Engineering Group 1023 Milstone Drive, #411 Lenexa, Kansas 66220 Phone: 816-916-4675 Email gogeceonsort.com
Date: 09/25/23	lssued for: PERMIT
Project nun	nber: 23-211
Drawn: J	EE/SWB/GPG
Date:	2023/09/25
Sheet Numb	er:
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MECHANICAL PLAN NOTES (#):

- 1. 4"Ø EXHAUST DUCT UP THRU ROOF TO WP CAP.
- 12"x6" SHEET METAL DUCT DOWN TO 8"
 Ø PVC CONTINUING DOWN IN WALL TO BELOW FLOOR SLAB.
- 12"X6" SHEET METAL DUCT DOWN TO 8"Ø PVC CONTINUING DOWN IN WALL TO CHASE BEHIND PEDICURE CHAIRS. TURN OUT THRU WALL INTO CHASE.
- 4. PVC DUCT UP THRU FLOOR TO BELOW MANICURE TABLES OR INTO CHASE BEHIND MANICURE CHAIRS. (SIZE AS INDICATED).
- 5. EXISTING FAN-COIL UNIT WITH ELECTRIC HEAT (KW AS INDICATED).
- 6. RELOCATE EXISTING CEILING DIFFUSER AND BALANCE TO CFM INDICATED.
- 7. EXTEND 4" Ø EXHAUST DUCT TO EACH MANICURE TABLE OR PEDICURE CHAIR DUCT CONNECTION.
- 8. DUCTWORK BELOW FLOOR OR IN CHASE.
- 9. DUCTWORK ABOVE CEILING.
- 10. DUCTWORK BELOW MANICURE TABLES.
- 11. CONNECT NEW SA DUCT TO EXISTING SA DUCT.
- 12. EXISTING SA DUCTWORK.
- 13. MODIFY EXISTING OA DUCT TO EXTEND 14" OA DUCT THRU ROOF TO WEATHERPROOF OA INTAKE (REPLACING EXISTING 10"Ø OA DUCT). INSTALL BALANCE DAMPERS AND BALANCE TO 1000 CFM TO MATCH BUILDING EXHAUST.
- 14. OPEN PLENUM RETURN. INSTALL SMOKE DETECTORS ON EACH AHU RA DUCT. SEE SPECIFICATION FOR ADDITIONAL DETAILS.

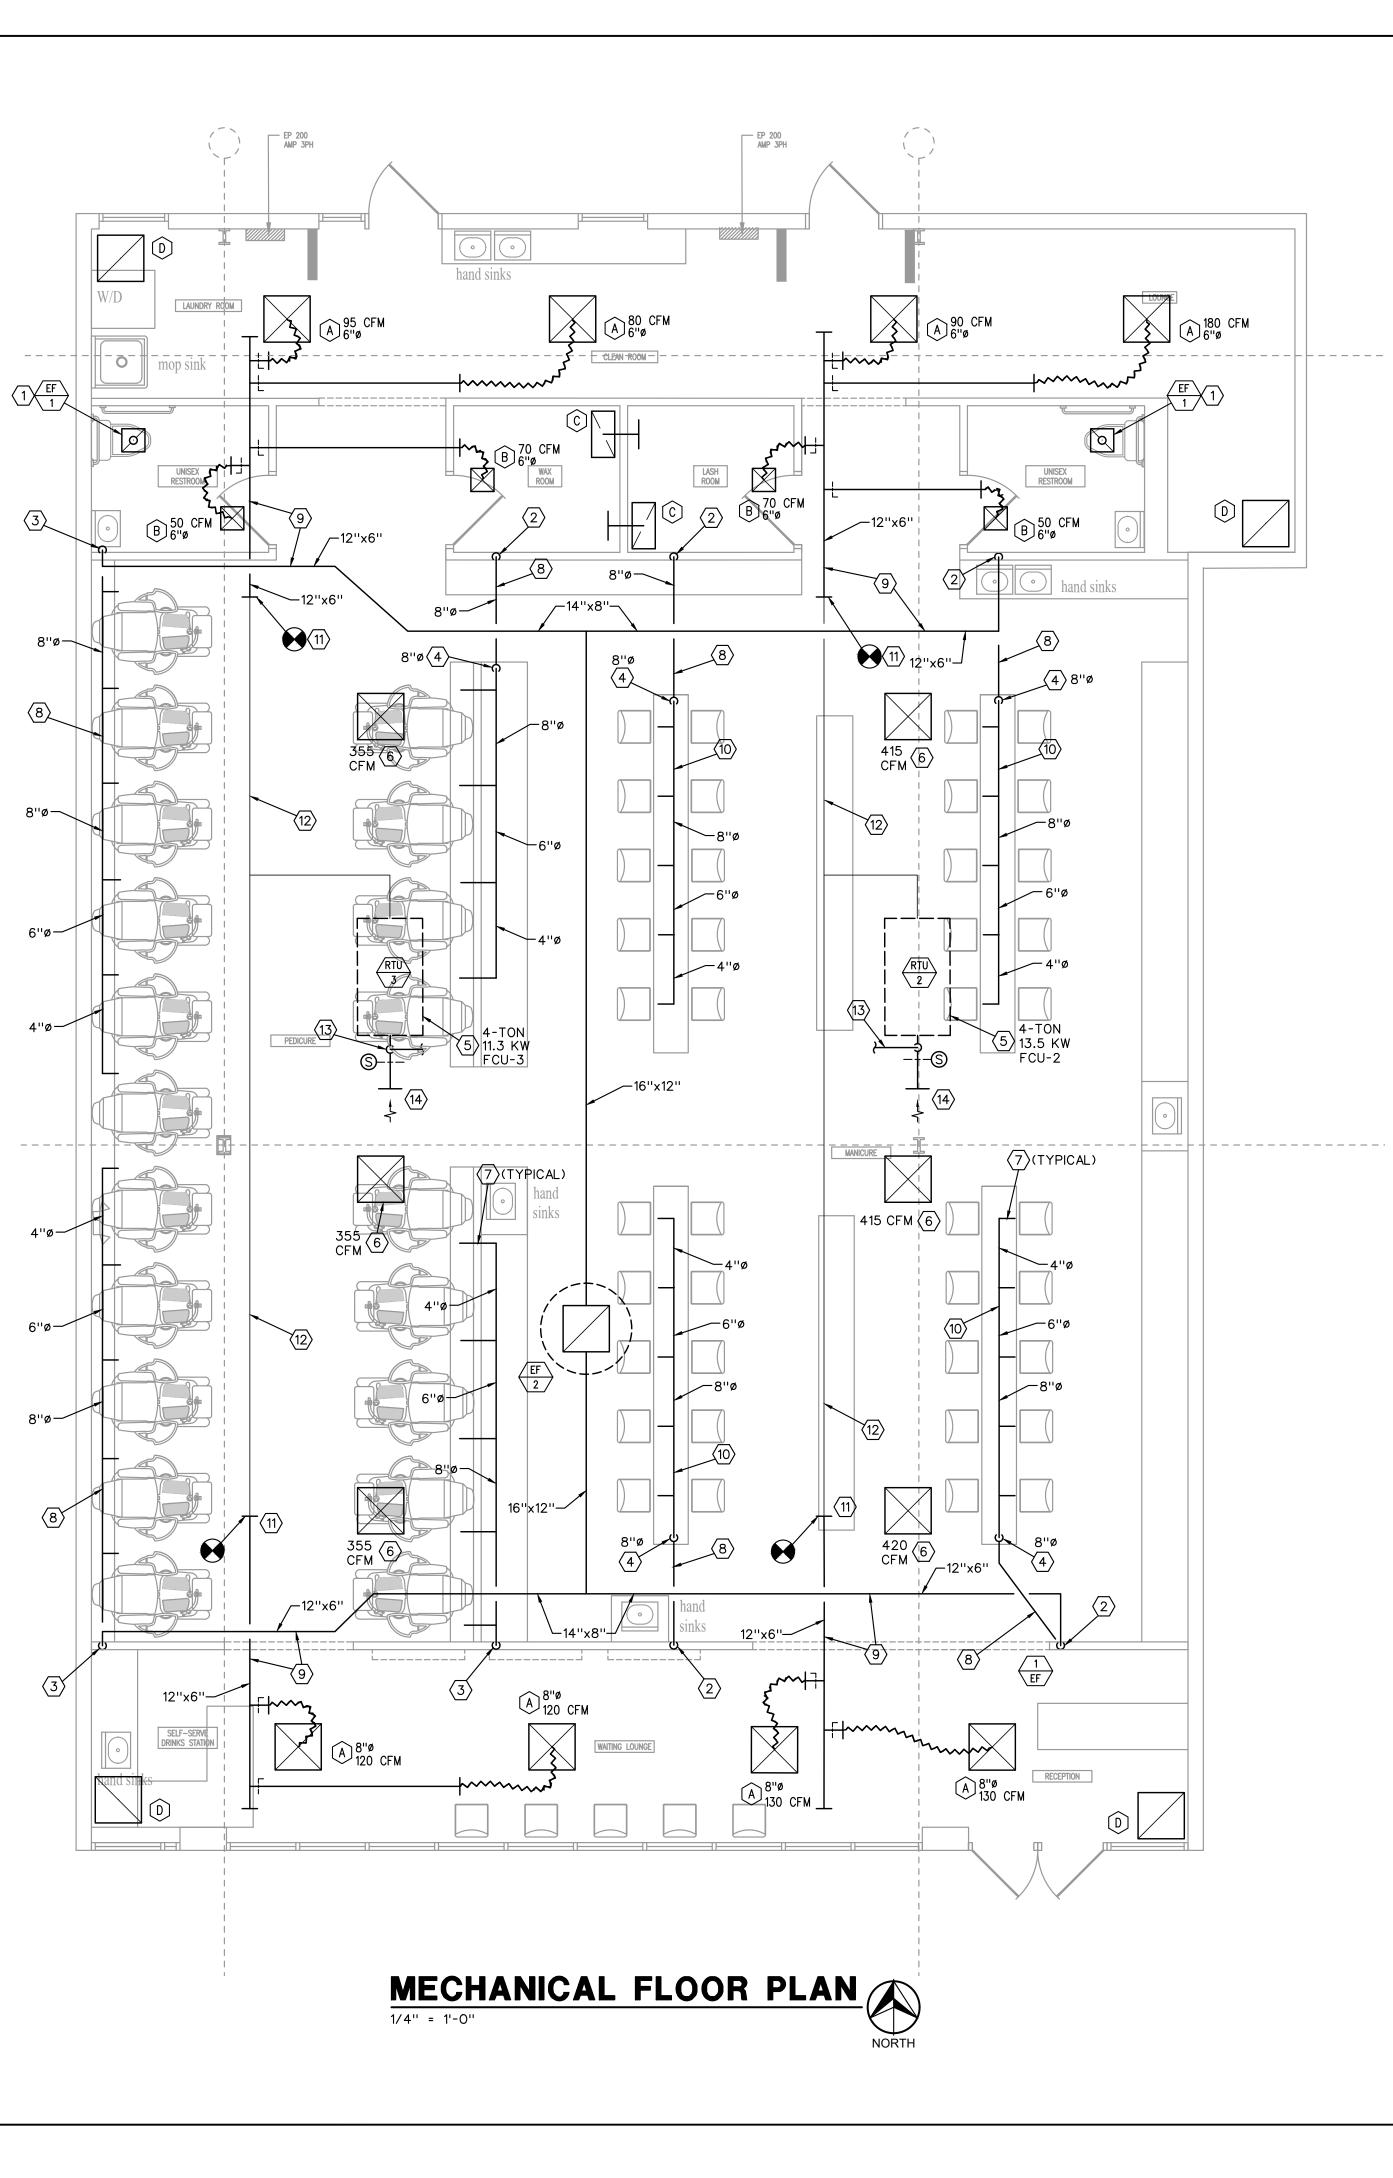


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·	Gladfeter Engineering Group Instant Rate Frank Reverse 6620 Prone: 816-965-4675 Email ggeteeconsort.com
Date: 09/25/23	lssued for: PERMIT
Project nur	nher:
	23-211
Drawn:	JEE/SWB/GPG
Date:	2023/09/25
Sheet Num	per:
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<image/>	HILE DESINE ALL EVEN HEAR OF THE ALL AND HEAR OF THE ALL AND HEAR ALL			
Image: Supply supply in the plane for the				
 COLOR PER ARCHITECT. PROVIDE DAMPER AT DUCT TAKE-OFF EXCEPT PROVIDE GRILLE 	MARK NO. MANUFACTURER MODEL NO. CFM ESP IN W.G. TYPE FAN SIZE RPM DRIVE ACCESSORIES VOLT Ø HZ HP/W			
4. PROVIDE WITH DAMPER OR EXTRACTOR IF REQUIRED FOR BALANCING.	1 COOK GC-144 100 0.25 CEILING - 1100 D X 120 1 60 98W 1 0 0001/ 01500			
	2 COOK 135C11ED 2000 0.5 ROOF - 1550 D X 120 1 60 1/2HP 2 NOTES:			
WATER HAMMER ARRESTOR SCHEDULE	1. PROVIDE CEILING FANS WITH CEILING GRILLE, DISCONNECT SWITCH, HANGER HARDWARE, BACKDRAFT DAMPER, UNIT MOUNTED VARIABLE SPEED SWITCH, WALL OR ROOF CAP, FLEX CONNECTOR, SWITCH WITH LIGHTS.			
MARK MANUEACTURER MODEL PDI UNIT FIXTURE UNIT	2. PROVIDE ROOF FANS WITH DISCONNECT SWITCH, ROOF CURB, BACKDRAFT DAMPER, FLEX CONNECTOR, TIME CLOCK			
NO. MANUFACTURER NO. RATING CAPACITY REMARKS	CONTROL.			
SIOUX CHIEF SERIES AA 4 (SINGLE FIXT) X				
A SIOUX CHIEF 652 A 1 - 11 X B SIOUX CHIEF 653 B 12 - 32 X	WH WATER HEATER SCHEDULE (ELECTRIC)			
B SIOUX CHIEF 653 B 12 - 32 X C SIOUX CHIEF 654 C 33 - 60 X	MARK MANUEACTURER MODEL TYPE ASME TANK STORAGE RECOVERY TEMP RISE DISCH. SET ELECTRICAL REMARKS			
	NO. MANUFACTORER NO. TTPE ASME LINING (GALLONS) GAL/HR °F POINT °F KW VOLT Ø HZ			
D SIOUX CHIEF 655 D 61 - 113 X	1 LOCHINVAR LETT-55 DAK TK N GL 50 27 90 240 6.0 240 1 60 1			
X X X X NOTES:	NOTES:			
NOTES: 1. INSTALL IN AN ACCESSIBLE LOCATION IN ACCORDANCE WITH THE PLUMBING CODE.	1. PROVIDE WITH ASME RATED P&T VALVE, DRAIN VALVE WITH HOSE THREAD OUTLET AND STAND AND/OR DRAIN PAN WHERE INDICATED.			



PLUMBING FIXTURE SCHEDULE

- A. INSTALL PLUMBING FIXTURES AND EQUIPMENT IN ACCC MANUFACTURER'S INSTRUCTIONS. VERIFY ROUGH-IN REC MANUFACTURER'S DRAWINGS AND INSTALL PER MANUF RECOMMENDATIONS. PROVIDE WATER-CONSERVING FIXT APPURTENANCES IF/AS REQUIRED BY LOCAL AUTHORITI LOCATIONS AND MOUNTING HEIGHTS WITH ARCHITECTUR SPECIFICATIONS. CAULK FIXTURES TO WALLS/FLOORS. SINKS AND LAVATORIES IN A BED OF CAULK. THE SPE FIXTURES, OR APPROVED EQUALS, SHALL BE USED UN OR INDICATED.
- B. WATER CLOSET (WC-1H), TOTO #CSC744SL.01, FLOOR-OF VITREOUS CHINA, MEETING ANSI A-117.1 AND ADA B REQUIREMENTS, 17" HIGH, 1.6-GALLON FLUSH, CLOSE-WITH ELONGATED BOWL AND SIPHON JET ACTION. TAN CHINA WITH COVER, 3/8" FLEXIBLE RISER WITH LOOSE VALVE, CHROME-PLATED BRASS TRIP LEVER AND MAN PROVIDE BENKE #527 WHITE ELONGATED OPEN FRONT PERMA BUMPER.
- C. LAVATORY (LAV-1H), TOTO #LT307.4 (20"X18"), WALL-CONSTRUCTED OF VITREOUS CHINA, MEETING ANSI A-1 BARRIER-FREE REQUIREMENTS. LAVATORY SHALL HAVE CENTERS AND DRILLED FOR CONCEALED ARM CARRIER. FLEXIBLE RISER W/ANGLE SUPPLIES WITH LOOSE KEY 1-1/2-INCH OUTLET CHROME PLATED CAST BRASS "P" PLUG AND ESCUTCHEON W/SET SCREW. PROVIDE DEL DUTY SINGLE LEVER FAUCET, 4-INCH CENTERS, VANDA AERATOR, PERFORATED OFFSET GRID DRAIN (W/ 1-1/4 VANDAL-RESISTANT SINGLE LEVER HANDLE. PROVIDE (TO MATCH WALL TYPE). MOUNT AT ADA HEIGHT AND UNDER LAVATORY AS REQUIRED BY ADA REGULATIONS. HOT WATER SUPPLY UNDER LAVATORY WITH UNDERSIN COVER, MOLDED, ANTIMICROBIAL, WITH FLUSH REUSABL LAV GUARD.
- D. SINK (SK-2), JUST #SL-2217-A-GR, SINGLE COMPARTME 304 STAINLESS STEEL, SELF RIMMING, UNDERSIDE FUL SOUND DAMPENING MATERIAL, 3 HOLE PUNCH, NOMINAL 22"X17"X7-1/2" DEEP. PROVIDE WITH DELTA COMMERC DUTY DECKMOUNT SINK FAUCET, 6" RIGID/SWIVEL GOC CENTERS, 2.0 GPM VANDAL-RESISTANT AERATOR, BASH 1-1/2" TAILPIECE, 3/8-INCH FLEXIBLE RISER W/ANGLE KEY STOPS, 1-1/2-INCH INLET 2-INCH OUTLET CHROME "P" TRAP W/CLEANOUT PLUG, ESCUTCHEON W/SET SC VANDAL-RESISTANT WRIST BLADE HANDLES.
- MOP SINK (MS-1), STERN WILLIAMS #SB-900, CONSTRU Ε. SQUARE BY 12" HIGH (COORDINATE SIZE WITH ARCHIT CHROME-PLATED CAST BRASS DRAIN (CAST INTEGRAL CAP. PROVIDE WITH DELTA #28T2383 FAUCET WITH \ HANDLES, 3/4" HOSE THREAD SPOUT WITH 48" LONG INTEGRAL STOPS AND ROUGH CHROME-PLATED FINISH.
- F. WASHING MACHINE WALL BOX (WB-1), GUY GRAY MANU RECESSED WALL MOUNTED, 16 GA. STEEL CONSTUCTIO RESISTANT EPOXY FINISH, 1/2" CW AND HW SUPPLIES BRASS QUARTER TURN SHUT-OFF HOSE BIBBS AND 2' BOX 36" AFF.
- G. EQUIPMENT DRAINS (ED-1) WADE #1100-94 ADJUSTABLE DRAIN WITH FLANGE, SEEPAGE OPENINGS, INTEGRAL CL EXTENSION ADAPTER INSTALLED ABOVE THE FLOOR E 3/4" TO PREVENT WATER ON THE FLOOR FROM ENTE PLUGGED TRAP PRIMER CONNECTION. PROVIDE WITH TRAP (SEE PLANS FOR SIZE).
- H. SANITARY FLOOR SINKS: <u>FS-1</u> WADE #9130-1-24-27-6 SINK WITH CAST IRON BODY (12" X 12" X 6" DEEP). ENAMELED INTERIOR, SEDIMENT BUCKET, TRAP PRIMER SQUARE NICKEL BRONZE FRAME AND GRATE. PROVIDE SEAL "P" TRAP (SEE PLANS FOR SIZE).
- I. FINISHED FLOOR CLEANOUTS; (FFCO) WADE #6000-1-2-CLEANOUT WITH FLANGE, PLASTIC TAPERED PLUG AND ADJUSTABLE TOP. PROVIDE WITH CARPET CLEANOUT IS LOCATED BELOW CARPET. COORDINATE WITH ARCH
- J. FINISHED WALL CLEANOUTS: (FWCO) WADE #8560, W/ CLEANOUT TEE WITH BRASS PLUG AND 6" ROUND STA COVER. J.R. SMITH FIGURE 4530. PROVIDE DUCO C CLEANOUT TEE WITH COUNTERSUNK PLUG. DELETE C CLEANOUT IS IN EXPOSED LOCATION.
- K. ALL FIXTURES USED SPECIFICALLY FOR HANDWASHING HAND SINKS, ETC.) SHALL BE PROVIDED WITH A TEMPI THE HOT WATER TO THE FIXTURE (MAXIMUM OF 105-E
- L. PC TO ROUGH-IN AND MAKE FINAL CONNECTION TO OV EQUIPMENT. WHERE REQUIRED, PC TO PROVIDE DRAIN FLEXIBLE RISERS W/ANGLE SUPPLIES WITH LOOSE KEY INLET/2-INCH OUTLET CHROME PLATED CAST BRASS PLUG AND ESCUTCHEON W/SET SCREW. SEE ARCHITEC

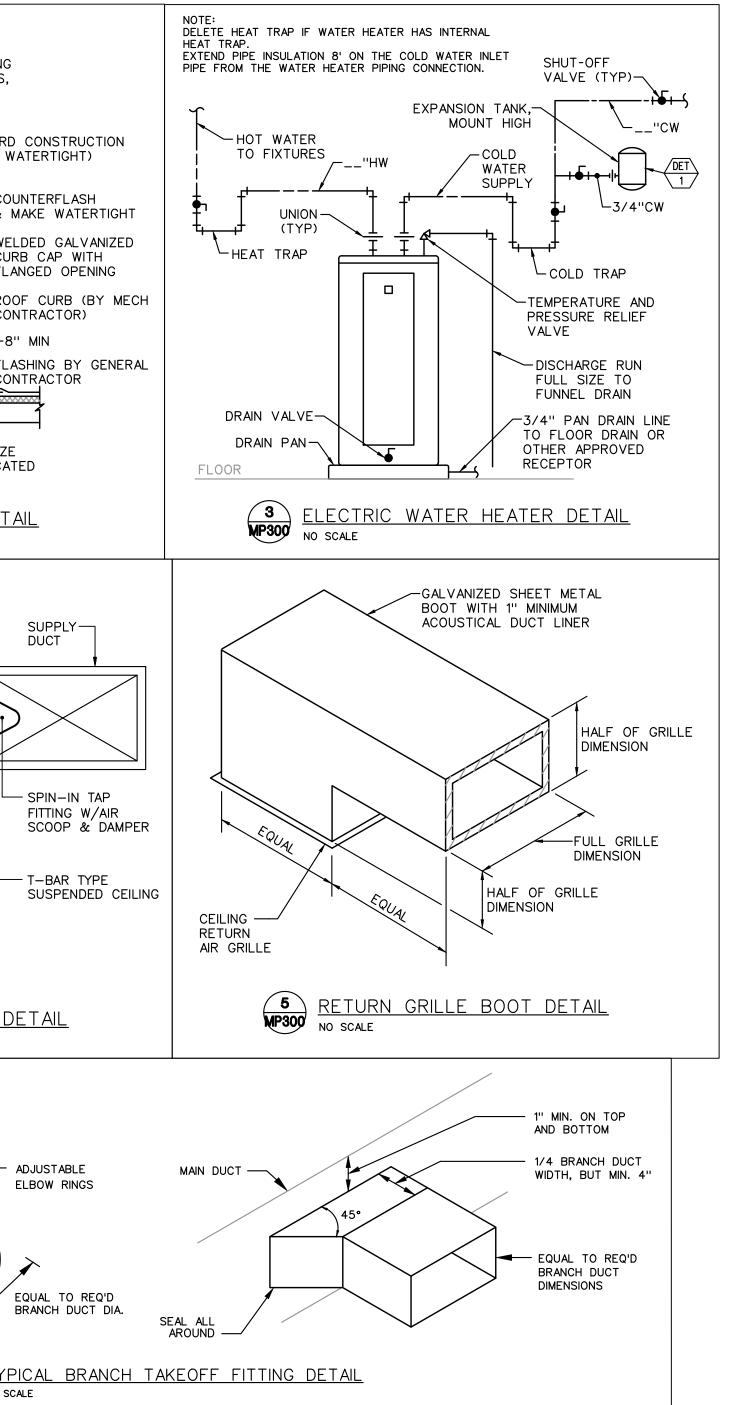FIXTURE	WASTE	VENT	COLD	нот
Water Closet (ft)	4"	2"	1/2"	
Water Closet (fv)	4"	2"	1"	
Urinal	2"	1 1/2"	3/4"	
Lavatory	2 1 ½" 2" 2"	1 ½" 1 ½" 1 ½"	1/2"	1/2"
Sink	2"	1 1/2"	1/2"	1/2"
Triple Sink	2"	1 ½" 1 ½"	(2) ½"	(2) 1/2
Shower, Tub	2"	1 ½"	1/2"	1/2"
Water Fountain	1 ½"	1 ½"	1⁄2"	
Janitor Sink (flr)	3"	$1 \frac{1}{2}$ 1 $\frac{1}{2}$ 2"	3/4"	3/4"
Janitor Sink (wall)	2"	1 1/2"	1/2"	1/2"
Floor Drain	2"	1 1/2"		
Floor Sink	2 1 ½" 3" 2" 2" 3"	2 1 ½" 1 ½" 2"		
Eqpt Floor Drain	3" 2" 2" 2"	2″		
Hub Drain	2"	1 1/2"		
Dishwasher	2"	1 1/2"		1/2"
Washer Box	2"	1 ½"	1⁄2"	1⁄2"
lce Maker			1/2"	
FPWH, HB			3/4"	

2. Size as shown on drawings and diagrams, but not less than listed.

1.

		PLUMBING SYMBOLS	NORODOWNOODOWNOODDOWNOODOWNOODDOWNOODDOWNOODDOWNOODDOWNOODDOWNOODDOWNOODDOWNOODDOWNOODDOWNOODDOWNOODDOWNOODDOWNOODDOWNOODDOWNOODDOWNOODOWNOODOW OODOWNOODDOWNOODOWNOODDOWNOODOWNOODOWNOODOWNOODOWNOODOWNOODOWNOODOWNOODOWNOODOWNOODOWNOODOWNOODOWNOODOWNOODOWNOO OODOWNOODOWNOODOWNOODOWNOODOWNOODOWNOODOWNOODOWOODOWOODOWOODOWOODOWOODOWOODOWOODOWOODOWNOODOWOODOWOODOWOODOWOODOWOODOWOODO
PRDANCE WITH		- EXISTING TO REMAIN.	GREGORY P.
QUIREMENTS WITH ACTURER'S		- NEW PIPING WORK.	GREGORY P. GLADFELTER NUMBER E-2000150421
TURES AND TIES. CONFIRM ALL RAL DRAWINGS AND/OR		- DOMESTIC COLD WATER (CW).	
SET COUNTER MOUNTED ECIFIED PLUMBING		- DOMESTIC HOT WATER (HW).	**************************************
NLESS OTHERWISE NOTED		- HOT WATER RECIRCULATION (HWR).	09/25/2023
-MOUNTED, CONSTRUCTED BARRIER-FREE	v	- PLUMBING VENT ABOVE FLOOR (V).	
COUPLED TANK DESIGN NK SHALL BE VITREOUS		- SANITARY WASTE ABOVE FLOOR (W).	
E KEY ANGLE STOP IUFACTURER'S BOLT CAPS.		- SANITARY WASTE BELOW FLOOR (W).	
F SEAT LESS COVER,	NG	- GAS (NATURAL) (NG).	
HUNG TYPE, 117.1 AND ADA	÷Э	ELBOW DOWN.	
4-INCH FAUCET . PROVIDE 3/8-INCH	—ю	ELBOW UP.	
STOPS, 1-1/4-INCH INLET ' TRAP W/CLEANOUT TA #523-WFOGHDF HEAVY		- TEE DOWN.	
AL-RESISTANT 2.2 GPM +'' TAILPIECE) AND	<u>ю</u>	- TEE UP.	
WITH J.R. SMITH CARRIER D MAINTAIN CLEARANCES		CAP.	
5. INSULATE WASTE AND NK PROTECTIVE PIPE LE FASTENERS, TRUEBRO		- PIPE UNION.	_ g ≥
LE TASTENERS, TROEBRO		- 1/4 TURN SHUT-OFF VALVE.	
IENT, 18 GAUGE TYPE LLY UNDERCOATED WITH		- CHECK VALVE.	
L DIMENSIONS OF CIAL #27T2934 HEAVY OSENECK SPOUT, 8''			I ₹"∑
SUPPLIES WITH LOOSE			SAL SUMMI
E PLATED CAST BRASS CREW AND 4''	VTR	VENT THRU ROOF (VTR).	
	ETR	EXISTING TO REMAIN.	S O S L
JCTED OF TERRAZZO, 32" ECTURAL PLANS), WITH STAINLESS STEEL		PLAN NOTE DESIGNATION.	120 EE
ACUUM BREAKER, LEVER HOSE, WALL SUPPORT,		PLAN REVISION DESIGNATION.	
	•	CONNECT TO EXISTING.	
JFACTURING #WB-200, ON WITH CORROSION 5 WITH DUAL CLOSING 1' DRAIN PIPE. MOUNT		PLUMBING EQUIPMENT DESIGNATION - TOP PORTION IS EQUIPMENT (HW, RTU, ETC.), BOTTOM PORTION IS NO. OR LETTER (SEE APPROPRIATE SCHEDULE).	
E CAST IRON FLOOR		MECHANICAL SYMBOLS	
LAMPING COLLAR, LEVATION APPROXIMATELY		NEW SHEET METAL DUCTWORK & SIZE.	
ERING DRAIN AND 1/2'' SEPARATE DEEP SEAL ''P''	· ــــــــــــــــــــــــــــــــــــ	NEW SHEET METAL DUCTWORK & SIZE.	
SQUARE PATTERN FLOOR		SUPPLY AIR DUCT OR OUTSIDE AIR INTAKE.	
ACID RESISTING CONNECTION AND 12"		RETURN AIR DUCT OR EXHAUST AIR DUCT.	
E WITH SEPARATE DEEP	4-	DIRECTION OF RETURN AIRFLOW.	
2-S CAST IRON FLOOR D SQUARE NICKEL BRONZE	Ū	THERMOSTAT OR TEMPERATURE SENSOR.	
MARKER WHEN CLEANOUT HITECTURAL PLANS.	CD	CONDENSATE DRAIN.	UD 6.4675 ort.com
8304-85-6 CAST IRON AINLESS STEEL ACCESS	G	ELBOW DOWN.	in Division
AST IRON WALL COVER PLATE IF	+O	ELBOW UP.	G 10233 Milistone Lenexo, Kai Phone: 81 Email gpgeae
	SA	SUPPLY AIR.	° °
PURPOSES (LAVATORIES, PERING VALVE TO TEMPER DEGREES F).	OA	OUTSIDE AIR.	
WNER PROVIDED	RA	RETURN AIR.	ine
N, TAILPIECE, 3/8-INCH Y STOPS, 1-1/2-INCH	EA	EXHAUST AIR.	ingine
"P" TRAP W/CLEANOUT CTURAL PLANS.			
	CU	CONDENSING UNIT.	
	EF	EXHAUST FAN.	life te
	RTU	ROOFTOP UNIT.	
		PLAN NOTE DESIGNATION.	· <u> </u>
		PLAN REVISION DESIGNATION.	
	•	CONNECT TO EXISTING.	Date: Issued for:
	$ \qquad \bigcirc$	MECHANICAL EQUIPMENT DESIGNATION - TOP PORTION IS EQUIPMENT (RTU, EF, HP, ETC.), BOTTOM PORTION	09/25/23 PERMIT
		IS NO. OR LETTER (SEE APPROPRIATE SCHEDULE).	

MARK NO.	MANUFACTURER	MODEL NO.	TYPE ARRANGEMENT	CAPACITY (GAL)	ASME	MAX WORKING PRESSURE (PSIG)	MAX OPERATING TEMP(°F)	REMARKS
1	ELBI	DTS-45	-	2.1	N	150	210	1
NOTES:								

PROVIDE POLYPROPYLENE LINED BLADDER TYPE EXPANSION TANK WITH BUTYL RUBBER DIAPHRAGM, AIR CHARGE & SYSTEM CONNECTION FITTING, MOUNING HARDWARE.

> Gladfelter Engineering Group assumes design responsibility for this project for only the mechanical, plumbing and electrical disciplines with drawing sheet number beginning with M, P and E. All other drawings should be considered the work of others. Further, drawings in this MP3 project set may contain drawing information, including but not limited to: architectural plans, sections and elevations, site plans and surveys and other information pertinent to showing th mechanical, plumbing and electrical work which is furnished by others, generally indicated by screened or light type. Gladfelter Engineering Group assumes no responsibility or liability for the accuracy or regulatory compliance for work prepared by others even though shown on MPE drawings. Gladfelter Engineering Group assumes responsibility only for the design of mechanical, plumbing and electrical disciplines contained herein, generally indicated in bold type.

Project number:

Sheet Number:


Drawn:

Date:

23-211

JEE/SWB/GPG

2023/09/25

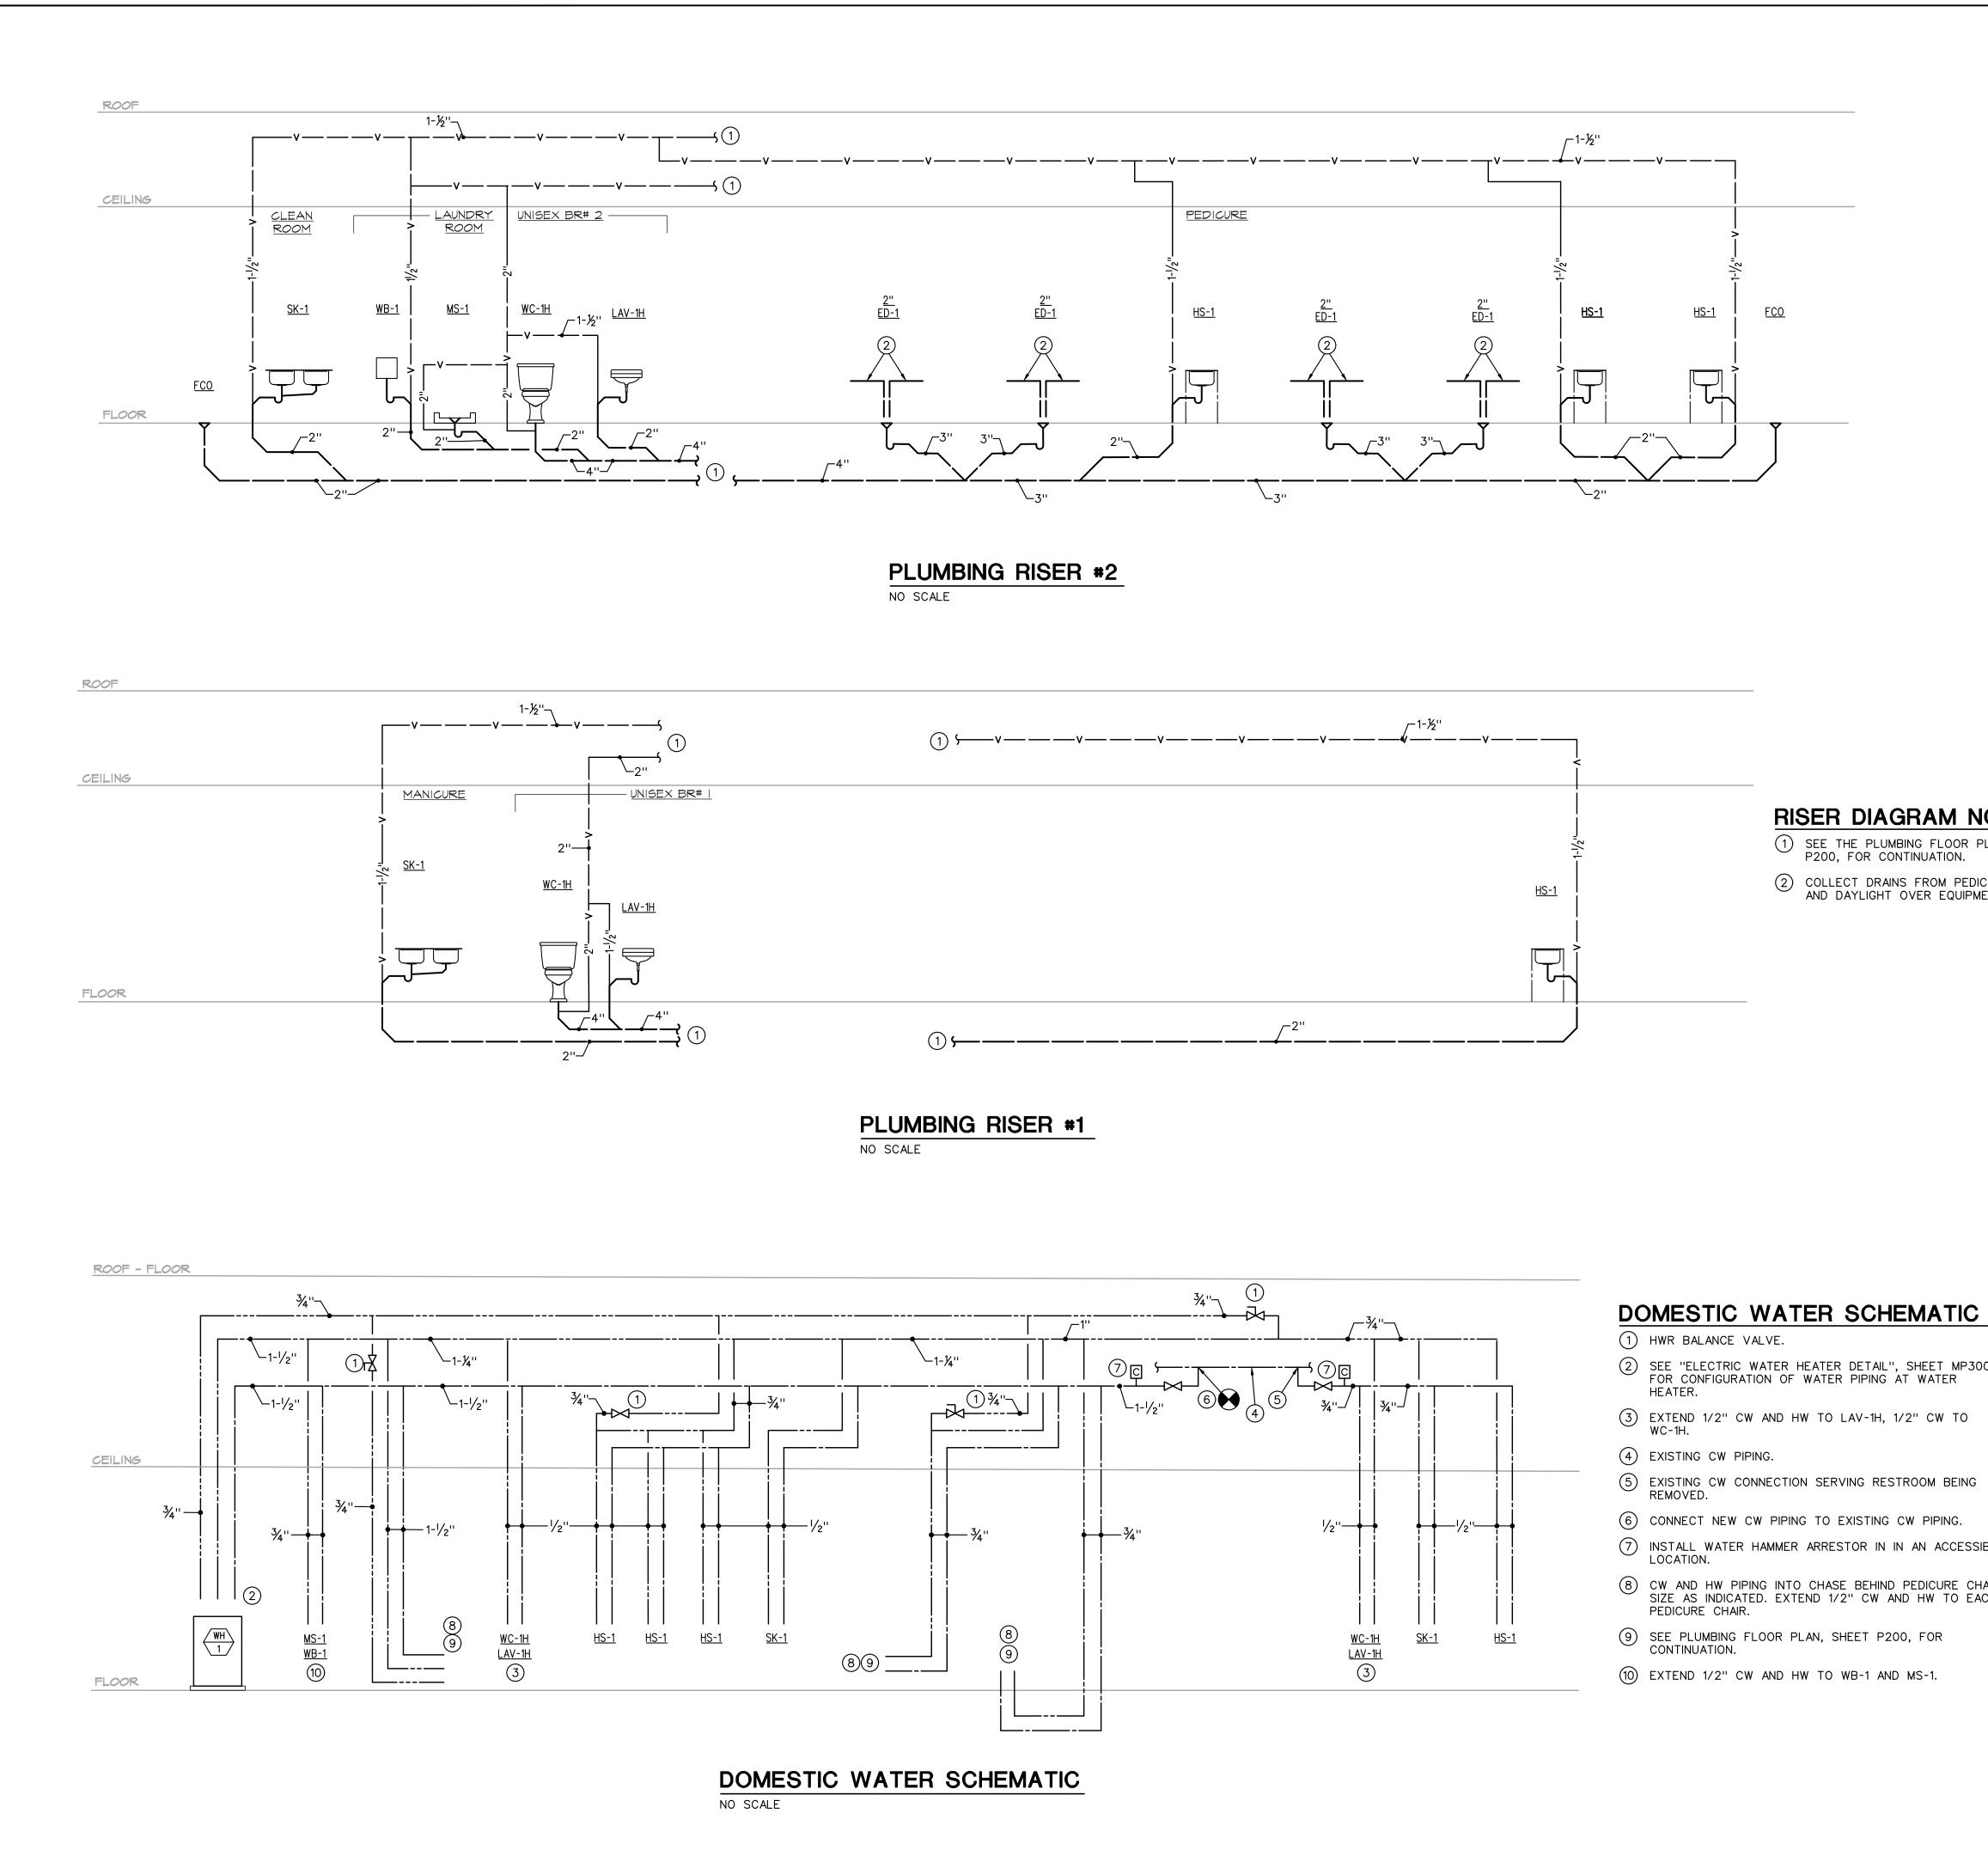


DOMESTIC WATER SCHEMATIC

2 SEE "ELECTRIC WATER HEATER DETAIL", SHEET MP300, FOR CONFIGURATION OF WATER PIPING AT WATER

(3) EXTEND 1/2" CW AND HW TO LAV-1H, 1/2" CW TO WC-1H.


- 6 CONNECT NEW CW PIPING TO EXISTING CW PIPING.
- INSTALL WATER HAMMER ARRESTOR IN IN AN ACCESSIBLE LOCATION.
- 8 CW AND HW PIPING INTO CHASE BEHIND PEDICURE CHAIRS. SIZE AS INDICATED. EXTEND 1/2'' CW AND HW TO EACH PEDICURE CHAIR.
- (10) EXTEND 1/2" CW AND HW TO WB-1 AND MS-1.

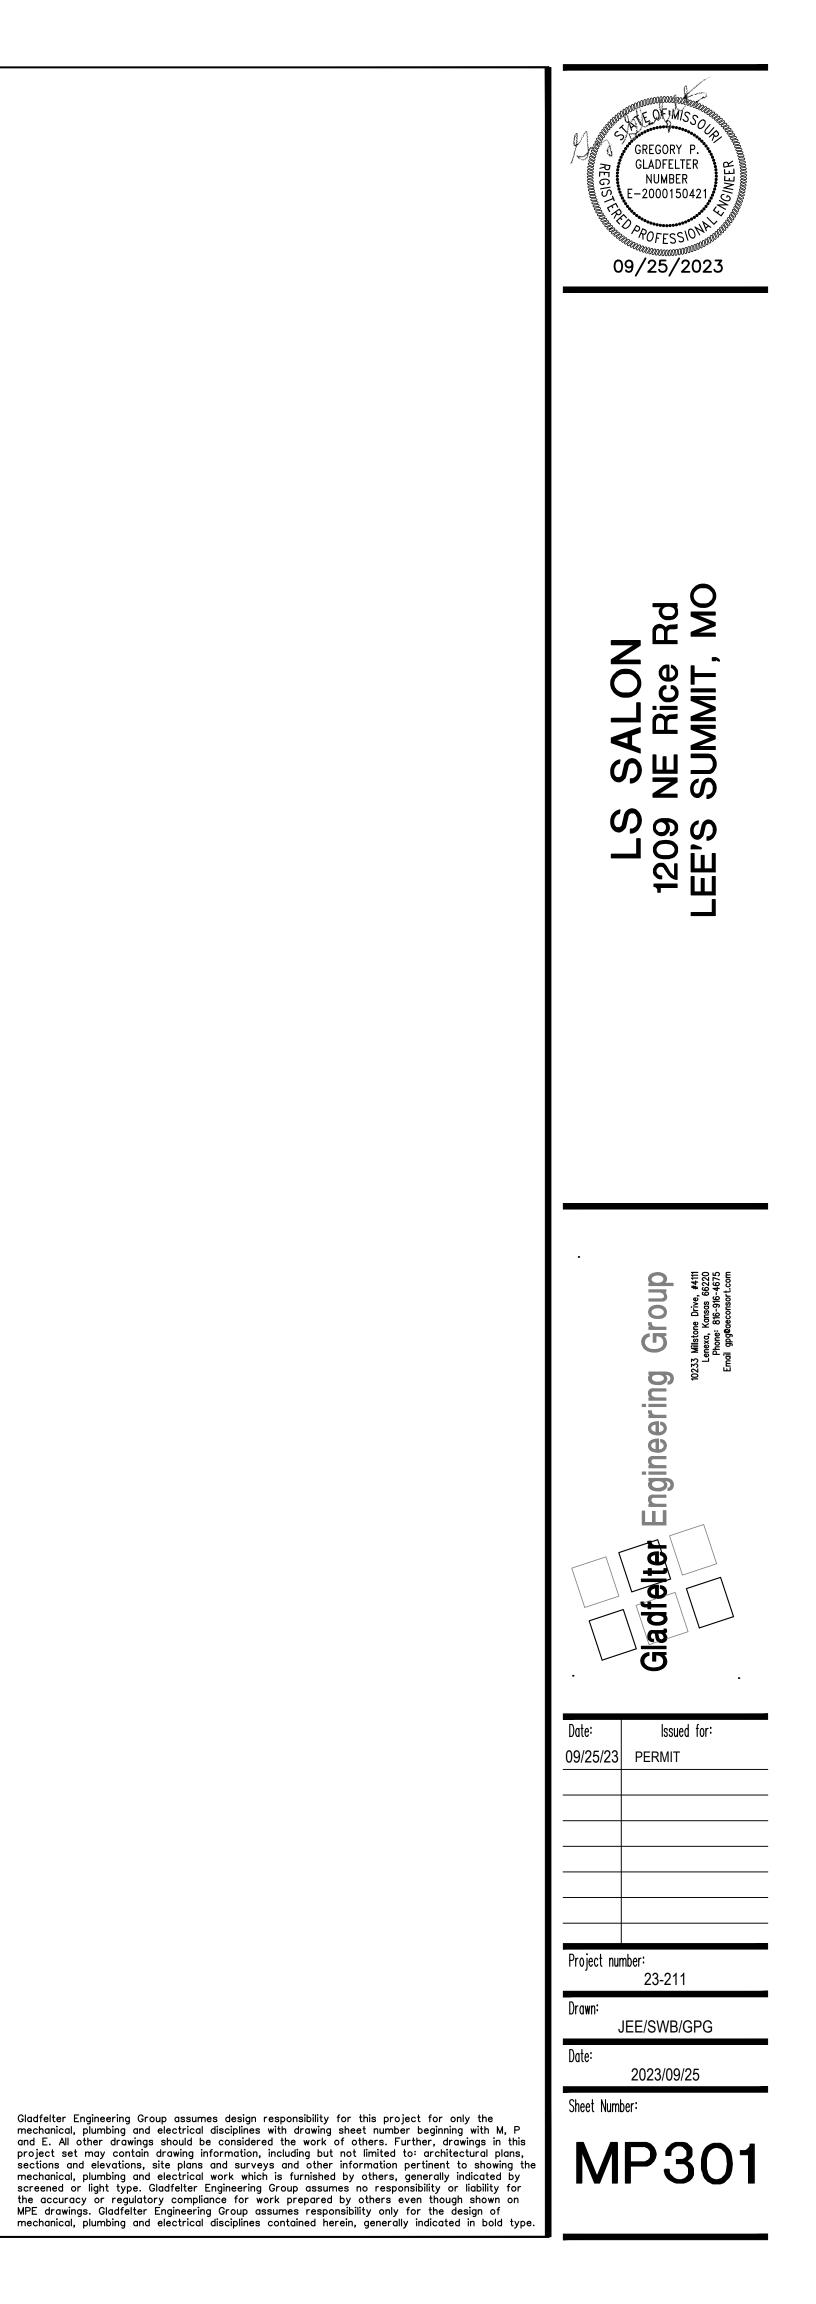

RISER DIAGRAM NOTES

(1) SEE THE PLUMBING FLOOR PLAN, SHEET P200, FOR CONTINUATION. 2 COLLECT DRAINS FROM PEDICURE CHAIRS AND DAYLIGHT OVER EQUIPMENT DRAINS.



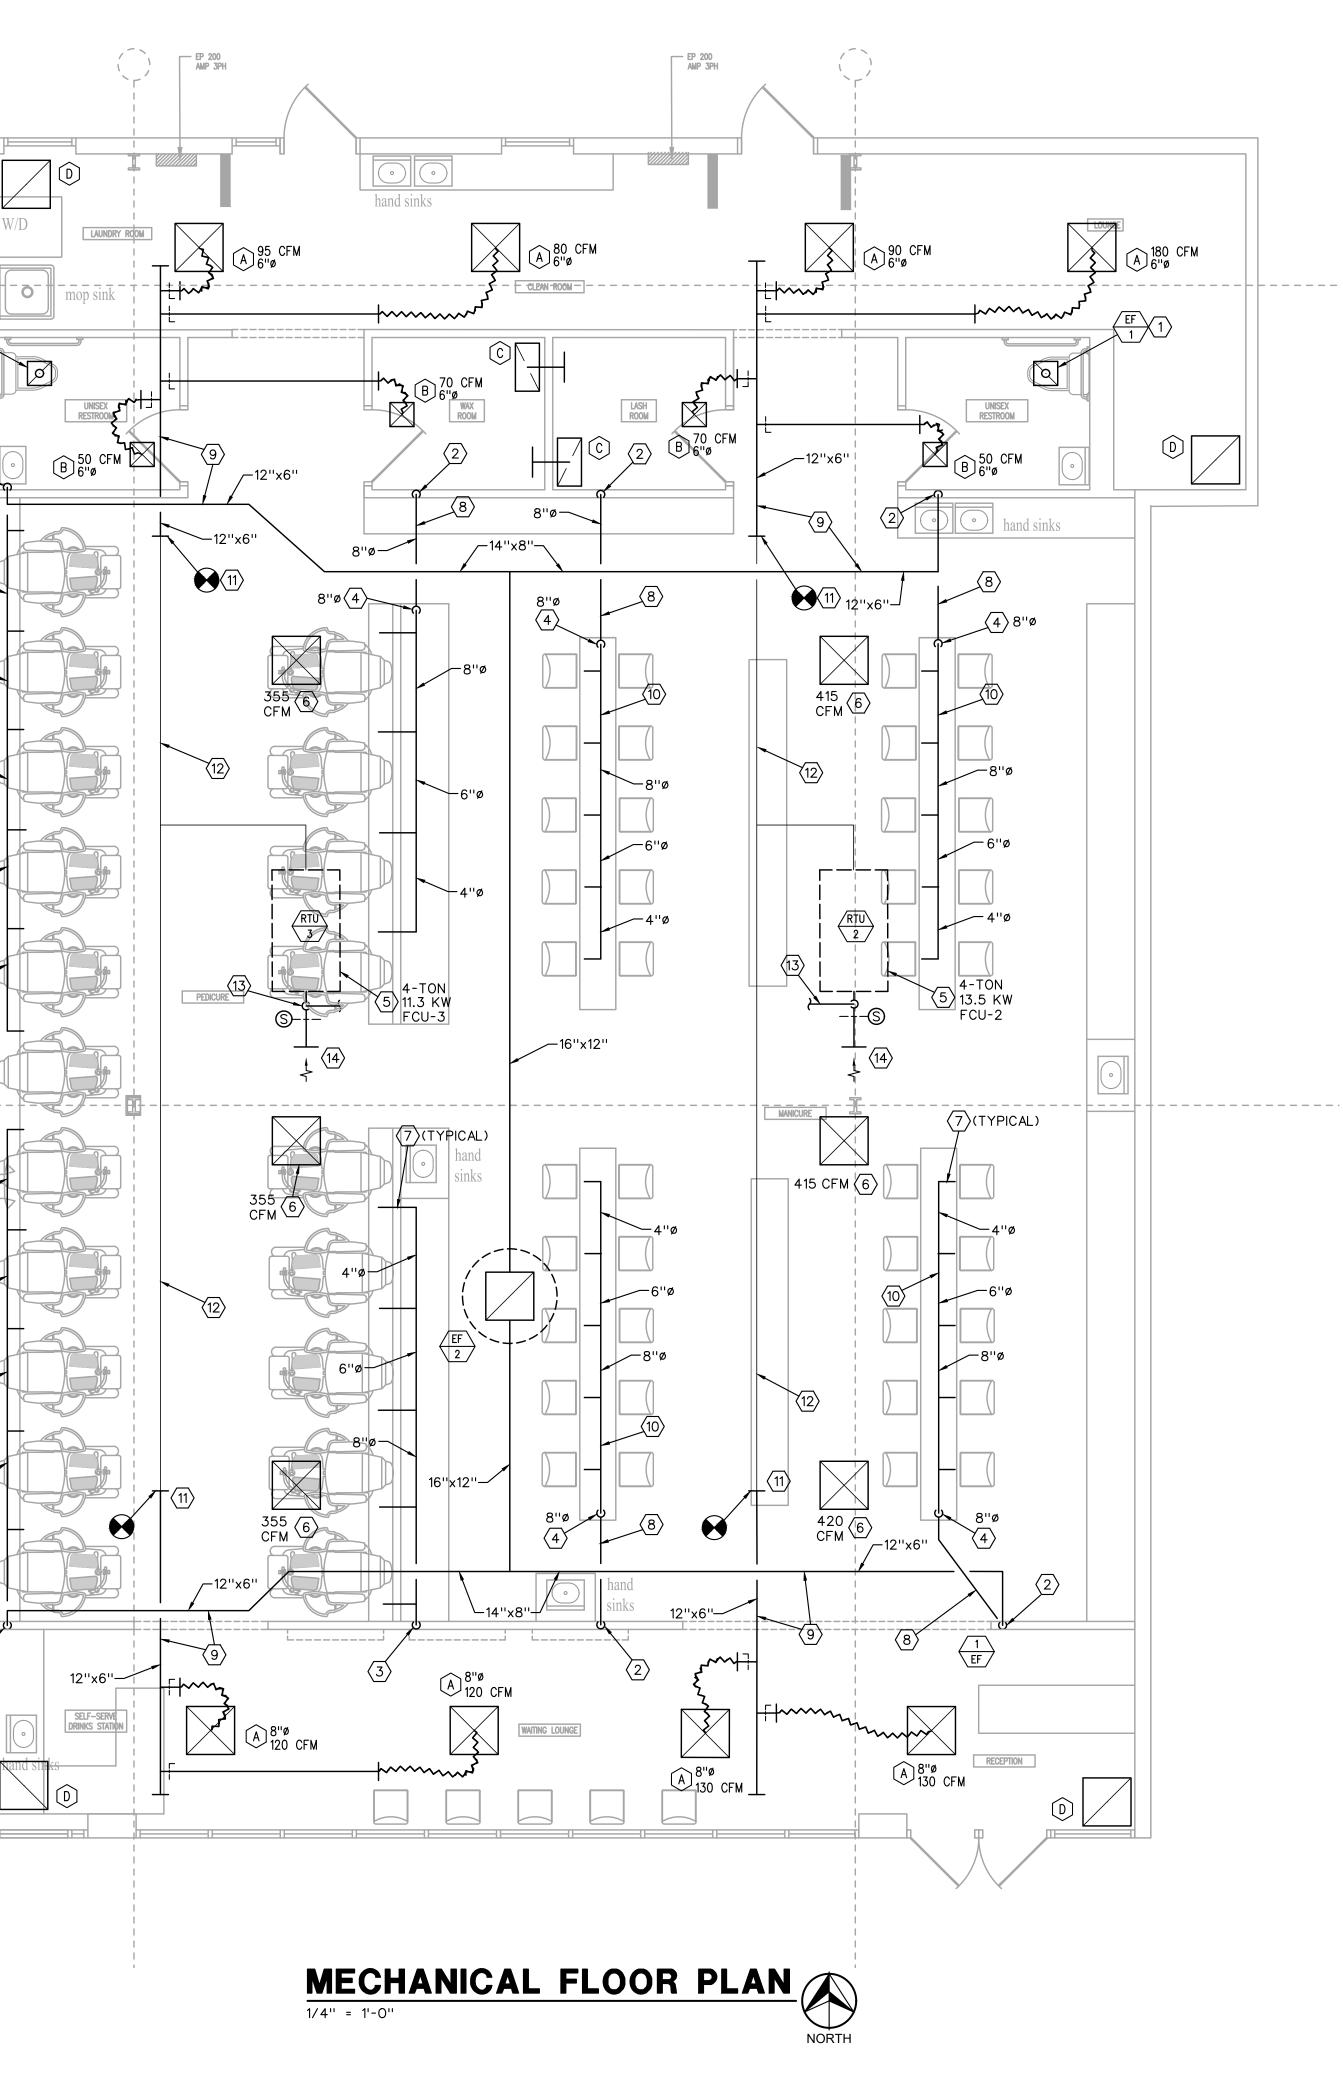

MECHANICAL PLAN NOTES (#):

- 1. 4"Ø EXHAUST DUCT UP THRU ROOF TO WP CAP.
- 12"x6" SHEET METAL DUCT DOWN TO 8"Ø PVC CONTINUING DOWN IN WALL TO BELOW FLOOR SLAB.
- 12"X6" SHEET METAL DUCT DOWN TO 8"Ø PVC CONTINUING DOWN IN WALL TO CHASE BEHIND PEDICURE CHAIRS. TURN OUT THRU WALL INTO CHASE.
- 4. PVC DUCT UP THRU FLOOR TO BELOW MANICURE TABLES OR INTO CHASE
- BEHIND MANICURE CHAIRS. (SIZE AS INDICATED).
- 5. EXISTING FAN-COIL UNIT WITH ELECTRIC HEAT (KW AS INDICATED).
- 6. RELOCATE EXISTING CEILING DIFFUSER AND BALANCE TO CFM INDICATED.
- 7. EXTEND 4"Ø EXHAUST DUCT TO EACH MANICURE TABLE OR PEDICURE CHAIR DUCT CONNECTION.
- 8. DUCTWORK BELOW FLOOR OR IN CHASE.
- 9. DUCTWORK ABOVE CEILING.
- 10. DUCTWORK BELOW MANICURE TABLES.
- 11. CONNECT NEW SA DUCT TO EXISTING SA DUCT.
- 12. EXISTING SA DUCTWORK.
- 13. MODIFY EXISTING OA DUCT TO EXTEND 14" OA DUCT THRU ROOF TO WEATHERPROOF OA INTAKE (REPLACING EXISTING 10"Ø OA DUCT). INSTALL BALANCE DAMPERS AND BALANCE TO 1000 CFM TO MATCH BUILDING EXHAUST.
- 14. OPEN PLENUM RETURN. INSTALL SMOKE DETECTORS ON EACH AHU RA DUCT. SEE SPECIFICATION FOR ADDITIONAL DETAILS.

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