

2023 REMODEL

2801 NORTHEAST INDEPENDENCE AVE SUITE 201 LEE'S SUMMIT MISSOURI, 64064

RELEASED FOR CONSTRUCTION

Lee's Summit Fire Department Lee's Summit, Missouri 09/26/2023

shown on the drawings. 6. The location of the notification devices shall be at a uniform height for all devices.

7. All cables, conduits, or wire mold shall be securely

fastened to the structure. 8. Smoke detectors shall be located in the ceiling no less than

4 inches from a sidewall to the nearest edge of the detector.

NOTES:

1. All smoke detectors shall be located a minimum of three

2. All manual pull stations shall be mounted four (4) feet above the finished floor (centerline of device, +or-6inches),

3. All strobe and horn/strobes shall be located so the bottom

of the device is not less than 80 inches above the finished floor and not greater than 96 inches above the finished floor.

4. All notification devices shall be located no less than 6

5. The candela rating of the strobes or horn/strobes shall be

(3) feet from any HVAC diffuser.

unless otherwise noted.

inches below finished ceilings.

9. Drawings indicate general fire alarm device locations and Field Verify device locations with minimal deviations and document any changes.

10. FACP & Power Supplies shall be on a dedicated 120V, 20A circuit breaker marked in red with lock-on provision.

11. Fire Alarm wire paths are reserved for fire alarm cabling only. Including all UL listed fire barrier penetrations.

12. Outdoor Weatherproof Horn/Strobe is to be mounted 10 13. All ceilings are 10' or below unless otherwise noted.

14. Default batteries are 18 - amp hour unless otherwise

15. LED Remote Test Switches are to be ceiling mounted directly below above ceiling duct detector.

NEW BUILDING AND INTERIOR FINISH

- ALL CONSTRUCTION FOR THIS PROJECT SHALL BE PERFORMED UNDER THE PROVISIONS OF FOLLOWING LIST OF CODES, AS AMENDED BY THE CITY OF LEES SUMMIT, MISSOURI:
 - 2018 International Building Code
 - 2018 International Plumbing Code
 - 2018 International Mechanical Code
 - 2018 International Fuel Gas Code
 - 2018 International Residential Code
 - 2018 International Fire Code
 - 2017 National Electrical Code
 - ICC/ANSI A117.1-2017, Accessible and Usable Buildings and Facilities
- Use, Occupancy Classification, and Type of Construction:
 - Tenant Use: Professional Services Medical Office.
 - Tenant Occupancy Classification: B Business
 - Building Type of Construction: IIB
- Tenant Square Foot Calculations:
 - D.1. Existing with limited work = 5,500 sf
 - Existing to be remodeled = 681 sf
 - Expansion in empty shell = 1,808 sf
 - Total Tenant area = 7,989 sf
- Fire Protection Systems:
 - Automatic Sprinkler Systems: Provided.
 - Fire Alarm and Detection Systems: Provided.
- Tenant Occupant Load (Table 1003.2.2.2): See Code Plan 22.02 + 13.89 + 20.44 + 27.92 + 6.63 = 90.9 = 91 occupants

Circuit Legend				
Abbreviation	Type	Name	Wire	
A	Notification	NAC	14/2 UNS SOL FPLF RED Jkt	


Symbol Legend					
SYMBOL	SYMBOL DESCRIPTION PART NUMBER				
	HORN/STROBE, 2 WIRE, M-C,WHITE, WALL	HS-24WW			
1	STROBE, M-C, WHITE, WALL	S-24WW			

Scope:	SANO Orthopedics is remodeling an existing building. Envision will installing new Potter devices in the remodeled space that will added on to the existing Potter FA system.

Sheet Index		
FA-1	Cover Sheet	RE
FA-2	Floor Plan	
FA-3	Floor Plan-Remodeled Space Expanded	_
FA-4	Battery Calculations, Riser Diagram	91
FA-5	NFPA 72 Reference	





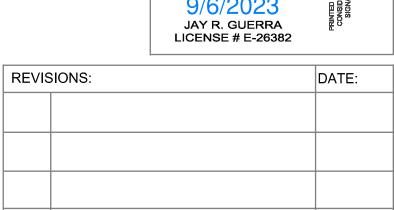




SITE:2801 NE Inc Summit	dependence	Ave Suite 201, Lee's
TITLE: Cover Pag	е	
SCALE AT:	DATE:	DESIGNED BY:


8/29/2023 REVISION:


PROJECT NO: DRAWING NO:

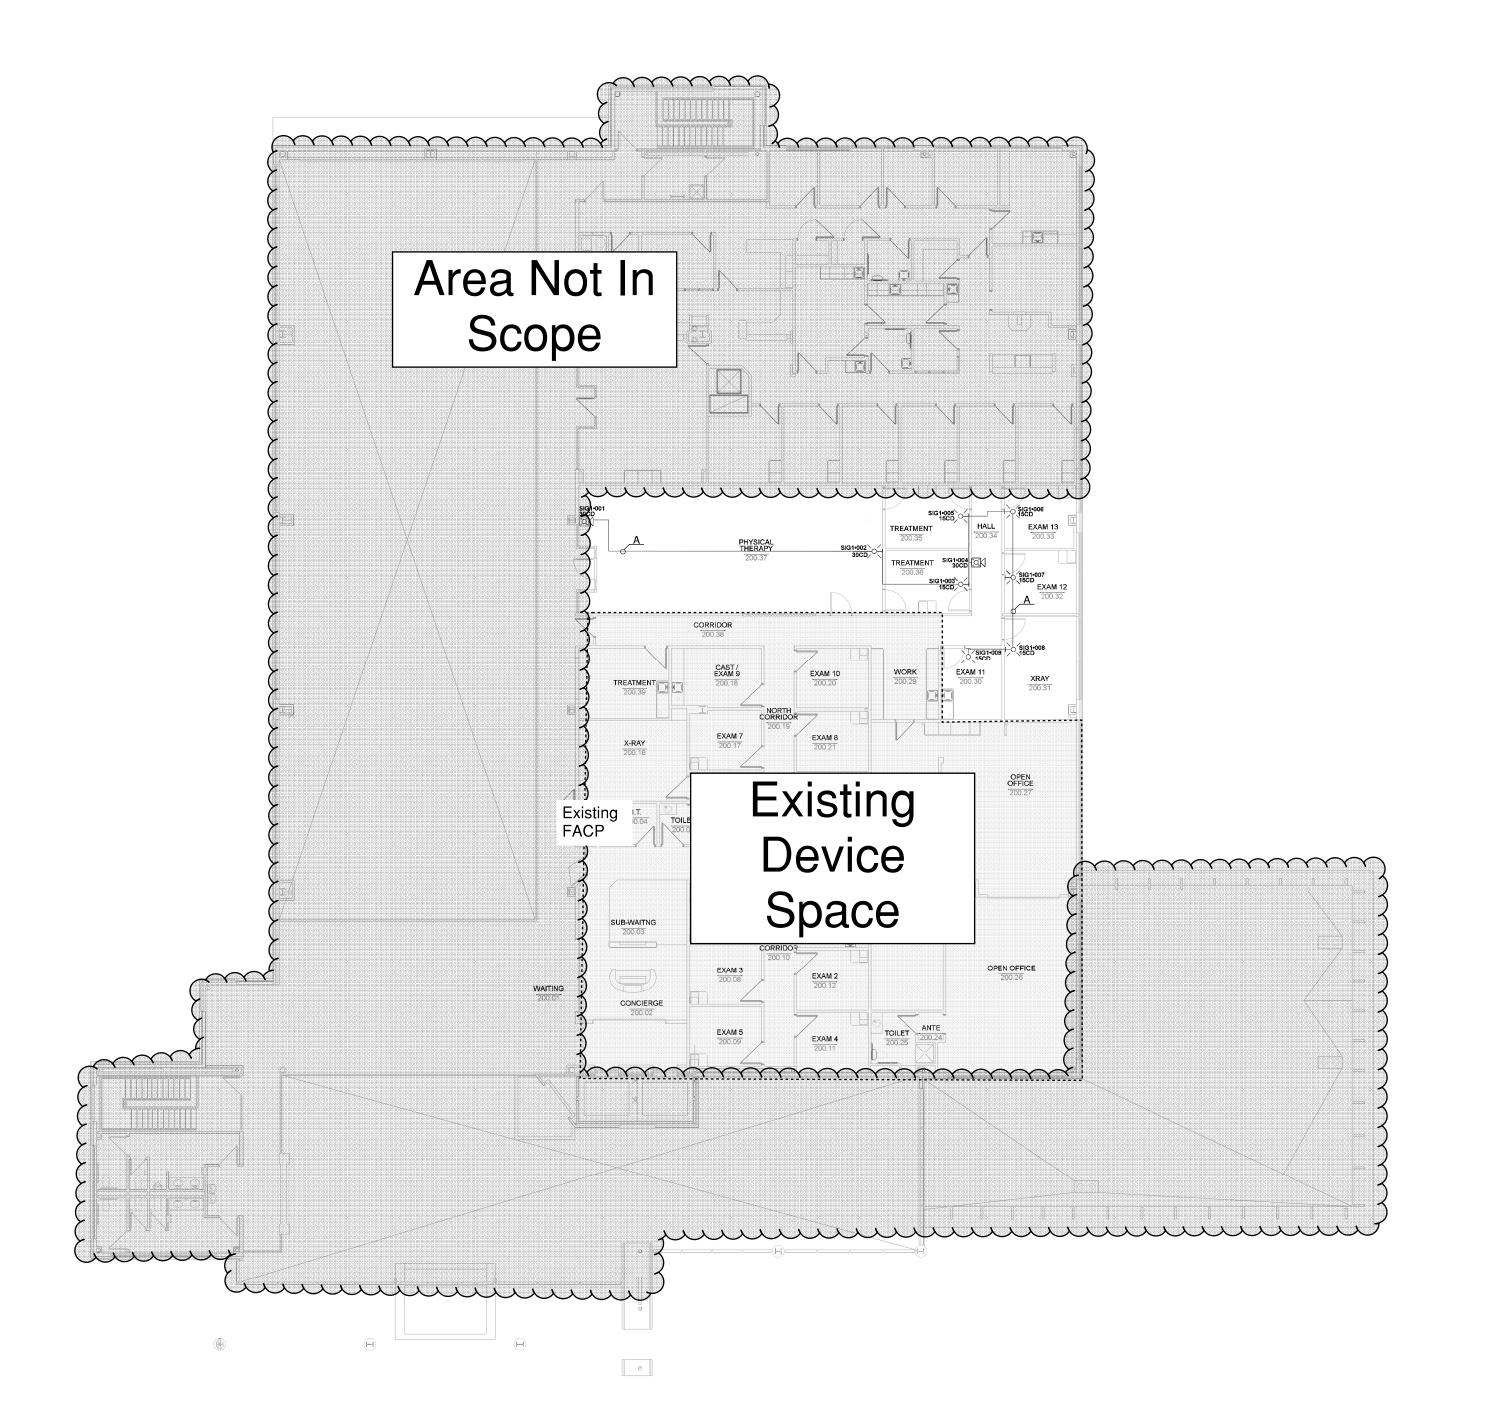

NOTES:

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 feet from any HVAC diffuser.
- 2. All manual pull stations shall be mounted four (4) feet above the finished floor (centerline of device, +or-6inches), unless otherwise noted.
- 3. All strobe and horn/strobes shall be located so the bottom of the device is not less than 80 inches above the finished floor and not greater than 96 inches above the finished floor.
- All notification devices shall be located no less than 6 inches below finished ceilings.
- 5. The candela rating of the strobes or horn/strobes shall be shown on the drawings.
- 6. The location of the notification devices shall be at a uniform height for all devices.
- 7. All cables, conduits, or wire mold shall be securely fastened to the structure.
- 8. Smoke detectors shall be located in the ceiling no less than 4 inches from a sidewall to the nearest edge of the detector.
- Drawings indicate general fire alarm device locations and Field Verify device locations with minimal deviations and document any changes.
- 10. FACP & Power Supplies shall be on a dedicated 120V, 20A circuit breaker marked in red with lock-on provision.
- 11. Fire Alarm wire paths are reserved for fire alarm cabling only. Including all UL listed fire barrier penetrations.
- 12.Outdoor Weatherproof Horn/Strobe is to be mounted 10' 00" AFF FDC.
- 13. All ceilings are 10' or below unless otherwise noted.
- 14. Default batteries are 18 amp hour unless otherwise
- 15. LED Remote Test Switches are to be ceiling mounted directly below above ceiling duct detector.

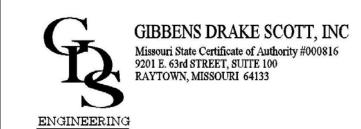

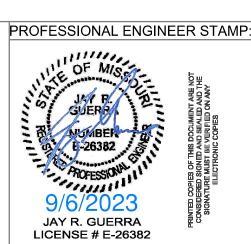

REVISION	S:		



913-491-1700 6985 W 153rd St 913-491-1701 Overland Park, KS 66223

SITE:2801 NE Independence Ave Suite 201, Lee's Summit


TITLE: Floor Plan

SCALE AT: 1/16"=1' DATE: DESIGNED BY:

8/29/2023 PROJECT NO: DRAWING NO:

DRAWING NO: REVISION:

NORTH 1/16" = 1'0" 0 12 24 36 48 60 FT

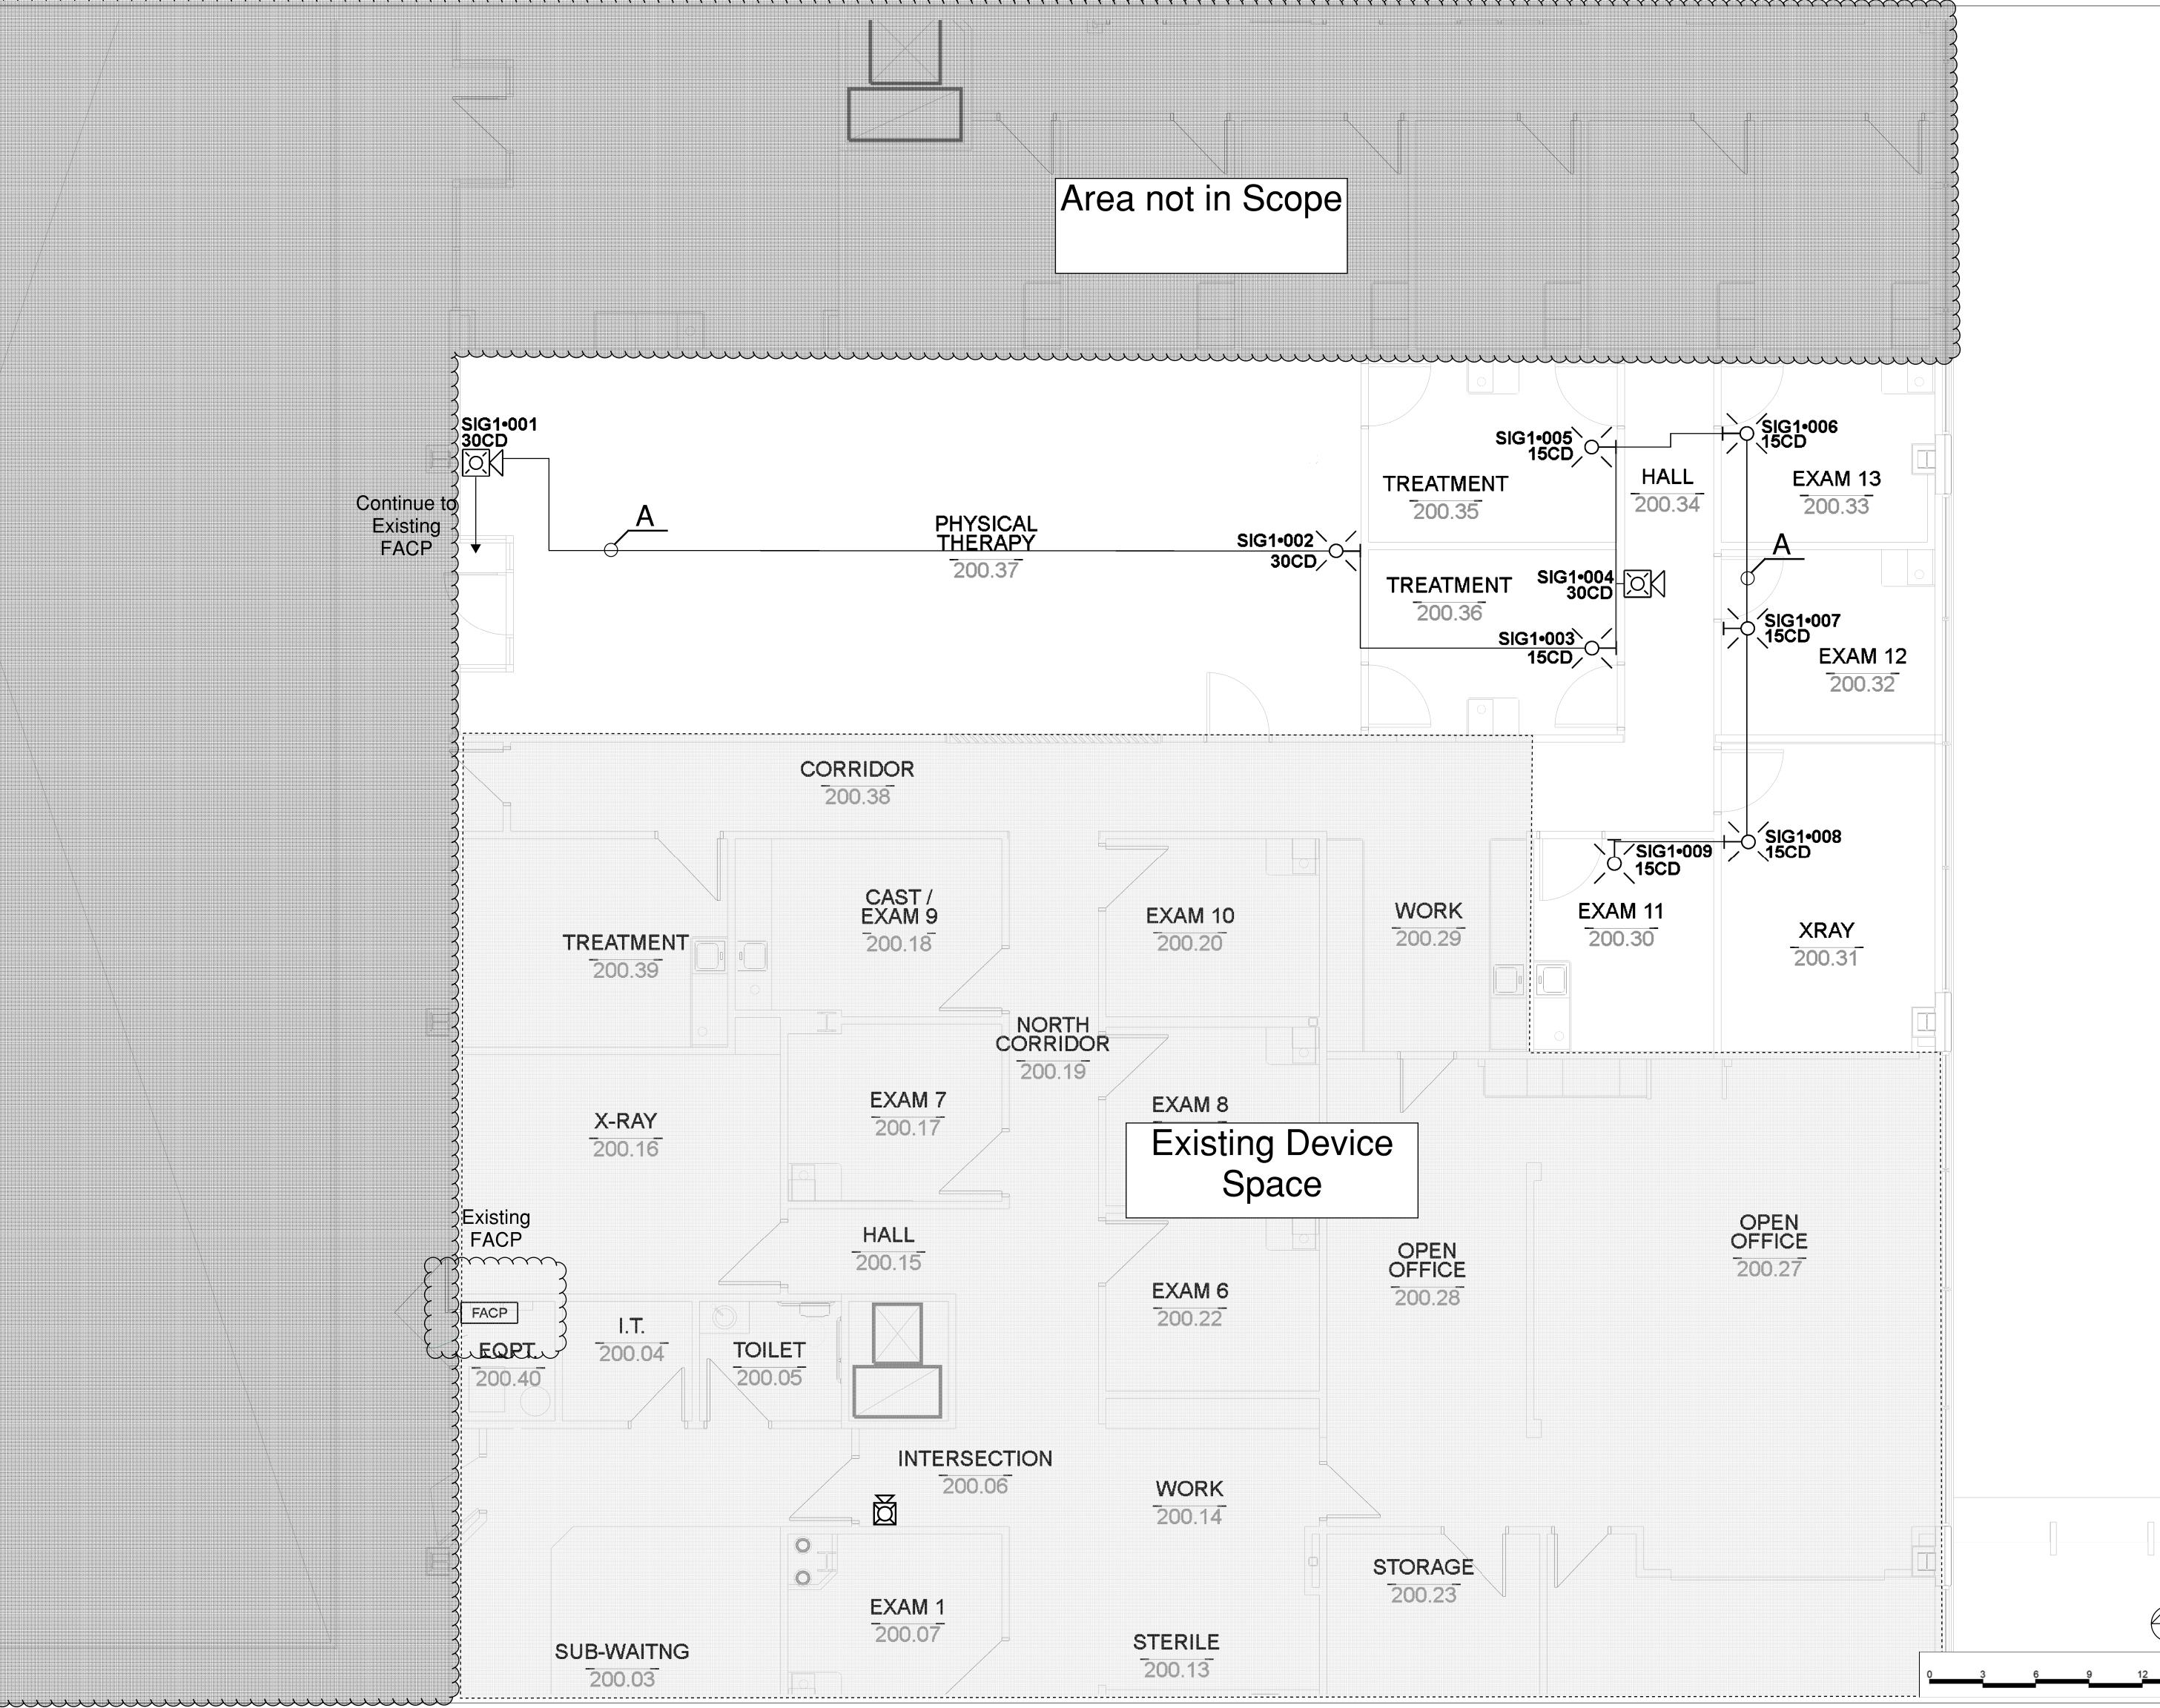

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RAYTOWN, MISSOURI 64133 ENGINEERING







SITE:2801 NE Independence Ave Suite 201, Lee's Summit

TITLE: Floor Plan-Remodeled Space Expanded

DESIGNED BY:

8/29/2023

Battery Calculations for Panel: Existing FACP

Part No:IPA-60 - IPA-60, 60 POINT RELEASING FACP

Job number: 1 Job name: Drawing1

Part No.	Qty.	Description	Standby	Total Standby	Alarm	Total Alarm
		Panel Equipment				
IPA60_MB	1	IPA60_MB	160.0000 mA	160.0000 mA	200.0000 mA	200.0000 m/
			Total Panel Stby	160.0000 mA	Total Panel Alarm	200.0000 mA
		Peripheral Devices				
S-24WW	6	STROBE, M-C, WHITE, WALL (Notification) 15CD	0.0000 mA	0.0000 mA	42.0000 mA	252.0000 m/
HS-24WW	2	HORN/STROBE, 2 WIRE, M-C,WHITE, WALL (Notification) 30CD 70dB	0.0000 mA	0.0000 mA	73.0000 mA	146.0000 m
S-24WW	1	STROBE, M-C, WHITE, WALL (Notification) 30CD	0.0000 mA	0.0000 mA	58.0000 mA	58.0000 mA
			Total Peripheral Stby	0.0000 mA	Total Periph Alarm	456.0000 m <i>A</i>
			Total Standby Amps	160.0000 mA	Total Alarm Amps	656.0000 m/

Standby time: 24 Hrs

3.84 Ah 0.055 Ah

Alarm time: 5 Min

Battery requirement: 3.895 Ah

Compensation Factors - Standby:1.25 Alarm:1.25 Requirement with compensation:

Circuit Calculations

Panel: Existing FACP Card: 00 Circuit:SIG1

Circuit Name: SIG1

Circuit Type: Notification

Terminal Voltage: 20.4 V:DC Amperage: 3.0000 A

Cable: 16 AWG 2 CONDUCTOR BARE COPPER, TWISTED, SHIELDED, PLENUM FA, FPLP #16


Calculations based on Running Total Length.

Design Criteria: Ambient temperature: 167 °F Max. operating voltage drop: 18%

Device	Part No	Appliance Desc	Distance	Current	Voltage	Voltage Drop
	IPA-60	Panel			20.4 V	
001	HS-24WW	HORN/STROBE, 2 WIRE, M-C,WHITE, WALL, 30CD	58'-6	73.0000 mA	20.2678 V	(0.1322 V)
002	S-24WW	STROBE, M-C, WHITE, WALL, 30CD	53'-81/2	58.0000 mA	20.1663 V	(0.1015 V)
003	S-24WW	STROBE, M-C, WHITE, WALL, 15CD	18'-61/2	42.0000 mA	20.137 V	(0.0292 V)
005	S-24WW	STROBE, M-C, WHITE, WALL, 15CD	11'-3	42.0000 mA	20.1254 V	(0.0116 V)
006	S-24WW	STROBE, M-C, WHITE, WALL, 15CD	8'-61/2	42.0000 mA	20.1187 V	(0.0067 V)
007	S-24WW	STROBE, M-C, WHITE, WALL, 15CD	11'-0	42.0000 mA	20.1118 V	(0.0069 V)
008	S-24WW	STROBE, M-C, WHITE, WALL, 15CD	11'-11	42.0000 mA	20.1071 V	(0.0046 V)
009	S-24WW	STROBE, M-C, WHITE, WALL, 15CD	7'-5	42.0000 mA	20.1057 V	(0.0015 V)
004	HS-24WW	HORN/STROBE, 2 WIRE, M-C,WHITE, WALL, 30CD	0'-11½	73.0000 mA	20.1328 V	(0 V)
			181'-101⁄2	456.0000 mA		

Total Current: 456.0000 mA

(Total VDrop Percent:1.44%) Total Voltage Drop: 0.2943 V

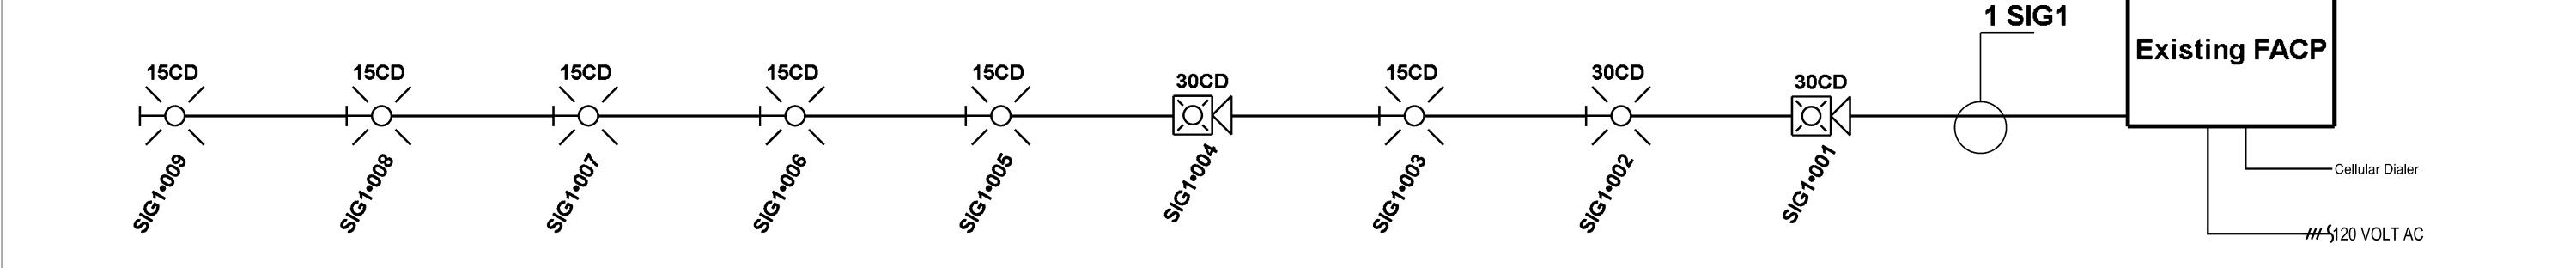

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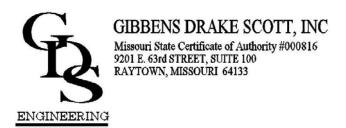
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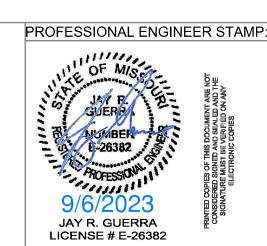
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REVISIONS:	DATE:



ITE:2801 NE Independence Ave Suite 201, Lee's Summit	

TITLE: Battery Calculations, Riser Diagram

DATE: DESIGNED BY:


SCALE AT:

PROJECT NO:


8/29/2023

DRAWING NO:

REVISION:

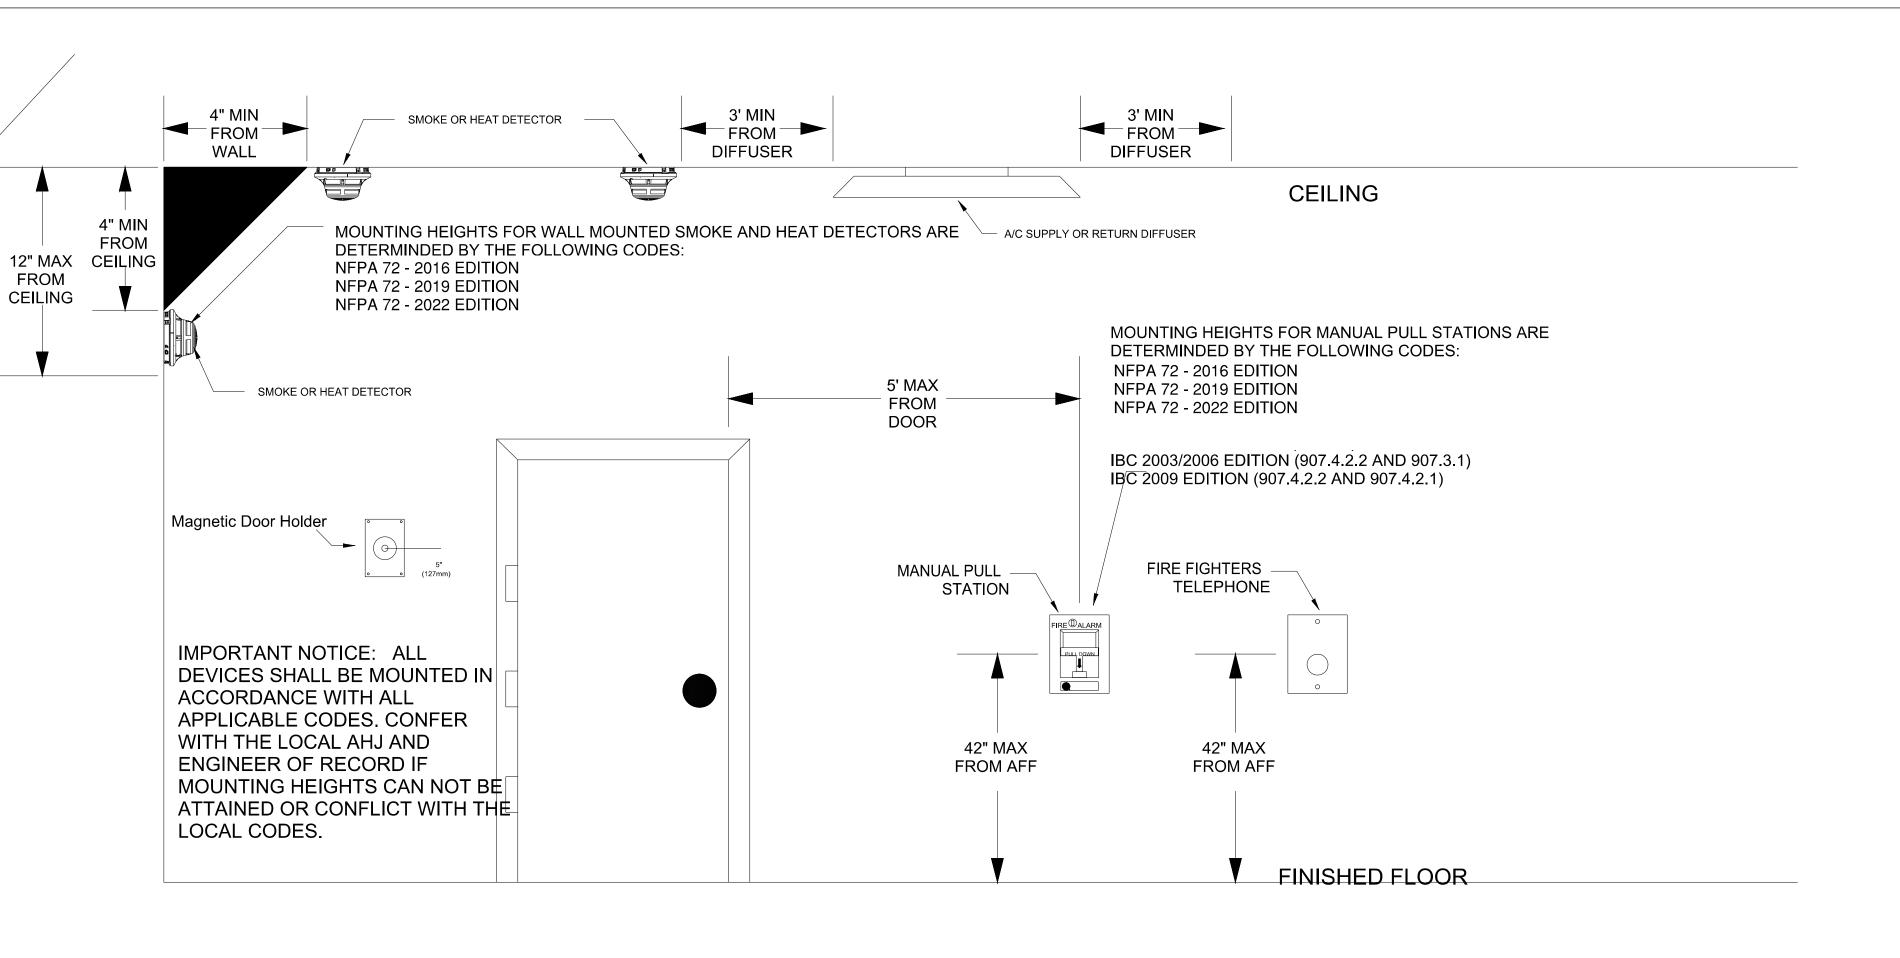

FROM

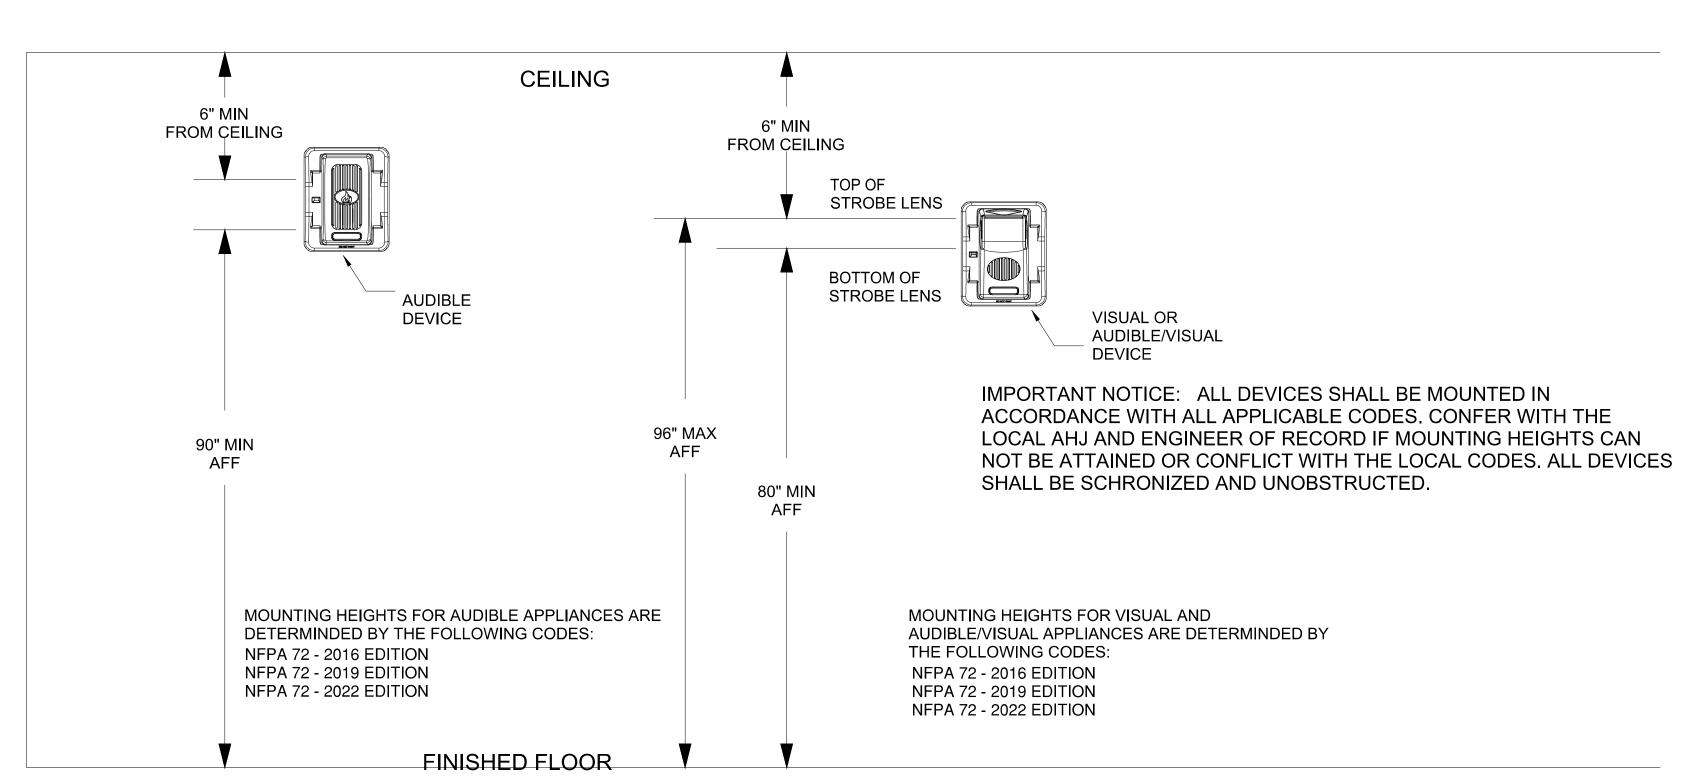

NFPA 72 Device Reference

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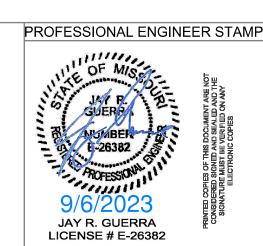
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SITE:2801 NE Independence Ave Suite 201, Lee's

DESIGNED BY: 8/29/2023 DRAWING NO:

Summit TITLE: NFPA 72 Reference