



RELEASE FOR CONSTRUCTION
 AS NOTED FOR PLAN REVIEW
 DEVELOPMENT SERVICES
 LEE'S SUMMIT, MISSOURI
07/07/2023

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PROJECT NO. 21-044-01
 DRAWN BY: KP, HRP
 DATE: 10-12-21
 PROJECT NO. 21-044-01
 SHEET NO. 01 OF 02

1800 SOUTH GREEN ROAD
 SUITE 100, LEE'S SUMMIT, MISSOURI 64081
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PERGOLA PARK LOT 119

DAVID & DIANE PARRISH
 3246 SW PERGOLA PARK DR.
 LEE'S SUMMIT, MO 64081

LANDROCK SIGNATURE HOMES LLC,
 4335 McGEE ST. - 616-863-6666
 KANSAS CITY, MO 64111



DRAWN BY: KP, HRP
 DATE: 10-12-21
 PROJECT NO. 21-044-01

SHEET NO. **A0**

FLOOR PLAN - SYMBOL LEGEND	
DESCRIPTION	SYMBOL
INTERIOR LOAD BEARING WALL	[Symbol]
STONE OR BRICK VENEER	[Symbol]
JOIST SIZE AND DIRECTION	[Symbol]
HEADER / BEAM	SIZE OF MEMBER PER BEAM / HEADRY BEAM SCHEDULE
BEAM	NUMBER OF PLYS 1/4" P UPSET
CENTERLINE	[Symbol]
POINT LOAD	[Symbol]
APPROX WINDOW FRAME SIZE IN INCHES (SEE GENERAL NOTES BELOW)	[Symbol]
SMOKE ALARM	[Symbol]
SMOKE & CARBON MONOXIDE ALARM	[Symbol]

HEADER / BEAM SCHEDULE			
MARK	LUMBER SIZE	CRIPPLE STUDS	TRIMMERS
(A)	2 x 6	1	
(B)	2 x 8	1	
(C)	2 x 10	1	
(D)	2 x 12	1	
(E)	1 1/2" x 10" LVL	2	
(F)	1 1/2" x 9 1/2" LVL	2	
(G)	1 1/2" x 8 1/2" LVL	2	
(H)	1 1/2" x 7 1/2" LVL	2	
(I)	1 1/2" x 6 1/2" LVL	2	
(J)	1 1/2" x 5 1/2" LVL	2	
(K)	1 1/2" x 4 1/2" LVL	2	
(L)	1 1/2" x 3 1/2" LVL	2	

1. BEAMS SHALL HAVE TOTAL NUMBER OF CRIPPLES AND TRIMMERS UNDER EACH END, SOLID BLOCK BELOW
 2. FOR LVL, BEAMS IN 2ND FLOORS, USE 3 1/4" LVL

FLOOR JOIST SCHEDULE			
MARK	TYPE	SUB-TYPE	SIZE (SPACING) MAX SPAN
FJ-1	1"	JOIST (SEE NOTE)	1 1/2" PER MANUFACTURER
FJ-2	1"	JOIST (SEE NOTE)	1 1/2" PER MANUFACTURER
FJ-3	1"	JOIST (SEE NOTE)	1 1/2" PER MANUFACTURER
FJ-4	1"	JOIST (SEE NOTE)	1 1/2" PER MANUFACTURER
FJ-5	1"	JOIST (SEE NOTE)	1 1/2" PER MANUFACTURER
FJ-6	1"	JOIST (SEE NOTE)	1 1/2" PER MANUFACTURER
FJ-7	1"	JOIST (SEE NOTE)	1 1/2" PER MANUFACTURER
FJ-8	1"	JOIST (SEE NOTE)	1 1/2" PER MANUFACTURER
FJ-9	1"	JOIST (SEE NOTE)	1 1/2" PER MANUFACTURER
FJ-10	1"	JOIST (SEE NOTE)	1 1/2" PER MANUFACTURER
FJ-11	1"	JOIST (SEE NOTE)	1 1/2" PER MANUFACTURER
FJ-12	1"	JOIST (SEE NOTE)	1 1/2" PER MANUFACTURER
FJ-13	1"	JOIST (SEE NOTE)	1 1/2" PER MANUFACTURER
FJ-14	1"	JOIST (SEE NOTE)	1 1/2" PER MANUFACTURER
FJ-15	1"	JOIST (SEE NOTE)	1 1/2" PER MANUFACTURER
FJ-16	1"	JOIST (SEE NOTE)	1 1/2" PER MANUFACTURER

NOTE: PERSON JOISTS (LOADED W/ TOTAL LIVE AND DEAD LOAD) WITH A MAX DEFLECTION OF L/360 EXCEPT BELOW BATHROOMS AND TILED AREAS WHERE THE DEFLECTION SHALL BE L/480 MAX.


CONCRETE WALL SCHEDULE			
MARK	THICKNESS	HEIGHT	REINFORCING
(1)	8"	4' OR LESS	4#3 AT 36" O.C. 2 #4'S
(2)	8"	4' TO 8'	4#3 AT 36" O.C. 2 #4'S
(3)	8"	6' TO 8'	4#3 AT 36" O.C. 2 #4'S
(4)	8"	8'	4#3 AT 36" O.C. 4 #4'S
(5)	8"	8'	4#3 AT 36" O.C. 4 #4'S
(6)	8"	8'	4#3 AT 36" O.C. 4 #4'S
(82)	8"	8'	4#3 AT 36" O.C. 4 #4'S
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(86)	8"	8'	4#3 AT 36" O.C. 4 #4'S
(87)	8"	8'	4#3 AT 36" O.C. 4 #4'S
(88)	8"	8'	4#3 AT 36" O.C. 4 #4'S
(89)	8"	8'	4#3 AT 36" O.C. 4 #4'S
(90)	8"	8'	4#3 AT 36" O.C. 4 #4'S
(91)	8"	8'	4#3 AT 36" O.C. 4 #4'S
(92)	8"	8'	4#3 AT 36" O.C. 4 #4'S
(93)	8"	8'	4#3 AT 36" O.C. 4 #4'S
(94)	8"	8'	4#3 AT 36" O.C. 4 #4'S
(95)	8"	8'	4#3 AT 36" O.C. 4 #4'S
(96)	8"	8'	4#3 AT 36" O.C. 4 #4'S
(97)	8"	8'	4#3 AT 36" O.C. 4 #4'S
(98)	8"	8'	4#3 AT 36" O.C. 4 #4'S
(99)	8"	8'	4#3 AT 36" O.C. 4 #4'S
(100)	8"	8'	4#3 AT 36" O.C. 4 #4'S

COLUMN & PAD SCHEDULE				
MARK	PAD SIZE	4 BARS REQD EACH WAY	COLUMN SIZE (SCHEDULE 40)	MAX LOAD
(A)	36"x36"x21"	3"	12"	183.8 K
(B)	48"x48"x21"	3"	12"	249.6 K
(C)	60"x60"x21"	3"	12"	315.4 K
(D)	72"x72"x21"	3"	12"	381.2 K

PIER SCHEDULE		
MARK	PIER DIAMETER	POST (AGG OR CEDAR UNG)
(1)	8"	6#6 UNG
(2)	8"	6#6 UNG
(3)	8"	6#6 UNG
(4)	8"	6#6 UNG
(5)	8"	6#6 UNG
(6)	8"	6#6 UNG
(7)	8"	6#6 UNG
(8)	8"	6#6 UNG
(9)	8"	6#6 UNG
(10)	8"	6#6 UNG
(11)	8"	6#6 UNG
(12)	8"	6#6 UNG
(13)	8"	6#6 UNG
(14)	8"	6#6 UNG
(15)	8"	6#6 UNG
(16)	8"	6#6 UNG
(17)	8"	6#6 UNG
(18)	8"	6#6 UNG
(19)	8"	6#6 UNG
(20)	8"	6#6 UNG
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(95)	8"	6#6 UNG
(96)	8"	6#6 UNG
(97)	8"	6#6 UNG
(98)	8"	6#6 UNG
(99)	8"	6#6 UNG
(100)	8"	6#6 UNG

GENERAL NOTES:
 A. FURNACE IS DIRECT VENT AND USES OUTSIDE AIR FOR COMBUSTION
 B. FOR COVERED PORCH FRAMING - SEE DETAIL 1/63
 C. SEE G4 SHEET FOR LOCATION OF HOLD-DOWN TIES FOR BRACED WALL PANELS

FOUNDATION PLAN NOTES:
 1. SEE DETAIL 3/62 FOR GARAGE SLAB CONSTRUCTION.
 2. SILL PLATE SET BACK - SEE DETAIL 4/6/62
 3. CONCRETE PIER AND PAD - SEE DETAIL 3/62
 4. RETURN WALL - SEE DETAIL 8/62
 5. CONCRETE WINDOW WELL WITH LADDER - SEE DETAIL 3/62
 6. CONCRETE DOORWAY HEADER - SEE DETAIL 1/62
 7. RECESSED CONCRETE SLAB FLOOR FOR ZERO ENTRY SHOWER
 8. 16" WIDE X 8" DEEP CONCRETE FOOTING W/2-#4 BARS CONTINUOUS
 9. 2x4 STUDS @ 16" O.C. WITH TREATED SILL PLATE.
 10. LEDGE OVER EXPOSED CONCRETE AND FINISH WALL
 11. ROUGH-IN FOR FUTURE SHOWER
 12. RECESSED FLOOR FRAMING 2" FOR ZERO ENTRY SHOWER ABOVE
 13. PROVIDE THERMAL EXPANSION CONTROL DEVICE
 14. SUMP PIT & PUMP: PROVIDE ELECTRICAL RECEPTACLE WITH GFCI PROTECTION. PROVIDE SLEEVE THROUGH FOOTING

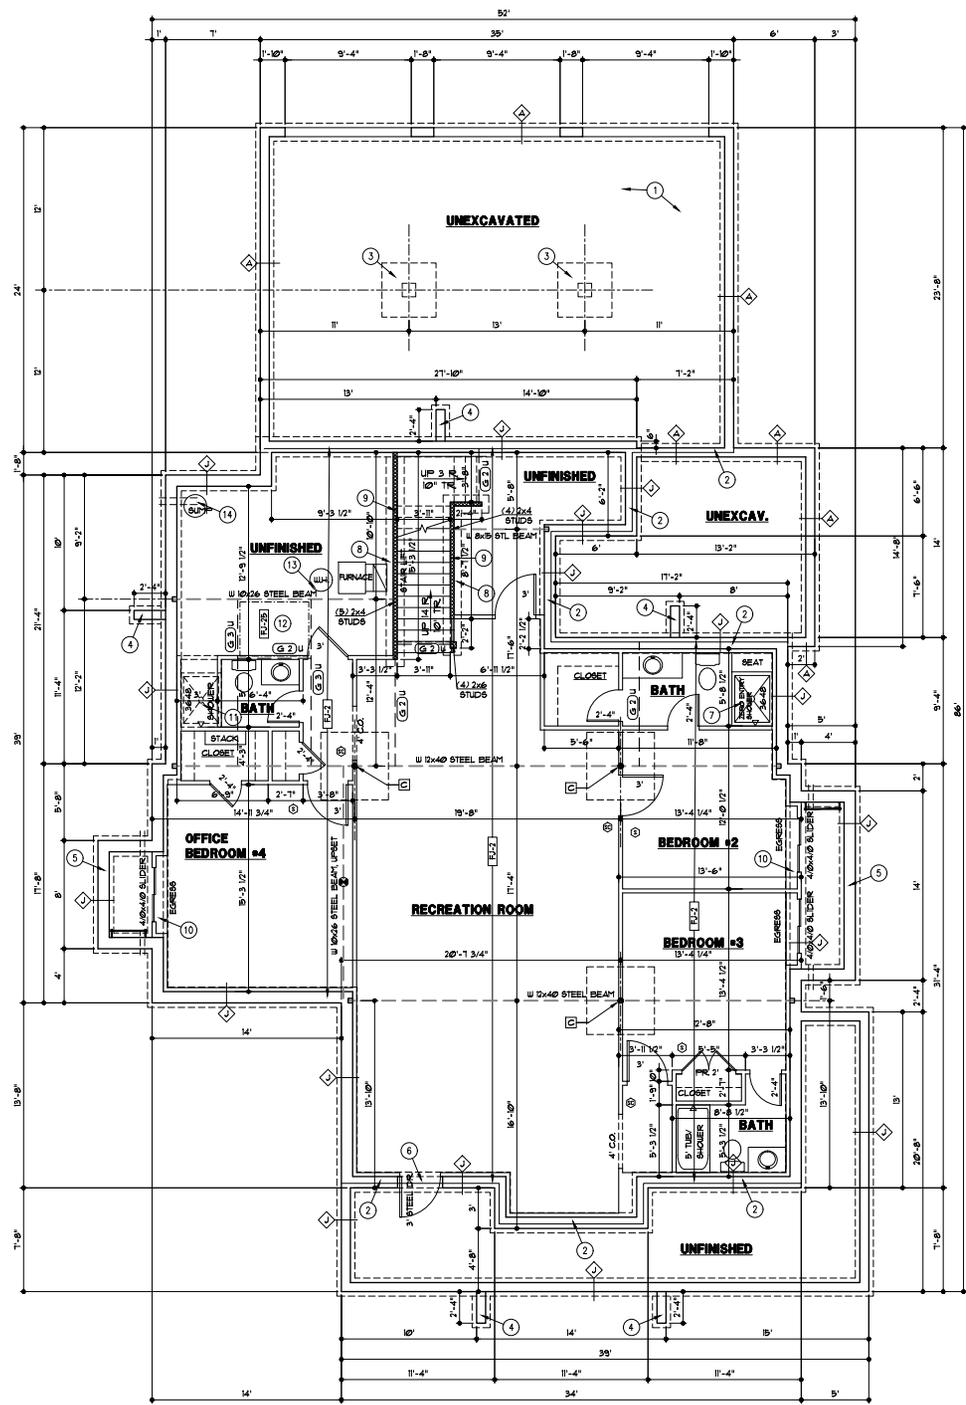

THESE DRAWINGS TO BE USED FOR THIS ADDRESS ONLY AND THEY SHALL NOT BE USED AS MASTER PLAN



RELEASE FOR CONSTRUCTION
 AS NOTED FOR PLAN REVIEW
 DEVELOPMENT SERVICES
 LEE'S SUMMIT, MISSOURI
 07/07/2023

FOUNDATION PLAN
 1/4"

DESCRIPTION	SYMBOL
INTERIOR LOAD BEARING WALL	
STONE OR BRICK VENEER	
JOIST SIZE AND DIRECTION	
HEADER/ BEAM	SIZE OF MEMBER PER HEADY BEAM SCHEDULE
BEAM	NUMBER OF PLYS
	1/4" P UPSET


MARK	LUMBER SIZE	CRIPPLE STUDS	TRIMMERS
(A)	2x6	1	
(B)	2x8	1	
(C)	2x10	1	
(D)	2x10	1	
(E)	1 1/2" x 10" LVL	2	
(F)	1 1/2" x 9 1/2" LVL	2	
(G)	1 1/2" x 10" LVL	2	
(H)	1 1/2" x 10" LVL	2	
(I)	1 1/2" x 10" LVL	3	
(J)	1 1/2" x 10" LVL	1	
(K)	1 1/2" x 10" LVL	1	
(L)	1 1/2" x 10" LVL	1	

1. BEAMS SHALL HAVE TOTAL NUMBER OF CRIPPLES AND TRIMMERS UNDER EACH END, SOLID BLOCK BELOW.
 2. FOR LVL, BEAMS IN 2x10 FLOORS, USE 9 1/4" LVL.

MARK	SIZE	SPACING	MAXIMUM SPAN - DOUGLAS FIR 2
CJ-1	2x6	16"	19'-8"
CJ-2	2x6	16"	17'-8"
CJ-3	2x8	16"	25'-8"
CJ-4	2x8	16"	23'-0"
CJ-5	2x8	16"	26'-0"
CJ-6	2x8	16"	26'-0"
CJ-7	2x4	24"	9'-10"
CJ-8	2x6	24"	14'-10"
CJ-9	2x8	24"	18'-8"
CJ-10	2x8	24"	22'-3"

GENERAL NOTES:
 A. EXTERIOR WALLS ARE 2x4 STUDS AT 16" O.C. UNLESS OTHERWISE NOTED.
 B. SOLID BLOCKING BELOW STUDS SUPPORTING BEAMS AND HEADERS.
 C. SEE G4 SHEET FOR LOCATION OF HOLD-DOWN TIES FOR BRACED WALL CONSTRUCTION.

- FLOOR PLAN NOTES
- 1'-8 1/8" TALL WALL FROM 2ND FLOOR DECK
 - 5'-6 3/4" TALL WALL FROM 2ND FLOOR DECK
 - 2'-6"x3'-6" ATTIC ACCESS PANEL
 - 5'-1 1/4" TALL WALL FROM 1ST FLOOR CEILING
 - 5'-0" TALL WALL FROM 1ST FLOOR CEILING
 - 15'-1" TALL WALL, 2x6 STUDS AT 12" O.C.
 - 3'-0" TALL WALL FROM 1ST FLOOR CEILING
 - 2x6 STUDS AT 16" O.C.
 - 3 STUDS BETWEEN WINDOWS

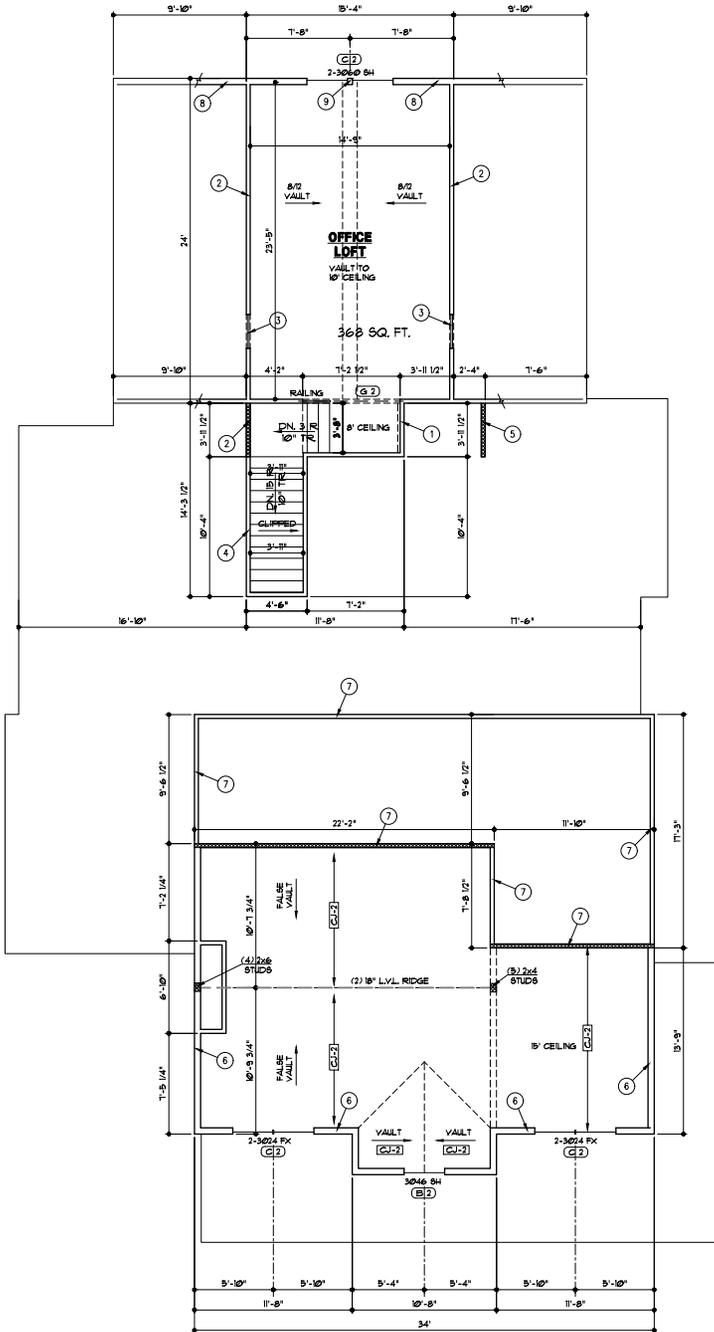

THESE DRAWINGS TO BE USED FOR THIS ADDRESS ONLY AND THEY SHALL NOT BE USED AS MASTER PLAN

SECOND FLOOR PLAN
 1/4" = 1'-0"



PERGOLA PARK LOT 119

DAVID & DIANE PARRISH
 3246 SW PERGOLA PARK DR.
 LEE'S SUMMIT, MO 64081

LANDROCK SIGNATURE HOMES LLC,
 4335 McGEE ST. - 816-863-6668
 KANSAS CITY, MO 64111




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 LEE'S SUMMIT, MISSOURI
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DESCRIPTION	SYMBOL
RIDGES AND HIP	---
VALLIES	---
BEAVEN, RAKE & GABLE	---
HOUSE WALLS	---
FURLIN	○
TOP OF FURLIN STRUT OR RIDGE POLE	○
BOT. OF FURLIN STRUT OR RIDGE POLE	○
LOWEST SIZE AND SPACING	→ RUFY ←
UPLIFT VALUE	600*

MARK	SIZE	SPACING	MAXIMUM SPAN	FLAT CEILING	VALLIED CEILING
RJ-1	2x6	12"	18'-7"	14'-9"	
RJ-2	2x6	16"	14'-4"	10'-9"	
RJ-3	2x6	24"	11'-5"	10'-9"	
RJ-4	2x8	12"	21'-0"	16'-8"	
RJ-5	2x6	16"	18'-2"	16'-2"	
RJ-6	2x8	24"	14'-10"	13'-2"	
RJ-7	2x10	12"	28'-8"	22'-9"	
RJ-8	2x10	16"	22'-3"	18'-9"	
RJ-9	2x10	24"	18'-2"	15'-1"	
RJ-10	2x2	16"	28'-9"	28'-5"	
RJ-11	2x2	24"	18'-2"	22'-10"	

- GENERAL NOTES:
- STRUTS TO BEAR ON WALLS AS INDICATED. CONTACT ARCHITECT WITH ANY PROPOSED CHANGE TO STRUT BEARING LOCATIONS. ARCHITECT THAT NEED TO VERIFY THAT BEAMS BELOW NEW STRUT LOCATION CAN SUPPORT ADDED LOADS.
 - SEE SHEET G1 FOR LOAD AND DEFLECTION LIMITATIONS
 - SEE SHEET G3 FOR ROOF FRAMING DETAILS 344/G3
 - ROOFING TO BE COMPOSITION-40 YR ON 30° FELT ON 1/4" OSB SHEATHING

- ROOF PLAN NOTES
- BEARING WALL OR BEAM BELOW
 - 2x6 FURLIN WITH 2x6 "T" BRACES AT 4' O.C. TO BEARING WALL/ BEAM BELOW
 - 2x6 "T" BRACE TO BEARING WALL OR BEAM BELOW. BRACE SHALL BE CONNECTED TO STRUCTURE AT ROOF AND CEILING WITH MINIMUM (5) 1/2" NAILS.
 - RAFTERS TO BEAR ON 2ND FLOOR KNEEWALLS
 - OVER FRAME THIS AREA
 - TIGHT BARGE SOFFIT
 - (3) 2x6 STUDS
 - BRACE RIDGE WITH 2x6 "T" BRACES TO BEARING WALLS OR BEAMS BELOW AT 4' O.C.
 - (4) 2x6 STUDS
 - (3) 1 3/4"x1 1/4" LVL'S
 - (4) 2x4 STUDS

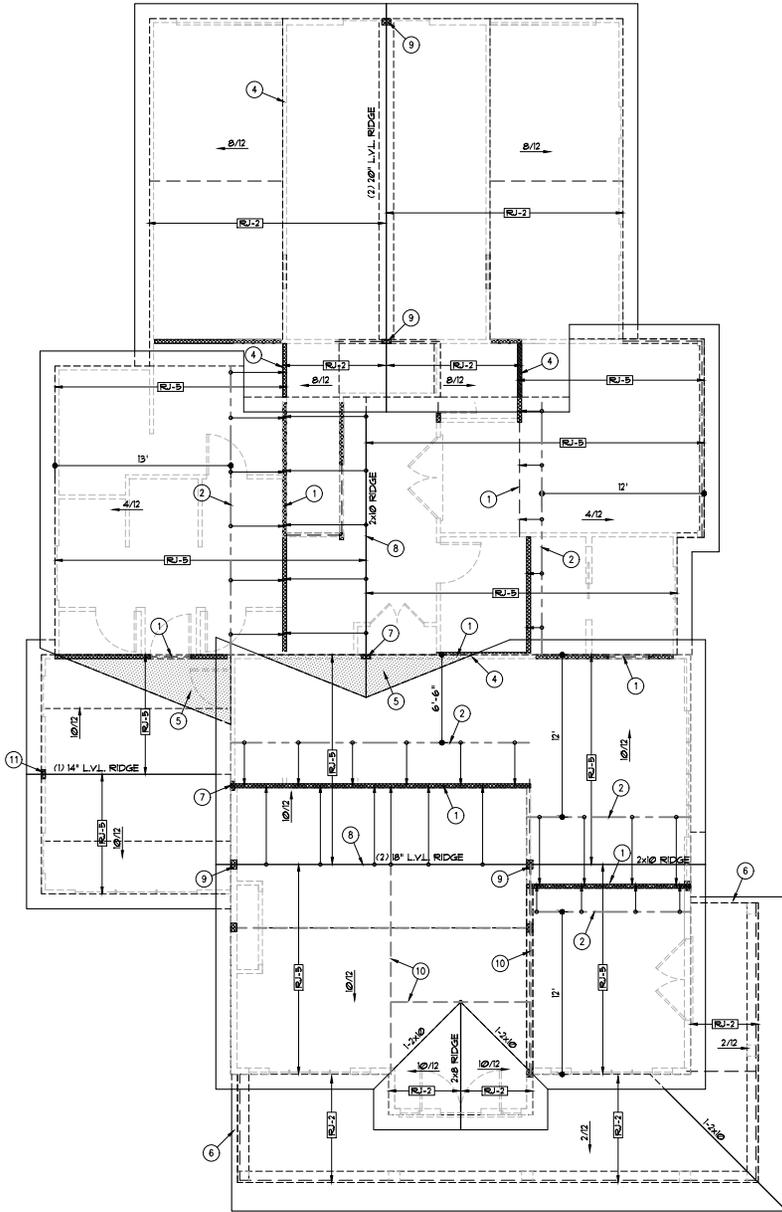

THESE DRAWINGS TO BE USED FOR THIS ADDRESS ONLY AND THEY SHALL NOT BE USED AS MASTER PLAN

ROOF PLAN
1/4" = 1'-0"
07/07/2023

PROJECT NO. 21-044-01
DATE: 07/07/2023
DRAWN BY: JF
CHECKED BY: JF
SCALE: AS SHOWN
SHEET NO. 21-044-01

Webster architects
1000 SOUTH GREEN ROAD
P.O. BOX 4880
PERGOLA PARK, MO 64081
www.websterarchitects.com


PERGOLA PARK LOT 119

DAVID & DIANE PARRISH
3246 SW PERGOLA PARK DR.
LEE'S SUMMIT, MO 64081


LANDROCK SIGNATURE HOMES LLC,
4335 McGEE ST. - 616-863-6666
KANSAS CITY, MO 64111




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DEVELOPMENT SERVICES
LEE'S SUMMIT, MISSOURI

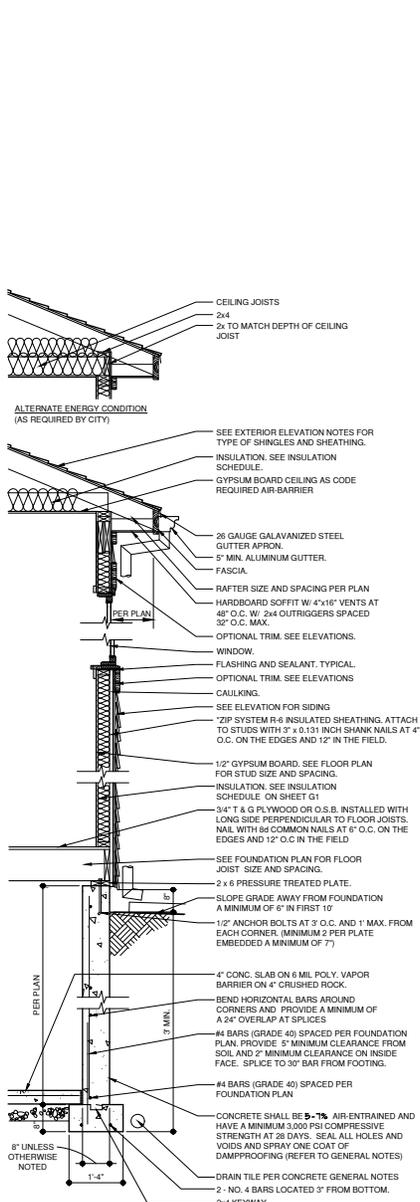

1 WALL SECTION
3/4"x1'-0"
A-DTW-0002-1E

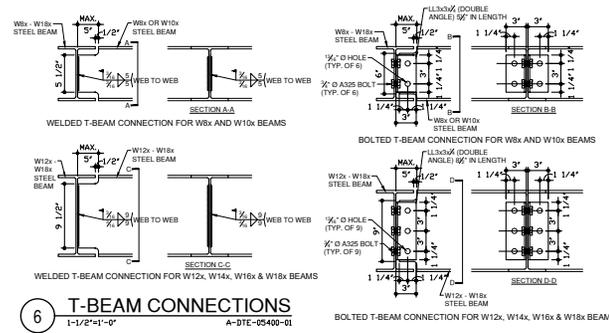


6 T-BEAM CONNECTIONS
1-1/2"x1'-0"
A-DTE-0300-01

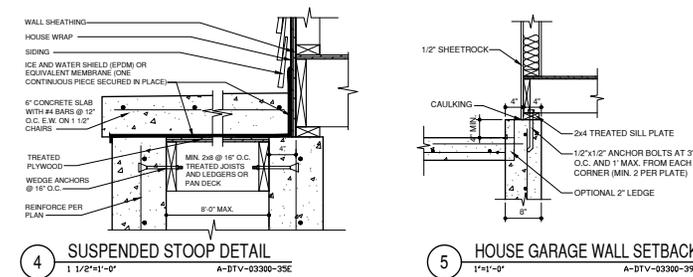


4 SUSPENDED STOOP DETAIL
1-1/2"x1'-0"
A-DTV-0300-35C


5 HOUSE GARAGE WALL SETBACK
1"x1'-0"
A-DTV-0300-39B

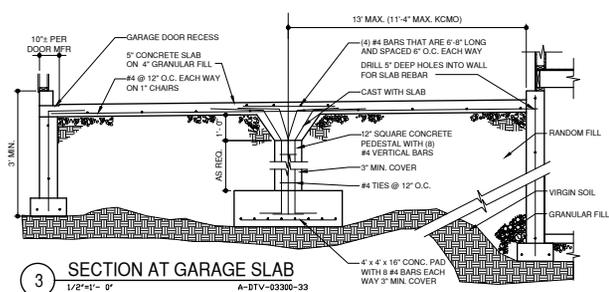


3 SECTION AT GARAGE SLAB
1/2"x1'-0"
A-DTV-0300-33

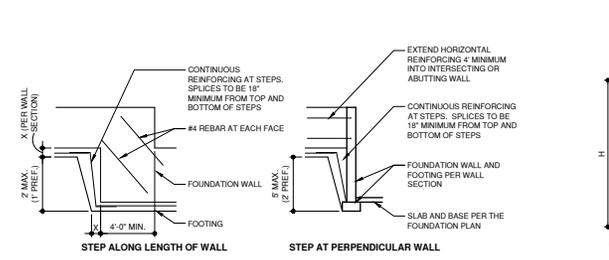


2 ELEVATION AT FOUNDATION STEP
1/4"x1'-0"
A-DTE-0300-01

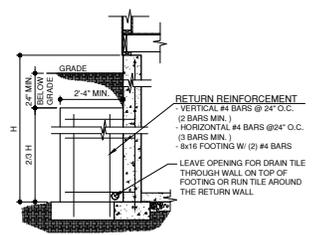

8 RETURN WALL DETAIL
1/2"x1'-0"
A-DTV-0300-34

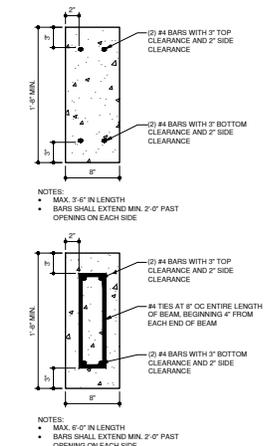

11 CONCRETE HEADER DETAILS
1-1/2"x1'-0"
A-DTV-0300-46

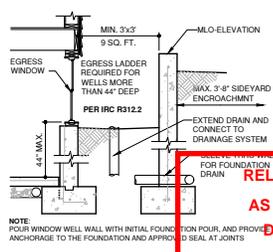

9 WINDOW WELL SECTION
1/2"x1'-0"
A-DTV-0300-32

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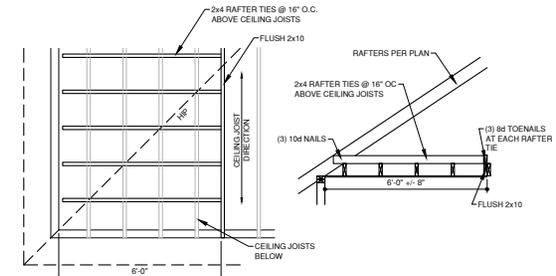
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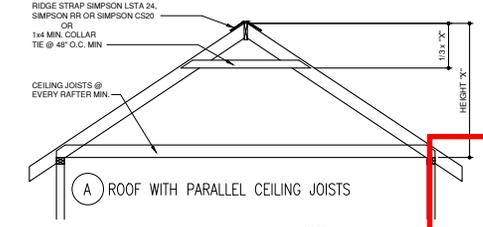
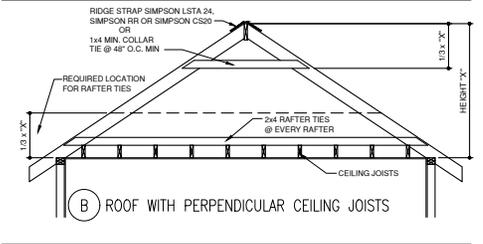
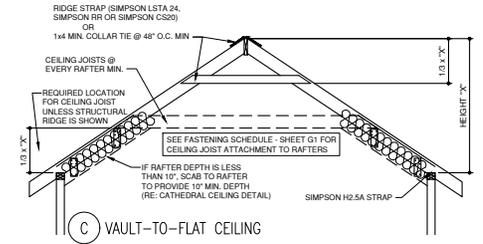
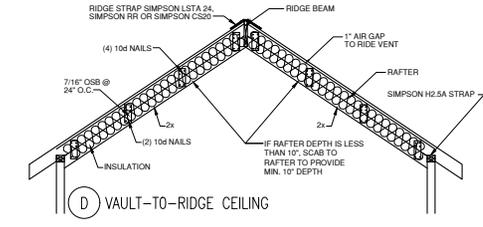
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1-5-2022




4 ROOF W/ PERPENDICULAR CEILING JOISTS
 1/2"x1'-0" A-DTV-06100-09




3 ROOF FRAMING DETAIL
 1/2"x1'-0" A-DTV-06100-04

NOTE:
 ROOF FRAMING TO COMPLY WITH SECTIONS
 R802, R802.3, R802.3.1 AND R802.11

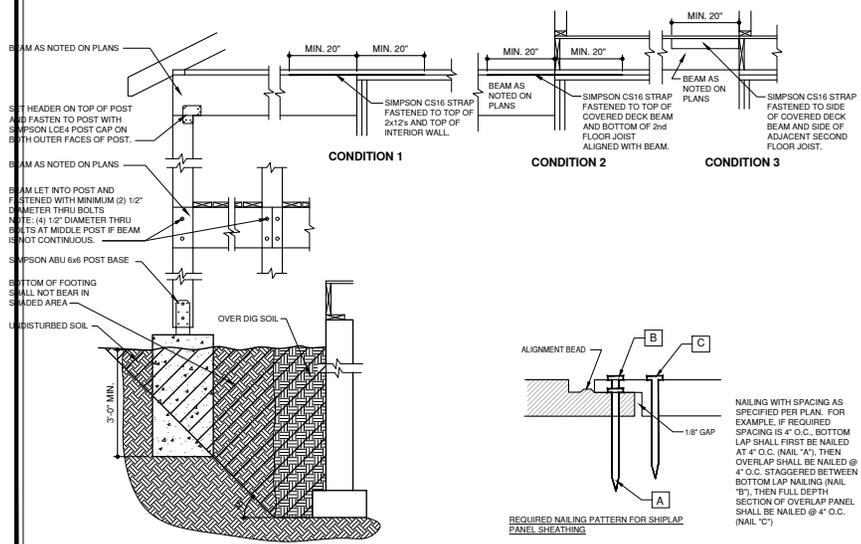

1 COVERED PORCH DETAIL
 3/4"x1'-0" A-DTV-06100-07

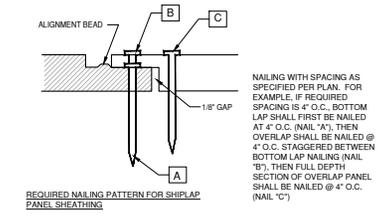

2 SHEATHING NAILING DETAIL
 1/2"x1'-0" A-DTV-06062-26

NAILING WITH SPACING AS SPECIFIED PER PLAN. FOR EXAMPLE, IF REQUIRED SPACING IS 4" O.C., BOTTOM LAP SHALL FIRST BE NAILED AT 4" O.C. (NAIL "A"), THEN OVERLAP SHALL BE NAILED @ 4" O.C. STAGGERED BETWEEN BOTTOM LAP NAILING (NAIL "B"), THEN FULL DEPTH SECTION OF OVERLAP PANEL SHALL BE NAILED @ 4" O.C. (NAIL "C")

