

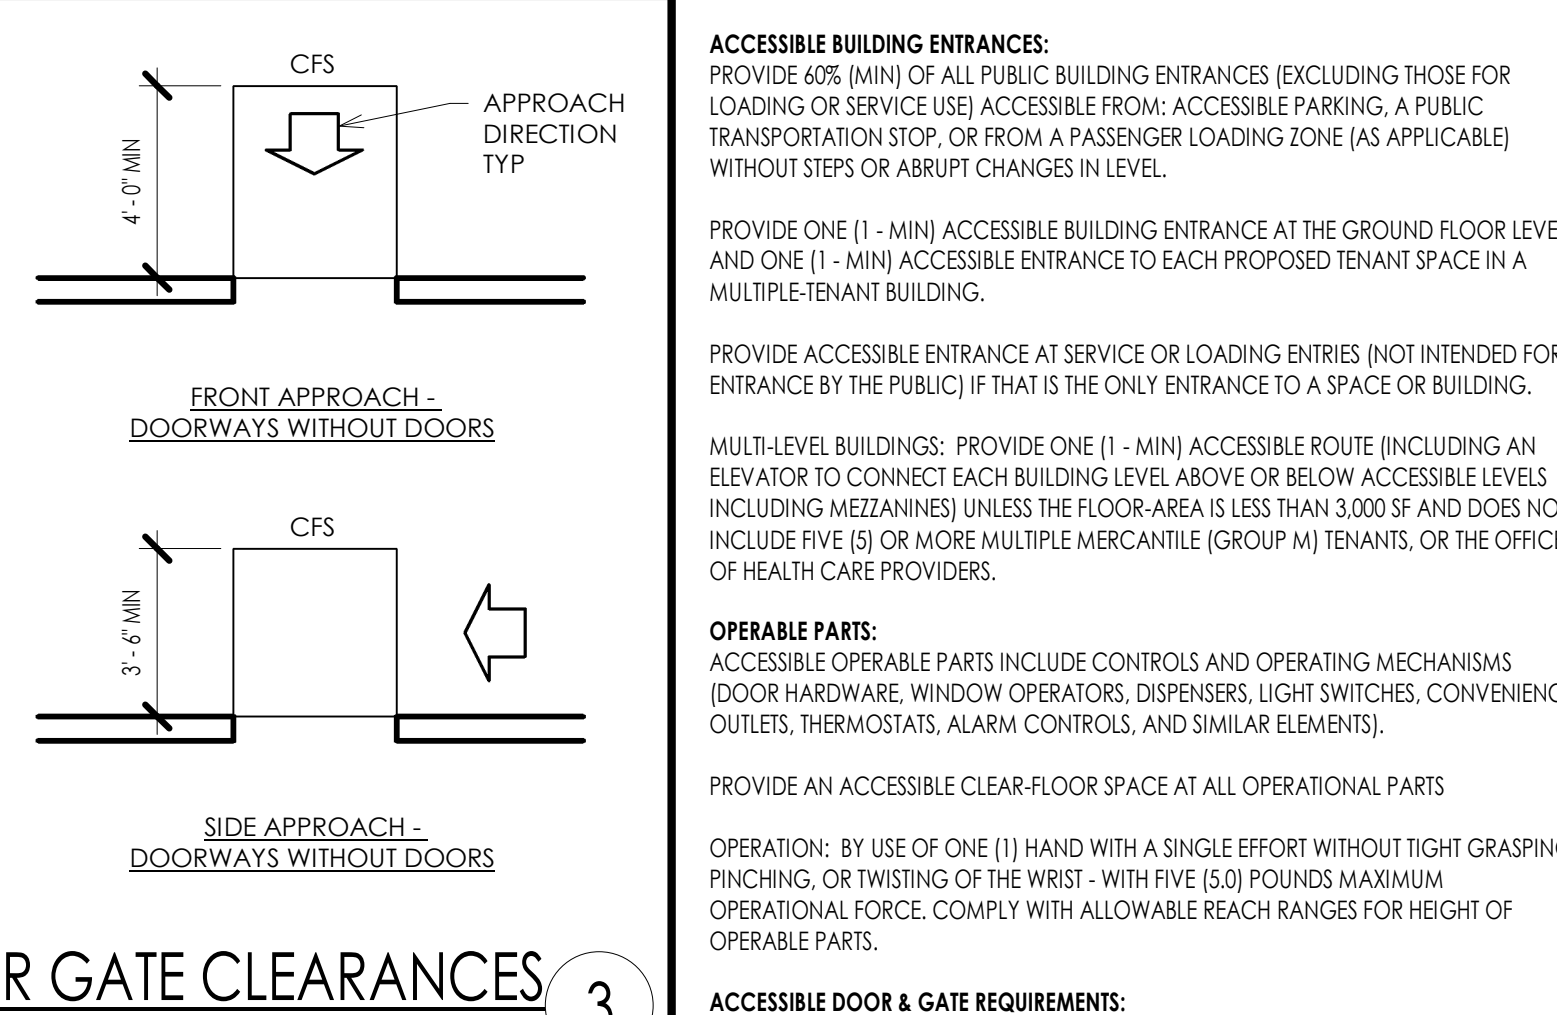
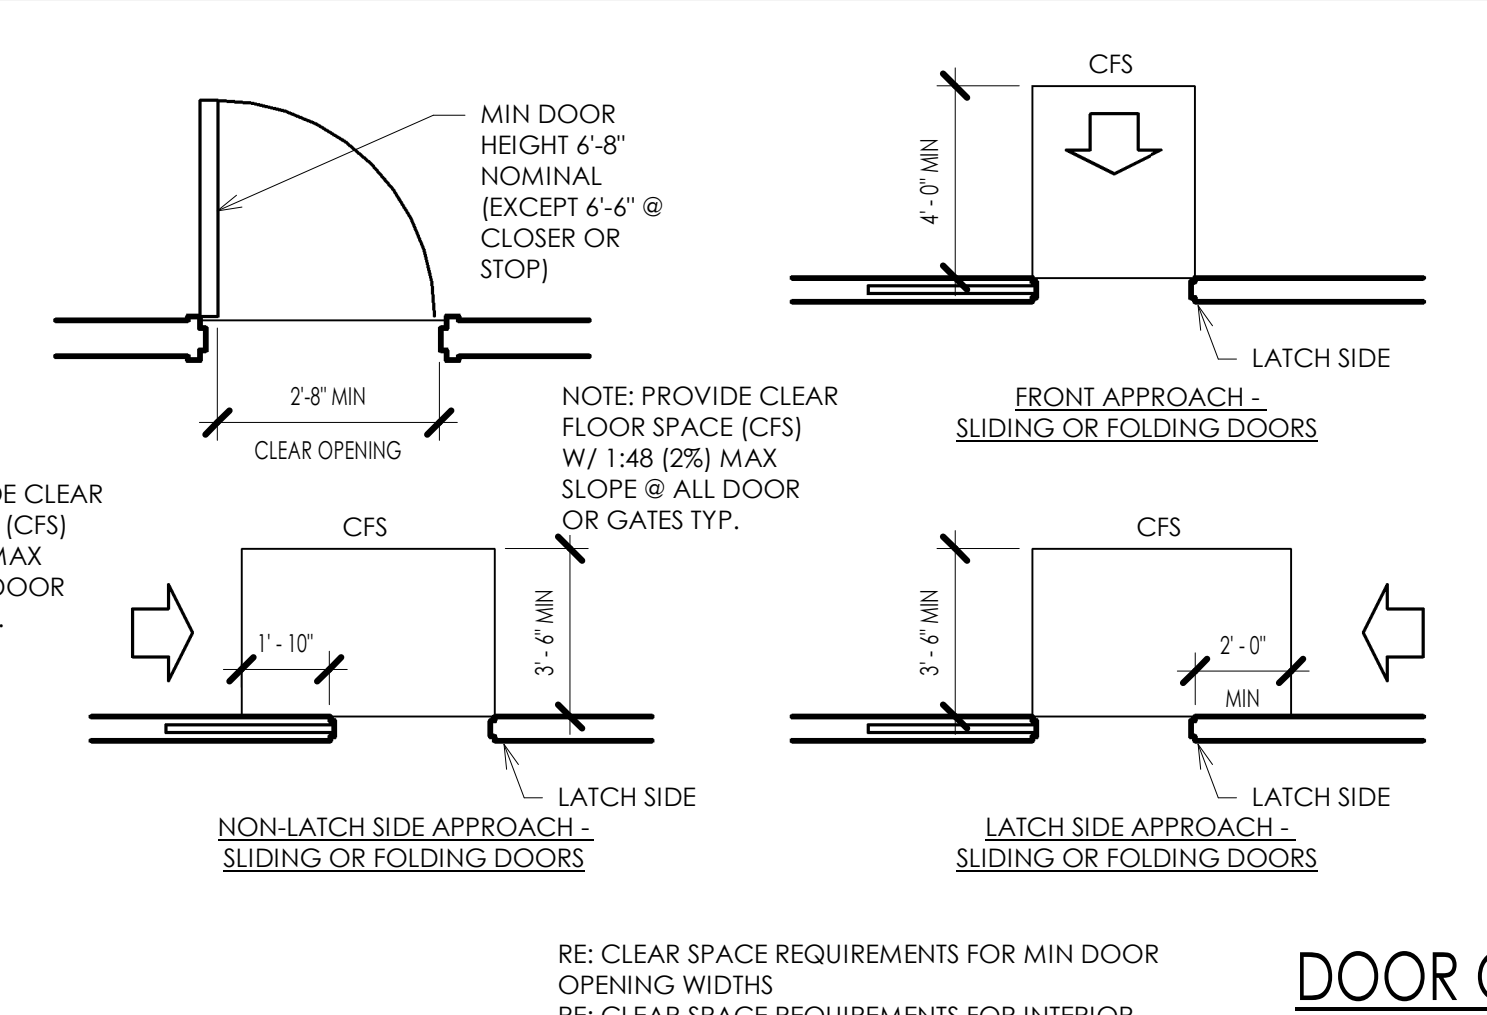
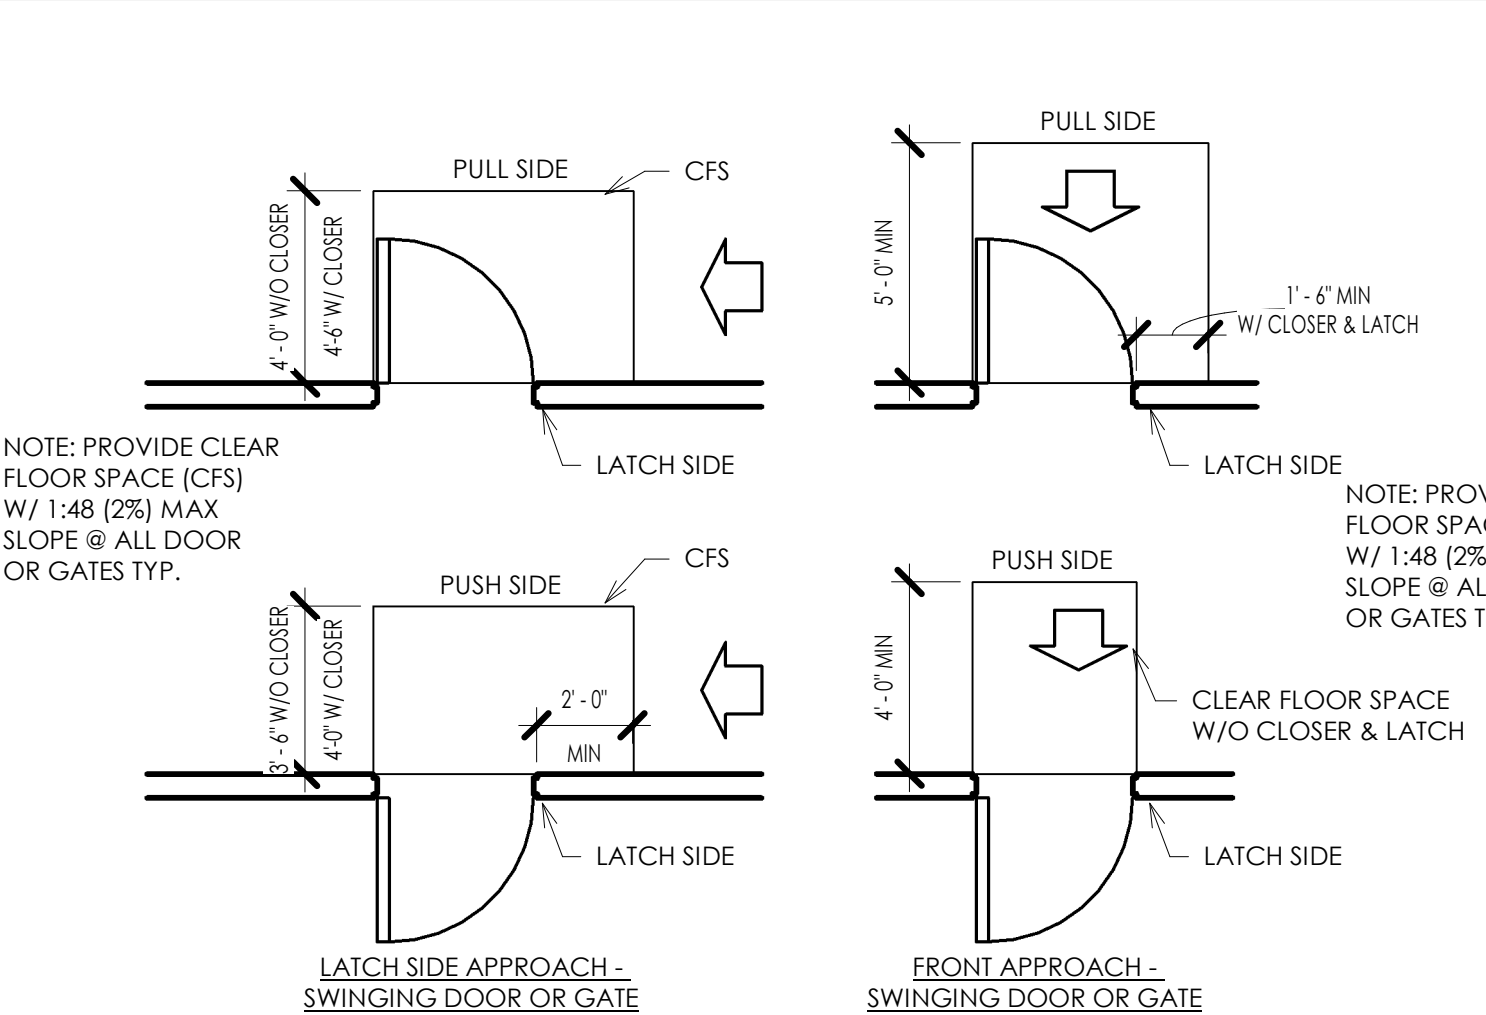



ACCESSIBLE STAIRS/RAMPS & HANDRAIL DETAILS 4
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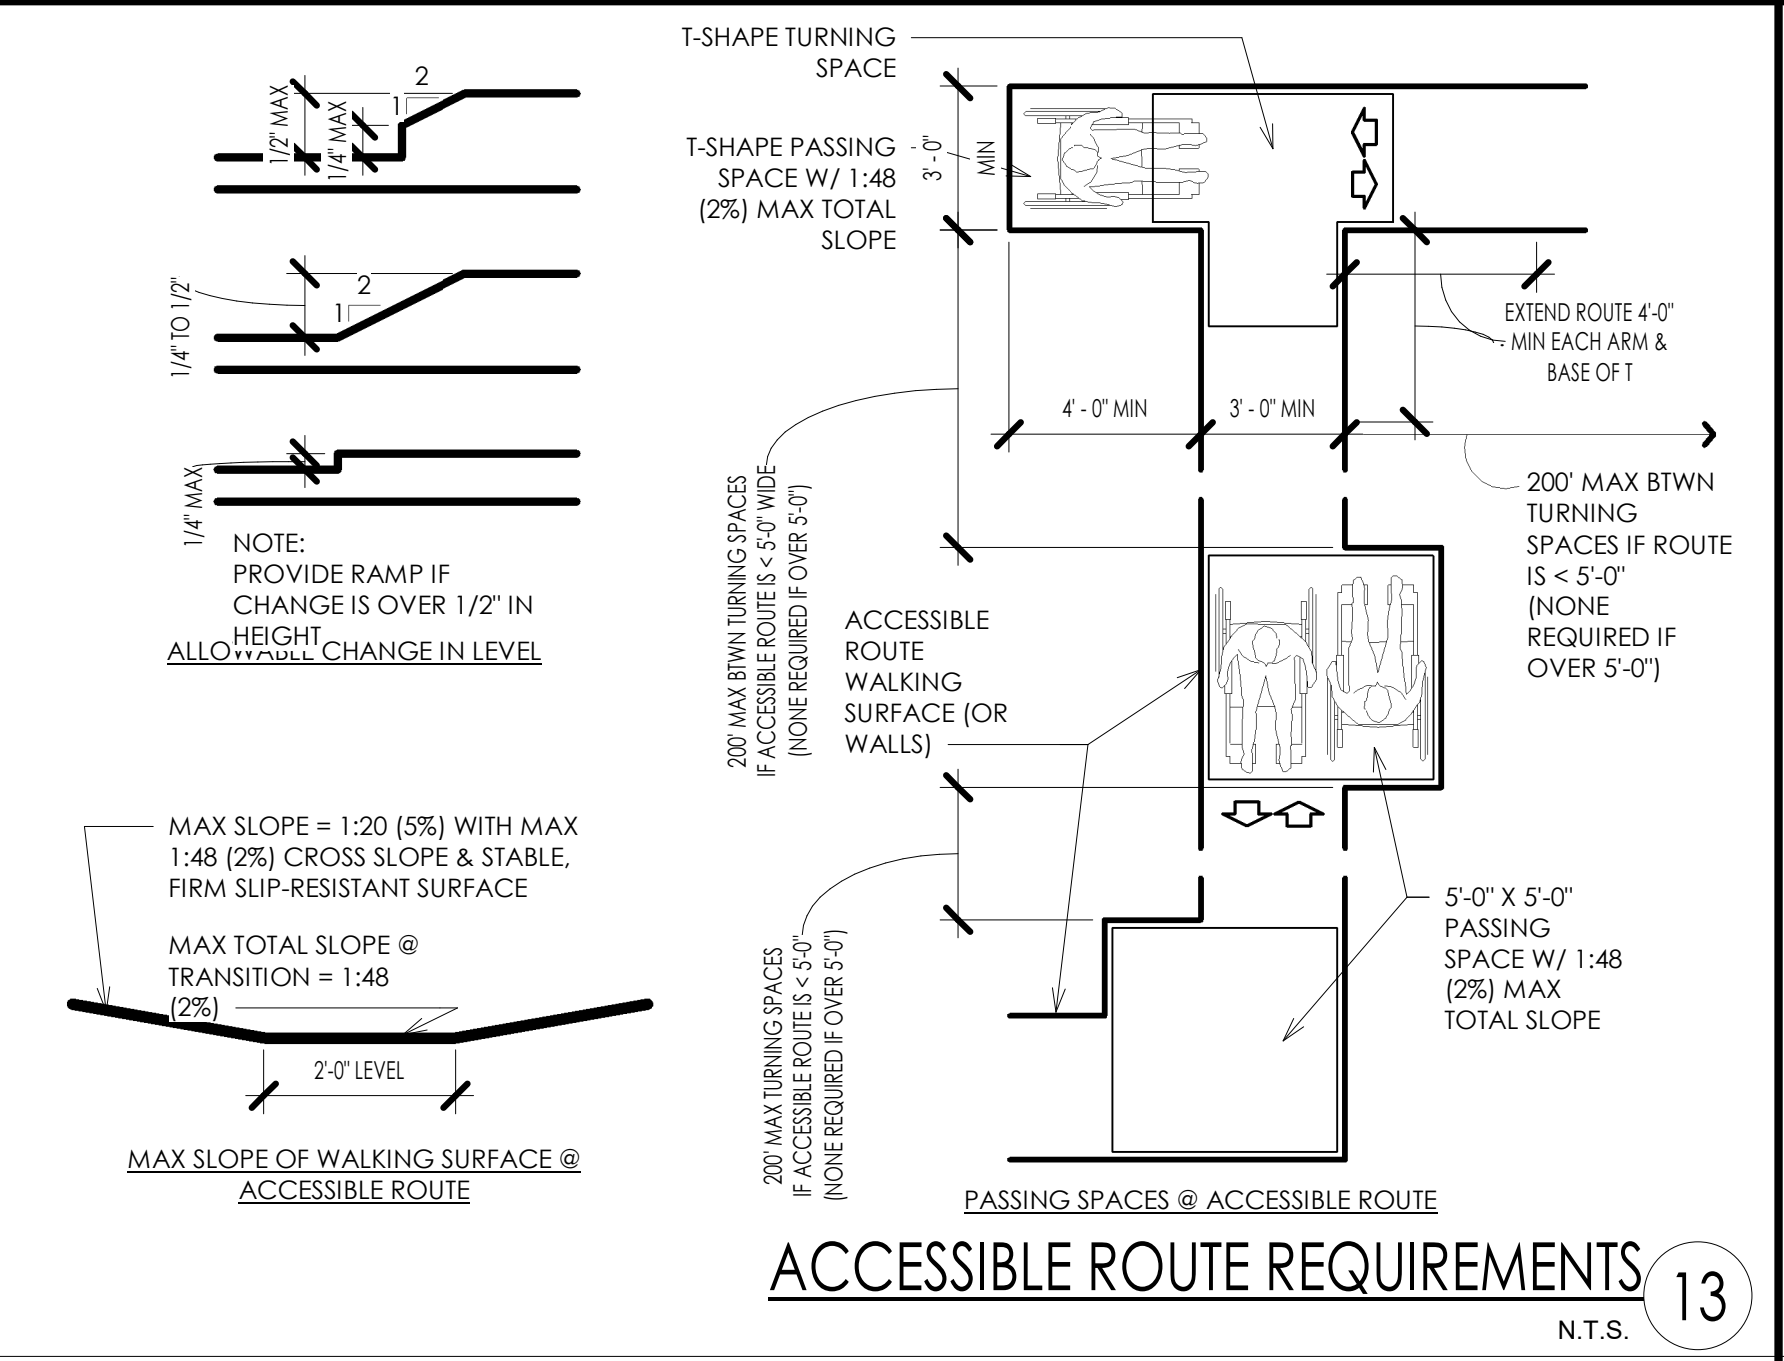
DOOR OR GATE CLEARANCES 3
N.T.S.

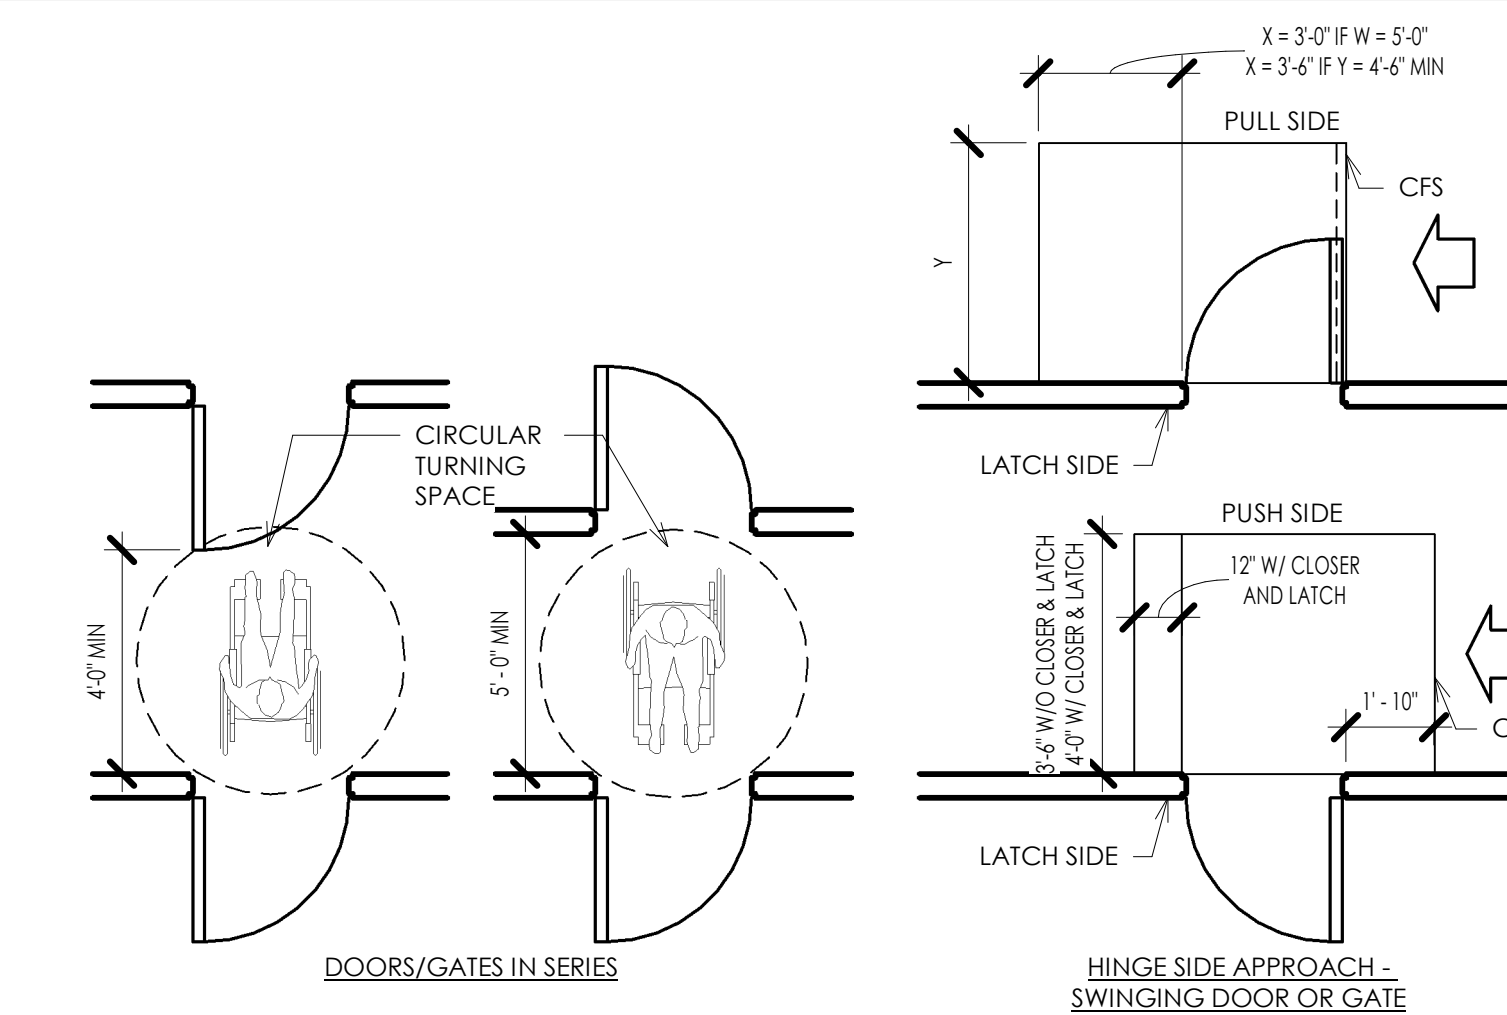



PROTRUDING OBJECTS 14
N.T.S.

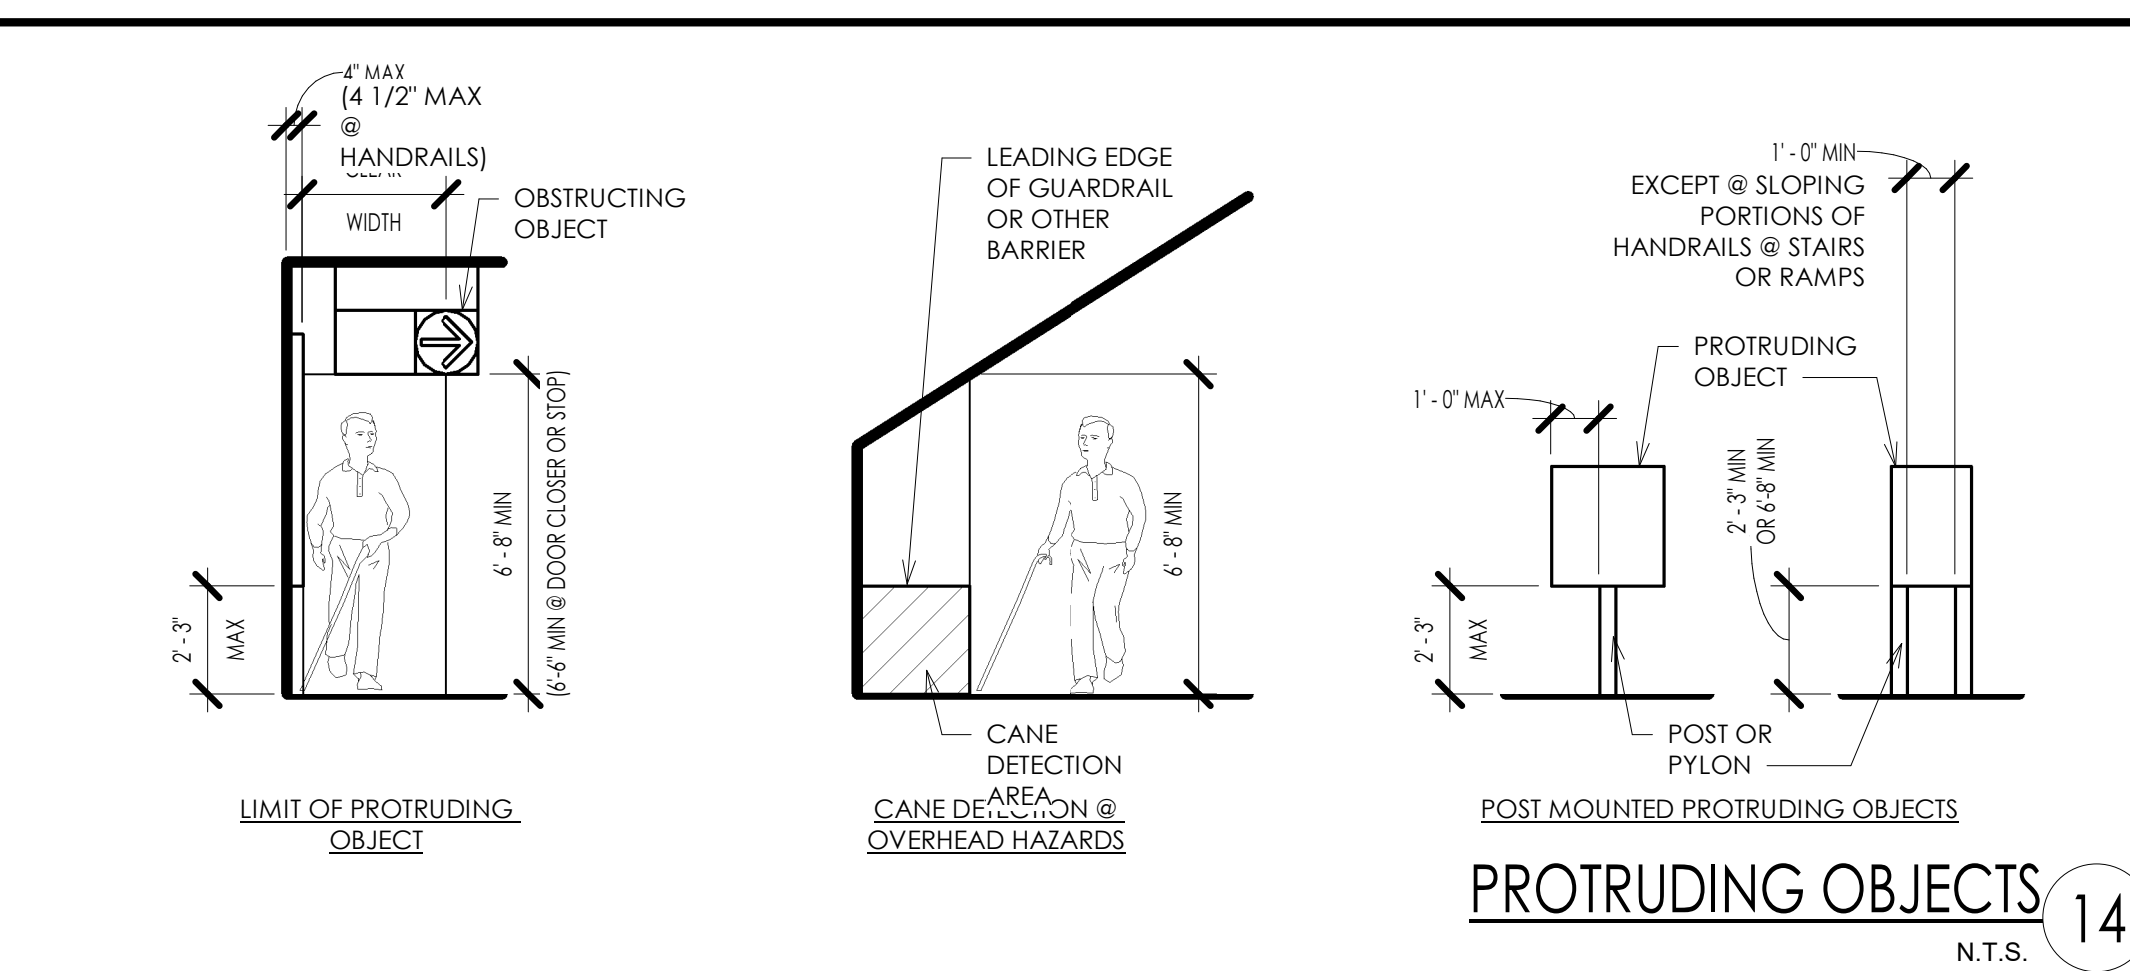

REACH RANGES 2
N.T.S.

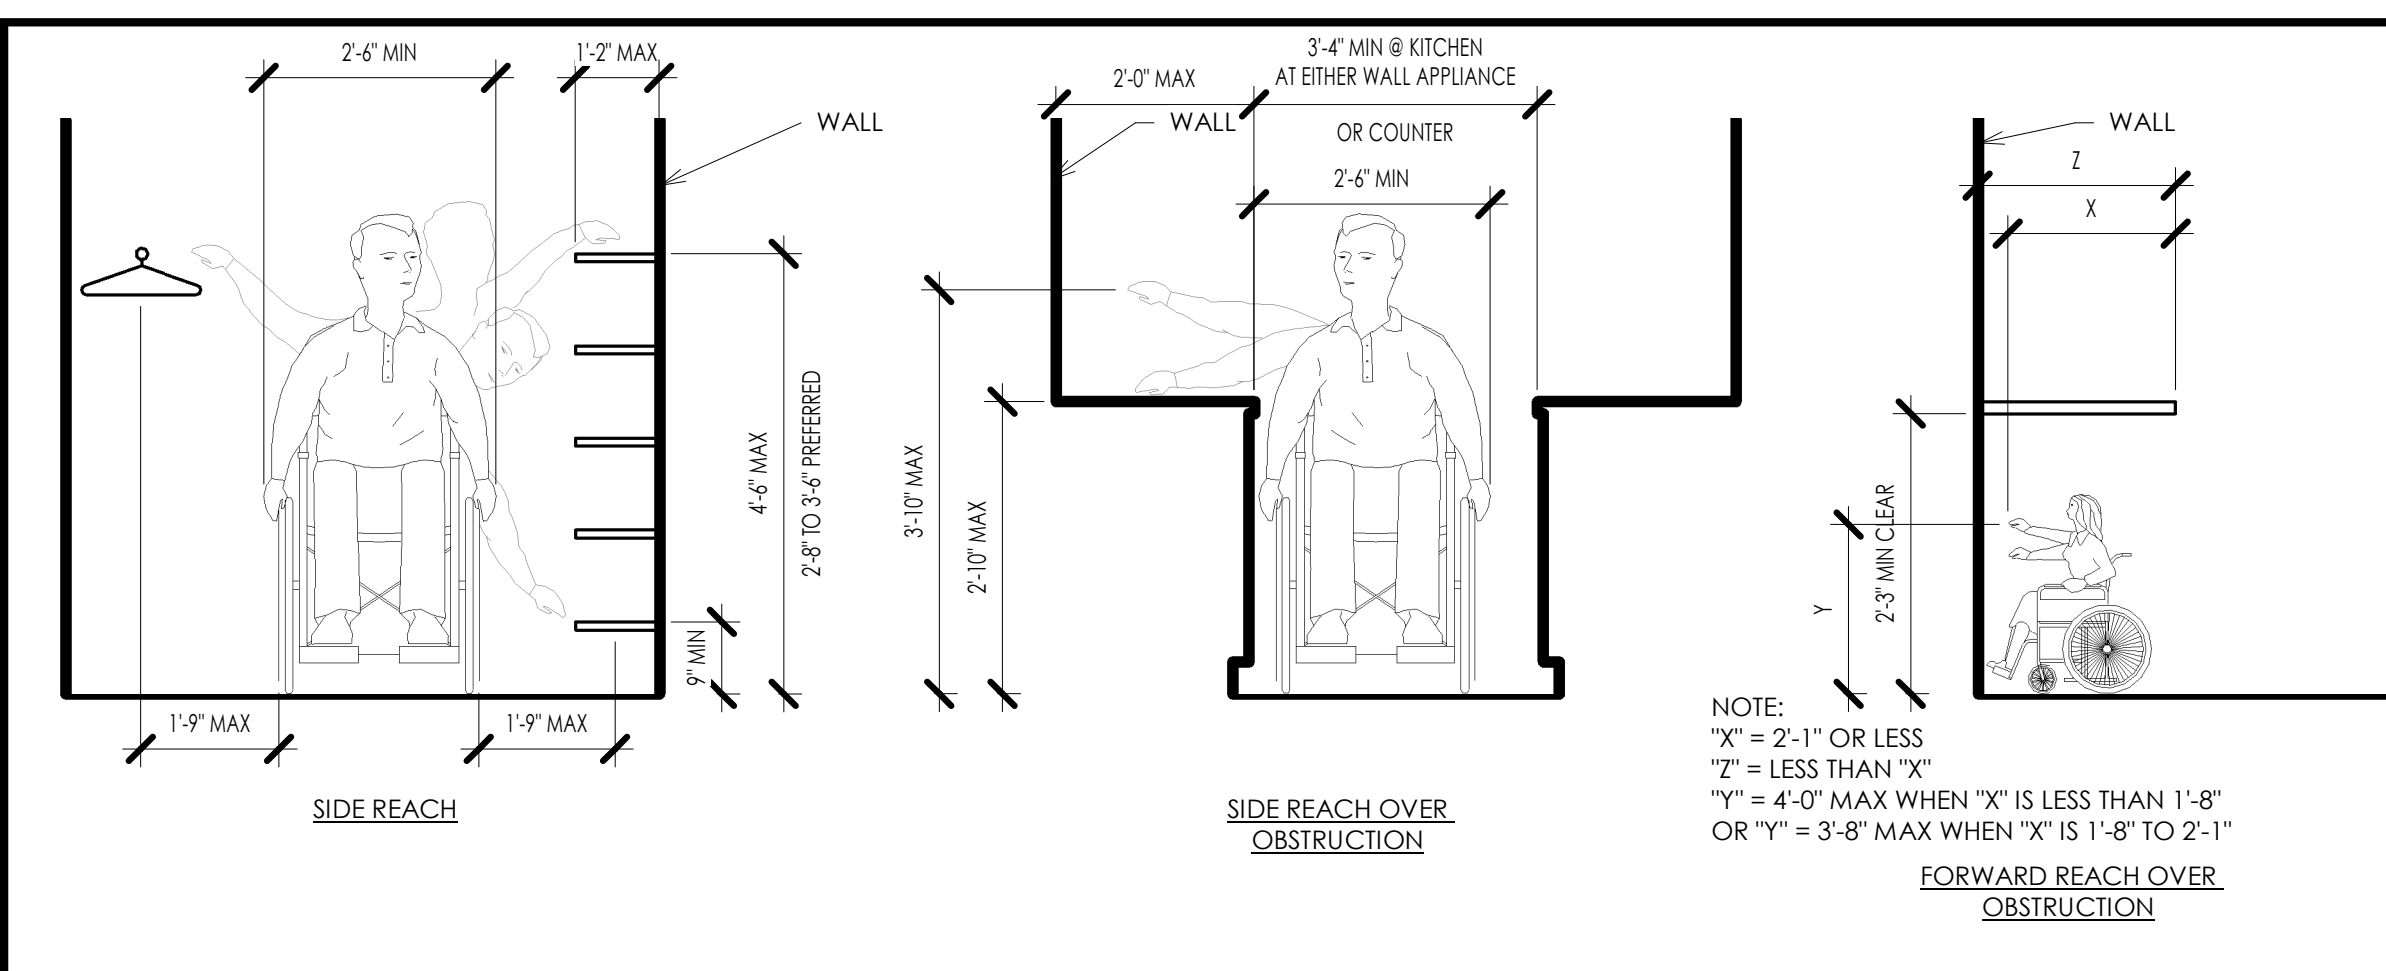

ACCESSING ROUTE REQUIREMENTS 13
N.T.S.

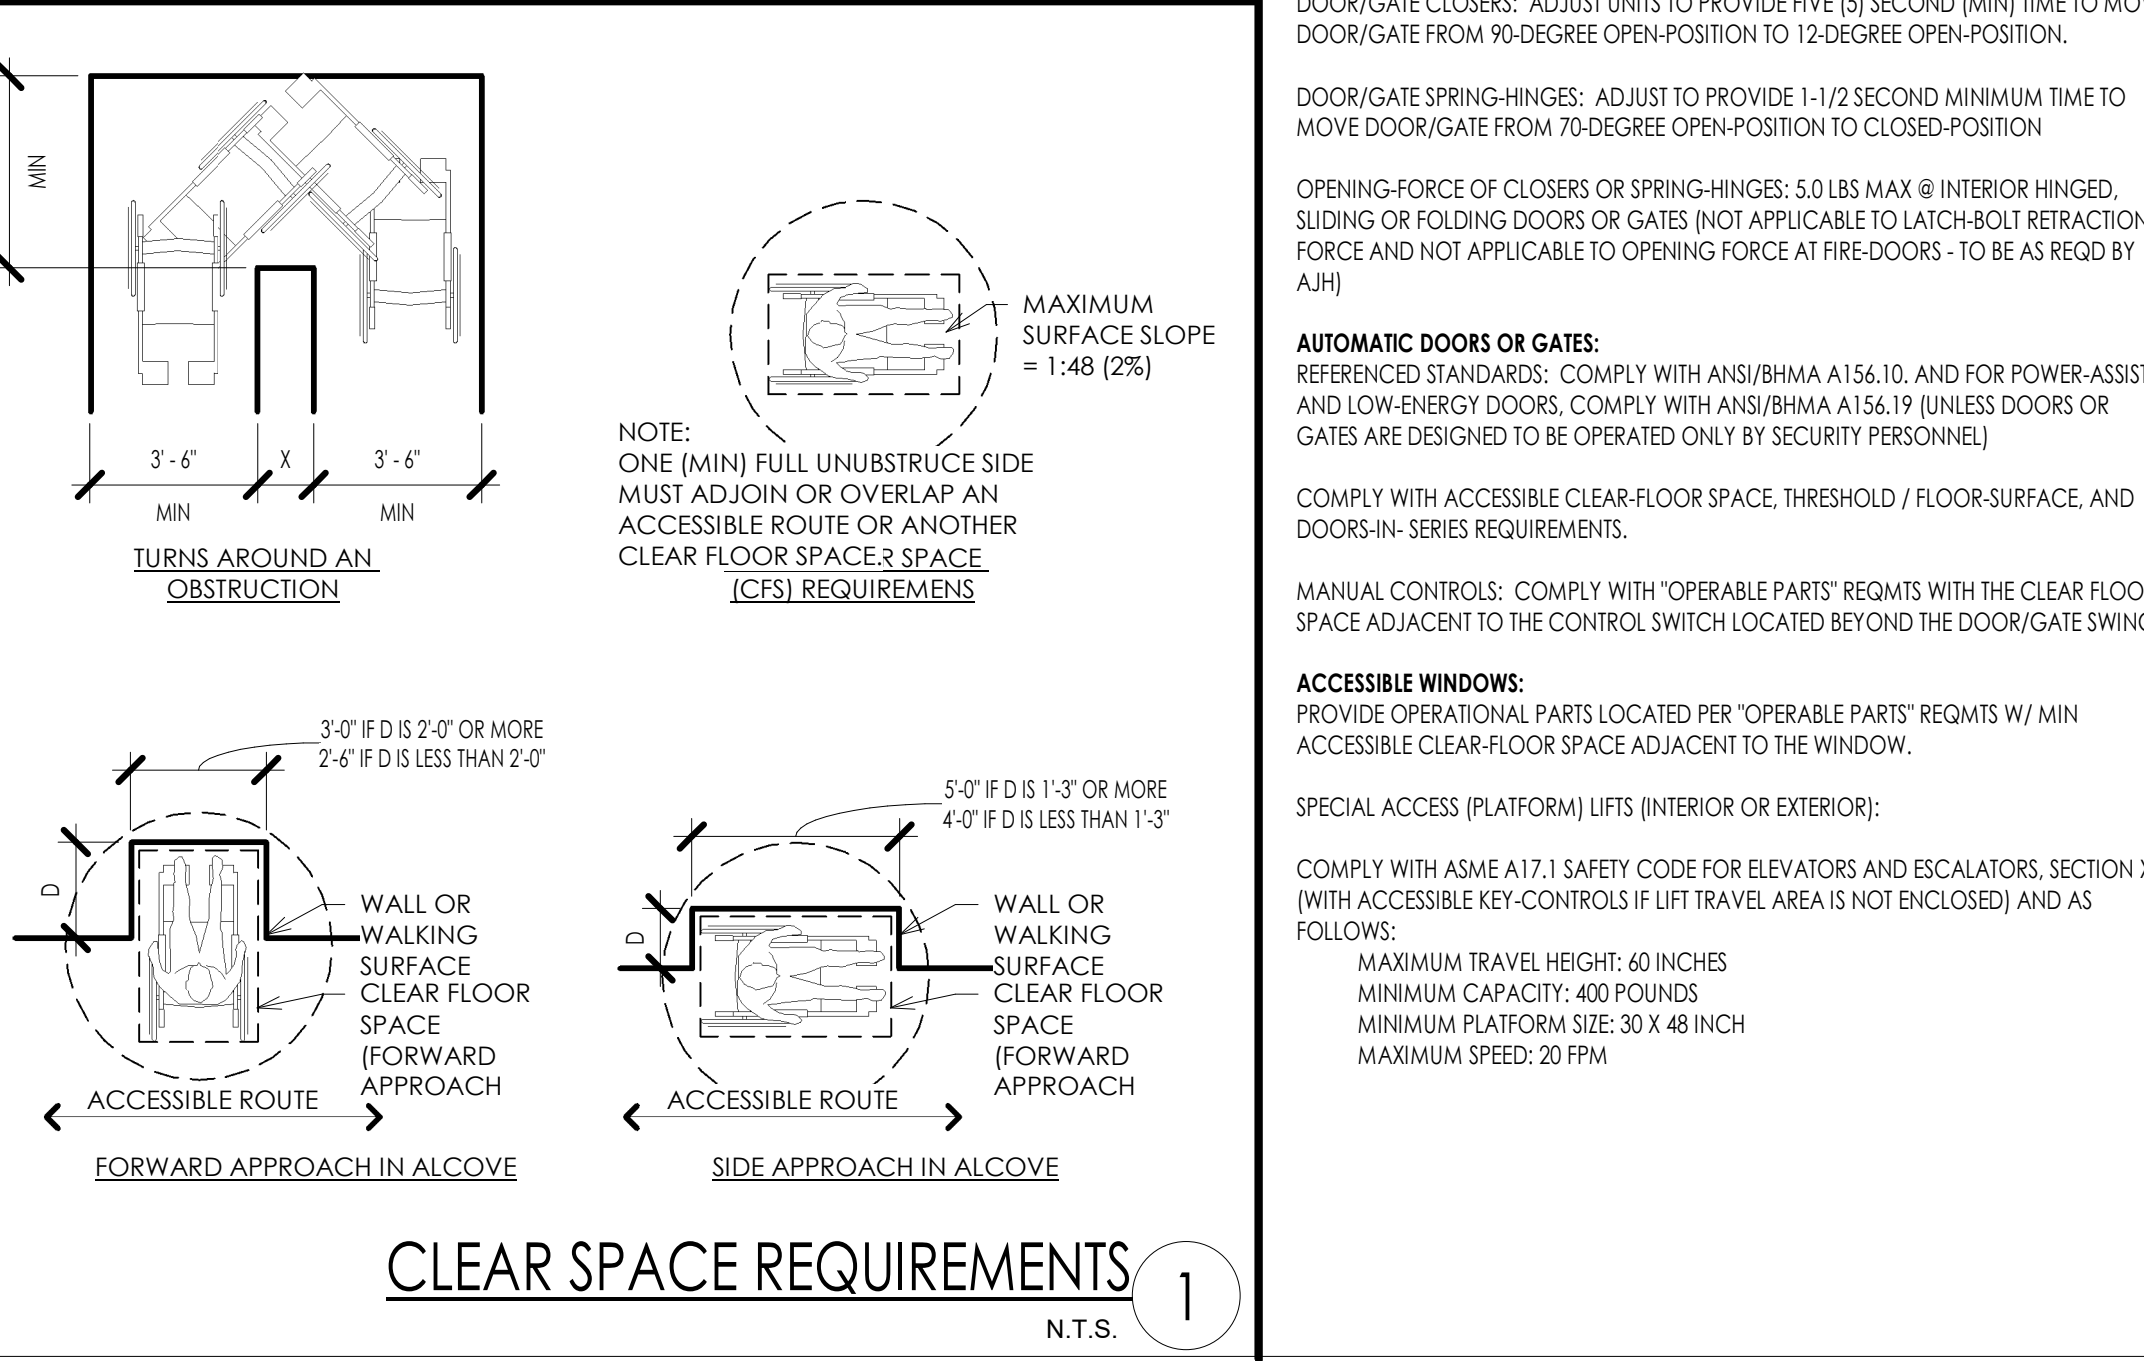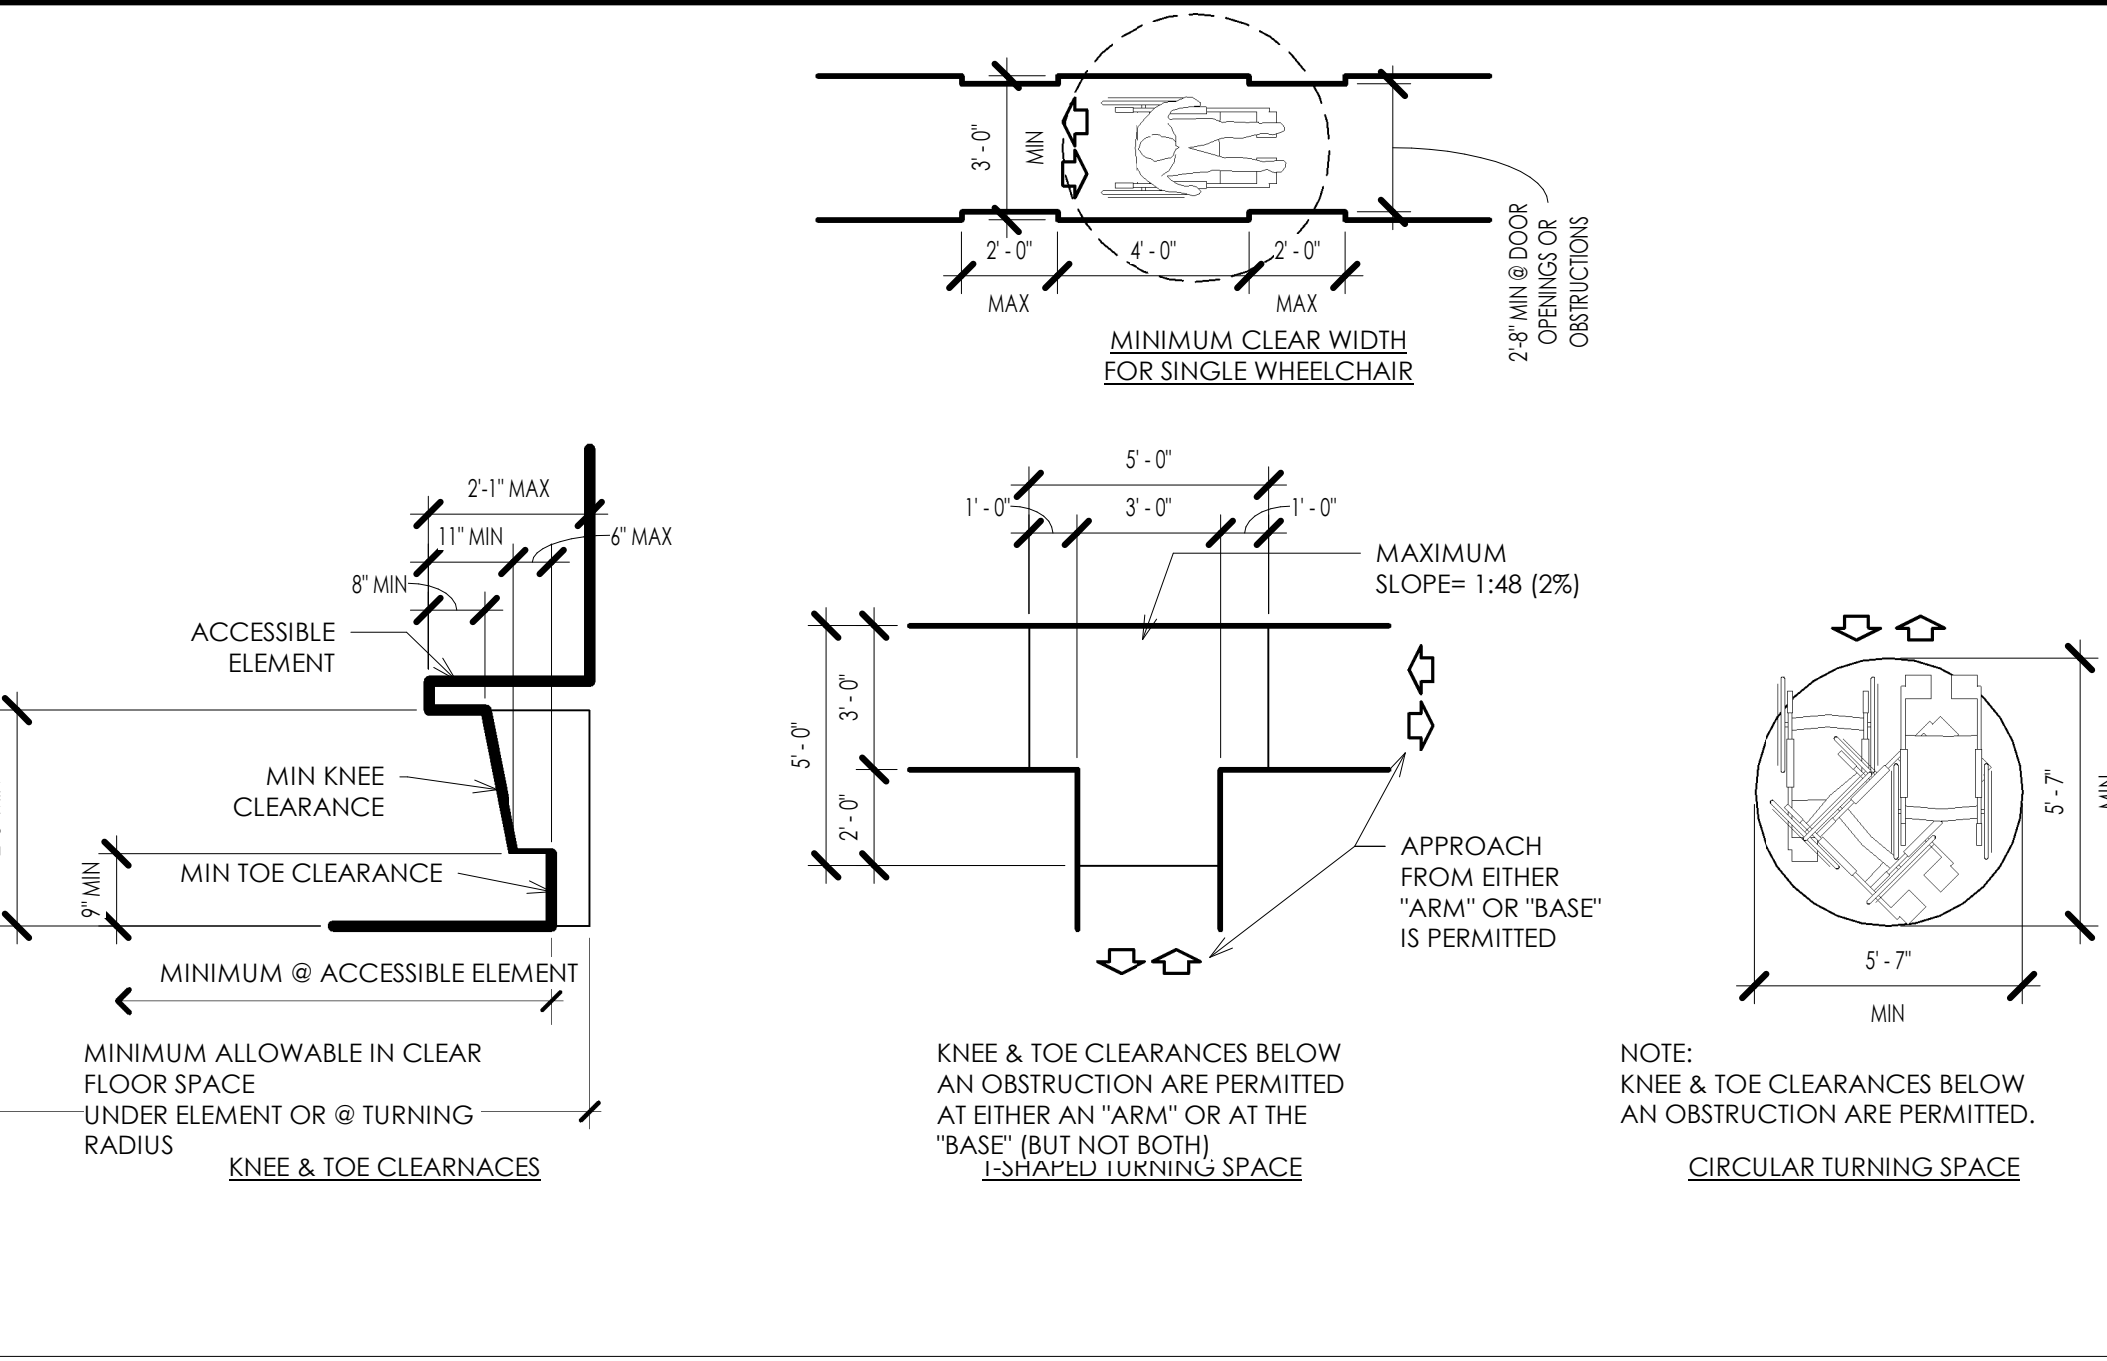

CLEAR SPACE REQUIREMENTS 1
N.T.S.

THE INFORMATION ON THESE ACCESSIBILITY DRAWINGS IS PROVIDED AS A GUIDE TO THE CONTRACTOR AND TO ANY OTHER ENTITIES INSTALLING BUILDING EQUIPMENT OR FIXTURES. THESE DRAWINGS ARE ABBREVIATED AND DO NOT INDICATE ALL CONDITIONS THAT MAY BE ENCOUNTERED AND THEY DO NOT INCLUDE ALL REQUIREMENTS OF EITHER THE ADA OR ICC/ANSI A117.1 IN THEIR ENTIRETY.

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COMPLY WITH REQUIREMENTS OF THE AMERICANS WITH DISABILITIES ACT (ADA) EVEN IF NOT REQUIRED BY BUILDING CODES, REGULATIONS OR ORDINANCES (ADA IS A FEDERAL LAW), AND AS INDICATED ON THESE DRAWINGS.

ACCESSIBLE ROUTE: PROVIDE AN ACCESSIBLE ROUTE CONNECTING ALL ACCESSIBLE SPACES AND ELEMENTS, INCLUDING WALKING SURFACES, RAMPS & CURB-RAMPS (EXCLUDING THE FLARED SIDES), DOORS & DOORWAYS, AND/OR ELEVATORS & PLATFORM LIFTS. AN ACCESSIBLE ROUTE MAY BE LOCATED AT EXTERIOR WALKWAYS, AISLES, HALLS, CORRIDORS, SKYWALKS OR TUNNELS.

ACCESSIBLE WALKING SURFACES: PROVIDE STABLE, FIRM, & SLIP-RESISTANT SURFACE FINISHES W/ SURFACE OPENINGS (GRATINGS) NOT TO PERMIT PASSAGE OF A 1/2" DIAMETER SPHERE - WITH LONGEST DIMENSION PERPENDICULAR TO DIRECTION OF TRAVEL.

MINIMUM WHEELCHAIR TURNING SPACE CAN INCLUDE ALLOWABLE FIXTURE KNEE & TOE CLEARANCES UNO. DOOR SWINGS ARE PERMITTED TO OVERLAP TURNING SPACE UNO.

ACCESSIBLE BUILDING ENTRANCES: PROVIDE 60% (MIN) OF ALL PUBLIC BUILDING ENTRANCES (EXCLUDING THOSE FOR LOADING OR SERVICE USE) ACCESSIBLE FROM: ACCESSIBLE PARKING, A PUBLIC TRANSPORTATION STOP, OR FROM A PASSENGER LOADING ZONE (AS APPLICABLE) WITHOUT STEPS OR ABRUPT CHANGES IN LEVEL.

PROVIDE ONE (1) - (MIN) ACCESSIBLE BUILDING ENTRANCE AT THE GROUND FLOOR LEVEL AND ONE (1) - (MIN) ACCESSIBLE ENTRANCE TO EACH PROPOSED TENANT SPACE IN A MULTIPLE-TENANT BUILDING.

PROVIDE ACCESSIBLE ENTRANCE AT SERVICE OR LOADING ENTRIES (NOT INTENDED FOR ENTRANCE BY THE PUBLIC) IF THAT IS THE ONLY ENTRANCE TO A SPACE OR BUILDING.

MULTI-LEVEL BUILDINGS: PROVIDE ONE (1) - (MIN) ACCESSIBLE ROUTE (INCLUDING AN ELEVATOR TO CONNECT EACH BUILDING LEVEL ABOVE OR BELOW ACCESSIBLE LEVELS INCLUDING MEZANINES) UNLESS THE FLOOR-AREA IS LESS THAN 3,000 SF AND DOES NOT INCLUDE FIVE (5) OR MORE MULTIPLE MERCANTILE (GROUP M) TENANTS, OR THE OFFICES OF HEALTH CARE PROVIDERS.

OPERABLE PARTS: ACCESSIBLE OPERABLE PARTS INCLUDE CONTROLS AND OPERATING MECHANISMS (DOOR HARDWARE, WINDOW OPERATORS, DISPENSERS, LIGHT SWITCHES, CONVENIENCE OUTLETS, THERMOSTATS, ALARM CONTROLS, AND SIMILAR ELEMENTS).

PROVIDE AN ACCESSIBLE CLEAR-FLOOR SPACE AT ALL OPERATIONAL PARTS

OPERATION: BY USE OF ONE (1) HAND WITH A SINGLE EFFORT WITHOUT TIGHT GRASPING, PINCHING, OR TWISTING OF THE WRIST - WITH FIVE (5) POUNDS MAXIMUM OPERATIONAL FORCE. COMPLY WITH ALLOWABLE REACH RANGES FOR HEIGHT OF OPERABLE PARTS.

ACCESSIBLE DOOR & GATE REQUIREMENTS: REVOLVING DOORS OR GATES ARE NOT ACCESSIBLE.

SECURITY & MAINTENANCE DOORS (INCLUDING SERVICE-ACCESS DOORS) DO NOT NEED TO COMPLY WITH ACCESSIBILITY REQUIREMENTS.

DOUBLE-LEAF DOORS OR GATES: ONLY ONE LEAF (MIN) MUST COMPLY WITH ACCESSIBILITY REQUIREMENTS

RECESSED DOORS: PROVIDE FORWARD APPROACH CLEARANCE WITH ANY OBSTRUCTION WITHIN 18 INCH OF LATCH SIDE OF DOORWAY PROJECTING MORE THAN 8 INCHES BEYOND THE FACE OF DOOR MEASURED PERPENDICULAR TO FACE OF DOOR

DOOR SURFACES: PROVIDE SMOOTH SURFACE WITHIN TEN (10) INCH AFF ON PUSH-SIDE EXTENDING FULL WIDTH WITH MAX 1/16 INCH BETWEEN SURFACE PLANE AND ANY PARTS (INCL. PLATE), CAP CAVITIES FORMED BY RICKETS EXCEPT AT SLIDING DOORS. TEMPERED GLASS DOORS WITHOUT SIDE STILES WITH A BOTTOM RAIL WITH ITS TOP EDGE SLOPED 40 DEGREES FROM HORIZONTAL OR MORE, OR AT DOORS NOT EXTENDING TO 10 INCHES AFF

SIDELITES OR VISION LITES: AT DOORS AND SIDELITES ADJACENT TO DOORS WITH ONE OR MORE GLAZING PANELS PERMITTING VIEWING, PROVIDE BOTTOM EDGE OF AT LEAST ONE PANEL ON EITHER THE DOOR OR THE ADJACENT SIDELITE AT 43 INCHES MAXIMUM AFF, EXCEPT AT VISION LITES (ONLY) WITH THE LOWEST PART MORE THAN 66 INCHES AFF.

ACCESSIBLE DOOR & GATE HARDWARE: PROVIDE ACCESSIBLE HARDWARE WITH AN EASY-TO-GRASP SHAPE COMPLYING WITH OPERABLE PARTS REQUIREMENTS (LEVERS/PULLS, OR PANIC DEVICES ARE ACCEPTABLE), MOUNTED BETWEEN 2'-10" AND 4'-0" AFF, WITH MAX PROJECTION (INTO REQUIRED MIN CLEARANCES) OF 4 INCH BWTN 34 - 80 INCH AFF

SLIDING DOOR/GATE HARDWARE: OPERABLE PARTS MUST BE EXPOSED AND USABLE FROM BOTH SIDES WHEN DOOR IS FULLY OPEN

DOOR/GATE CLOSERS: ADJUST UNITS TO PROVIDE FIVE (5) SECOND (MIN) TIME TO MOVE DOOR/GATE FROM 90-DEGREE OPEN-POSITION TO 12-DEGREE OPEN-POSITION.

DOOR/GATE SPRING-HINGES: ADJUST TO PROVIDE 1-1/2 SECOND MINIMUM TIME TO MOVE DOOR/GATE FROM 70-DEGREE OPEN-POSITION TO CLOSED-POSITION

OPENING-FORCE OF CLOSERS OR SPRING-HINGES: 5.0 LBS MAX @ INTERIOR HINGED, SLIDING OR FOLDING DOORS OR GATES (NOT APPLICABLE TO LATCH-BOLT RETRACTION FORCE AND NOT APPLICABLE TO OPENING FORCE AT FIRE-DOORS - TO BE AS REQD BY A/J/H)

AUTOMATIC DOORS OR GATES: REFERENCED STANDARDS: COMPLY WITH ANSI/BHMA A156.10, AND FOR POWER-ASSIST AND LOW-ENERGY DOORS, COMPLY WITH ANSI/BHMA A156.19 (UNLESS DOORS OR GATES ARE DESIGNED TO BE OPERATED ONLY BY SECURITY PERSONNEL)

COMPLY WITH ACCESSIBLE CLEAR-FLOOR SPACE, THRESHOLD / FLOOR-SURFACE, AND DOORS-IN-SERIES REQUIREMENTS.

MANUAL CONTROLS: COMPLY WITH "OPERABLE PARTS" REQMS WITH THE CLEAR FLOOR SPACE ADJACENT TO THE CONTROL SWITCH LOCATED BEYOND THE DOOR/GATE SWING.

ACCESSIBLE WINDOWS: PROVIDE OPERATIONAL PARTS LOCATED FOR "OPERABLE PARTS" REQMS W/ MIN ACCESSIBLE CLEAR-FLOOR SPACE ADJACENT TO THE WINDOW.

SPECIAL ACCESS (PLATFORM) LIFTS (INTERIOR OR EXTERIOR):

COMPLY WITH ASME A17.1 SAFETY CODE FOR ELEVATORS AND ESCALATORS, SECTION XX WITH ACCESSIBLE KEY-CONTROLS IF LIFT TRAVEL AREA IS NOT ESCALATED, AND AS FOLLOWS:

MAXIMUM TRAVEL HEIGHT: 40 INCHES
MINIMUM CAPACITY: 400 POUNDS
MINIMUM PLATFORM SIZE: 30 X 48 INCH
MAXIMUM SPEED: 20 FPM

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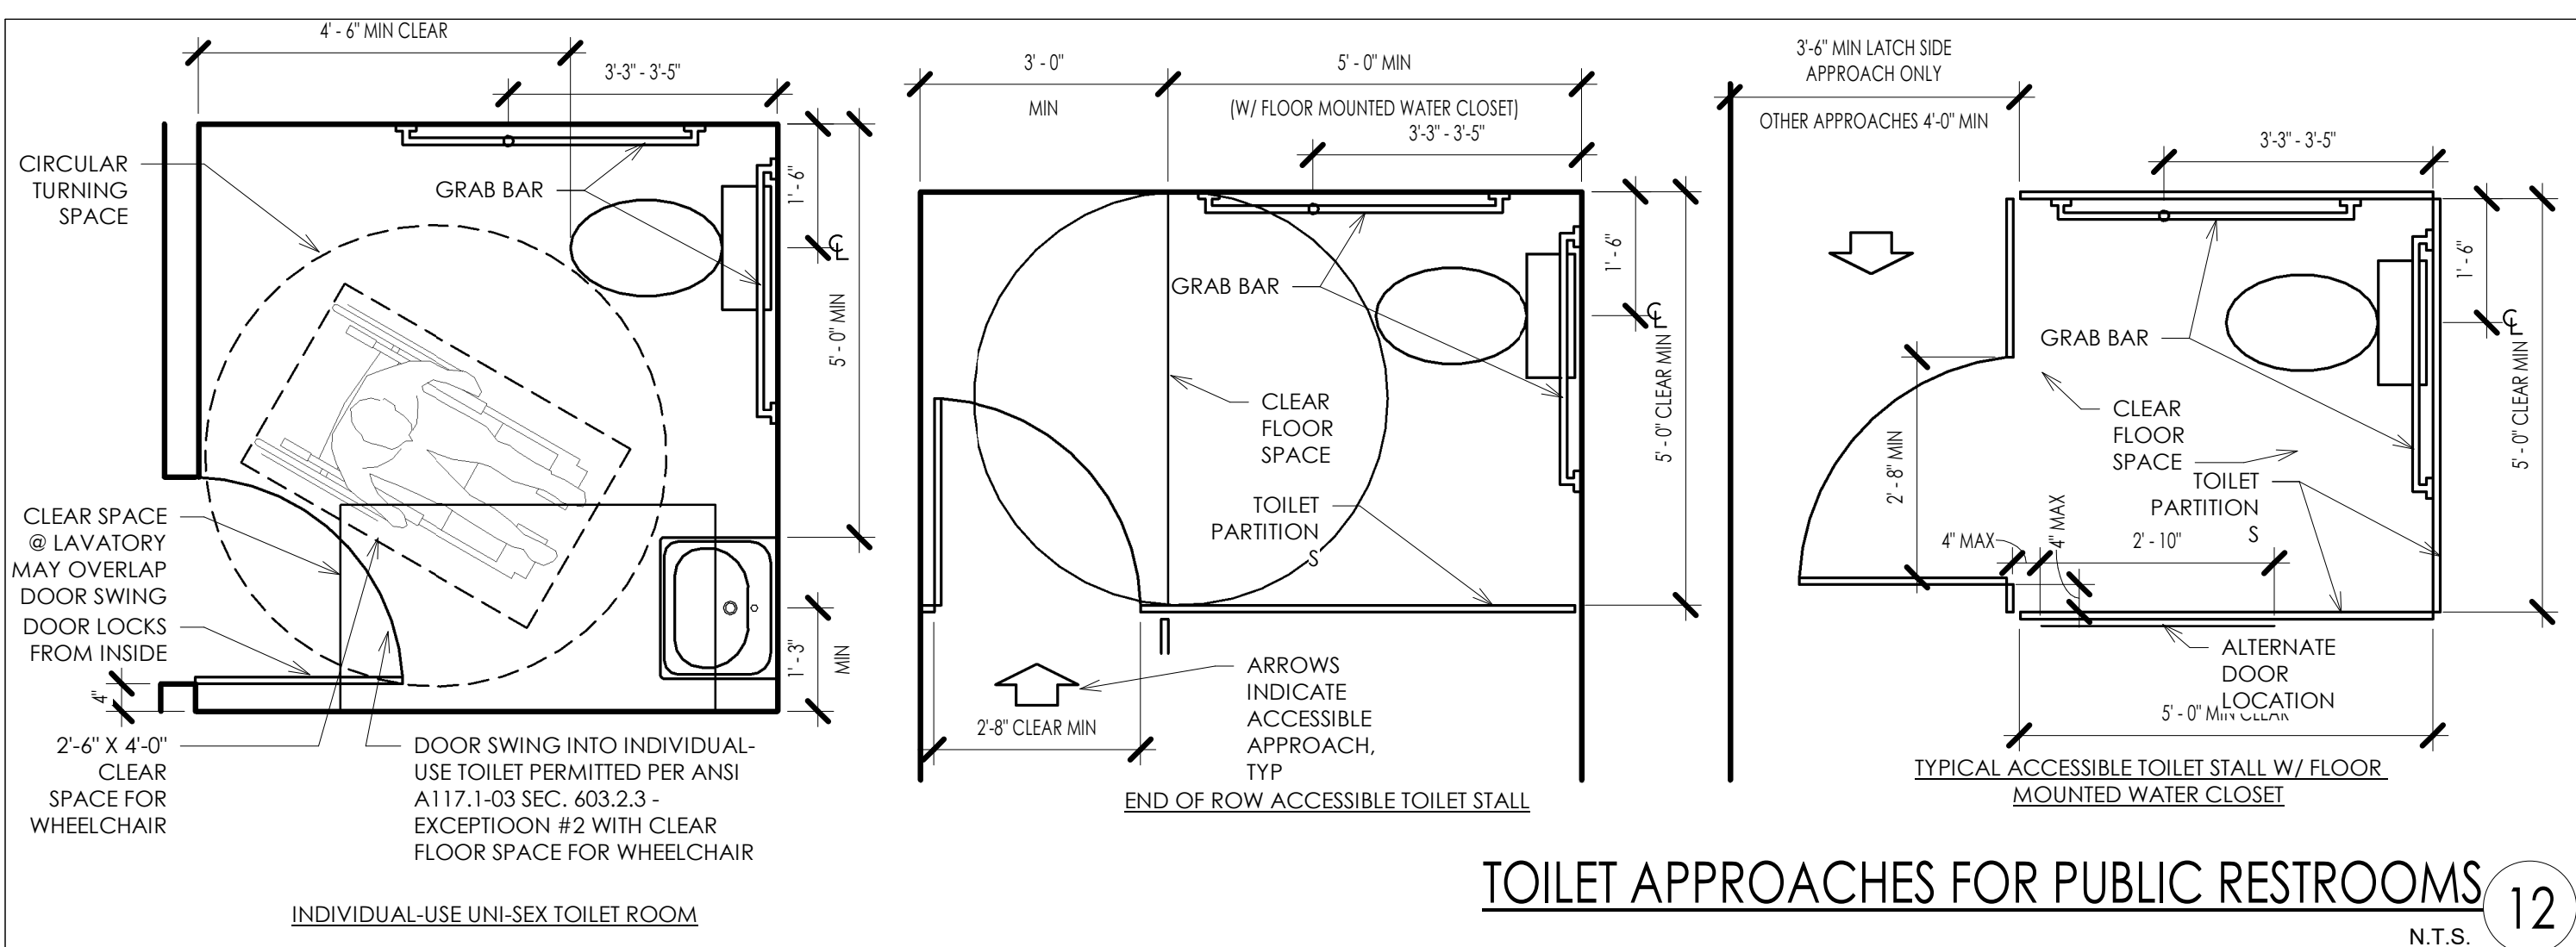
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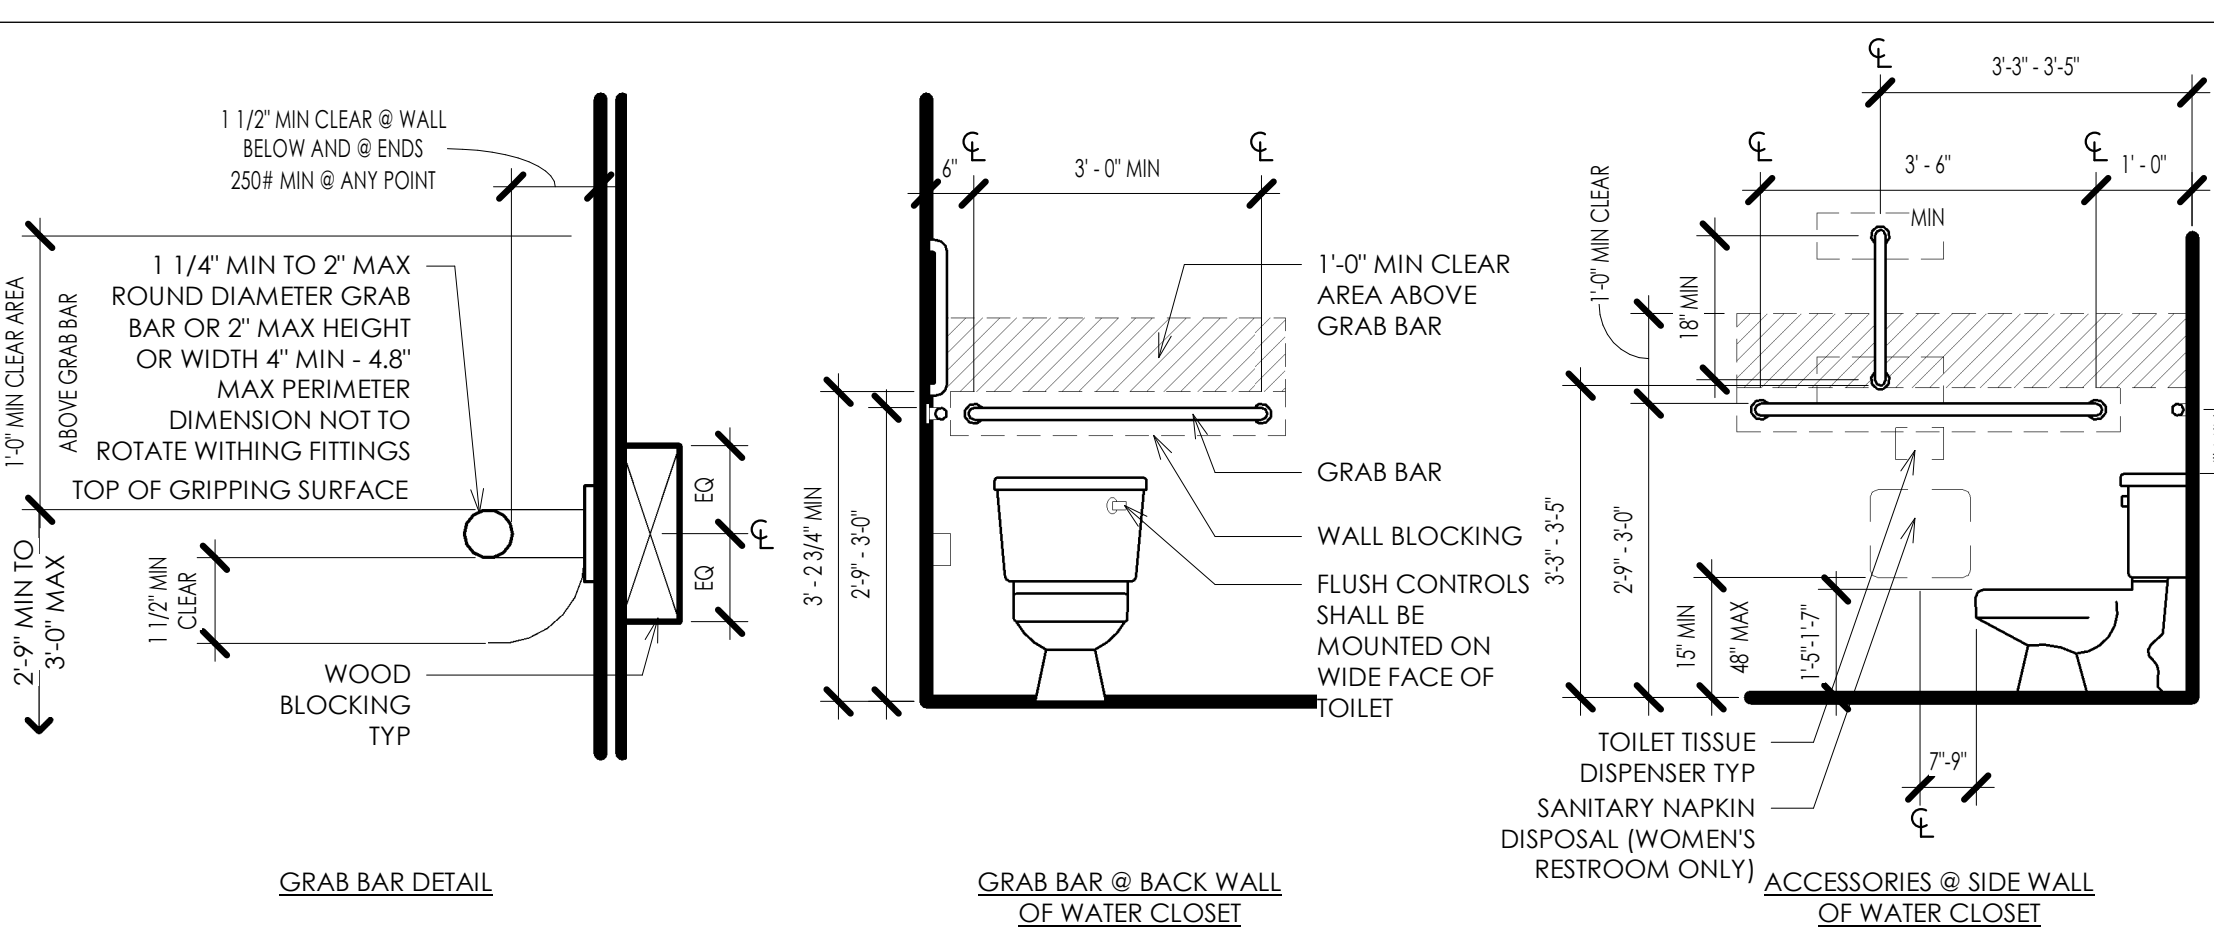
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drawing title GENERAL ACCESSIBILITY
drawing number G003



TOILET APPROACHES FOR PUBLIC RESTROOMS 12

N.T.S.



ACCESSIBLE TOILETS 4

N.T.S.

ACCESSIBLE ROUTE WITHIN BUILDING: PROVIDE AN ACCESSIBLE ROUTE TO EACH SPACE OR PORTION WITHIN A BUILDING. TO ACCESSIBLE BUILDING ENTRANCES - NOT PASSING THROUGH KITCHENS, STORAGE ROOMS, RESTROOMS CLOSETS OR SIMILAR SPACES (IF ONLY ONE ACCESSIBLE ROUTE IS PROVIDED).

CONSTRUCT WORK AREAS USED ONLY BY EMPLOYEES SO THAT INDIVIDUALS WITH DISABILITIES CAN APPROACH, ENTER AND EXIT THE AREA (EXCEPT AT WORK-AREAS LESS THAN 150 SF AND ELEVATED SEVEN (7) INCHES OR MORE ABOVE GROUND OR FINISH FLOOR - WHEN THE RAISED ELEVATION IS ESSENTIAL TO THE FUNCTION OF THE WORK-AREA - PER IBC). PROVIDE ACCESSIBLE ROUTES AT ALL COMMON-USE CIRCULATION PATHS WITHIN EMPLOYEE WORK AREAS UNLESS WORK AREA IS LESS THAN 300 SF AND DEFINED BY PERMANENTLY INSTALLED PARTITIONS, COUNTERS, CABS/WORK OR FURNISHINGS. ACCESSIBILITY IS NOT REQUIRED TO NON-OCCUPIED SPACES ACCESSED ONLY BY LADDERS, CATWALKS, CRAWL SPACES OR FREIGHT (NON-PASSENGER) ELEVATORS THAT ARE FREQUENTED ONLY BY SERVICE PERSONNEL FOR MAINTENANCE PURPOSES, INCLUDING BUT NOT LIMITED TO ELEVATOR PITS, ELEVATOR PENTHOUSES, AND PIPING OR EQUIPMENT CATWALKS.

ACCESSIBLE ROUTE WITHIN BUILDING: ACCESSIBLE ROUTES MAY CONSIST OF ONE OR MORE OF THESE COMPONENTS: WALKING SURFACES, RAMPS, DOORS AND DOORWAYS, ELEVATORS AND PLATFORM LIFTS. MINIMUM CORRIDOR WIDTH: 3'-8" MINIMUM WIDTH OF ACCESS AISLES: 3'-0"

CARPETED WALKING SURFACES: BROODLOOM OR CARPET-TILE WITH FIRM CUSHION/PAD (OR WITHOUT CUSHION & PAD) WITH LEVEL LOOP, TEXTURED LOOP, LEVEL CUT, OR LEVEL CUT/UNCLUT PILE TEXTURE WITH 1/2 INCH MAX PILE-HEIGHT. SECURELY ATTACH TO SUBSTRATE AND PROVIDE BEVELED EDGE-TRIM ALONG ENTIRE LENGTH OF EXPOSED EDGE PER ABOVE.

AREA-OF-RESUE ASSISTANCE: PROVIDE AN "AREA-OF-RESUE-ASSISTANCE" AT NON-ACCESSIBLE EXIT-DISCHARGE DOORS - EXCEPT IN BUILDINGS WITH A SUPERVISED AUTOMATIC FIRE-SUPPRESSION SYSTEM. MINIMUM SIZE: PROVIDE MINIMUM OF TWO (2) EA 2'-6" X 4'-0" AREAS OR ONE (1) EACH PER 200 OCCUPANTS PER STORY SERVED NOT ENCRANCHING ON ANY REQUIRED EXIT WIDTH

TOILET ROOMS OR COMPARTMENTS: UNI-SEX TOILET ROOM: PROVIDE AN ACCESSIBLE FACILITY WITH A SINGLE WATER-CLOSET AND LAVATORY IN ANY MERCANTILE OR ASSEMBLY OCCUPANCIES WHERE A TOTAL OF SIX (6) OR MORE MALE AND FEMALE WATER-CLOSETS ARE REQUIRED (PER IBC). PROVIDE UNI-SEX AND SINGLE-USE TOILET ROOMS WITH DOOR LOCKING FROM INSIDE. WATER-CLOSET COMPARTMENTS: PROVIDE A MINIMUM OF ONE (1) WHEELCHAIR ACCESSIBLE COMPARTMENT AND MEN OVER SIX (6) WATER-CLOSETS + URINALS ARE PROVIDED IN A TOILET ROOM, PROVIDE ONE (1) TO BE AMBULATORY-ACCESSIBLE IN ADDITION TO THE WHEELCHAIR-ACCESSIBLE UNIT. SINKS: PROVIDE NO LESS THAN ONE (1) ACCESSIBLE SINK (OR 5% OF TOTAL) WHERE PROVIDED (MOP OR SERVICE-SINKS ARE NOT REQUIRED TO BE ACCESSIBLE)

DRINKING FOUNTAINS: IF ONLY ONE DRINKING FOUNTAIN IS PROVIDED IN A SPACE OR BUILDING, PROVIDE A "DUAL HI-LOW" TYPE UNIT ACCESSIBLE TO BOTH WHEELCHAIR USERS AND TO PERSONS WITH DIFFICULTY BENDING OR STOOPING (STANDARD HEIGHT UNIT) OR OTHER MEANS TO ACHIEVE EQUIVALENT ACCESSIBILITY FOR BOTH (PROVIDING AN ACCESSIBLE WATER COOLER, FOR EXAMPLE). PROVIDE DRINKING FOUNTAINS IN ALCOVE OUT OF COMMON PATH OF TRAVEL SPACING BETWEEN DRINKING FOUNTAINS: 2'-3" (27") MINIMUM


ACCESSIBLE ELEVATORS: MINIMUM CAR SIZE: DEPTH: 4'-3" TO FRONT WALL - 4'-6" TO DOOR WIDTH: 50 OR MORE OCCUPANTS: 4'-8" MIN (STRETCHER TYPE) UNDER 50 OCCUPANTS: 4'-6" MIN MINIMUM DOOR WIDTH: 50 OR MORE OCCUPANTS: 3'-6" MIN UNDER 50 OCCUPANTS: 2'-10" MIN HANDRAIL AT REAR: LOCATE BETWEEN 2'-6" TO 2'-10" AFF ELEVATOR CONTROLS. LOCATE BETWEEN 2'-11" MIN AND 4'-6" AFF MAX. PROVIDE EMERGENCY PHONE @ 4'-0" AFF MAX WITH 2'-5" MIN CORD LENGTH HALL-CALL BUTTONS: CENTER AT 3'-6" AFF HALL LANTERNS: 6'-0" (72 INCH) AFF - VISUAL AND AUDIBLE FLOOR INDICATOR SIGNS: 2" HIGH CONTRASTING LETTER SIGN WITH BRAILLE ON SIDE OF DOOR JAMB AT 60" AFF

ACCESSIBLE SEATING: WHEN PROVIDED AT FIXED OR BUILT-IN TABLES, COUNTERS OR WORK SURFACES, PROVIDE 5% MINIMUM BUT NOT LESS THAN ONE (1) ACCESSIBLE SEATING, DISTRIBUTED THROUGHOUT. POINT-OF-SALE (POS) OR SERVICE COUNTERS: PROVIDE NOT LESS THAN ONE (1) UNIT TO BE ACCESSIBLE DISPERSED THROUGHOUT IF COUNTERS ARE DISPERSED.

SIGNAGE: REQUIRED ACCESSIBLE SIGNS (MINIMUM) EXCEPT AT BUILDING DIRECTORIES, MENU BOARDS, OR TEMPORARY SIGNS PROVIDE ACCESSIBLE SIGNS AS FOLLOWS: ACCESSIBLE ENTRANCES: PROVIDE A 4 X 4" ACCESSIBILITY DECAL AT ALL ACCESSIBLE PUBLIC ENTRANCE DOORS CENTERED AT 60" AFF. NON-ACCESSIBLE PUBLIC ENTRANCES: PROVIDE DIRECTIONAL SIGNS INDICATING LOCATION OF NEAREST ACCESSIBLE ENTRANCE. NON-ACCESSIBLE TOILET ROOMS: PROVIDE DIRECTIONAL SIGNS INDICATING LOCATION OF NEAREST ACCESSIBLE UNITS. ROOM (OR SPACE) SIGNS (INCLUDING TOILET ROOMS): PROVIDE RAISED PICTOGRAMS, TACTILE CHARACTERS AND BRAILLE TEXT. ACCEPTABLE CHARACTERS: UPPER-CASE, LOWER-CASE, OR A COMBINATION OF BOTH IN A SANS-SERIF CONVENTIONAL STYLE - NO ITALIC, OBLIQUE, SCRIPT, HIGHLY DECORATIVE OR OTHER UNUSUAL FORMS FINISH & CONTRAST: NON-GLARE WITH EITHER LIGHT CHARACTERS ON DARK BACKGROUND OR DARK CHARACTERS ON LIGHT BACKGROUND ILLUMINATION LEVEL AT ACCESSIBLE SIGNS: MINIMUM 10 FOOT-CANDELES PROVIDE CLEAR FLOOR AREA OF 18 X 18 INCHES CENTERED ON TACTILE CHARACTER SIGNS BEYOND ARC OF DOOR SWING FROM CLOSED TO 45 DEGREE OPEN POSITION. CONTRASTED (GRADE 2) WITH INDICATION OF AN UPPERCASE LETTER ONLY BEFORE THE FIRST WORD OF SENTENCES, PROPER NOUNS, AND NAMES, INDIVIDUAL LETTERS OF THE ALPHABET, INITIALS, OR ACRONYM.


ALARMS: IF EMERGENCY WARNING SYSTEMS ARE PROVIDED, PROVIDE BOTH AUDIBLE AND VISUAL ALARMS IN ANY COMMON-USE AREAS, (INCLUDING BUT NOT LIMITED TO RESTROOMS, MEETING ROOMS, HALLWAYS, AND LOBBIES). PERMANENTLY CONNECT ALARM SYSTEMS TO THE BUILDING ELECTRICAL POWER AND LIGHTING SYSTEM AS APPROPRIATE. IF AUDIBLE ALARMS ARE PROVIDED, THEY MUST PRODUCE SOUND EXCEEDING THE PREVAILING EQUIVALENT SOUND LEVEL OF A SPACE BY AT LEAST 15 dbA OR EXCEED ANY MAXIMUM SOUND LEVEL WITH A DURATION OF 60 SECONDS BY 5 dbA, WHICHEVER IS LOUDER (NOT EXCEEDING 120dbA).

IF VISUAL ALARMS ARE PROVIDED, PROVIDE UNFILTERED OR CLEAR-FILTERED WHITE XENON-STROBE TYPE LAMPS OR EQUIVALENT, WITH 0.2 SECOND MAXIMUM PULSE DURATION AND MAXIMUM DUTY CYCLE OF 40 PERCENT, PROVIDING A MINIMUM BRIGHTNESS INTENSITY OF 75 CANDELA WITH A FLASH RATE BETWEEN 1 AND 3 Hz. LOCATE UNITS NO MORE THAN 6'-10" (80") AFF OR 6" BELOW CEILING (WHICHEVER IS LOWER). LOCATE 50 FEET MAXIMUM FROM ANY POINT WITHIN A SPACE OR COMMON CORRIDOR, OR IN LARGE SPACES OVER 100 FEET ACROSS (SUCH AS AUDITORIUMS) WITHOUT OBSTRUCTIONS 6 FT AFF. LOCATE AROUND ROOM PERIMETER AT MAXIMUM 100 FT CENTERS. ALL STROBES IN ROOM MUST BE SYNCHRONIZED.

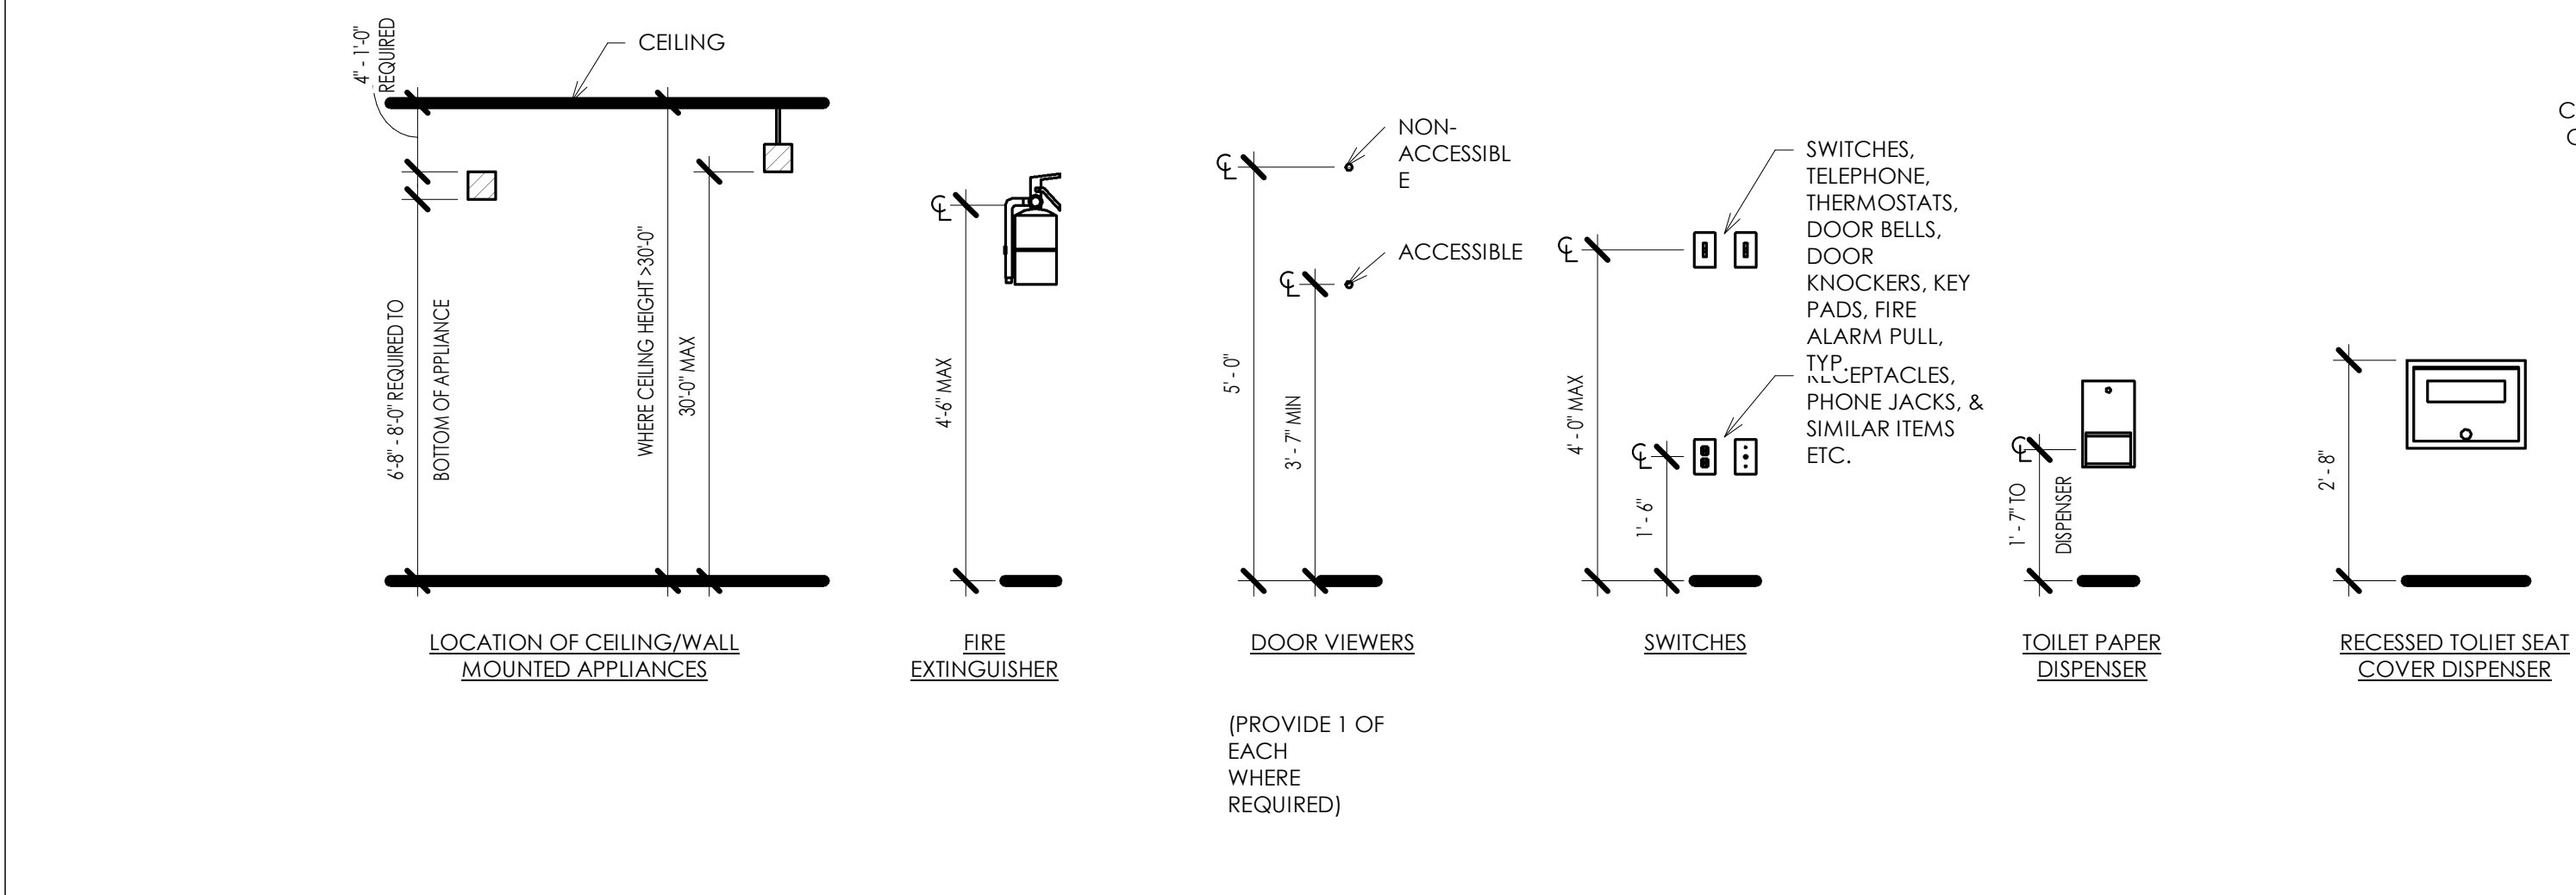


FIXTURE MOUNTING HEIGHTS 3

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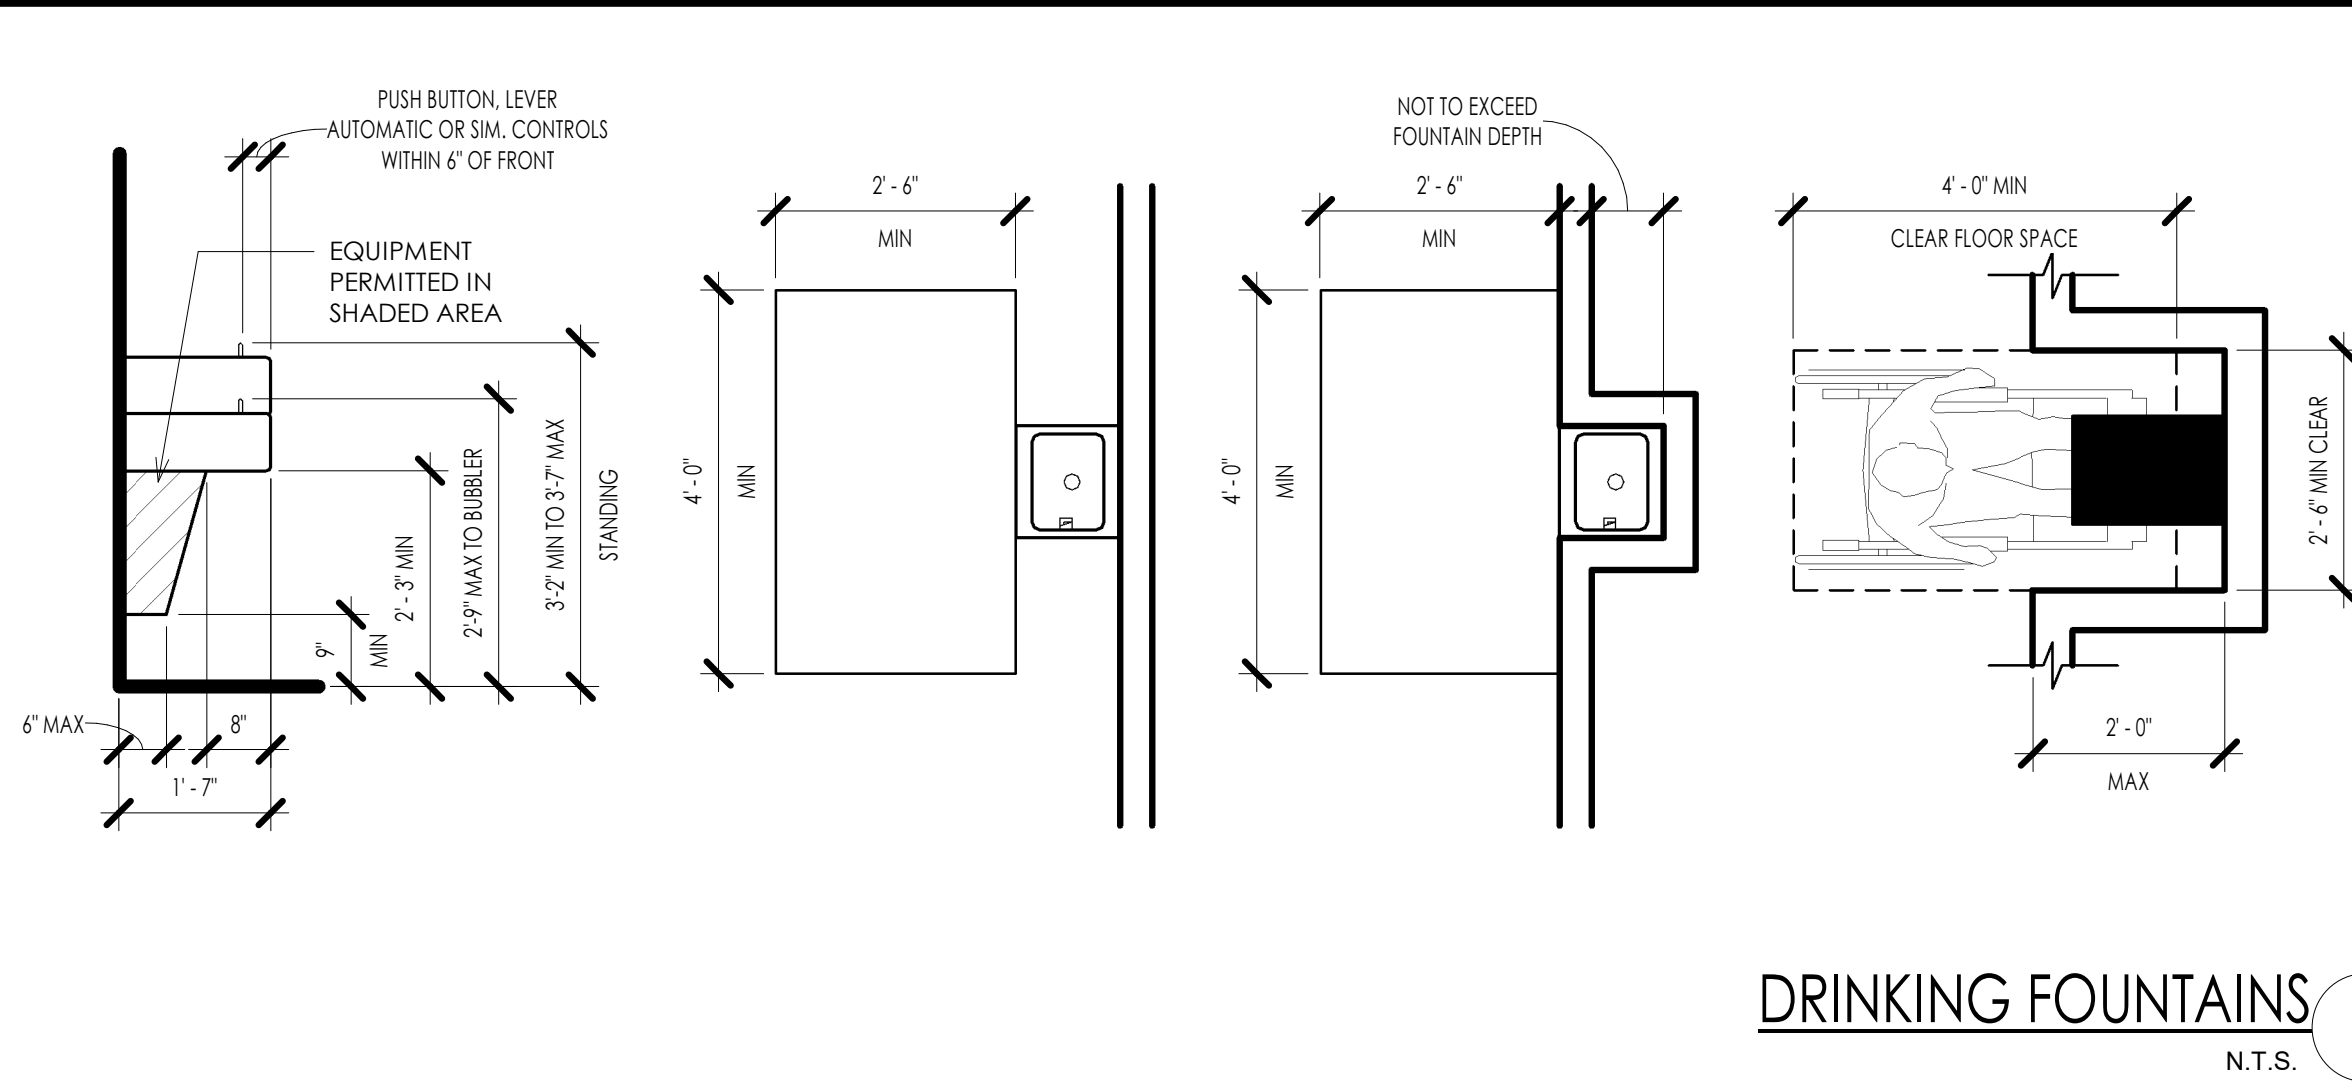
EXTERIOR SIGNAGE 18
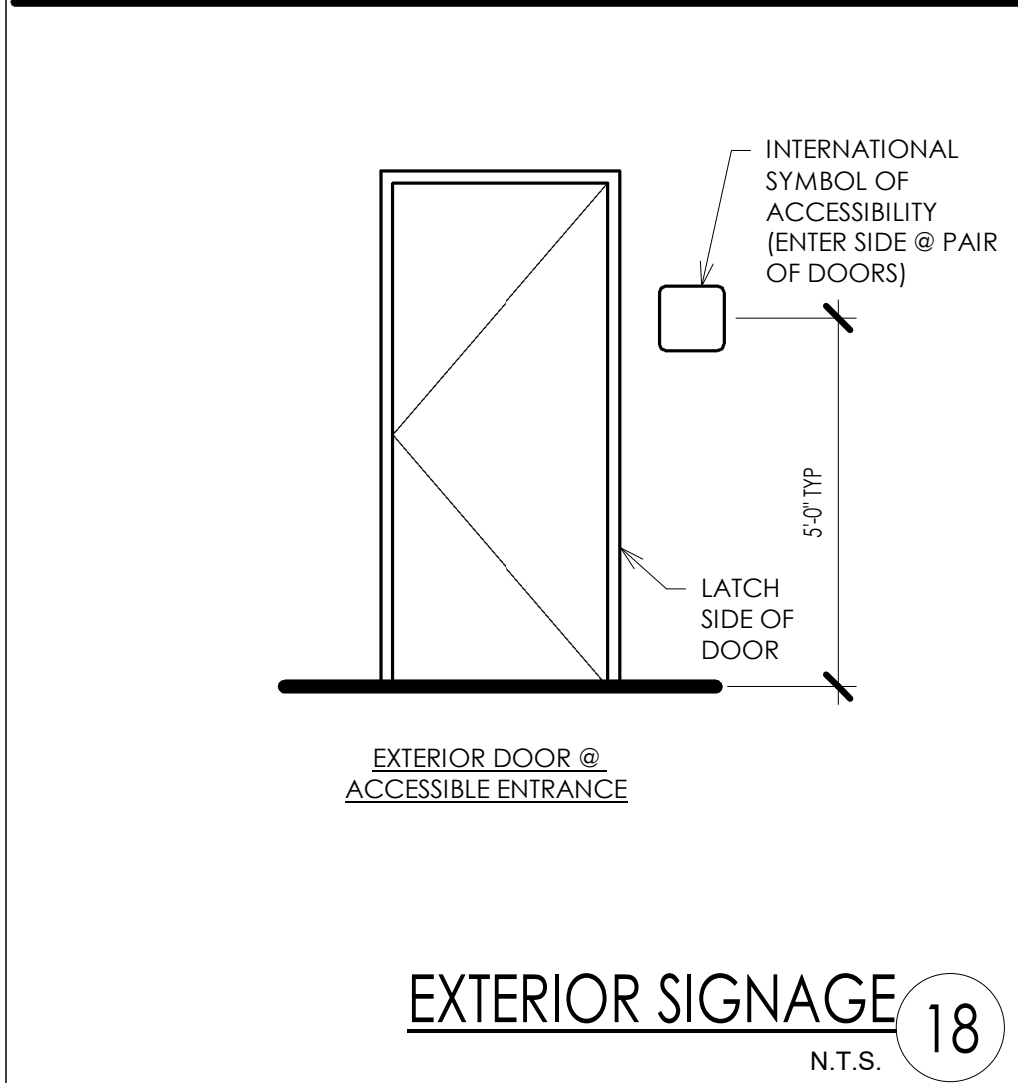
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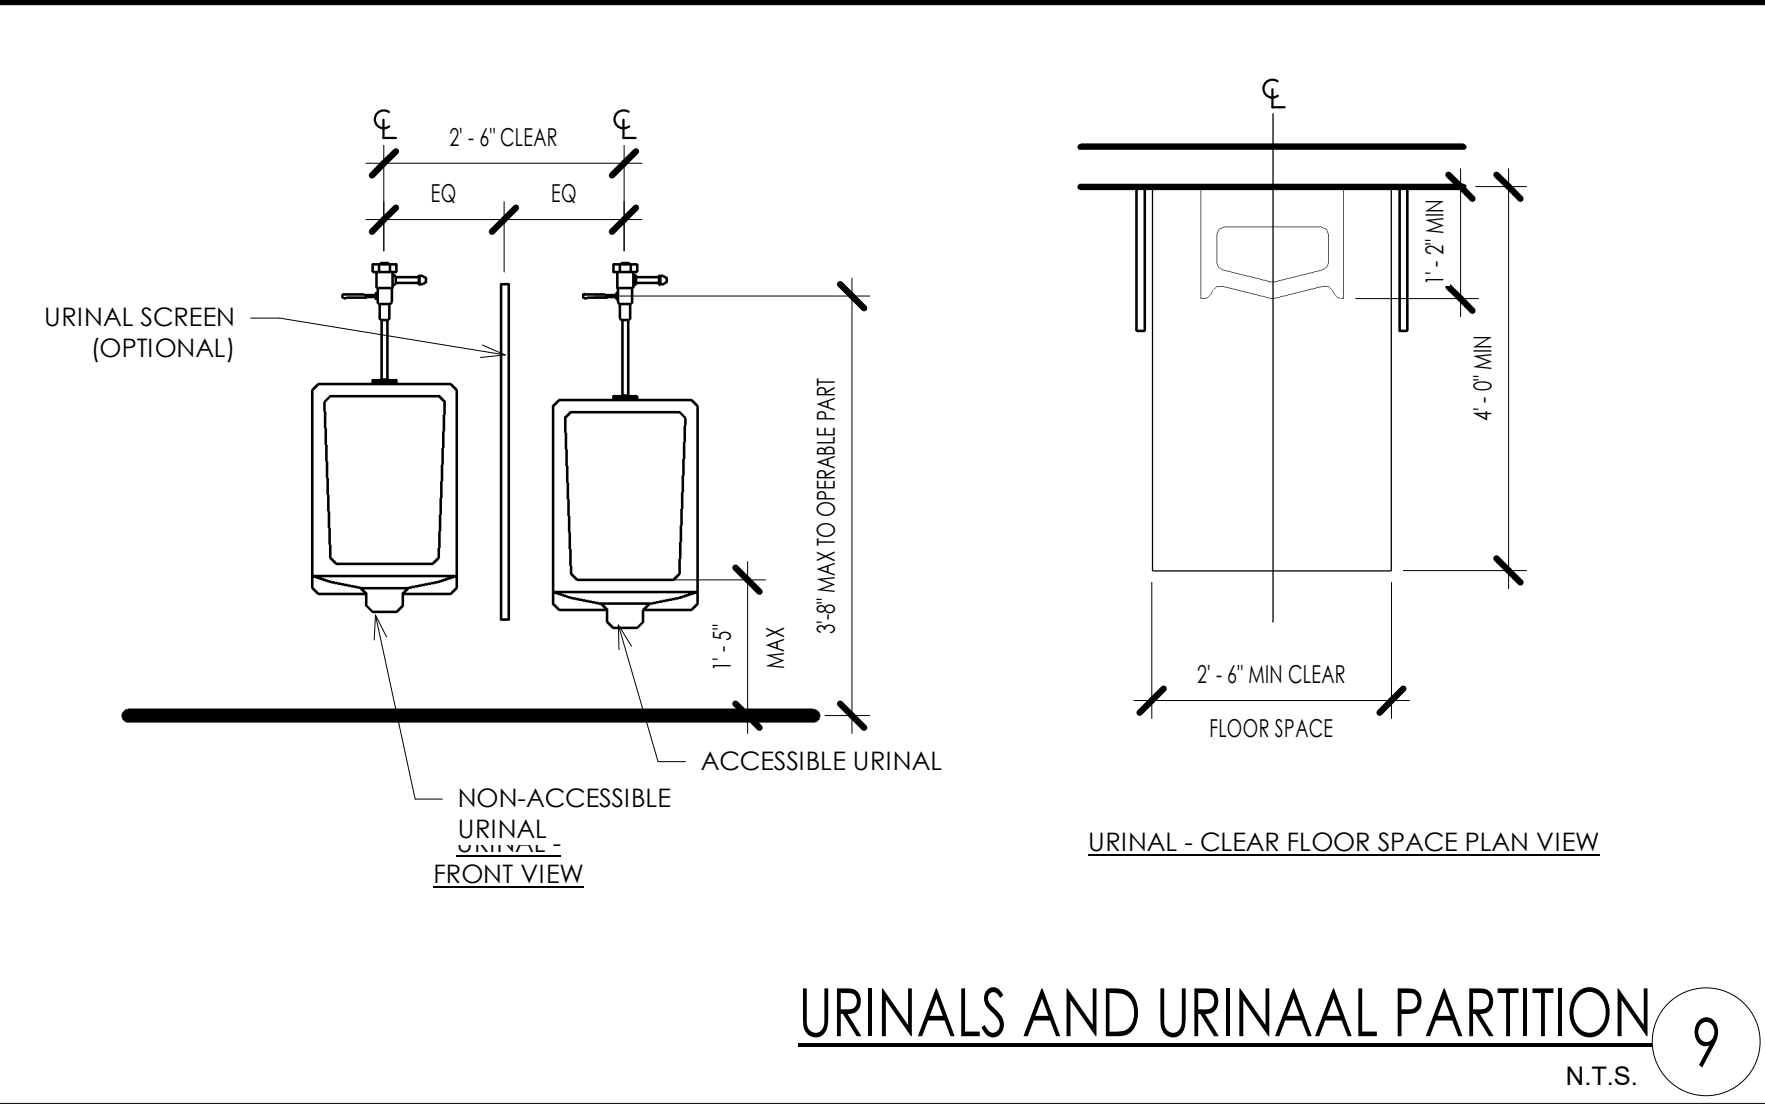
ACCESSIBLE LAVATORY OR SINK 10

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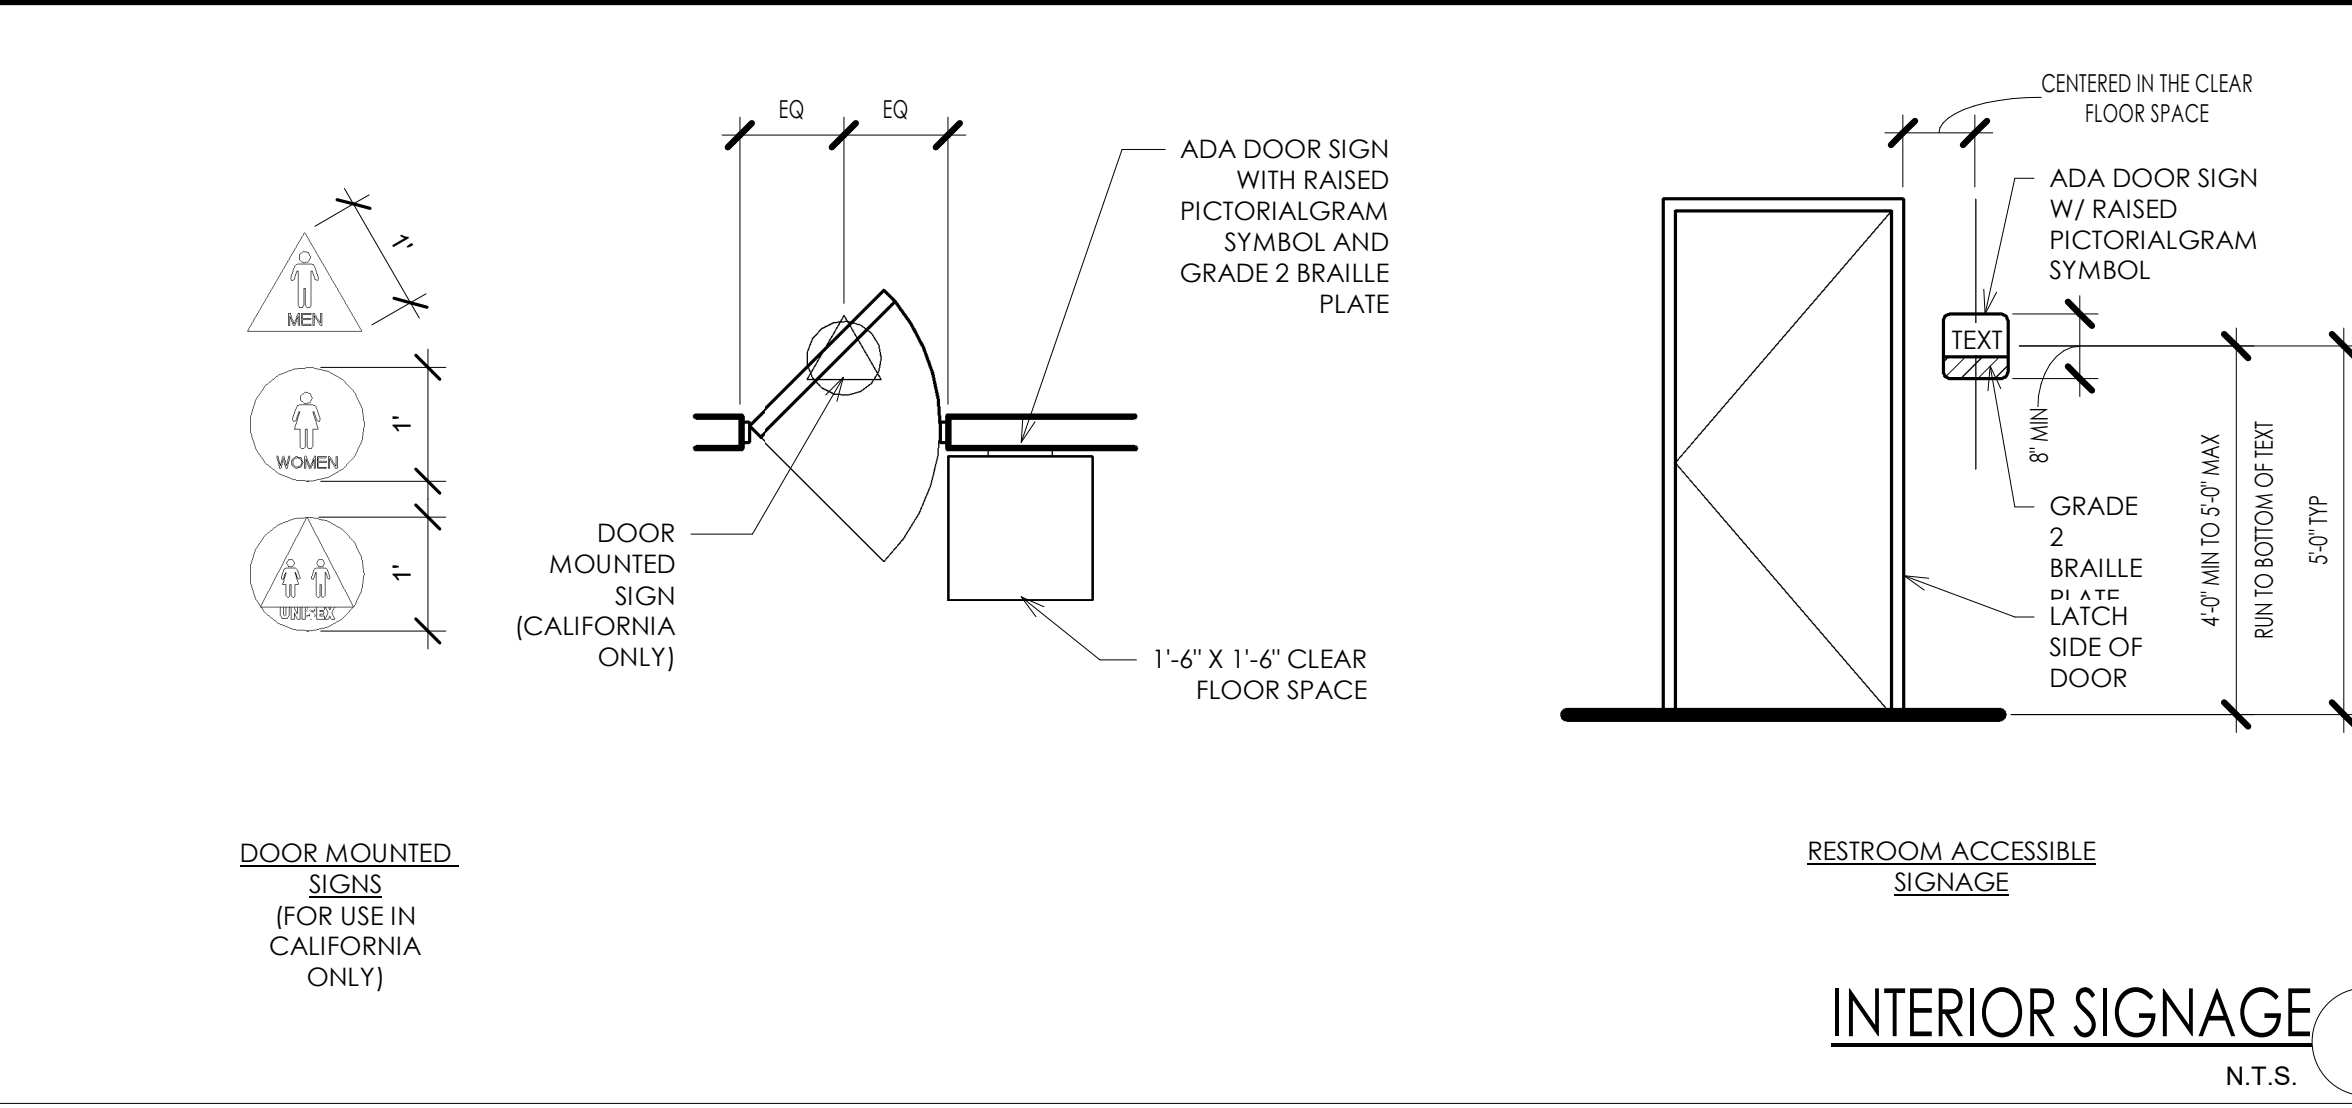
DRINKING FOUNTAINS 2

N.T.S.

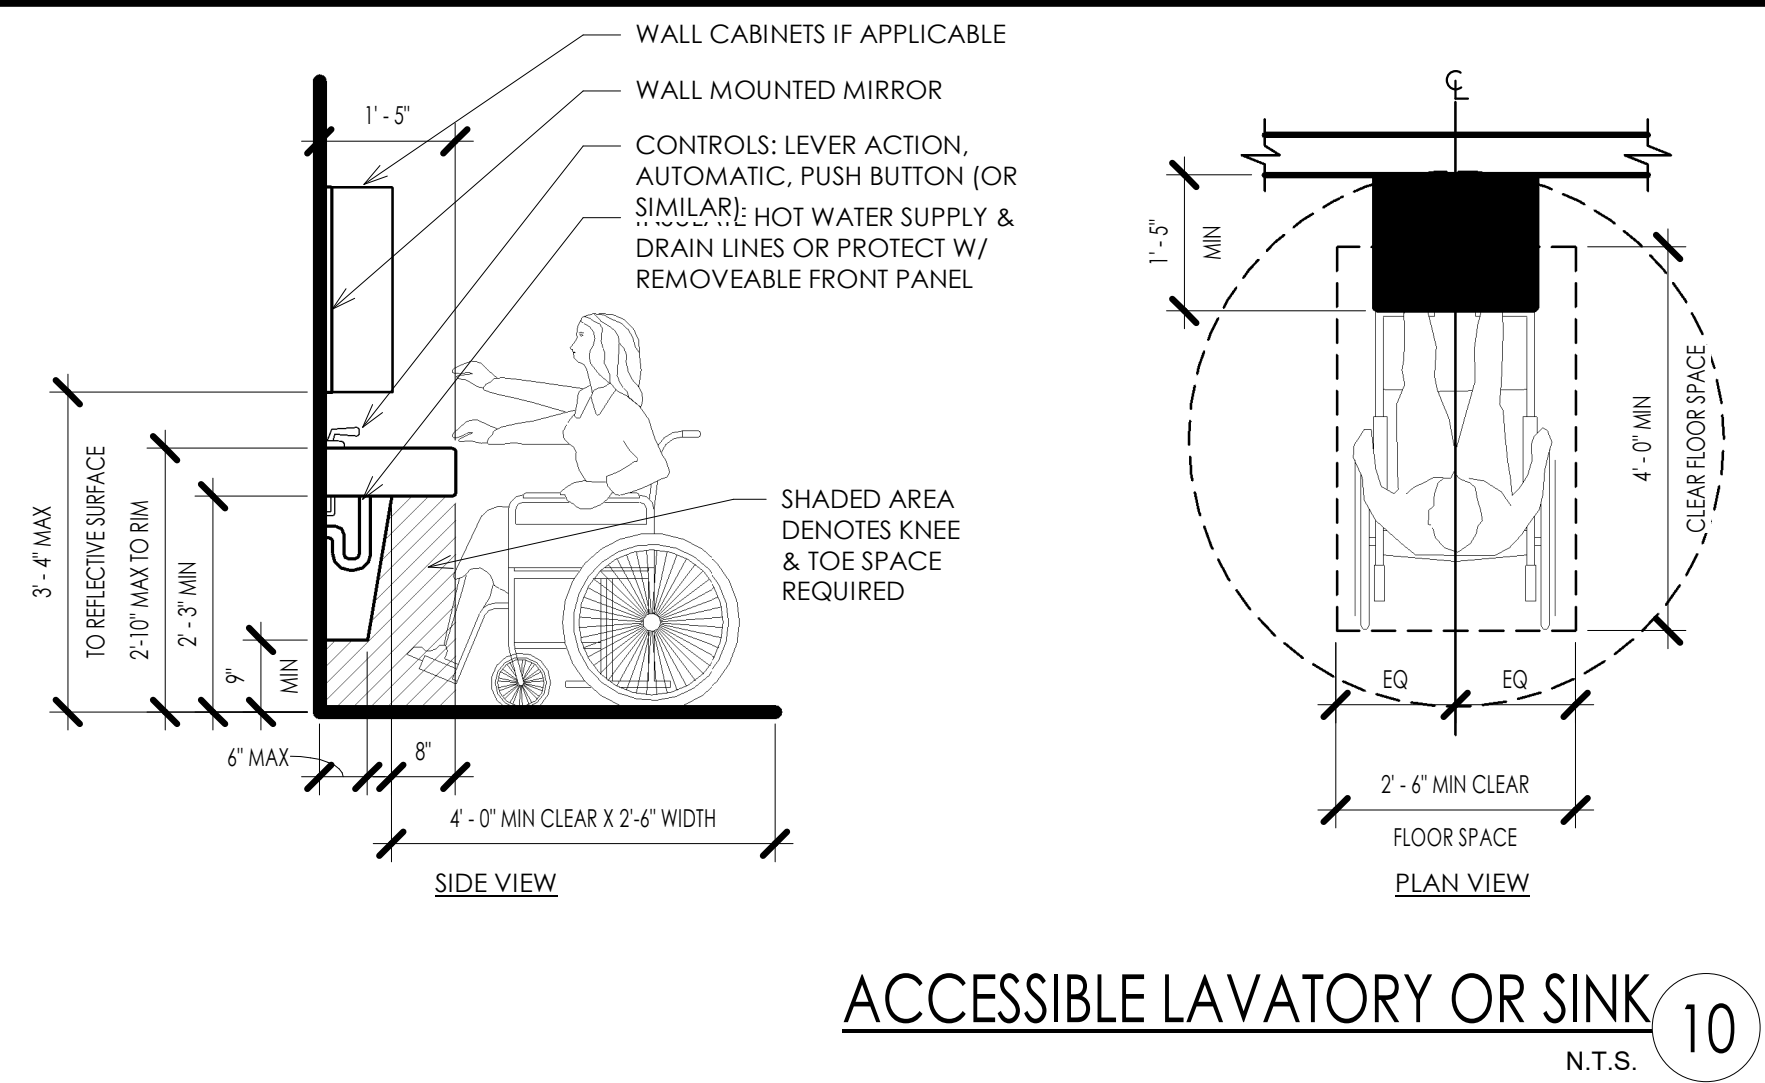

URINALS AND URINAL PARTITION 9

N.T.S.



INTERIOR SIGNAGE 1

N.T.S.

klloverarchitects
 8813 PENROSE LANE, SUITE 400 • LENEKA, KS 66219
 PH: 913.649.8181 • FX: 913.649.1275 • WWW.KLOVER.NE

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 SUMMIT FAIR
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 Lee's Summit, MO 64086

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 SUMMIT FAIR**
 910 G NW Blue Pkwy
 Lee's Summit, MO 64086

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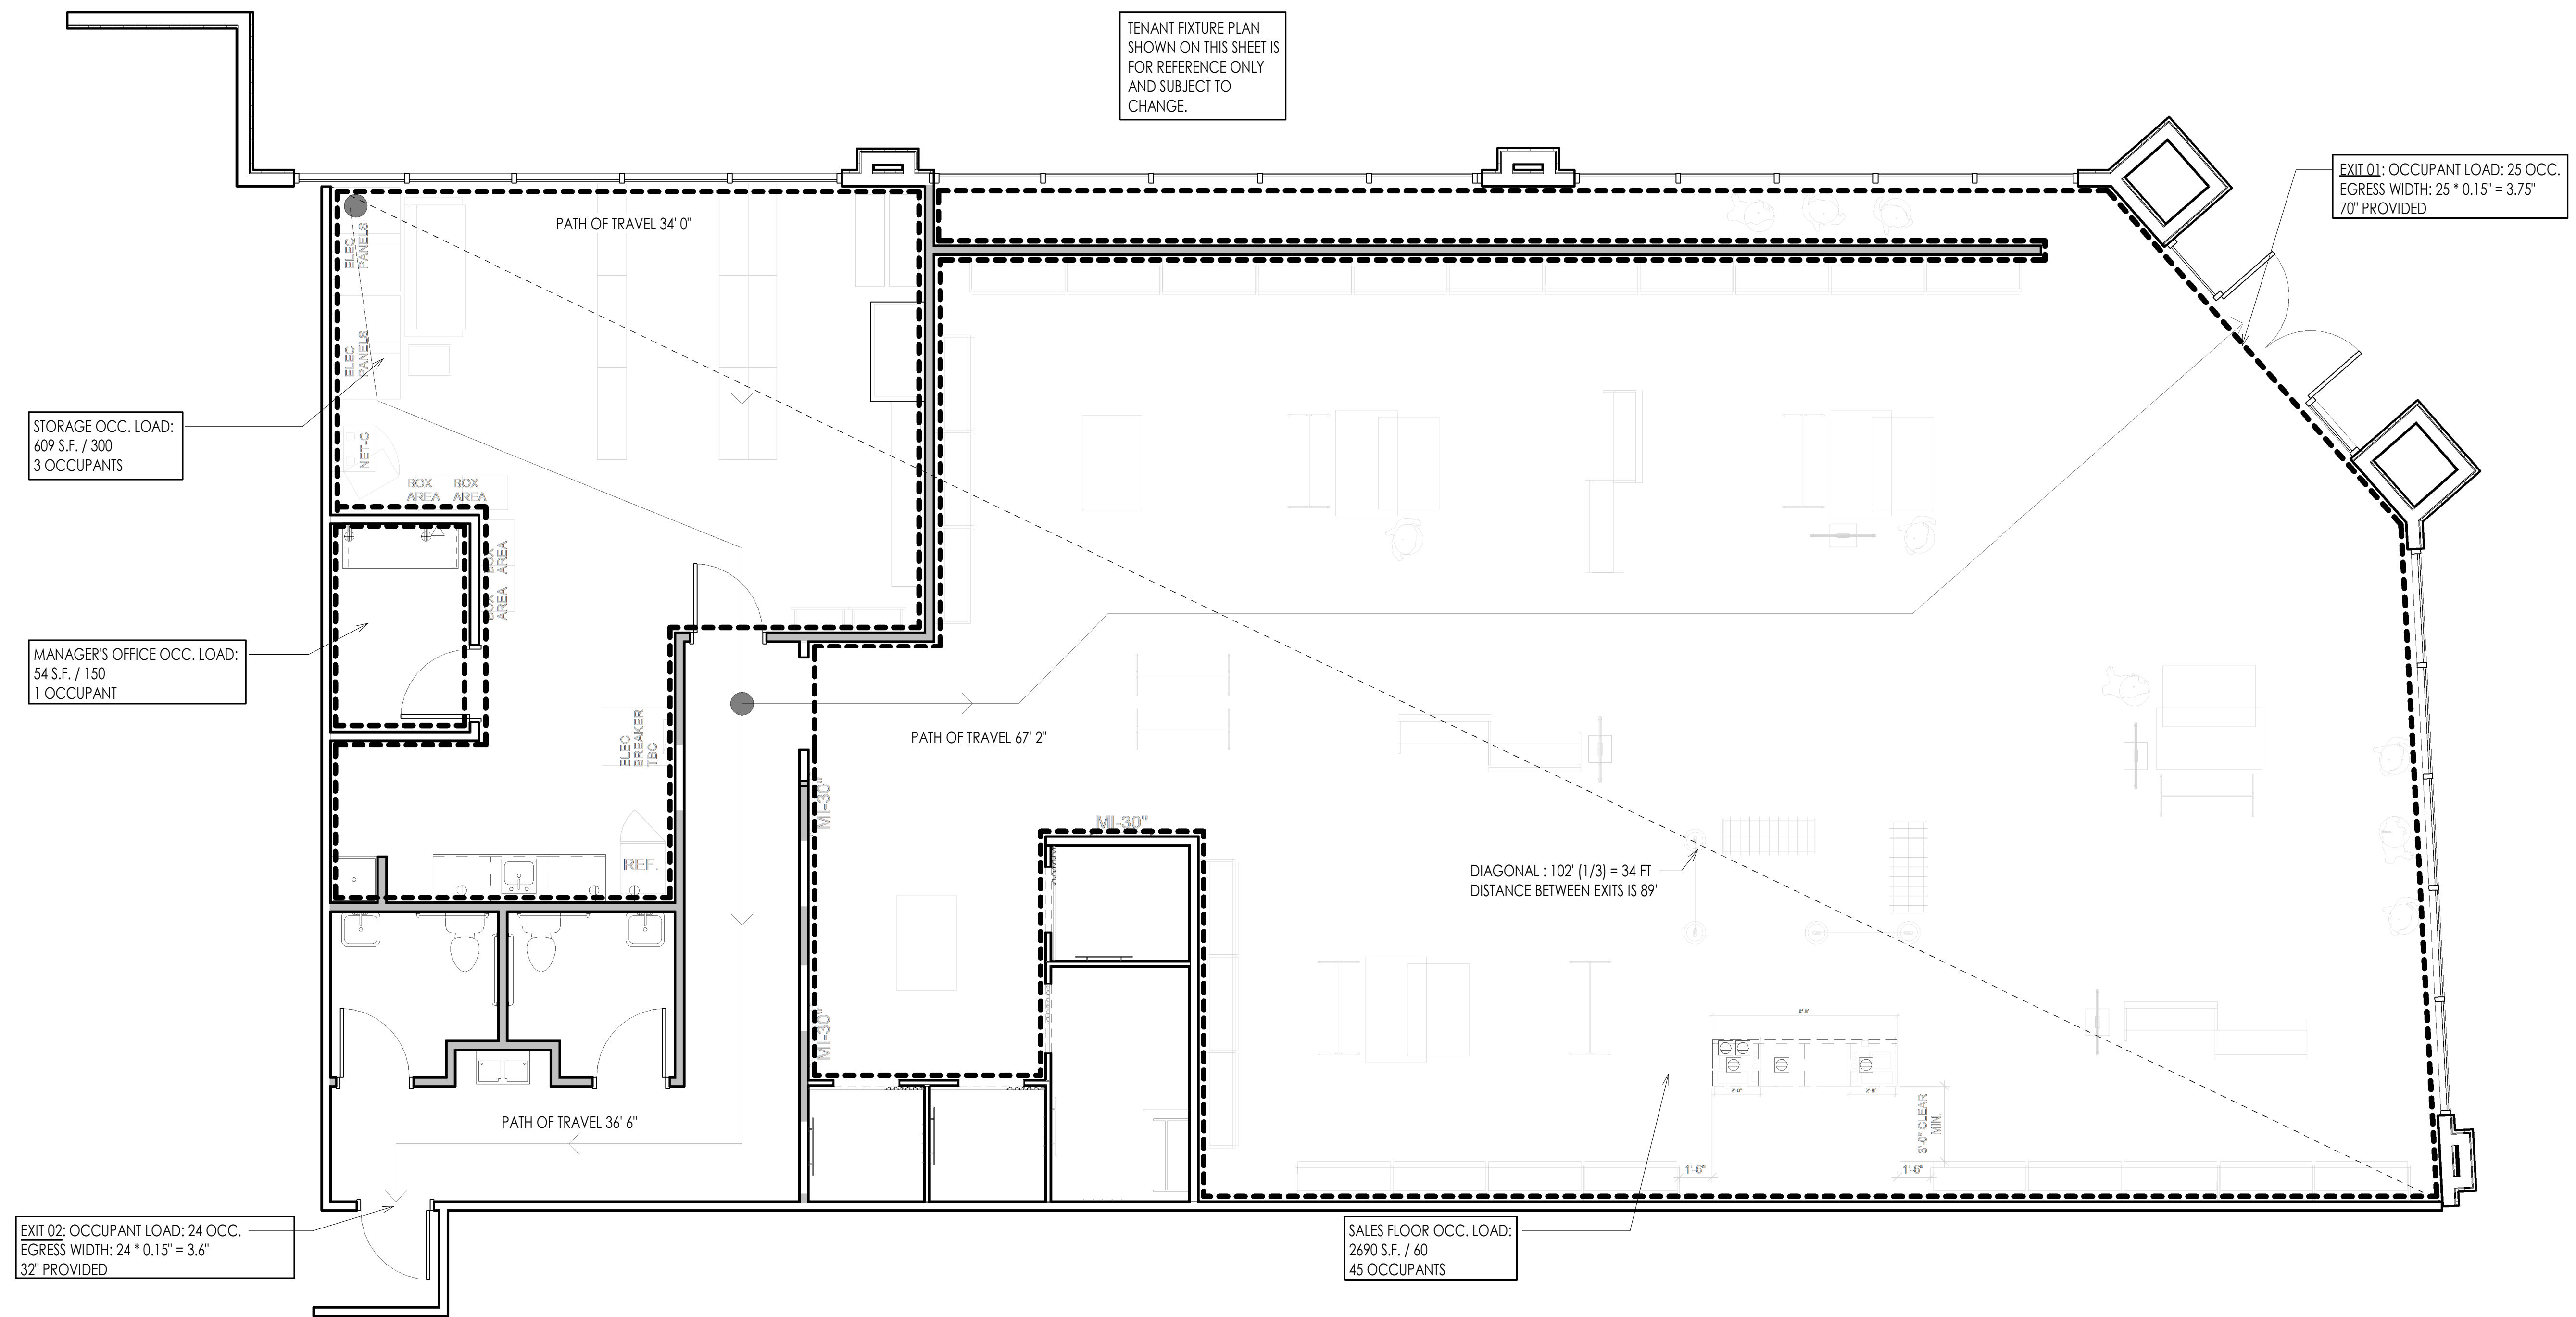
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drawing title

LIFE SAFETY PLAN

drawing number

G015



LULULEMON PROVIDED AND APPROVED SPECIFICATIONS

RFID SHIELDING REQUIREMENTS:
 WHITE RFID SINGLE REFLECTIVE SHIELDING TO BE INSTALLED OVER EXISTING GYP. BD. ON ALL STOCKROOM PARTITIONS CONTINUOUS WITH THE SALES FLOOR AND ADJACENT TENANTS.
 SEE PRODUCT SPECIFICATIONS FOR INSTALLATION DETAILS AND REQUIREMENTS.
 WHITE SINGLE REFLECTIVE SHIELDING TO BE INSTALLED FULL HEIGHT AND WIDTH OF ENTIRE PARTITION OR TO UNDERSIDE OF DECK
 MIN. HEIGHT OF RFID SHIELDING TO 12'-0"
 ENSURE A 2" MINIMUM OVERLAP ON ALL SEAMS TO ENSURE THERE IS NO BLEED.
 SEE PRODUCT SPECIFICATIONS FOR MORE INSTALLATION DETAILS AND REQUIREMENTS.
 RFID SINGLE REFLECTIVE SHIELDING TO BE INSTALLED ON THE STOCKROOM SIDE OF THE EXISTING WALL.
 ALL PENETRATIONS INCLUDING BUT NOT LIMITED TO OUTLETS, CONDUIT, PIPING AND DUCTWORK SHALL BE SEALED WITH SPECIFYING RFID SHIELDING TAPE.
 SEE PRODUCT SPECIFICATIONS FOR MORE INSTALLATION DETAILS AND REQUIREMENTS.

RFID SINGLES REFLECTIVE SHIELDING (SIDE FACING BACKROOM IS REQUIRED TO BE WHITE):
 OPTIONS BELOW OR SIMILAR:
 PRODUCT: SINGLE BUBBLE/WHITE FOIL REFLECTIVE INSULATION

- OPTION 1:
[HTTPS://WWW.REFLECTIXINC.COM/PRODUCTS/SINGLE-REFLECTIVE-INSULATION/](https://www.reflectixinc.com/products/single-reflective-insulation/)
- OPTION 2:
[HTTP://WWW.RADIANTBARRIER.COM/PRODUCTS/TEMPSHIELD-SINGLE-BUBBLE-WHITE-FOIL/](http://www.radiantbarrier.com/products/tempshield-single-bubble-white-foil/)
- OPTION 3:
[HTTPS://WWW.AVERYDENINSON.COM/CONTENT/DAM/AVERYDENINSON/PT/NA/EN/LITERATURE/PRODUCT%20INFORMATION/PT%200815/FT-0815-TS-ADPT.PDF](https://www.averydeninson.com/content/dam/averydeninson/pt/na/en/literature/product%20information/pt%200815/ft-0815-ts-adpt.pdf)
 - PRODUCT: SHIELD SENSE FT 0815/ALUMINUM FOIL ROLL & TAPE
 - ROLL: 27" WIDE X 187 FT ROLL FOR WALL SURFACE APPLICATION.
 - TAPE: 4" WIDE ROLL FOR SEALING PENETRATIONS AT OUTLETS, CONDUIT, PIPING AND DUCTWORK.

FLOORING SPECIFICATIONS:
CONCRETE SPECIFICATIONS
 OPTION 1
 GRIND AND POLISH EXISTING CONCRETE FLOORING
 COLOUR: SITE DEPENDANT
 POLISH: LEVEL 1
 AGGREGATE: VARIES
 APPLICATION: SALES FLOOR RETROPLATE TO REPOLISH EXISTING CONCRETE FLOORS – OR GC TO DO SIMILAR WITHOUT USING THE CERTIFIED "RETROPLATE" INSTALLER AND PRODUCT OR
 FOR CONCRETE FLOORS THAT ARE NOT IN A CONDITION THAT THEY CAN BE PATCH AND REPOLISHED WHICH IS OUR ARDEXTOPPING.

BASEBOARD SPECIFICATIONS:
 INSTALL WHITE VINYL BASEBOARDS (4 1/2" X 3/8" JOHNSONITE MANDALAY 50 WHITE OR SIMILAR) THROUGHOUT SALESFLOOR.
 INSTALL BLACK VINYL BASEBOARDS (4 1/2" X 3/8" JOHNSONITE MANDALAY 40 BLACK OR SIMILAR) THROUGHOUT BACK OF HOUSE SPACES.

WALL FINISH SPECIFICATIONS:
 FOH/SALES FLOOR WALLS: BENJAMIN MOORE REGAL SELECT HORIZON OC-53; FINISH: EGGSHELL (549)
 FOH FITTING ROOM WALLS: BENJAMIN MOORE ULTRA SPEC SCUFF-X HORIZON OC-53; FINISH: MATTE (484)
 BOH/RESTROOM WALLS: BENJAMIN MOORE ULTRA SPEC SCUFF-X STONINGTON GRAY; FINISH: SATIN (486)
 DOOR FRAMES AND DOORS: BENJAMIN MOORE ULTRA SPEC SCUFF-X KENDALL CHARCOAL HC-166; FINISH: SATIN (486)
 WHITE SPEC (CEILINGS AND OTHER ELEMENTS REQUIRED TO BE WHITE); BENJAMIN MOORE WATERBOURNE CEILING PAINT CHANTILLY LACE OC-65; FINISH: ULTRA FLAT (508)

CEILING PAINT SPECIFICATIONS:
 OPEN CEILING (14'-0" TO 16'-0"): BENJAMIN MOORE WATERBOURNE CEILING PAINT SECRET AF-710; FINISH: ULTRA FLAT (508)
 TO BE USED WHEN DECK IS BETWEEN 14'-0" TO 16'-0" AFF- TBC WITH LULULEMON PRIOR TO IMPLEMENTATION
 APPLICATION: FOH/SALESFLOOR CEILING SURFACE, HVAC, EXPOSED CEILING ITEMS, WALLS ABOVE 12'-0" PAINT LINE
 WHEN OPEN LID CEILING CONDITIONS OCCUR. PAINT LINE TO RETURN DOWN TO 12'-0" AFF.
 OPEN CEILING (16'-0" +): BENJAMIN MOORE WATERBOURNE CEILING PAINT KENDALL CHARCOAL HC-166; FINISH: ULTRA FLAT (508)
 TO BE USED WHEN DECK IS OVER 16'-0" AFF- TBC WITH LULULEMON PRIOR TO IMPLEMENTATION
 APPLICATION: FOH/SALESFLOOR CEILING SURFACE, HVAC, EXPOSED CEILING ITEMS, WALLS ABOVE 12'-0" PAINT LINE WHEN OPEN LID CEILING CONDITIONS OCCUR. PAINT LINE TO RETURN DOWN TO 12'-0" AFF.
 GWB PAD CEILING/HARD LID CEILING OR ACT CEILING: BENJAMIN MOORE CHANTILLY LACE OC-65; FINISH: ULTRA FLAT (508)
 TO BE USED FOR GWB CEILING AND PERIMETER SOFFITS - TBC WITH LULULEMON PRIOR TO IMPLEMENTATION
 APPLICATION: FOH/SALESFLOOR CEILING WHEN GWB PAD AND HARD LID CEILING IS PRESENTED OR ACT IS PROVIDED.

RESTROOM FIXTURE AND ACCESSORY SPECIFICATIONS:
 ALL EXISTING RESTROOM FIXTURES TO REMAIN.

BOH KITCHENETTE SPECIFICATIONS:
CABINET:
 FRAME AND DOORS TO BE MADE OF WHITE P-LAM PANELS. CABINET TO HAVE A 4" H TOE KICK WITH A BASE ATTACHED TO THE TOW KICK PANEL.
 CABINET TO BE ADA COMPLIANT WITH THE TOP OF THE COUNTERTOP AT 34"H MAX. SEE DETAIL/ELEVATION FOR REFERENCE.
HARDWARE:
 LIBERTY 1 1/4" ROUND SOLID KNOBS
 FINISH: SATIN NICKEL OR EQUIVALENT.
COUNTERTOPS:
 SUPPLIER/SPEC: IKEA
 STYLE: SAJAN
 COLOUR: WHITE
 SIZE: 25 5/8" X 98"


FITTING ROOM FIXTURE SPECIFICATIONS:
 HANGBAR: TWO (2) X 30"L HANGBARS IN BLACKENED STAINLESS STEEL TO BE INSTALLED IN EACH FITTING ROOM OR EQUIVALENT [ALL EQUIVALENTS TO BE APPROVED BY LLL CONSTRUCTION & DESIGN TEAM]
 HOOKS: FIVE (5) HOOKS TO BE PROVIDED FOR EACH FITTING ROOM. FINISH TO BE BLACKENED STAINLESS STEEL OR EQUIVALENT [ALL EQUIVALENTS TO BE APPROVED BY LLL CONSTRUCTION & DESIGN TEAM]
 ADA BENCH: [HTTPS://PRIVEEDESIGNS.COM/COLLECTIONS/DRESSING-ROOM-ACCESSORIES/PRODUCTS/ADA-BENCH-42X18X24?VARIANT=32069850726533](https://priveedesigns.com/collections/dressing-room-accessories/products/ada-bench-42x18x24?variant=32069850726533) OR EQUIVALENT [ALL EQUIVALENTS TO BE APPROVED BY LLL CONSTRUCTION & DESIGN TEAM]
 CURTAIN ROD: [HTTPS://WWW.AMAZON.COM/VILON-DRAPERY-WINDOW-CURTAIN-ROD/DP/B06WWP9XXB](https://www.amazon.com/vilon-drapery-window-curtain-rod/dp/B06WWP9XXB) OR EQUIVALENT [ALL EQUIVALENTS TO BE APPROVED BY LLL CONSTRUCTION & DESIGN TEAM]
 CURTAIN/DRAPE: TO BE BLACKOUT CHARCOAL CURTAIN A MINIMUM OF 60"W PANELS, MOUNTED TO BE 4" CLEAR FROM FLOOR.

LIGHTING SPECIFICATIONS:
 WARM TEMPERATURE: 3000K
 BEAM SPREAD: 25-40
 LUMENS: 1600
 LIGHT SPACING: 1 LIGHT EVERY 18" TYP. U.N.O. ON PLANS
 TRACK DISTANCE FROM THE WALLS: 4'-0" AWAY FROM THE WALLS AROUND THE PERIMETERS
 DISTANCE BETWEEN TRACKS: 6'-0" TO 8'-0" MAX U.N.O.
TRACK LIGHTING:
 CON TECH LT-4-P, LT-4-P, LT8-P, LT-12-P, 1 CIRCUIT SUSPENDED WHITE/BLACK TRACK (COLOUR TO BE CONFIRMED WITH LLL DESIGNER)
 INSTALL DIRECTIONS: TRACK TO BE HUNG FROM STRUCTURE @12' AFF
 CON TECH GIMBLE, CTL838/2-P WHITE/BLACK TRACK HEAD 250W PAR38 (COLOUR TO BE CONFIRMED WITH LLL DESIGNER)

WALL WASHER SPECIFICATIONS:
 LUMENTURE TWW1 60-30H-1600-B-J TRACK HEAD – BLACK WALL WASHER 17 WATT LED
 TRACK MOUNTED
 DIRECTED TOWARDS WALL
POT LIGHT:
 RECESSED
 CON TECH RL38L-ICSA RF6L130KCE-PL LED DOWN LIGHT – WHITE TRIM 15W LED CEILING HEIGHT
 TO BE USED AS REQUIRED IN FOH/SALESFLOOR
 STAFF ROOM RECESSED IN GWB
FITTING ROOM LIGHTING:
 SURFACE MOUNTED @7" AFF ON FITROOM WALLS WITH ALUM CHANNEL (ALP-130-98-FR).


BOH/BACKROOM LIGHTING:
 SURFACE MOUNTED OR SUSPENDED
 L8 DAY-BRITE CFL F58-80L-830-UNV-DIM 62 WATT LED BACK OF HOUSE LED STRIP LIGHT, SUSPENDED U.N.O.
BATHROOM LIGHTING: (EXISTING TO REMAIN)
 RECESSED @ CEILING HEIGHT BROAN AE80L DELUXE FAN LIGHT COMBO 11 WATT LED
 FAN LIGHT COMBO TO BE CENTERED IN THE ROOM; FAN: 27 WATT/80CFM

FITTING ROOMS

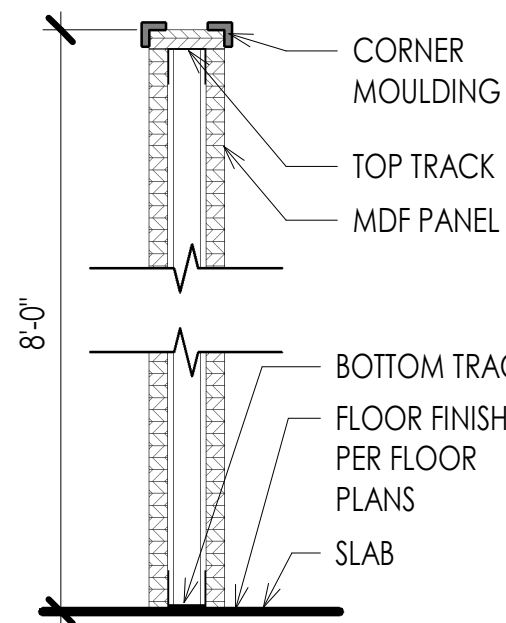

3 5/8" X 20 GAUGE METAL STUDS ROTATED SIDWAYS (2 STUDS SIDE BY SIDE, FLIPPED FOR ATTACHMENT OF MDF) AT 16" OC (TYP) WITH 3/4" MDF ON BOTH SIDES, MDF AND WHITE 1" CORNER MOULDING ON TOP OF WALL EA. SIDE, FLOOR TO 8' AFF UNLESS OTHERWISE NOTED


B TO 8' A.F.F.

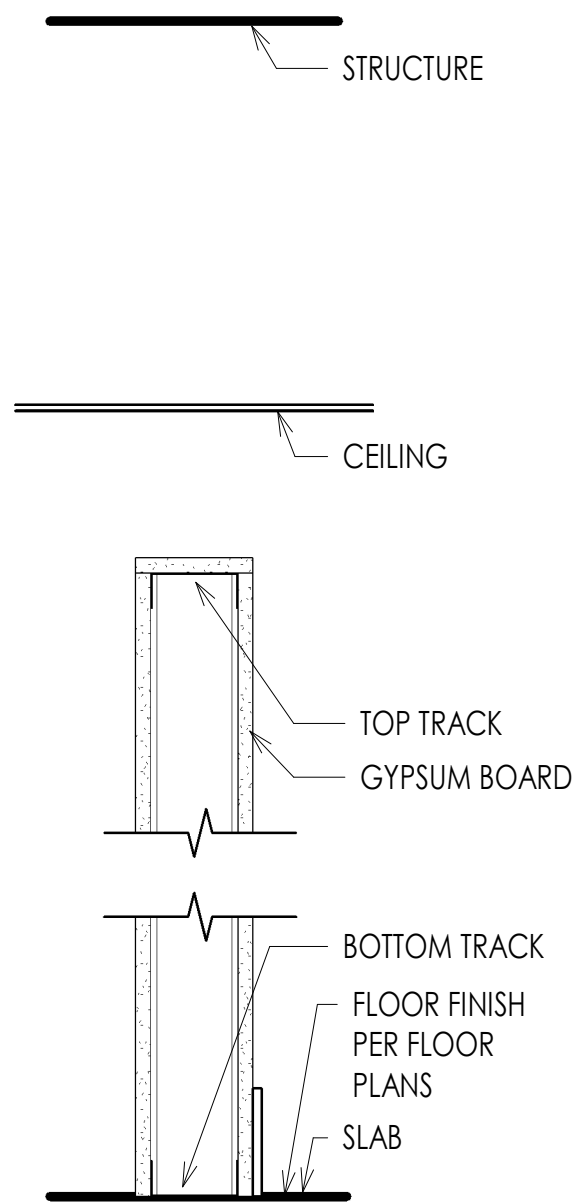

INTERIOR PARTITIONS

3 5/8" X 20 GAUGE METAL STUDS AT 16" OC (TYP) WITH 3/4" MDF ON BOTH SIDES, MDF AND CORNER BEAD ON TOP OF WALL, FLOOR TO 8' AFF UNLESS OTHERWISE NOTED


A2 TO 12'-0" AFF
A3 TO 10'-0" AFF
B2

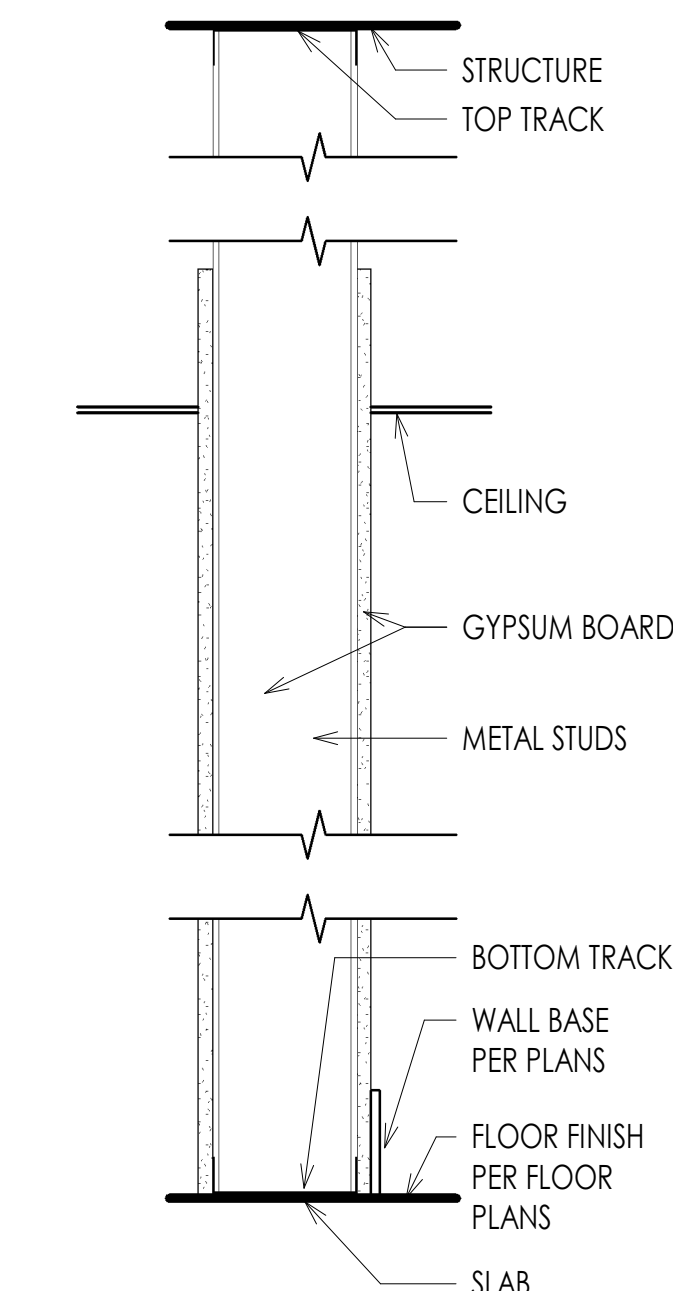

INTERIOR PARTITIONS

6" X 20 GAUGE METAL STUDS AT 16" OC (TYP) WITH 5/8" GYPSUM BOARD ON BOTH SIDES, FLOOR TO 6" ABOVE CEILING UNLESS OTHERWISE NOTED


E3

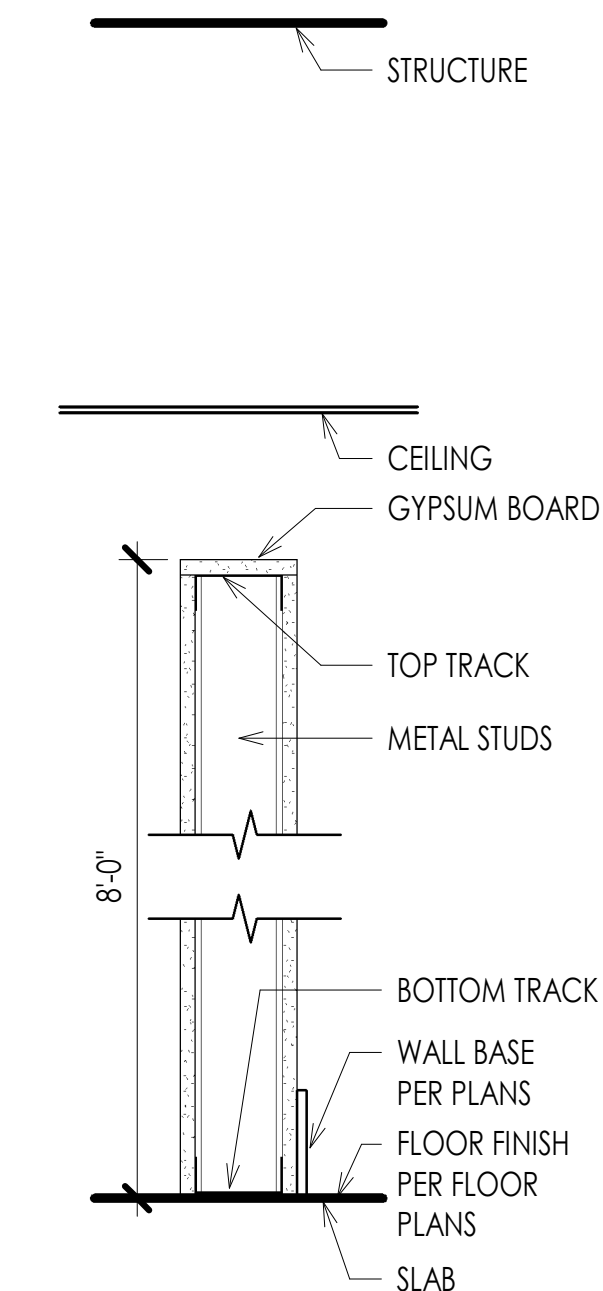

INTERIOR PARTITIONS

3 5/8" X 20 GAUGE METAL STUDS AT 16" OC (TYP) WITH 5/8" GYPSUM BOARD ON BOTH SIDES, GYPSUM BOARD AND CORNER BEAD ON TOP OF WALL, FLOOR TO 8'-0" AFF.

E2

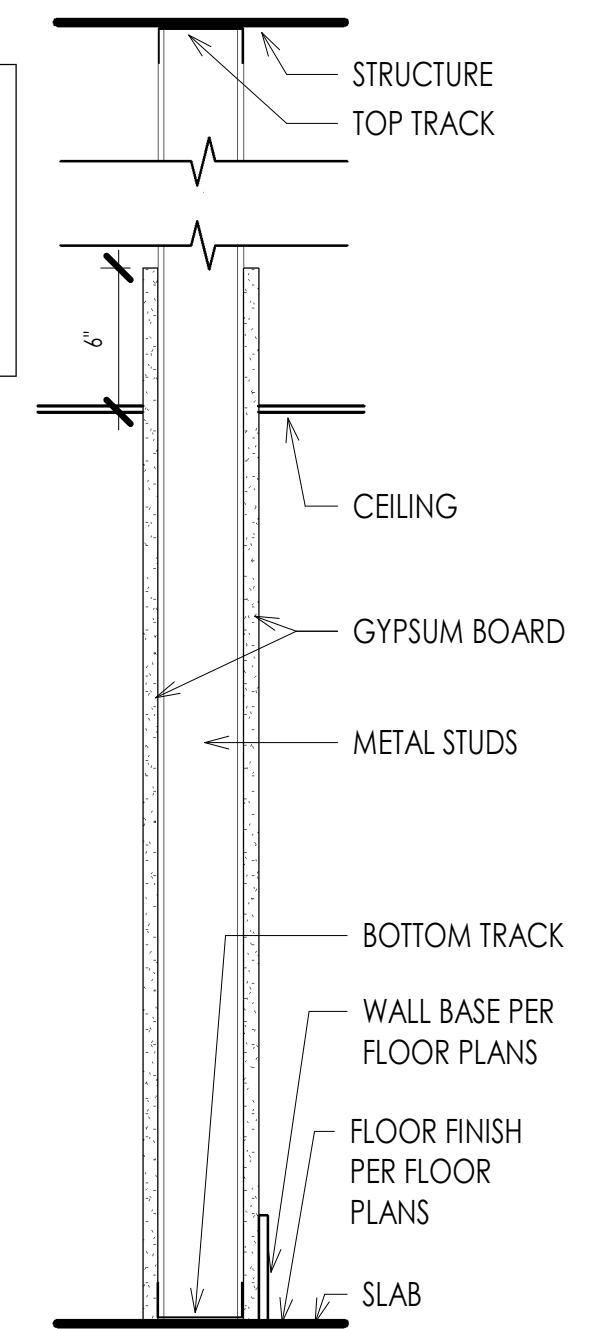

FOR NEW WALLS AND INFILLS, TYPE 'S' SELF-TAPPING STEEL SCREWS SPACED 8 IN O.C. ALONG EDGES OF BOARD AND 12 IN O.C. IN THE FIELD OF THE BOARD. JOINTS ORIENTED VERTICALLY AND STAGGERED ON OPPOSITE SIDES OF THE ASSEMBLY.

INTERIOR PARTITIONS


3 5/8" X 20 GAUGE METAL STUDS AT 16" OC (TYP) WITH 5/8" GYPSUM BOARD ON BOTH SIDES, FLOOR TO 6" ABOVE CEILING UNLESS OTHERWISE NOTED

A1 TO DECK

NEW WALL TYPES

SCALE: 1 1/2" = 1'-0"

2

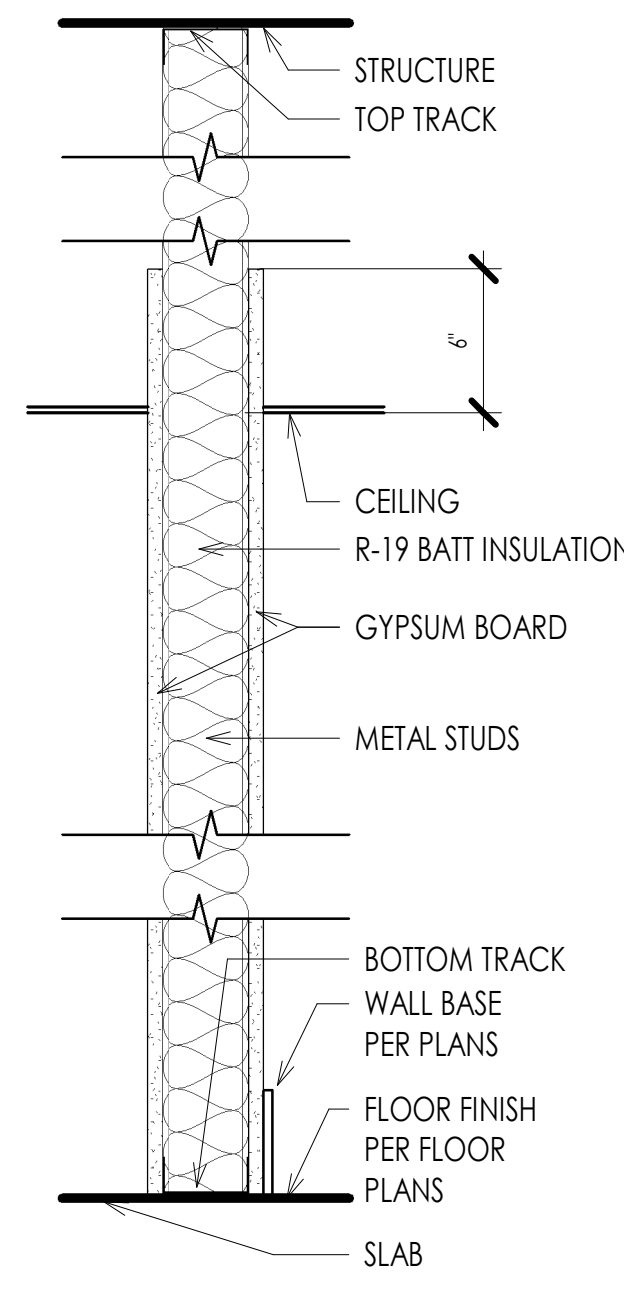

G.C. TO ENSURE FIRE RATING OF EXISTING DEMISING WALL TO REMAIN.

INTERIOR PARTITIONS


3 5/8" X 20 GAUGE METAL STUDS AT 16" OC (TYP) WITH 5/8" GYPSUM BOARD ON BOTH SIDES, FLOOR TO 6" ABOVE CEILING UNLESS OTHERWISE NOTED

E1

EXISTING WALL TYPES

SCALE: 1 1/2" = 1'-0"

1

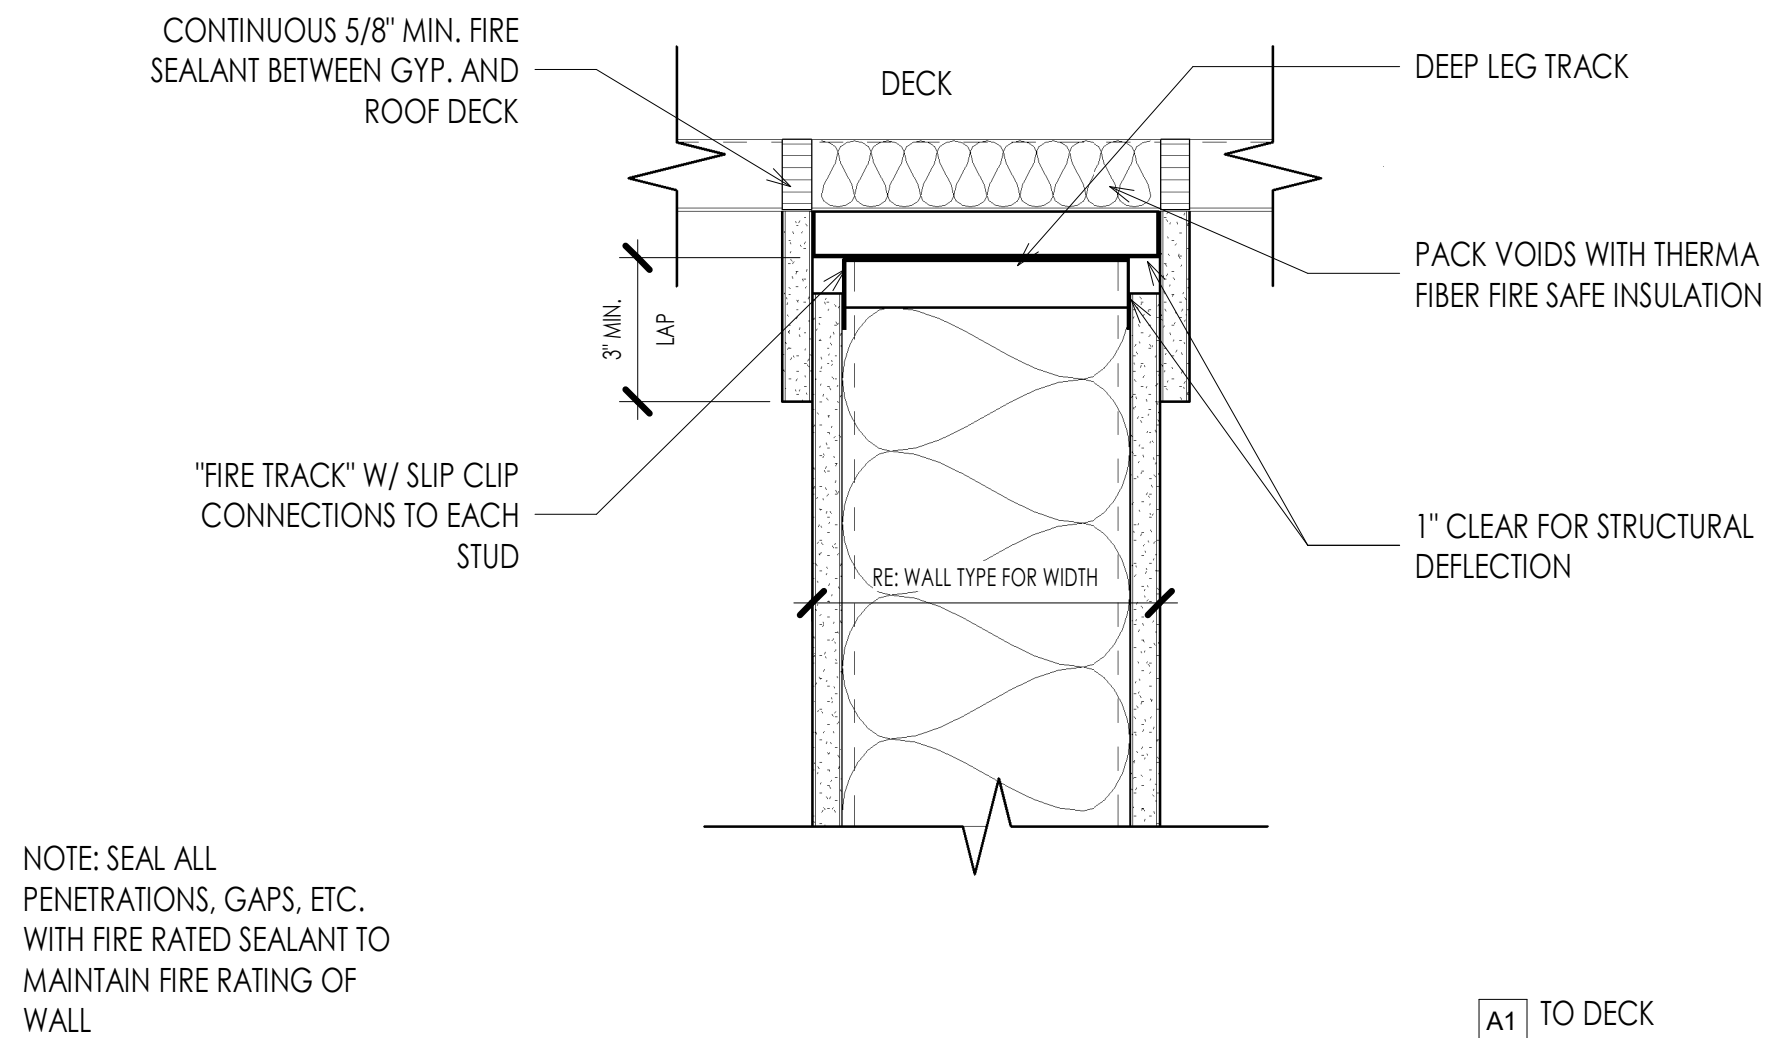

NOTE: SEAL ALL PENETRATIONS, GAPS, ETC. WITH FIRE RATED SEALANT TO MAINTAIN FIRE RATING OF WALL

A1 TO DECK

TOP OF WALL TO ROOF DECK CONNECTION

SCALE: 3" = 1'-0"

3


NOT USED **6**

WALL TYPES

E	EXISTING TO REMAIN
E1	EXISTING TO BE DEMO'D
E2	EXISTING TO BE MODIFIED
E3	
A	NEW
B	FITTING ROOM

GENERAL DEMOLITION NOTES

- DO NOT REMOVE STRUCTURAL MEMBERS UNLESS NOTED OTHERWISE.
- REFER TO OTHER SHEETS IN THIS SET FOR ADDITIONAL DEMOLITION REQUIREMENTS, WHICH SHALL BE BY THE CONTRACTOR UNLESS SPECIFICALLY NOTED OTHERWISE.
- REMOVE ALL EXISTING ELEMENTS WHICH CONFLICT WITH THE NEW WORK, WHETHER OR NOT SHOWN ON THE DRAWINGS.
- PATCH ALL EXISTING ELEMENTS DAMAGED BY DEMOLITION OPERATIONS TO RECEIVE NEW CONSTRUCTION/FINISH.
- DISPOSE OF ALL DEMOLITION DEBRIS LEGALLY.
- CONTRACTOR SHALL DESIGN AND PROVIDE SHORING TO SAFELY SUPPORT EXISTING CONSTRUCTION TO REMAIN DURING DEMOLITION OPERATIONS.
- SAFETY DURING DEMOLITION OPERATIONS SHALL BE THE CONTRACTOR'S SOLE RESPONSIBILITY.
- PERFORM ALL DEMOLITION WORK IN ACCORDANCE WITH THE OWNER/LANDLORD'S CRITERIA. COORDINATE DEMOLITION WITH OWNER/LANDLORD'S REPRESENTATIVE AND CONTACT OWNER/LANDLORD IN ADVANCE OF ANY WORK INVOLVING CONNECTION TO OWNER'S/LANDLORD'S BUILDING SYSTEMS OR REQUIRING TEMPORARY SHUT DOWN OF UTILITIES.
- PATCH AND REPAIR EXISTING DRYWALL FOUND UNSUITABLE FOR INSTALLATION OF NEW FINISHES.
- WHERE INDICATED REMOVE EXISTING PARTITIONS, CEILINGS, SOFFITS AND ASSOCIATED FRAMING AND BRACING BACK TO STRUCTURE. PROTECT EXISTING STRUCTURAL ELEMENTS NECESSARY FOR THE BUILDING SHELL.
- PROVIDE AND COORDINATE TEMPORARY DUSTPROOF PARTITIONS AS REQUIRED.
- DEMOLITION PLAN SHOWS APPROXIMATE LAYOUT OF EXISTING BUILDING AND IS NOT INTENDED TO REPRESENT "AS-BUILT" CONDITIONS. VISIT SITE AND OTHERWISE BECOME FAMILIAR WITH ACTUAL CONDITIONS WHEN BIDDING THE WORK.
- WALLS, PARTITIONS, DOORS, FRAMES, AND OTHER ITEMS TO BE REMOVED ARE SHOWN DASHED. SERVICES WITHIN WALLS AND PARTITIONS SHALL ALSO BE REMOVED. EDGES OF WALLS SHOWN TO REMAIN SHALL BE SAWCUT OR CLEANLY TOOTHED TO ACCEPT NEW CONSTRUCTION. REPAIR AND PATCH EXISTING WALLS SHOWN TO REMAIN WHERE INTERSECTING WALLS, DOORS, FRAMES, ETC. ARE SHOWN TO BE REMOVED AND WHERE EXISTING CONSTRUCTION WILL NOW BE EXPOSED IN THE NEW CONSTRUCTION.

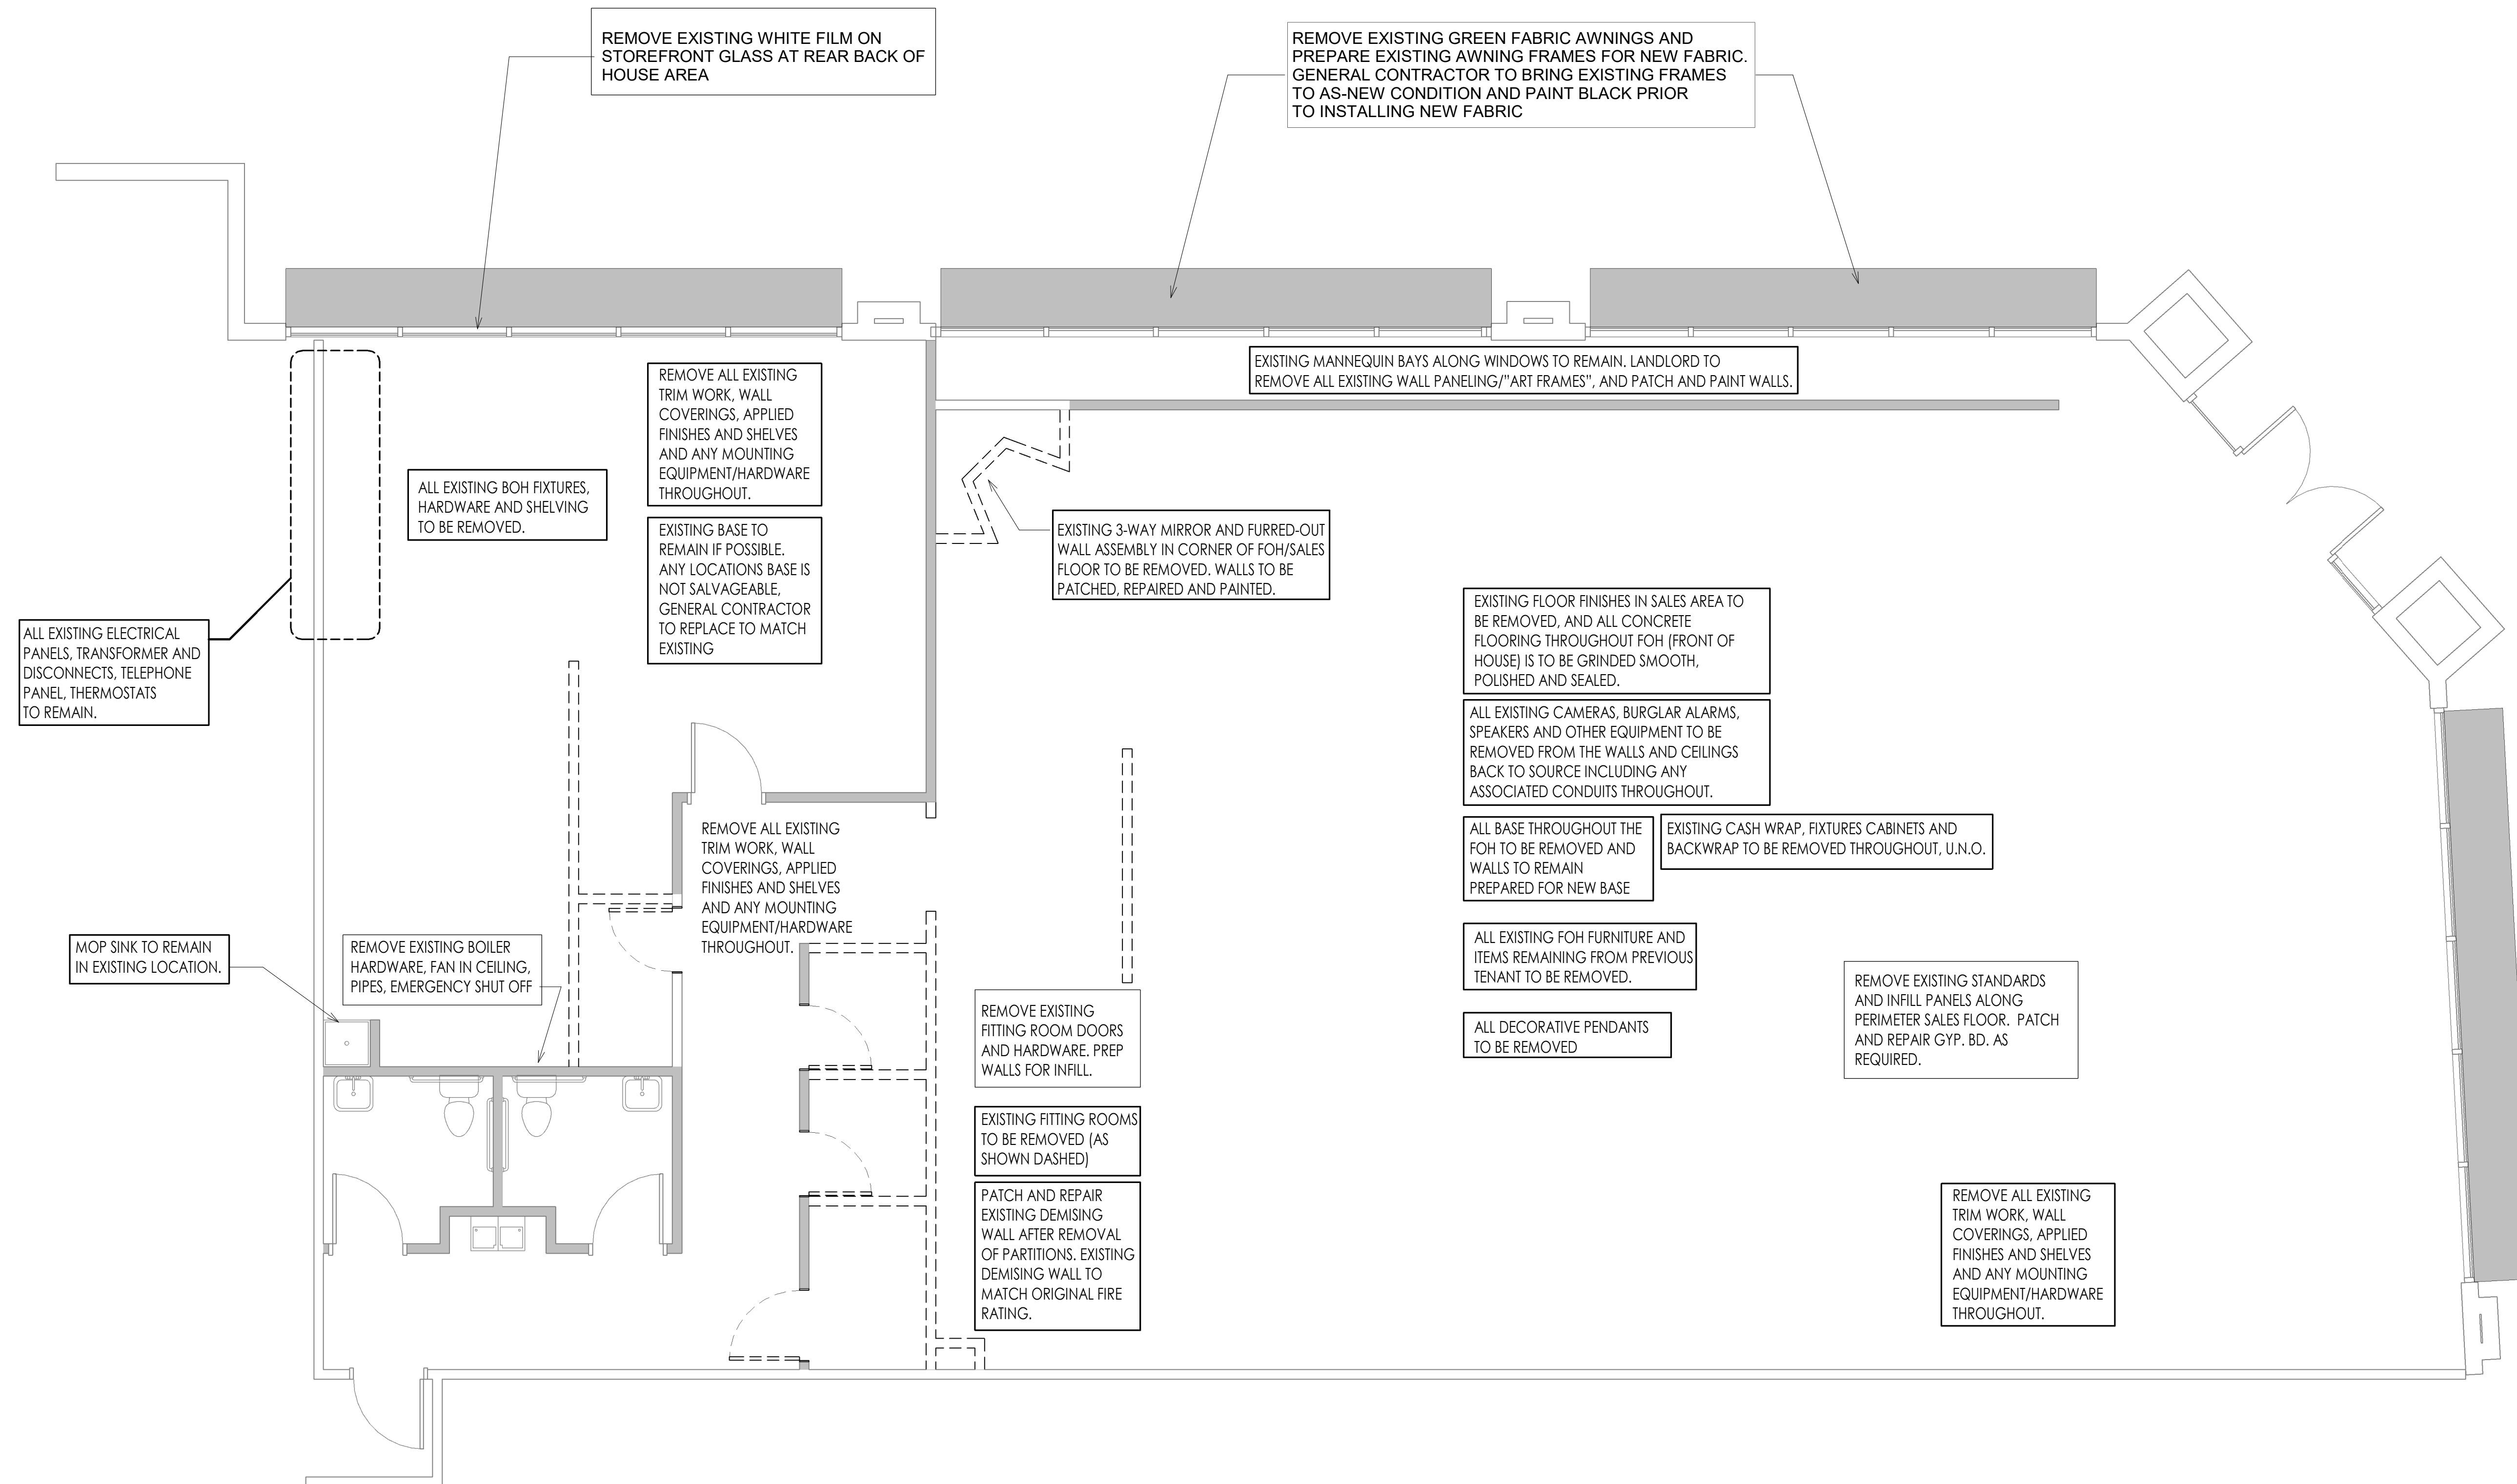

Kloverarchitects
 8813 PENROSE LANE, SUITE 400 • LENEXA, KS 66219
 PH: 913.649.8181 • FX: 913.649.1275 • www.klover.net

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project title

**RED DEVELOPMENT
 SUMMIT FAIR
 910 G NW Blue Pkwy
 Lee's Summit, MO 64086**

project number

23036.001

drawing issuance

ISSUED FOR PERMIT

06/14/23

drawing revisions

No. Description:

Date:

professional seal



Date Signed

JUN 15 2023

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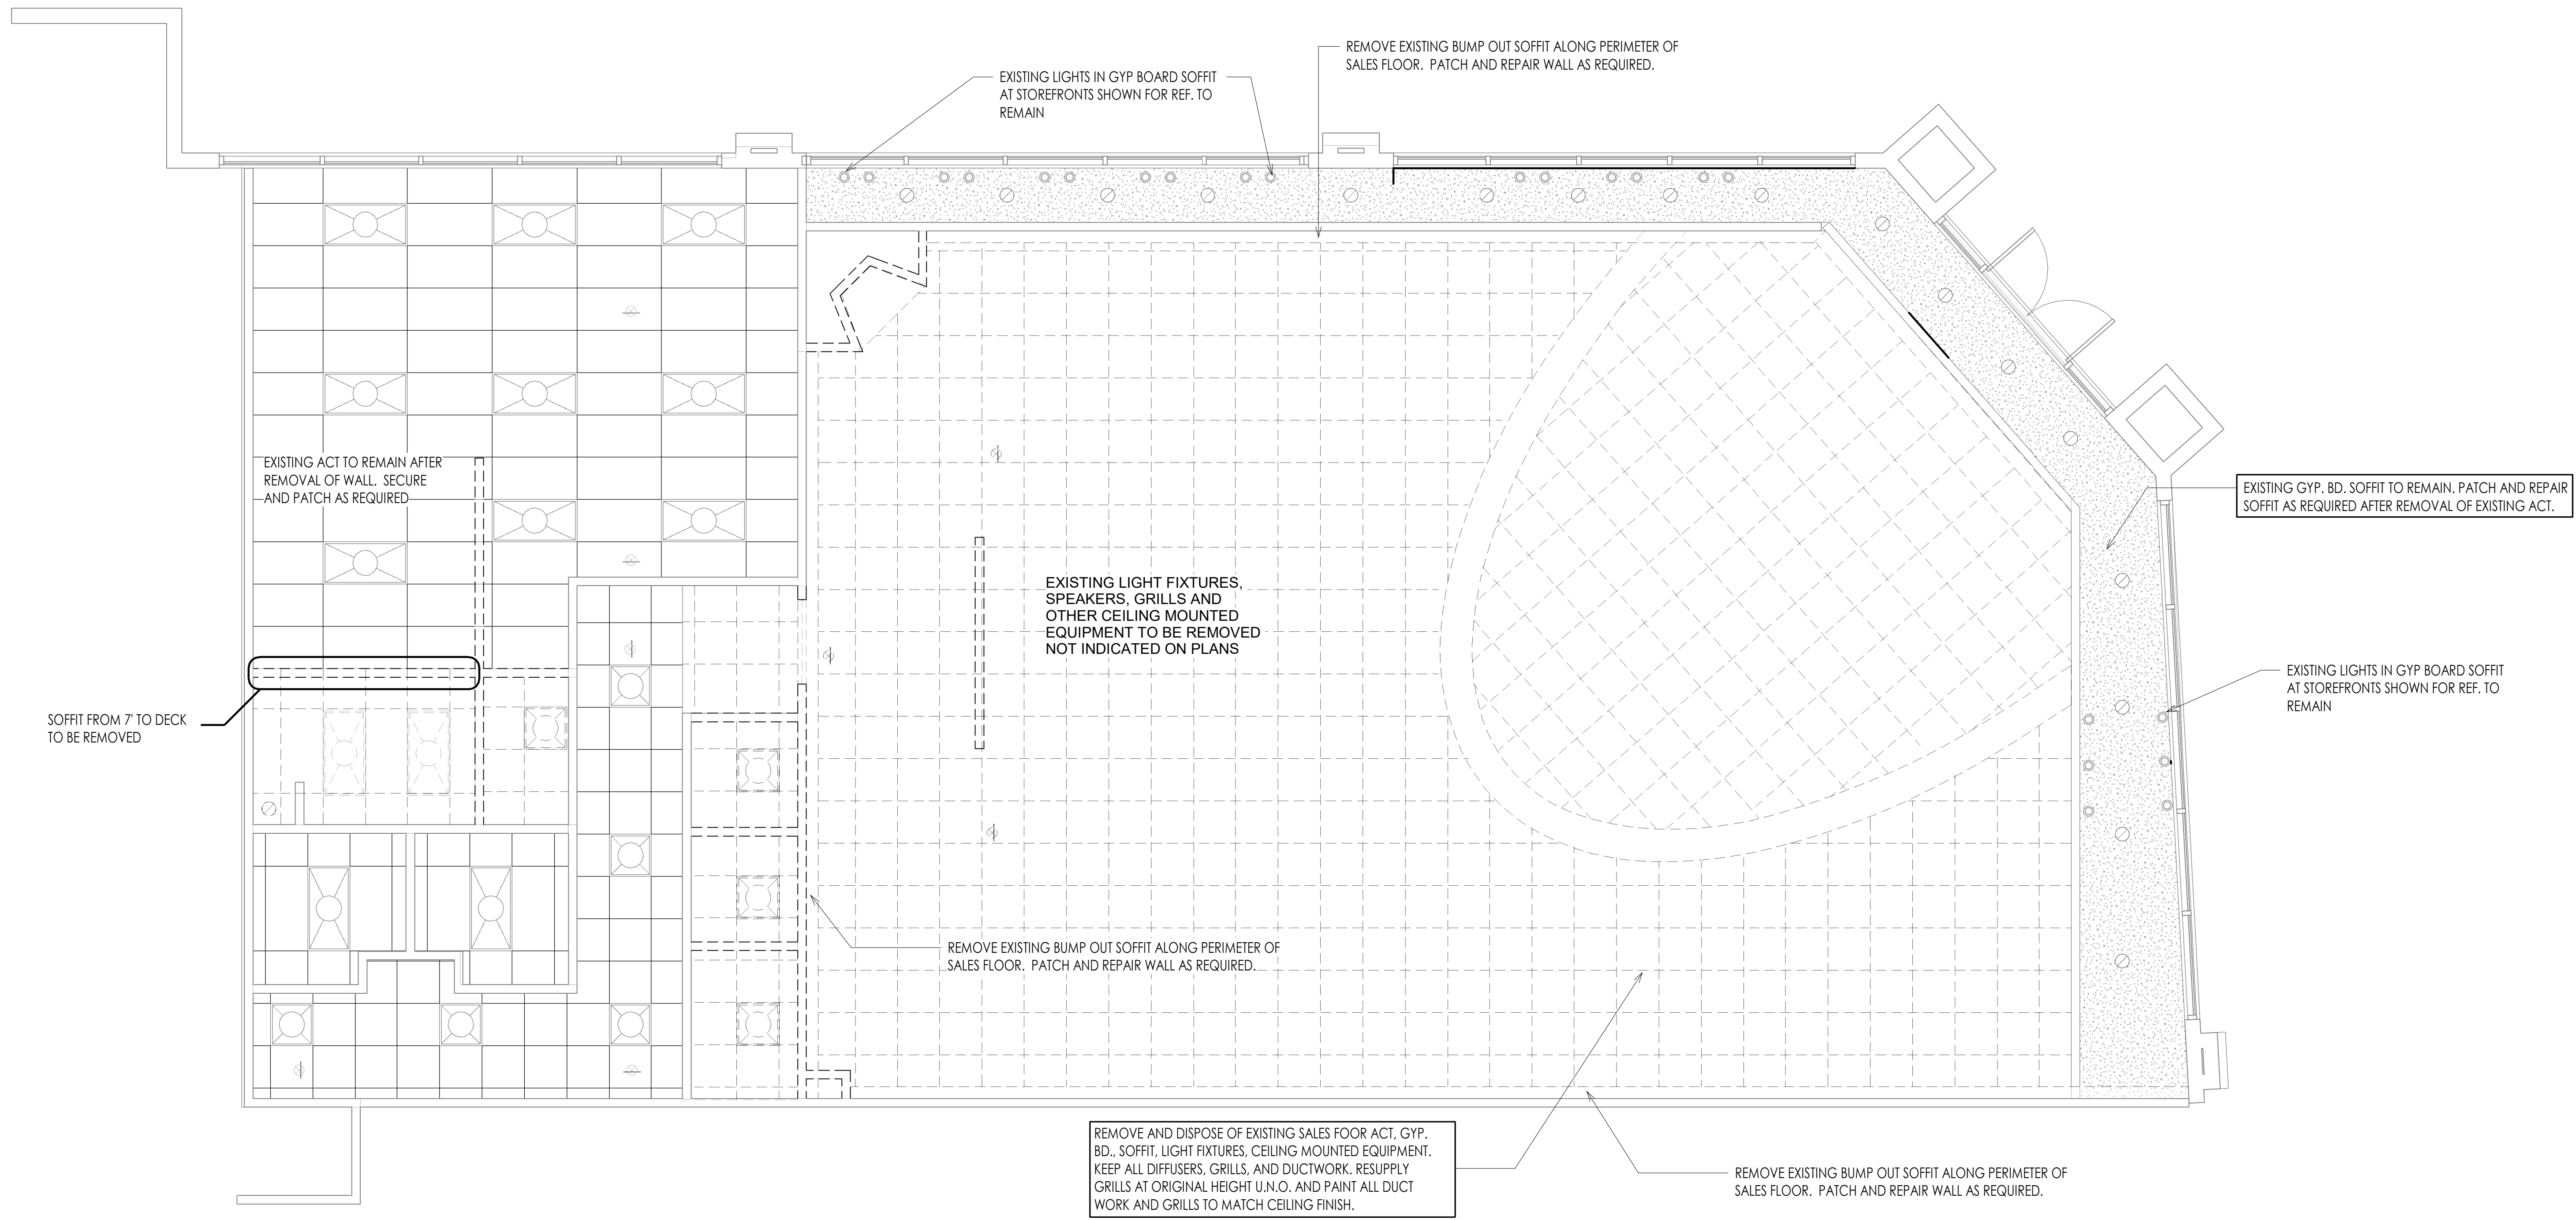
drawing title

DEMO PLAN

drawing number

D100

DEMO PLAN 1
 SCALE: 1/4" = 1'-0"



EXISTING LIGHTS IN GYP BOARD SOFFIT AT STOREFRONTS SHOWN FOR REF. TO REMAIN

REMOVE EXISTING BUMP OUT SOFFIT ALONG PERIMETER OF SALES FLOOR. PATCH AND REPAIR WALL AS REQUIRED.

EXISTING ACT TO REMAIN AFTER REMOVAL OF WALL. SECURE AND PATCH AS REQUIRED.

SOFFIT FROM 7' TO DECK TO BE REMOVED

EXISTING LIGHT FIXTURES, SPEAKERS, GRILLS AND OTHER CEILING MOUNTED EQUIPMENT TO BE REMOVED NOT INDICATED ON PLANS

EXISTING GYP. BD. SOFFIT TO REMAIN. PATCH AND REPAIR SOFFIT AS REQUIRED AFTER REMOVAL OF EXISTING ACT.

EXISTING LIGHTS IN GYP BOARD SOFFIT AT STOREFRONTS SHOWN FOR REF. TO REMAIN

REMOVE EXISTING BUMP OUT SOFFIT ALONG PERIMETER OF SALES FLOOR. PATCH AND REPAIR WALL AS REQUIRED.

REMOVE AND DISPOSE OF EXISTING SALES FLOOR ACT, GYP. BD., SOFFIT, LIGHT FIXTURES, CEILING MOUNTED EQUIPMENT. KEEP ALL DIFFUSERS, GRILLS, AND DUCTWORK. RESUPPLY GRILLS AT ORIGINAL HEIGHT U.N.O. AND PAINT ALL DUCT WORK AND GRILLS TO MATCH CEILING FINISH.

REMOVE EXISTING BUMP OUT SOFFIT ALONG PERIMETER OF SALES FLOOR. PATCH AND REPAIR WALL AS REQUIRED.

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project number
 23036.001
 drawing issuance
 ISSUED FOR PERMIT 06/14/23
 drawing revisions
 No. Description: Date:



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drawing title
 DEMO REFLECTED CEILING PLAN


drawing number
D101

DEMO RCP 1
 SCALE: 1/4" = 1'-0"

FINISH SCHEDULE

AREA	LOCATION	MANUFACTURER	MODEL / LINE	COLOR	FINISH / SIZE	NOTES
FRONT OF HOUSE (SALES)	BASEBOARDS	TARKETT	JOHNSONITE	50 WHITE	MANDALAY 4 1/2"	OR SIMILAR
	WALLS	BENJAMIN MOORE		OC-53 HORIZON	EGGSHELL	
	OPEN CEILINGS	BENJAMIN MOORE		HC-179 PLATINUM GRAY	ULTRA FLAT (508)	DECKS 14' AFF OR LESS
	SOFFIT	BENJAMIN MOORE		OC-65 CHANTILLY LACE, ULTRA FLAT		14' H SOFFIT ALONG STOREFRONT
	DOORS/CASINGS/TRIMS	BENJAMIN MOORE	SCUFF X	HC-166 KENDALL CHARCOAL	SATIN (486)	
BACK OF HOUSE / CORRIDOR	FITTING ROOM WALLS	BENJAMIN MOORE	ULTRA SPEC SCUFF X	OC-53 HORIZON	MATTE (484)	
	WALLS	BENJAMIN MOORE	ULTRA SPEC SCUFF X	HC STONINGTON GRAY	SATIN (486)	
	CEILINGS	BENJAMIN MOORE		OC-65 CHANTILLY LACE	ULTRA FLAT	ALL EXST. DRYWALL /ACT CEILINGS
	DOORS/CASINGS/TRIMS	BENJAMIN MOORE	SCUFF X	HC-166 KENDALL CHARCOAL	SATIN (486)	
	BASEBOARDS	TARKETT	JOHNSONITE	40 BLACK	MANDALAY 4 1/2"	
MANAGER'S OFFICE	WALLS	BENJAMIN MOORE	ULTRA SPEC SCUFF X	HC STONINGTON GRAY	SATIN	
	CEILINGS	BENJAMIN MOORE		OC-65 CHANTILLY LACE	ULTRA FLAT	ALL EXST. DRYWALL /ACT CEILINGS
	DOORS/CASINGS/TRIMS	BENJAMIN MOORE	SCUFF X	HC-166 KENDALL CHARCOAL	SATIN (486)	
	BASEBOARDS	TARKETT	JOHNSONITE	40 BLACK	MANDALAY 4 1/2"	
	WALLS	BENJAMIN MOORE	ULTRA SPEC SCUFF X	HC STONINGTON GRAY	SATIN (486)	
KITCHENETTE	CEILINGS	BENJAMIN MOORE		OC-65 CHANTILLY LACE	ULTRA FLAT	ALL EXST. DRYWALL /ACT CEILINGS
	DOORS/CASINGS/TRIMS	BENJAMIN MOORE	SCUFF X	HC-166 KENDALL CHARCOAL	SATIN (486)	
	BASEBOARDS	TARKETT	JOHNSONITE	40 BLACK	MANDALAY 4 1/2"	
	WALLS	BENJAMIN MOORE	ULTRA SPEC SCUFF X	HC STONINGTON GRAY	SATIN (486)	
	CEILINGS	BENJAMIN MOORE		OC-65 CHANTILLY LACE	ULTRA FLAT	ALL EXST. DRYWALL /ACT CEILINGS
RESTROOMS	DOORS/CASINGS/TRIMS	BENJAMIN MOORE	SCUFF X	HC-166 KENDALL CHARCOAL	SATIN (486)	
	BASEBOARDS	TARKETT	JOHNSONITE	40 BLACK	MANDALAY 4 1/2"	

ALL PAINT SHALL NOT BE LOW VOC, SHOULD NOT CONTAIN ANY SILICONE, ACRYLIC ADDITIVES, OR ANTI-GRAFFITI/ANTI MOLD/ANTI SCUFF COMPONENTS U.N.O.

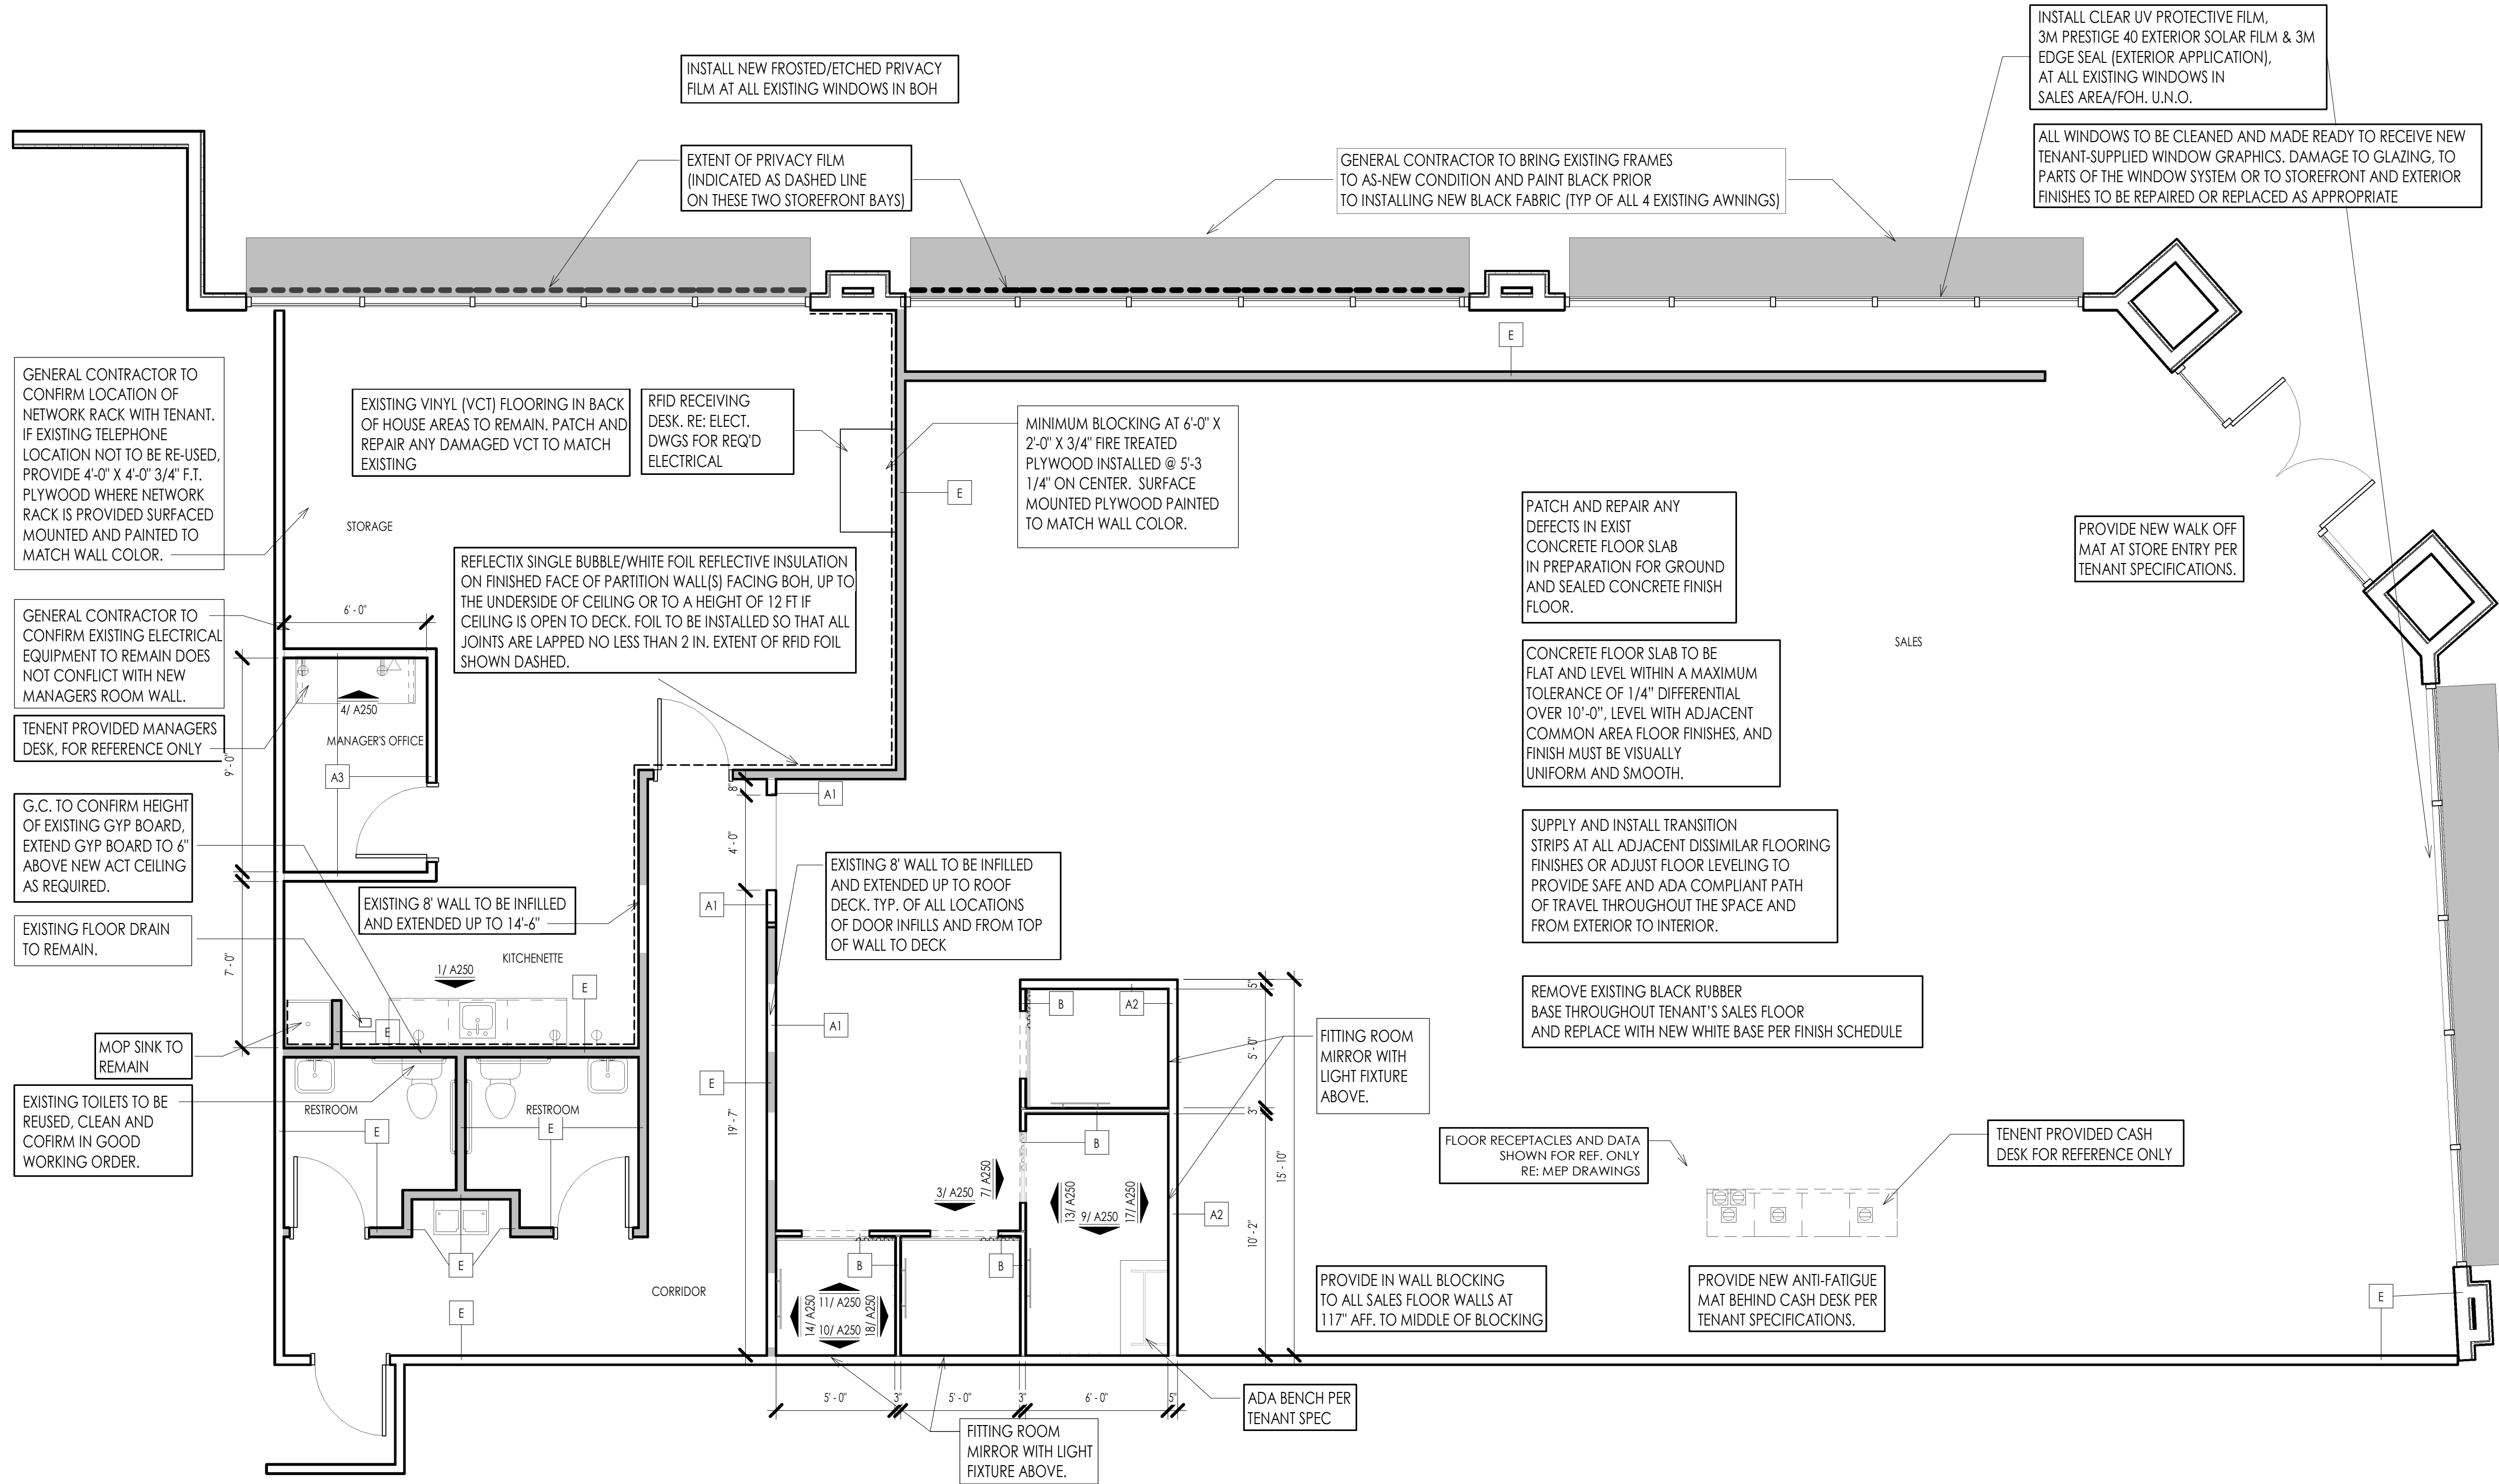

FLOOR PLAN
SCALE: 1/4" = 1'-0"

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project title
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SUMMIT FAIR
910 G NW Blue Pkwy
Lee's Summit, MO 64086


project number
2303A.001
drawing issuance
ISSUED FOR PERMIT 06/14/23
drawing revisions
No. Description: Date:

professional seal
STATE OF MISSOURI
ARCHITECT
JAMES KLOVER
A2302


Date Signed **JUN 15 2023**
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drawing title
FLOOR PLAN

drawing number
A100

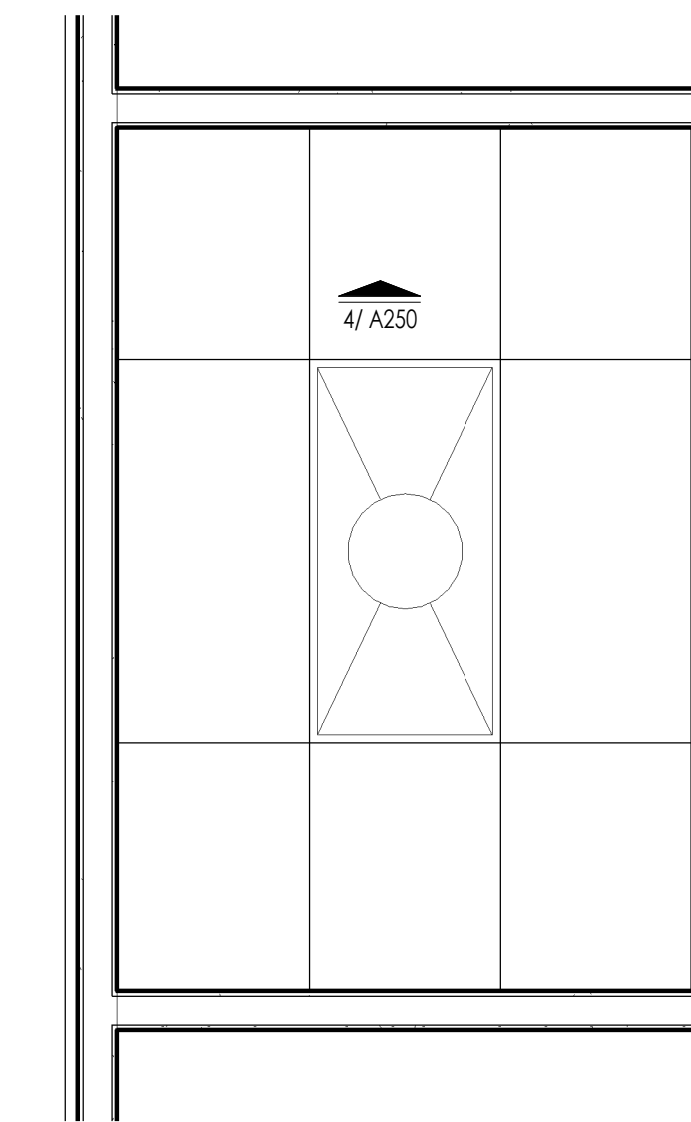

MANAGER'S OFFICE NEW RCP ④
SCALE: 1/2" = 1'-0"

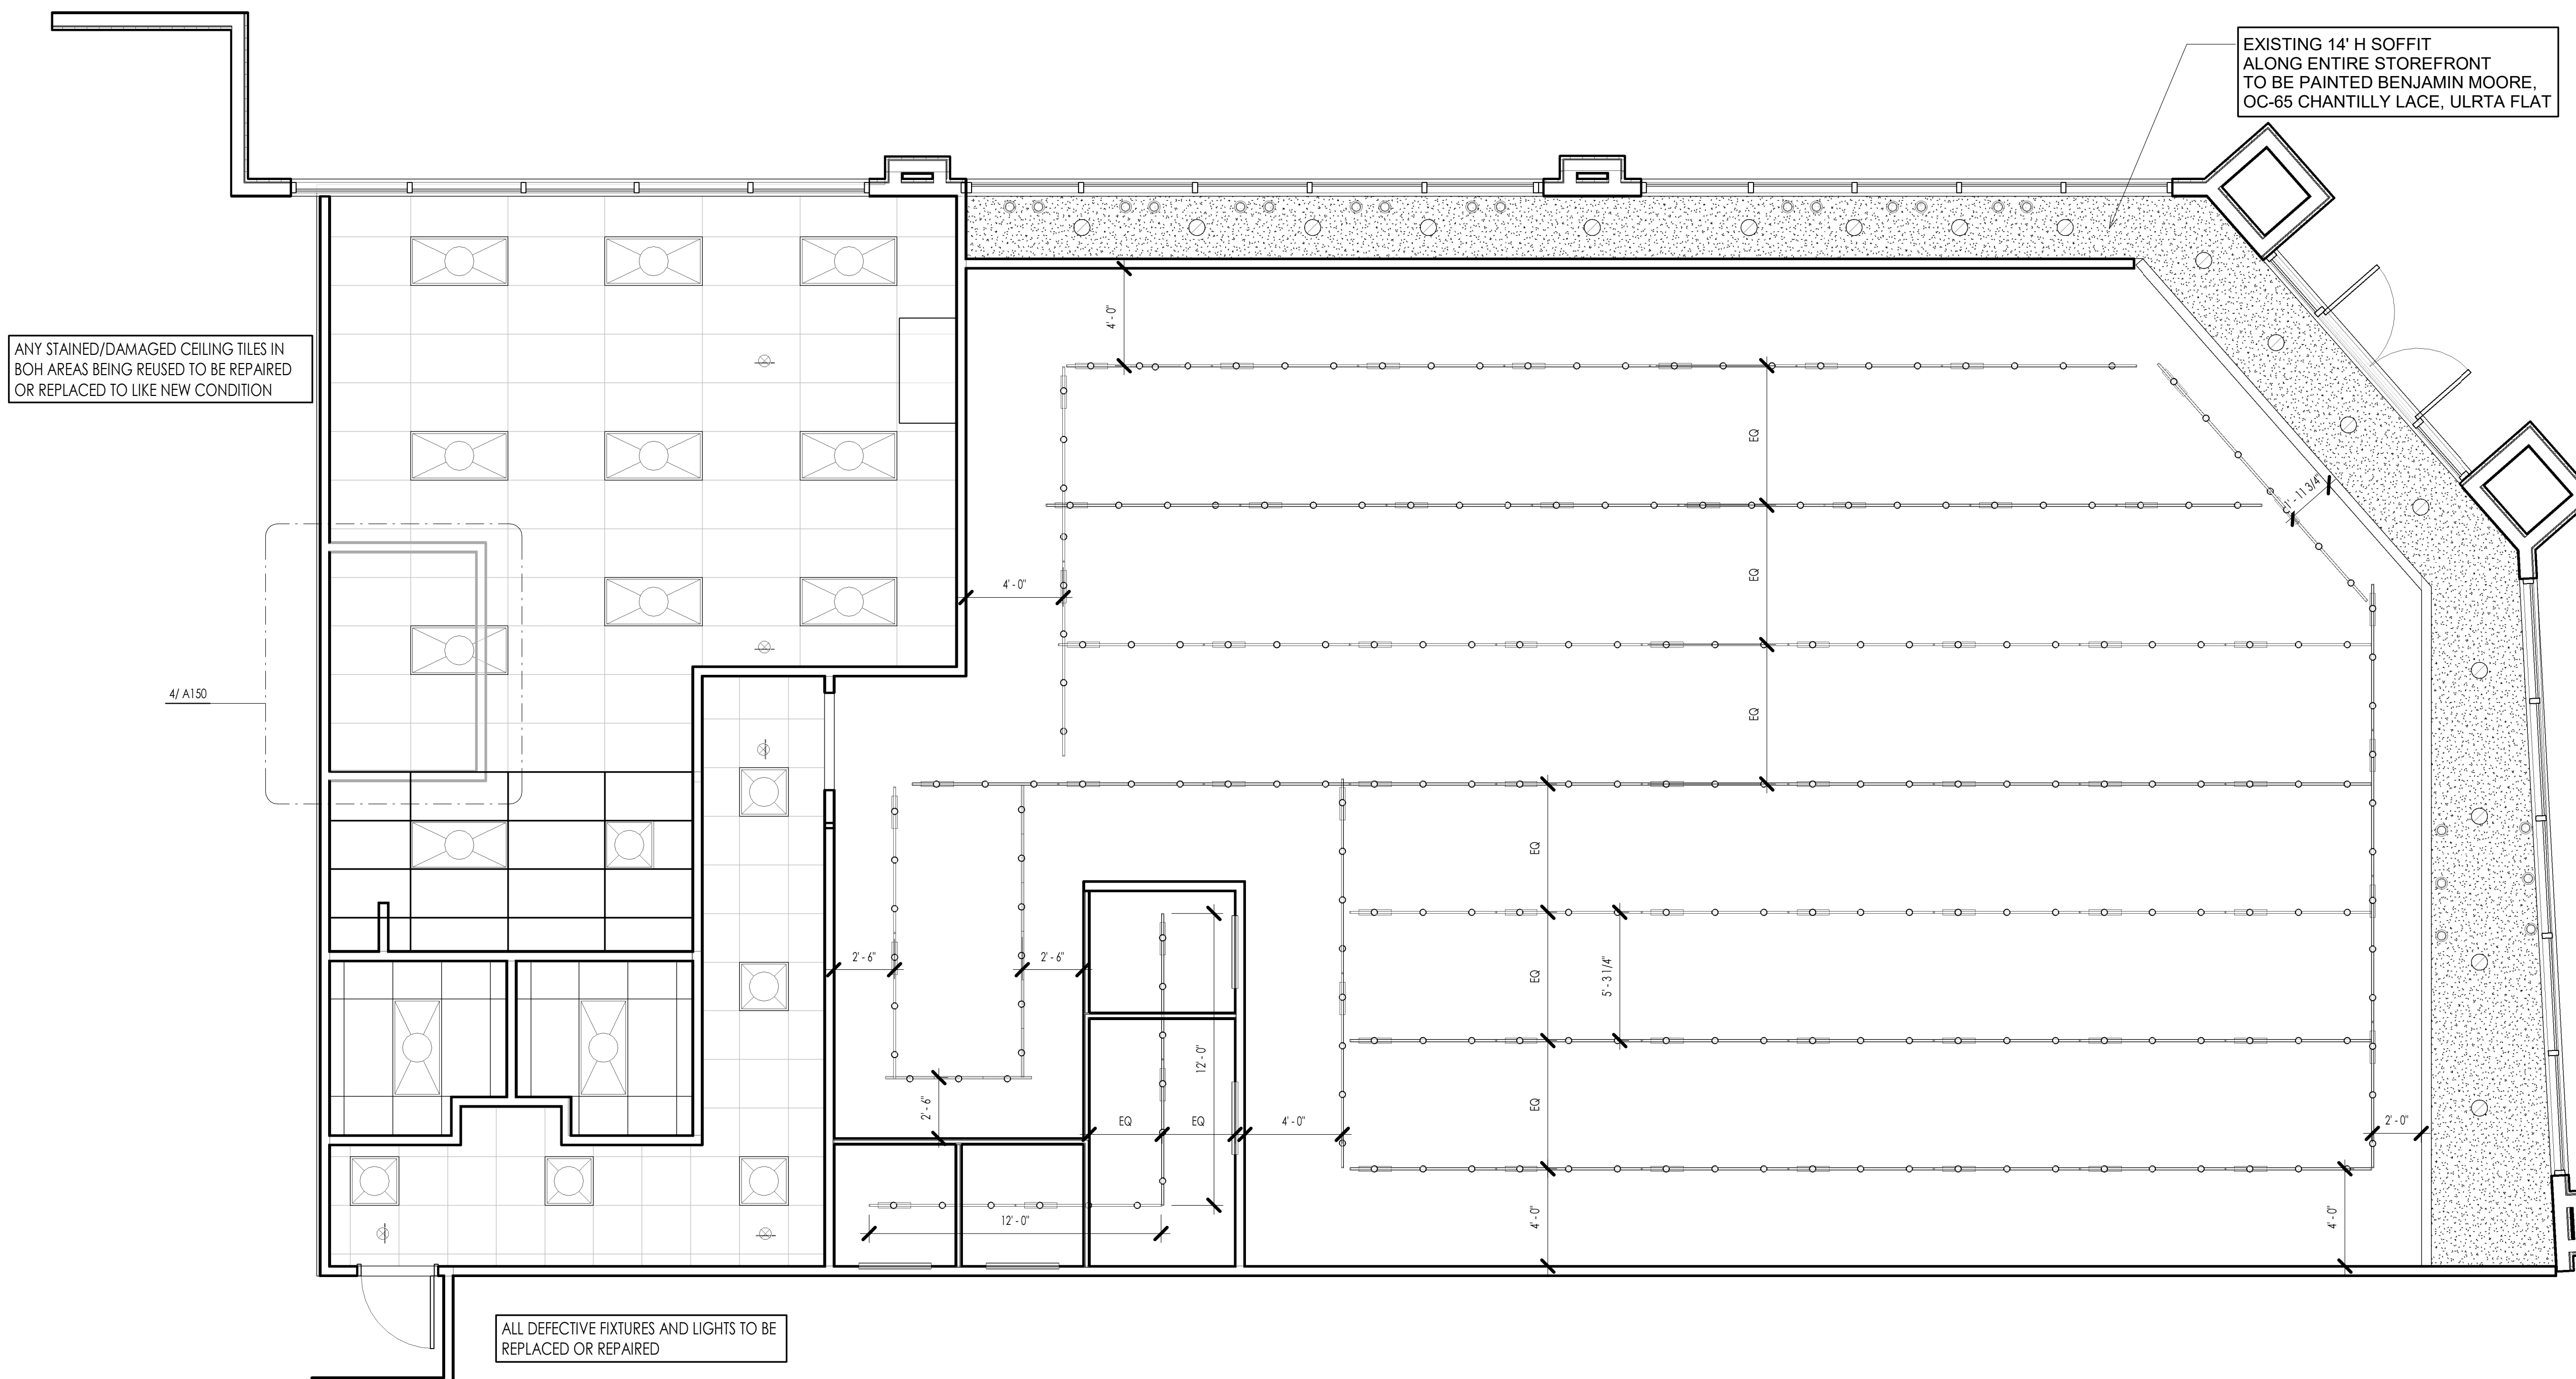

REFLECTED CEILING PLAN ①
SCALE: 1/4" = 1'-0"

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**RED DEVELOPMENT
SUMMIT FAIR
910 G NW Blue Pkwy
Lee's Summit, MO 64086**

project number
28036.001

drawing issuance
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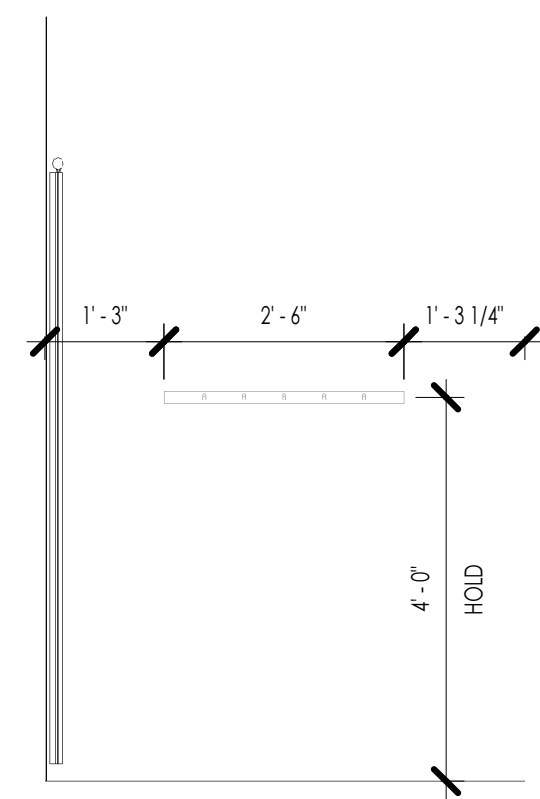
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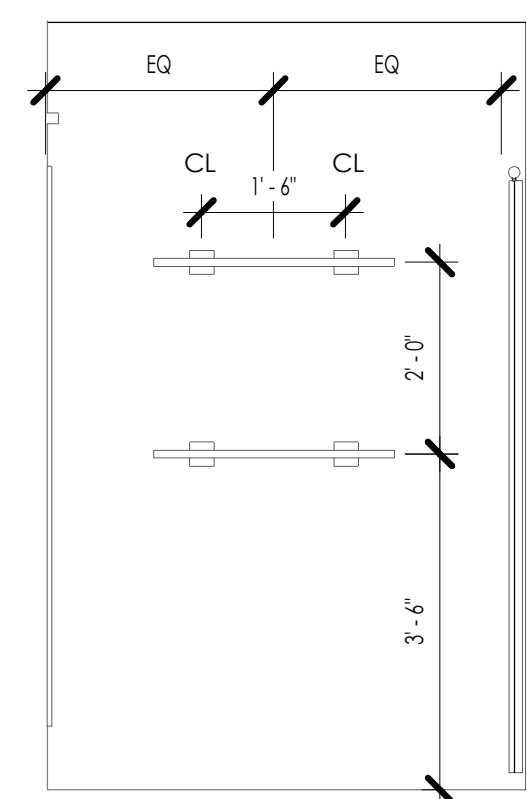
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drawing title
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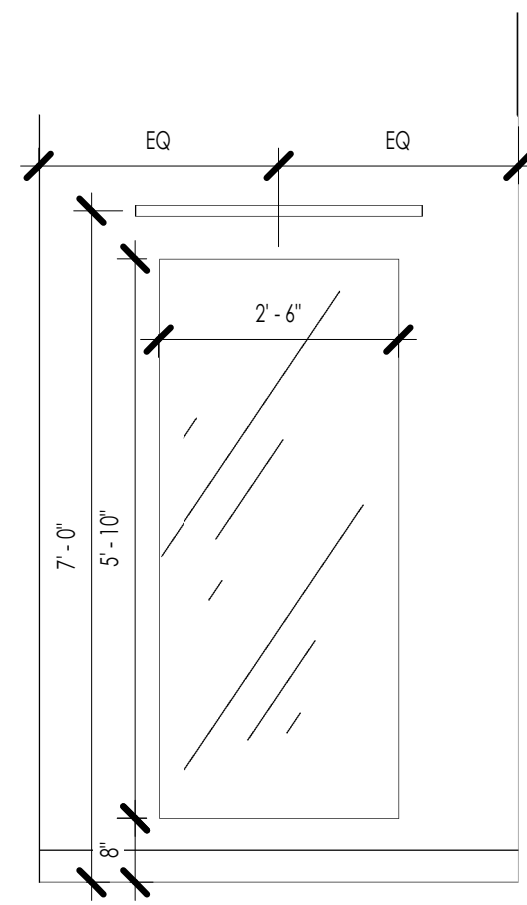
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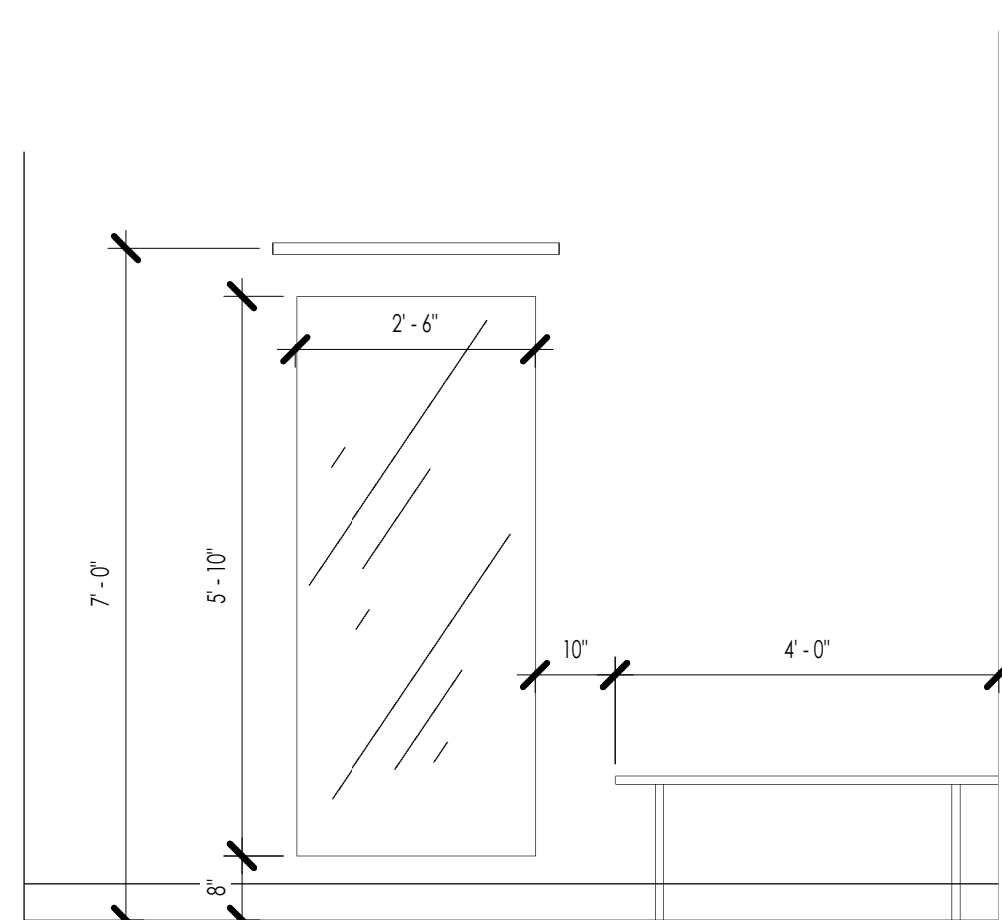
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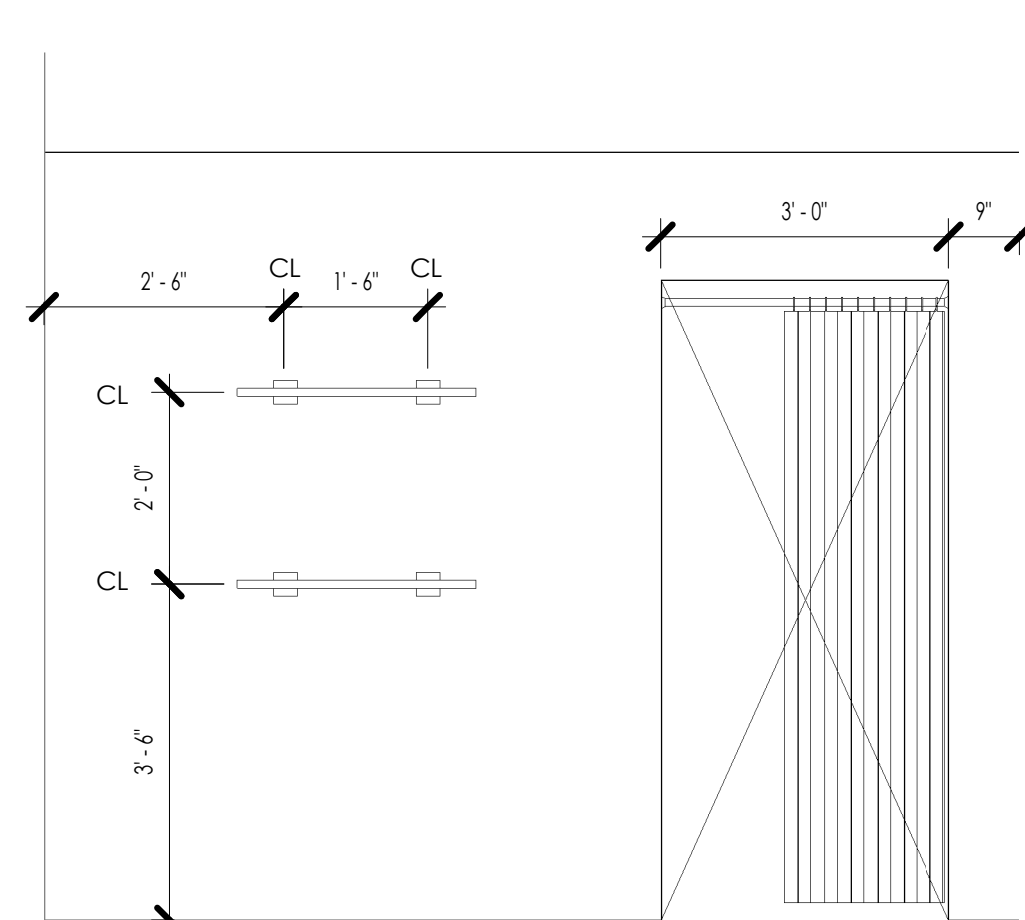
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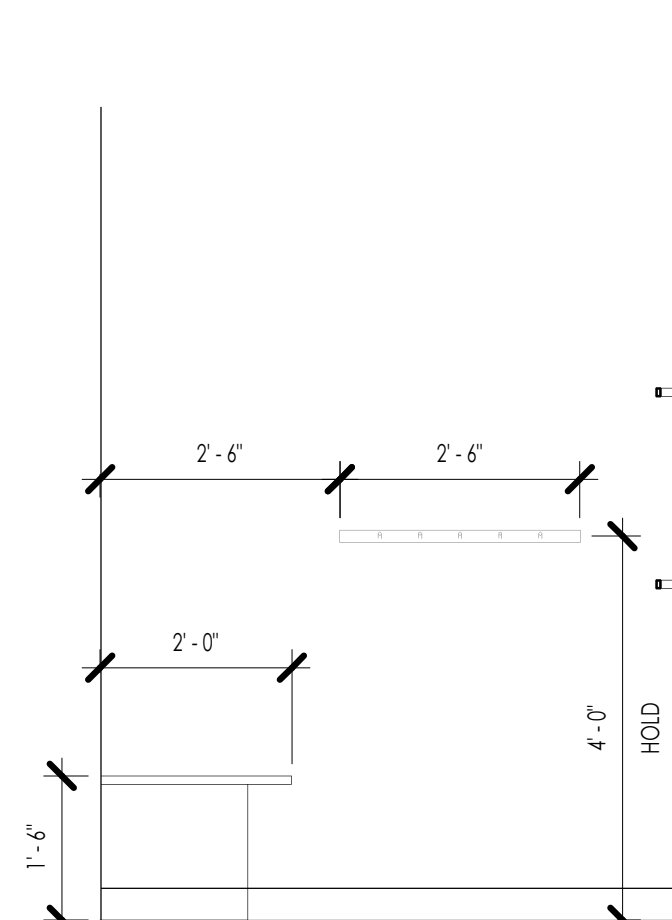
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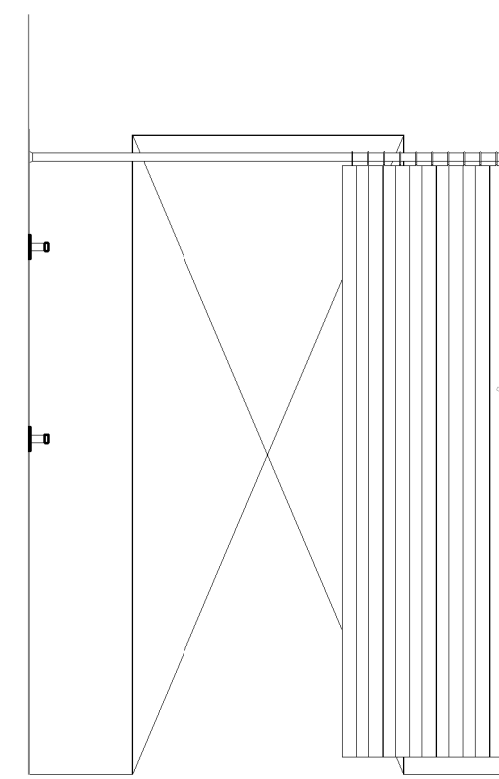
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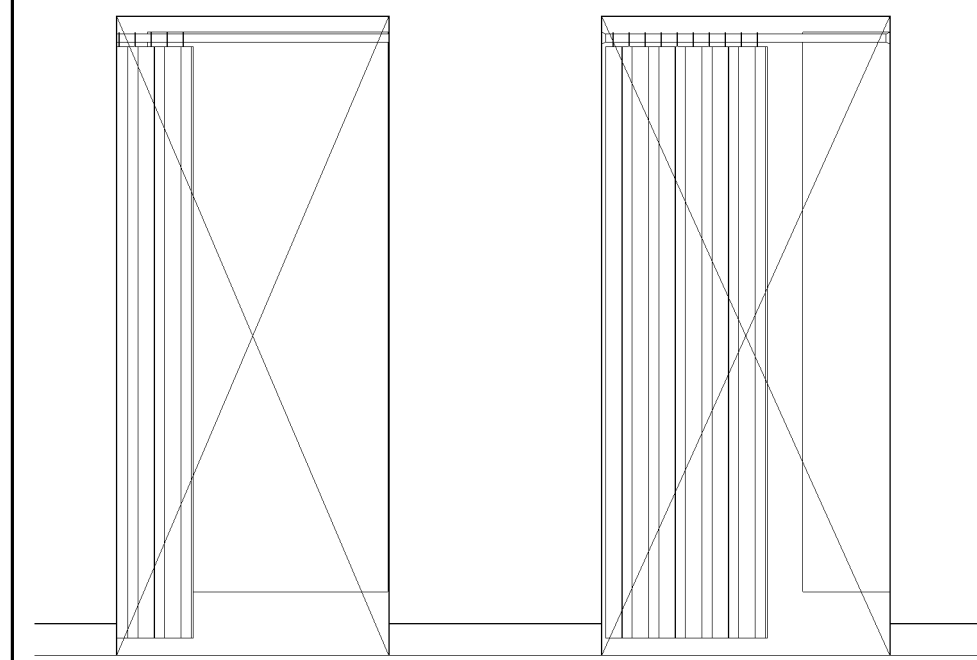
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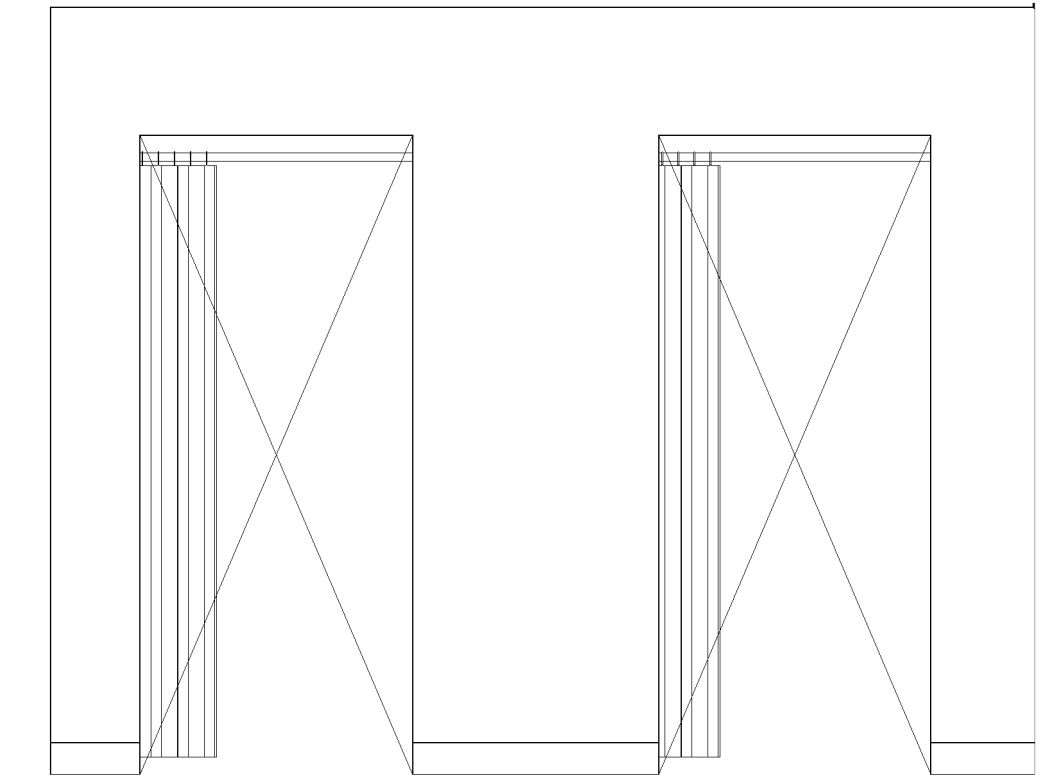
ADA FITTING ROOM SIDE (9)
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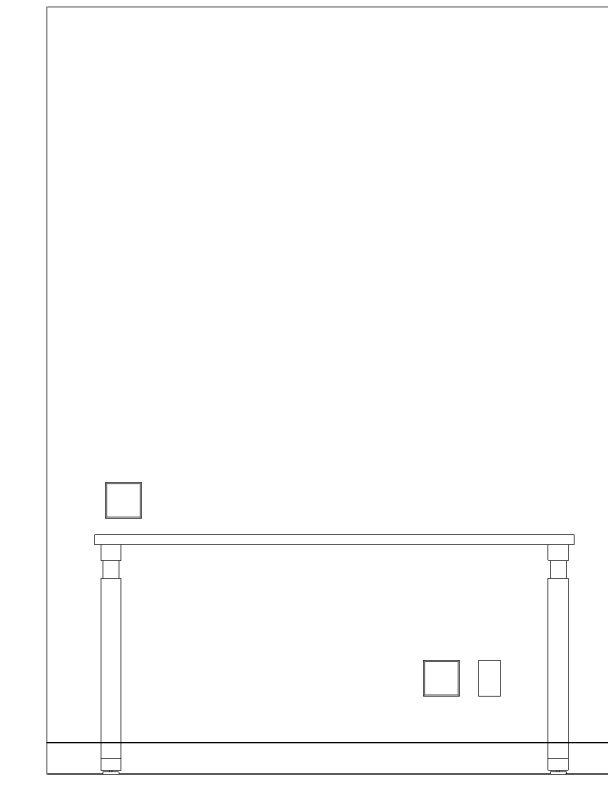
FITTING ROOM FRONT (11)
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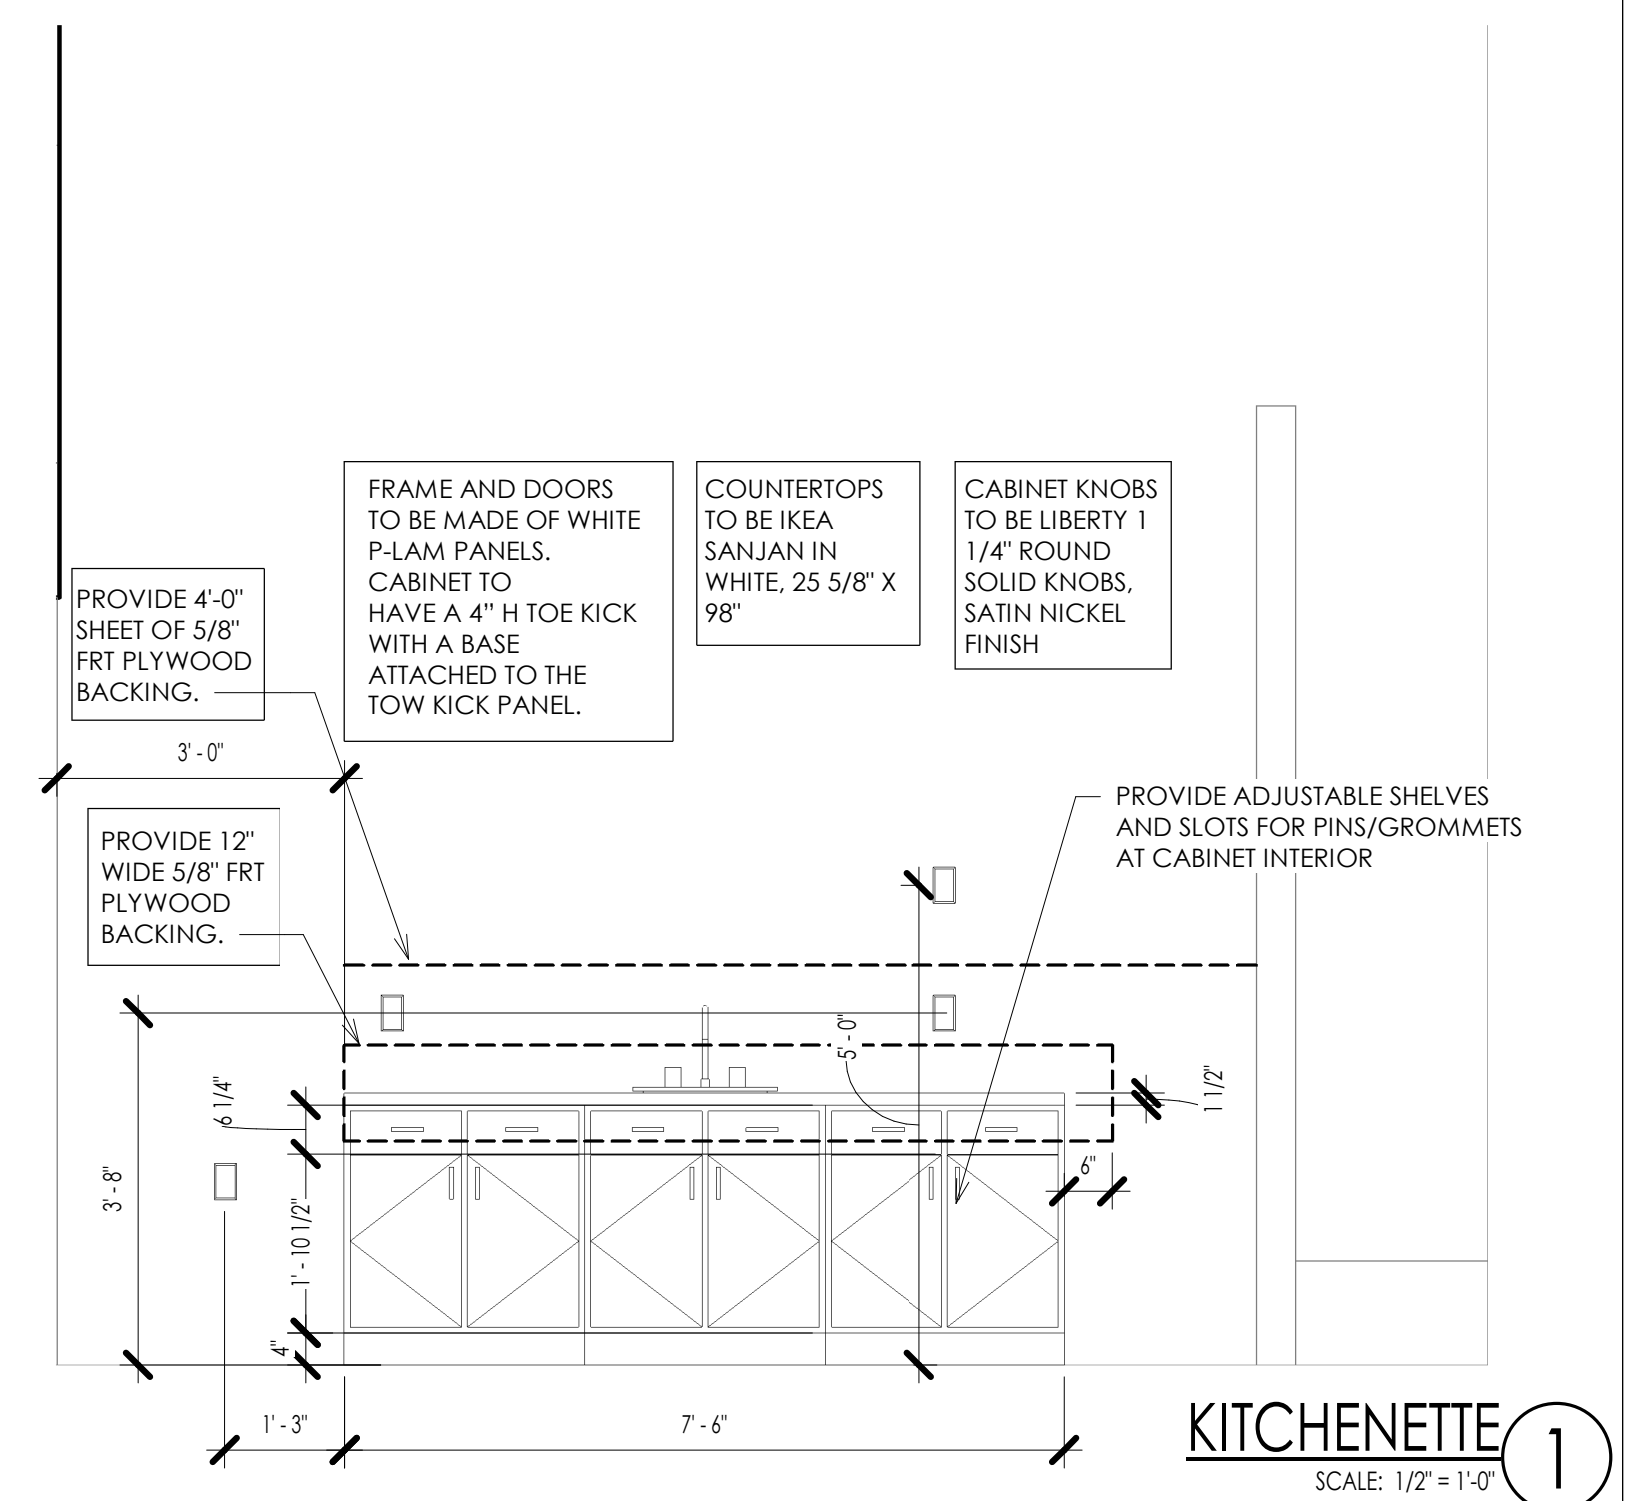
FITTING ROOM EXT. 2 (7)
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FITTING ROOM EXT. 3 (3)
SCALE: 1/2" = 1'-0"



MANAGER'S OFFICE (4)
SCALE: 1/2" = 1'-0"



KITCHENETTE (1)
SCALE: 1/2" = 1'-0"

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project title

RED DEVELOPMENT
SUMMIT FAIR
910 G NW Blue Pkwy
Lee's Summit, MO 64086

project number

2303A.001

drawing issuance

ISSUED FOR PERMIT

06/14/23

drawing revisions

No. Description Date:

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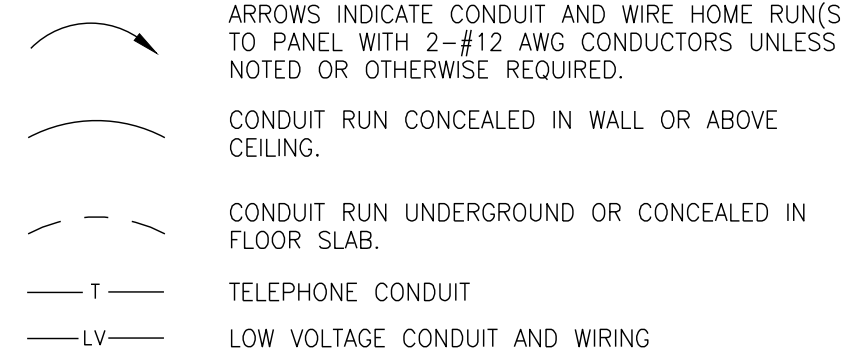
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INTERIOR ELEVATIONS


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A250

CONDUIT AND WIRE



LIGHTING

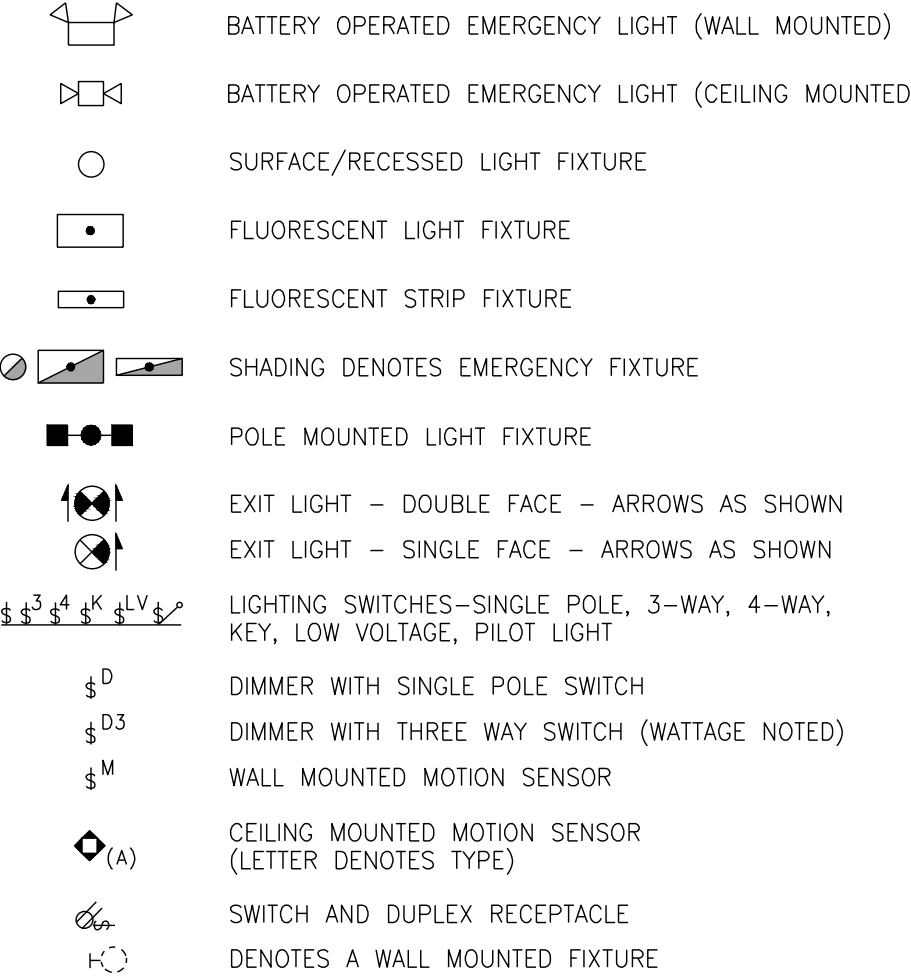

WIRING DEVICES



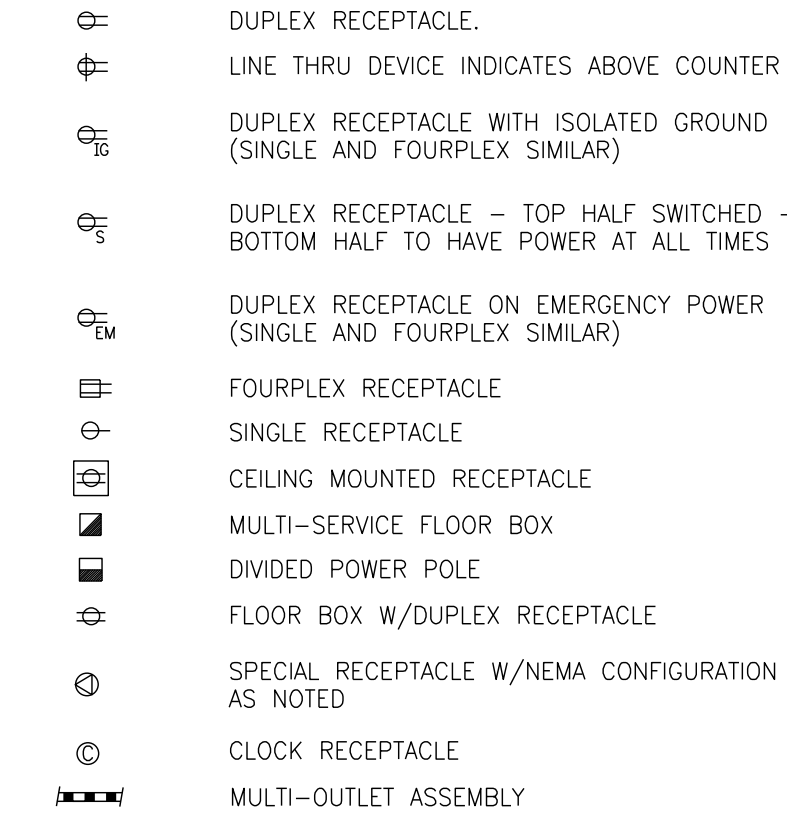


Table of abbreviations for mechanical and electrical systems, including air conditioning, ductwork, heating, ventilation, and plumbing components.


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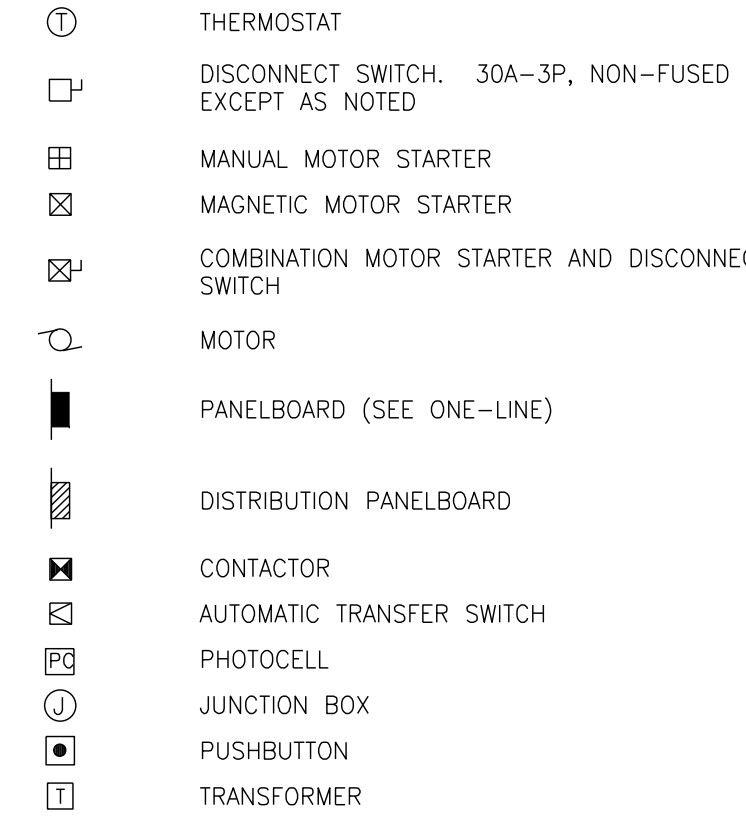
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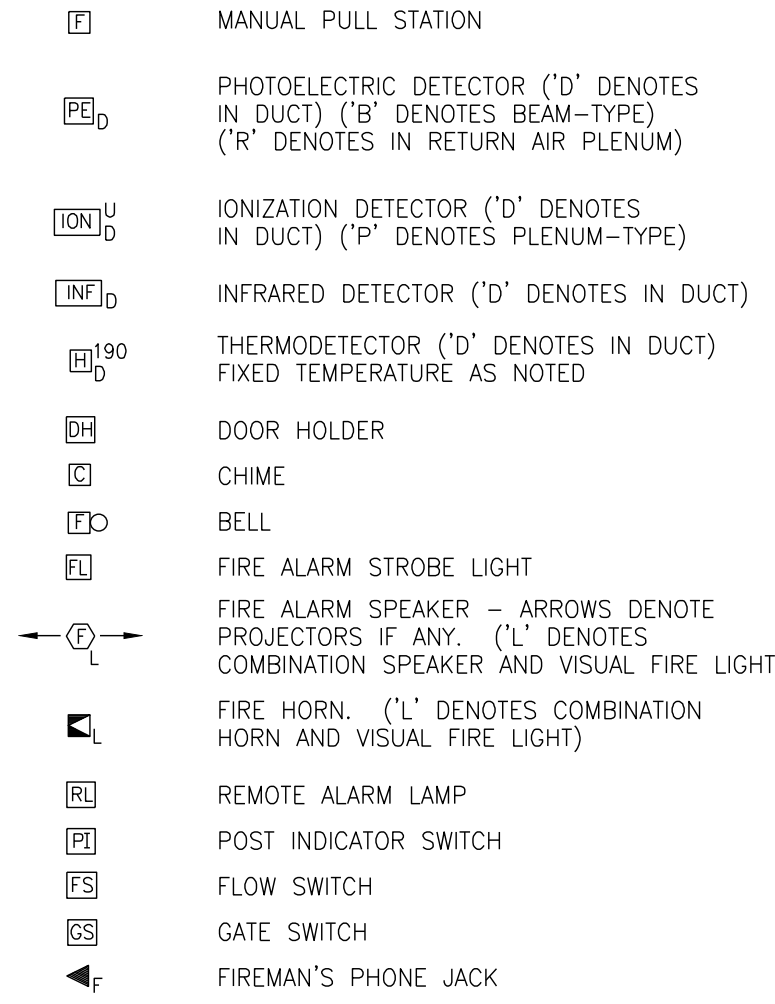
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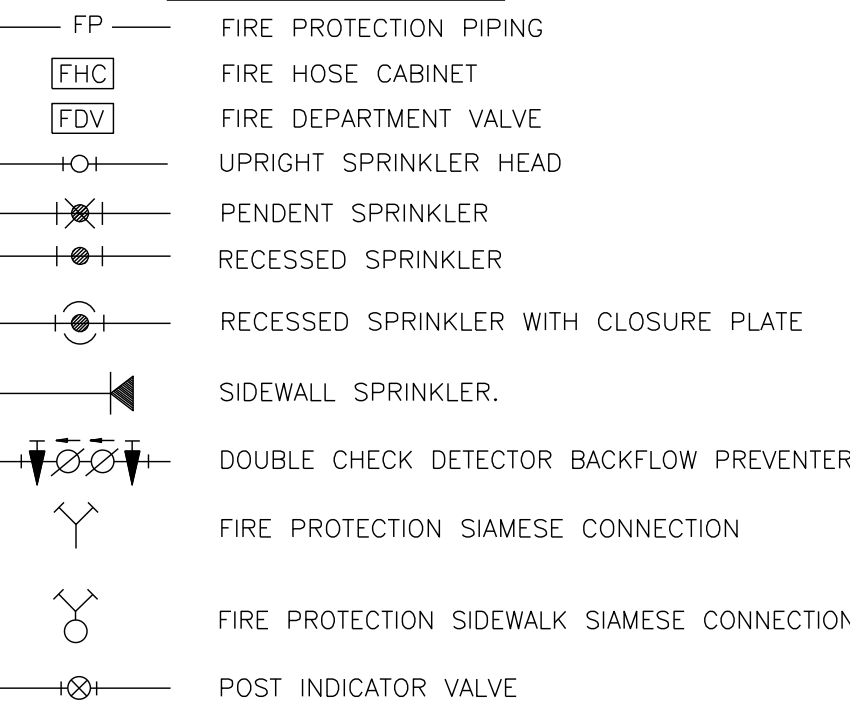
POWER DEVICE AND CONTROLS

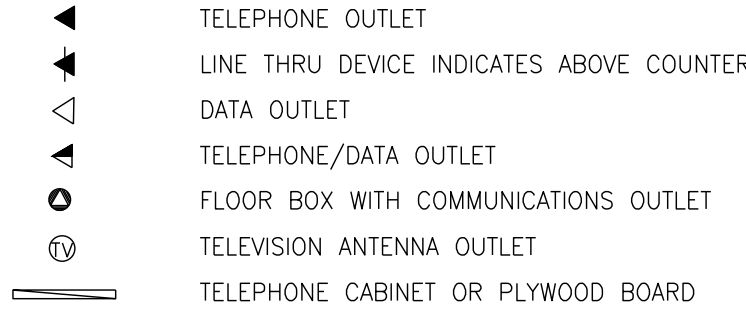


FIRE ALARM

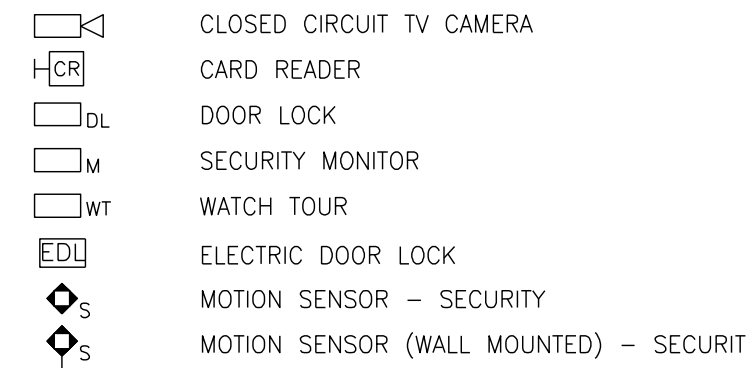


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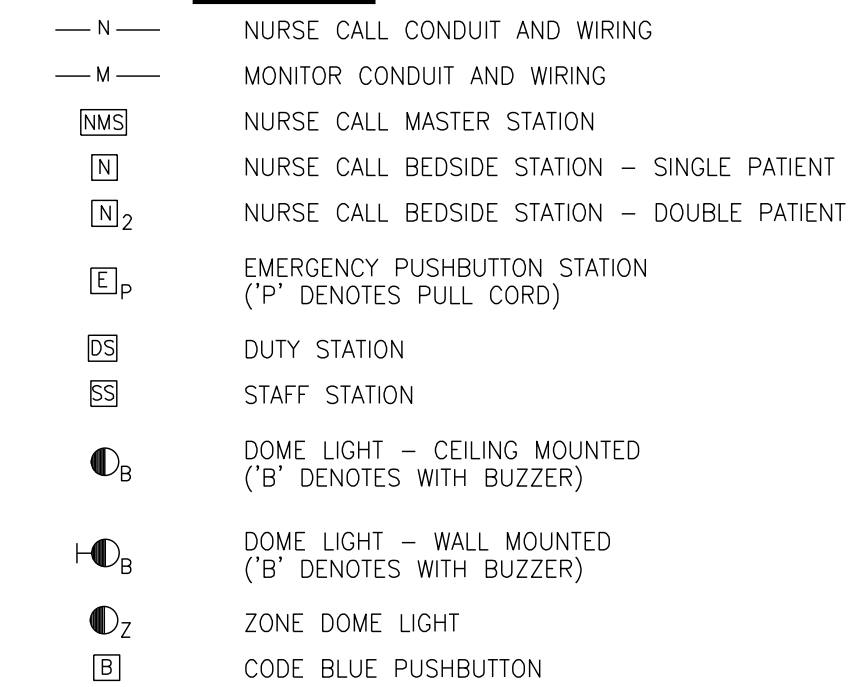
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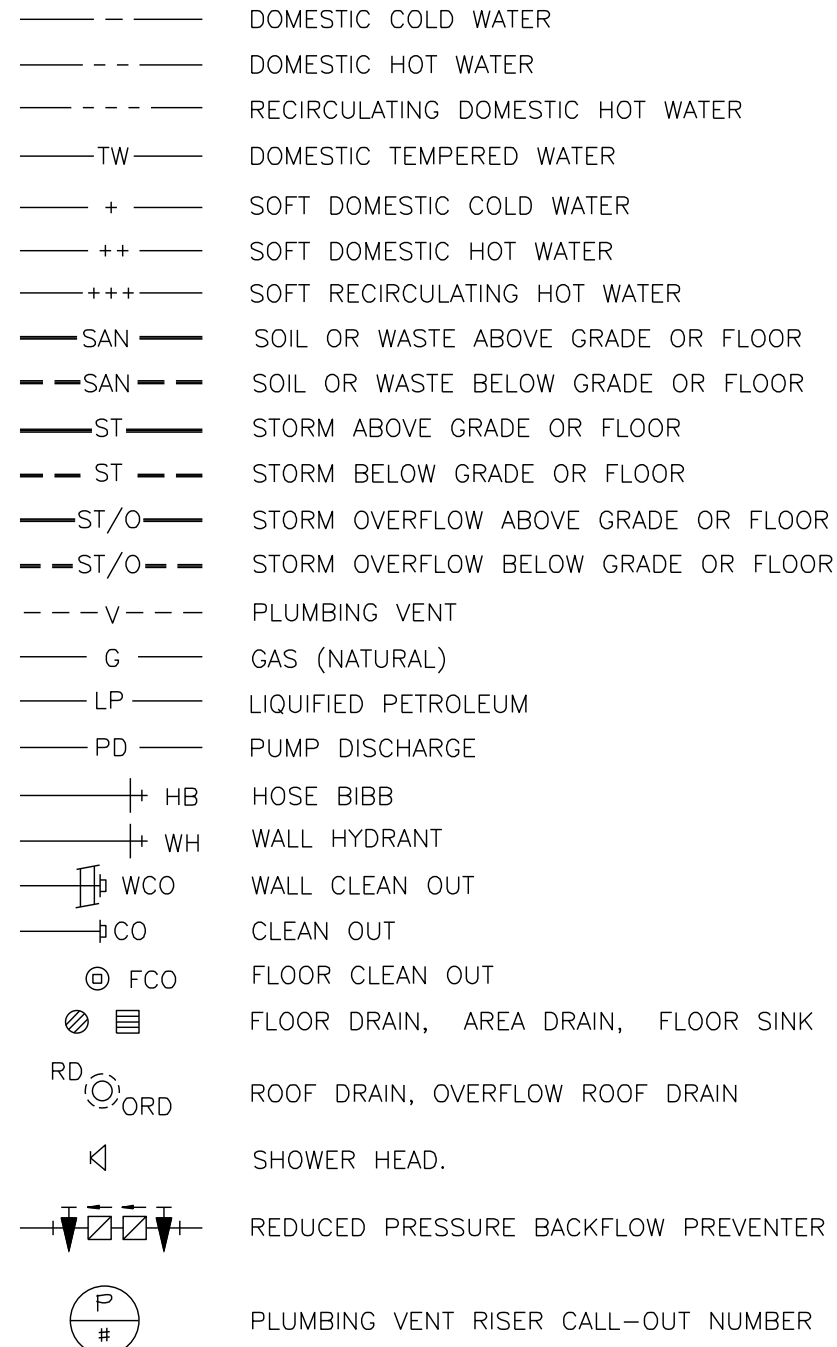
HVAC

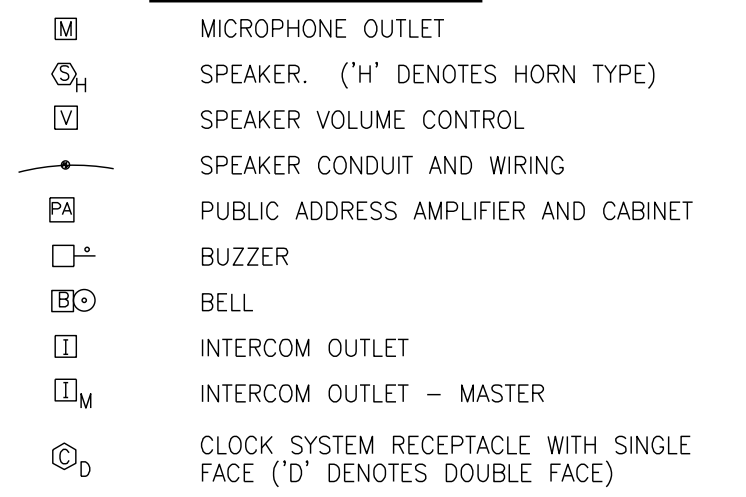


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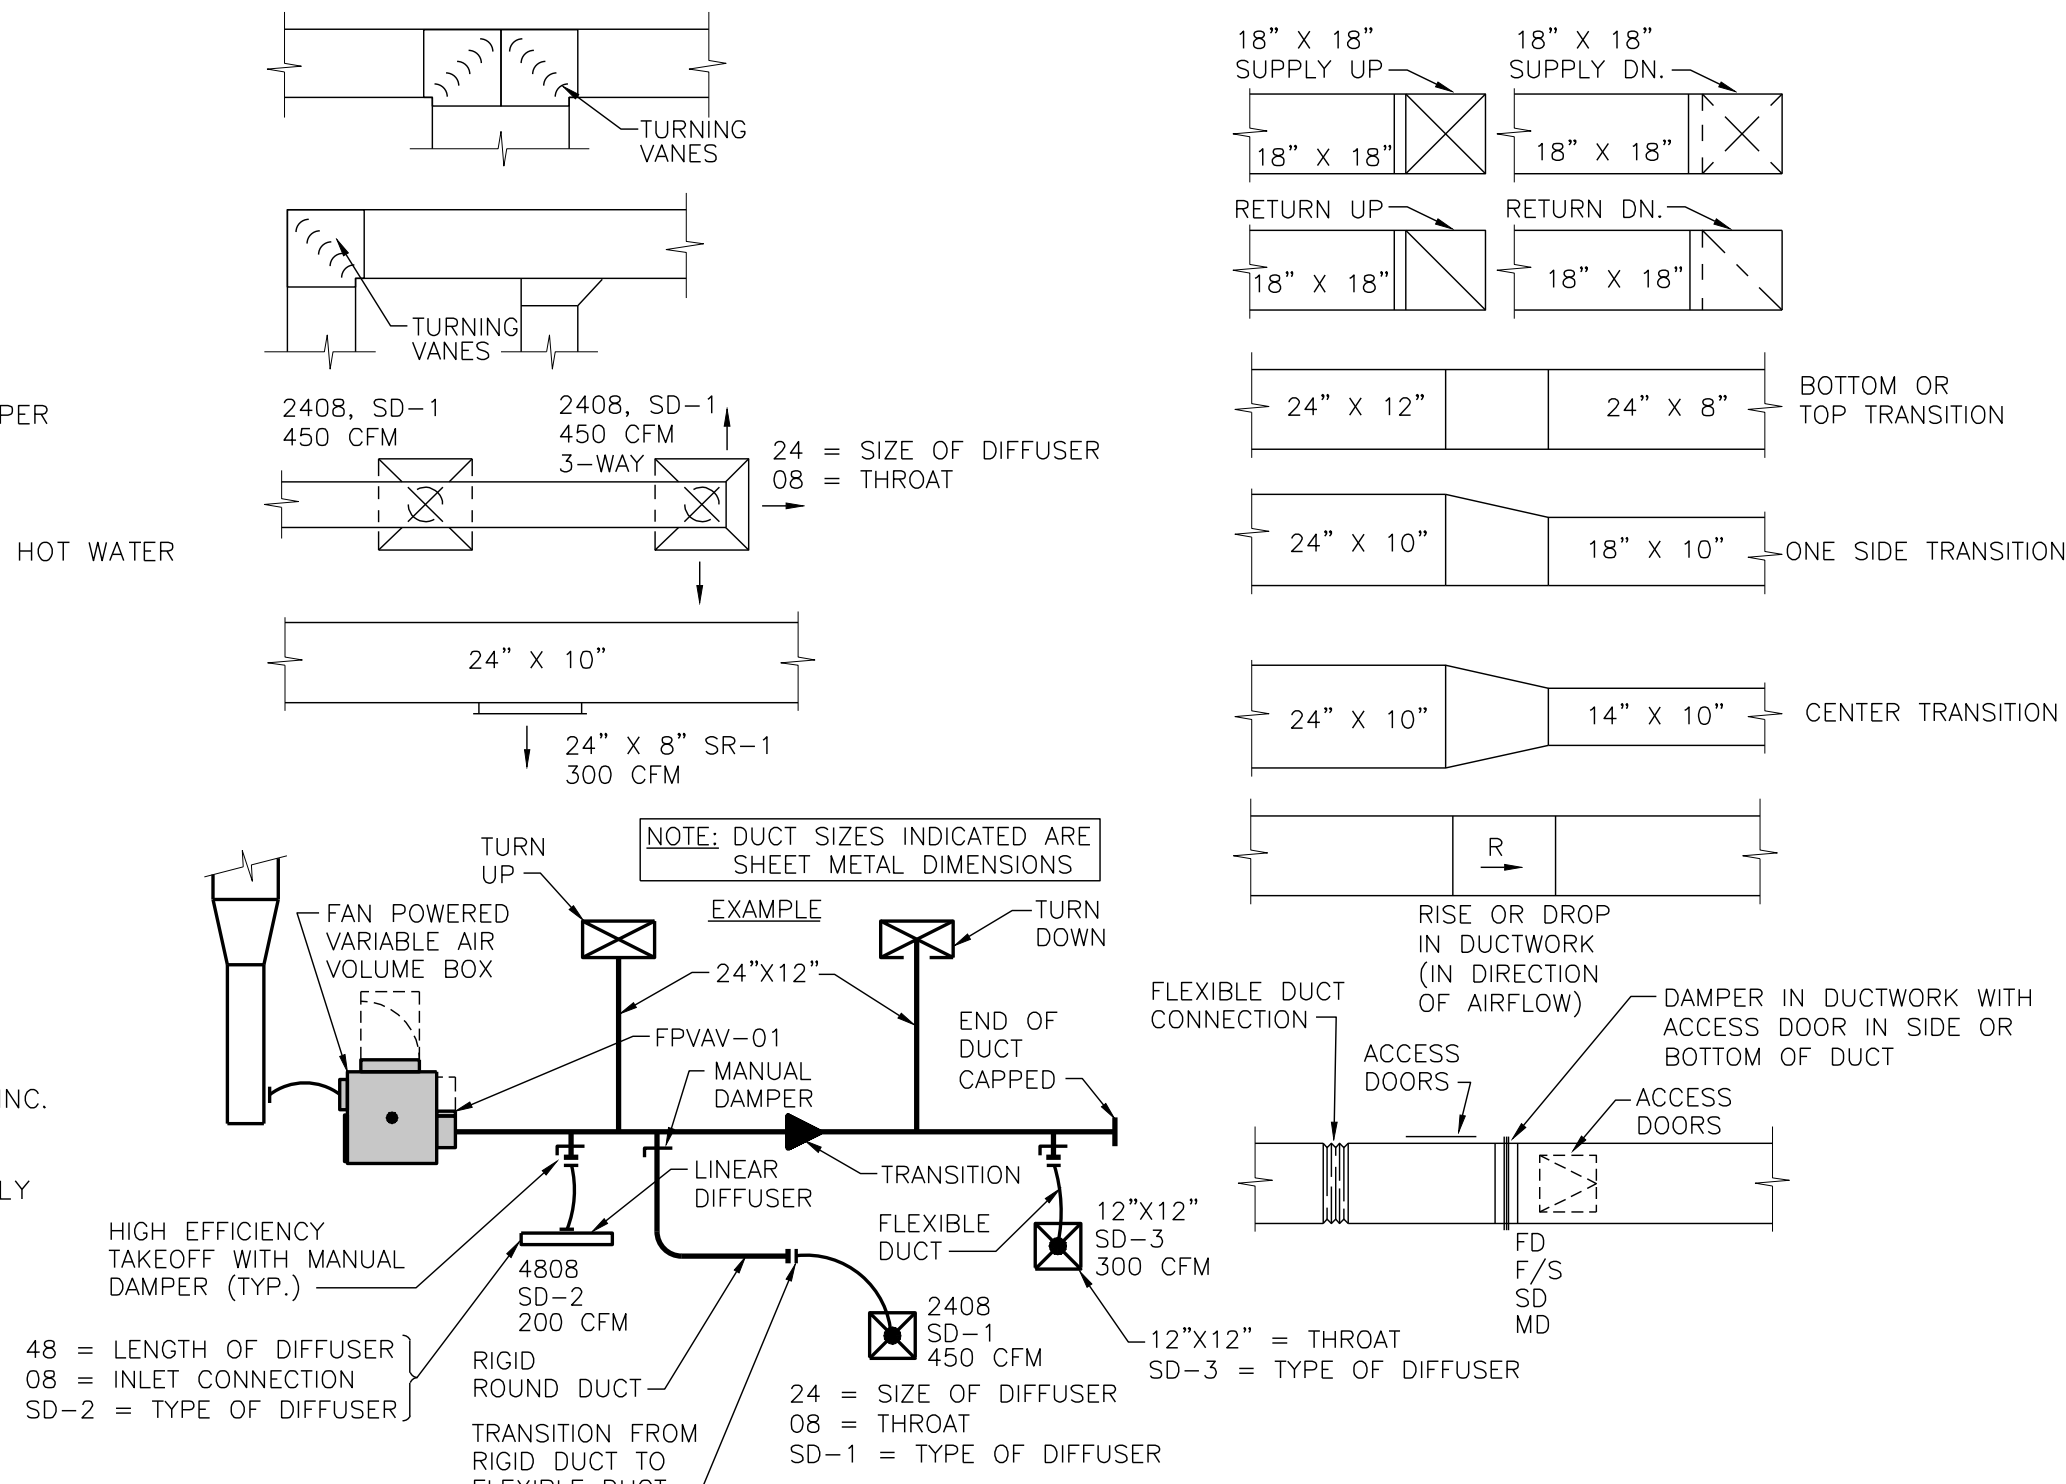
PLUMBING

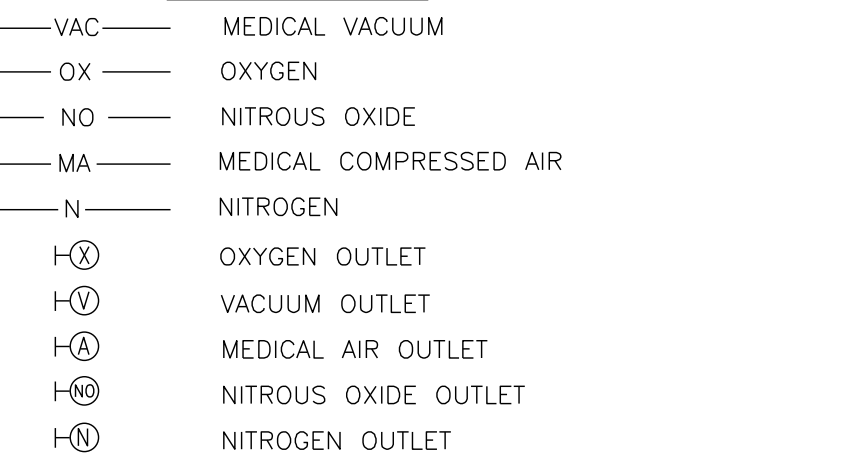

GENERAL

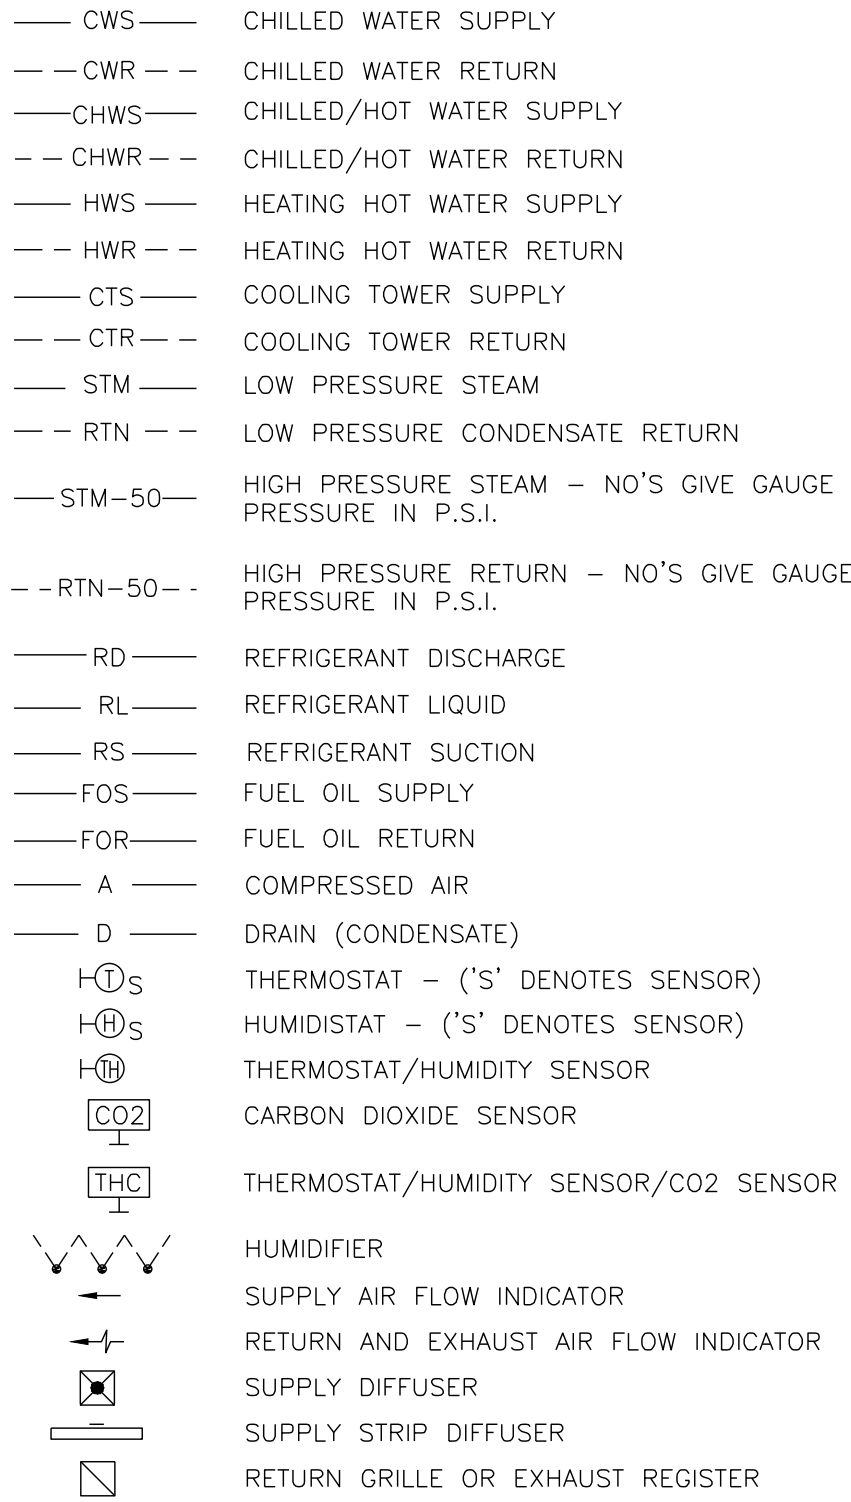

DUCTWORK

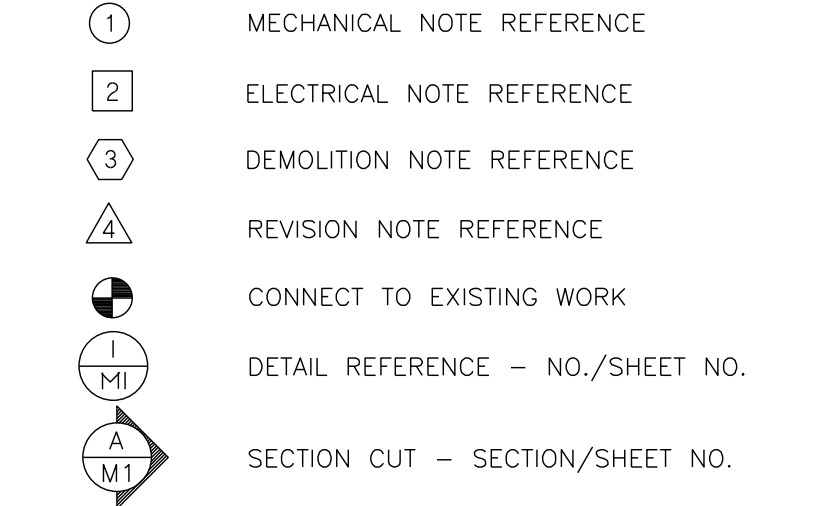

MECHANICAL AND ELECTRICAL SYMBOLS AND ABBREVIATIONS

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project number: 2318400

drawing issuance: 06/14/23

drawing revisions: No. Description. Date.

professional seal: STATE OF MISSOURI CHRISTOPHER EDWARD ALBRIGHT

DATE SIGNED: 06/14/2023


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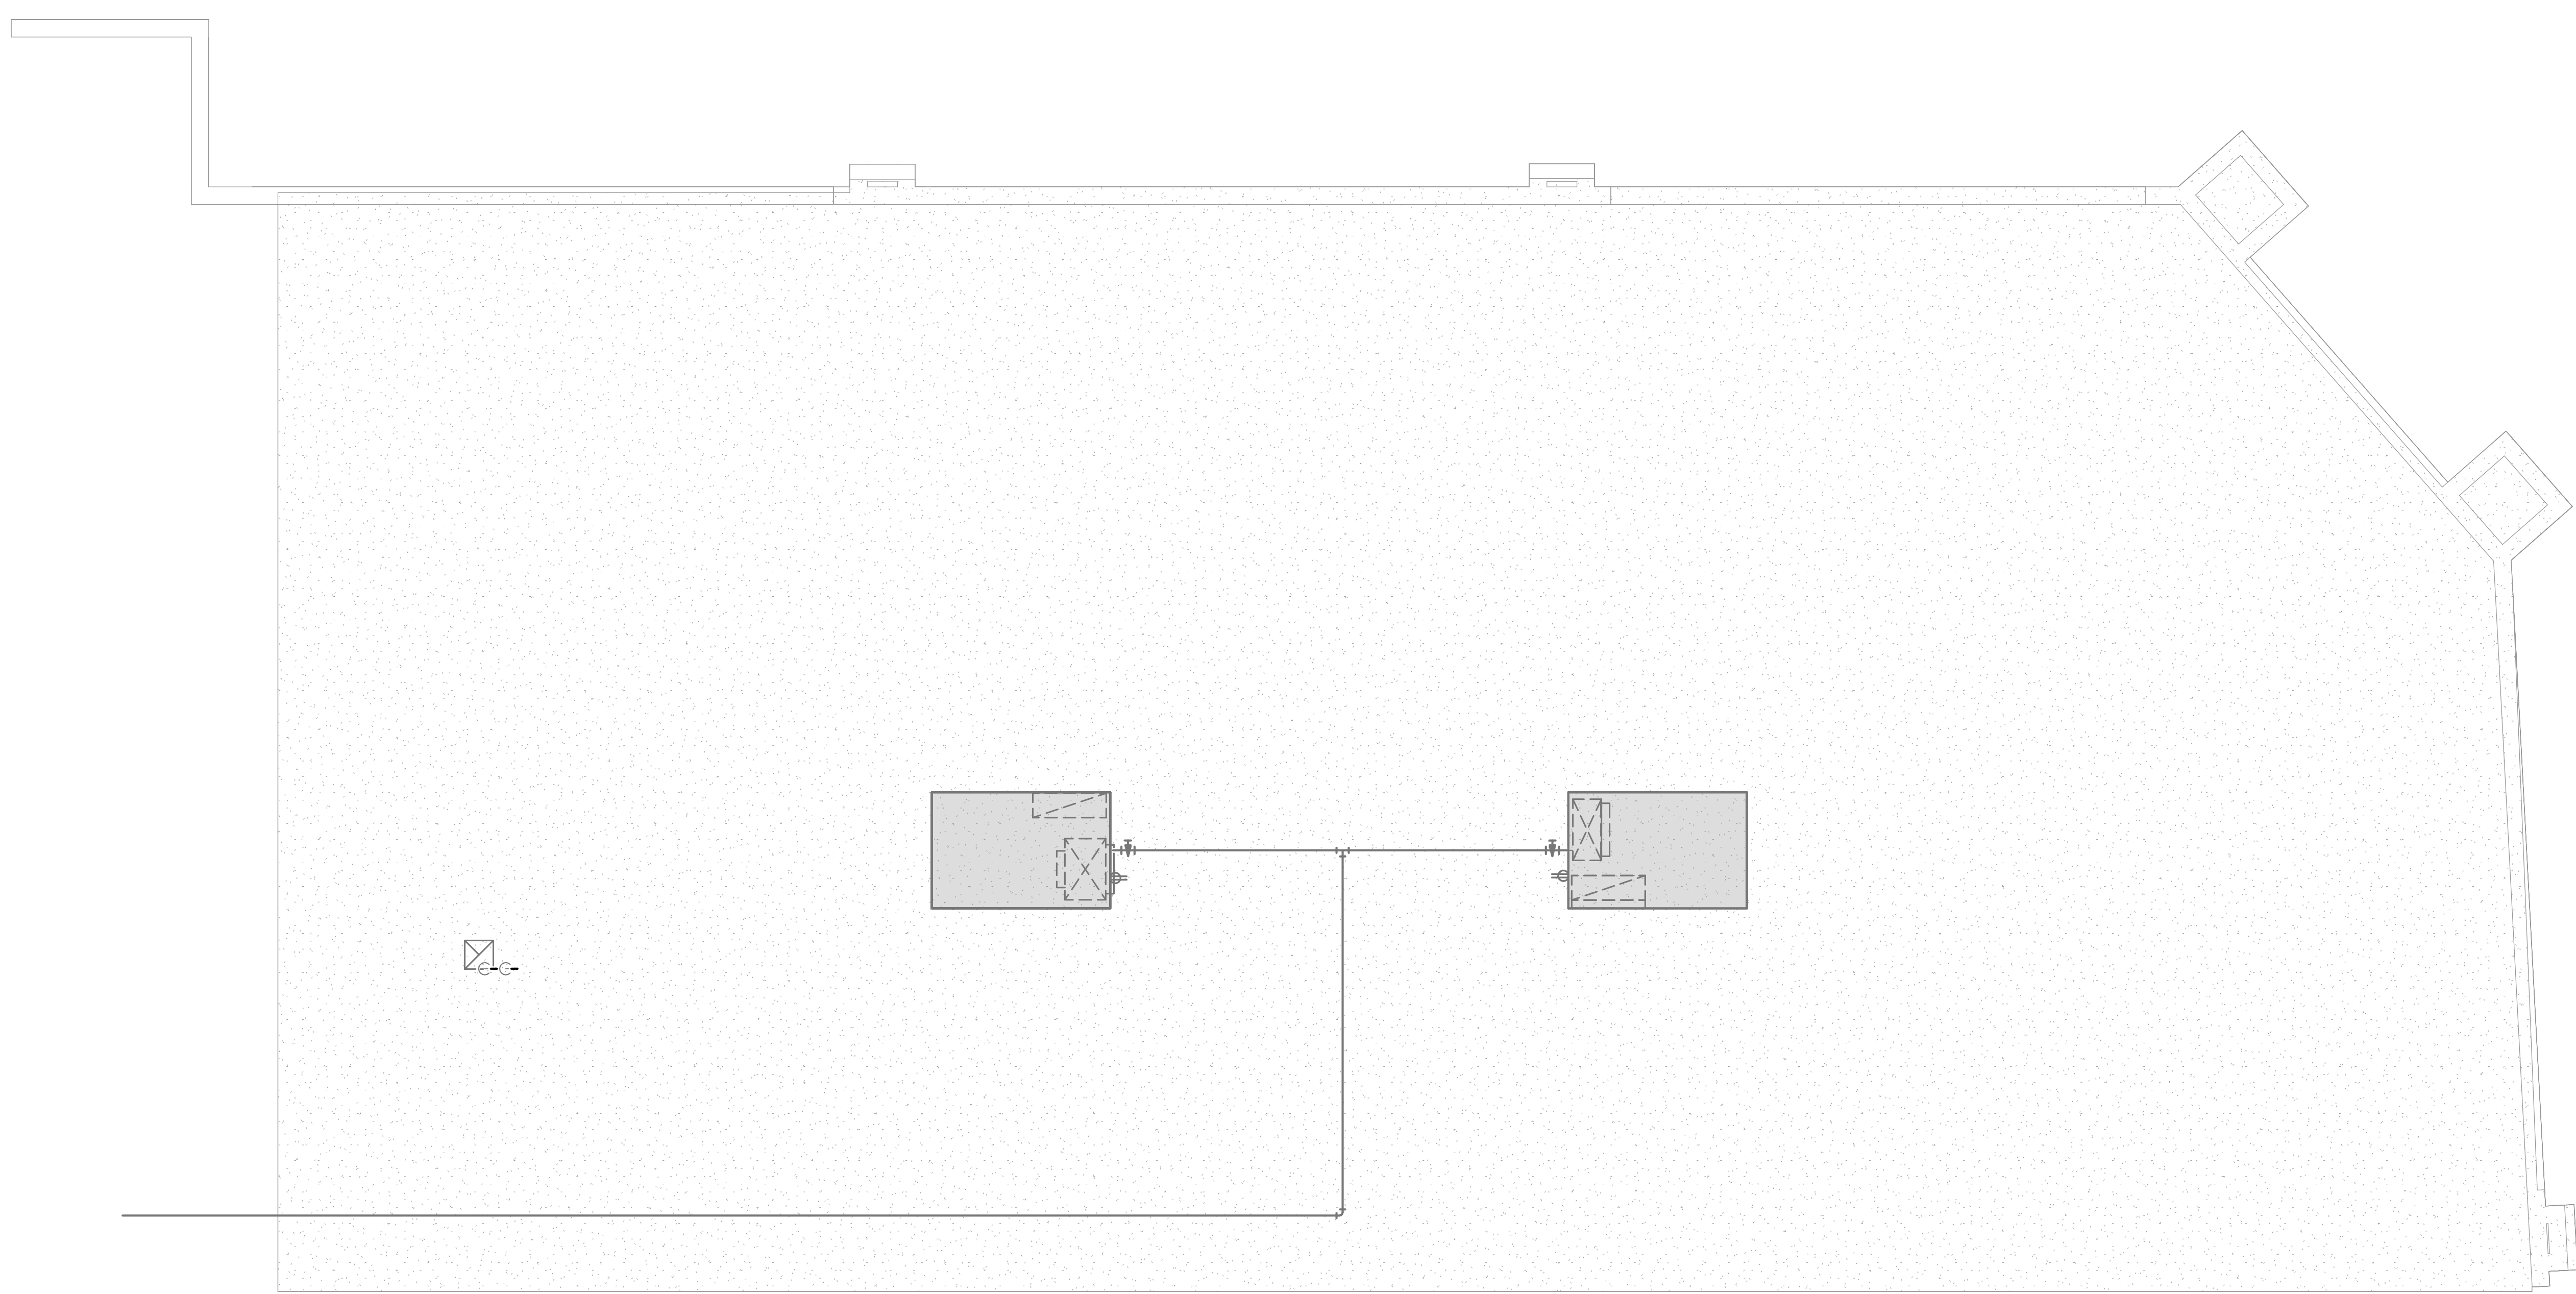
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 SUMMIT FAIR
 910 G NW Blue Pkwy
 Lee's Summit, MO 64086

project number
 Project Number
drawing issuance
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drawing revisions
 No. Description Date:

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drawing title
 MECHANICAL AND ELECTRICAL - ROOF PLAN
drawing number
ME202



PLUMBING FIXTURE SCHEDULE

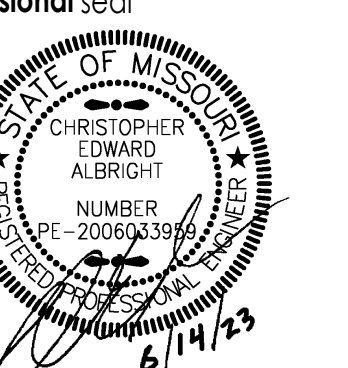MARK	MANUFACTURER/ MODEL	DESCRIPTION	FITTINGS		PIPING CONNECTIONS				
			MANUFACTURER/ MODEL	DESCRIPTION	NOTES	CW	HW	SAN	VENT
S-1	ELKAY LWSB252264N	ADA COMPLIANT SINGLE BOWL, UNDERMOUNT, 16 GAUGE, TYPE 304 STAINLESS STEEL, 30-1/2" X 18-1/2" X 8" DEEP, REAR CENTER DRAIN	MOEN 87912SRS	HIGH ARC SPOUT, REFLEX PULLDOWN FAUCET WITH BRAIDED HOSE, SWING FAUCET SPOUT, SINGLE HOLE FAUCET DECK MOUNTED WITHOUT PLATE.	1, 2, 3, 4	1/2"	1/2"	2"	1-1/2"

NOTES:

1. PROVIDE CHROME PLATED BRASS TAILPIECE AND GRID DRAIN.
2. PROVIDE CHROME PLATED BRASS P-TRAP.
3. PROVIDE 1/4 TURN SHUT OFF VALVES AND FLEXIBLE RISERS.
4. INSULATE EXPOSED TAILPIECE, P-TRAP, AND WATER RISERS. COVER TAILPIECE, P-TRAP, AND ANY EXPOSED WASTE AND VENT PIPING WITH CROME COVER. REFER TO SPECIFICATIONS FOR INSULATION METHODS.

PIPING MATERIAL SCHEDULE - PLUMBING

APPLICATION	SIZE	LOCATION	PIPE MATERIAL
DOMESTIC WATER	2" AND SMALLER	ABOVE GROUND	HARD COPPER TUBE, ASTM B88, TYPE L; CAST OR WROUGHT COPPER SOLDER-JOINT FITTINGS; AND BRAZED JOINTS. OR CPVC PIPE; CPVC SOCKET FITTINGS; AND SOLVENT-CEMENTED JOINTS. OR PEX-A PIPE AND FITTINGS (FOR USE INSIDE DWELLING UNITS ONLY; NOT INTENDED FOR BUILDING MAINS). PEX-B PIPE AND FITTINGS NOT ALLOWED.
SOIL/WASTE/VENT	ALL SIZES	BELOW GROUND	HUBLESS, CAST-IRON SOIL PIPE AND FITTINGS; HEAVY-DUTY CAST-IRON HUBLESS-PIPING COUPLINGS; AND COUPLED JOINTS. OR SOILD WALL SCHEDULE 40 PVC PIPE; PVC SOCKET FITTINGS, AND SOLVENT-CEMENTED JOINTS.
SOIL/WASTE/VENT	ALL SIZES	ABOVE GROUND	HUBLESS, CAST-IRON SOIL PIPE AND FITTINGS; HEAVY-DUTY CAST-IRON HUBLESS-PIPING COUPLINGS; AND COUPLED JOINTS. OR SOILD WALL SCHEDULE 40 PVC PIPE; PVC SOCKET FITTINGS, AND SOLVENT-CEMENTED JOINTS. PVC SHALL NOT BE INSTALLED WITHIN RETURN AIR PLENUMS UNLESS FULLY ENCAPSULATED WITH PLENUM RATED MATERIAL.

PIPE INSULATION SCHEDULE - PLUMBING

SERVICE	PIPE SIZE	INSULATION
DOMESTIC COLD WATER	1/2" - 2"	1/2" FIBERGLASS, ASJ
DOMESTIC HOT WATER	ALL	1" FIBERGLASS, ASJ
RECIRCULATING HOT WATER		
TEMPERED WATER		




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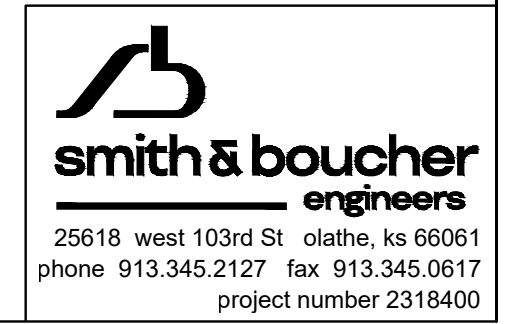
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SUMMIT FAIR
910 G NW Blue Pkwy
Lee's Summit, MO 64086**

project number
drawing issuance
drawing revisions




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drawing title
MECHANICAL AND ELECTRICAL - SCHEDULES AND DETAILS

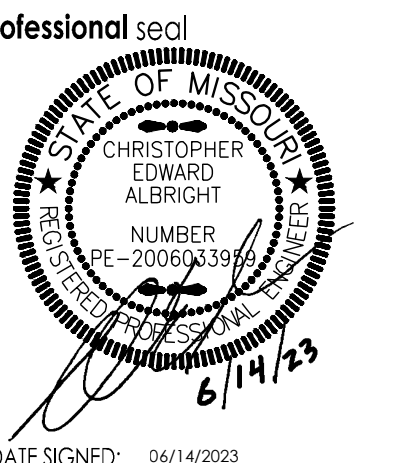drawing number
ME301



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LAST CORRECTION BY: DATE • TIME: Booty, Charles Wednesday, June 14, 2023 10:15:57 AM
PLOTTED BY: DATE • TIME:

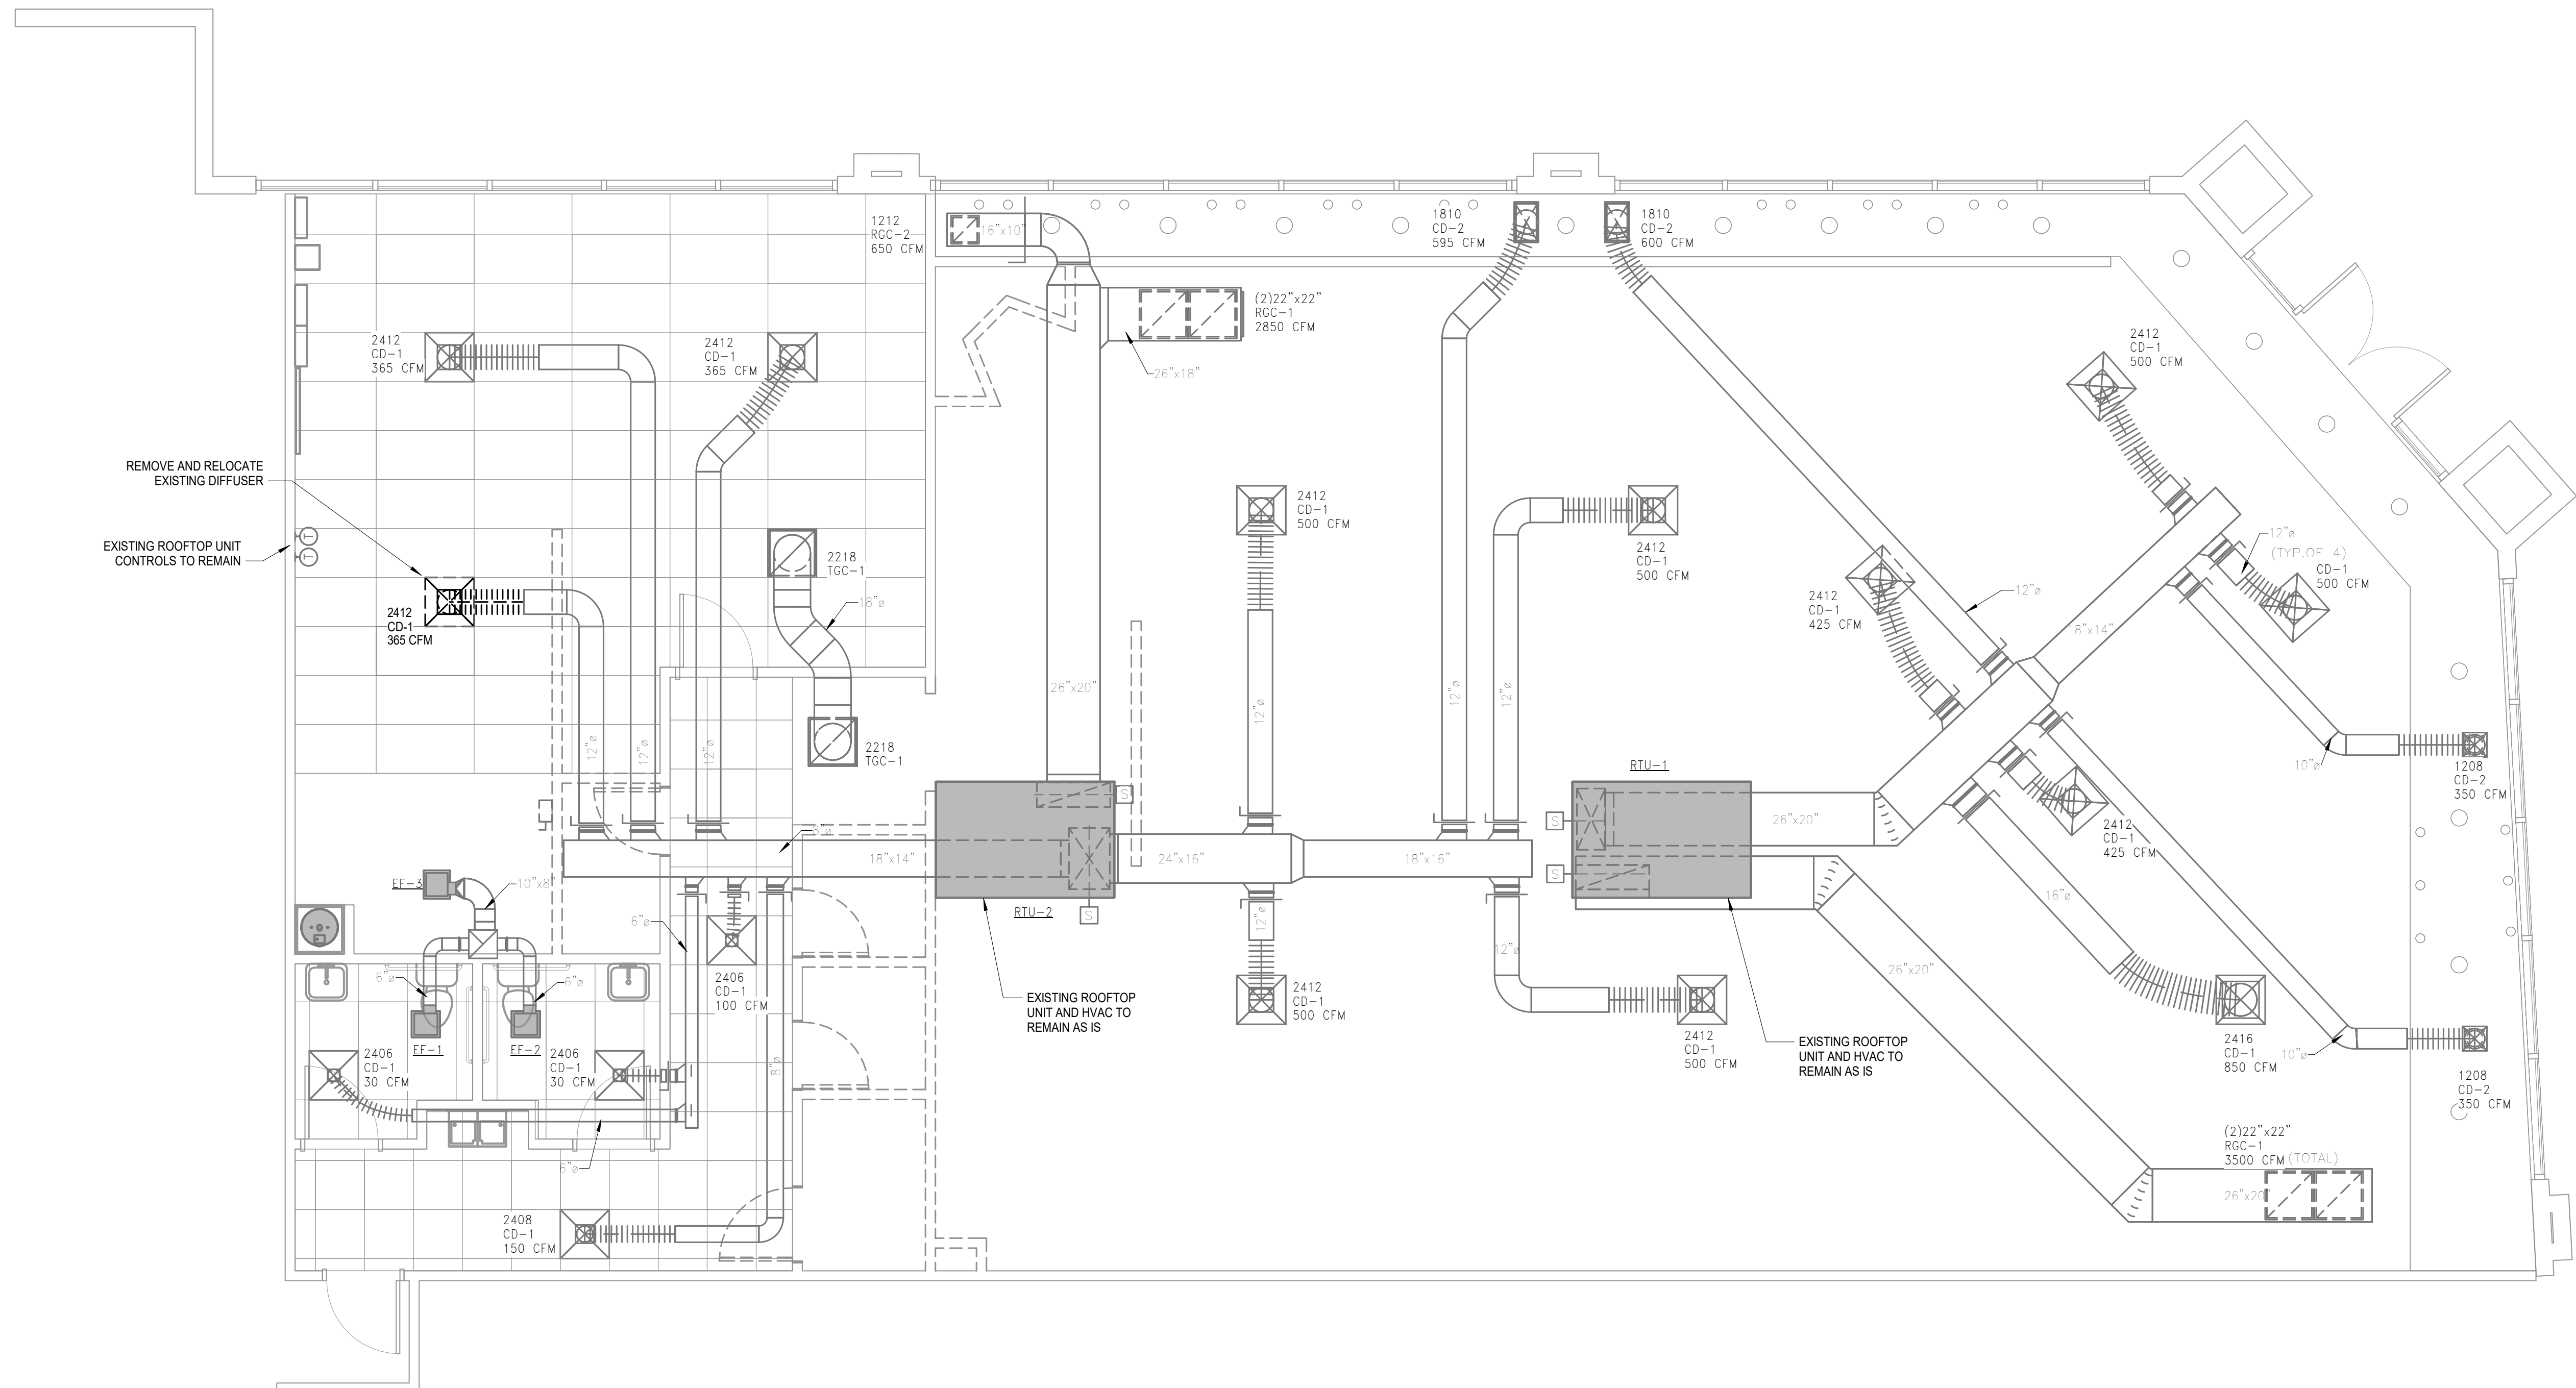

HVAC PLAN - DEMOLITION ①
SCALE: 1/4" = 1'-0"

smith & boucher
engineers
25618 west 103rd St olathe, ks 66061
phone 913.345.2127 fax 913.345.0617
SBI PROJECT NUMBER: 2318400

Kloverarchitects
8813 PENROSE LANE, SUITE 400 • LENEXA, KS 66219
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project title
**RED DEVELOPMENT
SUMMIT FAIR
910 G NW Blue Pkwy
Lee's Summit, MO 64086**

project number
Project Number
drawing issuance
Permit Set 06/14/23
drawing revisions
No. Description: Date:

professional seal
STATE OF MISSOURI
CHRISTOPHER EDWARD ALBRIGHT
NUMBER PE-200603392
6/14/23

DATE SIGNED: 06-14-23
drawing title
HVAC PLAN - DEMOLITION

drawing number
DM101

GENERAL NOTES:

- EXISTING HVAC SYSTEM TO REMAIN INTACT AND BE REUSED. CLEAN AND WIPE DOWN ALL DIFFUSERS AND GRILLES.
- PROVIDE NEBB OR AABC CERTIFIED TAB OF THE DIFFUSERS AND GRILLES. TEST EXISTING ROOFTOP UNIT FOR FULL AIRFLOW (RTU-1 AT 4000CFM SUPPLY AND 900CFM OUTSIDE AIR, RTU-2 AT 3405CFM SUPPLY AND 900CFM OF OUTSIDE AIR).

PLAN NOTES:

- ADJUST LOCATION OF EXISTING SUPPLY DIFFUSER TO ACCOMMODATE NEW CEILING AND LIGHTING.
- TEMPORARILY REMOVE EXISTING DIFFUSERS AND REINSTALL TO ACCOMMODATE SOFFIT WORK.

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project title

**RED DEVELOPMENT
 SUMMIT FAIR
 910 G NW Blue Pkwy
 Lee's Summit, MO 64086**

project number

Project Number


drawing issuance

Permit Set 06/14/23

drawing revisions

No. Description: Date:

professional seal

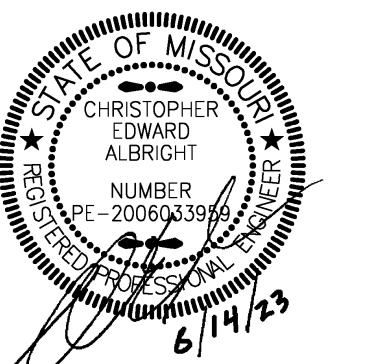


DATE SIGNED: 06-14-23

drawing title

HVAC PLAN - NEW WORK


drawing number

M101

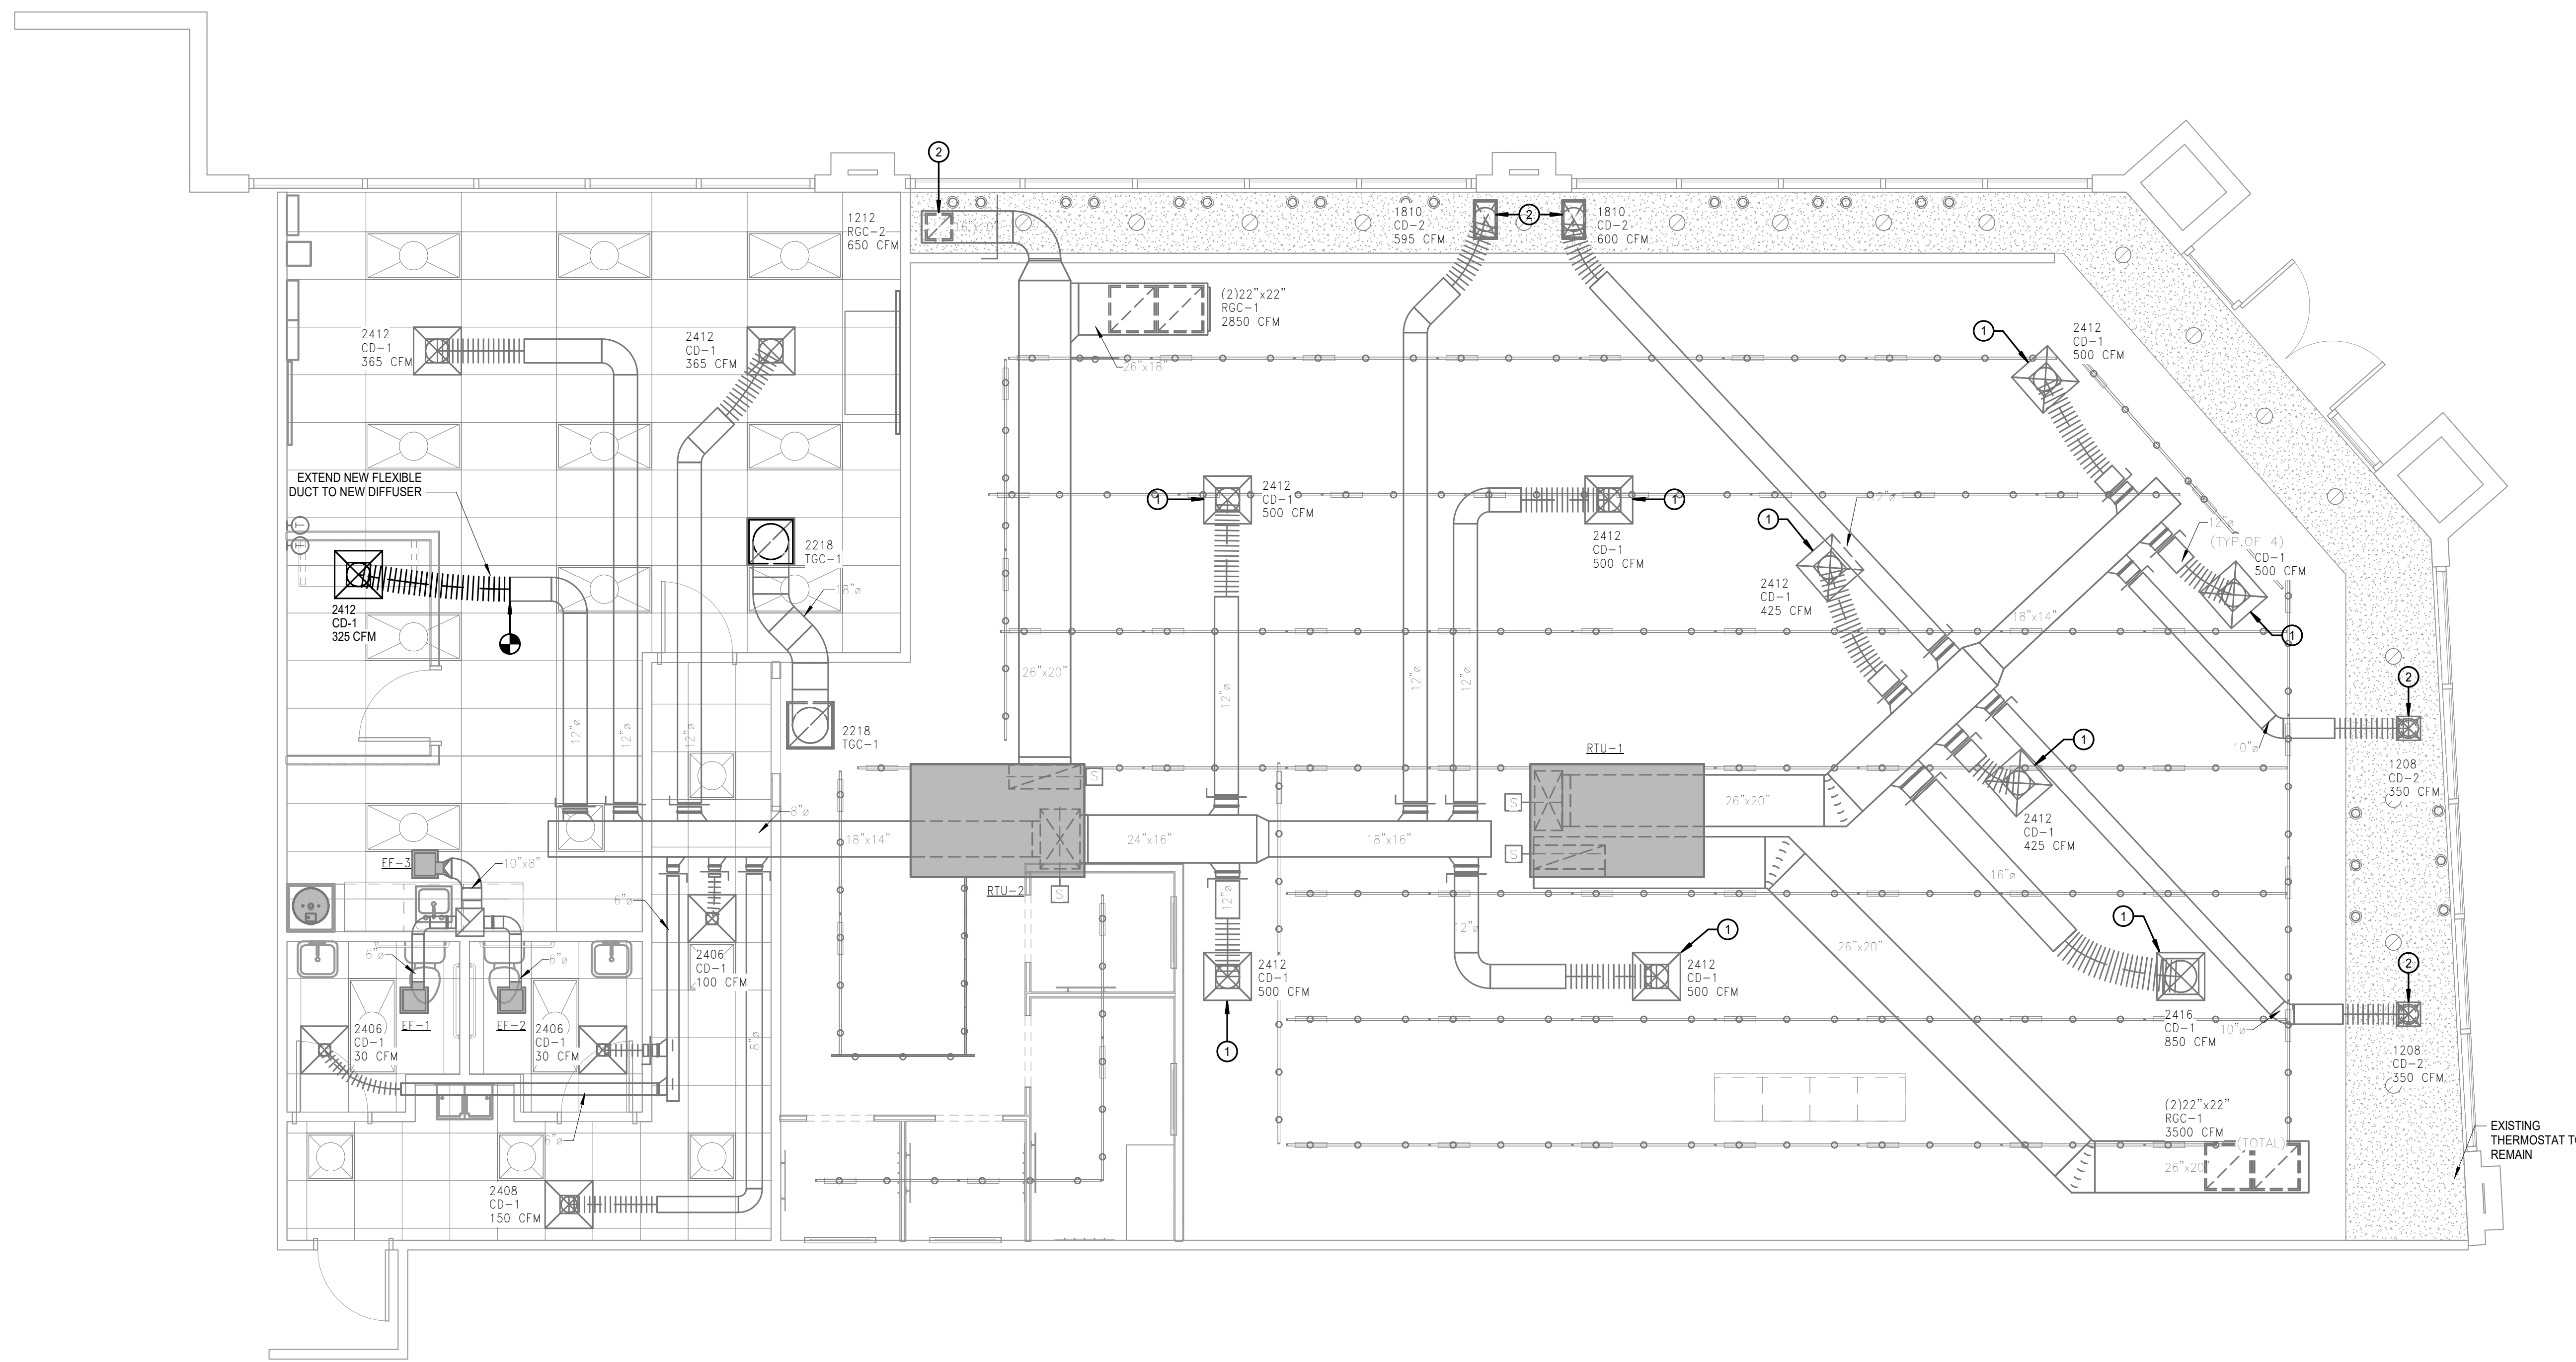

HVAC PLAN - NEW WORK ①
 SCALE: 1/4" = 1'-0"

DEMOLITION PLAN NOTES:
 ⓧ DISCONNECT AND REMOVE EXISTING BACKFLOW PREVENTER AND COLD WATER LINE. ADJUST AS REQUIRED FOR NEW WORK.

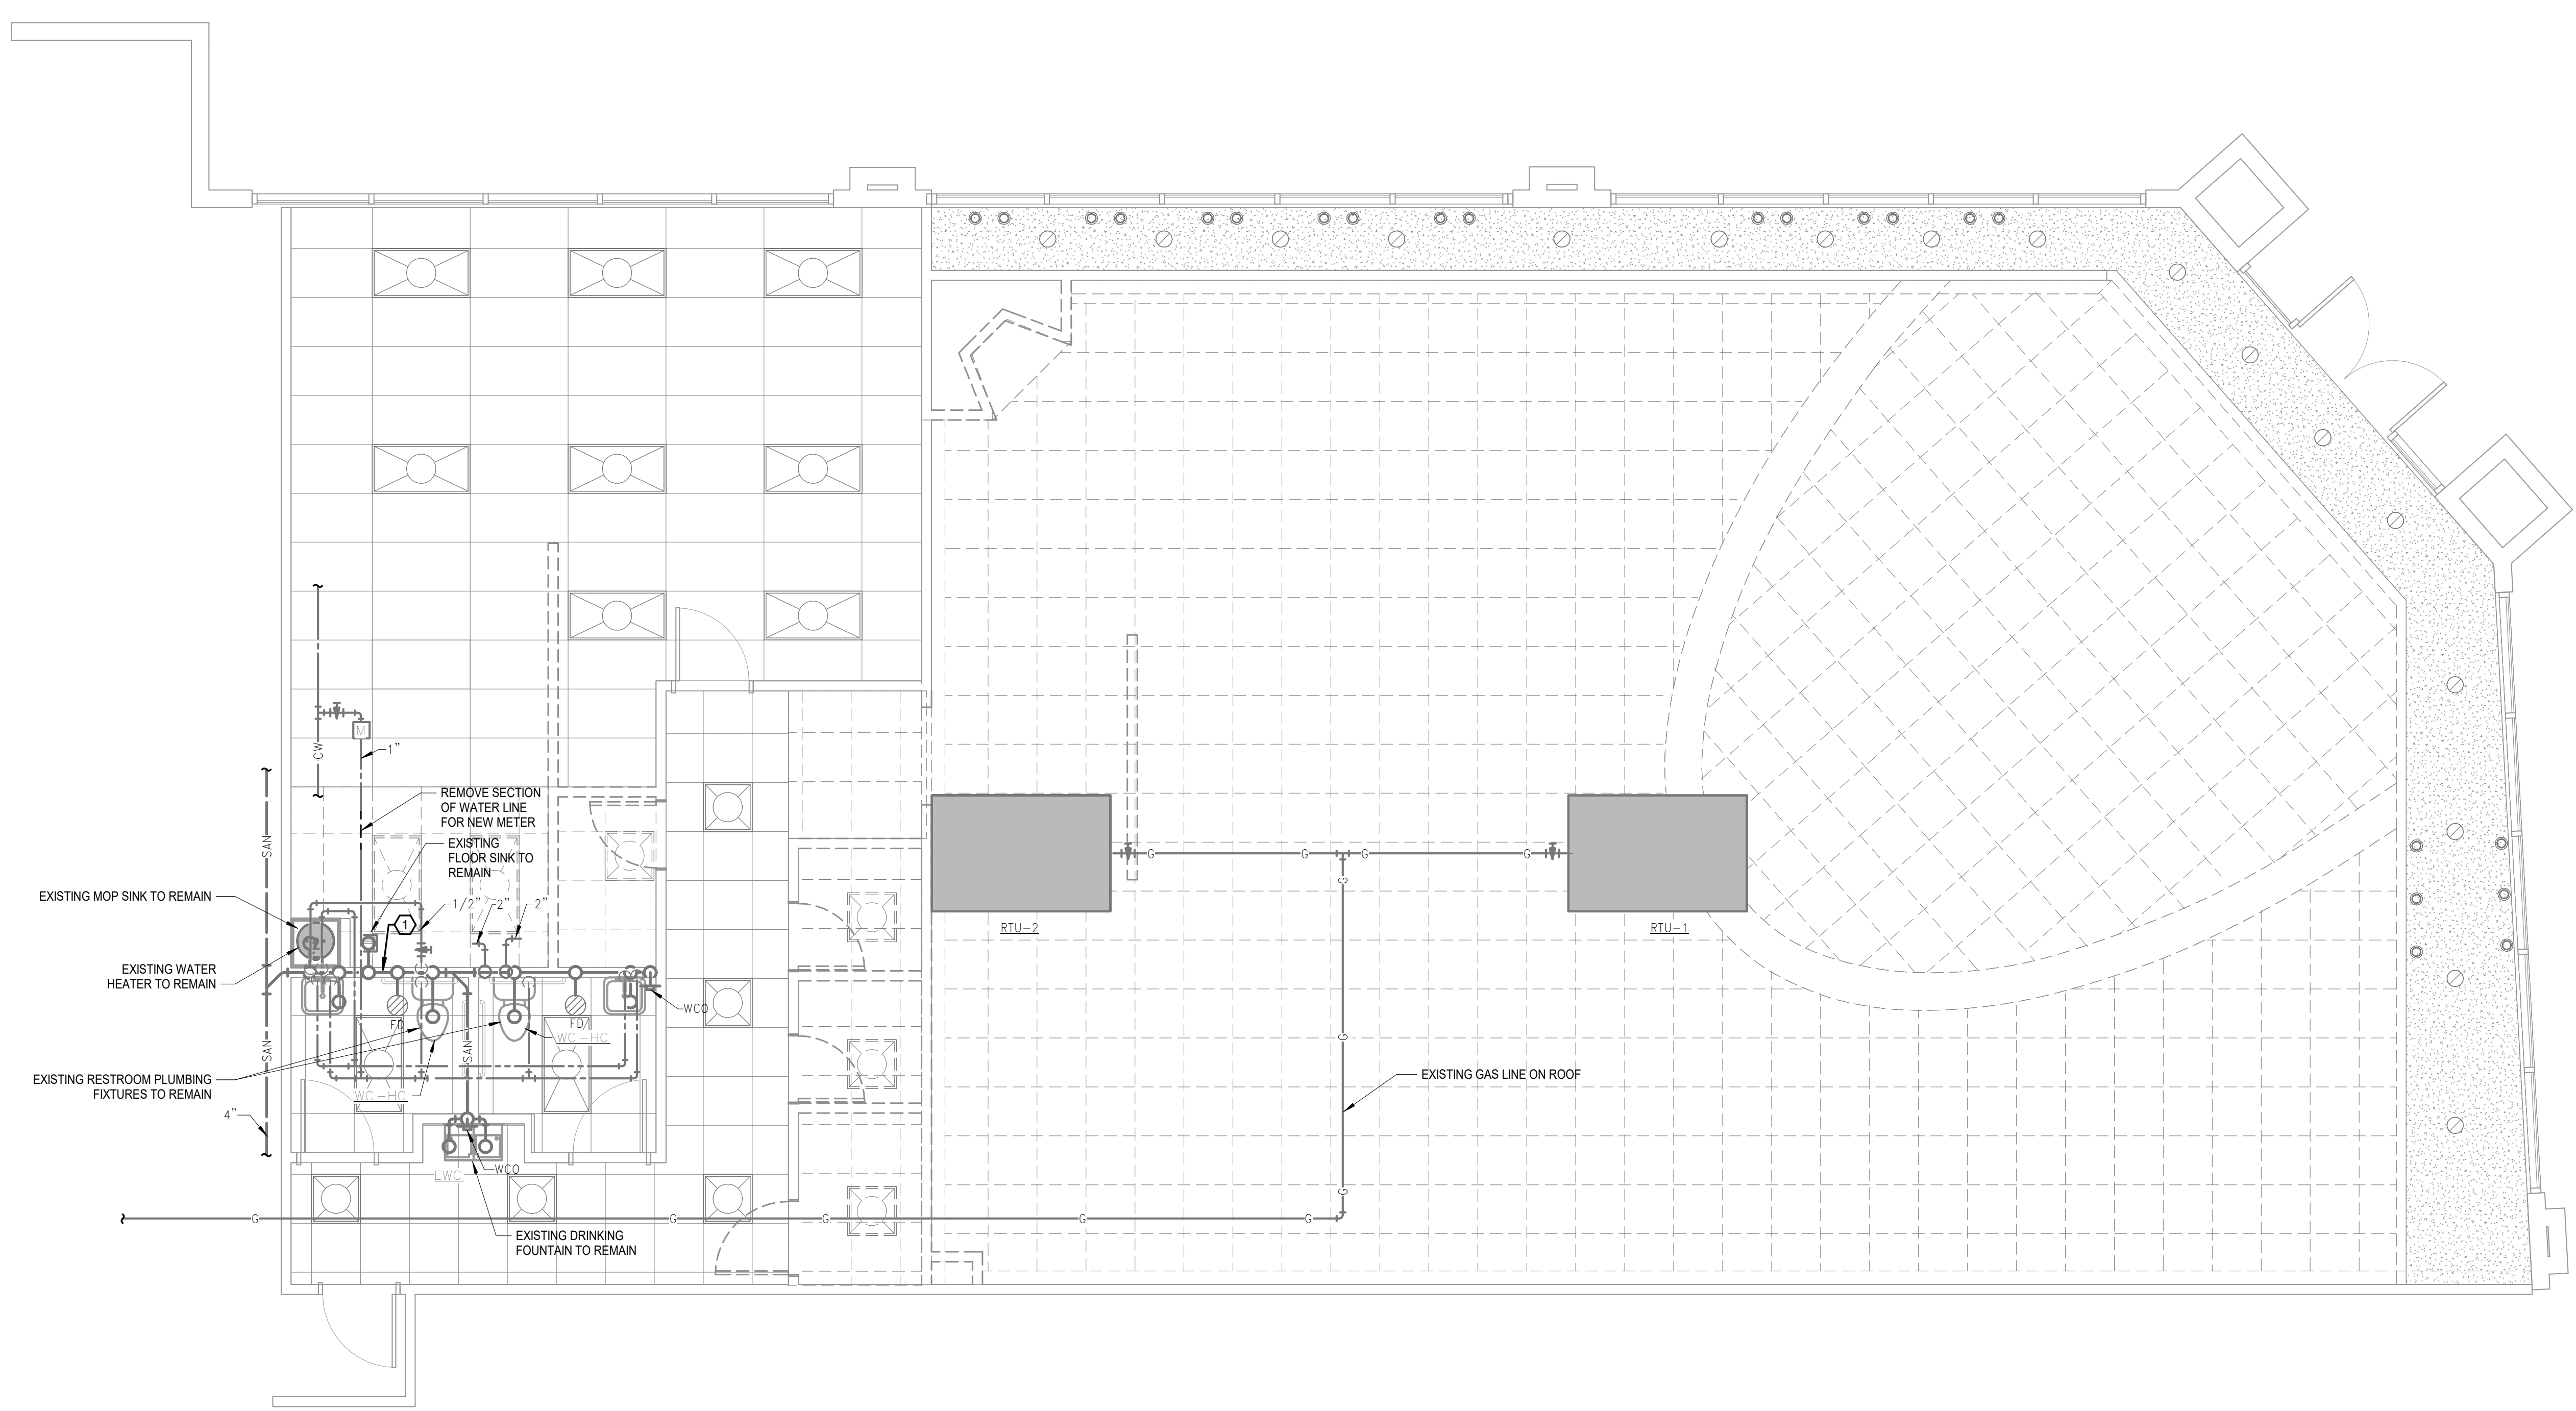

PLUMBING PLAN - DEMOLITION 1
 SCALE: 1/4" = 1'-0"

smith & boucher
 engineers
 25618 west 103rd St. olathe, ks 66061
 phone 913.345.2127 fax 913.345.0617
 SBI PROJECT NUMBER: 2318400

Kloverarchitects
 8813 PENROSE LANE, SUITE 400 • LENEXA, KS 66219
 PH: 913.649.8181 • FX: 913.649.1275 • WWW.KLOVER.NET


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project title
**RED DEVELOPMENT
 SUMMIT FAIR**
 910 G NW Blue Pkwy
 Lee's Summit, MO 64086

project number
 Project Number
 drawing issuance
 Permit Set 06/14/23
 drawing revisions
 No. Description: Date:



DATE SIGNED: 06-14-23
 drawing title
 PLUMBING PLAN - DEMOLITION


drawing number
DP101

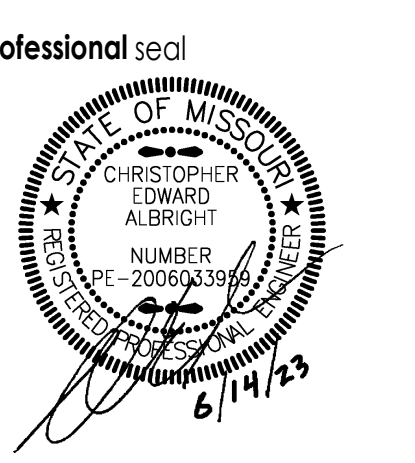FIRE PROTECTION GENERAL NOTES:

1. THE EXISTING FIRE SPRINKLER SYSTEM IS TO REMAIN AND BE REUSED. ADJUST OR MODIFY ANY HEAD LOCATIONS AS A RESULT OF NEW CONSTRUCTION (WALLS, LIGHTING, ETC.).

PLUMBING PLAN NOTES:

1. CONNECT 1/2" COLD WATER, 1/2" HOT WATER, 2" SANITARY AND 1-1/2" VENT TO NEW BREAKROOM SINK. MODIFY SANITARY AND VENT PIPING IN CHASE TO CONNECT TO EXISTING PIPING IN THE WALL.
2. PROVIDE AND INSTALL NEW TENANT WATER SUB-METER AND ISOLATION VALVE. METER TO BE A NEPTUNE T-10 (OR EQUAL).

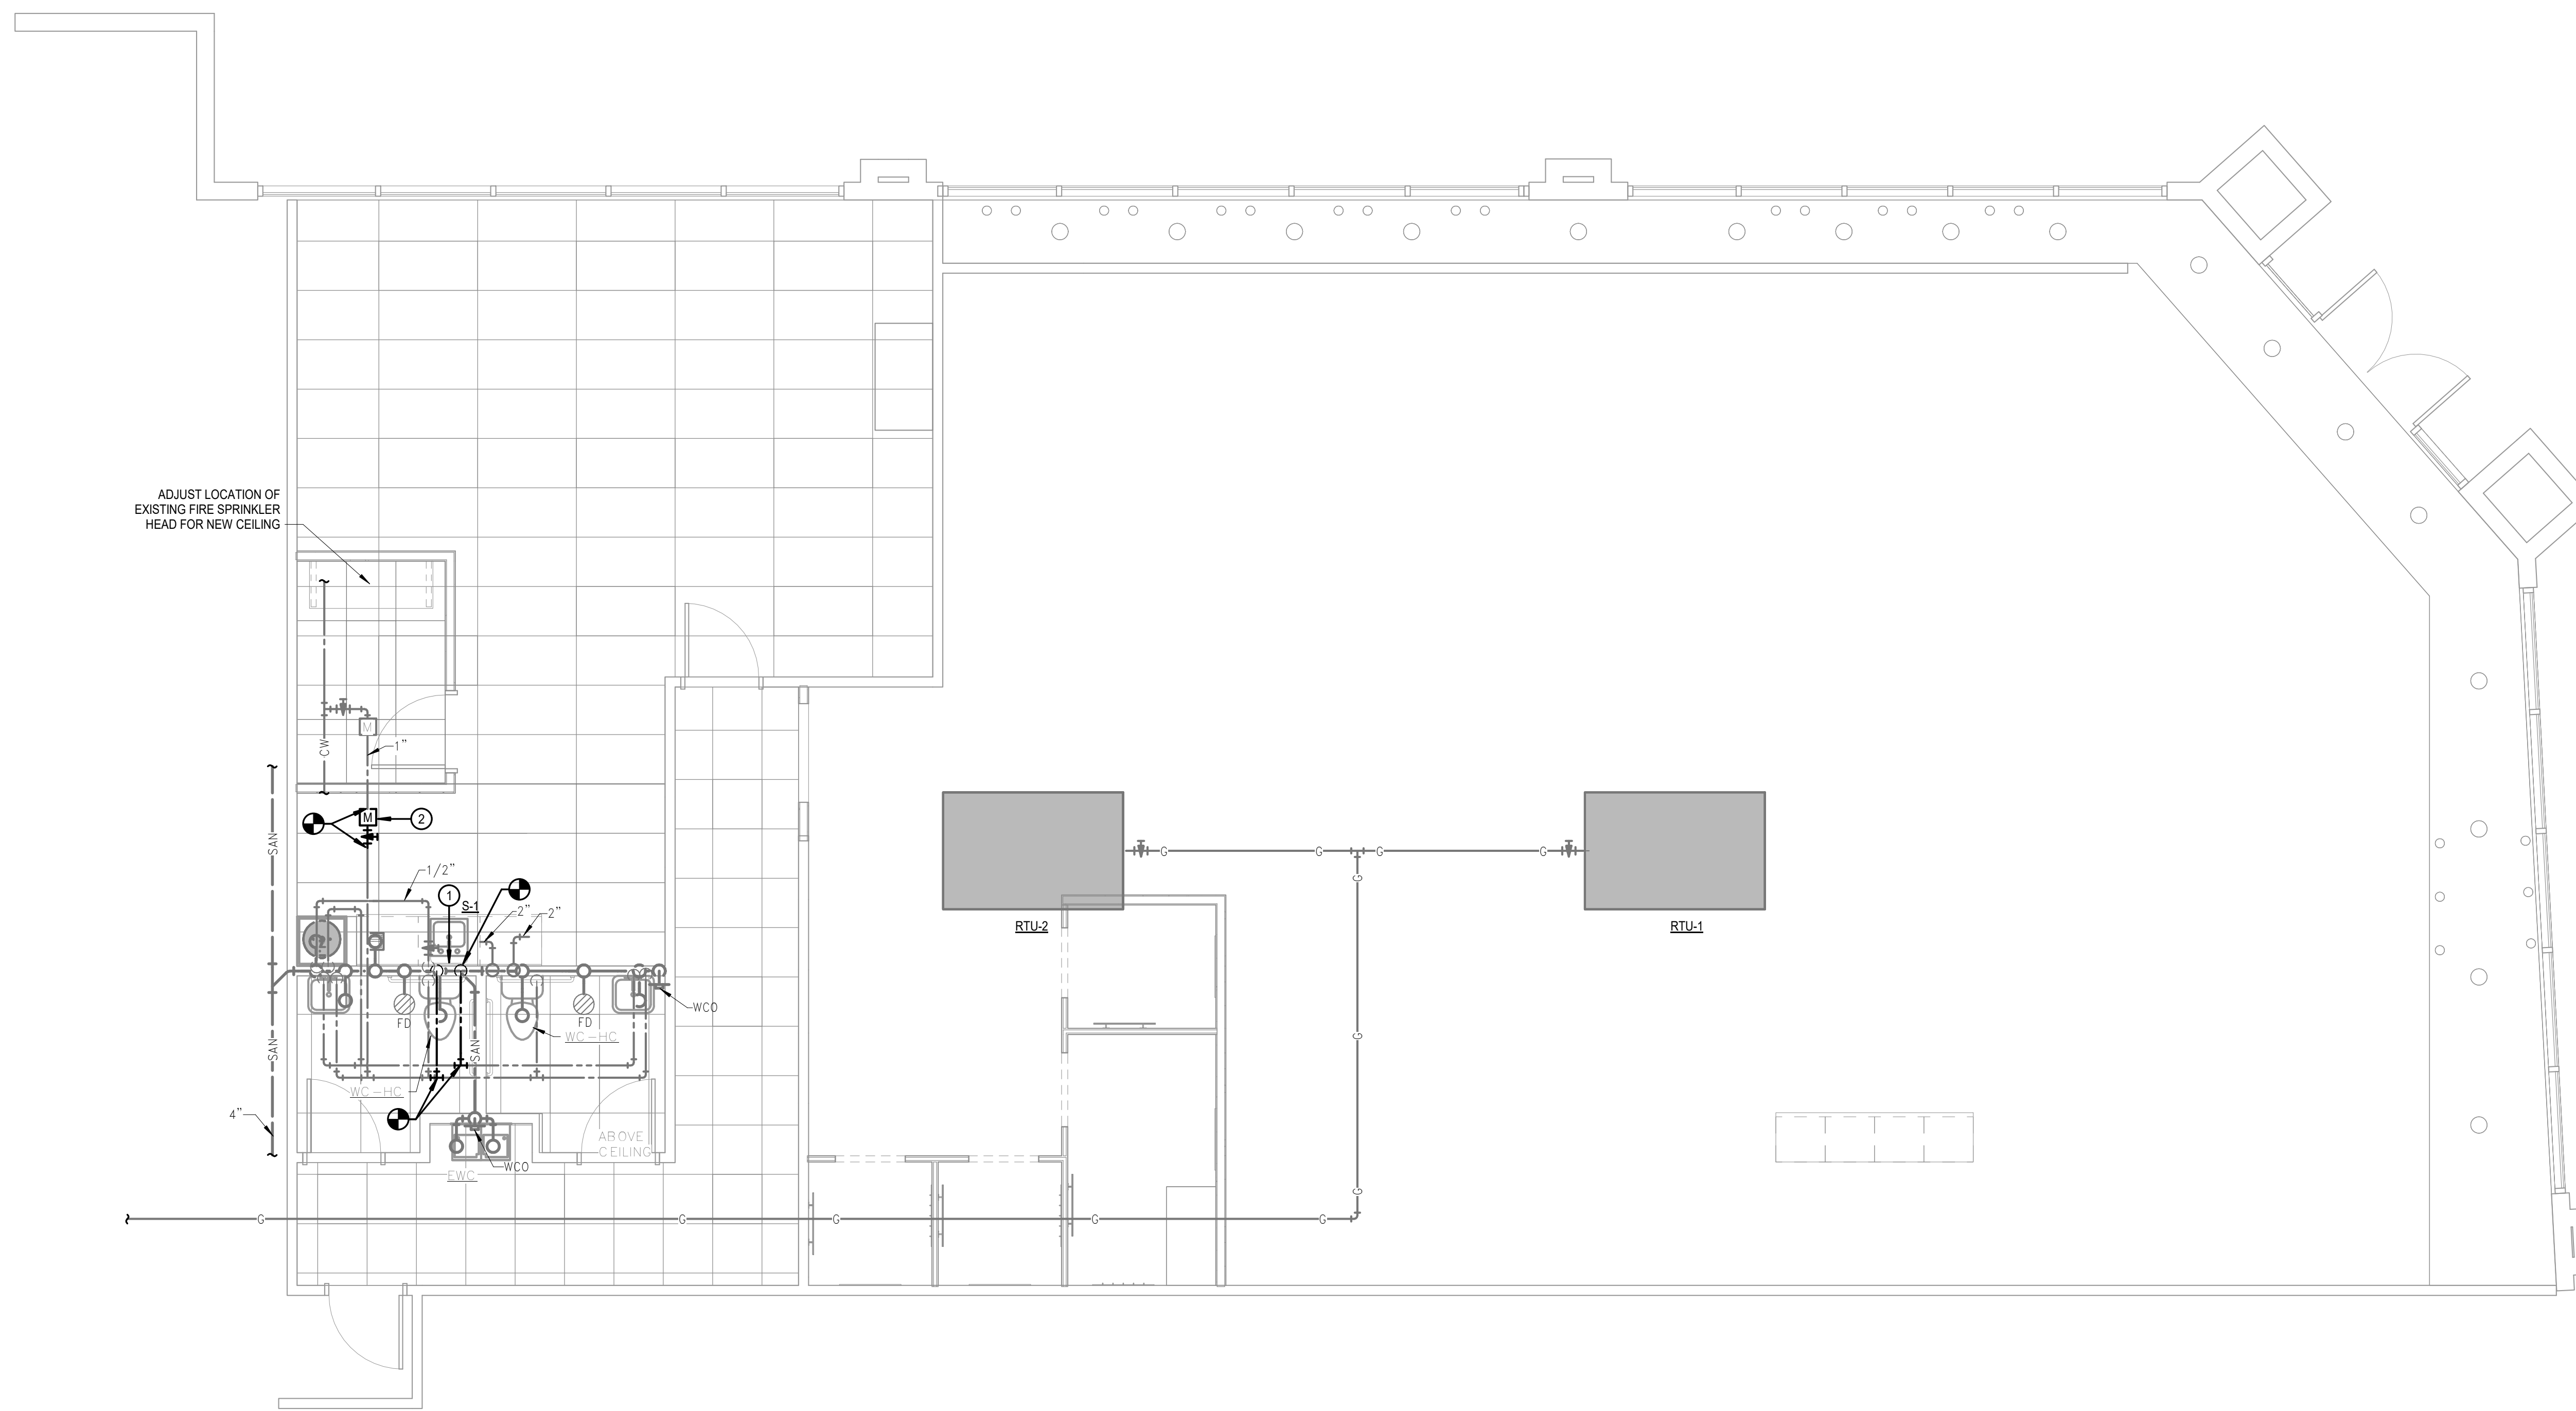

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project title
**RED DEVELOPMENT
 SUMMIT FAIR
 910 G NW Blue Pkwy
 Lee's Summit, MO 64086**

project number
 Project Number
 drawing issuance
 Permit Set 06/14/23
 drawing revisions
 No. Description: Date:

professional seal

 DATE SIGNED: 06-14-23
 drawing title
 PLUMBING PLAN - NEW WORK

drawing number
P101

PLUMBING PLAN - NEW WORK ①
 SCALE: 1/4" = 1'-0"


smith & boucher
 engineers
 25618 west 103rd St. olathe, ks 66061
 phone 913.345.2127 fax 913.345.0617
 SBI PROJECT NUMBER: 2318400

GENERAL DEMOLITION NOTES:

1. UNLESS NOTED OTHERWISE, SERVICES AND EQUIPMENT SHOWN FULL TONE ARE NEW WORK, HALF TONE ARE EXISTING TO REMAIN, AND FULL TONE AND DASHED ARE EXISTING TO BE DEMOLISHED.
2. THE EXISTING CONDITIONS INDICATED ON THE DRAWINGS ARE TAKEN FROM THE BEST INFORMATION AVAILABLE AND ARE NOT TO BE CONSTRUED AS "AS BUILT" CONDITIONS. THE INFORMATION IS SHOWN TO HELP ESTABLISH THE EXTENT OF THE NEW WORK. VERIFY ALL ACTUAL EXISTING CONDITIONS AT THE PROJECT SITE AND PERFORM WORK AS REQUIRED TO MEET THE EXISTING CONDITIONS AND THE EXTENT OF THE WORK INDICATED.
3. DISCONNECT AND REMOVE ALL CIRCUITRY, DISCONNECTS, CONTROLLERS AND CONDUIT THAT BECOMES UNNECESSARY AS A RESULT OF THE REMOVAL OF FIXTURES, DEVICES OR EQUIPMENT INDICATED TO BE REMOVED. LABEL ALL CIRCUIT BREAKERS IN EXISTING PANELBOARDS NO LONGER IN USE AS SPARE. CAP ALL UNUSED CONDUIT AND WIRING BEYOND THE FLOOR LINE OR WALL LINE TO FACILITATE RESTORATION OF FINISH.
4. VERIFY AND RESTORE CONTINUITY OF ALL EXISTING CIRCUITRY INDICATED TO REMAIN IN USE. WHERE REMOVAL OF EXISTING WIRING INTERRUPTS ELECTRICAL CONTINUITY OF CIRCUITS WHICH ARE TO REMAIN, FURNISH AND INSTALL ALL REQUIRED CIRCUITRY, CONDUIT, JUNCTION BOXES, ETC. TO INSURE CONTINUED ELECTRICAL CONTINUITY.
5. RELOCATE AND RECONNECT ANY MECHANICAL EQUIPMENT AND ANY ELECTRIC FIXTURES, DEVICES OR EQUIPMENT THAT MUST BE RELOCATED IN ORDER TO ACCOMPLISH THE REVISIONS INDICATED ON THE DRAWINGS OR INDICATED IN THE SPECIFICATIONS OR TO MEET NEC CODE REQUIRED CLEARANCES.
6. ELECTRIC CONTRACTOR TO FURNISH AND INSTALL BLANK JUNCTION BOX COVERS ON ALL EXISTING JUNCTION BOXES WITHIN THE CONSTRUCTION AREA THAT ARE NOT BEING DEMOLISHED.

DEMOLITION PLAN NOTES:

- 1 EXISTING FIXTURE TO REMAIN. UNLESS NOTED OTHERWISE.
- 2 ALL FIXTURES TO BE DEMOLISHED. MAINTAIN CIRCUIT CONTINUITY OF ANY DOWNSTREAM DEVICE.
- 3 FIXTURE TO BE DEMOLISHED.
- 4 TEMPORARILY REMOVE EXIT SIGNS AND REINSTALL DURING NEW WORK. REFER TO NEW WORK PLANS FOR ADDITIONAL INFORMATION.

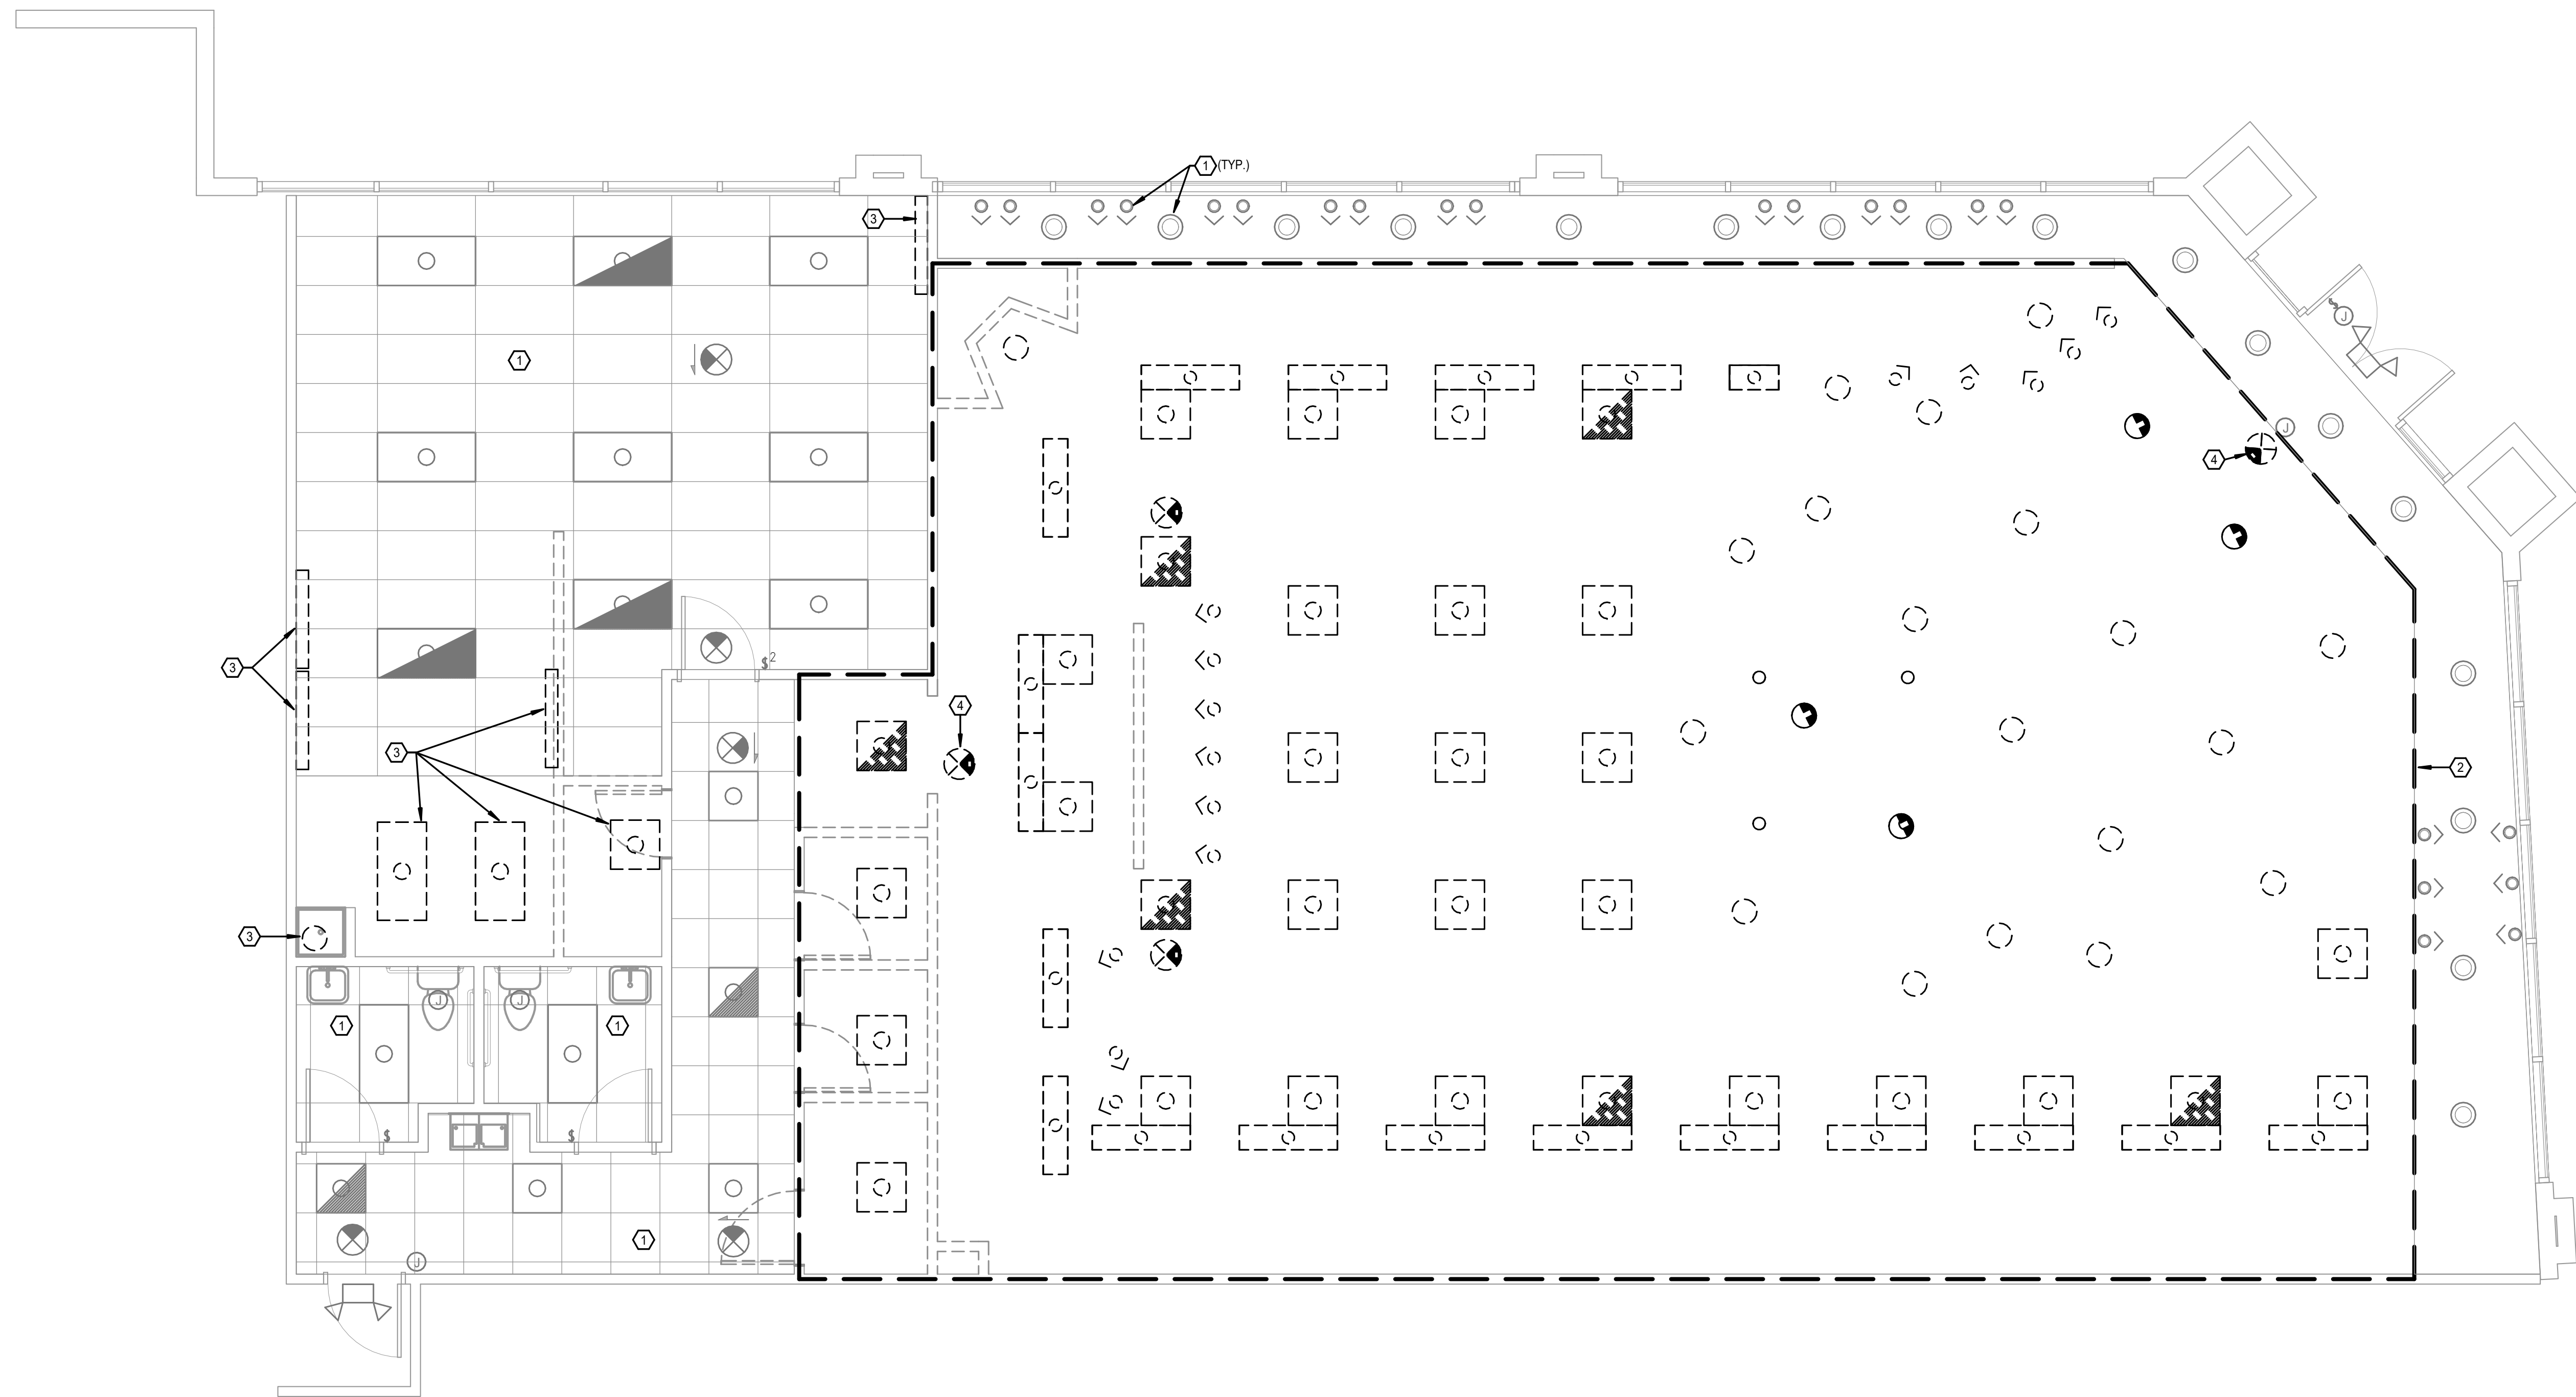

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project title

**RED DEVELOPMENT
 SUMMIT FAIR
 910 G NW Blue Pkwy
 Lee's Summit, MO 64086**

project number

Project Number


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No. Description: Date:

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DATE SIGNED: 06-14-23

drawing title

LIGHTING PLAN - DEMOLITION

drawing number

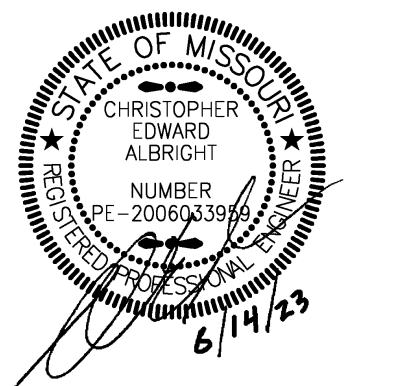DE101

LIGHTING PLAN - DEMOLITION


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GENERAL DEMOLITION NOTES:

1. UNLESS NOTED OTHERWISE, SERVICES AND EQUIPMENT SHOWN FULL TONE ARE NEW WORK, HALF TONE ARE EXISTING TO REMAIN, AND FULL TONE AND DASHED ARE EXISTING TO BE DEMOLISHED.
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3. DISCONNECT AND REMOVE ALL CIRCUITRY, DISCONNECTS, CONTROLLERS AND CONDUIT THAT BECOMES UNNECESSARY AS A RESULT OF THE REMOVAL OF FIXTURES, DEVICES OR EQUIPMENT INDICATED TO BE REMOVED. LABEL ALL CIRCUIT BREAKERS IN EXISTING PANELBOARDS NO LONGER IN USE AS SPARE. CAP ALL UNUSED CONDUIT AND WIRING BEYOND THE FLOOR LINE OR WALL LINE TO FACILITATE RESTORATION OF FINISH.
4. VERIFY AND RESTORE CONTINUITY OF ALL EXISTING CIRCUITRY INDICATED TO REMAIN IN USE. WHERE REMOVAL OF EXISTING WIRING INTERRUPTS ELECTRICAL CONTINUITY OF CIRCUITS WHICH ARE TO REMAIN, FURNISH AND INSTALL ALL REQUIRED CIRCUITRY, CONDUIT, JUNCTION BOXES, ETC. TO INSURE CONTINUED ELECTRICAL CONTINUITY.
5. RELOCATE AND RECONNECT ANY MECHANICAL EQUIPMENT AND ANY ELECTRIC FIXTURES, DEVICES OR EQUIPMENT THAT MUST BE RELOCATED IN ORDER TO ACCOMPLISH THE REVISIONS INDICATED ON THE DRAWINGS OR INDICATED IN THE SPECIFICATIONS OR TO MEET NEC CODE REQUIRED CLEARANCES.
6. ELECTRIC CONTRACTOR TO FURNISH AND INSTALL BLANK JUNCTION BOX COVERS ON ALL EXISTING JUNCTION BOXES WITHIN THE CONSTRUCTION AREA THAT ARE NOT BEING DEMOLISHED.

DEMOLITION PLAN NOTES:

- 1 RECEPTACLE TO BE DEMOLISHED. MAINTAIN CONTINUITY FOR ANY DOWNSTREAM CIRCUITS.
- 2 EXISTING FIRE ALARM DEVICE TO BE TEMPORARY REMOVED AND RELOCATED DURING NEW WORK.
- 3 EXISTING LIGHTING CONTACTORS AND TIMER CONTROLS.
- 4 EXISTING LOW-VOLTAGE EQUIPMENT FOR SECURITY/TELECOM AND OTHERS. REMOVE ALL UN-USED OLD EQUIPMENT AFTER VERIFYING WITH OWNER TO MAKE ROOM FOR LULULEMONS EQUIPMENT. MAINTAIN ALL OUTLETS FOR RE-USE DURING NEW WORK.

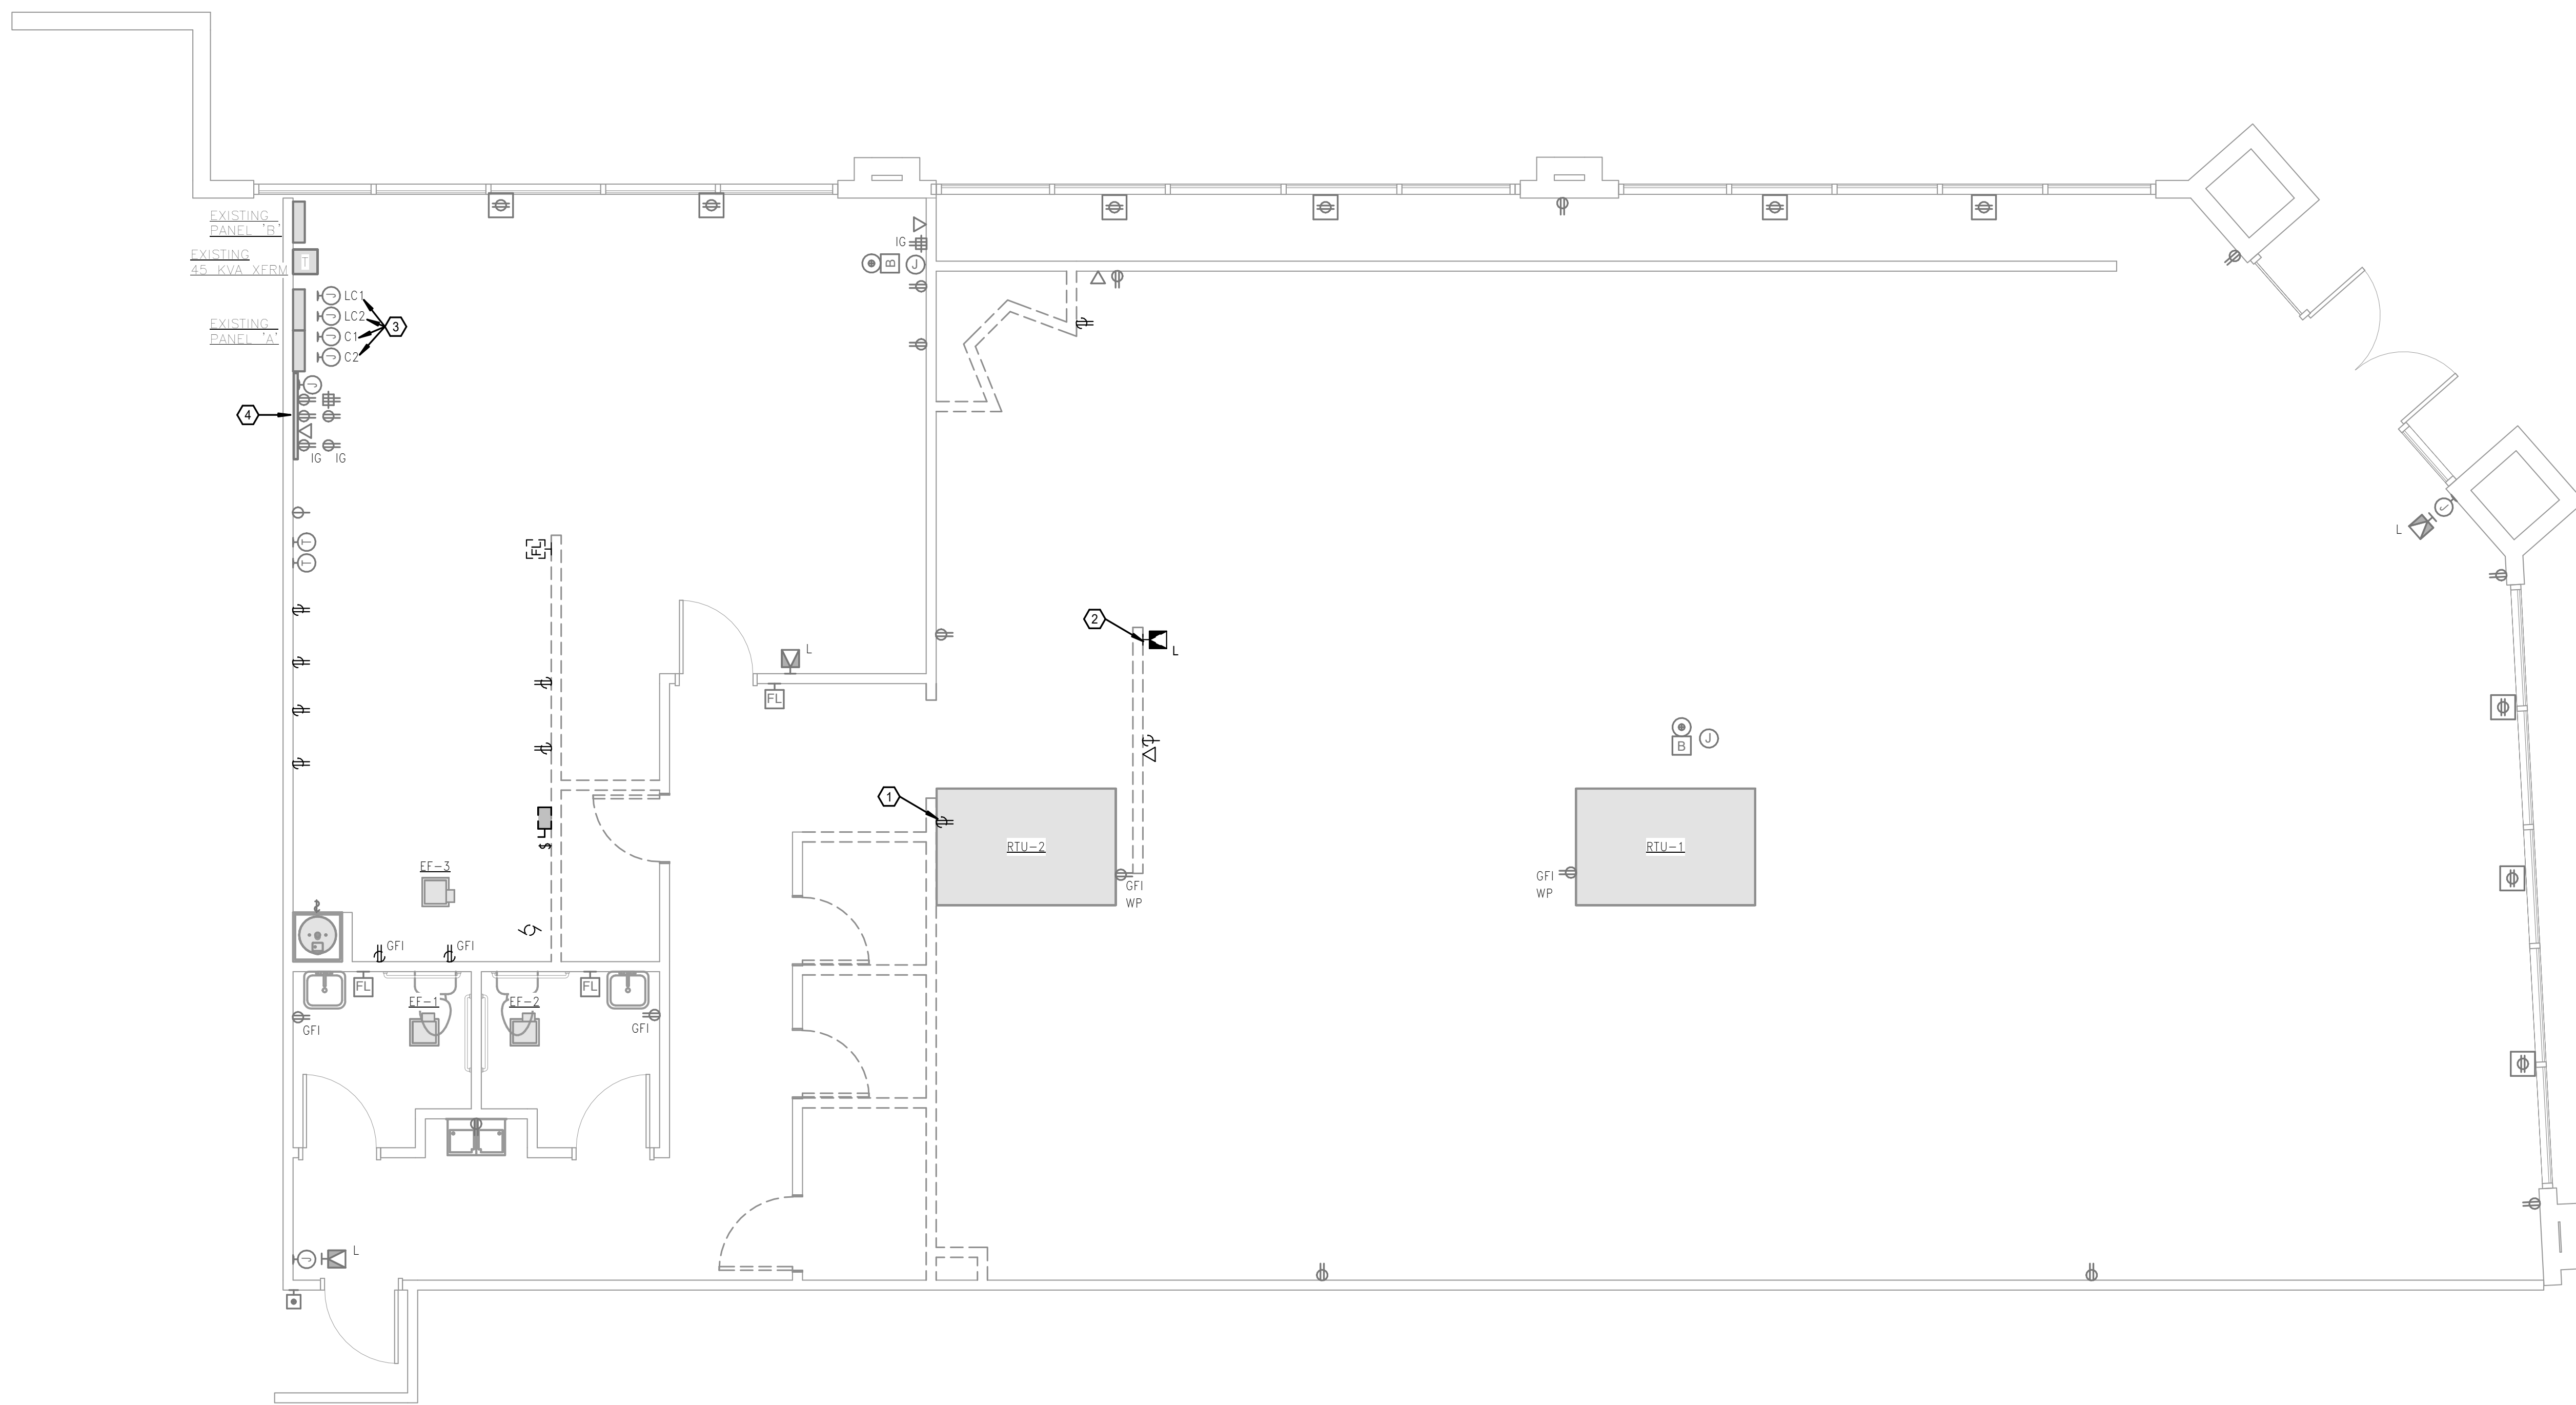

POWER PLAN - DEMOLITION
SCALE: 1/4" = 1'-0" **1**

smith & boucher
engineers
25618 west 103rd St. olathe, ks 66061
phone 913.345.2127 fax 913.345.0617
SBI PROJECT NUMBER: 2318400

Kloverarchitects
8813 PENROSE LANE, SUITE 400 • LENEXA, KS 66219
PH: 913.649.8181 • FX: 913.649.1275 • www.klover.net

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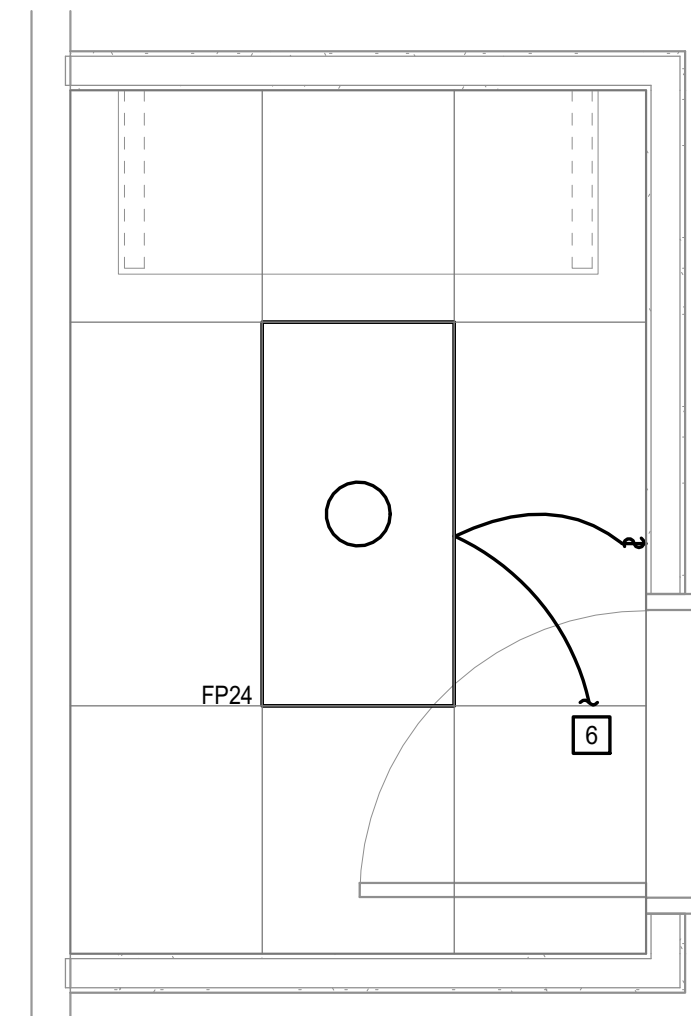
project title
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SUMMIT FAIR
910 G NW Blue Pkwy
Lee's Summit, MO 64086

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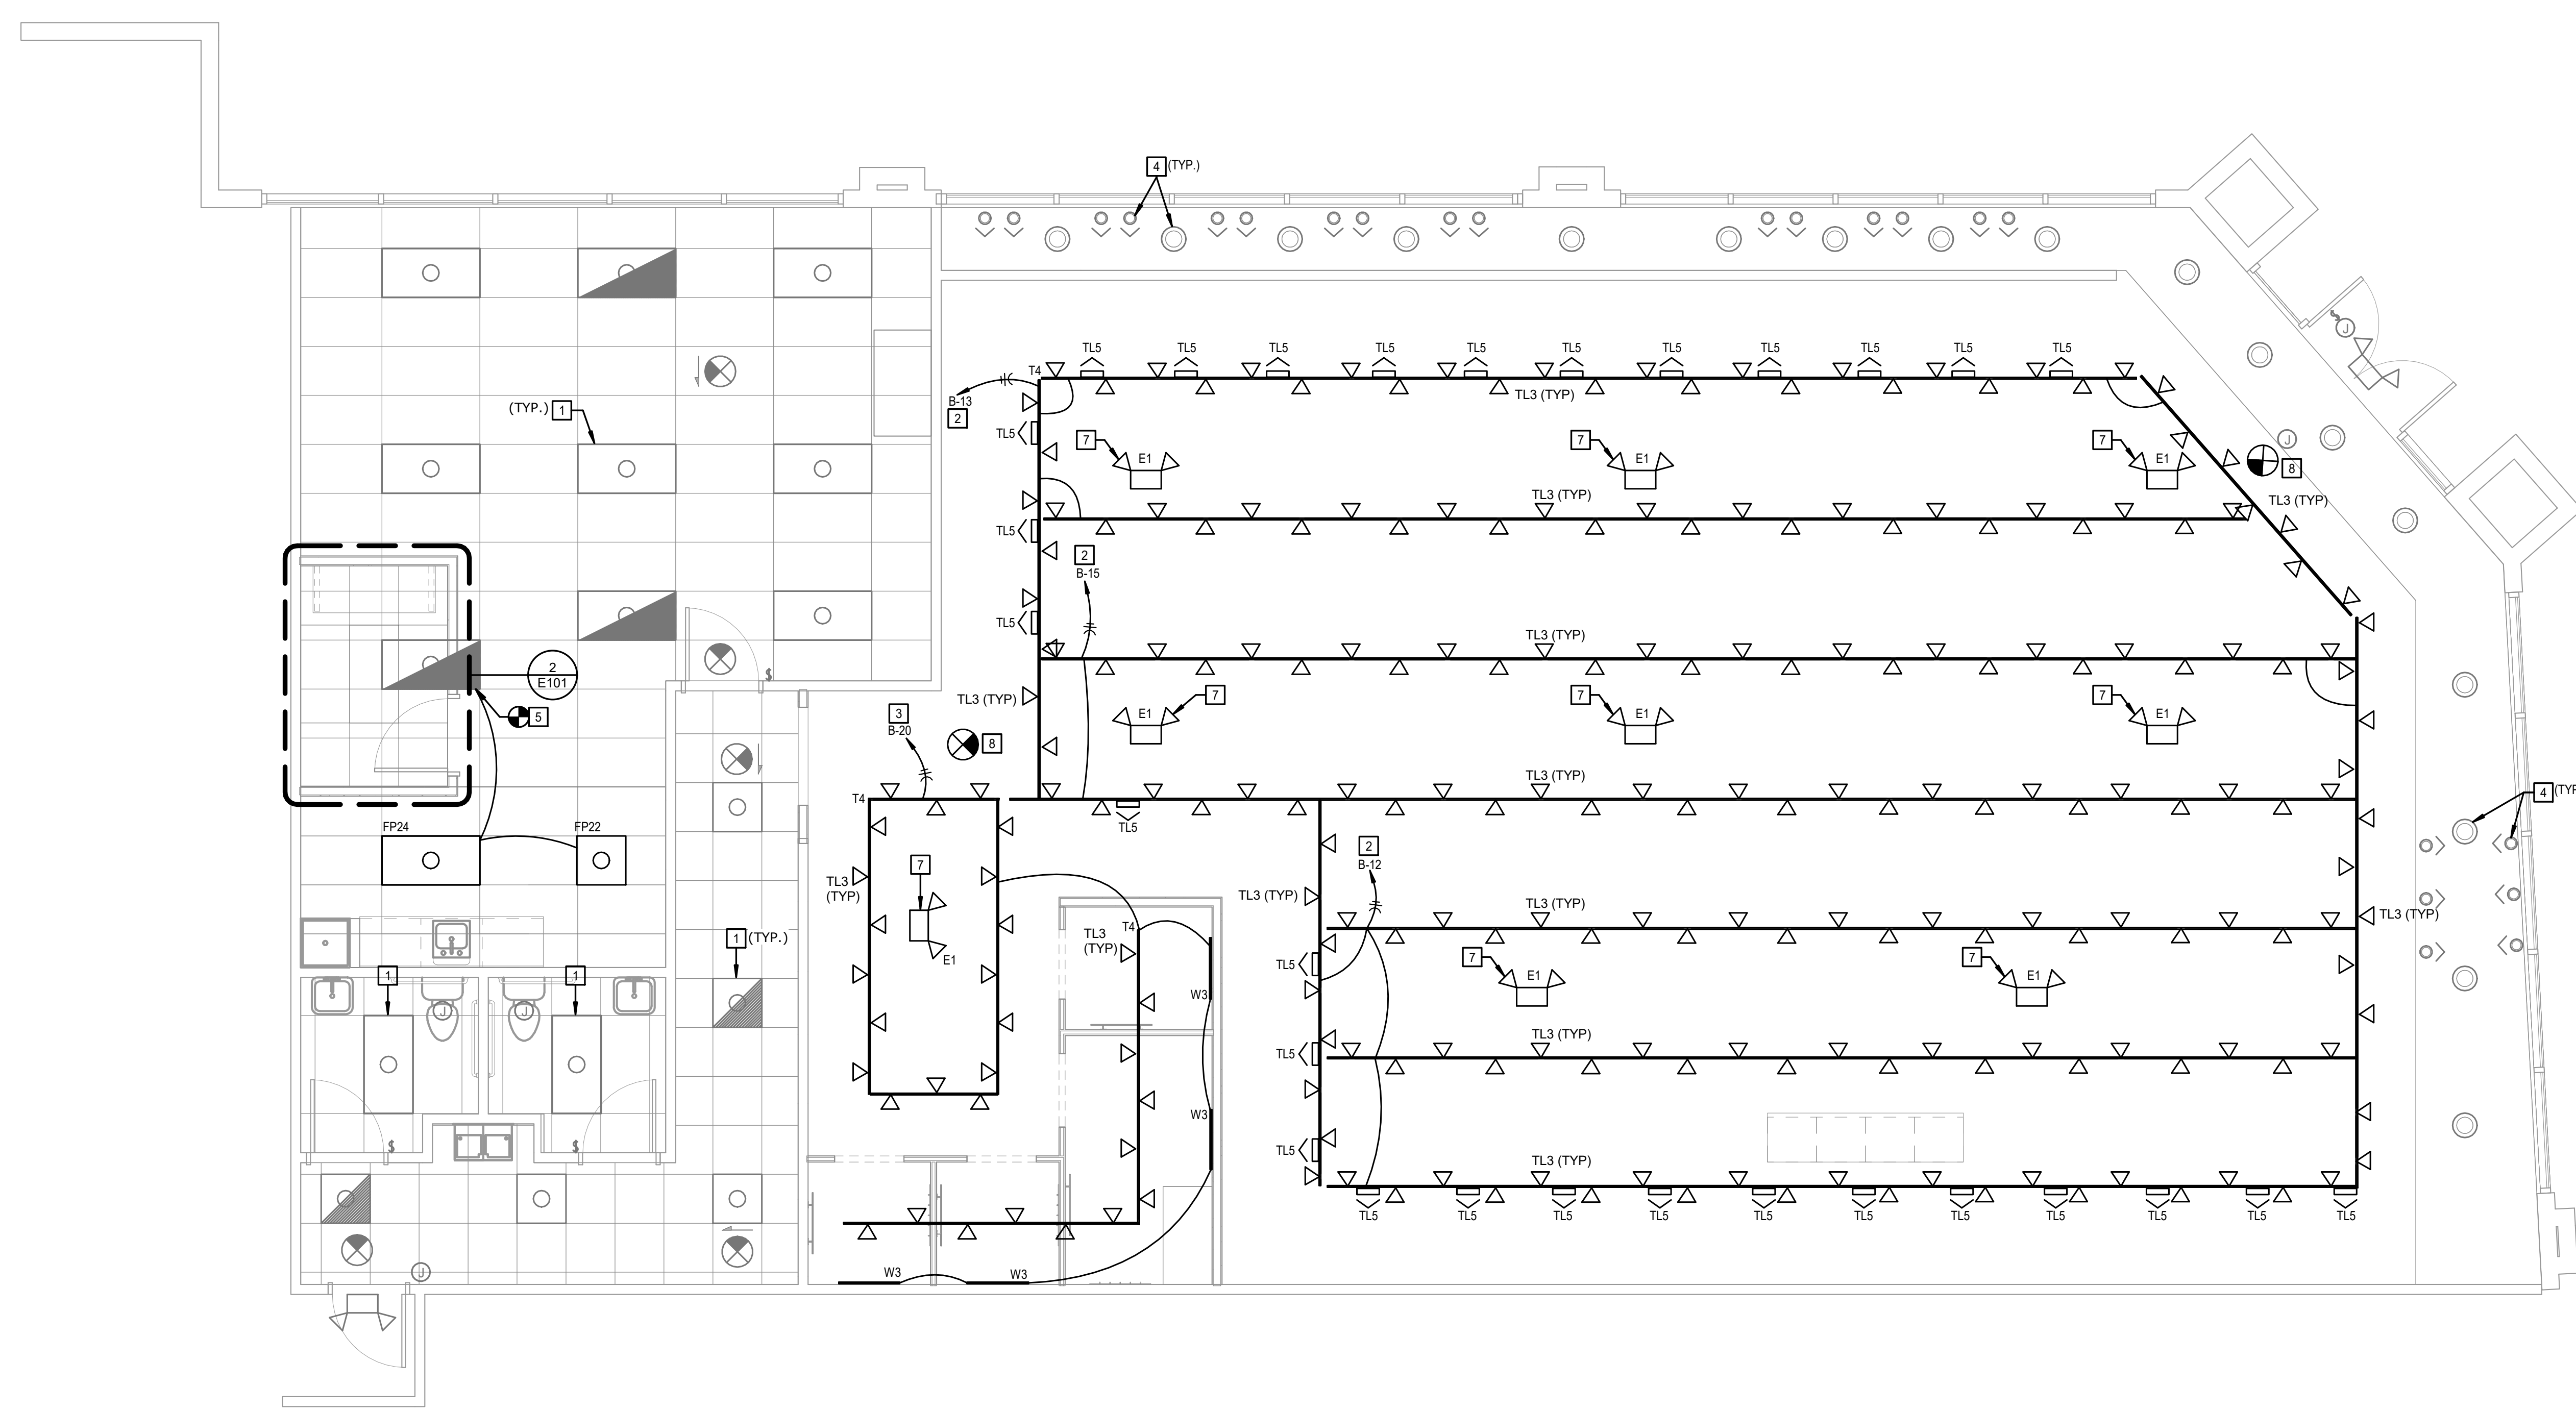
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STATE OF MISSOURI
CHRISTOPHER EDWARD ALBRIGHT
NUMBER PE-200662339
6/14/23

DATE SIGNED: 06-14-23
drawing title
POWER PLAN - DEMOLITION

drawing number
DE201



ENLARGED LIGHTING PLAN - MANAGER'S OFFICE (2)
SCALE: 1/2" = 1'-0"



GENERAL NOTES:

1. CIRCUIT ALL EMERGENCY DRIVERS AND EXIT SIGNS WITH AN UNSWITCHED HOT CONDUCTOR FROM LOCAL ROOM CIRCUIT.
2. REFER TO ARCHITECTURAL EXTERIOR ELEVATIONS FOR EXACT MOUNTING HEIGHTS/LOCATIONS FOR EXTERIOR BUILDING LIGHTING.
3. PROVIDE LOW VOLTAGE WIRING BETWEEN OCCUPANCY SENSOR AND TO CORRESPONDING POWER PACKS WITHIN EACH ROOM UNLESS NOTED OTHERWISE. REFER TO WIRING DIAGRAMS ON DETAILS SHEET FOR MORE INFORMATION.
4. REFER TO ARCHITECTURAL FLOORING PLANS AND REFLECTED CEILING PLANS OF EXACT MOUNTING LOCATIONS OF ALL LIGHT FIXTURES AND WALL MOUNTED ELECTRICAL DEVICES.
5. PATCH AND REPAIR ALL OPENINGS CREATED THAT PENETRATE FIRE RATED WALLS, FLOORS AND CEILING USING UL APPROVED METHODS AND MATERIALS CONSISTENT WITH THE RATING OF THE SURFACE PENETRATED.
6. 120V BRANCH CIRCUITING SHALL BE AS FOLLOWS, UNLESS NOTED OTHERWISE:

0-100' = #12 AWG
101'-150' = #10 AWG
151'-250' = #8 AWG

PLAN NOTES:

1. REPLACE ALL EXISTING 2X4 & 2X2 BULBS WITH LED EQUIVALENTS. EXISTING CONDITIONS SHOW THEY USE F32T8 FOR 2X4 AND F17T8 FOR 2X2. VERIFY IN FIELD EXACT BULB TYPES PRIOR TO INSTALL.
2. VERIFY IN FIELD EXISTING LIGHTING CONTACTOR CIRCUITS AND RE-USE EXISTING SALES FLOOR LIGHTING CIRCUITS ON CONTACTOR IF DIFFERENT FROM WHAT'S CALLED OUT ON PLAN. INTENT IS TO RE-USE EXISTING LIGHTING CONTACTOR AND CIRCUITS FOR SALES FLOOR LIGHTING.
3. CONNECT CIRCUIT THROUGH EXISTING LIGHTING CONTACTOR NEXT TO PANEL. VERIFY IN FIELD EXISTING SPARE AND CONTROL THROUGH EXISTING TIMER.
4. REPLACE ALL BULBS WITH LED EQUIVALENT. EXISTING CONDITIONS SHOW THEY USE A GX24 BASE FOR THE DOWNLIGHTS AND GX5.3 FOR THE ADJUSTABLE DOWNLIGHTS. VERIFY IN FIELD EXACT BULB TYPES PRIOR TO INSTALL.
5. CONNECT LIGHTING TO EXISTING CIRCUIT.
6. CONNECT TO EXISTING CIRCUIT BACK OF HOUSE LIGHTING CIRCUIT A-7.
7. EMERGENCY FIXTURES TO BE PENDANT MOUNTED FROM CEILING AT SAME HEIGHT AS TRACK FIXTURES. COORDINATE HEIGHTS IN FIELD. CONNECT LIGHTING CIRCUIT FROM PANEL A: 277V PANEL. THIS MAY BE CONNECTED TO CIRCUIT A-5 AS IT RELATES TO OTHER EMERGENCY FIXTURES. VERIFY IF CIRCUIT IS LOADED; PUT ON NEW 20A-1P SPARE FROM PANEL A, IF SO.
8. EXISTING EXIT SIGNS TO BE RE-INSTALLED FROM TEMPORARY REMOVAL. EXIT SIGNS TO BE PENDANT MOUNT EXIT SIGNS AS REQUIRED TO BE INSTALLED DURING NEW CEILING WORK.




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project title
**RED DEVELOPMENT
SUMMIT FAIR
910 G NW Blue Pkwy
Lee's Summit, MO 64086**

project number
Project Number
drawing issuance
Permit Set 06/14/23
drawing revisions
No. Description: Date:




DATE SIGNED: 06-14-23
drawing title
LIGHTING PLAN - NEW WORK

drawing number
E101

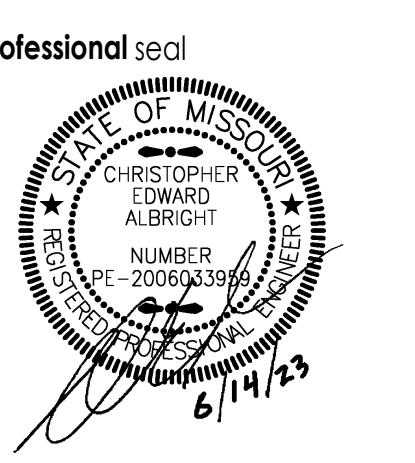LIGHTING PLAN - NEW WORK (1)
SCALE: 1/4" = 1'-0"

smith & boucher
engineers
25618 west 103rd St olathe, ks 66061
phone 913.345.2127 fax 913.345.0617
SBI PROJECT NUMBER: 2318400

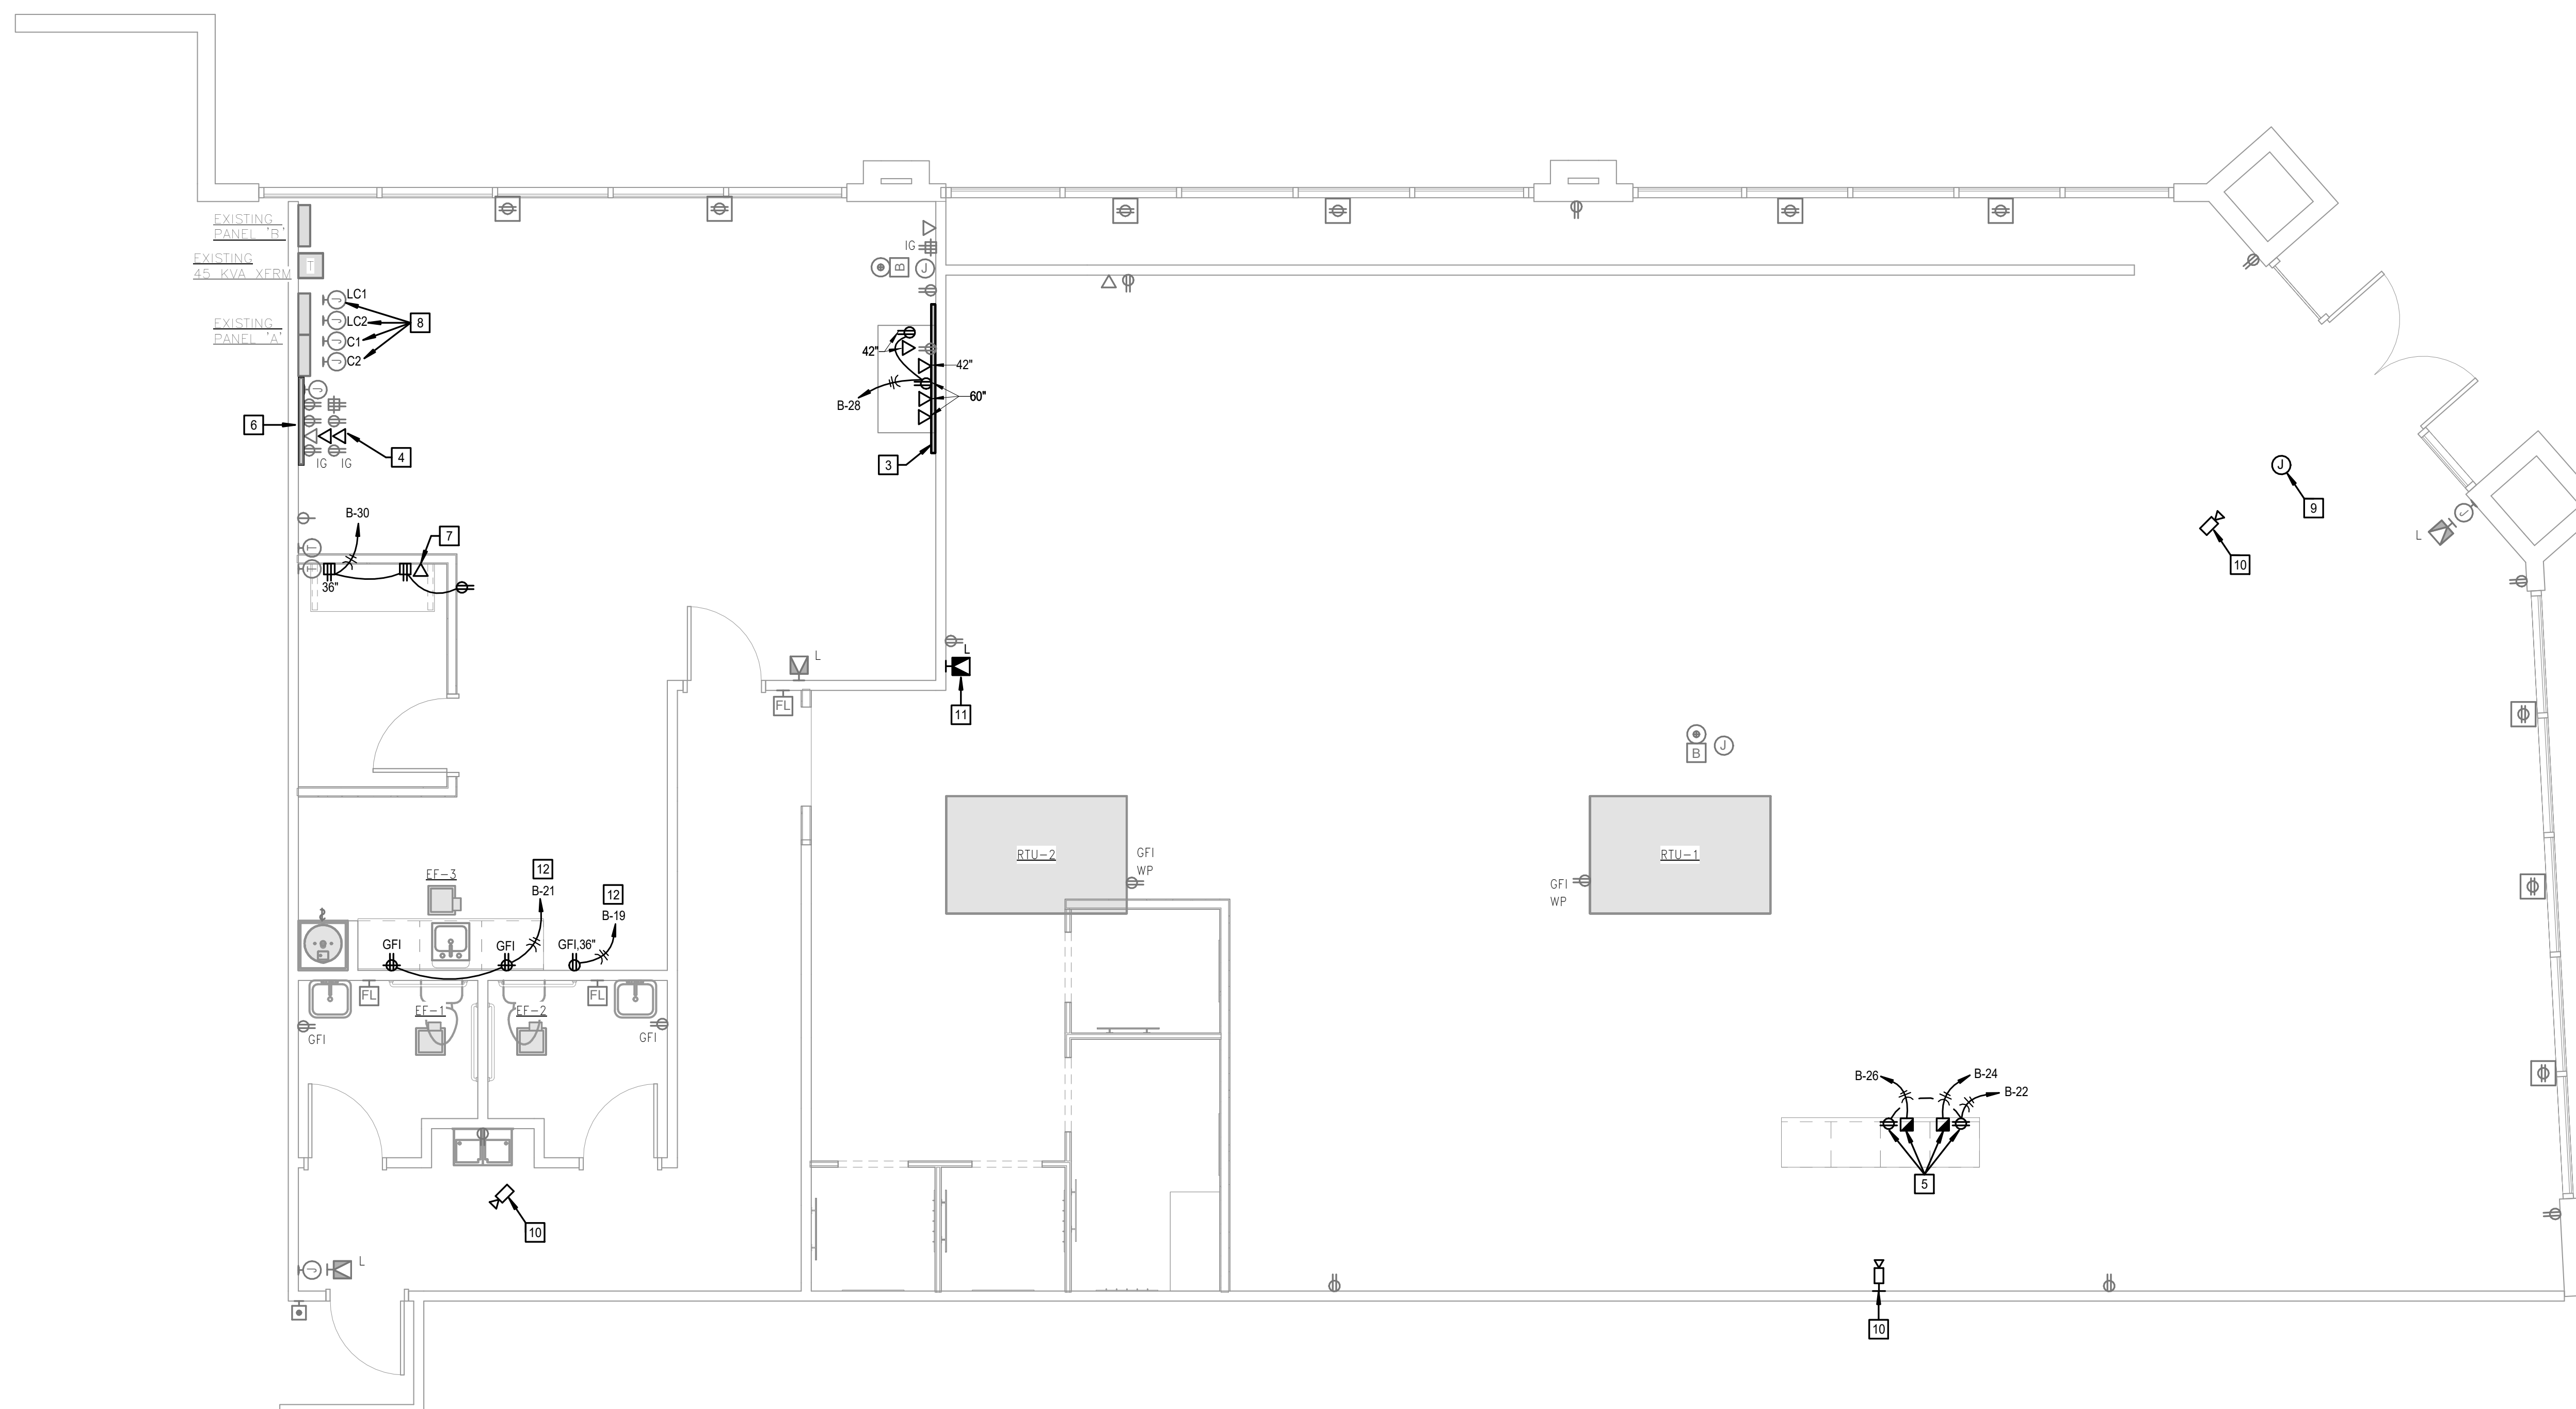

- GENERAL NOTES:**
- REFER TO ARCHITECTURAL PLANS AND ELEVATIONS FOR EXACT MOUNTING LOCATIONS OF ALL CEILING, FLOOR, AND WALL MOUNTED ELECTRICAL DEVICES.
 - REFER TO M/E SCHEDULES AND DETAILS FOR MECHANICAL EQUIPMENT CIRCUITING INFORMATION.
 - SPECIAL MOUNTING HEIGHTS NOTED ON PLANS ARE TO CENTER OF JUNCTION BOX.
 - 120V BRANCH CIRCUITING SHALL BE AS FOLLOWS, UNLESS NOTED OTHERWISE.
 - 0-100' = #12AWG.
 - 101-150' = #10AWG.
 - 151-250' = #8AWG.
 - GROUND CONDUCTOR AND RACEWAY SHALL BE INCREASED AS REQUIRED.
 - ALL ELECTRICAL CONDUIT AND INFRASTRUCTURE THAT PENETRATES A RATED WALL, FLOOR, OR CEILING ARE TO BE SEALED WITH UL APPROVED METHODS AND MATERIALS CONSISTENT WITH THE RATING OF THE ASSEMBLY PENETRATED.

- PLAN NOTES:**
- PROVIDE (1) 2'-0" WHIP WITH A QUAD THAT WILL ATTACH INSIDE THE MILLWORK BY OTHERS. TRENCH AS REQUIRED TO BRING THE CONDUITS UNDER THE CASHWRAP LOCATION. REFER TO LULULEMONS CONSTRUCTION STANDARDS & SPECIFICATIONS FOR ADDITIONAL INFORMATION.
 - PROVIDE (1) DEDICATED QUAD RECEPTACLE & (1) DUPLEX RECEPTACLE (IN-GROUND) AT "POS" LOCATION. COORDINATE WITH ARCHITECT/OWNER EXACT LOCATION OF "POS" PRIOR TO ROUGH-IN. ALSO PROVIDE 1" CONDUIT FOR RUNNING (3) CAT6 CABLING BY OTHERS PER TILL AT THE LOCATION SHOWN. REFER TO LULULEMONS CONSTRUCTION STANDARDS & SPECIFICATIONS FOR ADDITIONAL INFORMATION. TRENCH AS REQUIRED FOR BRINGING POWER & CONDUIT TO THE TILL LOCATIONS.
 - 6'-0"x2'-0"x3/4" FIRE RATED PLYWOOD INSTALLED AT 5'-3 1/4" ON CENTER FOR RFID RECEIVING DESK. SURFACE MOUNTED PLYWOOD TO BE PAINTED TO MATCH THE COLOUR OF THE WALL. REFER TO LULULEMONS CONSTRUCTION STANDARDS & SPECIFICATIONS FOR ADDITIONAL INFORMATION. TRENCH AS REQUIRED FOR BRINGING POWER & CONDUIT TO THE TILL LOCATIONS. COORDINATE EXACT LOCATION WITH LULULEMON & ARCHITECT.
 - RE-USE EXISTING OUTLETS FOR REQUIRED LULULEMON TELECOM & NETWORKING RACK ON EXISTING PLYWOOD BACKBOARD. PROVIDE ADDITIONAL (2) DATA OUTLET ROUGH-IN ON AVAILABLE SPACE. REFER TO REFER TO LULULEMONS CONSTRUCTION STANDARDS & SPECIFICATIONS FOR ADDITIONAL INFORMATION.
 - PROVIDE (1) DEDICATED QUAD RECEPTACLE, (3) DATA OUTLETS & (1) DUPLEX RECEPTACLE (IN-GROUND) AT "POS" LOCATION. COORDINATE WITH ARCHITECT/OWNER EXACT LOCATION OF "POS" PRIOR TO ROUGH-IN. ALSO PROVIDE 1" CONDUIT FOR RUNNING (3) CAT6 CABLING BY OTHERS PER TILL AT THE LOCATION SHOWN. REFER TO LULULEMONS CONSTRUCTION STANDARDS & SPECIFICATIONS FOR ADDITIONAL INFORMATION. TRENCH AS REQUIRED FOR BRINGING POWER & CONDUIT TO THE TILL LOCATIONS.
 - VERIFY IN FIELD IF EXISTING FOR (3) 3/4" CONDUIT ON TOP OF PLYWOOD FOR SECURITY, MAIN PHONE LINE & OTHER FUTURE CONDUIT FOR FUTURE USES ROUTED UP TO DECK. IF THIS DOESN'T EXIST, PROVIDE MISSING CONDUITS. REFER TO LULULEMONS CONSTRUCTION STANDARDS & SPECIFICATIONS FOR ADDITIONAL INFORMATION.
 - PROVIDE (1) 1" CONDUIT TO A LARGER JUNCTION TO ACCOMMODATE A FACE PLATE FOR (6) DATA OUTLETS BY OTHERS. REFER TO LULULEMONS CONSTRUCTION STANDARDS & SPECIFICATIONS FOR ADDITIONAL INFORMATION.
 - EXISTING LIGHTING CONTACTORS AND TIMER CONTROLS.
 - LOCATION REFERENCE FOR TRAFFIC COUNTER. WORK TO BE COMPLETED BY TENANT.
 - LOCATION REFERENCE FOR SECURITY CAMERA. WORK TO BE COMPLETED BY TENANT.
 - EXISTING FIRE ALARM DEVICE RELOCATED. RE-CONNECT TO EXISTING FIRE ALARM SYSTEM AS REQUIRED.
 - VERIFY IN FIELD IF CIRCUIT CAN BE UTILIZED. IF CIRCUIT IS NOT AVAILABLE, CIRCUIT TO SPARE 20A-1P BREAKER ON PANEL B.

POWER PLAN - NEW WORK 1
SCALE: 1/4" = 1'-0"

smith & boucher
engineers
25618 west 103rd St olathe, ks 66061
phone 913.345.2127 fax 913.345.0617
SBI PROJECT NUMBER: 2318400

Kloverarchitects
8813 PENROSE LANE, SUITE 400 • LENEXA, KS 66219
PH: 913.649.8181 • FX: 913.649.1275 • www.klover.net

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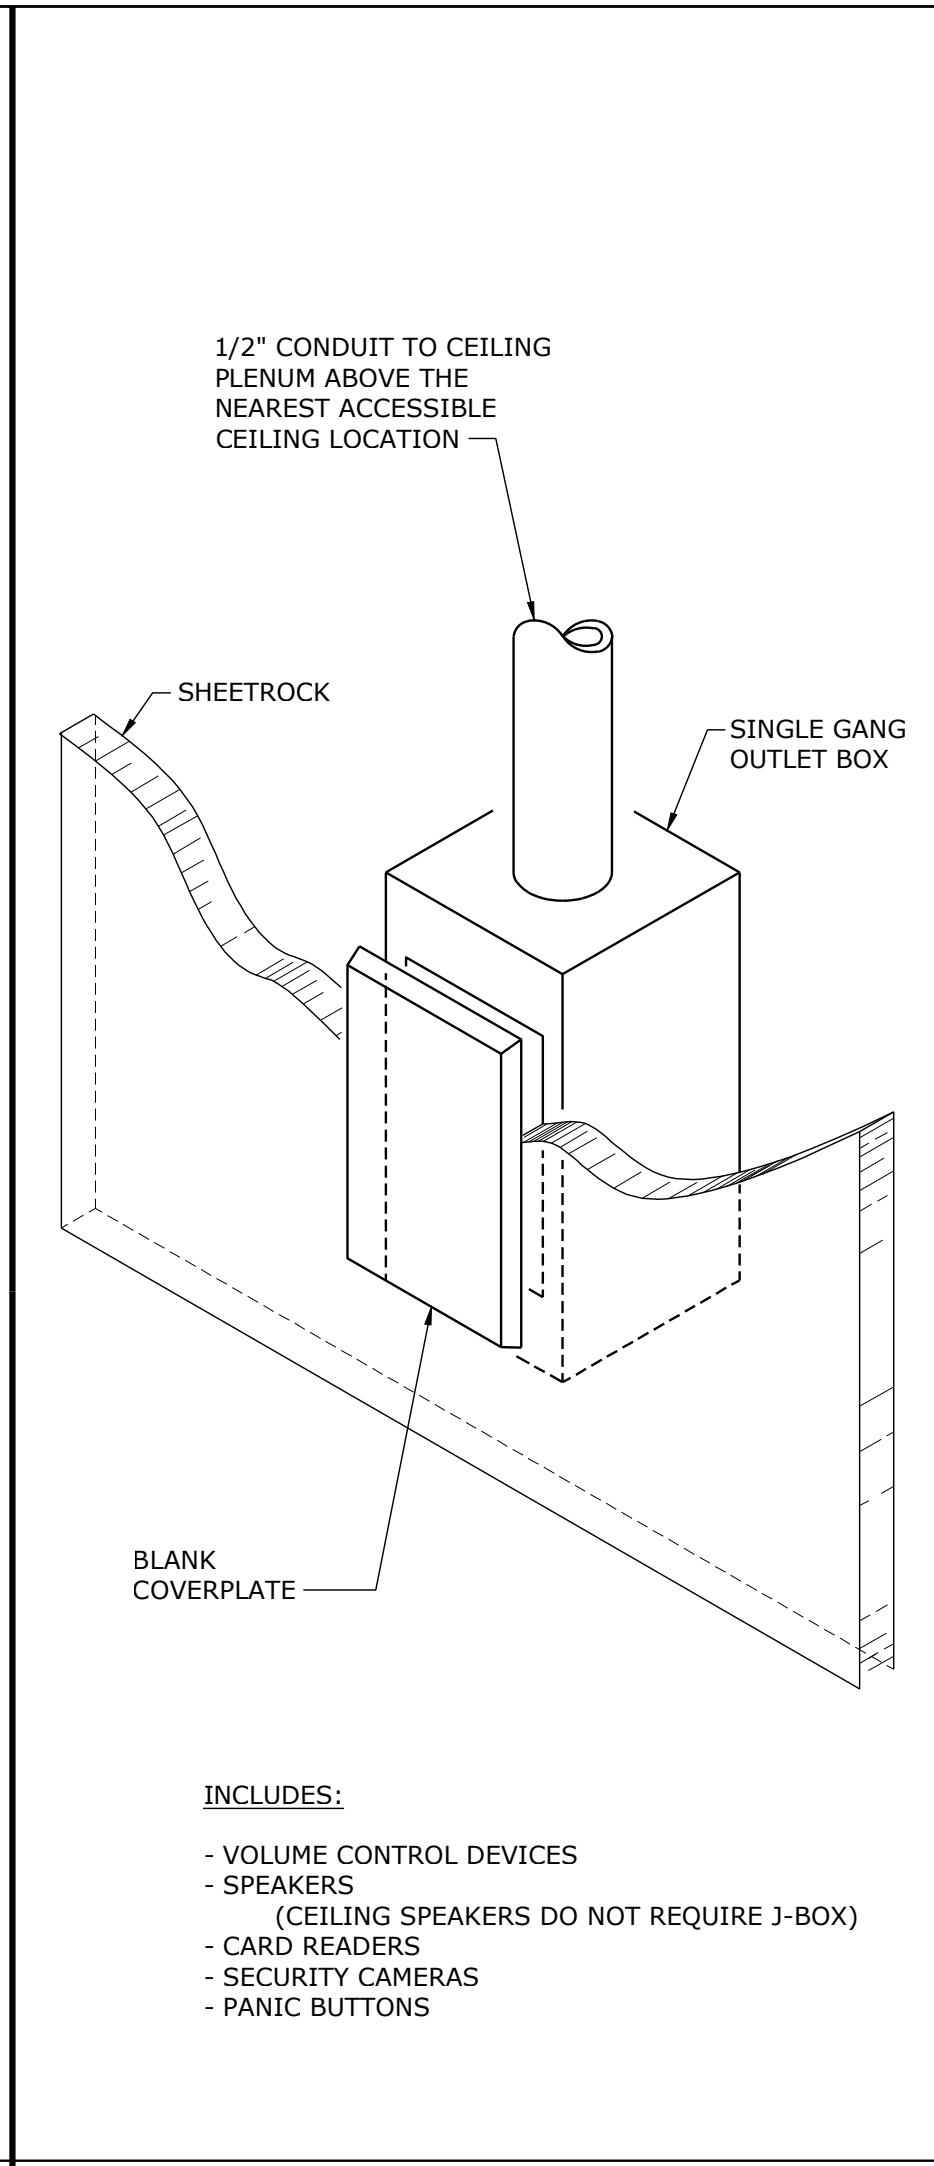
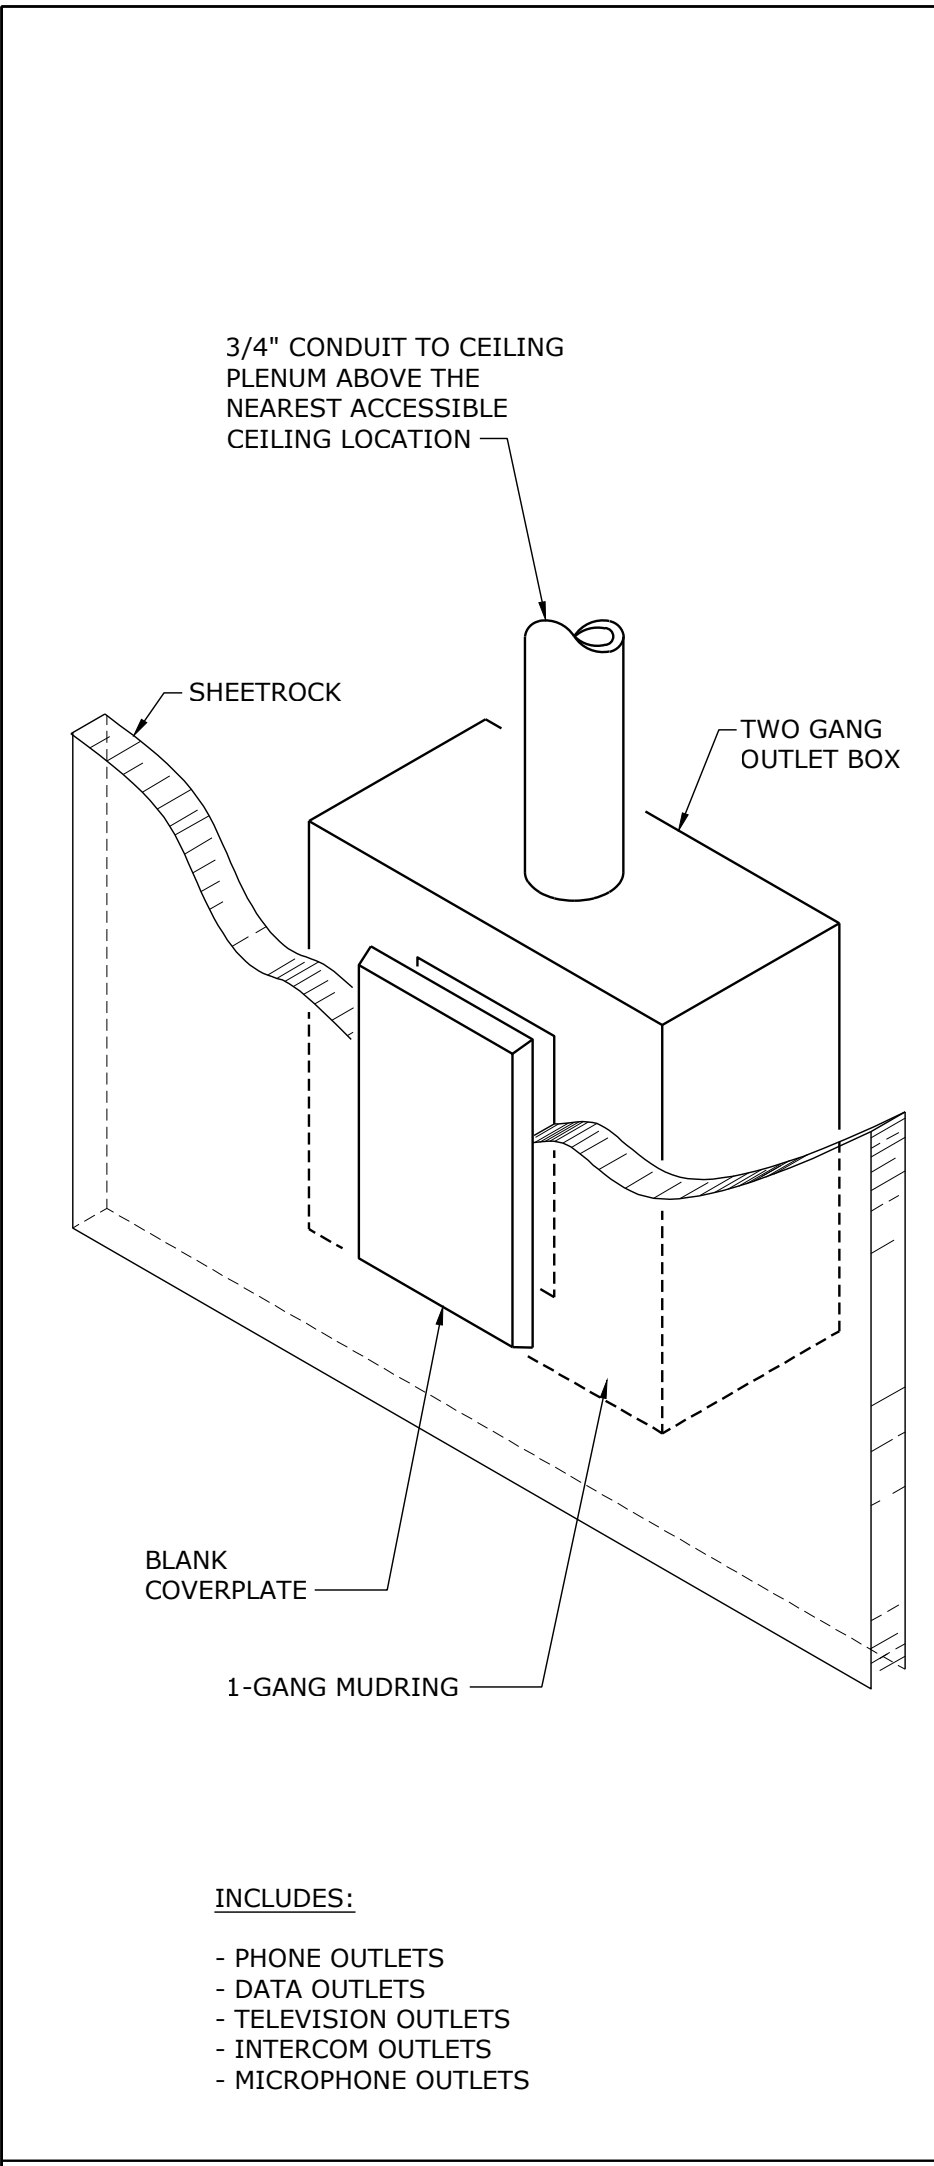
project title
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SUMMIT FAIR
910 G NW Blue Pkwy
Lee's Summit, MO 64086**

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Project Number
drawing issuance
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No. Description: Date:

professional seal
STATE OF MISSOURI
CHRISTOPHER EDWARD ALBRIGHT
NUMBER
PE-200623392
6/14/23


DATE SIGNED: 06-14-23
drawing title
POWER PLAN - NEW WORK

drawing number
E201




COMMUNICATIONS / AV OUTLET DETAIL
NOT TO SCALE

PUBLIC ADDRESS / SECURITY OUTLET DETAIL
NOT TO SCALE

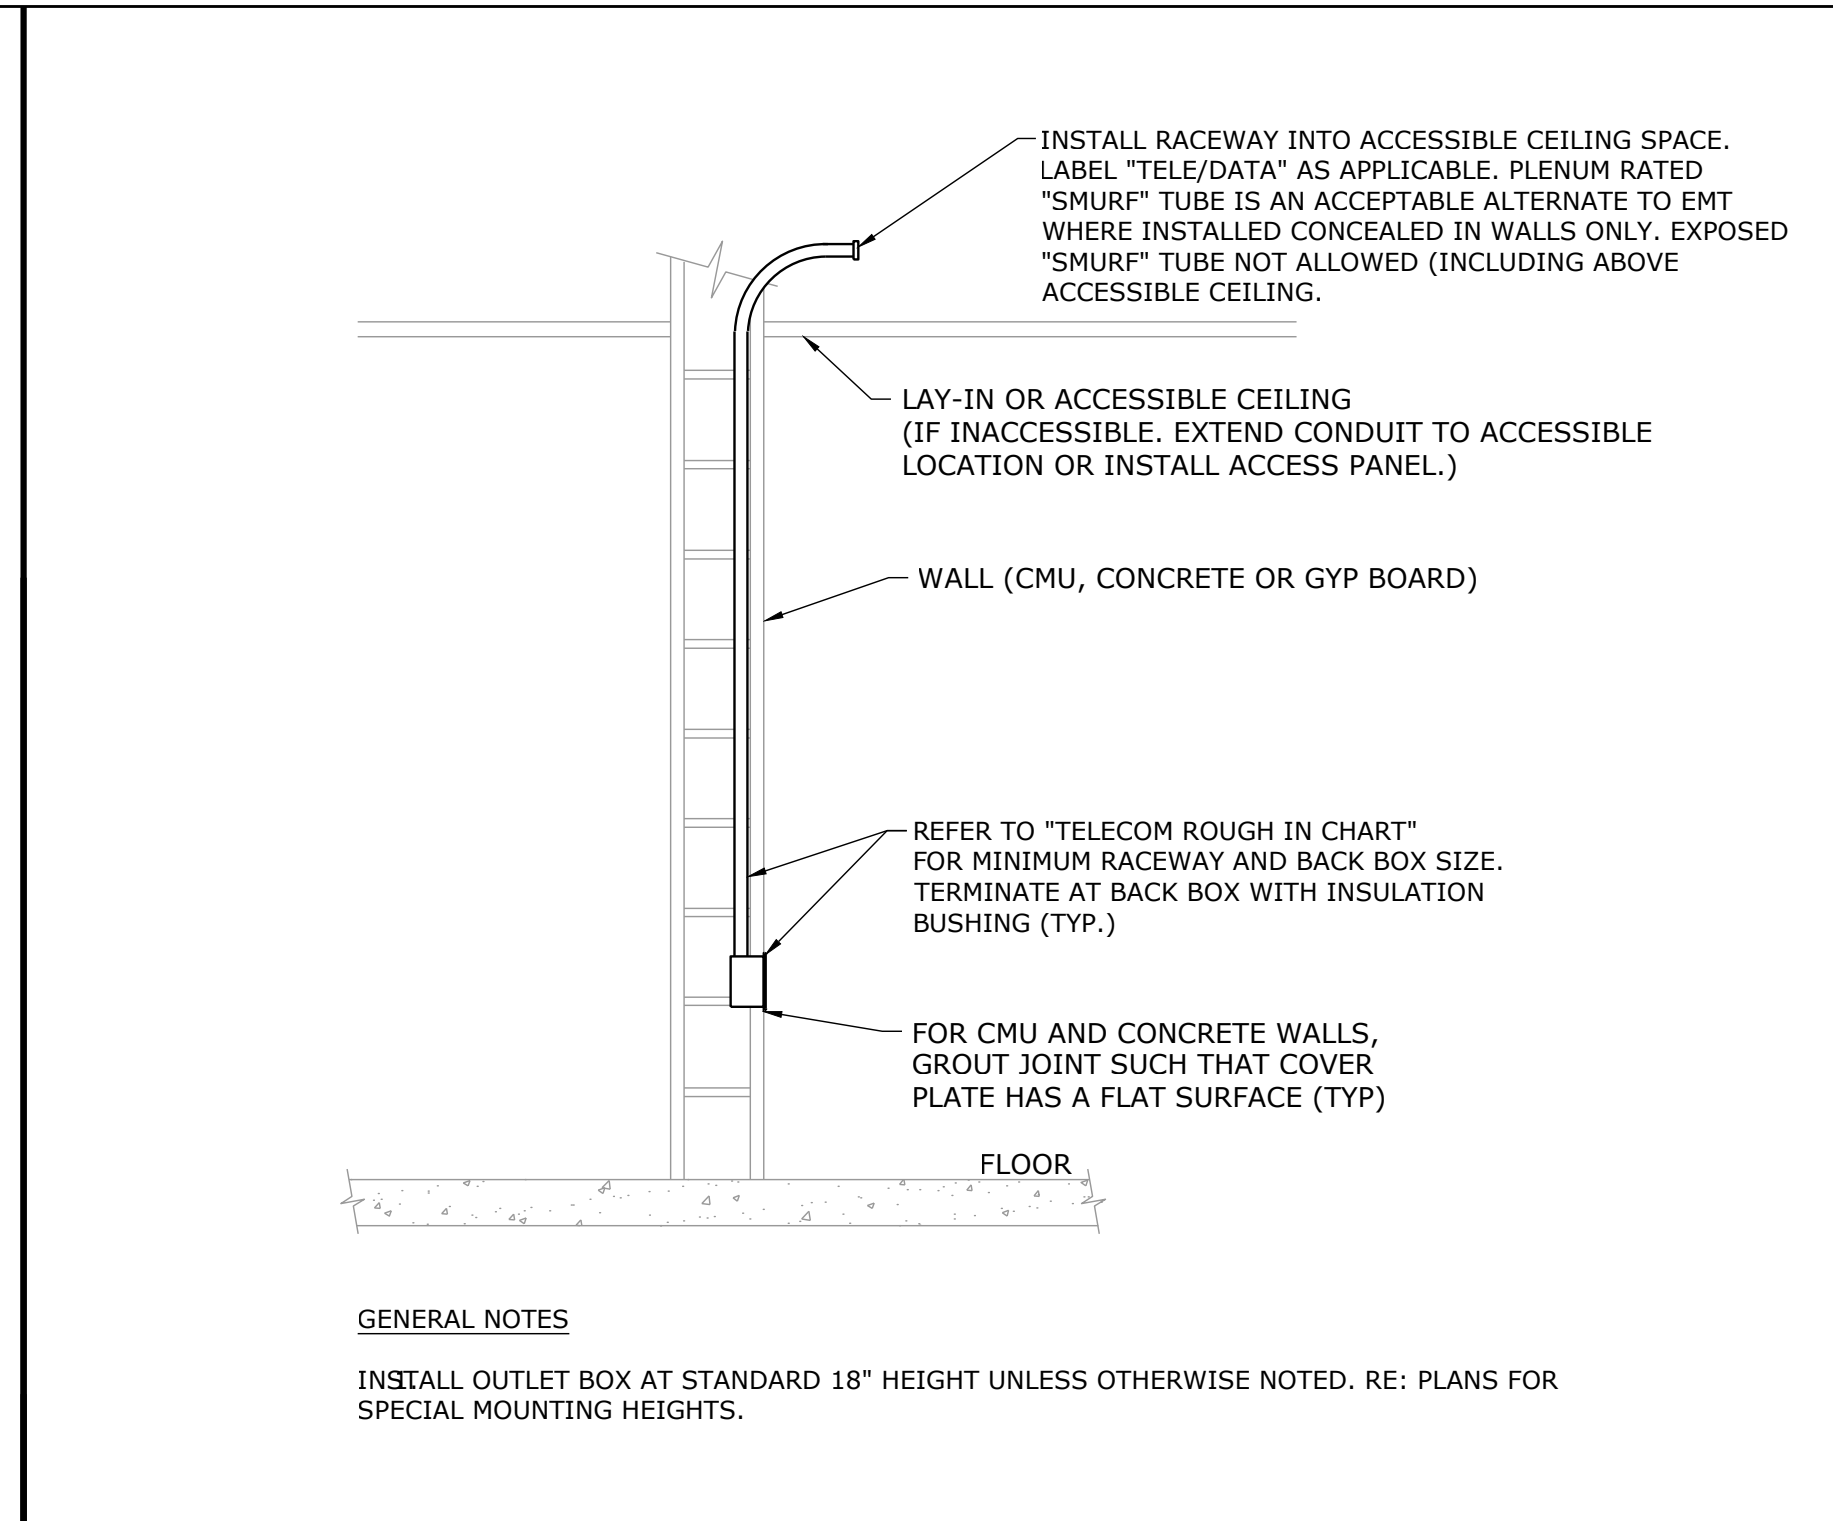

COMMUNICATIONS CONDUIT STUB UP
SCALE: NO SCALE (SYMBOLS ▽)

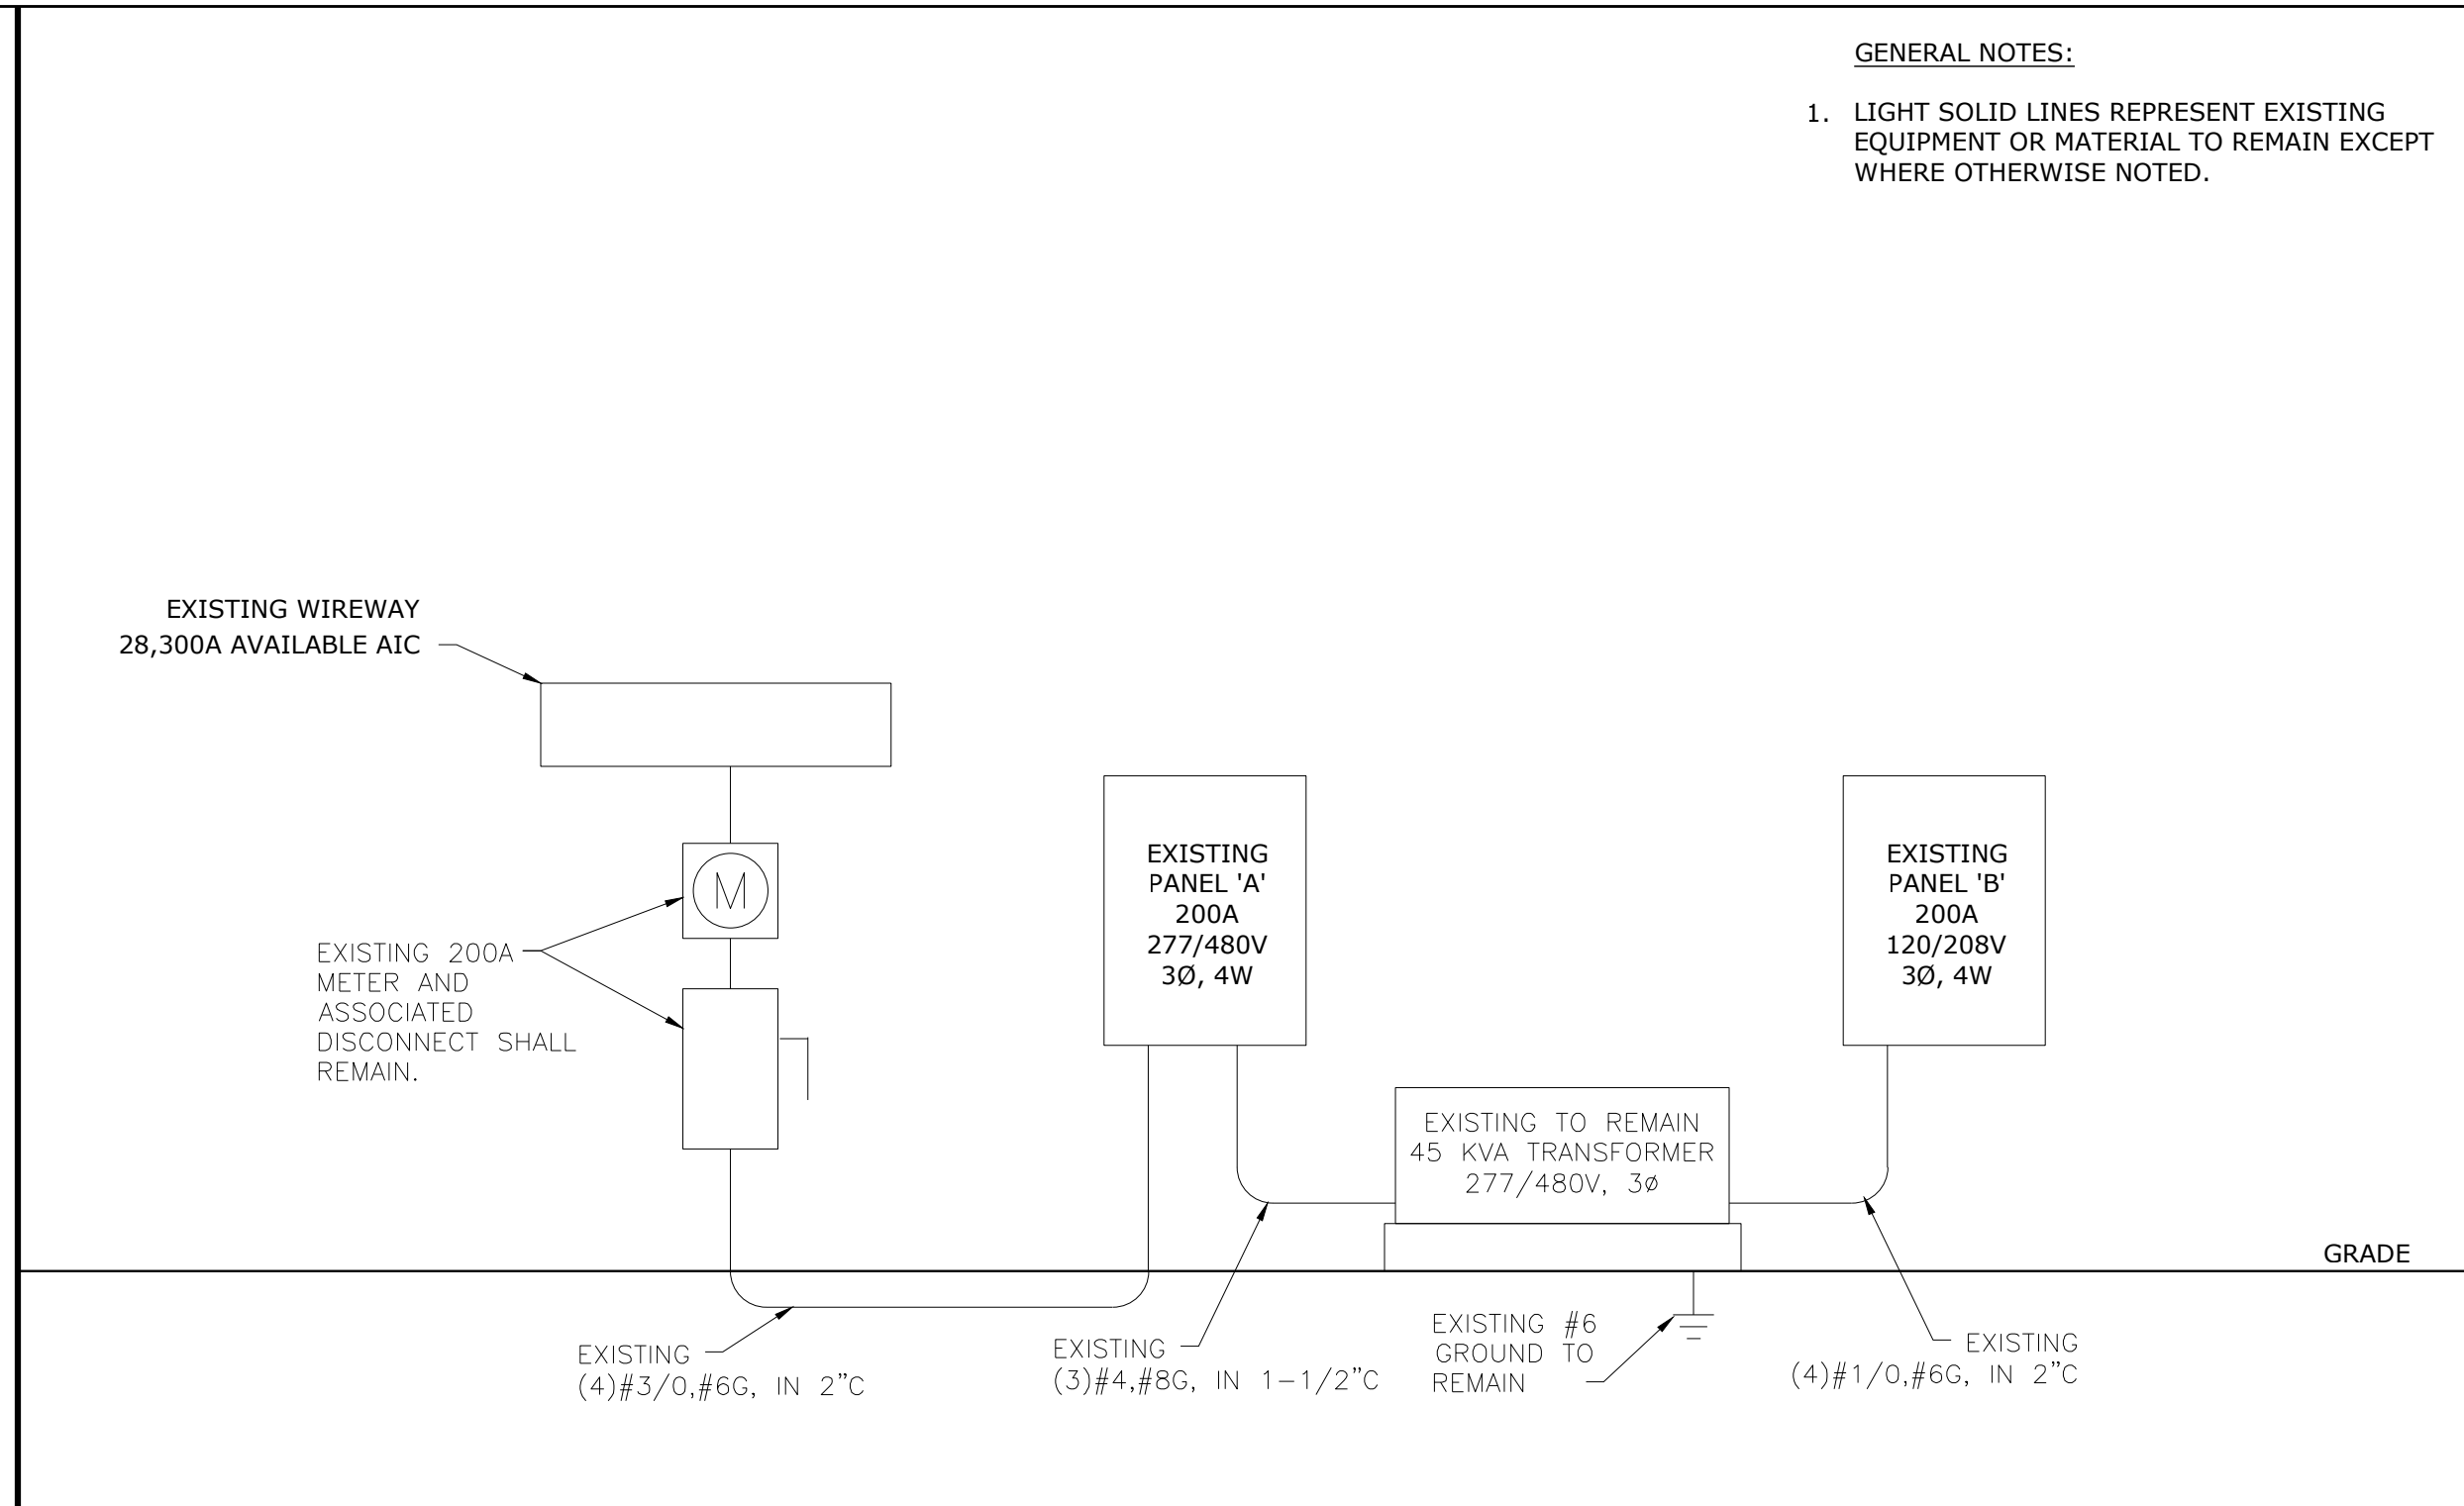

EXISTING ELECTRICAL RISER DIAGRAM
NO SCALE

INCLUDES:

- PHONE OUTLETS
- DATA OUTLETS
- TELEVISION OUTLETS
- INTERCOM OUTLETS
- MICROPHONE OUTLETS


INCLUDES:

- VOLUME CONTROL DEVICES
- SPEAKERS (CEILING SPEAKERS DO NOT REQUIRE J-BOX)
- CARD READERS
- SECURITY CAMERAS
- PANIC BUTTONS

INCLUDES:

- VOLUME CONTROL DEVICES
- SPEAKERS (CEILING SPEAKERS DO NOT REQUIRE J-BOX)
- CARD READERS
- SECURITY CAMERAS
- PANIC BUTTONS

TYPE	DESCRIPTION	MOUNTING	LAMP	VOLTS	MANUFACTURER	V-A
FP22	2X2 LED FIELD SELECTABLE CCT & OUTPUT FLAT PANEL. MID OUTPUT. INTEGRAL 0-10V DIMMING DRIVER.	RECESSED	LED 3800 LUMENS 3500K 80 CRI	UNV	SOLAIS - LUMITRAY 2X2	27
FP24	2X4 LED FIELD SELECTABLE CCT & OUTPUT FLAT PANEL. MID OUTPUT. INTEGRAL 0-10V DIMMING DRIVER.	RECESSED	LED 4600 LUMENS 3500K 80 CRI	UNV	SOLAIS - LUMITRAY 2X4	32
TL3	SLIM STYLE GIMBAL LINE VOLTAGE TRACK FIXTURE HEAD. INTEGRAL ON/OFF SWITCH. E26 MEDIUM SKIRTED BASE. BLACK FINISH. PHILLIPS 17W LED PAR38 BULB.	TRACK MOUNTED	LED PAR38 BULB 1200 LUMENS 3000K	120	CONTECH LIGHTING - CTL838/2	250 MAX
T4	SINGLE CIRCUIT LINE VOLTAGE TRACK. COORDINATE EXACT LENGTHS WITH DRAWINGS. PROVIDE NECESSARY CONNECTORS. BLACK FINISH. MAX 1920W PER CIRCUIT, PER NEC 80% CAPACITY RULE.	SUSPENDED	SEE TL3 FOR HEAD	120	CONTECH LIGHTING - LT	-
TL5	TRACK WALL WASHER. TRIAC ELV DIMMING. BLACK FINISH. J-TYPE MOUNTING.	TRACK MOUNTED	LED 1600 LUMENS 3000K 90 CRI	120	LUMENTURE - TWW160	17
W3	2" WIDTH LED LINEAR FIXTURE. 3'-0" LENGTH. MEDIUM OUTPUT. STANDARD 0-10V 1% DIM. BLACK FINISH. FLAT DIFFUSER.	SURFACE	LED 608 LUM/FT 3000K	UNV	CORONET - LS1 DIRECT	7 LF
E1	EMERGENCY TWIN BUG EYE LED FIXTURE. BLACK FINISH. PROVIDE NECESSARY BATTERY TO POWER ALL ELA Q SERIES FIXTURE. BATTERY CAPABLE OF 90 MINUTES OF EMERGENCY OPERATION.	PENDANT	LED	UNV	LITHONIA - ELA Q SERIES	3
EX3	LED EXIT SIGN WITH THERMOPLASTIC HOUSING. WHITE FINISH AND RED LETTERING. PROVIDE ARROWS AS NOTED ON DRAWINGS, AND SINGLE OR DOUBLE SIDED AS NEEDED AND SHOWN ON DRAWINGS. PROVIDE TOP, BACK, OR SIDE MOUNT HARDWARE AS REQUIRED BY ARCHITECTURAL CONDITIONS. BATTERY CAPABLE OF 90 MINUTES OF EMERGENCY OPERATION.	SURFACE WALL OR CEILING	LED	UNV	BEST LIGHTING - EZXTEU	3.8

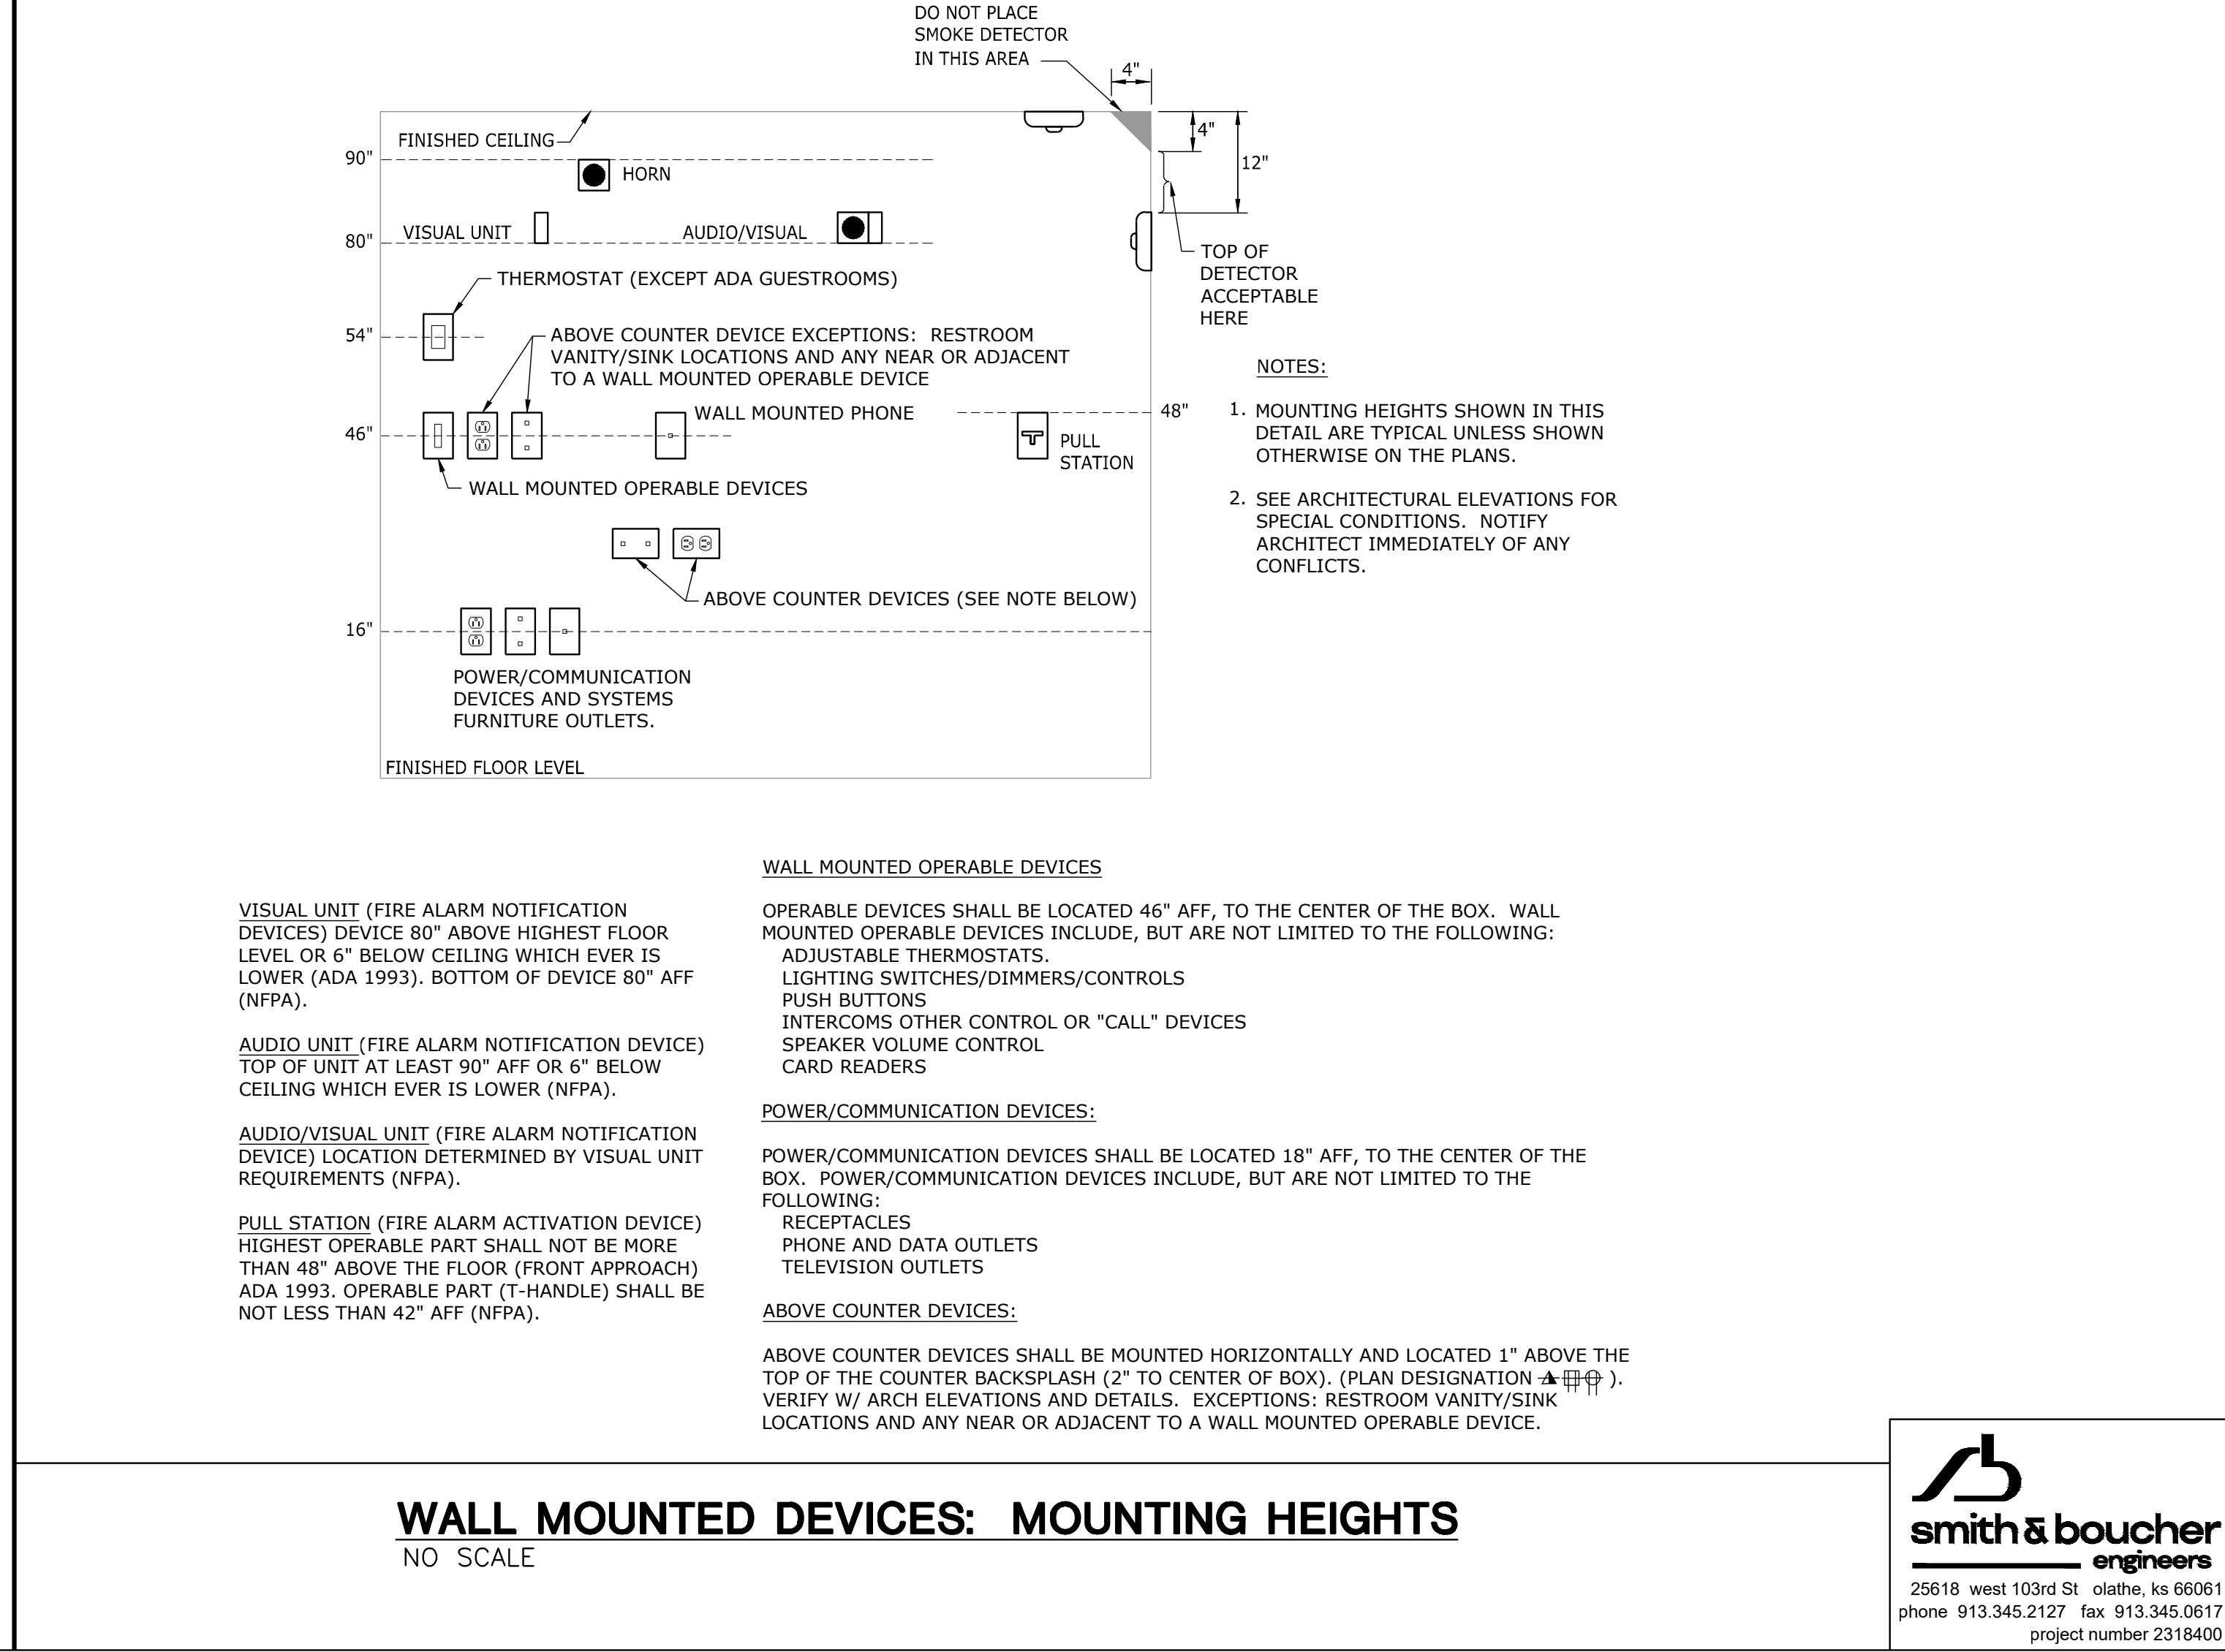

GENERAL NOTES:
1. LIGHT SOLID LINES REPRESENT EXISTING EQUIPMENT OR MATERIAL TO REMAIN EXCEPT WHERE OTHERWISE NOTED.

Kloverarchitects
8813 PENROSE LANE, SUITE 400 • LENEXA, KS 66219
PH: 913.649.8181 • FX: 913.649.1275 • WWW.KLOVER.NET

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project title
**RED DEVELOPMENT
SUMMIT FAIR
910 G NW Blue Pkwy
Lee's Summit, MO 64086**

project number
drawing issuance
drawing revisions

professional seal
STATE OF MISSOURI
CHRISTOPHER EDWARD ALBRIGHT
NUMBER
PE-20060339
6/14/23
DATE SIGNED: 06/14/2023
drawing title
ELECTRICAL - SCHEDULES AND DETAILS
drawing number
E301

smith & boucher
engineers
25618 west 103rd St. olathe, ks 66061
phone 913.345.2127 fax 913.345.0617
project number 2318400

PROJECT NAME: X:\23\23184\Drawings\06-2318400_E301.dwg
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LAST CORRECTION BY: Tuesday, June 13, 2023 10:39:59 AM
PLOTTED BY: Wednesday, June 14, 2023 10:16:28 AM
Booby, Charles

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 LAST CORRECTION BY: Blue Tuesday, June 13, 2023 10:47:59 AM
 PLOTTED BY: Booty, Charles Wednesday, June 14, 2023 10:16:42 AM

PANEL B (EXISTING DEMO WORK)									
MAIN BUS AMPS:		200 A	AIC:		22,000 A		EQUIPMENT GROUND BUS		
MAIN BREAKER:		150 A	SECTIONS:		1-42 SPACE				
VOLTAGE:		208Y/120 V	MOUNTING:		SURFACE				
PHASES/WIRES:		3 PH / 4 W	ENCLOSURE TYPE:		NEMA 1				
CIRCUIT DESCRIPTION	POLES	AMPS	CKT NO	CKT NO	AMPS	POLES	CIRCUIT DESCRIPTION		
BATHROOM/WATER FOUNTAIN	1	20	1	2	20	1	BACK ROOM RECEPTS		
SHOW WINDOW RECEPTS	1	20	3	4	20	1	BACK ROOM RECEPTS		
SHOW WINDOW RECEPTS	1	20	5	6	20	1	BACK ROOM RECEPTS		
LTG: CANS S WINDOW	1	20	7	8	20	1	SALES FLOOR RECEPTS		
LTG: CANS W WINDOW	1	20	9	10	20	1	SALE		
LTG: CANS W WINDOW	1	20	11	12	20	1	LTG: CANS SALES		
LTG: CANS SALES FL	1	20	13	14	20	1	CASH WRAP		
LTG: CANS	1	20	15	16	20	1	CASH WRAP		
AMPLIFIER RECEPT	1	20	17	18	20	1	CASH WRAP		
REFRIGERATOR	1	20	19	20	20	1	TAYLOR SHOP RECEPTS		
MICROWAVE	1	20	21	22	20	1	TAYLOR SHOP RECEPTS		
SECURITY RECEPT	1	20	23	24	20	1	TAYLOR SHOP RECEPTS		
BACK ROOM RECEPTS	1	20	25	26	20	1	TAYLOR SHOP RECEPTS		
TAYLOR SHOP RECEPTS	1	20	27	28	20	1	TAYLOR SHOP RECEPTS		
TAYLOR SHOP RECEPTS	1	20	29	30	20	1	TAYLOR SHOP RECEPTS		
TAYLOR SHOP RECEPTS	1	20	31	32	20	1	SALES FLOOR RECEPTS		
TELEPHONE/DATA RECEPT	1	20	33	34	20	1	SALES FLOOR RECEPTS		
EMS	1	20	35	36	20	1	SALES FLOOR RECEPTS		
SPACE ONLY	1		37	38	20	1	SPARE		
SPACE ONLY	1		39	40	20	1	SPARE		
SPACE ONLY	1		41	42	20	1	WATER HEATER		

ITALIC - EXISTING
 BOLD - DEMO

PANEL A (EXISTING DEMO WORK)									
MAIN BUS AMPS:		200 A	AIC:		22,000 A		EQUIPMENT GROUND BUS		
MAIN BREAKER:		200 A	SECTIONS:		1-42 SPACE				
VOLTAGE:		480Y/277 V	MOUNTING:		SURFACE				
PHASES/WIRES:		3 PH / 4 W	ENCLOSURE TYPE:		NEMA 1				
CIRCUIT DESCRIPTION	POLES	AMPS	CKT NO	CKT NO	AMPS	POLES	CIRCUIT DESCRIPTION		
LTG: SALES AREA	1	20	1	2		1	LTG - WALL WASHERS		
LTG: SALES AREA	1	20	3	4		1	LTG - WALL WASHERS		
LTG: N/EXIT/EMERG	1	20	5	6		1	SPACE ONLY		
LTG: TAYLOR SHOP/STOCK EM	1	20	7	8		1	SPACE ONLY		
SIGNS	1	20	9	10		1	SPACE ONLY		
SPACE ONLY	1		11	12		1	SPACE ONLY		
SPACE ONLY	1		13	14		1	SPACE ONLY		
SPACE ONLY	1		15	16		1	SPACE ONLY		
SPACE ONLY	1		17	18		1	SPACE ONLY		
SPACE ONLY	1		19	20		1	SPACE ONLY		
SPACE ONLY	1		21	22		1	SPACE ONLY		
SPACE ONLY	1		23	24		1	SPACE ONLY		
SPACE ONLY	1		25	26		1	SPACE ONLY		
SPACE ONLY	1		27	28		1	SPACE ONLY		
SPACE ONLY	1		29	30		1	SPACE ONLY		
RTU #2	3	30	31	32		3	RTU-2		
			33	34					
			35	36					
RTU #1	3	30	37	38		3	PANEL 'B' - 45KVA XFRM		
			39	40					
			41	42					

ITALIC - EXISTING
 BOLD - DEMO

PANEL B (EXISTING NEW WORK)									
MAIN BUS AMPS:		200 A	AIC:		22,000 A		EQUIPMENT GROUND BUS		
MAIN BREAKER:		150 A	SECTIONS:		1-42 SPACE				
VOLTAGE:		208Y/120 V	MOUNTING:		SURFACE				
PHASES/WIRES:		3 PH / 4 W	ENCLOSURE TYPE:		NEMA 1				
CIRCUIT DESCRIPTION	POLES	AMPS	CKT NO	CKT NO	AMPS	POLES	CIRCUIT DESCRIPTION		
BATHROOM/WATER FOUNTAIN	1	20	1	2	20	1	BACK ROOM RECEPTS		
SHOW WINDOW RECEPTS	1	20	3	4	20	1	BACK ROOM RECEPTS		
SHOW WINDOW RECEPTS	1	20	5	6	20	1	BACK ROOM RECEPTS		
LTG: CANS S WINDOW	1	20	7	8	20	1	SALES FLOOR RECEPTS		
LTG: CANS W WINDOW	1	20	9	10	20	1	SALE		
LTG: CANS W WINDOW	1	20	11	12	20	1	*LTG: SALES FLOOR TRACK		
*LTG: SALES FLOOR TRACK	1	20	13	14	20	1	CASH WRAP		
*LTG: SALES FLOOR TRACK	1	20	15	16	20	1	CASH WRAP		
AMPLIFIER RECEPT	1	20	17	18	20	1	CASH WRAP		
REFRIGERATOR	1	20	19	20	20	1	LTG: SALES FLOOR TRACK		
MICROWAVE	1	20	21	22	20	1	REC - POS #1 - DUPLEX		
SECURITY RECEPT	1	20	23	24	20	1	REC - POS #2 - QUADS		
BACK ROOM RECEPTS	1	20	25	26	20	1	REC - POS #3 - QUADS		
SPARE	1	20	27	28	20	1	REC - RFID EQUIPMENT		
SPARE	1	20	29	30	20	1	REC - MANAGERS OFFICE		
SPARE	1	20	31	32	20	1	SALES FLOOR RECEPTS		
TELEPHONE/DATA RECEPT	1	20	33	34	20	1	SALES FLOOR RECEPTS		
EMS	1	20	35	36	20	1	SALES FLOOR RECEPTS		
SPACE ONLY	1		37	38	20	1	SPARE		
SPACE ONLY	1		39	40	20	1	SPARE		
SPACE ONLY	1		41	42	20	1	WATER HEATER		

ITALIC - EXISTING
 BOLD - NEW
 UPDATE PANEL SCHEDULE PER NEW WORK
 *CIRCUIT TO BE RE-USED WITH NAME CHANGE IN SCHEDULE.

PANEL A (EXISTING NEW WORK)									
MAIN BUS AMPS:		200 A	AIC:		22,000 A		EQUIPMENT GROUND BUS		
MAIN BREAKER:		200 A	SECTIONS:		1-42 SPACE				
VOLTAGE:		480Y/277 V	MOUNTING:		SURFACE				
PHASES/WIRES:		3 PH / 4 W	ENCLOSURE TYPE:		NEMA 1				
CIRCUIT DESCRIPTION	POLES	AMPS	CKT NO	CKT NO	AMPS	POLES	CIRCUIT DESCRIPTION		
LTG: SALES AREA	1	20	1	2		1	LTG - WALL WASHERS		
LTG: SALES AREA	1	20	3	4		1	LTG - WALL WASHERS		
LTG: N/EXIT/EMERG	1	20	5	6		1	SPACE ONLY		
LTG: TAYLOR SHOP/STOCK EM	1	20	7	8		1	SPACE ONLY		
SIGNS	1	20	9	10		1	SPACE ONLY		
SPACE ONLY	1		11	12		1	SPACE ONLY		
SPACE ONLY	1		13	14		1	SPACE ONLY		
SPACE ONLY	1		15	16		1	SPACE ONLY		
SPACE ONLY	1		17	18		1	SPACE ONLY		
SPACE ONLY	1		19	20		1	SPACE ONLY		
SPACE ONLY	1		21	22		1	SPACE ONLY		
SPACE ONLY	1		23	24		1	SPACE ONLY		
SPACE ONLY	1		25	26		1	SPACE ONLY		
SPACE ONLY	1		27	28		1	SPACE ONLY		
SPACE ONLY	1		29	30		1	SPACE ONLY		
RTU #2	3	30	31	32		3	RTU-2		
			33	34					
			35	36					
RTU #1	3	30	37	38		3	PANEL 'B' - 45KVA XFRM		
			39	40					
			41	42					

ITALIC - EXISTING
 BOLD - NEW
 UPDATE PANEL SCHEDULE PER NEW WORK


Kloverarchitects
 8813 PENROSE LANE, SUITE 400 • LENEWA, KS 66219
 PH: 913.649.8181 • FX: 913.649.1275 • WWW.KLOVER.NET

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project title
**RED DEVELOPMENT
 SUMMIT FAIR**
 910 G NW Blue Pkwy
 Lee's Summit, MO 64086

project number
 drawing issuance
 drawing revisions
 No. Description: Date:



DATE SIGNED: 06/14/2023
 drawing title

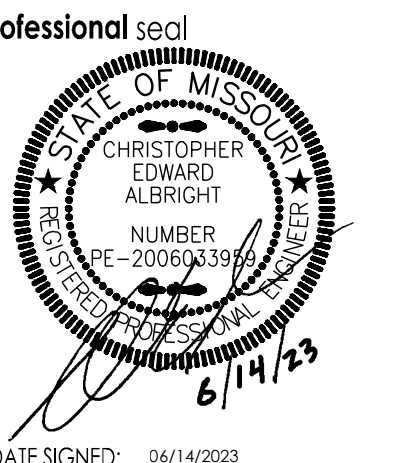smith & boucher
 engineers
 25618 west 103rd St olathe, ks 66061
 phone 913.345.2127 fax 913.345.0617
 project number 2318400

ELECTRICAL - SCHEDULES AND DETAILS
 drawing number
E302