

ELEVATIONS:

MPH REQUIREMENTS.

WITH IRC R703.2.

CORRESPONDING STUD SIZE.

ON LOAD BEARING WALLS.

DIAPHRAGM SHALL COMPLY WITH IRC R602.3.

WALL FRAMING SHALL BE DOUGLAS FIR LARCH #2 UNLESS OTHERWISE NOTED. IN BEARING WALLS, STUDS WHICH ARE NOT MORE THAN TEN FEET IN LENGTH SHALL BE SPACED NOT MORE THAN IS SPECIFIED BY IRC TABLE R602.3(5) FOR

WATER-RESISTIVE EXTERIOR WALL BARRIER IN WALL SECTION SHALL COMPLY

WHEN APPLICABLE, CONTINUOUS STUDS BETWEEN FLOOR AND ROOF/CEILING

SHIPLAP SIDING MUST BE FASTENED AT BOTH UNDERLAP AND OVERLAP.

ALL UNMARKED HEADERS SHALL BE A MINIMUM #2 DOUGLAS FIR LARCH (2) 2 X 10

SCALE: 1/4" = 1'-0"

FRONT & REAR ELEVATION NOTES

- 1.12 TOP OF FOOTING DEPTH DETERMINED PER SITE. .71 CONCRETE WINDOW WELL FOR EGRESS WITH LADDER. PROVED SLEEVE THROUGH WALL FOR FOUNDATION DRAIN. TOP OF WINDOW WELL TO BE 3" BELOW TOP
- OF FOUNDATION. 2.62 DOUBLED 1X8"TRIM. 1 1/2" ARCH ON GARAGE DOOR

WINDOWS, AND CORNERS UNLESS NOTED OTHERWISE.

- TRIM UNLESS NOTED OTHERWISE ON ELEVATION. 3.11 LAP SIDING WITH 5/4X6 TRIM AROUND DOORS,
- 3.13 PANEL SIDING WITH 3/4X4 TRIM AROUND DOORS, WINDOWS, AND CORNERS UNLESS NOTED OTHERWISE. BOTTOM OF SIDING SHALL BE A MINIMUM OF 6" ABOVE GRADE.
- 3.15 BOARD AND BATTEN.
- 3.17 MANUFACTURED STONE VENEER.
- 3.18 CAST STONE CAP

AS REQUIRED BY CODE.

- 3.38 6X6 CEDAR POST. 1X6 TRIM AT BASE AND TOP.
- 3.66 DECORATIVE FALSE LOUVERED VENT. 4.11 MINIMUM ROOFING COMPOSITION— 30 YR COMPOSITE SHINGLES ON 15# FELT ON 1/2" OSB SHEATHING OR

CPG DBA

120 SE 30TH ST. LEE'S SUMMIT, MO 64082 816-246-6700

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ADDRESS:

UNIT A: 2139 SW OSAGE DR UNIT B: 2141 SW OSAGE DR

GENERAL NOTES

DIMENSIONAL LUMBER IS LABELED PER INDUSTRY STANDARD TERMINOLOGY. ACTUAL LUMBER SIZING IS EXPECTED TO VARY PER VENDOR.

WINDOW SIZES ARE WRITTEN IN FEET AND INCHES PER INDUSTRY STANDARDS. EX: 3050 SH = 3'-0" X 5'-0" SINGLE HUNG, 3066 FIX = 3'-0" X 6'-6" FIXED.

SHEET INDEX

- A1. FRONT AND REAR ELEVATION
- A2. LEFT AND RIGHT ELEVATION
- A3. FOUNDATION LEVEL PLAN
- A4. MAIN LEVEL PLAN
- A5. ROOF PLAN

GARAGE

NO. DATE

| DAVIS NUMBER PE-2015016986 06/01/2023 |
|--|
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EVERSTEAD 3741 NE TROON DRIVE

SUITE 200

LEE'S SUMMIT, MO 64064

816-399-4901

PROFESSIONAL SEAL

FINISHED PER UNIT | TOTAL MAIN FLOOR 1239 FINISHED STAIRS TO LOWER LEVEL 48 1263 2526 UNFINISHED LOWER LEVEL - UNFINISHED 1054 2108 117 234

473

946

VERSION #: V1.2

ISSUE DATE:

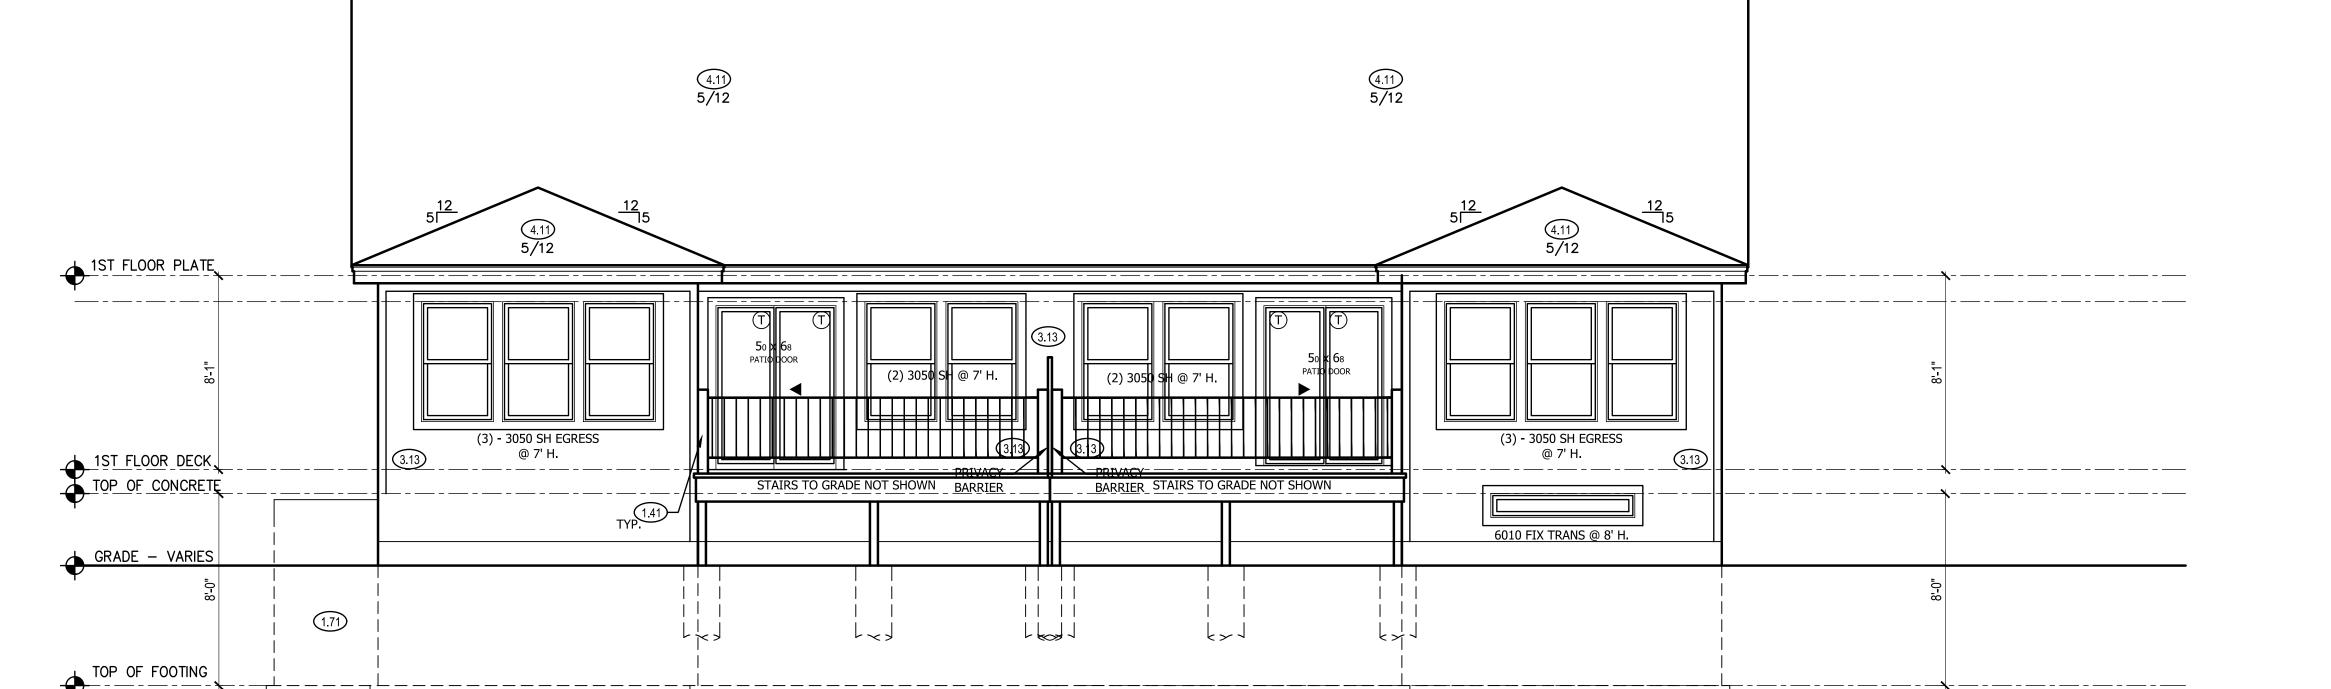
TRUSS ENGINEER I-JOIST **EVERSTEAD**

REVISIONS


DESCRIPTION

04.05.2023

SHEET NUMBER:



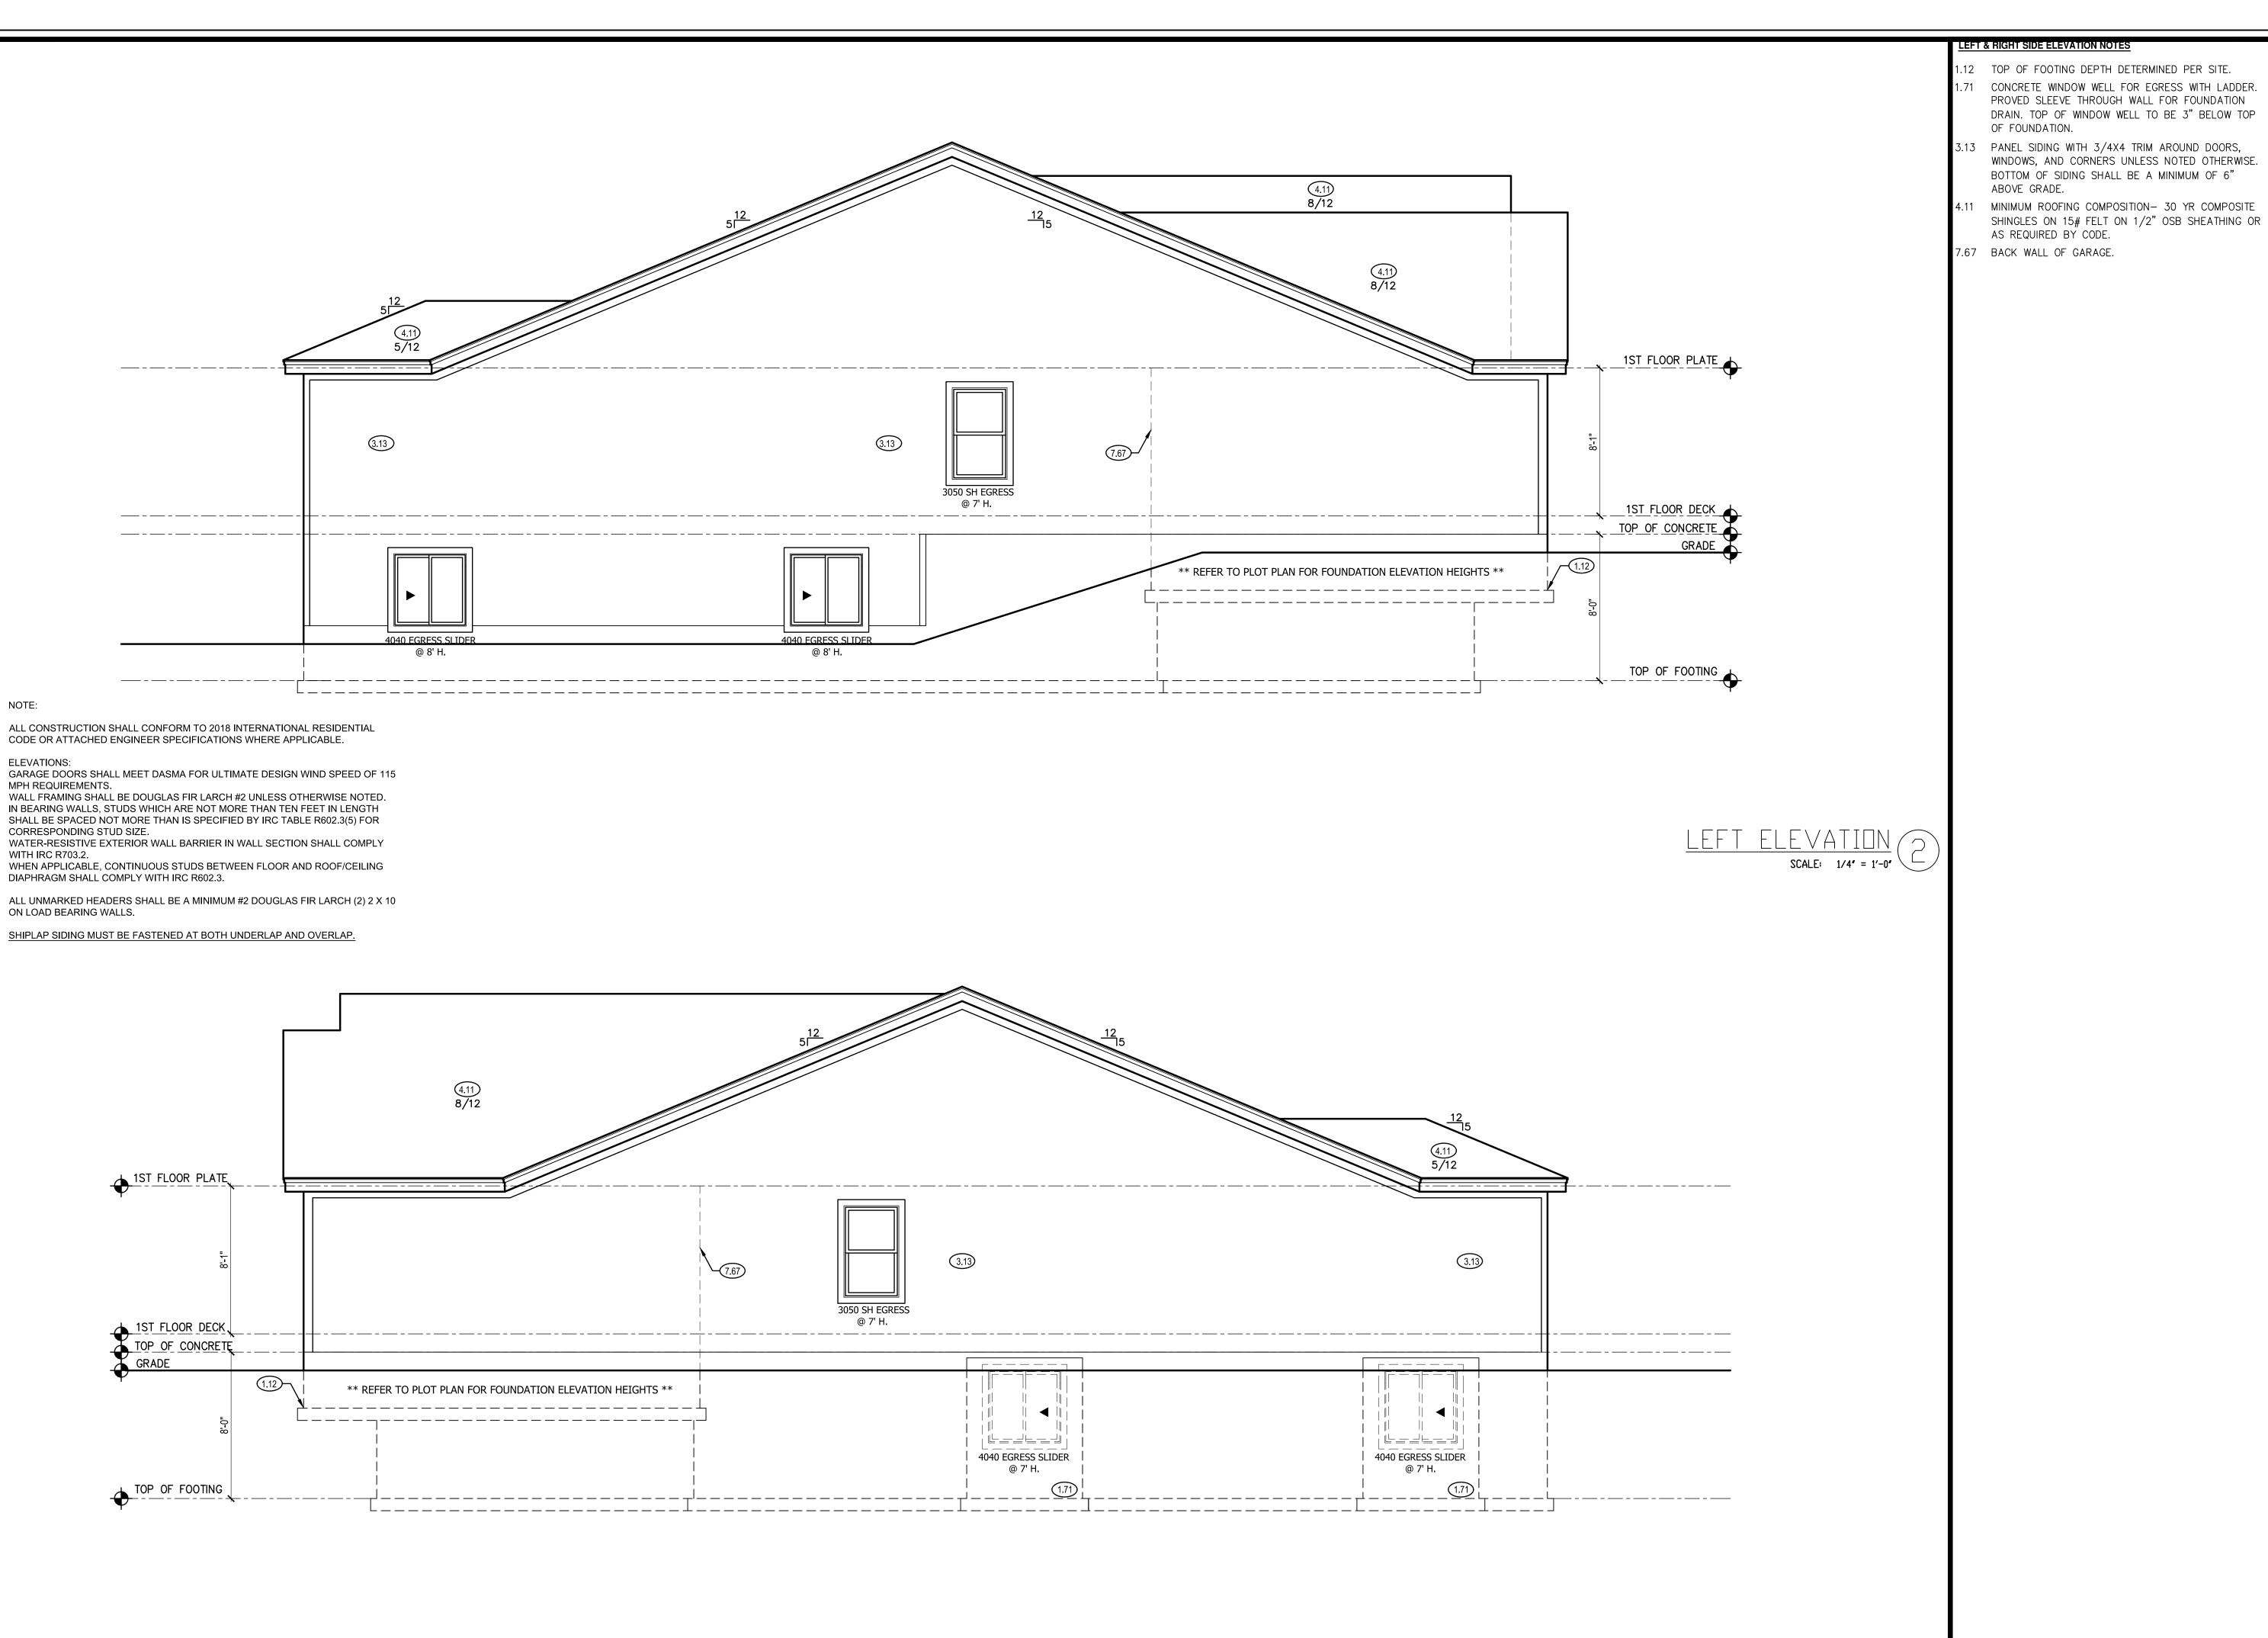RELEASE FOR CONSTRUCTION AS NOTED FOR PLAN REVIEW DEVELOPMENT SERVICES LEE'S SUMMIT, MISSOURI 06/09/2023



GENERAL NOTES

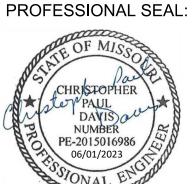
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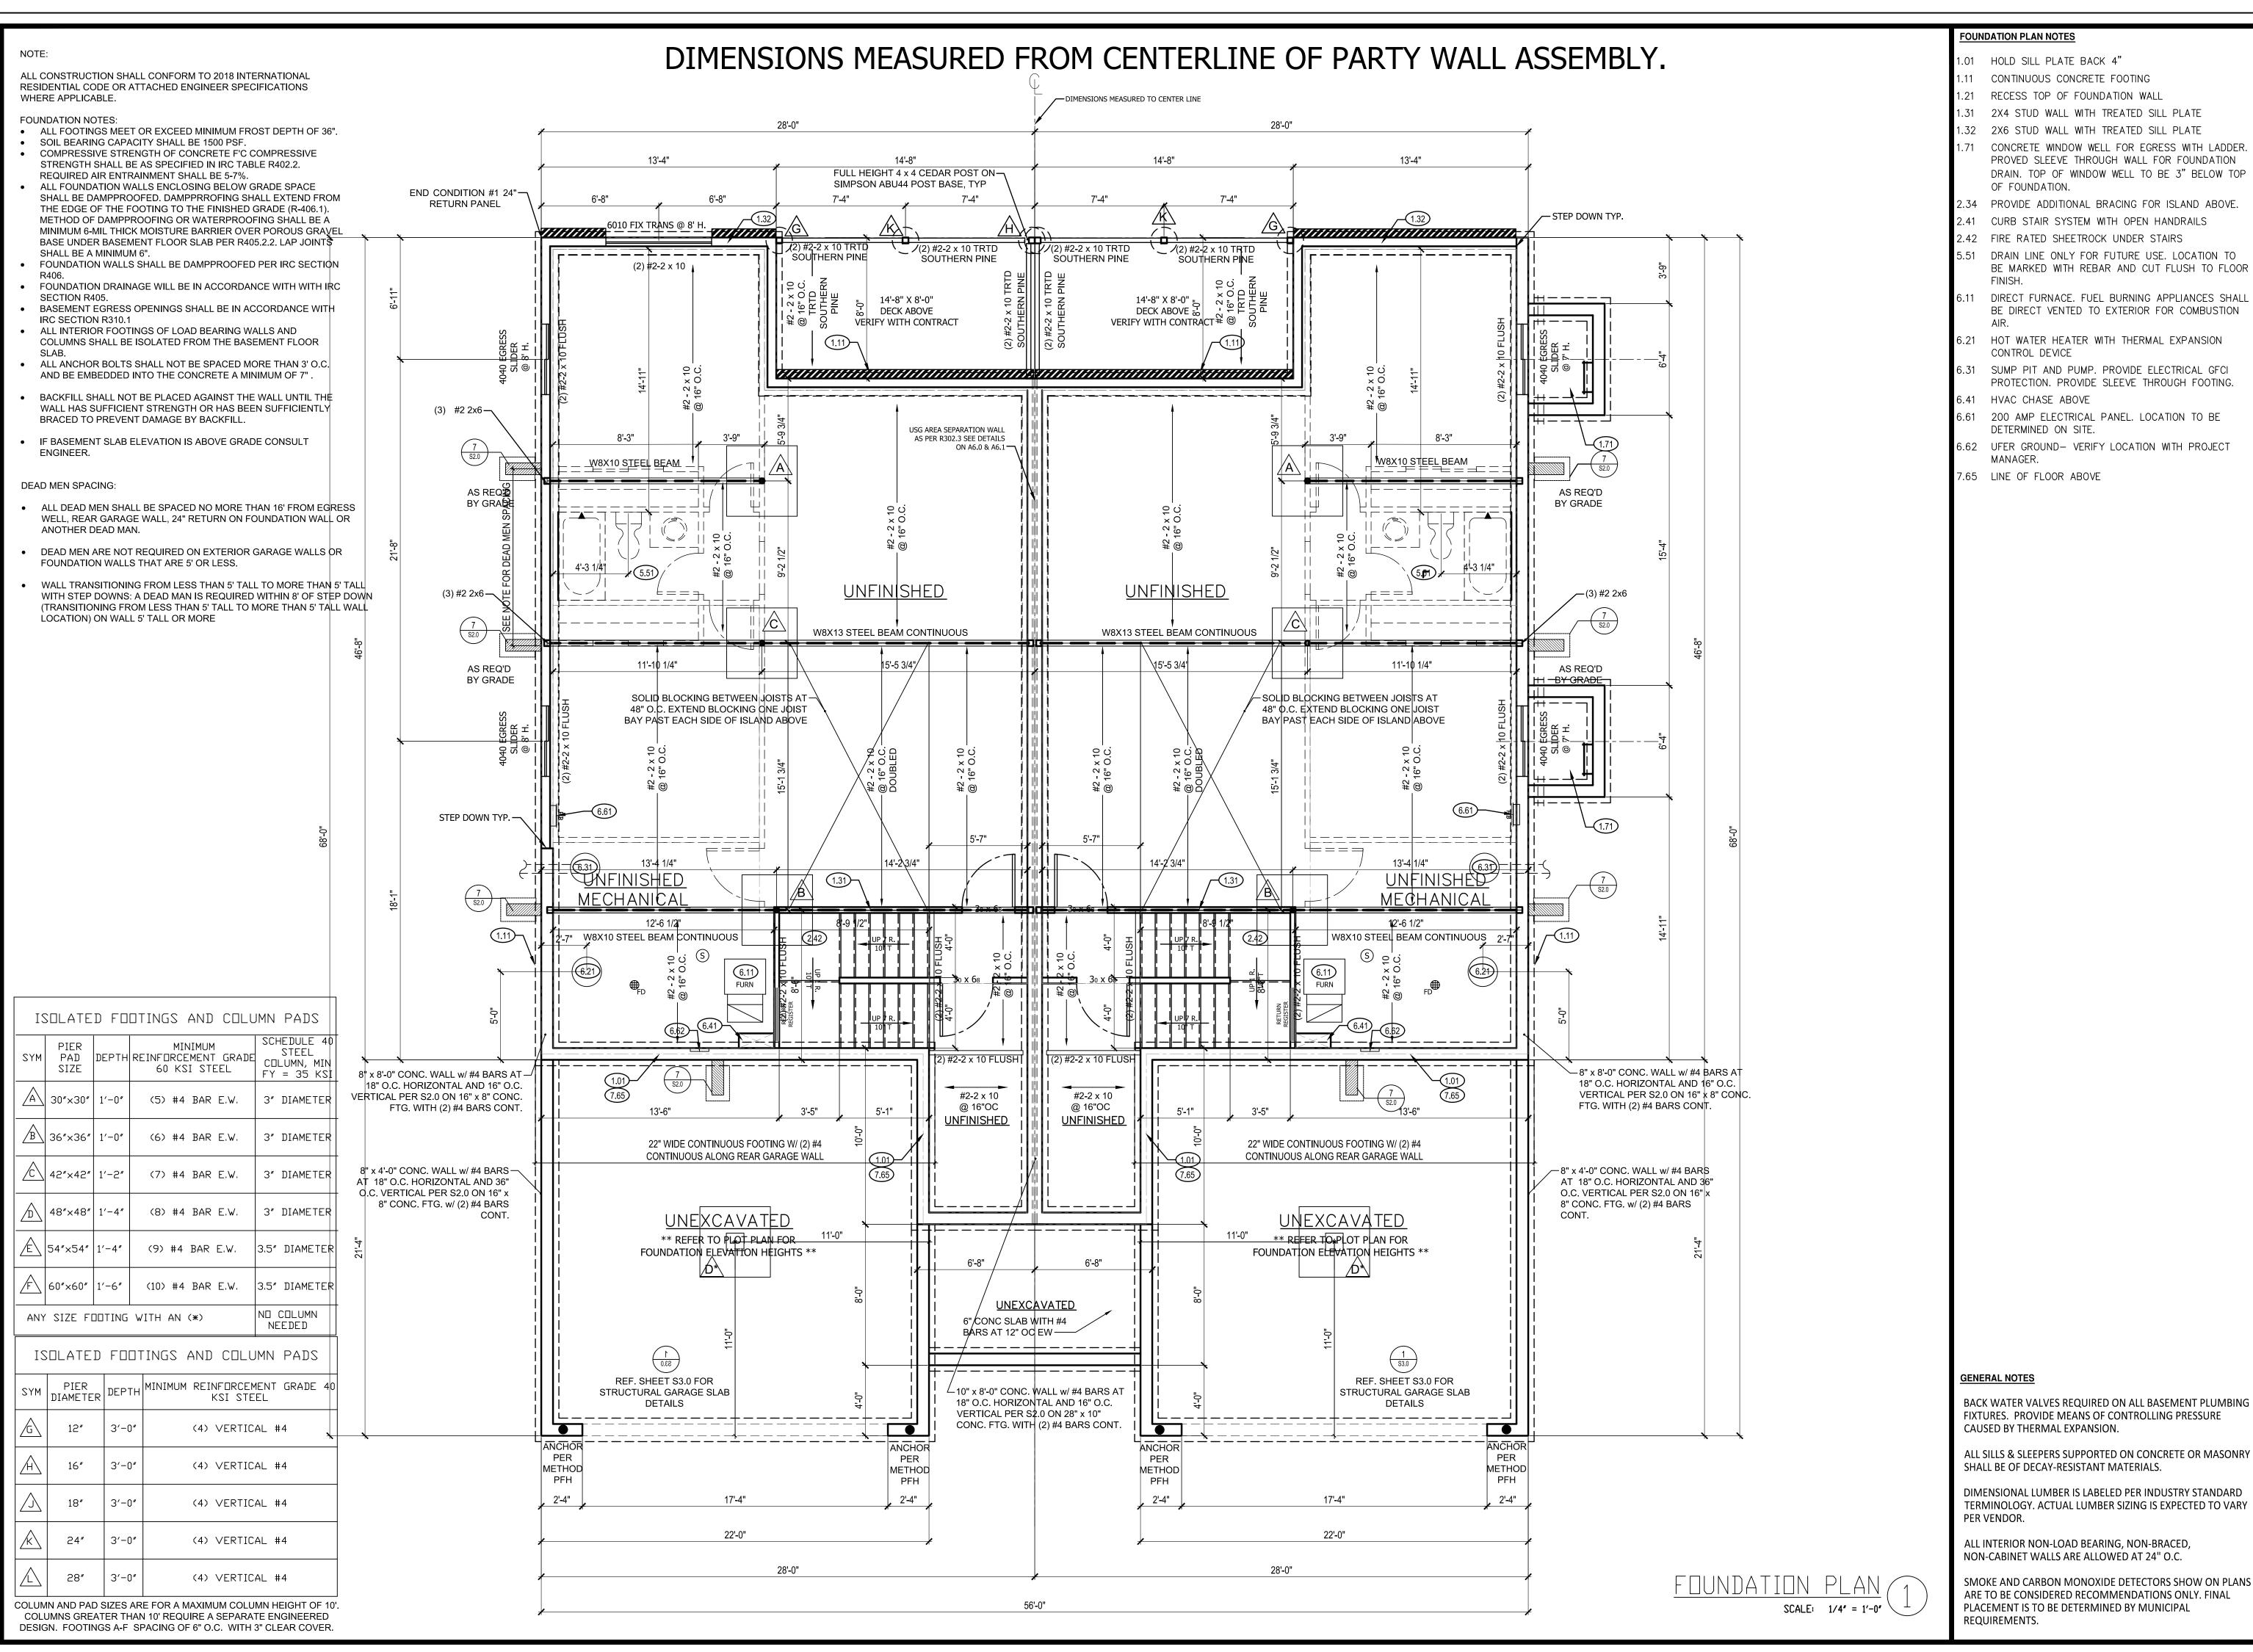
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06/09/2023



FOUNDATION PLAN NOTES

- .01 HOLD SILL PLATE BACK 4"
- CONTINUOUS CONCRETE FOOTING
- 1.21 RECESS TOP OF FOUNDATION WALL
- 1.31 2X4 STUD WALL WITH TREATED SILL PLATE
- 1.32 2X6 STUD WALL WITH TREATED SILL PLATE
- .71 CONCRETE WINDOW WELL FOR EGRESS WITH LADDER. PROVED SLEEVE THROUGH WALL FOR FOUNDATION DRAIN. TOP OF WINDOW WELL TO BE 3" BELOW TOP OF FOUNDATION.
- 2.34 PROVIDE ADDITIONAL BRACING FOR ISLAND ABOVE.
- 2.41 CURB STAIR SYSTEM WITH OPEN HANDRAILS
- 2.42 FIRE RATED SHEETROCK UNDER STAIRS
- 5.51 DRAIN LINE ONLY FOR FUTURE USE. LOCATION TO BE MARKED WITH REBAR AND CUT FLUSH TO FLOOR
- 6.11 DIRECT FURNACE. FUEL BURNING APPLIANCES SHALL BE DIRECT VENTED TO EXTERIOR FOR COMBUSTION
- 5.21 HOT WATER HEATER WITH THERMAL EXPANSION CONTROL DEVICE
- 3.31 SUMP PIT AND PUMP. PROVIDE ELECTRICAL GFCI
- PROTECTION. PROVIDE SLEEVE THROUGH FOOTING.
- 5.61 200 AMP ELECTRICAL PANEL. LOCATION TO BE
- DETERMINED ON SITE. 6.62 UFER GROUND- VERIFY LOCATION WITH PROJECT
- MANAGER.
- 7.65 LINE OF FLOOR ABOVE

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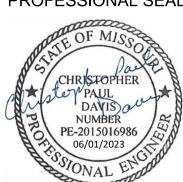
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