

-- IRILOGY-

A NORTHPOINT PROPERTY

PROJECT INFORMATION

PROJECT ADDRESS:

800 & 810 NORTH WARD ROAD
LEE'S SUMMIT
JACKSON
MISSOURI

SITE DATA

TOTAL LAND AREA	11.83 ACRES (515,
TOTAL BUILDING FOOTPRINT	114,936 SF
BUILDING 1	62,085 SF
BUILDING 2	52,851 SF
TOTAL BUILDING AREA	474,057 SF
BUILDING 1	251,600 SF
BUILDING 2	222,457 SF
TOTAL RESIDENTIAL UNIT COUNT	323
BUILDING 1	178
BUILDING 2	145
DENSITY (UNITS/ACRE)	27/ACRE

PARKING DATA

VEHICLE PARKING	
TOTAL PARKING SPACES REQUIRED	565 (1.75/DU)
TOTAL PARKING SPACES PROVIDED SURFACE DETACHED GARAGE TUCK UNDER GARAGE	579 406 48 125

VICINITY MAP



PROJECT TEAM

OWNER:	ARCHITECT:
NORTHPOINT DEVELOPMENT 3315 N OAK TRAFFICWAY KANSAS CITY, MO 64116 TEL: (516) 888-7380 EMAIL: BRAD@NORTHPOINTKC.COM CONTACT: BRAD HAYMOND	NSPJ ARCHITECTS, P.A. 3515 W. 75TH ST., SUITE 201 PRAIRIE VILLAGE, KS 66208 TEL: (913)-831-1415 FAX: (913)-831-1563 EMAIL: THOMBURG@NSPJARCH.COM CONTACT: TIM HOMBURG, AIA
CIVIL ENGINEER:	STRUCTURAL ENGINEER:
SITEPOINT 3315 N OAK TRAFFICWAY KANSAS CITY, MO 64116 TEL: (816) 888-7380 EMAIL: NHAAS@NORTHPOINTKC.COM CONTACT: NEIL HAAS	KRUDWIG STRUCTURAL ENGINEERS, INC 8801 RENNER AVENUE, SUITE 407 LENEXA, KS 66219 TEL: (913) 660-0584 EMAIL: JKRUDWIG@KRUDWIG.COM CONTACT: JOHN KRUDWIG
MEP ENGINEER:	LANDSCAPE ARCHITECT:
MEP ENGINEER: LATIMER, SOMMERS & ASSOCIATES 3639 SW SUMMERFIELD DR, SUITE A TOPEKA, KS 66614 TEL: (785) 233-3232 EMAIL: RBEARDMORE@LSAPA.COM CONTACT: RICH BEARDMORE	
LATIMER, SOMMERS & ASSOCIATES 3639 SW SUMMERFIELD DR, SUITE A TOPEKA, KS 66614 TEL: (785) 233-3232 EMAIL: RBEARDMORE@LSAPA.COM	LANDSCAPE ARCHITECT: NSPJ ARCHITECTS, P.A. 3515 W. 75TH ST., SUITE 201 PRAIRIE VILLAGE, KS 66208 TEL: (913)-831-1415 FAX: (913)-831-1563 EMAIL: BHUS@NSPJARCH.COM

PROJECT GENERAL NOTES

1.	ALL CONSTRUCTION SHALL COMPLY WITH ALL APPLICABLE FEDERAL, LOCAL, AND STATE LAWS, REGULATIONS, CODES AND AMENDMENTS.
2.	THE CONTRACTOR SHALL PERFORM THE WORK IN ACCORDANCE WITH THE CONTRACT DOCUMENTS. THE CONTRACT DOCUMENTS ARE COMPLEMENTARY, AND WHAT IS REQUIRED BY ONE SHALL BE AS BINDING AS IF

REQUIRED BY ALL.

DO NOT SCALE DRAWINGS. REFER TO WRITTEN DIMENSIONS.

4. THE CONTRACTOR SHALL CHECK AND VERIFY ALL DIMENSIONS BY TAKING FIELD MEASUREMENTS. PROPER FIT AND ATTACHMENTS OF ALL SPECIFIED ITEMS AND WORK IS REQUIRED.

THE CONTRACTOR SHALL THOROUGHLY REVIEW THE DRAWINGS AND SPECIFICATIONS AND IMMEDIATELY REPORT ANY DISCREPANCIES TO THE ARCHITECT. HOWEVER, WHERE A CONFLICT BETWEEN THE DRAWINGS AND SPECIFICATIONS OCCURS, WHICHEVER IS OF GREATER VALUE WILL TAKE PRECEDENT. A FAILURE TO COOPERATE BY A SIMPLE NOTICE TO THE ARCHITECT SHALL RELIEVE THE ARCHITECT FROM RESPONSIBILITY FOR ALL CONSEQUENCES. CHANGES MADE FROM THE PLANS WITHOUT THE CONSENT OF THE ARCHITECT ARE UNAUTHORIZED AND SHALL RELIEVE THE ARCHITECT OF RESPONSIBILITY FOR ALL CONSEQUENCES ARISING OUT

CONTRACTOR IS SOLELY RESPONSIBLE FOR THE CONSTRUCTION MEANS, METHODS, TECHNIQUES, SEQUENCES OR PROCEDURES, SAFETY PRECAUTIONS AND PROGRAMS IN CONNECTION WITH THE WORK. CONTRACTOR AND EACH SUBCONTRACTOR SHALL INSTALL ALL THEIR MATERIALS IN ACCORDANCE WITH MANUFACTURERS INSTALLATION INSTRUCTIONS AND TO MEET PRODUCT WARRANTY REQUIREMENTS. THE ARCHITECT SHALL NOT BE RESPONSIBLE FOR THE CONTRACTOR'S FAILURE TO PERFORM THE WORK IN ACCORDANCE WITH THE REQUIREMENTS OF THE CONTRACT DOCUMENTS.

THE CONTRACTOR AND EACH SUBCONTRACTOR AFFIRMATIVELY REPRESENTS THAT THEY ARE SKILLED AND EXPERIENCED IN THE PERFORMANCE OF WORK AS REQUIRED BY THIS PROJECT AND IN THE USE AND INTERPRETATION OF DRAWINGS AND SPECIFICATIONS SUCH AS THOSE INCLUDED IN THE CONTRACT DOCUMENTS. THE CONTRACTOR AGREES THAT IT SHALL BE CONCLUSIVELY PRESUMED THAT THE CONTRACTOR HAS EXERCISED HIS AFOREMENTIONED SKILL AND EXPERIENCE AND HAS FOUND THE DRAWINGS AND SPECIFICATIONS SUFFICIENT AND FREE FROM AMBIGUITIES, ERRORS, DISCREPANCIES, AND OMISSIONS FOR THE PURPOSE OF DETERMINING ITS CONTRACT FOR THE PERFORMANCE OF THE WORK IN CONFORMITY WITH THE DRAWINGS, SPECIFICATIONS, AND ALL OTHER CONTRACT DOCUMENTS.

8. THE CONTRACTOR AND EACH SUBCONTRACTOR SHALL EXAMINE AND BECOME FAMILIAR WITH ALL CONTRACT DOCUMENTS IN THEIR ENTIRETY AND ARE RESPONSIBLE FOR ALL WORK PERTAINING TO THEIR TRADE REGARDLESS OF DRAWING OR SECTION OF SPECIFICATIONS IT IS WRITTEN OR DEPICTED IN. ALL COSTS SUBMITTED AND WORK PERFORMED SHALL BE BASED ON THOROUGH KNOWLEDGE OF ALL WORK AND MATERIALS REQUIRED FOR A COMPLETE AND FUNCTIONING SYSTEM TO FULFILL THE INTENT OF THE CONTRACT DOCUMENTS WHETHER FULLY DEFINED BY THE DRAWINGS AND SPECIFICATIONS OR NOT. ANY DISCREPANCY AND/OR UNCERTAINTY SHOULD BE VERIFIED WITH THE ARCHITECT.

9. IN NO CASE SHALL ANY CONTRACTOR PROCEED WITH WORK IN UNCERTAINTY.

IF THE CONTRACTOR OR THE OWNER SELECTS OR SUBSTITUTES ANY ASSEMBLY, SYSTEM, PRODUCT, MATERIAL, OR DESIGN FOR THE PROJECT WITHOUT OR AGAINST THE ARCHITECT'S APPROVAL, THE ARCHITECT SHALL HAVE NO RESPONSIBILITY FOR THAT DECISION BY THE CONTRACTOR OR OWNER OR FOR THE PERFORMANCE OF SUCH ITEMS, AND THE ARCHITECT SHALL NOT BE REQUIRED TO ISSUE ANY OPINION OR CERTIFICATE WITH RESPECT TO

11. THE CONTRACTOR IS SOLELY RESPONSIBLE FOR COORDINATION OF WORK BETWEEN ALL TRADES AND WILL IDENTIFY ALL BLOCKING, SURFACE PREPARATION AND SIMILAR ITEMS THAT ARE NECESSARILY PROVIDED BY ONE TRADE TO FACILITATE THE WORK OF ANY OTHER. ALL TRADES WILL BE REQUIRED TO REPORT ANY DEFICIENCIES ON THE PROJECT WHICH WOULD LEAD TO AN INCOMPLETE OR POOR-QUALITY FINISHED PRODUCT.

EACH TRADE SHALL EXAMINE ALL SUBSURFACES AND WORK OF OTHERS THAT AFFECT THEIR INDIVIDUAL SCOPE OF WORK. REPORT IN WRITING, TO THE GENERAL CONTRACTOR, WITH A COPY TO THE ARCHITECT, ANY CONDITIONS, EXCEPT FOR UNFORESEEN EXISTING CONDITIONS, WHICH MAY PROVE DETRIMENTAL TO THE WORK. FAILURE TO OBSERVE THIS INJUNCTION WILL CONSTITUTE A WAIVER TO ANY SUBSEQUENT CLAIMS TO THE CONTRARY AND MAKE THIS CONTRACTOR RESPONSIBLE FOR ANY CORRECTION ARCHITECT MAY REQUIRE. COMMENCEMENT OF WORK WILL BE CONSTRUED AS ACCEPTANCE OF ALL SUBSURFACES.

UNIT TYPE	# UNITS	% TOTAL	TOTAL SF
1 BED / 1 BATH			
UNIT A1	13	5.0%	8629 SF
UNIT A2	10	4.2%	7255 SF
UNIT A2 TYPE A	2 1	0.8%	1451 SF
UNIT A3	33	15.0%	25824 SF
UNIT A3 ALT	12	5.5%	9548 SF
	70	30.6%	52707 SF
1 BED / 1 BATH / DEI	N		
UNIT B1	9	5.3%	9186 SF
UNIT B1 ALT	4	2.4%	4185 SF
UNIT B2	4	2.7%	4598 SF
UNIT B4	1	0.7%	1148 SF
	18	11.1%	19117 SF
2 BED / 2 BATH			
UNIT C1	32	21.3%	36713 SF
UNIT C1 ALT 2	1	0.7%	1127 SF
LINIT C1 ALT 3	4 1	2.7%	4692 SF
UNIT C1 TYPE A	1.5	0.7%	1147 SF
UNIT C2	14	10.0%	17229 SF
UNIT C3	8	5.6%	9639 SF
UNIT C4	4	2.9%	4947 SF
	64	43.8%	75494 SF
2 BED / 2 BATH / DEI	N		
UNIT D1	3	2.6%	4497 SF
UNIT D1 ALT	2	1.7%	2998 SF
UNIT D1 ALT 2	1	0.9%	1499 SF
UNIT PH	6	5.5%	9563 SF
	12	10.8%	18558 SF
GUEST			
GUEST SUITE	1	0.2%	358 SF

UNIT TYPE	# UNITS	% TOTAL	TOTAL SF.
BED / 1 BATH			
NIT A1	7	3.2%	4647 SF
NIT A2	11	5.5%	7980 SF
NIT A2 TYPE A	2	1.0%	1451 SF
NIT A3	18	9.7%	14086 SF
NIT A3 ALT	18	9.9%	14322 SF
NIT A4	3	1.5%	2221 SF
BED / 1 BATH / DE	59 N	30.9%	44707 SF
NIT B1	6	4.2%	6124 SF
NIT B3	4	2.9%	4241 SF
INIT DO	10	7.2%	10365 SF
BED / 2 BATH	10	1.2/0	10000 31
NIT C1	31	24.6%	35566 SF
NIT C1 ALT	4	3.2%	4692 SF
NIT C1 ALT 2	3	2.3%	3381 SF
NIT C1 TYPE A	2	1.6%	2294 SF
NIT C2	12	10.2%	14768 SF
NIT C3	6	5.0%	7229 SF
BED / 2 BATH / DE	58 N	46.9%	67930 SF
NIT D1	8	8.3%	11993 SF
NIT PH	4	4.4%	6376 SF
1411 1 11	12	12.7%	18369 SF
TUDIO	12	12.770	10003 01
NIT S1	7	2.3%	3360 SF
	7	2.3%	3360 SF
OTALS	146	100.0%	144730 SF

riangleRevisions

JOB NO. DATE
705921 03.15.2023

DRAWN BY
TSC/SIW

4/11/2023

CITY COMMENTS

SHEET NAME
COVER SHEET

SHEET NO.

A2.43

A2.44

A2.47

A2.48

A3.00

A4.11

A4.12

A4.13

A4.14

A4.15

A4.27

A5.10

A5.20

A5.40

A6.11

C-0001

C-0010

C-0200

C-0210

C-0211

C-0212

C-0300

C-0400

C-0420

C-0421

C-0422

C-0423

C-0430

C-0500

C-0510

C-0520

C-0530

A7.02

SEGMENT H SLAB & 1ST FLOOR PLANS

SEGMENT H 2ND & 3RD FLOOR PLANS

SEGMENT H 4TH FLOOR & ROOF PLAN

ROOF DRAIN PLAN

DRAINAGE PLAN

STORM SEWER PLAN AND PROFILE

STORM SEWER PLAN AND PROFILE

STORM SEWER PLAN AND PROFILE

02 - CIVIL & SITE

01 - ARCHITECTURAL

COVER SHEET

DRAWING INDEX

BUILDING 1 AREA PLANS

BUILDING 1 AREA PLANS

BUILDING 2 AREA PLANS

BUILDING 2 AREA PLANS

RATED ASSEMBLIES

TYPICAL UNIT INFO

UNIT S1 PLANS

UNIT A1 PLANS

UNIT A2 PLANS

UNIT A3 PLANS

UNIT A4 PLANS

UNIT B1 PLANS

UNIT B2 PLANS

UNIT B3 PLANS

UNIT B4 PLANS

UNIT C1 PLANS

UNIT C2 PLANS

UNIT C3 PLANS UNIT C4 PLANS

UNIT D1 PLANS

UNIT PH PLANS

GUEST SUITE

TYPE A UNIT PLANS

BUILDING 1 OVERALL SLAB PLAN

BUILDING 1 OVERALL 1ST FLOOR PLAN

BUILDING 1 OVERALL 2ND FLOOR PLAN

BUILDING 1 OVERALL 3RD FLOOR PLAN

BUILDING 1 OVERALL 4TH FLOOR PLAN

SEGMENT A SLAB & 1ST FLOOR PLAN

SEGMENT A 2ND & 3RD FLOOR PLAN

SEGMENT A 4TH FLOOR & ROOF PLAN

SEGMENT B SLAB & 1ST FLOOR PLAN

SEGMENT B 2ND & 3RD FLOOR PLAN

SEGMENT C SLAB PLAN

SEGMENT C 1ST FLOOR PLAN

SEGMENT C 2ND FLOOR PLAN

SEGMENT C 3RD FLOOR PLAN

SEGMENT C 4TH FLOOR PLAN

SEGMENT C ROOF PLAN

SEGMENT D SLAB PLAN

SEGMENT D 1ST FLOOR

SEGMENT D 2ND FLOOR

SEGMENT D 3RD FLOOR

SEGMENT D 4TH FLOOR

SEGMENT D ROOF PLAN

SEGMENT E 2ND & 3RD FLOOR

SEGMENT E SLAB AND 1ST FLOOR PLAN

SEGMENT E 4TH FLOOR & ROOF PLAN

BUILDING 2 OVERALL 1ST FLOOR PLAN

BUILDING 2 OVERALL 2ND FLOOR PLAN

BUILDING 2 OVERALL 3RD FLOOR PLAN

BUILDING 2 OVERALL 4TH FLOOR PLAN

SEGMENT F SLAB & 1ST FLOOR PLAN

SEGMENT F 2ND & 3RD FLOOR PLANS

SEGMENT G SLAB & 1ST FLOOR PLAN

SEGMENT G 2ND & 3RD FLOOR

SEGMENT F 4TH FLOOR & ROOF PLANS

SEGMENT G 4TH FLOOR & ROOF PLAN

SEGMENT G / H BASEMENT SLAB & FLOOR PLAN

BUILDING 2 OVERALL ROOF PLAN

BUILDING 2 OVERALL SLAB & BASEMENT PLAN

SEGMENT B 4TH FLOOR & ROOF PLAN

BUILDING 1 OVERALL ROOF PLAN

RATED PENETRATIONS

BUILDING 1 CODE ANALYSIS & PLANS

BUILDING 2 CODE ANALYSIS & PLANS

TYPE "A" UNIT ACCESSIBILITY INFO

TYPE "B" UNIT ACCESSIBILITY INFO

COMMON AREA ACCESSIBILITY INFO

BUILDING 1 EGRESS & OCCUPANCY PLANS

BUILDING 1 EGRESS & OCCUPANCY PLANS

BUILDING 2 EGRESS & OCCUPANCY PLANS

BUILDING 2 EGRESS & OCCUPANCY PLANS

A0.00

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A2.37

A2.38

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A2.41

A2.42

C-0540

C-0601

➤ C-0900

S2.22

S2.23a

S2.30

SEG (E) 2ND & 3RD FLOOR FRAMING PLAN

SEG (E) SHEARWALL PLAN

OVERALL PT SLAB PLAN

SEG (E) 4TH FLOOR & ROOF FRAMING PLAN

BLDG 2 - OVERALL BASEMENT PT SLAB PLAN /

DRAINAGE TABLES

UTILITY PLAN

SANITARY SEWER PLAN & PROFILE

P. 913.831.1415 F. 913.831.1563 NSPJARCH.COM

SEGMENT A ROOF - ELECTRICAL

SEGMENT B 1ST & 2ND FLOOR - ELECTRICAL

SEGMENT B 3RD & 4TH FLOOR - ELECTRICAL

SEGMENT J BASEMENT & 1ST FLOOR PLANS	C-2000	DETAILS	S2.33	BLDG 2 - OVERALL 3RD FLOOR FRAMING PLAN	P1.27	SEGMENT F 4TH FLOOR - PLUMBING	E1.08	SEGMENT B ROOF - ELECTRICAL
SEGMENT J 2ND & 3RD FLOOR	C-2001	DETAILS	S2.34	BLDG 2 - OVERALL 4TH FLOOR FRAMING PLAN	P1.28	SEGMENT F - ROOF PLAN - PLUMBING	E1.09	SEGMENT C 1ST FLOOR - ELECTRICAL
SEGMENT J 4TH FLOOR & ROOF PLAN	C-2002	DETAILS	S2.35	BLDG 2 - OVERALL ROOF FRAMING PLAN	P1.29	SEGMENT G BASEMENT & 1ST FLOOR - PLUMBING	E1.10	SEGMENT C 2ND FLOOR - ELECTRICAL
BLDG. 1 EXTERIOR ELEVATIONS	C-2003	DETAILS	S2.36	SEG (F) PT SLAB & FOUNDATION PLAN	P1.30	SEGMENT G 2ND & 3RD FLOOR - PLUMBING	E 1.11	SEGMENT C 3RD FLOOR - ELECTRICAL
BLDG. 1 EXTERIOR ELEVATIONS	C-2004	DETAILS	S2.37	SEG (F) 2ND & 3RD FLOOR FRAMING PLAN	P1.31	SEGMENT G 4TH FLOOR & ROOF - PLUMBING	E1.12	SEGMENT C 4TH FLOOR - ELECTRICAL
BLDG. 1 EXTERIOR ELEVATIONS	L-0100	LANDSCAPE PLAN - OVERVIEW	S2.38	SEG (F) 4TH FLOOR & ROOF FRAMING PLAN	P1.32	SEGMENT H BASEMENT & 1ST FLOOR - PLUMBING	E1.13	SEGMENT C ROOF - ELECTRICAL
BLDG. 1 COURTYARD ELEVATIONS	L-0200	LANDSCAPE PLAN - GROUNDCOVER	S2.38a	SEG (F) SHEARWALL PLAN	P1.33	SEGMENT H 2ND & 3RD FLOOR - PLUMBING	E1.14	SEGMENT D 1ST FLOOR - ELECTRICAL
BLDG. 2 EXTERIOR ELEVATIONS	L-0300	LANDSCAPE PLAN - DETAILED	S2.39a	SEG (G) BASEMENT PT SLAB PLAN / PT SLAB PLAN	P1.34	SEGMENT H 4TH FLOOR & ROOF - PLUMBING	E 1.15	SEGMENT D 2ND FLOOR - ELECTRICAL
BLDG. 2 EXTERIOR ELEVATIONS	L-0301	LANDSCAPE PLAN - DETAILED	S2.39b	SEG (G) BASEMENT FOUNDATION / FOUNDATION &	P1.35	SEGMENT J BASEMENT & 1ST FLOOR - PLUMBING	E 1.16	SEGMENT D 3RD FLOOR - ELECTRICAL
BLDG 2. COURTYARD ELEVATIONS	L -0302	LANDSCAPE PLAN - DETAILED	00.40	1ST FLOOR FRAMING PLAN	P1.36	SEGMENT J 2ND & 3RD FLOOR - PLUMBING	E 1.17	SEGMENT D 4TH FLOOR - ELECTRICAL
BUILDING SECTION	L-0303	LANDSCAPE PLAN - DETAILED	S2.40	SEG (G) 2ND & 3RD FLOOR FRAMING PLAN	P1.37	SEGMENT J 4TH FLOOR & ROOF - PLUMBING	E1.18	SEGMENT D ROOF - ELECTRICAL
WALL SECTIONS	L -0304	LANDSCAPE PLAN - DETAILED	S2.41	SEG (G) 4TH FLOOR & ROOF FRAMING PLAN	P 2.01	UNIT PLUMBING PLANS	Ē1.19	SEGMENT E 1ST FLOOR - ELECTRICAL
WALL SECTIONS	L -0305	LANDSCAPE PLAN - DETAILED	S2.41a	SEG (G) SHEARWALL PLAN	P 2.02	UNIT PLUMBING PLANS	E 1.20	SEGMENT E 2ND FLOOR - ELECTRICAL
WALL SECTIONS	L-0306	LANDSCAPE PLAN - DETAILED	S2.42	SEG (H) BASEMENT PT SLAB PLAN / PT SLAB PLAN	P 2.03	UNIT PLUMBING PLANS	E1.21	SEGMENT E 3RD FLOOR - ELECTRICAL
WALL SECTIONS	L -0307	LANDSCAPE PLAN - DETAILED	S2.43	SEG (H) BASEMENT FOUNDATION / FOUNDATION & 1ST FLOOR FRAMING PLAN	P2.04	UNIT PLUMBING PLANS	E1.22	SEGMENT E 4TH FLOOR - ELECTRICAL
WALL SECTIONS	L-0308	LANDSCAPE PLAN - DETAILED	S2.44	SEG (H) 2ND & 3RD FLOOR FRAMING PLAN	P 2.05	UNIT PLUMBING PLANS	E1.23	SEGMENT E ROOF - ELECTRICAL
WALL SECTIONS	L-0309	LANDSCAPE PLAN - DETAILED	S2.45	SEG (H) 4TH FLOOR & ROOF FRAMING PLAN	P3.01	PLUMBING RISERS	Ē1.24	SEGMENT F 1ST FLOOR - ELECTRICAL
WALL SECTIONS	L-0310	LANDSCAPE PLAN - DETAILED	S2.45a	SEG (H) SHEARWALL PLAN	P 3.02	PLUMBING RISERS	E1.25	SEGMENT F 2ND FLOOR - ELECTRICAL
STAIR & ELEVATOR A PLANS & SECTIONS	L-0311	LANDSCAPE PLAN - DETAILED	S2.46a	SEG (J) BASEMENT PT SLAB PLAN / PT SLAB PLAN	P3.03	PLUMBING RISERS	E 1.26	SEGMENT F 3RD FLOOR - ELECTRICAL
STAIR B PLANS & SECTIONS	L-0400	LANDSCAPE NOTES	S2.46b	SEG (J) BASEMENT FOUNDATION / FOUNDATION & 1ST	P3.04	PLUMBING RISERS	E 1.27	SEGMENT F 4TH FLOOR - ELECTRICAL
STAIR & ELEVATOR C & D PLANS & SECTIONS	L -0401	LANDSCAPE NOTES	02.400	FLOOR FRAMING PLAN		/IECHANICAL	E1.28	SEGMENT F ROOF - ELECTRICAL
STAIR & ELEVATOR E PLANS & SECTIONS	L -0402	LANDSCAPE NOTES	S2.47	SEG (J) 2ND & 3RD FLOOR FRAMING PLAN	<i>(</i>		E1.29	SEGMENT G BASEMENT & 1ST FLOOR - ELECTRICAL
STAIR & ELEVATOR F PLANS & SECTIONS	SP1.00	OVERALL SITE AMENITY PLAN	S2.48	SEG (J) 4TH FLOOR & ROOF FRAMING PLAN	M1.01	SEGMENT A 1ST FLOOR - HVAC	E 1.30	SEGMENT G 2ND & 3RD FLOOR - ELECTRICAL
STAIR & ELEVATOR G PLANS & SECTIONS	SP1.01	DETAILED POOL AMENITY PLAN	S2.48a	SEG (J) SHEARWALL PLAN	M1.02	SEGMENT A 2ND FLOOR - HVAC	E1.31	SEGMENT G 4TH FLOOR & ROOF - ELECTRICAL
STAIR & ELEVATOR J PLANS & SECTIONS	SP1.02	POOL AMENITY AREA DETAILS	S2.60	BLDG 2 - SHEARWALL ELEVATIONS	M1.03	SEGMENT A 3RD FLOOR - HVAC	E1.32	SEGMENT H BASEMENT & 1ST FLOOR - ELECTRICAL
STAIR & ELEVATOR DETAILS	SP1.03	POOL AMENITY AREA DETAILS	S2.70	DETACHED GARAGES & TRASH ENCLOSURE	M1.04	SEGMENT A 4TH FLOOR - HVAC	E1.33	SEGMENT H 2ND & 3RD FLOOR - ELECTRICAL
FLOOR/WALL DETAILS	SP1.04	KITCHEN STRUCTURE & DOG PARK AREA	<u>√</u> \$2.80	BRACE ELEVATIONS	M1.05	SEGMENT A ROOF - HVAC	E1.34	SEGMENT H 4TH FLOOR & ROOF - ELECTRICAL
FIREWALL DETAILS	SP1.05	MONUMENT DETAILS	\$3.00	FOUNDATION DETAILS	M1.06	SEGMENT B 1ST & 2ND FLOOR - HVAC	E1.35	SEGMENT J BASEMENT & 1ST FLOOR - ELECTRICAL
FOUNDATION DETAILS		TRUCTURAL	S3.01	FOUNDATION DETAILS	M1.07	SEGMENT B 3RD & 4TH FLOOR - HVAC	£1.36	SEGMENT J 2ND & 3RD FLOOR - ELECTRICAL
FOUNDATION DETAILS	03 - 3	IRUCIURAL	S3.02	FOUNDATION DETAILS	M1.08	SEGMENT B ROOF - HVAC	E 1.37	SEGMENT J 4TH FLOOR & ROOF - ELECTRICAL
FOUNDATION DETAILS	S0.01	GENERAL NOTES	<u>\$3</u> .03	FOUNDATION DETAILS	M1.09	SEGMENT C 1ST FLOOR - HVAC	E 2.01	UNIT PLANS - ELECTRICAL
MID WALL & BALCONY DETAILS	S0.02	WIND & SNOW LOAD INFORMATION, NAILING		FOUNDATION DETAILS	M1.10	SEGMENT C 2ND FLOOR - HVAC	E 2.02	UNIT PLANS - ELECTRICAL
MID WALL & BALCONY DETAILS		SCHEDULE	\$3.04 \$3.10	FLOOR FRAMING DETAILS	M1.11	SEGMENT C 3RD FLOOR - HVAC	E2.03	UNIT PLANS - ELECTRICAL
ROOF DETAILS	S0.03	FRAMING, FOODTING & SLAB/DECK SCHEDULES	S3.11	FLOOR FRAMING DETAILS	M1.12	SEGMENT C 4TH FLOOR - HVAC	E 2.04	UNIT PLANS - ELECTRICAL
ROOF DETAILS	S0.04	STUD BEARING WALL SCHEDULE	S3.12	FLOOR FRAMING DETAILS	M1.13	SEGMENT C ROOF - HVAC	E2.05	UNIT PLANS - ELECTRICAL
MATERIAL TRANSITION DETAILS	S0.05	SHEARWALL SCHEDULE & DETAILS	S3.12	FLOOR FRAMING DETAILS	M1.14	SEGMENT D 1ST FLOOR - HVAC	E 3.01	ELECTRICAL DETAILS
DOOR SCHEDULE	S0.06	SHEARWALL & FRAMING DETAILS	93.10 93.1 <i>1</i>	FLOOR FRAMING DETAILS	M1.15	SEGMENT D 2ND FLOOR - HVAC	E 3.02	ELECTRICAL DETAILS
WINDOW SCHEDULE	S0.07	SHEARWALL & FRAMING DETAILS	A S3 15	GARAGE FRAMING DETAILS	M1.16	SEGMENT D 3RD FLOOR - HVAC	E3.03	ELECTRICAL DETAILS/SCHEDULES
WINDOW DETAILS	S0.08	GENERAL FRAMING DETAILS	△S3.15	ROOF FRAMING DETAILS	M1.17	SEGMENT D 4TH FLOOR - HVAC	E 3.04	ELECTRICAL DETAILS/SCHEDULES
CLUBHOUSE 1ST FLOOR PLAN	S0.09	GENERAL FRAMING DETAILS	\$3.20 \$3.21	ROOF FRAMING DETAILS	M1.18	SEGMENT D ROOF - HVAC	E 3.05	ELECTRICAL SCHEDULES
CLUBHOUSE 2ND FLOOR PLAN	S0.10	STAIR FRAMING DETAILS	S3.22	ROOF FRAMING DETAILS	► M1.19	SEGMENT E 1ST FLOOR - HVAC	E3.06	ELECTRICAL SCHEDULES
CLUBHOUSE RCP - 1ST FLOOR	\$0.20 \$1.99	STEEL FRAMING INFO & DETAILS	S3.23	ROOF FRAMING DETAILS	M1.20	SEGMENT E 2ND FLOOR - HVAC	√ 07 T	ELECOM
CLUBHOUSE RCP - 2ND FLOOR	^{∠1} \$1.99	BLDGS's 1 & 2 OVERALL GRID REFERENCE PLAN			M1.21	SEGMENT E 3RD FLOOR - HVAC	6 07 - T	ELECOM
DOG WASH/BIKE SHOP PLANS	S2.00	BLDG 1 - OVERALL PT SLAB PLAN	04 - N	MEP	M1.22	SEGMENT E 4TH FLOOR - HVAC	T1.01	BUILDING 1 - OVERALL 1ST FLOOR PLAN
CLUBHOUSE - INTERIOR ELEVATIONS	S2.01	BLDG 1 - OVERALL FOUNDATION PLAN	ME0.01	PROJECT STANDARDS	M1.23	SEGMENT E ROOF - HVAC	T1.02	BUILDING 1 - OVERALL 2ND FLOOR PLAN
CLUBHOUSE - INTERIOR ELEVATIONS	S2.02	BLDG 1 - OVERALL 2ND FLOOR FRAMING PLAN	ME1.01	SITE PLAN	M1.24	SEGMENT F 1ST FLOOR - HVAC	T1.03	BUILDING 1 - OVERALL 3RD FLOOR PLAN
GARAGE PLANS AND ELEVATIONS	S2.03	BLDG 1 - OVERALL 3RD FLOOR FRAMING PLAN	ME1.01	PARTIAL SITE PLAN	M1.25	SEGMENT F 2ND FLOOR - HVAC	T 1.04	BUILDING 1 - OVERALL 4TH FLOOR PLAN
TRASH ENCLOSURE	S2.04	BLDG 1 - OVERALL 4TH FLOOR FRAMING PLAN	ME1.03	GARAGE FLOOR PLANS - ELECTRICAL	M1.26	SEGMENT F 3RD FLOOR - HVAC	T1.05	BUILDING 2 - OVERALL 1ST FLOOR PLAN
IVII 9 CITE	S2.05	BLDG 1 - OVERALL ROOF FRAMING PLAN	~		M1.27	SEGMENT F 4TH FLOOR - HVAC	T 1.06	BUILDING 2 - OVERALL 2ND FLOOR PLAN
IVIL & SITE	S2.06	SEG (A) PT SLAB & FOUNDATION PLAN	04 - F	PLUMBING	M1.28	SEGMENT F ROOF - HVAC	T1.07	BUILDING 2 - OVERALL 3RD FLOOR PLAN
COVER SHEET	S2.07	SEG (A) 2ND & 3RD FLOOR FRAMING PLAN	P1.01	SEGMENT A 1ST FLOOR - PLUMBING	M1.29	SEGMENT G BASEMENT & 1ST FLOOR - HVAC	T1.08	BUILDING 2 - OVERALL 4TH FLOOR PLAN
GENERAL NOTES	S2.08	SEG (A) 4TH FLOOR & ROOF FRAMING PLAN	P1.02	SEGMENT A 2ND FLOOR - PLUMBING	M1.30	SEGMENT G 2ND & 3RD FLOOR - HVAC	C T2.01	TELECOM DETAILS
EXISTING CONDITIONS PLAN	S2.08a	SEG (A) SHEARWALL PLAN	P1.02	SEGMENT A 3RD FLOOR - PLUMBING	M1.31	SEGMENT G 4TH FLOOR & ROOF - HVAC	Zno II	ITEDIODO
SITE PLAN	S2.09	SEG (B) PT SLAB & FOUNDATION PLAN	P1.04	SEGMENT A 4TH FLOOR - PLUMBING	M1.32	SEGMENT H BASEMENT & 1ST FLOOR - HVAC	7 UO - II	NTERIORS
DIMENSION PLAN	S2.10	SEG (B) 2ND & 3RD FLOOR FRAMING PLAN		SEGMENT A ROOF PLAN - PLUMBING	M1.33	SEGMENT H 2ND & 3RD FLOOR - HVAC	ID.100	CLUBHOUSE - FURNITURE PLAN
DIMENSION PLAN	S2.11	SEG (B) 4TH FLOOR & ROOF FRAMING PLAN	P1.05 P1.06	SEGMENT B 1ST & 2ND FLOOR - PLUMBING	M1.34	SEGMENT H 4TH FLOOR & ROOF - HVAC	D.200	CLUBHOUSE - FINISH PLANS
DIMENSION PLAN	S2.11a	SEG (B) SHEARWALL PLAN	P1.07	SEGMENT B 3RD & 4TH FLOOR - PLUMBING	M1.35	SEGMENT J BASEMENT & 1ST FLOOR - HVAC	(ID.300	CLUBHOUSE - FLOORING PLANS
EROSION CONTROL PLAN - PHASE 1	S2.12	SEG (C) PT SLAB & FOUNDATION PLAN	P1.08	SEGMENT B - ROOF PLAN - PLUMBING	M1.36	SEGMENT J 2ND & 3RD FLOOR - HVAC	D.400	CLUBHOUSE - DECORATIVE CEILING & LIGHTING
EROSION CONTROL PLAN - PHASE 2	S2.13	SEG (C) 2ND & 3RD FLOOR FRAMING PLAN	P1.09	SEGMENT C 1ST FLOOR - PLUMBING	M1.37	SEGMENT J 4TH FLOOR & ROOF - HVAC	ID.500	CLUBHOUSE - INTERIOR ELEVATIONS
EROSION CONTROL PLAN - PHASE 3	S2.14	SEG (C) 4TH FLOOR & ROOF FRAMING PLAN	P1.09	SEGMENT C 2ND FLOOR - PLUMBING SEGMENT C 2ND FLOOR - PLUMBING	M2.01	UNIT PLANS - HVAC	D.501	CLUBHOUSE - INTERIOR ELEVATIONS
GRADING PLAN	S2.14a	SEG (C) SHEARWALL PLAN	P1.11	SEGMENT C 3RD FLOOR - PLUMBING SEGMENT C 3RD FLOOR - PLUMBING	M2.02	UNIT PLANS - HVAC	D.502	CLUBHOUSE - ENLARGED PLANS & INTERIOR
SPOT ELEVATION PLAN	S2.15	SEG (D) PT SLAB PLAN	P1.11	SEGMENT C 4TH FLOOR - PLUMBING	M2.03	UNIT PLANS - HVAC		ELEVATIONS
SPOT ELEVATION PLAN	S2.16	SEG (D) FOUNDATION PLAN	P1.12	SEGMENT C - ROOF PLAN - PLUMBING	M 2.04	UNIT PLANS - HVAC	مرر	
SPOT ELEVATION PLAN	S2.17	SEG (D) 2ND FLOOR FRAMING PLAN	P1.13	SEGMENT D 1ST FLOOR - PLUMBING	M2.05	UNIT PLANS - HVAC		
SPOT ELEVATION PLAN	S2.18	SEG (D) 3RD FLOOR FRAMING PLAN	A		MP1.01	MECHANICAL DETAILS		
RETAINING WALL PLAN	S2.19	SEG (D) 4TH FLOOR FRAMING PLAN	P1.15 P1.16	SEGMENT D 2ND FLOOR - PLUMBING SEGMENT D 3RD FLOOR - PLUMBING	MP1.02	MECHANICAL DETAILS		
STORM SEWER GENERAL LAYOUT	S2.20	SEG (D) ROOF FRAMING PLAN	P1.16	SEGMENT D 4TH FLOOR - PLUMBING	MP1.03	MECHANICAL DETAILS		
STORM SEWER GENERAL LAYOUT	S2.20a	SEG (D) SHEARWALL PLAN		SEGMENT D - ROOF PLAN - PLUMBING	~~~\\c_F			
STORM SEWER PLAN AND PROFILE	S2.21	SEG (E) PT SLAB & FOUNDATION PLAN	P1.18	SEGMENT E 1ST FLOOR - PLUMBING	U0 - E	LECTRICAL		
	CO 00	CEC /E) OND 0 ODD ELOOD EDAMINO DI ANI	1.19	OLOMBIAL E TOTT LOOK - I LOMBING				

P1.24 P1.25

P1.26

SEGMENT F 1ST FLOOR - PLUMBING

SEGMENT F 2ND FLOOR - PLUMBING

SEGMENT F 3RD FLOOR - PLUMBING

SEGMENT A 1ST FLOOR - ELECTRICAL

SEGMENT A 2ND FLOOR - ELECTRICAL

SEGMENT A 3RD FLOOR - ELECTRICAL

SEGMENT A 4TH FLOOR - ELECTRICAL

E1.01

E1.02

E1.03

<u>∧</u> E1.04

SEGMENT E 2ND FLOOR - PLUMBING

SEGMENT E 3RD FLOOR - PLUMBING

SEGMENT E 4TH FLOOR - PLUMBING

SEGMENT E - ROOF PLAN - PLUMBING

P1.22

↑ P1.23

BLDG 2 - OVERALL BASEMENT FOUNDATION /

OVERALL FOUNDATION & 1ST FLOOR FRAMING

BLDG 2 - OVERALL 2ND FLOOR FRAMING PLAN

S2.32


LEE'

DRAWING RELEASE LOG

• 03.15.2023 - PERMIT SUBMITTAL

 \triangle REVISIONS

03.15.2023 TSC/SIW CITY COMMENTS
SHEET NAME
DRAWING INDEX

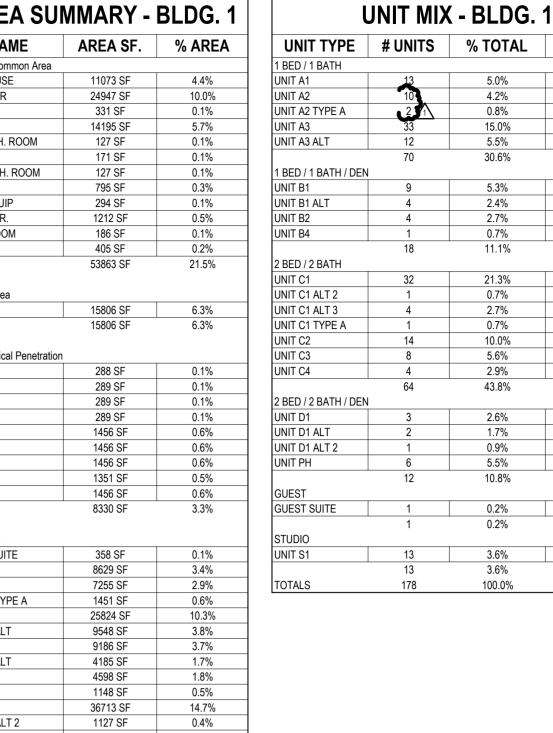

GARAGE IDF/ MECH. ROOM IDF/MEP 1499 SF 9563 SF 6240 SF 172474 SF 250473 SF 0.6% 3.8% 2.5% 68.9% 100.0%

1 AREA USE - B1 - 1ST FLR.

3/64" = 1'-0"

NOT FOR CONSTRUCTION

JOB NO. **705921** DRAWN BY **TSC/SIW** DATE **03.15.2023** 4/11/2023
CITY COMMENTS
SHEET NAME
BUILDING 1 AREA PLANS

2 AREA USE - B1 - 2ND FLR.

ARCHITECTS PA 3515 W. 75TH ST., SUITE 20



UNIT TYPE	# UNITS	% TOTAL	TO
1 BED / 1 BATH			
UNIT A1	13	5.0%	8
UNIT A2	10	4.2%	7
UNIT A2 TYPE A	2	0.8%	1
UNIT A3	33	15.0%	2
UNIT A3 ALT	12	5.5%	9
	70	30.6%	5
1 BED / 1 BATH / DEN			
UNIT B1	9	5.3%	9
UNIT B1 ALT	4	2.4%	4
UNIT B2	4	2.7%	4
UNIT B4	1	0.7%	1
	18	11.1%	1
2 BED / 2 BATH			
UNIT C1	32	21.3%	3
UNIT C1 ALT 2	1	0.7%	1
UNIT C1 ALT 3	4	2.7%	4
UNIT C1 TYPE A	1	0.7%	1
UNIT C2	14	10.0%	1
UNIT C3	8	5.6%	9
UNIT C4	4	2.9%	4
2 BED / 2 BATH / DEN	64 J	43.8%	7
UNIT D1	3	2.6%	4
UNIT D1 ALT	2	1.7%	2
UNIT D1 ALT 2	1	0.9%	1
UNIT PH	6	5.5%	9
	12	10.8%	1
GUEST	1 4	0.20/	
GUEST SUITE	1	0.2%	;
STUDIO	ı	0.270	,
UNIT S1	13	3.6%	6
	13	3.6%	6

AREA USE - B1 - 3RD FLR.

RICOGY

DRAWING RELEASE LOG

03.15.2023 - PERMIT SUBMITTAL

NO. DATE **921 03.15.2023**

JOB NO. DATE
705921 03.15.2023
DRAWN BY
TSC/SIW
4/11/2023
CITY COMMENTS
SHEET NAME
BUILDING 1 AREA PLANS

SHEET NO. **A0.11**

2 AREA USE - B1 - 4TH FLR.

2 AREA USE - B2 - 2ND FLR.

1 AREA USE - B2 - 1ST FLR.

A0.12



JOB NO. **705921** DRAWN BY **TSC/SIW** DATE **03.15.2023** 4/11/2023
CITY COMMENTS
SHEET NAME
BUILDING 2 AREA PLANS

1 AREA USE - B2 - 3RD FLR.

UNIT CI VIOLE VIOL	Exterior Area PATIO Major Vertical Penetrati ELEV. F ELEV. G ELEV. J STAIR F STAIR G STAIR J2 Store Area GARAGE UNIT A1 UNIT A2 UNIT A2 TYPE A UNIT A3 UNIT A3 ALT UNIT B1 UNIT B1 UNIT B1 UNIT B1 UNIT C1 UNIT C1 ALT UNIT C1 TYPE A UNIT C2 UNIT C3 UNIT C3 UNIT C3 UNIT C3 UNIT C3 UNIT C3 UNIT C1	12785 SF 12785 SF 12785 SF on 283 SF 355 SF 285 SF 1456 SF 1820 SF 1456 SF 393 SF 6048 SF 3419 SF 4647 SF 7980 SF 1451 SF 14086 SF 14322 SF 2221 SF 6124 SF 4241 SF 35566 SF 4692 SF 3381 SF 2294 SF 14768 SF 7229 SF 11993 SF 6376 SF 3360 SF 148149 SF 223584 SF	5.5. 5.6. 0.0. 0.0. 0.0. 0.0. 0.0. 2.7 1.1. 2.1. 1.5 2.1. 1.6.6. 3.3. 5.2. 1.1. 666 1000
UNITED TOO TOO TOO TOO TOO TOO TOO TOO TOO TO	B3 SF	????	
1594 SF	T PH 14 SF BATH / DEN NIT S1 480 SF STUDIO		
WIT C2 280 / 280			

5.7% 5.7% 0.1% 0.2% 0.1% 0.7% 0.8% 0.7% 0.2% 2.7% 7 2.3% 3360 SF 7 2.3% 3360 SF 146 100.0% 144730 SF

AREA SUMMARY - BLDG. 2

286 SF 25127 SF 380 SF 1264 SF 609 SF 76 SF 3201 SF 176 SF 166 SF 56602 SF

0.3% 11.0% 0.1% 11.2% 0.2% 0.6% 0.3% 0.0% 1.4% 0.1% 25.3%

UNIT MIX - BLDG. 2

8.3% 11993 SF 4.4% 6376 SF 12.7% 18369 SF

UNIT TYPE # UNITS % TOTAL TOTAL SF

2 AREA USE - B2 - 4TH FLR.

1.0-HOUR ————— 2.0-HOUR _____ 2.0-HOUR ----2.0 HOUR ----

SHAFT ENCLOSURE (CONNECTING FOUR STORIES OR MORE):

50 STC SEE A0.30 FOR TYPICAL FIRE RESISTIVE ASSEMBLY INFORMATION SOUND TRANSMISSION CLASS RATING (STC): IMPACT INSULATION CLASS RATING (IIC): FIRE DEPARTMENT GENERAL NOTES

1. A KNOX BOX SHALL BE INSTALLED ON EACH BUILDING AT THE SPRINKLER RISER ROOM AND AT THE LOWEST STOP OF EACH ELEVATOR. THE KNOX BOX SHALL BE MOUNTED AT 60" A.F.F. & 48" A.F.F, RESPECTIVELY. 2. INSTALL SIGN ON THE DOOR TO RISER ROOM DESIGNATING: "FIRE ALARM/SPRINKLER RISER" 3. A SIGN SHALL BE PROVIDED AT EACH FLOOR LANDING IN AN INTERIOR EXIT STAIRWAY AND RAMP CONNECTING MORE THAN THREE STORIES, DESIGNATING THE FLOOR LEVEL, THE TERMINUS OF THE TOP AND BOTTOM OF THE INTERIOR EXIST STAIRWAY OR RAMP, AND THE IDENTIFICATION OF THE STAIR OR RAMP. THE SIGNAGE SHALL ALSO STATE THE STORY OF AND THE DIRECTION TO, THE EXIT DISCHARGE AND THE AVAILABILITY OF ROOF ACCESS FROM THE INTERIOR EXIT STAIRWAY AND RAMP FOR THE FIRE DEPARTMENT. THE SIGN SHALL BE LOCATED 5'-0" ABOVE THE FLOOR LANDING IN A POSITION THAT IS READILY VISIBLE WHEN THE DOORS ARE IN THE OPEN AND CLOSED POSITION, IN ADDITION TO THE STAIRWAY IDENTIFICATION SIGN, A FLOOR LEVEL SIGN IN RAISED CHARACTERS AND BRAILLE COMPLYING WITH

ICC A117.1 SHALL BE LOCATED AT EACH FLOOR LEVEL LANDING ADJACENT TO THE DOOR LEADING FROM THE ITNERIOR EXIT STAIRWAY AND RAMP INTO THE CORRIDOR TO IDENTIFY THE FLOOR LEVEL. 4. IN APPLICABLE, A 42" X 30" METAL GATE WITH SPRING CLOSER SHALL BE PROVIDED IN STAIRWAYS CONTINUING PAST THE LEVEL OF EXIT DISCHARGE TO PREVENT PERSONS FROM UNINTENTIONALLY CONTINUING INTO THE LEVELS BELOW. DIRECTION EXIT SIGNS SHALL BE

PASSIVE SYSTEMS

BEARING WALLS-EXTERIOR:

BEARING WALLS-INTERIOR:

FLOOR CONSTRUCTION:

SOUND RATINGS

ROOF CONSTRUCTION:

EXIT PASSAGEWAYS:

NON-BEARING WALLS-INTERIOR:

UNIT DEMISING WALLS(FIRE PARTITION):

CORRIDOR WALLS(FIRE PARTITION):

FIREBLOCKING REQUIRED IN COMBUSTIBLE CONCEALED LOCATIONS PER SECTION 708.4.2 & 718.2

2. EACH GARAGE DOOR TO BE ACTUATED BY CO MONITOR, TYP EACH LOCATION

CODE REFERENCE BUILDING CODE: JURISDICTION: LEE'S SUMMIT, MISSOURI

ADOPTED NATIONAL AND INTERNATIONAL CODES 2018 INTERNATIONAL BUILDING CODE (IBC) 2018 INTERNATIONAL FIRE CODE (IFC) 2018 INTERNATIONAL FUEL GAS CODÉ (IFGC) 2018 INTERNATIONAL MECHANICAL CODE (IMC) 2018 INTERNATIONAL PLUMBING CODE (IPC) 2017 NATIONAL ELECTRICAL CODE (NEC) 2009 ICC/ANSI A117.1 ACCESSIBILITY AND USABLE BUILDINGS

2018 NATIONAL FIRE PROTECTION ASSOCIATION (NFPA)

CODE APPROACH SUMMARY

BUILDING 1: THE OVERALL FACILITY IS SEPARATED INTO 5 BUILDINGS (SEGMENTS) WITH 2-HOUR FIRE WALLS TO ACCOMMODATE IBC AREA RESTRICTIONS. THE INDIVIDUAL BUILDINGS (SEGMENTS) THEN USE A COMBINATION OF SEPARATED AND NONSEPARATED MIXED USE APPROACHES AS DEFINDED THE IBC.

BUILDING 2: THE OVERALL FACILITY IS SEPARATED INTO 4 BUILDINGS (SEGMENTS) WITH 2-HOUR FIRE WALLS TO ACCOMMODATE IBC AREA RESTRICTIONS. THE INDIVIDUAL BUILDINGS (SEGMENTS) THEN USE A COMBINATION OF SEPARATED AND NONSEPARATED MIXED USE APPROACHES AS DEFINDED THE IBC.

ACCESSIBILITY COMPLIANCE

PERCENTAGE OF UNIT TYPES: REQUIRED: SECTION 1107.6.2.2.2 2% OF TOTAL PER SECTION 1107.6.2.2.1 TYPE A TYPE B PER SECTION 1107.6.2.2.2 PROVIDED: TYPE A TYPE B

THESE FACILITIES MUST BE DESIGNED TO COMPLY WITH ALL THE REQUIREMENTS OF THE AMERICANS WITH DISABILITY ACT, FAIR HOUSING AMENDMENTS ACT OF 1988, AS WELL AS ALL LOCAL AND STATE ACCESSIBILITY REGULATIONS. COMPLIANCE WITH ONE CODE DOES NOT NECESSARILY GUARANTEE COMPLIANCE WITH ALL ACCESSIBILITY CODES.

LIFE SAFETY SYSTEMS

SPRINKLER SYSTEMS

SEGMENT A

NFPA 13R CLASS 1 WET STANDPIPES SHALL BE LOCATED IN EVERY EXIT STAIR AND AT HORIZONTAL EXITS LOCATED MORE THAN 130' FROM CONNECTION IN EXIT STAIR (SECTION 905.4, #2 - EXCEPTION)

EXIT SIGNS **SECTION 1013.1**

SMOKE DETECTION IN R2 SECTION 420.6

RESIDENTIAL CORRIDORS, CLUBHOUSE AREAS AND GARAGE CARBON MONOXIDE DETECTORS SHALL BE PROVIDED IN EVERY DWELLING UNIT

ACTIVE SYSTEMS

FIRE ALARM (IN ACCORDANCE WITH NFPA 72) & SMOKE ALARM SYSTEMS SHALL BE INSTALLED IN GROUP R2 OCCUPANCIES PER SECTION FIRE ALARM TO BE ACTIVATED BY AUTOMATIC SPRINKLER SYSTEM PER SECTION 907.2.9.1, EXCEPTION 2

ILLUMINATED WITH 90 MIN BATTERY BACKUP


PORTABLE FIRE EXTINGUISHERS SHALL BE LOCATED WITHIN EACH DWELLING UNIT, POOL EQUIPMENT ROOM AND DISTRIBUTED THROUGHOUT

SEGMENT E SEGMENT D SEGMENT A SEGMENT B SEGMENT C

SEGMENT E

SEGMENT B



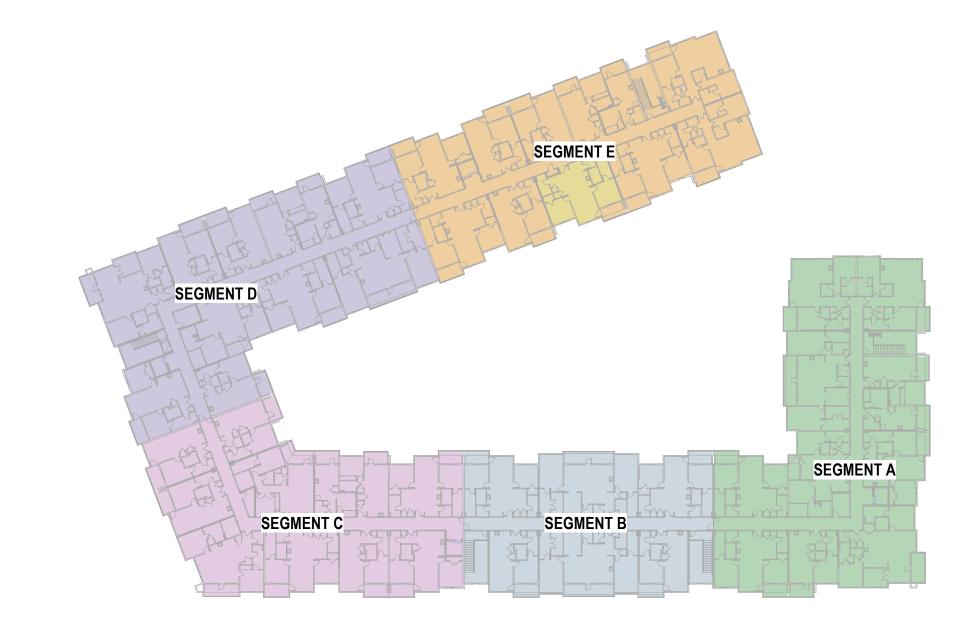

SEGMENT E

SEGMENT B

CODE REFERENCE PLAN - 4TH FLOOR

1" = 50'-0"

SEGMENT D

SEGMENT C

CODE REFERENCE PLAN - 2ND FLOOR

1" = 50'-0"

DRAFTSTOPPING IN ATTIC REQUIRED PER SECTION 708.4.2

SMOKE DOORS AT ELEVATORS AS REQUIRED PER SECTION 3006

PRIVATE GARAGES - U OCCUPANCY PROVISIONS 1. PROVIDE CO MONITOR IN EACH GARAGE STALL

3. CO MONITORS TO BE LOCATED WITHIN COMMON AREAS ON FLOOR WITH GARAGES AS WEL AS COMMON AREAS ON THE FLOOR ABOVE

SEGMENT A INFORMATION

SEGMENT D

SEGMENT C

CODE REFERENCE PLAN - 1ST FLOOR

1" = 50'-0"

DESCRIPTION: 4-STORY MULTI-FAMILY RESIDENTIAL CONSTRUCTION TYPE OCCUPANCY CLASSIFICATION YES - 13R SYSTEM SECTION 903.1.1.1 SPRINKLERED FIRE ALARM SECTION 420.6 YES - CLASS 1 SECTION 905.3 STANDPIPE SMOKE CONTROL SYSTEM EMERGENCY/STANDBY POWER ALLOWABLE BUILDING HEIGHT: ACTUAL BUILDING HEIGHT: ALLOWABLE STORIES **TABLE 504.4** ACTUAL NUMBER OF STORIES: AREA
ALLOWABLE AREA SECTION 506.2 ALLOWABLE AREA PER FLOOR 16,440 SF SECTION 506.2 $A_a = [A_t + (NS \times I_t)]$ $A_a = [12,000 + (12,000 \times .37)]$ SECTION 506.2.4 A_a = 16,440 SF SECTION 506.3 FRONTAGE INCREASE $I_f = [345/555 - 25]30/30$ $I_f = .37$ ACTUAL AREA:

SEGMENT A

1ST FLOOR

14,794 SF

2ND FLOOR

14,885 SF

3RD FLOOR

14,915 SF

4TH FLOOR

14,936 SF

TOTAL

59,930 SF

SEGMENT B INFORMATION DESCRIPTION: 4-STORY MULTI-FAMILY RESIDENTIAL CONSTRUCTION TYPE OCCUPANCY CLASSIFICATION CHAPTER 3 SPRINKLERED YES - 13R SYSTEM SECTION 903.1.1.1 FIRE ALARM SECTION 420.6 YES - CLASS 1 SECTION 905.3 STANDPIPE SMOKE CONTROL SYSTEM EMERGENCY/STANDBY POWER ALLOWABLE BUILDING HEIGHT ACTUAL BUILDING HEIGHT: ALLOWABLE STORIES TABLE 504.4 ACTUAL NUMBER OF STORIES: ALLOWABLE AREA SECTION 506.2 ALLOWABLE AREA PER FLOOR 12,000 SF SECTION 506.2 $A_a = [A_t + (NS \times I_f)]$ **SECTION 506.2.4** $A_a = [12,000 + (12,000 \times 0)]$ $A_a = 12,000 SF$ FRONTAGE INCREASE - NONE REQUIRED SECTION 506.3 ACTUAL AREA:

SEGMENT A

SEGMENT C INFORMATION

DESCRIPTION: 4-STORY MULTI-FAMILY RESIDENTIAL		
DATA:		
CONSTRUCTION TYPE OCCUPANCY CLASSIFICATION	VA R-2, U	CHAPTER 6 CHAPTER 3
SPRINKLERED FIRE ALARM STANDPIPE SMOKE CONTROL SYSTEM EMERGENCY/STANDBY POWER	YES - 13R SYSTEM YES YES - CLASS 1 NO NO	SECTION 903.1.1.1 SECTION 420.6 SECTION 905.3
HEIGHT AND NUMBER OF	STORIES	
ALLOWABLE BUILDING HEIGHT: ACTUAL BUILDING HEIGHT:	60'-0" 44'-3"	TABLE 504.3
ALLOWABLE STORIES ACTUAL NUMBER OF STORIES:	4 4	TABLE 504.4
AREA		
ALLOWABLE AREA ALLOWABLE AREA PER FLOOR	57,600 SF 14,400 SF	SECTION 506.2 SECTION 506.2
$A_a = [A_t + (NS \times I_f)]$ $A_a = [12,000 + (12,000 \times .2)]$ $A_a = 14,400 SF$		SECTION 506.2.4
FRONTAGE INCREASE I _f = [F/P25]W/30 I _f = [216/48125]30/30 I _f = .2		SECTION 506.3
ACTUAL AREA: SEGMENT C [1ST FLOOR 12,270] 2ND FLOOR 12,313 3RD FLOOR 12,313 4TH FLOOR 12,313 TOTAL 49,208	3 SF 3 SF 3 SF	

SEGMENT D INFORMATION

DESCRIPTION: 4-STORY MULTI-FAMILY RESIDENTIAL		
DATA:		
CONSTRUCTION TYPE OCCUPANCY CLASSIFICATION	VA R-2, U	CHAPTER 6 CHAPTER 3
SPRINKLERED FIRE ALARM STANDPIPE SMOKE CONTROL SYSTEM EMERGENCY/STANDBY POWER	YES - 13R SYSTEM YES YES - CLASS 1 NO NO	SECTION 903.1.1.1 SECTION 420.6 SECTION 905.3
HEIGHT AND NUMBER OF	STORIES	
ALLOWABLE BUILDING HEIGHT: ACTUAL BUILDING HEIGHT:	60'-0" 44'-3"	TABLE 504.3
ALLOWABLE STORIES ACTUAL NUMBER OF STORIES:	4 4	TABLE 504.4
AREA		
ALLOWABLE AREA ALLOWABLE AREA PER FLOOR	60,000 SF 15,000 SF	SECTION 506.2 SECTION 506.2
$A_a = [A_t + (NS \times I_t)]$ $A_a = [12,000 + (12,000 \times .25)]$ $A_a = 15,000 SF$		SECTION 506.2.4
FRONTAGE INCREASE I _f = [F/P25]W/30 I _f = [216/53525]30/30 I _f = .25		SECTION 506.3
ACTUAL AREA: SEGMENT D 1ST FLOOR 2ND FLOOR 14,011 S 3RD FLOOR 4TH FLOOR 14,057 S TOTAL 55,891 S	SF SF SF	

SEGMENT E INFORMATION

DESCRIPTION: 4-STORY MULTI-FAMILY RESIDENTIAL		
4 OTORT MOETITAMIET RESIDENTIAL		
DATA:		
CONSTRUCTION TYPE OCCUPANCY CLASSIFICATION	VA R-2, U	CHAPTER 6 CHAPTER 3
SPRINKLERED FIRE ALARM STANDPIPE SMOKE CONTROL SYSTEM EMERGENCY/STANDBY POWER	YES - 13R SYSTEM YES YES - CLASS 1 NO NO	SECTION 903.1.1.1.1 SECTION 420.6 SECTION 905.3
HEIGHT AND NUMBER OF	STORIES	
ALLOWABLE BUILDING HEIGHT: ACTUAL BUILDING HEIGHT:	60'-0" 44'-3"	TABLE 504.3
ALLOWABLE STORIES ACTUAL NUMBER OF STORIES:	4 4	TABLE 504.4
AREA		
ALLOWABLE AREA ALLOWABLE AREA PER FLOOR	60,000 SF 15,000 SF	SECTION 506.2 SECTION 506.2
$A_a = [A_t + (NS \times I_f)]$ $A_a = [12,000 + (12,000 \times .25)]$ $A_a = 15,000 SF$		SECTION 506.2.4
FRONTAGE INCREASE I _f = [F/P25]W/30 I _f = [249/50225]30/30 I _f = .25		SECTION 506.3
ACTUAL AREA: SEGMENT E [1ST FLOOR	SF] SF] SF]	

LEE'S

CONSTRUCTION

△REVISIONS

1 23 0411 CITY COMMENTS 1

JOB NO. 705921 03.15.2023 **DRAWN BY** TSC/SIW 4/11/2023 **CITY COMMENTS** SHEET NAME
BUILDING 1 CODE
ANALYSIS & PLANS
SHEET NO.

A0.20





CODE REFERENCE PLAN - 2ND FLOOR

OCCUPANT LOAD BUILDING CALCULATIONS

SEGMENT A - LEVE	<u>L 2</u>		
OCCUPANCY TYPE	GROSS FLOOR AREA	LOAD FACTOR	OCCUPANT LOAD
RESIDENTIAL	12,953 SF	200 GROSS	65
ACCESSORY STOR/MECH	127 SF	300 GROSS	1
TOTAL OCCUPANT LOAD			66
SEGMENT B - LEVE	<u>L 2</u>		
OCCUPANCY TYPE	GROSS FLOOR AREA	LOAD FACTOR	OCCUPANT LOAD
RESIDENTIAL	3,395 SF	200 GROSS	17
EXERCISE ROOMS	364 SF	50 GROSS	7
ASSEMBLY- UNCONCENTRAT	ED 2,884 SF	15 NET	190
ACCESSORY STOR/MECH	43 SF	300 GROSS	1
TOTAL OCCUPANT LOAD			215
SEGMENT C - LEVE	<u>L 2</u>		
OCCUPANCY TYPE	GROSS FLOOR AREA	LOAD FACTOR	OCCUPANT LOAD
RESIDENTIAL	10,925 SF	200 GROSS	55
ACCESSORY STOR/MECH	85 SF	300 GROSS	1
TOTAL OCCUPANT LOAD			56
SEGMENT D - LEVE	L 2		
OCCUPANCY TYPE	GROSS FLOOR AREA	LOAD FACTOR	OCCUPANT LOAD
RESIDENTIAL	12,983 SF	200 GROSS	60
ACCESSORY STOR/MECH	127 SF	300 GROSS	1
TOTAL OCCUPANT LOAD			61
SEGMENT E - LEVE	L 2		
OCCUPANCY TYPE	GROSS FLOOR AREA	LOAD FACTOR	OCCUPANT LOAD
RESIDENTIAL	11,303 SF	200 GROSS	57
TOTAL OCCUPANT LOAD	•		57

EGRESS REQUIREMENTS

ELEMENT	REQUIRED	PROVIDED
MINIMUM NUMBER OF EXITS		
SEGMENT A	2	2
SEGMENT B	2	2
SEGMENT C	2	2
SEGMENT D	2	2
SEGMENT E	2	2
EXIT WIDTH FACTORS (STAIRS/OTH	IER)	SECTION 1005, 1024
SEGMENT A	44"/44"	44"/80"
SEGMENT B	44"/44"	44"/80"
SEGMENT C	44"/44"	44"/80"
SEGMENT D		
SEGMENT E		
MAXIMUM EXIT ACCESS TRAVEL DI	STANCE	TABLE 1017.2
SEGMENT A (R2)	250 FT	101'- 10"
SEGMENT B (R2)	250 FT	68'-0"
SEGMENT C (R2)	250 FT	155'-7"
SEGMENT D (R2)	250 FT	113'-11"
SEGMENT E (R2)	250 FT	92'-5"
MAXIMUM COMMON PATH OF TRAV	EL DISTANCE	TABLE 1006.2.1
SEGMENT A (R2)	125 FT	36'-7"
SEGMENT B (R2)	125 FT	32'-10"
SEGMENT C (R2)	125 FT	32'-0"
SEGMENT D (R2)	125 FT	35'-4
SEGMENT E (R2)	125 FT	31'-7
MAXIMUM DEAD END CORRIDOR LE	ENGTH	SECTION 1020.4
GROUP R2	20 FT	
PANIC HARDWARE		
REQUIRED ON ALL EXIT	ACCESS DOORS S	ERVING ASSEMBLY SPACES WITH 50 OR MORE OCCUPA

CODE REFERENCE PLAN - 1ST FLOOR

OCCUPANT LOAD BUILDING CALCULATIONS

OCCUPANCY TYPE	GROSS FLOOR AREA	LOAD FACTOR	OCCUPANT LOAD
RESIDENTIAL	8,897 SF	200 GROSS	45
PARKING GARAGES	2,971 SF	200 GROSS	15
ACCESSORY STOR/MECH	489 SF	300 GROSS	2
TOTAL OCCUPANT LOAD			62
SEGMENT B - LEVE	<u>L 1</u>		
OCCUPANCY TYPE	GROSS FLOOR AREA	LOAD FACTOR	OCCUPANT LOAD
BUSINESS	687 SF	150 GROSS	5
EXERCISE ROOMS	1,399 SF	50 GROSS	28
ASSEMBLY- UNCONCENTRAT	ED 3,930 SF	15 NET	386
ACCESSORY STOR/MECH	153 SF	300 GROSS	2
TOTAL OCCUPANT LOAD			421
SEGMENT C - LEVE	<u>L 1</u>		
OCCUPANCY TYPE	GROSS FLOOR AREA	LOAD FACTOR	OCCUPANT LOAD
RESIDENTIAL	9,206 SF	200 GROSS	46
PARKING GARAGES	1,407 SF	200 GROSS	7
ACCESSORY STOR/MECH	2,272 SF	300 GROSS	11
TOTAL OCCUPANT LOAD			54
SEGMENT D - LEVE			
OCCUPANCY TYPE	GROSS FLOOR AREA	LOAD FACTOR	OCCUPANT LOAD
RESIDENTIAL	5,077 SF	200 GROSS	25
PARKING GARAGE	5,427 SF	200 GROSS	27
ACCESSORY STOR/MECH	811 SF	300 GROSS	3
TOTAL OCCUPANT LOAD			55
SEGMENT E - LEVE	L 1		
OCCUPANCY TYPE	GROSS FLOOR AREA	LOAD FACTOR	OCCUPANT LOAD
RESIDENTIAL	5,491 SF	200 GROSS	28
PARKING GARAGE	4,391 SF	200 GROSS	22
ACCESSORY STOR/MECH	415 SF	300 GROSS	1

EGRESS REQUIREMENTS

TRAVEL DISTANCE - 138'-2"

TRAVEL DISTANCE - 107'-6"

COMMON PATH OF TRAVEL - 21'-10"

COMMON PATH OF TRAVEL - 30'-8"

COMMON PATH OF TRAVEL - 31'-9"

TRAVEL DISTANCE - 73'-9" —

COMMON PATH OF TRAVEL - 32'-7"

TRAVEL DISTANCE - 153'-5"

COMMON PATH OF TRAVEL - 42'-9"

ELEMENT	REQUIRED	PROVIDED .	
MINIMUM NUMBER OF EXITS			
SEGMENT A	2	3	
SEGMENT B	2	4	
SEGMENT C	2	2	
SEGMENT D	2	2	
SEGMENT E	2	3	
EXIT WIDTH FACTORS (STAIRS/O	THER) SECTION 10	005, 1011, 1024	
SEGMENT A	, 44"/44"	44"/80"	
SEGMENT B	44"/44"	44"/80"	
SEGMENT C	44"/44"	44"/80"	
SEGMENT D	44"/44"	44"/80"	
SEGMENT E	44"/44"	44"/80"	
MAXIMUM EXIT ACCESS TRAVEL	DISTANCE	TABLE 1017.2	
SEGMENT A (R2)	250 FT	107'-6"	
SEGMENT B (R2)	250 FT	73'-9"	
SEGMENT C (R2)	250 FT	148'-6"	
SEGMENT D (R2)	250 FT	153'-5"	
SEGMENT E (R2)	250 FT	138'-2"	
MAXIMUM COMMON PATH OF TRA	AVEL DISTANCE	TABLE 1006.2.1	
SEGMENT A (R2)	125 FT	30'-8"	
SEGMENT B (R2)	125 FT	21'-10"	
SEGMENT C (R2)	125 FT	42'-9"	
SEGMENT D (R2)	125 FT	32'-7"	
SEGMENT E (R2)	125 FT	31'-9"	
MAXIMUM DEAD END CORRIDOR	LENGTH	SECTION 1020.4	
GROUP R2	20 FT		
PANIC HARDWARE			
REQUIRED ON ALL EXI	TACCESS DOORS S	SERVING ASSEMBLY SPACES WITH 50 OR MORE OCCUPAN	ITS

 \triangle REVISIONS

JOB NO. 705921 DRAWN BY TSC/SIW DATE **03.15.2023** 4/11/2023
CITY COMMENTS
SHEET NAME
BUILDING 1 EGRESS &
OCCUPANCY PLANS
SHEET NO.


A0.21



LEE'S SUMMIT, MO

WARD RD.

810 NW

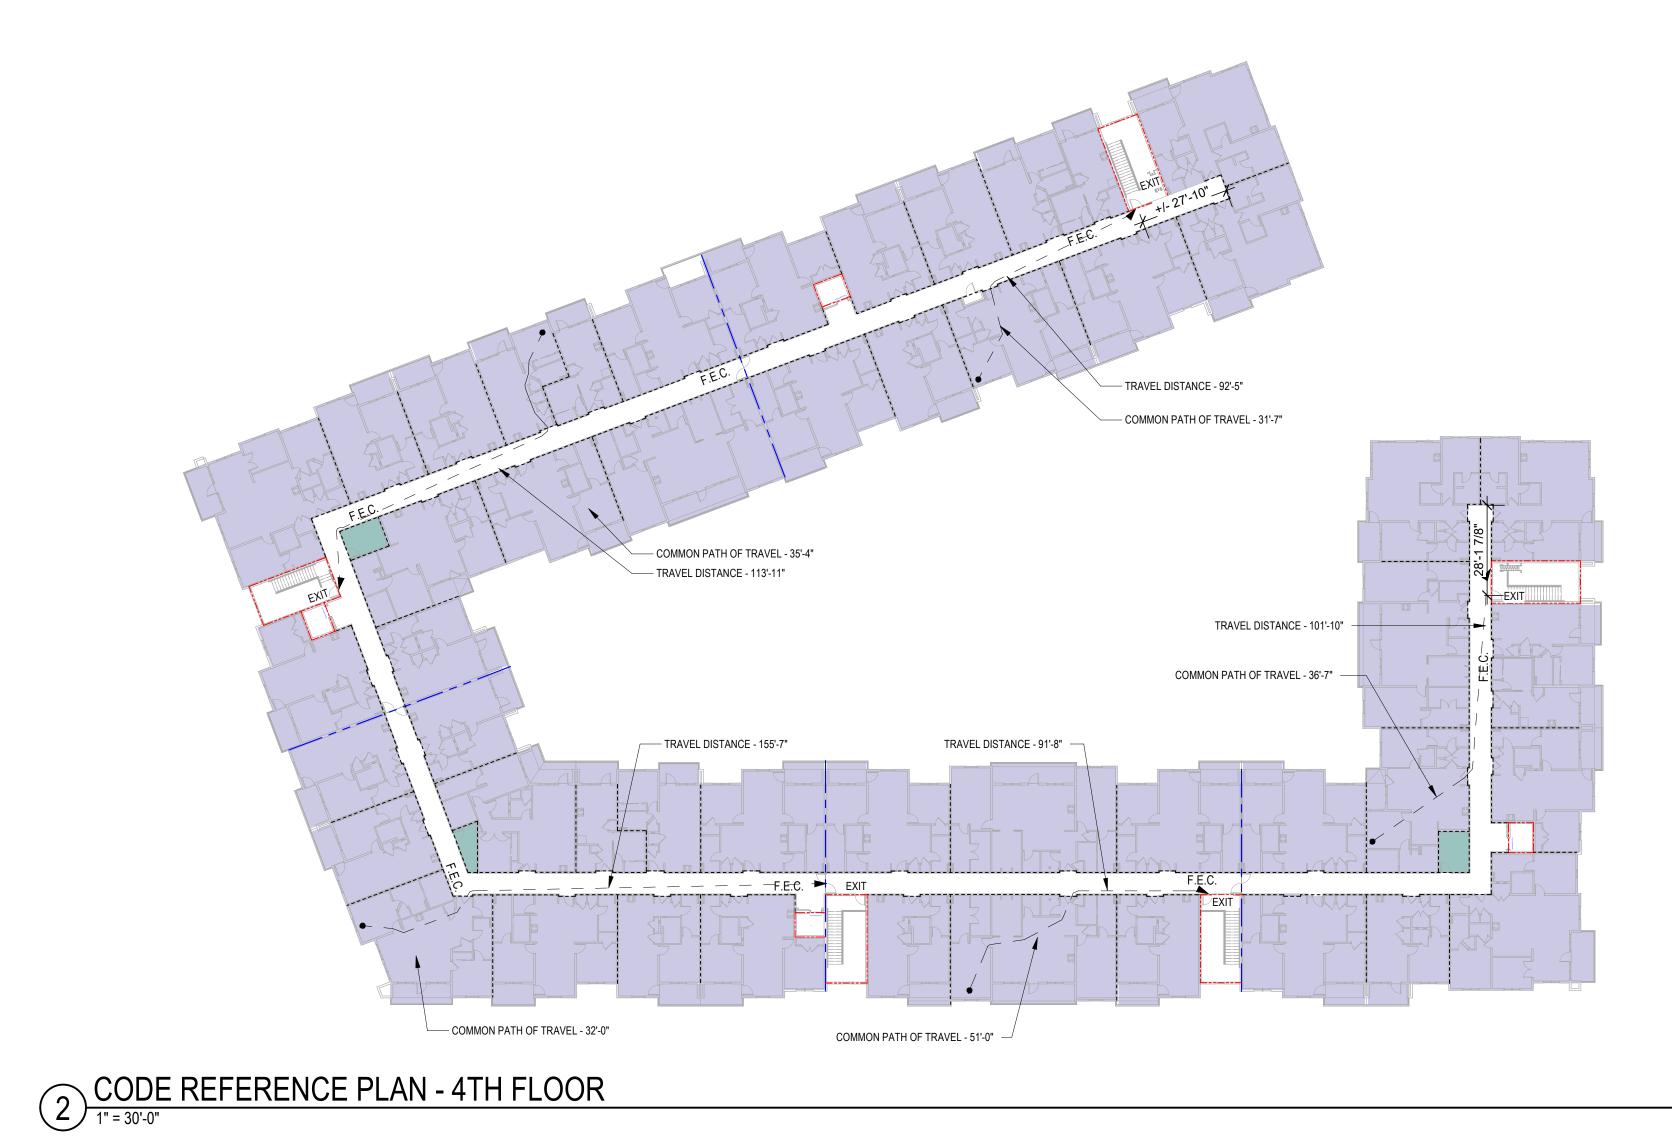

OCCUPANT LOAD BUILDING CALCULATIONS

SEGMENT A - LEVE	EL 4		
OCCUPANCY TYPE	GROSS FLOOR AREA	LOAD FACTOR	OCCUPANT LOAD
RESIDENTIAL	12,953 SF	200 GROSS	65
ACCESSORY STOR/MECH	127 SF	300 GROSS	1
TOTAL OCCUPANT LOAD			66
SEGMENT B - LEVE	<u>L 4</u>		
OCCUPANCY TYPE	GROSS FLOOR AREA	LOAD FACTOR	OCCUPANT LOAD
RESIDENTIAL	3,395 SF	200 GROSS	17
ACCESSORY STOR/MECH	43 SF	300 GROSS	1
TOTAL OCCUPANT LOAD			215
SEGMENT C - LEVE	=1 <i>1</i>		
OCCUPANCY TYPE	GROSS FLOOR AREA	LOAD FACTOR	OCCUPANT LOAD
RESIDENTIAL	10.925 SF	200 GROSS	55
ACCESSORY STOR/MECH	85 SF	300 GROSS	1
TOTAL OCCUPANT LOAD			56
SEGMENT D - LEVE	EL 4		
OCCUPANCY TYPE	GROSS FLOOR AREA	LOAD FACTOR	OCCUPANT LOAD
RESIDENTIAL	12,983 SF	200 GROSS	60
ACCESSORY STOR/MECH	127 SF	300 GROSS	1
TOTAL OCCUPANT LOAD			61
SEGMENT E - LEVE	L 4		
		LOAD EACTOR	OCCUDANTIOAD
OCCUPANCY TYPE	GROSS FLOOR AREA	LOAD FACTOR	OCCUPANT LOAD
OCCUPANCY TYPE RESIDENTIAL	GROSS FLOOR AREA 11,303 SF	200 GROSS	57

EODEOO DEOLUDEMENTO

ELEMENT MINIMUM NUMBER OF EXITS	REQUIRED	<u>PROVIDED</u>
SEGMENT A	2	2
SEGMENT B	2	2
SEGMENT C	2	2
SEGMENT D	2	2
SEGMENT E	2	2
EXIT WIDTH FACTORS (STAIRS/OTI	HER)	SECTION 1005, 1011, 1024
SEGMENT A	[′] 44"/44"	44"/80"
SEGMENT B	44"/44"	44"/80"
SEGMENT C	44"/44"	44"/80"
SEGMENT D		
SEGMENT E		
MAXIMUM EXIT ACCESS TRAVEL D	ISTANCE	TABLE 1017.2
SEGMENT A (R2)	250 FT	101'- 10"
SEGMENT B (R2)	250 FT	68'-0"
SEGMENT C (R2)		155'-7"
SEGMENT D (R2)		113'-11"
SEGMENT E (R2)	250 FT	92'-5"
MAXIMUM COMMON PATH OF TRAY	VEL DISTANCE	TABLE 1006.2.1
SEGMENT A (R2)	125 FT	36'-7"
SEGMENT B (R2)	125 FT	51'-0"
SEGMENT C (R2)	125 FT	32'-0"
SEGMENT D (R2)	125 FT	35'-4
SEGMENT E (R2)	125 FT	31'-7
MAXIMUM DEAD END CORRIDOR L	ENGTH	SECTION 1020.4
GROUP R2	20 FT	

CODE REFERENCE PLAN - 3RD FLOOR 1" = 30'-0"

COMMON PATH OF TRAVEL - 32'-0"

— COMMON PATH OF TRAVEL - 35'-4"

TRAVEL DISTANCE - 113'-11"

TRAVEL DISTANCE - 155'-7"

_/ _ _ _ _ _ _ F.E.C. ► EXIT

OCCUPAN	NT LOAD B	BUILDING	SCALCULATION
SEGMENT A - LEVE	EL 3		
OCCUPANCY TYPE RESIDENTIAL ACCESSORY STOR/MECH	GROSS FLOOR AREA 12,953 SF 127 SF	LOAD FACTOR 200 GROSS 300 GROSS	OCCUPANT LOAD 65
TOTAL OCCUPANT LOAD	121 35	300 GROSS	66
SEGMENT B - LEVE	EL 3		
OCCUPANCY TYPE RESIDENTIAL ACCESSORY STOR/MECH	GROSS FLOOR AREA 3,395 SF 43 SF	LOAD FACTOR 200 GROSS 300 GROSS	OCCUPANT LOAD 17
TOTAL OCCUPANT LOAD	40 01	OU GROOD	215
SEGMENT C - LEVE	EL 3		
OCCUPANCY TYPE RESIDENTIAL ACCESSORY STOR/MECH	GROSS FLOOR AREA 10,925 SF 85 SF	LOAD FACTOR 200 GROSS 300 GROSS	OCCUPANT LOAD 55 1
TOTAL OCCUPANT LOAD			56
SEGMENT D - LEVE OCCUPANCY TYPE RESIDENTIAL ACCESSORY STOR/MECH	EL 3 GROSS FLOOR AREA 12,983 SF 127 SF	LOAD FACTOR 200 GROSS 300 GROSS	OCCUPANT LOAD 60 1
TOTAL OCCUPANT LOAD			61
SEGMENT E - LEVE	EL 3		
OCCUPANCY TYPE RESIDENTIAL ACCESSORY STOR/MECH	GROSS FLOOR AREA 11,303 SF	LOAD FACTOR 200 GROSS 300 GROSS	OCCUPANT LOAD 57
TOTAL OCCUPANT LOAD		300 GIVO33	

EGRESS REQUIREMENTS

TRAVEL DISTANCE - 94'-2"


COMMON PATH OF TRAVEL - 51'-0" —

TRAVEL DISTANCE - 92'-5"

— COMMON PATH OF TRAVEL - 31'-7"

TRAVEL DISTANCE - 101'-10" -


COMMON PATH OF TRAVEL - 36'-7"

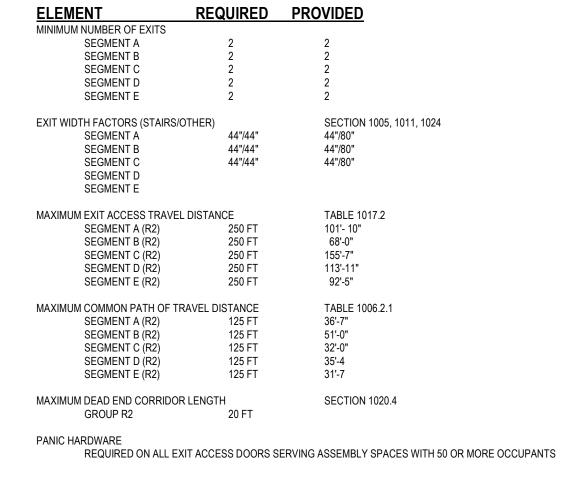

 \triangle REVISIONS

JOB NO. **705921** 03.15.2023 DRAWN BY TSC/SIW 4/11/2023
CITY COMMENTS
SHEET NAME
BUILDING 1 EGRESS &
OCCUPANCY PLANS
SHEET NO.

A022

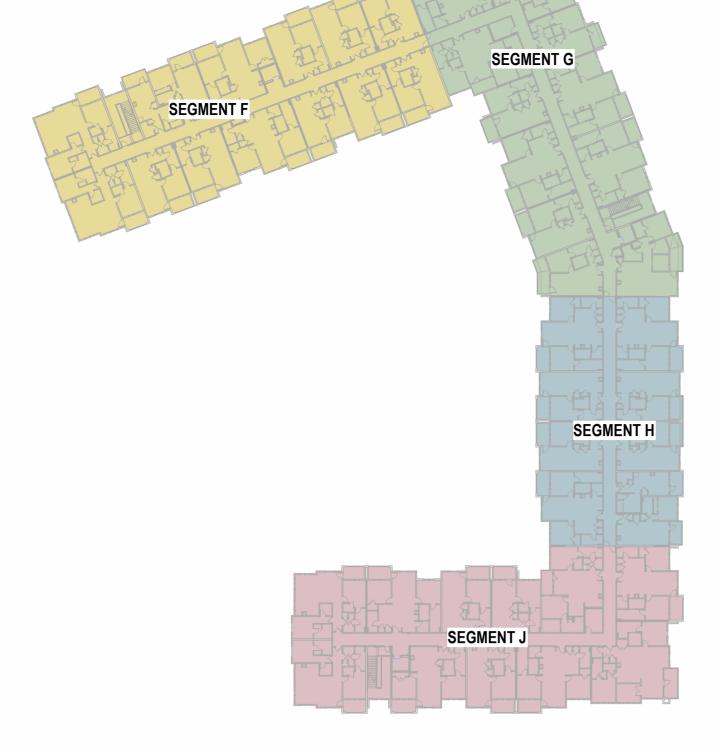

5 CODE REFERENCE PLAN - 4TH FLOOR


SEGMENT F

SEGMENT G

SEGMENT J

SEGMENT H



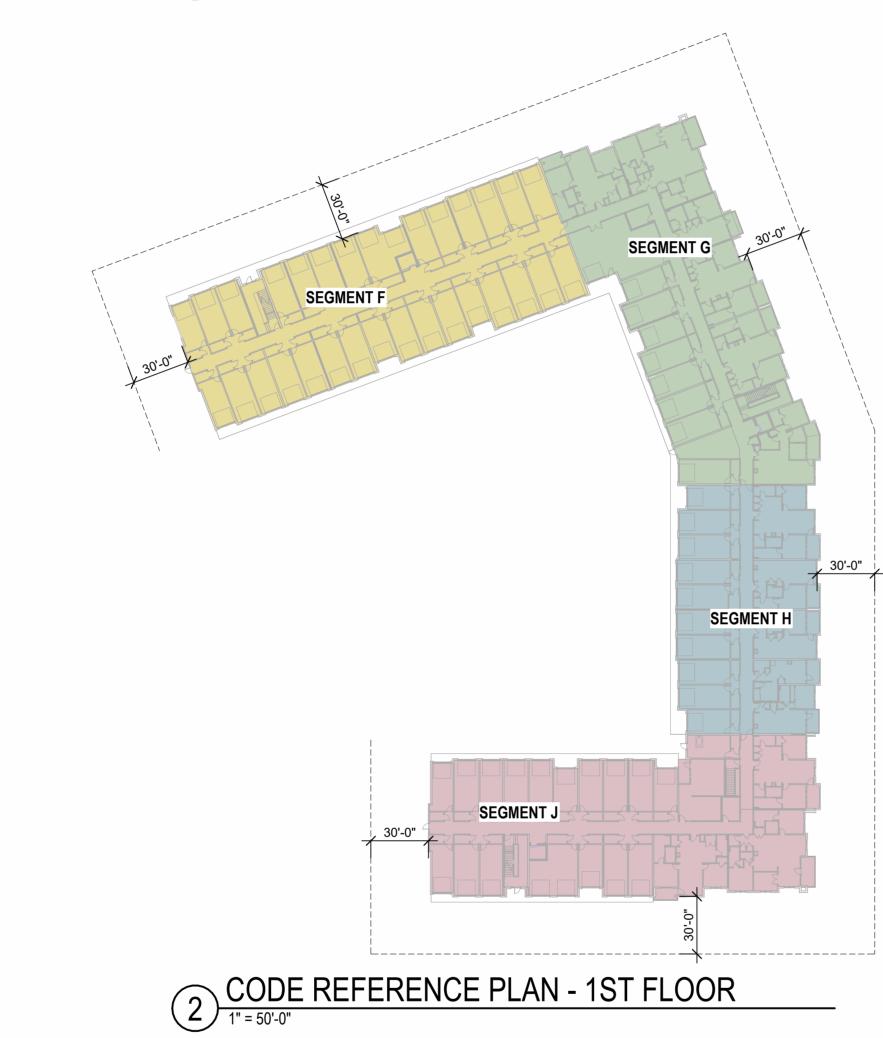

3 CODE REFERENCE PLAN - 2ND FLOOR

SEGMENT G INFORMATION

DESCRIPTION:			DESCRIP
4-STORY MULTI-FAMILY RESIDENTIAL			BASEMENT + 4
DATA:			DATA:
CONSTRUCTION TYPE OCCUPANCY CLASSIFICATION	VA R-2 ,U	CHAPTER 6 CHAPTER 3	CONSTRUCTIO OCCUPANCY (
SPRINKLERED FIRE ALARM STANDPIPE SMOKE CONTROL SYSTEM EMERGENCY/STANDBY POWER	YES - 13R SYSTEM YES YES - CLASS 1 NO NO	SECTION 903.1.1.1 SECTION 420.6 SECTION 905.3	SPRINKLERED FIRE ALARM STANDPIPE SMOKE CONTE EMERGENCY/S
HEIGHT AND NUMBER O	F STORIES		HEIGHT A
ALLOWABLE BUILDING HEIGHT:	60'-0" 44'-3"	TABLE 504.3	ALLOWABLE B

SPRINKLERED FIRE ALARM STANDPIPE SMOKE CONTROL SYSTEM EMERGENCY/STANDBY POWER	YES - 13R SYSTEM YES YES - CLASS 1 NO NO	SECTION 903.1.1.1 SECTION 420.6 SECTION 905.3
HEIGHT AND NUMBER OF S	STORIES	
ALLOWABLE BUILDING HEIGHT: ACTUAL BUILDING HEIGHT:	60'-0" 44'-3"	TABLE 504.3
ALLOWABLE STORIES ACTUAL NUMBER OF STORIES:	4 4	TABLE 504.4
AREA		
ALLOWABLE AREA ALLOWABLE AREA PER FLOOR	60,000 SF 15,000 SF	SECTION 506.2 SECTION 506.2
$A_a = [A_t + (NS \times I_f)]$ $A_a = [12,000 + (12,000 \times .25)]$ $A_a = 15,000 SF$		SECTION 506.2.4
FRONTAGE INCREASE I _f = [F/P25]W/30 I _f = [276/55625]30/30 I _f = .25		SECTION 506.3
ACTUAL ADEA:		

SEGMENT F INFORMATION

$ I_f = [F/P25]W/30 $ $ I_f = [276/55625]30/30 $ $ I_f = .25 $	
ACTUAL AREA:	
SEGMENT F	
1ST FLOOR	14,634 SF]
2ND FLOOR	14,908 SF
3RD FLOOR	14,943 SF
4TH FLOOR	14,985 SF
TOTAL	EO 470 CE

DESCRIPTION:					
BASEMENT + 4-STORY MULTI-FAMILY RESIDENTIAL					
DATA:					
CONSTRUCTION TYPE OCCUPANCY CLASSIFICATION	VA R-2, U	CHAPTER 6 CHAPTER 3			
SPRINKLERED FIRE ALARM STANDPIPE SMOKE CONTROL SYSTEM EMERGENCY/STANDBY POWER	YES - 13R SYSTEM YES YES - CLASS 1 NO NO	SECTION 903.1.1.1 SECTION 420.6 SECTION 905.3			
HEIGHT AND NUMBER OF STORIES					
ALLOWABLE BUILDING HEIGHT: ACTUAL BUILDING HEIGHT:	60'-0" 44'-3"	TABLE 504.3			

R OF STO	ORIES	
		TABLE 504.3
		TABLE 504.4
	,	SECTION 506.2 SECTION 506.2
		SECTION 506.2.4
		SECTION 506.3
2,006 SF 14,295 SF 14,411 SF 14,425 SF 59,526 SF		
	2,006 SF 14,295 SF 14,411 SF 14,425 SF 14,425 SF	R OF STORIES : 60'-0"

SEGMENT H INFORMATION

DESCRIPTION:			
BASEMENT + 4-STORY MULTI	-FAMILY RES	SIDENTIAL	
DATA:			
CONSTRUCTION TYPE DCCUPANCY CLASSIFICATIO	N	VA R-2, U	CHAPTER 6 CHAPTER 3
SPRINKLERED FIRE ALARM STANDPIPE SMOKE CONTROL SYSTEM SMERGENCY/STANDBY POW	ER	YES - 13R SYSTEM YES YES - CLASS 1 NO NO	SECTION 903.1.1.1 SECTION 420.6 SECTION 905.3
HEIGHT AND NUMB	ER OF S	TORIES	
ALLOWABLE BUILDING HEIGH ACTUAL BUILDING HEIGHT:	łT:	60'-0" 44'-3"	TABLE 504.3
ALLOWABLE STORIES ACTUAL NUMBER OF STORIE	S:	4 BSMNT + 4	TABLE 504.4
AREA			
ALLOWABLE AREA ALLOWABLE AREA PER FLOC)R	48,000 SF 12,000 SF	SECTION 506.2 SECTION 506.2
$A_a = [A_t + (NS \times I_t)]$ $A_a = [12,000 + (12,000 \times 0)]$ $A_a = 12,000 SF$			SECTION 506.2.4
RONTAGE INCREASE - NON	E REQUIRED)	SECTION 506.3
SEGMENT H BASEMENT 1ST FLOOR 2ND FLOOR 3RD FLOOR 4TH FLOOR TOTAL	5,201 SF] 9,318 SF] 9,381 SF] 9,395 SF] 9,395 SF] 42,690 SF		

CODE REFERENCE

BUILDING CODE:

JURISDICTION: LEE'S SUMMIT, MISSOURI

ADOPTED NATIONAL AND INTERNATIONAL CODES: 2018 INTERNATIONAL BUILDING CODE (IBC)

2018 INTERNATIONAL FIRE CODE (IFC) 2018 INTERNATIONAL FUEL GAS CODE (IFGC) 2018 INTERNATIONAL MECHANICAL CODE (IMC) 2018 INTERNATIONAL PLUMBING CODE (IPC) 2017 NATIONAL ELECTRICAL CODE (NEC) 2009 ICC/ANSI A117.1 ACCESSIBILITY AND USABLE BUILDINGS 2018 NATIONAL FIRE PROTECTION ASSOCIATION (NFPA)

CODE APPROACH SUMMARY

BUILDING 1: THE OVERALL FACILITY IS SEPARATED INTO 5 BUILDINGS (SEGMENTS) WITH 2-HOUR FIRE WALLS TO ACCOMMODATE IBC AREA RESTRICTIONS. THE INDIVIDUAL BUILDINGS (SEGMENTS) THEN USE A COMBINATION OF SEPARATED AND NONSEPARATED MIXED USE APPROACHES AS DEFINDED THE IBC.

BUILDING 2: THE OVERALL FACILITY IS SEPARATED INTO 4 BUILDINGS (SEGMENTS) WITH 2-HOUR FIRE WALLS TO ACCOMMODATE IBC AREA RESTRICTIONS. THE INDIVIDUAL BUILDINGS (SEGMENTS) THEN USE A COMBINATION OF SEPARATED AND NONSEPARATED MIXED USE APPROACHES AS DEFINDED THE IBC.

ACCESSIBILITY COMPLIANCE

PERCENTAGE OF UNIT TYPES:

REQUIRED: SECTION 1107.6.2.2.2 THESE FACILITIES MUST BE DESIGNED TO COMPLY WITH ALL THE REQUIREMENTS OF THE AMERICANS WITH DISABILITY ACT, FAIR HOUSING 2% OF TOTAL PER SECTION 1107.6.2.2.1 TYPE B PER SECTION 1107.6.2.2.2 AMENDMENTS ACT OF 1988, AS WELL AS ALL LOCAL AND STATE ACCESSIBILITY REGULATIONS. COMPLIANCE WITH ONE CODE DOES NOT PROVIDED: NECESSARILY GUARANTEE COMPLIANCE WITH ALL ACCESSIBILITY CODES.

TYPE A TYPE B

LIFE SAFETY SYSTEMS

ACTIVE SYSTEMS

SECTION 903.3.1.2 CLASS 1 WET STANDPIPES SHALL BE LOCATED IN EVERY EXIT STAIR AND AT HORIZONTAL EXITS LOCATED MORE THAN 130' FROM CONNECTION IN EXIT STAIR (SECTION 905.4, #2 - EXCEPTION)

SMOKE DETECTION IN R2 SECTION 420.6 FIRE ALARM (IN ACCORDANCE WITH NFPA 72) & SMOKE ALARM SYSTEMS SHALL BE INSTALLED IN GROUP R2 OCCUPANCIES PER SECTION 907.2.9.1 THROUGH 907.2.9.3

FIRE ALARM TO BE ACTIVATED BY AUTOMATIC SPRINKLER SYSTEM PER SECTION 907.2.9.1, EXCEPTION 2 EXIT SIGNS **SECTION 1013.1**

PORTABLE FIRE EXTINGUISHERS SHALL BE LOCATED WITHIN EACH DWELLING UNIT, POOL EQUIPMENT ROOM AND DISTRIBUTED THROUGHOUT RESIDENTIAL CORRIDORS, CLUBHOUSE AREAS AND GARAGE

CARBON MONOXIDE DETECTORS SHALL BE PROVIDED IN EVERY DWELLING UNIT

ILLUMINATED WITH 90 MIN BATTERY BACKUP

RESISTIVE REQUIREMENTS

FIRE RESISTIVE RATINGS - TYPE 5A CONSTRUCTION

STRUCTURAL FRAME: 1.0-HOUR BEARING WALLS-EXTERIOR: 1.0-HOUR BEARING WALLS-INTERIOR: 1.0-HOUR 0.0-HOUR NON-BEARING WALLS-INTERIOR: 1.0-HOUR 1.0-HOUR FLOOR CONSTRUCTION: ROOF CONSTRUCTION: UNIT DEMISING WALLS(FIRE PARTITION): CORRIDOR WALLS(FIRE PARTITION): EXIT PASSAGEWAYS: 2.0-HOUR -STAIR SHAFT WALLS (CONNECTING FOUR STORIES OR MORE): ELEVATOR SHAFT WALLS-EXTERIOR(FIRE BARRIER): ELEVATOR SHAFT WALLS-INTERIOR(FIRE BARRIER): SHAFT ENCLOSURE (CONNECTING FOUR STORIES OR MORE):

1.0-HOUR -----0.5-HOUR -----2.0-HOUR ----1.0-HOUR ————— 2.0-HOUR _____ 2.0-HOUR ----2.0 HOUR ----

SOUND RATINGS

SOUND TRANSMISSION CLASS RATING (STC): 50 STC SEE A0.30 FOR TYPICAL FIRE RESISTIVE ASSEMBLY INFORMATION IMPACT INSULATION CLASS RATING (IIC):

FIRE DEPARTMENT GENERAL NOTES

1. A KNOX BOX SHALL BE INSTALLED ON EACH BUILDING AT THE SPRINKLER RISER ROOM AND AT THE LOWEST STOP OF EACH ELEVATOR. THE KNOX BOX SHALL BE MOUNTED AT 60" A.F.F. & 48" A.F.F, RESPECTIVELY. 2. INSTALL SIGN ON THE DOOR TO RISER ROOM DESIGNATING: "FIRE ALARM/SPRINKLER RISER" 3. A SIGN SHALL BE PROVIDED AT EACH FLOOR LANDING IN AN INTERIOR EXIT STAIRWAY AND RAMP CONNECTING MORE THAN THREE STORIES, DESIGNATING THE FLOOR LEVEL, THE TERMINUS OF THE TOP AND BOTTOM OF THE INTERIOR EXIST STAIRWAY OR RAMP, AND THE

IDENTIFICATION OF THE STAIR OR RAMP. THE SIGNAGE SHALL ALSO STATE THE STORY OF AND THE DIRECTION TO, THE EXIT DISCHARGE AND THE AVAILABILITY OF ROOF ACCESS FROM THE INTERIOR EXIT STAIRWAY AND RAMP FOR THE FIRE DEPARTMENT. THE SIGN SHALL BE LOCATED 5'-0" ABOVE THE FLOOR LANDING IN A POSITION THAT IS READILY VISIBLE WHEN THE DOORS ARE IN THE OPEN AND CLOSED POSITION. IN ADDITION TO THE STAIRWAY IDENTIFICATION SIGN, A FLOOR LEVEL SIGN IN RAISED CHARACTERS AND BRAILLE COMPLYING WITH ICC A117.1 SHALL BE LOCATED AT EACH FLOOR LEVEL LANDING ADJACENT TO THE DOOR LEADING FROM THE ITNERIOR EXIT STAIRWAY AND RAMP INTO THE CORRIDOR TO IDENTIFY THE FLOOR LEVEL. 4. IN APPLICABLE, A 42" X 30" METAL GATE WITH SPRING CLOSER SHALL BE PROVIDED IN STAIRWAYS CONTINUING PAST THE LEVEL OF EXIT DISCHARGE TO PREVENT PERSONS FROM UNINTENTIONALLY CONTINUING INTO THE LEVELS BELOW. DIRECTION EXIT SIGNS SHALL BE

FIREBLOCKING REQUIRED IN COMBUSTIBLE CONCEALED LOCATIONS PER SECTION 708.4.2 & 718.2

DRAFTSTOPPING IN ATTIC REQUIRED PER SECTION 708.4.2

SMOKE DOORS AT ELEVATORS AS REQUIRED PER SECTION 3006

PRIVATE GARAGES - U OCCUPANCY PROVISIONS

2. EACH GARAGE DOOR TO BE ACTUATED BY CO MONITOR, TYP EACH LOCATION

PASSIVE SYSTEMS

1. PROVIDE CO MONITOR IN EACH GARAGE STALL

3. CO MONITORS TO BE LOCATED WITHIN COMMON AREAS ON FLOOR WITH GARAGES AS WEL AS COMMON AREAS ON THE FLOOR ABOVE




 \triangle REVISIONS

JOB NO. 705921 DRAWN BY TSC/SIW 03.15.2023

4/11/2023
CITY COMMENTS
SHEET NAME
BUILDING 2 CODE
ANALYSIS & PLANS
SHEET NO.

A0.23

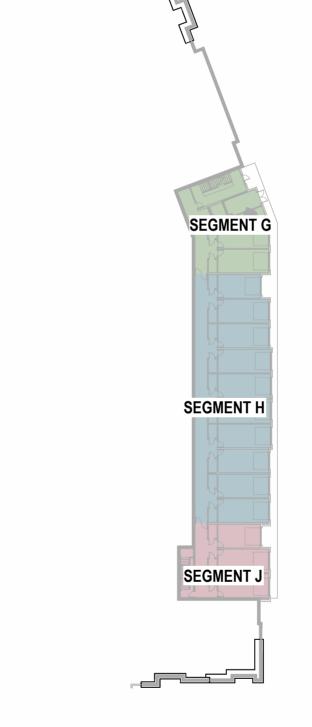

CODE REFERENCE PLAN - BASEMENT

1" = 50'-0"

SEGMENT J INFORMATION

DESCRIPTION:		
BASEMENT + 4-STORY MULTI-FAMILY RE	SIDENTIAL	
DATA:		
CONSTRUCTION TYPE OCCUPANCY CLASSIFICATION	VA R-2, U	CHAPTER 6 CHAPTER 3
SPRINKLERED FIRE ALARM STANDPIPE SMOKE CONTROL SYSTEM EMERGENCY/STANDBY POWER	YES - 13R SYSTEM YES YES - CLASS 1 NO NO	SECTION 903.1.1.1 SECTION 420.6 SECTION 905.3

EMERGENCY/STANDBY POWER	NO	
HEIGHT AND NUMBER OF	STORIES	
ALLOWABLE BUILDING HEIGHT: ACTUAL BUILDING HEIGHT:	70'-0" 44'-3"	TABLE 504.3
ALLOWABLE STORIES ACTUAL NUMBER OF STORIES:	4 BSMNT +4	TABLE 504.4
AREA		
ALLOWABLE AREA ALLOWABLE AREA PER FLOOR	61,920 SF 15,480 SF	SECTION 506.2 SECTION 506.2
$A_a = [A_t + (NS \times I_t)]$ $A_a = [12,000 + (12,000 \times .29)]$ $A_a = 15,480 \text{ SF}$		SECTION 506.2.4
FRONTAGE INCREASE I _f = [F/P25]W/30 I _f = [344/63325]30/30 I _f = .29		SECTION 506.3

ACTUAL AREA:

SEGMENT J
BASMENT
1ST FLOOR
2ND FLOOR
3RD FLOOR
4TH FLOOR
TOTAL

1,747 SF] 14,604 SF 14,755 SF 14,778 SF 14,800 SF **60,684 SF**

- COMMON PATH OF TRAVEL - 32'-2" TRAVEL DISTANCE - 105'-8" COMMON PATH OF TRAVEL - 30'-6" -- COMMON PATH OF TRAVEL - 21'-8" TRAVEL DISTANCE - 90'-3" TRAVEL DISTANCE - 79'-2" -TRAVEL DISTANCE - 129'-9" TRAVEL DISTANCE - 45'-9" — COMMON PATH OF TRAVEL - 18'-0" TRAVEL DISTANCE - 145'-4" -TRAVEL DISTANCE - 162'-0" TRAVEL DISTANCE - 118'-10" < COMMON PATH OF TRAVEL - 18'-0" — COMMON PATH OF TRAVEL - 34'-2" COMMON PATH OF TRAVEL - 32'-3" TRAVEL DISTANCE - 37'-10" EXIT TRAVEL DISTANCE - 132'-0" TRAVEL DISTANCE - 170'-10" — COMMON PATH OF TRAVEL - 18'-0" COMMON PATH OF TRAVEL - 33'-2" - COMMON PATH OF TRAVEL - 32'-8"

3 CODE REFERENCE PLAN - 2ND FLOOR

OCCUPANT LOAD BUILDING CALCULATIONS SEGMENT F - LEVEL 2

OCCUPANCY TYPE
RESIDENTIAL
TOTAL OCCUPANT LOAD

GROSS FLOOR AREA
13.137 SF
 LOAD FACTOR
 OCCUPANT LOAD

 200 GROSS
 66

 66
 66
 SEGMENT G - LEVEL 2 GROSS FLOOR AREA 12,360 SF _127 SF
 LOAD FACTOR
 OCCUPANT LOAD

 200 GROSS
 62

 300 GROSS
 1
 OCCUPANCY TYPE
RESIDENTIAL ACCESSORY STOR/MECH TOTAL OCCUPANT LOAD SEGMENT H - LEVEL 2

OCCUPANCY TYPE
RESIDENTIAL
TOTAL OCCUPANT LOAD
 LOAD FACTOR
 OCCUPANT LOAD

 200 GROSS
 43

 43
 GROSS FLOOR AREA 8,492 SF SEGMENT J - LEVEL 2

OCCUPANCY TYPE
RESIDENTIAL
ACCESSORY STOR/MECH
TOTAL OCCUPANT LOAD

SEGMENT J - LEVEL 2
GROSS FLOOR AREA
12,826 SF
127 SF
 LOAD FACTOR
 OCCUPANT LOAD

 200 GROSS
 64

 300 GROSS
 1
 ACCESSORY STOR/MECH TOTAL OCCUPANT LOAD

EGRESS REQUIREMENTS

LONEGO NEGONEMENTO				
<u>ELEMENT</u>	REQUIRED	<u>PROVIDED</u>		
MINIMUM NUMBER OF EXITS				
SEGMENT F	2	2		
SEGMENT G	2	2		
SEGMENT H	2	2		
SEGMENT J	2	2		
EXIT WIDTH FACTORS (STAIRS/C	OTHER)	SECTION 1005, 1011, 1024		
SEGMENT F	44"/44"	44"/80"		
SEGMENT G	44"/44"	44"/80"		
SEGMENT H	44"/44"	44"/80"		
SEGMENT J	44"/44"	44"/80"		
MAXIMUM EXIT ACCESS TRAVEL	DISTANCE	TABLE 1017.2		
SEGMENT F (R2)	250 FT	90'- 3"		
SEGMENT G (R2)	250 FT	79'-2"		
SEGMENT H (R2)	250 FT	145'-4"		
SEGMENT J (R2)	250 FT	132'-0"		
MAXIMUM COMMON PATH OF TR	AVEL DISTANCE	TABLE 1006.2.1		
SEGMENT F (R2)	125 FT	33'-0"		
SEGMENT G (R2)	125 FT	36'-0"		
SEGMENT H (R2)	125 FT	33'-0"		
SEGMENT J (R2)	125 FT	32'-8"		
MAXIMUM DEAD END CORRIDOR	LENGTH	SECTION 1020.4		
GROUP R2	20 FT			
PANIC HARDWARE				
REQUIRED ON ALL EX	IT ACCESS DOORS S	ERVING ASSEMBLY SPACES WITH 50 OR MORE OCCUPANTS		

OCCUPANT LOAD BUILDING CALCULATIONS

	· · · · · · ·	0.2 0
L 1 GROSS FLOOR AREA 10,789 SF 1,180 SF	LOAD FACTOR 200 GROSS 300 GROSS	OCCUPANT LOAD 54 _4 58
GROSS FLOOR AREA 7,324 SF 2,759 SF 1,712 SF	LOAD FACTOR 200 GROSS 200 GROSS 300 GROSS	OCCUPANT LOAD 37 14 _6 57
L 1 GROSS FLOOR AREA 4,295 SF 3,478 SF 415 SF	LOAD FACTOR 200 GROSS 200 GROSS 300 GROSS	OCCUPANT LOAD 22 17 1 40
L 1 GROSS FLOOR AREA 4,069 SF 6,078 SF 1,925 SF	LOAD FACTOR 200 GROSS 200 GROSS 300 GROSS	OCCUPANT LOAD 20 30 7 57
	GROSS FLOOR AREA 10,789 SF 1,180 SF L 1 GROSS FLOOR AREA 7,324 SF 2,759 SF 1,712 SF L 1 GROSS FLOOR AREA 4,295 SF 3,478 SF 415 SF L 1 GROSS FLOOR AREA 4,069 SF 6,078 SF	CAD FACTOR CAD

CODE REFERENCE PLAN - 1ST FLOOR

EGRESS REQUIREMENTS

MINIMUM NUMBER OF EXITS	_	
SEGMENT F	2	2
SEGMENT G	2	2
SEGMENT H	2	2
SEGMENT J	2	2
EXIT WIDTH FACTORS (STAIRS/OTHE	ER)	SECTION 1005, 1011, 1024
SEGMENT F	44"/44"	44"/80"
SEGMENT G	44"/44"	44"/80"
SEGMENT H	44"/44"	44"/80"
SEGMENT J	44"/44"	44"/80"
MAXIMUM EXIT ACCESS TRAVEL DIS	TANCE	TABLE 1017.2
SEGMENT F (R2)	250 FT	129'- 9"
SEGMENT G (R2)	250 FT	105'-8"
SEGMENT H (R2)	250 FT	162'-0"
SEGMENT J (R2)	250 FT	170'-10"
MAXIMUM COMMON PATH OF TRAVE	L DISTANCE	TABLE 1006.2.1
SEGMENT F (R2)	125 FT	21'-8"
SEGMENT G (R2)	125 FT	32'-2"
SEGMENT H (R2)	125 FT	34'-2"
SEGMENT J (R2)	125 FT	33'-2"
MAXIMUM DEAD END CORRIDOR LEN	NGTH	SECTION 1020.4
GROUP R2	20 FT	
PANIC HARDWARE		

OCCUPANT LOAD BUILDING CALCULATIONS

 LOAD FACTOR
 OCCUPANT LOAD

 200 GROSS
 4

 300 GROSS
 1

GROSS FLOOR AREA 862 SF 78 SF

SEGMENT G - LEVEL 1

OCCUPANCY TYPE
PARKING GARAGES

ACCESSORY STOR/MECH TOTAL OCCUPANT LOAD

SEGMENT H - LEVEL 1

1 CODE REFERENCE PLAN - BASEMENT

OCCUPANCY TYPE PARKING GARAGES ACCESSORY STOR/MECH TOTAL OCCUPANT LOAD	GROSS FLOOR AREA 3,551 SF 400 SF	LOAD FACTOR 200 GROSS 300 GROSS	OCCUPANT LOAD 18 1 19
SEGMENT J - LEVEL OCCUPANCY TYPE PARKING GARAGE ACCESSORY STOR/MECH TOTAL OCCUPANT LOAD	GROSS FLOOR AREA 1,029 SF 112 SF	LOAD FACTOR 200 GROSS 300 GROSS	OCCUPANT LOAD 5 1 6
EGRESS R	•		
ELEMENT MINIMUM NUMBER OF EXITS	REQUIRED F	PROVIDED	
SEGMENT G	2	2	
SEGMENT H	2	2	
SEGMENT J	2	2	
EXIT WIDTH FACTORS (STAIRS	/OTHER)	SECTION 1005, 10	11, 1024
SEGMENT G	44"/44"	44"/80"	
SEGMENT H	44"/44"	44"/80"	
SEGMENT J	44"/44"	44"/80"	
MAXIMUM EXIT ACCESS TRAVE	EL DISTANCE	TABLE 1017.2	
SEGMENT G (R2)	250 FT	45'-9"	
SEGMENT H (R2)	250 FT	118'-10"	
SEGMENT J (R2)	250 FT	37'-10"	
MAXIMUM COMMON PATH OF 1	RAVEL DISTANCE	TABLE 1006.2.1	
SEGMENT G (R2)	125 FT	18'-0"	
SEGMENT H (R2)	125 FT	18'-0"	
SEGMENT J (R2)	125 FT	18'-0"	
MAXIMUM DEAD END CORRIDO	R LENGTH	SECTION 1020.4	
GROUP R2	20 FT		
PANIC HARDWARE			

COMMON PATH OF TRAVEL - 32'-3"

COMMON PATH OF TRAVEL - 32'-8"

| LEE'S SUMMIT, MO

 \triangle REVISIONS

JOB NO. **705921** DRAWN BY **TSC/SIW** DATE **03.15.2023** 4/11/2023
CITY COMMENTS
SHEET NAME
BUILDING 2 EGRESS &
OCCUPANCY PLANS
SHEET NO.

A0.25

— COMMON PATH OF TRAVEL - 33'-0" COMMON PATH OF TRAVEL - 30'-6" -TRAVEL DISTANCE - 90'-3" TRAVEL DISTANCE - 79'-2" — TRAVEL DISTANCE - 145'-4" — COMMON PATH OF TRAVEL - 32'-3" TRAVEL DISTANCE - 132'-0" COMMON PATH OF TRAVEL - 32'-8"

2 CODE REFERENCE PLAN - 4TH FLOOR

OCCUPANT LOAD BUILDING CALCULATIONS

<u>SEGMENT F - LEV</u>	<u>/EL 4</u>		
OCCUPANCY TYPE RESIDENTIAL TOTAL OCCUPANT LOAD	GROSS FLOOR AREA 13,220 SF	LOAD FACTOR 200 GROSS	OCCUPANT LOAD 66 66
SEGMENT G - LEV	<u>/EL 4</u>		
OCCUPANCY TYPE RESIDENTIAL ACCESSORY STOR/MECH TOTAL OCCUPANT LOAD	GROSS FLOOR AREA 12,375 SF 146 SF	LOAD FACTOR 200 GROSS 300 GROSS	OCCUPANT LOAD 62 _1 63
SEGMENT H - LEVOCCUPANCY TYPE RESIDENTIAL TOTAL OCCUPANT LOAD	/EL 4 GROSS FLOOR AREA 8,559 SF	LOAD FACTOR 200 GROSS	OCCUPANT LOAD 43 43
SEGMENT J - LEV OCCUPANCY TYPE RESIDENTIAL ACCESSORY STOR/MECH TOTAL OCCUPANT LOAD	GROSS FLOOR AREA 12,871 SF 127 SF	LOAD FACTOR 200 GROSS 300 GROSS	OCCUPANT LOAD 64 1 65

EADEAA DEALUDEMENTA

EGRESS RE	QUIREN	MENTS
ELEMENTF	REQUIRED	PROVIDED .
MINIMUM NUMBER OF EXITS		
SEGMENT F	2	2
SEGMENT G	2	2
SEGMENT H	2	2
SEGMENT J	2	2
EXIT WIDTH FACTORS (STAIRS/OTH	ER)	SECTION 1005, 1011, 1024
SEGMENT F	44"/44"	44"/80"
SEGMENT G	44"/44"	44"/80"
SEGMENT H	44"/44"	44"/80"
SEGMENT J	44"/44"	44"/80"
MAXIMUM EXIT ACCESS TRAVEL DIS	STANCE	TABLE 1017.2
SEGMENT F (R2)	250 FT	90'- 3"
SEGMENT G (R2)	250 FT	79'-2"
SEGMENT H (R2)	250 FT	145'-4"
SEGMENT J (R2)	250 FT	132'-0"
MAXIMUM COMMON PATH OF TRAVE	EL DISTANCE	TABLE 1006.2.1
SEGMENT F (R2)	125 FT	33'-0"
SEGMENT G (R2)	125 FT	36'-0"
SEGMENT H (R2)	125 FT	33'-0"
SEGMENT J (R2)	125 FT	32'-8"
MAXIMUM DEAD END CORRIDOR LE	NGTH	SECTION 1020.4
GROUP R2	20 FT	
PANIC HARDWARE REQUIRED ON ALL EXIT A	CCESS DOORS SER	VING ASSEMBLY SPACES WITH 50 OR MORE OCCUPANTS

CODE REFERENCE PLAN - 3RD FLOOR 1" = 30'-0"

OCCUPANT LOAD BUILDING CALCULATIONS

— COMMON PATH OF TRAVEL - 33'-0"

TRAVEL DISTANCE - 132'-0"

TRAVEL DISTANCE - 90'-3"

COMMON PATH OF TRAVEL - 30'-6" -

TRAVEL DISTANCE - 79'-2" -


TRAVEL DISTANCE - 145'-4" -

OCCUPAN	II LOAD D	OILDIN	CALCU
SEGMENT F - LEVE OCCUPANCY TYPE RESIDENTIAL ACCESSORY STOR/MECH TOTAL OCCUPANT LOAD	L 3 GROSS FLOOR AREA 13,153 SF 20 SF	LOAD FACTOR 200 GROSS 300 GROSS	OCCUPANT LOAD 66 _1 67
SEGMENT G - LEVE OCCUPANCY TYPE RESIDENTIAL ACCESSORY STOR/MECH TOTAL OCCUPANT LOAD	GROSS FLOOR AREA 12,375 SF _146 SF	LOAD FACTOR 200 GROSS 300 GROSS	OCCUPANT LOAD 62 _1 63
SEGMENT H - LEVE OCCUPANCY TYPE RESIDENTIAL TOTAL OCCUPANT LOAD	GROSS FLOOR AREA 8,505 SF	LOAD FACTOR 200 GROSS	OCCUPANT LOAD 43 43
SEGMENT J - LEVE OCCUPANCY TYPE RESIDENTIAL ACCESSORY STOR/MECH TOTAL OCCUPANT LOAD	L 3 GROSS FLOOR AREA 12,849 SF 127 SF	LOAD FACTOR 200 GROSS 300 GROSS	OCCUPANT LOAD 64 1 65

<u>element</u> <u>f</u>	<u> REQUIRED</u>	PROVIDED PROVIDED
MINIMUM NUMBER OF EXITS		
SEGMENT F	2	2
SEGMENT G	2	2
SEGMENT H	2	2
SEGMENT J	2	2
EXIT WIDTH FACTORS (STAIRS/OTHE	ER)	SECTION 1005, 1011, 1024
SEGMENT F	44"/44"	44"/80"
SEGMENT G	44"/44"	44"/80"
SEGMENT H	44"/44"	44"/80"
SEGMENT J	44"/44"	44"/80"
MAXIMUM EXIT ACCESS TRAVEL DIS	TANCE	TABLE 1017.2
SEGMENT F (R2)	250 FT	90'- 3"
SEGMENT G (R2)	250 FT	79'-2"
SEGMENT H (R2)	250 FT	145'-4"
SEGMENT J (R2)	250 FT	132'-0"
MAXIMUM COMMON PATH OF TRAVE	EL DISTANCE	TABLE 1006.2.1
SEGMENT F (R2)	125 FT	33'-0"
SEGMENT G (R2)	125 FT	36'-0"
SEGMENT H (R2)	125 FT	33'-0"
SEGMENT J (R2)	125 FT	32'-8"
MAXIMUM DEAD END CORRIDOR LEI	NGTH	SECTION 1020.4
GROUP R2	20 FT	



WALL ASSEMBLY INFORMATION 4-3/4" 6-3/4" 0-HR 0-HR N/A N/A N/A N/A N/A N/A

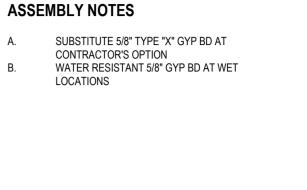

IDENTIFICATION

STUD SIZE

THICKNESS

FIRE RATING

FIRE TEST NUMBER

ACOUSTICAL RATING

ACOUSTICAL TEST NUMBER



THICKNESS

>----- 5/8" TYPE GYPSUM WALLBOARD


JOINTS & NAIL HEADS

(OPTIONAL)


— WOOD STUDS

DIMENSION TO FACE OF STUD U.N.O

— CEMENTITIOUS BACKER BOARD

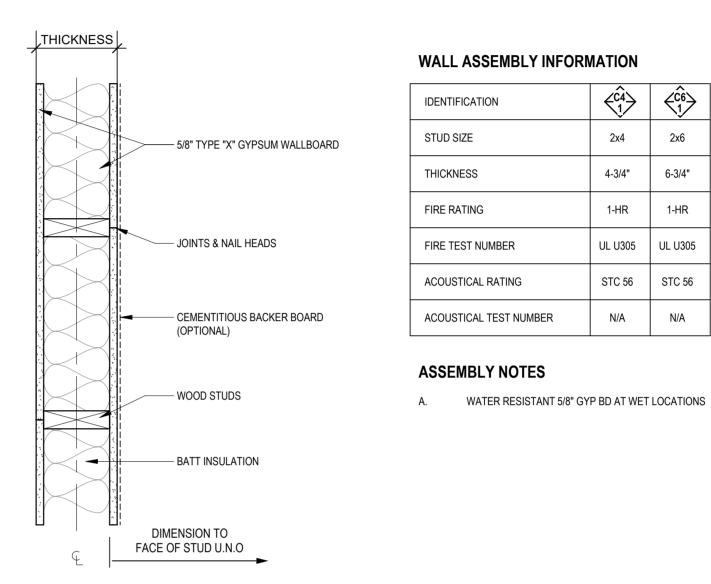


C 1-HOUR INTERIOR WOOD STUD WALL
1 1/2" = 1'-0"

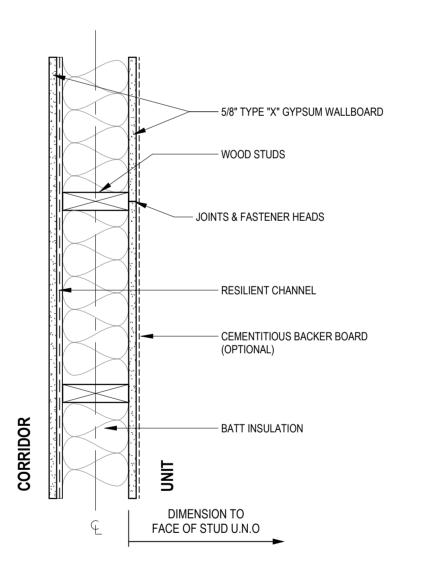

IDENTIFICATION	⟨\$\hat{94}\right\}	⟨\$\hat{6}{1}\$
STUD SIZE	2x4	2x6
THICKNESS	5-1/4"	7-1/4"
FIRE RATING	1-HR	1-HR
FIRE TEST NUMBER	UL U309	UL U309
ACOUSTICAL RATING	50	50
ACOUSTICAL TEST NUMBER	BBN 760903	BBN 760903
ASSEMBLY NOTES		
A. WATER RESISTANT 5/8"	GYP BD AT WET	LOCATION

B. TYP AT CORRIDOR WALLS

B 1-HR INTERIOR WOOD STUD WALL W/ RES CHANNELS

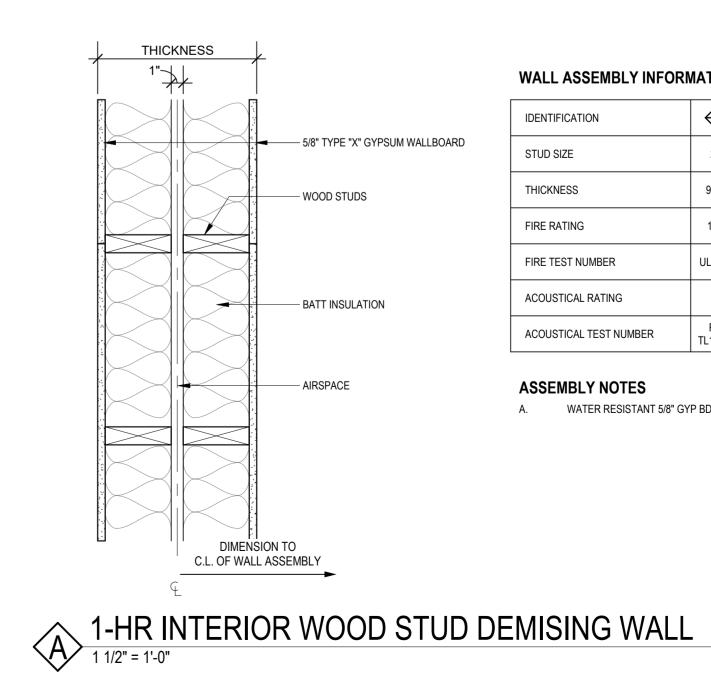

IDENTIFICATION	₹Â4	\Diamond
STUD SIZE	2x4	
THICKNESS	9 1/4"	
FIRE RATING	1-HR	
FIRE TEST NUMBER	UL U341	
ACOUSTICAL RATING	55	
ACOUSTICAL TEST NUMBER	RAL TL11-160	

ASSEMBLY NOTES A. WATER RESISTANT 5/8" GYP BD AT WET LOCATIONS

705921 **DRAWN BY** TSC/SIW 4/11/2023

CITY COMMENTS SHEET NAME RATED ASSEMBLIES

03.15.2023

 \triangle REVISIONS


LEE'S

ARD RD.

IDENTIFICATION - ROOFING SYSTEM - TRUSS RE: STRUCTURAL FRAMING - INSULATION RE: SPEC THICKNESS FIRE RATING FIRE TEST NUMBER ACOUSTICAL RATING ACOUSTICAL TEST NUMBER **ASSEMBLY NOTES** - 5/8" GYPSUM BOARD - FURRING CHANNELS

- AIR DUCT RE: MECHANICAL



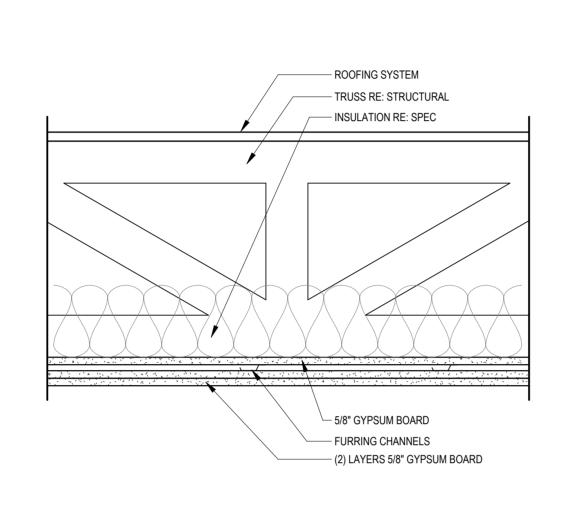

WOOD TRUSS	\Diamond
VARIES	
2-HR	
P571	

ASSEMBLY NOTES

ROOF ASSEMBLY INFORMATION


WOOD

TRUSS

VARIES

1-HR

P556

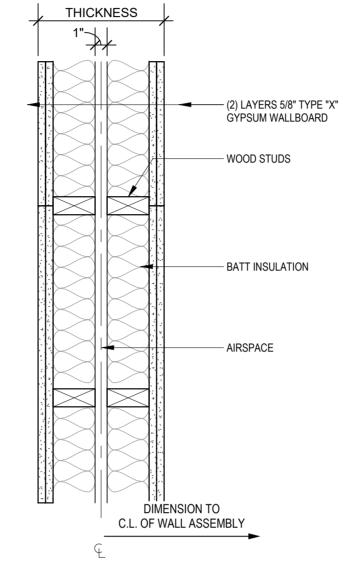

IDENTIFICATION	€ G4 >
STUD SIZE	2x4
THICKNESS	10 1/2"
FIRE RATING	2-HR
FIRE TEST NUMBER	UL U351
ACOUSTICAL RATING	N/A
ACOUSTICAL TEST NUMBER	N/A

WALL ASSEMBLY INFORMATION

IDENTIFICATION

STUD SIZE

THICKNESS

FIRE RATING

FIRE TEST NUMBER

ACOUSTICAL RATING

ACOUSTICAL TEST NUMBER

ASSEMBLY NOTES

A. TYP AT STAIRS, ELEVATORS & TRASH CHUTES

2x6


2-HR

UL U301


52

USG-810218



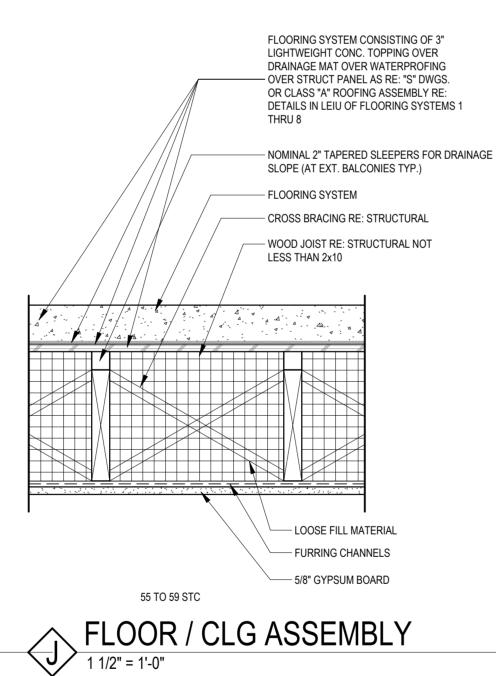


IDENTIFICATION	⟨¹⟩	\Diamond
FRAMING	2x10	
THICKNESS	VARIES	
FIRE RATING	1-HR	
FIRE TEST NUMBER	L569	
ACOUSTICAL RATING	N/A	
ACOUSTICAL TEST NUMBER		

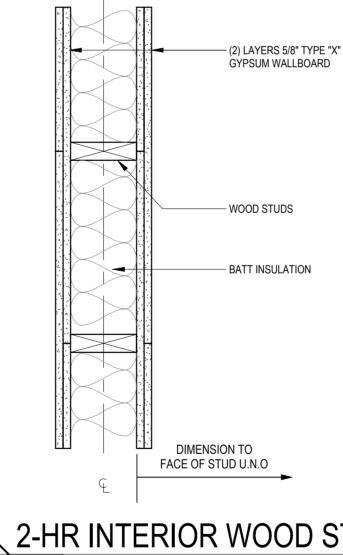

<u>:</u>	DIMENSION TO FACE OF STUD U.N.O
2-HR INT	ERIOR WOOD STUD WALL

				WALL A	ASSEMBLY INFORI	MATION	
		- - -		IDENTIFIC	CATION	⟨ <u>£6</u> }	\Diamond
			- 5/8" TYPE "X" GYPSUM WALLBOARD	STUD SIZ	E	2x6	
		WOOD STUDS	THICKNE	THICKNESS			
			FIRE RAT	ING	1-HR		
			- WOOD STRUCTURAL PANEL SHEATHING	FIRE TES	T NUMBER	UL U356	
)E)		- BATT INSULATION	ACOUSTI	CAL RATING	N/A		
		- CEMENTITIOUS BACKER BOARD	ACOUSTI	CAL TEST NUMBER	N/A		
		UNITS (OPTIONAL)	ASSEM	BLY NOTES			
RE SII		- EXTERIOR FACING	A.	WATER RESISTANT 5/8" GY	/P BD AT WET	LOCATIONS	
INTERIOR (FIRE SIDE)		IOR IOR					
NTERI		EXTERIOR					
=]	SION TO				
			EATHING U.N.O				
ш	D EVT			Λ/ΛΙΙ			

FLOORING SYSTEM WOOD TRUSS @ 24 O.C.	1
	THICKNESS
FURRING CHANNELS 5/8" GYPSUM BOARD	1-+

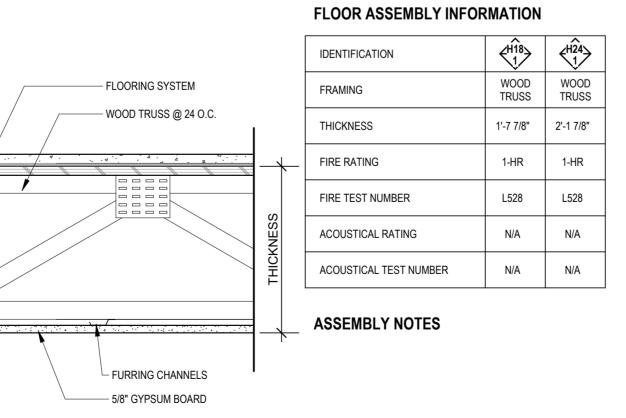



COLUMN ASSEMBLY 1 1/2" = 1'-0"

BEAM ASSEMBLY
1 1/2" = 1'-0"

— STEEL STUDS

— CORNER BEADS

— (1) LAYER TYPE X GYP BD

— OPT: DECORATIVE COLUMN

COVER RE: ID

- STEEL COLUMN RE: STRUCTURAL

FLR / CLG ASSEMBLY
1 1/2" = 1'-0"

A. SEE UL X528 FOR MORE INFORMATION

BEAM ASSEMBLY INFORMATION

PER

STRUC.

VARIES

1-HR

N743/X790

CAFCO 300 SPRAY APPLIED FIRE PROOFING. APPLY RE: MANF. INSTRUCTIONS TO DEVELOP REQUIRED

PER

STRUC.

VARIES

1-HR

X528

IDENTIFICATION

STUD SIZE

THICKNESS

FIRE RATING

FIRE TEST NUMBER

ASSEMBLY NOTES

COLUMN ASSEMBLY INFORMATION

IDENTIFICATION

THICKNESS

FIRE RATING

FIRE TEST NUMBER

ASSEMBLY NOTES

STEEL BEAM

MATERIALS

SPRAY-APPLIED FIRE RESISTIVE

BASED ON UL N743 & X790

derwiters Laboratories, Inc.

o ASTM/UL1479 (ASTM E814)

include the following construction features:

Resistance Directory. Max diam of opening is 2-1/2 in.

Rating is equal to the F rating of the firestop system.


T Rating is equal to the F Rating of the firestop system.


used, the T Rating is equal to the F Rating of the firestop system.

Rating is equal to the F Rating of the firestop system.

equal to the F Rating of the firestop system.

The following types and sizes of cables may be used:

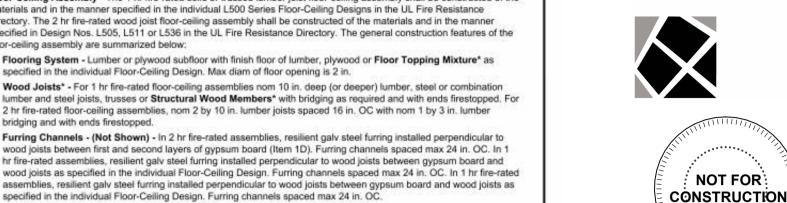

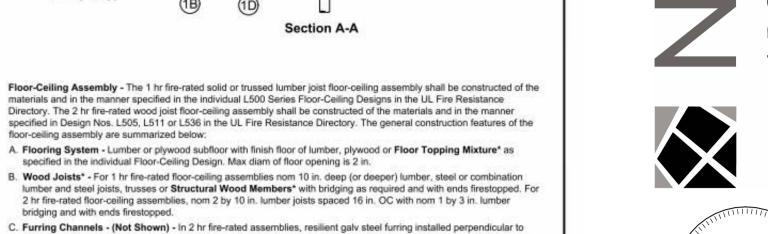

hr fire-rated assemblies, resilient galv steel furring installed perpendicular to wood joists between gypsum board and wood joists as specified in the individual Floor-Ceiling Design. Furring channels spaced max 24 in: OC. In 1 hr fire-rated assemblies, resilient galv steel furring installed perpendicular to wood joists between gypsum board and wood joists as specified in the individual Floor-Ceiling Design. Furring channels spaced max 24 in. OC. D. Gypsum Board* - Nom 4 ft wide by 5/8 in. thick as specified in the individual Floor-Ceiling Design. First layer of gypsum board secured to wood joists or furring channels as specified in the individual Floor-Ceiling Design. Second layer of wallboard (2 hr fire-rated assembly) screw-attached to furring channels as specified in the individual Floor-Ceiling Design. Max diam of ceiling opening is 2 in.

> Specified Technologies Inc. 210 Evans Way Somerville, NJ 08876 Reproduced courtesy of Underwriters Laboratories, Inc. Created or Revised: August 17, 2011

(800)992-1180 • (908)526-8000 • FAX (908)231-8415 • E-Mail:techserv@stffrestop.com • Website:www.stifirestop.com

Inderwiters Laboratories, Inc. to ASTM/UL1479 (ASTM E814)

floor-ceiling assembly are summarized below:

bridging and with ends firestopped.

1. Floor-Ceiling Assembly - The 1 hr fire-rated solid or trussed lumber joist floor-ceiling assembly shall be constructed of the materials and in the manner specified in individual L500 Series Floor-Ceiling Designs in the UL Fire Resistance Directory, as summarized below:

T Rating - 1 Hi

L Rating at Ambient - Less Than 1 CFM/sq ft

L Rating at 400° F - Less Than 1 CFM/sq ft

Underwiters Laboratories, Inc.

to ASTM/UL1479 (ASTM E814)

A. Flooring System - Lumber or plywood subfloor with finish floor of lumber, plywood or Floor Topping Mixture* as specified in the individual Floor-Ceiling Design. Max diam of floor opening is 2 in. (51 mm B. Wood Joists - Nom 2 by 10 in. (51 by 254 mm) lumber joists spaced 16 in. OC with nom 1 by 3 in. (25 by 76 mm) lumber bridging and with ends firestopped. As an alternate to lumber joists, nom 10 in. (254 mm) deep (or deeper) lumber, steel or combination lumber and steel joists, trusses or Structural Wood Members* with bridging as required with ends firestopped.


C. Furring Channels - (Not Shown) - Resilient galv steel furring installed perpendicular to wood joists (Item 1B) between wallboard (Item 1D) and wood joists or furring channels as required in the individual Floor-Ceiling D. Gypsum Board* - Nom 4 ft (1.2 m) wide by 5/8 in. (16 mm) thick as specified in the individual Floor-Ceiling Design. Wallboard secured to wood joists or furring channels as specified in the individual Floor-Ceiling


2. Chase Wall - (Optional) - The through penefrant (Item 3) may be routed through a 1 hr fire-rated single, double or staggered wood stud/gypsum wallboard chase wall constructed of the materials and in the manner specified in the individual U300 Series Wall and Partition Designs in the UL Fire Resistance Directory and shall include A. Studs - Nom 2 by 6 in. (51 by 152 mm) or double nom 2 by 4 in. (51 by 102 mm) lumber studs. B. Sole Plate - Nom 2 by 6 in. (51 by 152 mm) or parallel 2 by 4 in. (51 by 102 mm) lumber plates, tightly

Design, Max diam of ceiling opening is 2 in. (51 mm).

C. Top Plate - The double top plate shall consist of two nom 2 by 6 in. (51 by 152 mm) or two sets of parallel 2 by 4 in. (51 by 102 mm) lumber plates, tightly butted. Max diam of opening is 2 in. (51 mm). D. Gypsum Board* - Thickness, type, number of layers and fasteners shall be as specified in individual Wall and Partition Design.


Specified Technologies Inc. 210 Evans Way Somerville, NJ 08876

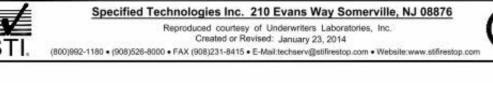

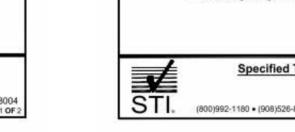

SUMMIT,

LEE'S

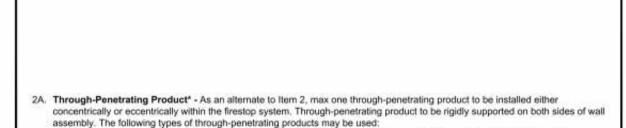

System No. W-L-3024

T Ratings - 0, 1/2, 1 and 2 Hr (See Items 2 and 2A)

L Rating At Ambient - Less Than 1 CFM/sq ft

L Rating At 400 F - Less Than 1 CFM/sq ft

Wall Assembly - The 1 or 2 hr fire rated gypsum board/stud wall assembly shall be constructed of the materials and in the manner specified in the individual U300 or U400 Series Wall and Partition Designs in the UL Fire Resistance Directory and shall

spaced 16 in. OC. Steel studs to be min 2-1/2 in. wide and spaced max 24 in. OC.

A. Studs - Wall framing may consist of either wood studs or steel channel studs. Wood studs to consist of nom 2 by 4 in. lumber

B. Gypsum Board* - 5/8 in. thick, 4 ft wide with square or tapered edges. The gypsum board type, thickness, number of layers,

fastener type and sheet orientation shall be as specified in the individual U300 or U400 Series Design in the UL Fire

The hourly F Rating of the firestop system is equal to the hourly fire rating of the wall assembly in which it is installed.

Cables - One cable to be installed either concentrically or eccentricity within the firestop system. The annular space within the

firestop system shall be a min 0 in. (point contact) to a max 1/4 in. Cable to be rigidly supported on both sides of wall assembly.

A. Max 200 pair No. 24 AWG (or smaller) copper conductor cable with polyvinyl chloride (PVC) jacketing and insulation. When

B. Max 3/C No. 2/0 AWG (or smaller) aluminum conductor service entrance cable with PVC insulation and jacketing. When

C. Max 1/C-750 kcmil copper conductor power cable with cross-linked polyethylene (XLPE) insulation and jacketing. When

service entrance cable is used, the T Rating is equal to the F Rating of the firestop system.

1/C-750 kcmil cable is used, the T Rating is equal to the F Rating of the firestop system.

200 pair No. 24 AWG telephone cable is used, T Rating is 0 hr. When 50 pair No. 24 AWG telephone cable is used, T

D. Max 3/C No. 8 AWG (or smaller) PVC insulated and jacketed nonmetallic sheathed (Romex) cable. When Romex is used, the

E. Max RG59/U (or smaller) coaxial cable with fluorinated ethylene insulation and jacketing. When coaxial cable is used, the T

F. Max 62.5/125 micron fiber optic cable with PVC insulation and jacketing. When fiber optic cable is used, the T Rating is

G. Max 4 pair No. 24 AWG (or smaller) copper conductor data cable with Hylar insulation and jacketing. When data cable is

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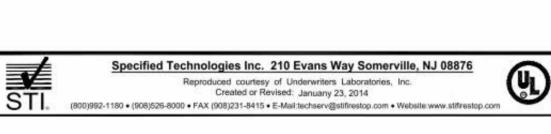
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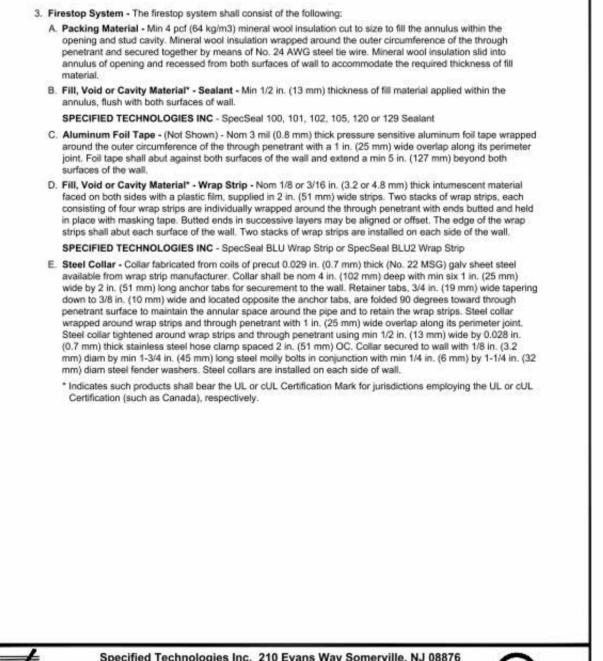
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Section A-A

- A. Max four copper conductors No. 4/0 AWG (or smaller) aluminum or steel Armored Cable+ or Metal-Clad Cable+. When armored or metal-clad cable is used, the T Rating is 1/2 hr. AFC CABLE SYSTEMS INC B. Two or more twisted copper conductors No. 6 AWG (or smaller) Power Limited Circuit Cable+ with or without a jacket under a metal armor. When Power Limited Circuit Cable+ is used, the T Rating is 1/2 hr
- AFC CABLE SYSTEMS INC C. Two or more twisted copper conductors No. 10 AWG (or smaller) Power Limited Fire Alarm Cable+ with or without a jacket under a metal armor. When Power Limited Fire Alarm Cable+ is used, the T Rating is equal to the F Rating of the
- AFC CABLE SYSTEMS INC D. Two or more twisted copper conductors No. 12 AWG (or smaller) Non Power Limited Fire Alarm Cable+ with or without a jacket under a metal armor. When Non Power Limited Fire Alarm Cable+ is the T Rating is equal to the F Rating of the firestop system. AFC CABLE SYSTEMS INC
- Fill Void or Cavity Material* Sealant or Putty Min 5/8 in. thickness of fill material installed within annulus, flush with both surfaces of wall assembly. Additional fill material installed such that a min 1/4 in, diam crown is formed around the through-penetrant on both sides of the wall. SPECIFIED TECHNOLOGIES INC - SpecSeal Series SSS Sealant, SpecSeal Putty or SpecSeal LCI Sealant
- *Bearing the UL Classification Marking +Bearing the UL Listing Mark





Underwiters Laboratories, Inc.

to ASTM/UL1479 (ASTM E814)

System No. W-L-2079

T Rating - 0 Hr

L Rating At Ambient - 1 CFM/sq ft

L Rating At 400 F - Less Than 1 CFM/sq ft

. Wall Assembly - The 1 or 2 hr fire-rated gypsum wallboard/stud wall assembly shall be constructed of the

Fire Resistance Directory and shall include the following construction features:

assembly. The following types and sizes of nonmetallic pipes may be used:

pipe for use in closed (process or supply) piping systems.

closed (process or supply) vented (drain, waste, or vent) piping systems.

materials and in the manner described in the individual U300 or U400 Series Wall or Partition Design in the UL

A. Studs - Wall framing may consist of either wood studs or steel channel studs. Wood studs to consist of nom 2

by 4 in. (51 by 102 mm) lumber spaced 16 in. OC (406 mm) with nom 2 by 4 in. (51 by 102 mm) lumber end

plates and cross braces. Steel studs to be min 2-1/2 in. (64 mm) wide and spaced max 24 in. (610 mm) OC.

wallboard type, thickness, number of layers, fastener type and sheet orientation shall be as specified in the

The hourly F rating of the firestop system is equal to the hourly fire rating of the wall assembly in which it is

individual U300 or U400 Series Design in the UL Fire Resistance Directory. Max diam of opening is 10 in. (254

B. Gypsum Board* - 5/8 in. (16 mm) thick, 4 ft (1219 mm) wide with square or tapered edges. The gypsum

2. Through Penetrant - One nonmetallic pipe to be centered within the firestop system. A normannular space of

A. Polyvinyl Chloride (PVC) Pipe - Nom 8 in. (203 mm) diam (or smaller) Schedule 40 PVC pipe for use in

11/16 in. (18 mm) is required within the firestop system. Pipe to be rigidly supported on both sides of the wall

B. Flame Retardant Polypropylene (FRPP) Pipe - Nom 8 in. (203 mm) diam (or smaller) Schedule 40 FRPP

C. Chlorinated Polyvinyl Chloride (CPVC) Pipe - Nom 8 in. (203 mm) diam (or smaller) SDR 17 13.5 CPVC

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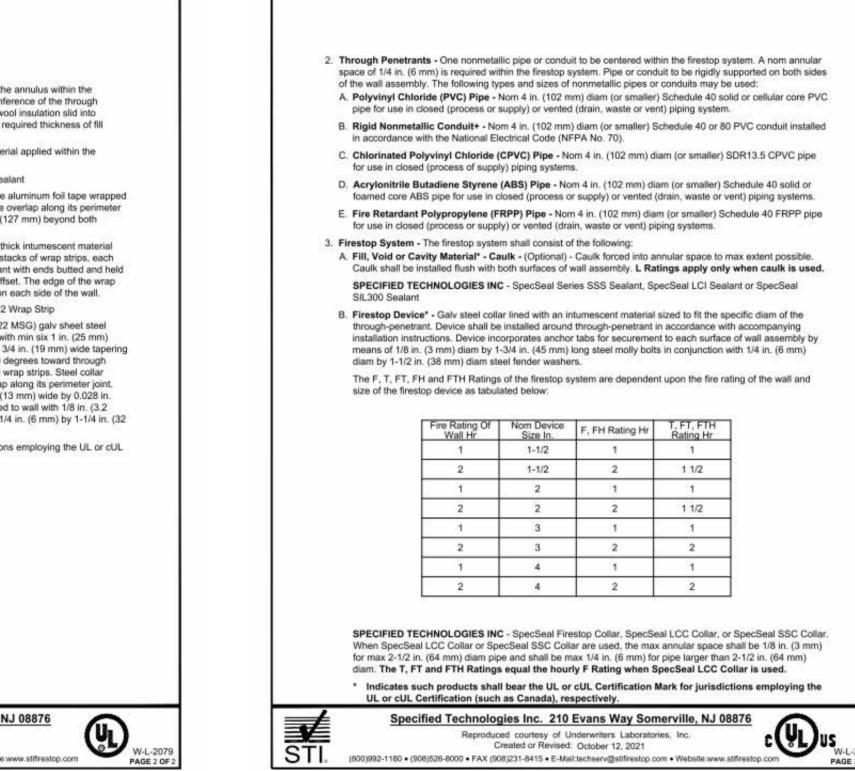
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pipe for use in closed (process or supply) or vented (drain, waste or vent) piping systems.

F Ratings - 1 and 2 Hr (See Item 1B



Pipe Covering - One of the following types of pipe coverings shall be used:

Underwiters Laboratories, Inc.

to ANSI/UL 1479 (ASTM E814) and CAN/ULC S115 System No. W-L-2029

CAN/ULC S115

F Ratings - 1 and 2 Hr (See Items 1 and 3B)

FT Ratings - 1, 1-1/2 and 2 Hr (See Item 3B)

FH Ratings - 1 and 2 Hr (See Items 1 and 3B)

FTH Ratings- 1, 1-1/2 and 2 Hr (See Item 3B) L Rating At Ambient - Less Than 5.1 L/s/m2 L Rating At 204°C - Less Than 5.1 L/s/m2

Section A-A

System tested with a pressure differential of 2.5 Pa between the exposed and the unexposed surfaces

Wall Assembly - The 1 or 2 hr fire rated gypsum wallboard/stud wall assembly shall be constructed of the

materials and in the manner described in the individual U300, V300, U400, V400 or W400 Series Wall and

A. Studs - Wall framing may consist of either wood studs or steel channel studs. Wood studs to consist of nom 2

B. Gypsum Board* - 5/8 in. (16 mm) thick, 4 ft (1.2 m) wide with square or tapered edges. The gypsum board

The hourly F and FH Ratings of the firestop system are equal to the hourly fire rating of the wall

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type, thickness, number of layers, fastener type and sheet orientation shall be as specified in the individual

by 4 in. (51 by 102 mm) lumber spaced 16 in. (406 mm) OC. Steel studs to be min 2-1/2 in. (64 mm) wide and

Partition Designs in the UL Fire Resistance Directory and shall include the following construction features:

Design in the UL Fire Resistance Directory, Max diam of opening is 5 in. (127 mm).

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ANSI/UL1479 (ASTM E814)

F Ratings - 1 and 2 Hr (See Items 1 and 3B)


T Ratings - 1, 1-1/2 and 2 Hr (See Item 3B) L Rating At Ambient - Less Than 1 CFM/ft2

L Rating At 400°F - Less Than 1 CFM/ft2

with the higher pressure on the exposed side.


spaced max 24 in. (610 mm) OC.


assembly in which it is installed.

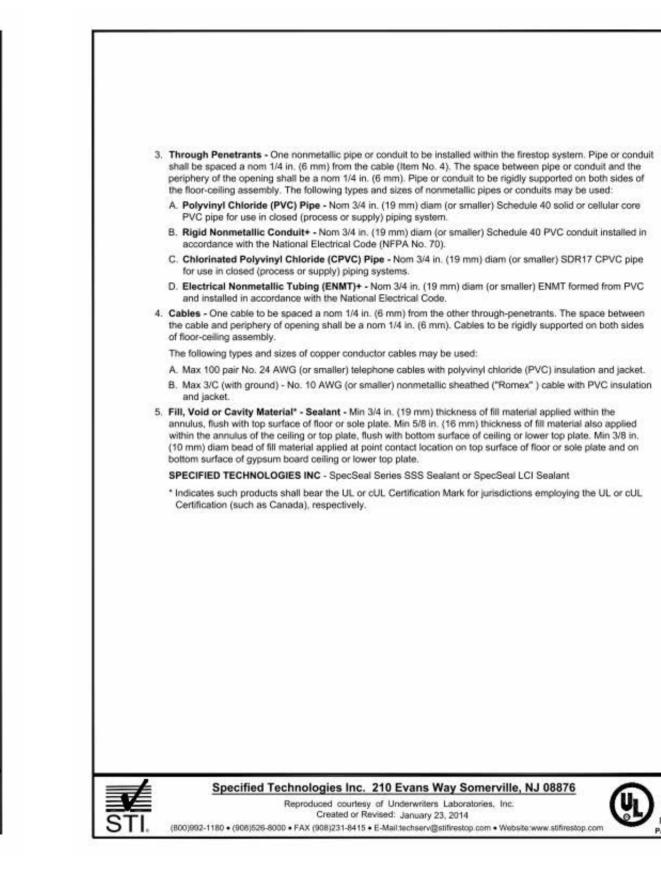

Inderwiters Laboratories, Inc

to ASTM/UL1479 (ASTM E814)

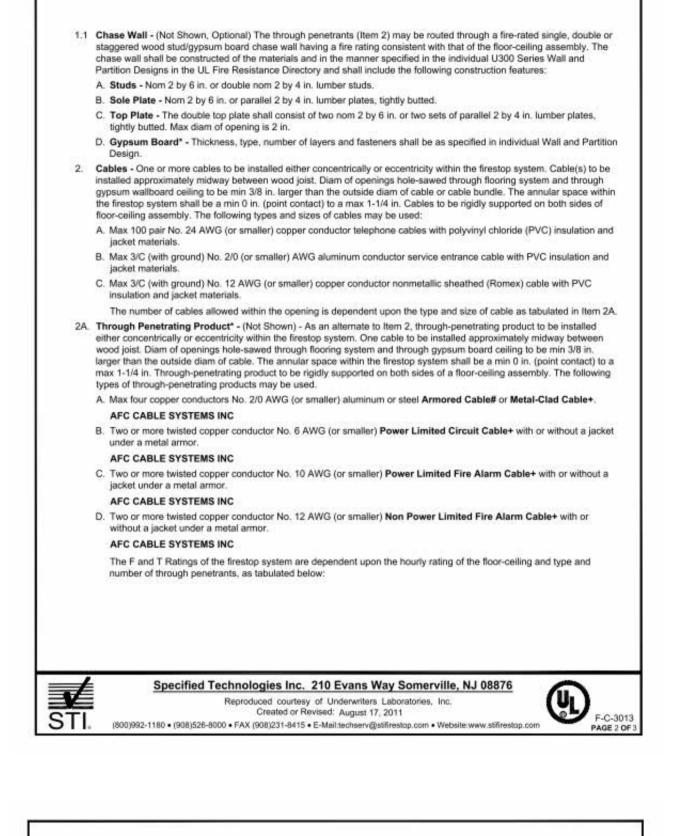

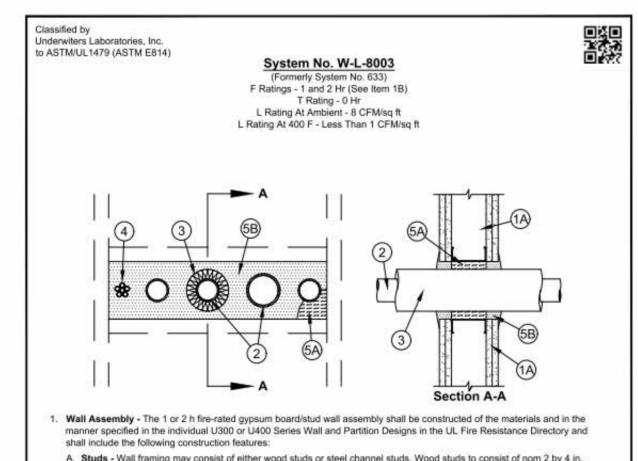


- A. Studs Wall framing may consist of either wood studs or steel channel studs. Wood studs to consist of nom 2 by 4 in.
- h fire rated assemblies, steel studs to be min 3-5/8 in. wide and spaced 24 in. OC. Additional studs shall be installed horizontally in such a manner to form a nom 22-3/4 in. wide by 6 in. high opening. B. Gypsum Board* - 5/8 in. thick, 4 ft wide with square or tapered edges. The gypsum board type, thickness, number of layers, fastener type and sheet orientation shall be as specified in the individual U300 or U400 Series Design in the UL Fire stance Directory. If the through penetrants are installed in a wood stud/gypsum board assembly, the max area of opening is 87 sq. in. with max dimension of 14-1/2 in.


lumber spaced 16 in. OC. In 2 h fire-rated assemblies, steel studs to be min 2-1/2 in. wide and spaced max 24 in. OC. In 1

The hourly F rating of the firestop system is equal to the hourly fire rating of the wall assembly in which it is Through Penetrants - Four pipes, conduits or tubing to be installed within the opening. The space between pipes, conduits or tubing shall be a nom 1-7/8 in. The space between pipes, conduits or tubing and periphery of opening shall be min 5/8 in. to

max 1-15/16 in. Pipe, conduit or tubing to be rigidly supported on both sides of wall assembly. The following types and sizes of


- pipes, conduits or tubing may be used: A. Steel Pipe - Nom 3 in. diam (or smaller) Schedule 5 (or heavier) steel pipe. B. Iron Pipe - Nom 2 in. diam (or smaller) cast or ductile iron pipe.
- C. Conduit Nom 3 in. diam (or smaller) steel electrical metallic tubing or steel conduit. D. Copper Tubing - Nom 2 in. diam (or smaller) Type L (or heavier) copper tubing.
- E. Copper Pipe Nom 2 in. diam (or smaller) Regular (or heavier) copper pipe. F. Polyvinyl Chloride (PVC) Pipe - Nom 2 in. diam (or smaller) Schedule 40 PVC pipe for use in closed (process or supply)

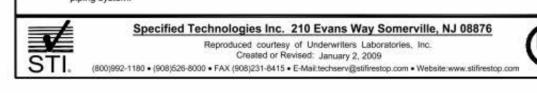

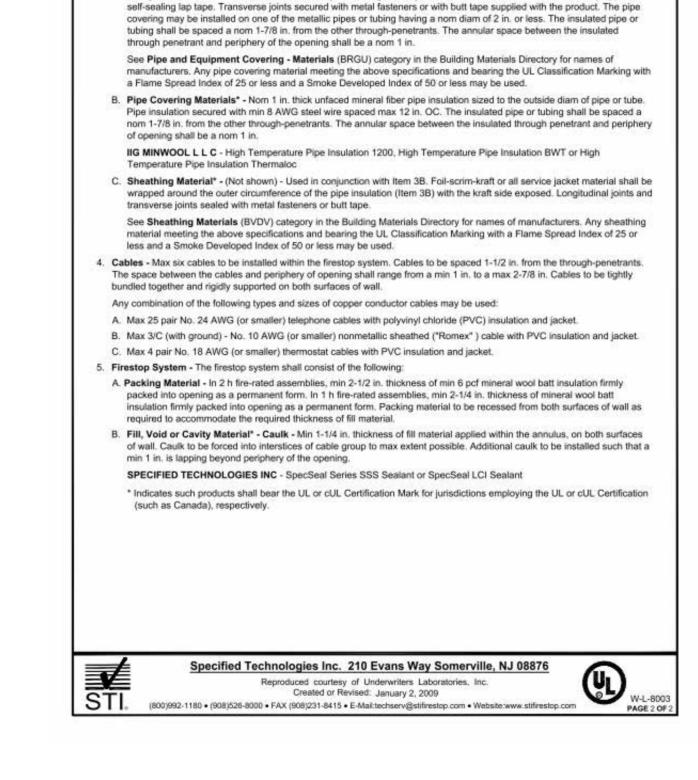

A. Pipe and Equipment Covering - Marerials* - Nom 1 in. thick hollow cylindrical heavy density (min 3.5 pcf) glass fiber

units jacketed on the outside with an all service jacket. Longitudinal joints sealed with metal fasteners or factory-applied

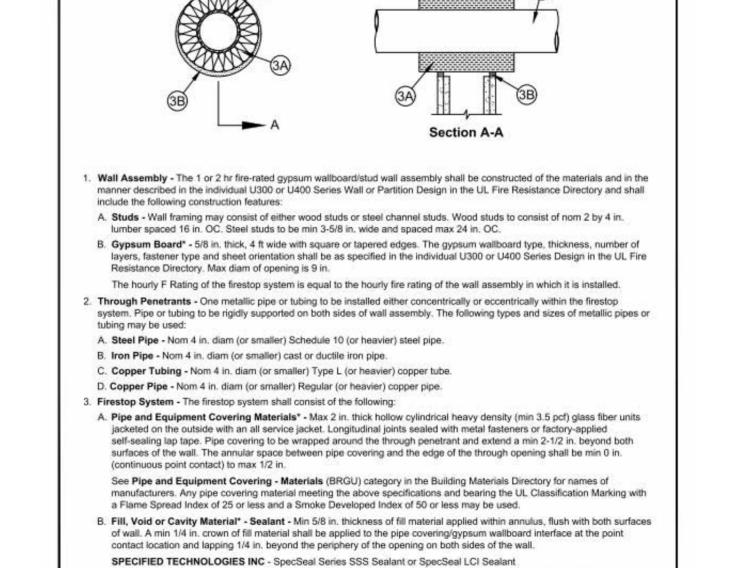

* Indicates such products shall bear the UL or cUL Certification Mark for jurisdictions employing the UL or cUL Certification

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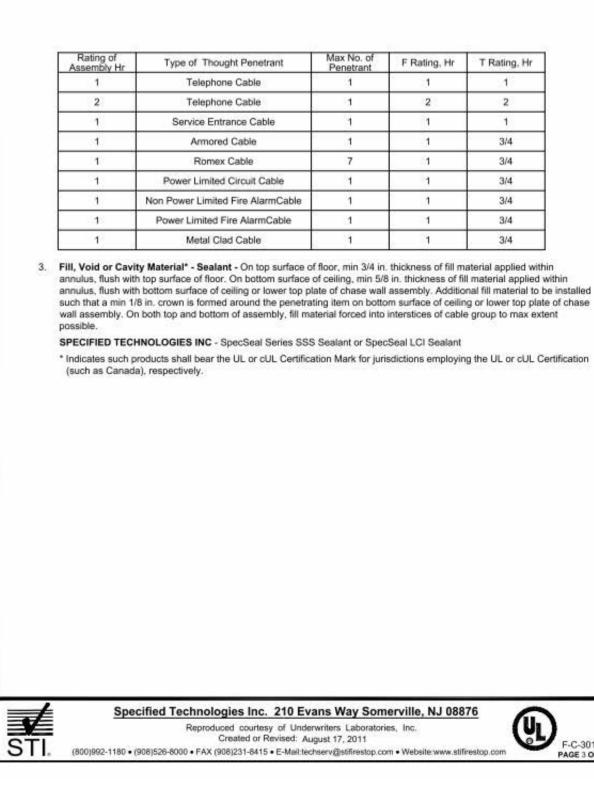
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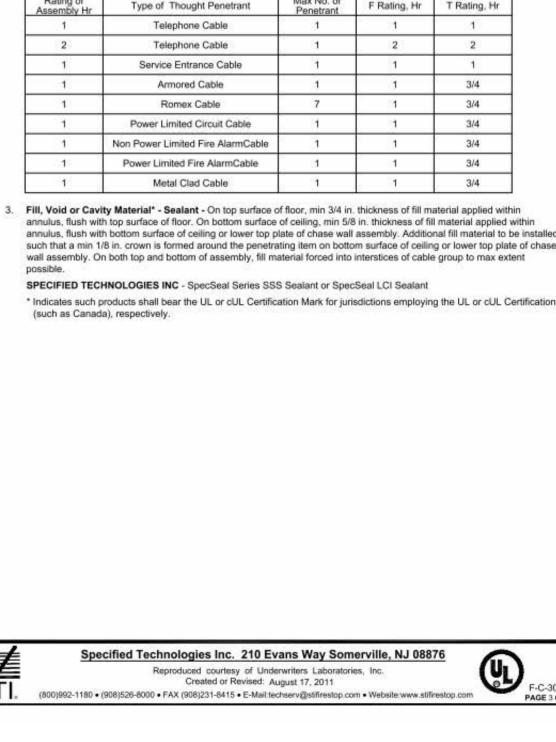
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System No. W-L-110

Ratings - 1 & 2 Hr (See Item 1

T Rating - 0 Hr





705921 03.15.2023 **DRAWN BY** TSC/SIW 4/11/2023 CITY COMMENTS SHEET NAME RATED PENETRATIONS

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TOILET PAPER (TP) TYPE "A" DWELLING UNIT MOUNTING HEIGHTS

COUNTERTOPS

MIN. OR AS NECESSARY TO SPAN STUD BAYS

L – – – + – – – – –

CENTER BLKG. ON WALLS, OR PER ARCHITECT'S DIRECTION

T.V. BLOCKING

ENTRY DOOR


STROBES


ROLL-UNDER COUNTERTOP DETAIL

DEVICES


KITCHEN COUNTERTOPS

TYPE "A" DWELLING UNIT GRAB BAR REINFORCEMENT FOR TOILETS

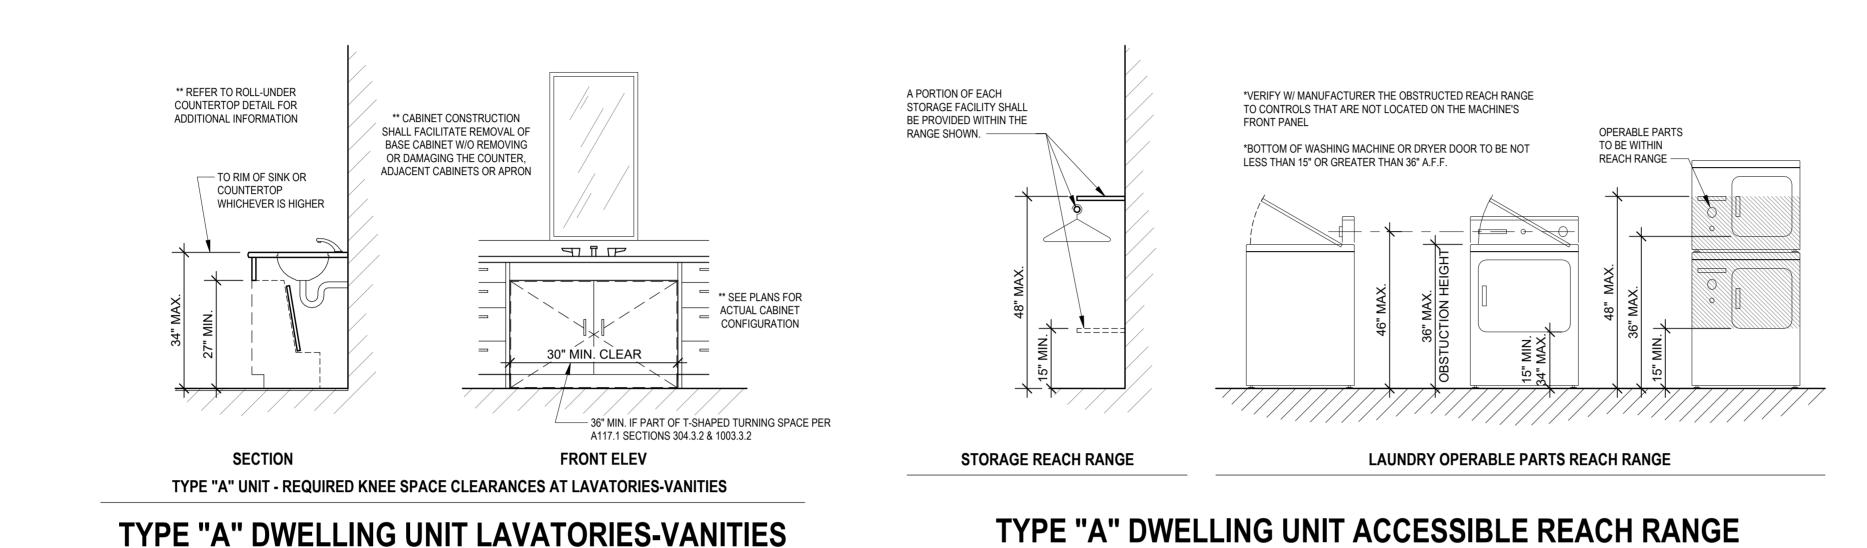

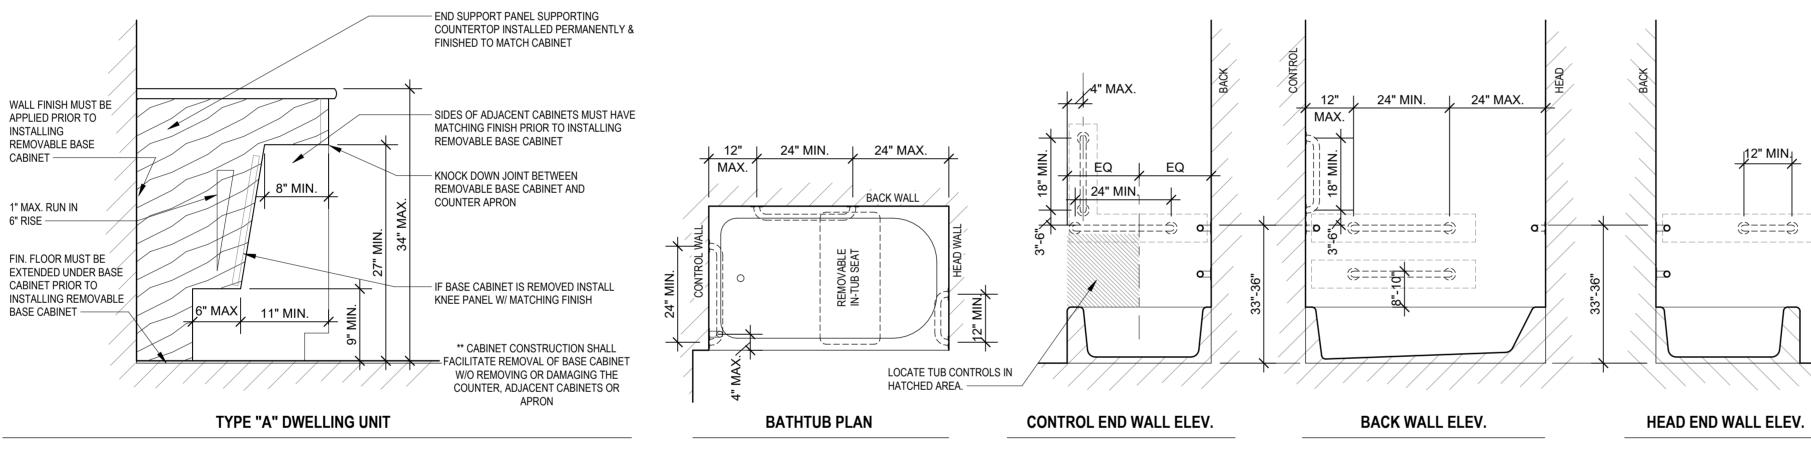

TYPE "A" DWELLING UNIT GRAB BAR REINFORCEMENT FOR BATHTUBS

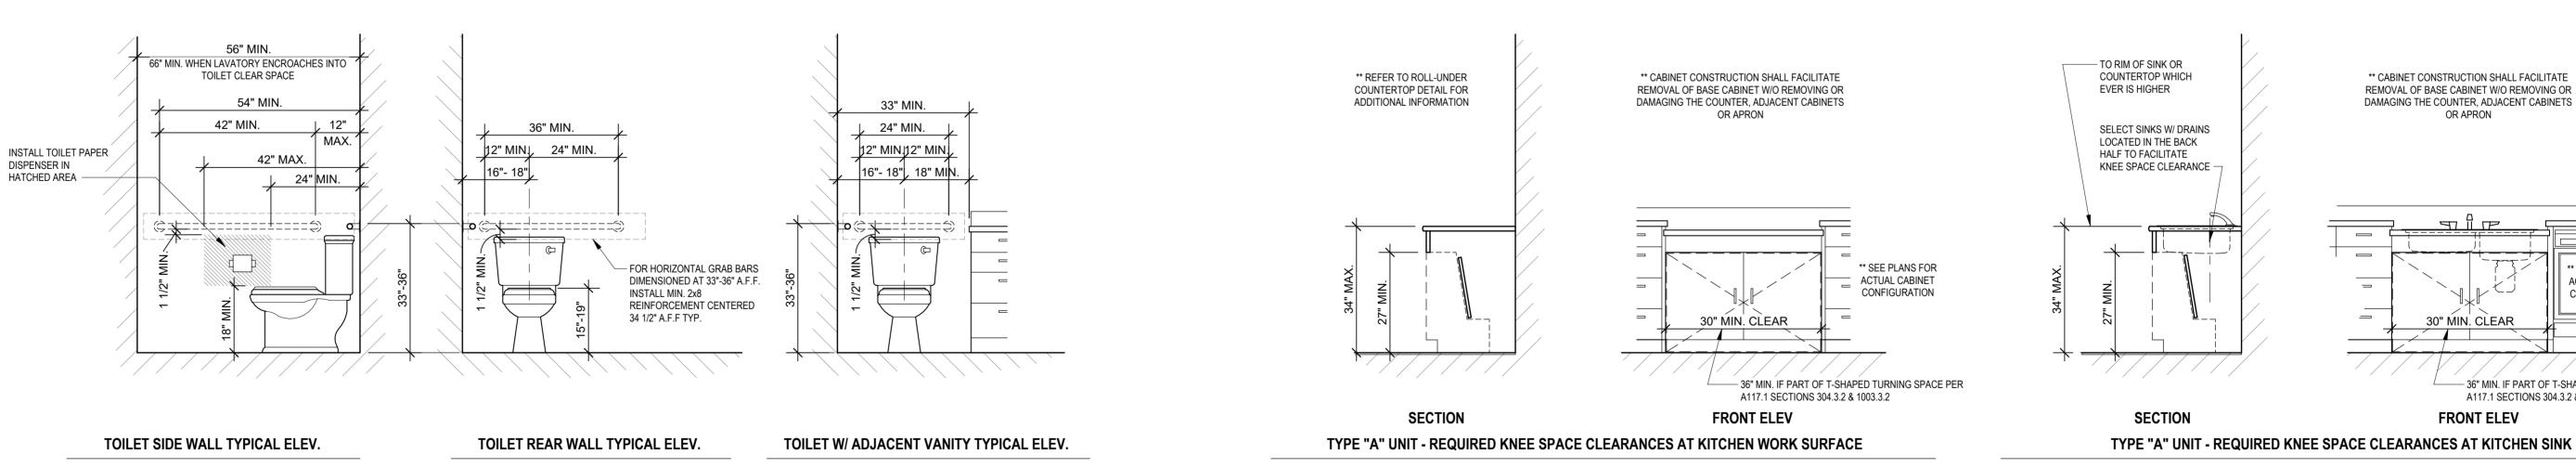

HAND HELD SHOWERHEAD ON SLIDEBAR.

INSTALL PER MRF. RECOMMENDATIONS TO MEET ACCESSIBILITY REQUIREMENTS —

HOOK

TOWEL

TOWEL RING (TR)

ROBE HOOK (RH)

TYPE "A" DWELLING UNITS - ACCESSIBILITY NOTES

BLOCKING

- LOCATE TUB

CONTROLS IN

HATCHED AREA.

CONTROL LOCATION

CURTAIN ROD

SHOWER HEAD

UNITS DESIGNATED ON THE PLANS AS "TYPE A" SHALL MEET ALL APPLICABLE REQUIREMENTS OF A117.1-2009 SECTION 1003.

THE ACCESSIBLE PRIMARY ENTRANCE SHALL BE ON AN ACCESSIBLE ROUTE FROM PUBLIC AND COMMON AREAS.

AT LEAST ONE ACCESSIBLE ROUTE SHALL CONNECT ALL SPACES AND ELEMENTS THAT ARE A PART OF THE UNIT. AN ACCESSIBLE ROUTE SHALL HAVE A CLEAR WIDTH OF 36" MIN. ALL ROOMS SERVED BY AN ACSHANDLETAE 60" WHEELCHAIR TURNING SPACE EXCEPT FOR BATHROOMS NOT REQURED TO COMPLY. A TURNING SPACE IS NOT REQIRED WITHIN CLOSETS OR PANTRES THAT ARE 48" MAXIMUM IN DEPTH.

BETWEEN 1/4" HIGH MIN. AND 1/2" HIGH MAX. SHALL BE BEVELED WITH A SLOPE NOT STEEPER THAN 1:2. THRESHOLDS AT EXTERIOR SLIDING DOORS SHALL BE PERMITTED TO BE 3/4" HIGH MAX. PROVIDED THEY ARE BEVELED WITH A SLOPE NOT GREATER THAN 1:2.

THE FORCE FOR PUSHING OR PULLING OPEN DOORS, OTHER THAN FIRE DOORS, SHALL BE 5.0 LBS. MAX. FOR INTERIOR HINGED DOORS AND 5.0 LBS. MAX. FOR SLIDING OR FOLDING DOORS. THESE FORCES DO NOT APPLY TO THE FORCE REQUIRED TO RET DISENGAGE OTHER DEVICES THAT HOLD THE DOOR IN A CLOSED POSITION.

HANDLES, PULLS, LATCHES, LOCKS, AND OTHER OPERABLE PARTS ON ALL ACCESSIBLE DOORS SHALL HAVE A SHAPE THAT IS EASY TO GRASP WITH ONE HAND AND DOES NOT REQUIRE TIGHT GRASPING, WPRIST HINDOOPERTANTIS TONGER WAS PARTS OF SUCH HARDWARE SHALL BE 34" MIN. AND 48" MAX. AFF. WHERE SLIDING DOORS ARE IN THE FULLY OPEN POSITION, OPERATING HARDWARE SHALL BE EXPOSED AND USABLEDING DOORS ARE IN THE FULLY OPEN POSITION, OPERATING HARDWARE SHALL BE EXPOSED AND USABLEDING DOORS ARE IN THE FULLY OPEN POSITION, OPERATING HARDWARE SHALL BE EXPOSED AND USABLEDING DOORS ARE IN THE FULLY OPEN POSITION, OPERATING HARDWARE SHALL BE EXPOSED AND USABLEDING DOORS ARE IN THE FULLY OPEN POSITION, OPERATING HARDWARE SHALL BE EXPOSED AND USABLEDING DOORS ARE IN THE FULLY OPEN POSITION, OPERATING HARDWARE SHALL BE EXPOSED AND USABLEDING DOORS ARE IN THE FULLY OPEN POSITION, OPERATING HARDWARE SHALL BE EXPOSED AND USABLEDING DOORS ARE IN THE FULLY OPEN POSITION, OPERATING HARDWARE SHALL BE EXPOSED AND USABLEDING DOORS ARE IN THE FULLY OPEN POSITION, OPERATING HARDWARE SHALL BE EXPOSED AND USABLEDING DOORS ARE IN THE FULLY OPEN POSITION, OPERATING HARDWARE SHALL BE EXPOSED AND USABLEDING DOORS ARE IN THE FULLY OPEN POSITION, OPERATING HARDWARE SHALL BE EXPOSED AND USABLEDING DOORS ARE IN THE FULLY OPEN POSITION, OPERATING HARDWARE SHALL BE EXPOSED AND USABLEDING DOORS ARE IN THE FULLY OPEN POSITION, OPERATING HARDWARE SHALL BE EXPOSED AND USABLEDING DOORS ARE IN THE FULLY OPEN POSITION, OPERATING HARDWARE SHALL BE EXPOSED AND USABLEDING DOORS DOOR SURFACES WITHIN 10" OF THE FLOOR MEASURED VERTICALLY SHALL BE A SMOOTH SURFACE ON THE PUSH SIDE EXTENDING THE FULL WIDTH OF THE DOOR EXCEPT SLIDING DOORS.

AT LEAST ONE TOILET AND BATHING FACILITY MUST COMPLY HAVING AT LEAST ONE LAVATORY, WATER CLOSET, AND EITHER A BATHTUB OR SHOWER

DOORS SHALL NOT SWING INTO THE CLEAR FLOOR SPACE OR CLEARANCE FOR ANY FIXTURE EXCEPT WHEN A CLEAR FLOOR SPACE OF 30" BY 48" IS PROVIDED WITHIN THE ROOM BEYOND THE ARC OF THE DOOR SWING.

LAVATORY HEIGHT SHALL BE 34" MAX A.F.F. LAVATORY CLEAR FLOOR SPACE SHALL BE 30"x48" AND POSITIONED FOR FORWARD APPROACH WITH KNEE AND TOE CLEARANCES PER A117.1 SECTION 606 LAVATORY CABINETRY SHALL BE PERMITTED UNDER THE LAVATORY PROVIDED THE CABINETRY CAN BE REMOVED WITHOUT REMOVAL OR REPLACEMENT OF THE LAVATORY, THE FLOOR FINISH EXTENDS WALD STREET PROVIDED THE CABINETRY

THE WATER CLOSET SHALL BE POSITIONED WITH A WALL TO THE REAR AND TO ONE SIDE. THE CENTERLINE OF THE WATER CLOSET SHALL BE 16" MIN. AND 18" MAX. FROM THE SIDE WALL. WATER CLOSET FLUSH CONTROLS SHALL BE LOCATED ON THE OPEN SIDE OF THE WATER CLOSET

WATER CLOSET SEAT HEIGHT SHALL BE A MIN. 15" AND A MAX 19" A.F.F., MEASURED TO THE TOP OF THE SEAT

REINFORCEMENT SHALL BE PROVIDED IN WALLS TO PERMIT THE FUTURE INSTALLATION OF GRAB BARS.

MIRRORS SHALL HAVE THE BOTTOM EDGE OF THE REFLECTING SURFACE 40" MAXIMUM AFF. BATHTUB HAND SHOWERS SHALL BE PROVIDED PER A117.1 SECTION 607.6.

KITCHEN CLEARANCES SHALL COMPLY WITH A117.1 SECTION 1003.12.1. CLEARANCE BETWEEN ALL OPPOSING BASE CABINETS, COUNTERTOPS, APPLIANCES, OR WALLS WITHIN KITCHEN WORKSARPEN SHAULENESSON 1003.12.1. CLEARANCE SHALL BE 60" MIN. A CLEAR FLOOR SPACE OF 30"x48" AT EACH APPLIANCE. HOWEVER, A REFRIGEPATOR MUST PROVIDE A PARALLEL APPROACH. PROVIDE A PARALLEL APPROACH AT REFRIGERATORS AND RANGES. ALL OTHER APPLIANCES MAY BE PARALLEL OR

CLEAR FLOOR SPACE SHALL BE POSITIONED ADJACENT TO THE DISHWASHER DOOR. THE DISHWASHER DOOR IN THE OPEN POSITION SHALL NOT OBSTRUCT THE CLEAR FLOOR SPACE FOR THE TOOM WASHER, WITHOUT TO THE DISHWASHER DOOR. THE DISHWASHER DOOR IN THE OPEN POSITION, SHALL

COMBINATION REFRIGERATORS AND FREEZERS SHALL HAVE AT LEAST 50% OF THE FREEZER SPACE 54" MAX. AFF.

ALL CABINETS SHALL HAVE A CLEAR FLOOR SPACE POSITIONED FOR PARALLEL OR FORWARD APPROACH. THE SHELVES NEED NOT BE LOCATED WITHIN REACH RANGES OR THE HANDLES MEET OPERABLE PARTS PROVISIONS.

A WORK SURFACE 30" MIN. IN LENGTH, WITH A CLEAR FLOOR SPACE OF 30"x48" AND POSITIONED FOR FORWARD APPROACH, KNEE AND TOE CLEARANCES PER A117.1 SECTION 306 SHALL BE PROVIDED. CLEAR FLOOR SPACE SHALL BE CENTERED ON THE WORK SURFACE. WORK SURFACE HEIGHT SHALL BE 34" MAX. UNLESS ADJUSTABLE.

WORK SURFACE CABINETRY SHALL BE PERMITTED IF THE CABINETRY IS EASILY REMOVABLE WITHOUT REMOVING WORK SURFACE, THE FINISH FLOORING EXTENDS UNDER, AND THE WALLS BEHIND AND SURROUNDING ARE FINISHED. A SINK COMPLYING WITH A CLEAR FLOOR SPACE OF 30"x48" AND POSITIONED FOR FORWARD APPROACH, KNEE AND TOE CLEARANCES PER A117.1 SECTION 306 SHALL BE PROVIDED AS INMEAS LURE OF SOUNTER SURFACE WHICHEVER IS

SINK CABINETRY SHALL BE PERMITTED IF THE CABINETRY IS EASILY REMOVABLE WITHOUT REMOVING THE SINK, THE FINISH FLOORING EXTENDS UNDER, AND THE WALLS BEHIND AND SURROUNDING ARE FINISHED.

MICROWAVE / HOOD COMBOS ARE NOT COMPLIANT DUE TO REACH RANGES. PROVIDE A SEPARATE SWITCHED HOOD VENT AND COUNTERTOP MICROWAVE. SWITCH MUST COMPLY WITH OUTLET REQUIREMENTS AND HAVE A 30" BY 48" CLEAR FLOOR SPACE CENTERED ON THE SWITCH.

THE LOCATION OF COOKTOP AND OVEN CONTROLS SHALL NOT REQUIRE REACHING ACROSS BURNERS.

A CLEAR FLOOR SPACE (30"x48") COMPLYING WITH A117.1 SECTION 305 POSITIONED FOR PARALLEL APPROACH SHALL BE PROVIDED. FOR TOP LOADING MACHINES, THE CLEAR FLOOR SPACE SHALL BE CENTERED ON THE APPLIANCE. FOR FRONT LOADING MACHINES, THE CENTERLINE OF THE CLEAR FLOOR SPACE SHALL BE OFFSET 24" MAX.FROM THE CENTERLINE OF THE DOOR OPENING.

TOP LOADING LAUNDRY MACHINES SHALL HAVE THE DOOR TO THE LAUNDRY COMPARTMENT 36" MAX. ABOVE THE FLOOR. FRONT LOADING MACHINES SHALL HAVE THE BOOTING MORTIMENT 15" MIN. AND 34" MAX. ABOVE THE FLOOR.

GENERAL ACCESSIBILITY NOTES

INSTALL CONCEALED 2X8 REINFORCEMENT AT LOCATIONS SHOWN AND AS REQUIRED TO FACILITATE THE INSTALLATION OF THE GRAB BARS & SEATS SHOWN. REINFORCEMENT SHALL BE CAPABLE OF SUPPORTING A VERTICAL OR HORIZONTAL FORCE OF 250 LBS APPLIED AT ANY POINT ALONG THE GRAB BAR, SEAT OR MOUNTED DEVICE.

INFORMATION SHOWN IS TO ILLUSTRATE GENERAL ACCESSIBILITY REQUIREMENTS. SEE SPECIFIC PLANS & INTERIOR ELEVATIONS FOR REQUIRED DIMENSIONS, STYLES, AND MATERIALS

** CABINET CONSTRUCTION SHALL FACILITATE REMOVAL OF BASE CABINET W/O REMOVING OR DAMAGING THE COUNTER, ADJACENT CABINETS ** SEE PLANS FOR ACTUAL CABINET — 36" MIN. IF PART OF T-SHAPED TURNING SPACE PER


TYPE "A" DWELLING UNIT AT KITCHEN

△REVISIONS


03.15.2023 TSC/SIW 4/11/2023 **CITY COMMENTS** SHEET NAME
TYPE "A" UNIT
ACCESSIBILITY INFO

LEE'S


TYPE "B" DWELLING UNIT MOUNTING HEIGHTS

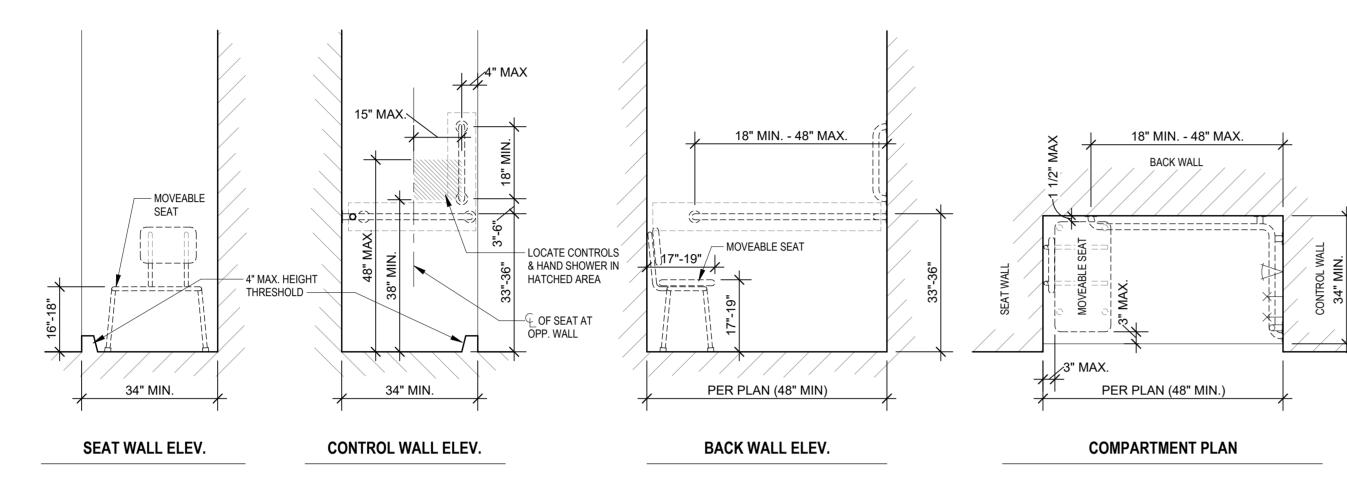

TYPE "B" DWELLING UNIT GRAB BAR REINFORCEMENT FOR SHOWERS

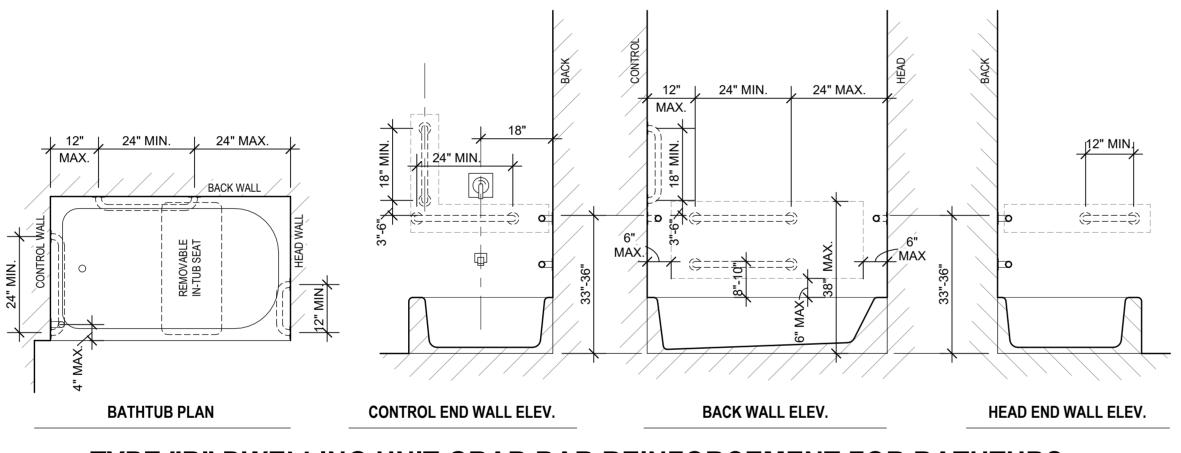

TYPE "B" DWELLING UNIT GRAB BAR REINFORCEMENT FOR BATHTUBS

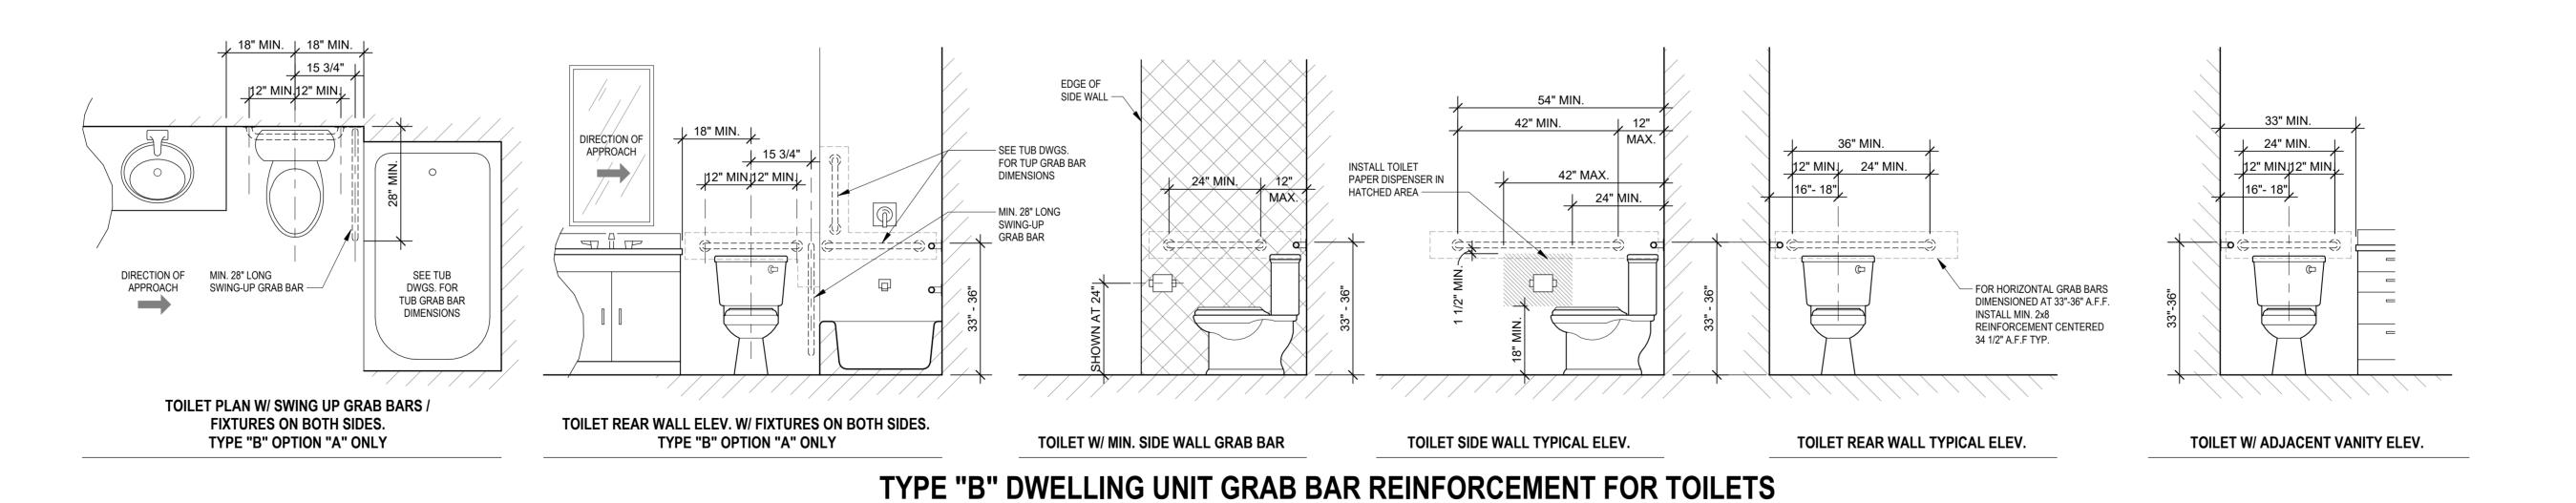

TYPE "B" DWELLING UNITS - ACCESSIBILITY NOTES

ALL UNITS NOT DESIGNATED AS "TYPE A" OR "EXEMPT" ARE CONSIDERED "TYPE B" AND SHALL MEET ALL APPLICABLE REQUIREMENTS OF A117.1-2009 SECTION 1004 AND THE FAIR HOUSING ACT.

ACCESSIBLE ROUTE:

1. THE ACCESSIBLE PRIMARY ENTRANCE SHALL BE ON AN ACCESSIBLE ROUTE FROM PUBLIC AND COMMON AREAS.

2. AT LEAST ONE ACCESSIBLE ROUTE SHALL CONNECT ALL SPACES & ELEMENTS WHICH ARE PART OF THE DWELLING UNIT. AN ACCESSIBLE ROUTE SHALL HAVE A CLEAR WIDTH OF 36" MIN.

ACCESSIBLE ROUTES SHALL CONSIST OF ONE OR MORE OF THE FOLLOWING ELEMENTS: WALKING SURFACES WITH A SLOPE NOT STEEPER THAN 1:20, DOORS AND DOORWAYS, RAMPS, ELEVATORS, AND WHEELCHAIR (PLATIFICIAN CONTINUES WARTERIES EXTERIOR ARE IMPERVIOUS, THE FINISHED IMPERVIOUS SURFACE SHALL BE 4" MAX. BELOW THE FLOOR LEVEL OF THE ADJACENT INTERIOR SPACES OF THE UNIT.

THE PRIMARY ENTRANCE DOOR TO THE DWELLING UNIT SHALL PROVIDE A CLEAR WIDTH OF NOT LESS THAN 32". CLEAR OPENINGS OF DOORWAYS WITH SWINGING DOORS SHALL BE MEASURED BETWEEN THE FACE OF THE DOPENANDOHORNESP, WITH THE

2. ALL DOORWAYS INTENDED FOR USER PASSAGE WITHIN THE DWELLING UNIT SHALL HAVE A CLEAR OPENING OF 31 3/4" MIN., MEASURED BETWEEN THE FACE OF THE DOOR AND STOP, WITH THE DOOR OPEN 90 DEGREES.

3. THRESHOLDS AT ALL EXTERIOR DOORS SHALL NOT EXCEED 1/2", EXCEPT SLIDING DOORS SHALL NOT EXCEED 3/4". CHANGES IN LEVEL OF 1/4" HIGH MAX. SHALL BE PERMITTED TO BE VERTICAL. CHANGES IN LEVEL BETWEEN 1/4" HIGH MIN. AND 1/2"

4 WHERE AN INACTIVE LEAF OF DOUBLE LEAF DOORWAYS WITH OPERARI E PARTS MORE THAN 48" OR LESS THAN 15" AROVE THE FLOOR IS PROVIDED. THE ACTIVE LEAF SHALL PROVIDE A CLEAR OPENING OF 31 3/4" MIN

WHERE AN INACTIVE LEAF OF DOUBLE LEAF DOORWAYS WITH OPERABLE PARTS MORE THAN 48" OR LESS THAN 15" ABOVE THE FLOOR IS PROVIDED, THE ACTIVE LEAF SHALL PROVIDE A CLEAR OPENING OF 31 3/4" MIN.

THE MAXIMUM EFFORT TO OPERATE DOORS SHALL NOT EXCEED 8 1/2 LBS. FOR EXTERIOR DOORS AND 5 LBS. FOR INTERIOR DOORS.

HANDLES, PULLS, LATCHES, LOCKS, AND OTHER OPERABLE PARTS ON THE PRIMARY ENTRY DOOR SHALL HAVE A SHAPE THAT IS EASY TO GRASP WITH ONE HAND AND DOES NOT REQUIRE TIGHT GRASPING, PINCHING OR TWISTING OF THE WRIST.

TOILET AND BATHING FACILITES:

1. DOORS SHALL NOT SWING INTO THE CLEAR FLOOR SPACE OR CLEARANCE FOR ANY FIXTURE EXCEPT WHEN A CLEAR FLOOR SPACE OF 30" BY 48" IS PROVIDED BEYOND THEARC OF THE DOOR SWING.

2. REINFORCEMENT SHALL BE PROVIDED FOR FUTURE INSTALLATION OF GRAB BARS AND SHOWER SEATS AT WATER CLOSETS, BATHTUBS, AND SHOWER COMPARTMENTS. REINFORCEMENT IS NOT REQUIRED IN A ROOM COMPARTMENT OF THE ACCESSIBLE LEVEL OF THE DWELLING UNIT.

EITHER ALL TOILET AND BATHING AREAS SHALL COMPLY WITH "OPTION A" REQUIREMENTS, OR ONE TOILET AND BATHING AREA SHALL COMPLY WITH "OPTION B" REQUIREMENTS.

OPTION A:

1. ALL FIXTURES WITHIN THE DWELLING UNIT SHALL COMPLY.

2. A CLEAR FLOOR SPACE POSITIONED FOR A PARALLEL APPROACH SHALL BE PROVIDED AND CENTERED AT THE LAVATORY.

3. THE WATER CLOSET SHALL BE POSITIONED TO ALLOW FOR FUTURE INSTALLATION OF A GRAB BAR ON THE SIDE WITH 18" CLEARANCE.

4. IF A SHOWER COMPARTMENT IS THE ONLY BATHING FACILITY THE SHOWER COMPARTMENT SHALL HAVE MINIMUM DIMENSIONS OF 36" MIN. BY 36" MIN. REINFORCING FOR SHOWER SEAT IS NOT REQUIRED IN SHOWER COMPARTMENTS LARGER THAN 36" BY 36". CLEARANCE 30" MIN, MEASURED FROM THE FACE OF THE SHOWER COMPARTMENT, BY 48" MIN., MEASURED FROM THE SHOWER HEAD WALL SHALL BE PROVIDED.

OPTION B:

ONE OF EACH TYPE OF FIXTURE PROVIDED AND SHALL BE IN A SINGLE TOILET/BATHING AREA, SUCH THAT TRAVEL BETWEEN FIXTURES DOES NOT REQUIRE TRAVEL THROUGH OTHER PARTS OF THE UNIT.

THE FRONT OF THE LAVATORY SHALL BE 34" MAX. ABOVE THE FLOOR, MEASURED TO THE HIGHER OF THE FIXTURE RIM OR COUNTER SURFACE.

THE WATER CLOSET SHALL BE POSITIONED TO ALLOW FOR FUTURE INSTALLATION OF A GRAB BAR ON THE SIDE WITH 18" CLEARANCE.

A CLEARANCE 48" MIN IN LENGTH MEASURED PERPENDICULAR FROM THE CONTROL END OF THE BATHTUB, AND 30" MIN. IN WIDTH SHALL BE PROVIDED IN FRONT OF BATHTUBS.

5. IF A SHOWER COMPARTMENT IS THE ONLY BATHING FACILITY THE SHOWER COMPARTMENT SHALL HAVE MINIMUM DIMENSIONS OF 36" MIN. BY 36" MIN. REINFORCING FOR SHOWER SEAT IS NOT REQUIRED IN SHOWER COMPARTMENT, BY 48" MIN., MEASURED FROM THE SHOWER HEAD WALL SHALL BE PROVIDED.

1. CLEARANCES SHALL COMPLY WITH A117.11004.12.1. CLEARANCE BETWEEN ALL OPPOSING BASE CABINETS, COUNTER TOPS, APPLIANCES, OR WALLS WITHIN KITCHEN WORK AREAS SHALL BE 40" MINIMUM. IN U-SHAPED KITCHENS THIS CLEARANCE SHALL BE 60" MINIMUM.

2. A CLEAR FLOOR SPACE OF 30" BY 48" POSITIONED FOR PARALLEL OR FORWARD APPROACH SHALL BE PROVIDED AT EACH KITCHEN APPLIANCE AND KITCHEN SINK.

3. A CLEAR FLOOR SPACE, POSITIONED FOR FORWARD OR PARALLEL APPROACH, SHALL BE POSITIONED BEYOND THE SWING OF THE DISHWASHER DOOR.

LAUNDRY EQUIPMENT:

1. A CLEAR FLOOR SPACE OF 30"x48" SHALL BE PROVIDED. A PARALLEL APPROACH SHALL BE PROVIDED FOR A TOP LOADING MACHINE. A FORWARD OR PARALLEL APPROACH SHALL BE PROVIDED FOR A FRONT LOADING MACHINE.

OPERABLE PART

LIGHTING CONTROLS, ELECTRICAL PANELBOARDS, ELECTRICAL SWITCHES AND RECEPTACLE OUTLETS, ENVIRONMENTAL CONTROLS, AND USER CONTROLS FOR SECURITY OR INTERCOM SYSTEMS SHALL COMPLY WITH CLEAR FLOOR SPACE AND HEIGHT REQUIRMENTS EXCEPT RECEPTACLES SERVING A DEDICATED USE, FLOOR ELECTRICAL RECEPTACLES, HVAC DIFFUSERS, CONTROLS OR SWITCHES MOUNTED ON APPLIANCES, CONTROLS MOUNTED ON CEILING FANS, AND RESET BUTTONS AND SHUT-OFFS SERVING APPLIANCES, PIPING AND PLUMBING FIXTURES WHERE TWO OR MORE RECEPTACLE OUTLETS ARE PROVIDED IN A KITCHEN ABOVE A LENGTH OF COUNTER TOP THAT IS UNINTERRUPTED BY A SINK OR APPLIANCE, ONE RECEPTACLE OUTLED WITH AND RECEPTACLE OUTLETS ARE PERMITTED TO BE LOCATED OVER CABINETS WITH COUNTER TOPS 36" MAX IN HEIGHT AND 25 1/2" MAX IN DEPTH

GENERAL ACCESSIBILITY NOTES

1. INSTALL CONCEALED 2X8 REINFORCEMENT AT LOCATIONS SHOWN AND AS REQUIRED TO FACILITATE THE INSTALLATION OF THE GRAB BARS & SEATS SHOWN. REINFORCEMENT SHALL BE CAPABLE OF SUPPORTING A VERTICAL OR HORIZONTAL FORCE OF 250 LBS APPLIED AT ANY POINT ALONG THE GRAB BAR, SEAT OR MOUNTED DEVICE.

2. INFORMATION SHOWN IS TO ILLUSTRATE GENERAL ACCESSIBILITY REQUIREMENTS. SEE SPECIFIC PLANS & INTERIOR ELEVATIONS FOR REQUIRED DIMENSIONS, STYLES, AND MATERIALS.

A NEW RESIDENTIAL COMMUNITY AT:

Brawing Beleas

On 15:2023 - Permit Submit


△ REVISIONS

JOB NO. DATE
705921 03.15.2023
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TSC/SIW


4/11/2023
CITY COMMENTS
SHEET NAME
TYPE "B" UNIT
ACCESSIBILITY INFO
SHEET NO.

800 & 810 NW WARD RD. | LEE'S SUMMIT, MO


ELEVATOR COMPONENTS

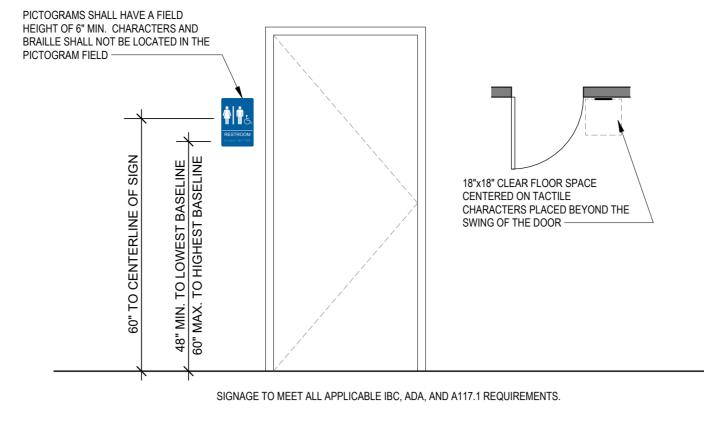


GENERAL SIGNAGE

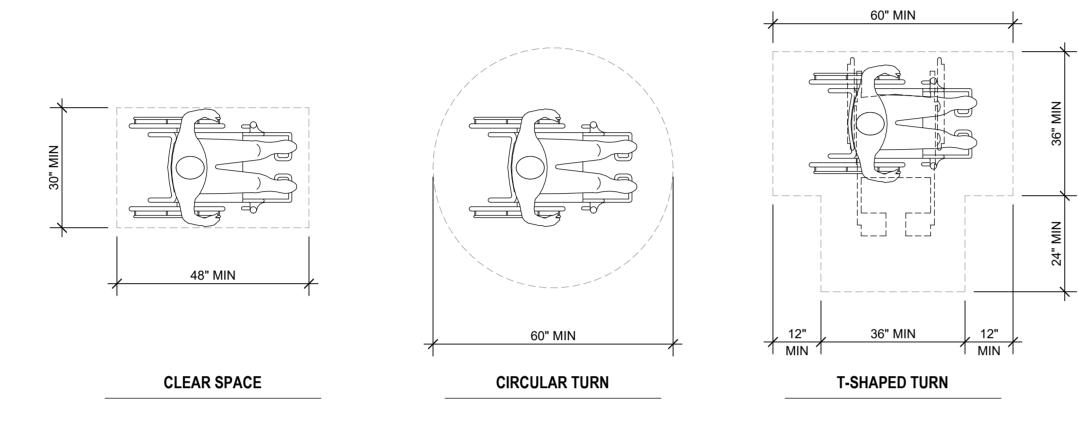


TURNING AND CLEAR FLOOR SPACES

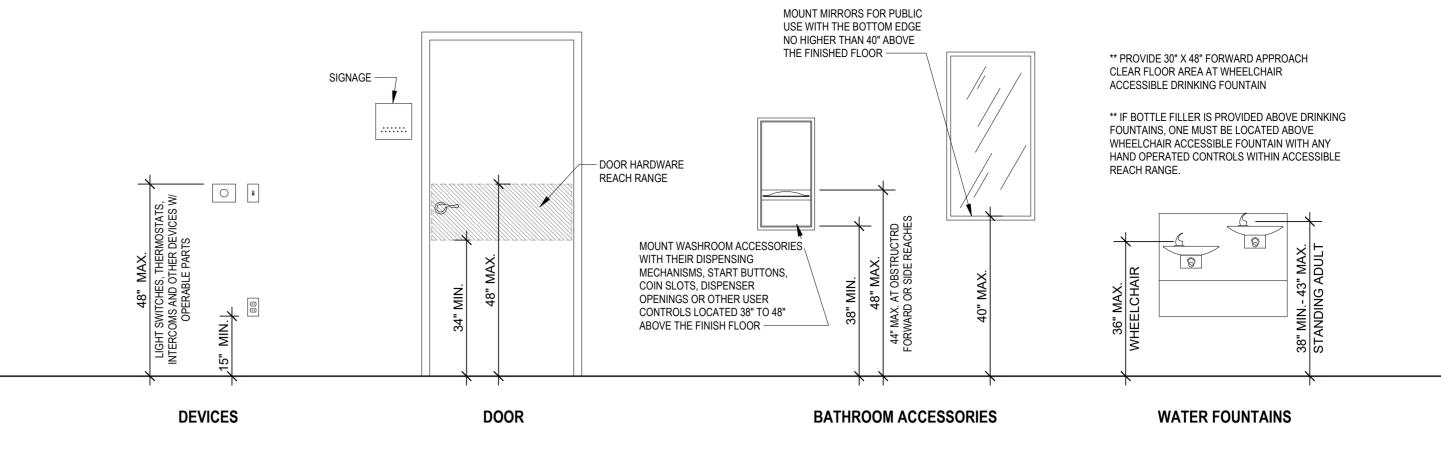

TYPICAL ACCESSIBLE MOUNTING HEIGHTS FOR UNOBSTRUCTED FORWARD REACH

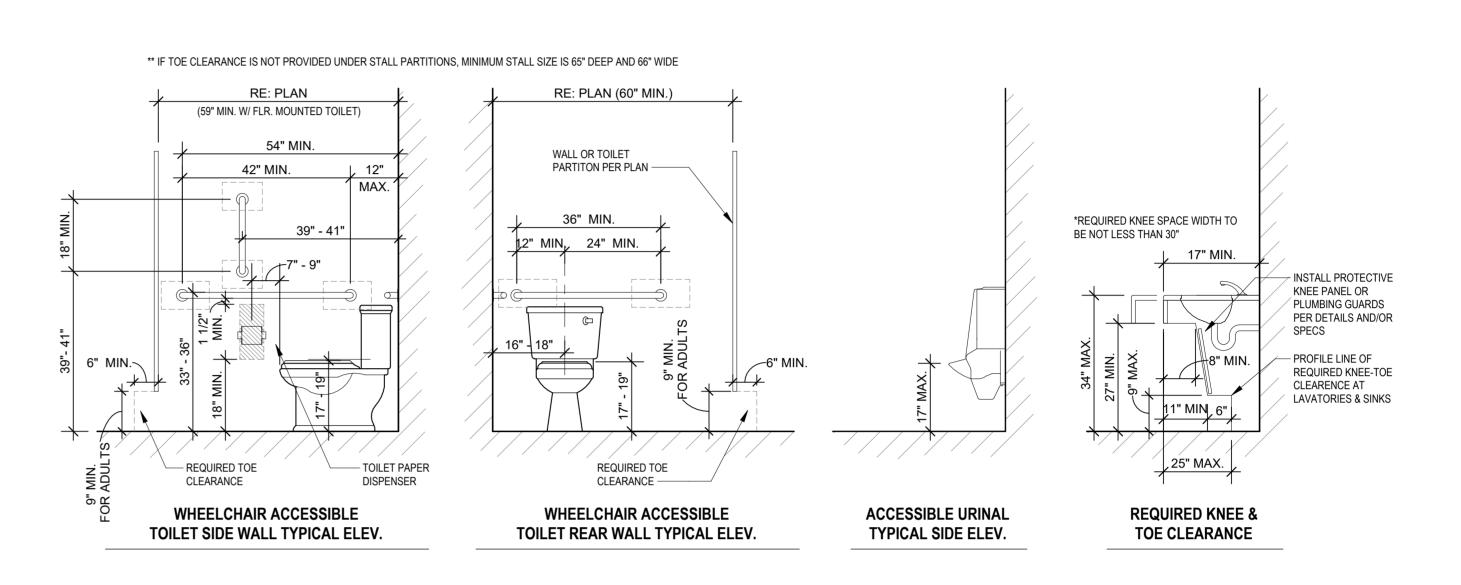

GRAB BARS AND CLEARANCES FOR PUBLIC RESTROOMS

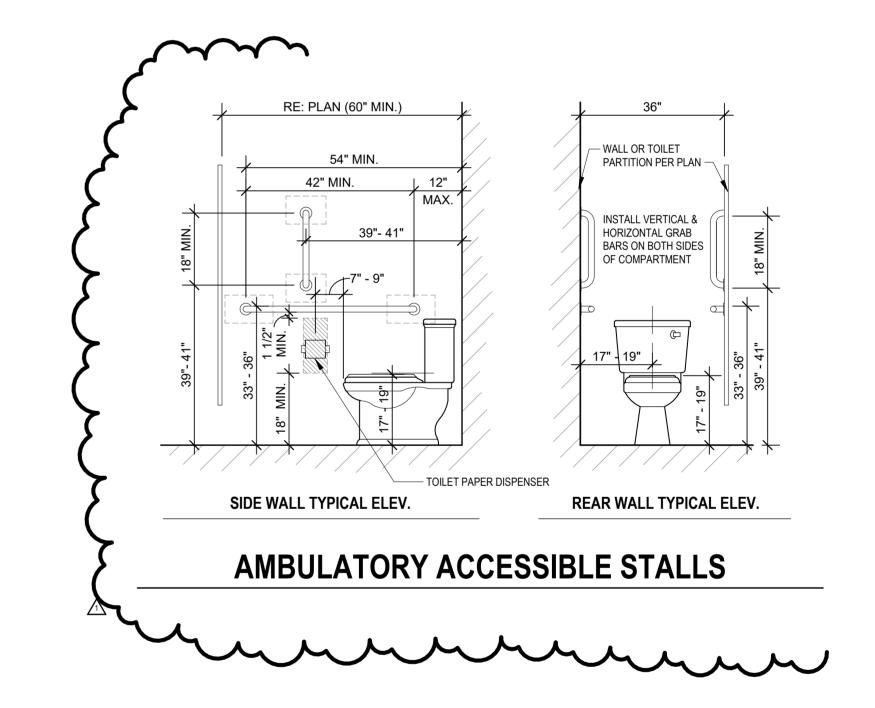

PRAWING RELEASE LOG
3.15.2023 - PERMIT SUBMITTAL

AREVISIONS

1 23 0411 CITY COMMENTS 1


JOB NO. 705921 03.15.2023
DRAWN BY TSC/SIW

4/11/2023
CITY COMMENTS
SHEET NAME
COMMON AREA
ACCESSIBILITY INFO
SHEET NO.

A 0.42


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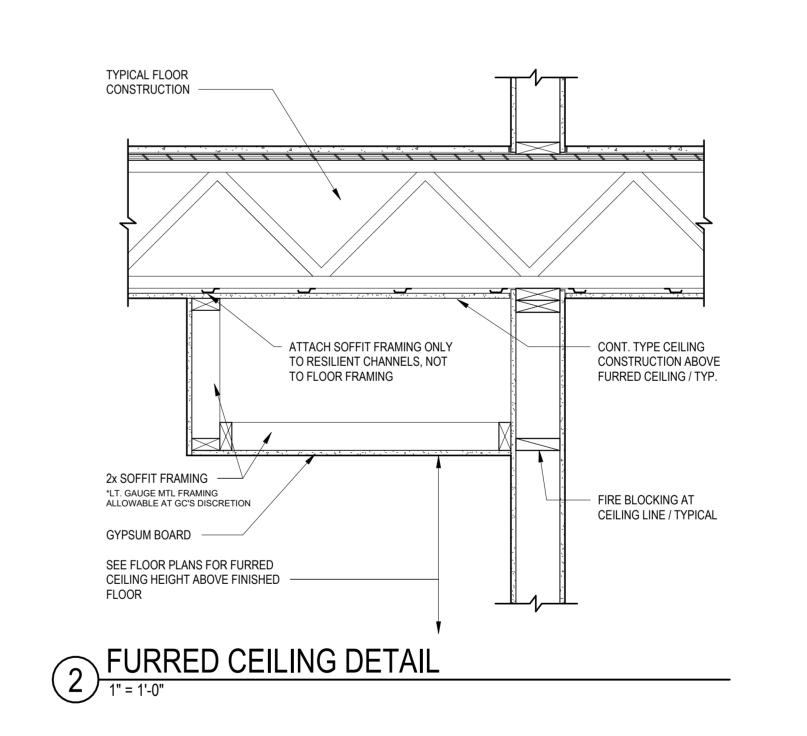
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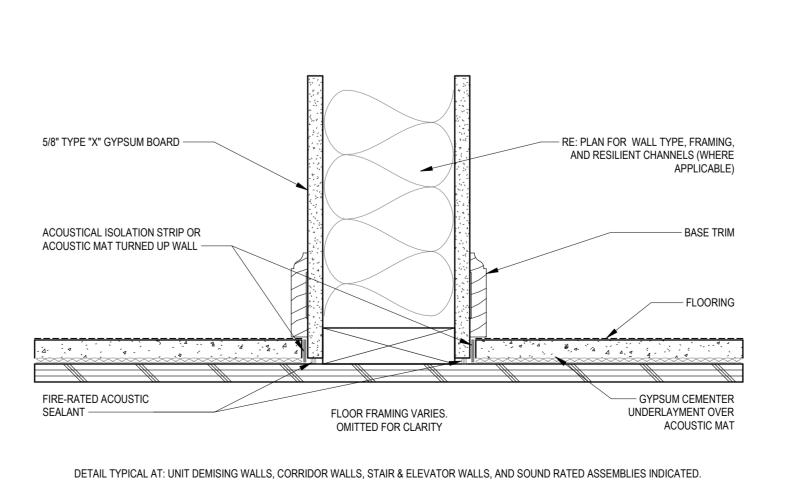


UNIT SHELVES MOUNTING HEIGHTS

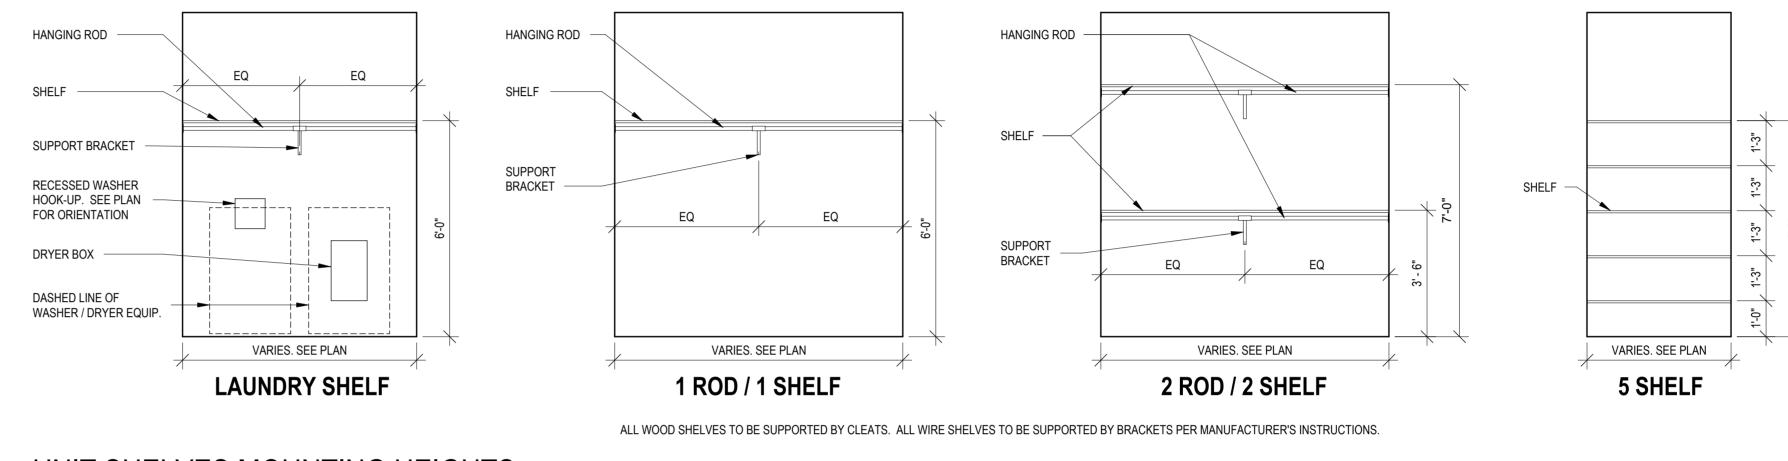
3/8" = 1'-0"





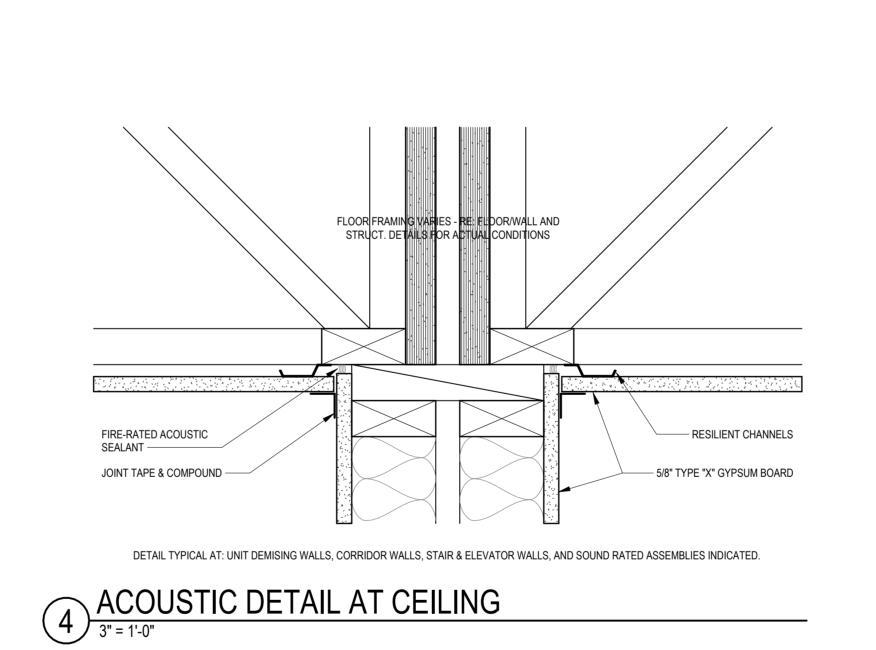

3 ACOUSTIC DETAIL AT FLOOR
3" = 1'-0"

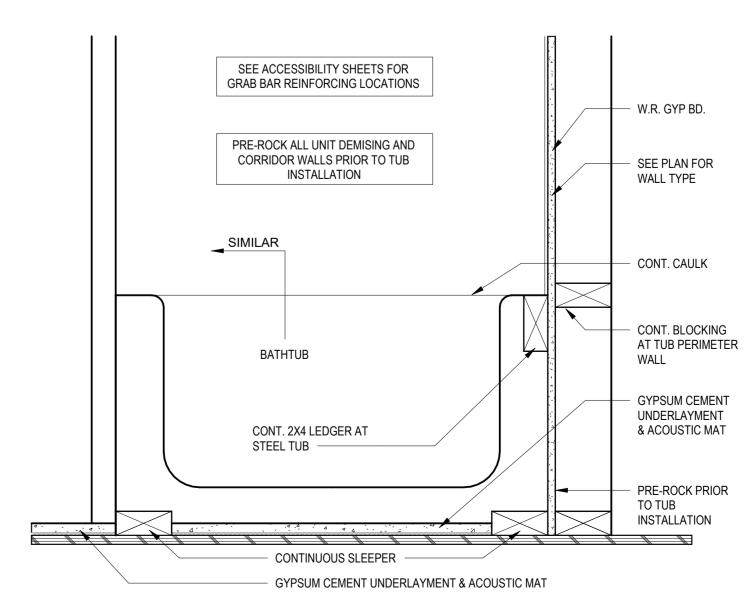

INTERIOR DETAIL - SECTION AT BATHTUB

1 1/2" = 1'-0"

4/11/2023 **CITY COMMENTS** SHEET NAME TYPICAL UNIT INFO


03.15.2023

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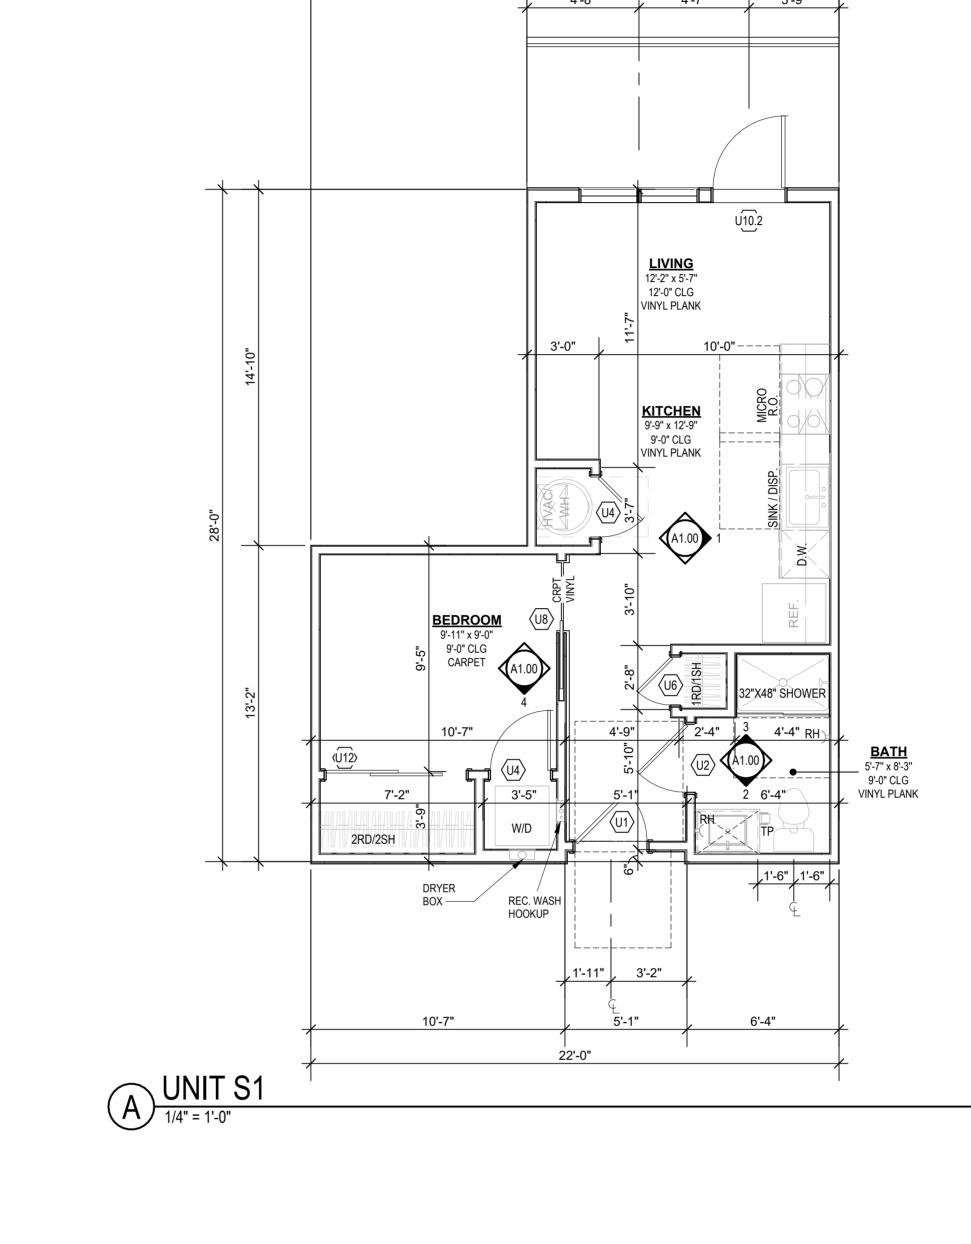
Јов No. **705921**

DRAWN BY


TSC/SIW

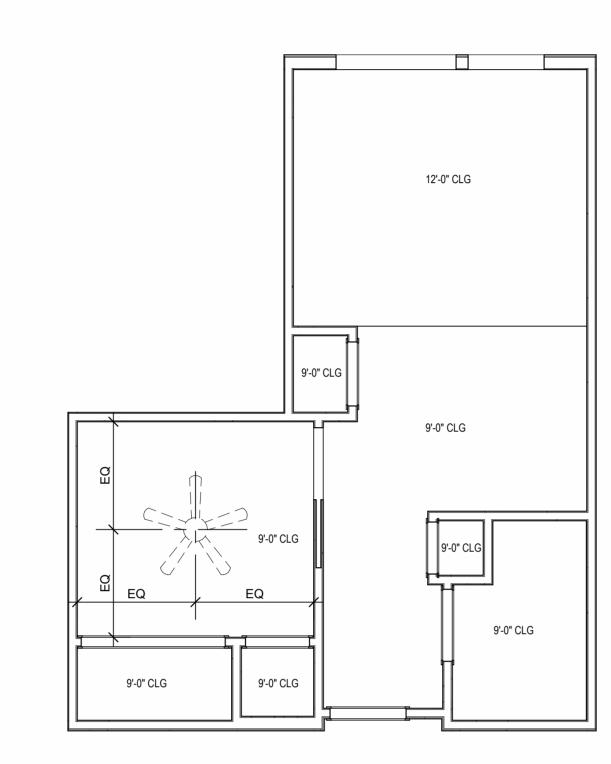

B UNIT S1 - 4TH FLOOR RCP



13'-0"

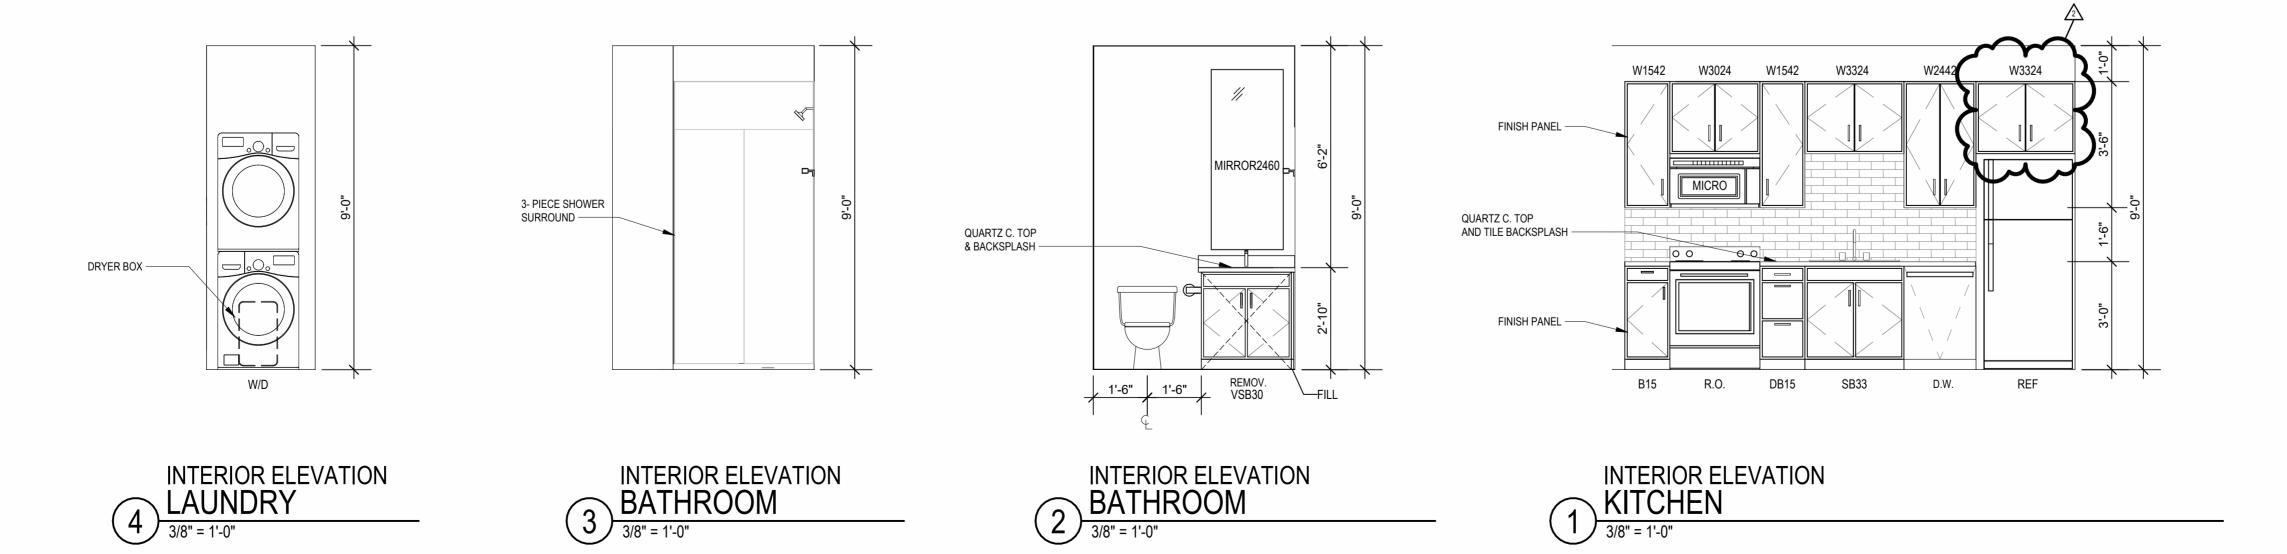

UNIT PLAN GENERAL NOTES:

REFER TO ASSEMBLY SHEET SERIES A0.30 FOR ASSEMBLY DIMENSION ORIGINS AND THICKNESS. REFER TO SHEETS A0.40, A0.41 AND A0.42 FOR MOUNTING HEIGHTS AND ACCESSIBILITY REQUIREMENTS. REFER TO BUILDING PLANS AND EXTERIOR ELEVATIONS FOR ADDITIONAL EXTERIOR ARCHITECTURAL ELEMENTS INCLUDING BALCONY LOCATIONS

AND CONFIGURATIONS, COLUMNS, WINDOWS/TRANSOMS, AND PATIO DOOR USE TEAR-AWAY BEAD, BACKER ROD, AND CAULK AT ALL DRYWALL RETURNS AT FENESTRATION CONDITIONS. ALL DIMENSIONS AND NOTES STATING "CLEAR", "MIN" OR "MAX" ARE FROM FINISH FACE TO FINISH FACE. PROVIDE BLOCKING FOR ALL TV LOCATIONS, WALL HUNG CABINETS, SHELVING, GRAB BARS, AND OTHER WALL MOUNTED ITEMS.

LANDINGS AND FLOORS ON EITHER SIDE OF DOORWAYS SHALL NOT BE MORE THAN 1/2" LOWER THAN DOORWAY THRESHOLD. PROVIDE SAFETY GLAZING AT HAZARDOUS LOCATIONS PER IBC SECTION 2406. SEE PLANS FOR LOCATIONS. PROVIDE APPROVED SMOKE DETECTORS AND REQUIRED EMERGENCY FIXTURES WIRED INTO THE BUILDING'S PRIMARY POWER SYSTEM PER IBC SECTION 907.2.10. SEE MECHANICAL PLANS FOR LOCATIONS.

ALL EXPOSED EDGES OF FINISHES TO BE DRESSED WITH APPROPRIATE FINISH STRIP. UNIT DEMISING WALLS AND FLOOR/CEILING ASSEMBLIES SEPARATING DWELLING UNITS SHALL MEET OR EXCEED 50 S.T.C. TEST PER IBC SECTION

WHEN TUBS AND SHOWERS ARE LOCATED ADJACENT TO A FIRE RATED

IN SIDE-BY-SIDE LAUNDRY CONFIGURATION, WASHER ALWAYS ON THE LEFT, DRYER ALWAYS ON THE RIGHT. CONTRACTOR TO FIELD COORDINATE. ALL WINDOWS TO RECEIVE 5/4X STOOL WITH 1X3 APRON & DRYWALL

ASSEMBLY, EXTEND GYPSUM BOARD BEHIND AND PROVIDE INSULATION. VERIFY ALL TUB AND SHOWER WALL LENGTHS AND DIMENSION WITH ACTUAL TUB OR SHOWER PROVIDED. CONTRACTOR TO COORDINATE FRAMING WITH TUB MANUFACTURER AND TUB DETAILS. MATCH SHOE FINISH TO CABINET FINISH WHERE ADJACENT TO BASE AVOID WATER LINES IN EXTERIOR WALLS. WHERE NOT POSSIBLE, INSTALL FOAM INSULATION BETWEEN WATER LINES & SHEATHING.

RETURNS ON JAMBS & HEAD. DEVICE TRIMS & DEVICE FACES TO CLOSELY MATCH THE COLOR OF THE SURFACE THEY ARE APPLIED TO. ALL PANTRY CABINETS & CABINETS ABOVE REFRIGERATOR SHALL BE 12" DEEP AND RECEIVE END PANELS WHERE EXPOSED. REFER TO FLOOR PLANS AND ROOF PLANS FOR ADDITIONAL RAISED PLATE LINES AND VAULTED CEILING INFORMATION.

ALL BATHROOM HARDWARE FINISHES TO MATCH, INCLUDING SHOWER DOOR FRAMES, UNLESS SPECIFICALLY NOTED BY INTERIOR DESIGNER. G.C. SHALL SUBMIT AVAILABLE HARDWARE FINISHES TO ARCHITECT WHERE AN EXACT MATCH CANNOT BE MADE. ALL PLUMBING PENETRATIONS TO RECEIVE ESCUTCHEON TRIM RINGS TO MATCH ADJACENT FIXTURE FINISH.

FIRE EXTINGUISHER (RE: SPECIFICATION) SHALL BE PROVIDED AND LOCATED IN SINK BASE CABINET UNDER KITCHEN SINK, U.N.O.



DRAWING RELEASE LOG

• 03.15.2023 - PERMIT SUBMITTAL

<u>REVISIONS:</u>
2 23 0428 ADD 1/CC 2

MORE THAN 1/2" LOWER THAN DOORWAY THRESHOLD. PROVIDE SAFETY GLAZING AT HAZARDOUS LOCATIONS PER IBC SECTION 2406. SEE PLANS FOR LOCATIONS. PROVIDE APPROVED SMOKE DETECTORS AND REQUIRED EMERGENCY FIXTURES WIRED INTO THE BUILDING'S PRIMARY POWER SYSTEM PER IBC SECTION 907.2.10. SEE MECHANICAL PLANS FOR LOCATIONS. ALL EXPOSED EDGES OF FINISHES TO BE DRESSED WITH APPROPRIATE UNIT DEMISING WALLS AND FLOOR/CEILING ASSEMBLIES SEPARATING DWELLING UNITS SHALL MEET OR EXCEED 50 S.T.C. TEST PER IBC SECTION WHEN TUBS AND SHOWERS ARE LOCATED ADJACENT TO A FIRE RATED ASSEMBLY, EXTEND GYPSUM BOARD BEHIND AND PROVIDE INSULATION. VERIFY ALL TUB AND SHOWER WALL LENGTHS AND DIMENSION WITH ACTUAL TUB OR SHOWER PROVIDED. CONTRACTOR TO COORDINATE FRAMING WITH TUB MANUFACTURER AND TUB DETAILS. MATCH SHOE FINISH TO CABINET FINISH WHERE ADJACENT TO BASE AVOID WATER LINES IN EXTERIOR WALLS. WHERE NOT POSSIBLE, INSTALL FOAM INSULATION BETWEEN WATER LINES & SHEATHING. IN SIDE-BY-SIDE LAUNDRY CONFIGURATION, WASHER ALWAYS ON THE LEFT, DRYER ALWAYS ON THE RIGHT. CONTRACTOR TO FIELD COORDINATE. ALL WINDOWS TO RECEIVE 5/4X STOOL WITH 1X3 APRON & DRYWALL RETURNS ON JAMBS & HEAD. DEVICE TRIMS & DEVICE FACES TO CLOSELY MATCH THE COLOR OF THE SURFACE THEY ARE APPLIED TO. ALL PANTRY CABINETS & CABINETS ABOVE REFRIGERATOR SHALL BE 12" DEEP AND RECEIVE END PANELS WHERE EXPOSED. REFER TO FLOOR PLANS AND ROOF PLANS FOR ADDITIONAL RAISED PLATE LINES AND VAULTED CEILING INFORMATION. ALL BATHROOM HARDWARE FINISHES TO MATCH, INCLUDING SHOWER DOOR FRAMES, UNLESS SPECIFICALLY NOTED BY INTERIOR DESIGNER. G.C. SHALL SUBMIT AVAILABLE HARDWARE FINISHES TO ARCHITECT WHERE AN EXACT MATCH CANNOT BE MADE. ALL PLUMBING PENETRATIONS TO RECEIVE ESCUTCHEON TRIM RINGS TO MATCH ADJACENT FIXTURE FINISH.

UNIT PLAN GENERAL NOTES:

INFORMATION.

ORIGINS AND THICKNESS.

ACCESSIBILITY REQUIREMENTS.

FINISH FACE TO FINISH FACE.

RETURNS AT FENESTRATION CONDITIONS.

REFER TO ASSEMBLY SHEET SERIES A0.30 FOR ASSEMBLY DIMENSION

REFER TO SHEETS A0.40, A0.41 AND A0.42 FOR MOUNTING HEIGHTS AND

REFER TO BUILDING PLANS AND EXTERIOR ELEVATIONS FOR ADDITIONAL EXTERIOR ARCHITECTURAL ELEMENTS INCLUDING BALCONY LOCATIONS AND CONFIGURATIONS, COLUMNS, WINDOWS/TRANSOMS, AND PATIO DOOR

ALL DIMENSIONS AND NOTES STATING "CLEAR", "MIN" OR "MAX" ARE FROM

LANDINGS AND FLOORS ON EITHER SIDE OF DOORWAYS SHALL NOT BE

PROVIDE BLOCKING FOR ALL TV LOCATIONS, WALL HUNG CABINETS, SHELVING, GRAB BARS, AND OTHER WALL MOUNTED ITEMS.

FIRE EXTINGUISHER (RE: SPECIFICATION) SHALL BE PROVIDED AND LOCATED IN SINK BASE CABINET UNDER KITCHEN SINK, U.N.O.


USE TEAR-AWAY BEAD, BACKER ROD, AND CAULK AT ALL DRYWALL

4'-8" 3'-5" **BEDROOM** 12'-3"x10'-0" 9'-0" CLG CARPET (10.2 13'-4" 12'-8" **LIVING** 15'-5"x8'-4" 12'-0" CLG VINYL PLANK 9'-0" CLG VINYL PLANK **DINING** 15'-5"x9'-8" 9'-0" CLG VINYL PLANK KITCHEN 11'-0"x8'-10" 9'-0" CLG VINYL PLANK 3'-3"

26'-0"


UNIT PLAN UNIT A1

1/4" = 1'-0"

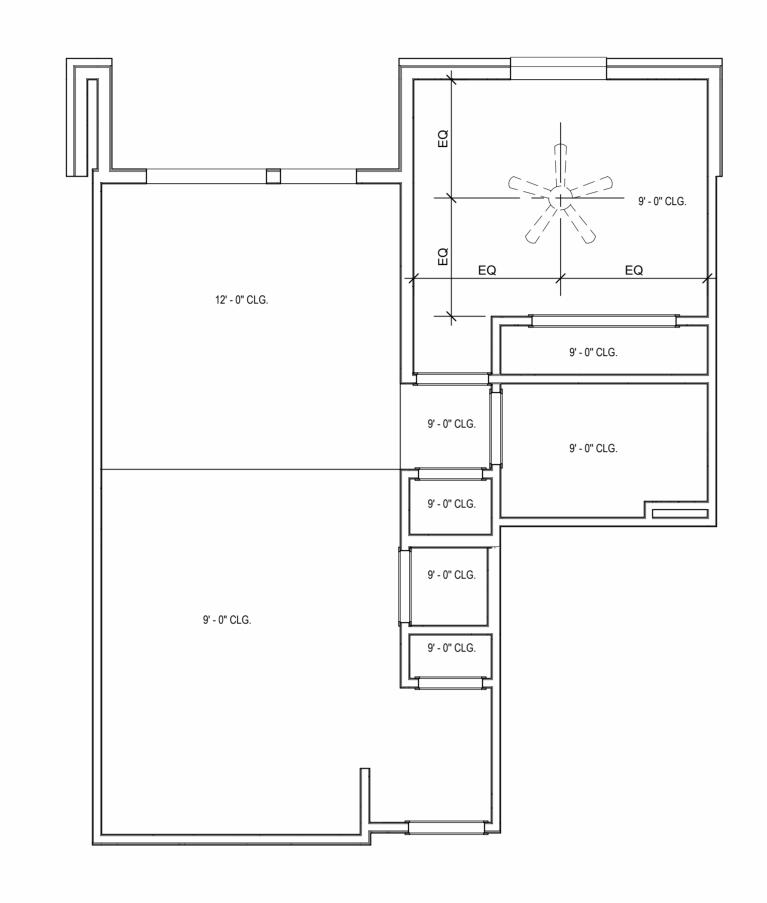

REFLECTED CEILING PLAN
UNIT A1 - 4TH FLOOR RCP


1/4" = 1'-0"

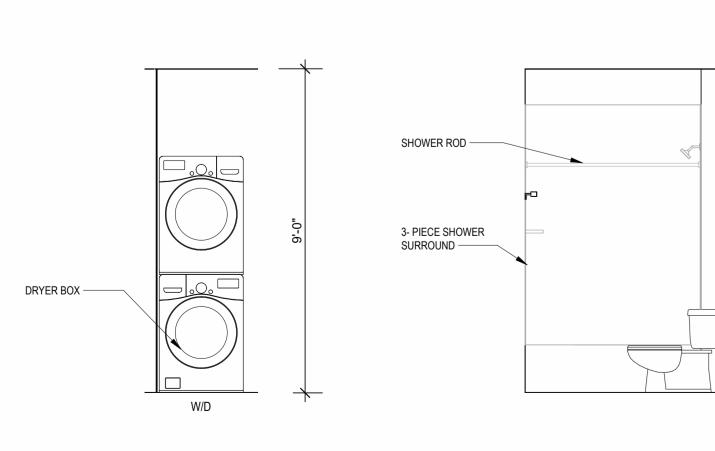


INTERIOR ELEVATION
SHOWER


3/8" = 1'-0" INTERIOR ELEVATION LAUNDRY


3/8" = 1'-0"

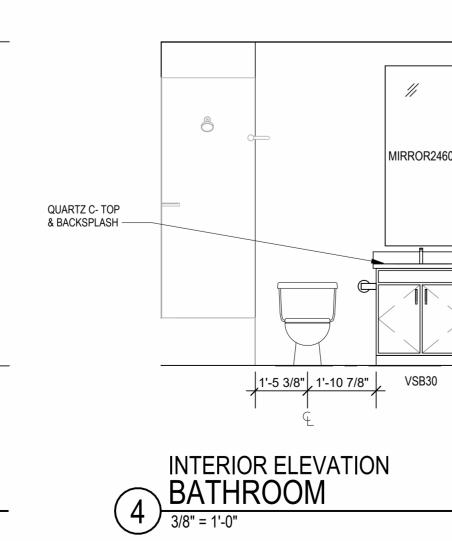

QUARTZ C- TOP ----

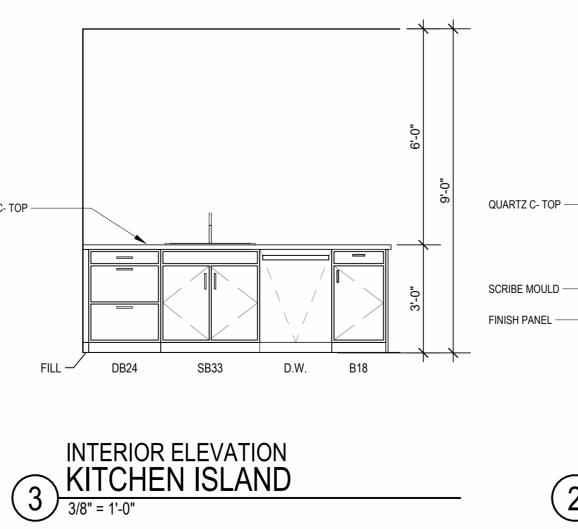

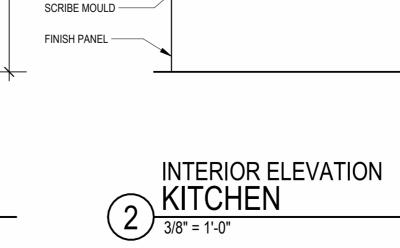

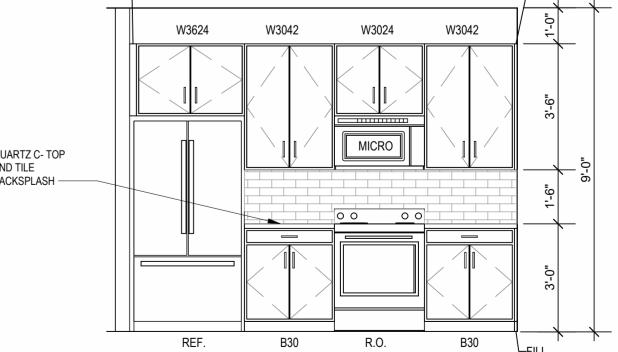

INTERIOR ELEVATION KITCHEN

3/8" = 1'-0"

QUARTZ C- TOP AND TILE BACKSPLASH —

DATE **03.15.2023** ЈОВ NO. **705921** DRAWN BY TSC/SIW 4/11/2023
CITY COMMENTS
SHEET NAME
UNIT A1 PLANS

FINISH STRIP.

REFER TO BUILDING PLANS AND EXTERIOR ELEVATIONS FOR ADDITIONAL EXTERIOR ARCHITECTURAL ELEMENTS INCLUDING BALCONY LOCATIONS

ALL DIMENSIONS AND NOTES STATING "CLEAR", "MIN" OR "MAX" ARE FROM

LANDINGS AND FLOORS ON EITHER SIDE OF DOORWAYS SHALL NOT BE

PROVIDE SAFETY GLAZING AT HAZARDOUS LOCATIONS PER IBC SECTION

PROVIDE APPROVED SMOKE DETECTORS AND REQUIRED EMERGENCY FIXTURES WIRED INTO THE BUILDING'S PRIMARY POWER SYSTEM PER IBC

UNIT DEMISING WALLS AND FLOOR/CEILING ASSEMBLIES SEPARATING DWELLING UNITS SHALL MEET OR EXCEED 50 S.T.C. TEST PER IBC SECTION

WHEN TUBS AND SHOWERS ARE LOCATED ADJACENT TO A FIRE RATED

ASSEMBLY, EXTEND GYPSUM BOARD BEHIND AND PROVIDE INSULATION.

SHALL SUBMIT AVAILABLE HARDWARE FINISHES TO ARCHITECT WHERE AN

SECTION 907.2.10. SEE MECHANICAL PLANS FOR LOCATIONS. ALL EXPOSED EDGES OF FINISHES TO BE DRESSED WITH APPROPRIATE

USE TEAR-AWAY BEAD, BACKER ROD, AND CAULK AT ALL DRYWALL

PROVIDE BLOCKING FOR ALL TV LOCATIONS, WALL HUNG CABINETS, SHELVING, GRAB BARS, AND OTHER WALL MOUNTED ITEMS.

MORE THAN 1/2" LOWER THAN DOORWAY THRESHOLD.

RETURNS AT FENESTRATION CONDITIONS.

FINISH FACE TO FINISH FACE.

2406. SEE PLANS FOR LOCATIONS.

LEE'S SUMMIT,

VERIFY ALL TUB AND SHOWER WALL LENGTHS AND DIMENSION WITH ACTUAL TUB OR SHOWER PROVIDED. CONTRACTOR TO COORDINATE FRAMING WITH TUB MANUFACTURER AND TUB DETAILS. MATCH SHOE FINISH TO CABINET FINISH WHERE ADJACENT TO BASE AVOID WATER LINES IN EXTERIOR WALLS. WHERE NOT POSSIBLE, INSTALL FOAM INSULATION BETWEEN WATER LINES & SHEATHING. IN SIDE-BY-SIDE LAUNDRY CONFIGURATION, WASHER ALWAYS ON THE LEFT, DRYER ALWAYS ON THE RIGHT. CONTRACTOR TO FIELD COORDINATE. ALL WINDOWS TO RECEIVE 5/4X STOOL WITH 1X3 APRON & DRYWALL DEVICE TRIMS & DEVICE FACES TO CLOSELY MATCH THE COLOR OF THE ALL PANTRY CABINETS & CABINETS ABOVE REFRIGERATOR SHALL BE 12" DEEP AND RECEIVE END PANELS WHERE EXPOSED. REFER TO FLOOR PLANS AND ROOF PLANS FOR ADDITIONAL RAISED PLATE LINES AND VAULTED CEILING INFORMATION. ALL BATHROOM HARDWARE FINISHES TO MATCH, INCLUDING SHOWER DOOR FRAMES, UNLESS SPECIFICALLY NOTED BY INTERIOR DESIGNER. G.C.

EXACT MATCH CANNOT BE MADE. ALL PLUMBING PENETRATIONS TO RECEIVE ESCUTCHEON TRIM RINGS TO MATCH ADJACENT FIXTURE FINISH. FIRE EXTINGUISHER (RE: SPECIFICATION) SHALL BE PROVIDED AND LOCATED IN SINK BASE CABINET UNDER KITCHEN SINK, U.N.O.

RETURNS ON JAMBS & HEAD.

SURFACE THEY ARE APPLIED TO.


3'-6" 4'-8" 4'-8" 6'-6" **LIVING** 10'-10"x11'-10" BEDROOM 14'-2"x12'-4" 12'-0" CLG 9'-0" CLG VINYL PLANK ----- REC. WASH HOOKUP 9'-0" CLG VINYL PLANK KITCHEN 10'-10"x10'-4" 9'-0" CLG VINYL PLANK

11'-8"

UNIT PLAN UNIT A2


1/4" = 1'-0"


11'-6"

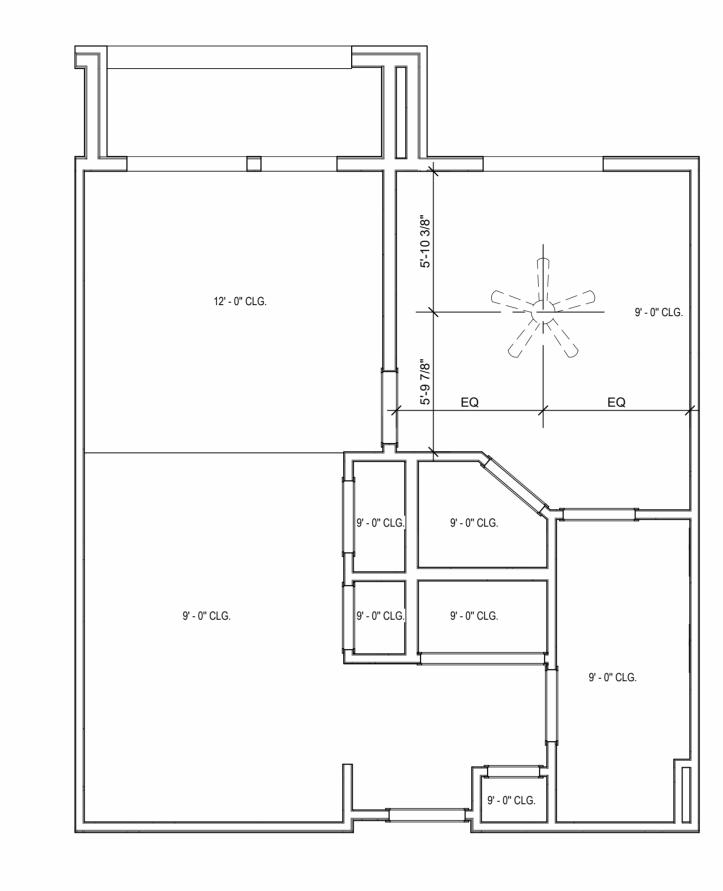


REFLECTED CEILING PLAN
UNIT A2 - 4TH FLOOR RCP


1/4" = 1'-0"

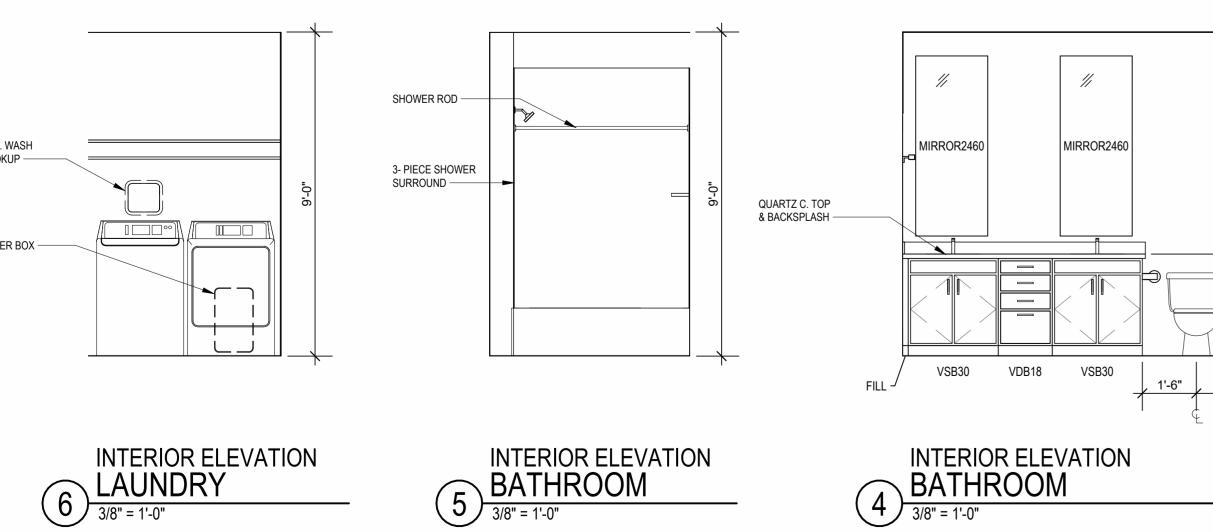

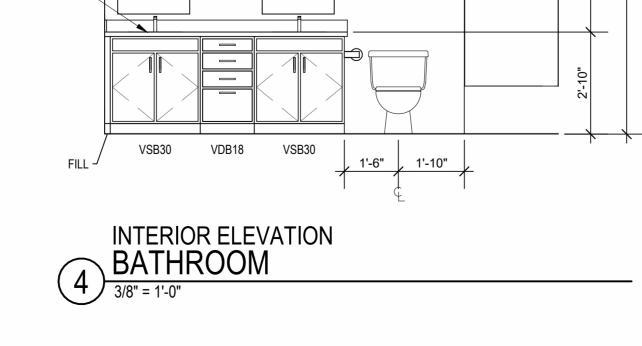


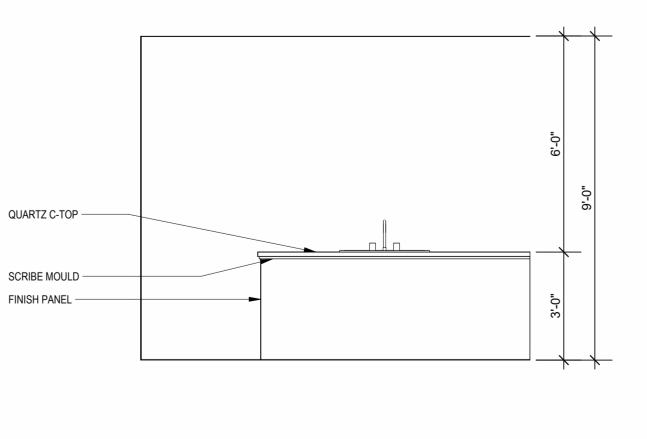



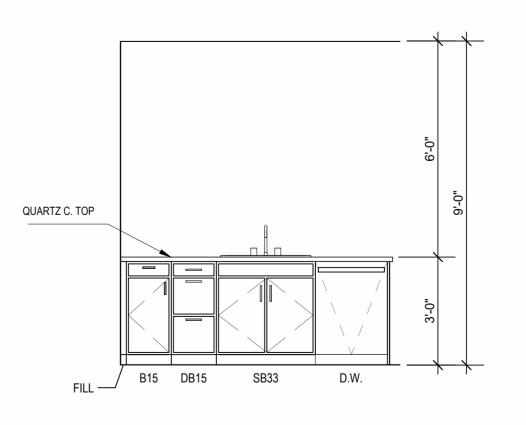



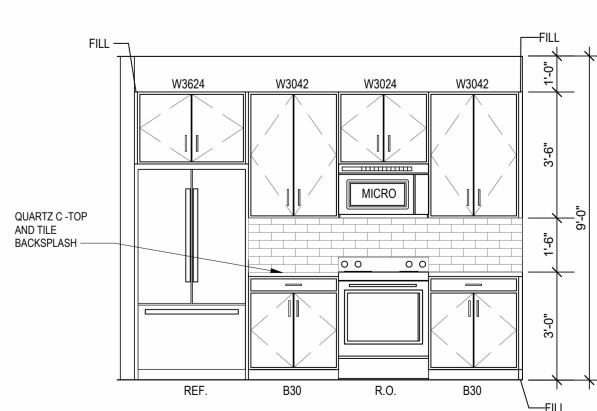

INTERIOR ELEVATION KITCHEN

3/8" = 1'-0"

JOB NO. **705921** DRAWN BY **TSC/SIW** DATE **03.15.2023** 4/11/2023 CITY COMMENTS
SHEET NAME
UNIT A2 PLANS

DRAWING RELEASE LOG

• 03.15.2023 - PERMIT SUBMITTAL

NOT FOR

CONSTRUCTION

ORIGINS AND THICKNESS. REFER TO SHEETS A0.40, A0.41 AND A0.42 FOR MOUNTING HEIGHTS AND ACCESSIBILITY REQUIREMENTS. REFER TO BUILDING PLANS AND EXTERIOR ELEVATIONS FOR ADDITIONAL EXTERIOR ARCHITECTURAL ELEMENTS INCLUDING BALCONY LOCATIONS

RETURNS AT FENESTRATION CONDITIONS. FINISH FACE TO FINISH FACE. MORE THAN 1/2" LOWER THAN DOORWAY THRESHOLD.

FINISH STRIP.

12. WHEN TUBS AND SHOWERS ARE LOCATED ADJACENT TO A FIRE RATED ASSEMBLY, EXTEND GYPSUM BOARD BEHIND AND PROVIDE INSULATION. VERIFY ALL TUB AND SHOWER WALL LENGTHS AND DIMENSION WITH ACTUAL TUB OR SHOWER PROVIDED. CONTRACTOR TO COORDINATE FRAMING WITH TUB MANUFACTURER AND TUB DETAILS. MATCH SHOE FINISH TO CABINET FINISH WHERE ADJACENT TO BASE


AVOID WATER LINES IN EXTERIOR WALLS. WHERE NOT POSSIBLE, INSTALL FOAM INSULATION BETWEEN WATER LINES & SHEATHING. IN SIDE-BY-SIDE LAUNDRY CONFIGURATION, WASHER ALWAYS ON THE LEFT, DRYER ALWAYS ON THE RIGHT. CONTRACTOR TO FIELD COORDINATE. ALL WINDOWS TO RECEIVE 5/4X STOOL WITH 1X3 APRON & DRYWALL RETURNS ON JAMBS & HEAD. DEVICE TRIMS & DEVICE FACES TO CLOSELY MATCH THE COLOR OF THE SURFACE THEY ARE APPLIED TO. ALL PANTRY CABINETS & CABINETS ABOVE REFRIGERATOR SHALL BE 12"

EXACT MATCH CANNOT BE MADE. MATCH ADJACENT FIXTURE FINISH.


AND CONFIGURATIONS, COLUMNS, WINDOWS/TRANSOMS, AND PATIO DOOR INFORMATION.
USE TEAR-AWAY BEAD, BACKER ROD, AND CAULK AT ALL DRYWALL ALL DIMENSIONS AND NOTES STATING "CLEAR", "MIN" OR "MAX" ARE FROM PROVIDE BLOCKING FOR ALL TV LOCATIONS, WALL HUNG CABINETS, SHELVING, GRAB BARS, AND OTHER WALL MOUNTED ITEMS.
LANDINGS AND FLOORS ON EITHER SIDE OF DOORWAYS SHALL NOT BE PROVIDE SAFETY GLAZING AT HAZARDOUS LOCATIONS PER IBC SECTION 2406. SEE PLANS FOR LOCATIONS. PROVIDE APPROVED SMOKE DETECTORS AND REQUIRED EMERGENCY FIXTURES WIRED INTO THE BUILDING'S PRIMARY POWER SYSTEM PER IBC SECTION 907.2.10. SEE MECHANICAL PLANS FOR LOCATIONS. ALL EXPOSED EDGES OF FINISHES TO BE DRESSED WITH APPROPRIATE UNIT DEMISING WALLS AND FLOOR/CEILING ASSEMBLIES SEPARATING
DWELLING UNITS SHALL MEET OR EXCEED 50 S.T.C. TEST PER IBC SECTION

DEEP AND RECEIVE END PANELS WHERE EXPOSED.
REFER TO FLOOR PLANS AND ROOF PLANS FOR ADDITIONAL RAISED PLATE LINES AND VAULTED CEILING INFORMATION. ALL BATHROOM HARDWARE FINISHES TO MATCH, INCLUDING SHOWER DOOR FRAMES, UNLESS SPECIFICALLY NOTED BY INTERIOR DESIGNER. G.C. SHALL SUBMIT AVAILABLE HARDWARE FINISHES TO ARCHITECT WHERE AN ALL PLUMBING PENETRATIONS TO RECEIVE ESCUTCHEON TRIM RINGS TO


FIRE EXTINGUISHER (RE: SPECIFICATION) SHALL BE PROVIDED AND LOCATED IN SINK BASE CABINET UNDER KITCHEN SINK, U.N.O.

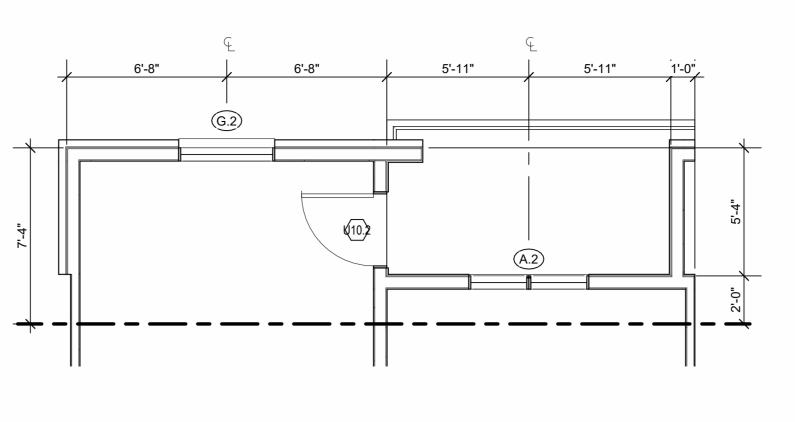




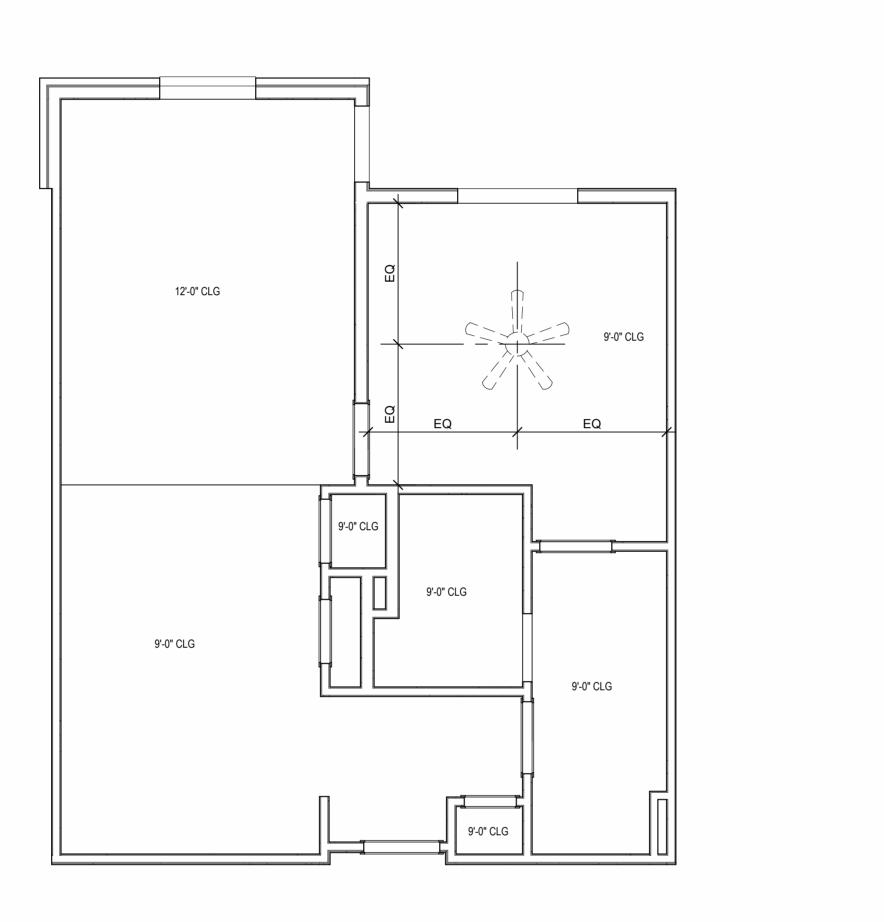

B UNIT A3 - 4TH FLOOR RCP

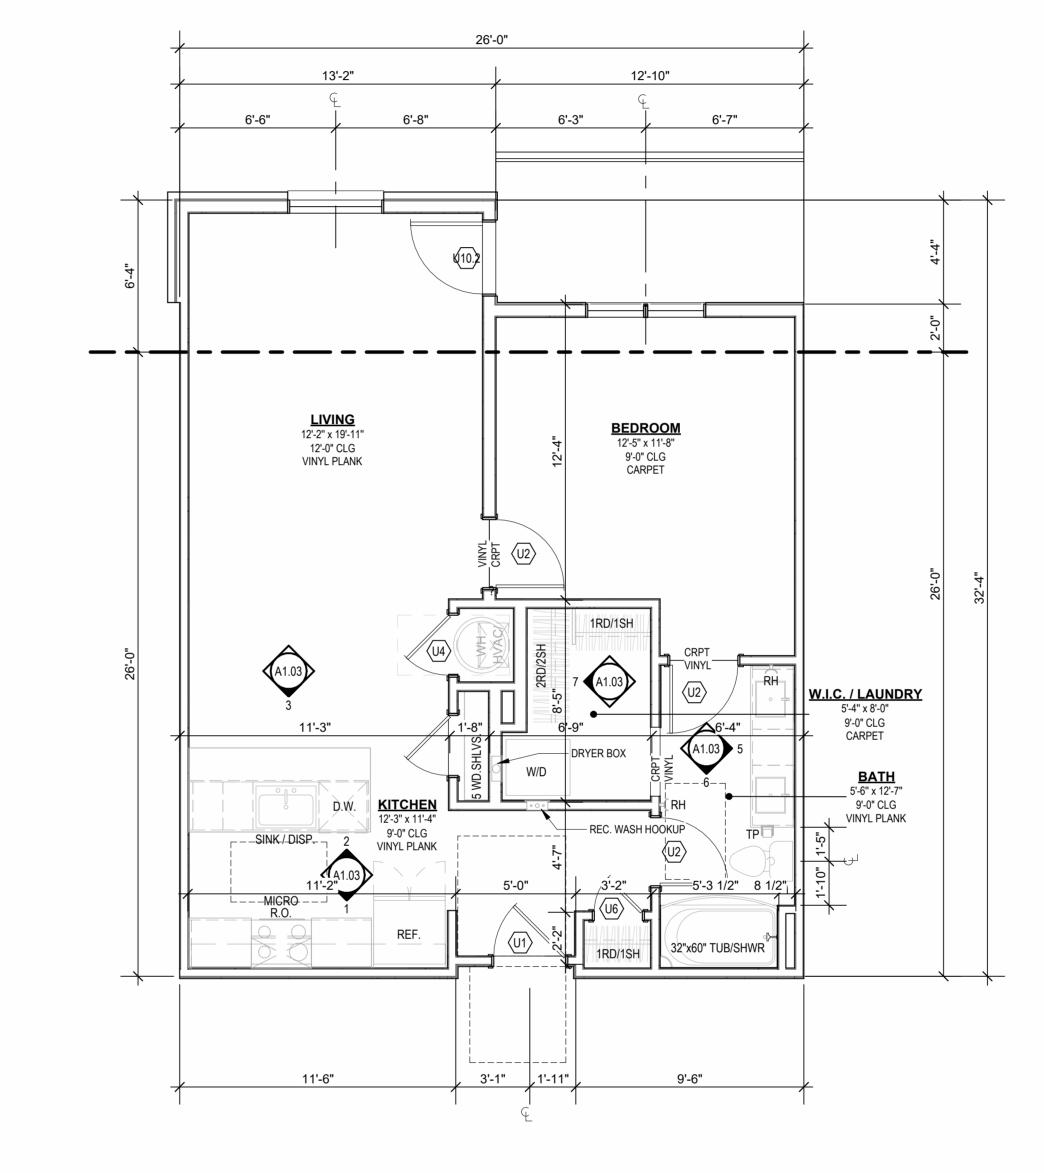


A UNIT A3

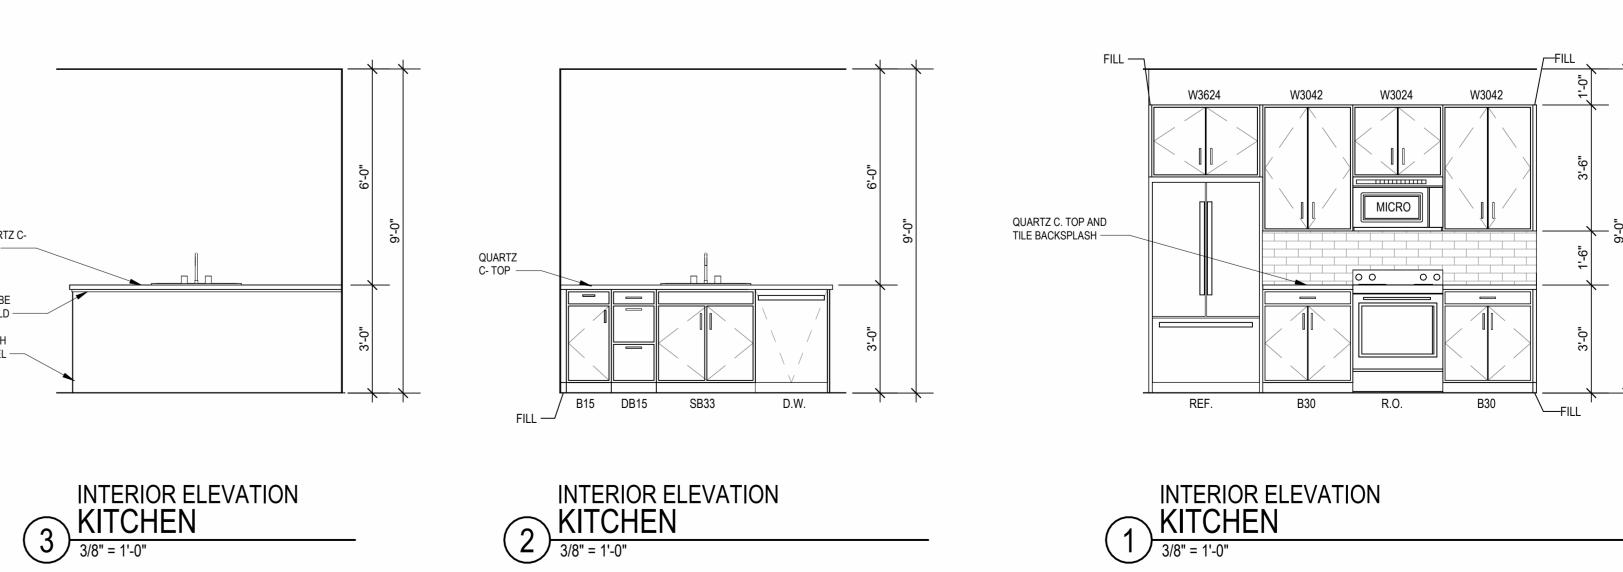


SHOWER ROD — MIRROR2460 QUARTZ C. TOP & BACKSPLASH — 3- PIECE SHOWER SURROUND ——— 2RD/2SH VSB30 VDB18 VSB30 1'-6" 1'-9 7/8" 7 INTERIOR ELEVATION W.I.C. / LAUNDRY 6 INTERIOR ELEVATION
BATHROOM
3/8" = 1'-0" INTERIOR ELEVATION
BATHROOM

3/8" = 1'-0"

MOULD — FINISH PANEL —

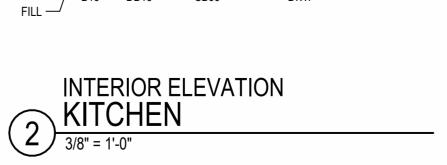

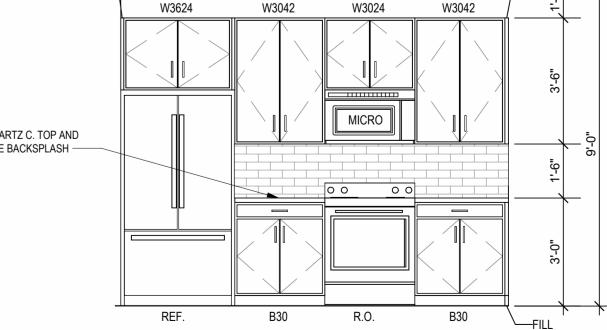

JOB NO. **705921** DRAWN BY **TSC/SIW** DATE **03.15.2023** 4/11/2023 CITY COMMENTS
SHEET NAME
UNIT A3 PLANS

AVOID WATER LINES IN EXTERIOR WALLS. WHERE NOT POSSIBLE, INSTALL FOAM INSULATION BETWEEN WATER LINES & SHEATHING. IN SIDE-BY-SIDE LAUNDRY CONFIGURATION, WASHER ALWAYS ON THE LEFT, DRYER ALWAYS ON THE RIGHT. CONTRACTOR TO FIELD COORDINATE. ALL WINDOWS TO RECEIVE 5/4X STOOL WITH 1X3 APRON & DRYWALL RETURNS ON JAMBS & HEAD. DEVICE TRIMS & DEVICE FACES TO CLOSELY MATCH THE COLOR OF THE SURFACE THEY ARE APPLIED TO. ALL PANTRY CABINETS & CABINETS ABOVE REFRIGERATOR SHALL BE 12" DEEP AND RECEIVE END PANELS WHERE EXPOSED. REFER TO FLOOR PLANS AND ROOF PLANS FOR ADDITIONAL RAISED PLATE LINES AND VAULTED CEILING INFORMATION. ALL BATHROOM HARDWARE FINISHES TO MATCH, INCLUDING SHOWER DOOR FRAMES, UNLESS SPECIFICALLY NOTED BY INTERIOR DESIGNER. G.C. SHALL SUBMIT AVAILABLE HARDWARE FINISHES TO ARCHITECT WHERE AN

EXACT MATCH CANNOT BE MADE.
ALL PLUMBING PENETRATIONS TO RECEIVE ESCUTCHEON TRIM RINGS TO MATCH ADJACENT FIXTURE FINISH. FIRE EXTINGUISHER (RE: SPECIFICATION) SHALL BE PROVIDED AND LOCATED IN SINK BASE CABINET UNDER KITCHEN SINK, U.N.O.

UNIT PLAN GENERAL NOTES:

INFORMATION.

ORIGINS AND THICKNESS.

ACCESSIBILITY REQUIREMENTS.

FINISH FACE TO FINISH FACE.

2406. SEE PLANS FOR LOCATIONS.

REFER TO ASSEMBLY SHEET SERIES A0.30 FOR ASSEMBLY DIMENSION

REFER TO SHEETS A0.40, A0.41 AND A0.42 FOR MOUNTING HEIGHTS AND

REFER TO BUILDING PLANS AND EXTERIOR ELEVATIONS FOR ADDITIONAL EXTERIOR ARCHITECTURAL ELEMENTS INCLUDING BALCONY LOCATIONS AND CONFIGURATIONS, COLUMNS, WINDOWS/TRANSOMS, AND PATIO DOOR

ALL DIMENSIONS AND NOTES STATING "CLEAR", "MIN" OR "MAX" ARE FROM

PROVIDE BLOCKING FOR ALL TV LOCATIONS, WALL HUNG CABINETS, SHELVING, GRAB BARS, AND OTHER WALL MOUNTED ITEMS. LANDINGS AND FLOORS ON EITHER SIDE OF DOORWAYS SHALL NOT BE

PROVIDE SAFETY GLAZING AT HAZARDOUS LOCATIONS PER IBC SECTION

PROVIDE APPROVED SMOKE DETECTORS AND REQUIRED EMERGENCY FIXTURES WIRED INTO THE BUILDING'S PRIMARY POWER SYSTEM PER IBC

WHEN TUBS AND SHOWERS ARE LOCATED ADJACENT TO A FIRE RATED ASSEMBLY, EXTEND GYPSUM BOARD BEHIND AND PROVIDE INSULATION. VERIFY ALL TUB AND SHOWER WALL LENGTHS AND DIMENSION WITH ACTUAL TUB OR SHOWER PROVIDED. CONTRACTOR TO COORDINATE

MATCH SHOE FINISH TO CABINET FINISH WHERE ADJACENT TO BASE

SECTION 907.2.10. SEE MECHANICAL PLANS FOR LOCATIONS. ALL EXPOSED EDGES OF FINISHES TO BE DRESSED WITH APPROPRIATE UNIT DEMISING WALLS AND FLOOR/CEILING ASSEMBLIES SEPARATING DWELLING UNITS SHALL MEET OR EXCEED 50 S.T.C. TEST PER IBC SECTION

4. USE TEAR-AWAY BEAD, BACKER ROD, AND CAULK AT ALL DRYWALL

MORE THAN 1/2" LOWER THAN DOORWAY THRESHOLD.


FRAMING WITH TUB MANUFACTURER AND TUB DETAILS.


RETURNS AT FENESTRATION CONDITIONS.

12' - 0" CLG. 9' - 0" CLG. 9' - 0" CLG. 9' - 0" CLG.


REFLECTED CEILING PLAN
UNIT A4 - 4TH FLOOR RCP


1/4" = 1'-0"

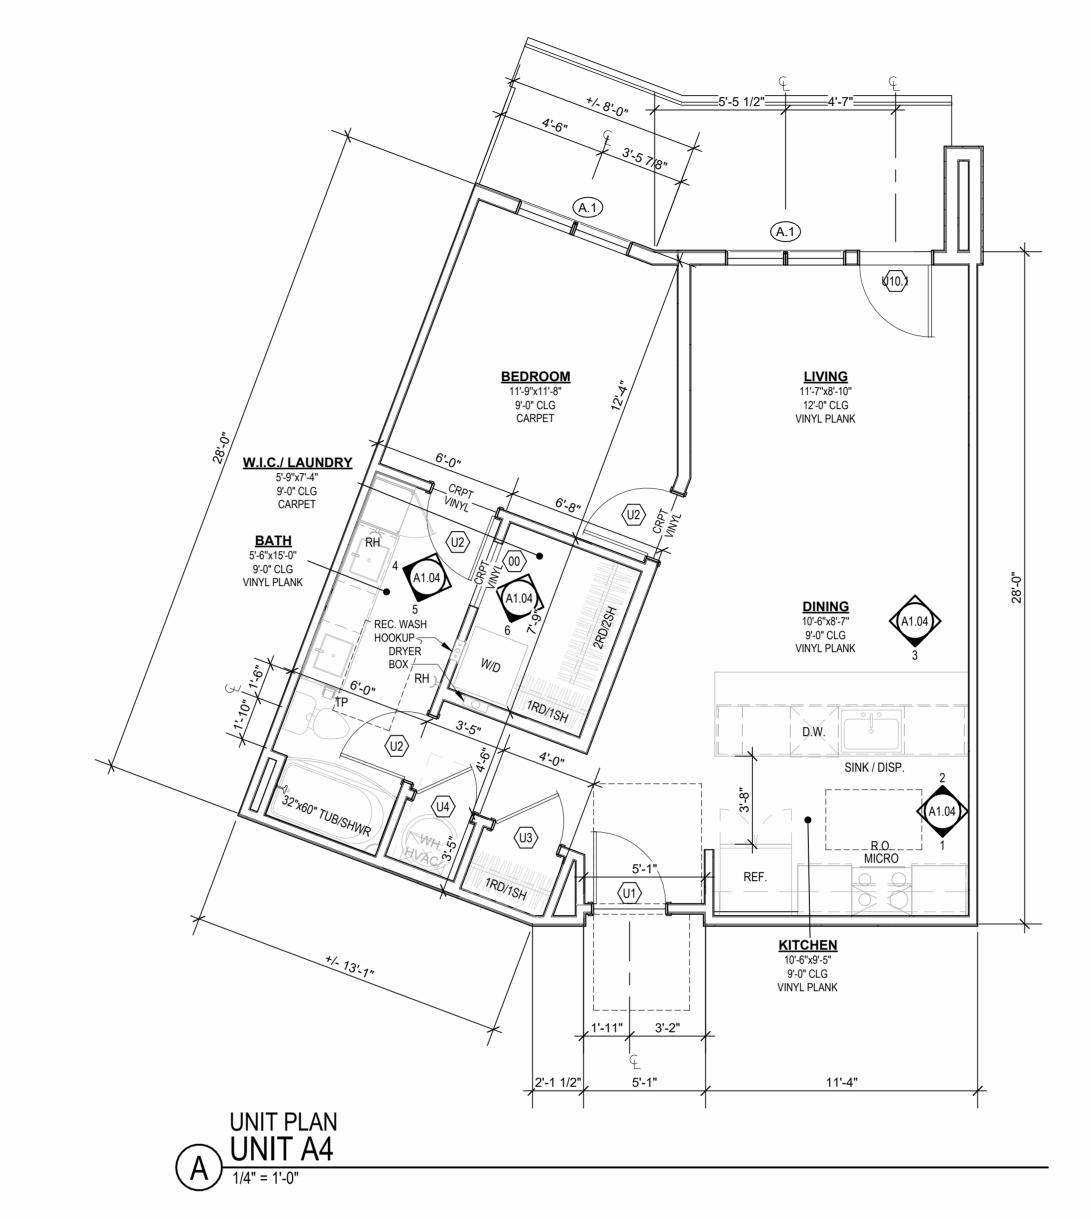

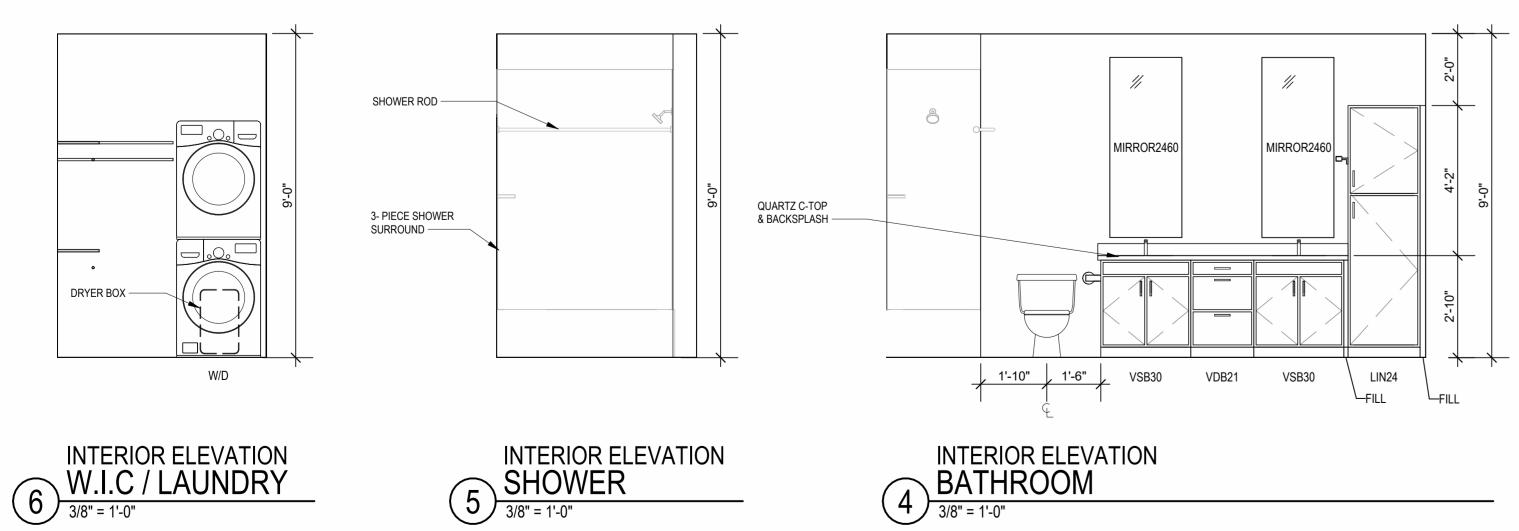




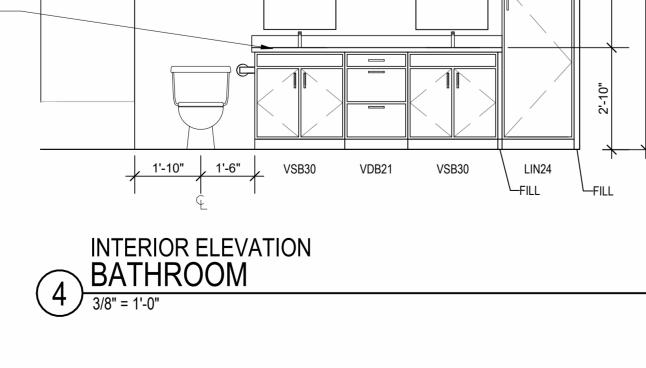

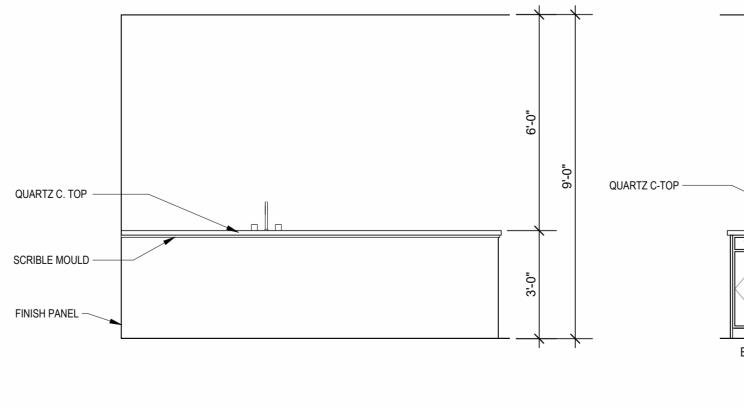




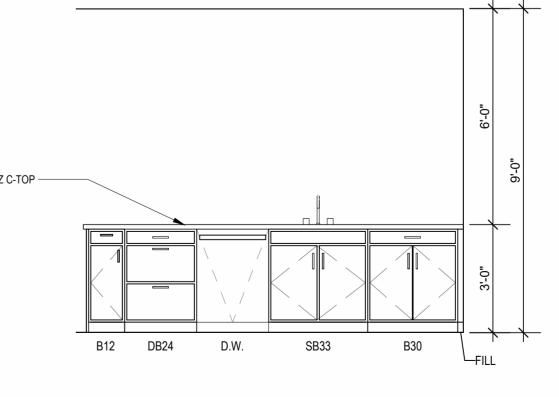

INTERIOR ELEVATION KITCHEN ISLAND

3/8" = 1'-0"

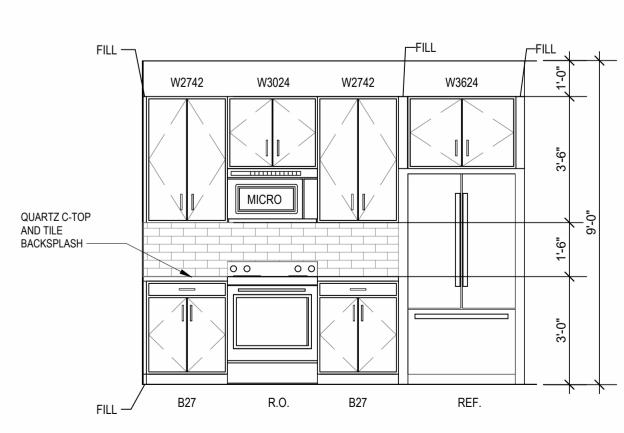

INTERIOR ELEVATION KITCHEN

3/8" = 1'-0"

 \triangle REVISIONS

DATE **03.15.2023** ЈОВ NO. **705921** DRAWN BY TSC/SIW 4/11/2023
CITY COMMENTS
SHEET NAME
UNIT A4 PLANS

CONSTRUCTION

UNIT PLAN GENERAL NOTES:

REFER TO ASSEMBLY SHEET SERIES A0.30 FOR ASSEMBLY DIMENSION ORIGINS AND THICKNESS. REFER TO SHEETS A0.40, A0.41 AND A0.42 FOR MOUNTING HEIGHTS AND ACCESSIBILITY REQUIREMENTS. REFER TO BUILDING PLANS AND EXTERIOR ELEVATIONS FOR ADDITIONAL EXTERIOR ARCHITECTURAL ELEMENTS INCLUDING BALCONY LOCATIONS AND CONFIGURATIONS, COLUMNS, WINDOWS/TRANSOMS, AND PATIO DOOR USE TEAR-AWAY BEAD, BACKER ROD, AND CAULK AT ALL DRYWALL RETURNS AT FENESTRATION CONDITIONS.

ALL DIMENSIONS AND NOTES STATING "CLEAR", "MIN" OR "MAX" ARE FROM FINISH FACE TO FINISH FACE. PROVIDE BLOCKING FOR ALL TV LOCATIONS, WALL HUNG CABINETS, SHELVING, GRAB BARS, AND OTHER WALL MOUNTED ITEMS.

LANDINGS AND FLOORS ON EITHER SIDE OF DOORWAYS SHALL NOT BE MORE THAN 1/2" LOWER THAN DOORWAY THRESHOLD. PROVIDE SAFETY GLAZING AT HAZARDOUS LOCATIONS PER IBC SECTION 2406. SEE PLANS FOR LOCATIONS. PROVIDE APPROVED SMOKE DETECTORS AND REQUIRED EMERGENCY SECTION 907.2.10. SEE MECHANICAL PLANS FOR LOCATIONS.


FIXTURES WIRED INTO THE BUILDING'S PRIMARY POWER SYSTEM PER IBC ALL EXPOSED EDGES OF FINISHES TO BE DRESSED WITH APPROPRIATE FINISH STRIP. UNIT DEMISING WALLS AND FLOOR/CEILING ASSEMBLIES SEPARATING DWELLING UNITS SHALL MEET OR EXCEED 50 S.T.C. TEST PER IBC SECTION WHEN TUBS AND SHOWERS ARE LOCATED ADJACENT TO A FIRE RATED

ASSEMBLY, EXTEND GYPSUM BOARD BEHIND AND PROVIDE INSULATION. VERIFY ALL TUB AND SHOWER WALL LENGTHS AND DIMENSION WITH ACTUAL TUB OR SHOWER PROVIDED. CONTRACTOR TO COORDINATE FRAMING WITH TUB MANUFACTURER AND TUB DETAILS. MATCH SHOE FINISH TO CABINET FINISH WHERE ADJACENT TO BASE CABINET.
AVOID WATER LINES IN EXTERIOR WALLS. WHERE NOT POSSIBLE, INSTALL FOAM INSULATION BETWEEN WATER LINES & SHEATHING. IN SIDE-BY-SIDE LAUNDRY CONFIGURATION, WASHER ALWAYS ON THE LEFT, DRYER ALWAYS ON THE RIGHT. CONTRACTOR TO FIELD COORDINATE. ALL WINDOWS TO RECEIVE 5/4X STOOL WITH 1X3 APRON & DRYWALL RETURNS ON JAMBS & HEAD.

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ALL PLUMBING PENETRATIONS TO RECEIVE ESCUTCHEON TRIM RINGS TO MATCH ADJACENT FIXTURE FINISH. FIRE EXTINGUISHER (RE: SPECIFICATION) SHALL BE PROVIDED AND LOCATED IN SINK BASE CABINET UNDER KITCHEN SINK, U.N.O.



13'-4"

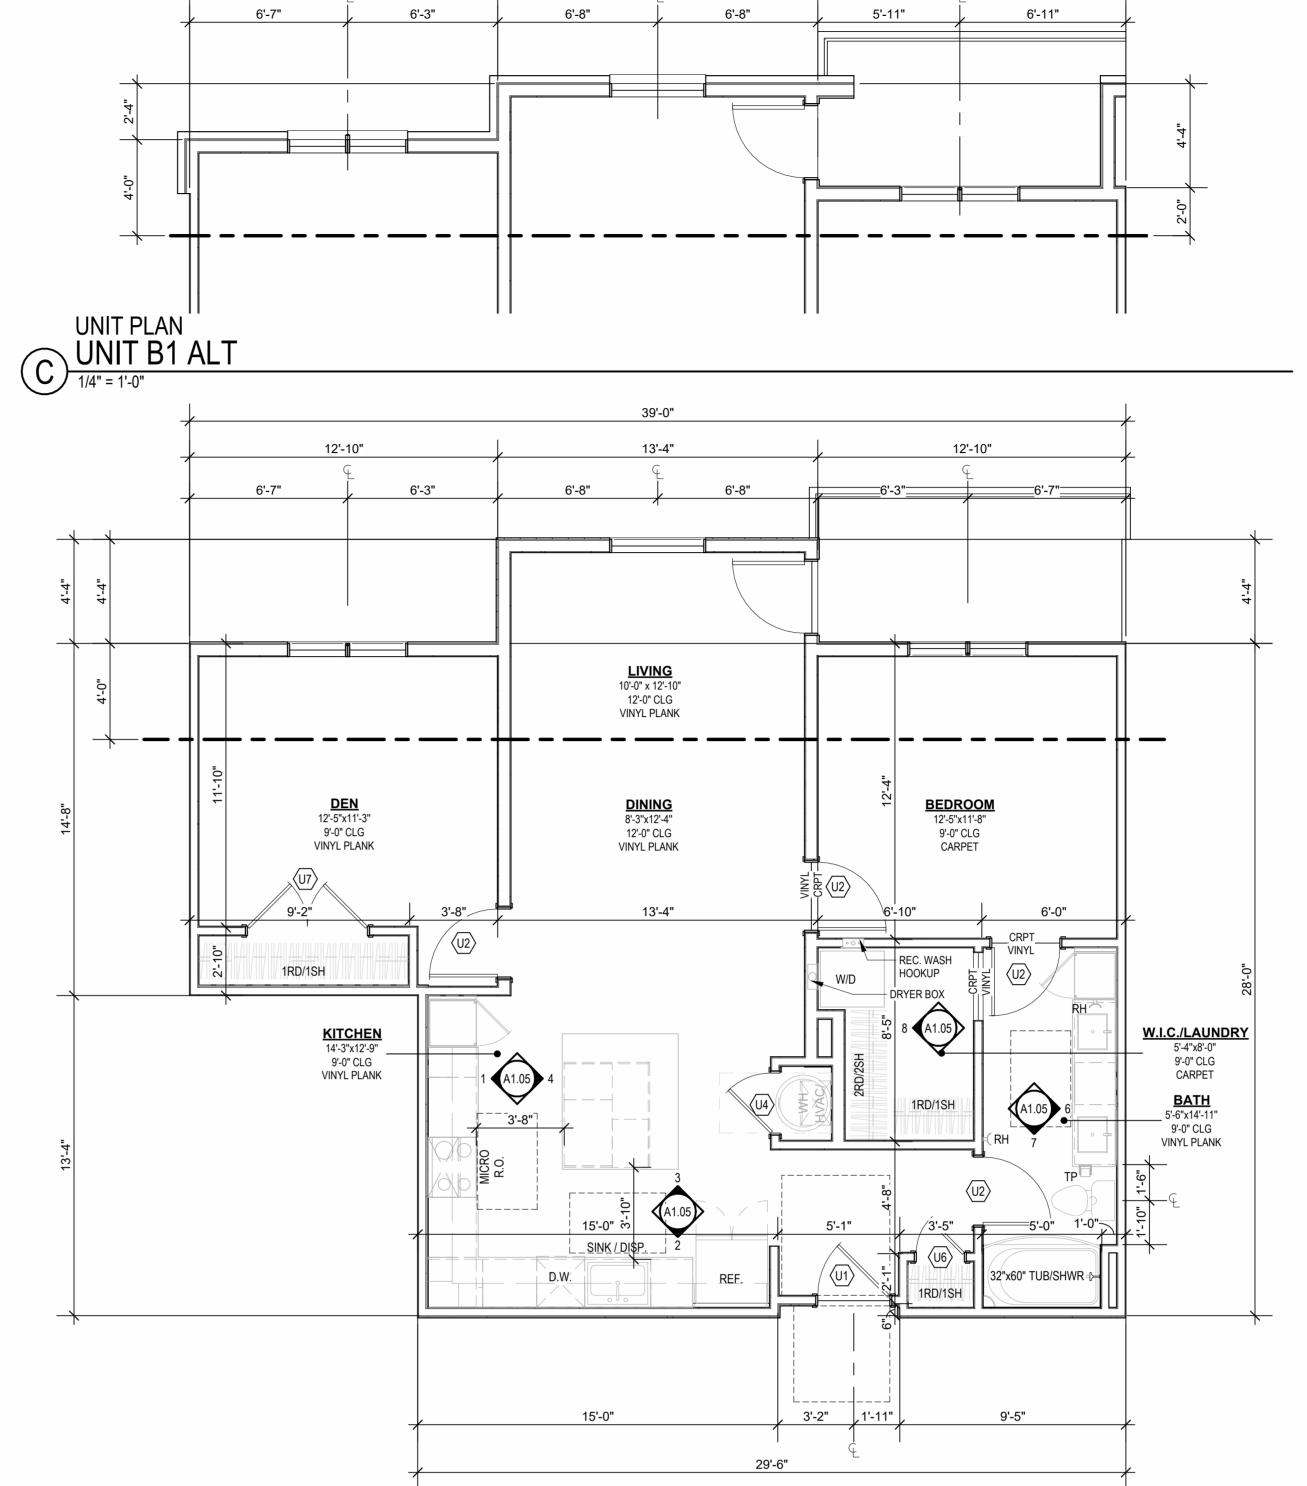12'-10"

12'-10"

REFLECTED CEILING PLAN
UNIT B1 - 4TH FLOOR RCP


1/4" = 1'-0"


9' - 0" CLG.

9' - 0" CLG.


12' - 0" CLG.

9' - 0" CLG.

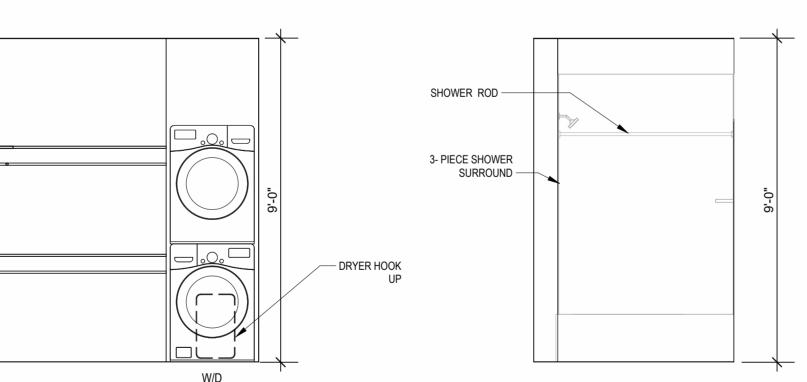

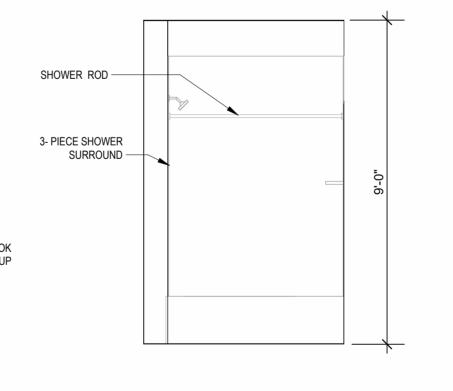


UNIT PLAN UNIT B1

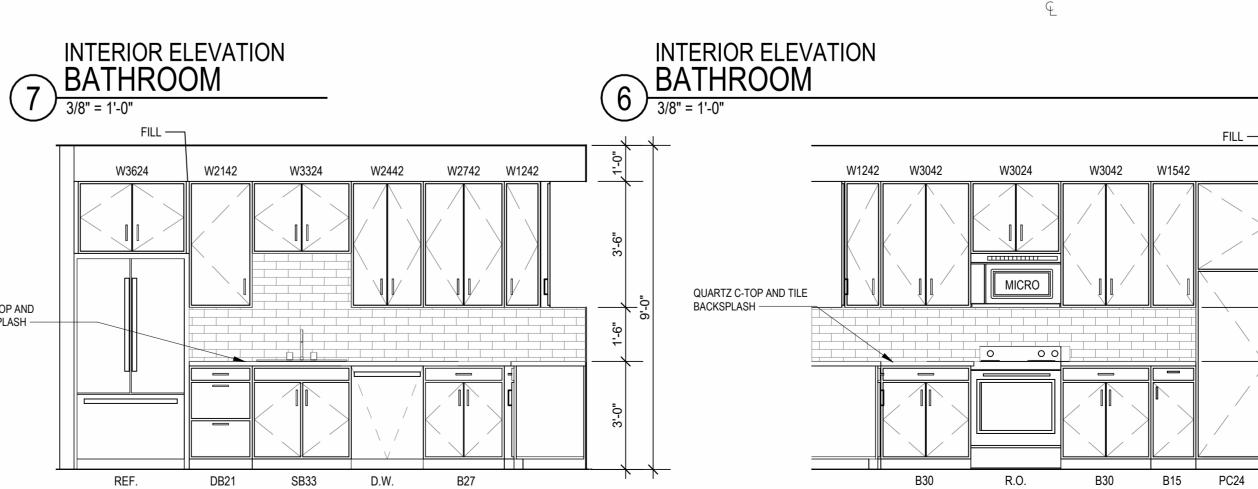

QUARTZ C-TOP & BACKSPLASH —

MIRROR2460

VSB30 VDB21

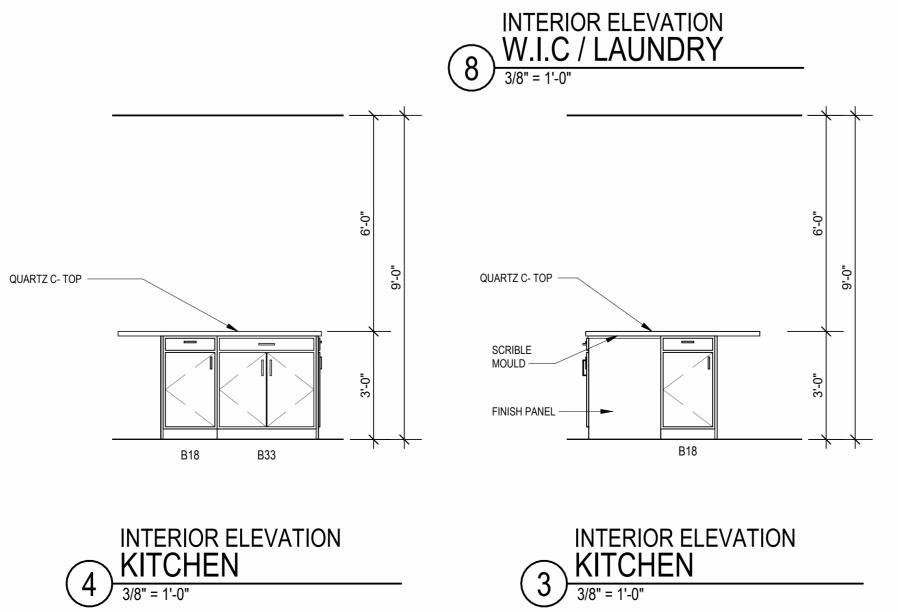

9' - 0" CLG.

9' - 0" CLG.

9' - 0" CLG.

9' - 0" CLG.

QUARTZ C-TOP AND TILE BACKSPLASH —

INTERIOR ELEVATION KITCHEN

3/8" = 1'-0"

INTERIOR ELEVATION KITCHEN

3/8" = 1'-0"

DRAWING RELEASE LOG

• 03.15.2023 - PERMIT SUBMITTAL

LEE'S SUMMIT, MO

ARD RD.

Јов No. **705921**

03.15.2023

 \triangle REVISIONS

DRAWN BY TSC/SIW 4/11/2023 CITY COMMENTS SHEET NAME
UNIT B1 PLANS

FINISH FACE TO FINISH FACE.

2406. SEE PLANS FOR LOCATIONS.

UNIT PLAN GENERAL NOTES:

INFORMATION.



AND CONFIGURATIONS, COLUMNS, WINDOWS/TRANSOMS, AND PATIO DOOR USE TEAR-AWAY BEAD, BACKER ROD, AND CAULK AT ALL DRYWALL RETURNS AT FENESTRATION CONDITIONS. ALL DIMENSIONS AND NOTES STATING "CLEAR", "MIN" OR "MAX" ARE FROM PROVIDE BLOCKING FOR ALL TV LOCATIONS, WALL HUNG CABINETS, SHELVING, GRAB BARS, AND OTHER WALL MOUNTED ITEMS. LANDINGS AND FLOORS ON EITHER SIDE OF DOORWAYS SHALL NOT BE MORE THAN 1/2" LOWER THAN DOORWAY THRESHOLD. PROVIDE SAFETY GLAZING AT HAZARDOUS LOCATIONS PER IBC SECTION PROVIDE APPROVED SMOKE DETECTORS AND REQUIRED EMERGENCY FIXTURES WIRED INTO THE BUILDING'S PRIMARY POWER SYSTEM PER IBC SECTION 907.2.10. SEE MECHANICAL PLANS FOR LOCATIONS. ALL EXPOSED EDGES OF FINISHES TO BE DRESSED WITH APPROPRIATE UNIT DEMISING WALLS AND FLOOR/CEILING ASSEMBLIES SEPARATING

DWELLING UNITS SHALL MEET OR EXCEED 50 S.T.C. TEST PER IBC SECTION WHEN TUBS AND SHOWERS ARE LOCATED ADJACENT TO A FIRE RATED ASSEMBLY, EXTEND GYPSUM BOARD BEHIND AND PROVIDE INSULATION. VERIFY ALL TUB AND SHOWER WALL LENGTHS AND DIMENSION WITH ACTUAL TUB OR SHOWER PROVIDED. CONTRACTOR TO COORDINATE FRAMING WITH TUB MANUFACTURER AND TUB DETAILS. MATCH SHOE FINISH TO CABINET FINISH WHERE ADJACENT TO BASE AVOID WATER LINES IN EXTERIOR WALLS. WHERE NOT POSSIBLE, INSTALL

FOAM INSULATION BETWEEN WATER LINES & SHEATHING. IN SIDE-BY-SIDE LAUNDRY CONFIGURATION, WASHER ALWAYS ON THE LEFT, DRYER ALWAYS ON THE RIGHT. CONTRACTOR TO FIELD COORDINATE. ALL WINDOWS TO RECEIVE 5/4X STOOL WITH 1X3 APRON & DRYWALL RETURNS ON JAMBS & HEAD. DEVICE TRIMS & DEVICE FACES TO CLOSELY MATCH THE COLOR OF THE SURFACE THEY ARE APPLIED TO. ALL PANTRY CABINETS & CABINETS ABOVE REFRIGERATOR SHALL BE 12"

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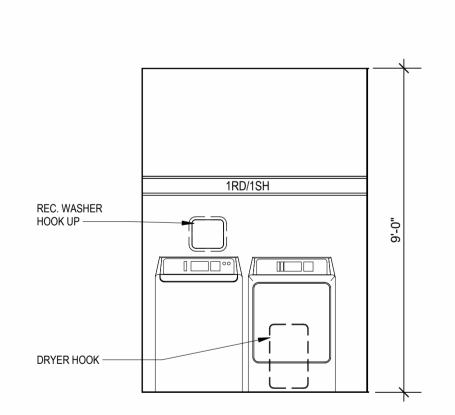
MATCH ADJACENT FIXTURE FINISH. FIRE EXTINGUISHER (RE: SPECIFICATION) SHALL BE PROVIDED AND LOCATED IN SINK BASE CABINET UNDER KITCHEN SINK, U.N.O.


13'-5 3/8" BEDROOM 10'-4"x12'-1" 9'-0" CLG **LIVING** 13'-1"x9'-5" 12'-0" CLG VINYL PLANK **W.I.C.** 8'-11"x8'-3" 9'-0" CLG 5'-8 1/4" **DINING** 13'-1"x8'-1" POWDER 6'-8"x5'-7" 12'-0" CLG VINYL PLANK 9'-0" CLG **LAUNDRY** VINYL PLANK 9'-0" CLG VINYL PLANK **DEN** 9'-9"x12'-1" 9'-0" CLG VINYL PLANK KITCHEN 12'-2'x9'-5" 9'-0" CLG VINYL PLANK 10'-3"

9' - 0" CLG. 9' - 0" CLG. 12' - 0" CLG. 9' - 0" CLG.

REFLECTED CEILING PLAN
UNIT B2 - 4TH FLOOR RCP


1/4" = 1'-0"




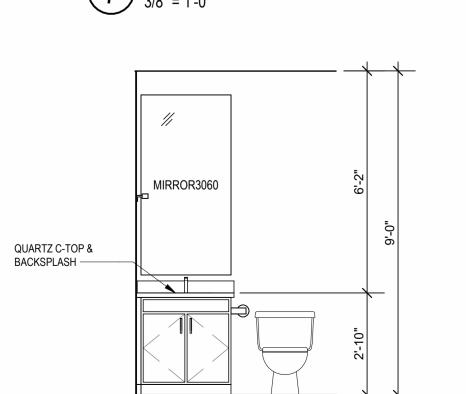



INTERIOR ELEVATION POWDER ROOM


3/8" = 1'-0"

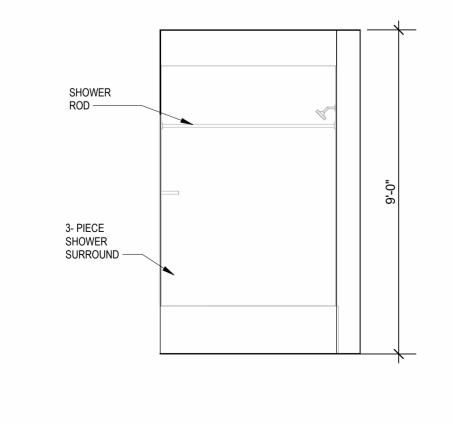

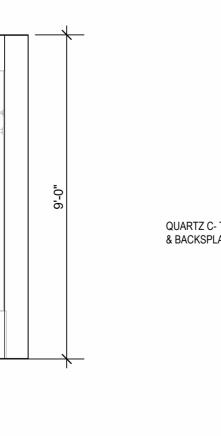


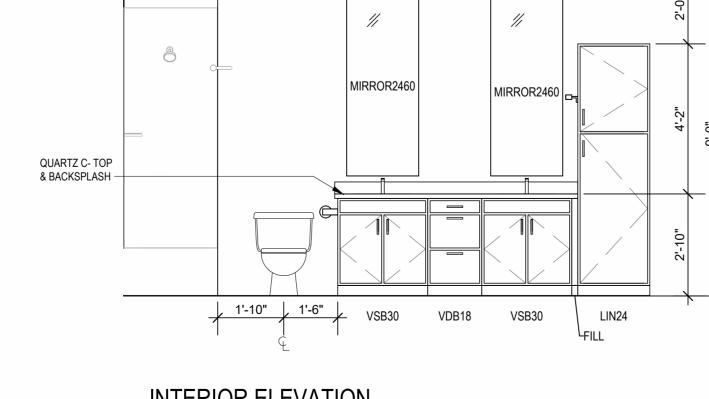

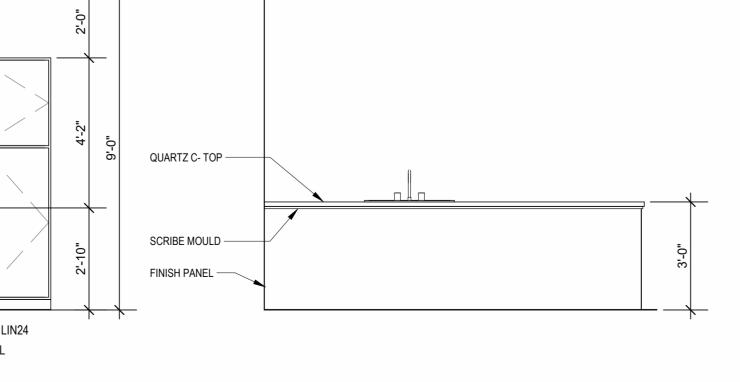

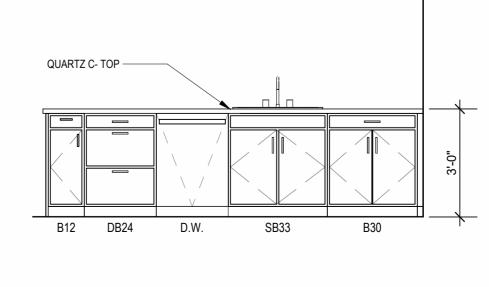




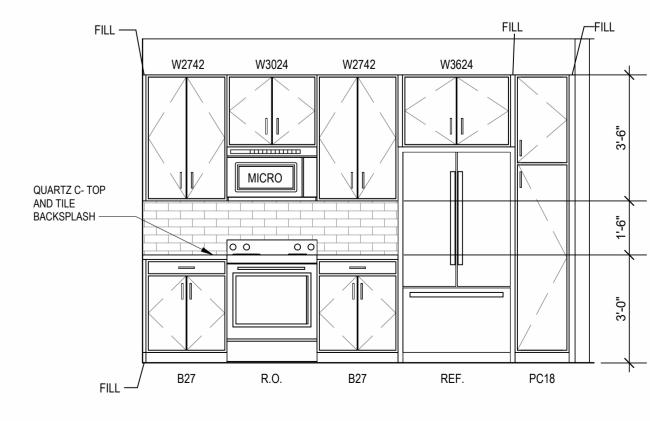

INTERIOR ELEVATION KITCHEN

3/8" = 1'-0"

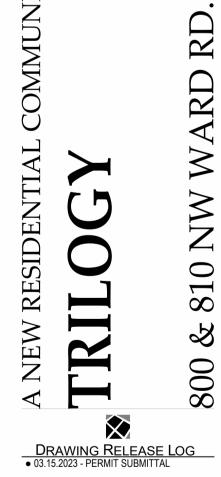

LEE'S SUMMIT, MO


DATE **03.15.2023** ЈОВ NO. **705921** DRAWN BY TSC/SIW 4/11/2023 CITY COMMENTS

 \triangle REVISIONS


SHEET NAME
UNIT B2 PLANS

INTERIOR ELEVATION LAUNDRY


3/8" = 1'-0"

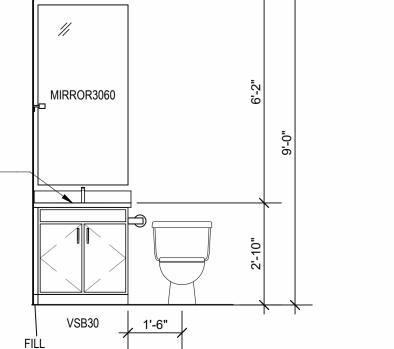



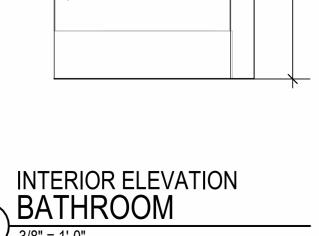



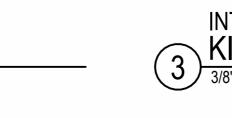

UNIT PLAN UNIT B2

EXTERIOR ARCHITECTURAL ELEMENTS INCLUDING BALCONY LOCATIONS AND CONFIGURATIONS, COLUMNS, WINDOWS/TRANSOMS, AND PATIO DOOR USE TEAR-AWAY BEAD, BACKER ROD, AND CAULK AT ALL DRYWALL RETURNS AT FENESTRATION CONDITIONS.
ALL DIMENSIONS AND NOTES STATING "CLEAR", "MIN" OR "MAX" ARE FROM

FINISH FACE TO FINISH FACE. PROVIDE BLOCKING FOR ALL TV LOCATIONS, WALL HUNG CABINETS, SHELVING, GRAB BARS, AND OTHER WALL MOUNTED ITEMS. LANDINGS AND FLOORS ON EITHER SIDE OF DOORWAYS SHALL NOT BE MORE THAN 1/2" LOWER THAN DOORWAY THRESHOLD. PROVIDE SAFETY GLAZING AT HAZARDOUS LOCATIONS PER IBC SECTION 2406. SEE PLANS FOR LOCATIONS. PROVIDE APPROVED SMOKE DETECTORS AND REQUIRED EMERGENCY

FIXTURES WIRED INTO THE BUILDING'S PRIMARY POWER SYSTEM PER IBC SECTION 907.2.10. SEE MECHANICAL PLANS FOR LOCATIONS. ALL EXPOSED EDGES OF FINISHES TO BE DRESSED WITH APPROPRIATE FINISH STRIP. UNIT DEMISING WALLS AND FLOOR/CEILING ASSEMBLIES SEPARATING DWELLING UNITS SHALL MEET OR EXCEED 50 S.T.C. TEST PER IBC SECTION

WHEN TUBS AND SHOWERS ARE LOCATED ADJACENT TO A FIRE RATED ASSEMBLY, EXTEND GYPSUM BOARD BEHIND AND PROVIDE INSULATION. VERIFY ALL TUB AND SHOWER WALL LENGTHS AND DIMENSION WITH ACTUAL TUB OR SHOWER PROVIDED. CONTRACTOR TO COORDINATE FRAMING WITH TUB MANUFACTURER AND TUB DETAILS.


MATCH SHOE FINISH TO CABINET FINISH WHERE ADJACENT TO BASE


CABINET.
AVOID WATER LINES IN EXTERIOR WALLS. WHERE NOT POSSIBLE, INSTALL FOAM INSULATION BETWEEN WATER LINES & SHEATHING. IN SIDE-BY-SIDE LAUNDRY CONFIGURATION, WASHER ALWAYS ON THE LEFT, DRYER ALWAYS ON THE RIGHT. CONTRACTOR TO FIELD COORDINATE. ALL WINDOWS TO RECEIVE 5/4X STOOL WITH 1X3 APRON & DRYWALL

RETURNS ON JAMBS & HEAD. DEVICE TRIMS & DEVICE FACES TO CLOSELY MATCH THE COLOR OF THE SURFACE THEY ARE APPLIED TO. ALL PANTRY CABINETS & CABINETS ABOVE REFRIGERATOR SHALL BE 12" DEEP AND RECEIVE END PANELS WHERE EXPOSED. REFER TO FLOOR PLANS AND ROOF PLANS FOR ADDITIONAL RAISED PLATE LINES AND VAULTED CEILING INFORMATION. ALL BATHROOM HARDWARE FINISHES TO MATCH, INCLUDING SHOWER DOOR FRAMES, UNLESS SPECIFICALLY NOTED BY INTERIOR DESIGNER. G.C.


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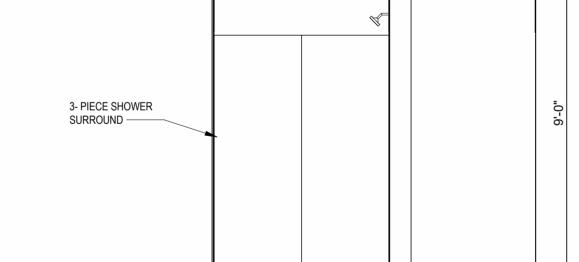
NOT FOR CONSTRUCTION



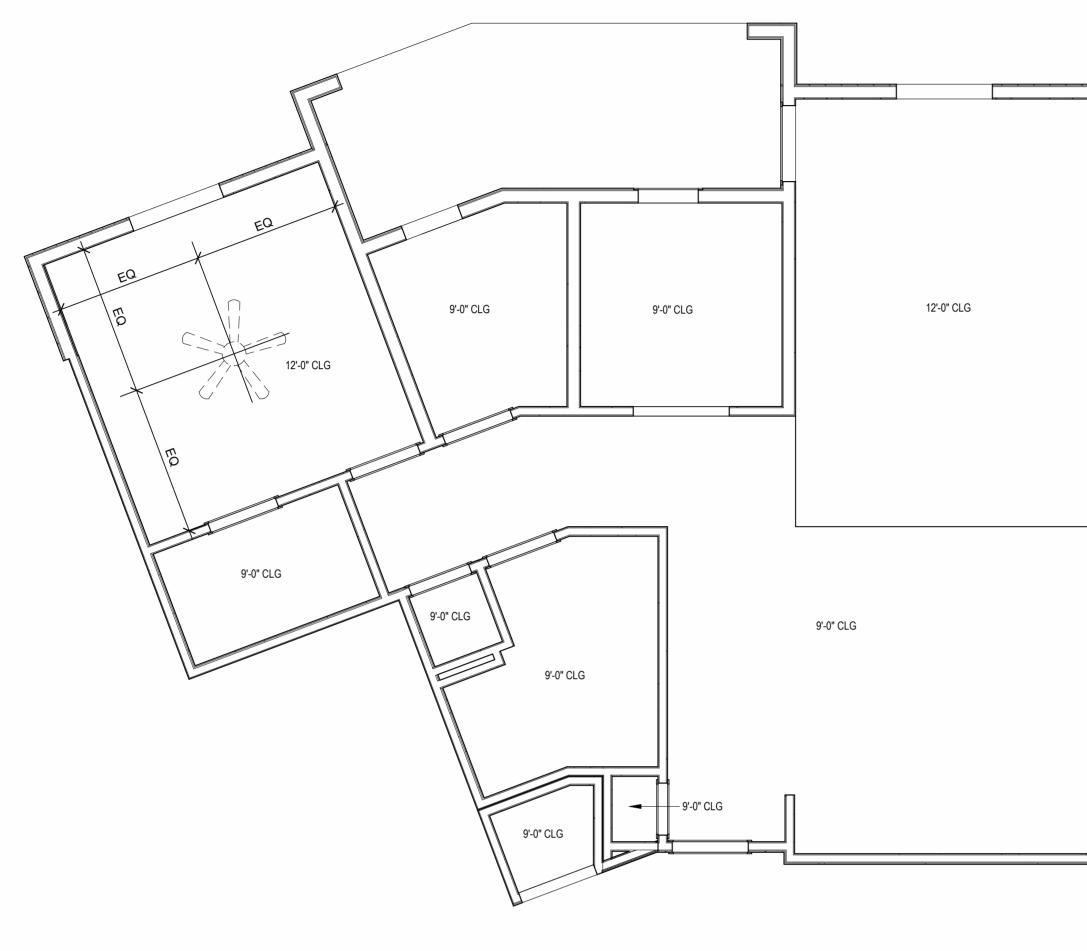

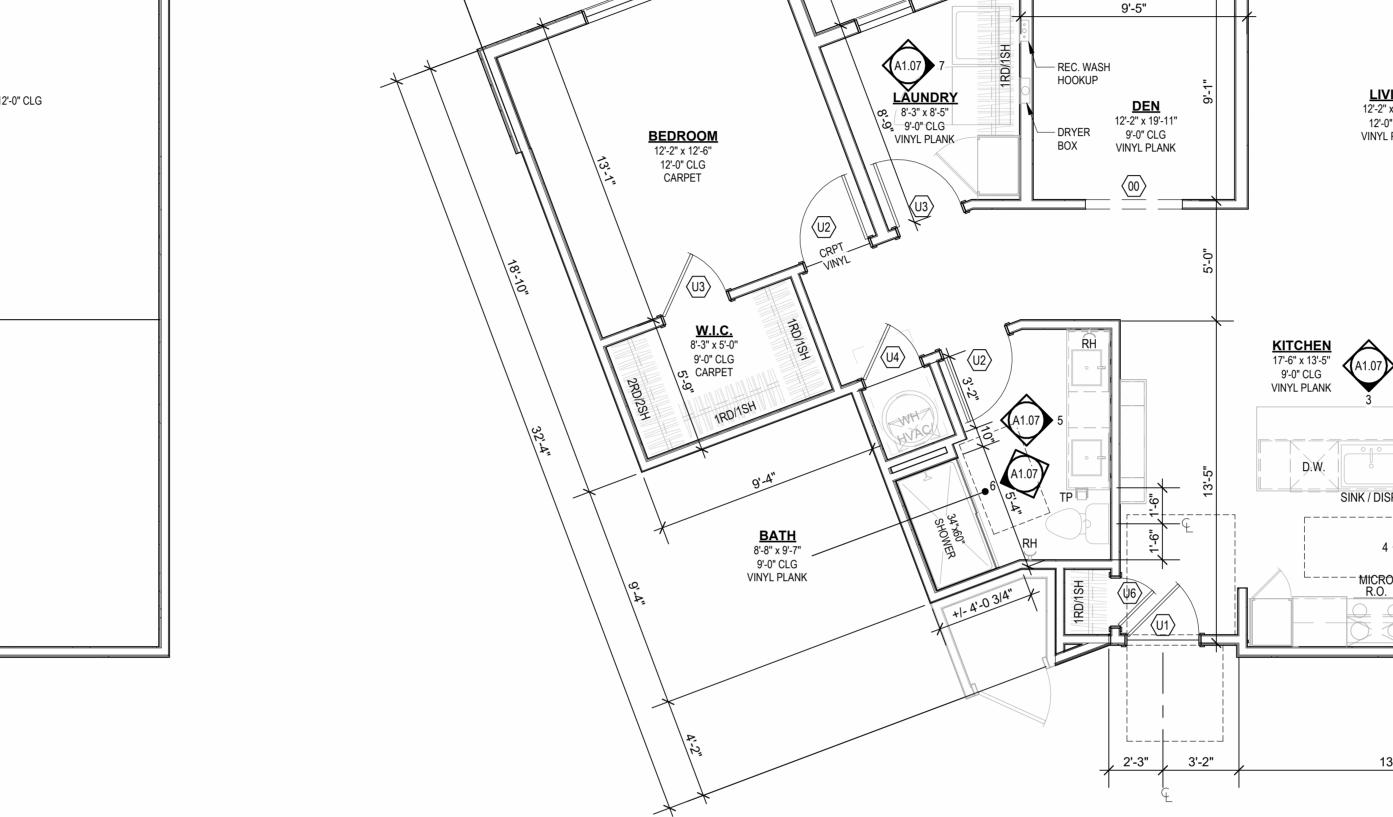
B UNIT B3 - 4TH FLOOR RCP




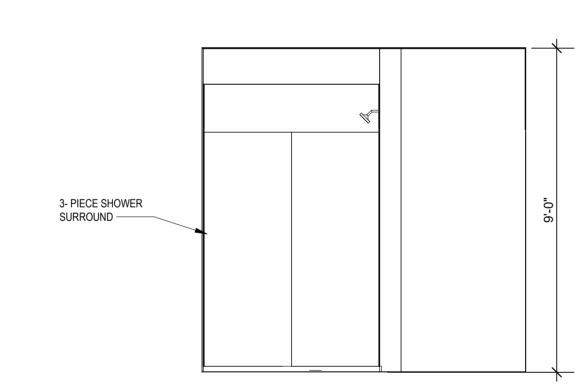


6 BATHROOM

3/8" = 1'-0"

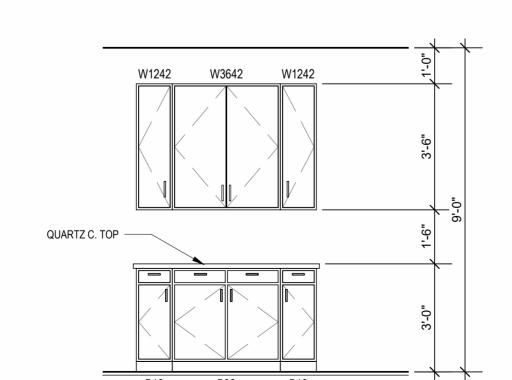

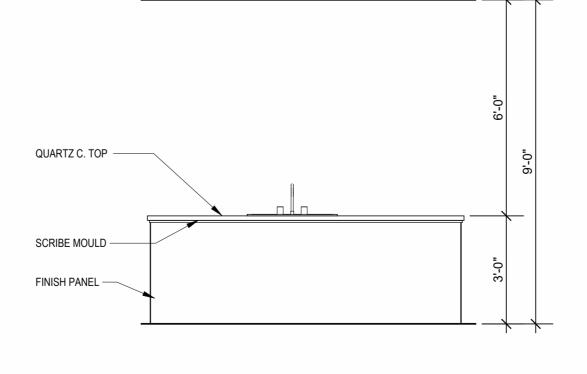

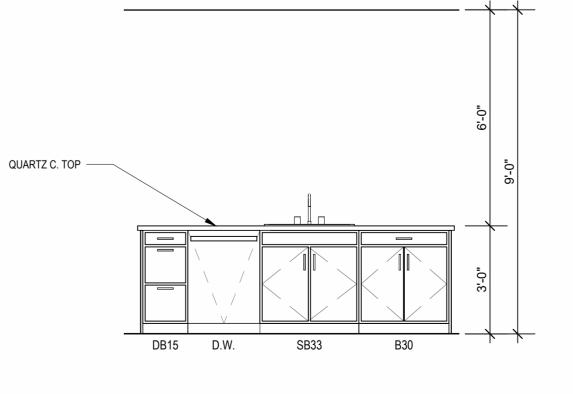

+/- 24'-10"

6'-9"

LIVING 12'-2" x 17'-9" 12'-0" CLG


VINYL PLANK

6'-5"

4'-9"

+/- 11'-8"

+/- 6'-11"

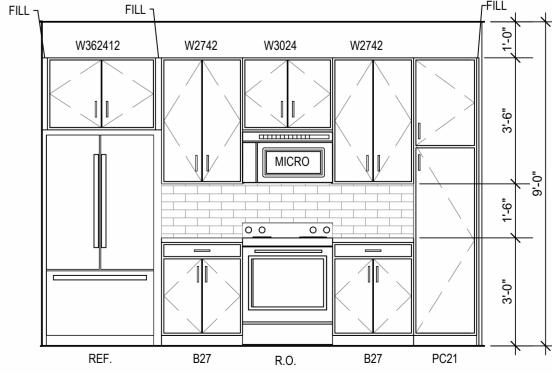

INTERIOR ELEVATION KITCHEN

3/8" = 1'-0"


INTERIOR ELEVATION
KITCHEN

3/8" = 1'-0"


 \triangle REVISIONS

LEE'S SUMMIT, MO

DATE **03.15.2023** ЈОВ NO. **705921** DRAWN BY TSC/SIW 4/11/2023 **CITY COMMENTS** SHEET NAME **UNIT B3 PLANS**

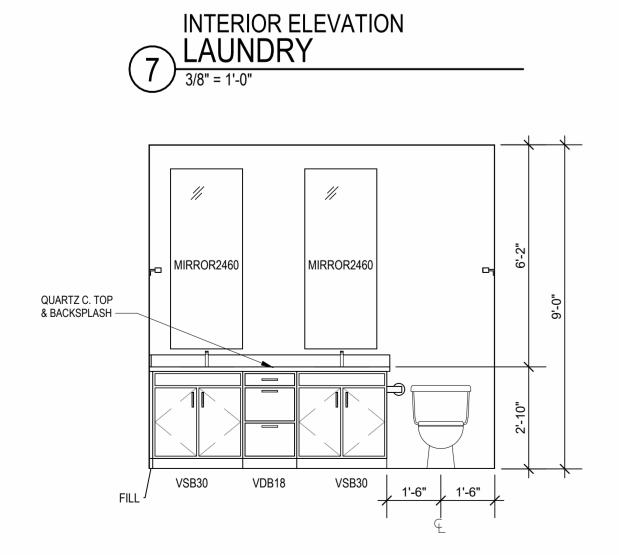

1RD/1SH

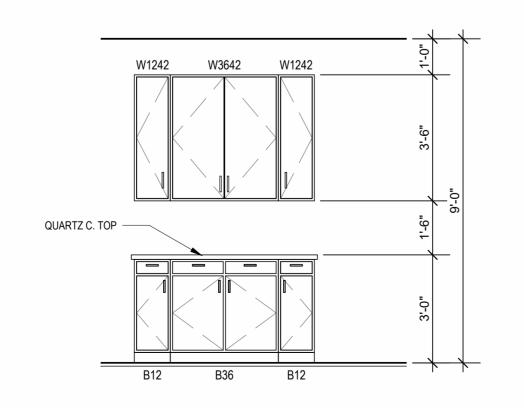



DRYER BOX -

REFER TO SHEETS A0.40, A0.41 AND A0.42 FOR MOUNTING HEIGHTS AND REFER TO BUILDING PLANS AND EXTERIOR ELEVATIONS FOR ADDITIONAL EXTERIOR ARCHITECTURAL ELEMENTS INCLUDING BALCONY LOCATIONS AND CONFIGURATIONS, COLUMNS, WINDOWS/TRANSOMS, AND PATIO DOOR INFORMATION. RETURNS AT FENESTRATION CONDITIONS.

4. USE TEAR-AWAY BEAD, BACKER ROD, AND CAULK AT ALL DRYWALL ALL DIMENSIONS AND NOTES STATING "CLEAR", "MIN" OR "MAX" ARE FROM FINISH FACE TO FINISH FACE. PROVIDE BLOCKING FOR ALL TV LOCATIONS, WALL HUNG CABINETS, SHELVING, GRAB BARS, AND OTHER WALL MOUNTED ITEMS. LANDINGS AND FLOORS ON EITHER SIDE OF DOORWAYS SHALL NOT BE

MORE THAN 1/2" LOWER THAN DOORWAY THRESHOLD. PROVIDE SAFETY GLAZING AT HAZARDOUS LOCATIONS PER IBC SECTION 2406. SEE PLANS FOR LOCATIONS. PROVIDE APPROVED SMOKE DETECTORS AND REQUIRED EMERGENCY FIXTURES WIRED INTO THE BUILDING'S PRIMARY POWER SYSTEM PER IBC SECTION 907.2.10. SEE MECHANICAL PLANS FOR LOCATIONS. ALL EXPOSED EDGES OF FINISHES TO BE DRESSED WITH APPROPRIATE UNIT DEMISING WALLS AND FLOOR/CEILING ASSEMBLIES SEPARATING

WHEN TUBS AND SHOWERS ARE LOCATED ADJACENT TO A FIRE RATED ASSEMBLY, EXTEND GYPSUM BOARD BEHIND AND PROVIDE INSULATION. VERIFY ALL TUB AND SHOWER WALL LENGTHS AND DIMENSION WITH ACTUAL TUB OR SHOWER PROVIDED. CONTRACTOR TO COORDINATE FRAMING WITH TUB MANUFACTURER AND TUB DETAILS. MATCH SHOE FINISH TO CABINET FINISH WHERE ADJACENT TO BASE AVOID WATER LINES IN EXTERIOR WALLS. WHERE NOT POSSIBLE, INSTALL

DRYER ALWAYS ON THE RIGHT. CONTRACTOR TO FIELD COORDINATE. ALL WINDOWS TO RECEIVE 5/4X STOOL WITH 1X3 APRON & DRYWALL RETURNS ON JAMBS & HEAD. DEVICE TRIMS & DEVICE FACES TO CLOSELY MATCH THE COLOR OF THE SURFACE THEY ARE APPLIED TO. ALL PANTRY CABINETS & CABINETS ABOVE REFRIGERATOR SHALL BE 12" DEEP AND RECEIVE END PANELS WHERE EXPOSED. REFER TO FLOOR PLANS AND ROOF PLANS FOR ADDITIONAL RAISED PLATE LINES AND VAULTED CEILING INFORMATION.


ALL BATHROOM HARDWARE FINISHES TO MATCH, INCLUDING SHOWER DOOR FRAMES, UNLESS SPECIFICALLY NOTED BY INTERIOR DESIGNER. G.C. SHALL SUBMIT AVAILABLE HARDWARE FINISHES TO ARCHITECT WHERE AN EXACT MATCH CANNOT BE MADE. ALL PLUMBING PENETRATIONS TO RECEIVE ESCUTCHEON TRIM RINGS TO

MATCH ADJACENT FIXTURE FINISH. FIRE EXTINGUISHER (RE: SPECIFICATION) SHALL BE PROVIDED AND LOCATED IN SINK BASE CABINET UNDER KITCHEN SINK, U.N.O.


DWELLING UNITS SHALL MEET OR EXCEED 50 S.T.C. TEST PER IBC SECTION FOAM INSULATION BETWEEN WATER LINES & SHEATHING. IN SIDE-BY-SIDE LAUNDRY CONFIGURATION, WASHER ALWAYS ON THE LEFT.


NOT FOR

CONSTRUCTION

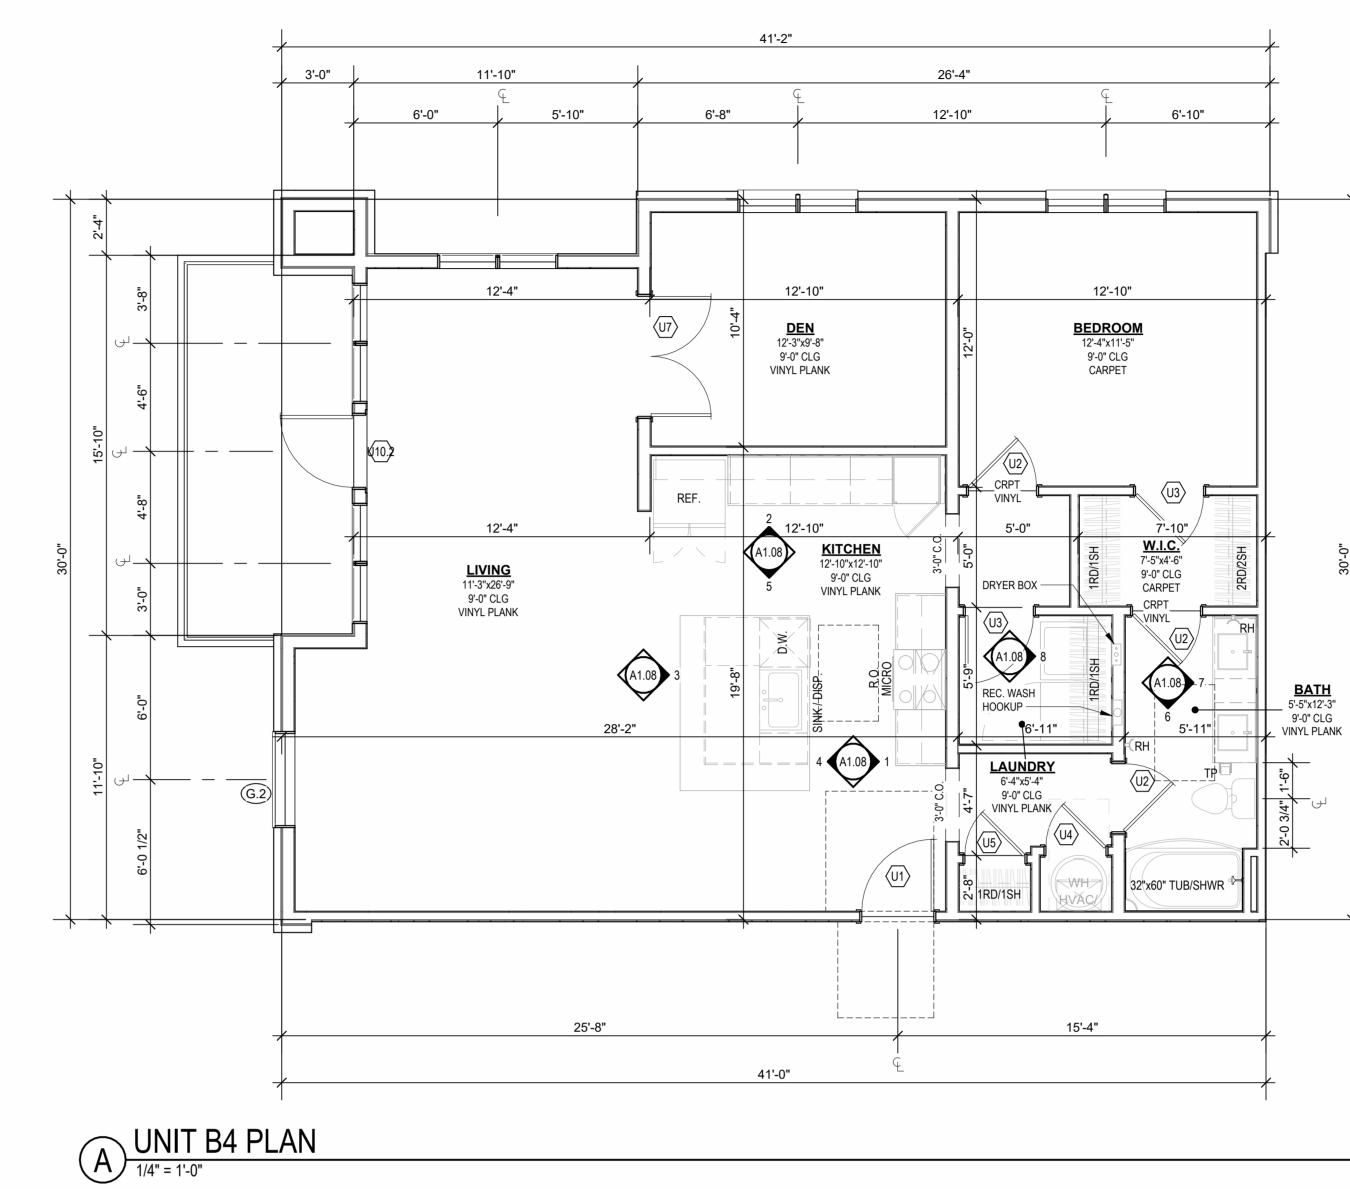

B UNIT B4 - RCP

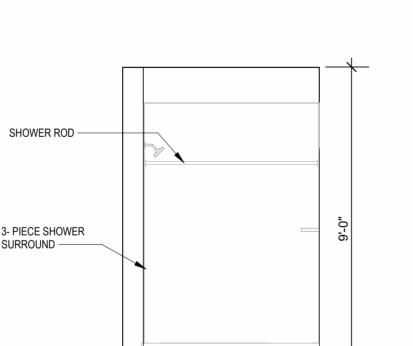

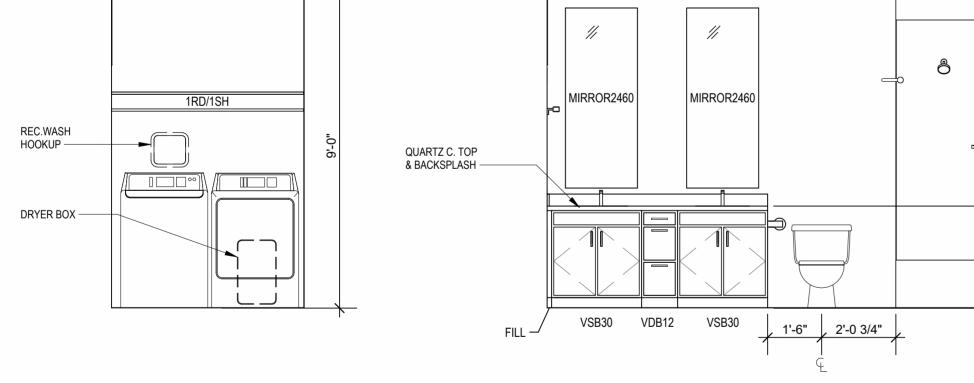



9' - 0" CLG.


9' - 0" CLG.


9'-0" CLG.


9' - 0" CLG.

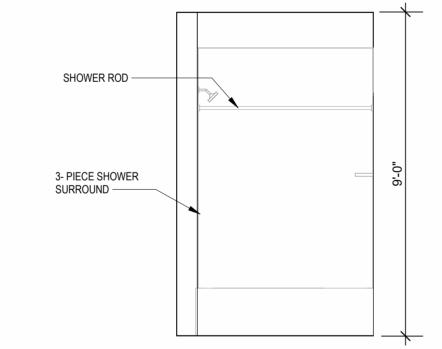


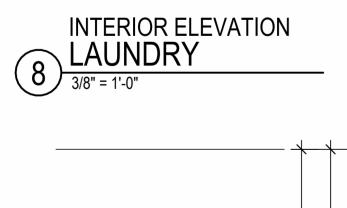

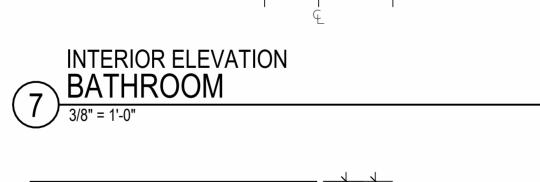

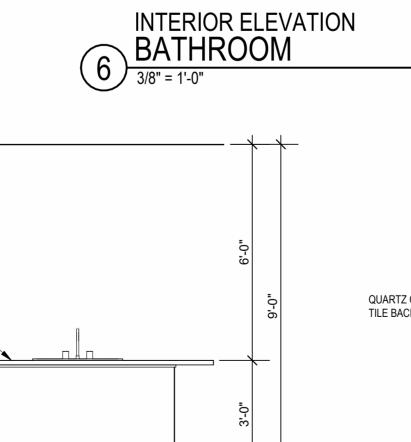


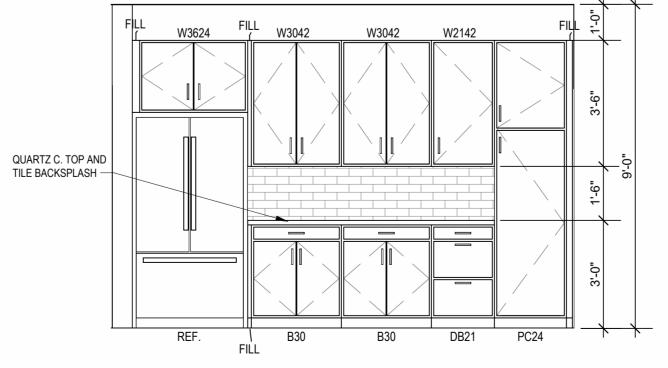

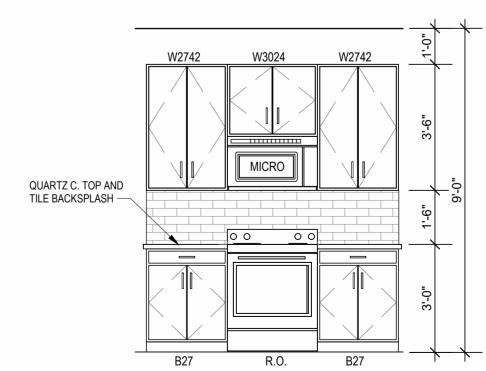

5'-5"x12'-3"

9'-0" CLG

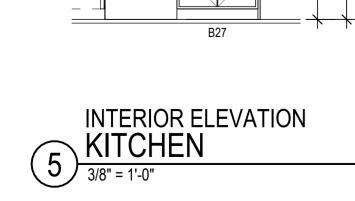

QUARTZ C-TOP —



QUARTZ C- TOP —

INTERIOR ELEVATION KITCHEN

3/8" = 1'-0"

QUARTZ C- TOP -

SCRIBE MOULD -

FINISH PANEL —



INTERIOR ELEVATION
KITCHEN

3/8" = 1'-0"

DRAWING RELEASE LOG

O 3.15.2023 - PERMIT SUBMITTAL

LEE'S SUMMIT,

 \triangle REVISIONS


Јов No. **705921** 03.15.2023 DRAWN BY TSC/SIW 4/11/2023 **CITY COMMENTS** SHEET NAME
UNIT B4 PLANS

SHOWER ROD -

3- PIECE SHOWER

QUARTZ C-TOP —

SURROUND ---

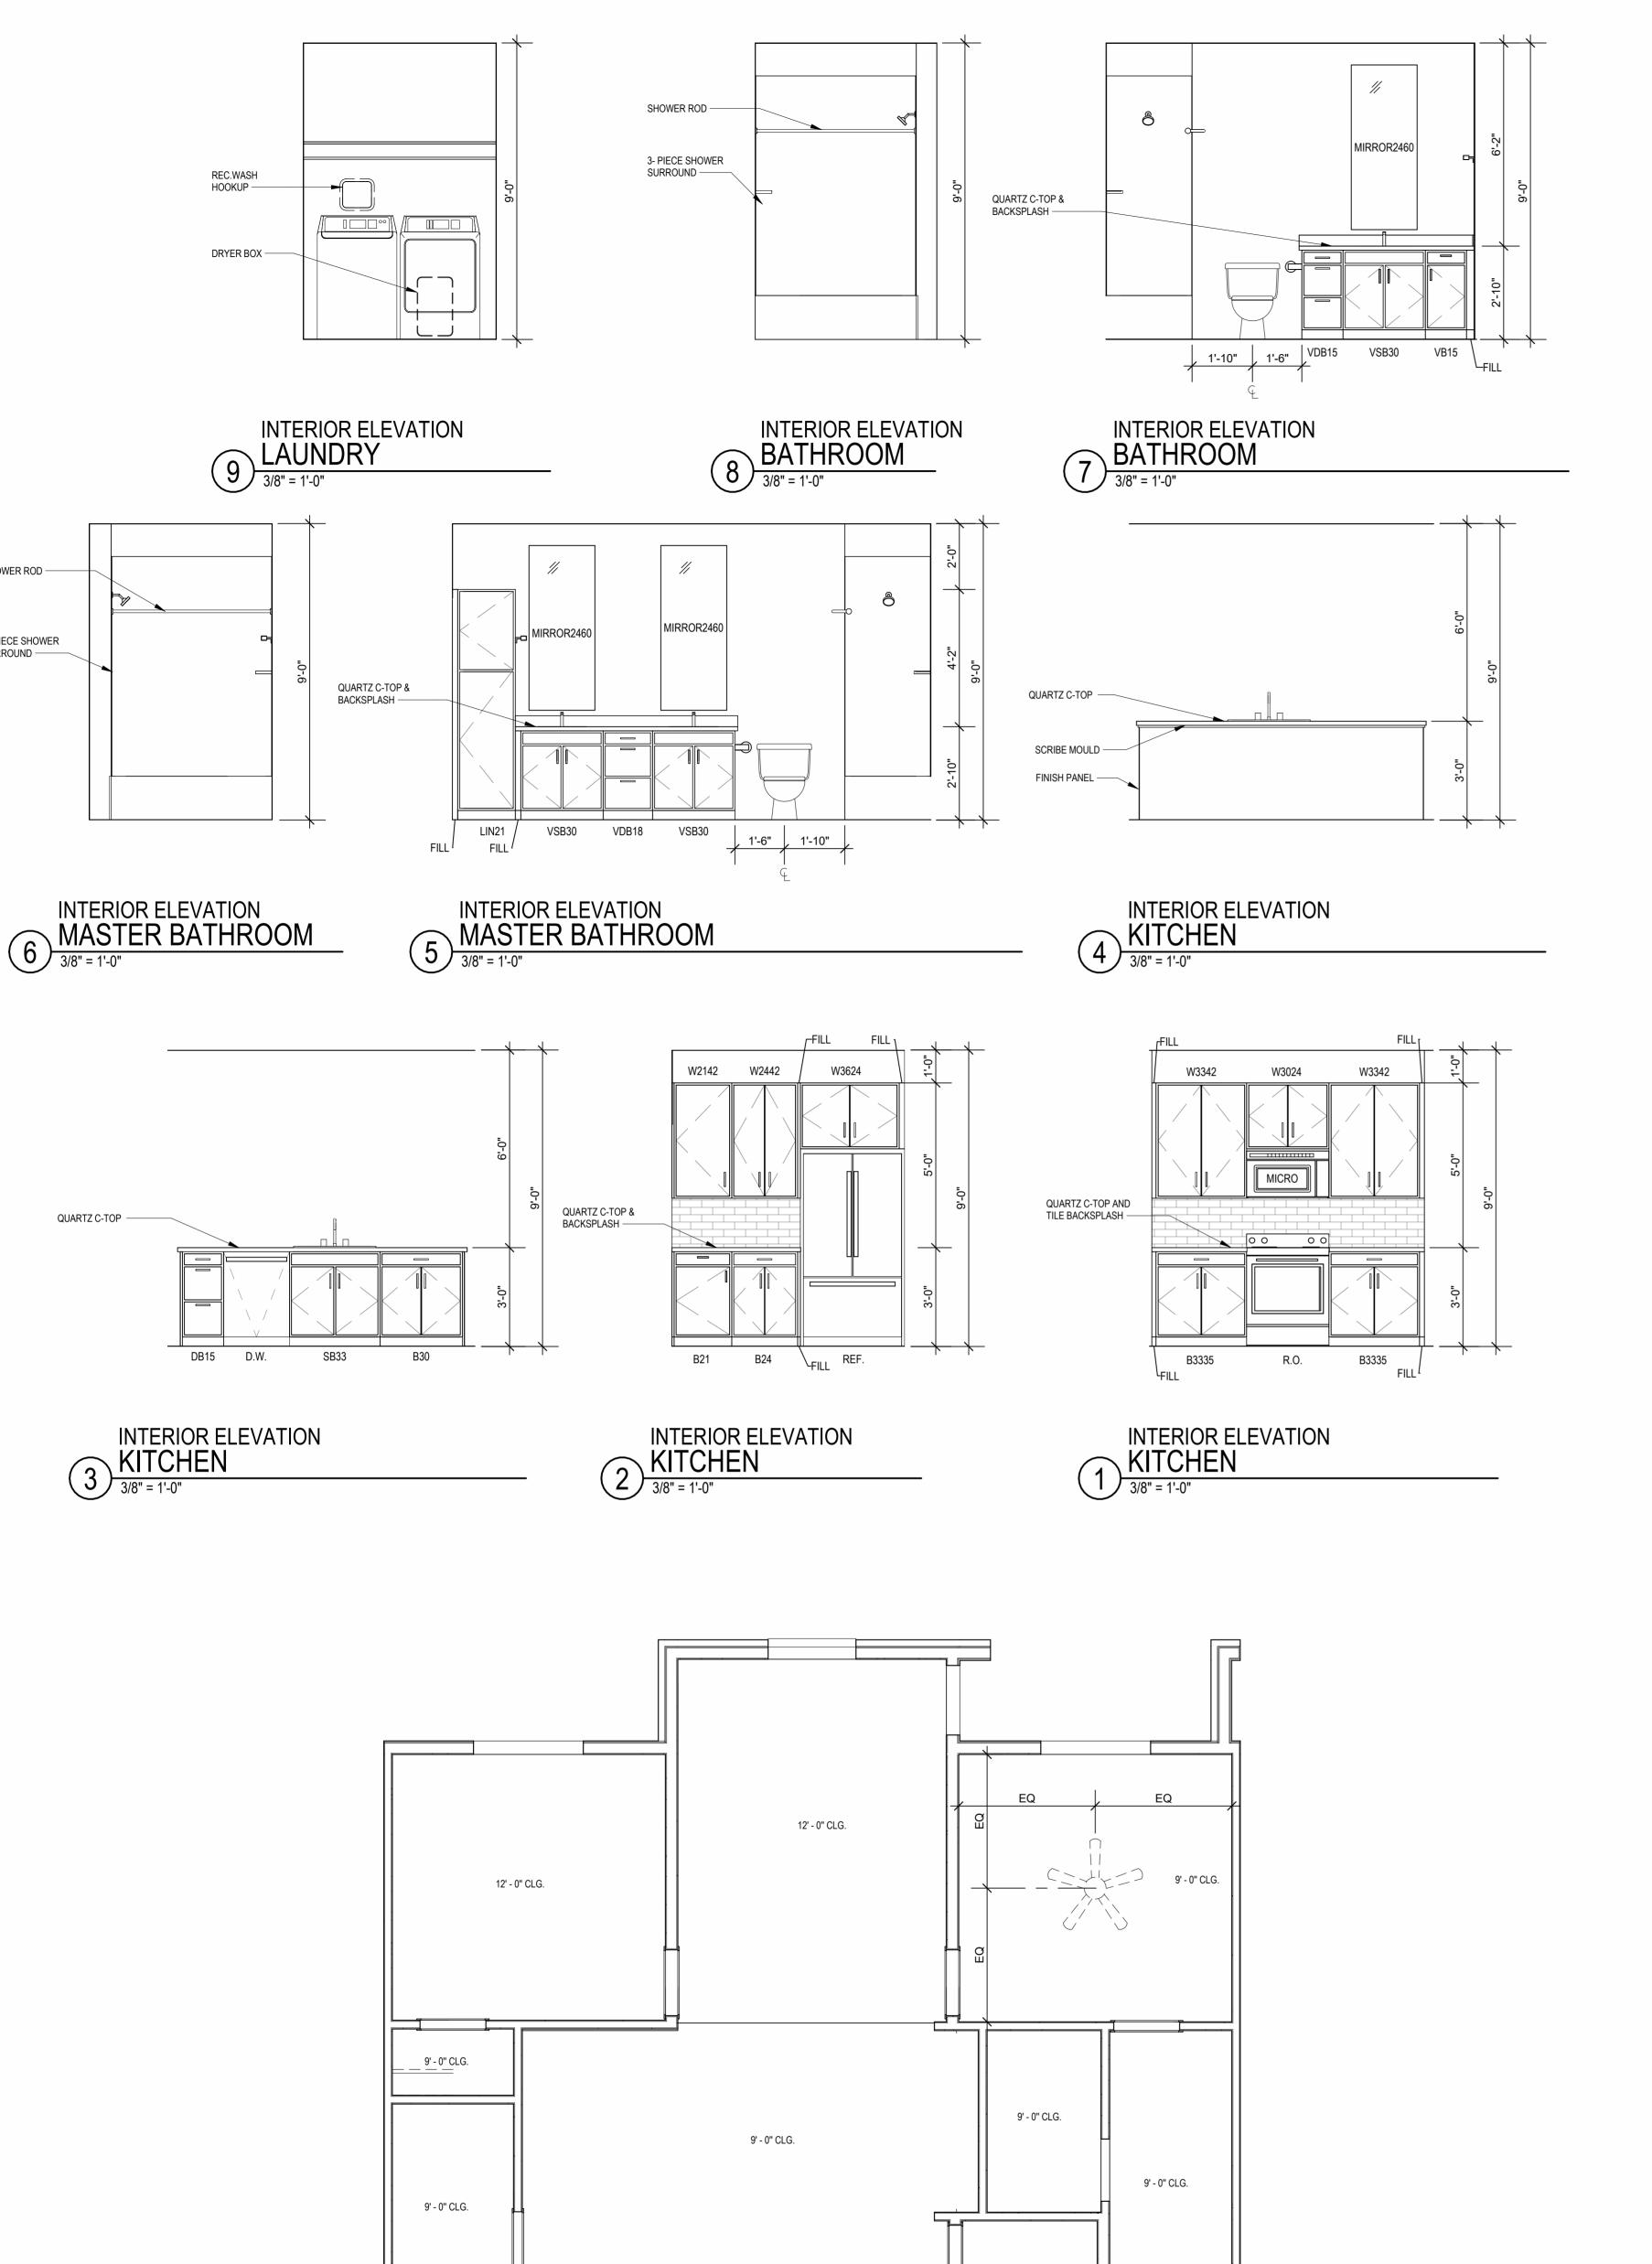


9' - 0" CLG.

9' - 0" CLG

9' - 0" CLG.


REFLECTED CEILING PLAN
UNIT C1 - 4TH FLOOR RCP


1/4" = 1'-0"

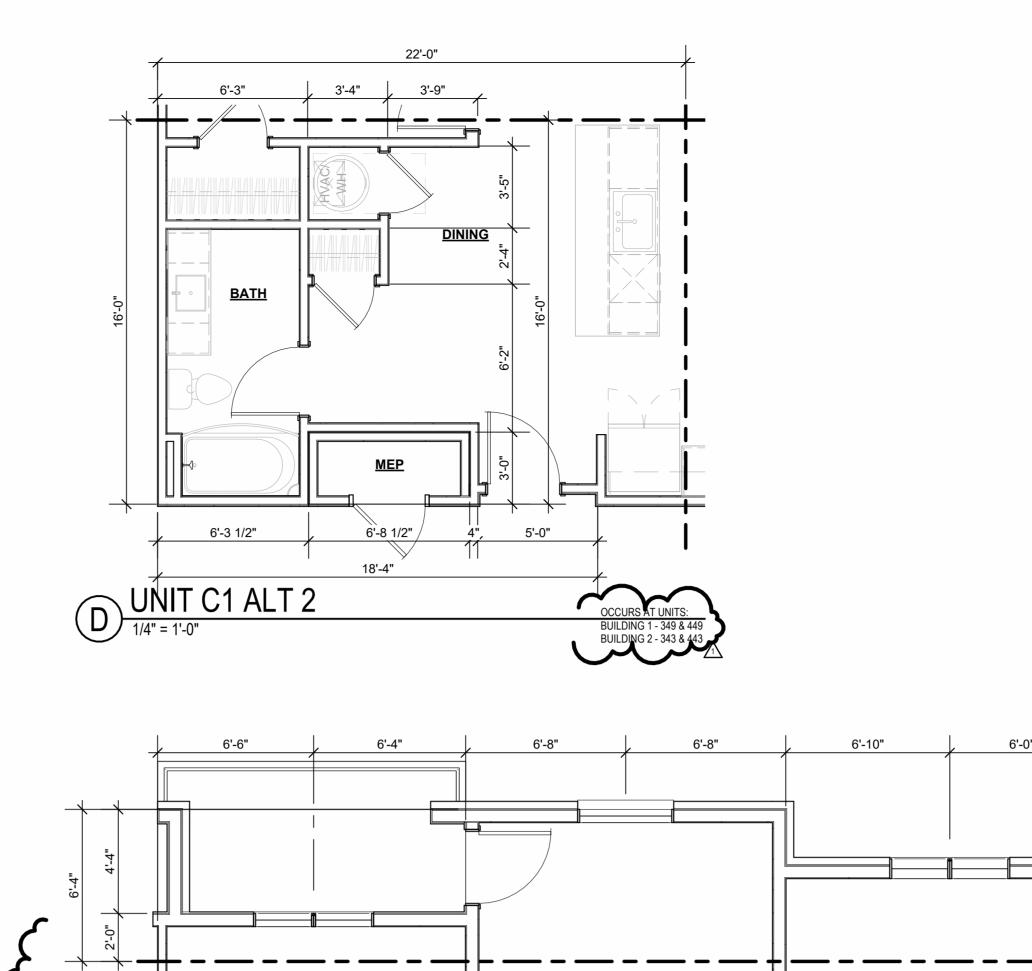

UNIT PLAN
UNIT C1 ALT 3

1/4" = 1'-0"

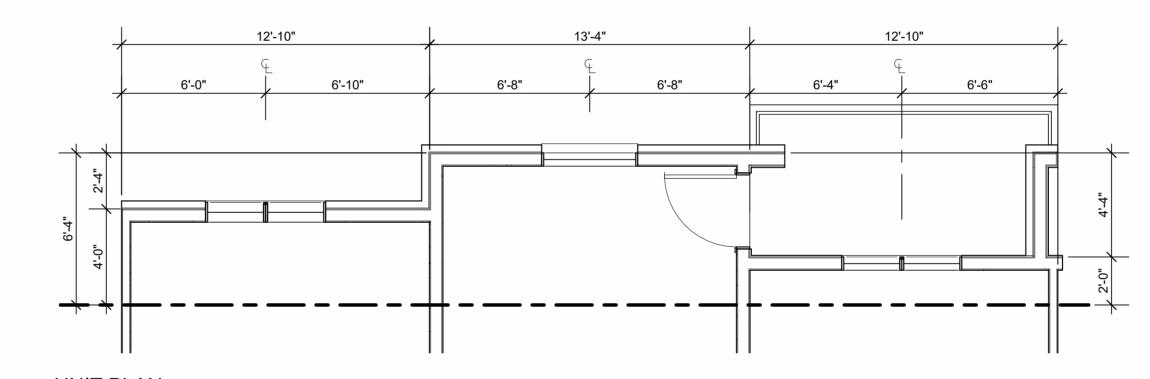

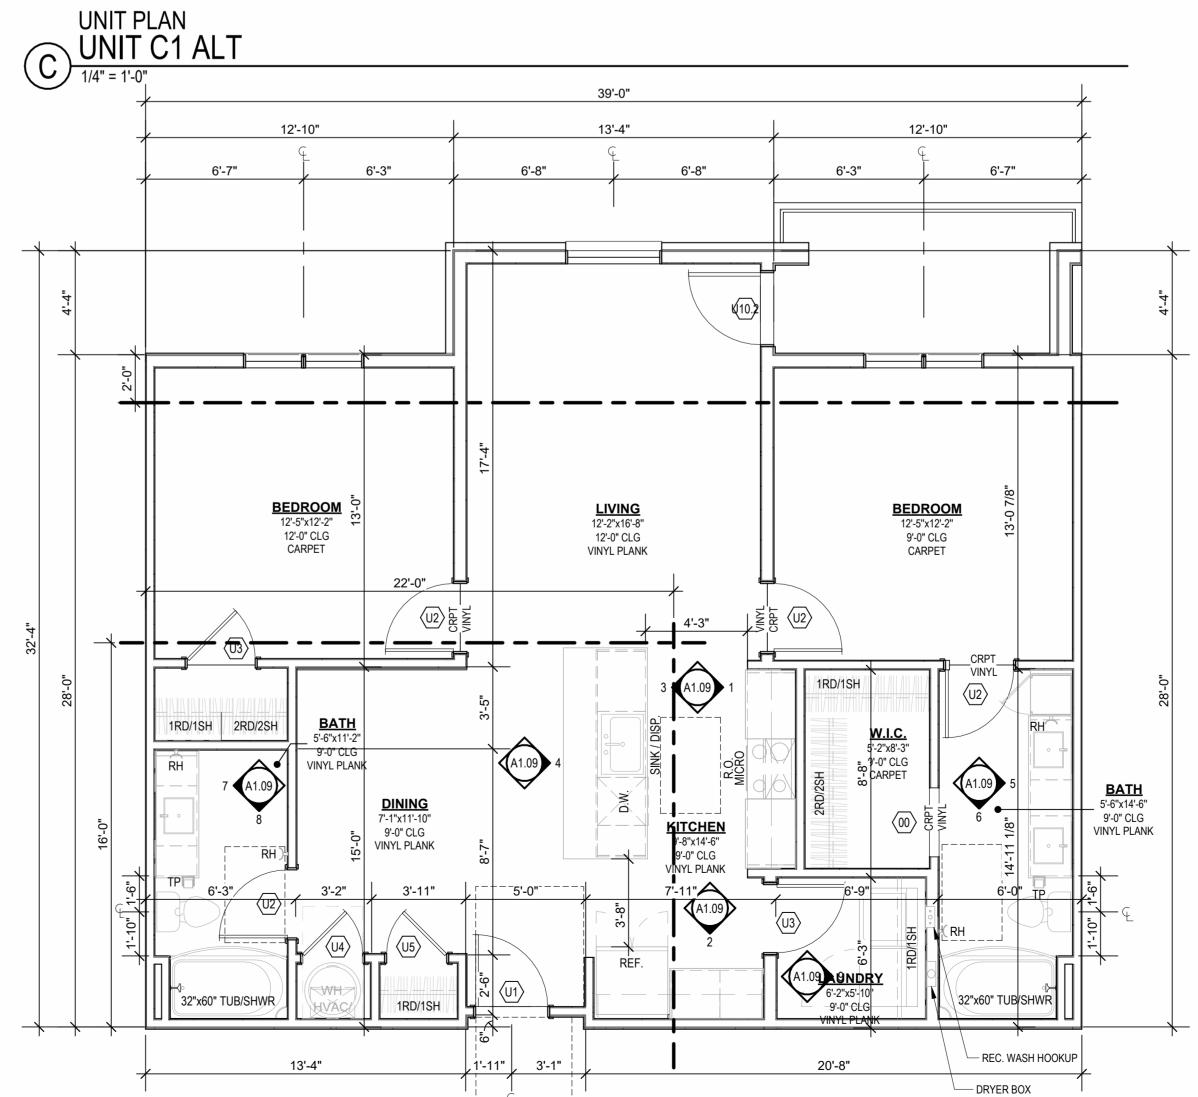

UNIT PLAN
UNIT C1

1/4" = 1'-0"

UNIT PLAN GENERAL NOTES:

REFER TO ASSEMBLY SHEET SERIES A0.30 FOR ASSEMBLY DIMENSION ORIGINS AND THICKNESS. REFER TO SHEETS A0.40, A0.41 AND A0.42 FOR MOUNTING HEIGHTS AND ACCESSIBILITY REQUIREMENTS. REFER TO BUILDING PLANS AND EXTERIOR ELEVATIONS FOR ADDITIONAL EXTERIOR ARCHITECTURAL ELEMENTS INCLUDING BALCONY LOCATIONS

AND CONFIGURATIONS, COLUMNS, WINDOWS/TRANSOMS, AND PATIO DOOR INFORMATION. USE TEAR-AWAY BEAD, BACKER ROD, AND CAULK AT ALL DRYWALL RETURNS AT FENESTRATION CONDITIONS. ALL DIMENSIONS AND NOTES STATING "CLEAR", "MIN" OR "MAX" ARE FROM FINISH FACE TO FINISH FACE.

PROVIDE BLOCKING FOR ALL TV LOCATIONS, WALL HUNG CABINETS, SHELVING, GRAB BARS, AND OTHER WALL MOUNTED ITEMS. LANDINGS AND FLOORS ON EITHER SIDE OF DOORWAYS SHALL NOT BE MORE THAN 1/2" LOWER THAN DOORWAY THRESHOLD. PROVIDE SAFETY GLAZING AT HAZARDOUS LOCATIONS PER IBC SECTION 2406. SEE PLANS FOR LOCATIONS. PROVIDE APPROVED SMOKE DETECTORS AND REQUIRED EMERGENCY FIXTURES WIRED INTO THE BUILDING'S PRIMARY POWER SYSTEM PER IBC SECTION 907.2.10. SEE MECHANICAL PLANS FOR LOCATIONS.

ALL EXPOSED EDGES OF FINISHES TO BE DRESSED WITH APPROPRIATE FINISH STRIP. UNIT DEMISING WALLS AND FLOOR/CEILING ASSEMBLIES SEPARATING DWELLING UNITS SHALL MEET OR EXCEED 50 S.T.C. TEST PER IBC SECTION WHEN TUBS AND SHOWERS ARE LOCATED ADJACENT TO A FIRE RATED

ASSEMBLY, EXTEND GYPSUM BOARD BEHIND AND PROVIDE INSULATION. VERIFY ALL TUB AND SHOWER WALL LENGTHS AND DIMENSION WITH ACTUAL TUB OR SHOWER PROVIDED. CONTRACTOR TO COORDINATE FRAMING WITH TUB MANUFACTURER AND TUB DETAILS. MATCH SHOE FINISH TO CABINET FINISH WHERE ADJACENT TO BASE AVOID WATER LINES IN EXTERIOR WALLS. WHERE NOT POSSIBLE, INSTALL

FOAM INSULATION BETWEEN WATER LINES & SHEATHING. IN SIDE-BY-SIDE LAUNDRY CONFIGURATION, WASHER ALWAYS ON THE LEFT, DRYER ALWAYS ON THE RIGHT. CONTRACTOR TO FIELD COORDINATE. ALL WINDOWS TO RECEIVE 5/4X STOOL WITH 1X3 APRON & DRYWALL RETURNS ON JAMBS & HEAD. DEVICE TRIMS & DEVICE FACES TO CLOSELY MATCH THE COLOR OF THE

SURFACE THEY ARE APPLIED TO. ALL PANTRY CABINETS & CABINETS ABOVE REFRIGERATOR SHALL BE 12" DEEP AND RECEIVE END PANELS WHERE EXPOSED.
REFER TO FLOOR PLANS AND ROOF PLANS FOR ADDITIONAL RAISED PLATE LINES AND VAULTED CEILING INFORMATION. ALL BATHROOM HARDWARE FINISHES TO MATCH, INCLUDING SHOWER DOOR FRAMES, UNLESS SPECIFICALLY NOTED BY INTERIOR DESIGNER. G.C. SHALL SUBMIT AVAILABLE HARDWARE FINISHES TO ARCHITECT WHERE AN EXACT MATCH CANNOT BE MADE. ALL PLUMBING PENETRATIONS TO RECEIVE ESCUTCHEON TRIM RINGS TO

MATCH ADJACENT FIXTURE FINISH. FIRE EXTINGUISHER (RE: SPECIFICATION) SHALL BE PROVIDED AND LOCATED IN SINK BASE CABINET UNDER KITCHEN SINK, U.N.O.





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Јов No. **705921** 03.15.2023 **DRAWN BY** TSC/SIW

4/11/2023 CITY COMMENTS SHEET NAME
UNIT C1 PLANS

| LEE'S SUMMIT, MO

ARD RD.

UNIT PLAN GENERAL NOTES: REFER TO ASSEMBLY SHEET SERIES A0.30 FOR ASSEMBLY DIMENSION ORIGINS AND THICKNESS. REFER TO SHEETS A0.40, A0.41 AND A0.42 FOR MOUNTING HEIGHTS AND ACCESSIBILITY REQUIREMENTS. REFER TO BUILDING PLANS AND EXTERIOR ELEVATIONS FOR ADDITIONAL EXTERIOR ARCHITECTURAL ELEMENTS INCLUDING BALCONY LOCATIONS AND CONFIGURATIONS, COLUMNS, WINDOWS/TRANSOMS, AND PATIO DOOR INFORMATION.

4. USE TEAR-AWAY BEAD, BACKER ROD, AND CAULK AT ALL DRYWALL RETURNS AT FENESTRATION CONDITIONS. ALL DIMENSIONS AND NOTES STATING "CLEAR", "MIN" OR "MAX" ARE FROM FINISH FACE TO FINISH FACE.

PROVIDE BLOCKING FOR ALL TV LOCATIONS, WALL HUNG CABINETS, SHELVING, GRAB BARS, AND OTHER WALL MOUNTED ITEMS. LANDINGS AND FLOORS ON EITHER SIDE OF DOORWAYS SHALL NOT BE MORE THAN 1/2" LOWER THAN DOORWAY THRESHOLD. PROVIDE SAFETY GLAZING AT HAZARDOUS LOCATIONS PER IBC SECTION 2406. SEE PLANS FOR LOCATIONS. PROVIDE APPROVED SMOKE DETECTORS AND REQUIRED EMERGENCY FIXTURES WIRED INTO THE BUILDING'S PRIMARY POWER SYSTEM PER IBC SECTION 907.2.10. SEE MECHANICAL PLANS FOR LOCATIONS.


ALL EXPOSED EDGES OF FINISHES TO BE DRESSED WITH APPROPRIATE UNIT DEMISING WALLS AND FLOOR/CEILING ASSEMBLIES SEPARATING DWELLING UNITS SHALL MEET OR EXCEED 50 S.T.C. TEST PER IBC SECTION

12. WHEN TUBS AND SHOWERS ARE LOCATED ADJACENT TO A FIRE RATED ASSEMBLY, EXTEND GYPSUM BOARD BEHIND AND PROVIDE INSULATION. VERIFY ALL TUB AND SHOWER WALL LENGTHS AND DIMENSION WITH ACTUAL TUB OR SHOWER PROVIDED. CONTRACTOR TO COORDINATE FRAMING WITH TUB MANUFACTURER AND TUB DETAILS. MATCH SHOE FINISH TO CABINET FINISH WHERE ADJACENT TO BASE

AVOID WATER LINES IN EXTERIOR WALLS. WHERE NOT POSSIBLE, INSTALL FOAM INSULATION BETWEEN WATER LINES & SHEATHING. IN SIDE-BY-SIDE LAUNDRY CONFIGURATION, WASHER ALWAYS ON THE LEFT, DRYER ALWAYS ON THE RIGHT. CONTRACTOR TO FIELD COORDINATE. ALL WINDOWS TO RECEIVE 5/4X STOOL WITH 1X3 APRON & DRYWALL RETURNS ON JAMBS & HEAD. DEVICE TRIMS & DEVICE FACES TO CLOSELY MATCH THE COLOR OF THE SURFACE THEY ARE APPLIED TO. ALL PANTRY CABINETS & CABINETS ABOVE REFRIGERATOR SHALL BE 12"

DEEP AND RECEIVE END PANELS WHERE EXPOSED. REFER TO FLOOR PLANS AND ROOF PLANS FOR ADDITIONAL RAISED PLATE LINES AND VAULTED CEILING INFORMATION. ALL BATHROOM HARDWARE FINISHES TO MATCH, INCLUDING SHOWER DOOR FRAMES, UNLESS SPECIFICALLY NOTED BY INTERIOR DESIGNER. G.C. SHALL SUBMIT AVAILABLE HARDWARE FINISHES TO ARCHITECT WHERE AN EXACT MATCH CANNOT BE MADE. 22. ALL PLUMBING PENETRATIONS TO RECEIVE ESCUTCHEON TRIM RINGS TO

MATCH ADJACENT FIXTURE FINISH. FIRE EXTINGUISHER (RE: SPECIFICATION) SHALL BE PROVIDED AND LOCATED IN SINK BASE CABINET UNDER KITCHEN SINK, U.N.O.

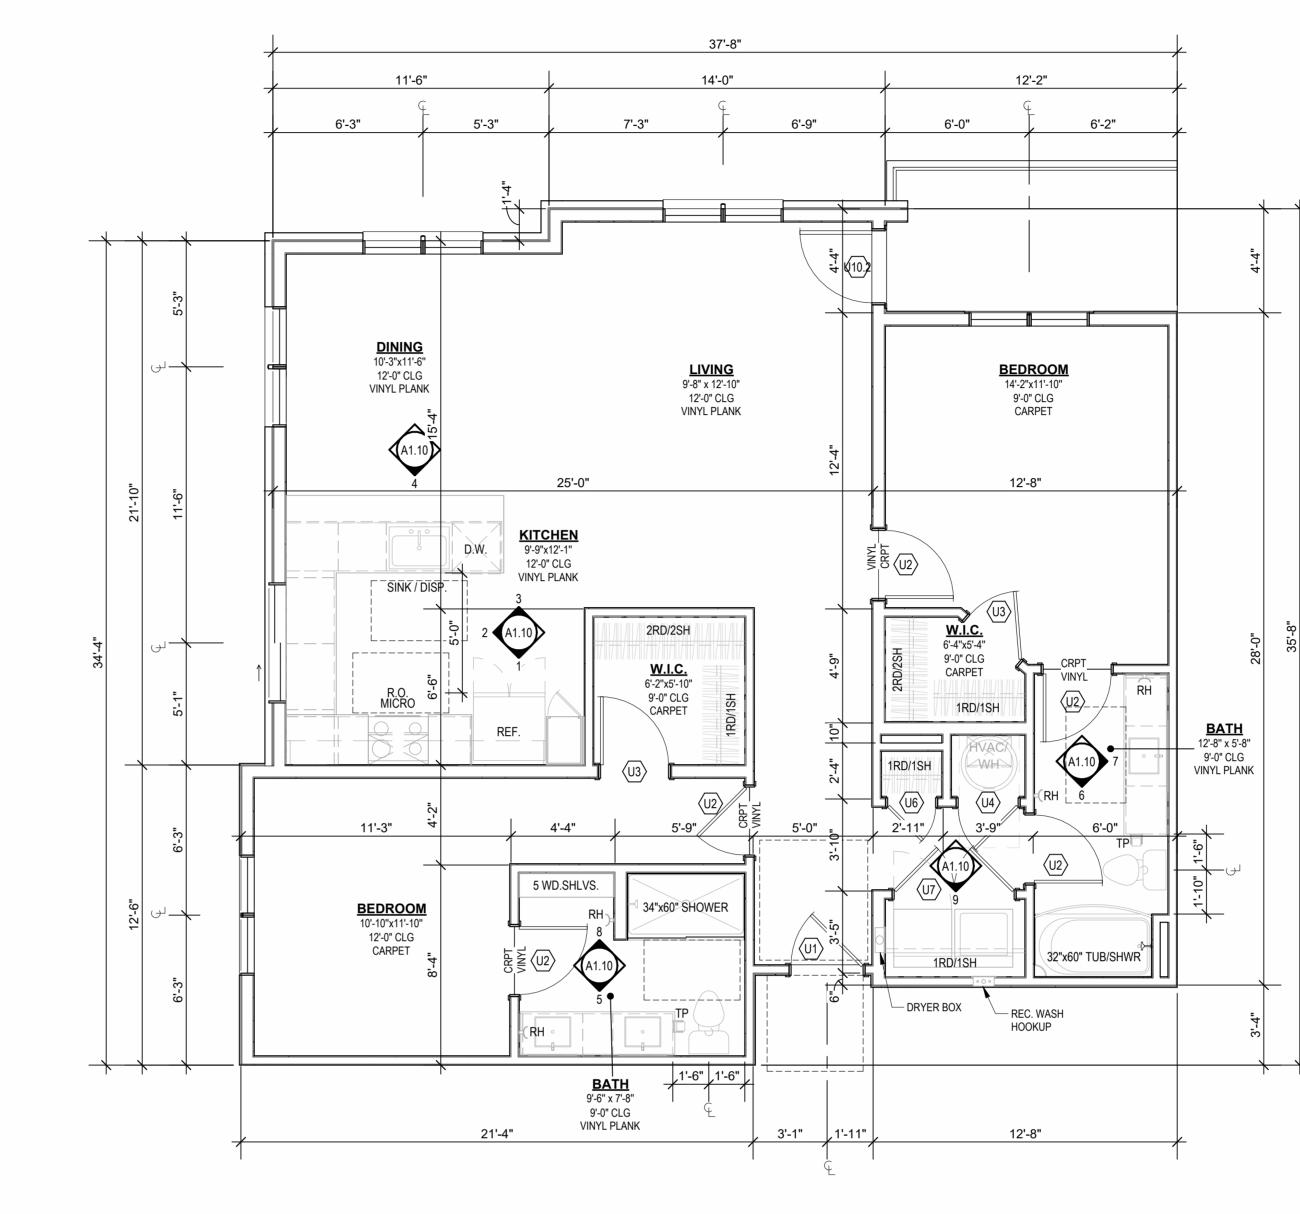



12'-0" CLG


12'-0" CLG

9'-0" CLG

9'-0" CLG

9'-0" CLG

A UNIT C2

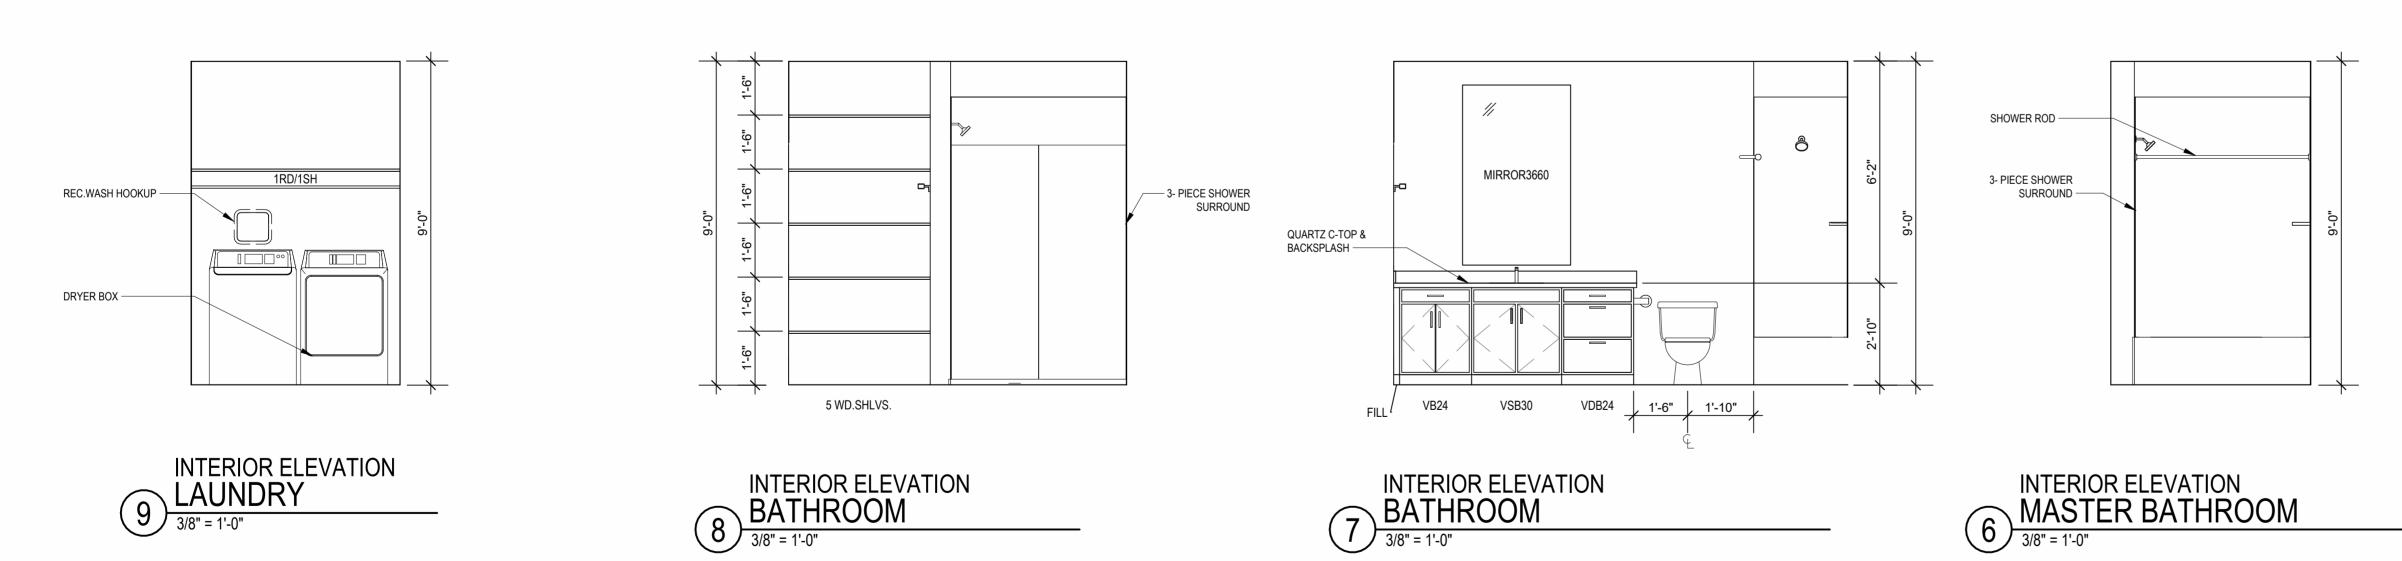

9'-0" CLG


9'-0" CLG

9'-0" CLG

9'-0" CLG 9'-0" CLG


9'-0" CLG


9'-0" CLG

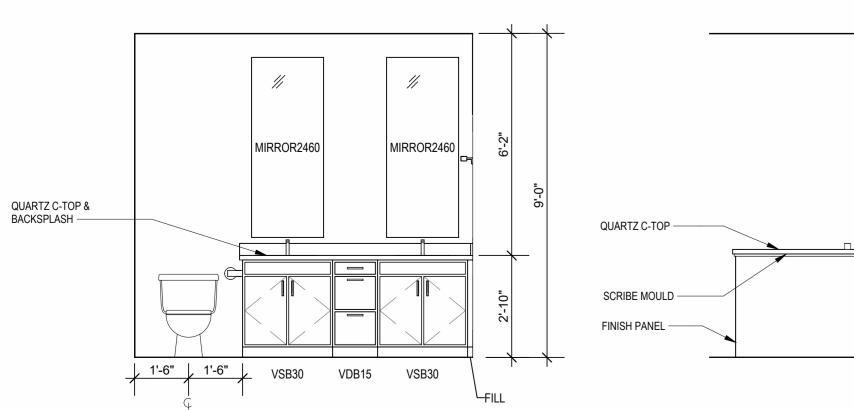



INTERIOR ELEVATION
MASTER BATHROOM

3/8" = 1'-0"

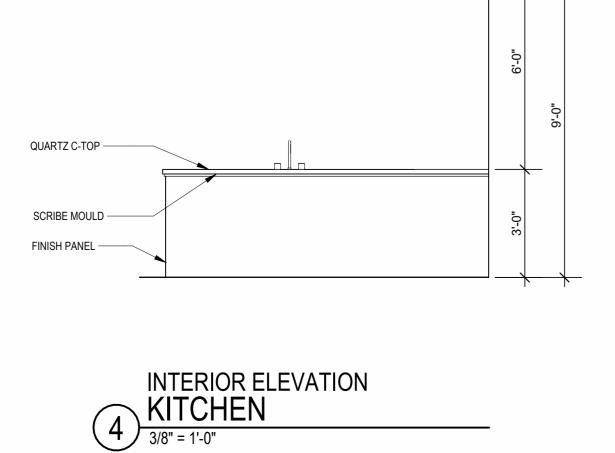

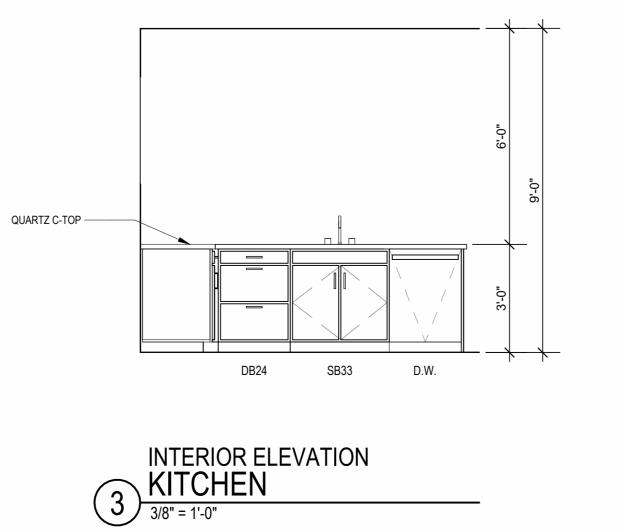

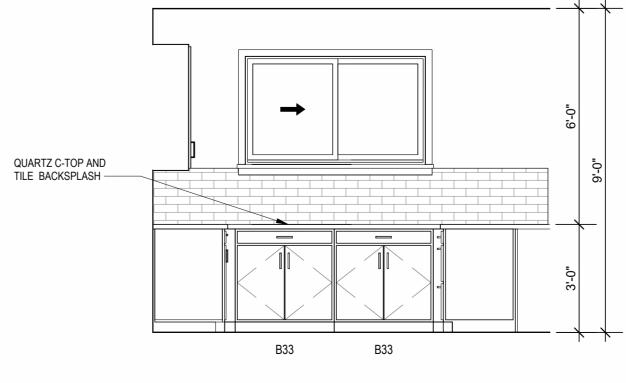

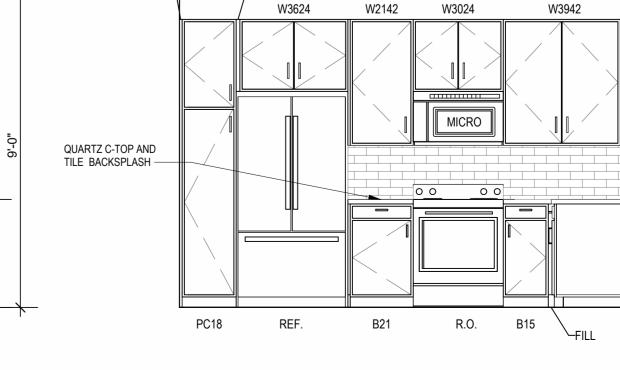

W3942



INTERIOR ELEVATION KITCHEN

3/8" = 1'-0"

Јов No. **705921** 03.15.2023 **DRAWN BY** TSC/SIW 4/11/2023 CITY COMMENTS SHEET NAME
UNIT C2 PLANS

DRAWING RELEASE LOG

• 03.15.2023 - PERMIT SUBMITTAL

LEE'S SUMMIT, MO

REFER TO ASSEMBLY SHEET SERIES A0.30 FOR ASSEMBLY DIMENSION ORIGINS AND THICKNESS. 2. REFER TO SHEETS A0.40, A0.41 AND A0.42 FOR MOUNTING HEIGHTS AND ACCESSIBILITY REQUIREMENTS.
REFER TO BUILDING PLANS AND EXTERIOR ELEVATIONS FOR ADDITIONAL EXTERIOR ARCHITECTURAL ELEMENTS INCLUDING BALCONY LOCATIONS AND CONFIGURATIONS, COLUMNS, WINDOWS/TRANSOMS, AND PATIO DOOR INFORMATION. USE TEAR-AWAY BEAD, BACKER ROD, AND CAULK AT ALL DRYWALL RETURNS AT FENESTRATION CONDITIONS. ALL DIMENSIONS AND NOTES STATING "CLEAR", "MIN" OR "MAX" ARE FROM FINISH FACE TO FINISH FACE.

PROVIDE BLOCKING FOR ALL TV LOCATIONS, WALL HUNG CABINETS, SHELVING, GRAB BARS, AND OTHER WALL MOUNTED ITEMS. LANDINGS AND FLOORS ON EITHER SIDE OF DOORWAYS SHALL NOT BE MORE THAN 1/2" LOWER THAN DOORWAY THRESHOLD. PROVIDE SAFETY GLAZING AT HAZARDOUS LOCATIONS PER IBC SECTION 2406. SEE PLANS FOR LOCATIONS. PROVIDE APPROVED SMOKE DETECTORS AND REQUIRED EMERGENCY FIXTURES WIRED INTO THE BUILDING'S PRIMARY POWER SYSTEM PER IBC SECTION 907.2.10. SEE MECHANICAL PLANS FOR LOCATIONS. ALL EXPOSED EDGES OF FINISHES TO BE DRESSED WITH APPROPRIATE FINISH STRIP. UNIT DEMISING WALLS AND FLOOR/CEILING ASSEMBLIES SEPARATING


UNIT PLAN GENERAL NOTES:


DWELLING UNITS SHALL MEET OR EXCEED 50 S.T.C. TEST PER IBC SECTION WHEN TUBS AND SHOWERS ARE LOCATED ADJACENT TO A FIRE RATED ASSEMBLY, EXTEND GYPSUM BOARD BEHIND AND PROVIDE INSULATION. VERIFY ALL TUB AND SHOWER WALL LENGTHS AND DIMENSION WITH ACTUAL TUB OR SHOWER PROVIDED. CONTRACTOR TO COORDINATE FRAMING WITH TUB MANUFACTURER AND TUB DETAILS.

MATCH SHOE FINISH TO CABINET FINISH WHERE ADJACENT TO BASE AVOID WATER LINES IN EXTERIOR WALLS. WHERE NOT POSSIBLE, INSTALL FOAM INSULATION BETWEEN WATER LINES & SHEATHING. IN SIDE-BY-SIDE LAUNDRY CONFIGURATION, WASHER ALWAYS ON THE LEFT, DRYER ALWAYS ON THE RIGHT. CONTRACTOR TO FIELD COORDINATE. ALL WINDOWS TO RECEIVE 5/4X STOOL WITH 1X3 APRON & DRYWALL RETURNS ON JAMBS & HEAD. DEVICE TRIMS & DEVICE FACES TO CLOSELY MATCH THE COLOR OF THE


SURFACE THEY ARE APPLIED TO. ALL PANTRY CABINETS & CABINETS ABOVE REFRIGERATOR SHALL BE 12" DEEP AND RECEIVE END PANELS WHERE EXPOSED. REFER TO FLOOR PLANS AND ROOF PLANS FOR ADDITIONAL RAISED PLATE LINES AND VAULTED CEILING INFORMATION. ALL BATHROOM HARDWARE FINISHES TO MATCH, INCLUDING SHOWER DOOR FRAMES, UNLESS SPECIFICALLY NOTED BY INTERIOR DESIGNER. G.C. SHALL SUBMIT AVAILABLE HARDWARE FINISHES TO ARCHITECT WHERE AN EXACT MATCH CANNOT BE MADE. ALL PLUMBING PENETRATIONS TO RECEIVE ESCUTCHEON TRIM RINGS TO


MATCH ADJACENT FIXTURE FINISH. FIRE EXTINGUISHER (RE: SPECIFICATION) SHALL BE PROVIDED AND LOCATED IN SINK BASE CABINET UNDER KITCHEN SINK, U.N.O.

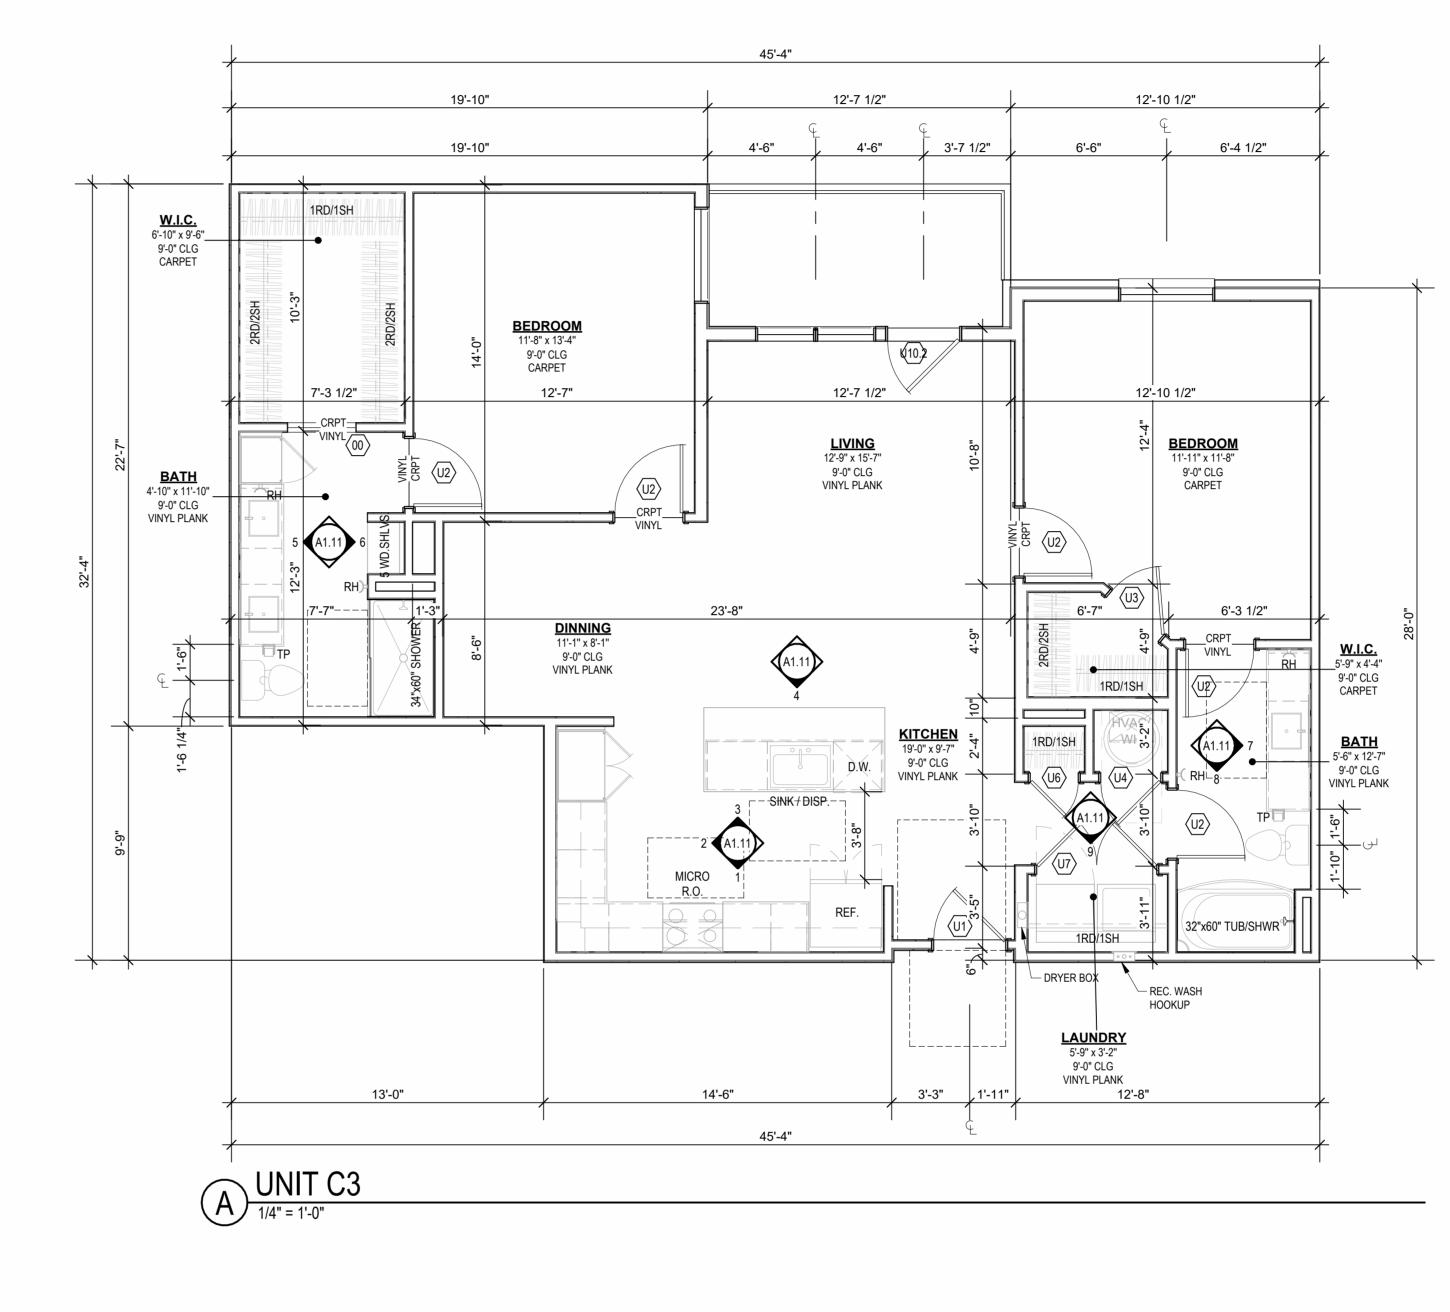

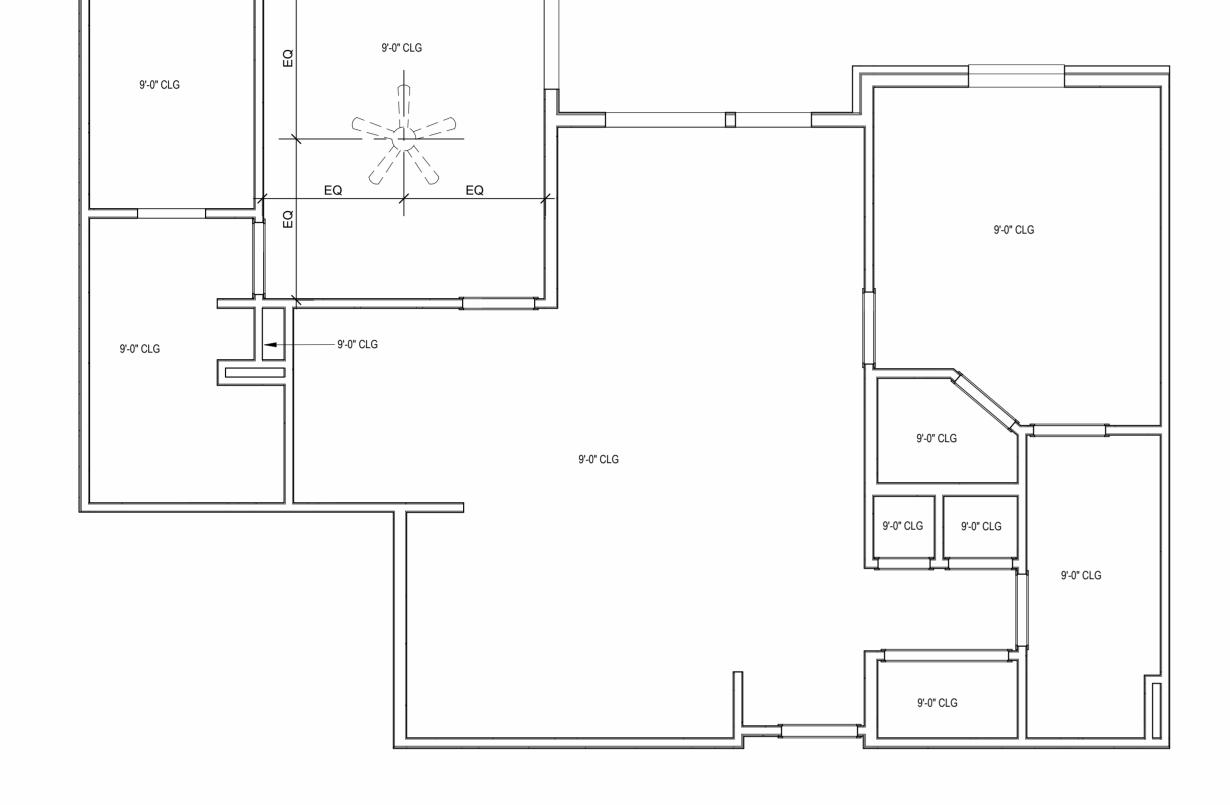

B UNIT C3 - RCP

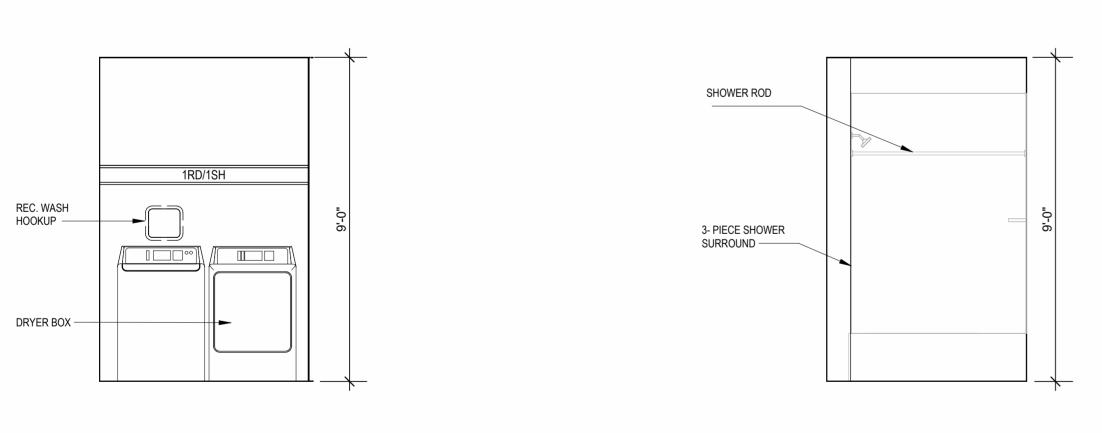


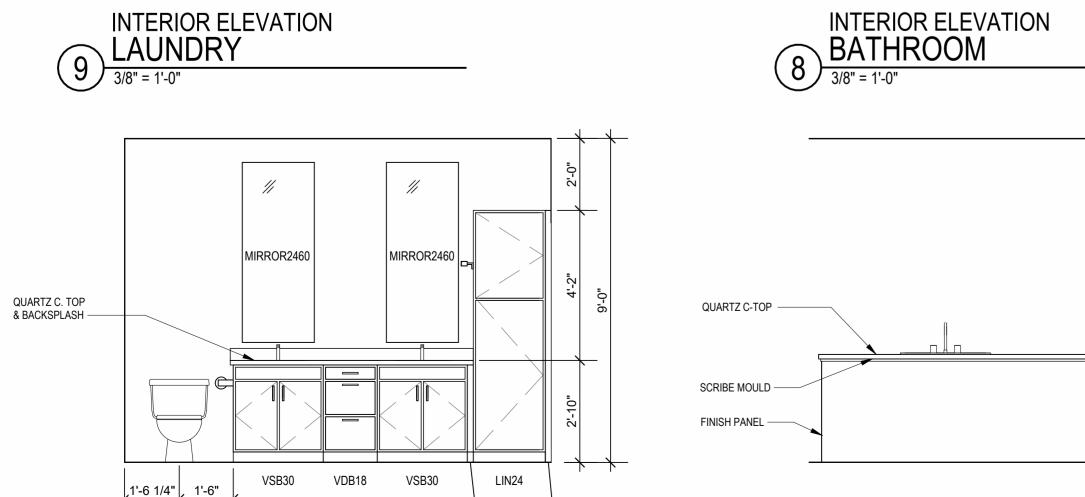



INTERIOR ELEVATION

MASTER BATHROOM


3/8" = 1'-0"

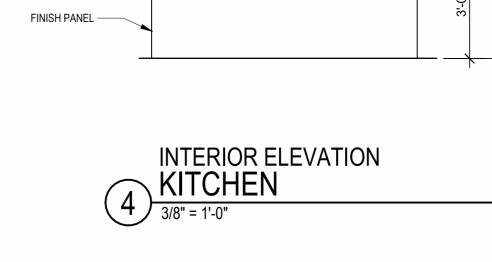


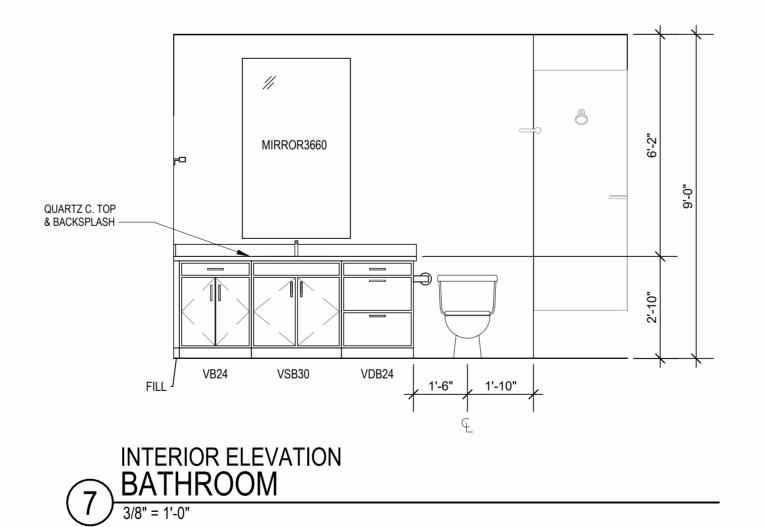

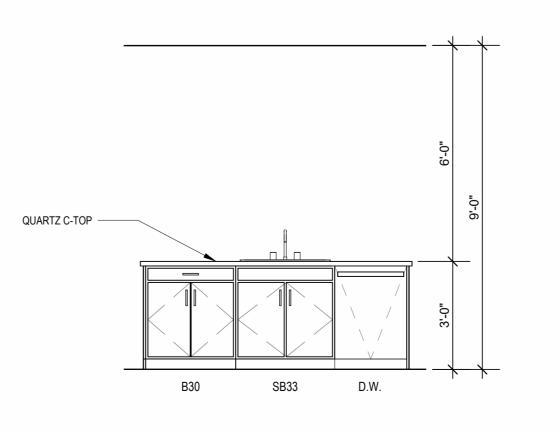




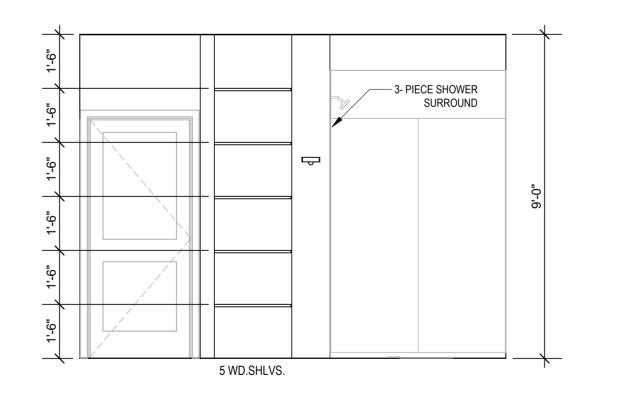

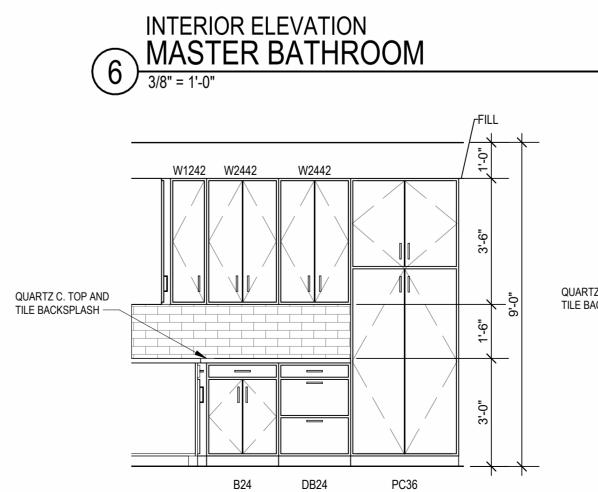



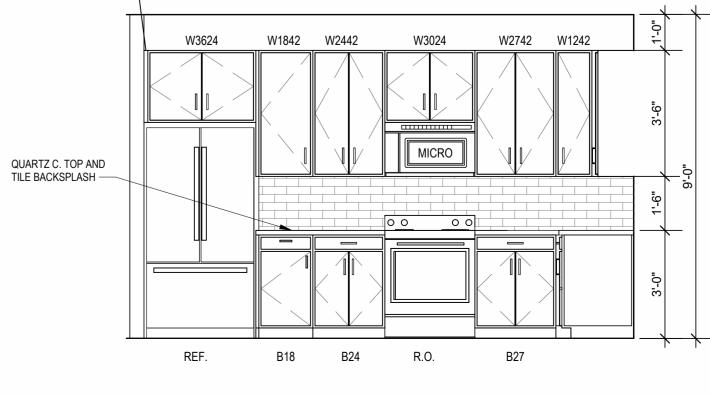

INTERIOR ELEVATION KITCHEN

3/8" = 1'-0"

Јов No. **705921** 03.15.2023

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DRAWING RELEASE LOG

• 03.15.2023 - PERMIT SUBMITTAL

DRAWN BY TSC/SIW 4/11/2023 CITY COMMENTS SHEET NAME **UNIT C3 PLANS**

INTERIOR ELEVATION KITCHEN

3/8" = 1'-0"

INTERIOR ELEVATION KITCHEN

3/8" = 1'-0"

NOT FOR CONSTRUCTION

| LEE'S SUMMIT, MO ARD RD.

 \triangle REVISIONS

Јов No. **705921** 03.15.2023 **DRAWN BY** TSC/SIW 4/11/2023 CITY COMMENTS SHEET NAME
UNIT C4 PLANS

INTERIOR ELEVATION

MASTER BATHROOM

3/8" = 1'-0"

INTERIOR ELEVATION KITCHEN

3/8" = 1'-0"

/2023 3:33:06 PM

UNIT PLAN GENERAL NOTES:

 REFER TO ASSEMBLY SHEET SERIES A0.30 FOR ASSEMBLY DIMENSION ORIGINS AND THICKNESS. REFER TO SHEETS A0.40, A0.41 AND A0.42 FOR MOUNTING HEIGHTS AND ACCESSIBILITY REQUIREMENTS.


REFER TO BUILDING PLANS AND EXTERIOR ELEVATIONS FOR ADDITIONAL EXTERIOR ARCHITECTURAL ELEMENTS INCLUDING BALCONY LOCATIONS

LANDINGS AND FLOORS ON EITHER SIDE OF DOORWAYS SHALL NOT BE PROVIDE SAFETY GLAZING AT HAZARDOUS LOCATIONS PER IBC SECTION PROVIDE APPROVED SMOKE DETECTORS AND REQUIRED EMERGENCY FIXTURES WIRED INTO THE BUILDING'S PRIMARY POWER SYSTEM PER IBC

NOT FOR CONSTRUCTION

 \triangle REVISIONS

Јов No. **705921** 03.15.2023 **DRAWN BY** TSC/SIW 4/11/2023 CITY COMMENTS SHEET NAME
UNIT PH PLANS

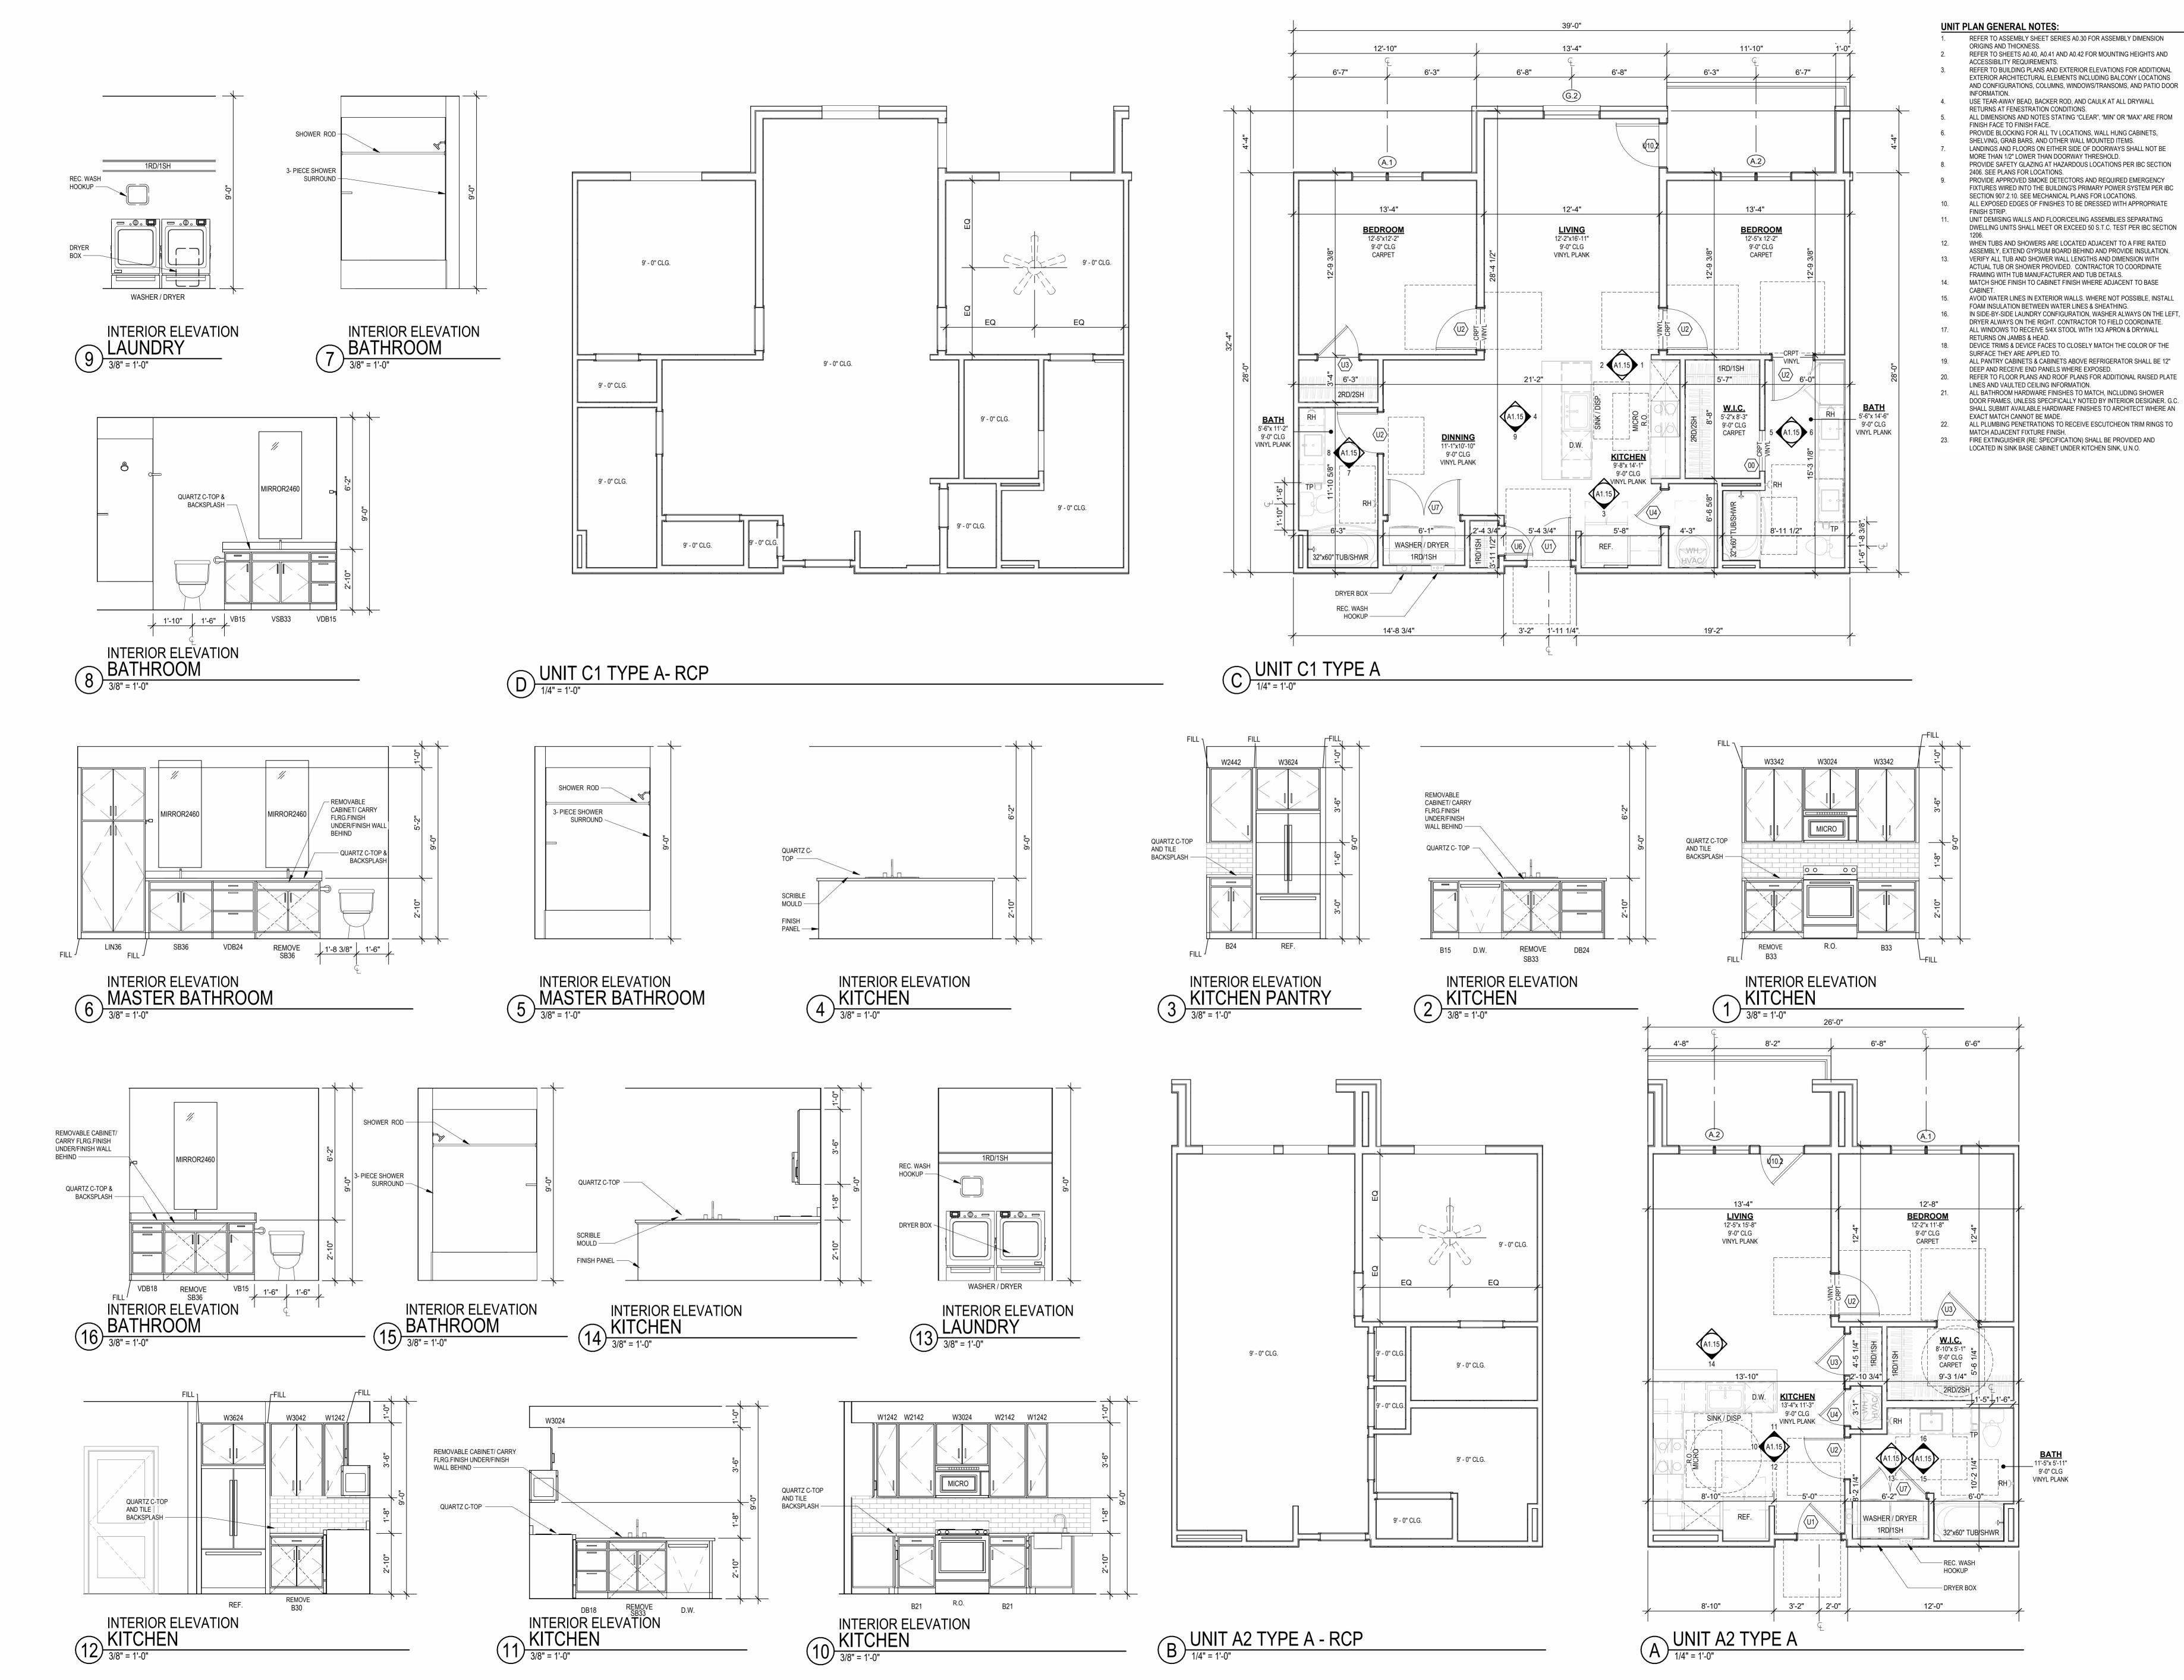


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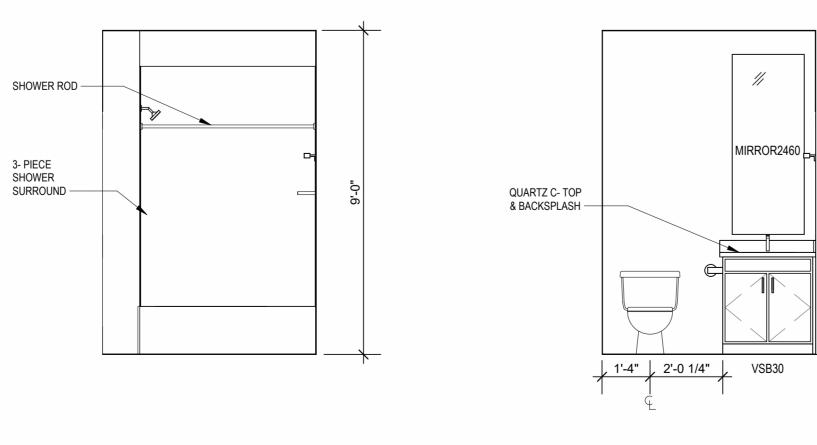
NOT FOR: CONSTRUCTION

 \triangle REVISIONS


Јов No. **705921** 03.15.2023 **DRAWN BY** TSC/SIW 4/11/2023 CITY COMMENTS SHEET NAME **TYPE A UNIT PLANS**

B GUEST SUITE - RCP



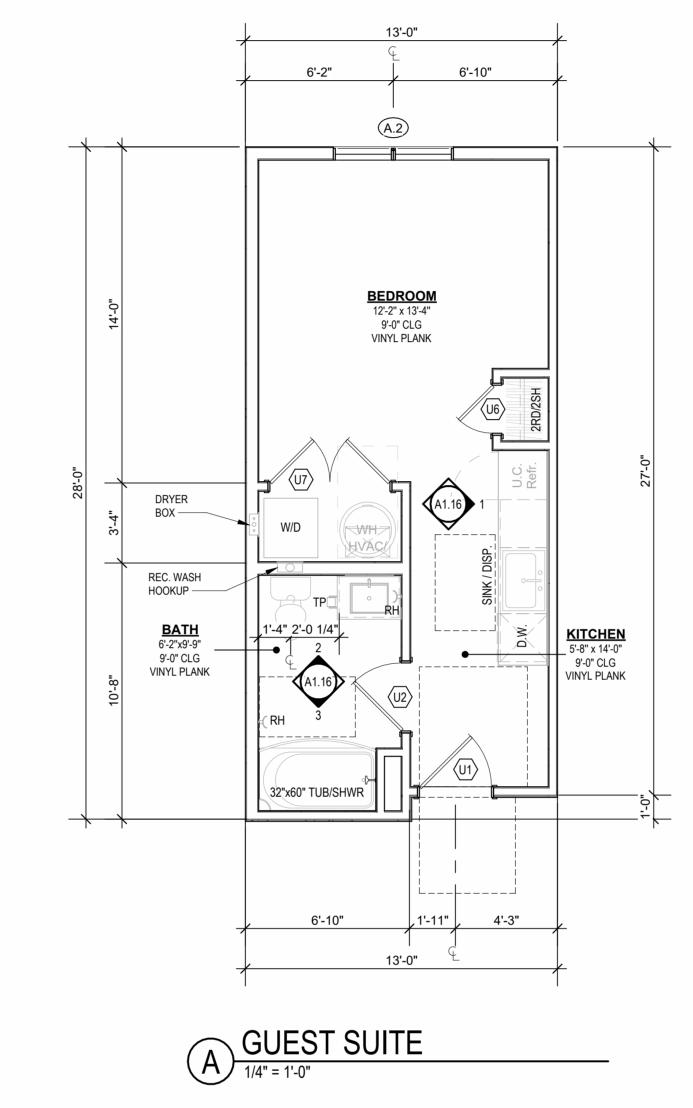

2 BATHROOM
3/8" = 1'-0"

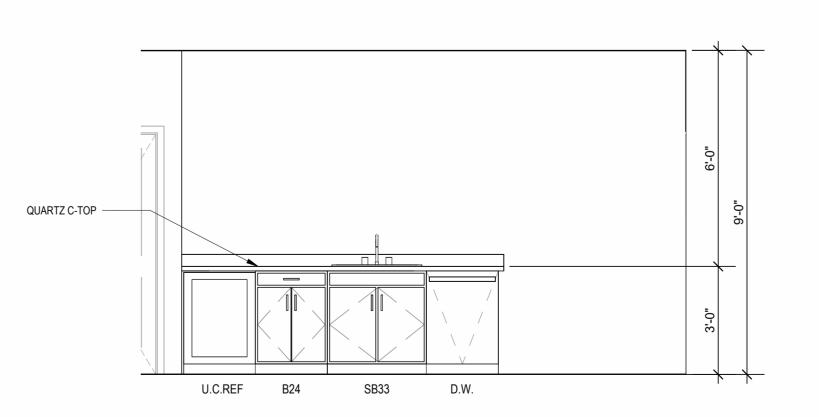

1 KITCHEN
3/8" = 1'-0"

UNIT PLAN GENERAL NOTES:

1. REFER TO ASSEMBLY SHEET SERIES A0.30 FOR ASSEMBLY DIMENSION ORIGINS AND THICKNESS. REFER TO SHEETS A0.40, A0.41 AND A0.42 FOR MOUNTING HEIGHTS AND ACCESSIBILITY REQUIREMENTS. 3. REFER TO BUILDING PLANS AND EXTERIOR ELEVATIONS FOR ADDITIONAL EXTERIOR ARCHITECTURAL ELEMENTS INCLUDING BALCONY LOCATIONS AND CONFIGURATIONS, COLUMNS, WINDOWS/TRANSOMS, AND PATIO DOOR

INFORMATION. 4. USE TEAR-AWAY BEAD, BACKER ROD, AND CAULK AT ALL DRYWALL RETURNS AT FENESTRATION CONDITIONS. ALL DIMENSIONS AND NOTES STATING "CLEAR", "MIN" OR "MAX" ARE FROM FINISH FACE TO FINISH FACE.

PROVIDE BLOCKING FOR ALL TV LOCATIONS, WALL HUNG CABINETS, SHELVING, GRAB BARS, AND OTHER WALL MOUNTED ITEMS. LANDINGS AND FLOORS ON EITHER SIDE OF DOORWAYS SHALL NOT BE MORE THAN 1/2" LOWER THAN DOORWAY THRESHOLD. PROVIDE SAFETY GLAZING AT HAZARDOUS LOCATIONS PER IBC SECTION 2406. SEE PLANS FOR LOCATIONS. PROVIDE APPROVED SMOKE DETECTORS AND REQUIRED EMERGENCY FIXTURES WIRED INTO THE BUILDING'S PRIMARY POWER SYSTEM PER IBC

SECTION 907.2.10. SEE MECHANICAL PLANS FOR LOCATIONS. 10. ALL EXPOSED EDGES OF FINISHES TO BE DRESSED WITH APPROPRIATE FINISH STRIP. UNIT DEMISING WALLS AND FLOOR/CEILING ASSEMBLIES SEPARATING DWELLING UNITS SHALL MEET OR EXCEED 50 S.T.C. TEST PER IBC SECTION

WHEN TUBS AND SHOWERS ARE LOCATED ADJACENT TO A FIRE RATED ASSEMBLY, EXTEND GYPSUM BOARD BEHIND AND PROVIDE INSULATION. VERIFY ALL TUB AND SHOWER WALL LENGTHS AND DIMENSION WITH ACTUAL TUB OR SHOWER PROVIDED. CONTRACTOR TO COORDINATE FRAMING WITH TUB MANUFACTURER AND TUB DETAILS. 14. MATCH SHOE FINISH TO CABINET FINISH WHERE ADJACENT TO BASE 15. AVOID WATER LINES IN EXTERIOR WALLS. WHERE NOT POSSIBLE, INSTALL

FOAM INSULATION BETWEEN WATER LINES & SHEATHING.

16. IN SIDE-BY-SIDE LAUNDRY CONFIGURATION, WASHER ALWAYS ON THE LEFT, DRYER ALWAYS ON THE RIGHT. CONTRACTOR TO FIELD COORDINATE. 17. ALL WINDOWS TO RECEIVE 5/4X STOOL WITH 1X3 APRON & DRYWALL RETURNS ON JAMBS & HEAD. DEVICE TRIMS & DEVICE FACES TO CLOSELY MATCH THE COLOR OF THE SURFACE THEY ARE APPLIED TO.

ALL PANTRY CABINETS & CABINETS ABOVE REFRIGERATOR SHALL BE 12" DEEP AND RECEIVE END PANELS WHERE EXPOSED. REFER TO FLOOR PLANS AND ROOF PLANS FOR ADDITIONAL RAISED PLATE LINES AND VAULTED CEILING INFORMATION. ALL BATHROOM HARDWARE FINISHES TO MATCH, INCLUDING SHOWER DOOR FRAMES, UNLESS SPECIFICALLY NOTED BY INTERIOR DESIGNER. G.C. SHALL SUBMIT AVAILABLE HARDWARE FINISHES TO ARCHITECT WHERE AN EXACT MATCH CANNOT BE MADE. ALL PLUMBING PENETRATIONS TO RECEIVE ESCUTCHEON TRIM RINGS TO

23. FIRE EXTINGUISHER (RE: SPECIFICATION) SHALL BE PROVIDED AND LOCATED IN SINK BASE CABINET UNDER KITCHEN SINK, U.N.O.

MATCH ADJACENT FIXTURE FINISH.



LEE'S SUMMIT, MO

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JOB NO. 705921 DRAWN BY TSC/SIW DATE **03.15.2023** 4/11/2023
CITY COMMENTS
SHEET NAME
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JOB NO. DATE
705921 03.15.2023
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TSC/SIW
4/11/2023
CITY COMMENTS
SHEET NAME
BUILDING 1 OVERALL SLAB
PLAN

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BUILDING 1 - OVERALL SLAB PLAN

1/16" = 1'-0"


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JOB NO. DATE
705921 03.15.2023
DRAWN BY
TSC/SIW
4/11/2023
CITY COMMENTS

SHEET NAME
BUILDING 1 OVERALL 1ST
FLOOR PLAN
SHEET NO.


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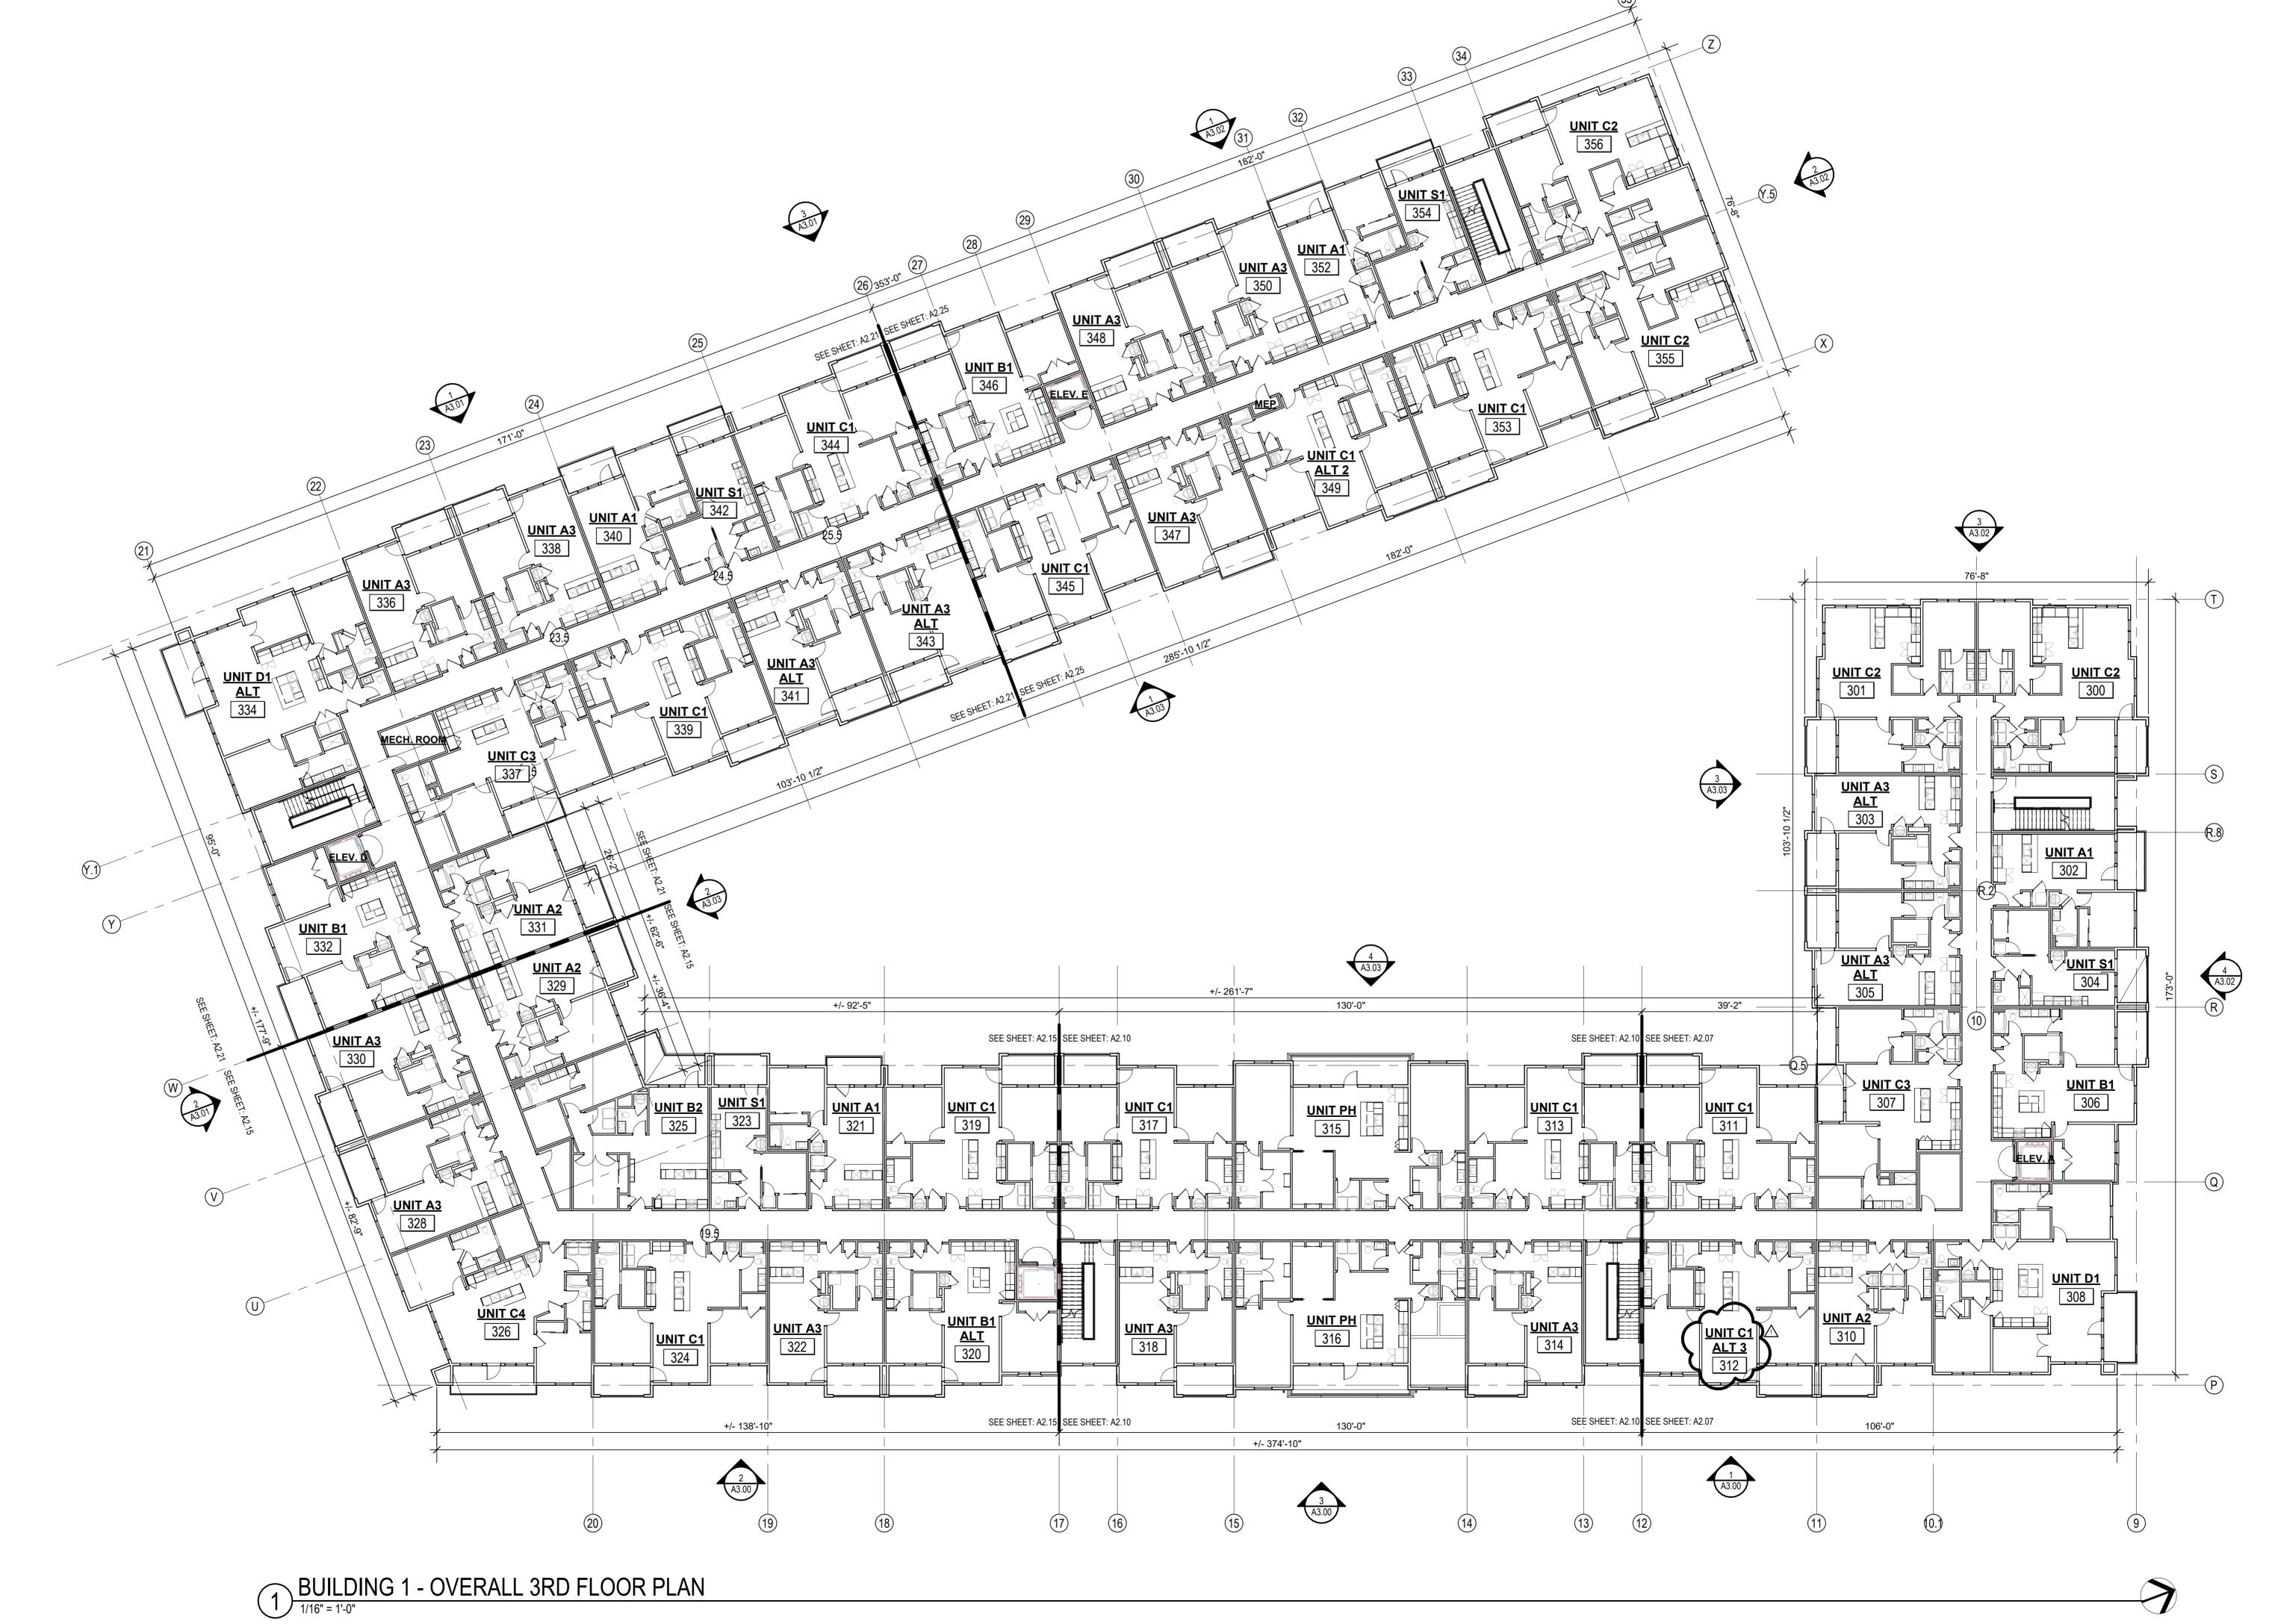
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DATE **03.15.2023** ЈОВ NO. **705921** DRAWN BY TSC/SIW 4/11/2023 CITY COMMENTS

SHEET NAME
BUILDING 1 OVERALL 2ND
FLOOR PLAN



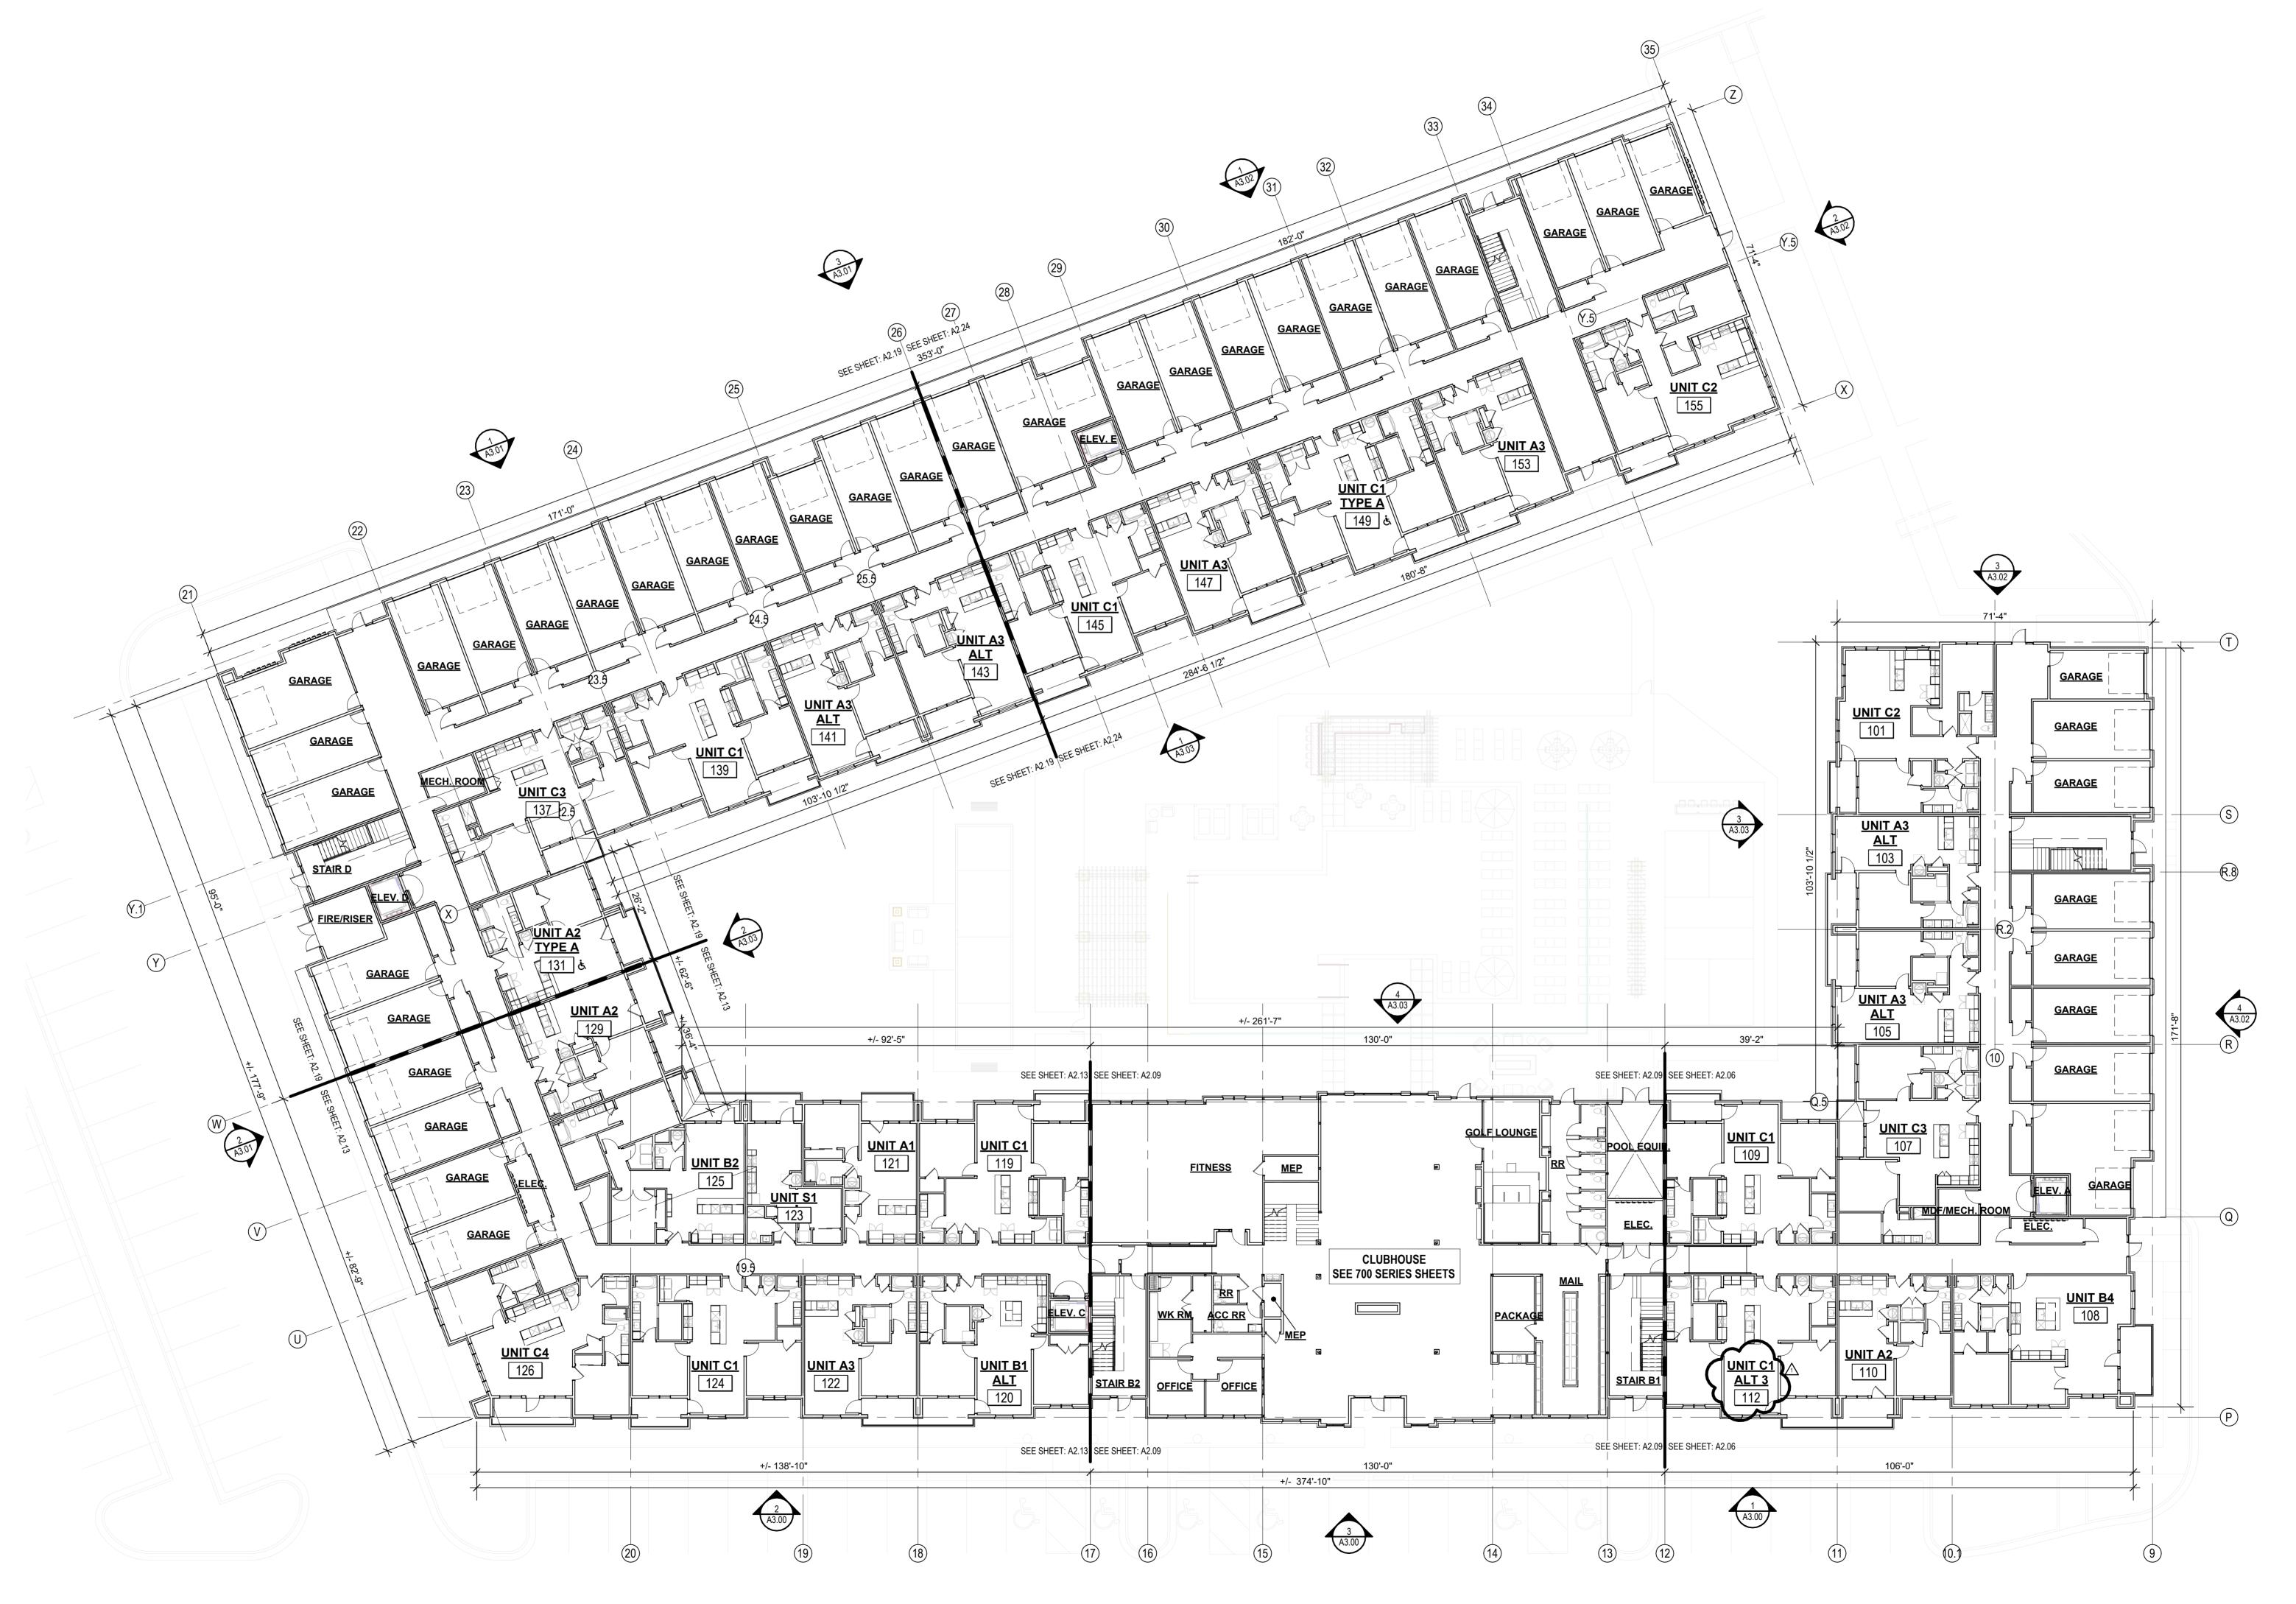

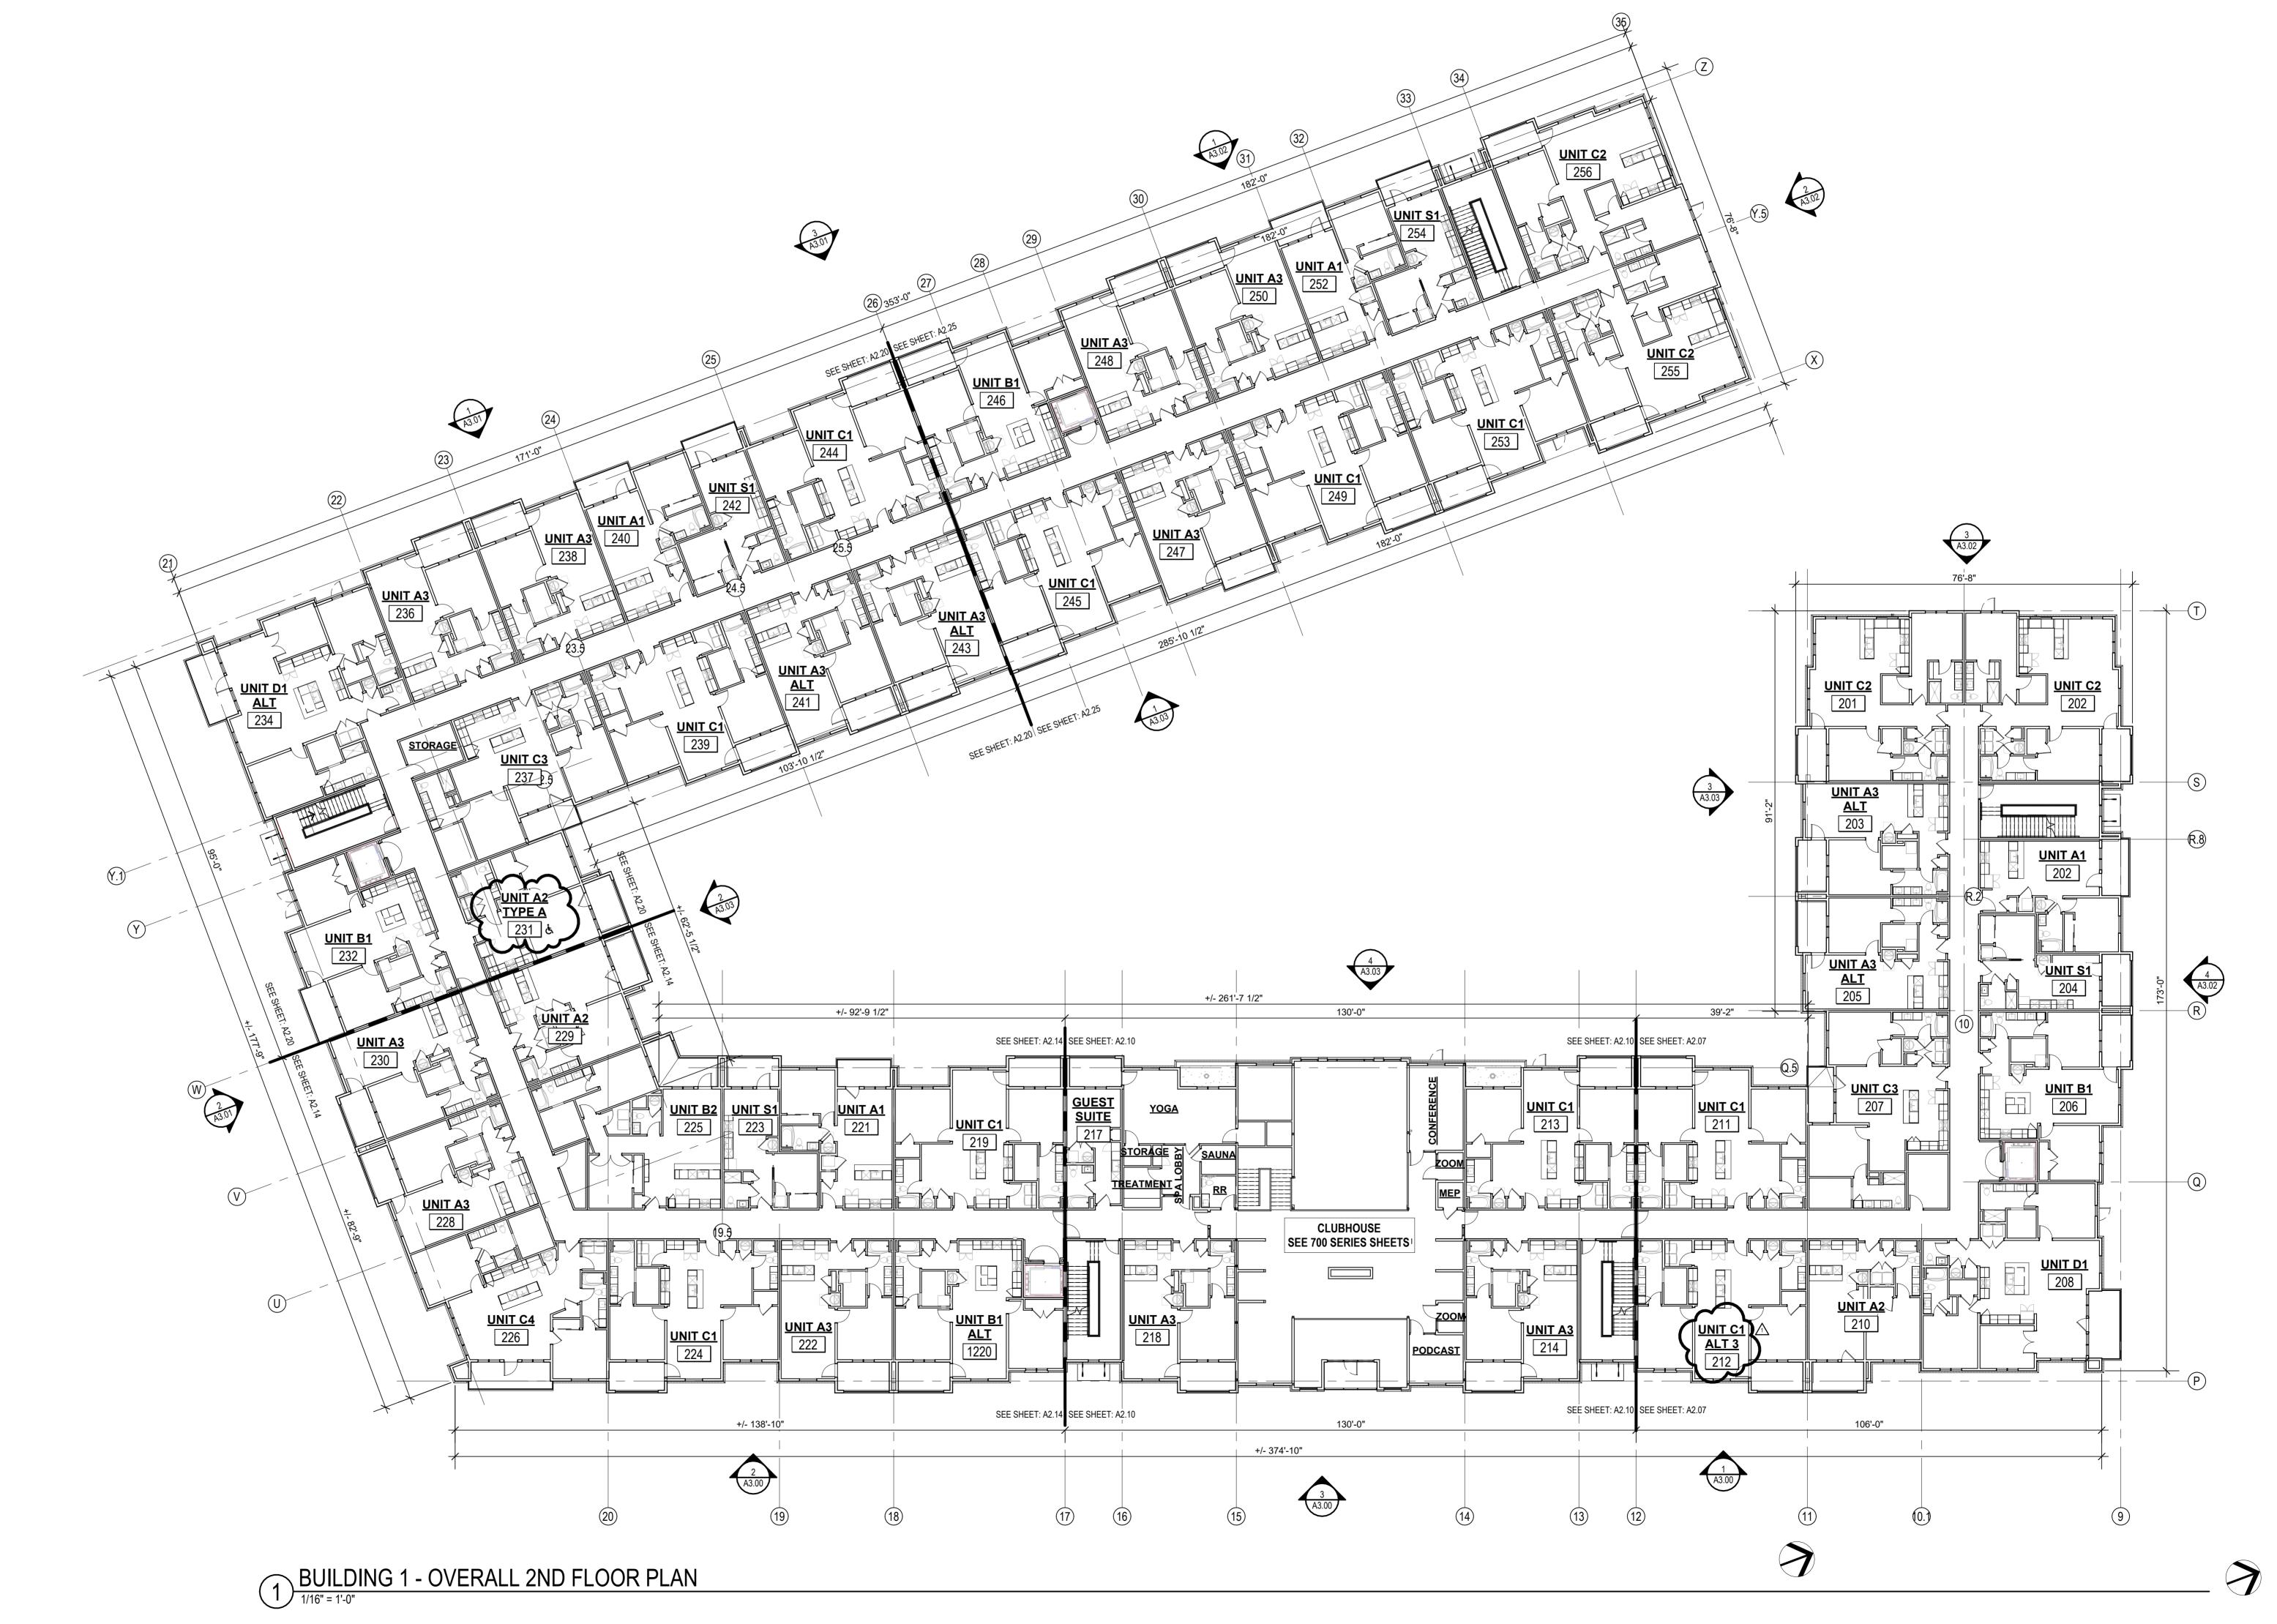

4/11/2023
CITY COMMENTS
SHEET NAME
BUILDING 1 OVERALL 3RD
FLOOR PLAN

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DATE **03.15.2023**

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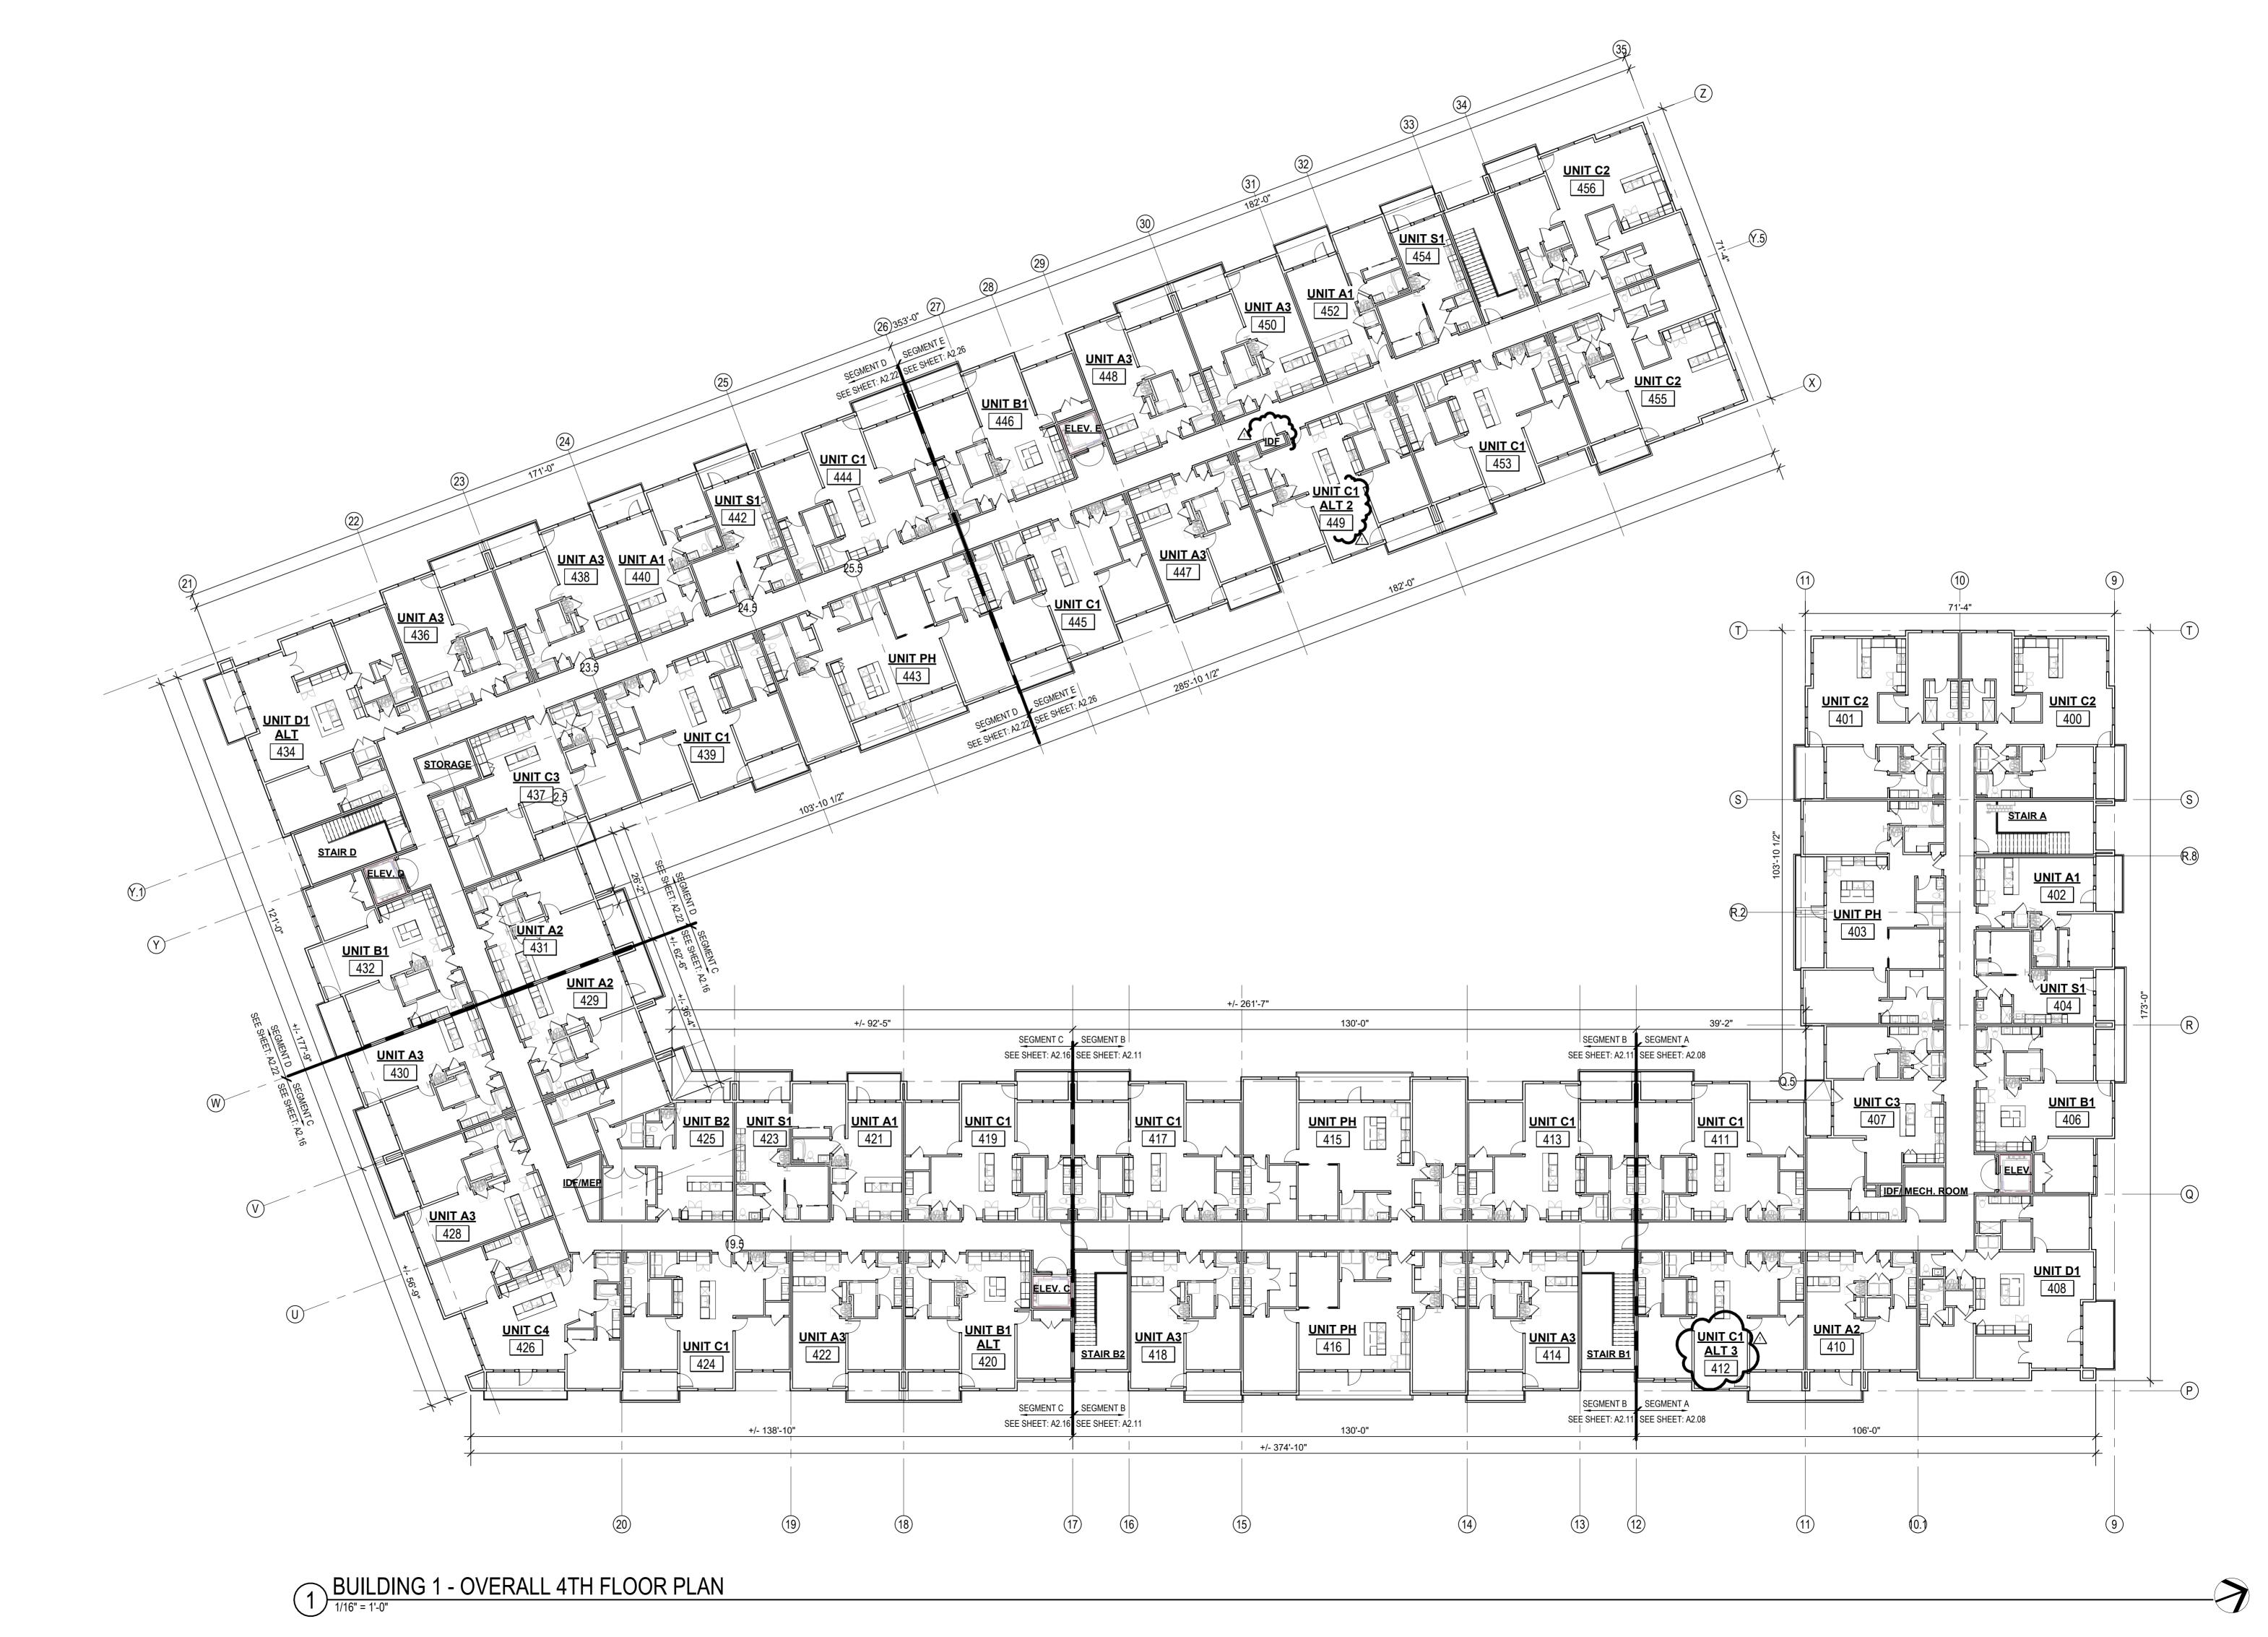
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DRAWN BY
TSC/SIW

4/11/2023
CITY COMMENTS
SHEET NAME
BUILDING 1 OVERALL 4TH
FLOOR PLAN
SHEET NO.

A2.04



BLDG. 1 - OVERALL ROOF PLAN


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BUILDING 1 OVERALL ROOF
PLAN
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D. | LEE'S SUMMIT, MO

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JOB NO. DATE
705921 03.15.2023
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4/11/2023

CITY COMMENTS

SHEET NAME

SEGMENT A 2ND & 3RD

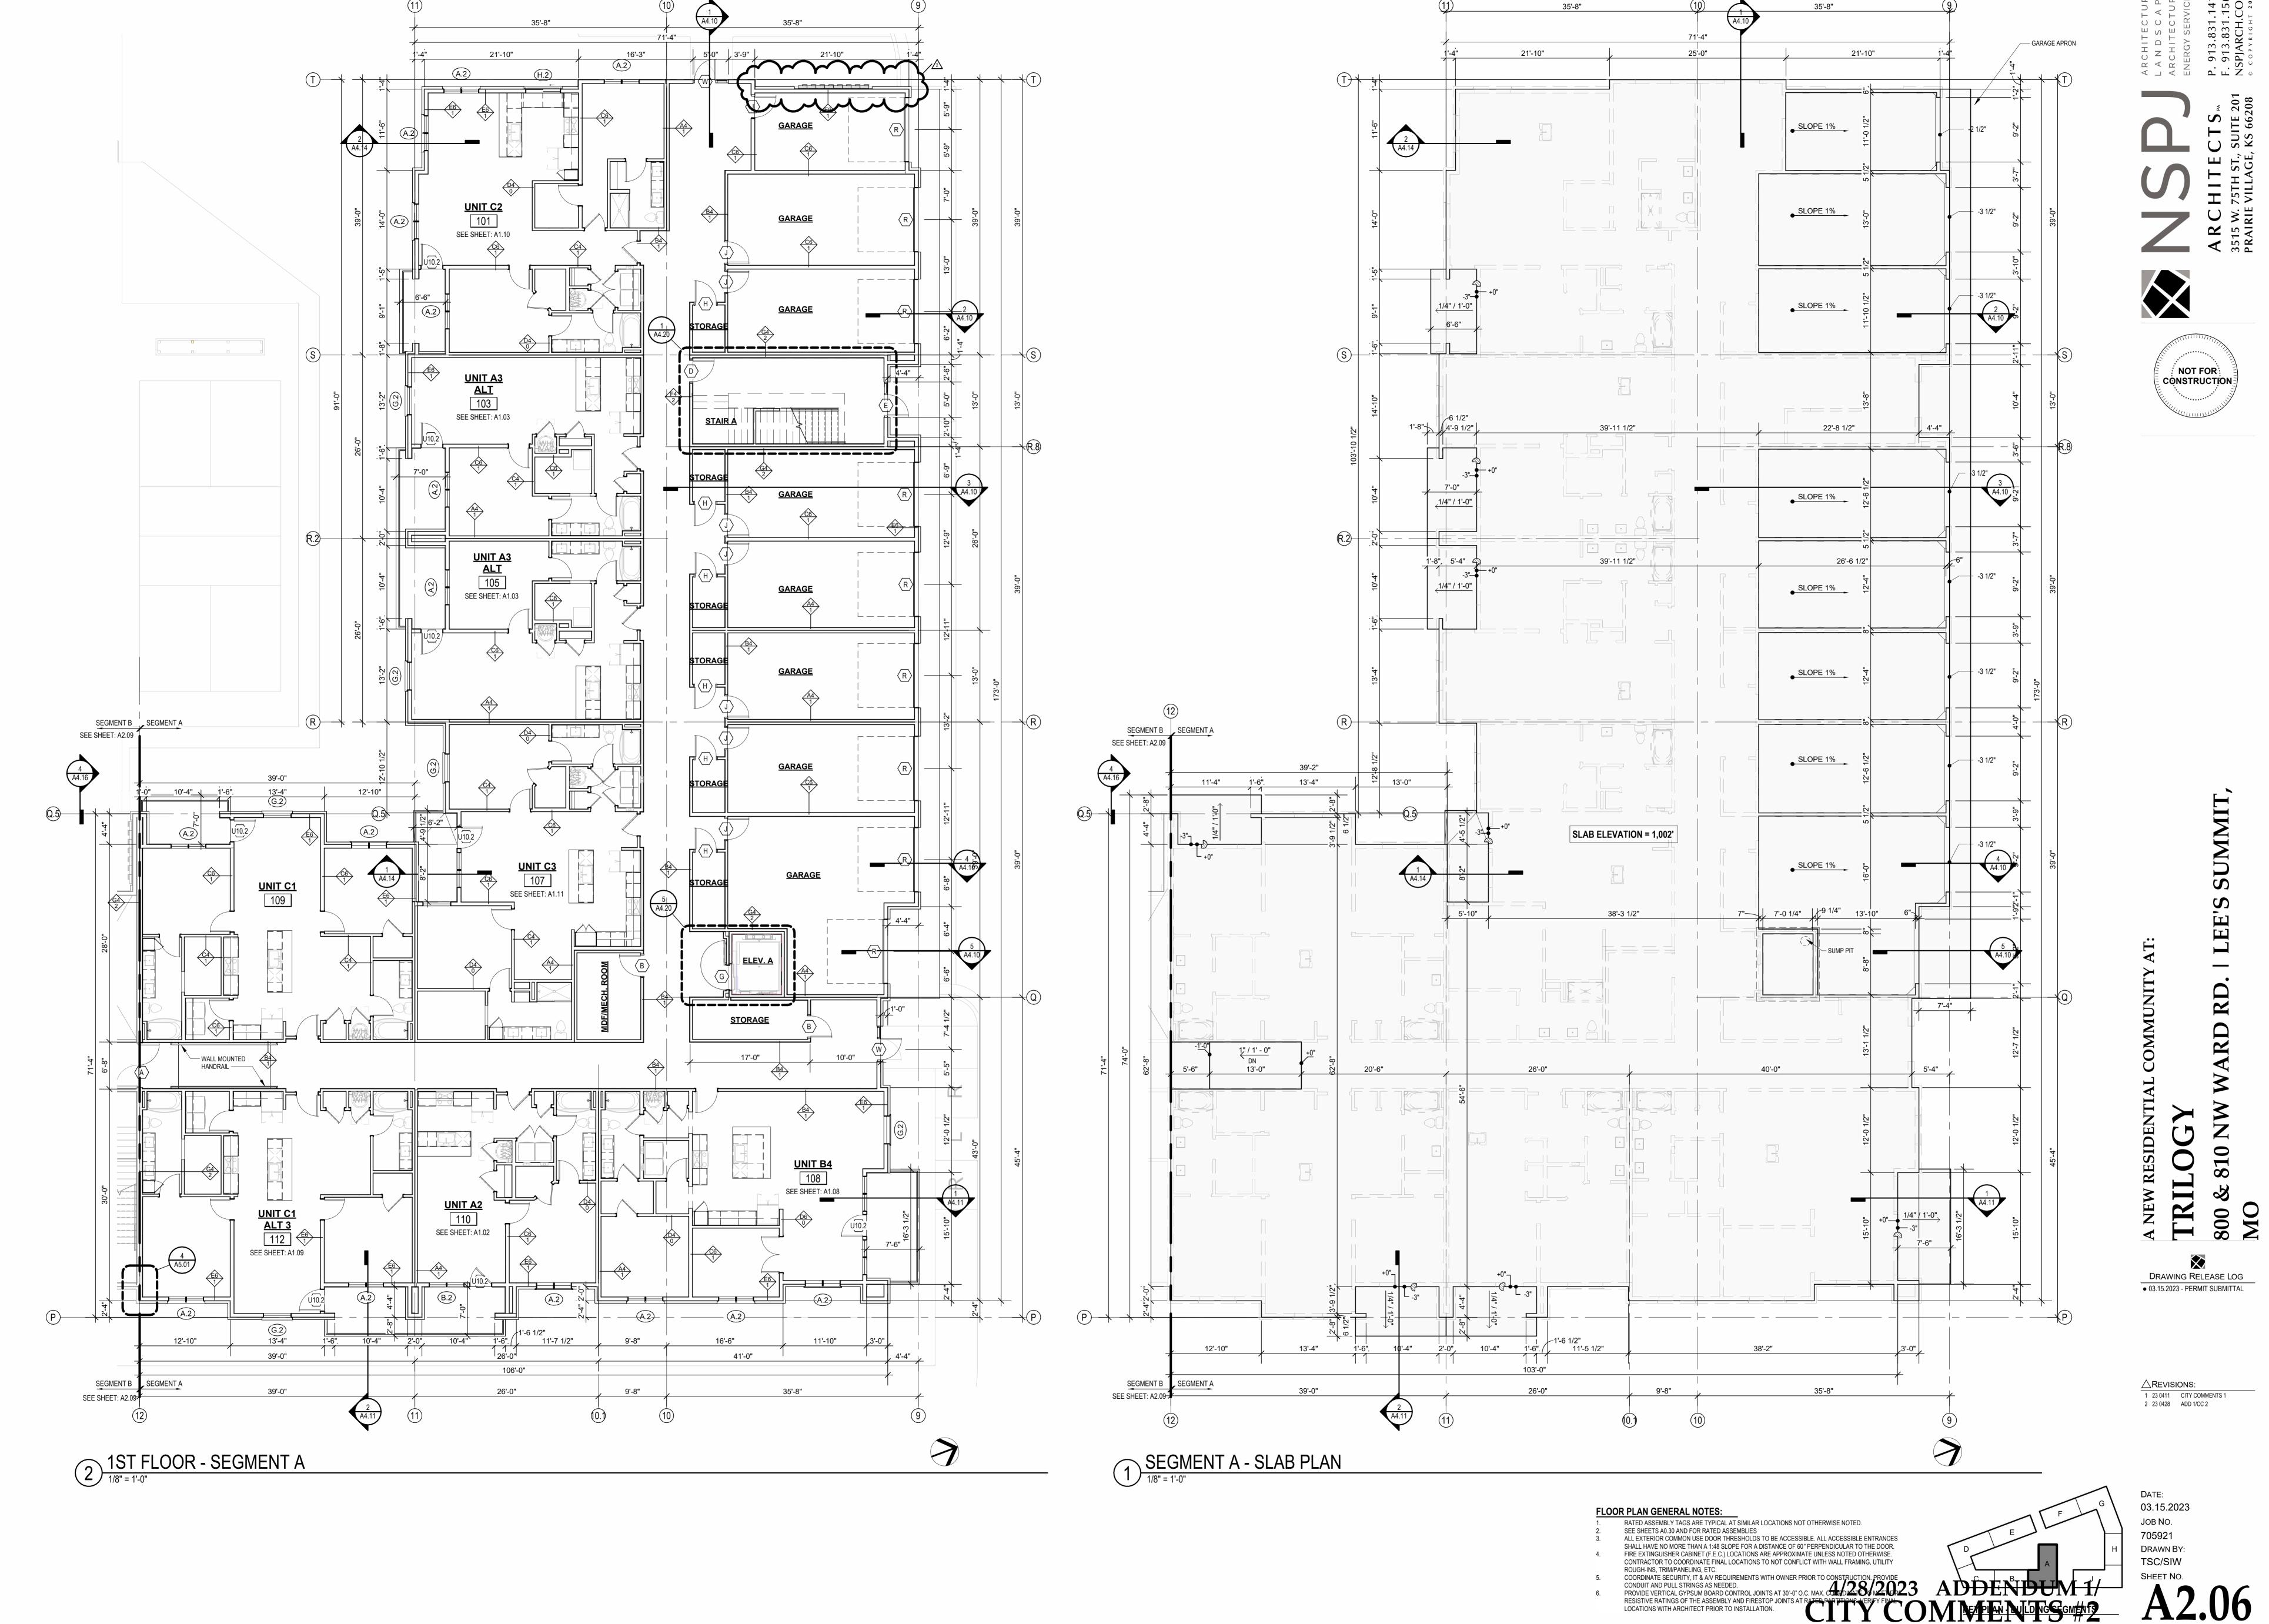FLOOR PLAN

SHEET NO.

RESISTIVE RATINGS OF THE ASSEMBLY AND FIRESTOP JOINTS AT RATED PARTITIONS. VERIFY FINAL

LOCATIONS WITH ARCHITECT PRIOR TO INSTALLATION.

STATIC VENT

Lower Static Vent

Total Lower

508 in²

508 in²

REQUIEMENTS PER 2018 IBC SECTION 1202.2:

PROVIDE 40%-50% VENT AREA HIGH, 50%-60% LOW

MIN. NET FREE AREA OF ROOF VENTILATION: 1/300 ROOF AREA

PROPOSED ROOF VENTILATION LOW: POP VENT INTAKE (254 SQ. IN. NET FREE AREA PER VENT)

HIGH: AURA ROOF VENT (254 SQ. IN NET FREE AREA PER VENT)

STATIC VENTING

at Upper Roof Upper Venting Provided

Total Net Free Area of Total Net Free Area of Vented Area Percentage at Vented Net Free Area Per Vented Units Provided Total Net Free Area of Vented Net Free Area Per Static Vents

Upper Roof Provided Static Vent at Upper Roof

2023 9:10:18 AM

Name Area

DRAFTSTOP A-1 2923 SF

DRAFTSTOP A-2 1750 SF

DRAFTSTOP A-3 2303 SF

DRAFTSTOP A-4 1273 SF

DRAFTSTOP A-5 1948 SF

DRAFTSTOP A-6 2584 SF

DRAFTSTOP A-7 1529 SF

DRAFTSTOP A-8 1302 SF

Venting Provided

1016 in²

1016 in²

1016 in²

1016 in²

KEY PLAN - BUILDING SEGMENTS

RATED ASSEMBLY TAGS ARE TYPICAL AT SIMILAR LOCATIONS NOT OTHERWISE NOTED.

ROUGH-INS, TRIM/PANELING, ETC.

CONDUIT AND PULL STRINGS AS NEEDED.

LOCATIONS WITH ARCHITECT PRIOR TO INSTALLATION.

SEE SHEETS A0.30 AND FOR RATED ASSEMBLIES
ALL EXTERIOR COMMON USE DOOR THRESHOLDS TO BE ACCESSIBLE. ALL ACCESSIBLE ENTRANCES

SHALL HAVE NO MORE THAN A 1:48 SLOPE FOR A DISTANCE OF 60" PERPENDICULAR TO THE DOOR.

FIRE EXTINGUISHER CABINET (F.E.C.) LOCATIONS ARE APPROXIMATE UNLESS NOTED OTHERWISE.

CONTRACTOR TO COORDINATE FINAL LOCATIONS TO NOT CONFLICT WITH WALL FRAMING, UTILITY

COORDINATE SECURITY, IT & A/V REQUIREMENTS WITH OWNER PRIOR TO CONSTRUCTION. PROVIDE

PROVIDE VERTICAL GYPSUM BOARD CONTROL JOINTS AT 30'-0" O.C. MAX. COORDINATE TO MEET FIRE RESISTIVE RATINGS OF THE ASSEMBLY AND FIRESTOP JOINTS AT RATED PARTITIONS. VERIFY FINAL

REFER TO BUILDING ELEVATIONS FOR DOWNSPOUT LOCATIONS.

DRAWINGS FOR ACTUAL MECHANICAL EQUIPMENT LOCATIONS.

PROVIDE ALL ROOFING DETAILS BY MANUFACTURER'S WARRANTED

PROVIDE KICK-OUT FLASHING AT ALL SIDE-WALL CONDITIONS.

ALL FLAT ROOFS SHALL SLOPE 1/4" PER FOOT MINIMUM.

ALL CRICKETS SHALL SLOPE 1/4" PER FOOT MINIMUM.

ALL OBJECTS INDICATED ON THE ROOF ARE GENERAL AND MUST BE

COORDINATED WITH MEP AND STRUCTURAL ELEMENTS. REFER TO MEP

ALL ROOFING DETAILS TO BE PER MANUFACTURER'S WARRANTED SYSTEM.

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NEW RESIDENTIAL COMINITY IN TRICORD

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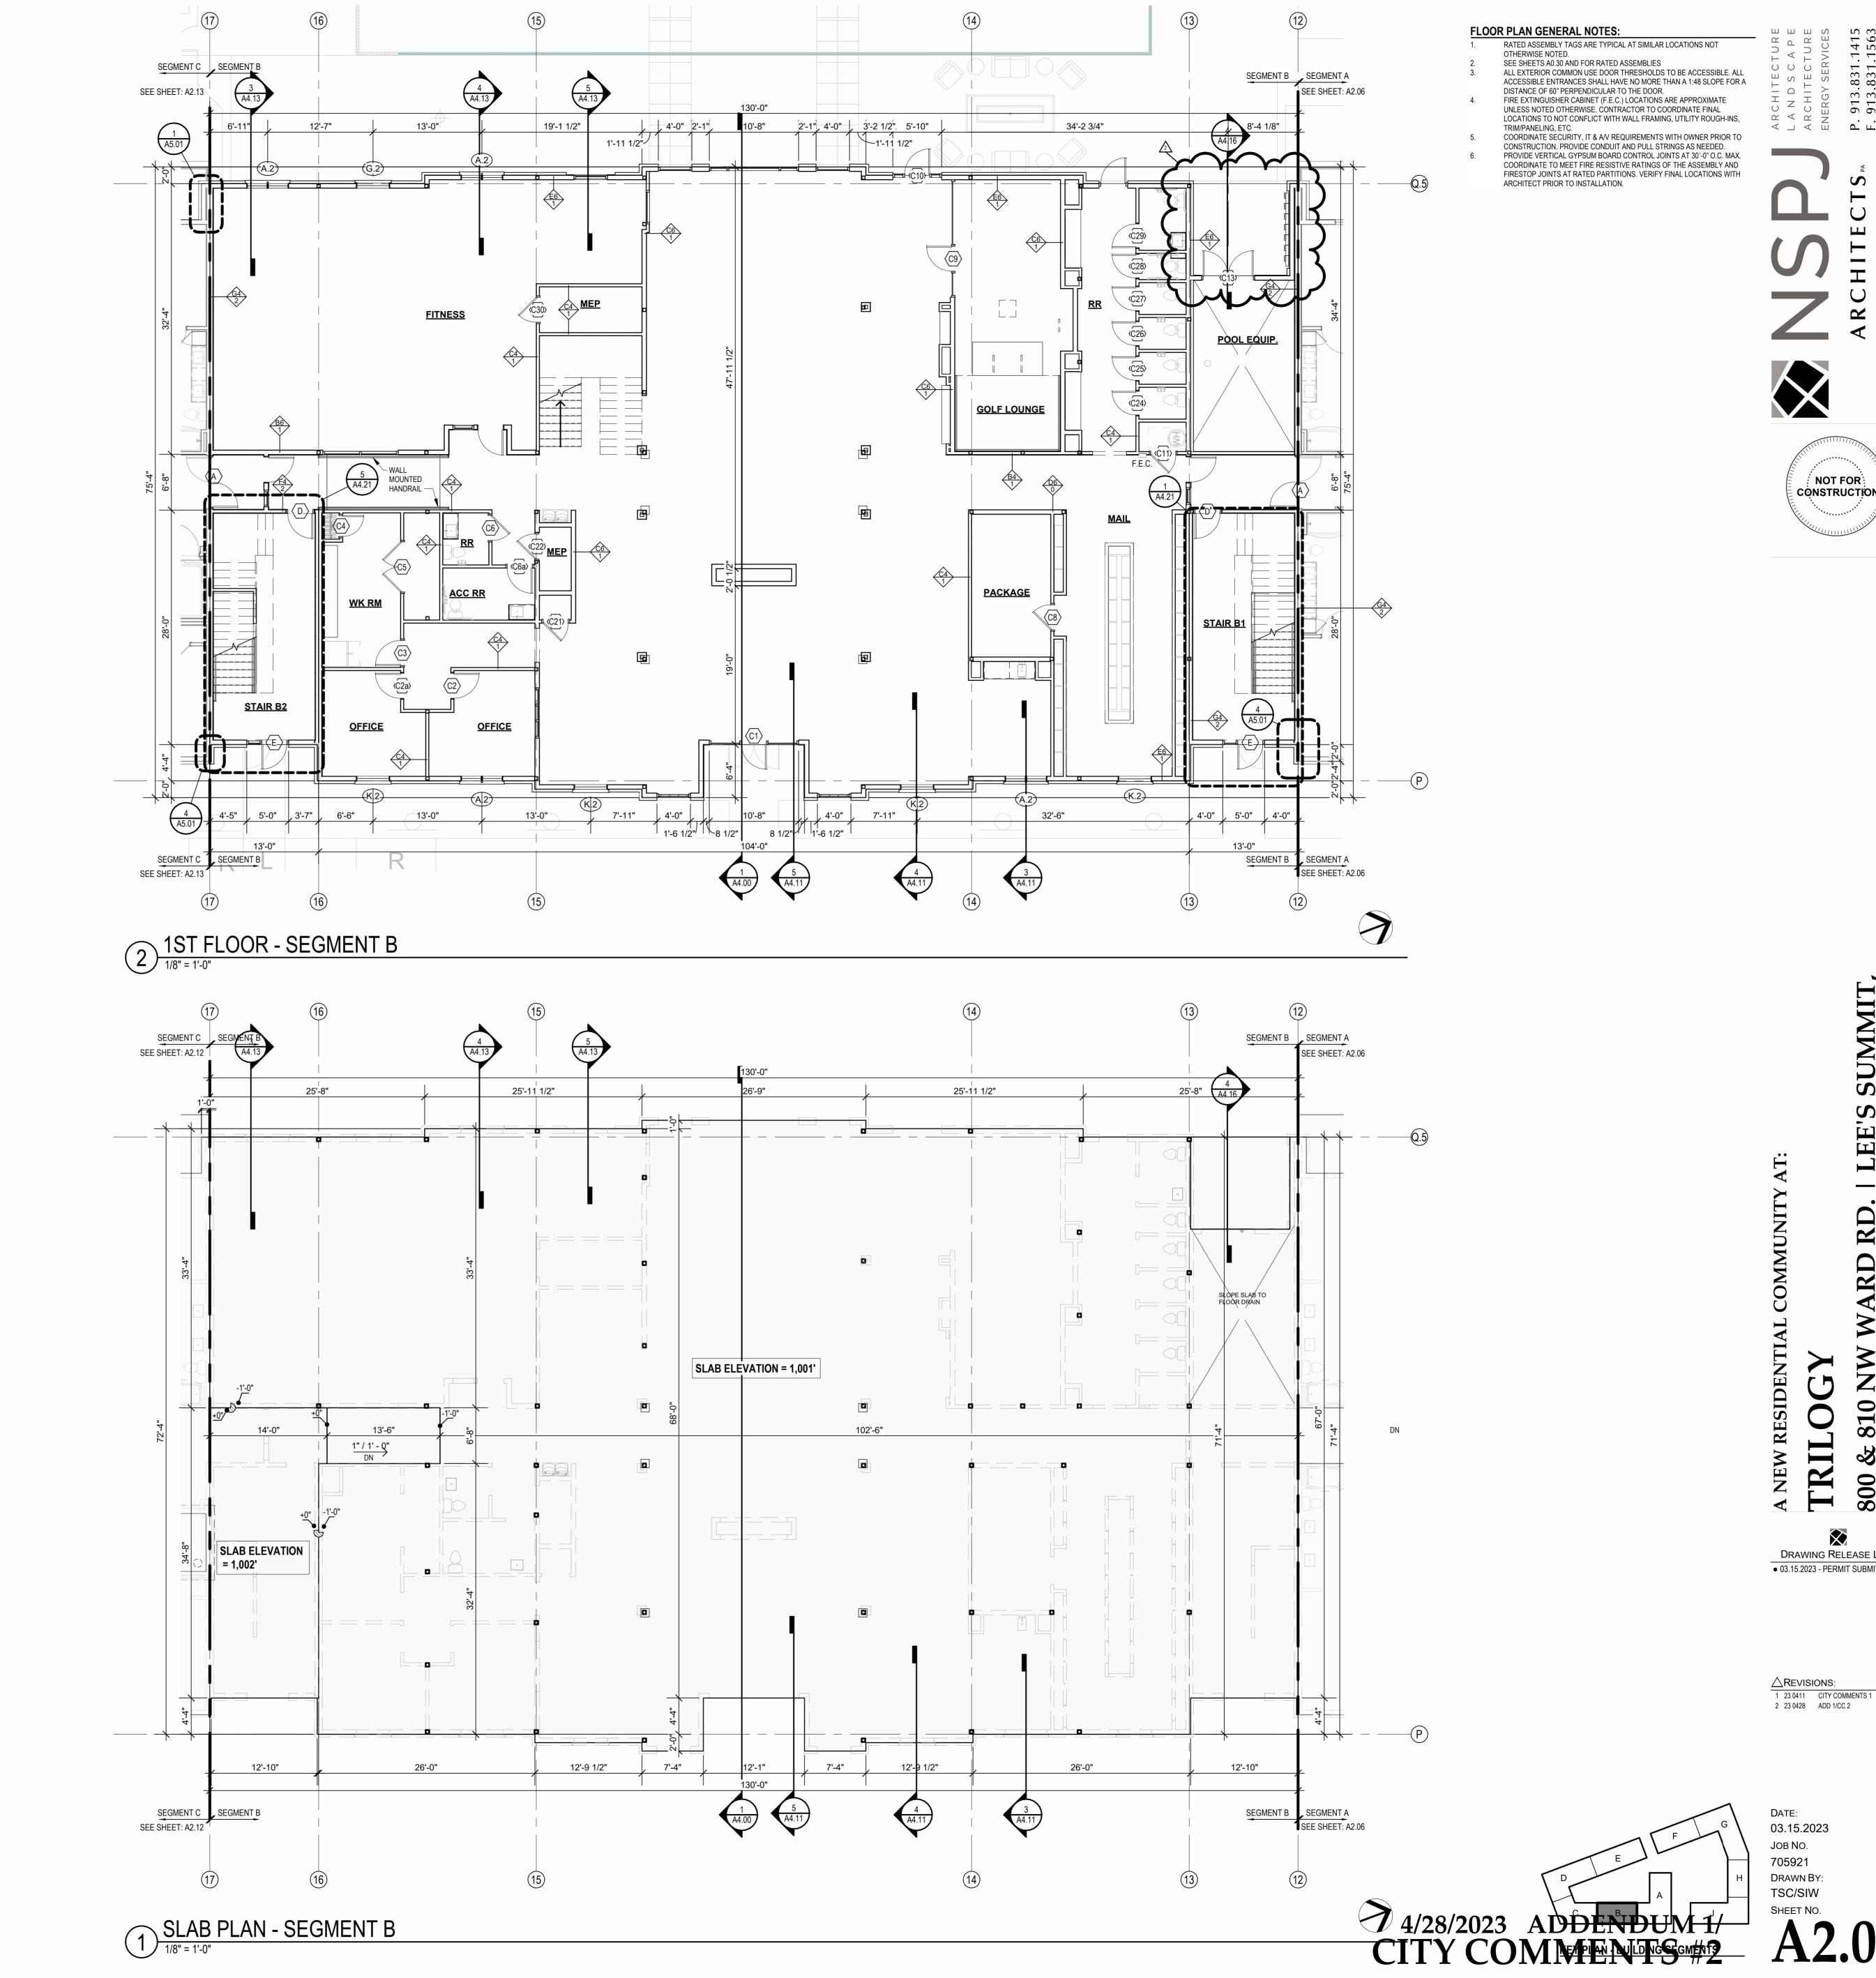
CITY COMMENTS

SHEET NAME
SEGMENT A 4TH FLOOR &
ROOF PLAN

ROOF PLAN SHEET NO.

NG SEGMENTS

ROOF PLAN SHEET NO.





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FLOOR PLAN GENERAL NOTES:

RATED ASSEMBLY TAGS ARE TYPICAL AT SIMILAR LOCATIONS NOT OTHERWISE NOTED. SEE SHEETS A0.30 AND FOR RATED ASSEMBLIES


ALL EXTERIOR COMMON USE DOOR THRESHOLDS TO BE ACCESSIBLE. ALL ACCESSIBLE ENTRANCES SHALL HAVE NO MORE THAN A 1:48 SLOPE FOR A DISTANCE OF 60" PERPENDICULAR TO THE DOOR. FIRE EXTINGUISHER CABINET (F.E.C.) LOCATIONS ARE APPROXIMATE UNLESS NOTED OTHERWISE. CONTRACTOR TO COORDINATE FINAL LOCATIONS TO NOT CONFLICT WITH WALL FRAMING, UTILITY ROUGH-INS,


COORDINATE SECURITY, IT & A/V REQUIREMENTS WITH OWNER PRIOR TO CONSTRUCTION. PROVIDE CONDUIT AND PULL STRINGS AS NEEDED. PROVIDE VERTICAL GYPSUM BOARD CONTROL JOINTS AT 30'-0" O.C. MAX. COORDINATE TO MEET FIRE RESISTIVE RATINGS OF THE ASSEMBLY AND FIRESTOP JOINTS AT RATED PARTITIONS. VERIFY FINAL LOCATIONS WITH ARCHITECT PRIOR TO INSTALLATION.




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DATE **03.15.2023**



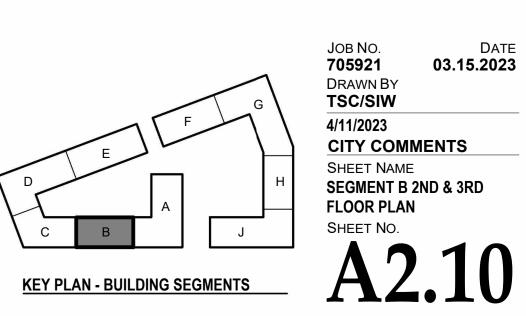

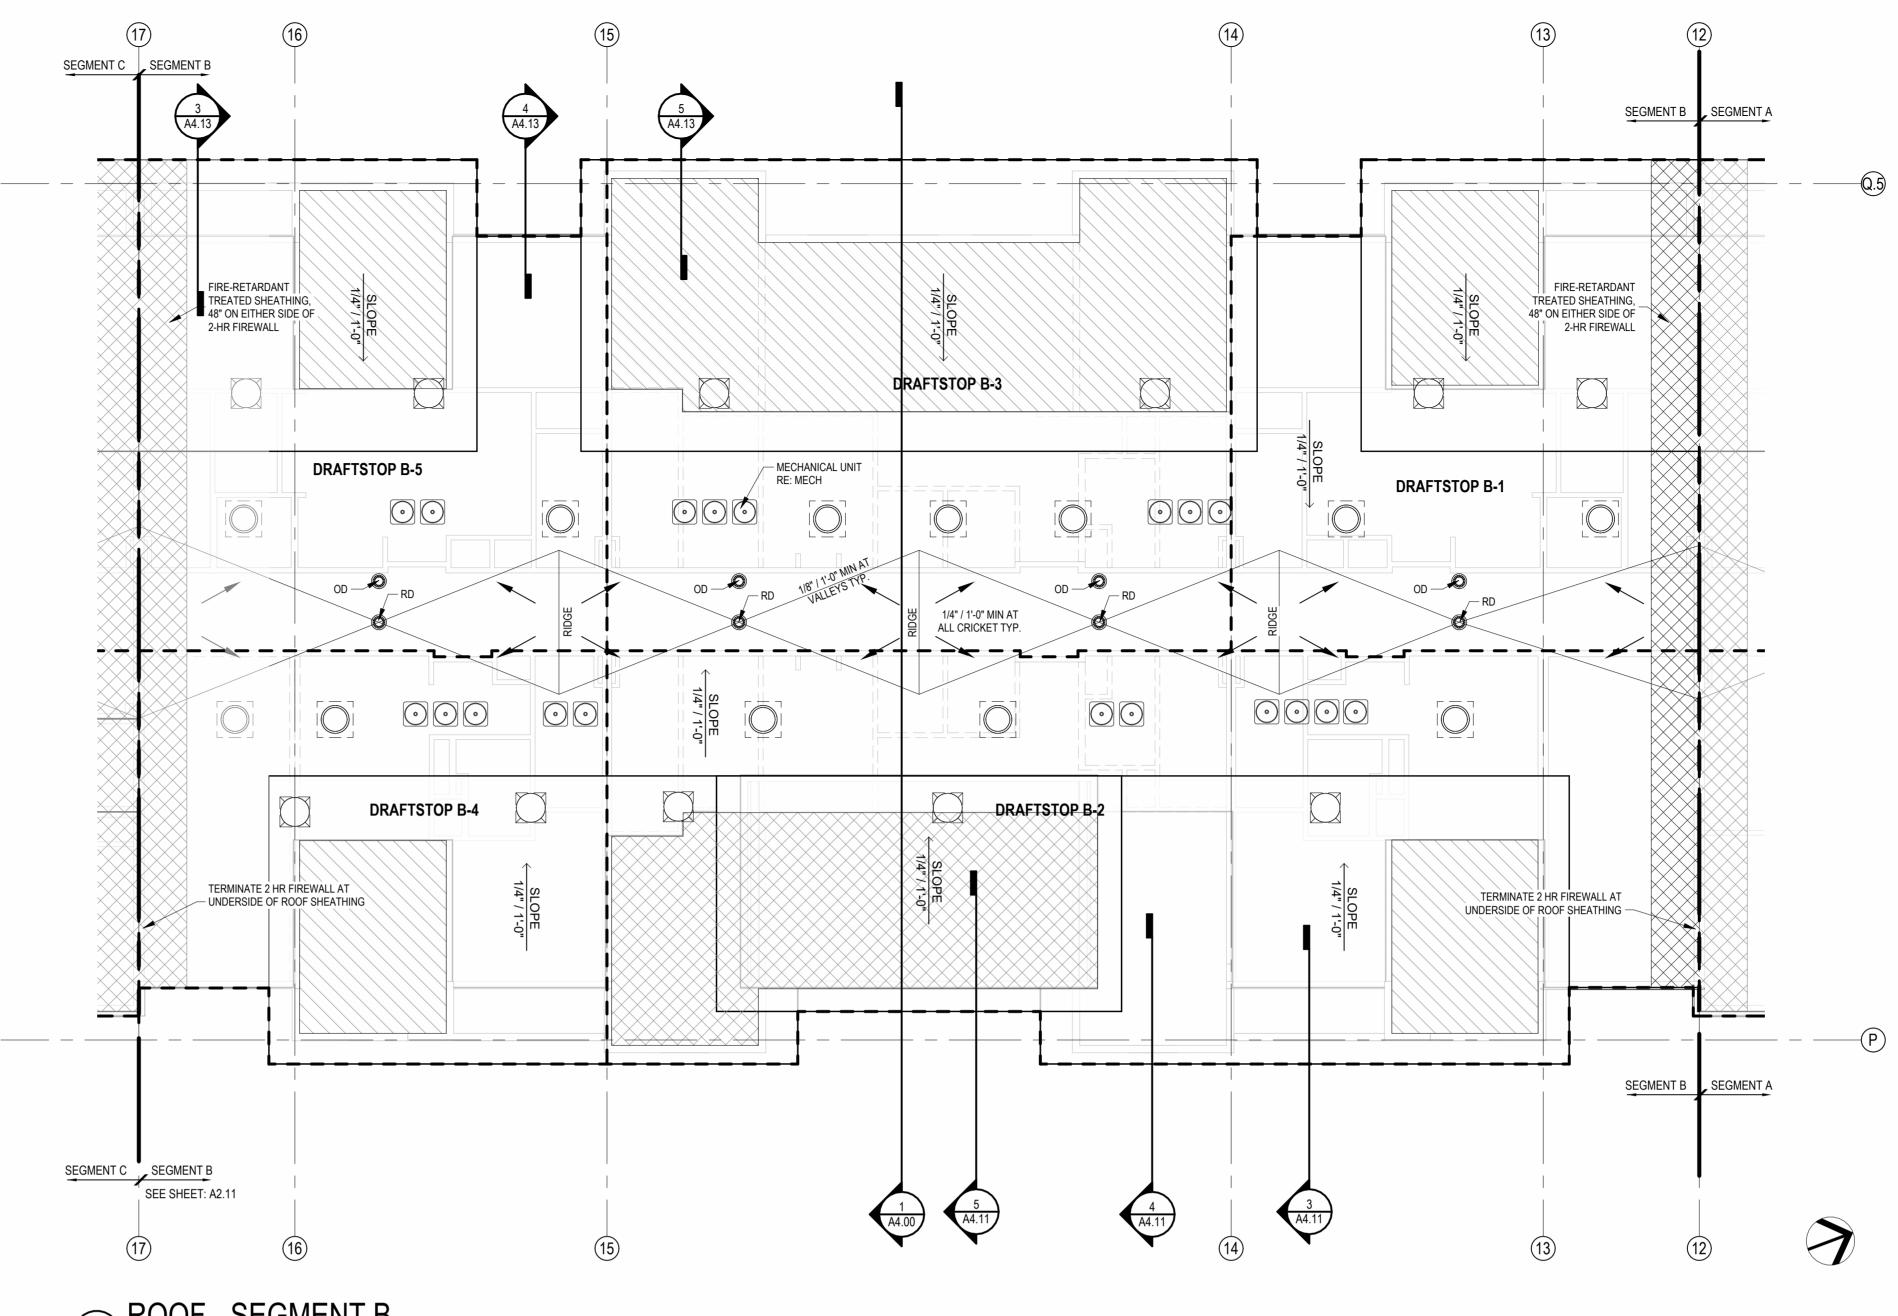

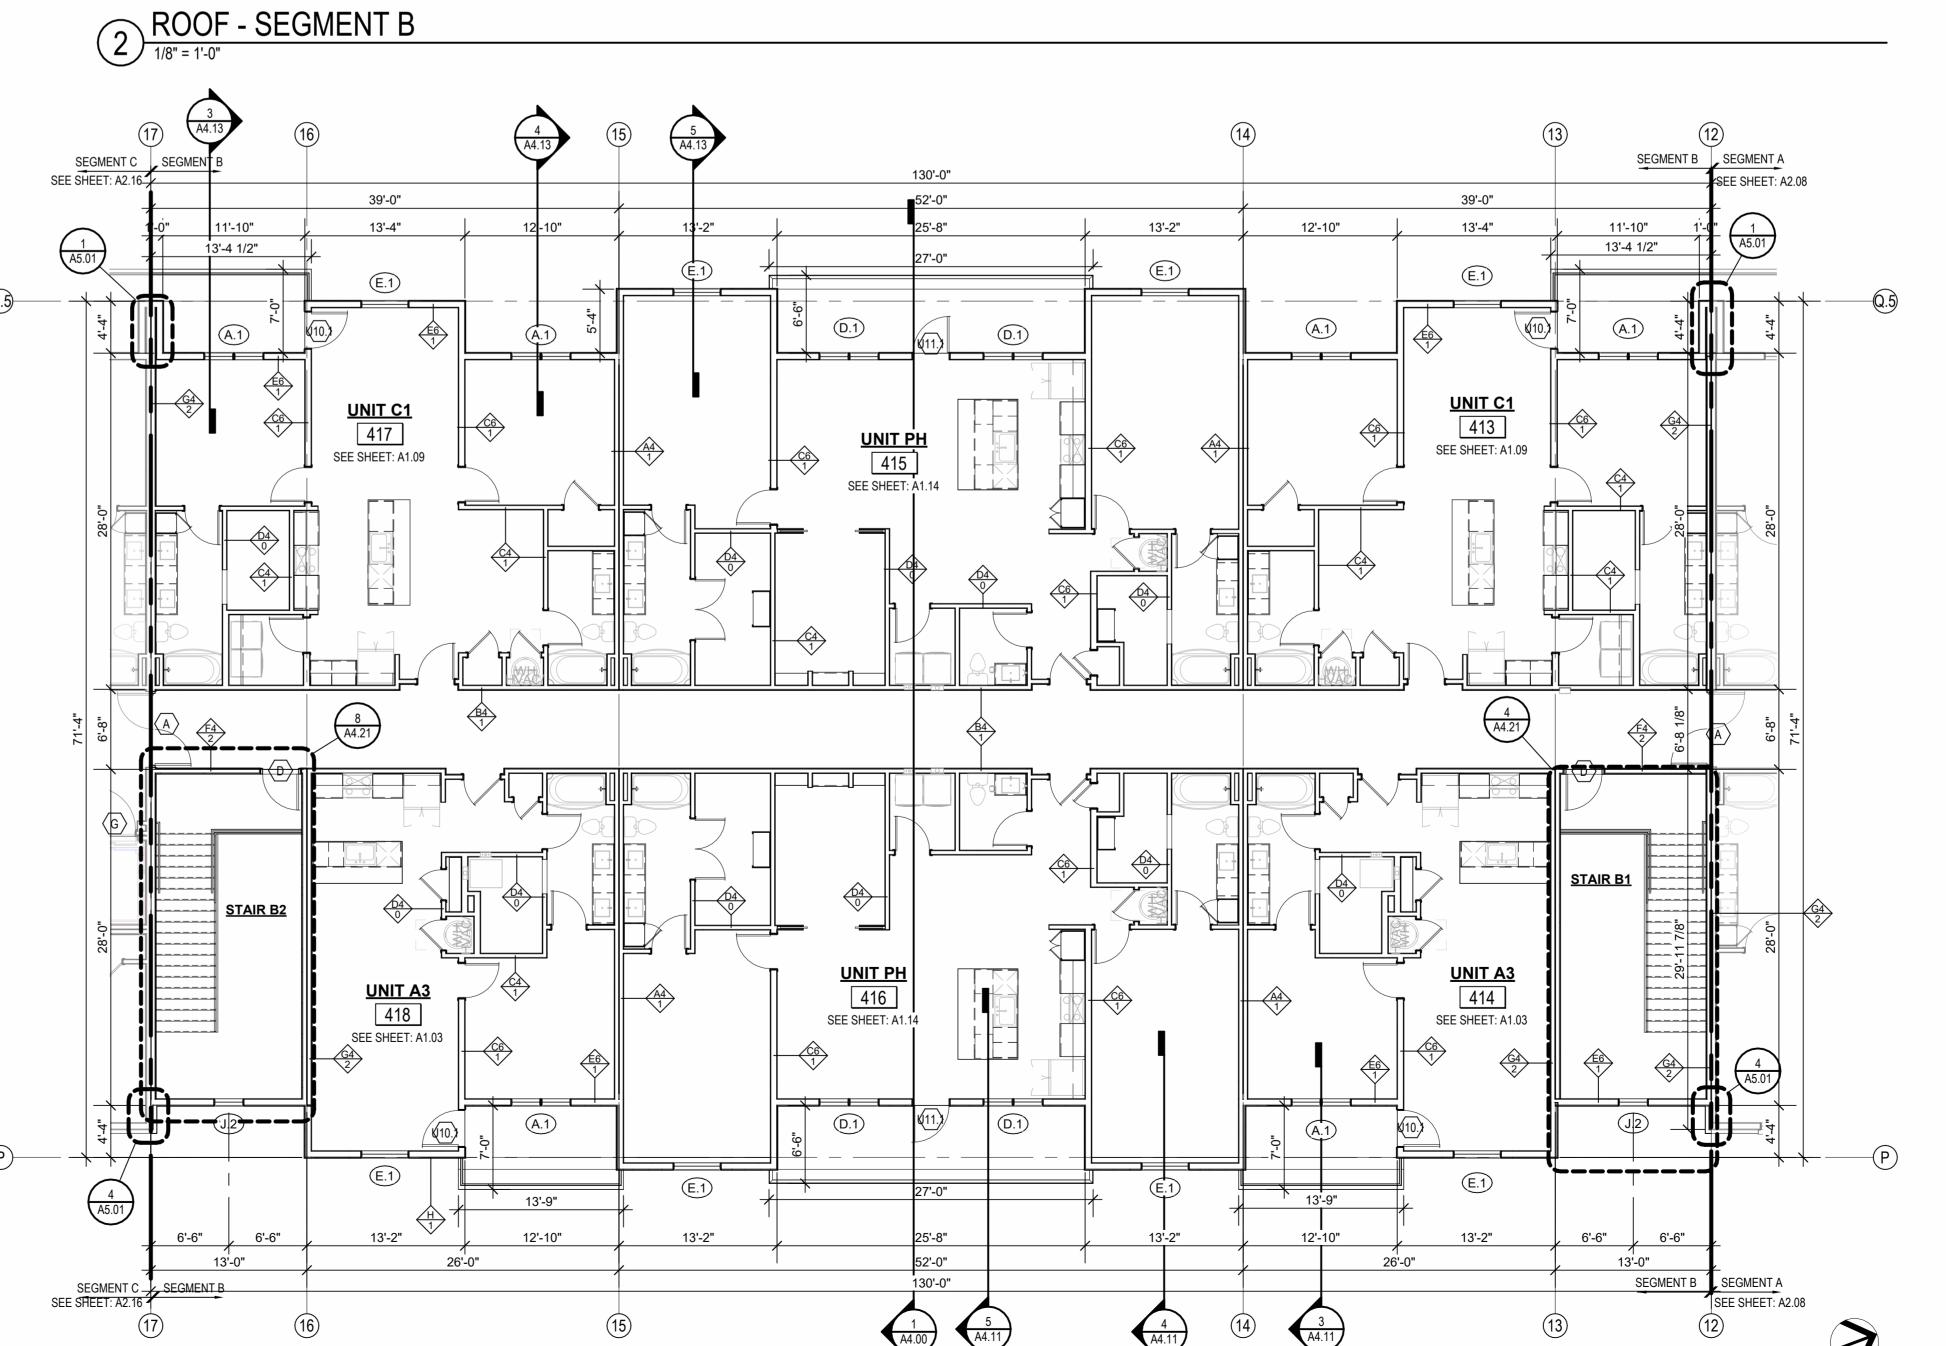FLOOR PLAN GENERAL NOTES:

RATED ASSEMBLY TAGS ARE TYPICAL AT SIMILAR LOCATIONS NOT OTHERWISE NOTED. SEE SHEETS A0.30 AND FOR RATED ASSEMBLIES ALL EXTERIOR COMMON USE DOOR THRESHOLDS TO BE ACCESSIBLE. ALL ACCESSIBLE ENTRANCES SHALL HAVE NO MORE THAN A 1:48 SLOPE FOR A DISTANCE OF 60" PERPENDICULAR TO THE DOOR. FIRE EXTINGUISHER CABINET (F.E.C.) LOCATIONS ARE APPROXIMATE UNLESS NOTED OTHERWISE. CONTRACTOR TO COORDINATE FINAL

LOCATIONS TO NOT CONFLICT WITH WALL FRAMING, UTILITY ROUGH-INS, COORDINATE SECURITY, IT & AV REQUIREMENTS WITH OWNER PRIOR TO CONSTRUCTION. PROVIDE CONDUIT AND PULL STRINGS AS NEEDED. PROVIDE VERTICAL GYPSUM BOARD CONTROL JOINTS AT 30'-0" O.C. MAX. COORDINATE TO MEET FIRE RESISTIVE RATINGS OF THE ASSEMBLY AND

FIRESTOP JOINTS AT RATED PARTITIONS. VERIFY FINAL LOCATIONS WITH ARCHITECT PRIOR TO INSTALLATION.

ROOF PLAN GENERAL NOTES:

REFER TO BUILDING ELEVATIONS FOR DOWNSPOUT LOCATIONS. ALL OBJECTS INDICATED ON THE ROOF ARE GENERAL AND MUST BE COORDINATED WITH MEP AND STRUCTURAL ELEMENTS. REFER TO MEP DRAWINGS FOR ACTUAL MECHANICAL EQUIPMENT LOCATIONS. ALL FLAT ROOFS SHALL SLOPE 1/4" PER FOOT MINIMUM. ALL CRICKETS SHALL SLOPE 1/4" PER FOOT MINIMUM. PROVIDE ALL ROOFING DETAILS BY MANUFACTURER'S WARRANTED PROVIDE KICK-OUT FLASHING AT ALL SIDE-WALL CONDITIONS.

ALL ROOFING DETAILS TO BE PER MANUFACTURER'S WARRANTED SYSTEM.


RAISED CEILING HEIGHT KEY

11'-0" CEILING 12'-0" CEILING



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DATE **03.15.2023**

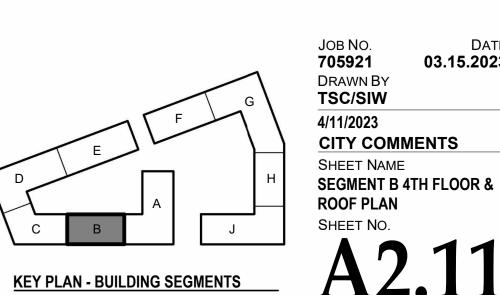

1 4TH FLOOR - SEGMENT B

FLOOR PLAN GENERAL NOTES:

1. RATED ASSEMBLY TAGS ARE TYPICAL AT SIMILAR LOCATIONS NOT

OTHERWISE NOTED.
SEE SHEETS A0.30 AND FOR RATED ASSEMBLIES
ALL EXTERIOR COMMON USE DOOR THRESHOLDS TO BE ACCESSIBLE. ALL
ACCESSIBLE ENTRANCES SHALL HAVE NO MORE THAN A 1:48 SLOPE FOR A
DISTANCE OF 60" PERPENDICULAR TO THE DOOR.
FIRE EXTINGUISHER CABINET (F.E.C.) LOCATIONS ARE APPROXIMATE

DISTANCE OF 60" PERPENDICULAR TO THE DOOR.


4. FIRE EXTINGUISHER CABINET (F.E.C.) LOCATIONS ARE APPROXIMATE UNLESS NOTED OTHERWISE. CONTRACTOR TO COORDINATE FINAL LOCATIONS TO NOT CONFLICT WITH WALL FRAMING, UTILITY ROUGH-INS, TRIM/PANELING, ETC.

5. COORDINATE SECURITY, IT & AV REQUIREMENTS WITH OWNER PRIOR TO CONSTRUCTION. PROVIDE CONDUIT AND PULL STRINGS AS NEEDED.

TRIM/PANELING, ETC.
 COORDINATE SECURITY, IT & AV REQUIREMENTS WITH OWNER PRIOR TO CONSTRUCTION. PROVIDE CONDUIT AND PULL STRINGS AS NEEDED.
 PROVIDE VERTICAL GYPSUM BOARD CONTROL JOINTS AT 30'-0" O.C. MAX. COORDINATE TO MEET FIRE RESISTIVE RATINGS OF THE ASSEMBLY AND FIRESTOP JOINTS AT RATED PARTITIONS. VERIFY FINAL LOCATIONS WITH ARCHITECT PRIOR TO INSTALLATION.

S W. 75TH ST., SUITE 201



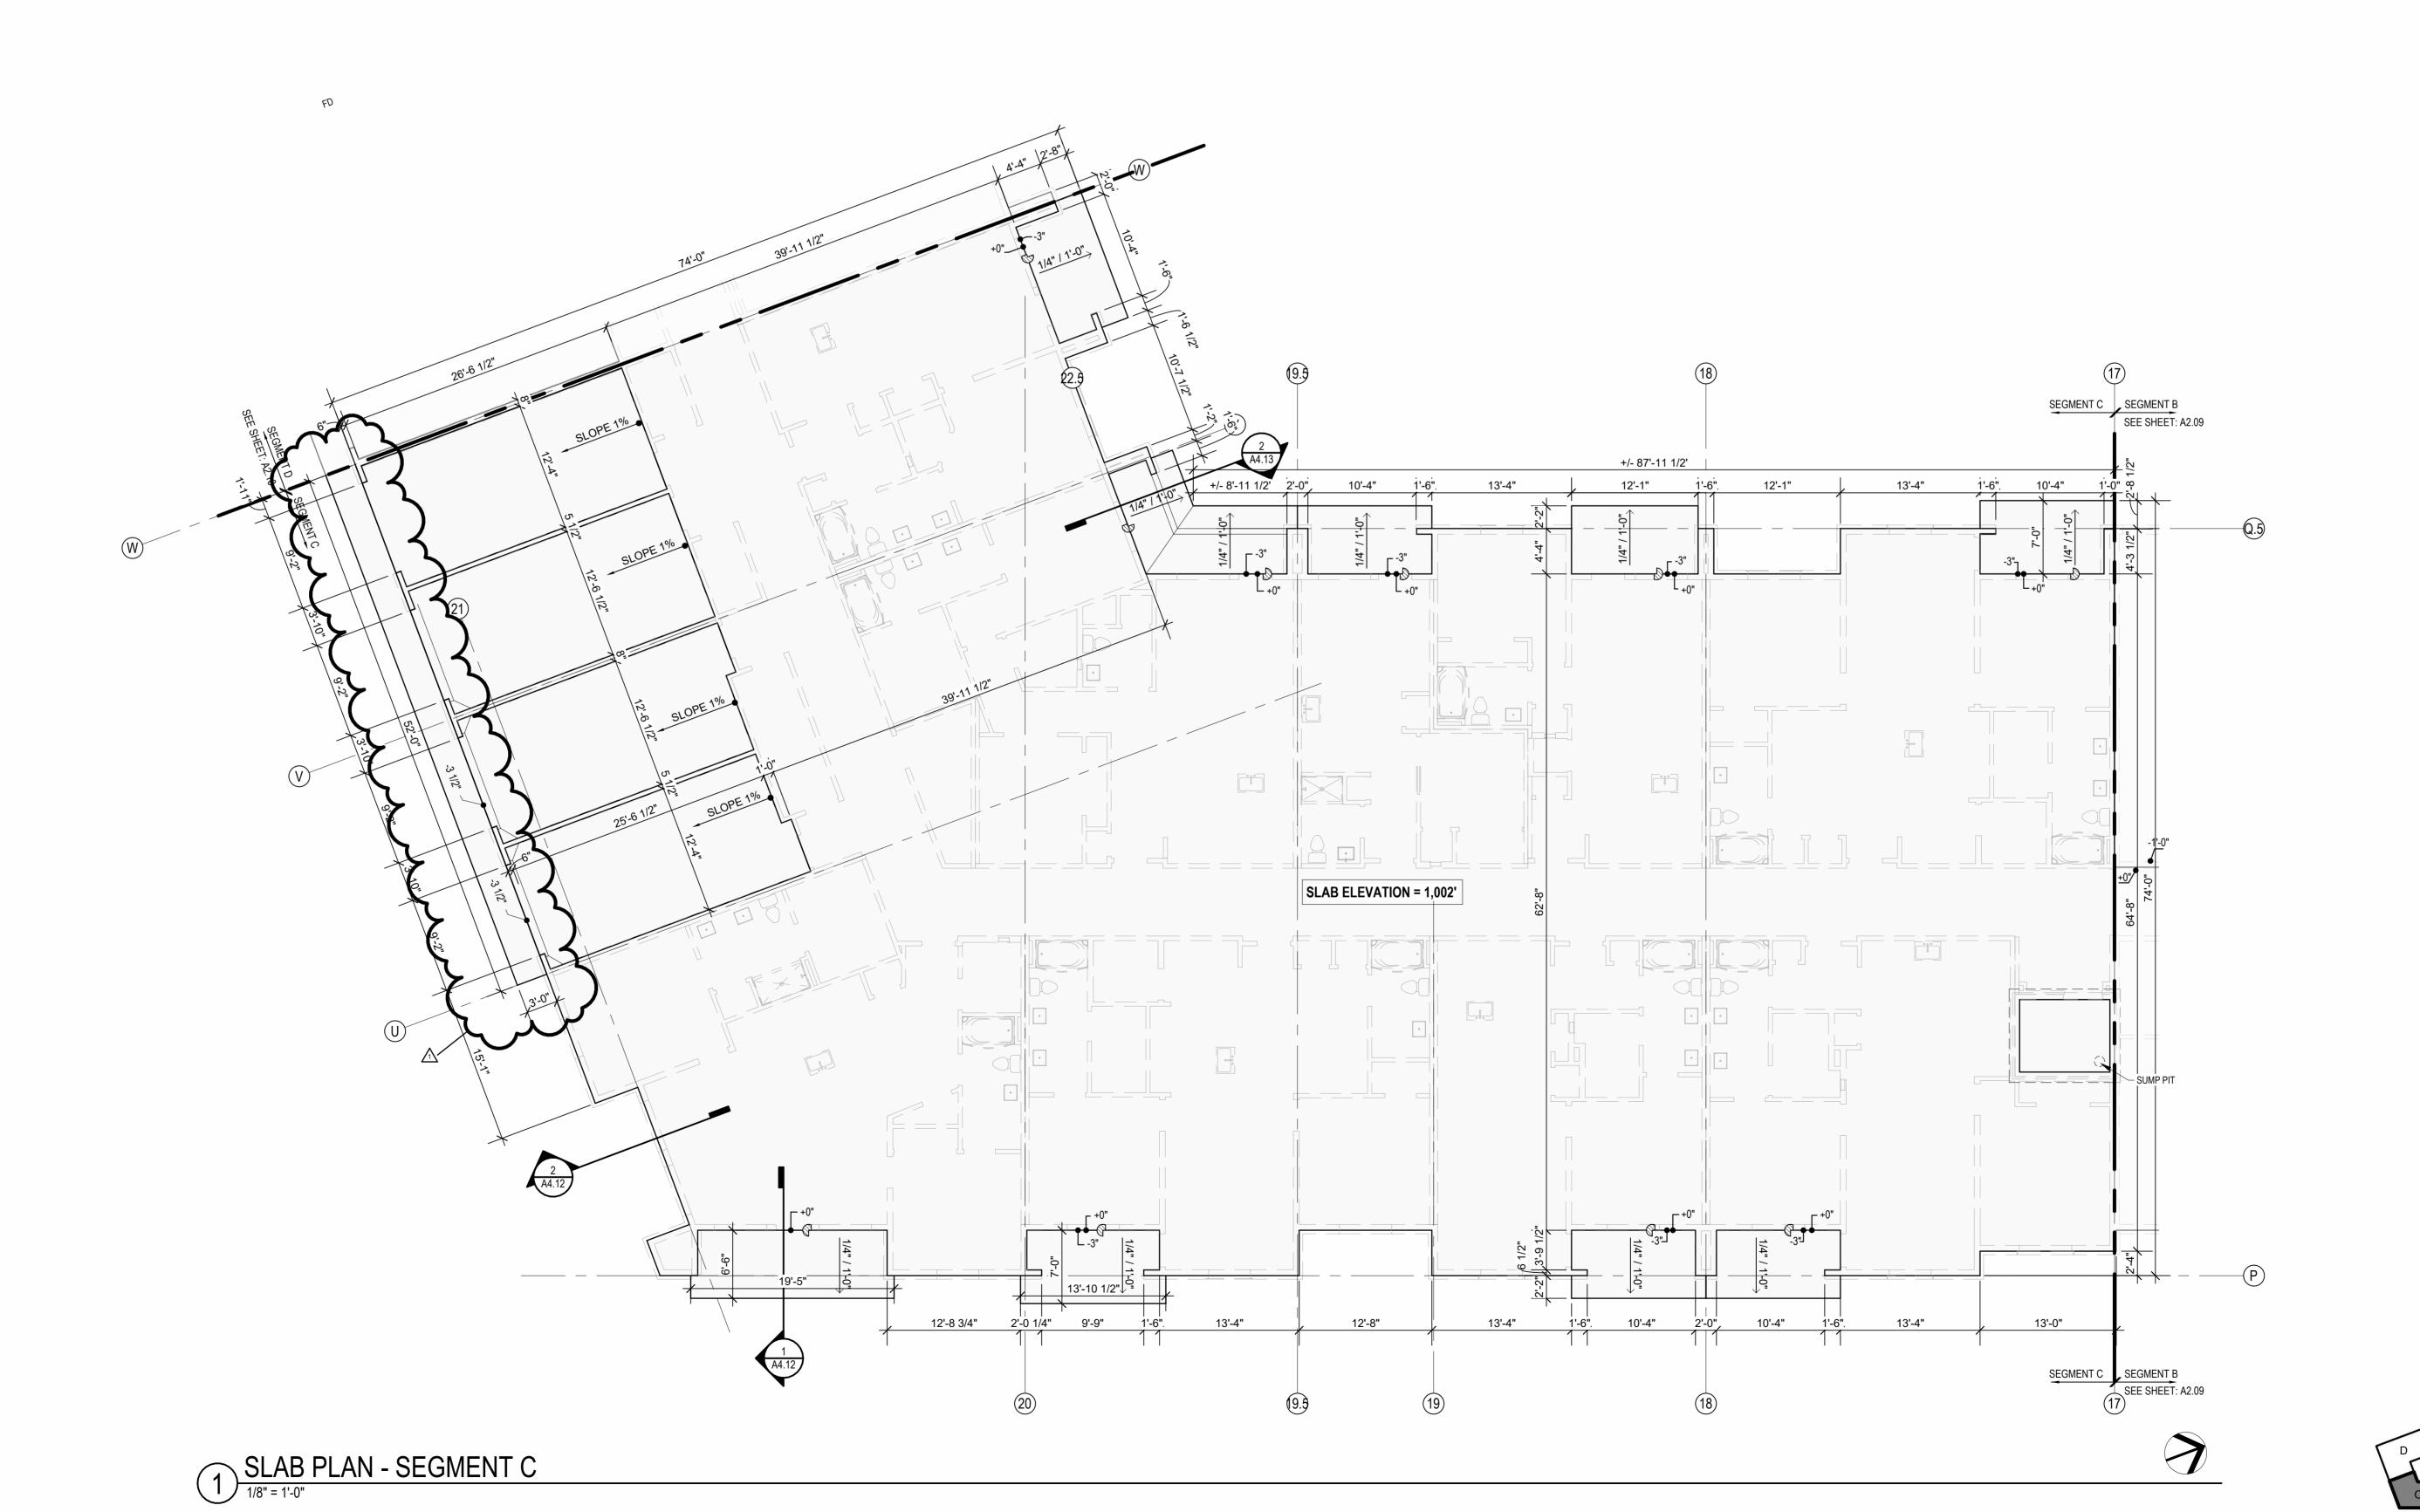

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JOB NO. DATE
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4/11/2023
CITY COMMENTS
SHEET NAME
SEGMENT C SLAB PLAN

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OTHERWISE NOTED.

2. SEE SHEETS A0.30 AND FOR RATED ASSEMBLIES


3. ALL EXTERIOR COMMON USE DOOR THRESHOLDS TO BE ACCESSIBLE. ALL ACCESSIBLE ENTRANCES SHALL HAVE NO MORE THAN A 1:48 SLOPE FOR A DISTANCE OF 60" PERPENDICULAR TO THE DOOR.

4. FIRE EXTINGUISHER CABINET (F.E.C.) LOCATIONS ARE APPROXIMATE UNLESS NOTED OTHERWISE. CONTRACTOR TO COORDINATE FINAL LOCATIONS TO NOT CONFLICT WITH WALL FRAMING, UTILITY ROUGH-INS, TRIM/PANELING, ETC.

COORDINATE SECURITY, IT & AV REQUIREMENTS WITH OWNER PRIOR TO CONSTRUCTION. PROVIDE CONDUIT AND PULL STRINGS AS NEEDED.
 PROVIDE VERTICAL GYPSUM BOARD CONTROL JOINTS AT 30'-0" O.C. MAX. COORDINATE TO MEET FIRE RESISTIVE RATINGS OF THE ASSEMBLY AND FIRESTOP JOINTS AT RATED PARTITIONS. VERIFY FINAL LOCATIONS WITH ARCHITECT PRIOR TO INSTALLATION.

ARCHITECTS PA 3515 W. 75TH ST., SUITE 201



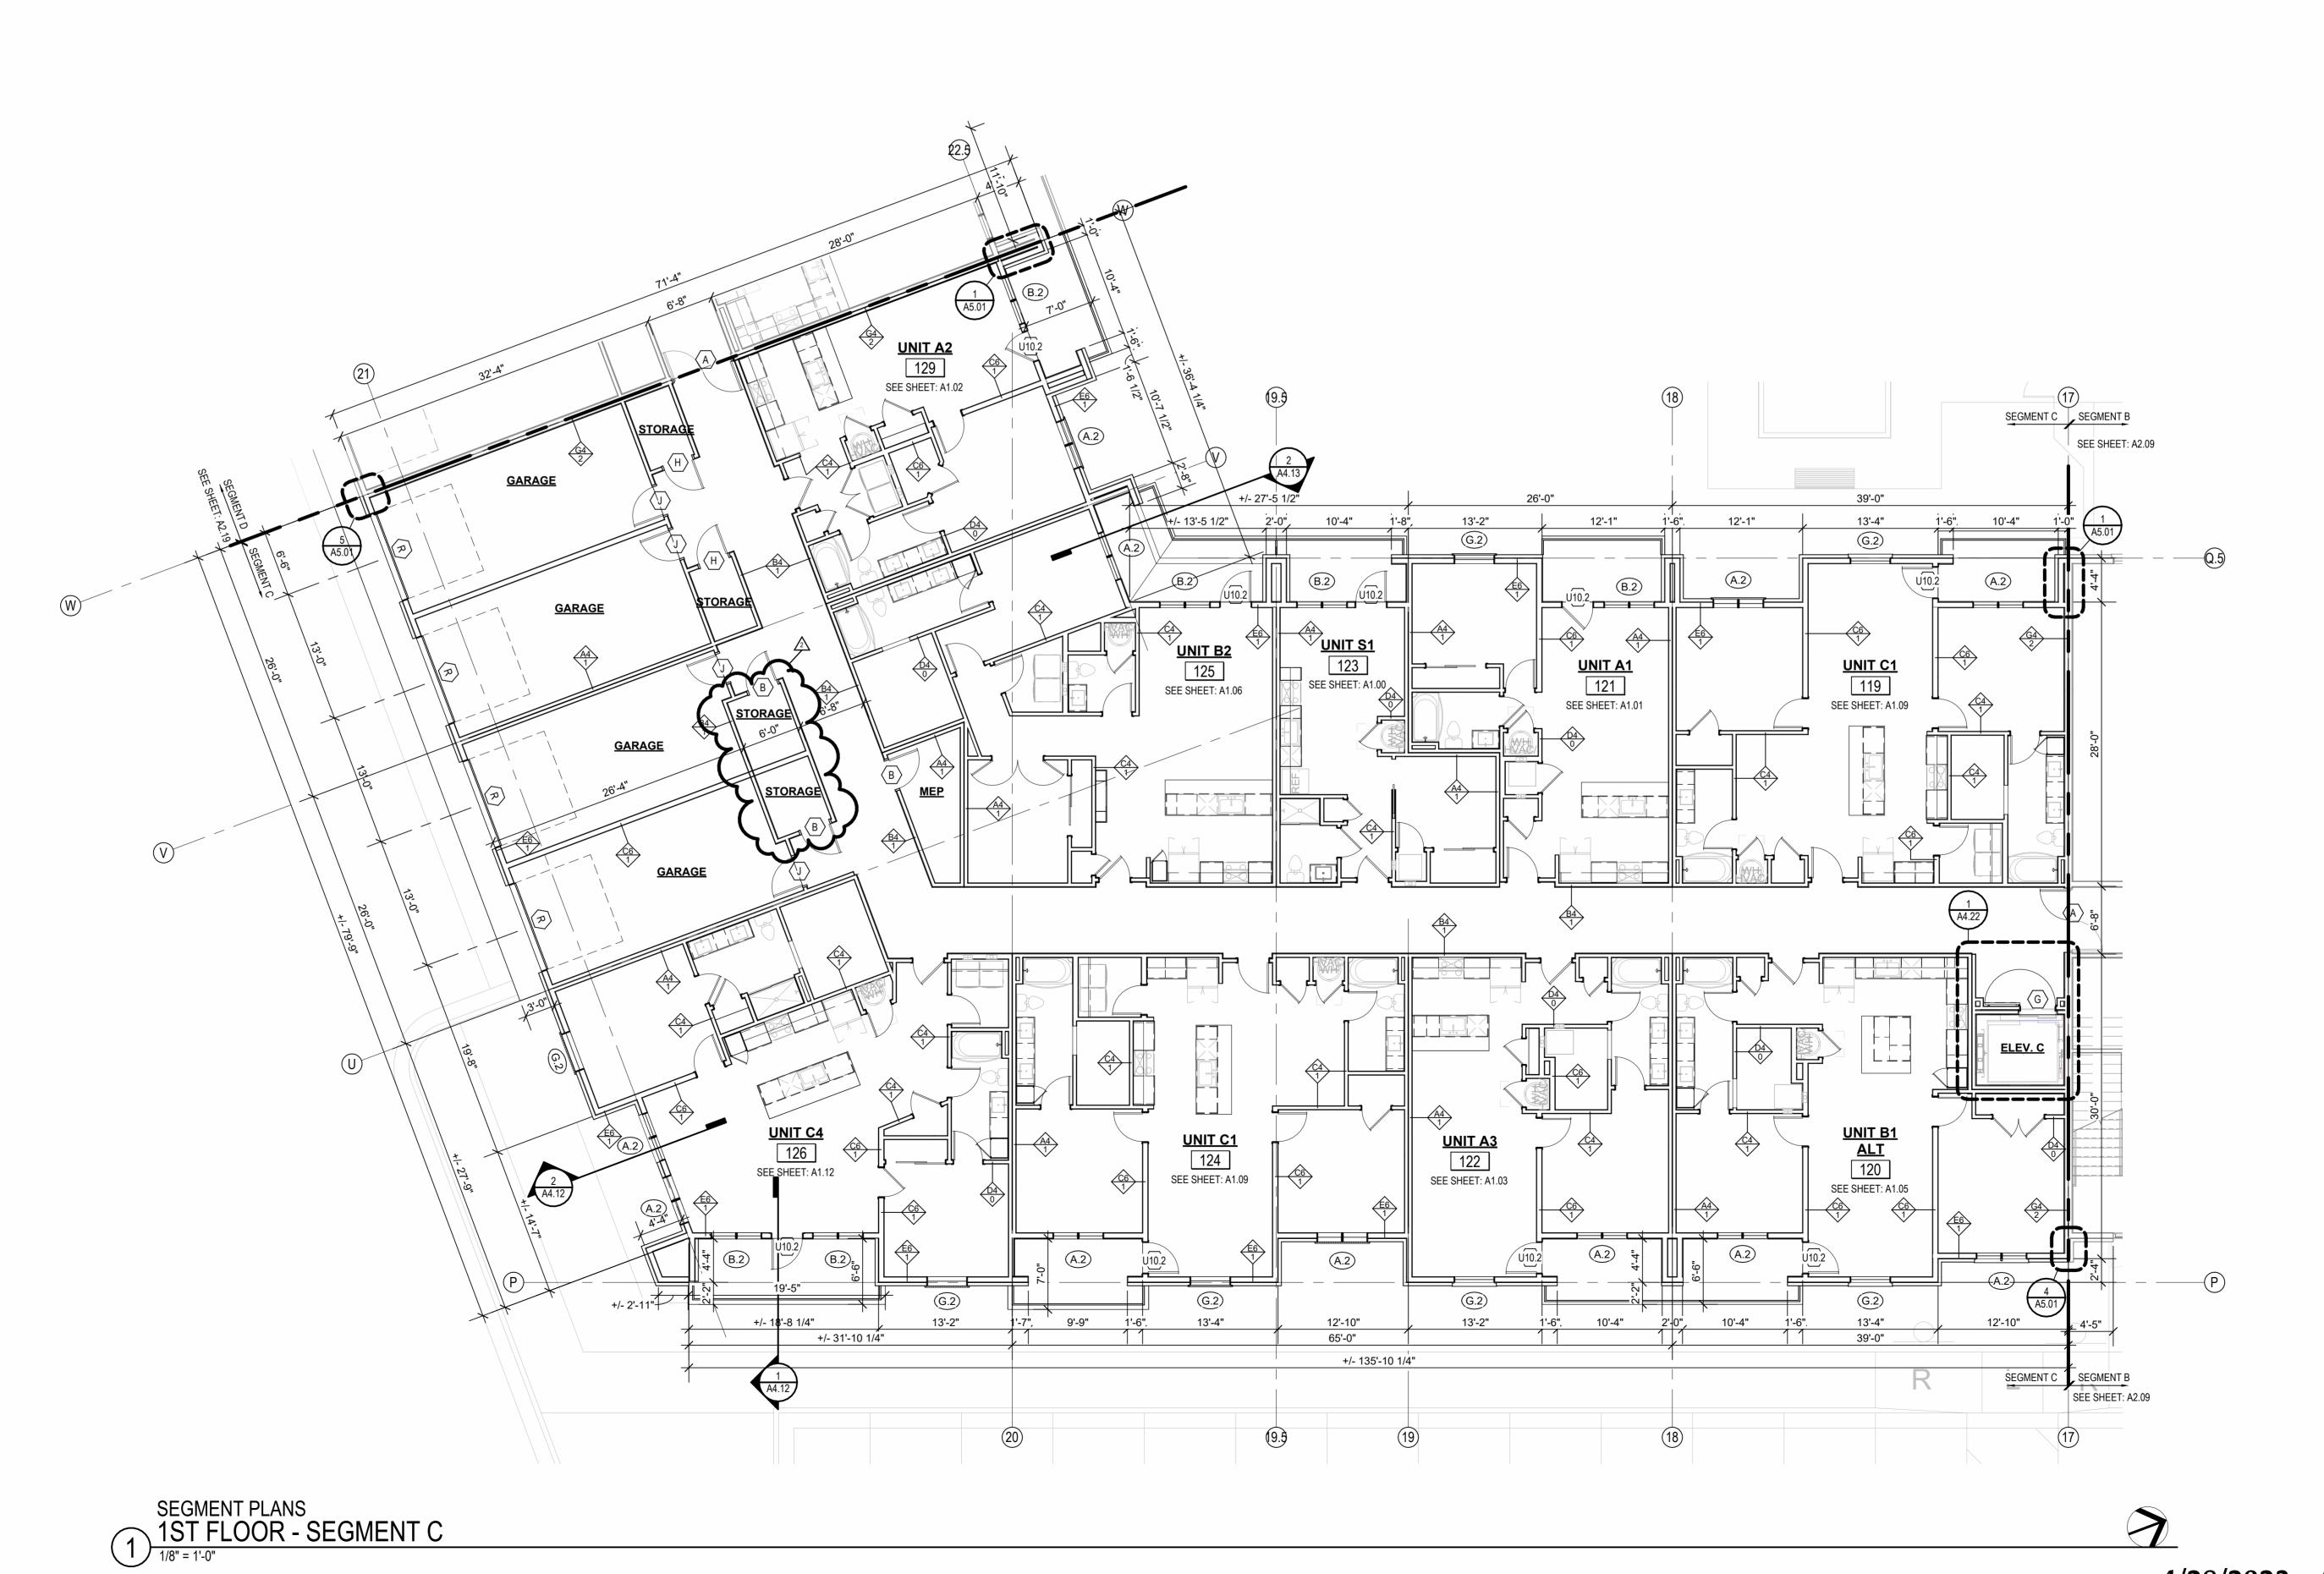

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03.15.2023

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TSC/SIW

SHEET NO.

4/28/2023 ADDENDUM 1/-CITY COMMENTS #2

SEE SHEETS A0.30 AND FOR RATED ASSEMBLIES
ALL EXTERIOR COMMON USE DOOR THRESHOLDS TO BE ACCESSIBLE. ALL ACCESSIBLE ENTRANCES SHALL HAVE NO MORE THAN A 1:48 SLOPE FOR A LOCATIONS TO NOT CONFLICT WITH WALL FRAMING, UTILITY ROUGH-INS, COORDINATE SECURITY, IT & A/V REQUIREMENTS WITH OWNER PRIOR TO

FLOOR PLAN GENERAL NOTES:

OTHERWISE NOTED.

TRIM/PANELING, ETC.

ARCHITECT PRIOR TO INSTALLATION.

RATED ASSEMBLY TAGS ARE TYPICAL AT SIMILAR LOCATIONS NOT


FIRE EXTINGUISHER CABINET (F.E.C.) LOCATIONS ARE APPROXIMATE UNLESS NOTED OTHERWISE. CONTRACTOR TO COORDINATE FINAL

CONSTRUCTION. PROVIDE CONDUIT AND PULL STRINGS AS NEEDED.

DISTANCE OF 60" PERPENDICULAR TO THE DOOR.

PROVIDE VERTICAL GYPSUM BOARD CONTROL JOINTS AT 30'-0" O.C. MAX. COORDINATE TO MEET FIRE RESISTIVE RATINGS OF THE ASSEMBLY AND FIRESTOP JOINTS AT RATED PARTITIONS. VERIFY FINAL LOCATIONS WITH



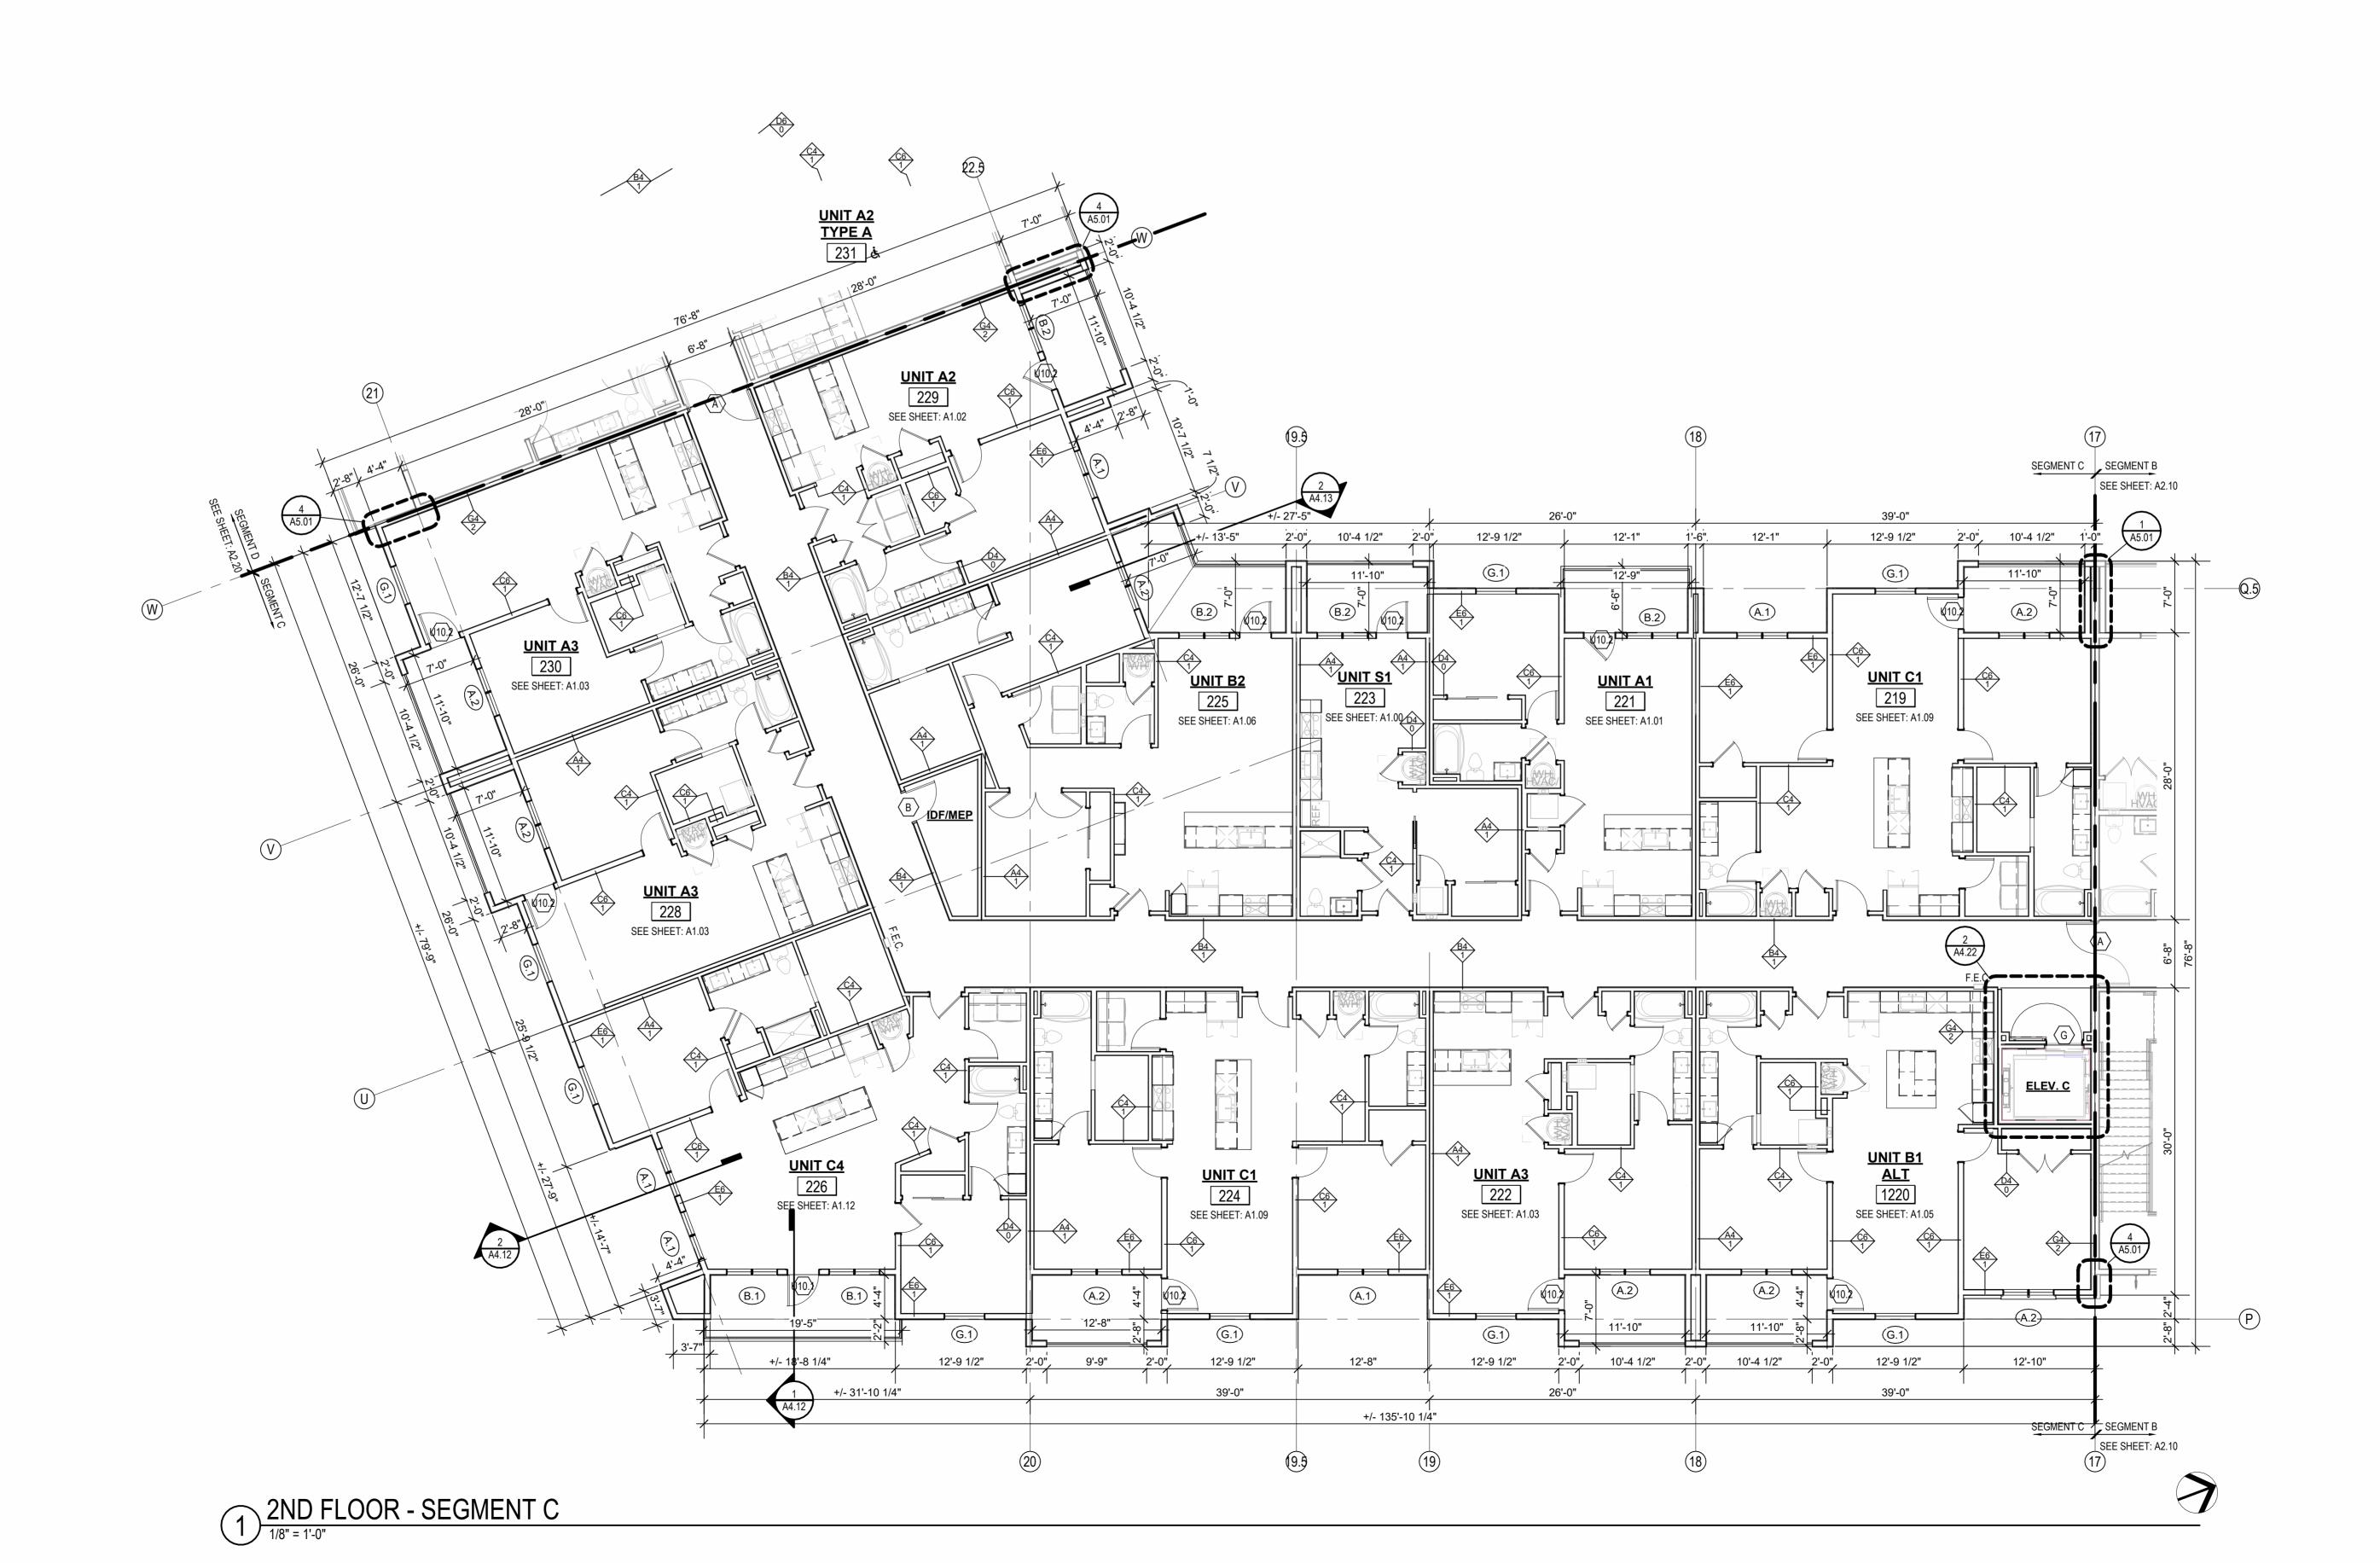

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SHEET NAME
SEGMENT C 2ND FLOOR
PLAN

KEY PLAN - BUILDING SEGMENTS


OTHERWISE NOTED. SEE SHEETS A0.30 AND FOR RATED ASSEMBLIES ALL EXTERIOR COMMON USE DOOR THRESHOLDS TO BE ACCESSIBLE. ALL ACCESSIBLE ENTRANCES SHALL HAVE NO MORE THAN A 1:48 SLOPE FOR A DISTANCE OF 60" PERPENDICULAR TO THE DOOR. FIRE EXTINGUISHER CABINET (F.E.C.) LOCATIONS ARE APPROXIMATE UNLESS NOTED OTHERWISE. CONTRACTOR TO COORDINATE FINAL


LOCATIONS TO NOT CONFLICT WITH WALL FRAMING, UTILITY ROUGH-INS, TRIM/PANELING, ETC. COORDINATE SECURITY, IT & A/V REQUIREMENTS WITH OWNER PRIOR TO CONSTRUCTION. PROVIDE CONDUIT AND PULL STRINGS AS NEEDED. PROVIDE VERTICAL GYPSUM BOARD CONTROL JOINTS AT 30'-0" O.C. MAX. COORDINATE TO MEET FIRE RESISTIVE RATINGS OF THE ASSEMBLY AND

ARCHITECT PRIOR TO INSTALLATION.

FIRESTOP JOINTS AT RATED PARTITIONS. VERIFY FINAL LOCATIONS WITH



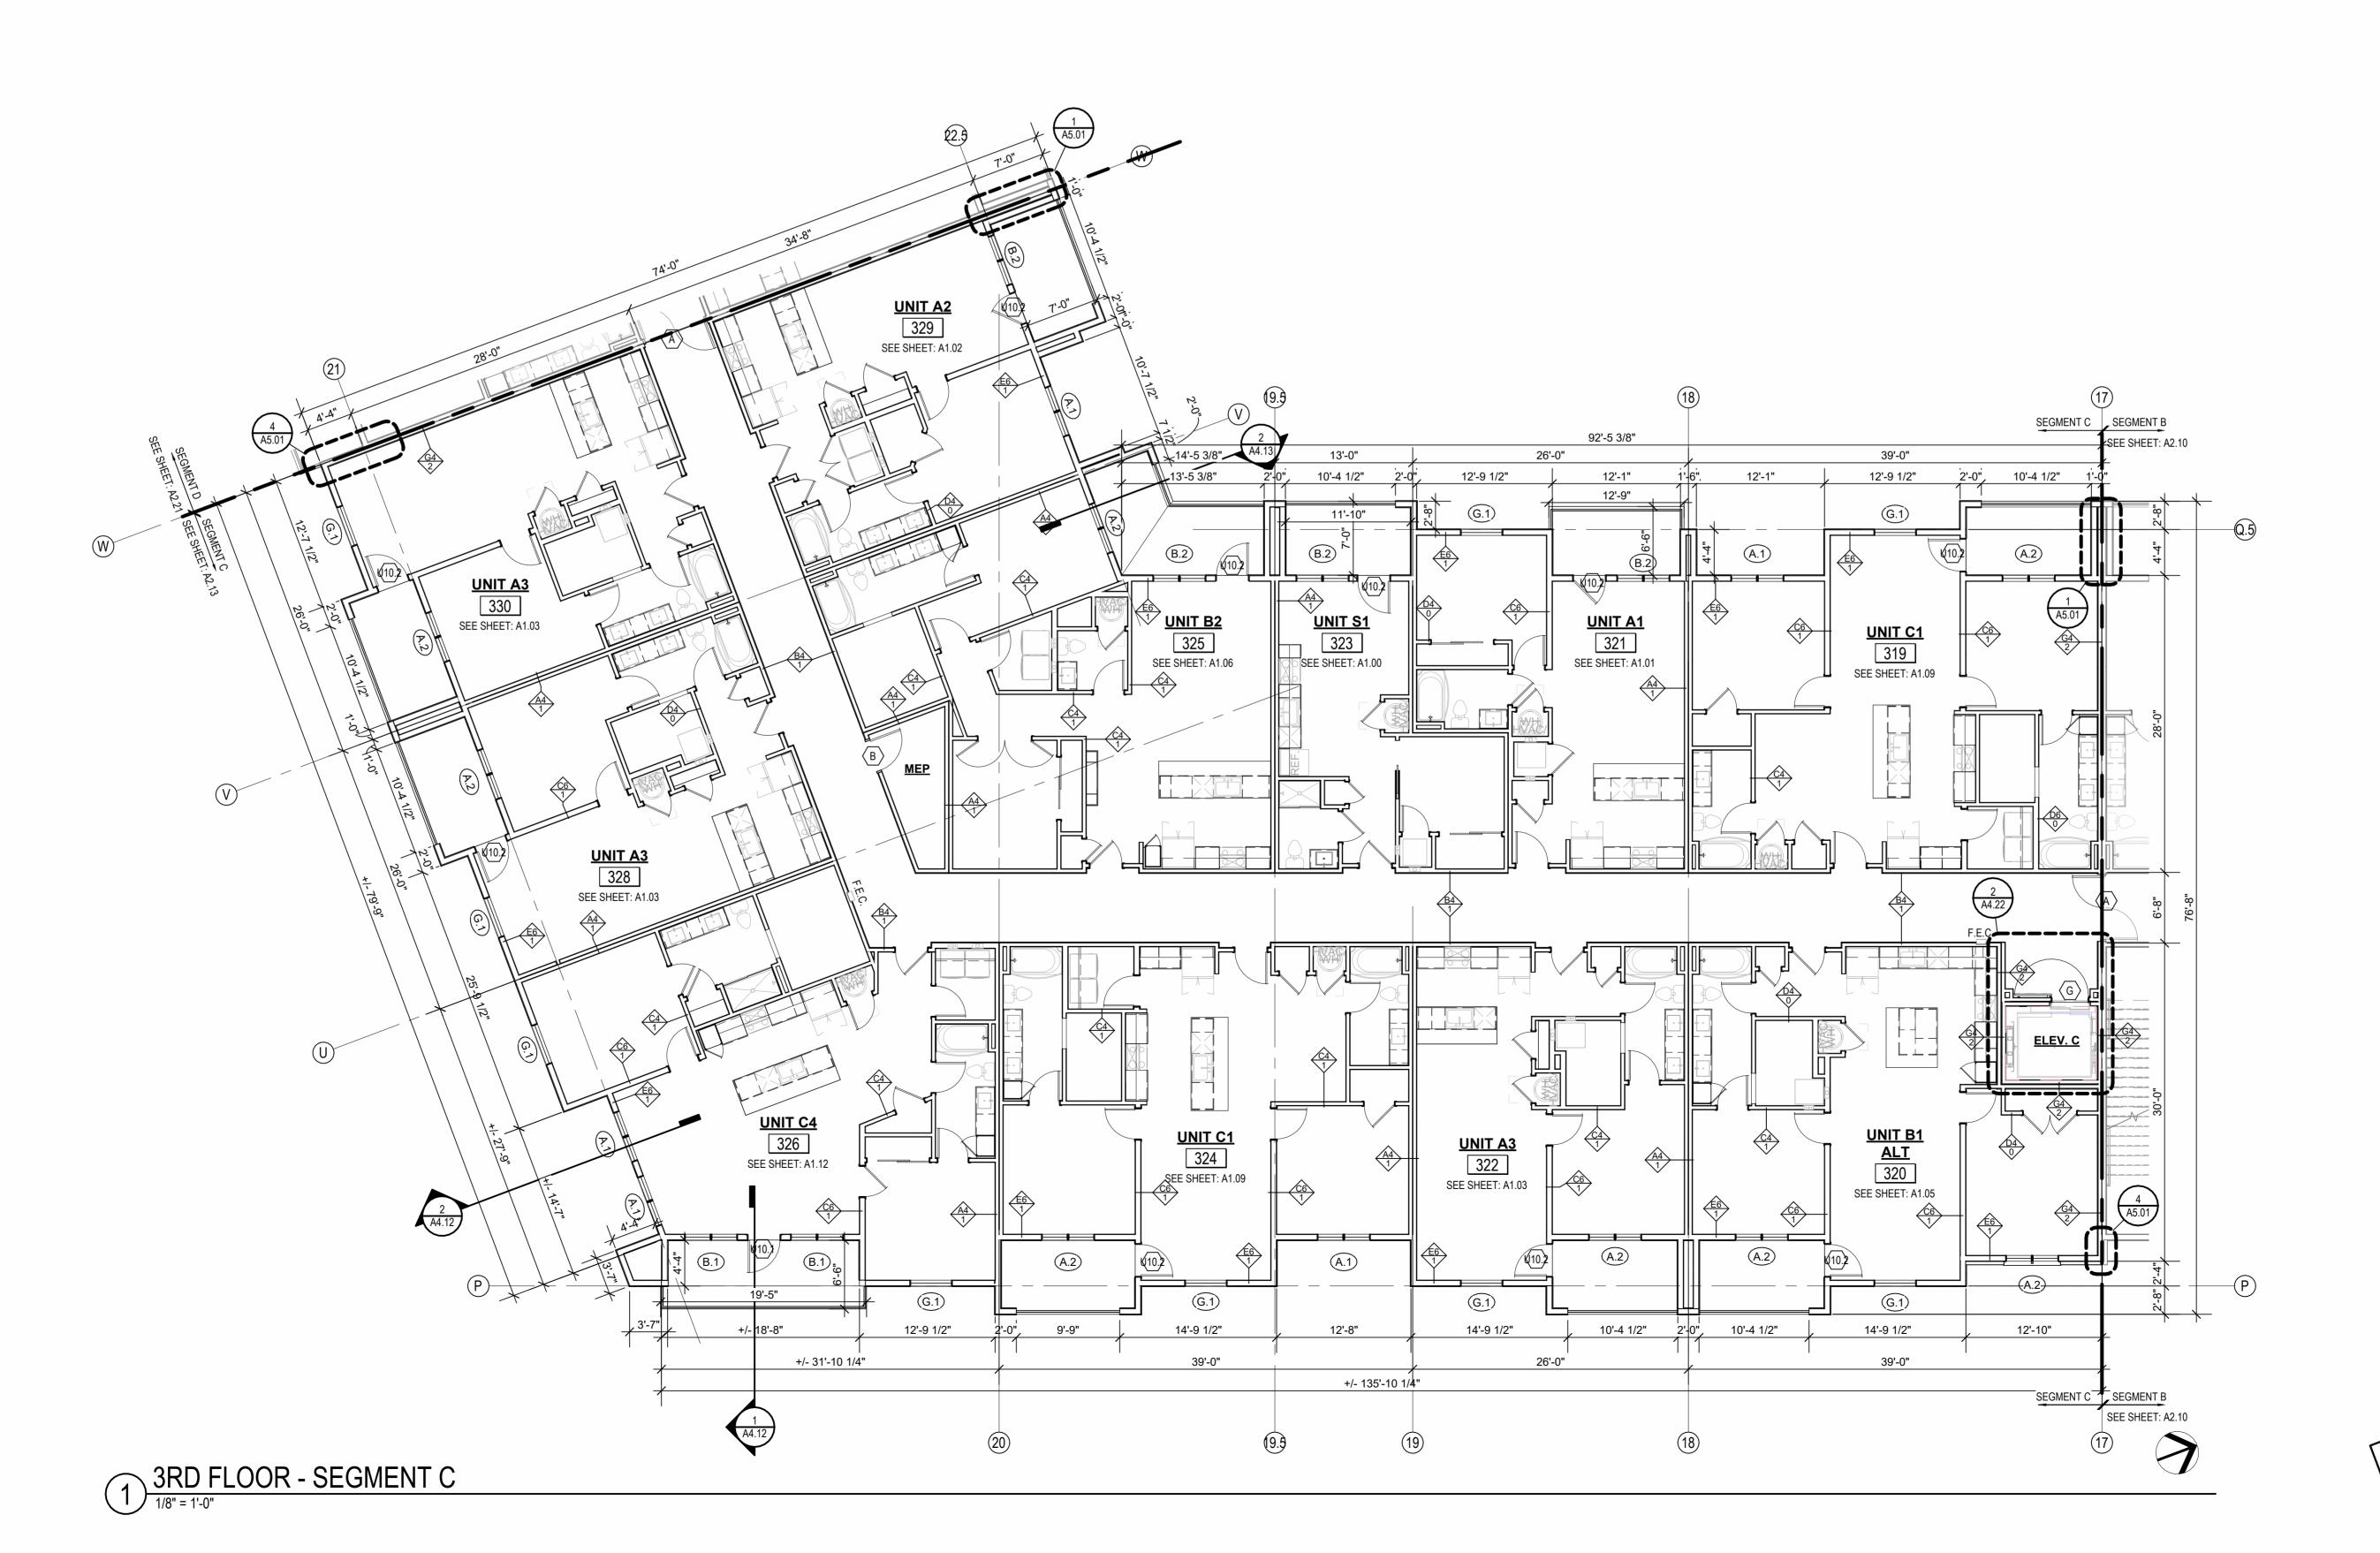

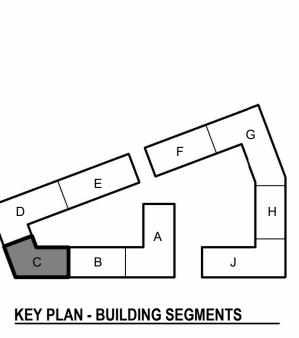

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CITY COMMENTS
SHEET NAME
SEGMENT C 3RD FLOOR
PLAN


OTHERWISE NOTED. SEE SHEETS A0.30 AND FOR RATED ASSEMBLIES
ALL EXTERIOR COMMON USE DOOR THRESHOLDS TO BE ACCESSIBLE. ALL ACCESSIBLE ENTRANCES SHALL HAVE NO MORE THAN A 1:48 SLOPE FOR A DISTANCE OF 60" PERPENDICULAR TO THE DOOR. FIRE EXTINGUISHER CABINET (F.E.C.) LOCATIONS ARE APPROXIMATE

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ARCHITECT PRIOR TO INSTALLATION.

PROVIDE VERTICAL GYPSUM BOARD CONTROL JOINTS AT 30'-0" O.C. MAX. COORDINATE TO MEET FIRE RESISTIVE RATINGS OF THE ASSEMBLY AND FIRESTOP JOINTS AT RATED PARTITIONS. VERIFY FINAL LOCATIONS WITH



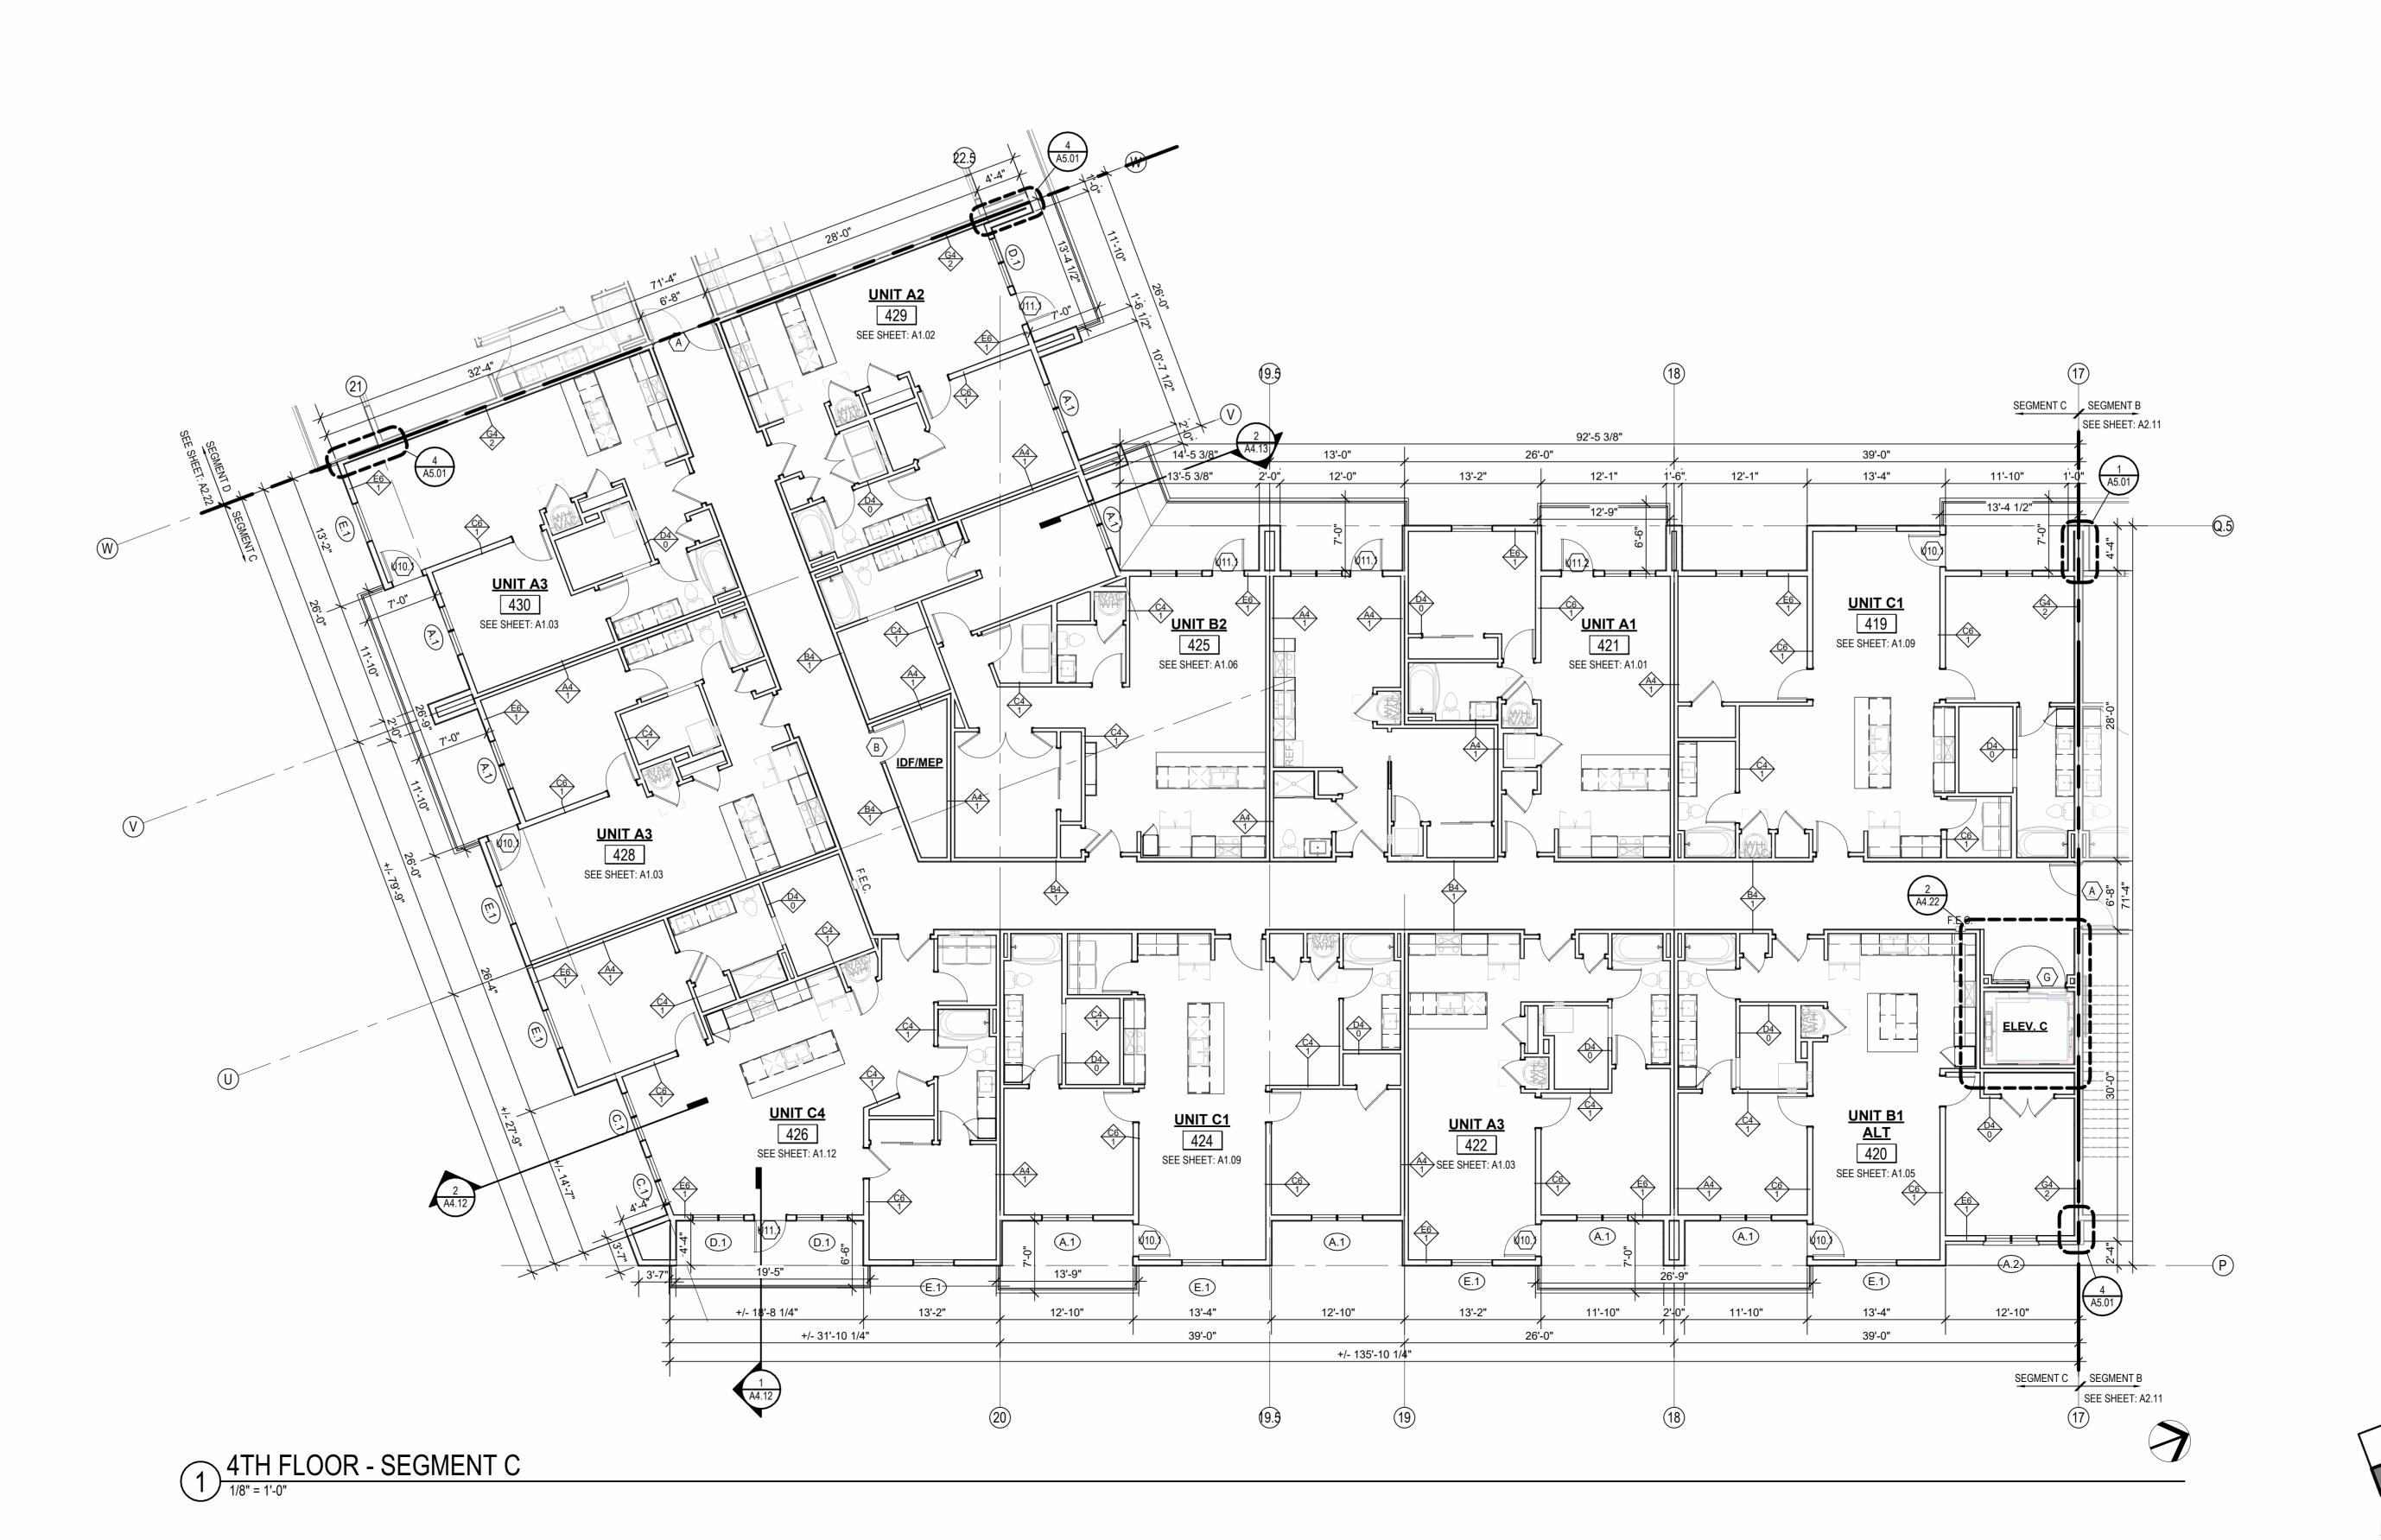

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ROOF VENTING LEGEND

1. ACTIVE VENTILATION PRODUCTS, INC. "INTAKE" POP VENT: (LOCATIONS AS NOTED ON DRAWINGS)

> - MAINTAIN 36" CLEAR FROM POP VENT CAP TO ADJACENT CONDENSING UNITS, TYP. WHERE REQUIRED FOR MAINTENANCE. RE: MECH/MFR INFO FOR ADDITIONAL OR ALTERNATE MIN. CLEARANCES. NOTE: COORDINATION W/MEP LOCATION OF CURB INLETS, WALL HYDRANTS, AND ANY ADDITIONAL ITEMS.
> *GC PLEASE ADVISE MEP/ARCH OF ANY CONFLICTS

2. ACTIVE VENTILATION PRODUCTS, INC. "EXHAUST" AURA VENT: (LOCATIONS AS NOTED ON DRAWINGS) - MAINTAIN 36" CLEAR FROM POP VENT CAP TO ADJACENT CONDENSING UNITS, TYP. WHERE REQUIRED FOR MAINTENANCE. RE: MECH/MFR INFO FOR ADDITIONAL OR ALTERNATE MIN. CLEARANCES. NOTE: COORDINATION W/MEP LOCATION OF CURB INLETS, WALL HYDRANTS, AND ANY ADDITIONAL ITEMS.
*GC PLEASE ADVISE MEP/ARCH OF ANY CONFLICTS

FLOOR PLAN GENERAL NOTES:

RATED ASSEMBLY TAGS ARE TYPICAL AT SIMILAR LOCATIONS NOT OTHERWISE NOTED.

SEE SHEETS A0.30 AND FOR RATED ASSEMBLIES ALL EXTERIOR COMMON USE DOOR THRESHOLDS TO BE ACCESSIBLE. ALL ACCESSIBLE ENTRANCES SHALL HAVE NO MORE THAN A 1:48 SLOPE FOR A DISTANCE OF 60" PERPENDICULAR TO THE DOOR. FIRE EXTINGUISHER CABINET (F.E.C.) LOCATIONS ARE APPROXIMATE

UNLESS NOTED OTHERWISE. CONTRACTOR TO COORDINATE FINAL LOCATIONS TO NOT CONFLICT WITH WALL FRAMING, UTILITY ROUGH-INS, TRIM/PANELING, ETC. COORDINATE SECURITY, IT & A/V REQUIREMENTS WITH OWNER PRIOR TO CONSTRUCTION. PROVIDE CONDUIT AND PULL STRINGS AS NEEDED. PROVIDE VERTICAL GYPSUM BOARD CONTROL JOINTS AT 30'-0" O.C. MAX.

ARCHITECT PRIOR TO INSTALLATION.

REFER TO BUILDING ELEVATIONS FOR DOWNSPOUT LOCATIONS.
ALL OBJECTS INDICATED ON THE ROOF ARE GENERAL AND MUST BE COORDINATED WITH MEP AND STRUCTURAL ELEMENTS. REFER TO MEP DRAWINGS FOR ACTUAL MECHANICAL EQUIPMENT LOCATIONS. ALL FLAT ROOFS SHALL SLOPE 1/4" PER FOOT MINIMUM. ALL CRICKETS SHALL SLOPE 1/4" PER FOOT MINIMUM. PROVIDE ALL ROOFING DETAILS BY MANUFACTURER'S WARRANTED

ALL ROOFING DETAILS TO BE PER MANUFACTURER'S WARRANTED SYSTEM.

REQUIEMENTS PER 2018 IBC SECTION 1202.2:

PROVIDE 40%-50% VENT AREA HIGH, 50%-60% LOW

PROPOSED ROOF VENTILATION LOW: POP VENT INTAKE (254 SQ. IN. NET FREE AREA PER VENT)


RAISED CEILING HEIGHT KEY

11'-0" CEILING

12'-0" CEILING

NOT FOR CONSTRUCTION

913.831.1² 913.831.1⁵ SPJARCH.CC

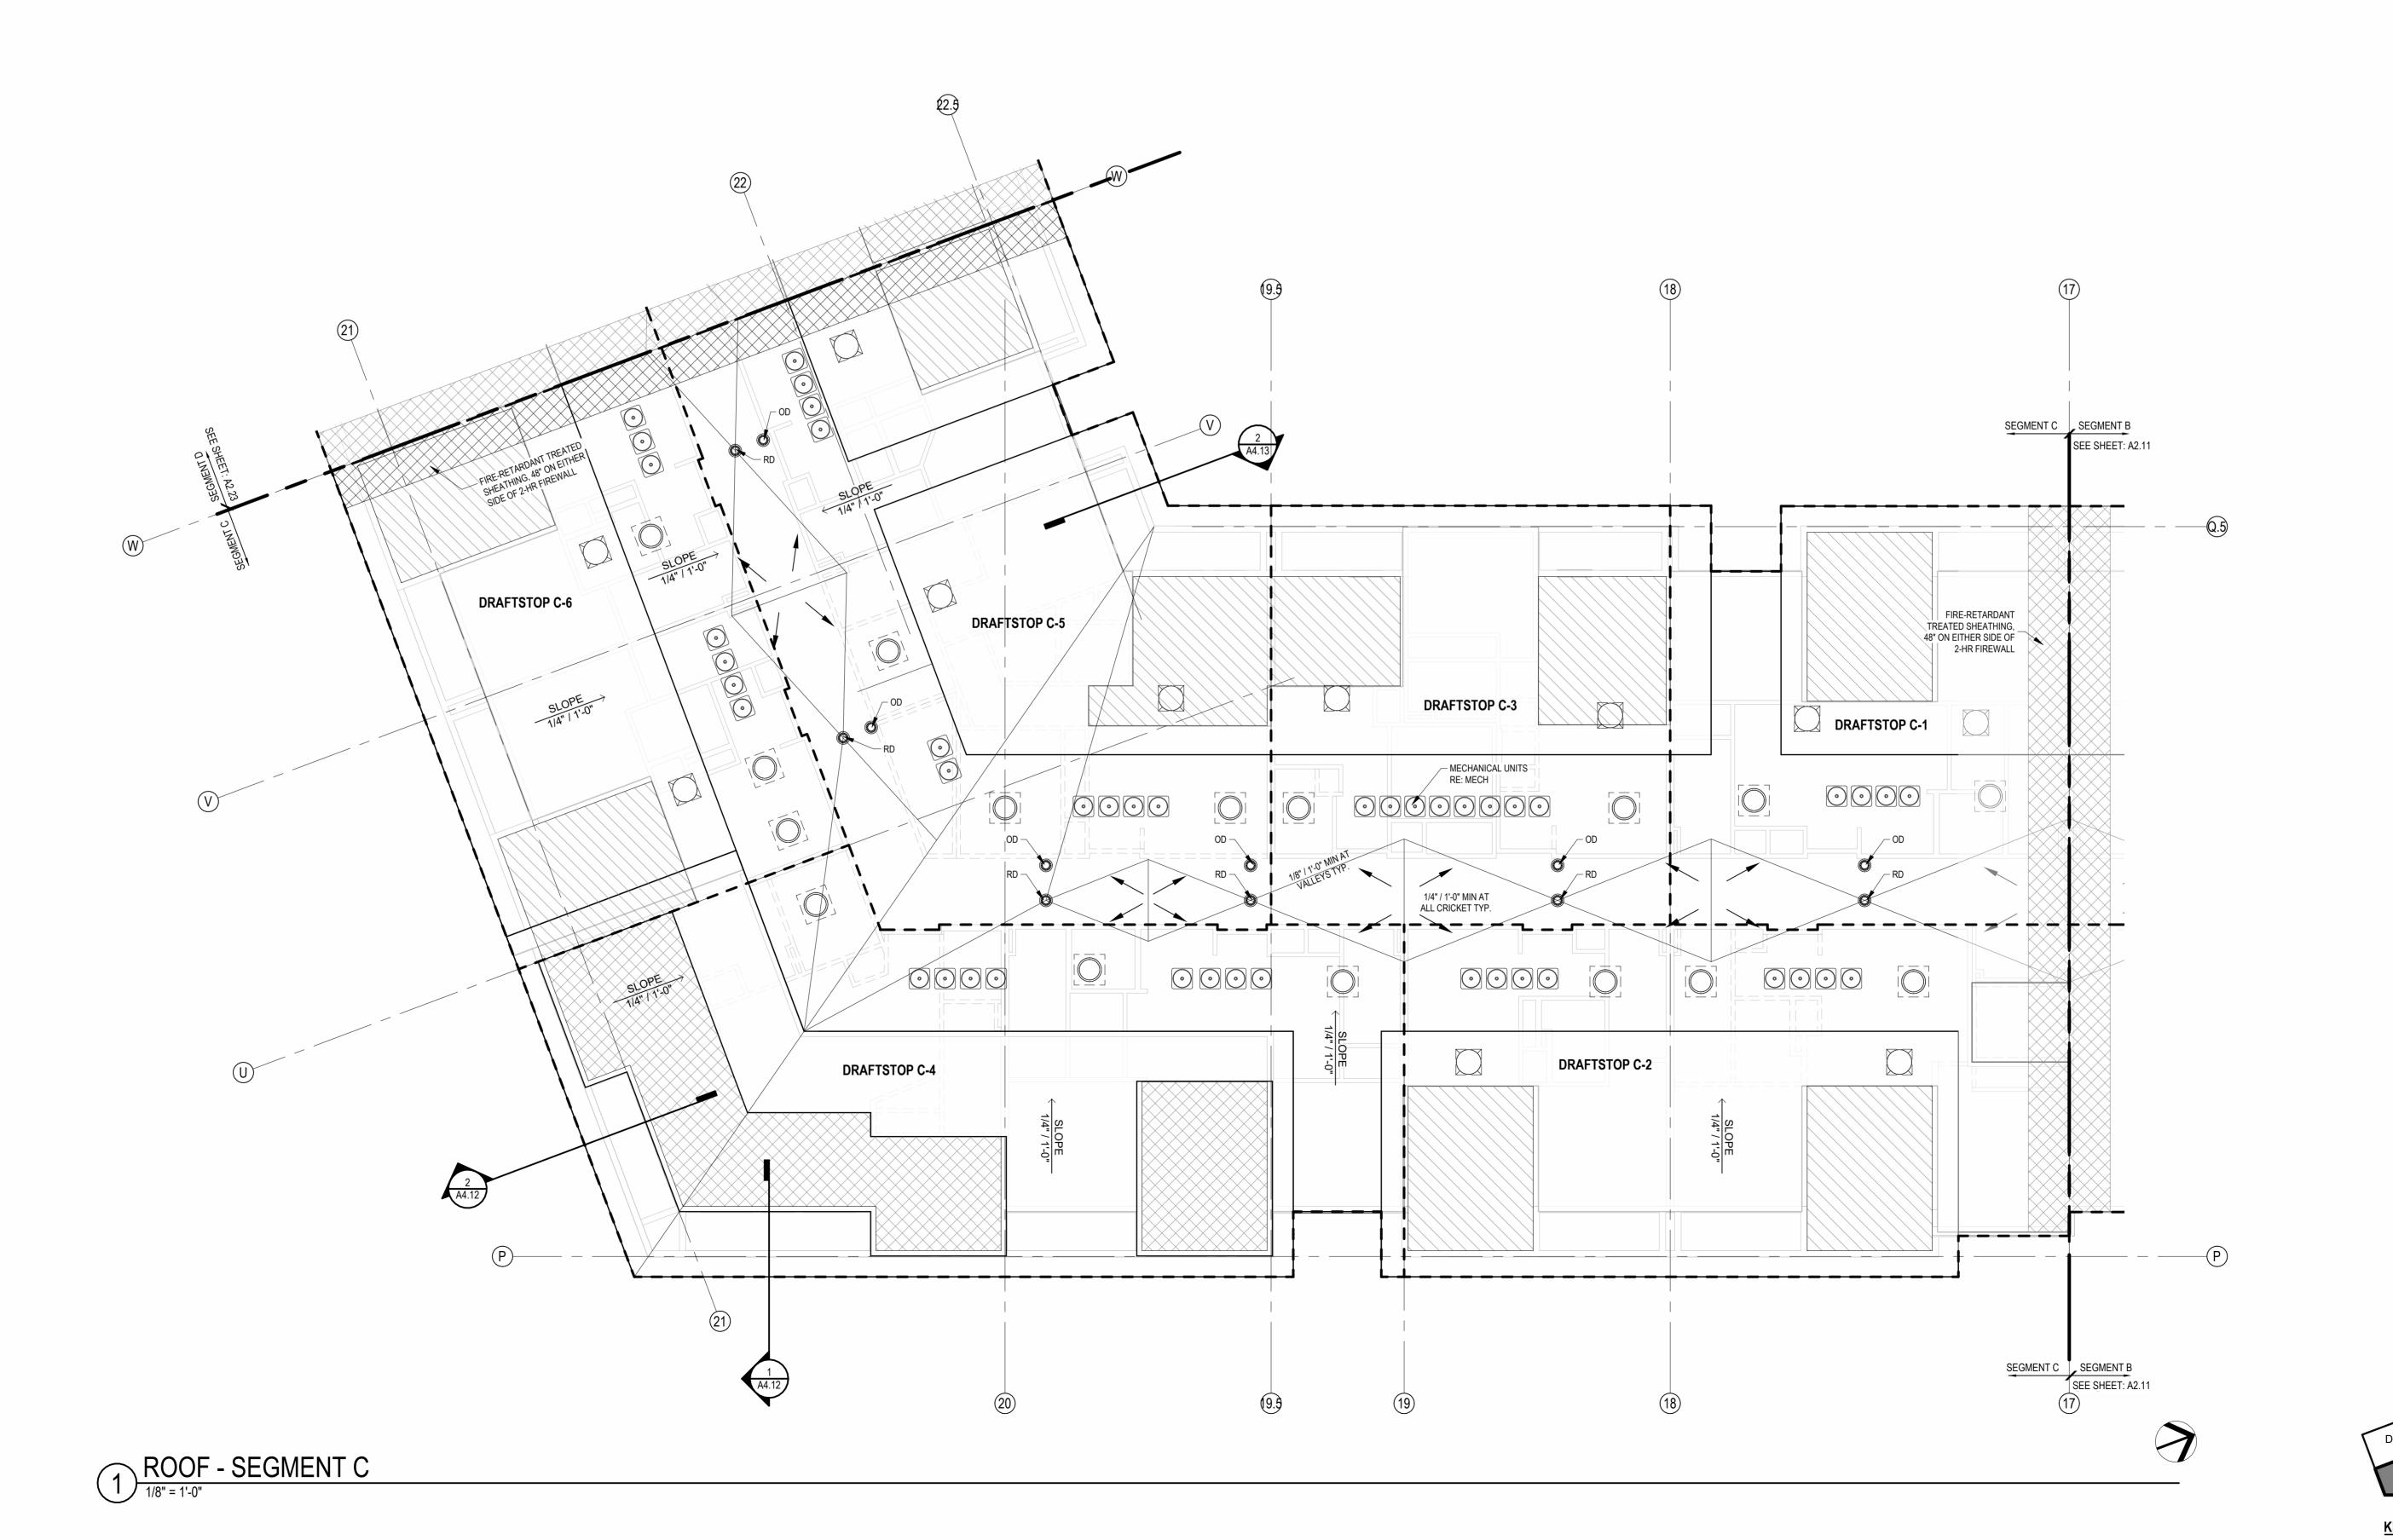

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DATE **03.15.2023** Јов No. **705921** DRAWN BY TSC/SIW 4/11/2023
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COORDINATE TO MEET FIRE RESISTIVE RATINGS OF THE ASSEMBLY AND FIRESTOP JOINTS AT RATED PARTITIONS. VERIFY FINAL LOCATIONS WITH

ROOF PLAN GENERAL NOTES:

PROVIDE KICK-OUT FLASHING AT ALL SIDE-WALL CONDITIONS.

ATTIC VENTING REQUIREMENTS MIN. NET FREE AREA OF ROOF VENTILATION: 1/300 ROOF AREA


HIGH: AURA ROOF VENT (254 SQ. IN NET FREE AREA PER VENT)

OTHERWISE NOTED.
SEE SHEETS A0.30 AND FOR RATED ASSEMBLIES
ALL EXTERIOR COMMON USE DOOR THRESHOLDS TO BE ACCESSIBLE. ALL ACCESSIBLE ENTRANCES SHALL HAVE NO MORE THAN A 1:48 SLOPE FOR A DISTANCE OF 60" PERPENDICULAR TO THE DOOR. FIRE EXTINGUISHER CABINET (F.E.C.) LOCATIONS ARE APPROXIMATE UNLESS NOTED OTHERWISE. CONTRACTOR TO COORDINATE FINAL LOCATIONS TO NOT CONFLICT WITH WALL FRAMING, UTILITY ROUGH-INS,

TRIM/PANELING, ETC.
COORDINATE SECURITY, IT & A/V REQUIREMENTS WITH OWNER PRIOR TO CONSTRUCTION. PROVIDE CONDUIT AND PULL STRINGS AS NEEDED. PROVIDE VERTICAL GYPSUM BOARD CONTROL JOINTS AT 30'-0" O.C. MAX. COORDINATE TO MEET FIRE RESISTIVE RATINGS OF THE ASSEMBLY AND FIRESTOP JOINTS AT RATED PARTITIONS. VERIFY FINAL LOCATIONS WITH ARCHITECT PRIOR TO INSTALLATION.



CONSTRUCTION

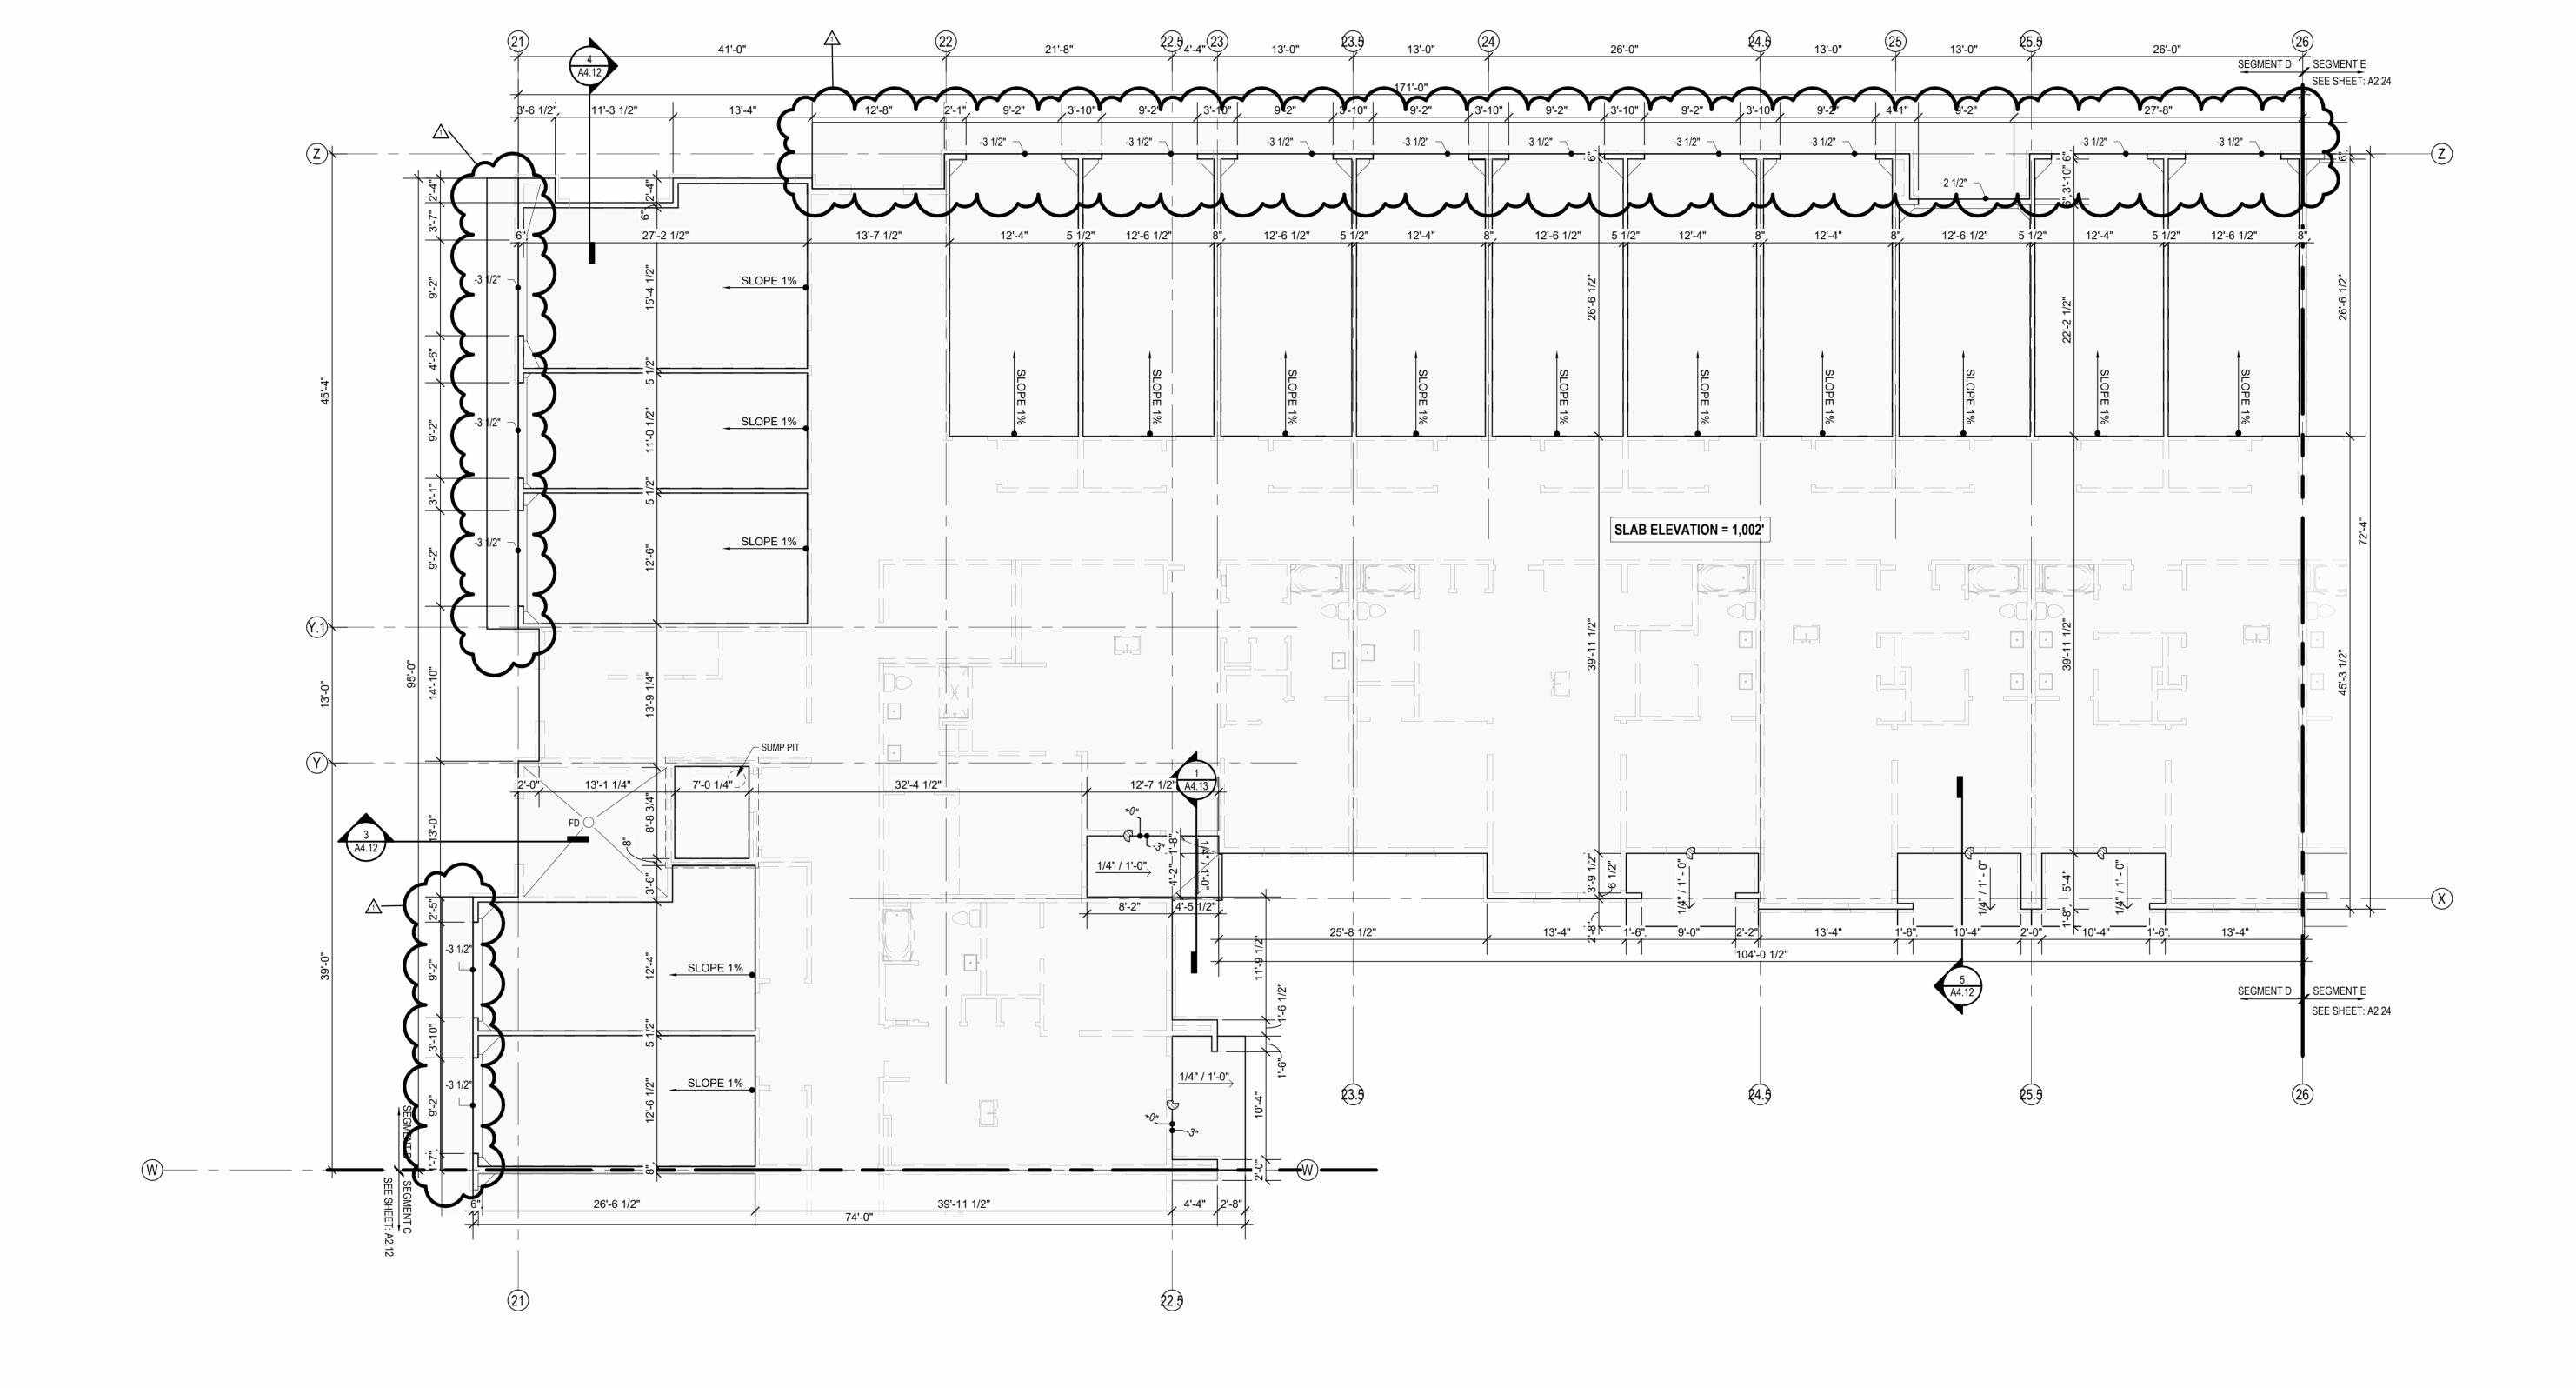

4/11/2023
CITY COMMENTS
SHEET NAME
SEGMENT D SLAB PLAN

SLAB PLAN - SEGMENT D

1/8" = 1'-0"


ARCHITECT PRIOR TO INSTALLATION.




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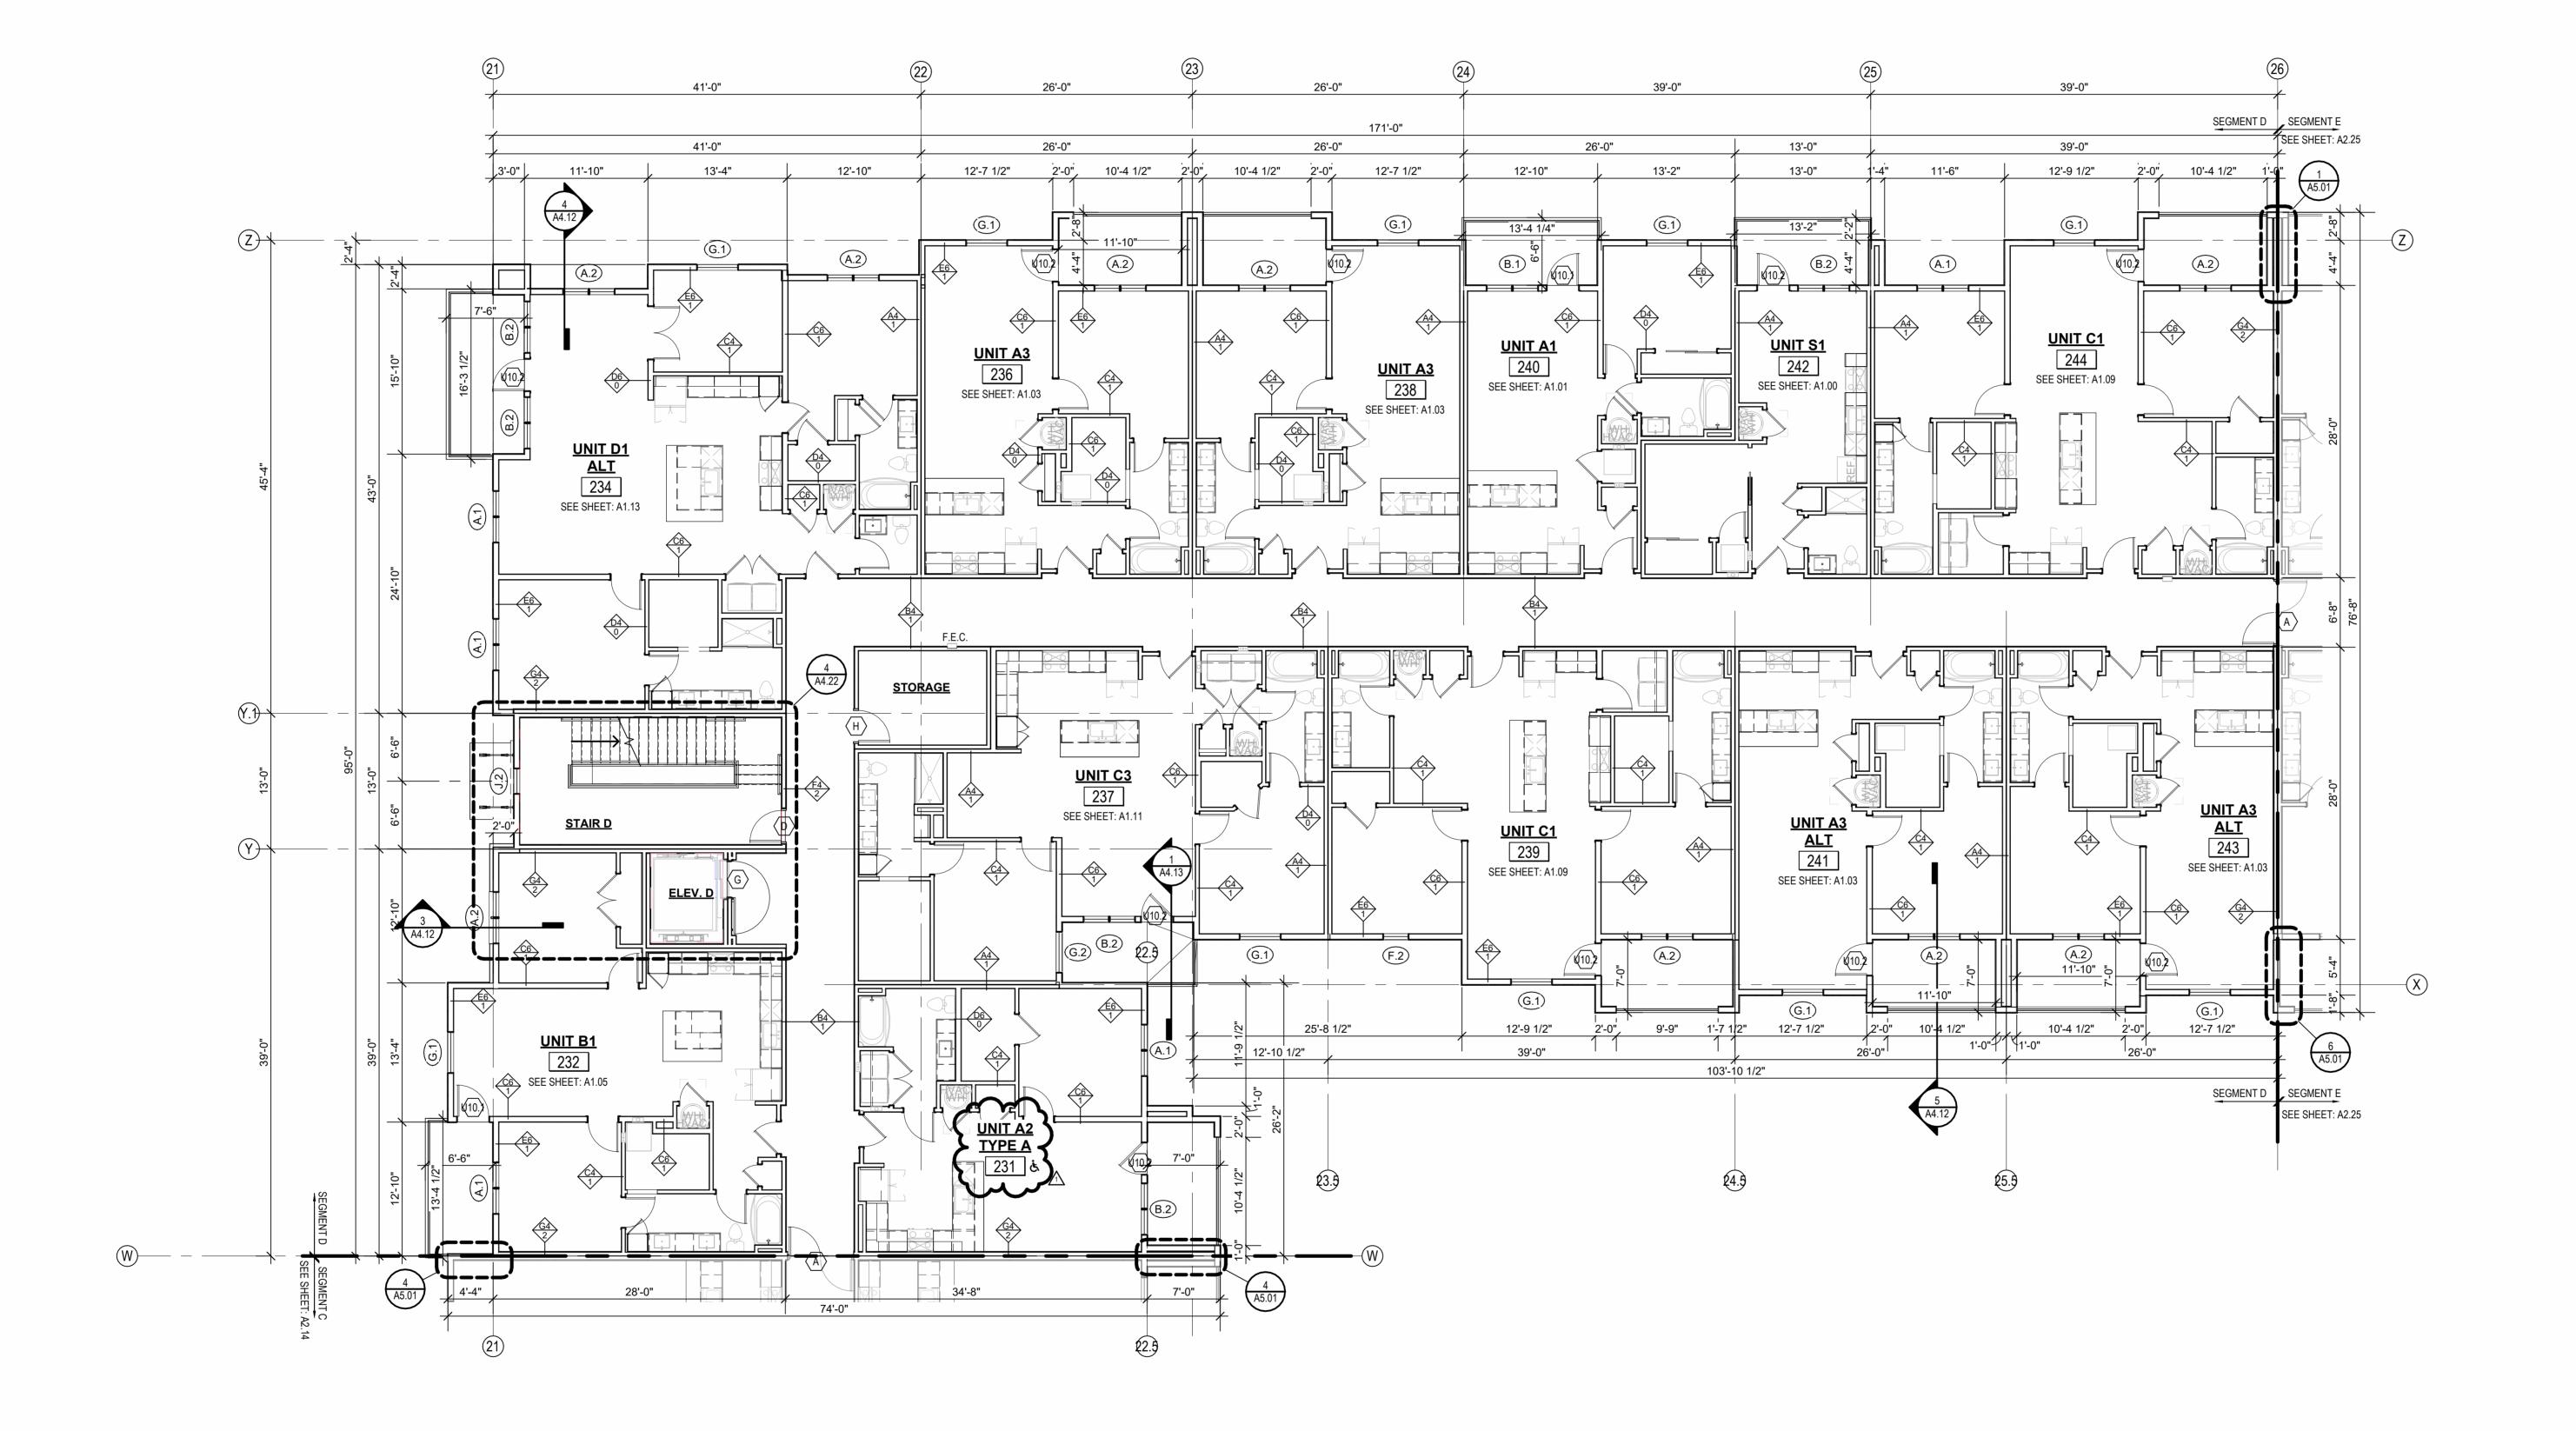
• 03.15.2023 - PERMIT SUBMITTAL

4/28/2023 ADDENDUM 1/CITY COMPENDESCRIPTION

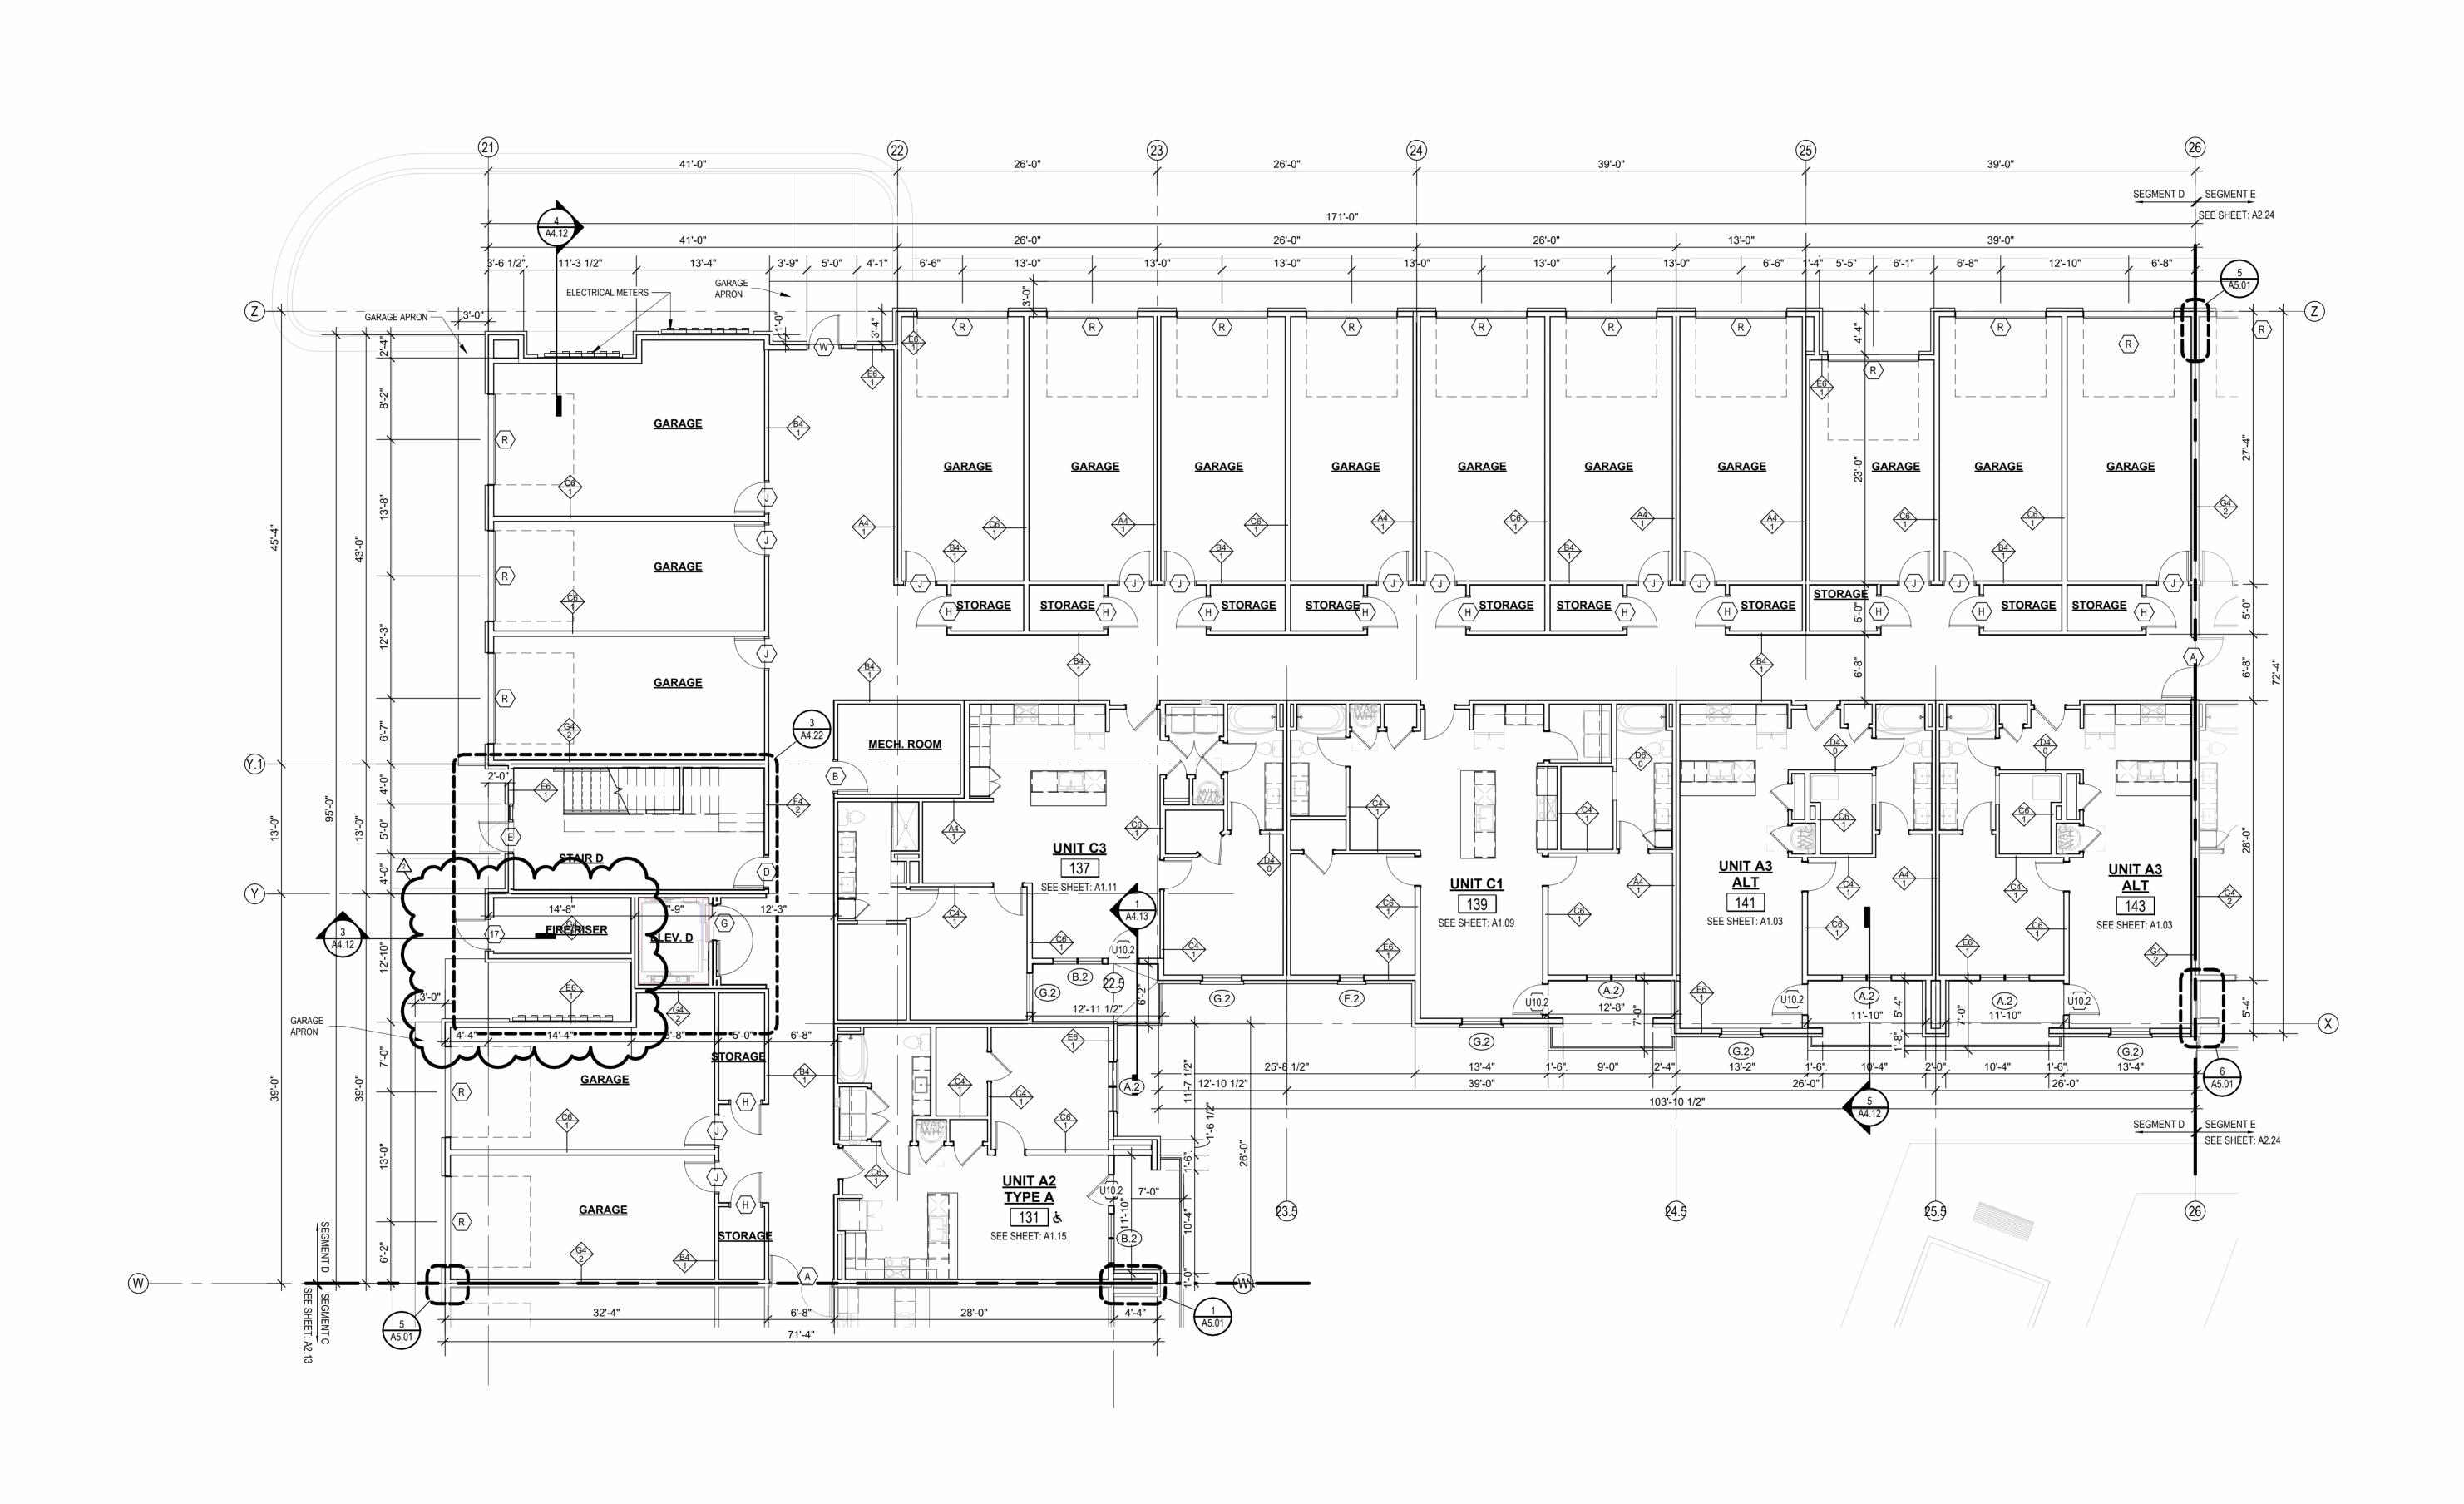


ARCHITECT PRIOR TO INSTALLATION.



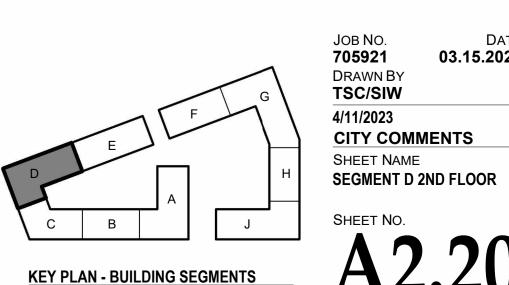


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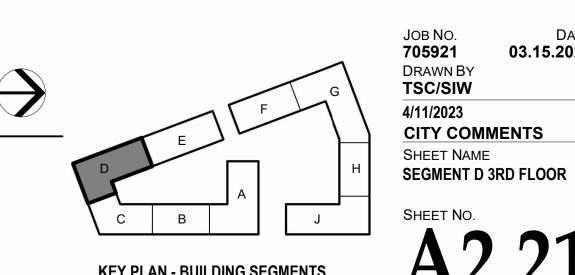




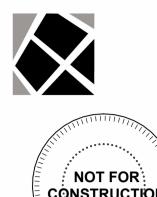


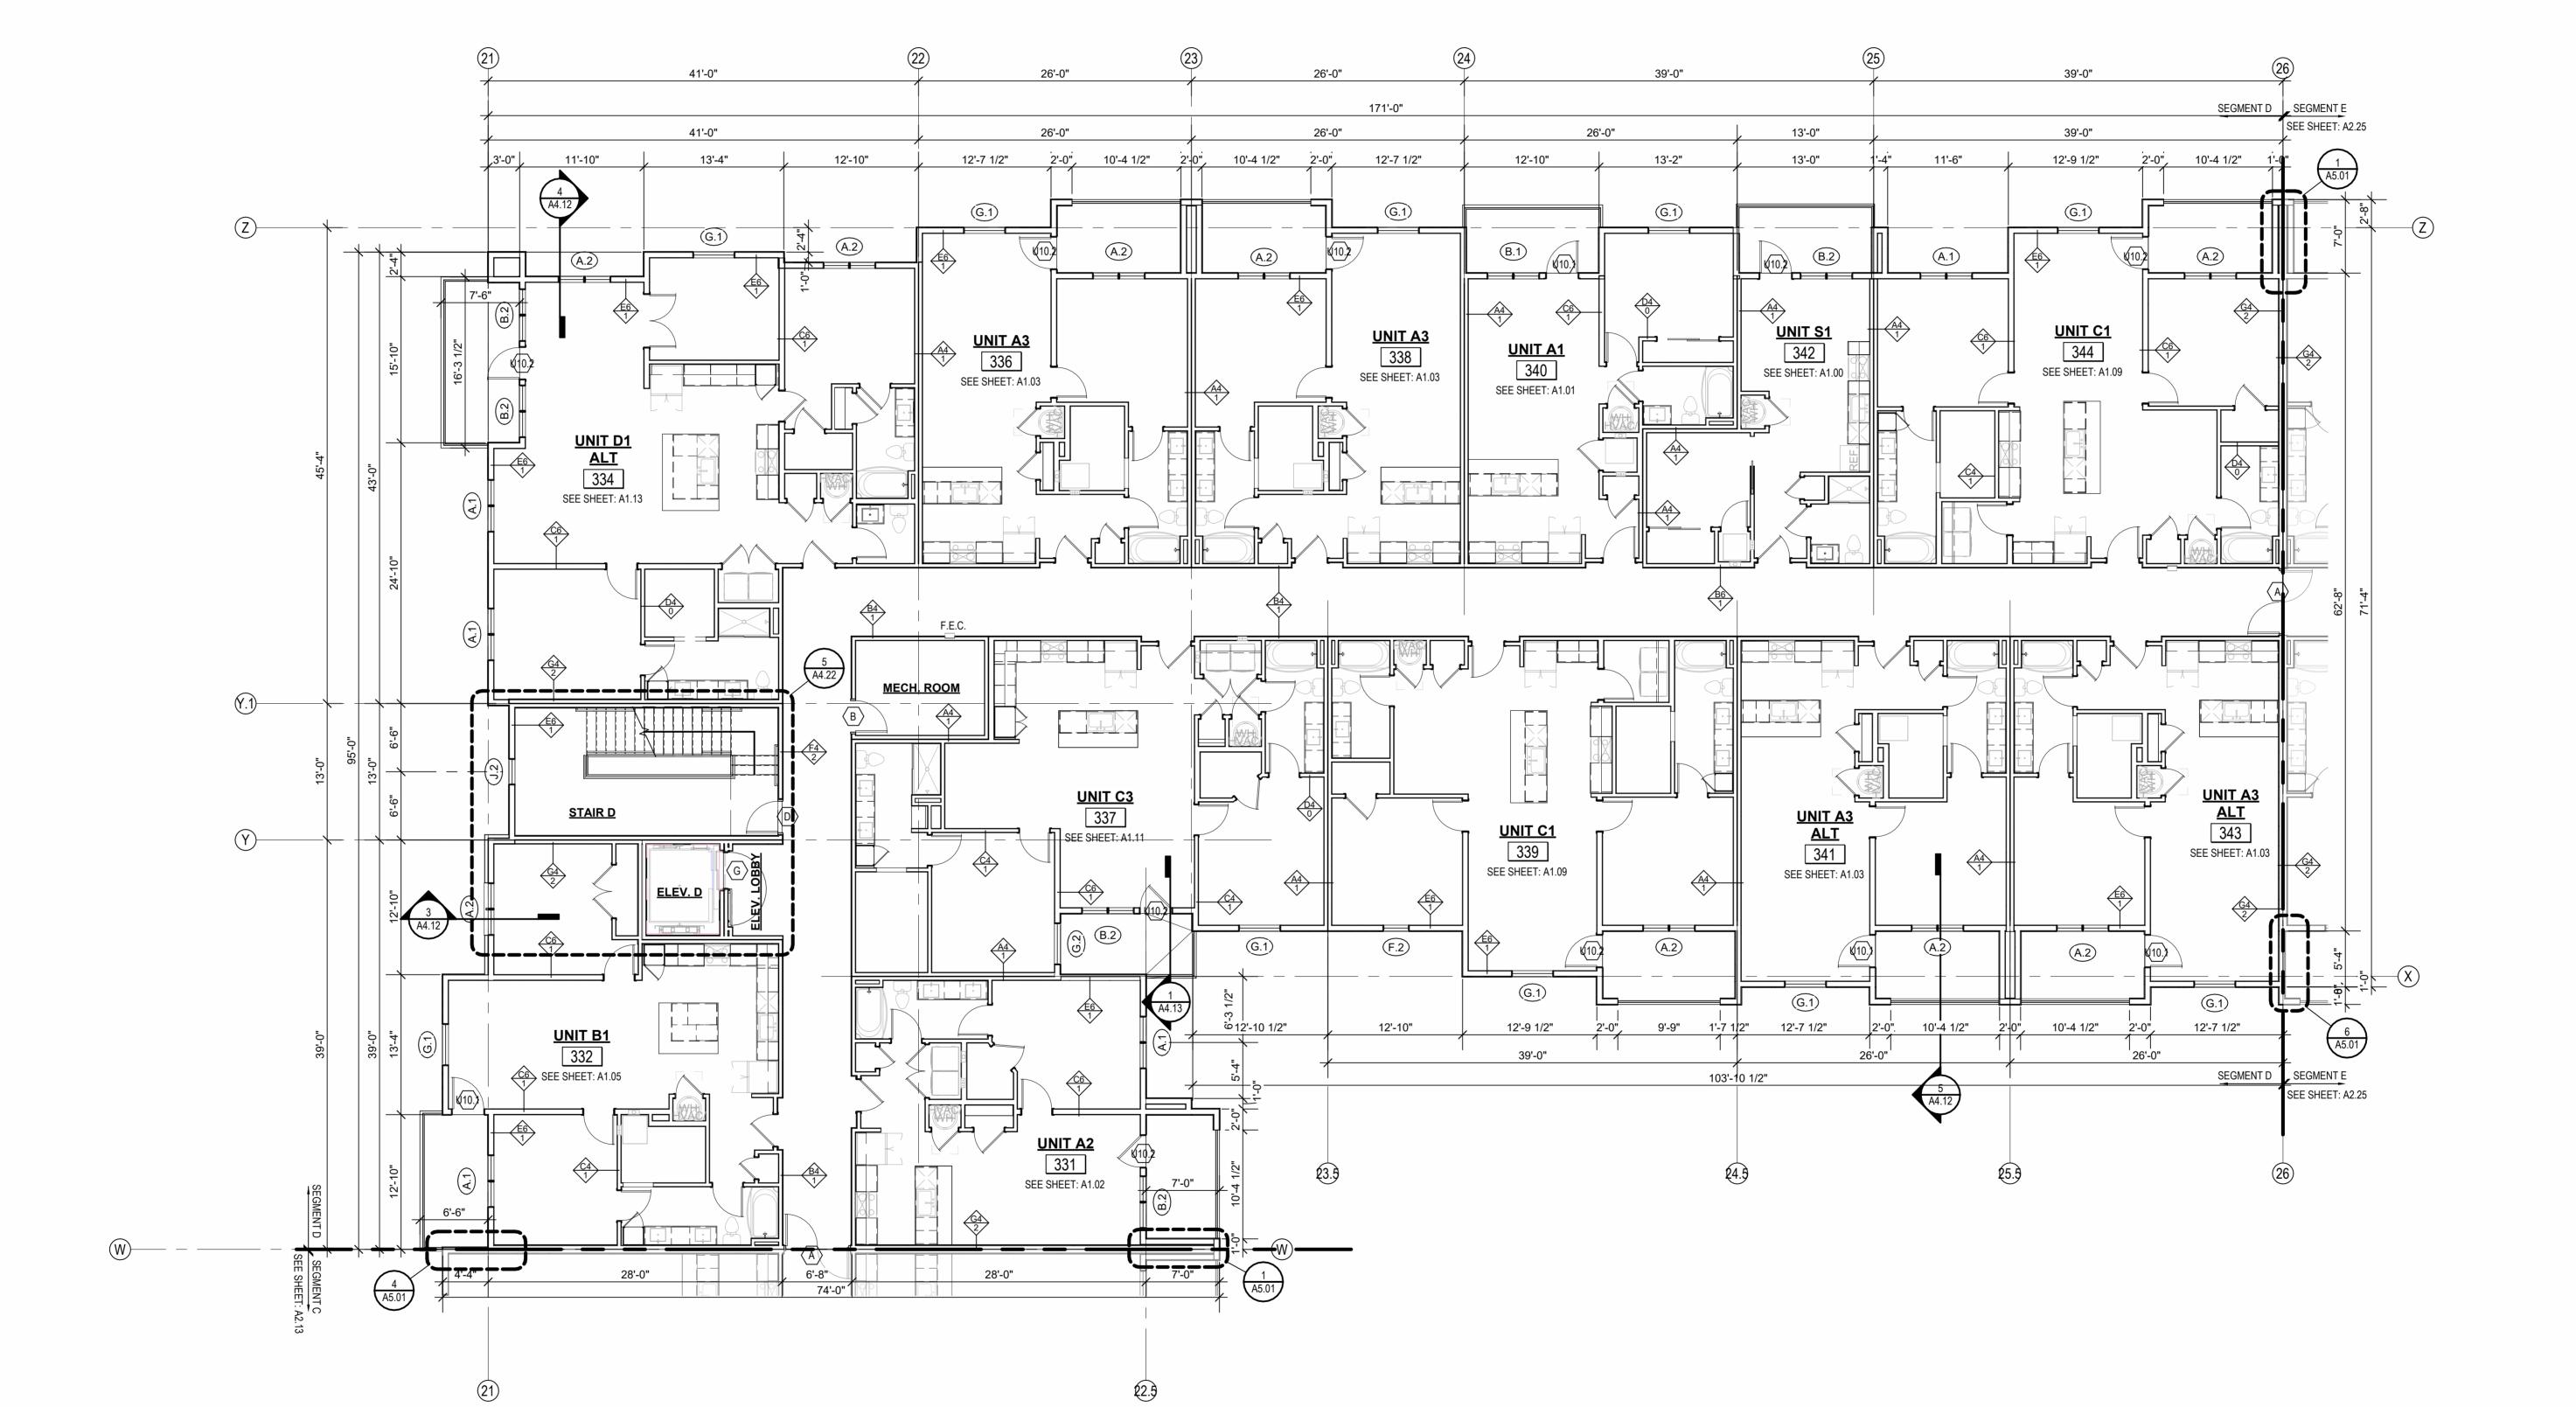


 \triangle REVISIONS




TRIM/PANELING, ETC. COORDINATE SECURITY, IT & A/V REQUIREMENTS WITH OWNER PRIOR TO CONSTRUCTION. PROVIDE CONDUIT AND PULL STRINGS AS NEEDED. PROVIDE VERTICAL GYPSUM BOARD CONTROL JOINTS AT 30'-0" O.C. MAX. COORDINATE TO MEET FIRE RESISTIVE RATINGS OF THE ASSEMBLY AND FIRESTOP JOINTS AT RATED PARTITIONS. VERIFY FINAL LOCATIONS WITH ARCHITECT PRIOR TO INSTALLATION.

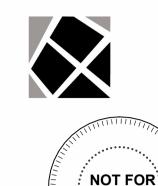



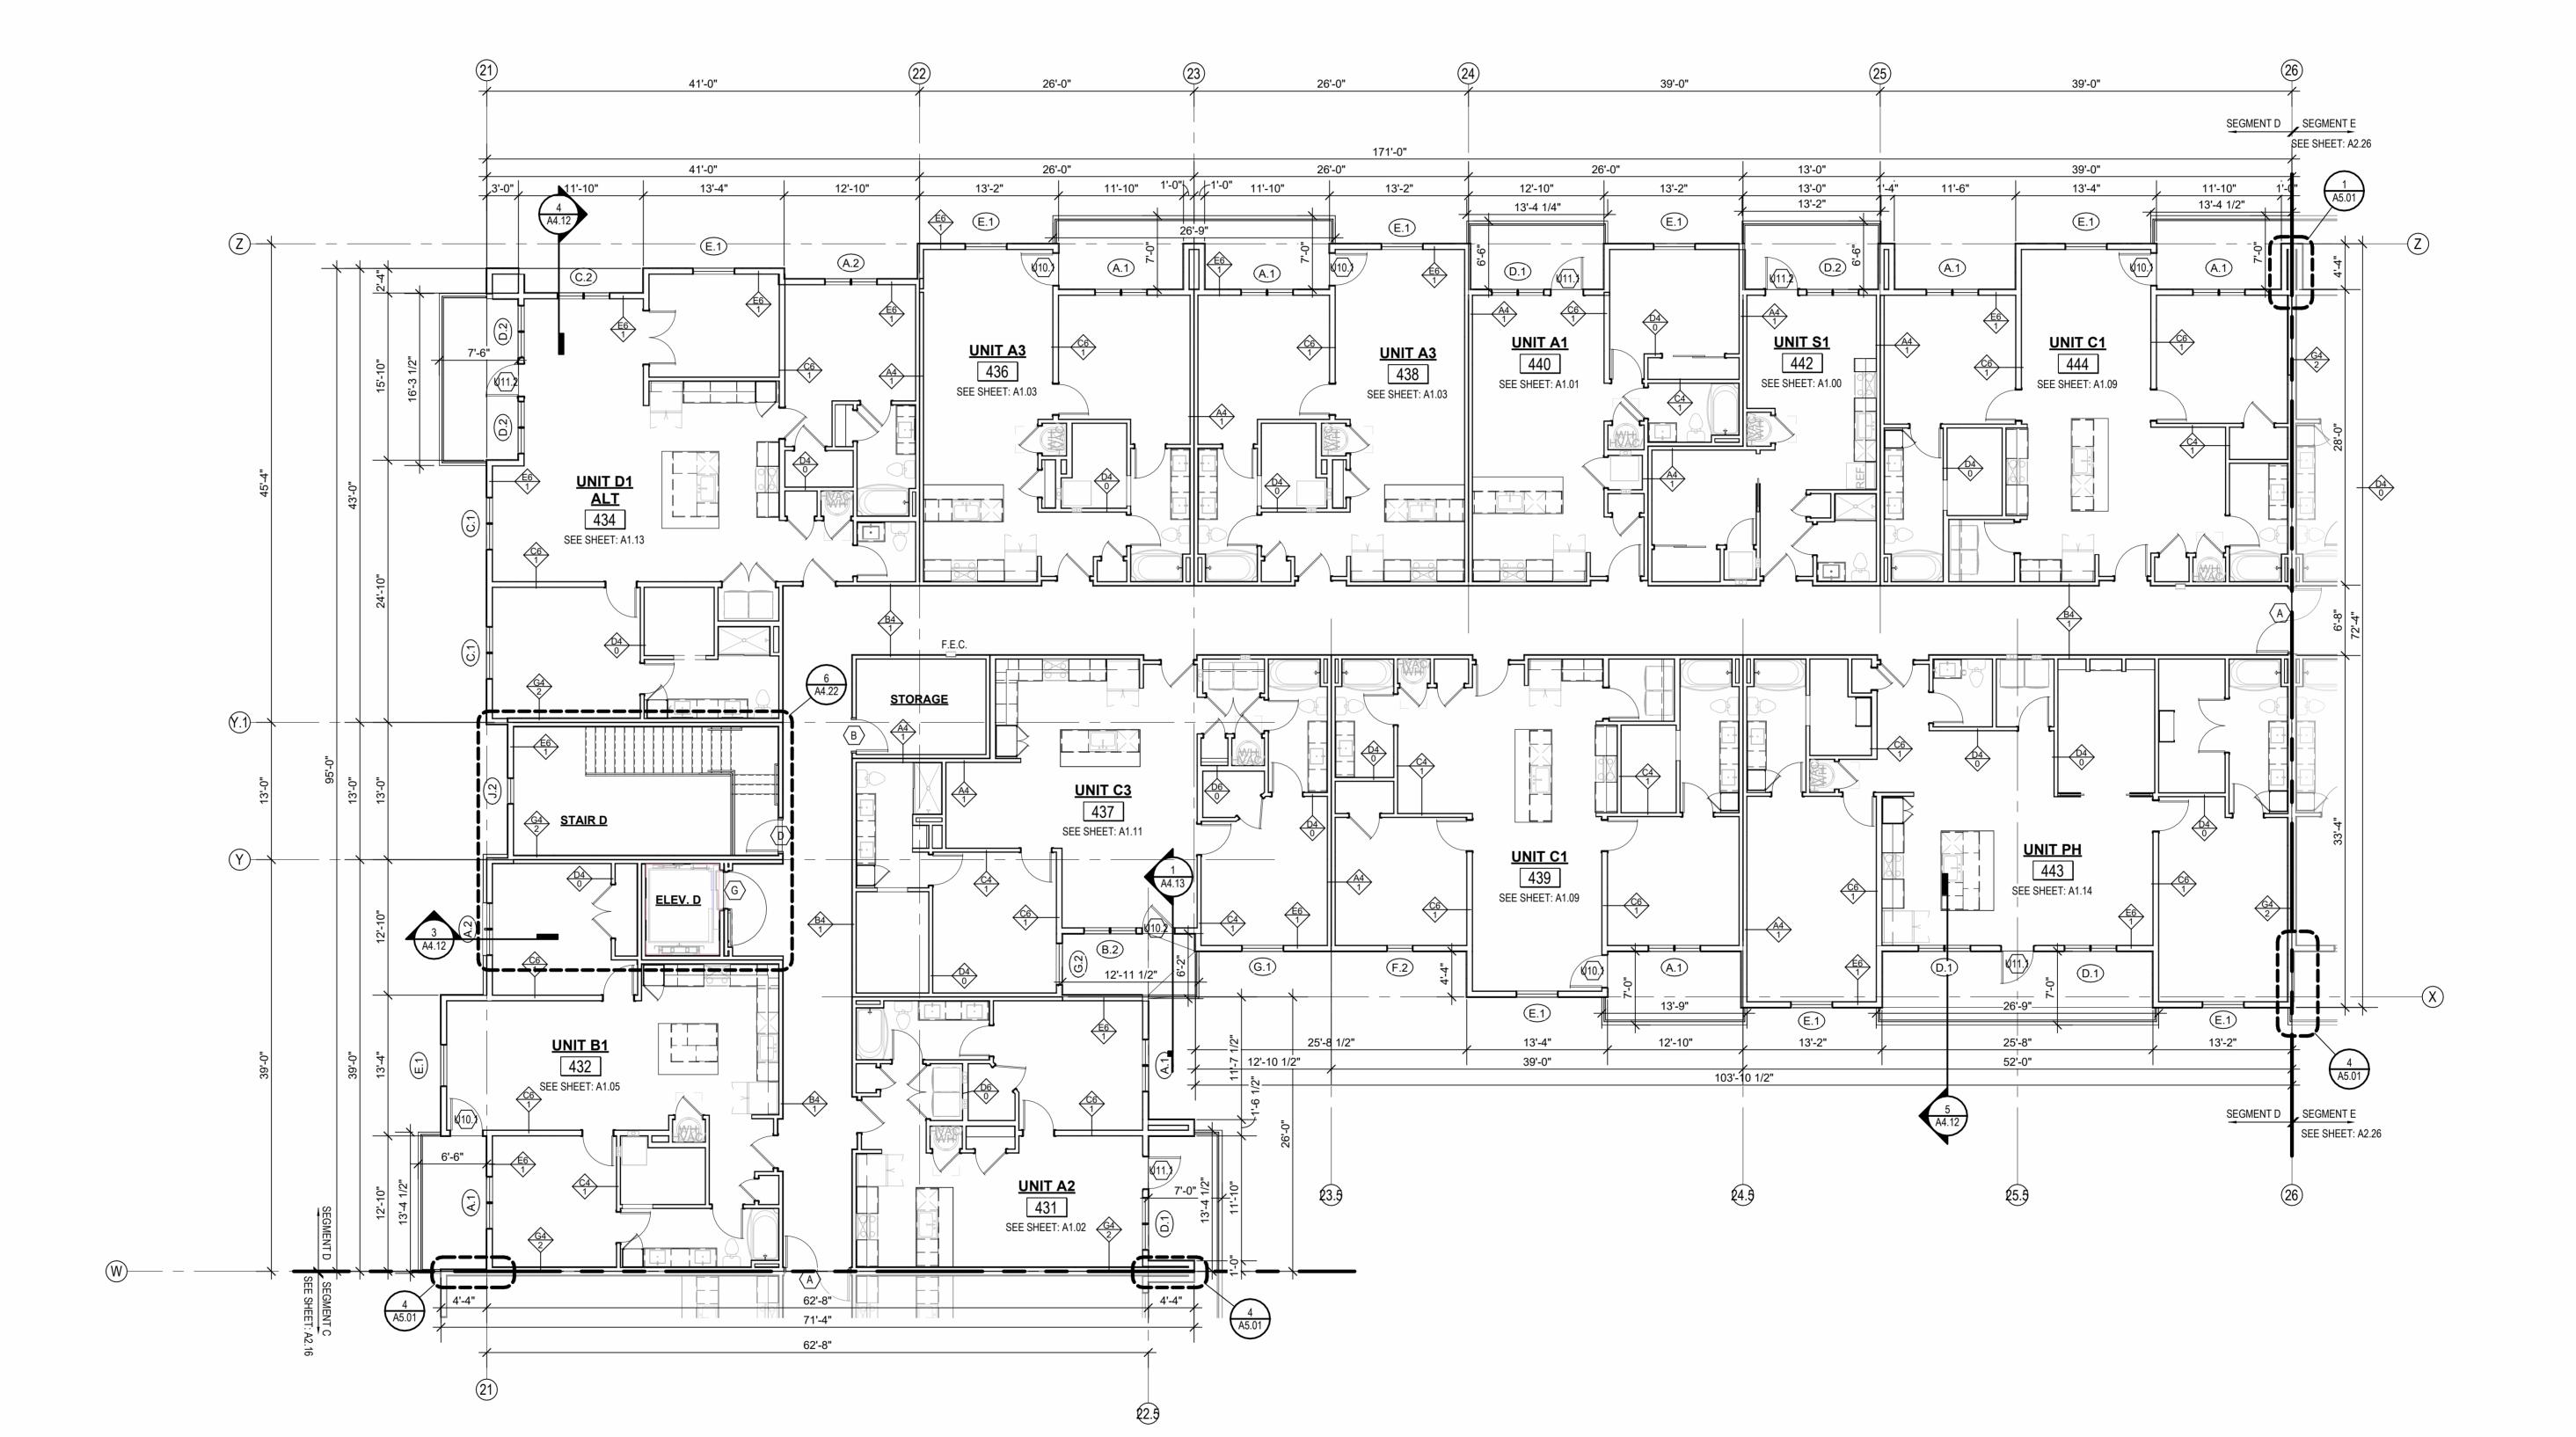

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SEG D ROOF VENT CALCULATOR												
						LOWER VENTING						
					STATIC VENTING			STATIC VENT		Total Lower		
Name	Area		1	Vented Area Percentage at Upper Roof Provided		Vented Units Provided at Upper Roof	Total Net Free Area of Upper Venting Provided	Vented Net Free Area Per Lower Static Vent	Static Vents Provided	Venting Provided		
AFTSTOP D-1	1630 SF	782 in²	1016 in ²	50.00%	254 in²	2	508 in ²	254 in²	2	508 in²		
AFTSTOP D-2	2957 SF	1419 in²	1524 in²	50.00%	254 in²	3	762 in²	254 in²	3	762 in²		
AFTSTOP D-3	2035 SF	977 in²	1524 in²	50.00%	254 in²	3	762 in ²	254 in²	3	762 in²		
AFTSTOP D-4	1533 SF	736 in²	1016 in ²	50.00%	254 in²	2	508 in ²	254 in²	2	508 in ²		
AFTSTOP D-5	1785 SF	857 in²	1016 in ²	50.00%	254 in²	2	508 in²	254 in²	2	508 in ²		
AFTSTOP D-6	2179 SF	1046 in²	1270 in ²	40.00%	254 in²	2	508 in ²	254 in²	3	762 in²		
AFTSTOP D-7	1338 SF	642 in²	1016 in ²	50.00%	254 in²	2	508 in ²	254 in²	2	508 in ²		
AFTSTOP D-8	1291 SF	620 in²	1016 in²	50.00%	254 in²	2	508 in²	254 in²	2	508 in ²		

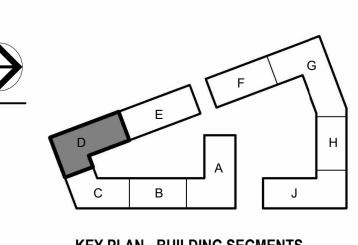ROOF VENTING LEGEND

1. ACTIVE VENTILATION PRODUCTS, INC. "INTAKE" POP VENT: (LOCATIONS AS NOTED ON DRAWINGS) MAINTAIN 36" CLEAR FROM POP VENT CAP TO ADJACENT CONDENSING UNITS, TYP. WHERE REQUIRED FOR MAINTENANCE. RE: MECH/MFR INFO FOR ADDITIONAL OR ALTERNATE MIN. CLEARANCES.

HYDRANTS, AND ANY ADDITIONAL ITEMS.
*GC PLEASE ADVISE MEP/ARCH OF ANY CONFLICTS

NOTE: COORDINATION W/MEP LOCATION OF CURB INLETS, WALL

2. ACTIVE VENTILATION PRODUCTS, INC. "EXHAUST" AURA VENT: (LOCATIONS AS NOTED ON DRAWINGS)

MAINTAIN 36" CLEAR FROM POP VENT CAP TO ADJACENT CONDENSING UNITS, TYP. WHERE REQUIRED FOR MAINTENANCE. RE: MECH/MFR INFO FOR ADDITIONAL OR ALTERNATE MIN. CLEARANCES. NOTE: COORDINATION W/MEP LOCATION OF CURB INLETS, WALL HYDRANTS, AND ANY ADDITIONAL ITEMS. *GC PLEASE ADVISE MEP/ARCH OF ANY CONFLICTS

ROOF PLAN GENERAL NOTES:

REFER TO BUILDING ELEVATIONS FOR DOWNSPOUT LOCATIONS. ALL OBJECTS INDICATED ON THE ROOF ARE GENERAL AND MUST BE COORDINATED WITH MEP AND STRUCTURAL ELEMENTS. REFER TO MEP DRAWINGS FOR ACTUAL MECHANICAL EQUIPMENT LOCATIONS. ALL FLAT ROOFS SHALL SLOPE 1/4" PER FOOT MINIMUM. ALL CRICKETS SHALL SLOPE 1/4" PER FOOT MINIMUM. PROVIDE ALL ROOFING DETAILS BY MANUFACTURER'S WARRANTED

ARCHITECT PRIOR TO INSTALLATION.

FLOOR PLAN GENERAL NOTES:

OTHERWISE NOTED.

TRIM/PANELING, ETC.

PROVIDE KICK-OUT FLASHING AT ALL SIDE-WALL CONDITIONS. ALL ROOFING DETAILS TO BE PER MANUFACTURER'S WARRANTED SYSTEM.

RATED ASSEMBLY TAGS ARE TYPICAL AT SIMILAR LOCATIONS NOT

ALL EXTERIOR COMMON USE DOOR THRESHOLDS TO BE ACCESSIBLE. ALL ACCESSIBLE ENTRANCES SHALL HAVE NO MORE THAN A 1:48 SLOPE FOR A

COORDINATE SECURITY, IT & A/V REQUIREMENTS WITH OWNER PRIOR TO CONSTRUCTION. PROVIDE CONDUIT AND PULL STRINGS AS NEEDED. PROVIDE VERTICAL GYPSUM BOARD CONTROL JOINTS AT 30'-0" O.C. MAX. COORDINATE TO MEET FIRE RESISTIVE RATINGS OF THE ASSEMBLY AND FIRESTOP JOINTS AT RATED PARTITIONS. VERIFY FINAL LOCATIONS WITH

FIRE EXTINGUISHER CABINET (F.E.C.) LOCATIONS ARE APPROXIMATE UNLESS NOTED OTHERWISE. CONTRACTOR TO COORDINATE FINAL LOCATIONS TO NOT CONFLICT WITH WALL FRAMING, UTILITY ROUGH-INS,

SEE SHEETS A0.30 AND FOR RATED ASSEMBLIES

DISTANCE OF 60" PERPENDICULAR TO THE DOOR.

ATTIC VENTING REQUIREMENTS REQUIEMENTS PER 2018 IBC SECTION 1202.2:

PROVIDE 40%-50% VENT AREA HIGH, 50%-60% LOW PROPOSED ROOF VENTILATION


LOW: POP VENT INTAKE (254 SQ. IN. NET FREE AREA PER VENT) HIGH: AURA ROOF VENT (254 SQ. IN NET FREE AREA PER VENT)

MIN. NET FREE AREA OF ROOF VENTILATION: 1/300 ROOF AREA

RAISED CEILING HEIGHT KEY

11'-0" CEILING 12'-0" CEILING


NOT FOR CONSTRUCTION

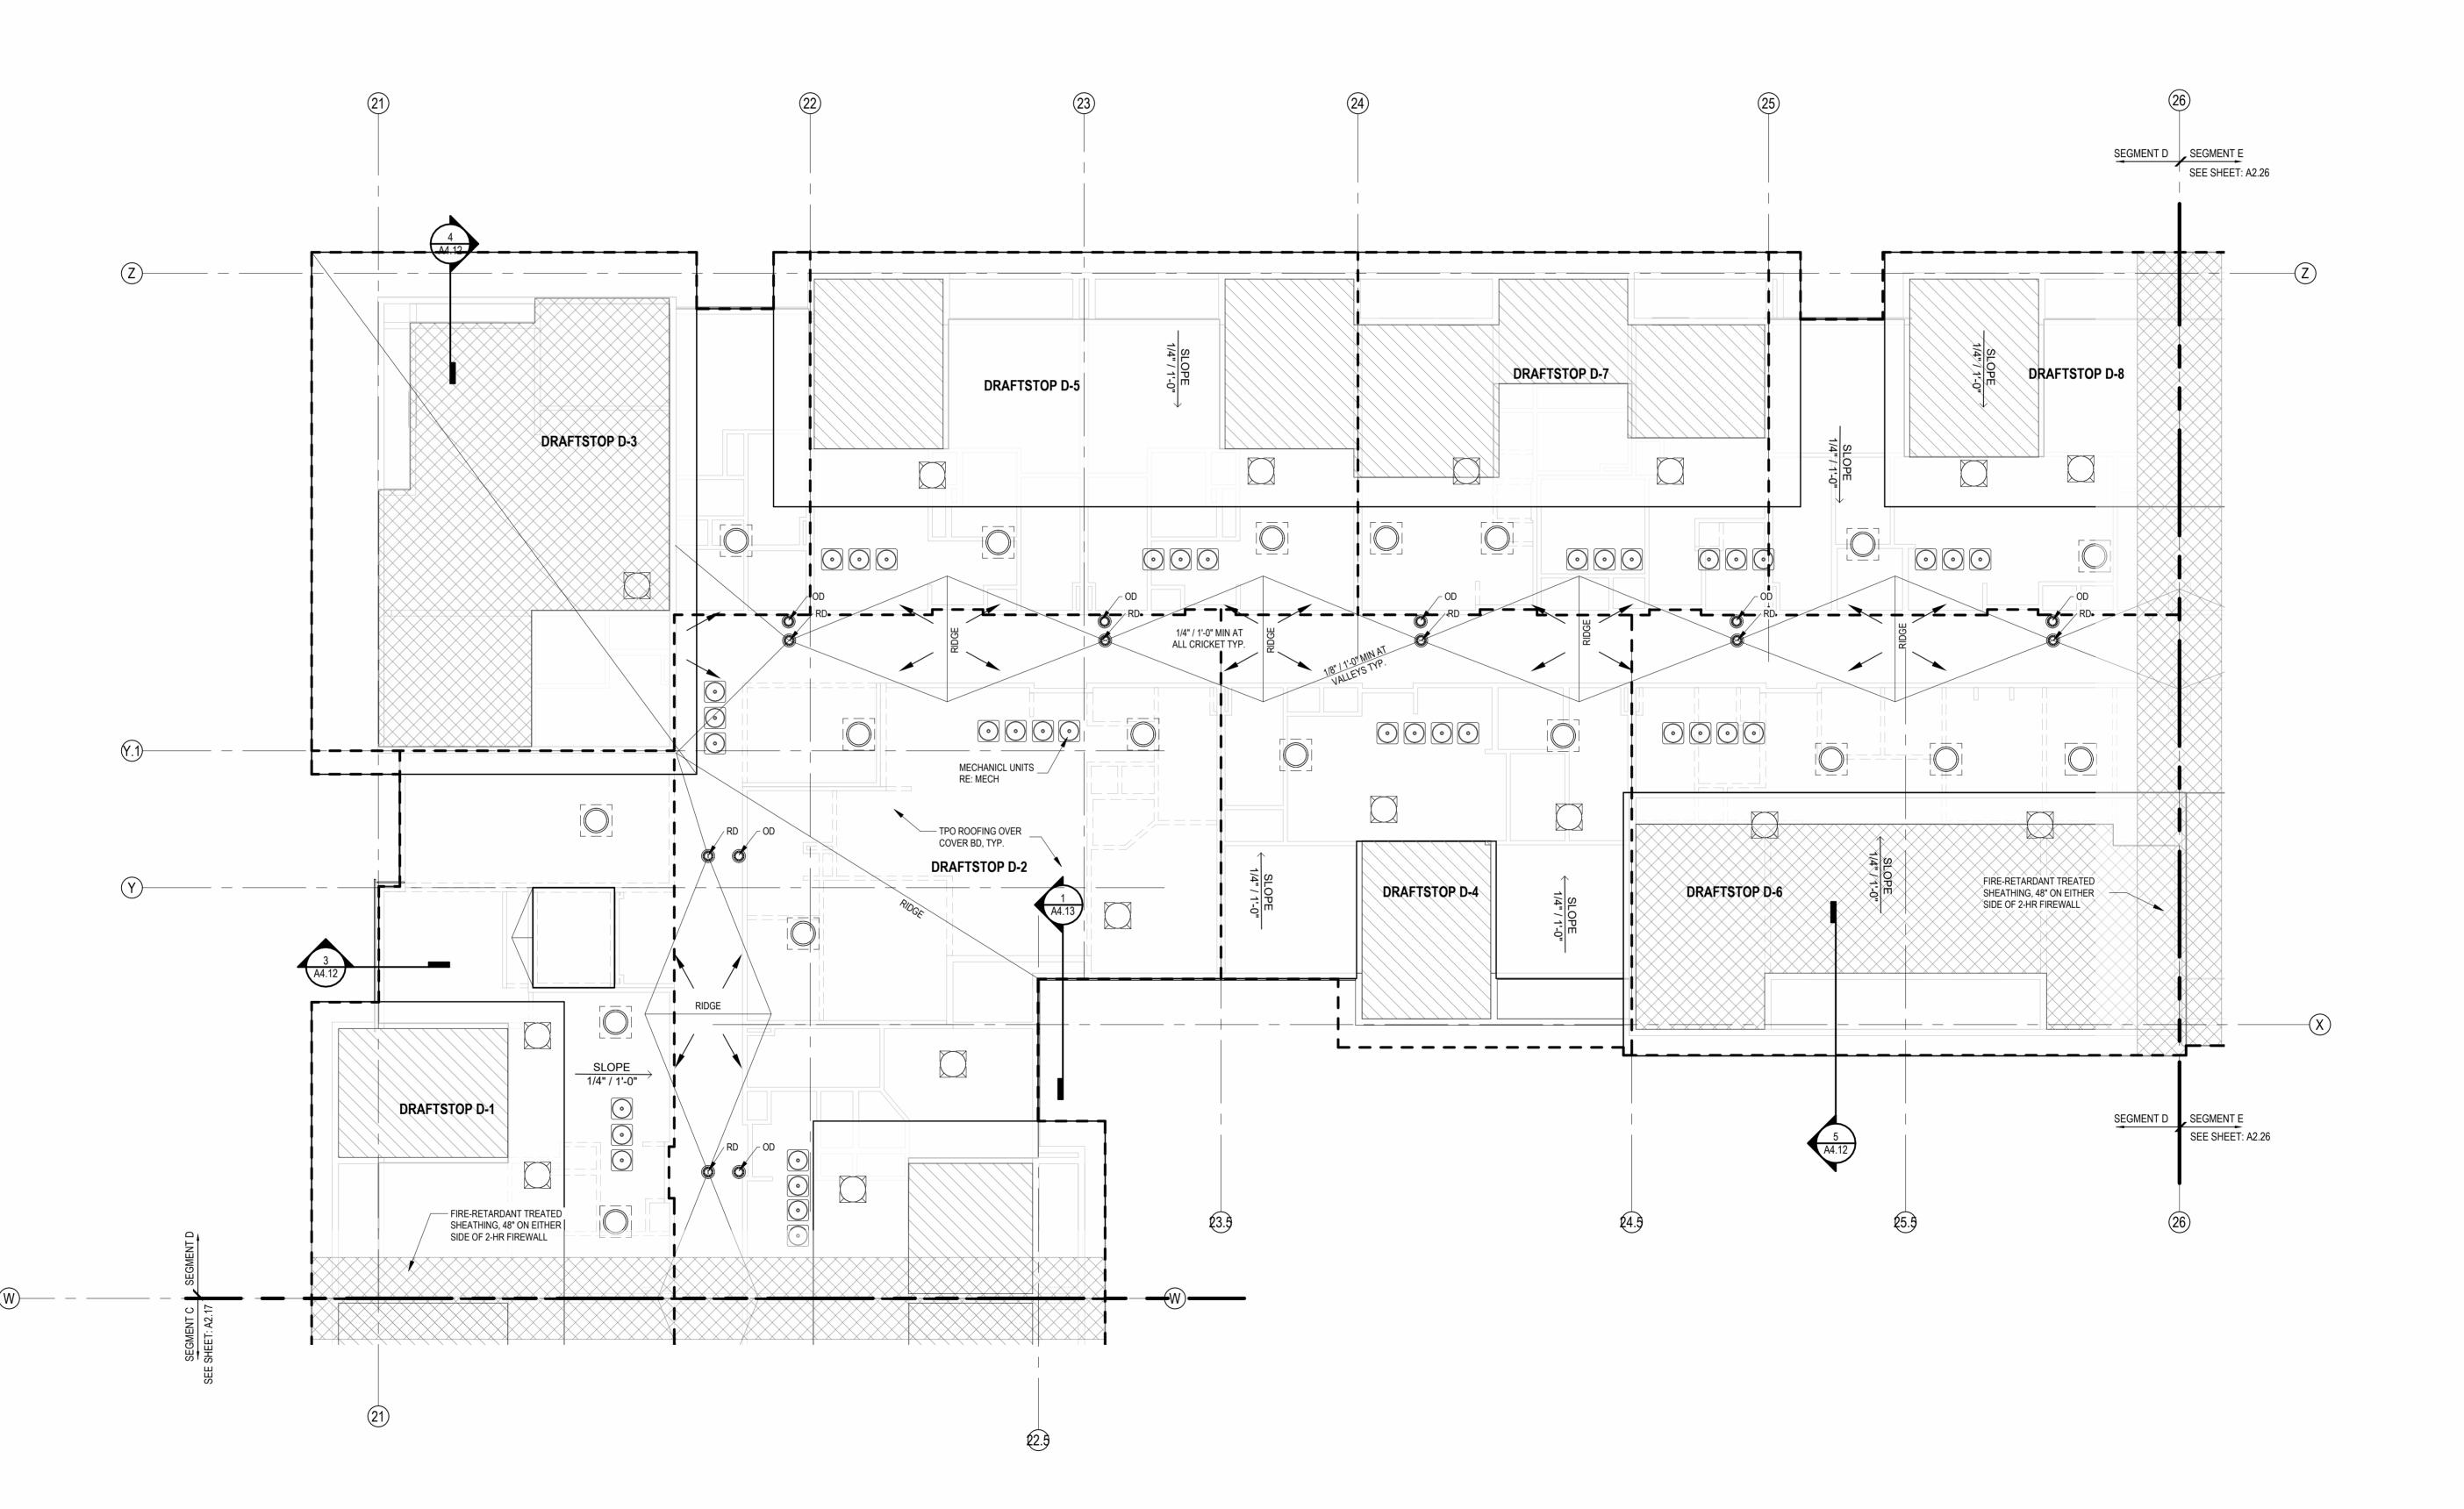

DRAWN BY TSC/SIW 4/11/2023
CITY COMMENTS
SHEET NAME
SEGMENT D ROOF PLAN

 \triangle REVISIONS

1 ROOF - SEGMENT D

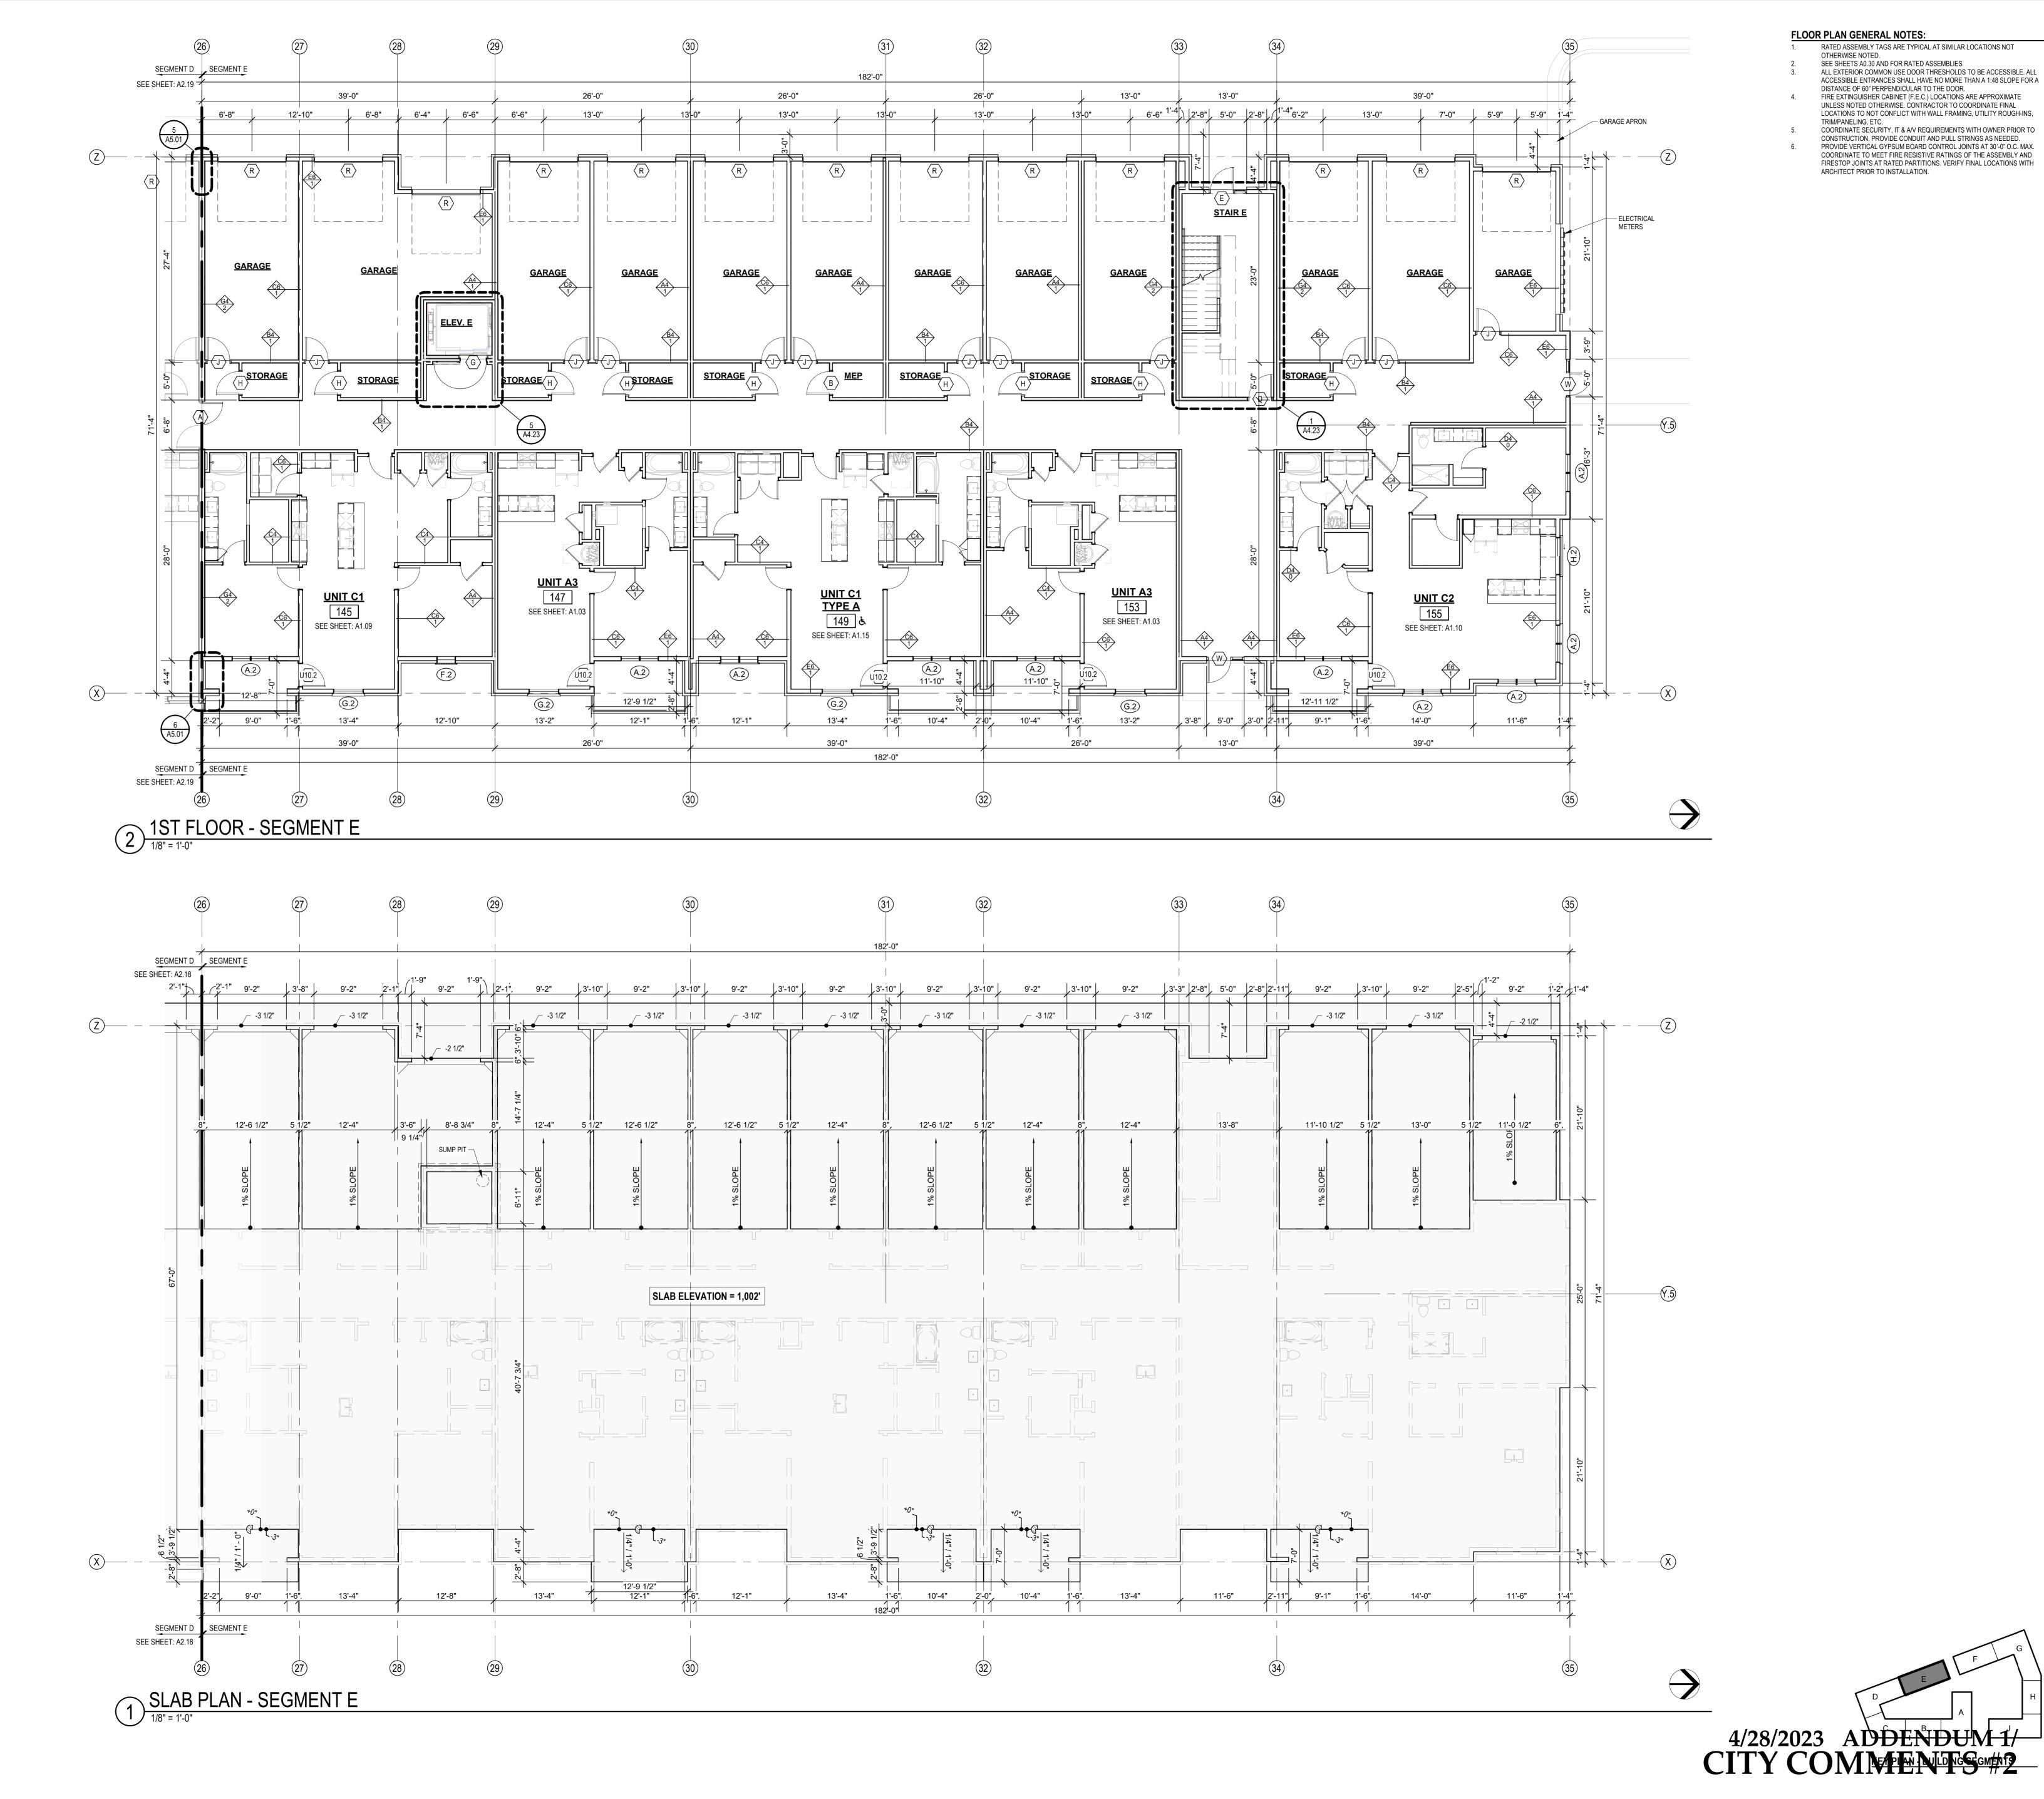

ARCHITECTS PARTY STILL SUITE 201 NS



TRILOGY 800 & 810 NW WARD RD. | LEE'S SUMMIT,

DRAWING RELEASE LOG

• 03.15.2023 - PERMIT SUBMITTAL

△REVISIONS:

DATE:
03.15.2023
JOB NO.
705921
DRAWN BY:
TSC/SIW
SHEET NO.

1/ SHEET NO. **A 2.2**4


FLOOR PLAN GENERAL NOTES:

OTHERWISE NOTED.

RATED ASSEMBLY TAGS ARE TYPICAL AT SIMILAR LOCATIONS NOT

ALL EXTERIOR COMMON USE DOOR THRESHOLDS TO BE ACCESSIBLE. ALL

SEE SHEETS A0.30 AND FOR RATED ASSEMBLIES

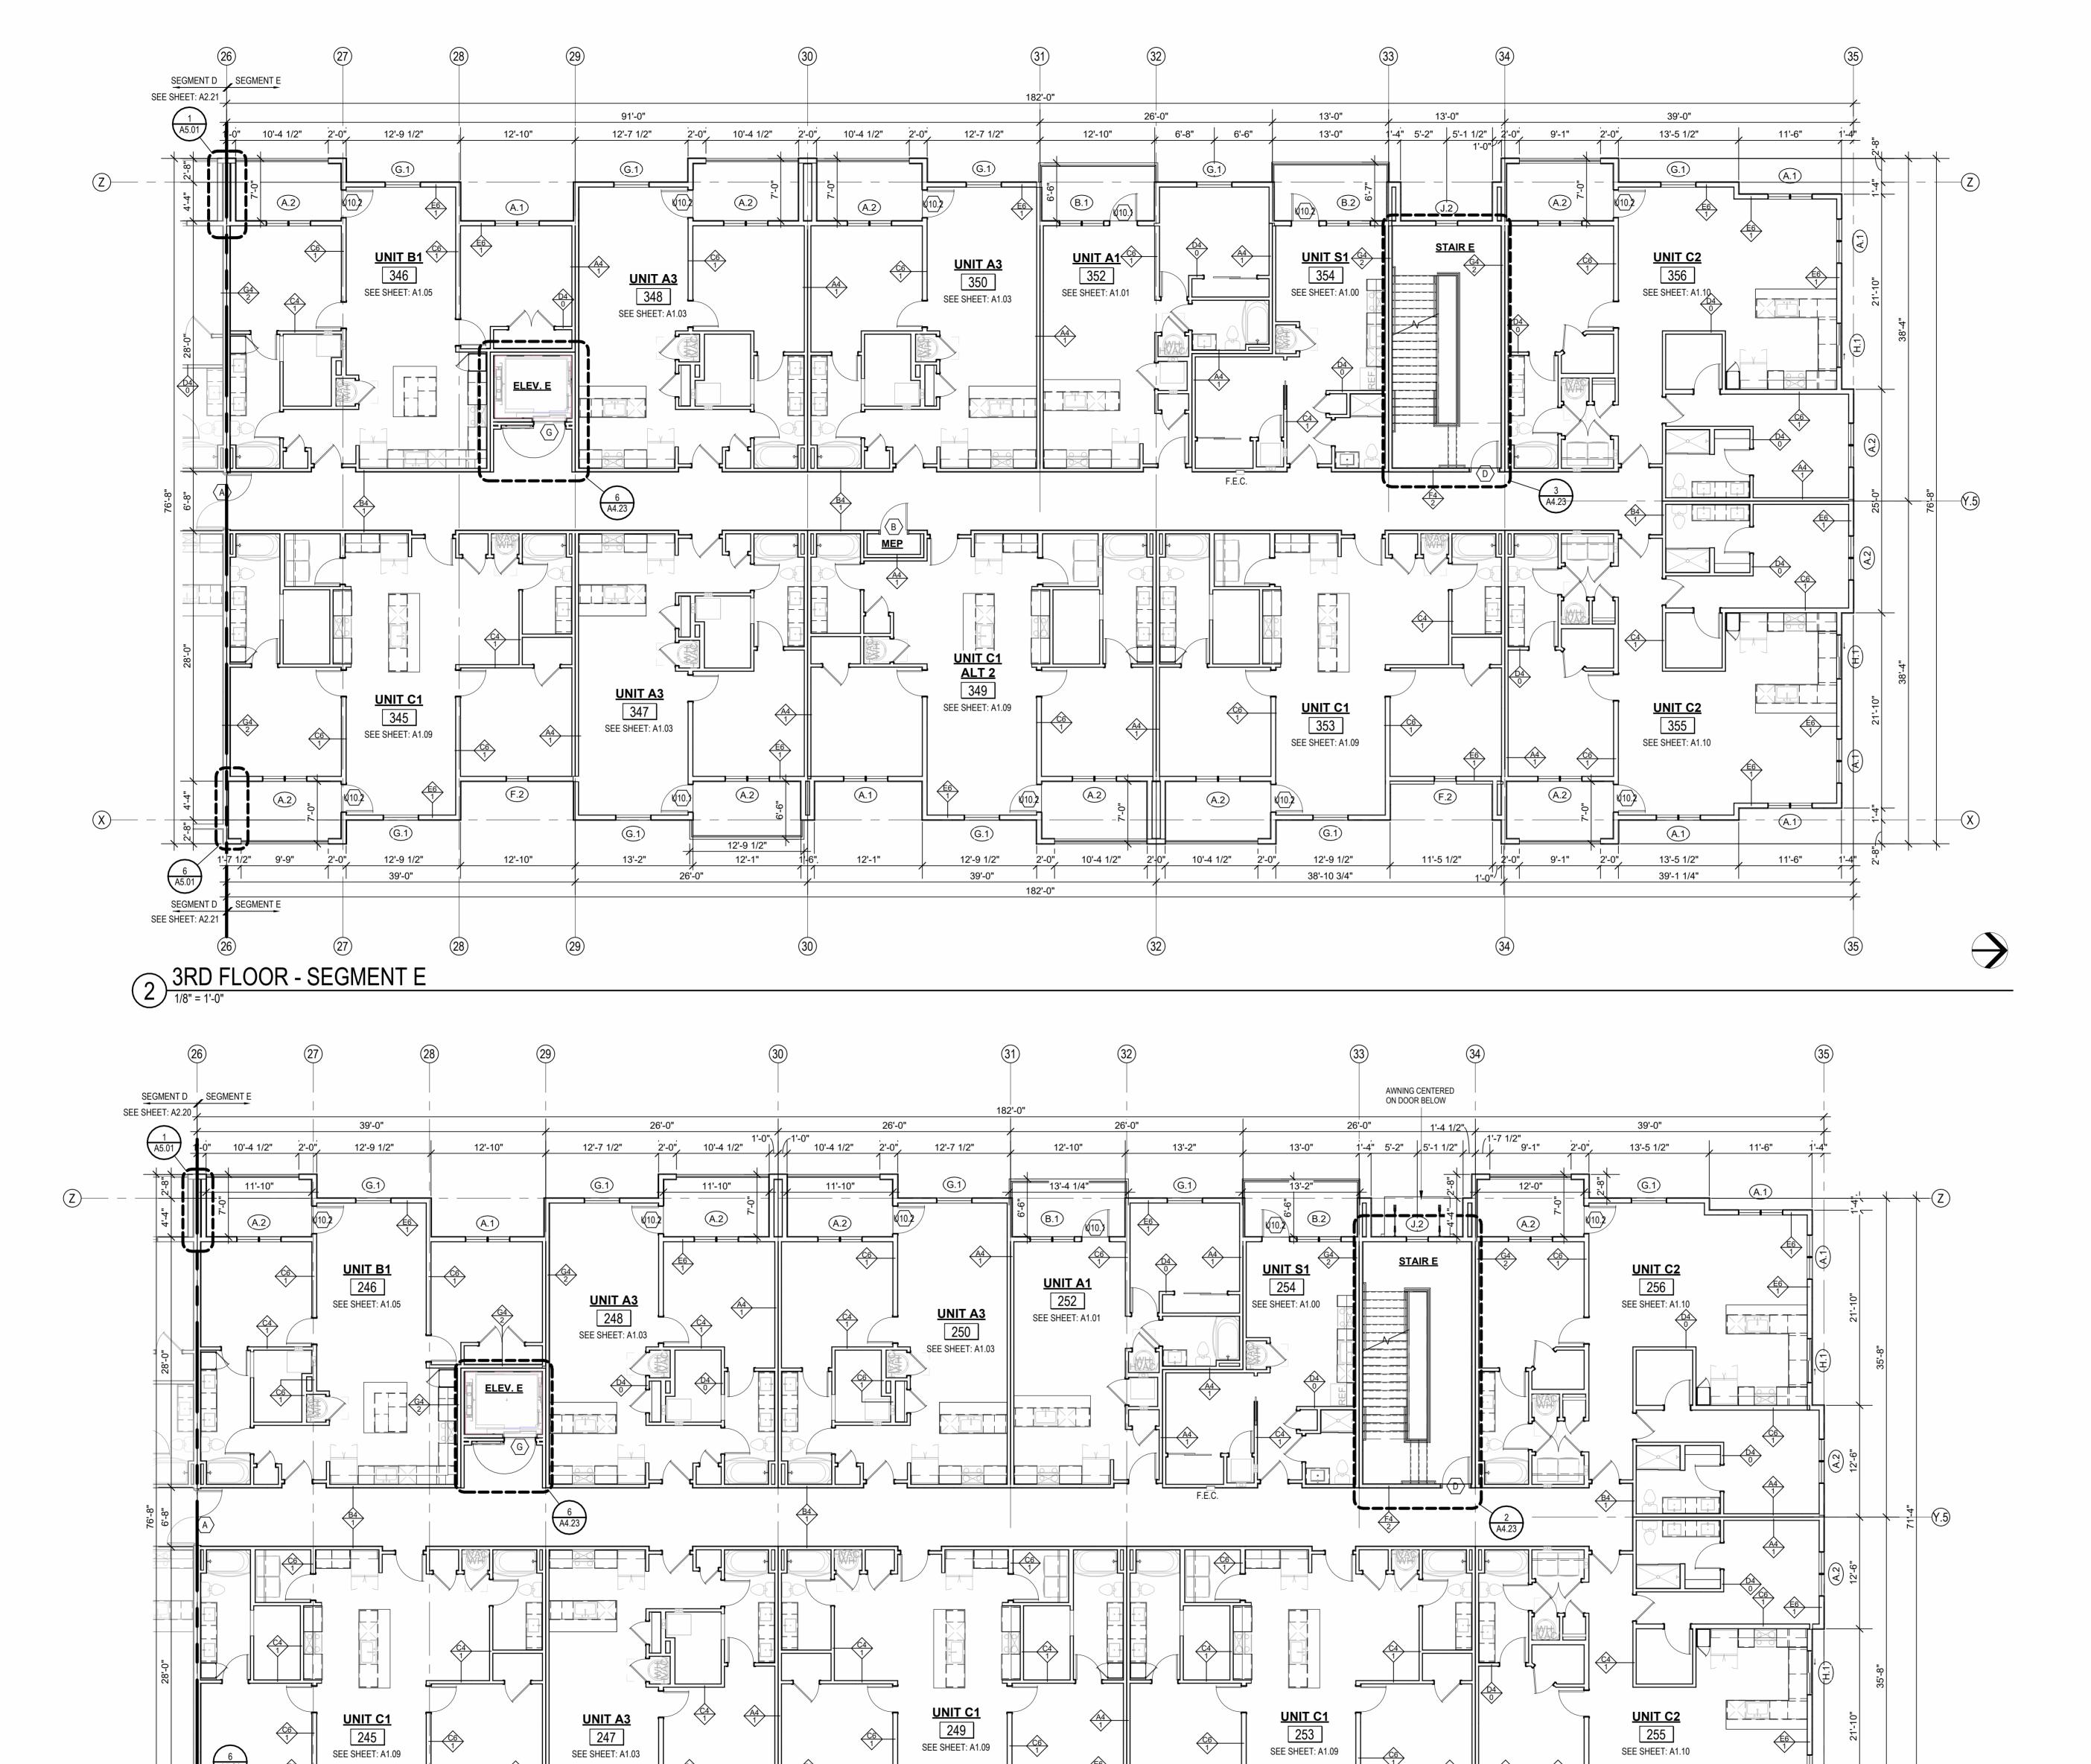

SEE SHEET: A1.09

12'-9 1/2"

10'-4 1/2"

182'-0"

10'-4 1/2" 2'-0"

38'-9 3/4"

11'-5 1/2"

10) A2 A.1

12'-1"

(F.2)


SEGMENT D 7

2ND FLOOR - SEGMENT E

(G.1)

13'-4"

 \triangle REVISIONS

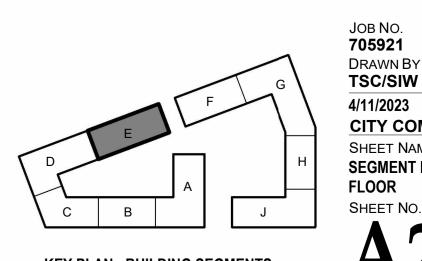

DATE **03.15.2023** CITY COMMENTS
SHEET NAME
SEGMENT E 2ND & 3RD
FLOOR KEY PLAN - BUILDING SEGMENTS

FLOOR PLAN GENERAL NOTES: RATED ASSEMBLY TAGS ARE TYPICAL AT SIMILAR LOCATIONS NOT

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ATTIC VENTING REQUIREMENTS

REQUIEMENTS PER 2018 IBC SECTION 1202.2: MIN. NET FREE AREA OF ROOF VENTILATION: 1/300 ROOF AREA


PROVIDE 40%-50% VENT AREA HIGH, 50%-60% LOW PROPOSED ROOF VENTILATION

LOW: POP VENT INTAKE (254 SQ. IN. NET FREE AREA PER VENT) HIGH: AURA ROOF VENT (254 SQ. IN NET FREE AREA PER VENT)

RAISED CEILING HEIGHT KEY

11'-0" CEILING

12'-0" CEILING

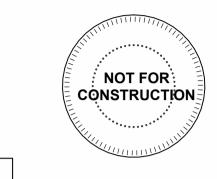


SEG E ROOF VENT CALCULATOR												
	Total Net Free Area of Venting Provided	Vented Area Percentage at Upper Roof Provided	UF	PPER VENTING	LOWER VENTING							
			STATIC	VENTING	Total Net Free Area of Upper Venting Provided	STATIC VENT						
tal Net Area of enting quired			Vented Net Free Area Per Static Vent at Upper Roof	Vented Units Provided at Upper Roof		Vented Net Free Area Per Lower Static Vent	Static Vents Provided	Total Lower Venting Provided				
355 in ²	1524 in²	50.00%	254 in²	3	762 in²	254 in²	3	762 in ²				
857 in²	1016 in ²	50.00%	254 in²	2	508 in ²	254 in²	2	508 in ²				
255 in ²	1270 in ²	40.00%	254 in²	2	508 in ²	254 in²	3	762 in ²				
838 in²	1016 in²	50.00%	254 in²	2	508 in ²	254 in²	2	508 in ²				
802 in²	1016 in ²	50.00%	254 in²	2	508 in ²	254 in ²	2	508 in ²				

ROOF VENTING LEGEND

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MAINTAIN 36" CLEAR FROM POP VENT CAP TO ADJACENT CONDENSING UNITS, TYP. WHERE REQUIRED FOR MAINTENANCE. RE: MECH/MFR INFO FOR ADDITIONAL OR ALTERNATE MIN. CLEARANCES. NOTE: COORDINATION W/MEP LOCATION OF CURB INLETS, WALL HYDRANTS, AND ANY ADDITIONAL ITEMS.
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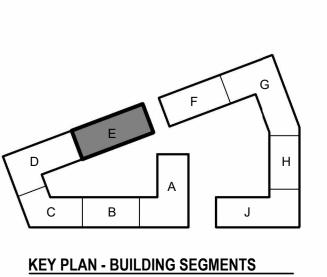


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 \triangle REVISIONS 1 23 0411 CITY COMMENTS 1

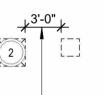

Јов No. **705921** DATE **03.15.2023** TSC/SIW CITY COMMENTS SHEET NAME
SEGMENT E 4TH FLOOR &
ROOF PLAN