# CITY OF LEE'S SUMMIT FIRE STATION #4

## 5031 NORTHEAST LAKEWOOD WAY LEE'S SUMMIT, MISSOURI 64064

#### CODE INFORMATION

#### I. Applicable Codes

- A. 2015 IBC
- C. 2014 ICC 500
- D. ICC/ANSI A117.1-2009
- E. 28 CODE OF FEDERAL REGULATIONS (CFR) PART 35.15 AS DETAILED IN THE DEPARTMENT OF JUSTICE TITLE II
  ADA REGULATIONS AND THE 2010 ADA STANDARDS OF ACCESSIBLE DESIGN

#### II. Building Information:

- A. II-B Construction (Per IBC 601)
- B. Fully Sprinklered (Per IBC 901.2)
- C. Full Perimeter Frontage (Per IBC 506.3)
- D. Use Group: Mixed Non-separated S-1, S-2, 8, R-2 (Per IBC 508.3)
  Occupant Load (IBC Table 1004.1.2)

Business Residential Storage Total

	This Project is new construction of a Fire Station in Lee's Summit. The building is fully sprinklered. Envision will install a full fire alarm system as well as monitoring of the sprinkler system.

Wiring Legend		
SLC	18/2 UNS SOL FPLP Red Jkt	
NAC	14/2 UNS SOL FPLP Red Jkt	
P-Link	18/4 UNS SOL FPLP Red Jkt	

Sheet Index		
FA - 1	Cover Page	
FA - 2	First Floor Plan	
FA - 3	Second Floor Plan	
FA - 4	Batter & Circuit Calculations, Operational Matrix, and Riser Diagram	
FA - 5	NFPA 72 Reference	

	Symbol Legend		
SYMBOL	DESCRIPTION		
NAC n	INTELLIGENT PWR EXPANDER, 6-AMP, 4-NAC		
FACP	FACP ADDRESSABLE 198 OR 318 POINTS		
<b>△</b> <sub>co</sub>	ADVANCED MULTI-CRITERIA FIRE/CO DETECTOR, WHITE		
⟨S⟩ <sub>P</sub>	LOW-PROFILE PHOTOELECTRIC SENSOR WHITE		
<b>Å</b> <sub>F</sub>	LOW-PROFILE INTELLIGENT 135F FIXED THERMAL SENSOR WHITE		
(MM) <sub>1</sub>	DUAL MONITOR MODULE		
FAA	REMOTE LCD ANNUNCIATOR, RED		
F	PULL STATION, DOUBLE ACTION, ADDRESSABLE		
(RM) <sub>1</sub>	RELAY MODULE, ADDRESSABLE		
	L-SERIES 2-WIRE, HORN STROBE, RED, WALL		
<b>₩</b>	L-SERIES STROBE, RED, WALL		
	HORN/STROBE, 2 WIRE, STANDARD CD, RED, OUTDOOR		
	HORN/STROBE, 2-WIRE, M-C HIGH, LOW FREQ, RED		

#### NOTES

- 1. All smoke detectors shall be located a minimum of three
- 2. All manual pull stations shall be mounted four (4) feet above the finished floor (centerline of device, +or-6inches), unless otherwise noted

of the device is not less than 80 inches above the finished floor and not greater than 96 inches above the finished floor.

- unless otherwise noted.


  3. All strobe and horn/strobes shall be located so the bottom
- 4. All notification devices shall be located no less than 6 inches below finished ceilings.
- 5. The candela rating of the strobes or horn/strobes shall be shown on the drawings.
- 6. The location of the notification devices shall be at a uniform
- 7. All cables, conduits, or wire mold shall be securely fastened to the structure.
- 8. Smoke detectors shall be located in the ceiling no less than
- 4 inches from a sidewall to the nearest edge of the detector.
- Drawings indicate general fire alarm device locations and Field Verify device locations with minimal deviations and document any changes.
- 10. FACP & Power Supplies shall be on a dedicated 120V, 20A circuit breaker marked in red with lock-on provision.
- 11. Fire Alarm wire paths are reserved for fire alarm cabling only. Including all UL listed fire barrier penetrations.
- 12.Outdoor Weatherproof Horn/Strobe is to be mounted 10'
- 13. All ceilings are 10' or below unless otherwise noted.
- 14. Default batteries are 18 amp hour unless otherwise
- 15. Remote Test Stations to be mounted on the wall 5' AFF.







ROFESSIONAL ENGINEER STAMF

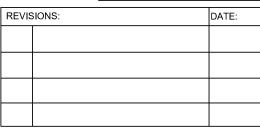



SITE: 5031 Northeast Lakewood Way Lee's Summit, Missouri 64064

TITLE: Cover Page


SCALE AT:

DATE:
5-31-2023

PROJECT NO:

DRAWING NO:
FA-1

REVISION:

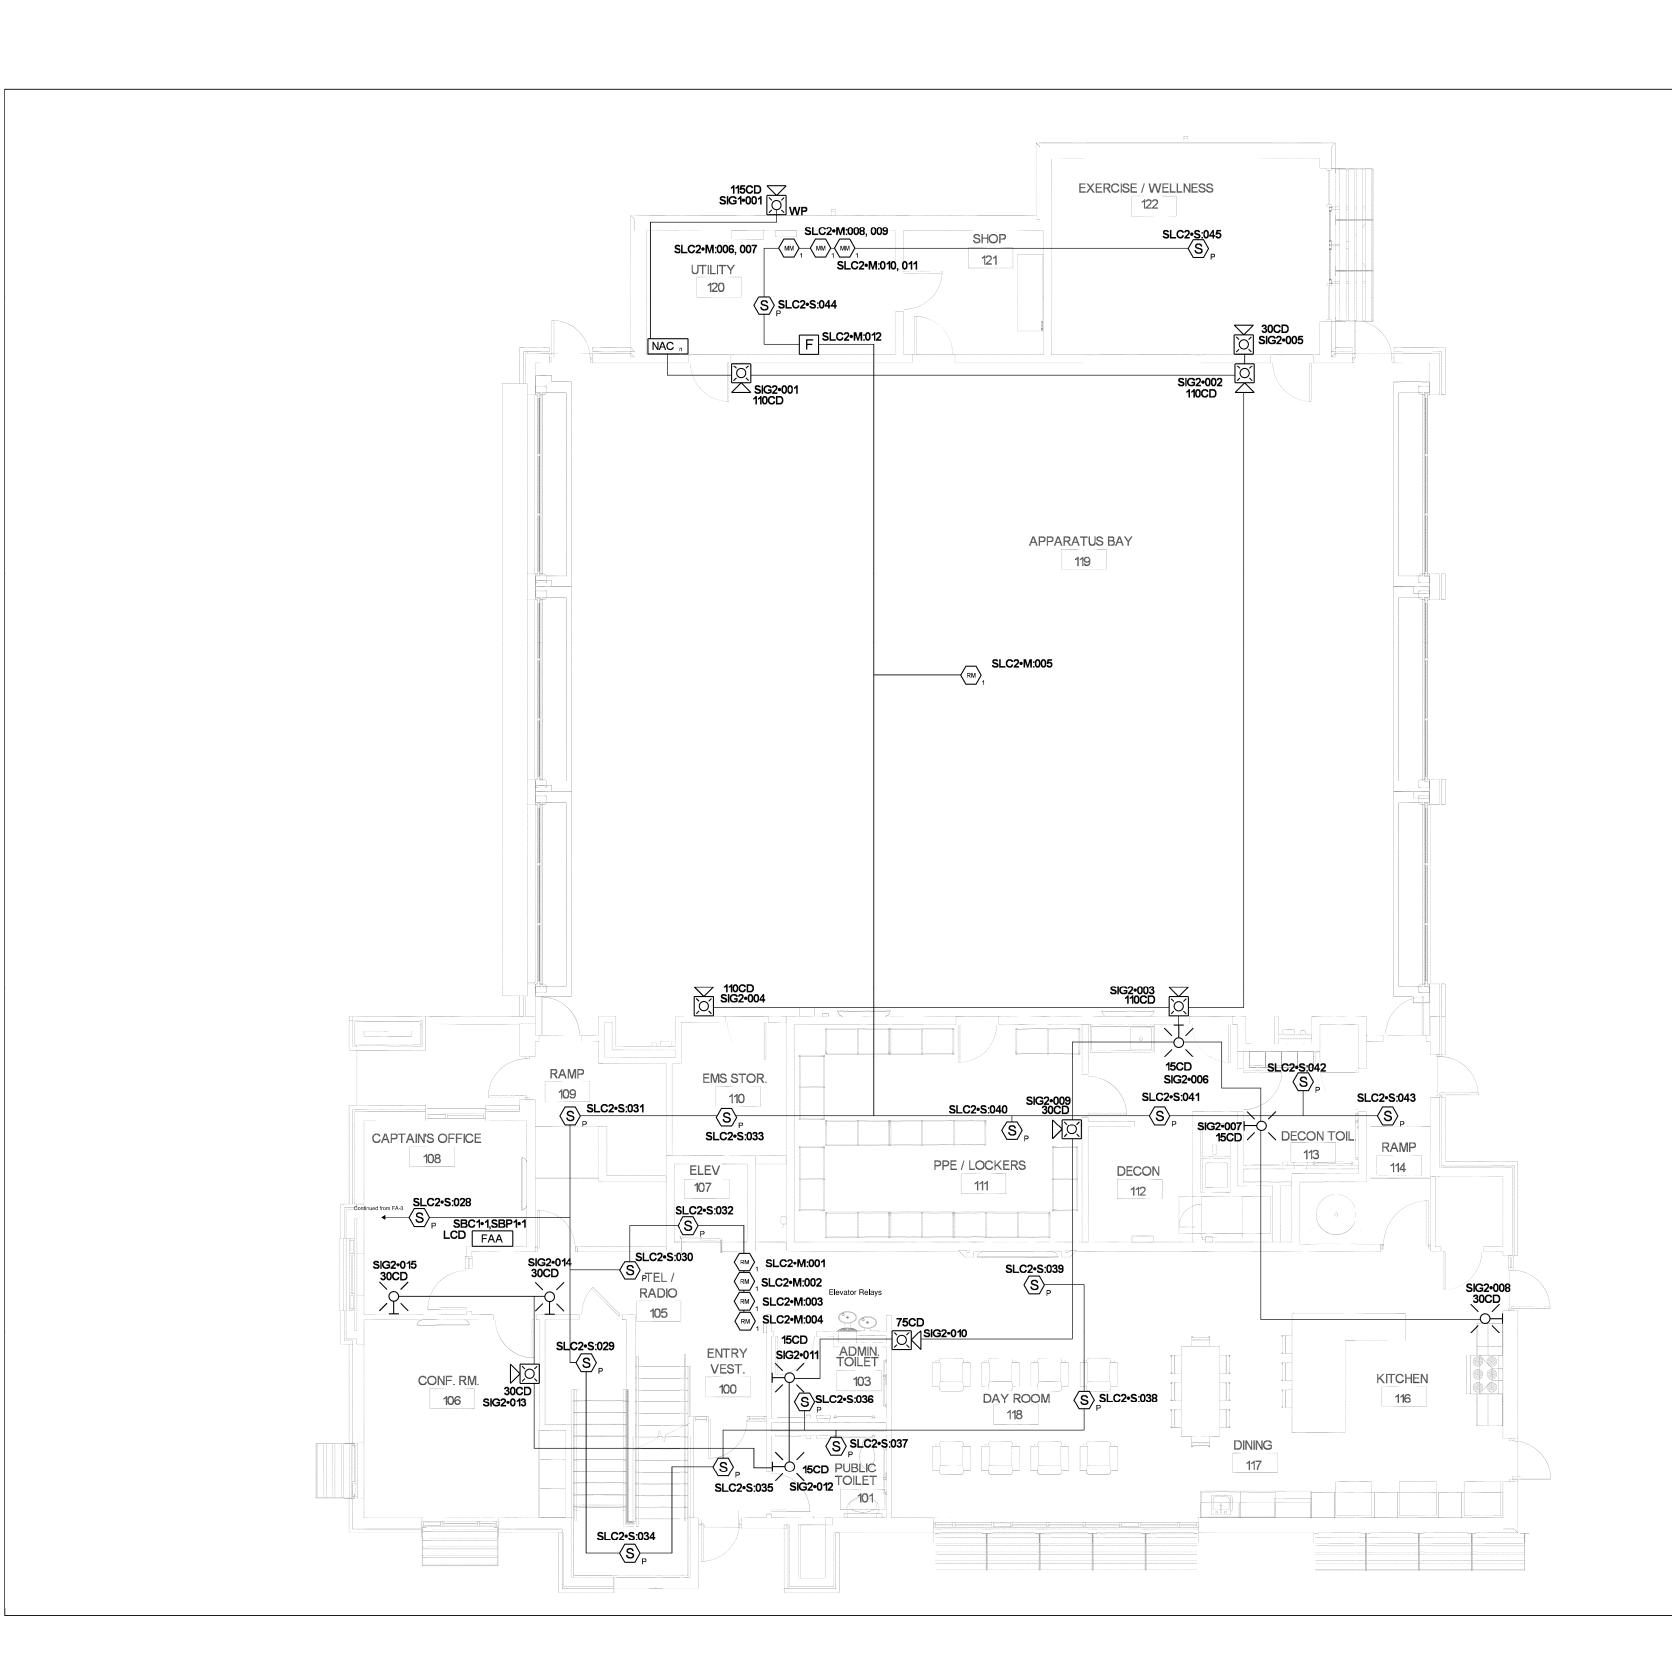

NOTES:

- 1. All smoke detectors shall be located a minimum of three (3) feet from any HVAC diffuser.
- All manual pull stations shall be mounted four (4) feet above the finished floor (centerline of device, +or-6inches), unless otherwise noted.
- unless otherwise noted.

  3. All strobe and horn/strobes shall be located so the bottom

of the device is not less than 80 inches above the finished floor and not greater than 96 inches above the finished floor.

- 4. All notification devices shall be located no less than 6 inches below finished ceilings
- 5. The candela rating of the strobes or horn/strobes shall be shown on the drawings.
- The location of the notification devices shall be at a uniform height for all devices.
- 7. All cables, conduits, or wire mold shall be securely
- 7. All cables, conduits, or wire mold shall be securely fastened to the structure.
- \_\_\_\_
- 8. Smoke detectors shall be located in the ceiling no less than 4 inches from a sidewall to the nearest edge of the detector.
- Drawings indicate general fire alarm device locations and Field Verify device locations with minimal deviations and document any changes.
- 10. FACP & Power Supplies shall be on a dedicated 120V,
- 20A circuit breaker marked in red with lock-on provision.

  11. Fire Alarm wire paths are reserved for fire alarm cabling only. Including all UL listed fire barrier penetrations.
- 12.Outdoor Weatherproof Horn/Strobe is to be mounted 10' 00" AFF FDC.
- 13. All ceilings are 10' or below unless otherwise noted.
- 14. Default batteries are 18 amp hour unless otherwise
- 15. Remote Test Stations to be mounted on the wall 5' AFF.





***************************************		A T
	ENVISIO	V
	TECHNOLOGY GRO	UP
•	6985 W 153rd St	
913-491-17 913-491-17		223

SITE: 5031 Northeast Lakewood Way Lee's Summit, Missouri 64064

TITLE: First Floor Plan


SCALE AT:
1/5" = 1'

PROJECT NO:

DATE:
5-31-2023

DESIGNED BY:
5-31-2023

DESIGNED BY:
FA-2

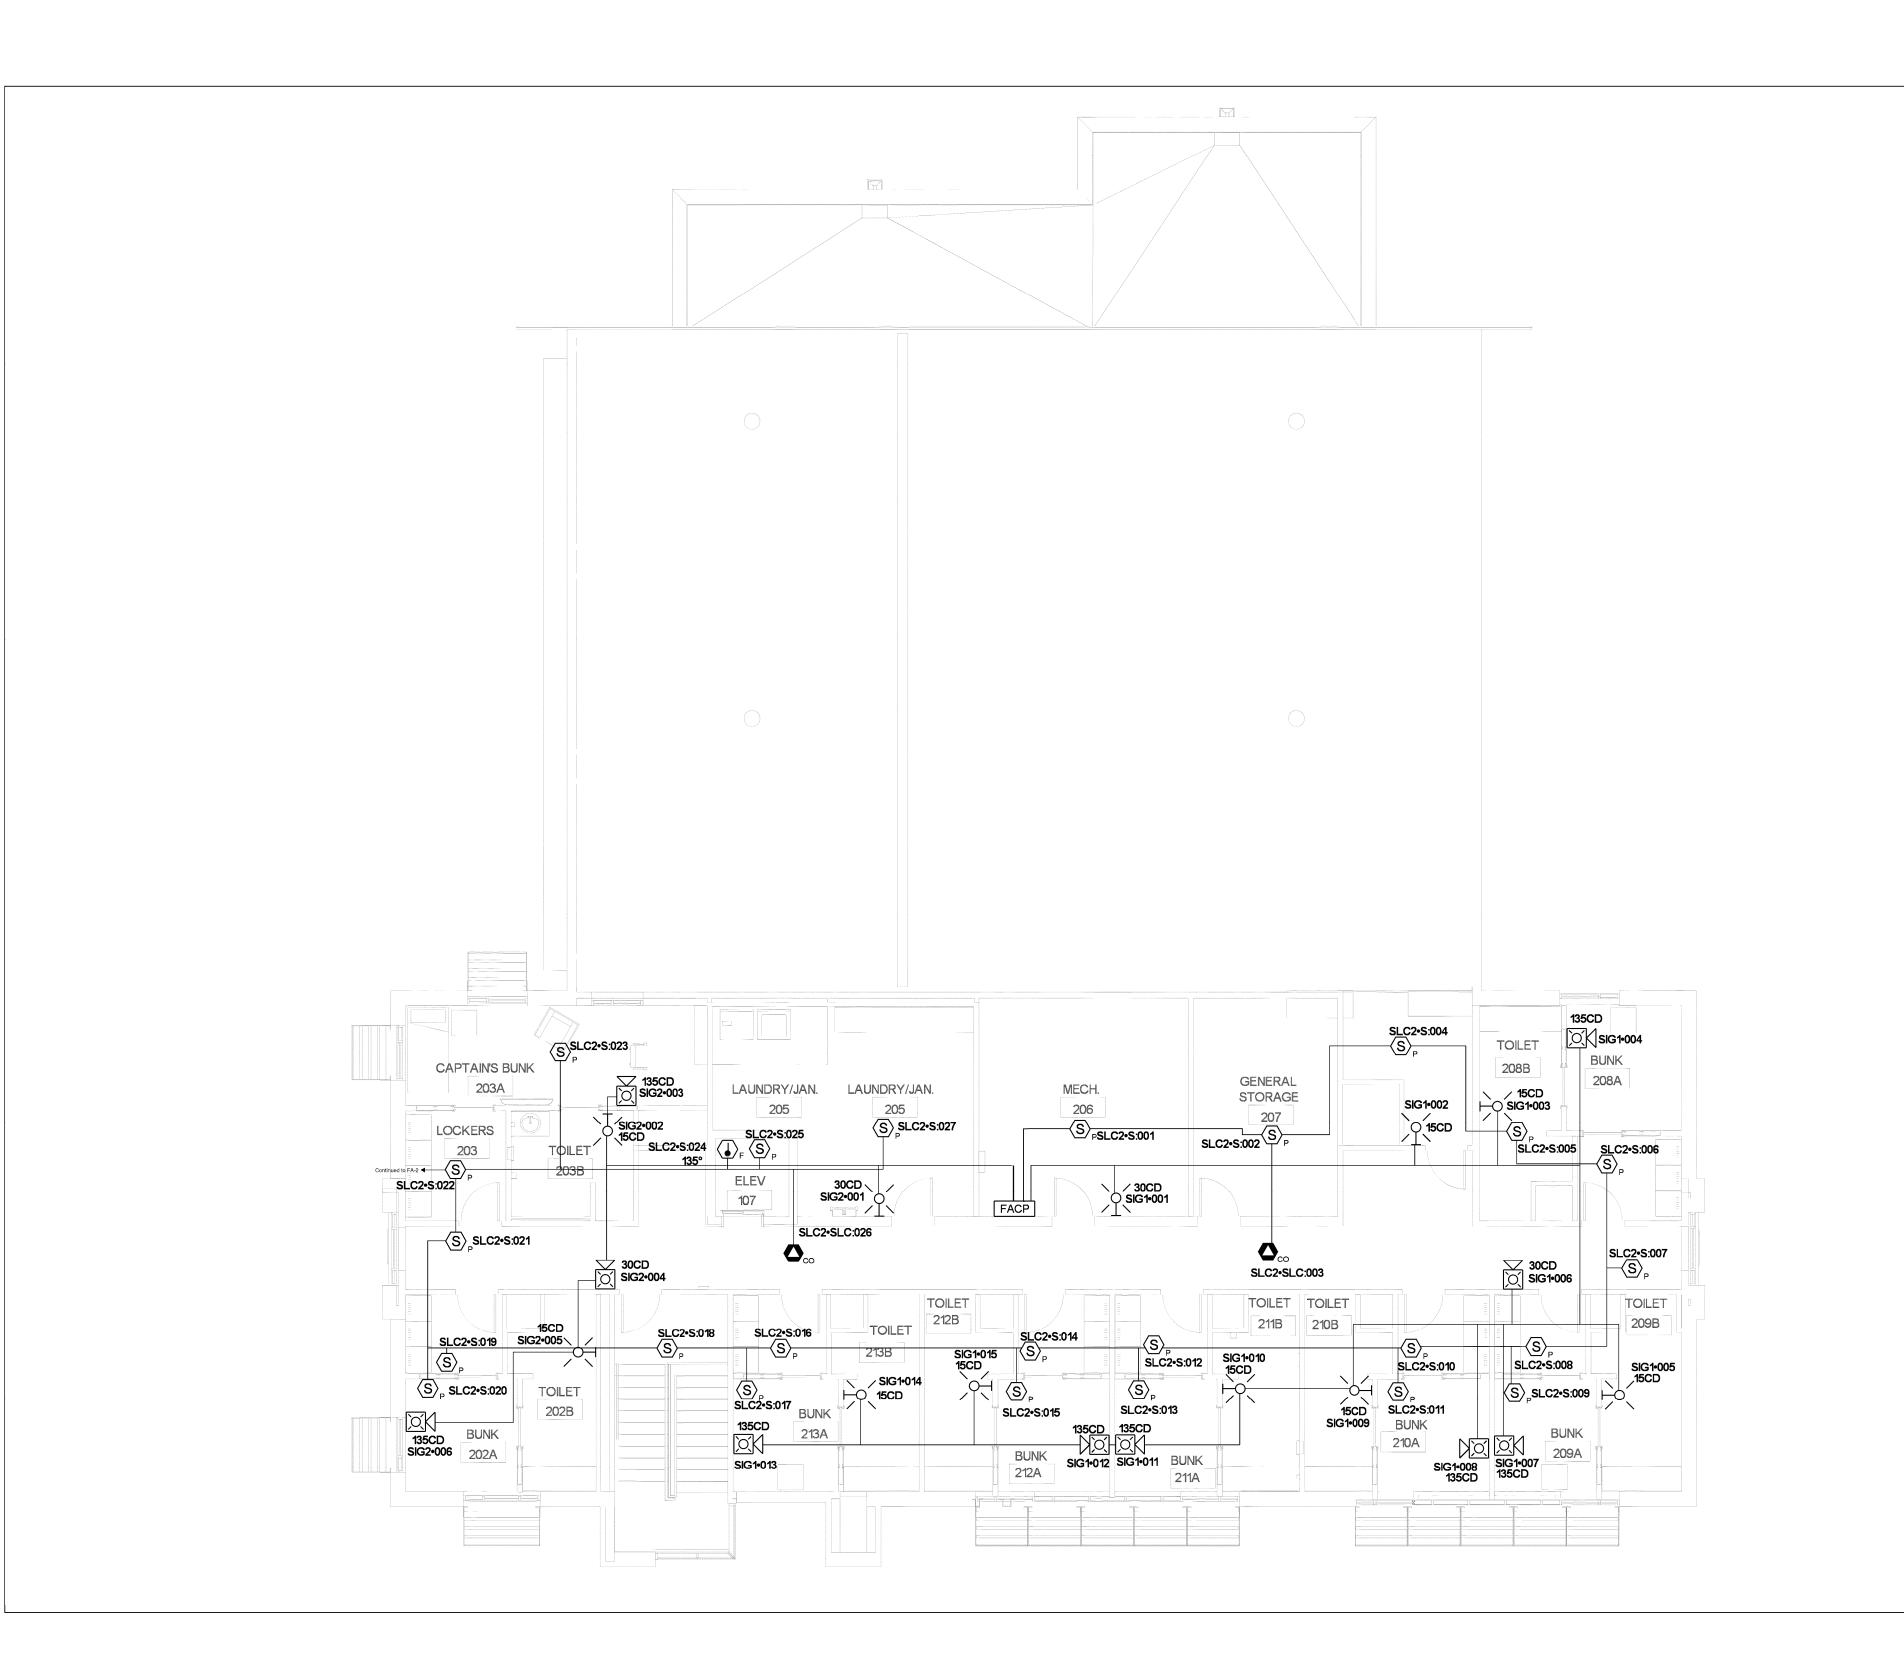


NOTES:

- 1. All smoke detectors shall be located a minimum of three (3) feet from any HVAC diffuser.
- 2. All manual pull stations shall be mounted four (4) feet above the finished floor (centerline of device, +or-6inches),
- 3. All strobe and horn/strobes shall be located so the bottom
- of the device is not less than 80 inches above the finished floor and not greater than 96 inches above the finished floor. 4. All notification devices shall be located no less than 6
- 5. The candela rating of the strobes or horn/strobes shall be

shown on the drawings.

- 6. The location of the notification devices shall be at a uniform height for all devices.
- 7. All cables, conduits, or wire mold shall be securely fastened to the structure.
- Smoke detectors shall be located in the ceiling no less than 4 inches from a sidewall to the nearest edge of the detector.
- Drawings indicate general fire alarm device locations and Field Verify device locations with minimal deviations and document any changes.
- 10. FACP & Power Supplies shall be on a dedicated 120V, 20A circuit breaker marked in red with lock-on provision.
- 11. Fire Alarm wire paths are reserved for fire alarm cabling only. Including all UL listed fire barrier penetrations.
- 12.Outdoor Weatherproof Horn/Strobe is to be mounted 10' 00" AFF FDC.
- 13. All ceilings are 10' or below unless otherwise noted.
- 14. Default batteries are 18 amp hour unless otherwise
- 15. Remote Test Stations to be mounted on the wall 5' AFF.



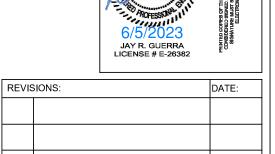





SITE: 5031 Northeast Lakewood Way Lee's Summit, Missouri 64064


TITLE: Second Floor Plan

	DATE: 5-31-2023	DESIGNED	BY:
PROJECT NO:	DRAWING N	10:	REVISION
	FΔ-3		

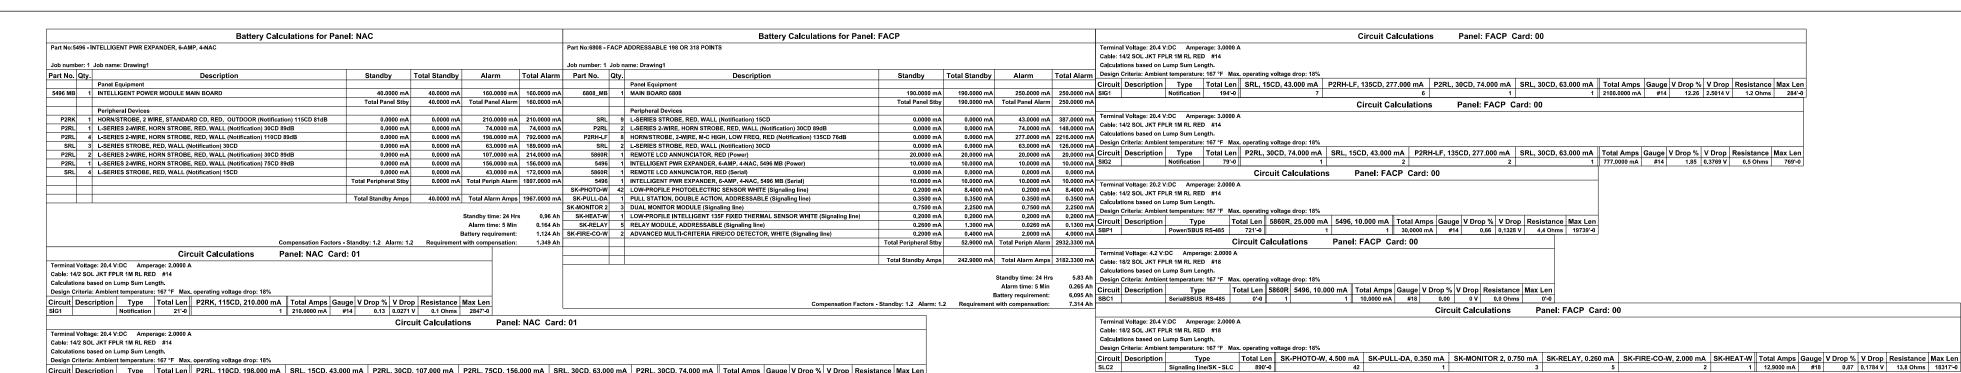

Circuit Description Type Total Len P2RL, 110CD, 198.000 mA SRL, 15CD, 43.000 mA P2RL, 30CD, 107.000 mA P2RL, 75CD, 156.000 mA SRL, 30CD, 63.000 mA P2RL, 30CD, 74.000 mA Total Amps Gauge V Drop Resistance Max Len SIG2 Notification 296'-0 4 4 4 2 2 1 1 3 1 1597.0000 mA #14 14.23 2.9025 1.8 Ohms 374'-0

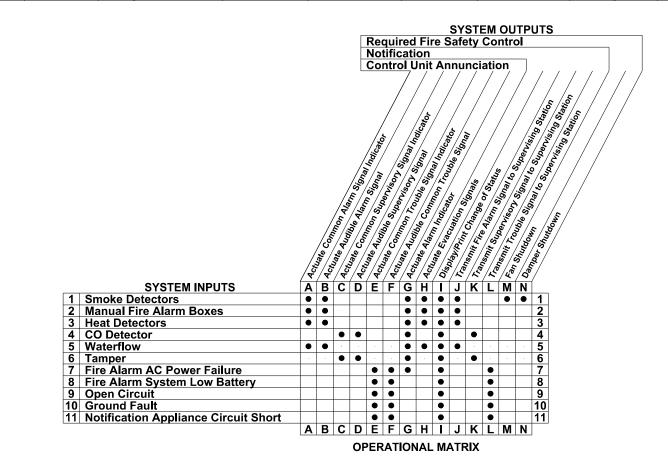

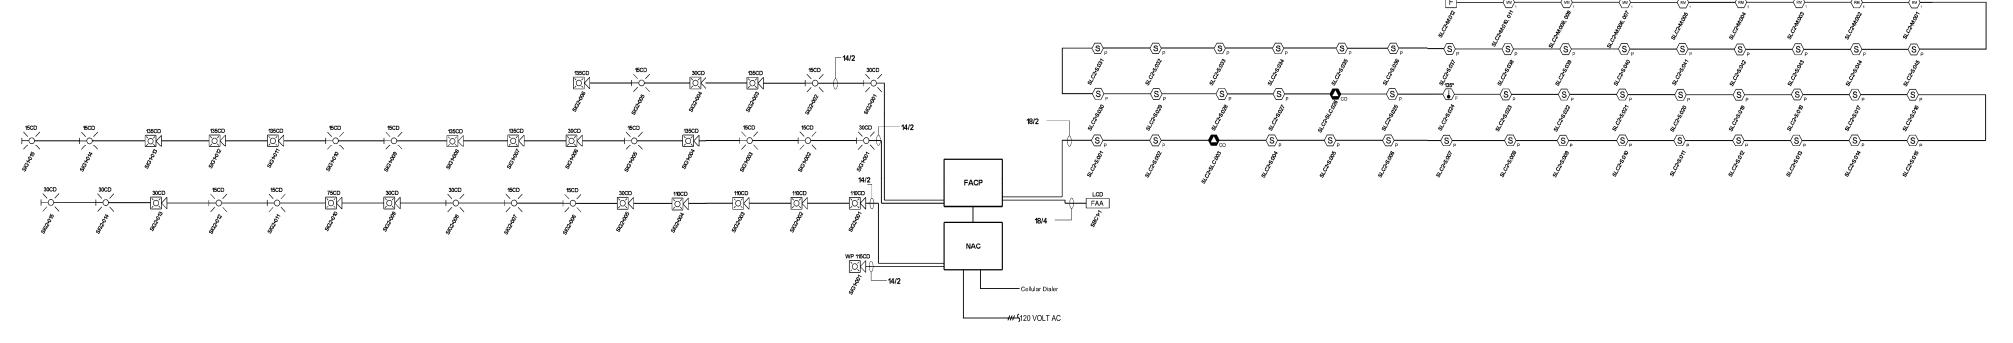

#### NOTES

- 1. All smoke detectors shall be located a minimum of three (3) feet from any HVAC diffuser
- 2. All manual pull stations shall be mounted four (4) feet above the finished floor (centerline of device, +or-6inches),
- unless otherwise noted.

  3. All strobe and horn/strobes shall be located so the bottom

of the device is not less than 80 inches above the finished floor and not greater than 96 inches above the finished floor.

- 4. All notification devices shall be located no less than 6
- 5. The candela rating of the strobes or horn/strobes shall be
- shown on the drawings.

  6. The location of the notification devices shall be at a uniform
- 7. All cables, conduits, or wire mold shall be securely


height for all devices.

- fastened to the structure.
- 8. Smoke detectors shall be located in the ceiling no less than
- 4 inches from a sidewall to the nearest edge of the detector.
- Drawings indicate general fire alarm device locations and Field Verify device locations with minimal deviations and
- document any changes.
- 10. FACP & Power Supplies shall be on a dedicated 120V, 20A circuit breaker marked in red with lock-on provision.
- 11. Fire Alarm wire paths are reserved for fire alarm cabling only. Including all UL listed fire barrier penetrations.
- 12.Outdoor Weatherproof Horn/Strobe is to be mounted 10'
- 13. All ceilings are 10' or below unless otherwise noted.
- 14. Default batteries are 18 amp hour unless otherwise
- 15. Remote Test Stations to be mounted on the wall 5' AFF.



ENGINEERING

REVISIONS:

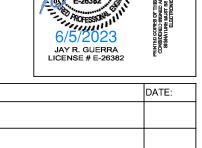

ROFESSIONAL ENGINEER STAM

	FNVICION
	TECHNOLOGY GROUP
13-491-17 13-491-17	0


SITE:	5031 North	east Lake	wood Wav
	Lee's Sumn	nit, iviissol	Jri 64064
TITLE:	Batter & Circuit Ca		
	Operational Matrix	k, and Riser Dia	agram
SCALE	AT:	DATE:	DESIGNED BY:
		5-31-2023	


DRAWING NO:

FA-4

REVISION

PROJECT NO:

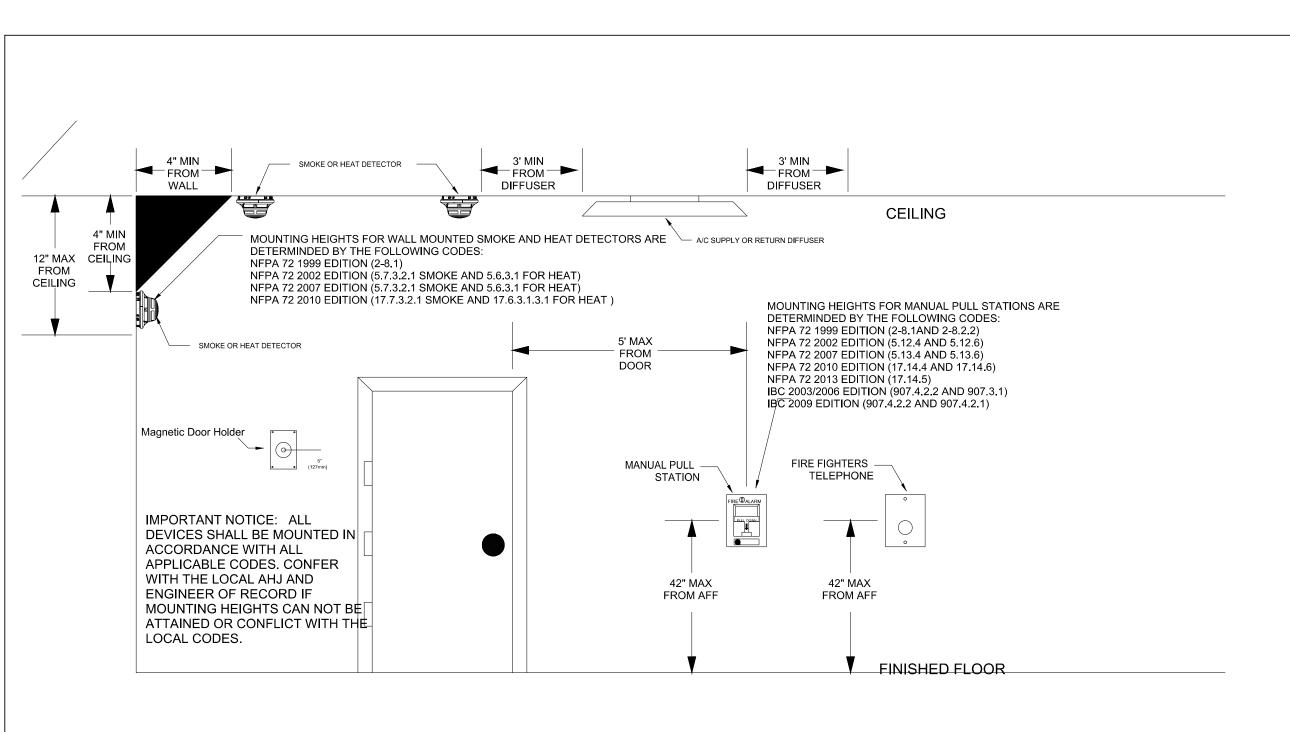

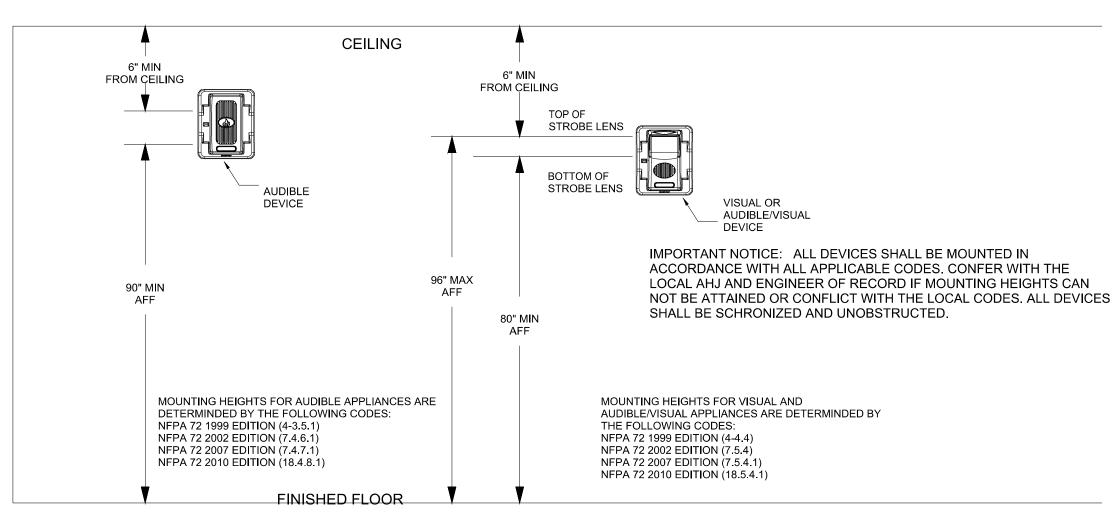

CEILING OR

REQUIREMENTS
NFPA 72

LOCATION

∃ اا 1.52 min. اا ع DETECT EITHER SMOKE DETECTO MOUNTING OR A ASSEMRIY 88 8 N 88 DETECTOR MOUNTED d (2, d


NOTES

- 1. All smoke detectors shall be located a minimum of three
- 2. All manual pull stations shall be mounted four (4) feet above the finished floor (centerline of device, +or-6inches),
- 3. All strobe and horn/strobes shall be located so the bottom of the device is not less than 80 inches above the finished floor and not greater than 96 inches above the finished floor.
- 4. All notification devices shall be located no less than 6
- 5. The candela rating of the strobes or horn/strobes shall be

shown on the drawings.

- 6. The location of the notification devices shall be at a uniform  $% \left\{ 1,2,...,n\right\}$ height for all devices.
- 7. All cables, conduits, or wire mold shall be securely
- fastened to the structure.
- 8. Smoke detectors shall be located in the ceiling no less than
- 4 inches from a sidewall to the nearest edge of the detector.
- 9. Drawings indicate general fire alarm device locations and Field Verify device locations with minimal deviations and
- document any changes. 10. FACP & Power Supplies shall be on a dedicated 120V,
- 20A circuit breaker marked in red with lock-on provision. 11. Fire Alarm wire paths are reserved for fire alarm cabling
- only. Including all UL listed fire barrier penetrations. 12.Outdoor Weatherproof Horn/Strobe is to be mounted 10'
- 13. All ceilings are 10' or below unless otherwise noted.
- 14. Default batteries are 18 amp hour unless otherwise
- 15. Remote Test Stations to be mounted on the wall 5' AFF.



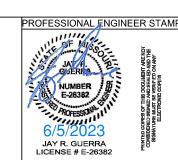

REVISIONS:		DATE:	



SITE: 5031 Northeast Lakewood Way Lee's Summit, Missouri 64064

TITLE: NFPA 72 Reference

DESIGNED BY: DATE: 5-31-2023 PROJECT NO: DRAWING NO: FA-5

### NFPA 72 Device Reference