


# PROTOTYPE - NEW CONSTRUCTION -TENANT IMPROVEMENT

# PANERA BREAD BAKERY-CAFE#2406 1410 NE DOUGLAS ST LEES SUMMIT, MO 64086

#### SITE MAP:

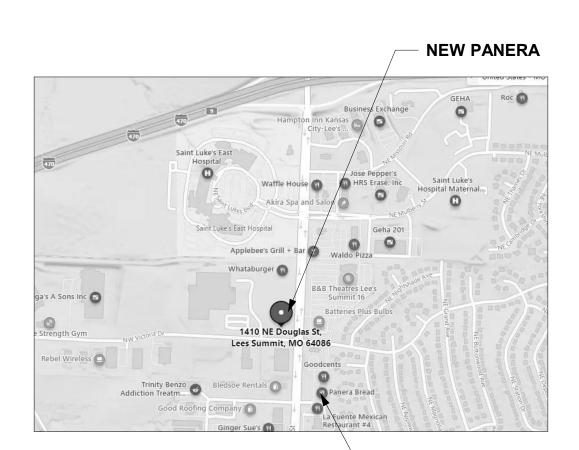

**REVISION ISSUE LOG - TI** 

Tenant - Construction Set

Tenant - Owner Revision

Prototype Updates

REVISION # ISSUE DATE

11/09/2022 02/03/2023

05/29/2023

**EXISTING PANERA** 

#### **CODE INFORMATION:**

**APPLICABLE CODES & REGULATIONS:** 2018 INTERNATIONAL FIRE CODE 2018 INTERNATIONAL FUEL GAS CODE **CODE CLASSIFICATION:** A. OCCUPANCY GROUP: A-2 ASSEMBLY

NOT REQUIRED

**B. CONSTRUCTION CLASSIFICATION:** C. AUTOMATIC FIRE SUPRESSION SYSTEM INSTALLED:

TOTAL GROSS PANERA SUITE: 3,482 SQFT 527 SQFT

TRAVEL DISTANCE: ALLOWED TRAVEL DISTANCE: 200 FT ACTUAL TRAVEL DISTANCE: 66'-0" FT MAX

#### PROTOTYPE INFORMATION:

THIS SET OF DOCUMENTS INCORPORATES ALL REVISIONS THROUGH PROTOTYPE UPDATE 2022-Q4.V1

#### LANDLORD APPROVAL:

NAME	
SIGNATURE	DATE

# AFFECTED SHEETS REMARKS

#### **CONTACT LIST**

PANERA BREAD DESIGN MANAGER: Sheet Number Sheet Name ROGER BOST 3630 S. GEYER ROAD, SUITE 100 ST. LOUIS, MO 63127 GENERAL PHONE: 573.300.9693 ROGER.BOST@PANERABREAD.COM GENERAL NOTES, SYMBOLS, LEGENDS & ABBREVIATIONS INTERIOR ACCESSIBILITY GUIDELINES 2017 ANSI 117.1 CONSTRUCTION PROJECT MANAGER: LIFE SAFETY PLAN SUSUN SABLAN 6200 OAK TREE BLVD., SUITE 250 INDEPENDENCE, OH 44131 PHONE: 530.520.1618 SLAB PLAN - DIMENSIONED SSABLAN@FLYNNRG.COM FLOOR PLAN - DIMENSIONED FLOOR PLAN - KEYED NOTES PARTITION TYPES TENANT IMPROVEMENT: WALL FINISH PLAN PAN KANSAS, LLC FLOOR FINISH PLAN INDEPENDENCE, OH 44131 REFLECTED CEILING PLAN CONTACT: PAT EULBERG LIGHTING SCHEDULE, DETAILS, & SECTIONS CEILING DETAILS LANDLORD: STAR AQUISITIONS & DEVELOPMENT, LLC ARCH-LARGE SCALE VIEWS CONTACT: TIMOTHY HARRIS ENLARGED RESTROOM PLANS & INTERIOR ELEVATIONS ARCHITECT: INTERIOR ELEVATIONS FRONT OF HOUSE DENNIS D. SMITH INTERIOR ELEVATIONS BACK OF HOUSE 345 RIVERVIEW, SUITE 200 WICHITA, KS 67203

PHONE: 316.268.0230 EXT: 354 CGABOIAN@LK-ARCHITECTURE.COM PLANNING/ZONING DEPARTMENT CONTACT: MIKE WEISENBORN 220 SE GREEN STREET LEE'S SUMMIT, MO 64063 PHONE: 816.969.1240 MIKE.WEISENBORN@CITYOFLS.NET

PANERA BREAD PROGRAM MANAGER: PHONE: 614.648.4920

ERIC.COX@PANERABREAD.COM

SHEET INDEX - TI ARCH-DETAILS INTERIOR DETAILS INTERIOR DETAILS CASEWORK SECTIONS & DETAILS FLOORING DETAILS ARCH-SCHEDULES & NOTES FINISH SCHEDULES, LEGENDS, & NOTES DOOR ELEVATIONS, SCHEDULES, & DETAILS ARCH-SPECIALTY EQUIPMENT PLAN EQUIPMENT SCHEDULES FURNITURE PLAN FURNITURE & WOOD/STEEL SCHEDULES ARTWORK & GRAPHICS PLAN

ARTWORK & SIGNAGE SCHEDULES, DETAIL & NOTES

### SHEET INDEX - TI

Sheet		Curre
Number	Sheet Name	Revis
MECHAN	ICAL	
M101	MECHANICAL PLAN & NOTES	5
M102	MECHANICAL SCHEDULES	5
M301	VENTILATION DETAILS & SCHEDULES	5
M302	VENTILATION DETAILS & SCHEDULES	2
M401	MECHANICAL DETAILS	5
M501	MEP ROOF PLAN	5

SANITARY PLUMBING ROUGH-IN PLAN DOMESTIC WATER ROUGH-IN PLAN & NOTES SANITARY PLUMBING PLAN DOMESTIC WATER & GAS PLUMBING PL PLUMBING DWV RISER PLUMBING SUPPLY RISER GAS RISER PLUMBING DETAILS PLUMBING DETAILS PLUMBING SCHEDULES PLUMBING SPECIFICATIONS

ELECTR	ICAL	
E201	ELECTRICAL ROUGH-IN PLAN	5
E202	ELECTRICAL ROUGH-IN SCHEDULES	5
E203	ELECTRICAL POWER PLAN	5
E301	ELECTRICAL LIGHTING PLAN	5
E401	SPECIAL SYSTEMS PLAN	5
E403	POS DIAGRAM AND NOTES	5
E501	PANEL SCHEDULES AND ONE-LINE DIAGRAM	4
E502	ELECTRICAL SPECIFICATIONS	2
E601	ELEVATIONS	5
FS101	ELECTRICAL SITE PLAN	5

Sheet Count: 55

Bakery-Cafe:

#2406


SYSTEM: G4 (ARIA)



LK ARCHITECTURE, INC.

345 RIVERVIEW, **WICHITA, KS 67203** T 316.268.0230 F 316.268.0205

**Architecture** · **Engineering Planning · Interior Design Landscape Architecture** 

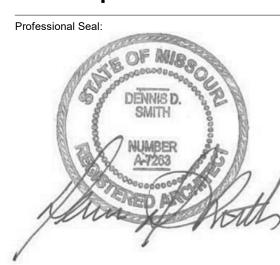

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No.	Description	Date
	Tenant - Permit Set	7/18/2022
1	Tenant - City Comments	9/22/2022
2	Tenant - Construction Set	11/09/2022
4	Tenant - Owner Revision	02/03/2023
5	Prototype Updates	05/29/2023

#### **COVER SHEET**

Project Number:		Sneet Number:
22301 Drawn By:	_	
EB	(·	6001.1
Issue Date: <b>05/29/2023</b>		
DPM:	DM:	CPM:
DPM	DM	CPM

ABOVE FINISHED FLOOR

**ALTERNATE** 

ALUMINUM

**BLOCKING** 

BUILDING

BOARD

ACOUSTICAL CEILING TILE

AFF

ACT

ALUM

ARCH

BLDG BD

FLR

FD

GΑ

INCL

INSUL

INT

FLOOR

INCLUDE(D)

APPROX

OWNER FURNISHED,

OWNER FURNISHED.

OWNER INSTALLED

OPPOSITE HAND

PLASTIC LAMINATE

ON CENTER

OPENING

**OPPOSITE** 

PAINT(ED)

**PARTITION** 

PLYWOOD

SIMILAR

CONTRACTOR INSTALLED

ORIENTED STRAND BOARD

REINFORCE(D)

CFCI CONTRACTOR FURNISHED CONTRACTOR INSTALLED OFCI CENTERLINE CLG CEILING CT CERAMIC TILE CLR CLEAR OC CONCRETE CONTINUE, CONTINUOUS OPG **CONTROL JOINT** 

CONC CONT CORR OSB CORRIDOR DIA DIAMETER PLAM DIM DIMENSION(S) PT PTN PWD EACH EΑ ELECTRIC(AL) **ELEVATION** ELEV QTY

QUANTITY EQ **EQUAL EQUIP EQUIPMENT** EXP **EXPANSION** REF REFERENCE EJ **EXPANSION JOINT** REINF **EXISTING** REQ REQUIRED EXT **EXTERIOR** REV REVISION **RESILIENT BASE** FIN FINISH(ED) SOUND ATTENUATION BATTS FIN FLF FINISHED FLOOR SC FIRE EXTINGUISHER SOLID CORE FEC SF FIRE EXTINGUISHER CABINET SQUARE FOOT (FEET)

FLOOR DRAIN SLNT SEALANT FLUOR **FLUORESCENT** SPEC SPECIFICATION FIRE-RETARDANT TREATED SQUARE SQ FT SQUARE FOOT (FEET) STL **STEEL** GAUGE SUSP SUSPEND(ED GYP BD GYPSUM BOARD SYM SYMMETRICAL

SIM

UNO

HCP **HANDICAPPED** TELEPHONE TEL HDW **HARDWARE TEMP TEMPERED** HT TOS TOP OF STRUCTURE HEIGHT HC **HOLLOW CORE** TOW TOP OF WALL **HOLLOW METAL** TYP **TYPICAL** HOR HORIZONTAL HR HOUR UNDERWRITERS LABORATORIES, INC. **UNLESS NOTED OTHERWISE** 

**INSULATION** VERTICAL INTERIOR **VERT JOINT** WALL COVERING WITH WITHOUT WD LAMINATE WOOD

#### SYMBOLS LEGEND




SIM /

\A101/∕**→** 

**NORTH ARROW** 


View Name

PLAN, DETAIL OR ELEVATION TITLE 1/8" = 1'-0"

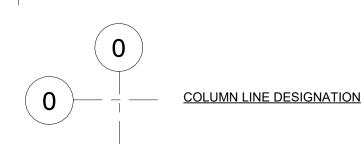


**BUILDING SECTION** DETAIL NUMBER

SHEET NUMBER

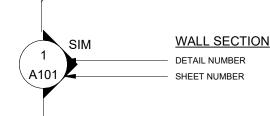



**DETAIL MARKS** SIM/ DETAIL NUMBER \A101/\_


ROOM NAME / NUMBER Room name ROOM NAME 101 ROOM

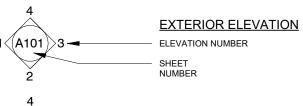



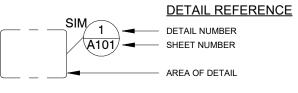

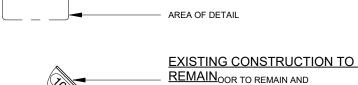

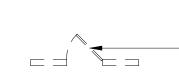

EXISTING CONSTRUCTION TO BE EXISTING DOOR TO BE



EXISTING PARTITIONS




**EXISTING PARTITIONS TO BE REMOVED** NEW PARTITIONS (REF PARTITION **NEW PARTITIONS W/ R-11 SOUND BATT** 

**COOLER / FREEZER WALL** 1/2 HEIGHT WALL (HEIGHT VARIES)



KEYED NOTE

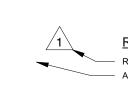

REVISION CLOUD AND TAG REVISION NUMBER AREA OF REVISION

WINDOW NUMBER SYMBOL

**WALL PARTITION TYPE** 

#### **GENERAL CONDITIONS...**

- 1 PERMITS: CONTRACTOR IS RESPONSIBLE FOR ALL PERMITS.
- 2 QUALITY: CONTRACTOR SHALL PERFORM ALL WORK AND INSTALL ALL COMPONENTS IN A PROFESSIONAL MANNER. ALL FINISH WORK TO BE TRUE, LEVEL AND PLUMB. ALL JOINTS TO BE TIGHT AND CLEAN.
- 3 CODE COMPLIANCE: WORK SHALL CONFORM TO ALL APPLICABLE LOCAL, STATE, AND FEDERAL CODES INCLUDING NFPA; AND USE TESTED AND CERTIFIED ASSEMBLIES, AS REQUIRED BY CODE.
- 4 HANDICAP ACCESSIBILITY: CONTRACTOR SHALL COMPLY WITH ACCESSIBILITY GUIDELINES 36 CFR PART 1191 OF THE FEDERAL REGISTER, ITS REVISIONS TO ANSI STANDARD A117.1, AND TITLE III OF THE AMERICAN'S WITH DISABILITY ACT (ADA), AND LOCAL
- 5 WARRANTY: ALL CONSTRUCTION, MATERIALS, PRODUCTS AND WORK TO BE WARRANTED FOR A PERIOD OF ONE YEAR FROM THE DATE OF FINAL ACCEPTANCE BY THE TENANT.
- 6 CONTRACTOR TO FIELD VERIFY ALL DIMENSIONS. NO MEASUREMENTS SHALL BE SCALED FROM THE DRAWINGS. CONTRACTOR SHALL OBTAIN CLARIFICATION FROM ARCHITECT BEFORE PROCEEDING WITH CONSTRUCTION IF A DIMENSION(S) IS IN QUESTION.
- 7 CONTRACTOR IS ADVISED THAT PORTIONS OF THIS DOCUMENT MAY BE BASED ON UNFIELD VERIFIED INFORMATION PROVIDED BY OTHERS IN ACCORDANCE WITH THE OWNERS DIRECTIONS. CONTRACTOR TO ADVISE ARCHITECT OF ANY EXISTING CONDITION DIFFERENT FROM THAT NOTED WHICH MAY IMPACT CONSTRUCTION PRIOR TO EXECUTION.
- 8 DIMENSIONS AND NOTES ON ENLARGED PLANS AND DETAILS ARE TO OVERRULE SMALLER SCALE DRAWINGS. ALL DIMENSIONS ARE TO FACE OF DRYWALL UNLESS NOTED OTHERWISE.
- 9 TURN OVER TO LANDLORD OR SAVE FOR REUSE THE FOLLOWING ITEMS WHEN DISMANTLED: A) DOORS, FRAMES, & DOOR HARDWARE AS INDICATED.
  - B) THERMOSTATS. C) SUPPLY AND RETURN AIR GRILLES.
  - D) ADDITIONAL ITEMS INDICATED ON PLAN. E) EXISTING LIGHT FIXTURES INDICATED ON PLAN.
- 1 CLEAN UP: REMOVE ALL DEBRIS, PACKING MATERIAL, DEMOLISHED 0 MATERIAL, AND EXTRANEOUS TRASH GENERATED BY CONSTRUCTION FROM BUILDING & SITE UNLESS NOTED, TO BE TURNED OVER TO LANDLORD. ALL DEMOLISHED MATERIAL NOT TO BE TURNED OVER TO LANDLORD SHALL BECOME THE PROPERTY OF GENERAL CONTRACTOR.
- 1 BUILDING STANDARDS: ALL MATERIAL, HARDWARE, FIXTURES, AND 1 FINISHES TO BE BUILDING STANDARD UNLESS NOTED OTHERWISE. BUILDING STANDARD INFORMATION IS AVAILABLE THROUGH THE TENANT'S REPRESENTATIVES, AND TYPICALLY MATCHES EXISTING INTERIOR CONSTRUCTION.
- 1 SITE VISIT; ALL GENERAL CONTRACTORS & SUBCONTRACTORS 2 ARE TO VISIT SITE PRIOR TO COMPLETING BID TO VERIFY EXISTING CONDITION. GENERAL CONTRACTOR & SUBCONTRACTORS TO PROVIDE WRITTEN DOCUMENTATION OF ANY DISCREPANCY BETWEEN SITE CONDITIONS & DOCUMENTS. SUBMISSION OF BID IS CONFIRMATION THAT EXISTING CONDITIONS HAVE BEEN FULLY TAKEN INTO CONSIDERATION & ARE REFLECTED IN THE COSTS
- 1 CONTRACTOR TO PROVIDE 2X FIRE RESISTANT BLOCKING AS 3 NECESSARY BEHIND ALL WALL MOUNTED INSTALLATIONS.
- 1 CONTRACTOR TO PROVIDE BUILDING CONSTRUCTION 4 REPRESENTATIVE WITH COPIES OF DELIVERY, AND CONSTRUCTION SCHEDULES. CONTRACTOR TO COORDINATE ALL SCHEDULES WITH BUILDINGS CONSTRUCTION REPRESENTATIVE.
- 1 IF EXTERIOR WINDOWS ARE BEING ENCLOSED CONTRACTOR IS TO 5 CLEAN ALL WINDOWS, SHADES, CAVITY AREA FROM CONSTRUCTION DUST AND DEBRIS PRIOR TO ENCLOSING EXTERIOR WINDOWS.
- 1 CUTTING & PATCHING: CONTRACTOR TO PATCH, REPAIR, & 6 REFINISH WORK DAMAGED AS A RESULT OF DEMOLITION OR REMOVAL OF CONSTRUCTION TO MATCH ADJACENT FINISH. PATCH THRU-WALL/ THRU-FLOOR PENETRATIONS TO MAINTAIN EXISTING BUILDING INTEGRITY.
- 1 USE 3M NON-INTUMESCENT FIRE STOPPING AS FOLLOWS: 7 FIREDAM 150 CAULK FOR WALL & FLOOR PENETRATION SEALS, TO MEET OR EXCEED ASTM E 814 (UL1479) AND/OR ASTM E 119 (UL263); STRUCTURAL STEEL, AND ELECTRICAL & CONTROL SYSTEM, TO MEET OR EXCEED ASTM E 119 (UL263) AND HIGH INTENSITY FIRE TEST
- (UL 1709). FIRE BARRIER 2001 SILICONE RTV FOAM FOR CABLE BUNDLES AND TRAYS, TRAYS CONDUIT BUNDLES AND MULTIPLE PIPE RUNS, AND OTHER LARGE OPENINGS TO MEET OR EXCEED ASTM E 814 AND TO COMPLY WITH CURRENTLY APPLICABLE REQUIREMENTS OF THE NEC (NFPA-70), BOCAI, ICBO, SBCCI, IBC AND NFPA CODE #101.
- 1 ALL NEW CONCRETE FLOORING SECTIONS TO BE DOWELED AND 8 PINNED TO EXISTING CONCRETE SLAB
- 1 ALL ROOF WORK TO BE COMPLETED BY LANDLORD'S APPROVED 9 ROOFING CONTRACTOR
- 2 FIRE PROTECTION: GENERAL CONTRACTOR IS RESPONSIBLE TO 0 PROVIDE, EXTEND, OR REVISE ALARM SYSTEMS AS REQUIRED TO COMPLY WITH APPLICABLE CODES. COORDINATE WORK WITH OWNER'S REPRESENTATIVES WHERE MODIFYING OR TYING INTO EXISTING SYSTEMS. GENERAL CONTRACTOR SHALL PREPARE REQUIRED DRAWINGS AND OBTAIN BUILDING PERMITS FOR ALARM SYSTEM WORK.
- 2 CONTRACTOR TO REQUEST FROM LANDLORD A COPY OF ALL 1 BUILDING RULES & REGULATIONS. THESE RULES & REGULATIONS TO BE FULLY COMPLIED WITH AT ALL TIMES DURING CONSTRUCTION BY THE GENERAL CONTRACTOR & SUB-CONTRACTOR(S). CONTRACTOR TO PROVIDE STATEMENT OF QUALIFICATIONS & INSURANCE CERTIFICATES AS NECESSARY TO THE BUILDING'S REPRESENTATIVE.
- 2 CONTRACTOR TO MAINTAIN CLEAR ACCESS TO ALL DRIVE & 2 ENTRANCES WHILE ON SITE.
- 2 CONTRACTOR TO STORE & INSTALL AS NECESSARY ANY 3 OWNER-PROVIDED EQUIPMENT. REFER TO DOCUMENTS FOR FURTHER DETAIL.
- 2 NOT USED

#### **GENERAL CONDITIONS...**

- 2 EXISTING CONDITIONS DOCUMENTS PROVIDED FOR REFERENCE 5 ONLY. ANY WORK INDICATED HAS ALREADY BEEN COMPLETED.
- 2 ALL AREAS MUST BE COMPLETELY CLEAN & CLEAR OF ANY
- 6 CONSTRUCTION MATERIALS @ A MINIMUM OF (2) HOURS BEFORE THE CAFE OPENS EACH DAY.
- 2 WOOD DOORS: REFER TO DOCUMENTS FOR FURTHER DETAIL.
- METAL DOORS: REFER TO DOCUMENTS FOR FURTHER DETAIL
- 2 FRAMES: REFER TO DOCUMENTS FOR FURTHER DETAIL.
- 3 HARDWARE STANDARD: PROVIDE DOOR HARDWARE IN ACCORDANCE W/ SCHEDULE. ALL LOCKSET/LATCHSET HARDWARE COMPLY W/TITLE III OF AMERICANS WITH DISABILITIES ACT (ADA). GENERAL CONTRACTOR TO COORDINATE KEYING WITH OWNER
- 3 DRYWALL: REFER TO PARTITION DETAILS FOR FURTHER 1 INFORMATION.

REPRESENTATIVE.

- 3 RESILIENT BASE: PROVIDE 6" HIGH RUBBER COVE BASE IN 100" 2 ROLLS. REFER TO DOCUMENTS FOR FURTHER DETAILS.
- 3 PAINT: PROVIDE 2 COATS OF ALKYD SEMI-GLOSS ENAMEL FINISH 3 COLOR ON METAL DOORS & FRAMES AS INDICATED ON DRAWINGS.
- 3 PAINT: PROVIDE 2 COATS OF PREMIUM BENJAMIN MOORE (NO 4 SUBSTITUTIONS ALLOWED) EGGSHELL FINISH COLOR ON ALL NEW SURFACES AS INDICATED ON DRAWINGS. PRIME NEW/EXISTING SURFACES & PATCH AS REQUIRED.
- 3 SOUND BATT INSULATION (WALLS ONLY): SHALL BE UNFACED 5 GLASS FIBER ACOUSTICAL INSULATION COMPLYING WITH ASTM C665. TYPE 1. SIZED AS INDICATED IN DETAILS. MAXIMUM FLAME SPREAD: 10, STC ABOVE 55.
- 3 SOUND ATTENUATION (ABOVE CEILINGS) SHALL BE 3" UNFACED, 6 LIGHT WEIGHT, RESILIENT FIBERGLASS DESIGNED TO ABSORB SOUND AND SPECIFICALLY MANUFACTURED FOR USE ABOVE CEILINGS. MAXIMUM FLAME SPREAD: 25 STC ABOVE 55. NO SOUND ATTENUATION INSULATION IS TO BE USED ABOVE FINISHED CEILING IN FOOD PREPARATION AREAS.
- 3 ALL FLOORING PRODUCTS TO BE INSTALLED IN ACCORDANCE WITH 7 MANUFACTURER RECOMMENDATIONS & SPECIFICATIONS. CONTRACTOR IS RESPONSIBLE FOR ALL FLOOR LEVELING THAT MAY BE REQUIRED IN ORDER TO COMPLY WITH PROPER INSTALLATION PROCEDURE.
- 3 ACOUSTICAL CEILING: SHALL BE AS INDICATED OR AS CALLED FOR 8 IN NOTES, INSTALLATION TO BE IN ACCORDANCE WITH MANUFACTURER RECOMMENDATIONS AND SPECIFICATIONS.
- 3 EXTERIOR SIGNAGE, IF INDICATED, TO COMPLY WITH ALL CITY REGULATION AND BUILDING DESIGN STANDARDS. ADVISE ARCHITECT OF ANY CONFLICTS. ALL SIGNAGE PROVIDED BY OWNER, U.N.O.
- 4 CONTRACTOR SHALL PROVIDE MASTER KEY LOCK BOX IN 0 ACCORDANCE TO CITY REGULATION FOR APPROVAL BY LOCAL FIRE DEPARTMENT.
- 4 CONTRACTOR TO PROVIDE SUITE NUMBERS AT EXTERIOR ENTRIES 1 AS REQUIRED BY CITY REGULATIONS AND APPROVED BY LOCAL FIRE DEPARTMENT AND LANDLORD. CONTRACTOR TO COORDINATE SIGNAGE TYPE AND LOCATION WITH ARCHITECT.
- 4 HVAC: REFERENCE MECH. DOCUMENTS FOR INFORMATION AND 2 LAYOUT. G.C. IS RESPONSIBLE FOR SCHEDULING AND PROVIDING A TEST AND BALANCE REPORT TO PANERA REPRESENTATIVE PRIOR TO TURNOVER. GC SHALL USE AN AABC OR NEBB INDEPENDENT THIRD PARTY AIR BALANCE COMPANY, THE REPORT SHALL BE AVAILABLE ON JOB SITE PRIOR TO FINAL INSPECTION.
- 4 PROVIDE MATERIAL & INSTALLATION ALLOWANCE FOR TWO (2) 3 CLASS C FIRE EXTINGUISHERS AS REQUIRED TO MEET LOCAL FIRE OFFICIALS REQUEST AND TO MEET NFPA. CONTRACTOR TO COORDINATE WITH FIRE MARSHALL TO DETERMINE EXACT QUANTITY & LOCATION OF ALL EXTINGUISHERS. ABC, RATING: 10 BC 15 LBS.
- 4 PLUMBING: FIXTURES LOCATED ON ARCHITECTURAL SHEETS FOR 4 GENERAL REFERENCE ONLY. REFER TO PLUMBING SHEETS FOR ROUGH-IN DETAILS.
- 4 FIRE PROTECTION: GENERAL CONTRACTOR IS RESPONSIBLE TO 5 PROVIDE, EXTEND, OR REVISE ALARM SYSTEMS AS REQUIRED TO COMPLY WITH APPLICABLE CODES. COORDINATE WORK WITH OWNER'S REPRESENTATIVES WHERE MODIFYING OR TYING INTO EXISTING SYSTEMS. GENERAL CONTRACTOR SHALL PREPARE REQUIRED DRAWINGS AND OBTAIN BUILDING PERMITS FOR ALARM
- 4 ALL ELECTRICAL RECEPTACLES TO BE MOUNTED AT MIN. 15" A.F.F. 6 U.N.O. TO CENTERLINE. ALL LIGHT SWITCHES AND THERMOSTATS TO BE MOUNTED AT 48" A.F.F. TO CENTERLINE.

SYSTEM WORK.

- 4 ELECTRICAL, DATA, AND COMMUNICATIONS OUTLETS ARE 7 PROVIDED FOR REFERENCE ONLY. REFERENCE ELEC. DOCUMENTS FOR ADDITIONAL ELECTRICAL INFORMATION ON SWITCHING, ADDITIONAL OUTLETS, EQUIPMENT ROOM REQUIREMENTS, ETC.
- 4 IF ANY DISCREPANCY EXISTS IN THE PLANS AND SPECIFICATIONS, 8 THE CONTRACTOR IS RESPONSIBLE FOR CLARIFYING WITH THE ARCHITECT. THE ARCHITECT, ONLY, SHALL INTERPRET THE PLANS AND SPECIFICATIONS. THE GENERAL CONTRACTOR SHALL RESOLVE FIELD CONDITIONS NOT SHOWN ON THE DRAWINGS WITH THE ARCHITECT.

Bakery-Cafe:

Project Team:

SYSTEM: G4 (ARIA)




LK ARCHITECTURE, INC. **345 RIVERVIEW** WICHITA, KS 67203 T 316.268.0230

F 316.268.0205

**Architecture** · **Engineering Planning · Interior Design Landscape Architecture** 

Professional Seal:

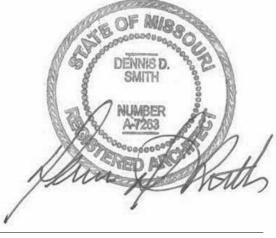

Project Title:

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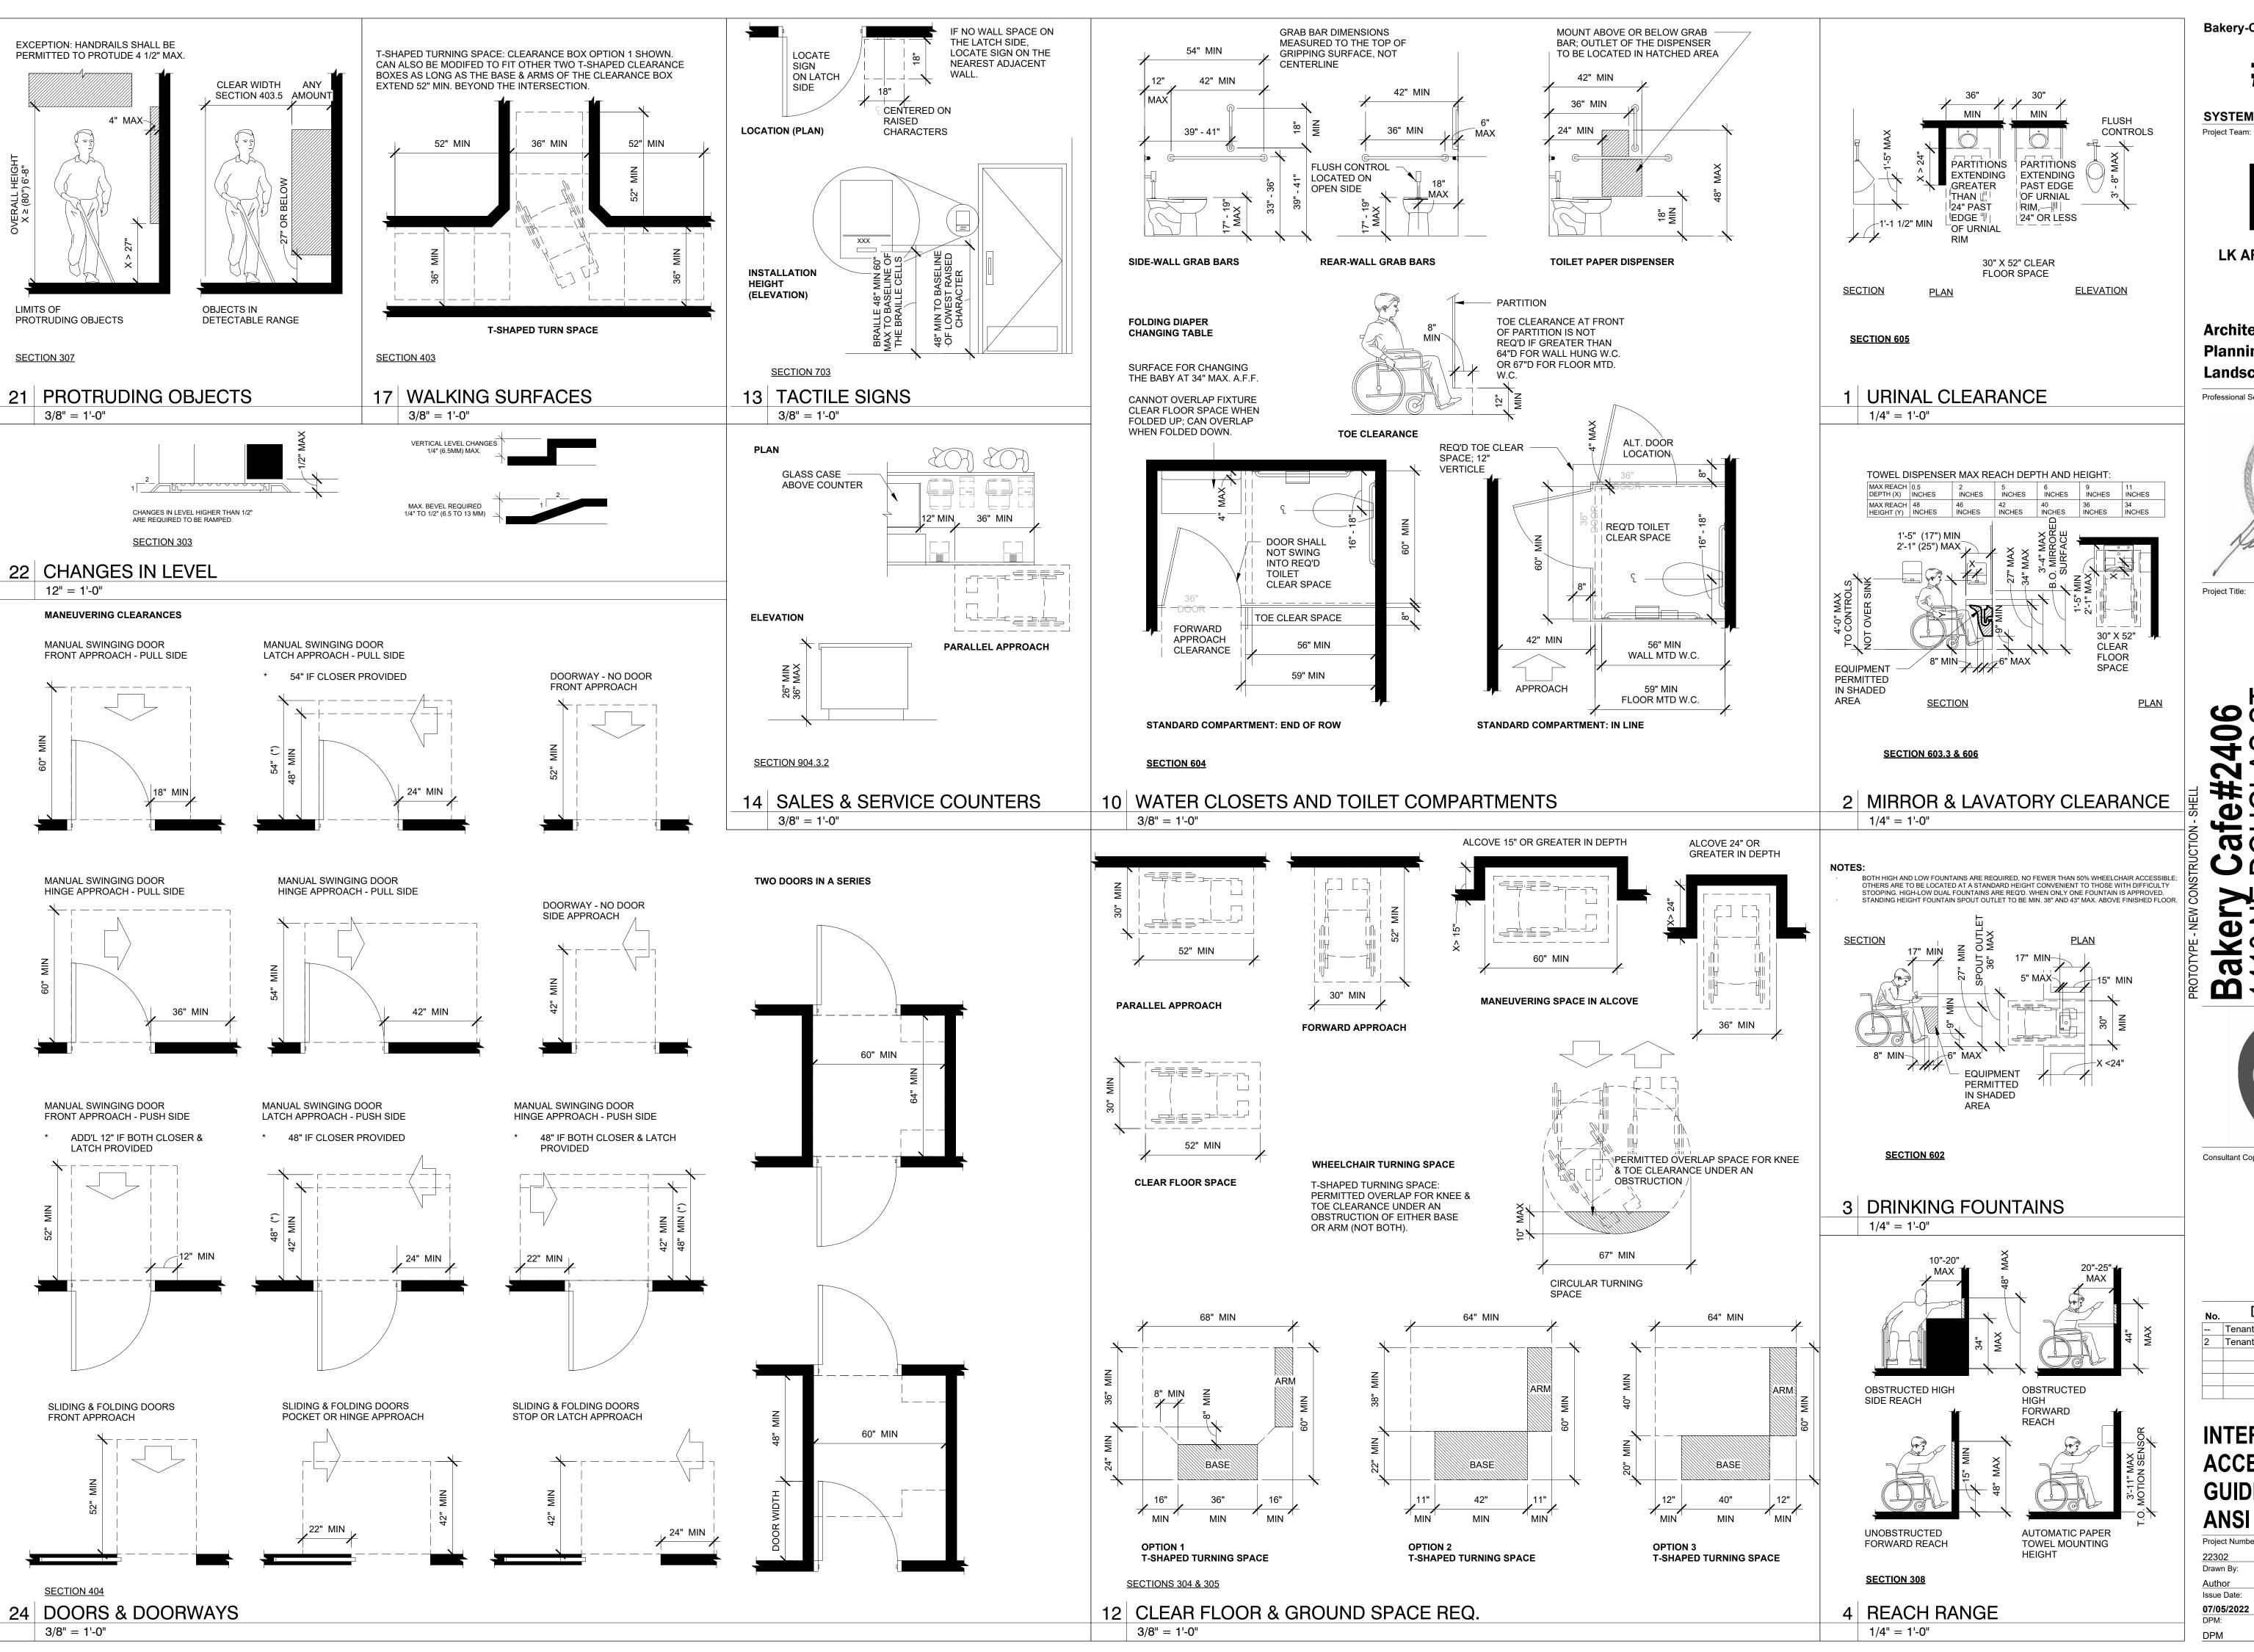
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Description Tenant - Permit Set 7/18/2022 Tenant - Construction Set 11/09/2022

**GENERAL NOTES,** SYMBOLS, LEGENDS

**& ABBREVIATIONS** Project Number: Issue Date 07/05/2022

DPM:



Bakery-Cafe:

SYSTEM: G4 (ARIA)




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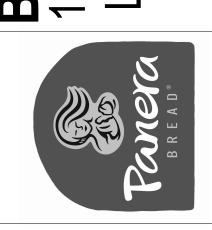
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Professional Seal:



Project Title:

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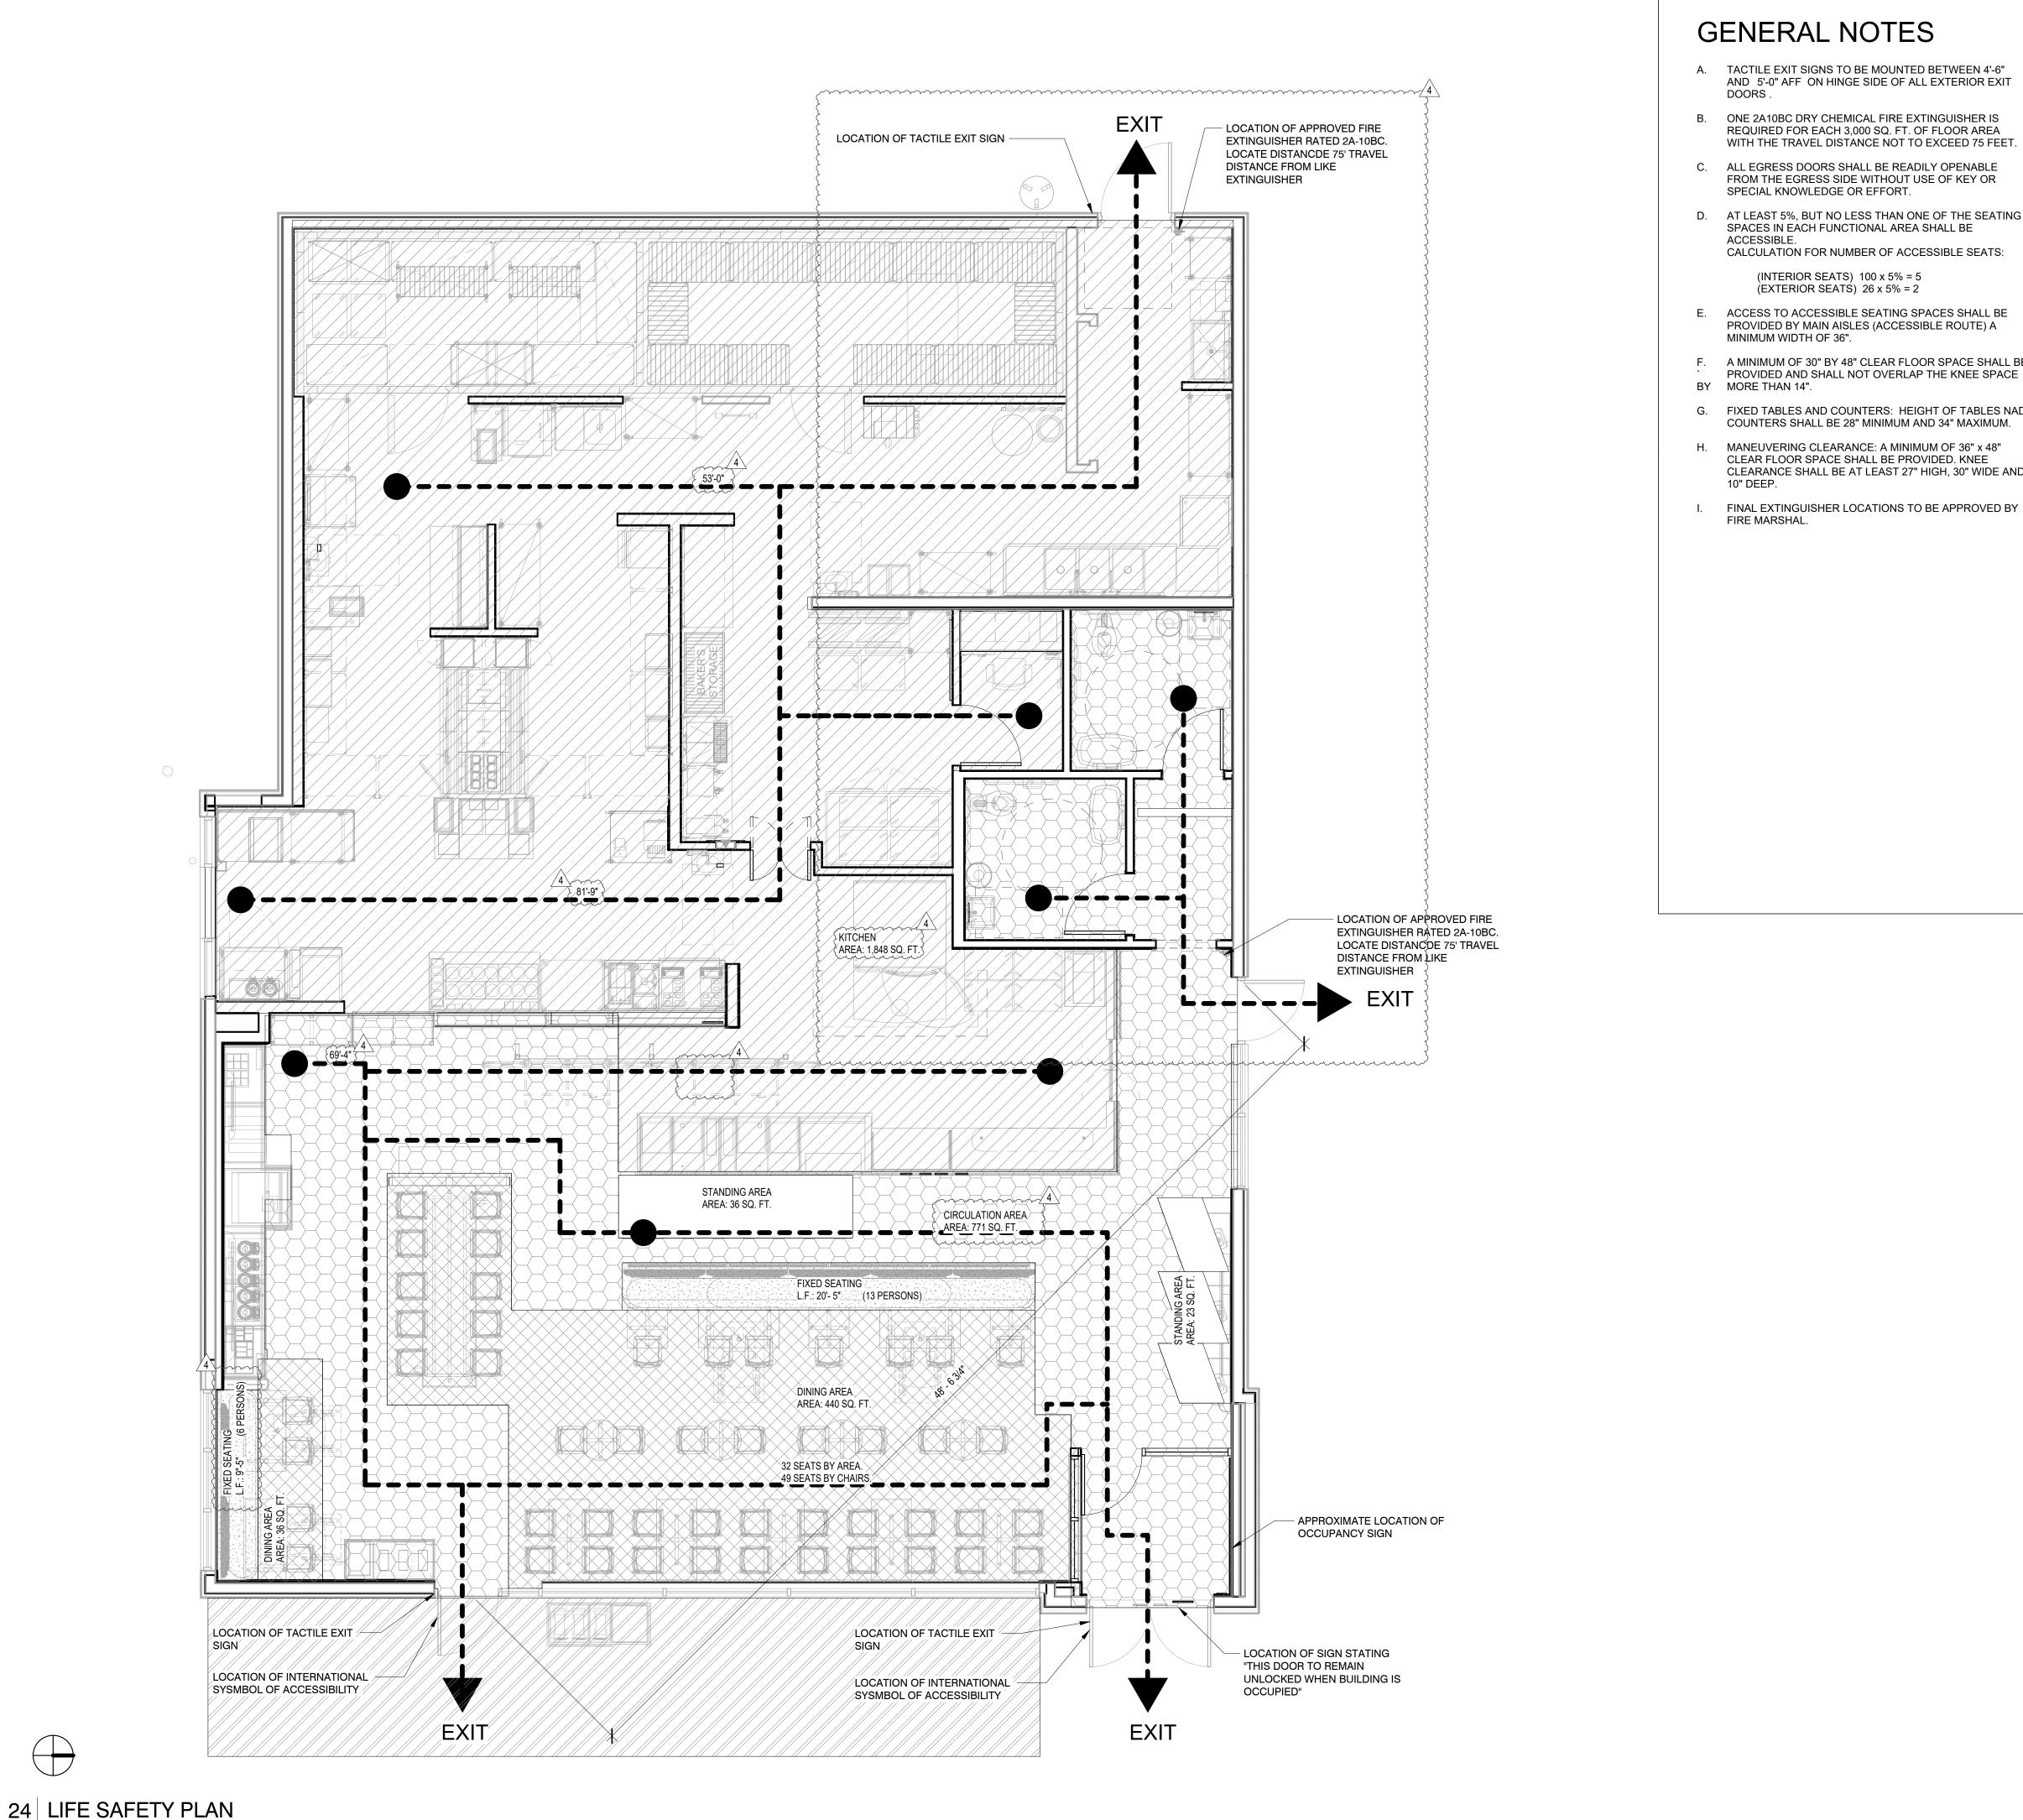

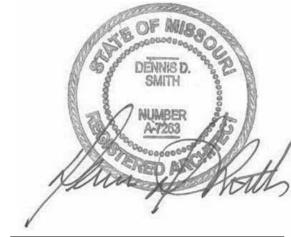
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Description 7/18/2022 Tenant - Permit Set 11/09/2022 Tenant - Construction Set

**INTERIOR ACCESSIBILITY GUIDELINES 2017 ANSI 117.1** 

Project Number: Drawn By: Issue Date 07/05/2022



1/4" = 1'-0"

- B. ONE 2A10BC DRY CHEMICAL FIRE EXTINGUISHER IS REQUIRED FOR EACH 3,000 SQ. FT. OF FLOOR AREA
- D. AT LEAST 5%, BUT NO LESS THAN ONE OF THE SEATING SPACES IN EACH FUNCTIONAL AREA SHALL BE

- E. ACCESS TO ACCESSIBLE SEATING SPACES SHALL BE
- F. A MINIMUM OF 30" BY 48" CLEAR FLOOR SPACE SHALL BE PROVIDED AND SHALL NOT OVERLAP THE KNEE SPACE
- G. FIXED TABLES AND COUNTERS: HEIGHT OF TABLES NAD
- H. MANEUVERING CLEARANCE: A MINIMUM OF 36" x 48" CLEAR FLOOR SPACE SHALL BE PROVIDED. KNEE
- FIRE MARSHAL.

GENERAL NOTES

- A. TACTILE EXIT SIGNS TO BE MOUNTED BETWEEN 4'-6" AND 5'-0" AFF ON HINGE SIDE OF ALL EXTERIOR EXIT
- WITH THE TRAVEL DISTANCE NOT TO EXCEED 75 FEET.
- C. ALL EGRESS DOORS SHALL BE READILY OPENABLE FROM THE EGRESS SIDE WITHOUT USE OF KEY OR SPECIAL KNOWLEDGE OR EFFORT.

CALCULATION FOR NUMBER OF ACCESSIBLE SEATS:

(INTERIOR SEATS)  $100 \times 5\% = 5$ (EXTERIOR SEATS)  $26 \times 5\% = 2$ 

PROVIDED BY MAIN AISLES (ACCESSIBLE ROUTE) A MINIMUM WIDTH OF 36".

- BY MORE THAN 14".
- COUNTERS SHALL BE 28" MINIMUM AND 34" MAXIMUM.
- CLEARANCE SHALL BE AT LEAST 27" HIGH, 30" WIDE AND

BUILDING CODE 2018 IBC PLUMBING CODE 2018 IPC ELECTRICAL CODE 2017 NATIONAL ELECTRICAL CODE MECHANICAL CODE 2018 INTERNATIONAL MECHANICAL CODE FIRE CODE 2018 INTERNATIONAL FIRE CODE 2009 AMERICANS WITH DISABILITIES ACT, ACCESSIBILITY CODE ICC/ ANSI A117.1 BUILDING INFORMATION CONSTRUCTION TYPE TYPE V - B

AREA: 59 SQ. FT.

APPLICABLE BUILDING CODES

LEGEND

SPRINKLERED

CIRCULATION DINING AREA & CAFE AREA: 771 SQ. FT. AREA: 475 SQ. FT. FIXED SEATING KITCHEN AREA AREA: 67 SQ. FT. AREA: 1,848 SQ. FT. STANDING ROOM

INTERIOR AREA (NET): 3,220 SQ. FT

PATIO AREA

AREA: 325 SQ.FT.

PATIO AREA: 325 SQ FT

BUILDING IS NON-SPRINKLERED

ALLOWABLE AREA PER 2018 IBC PRIMARY OCCUPANCY A-2 | ASSEMBLY MAXIMUM ALLOWABLE BUILDING | 6000 SF, ACTUAL 3,493 TRAVEL DISTANCE 150FT ALLOWED (PER 2018 IBC TABLE 1016.2) OCCUPANT LOAD

OCCUPANT LOAD COUNT TABLE PER 2018 IBC TABLE 1004.1.2

FUNCTION OF SPACE OCCUPANT AREA LOAD FACTOR (SQFT) OCCUPANTS DINING AREA UNCONCENTRATED 15 475 32 (49 SEATS) 771 CIRCULATION UNCONCENTRATED 0 KITCHEN: 1848 } 9 KITCHEN COMMERCIAL STANDING AREA STANDING AREA 59 12 FIXED SEATING TOTAL LINEAL LINEAL IN. PER OCC. PERSONS

20'-5"

TOTAL INTERIOR OCCUPANTS: SEAT COUNT 16 PATIO: TOTAL OCCUPANTS (INCLUDING PATIO):

EXIT REQUIRMENTS PER 2018 IBC SECTION 1015.2.1 LONGEST INTERIOR DIAGONAL DIMENSION 69'-8 1/8" MIN. DISTANCE BETWEEN DOORWAYS 69'-8 1/8" = 34'-4 1/8" } (SPRINKLED) ACTUAL DISTANCE BETWEEN CLOSEST DOORWAYS 48' - 6 3/4"

ALLOWABLE EGRESS WIDTH PER 2018 IBC SECTION 1005.3.2

LENGTH

OCCUPANTS FACTOR (IN.) INTERIOR 0.20 EXTERIOR PATIO SPACE W/OUT 0.20 SPRINKLER MINIMUM EGRESS OPENING WIDTH 22.2 REQUIRED MINIMUM DOOR SIZE (PER 1008.1.1) 32.00 [CLEAR OPENING] MAIN EXIT SECONDARY TOTAL (IN.) (IN.) (IN.)

ACTUAL EGRESS OPENING WIDTH PLUMBING CALCULATIONS

PER 2018 IPC BUILDING OCCUPANCY TOTAL MEN/WOMEN } WATER CLOSETS LAVATORIES BUILDING ASSEMBLY MALE FEMALE MALE FEMALE

OTHER 1:75 1:75 1:100 | 1:100 | 1 SER SINK REQUIRED PROVIDED 1 | 1 | 3 | 1 | 1

Description

Tenant - Construction Set

Tenant - Owner Revision

7/18/2022 11/09/2022

02/03/2023

Tenant - Permit Set

Drawn By: Issue Date: 07/05/2022 DPM:

Bakery-Cafe:

SYSTEM: G4 (ARIA) Project Team:




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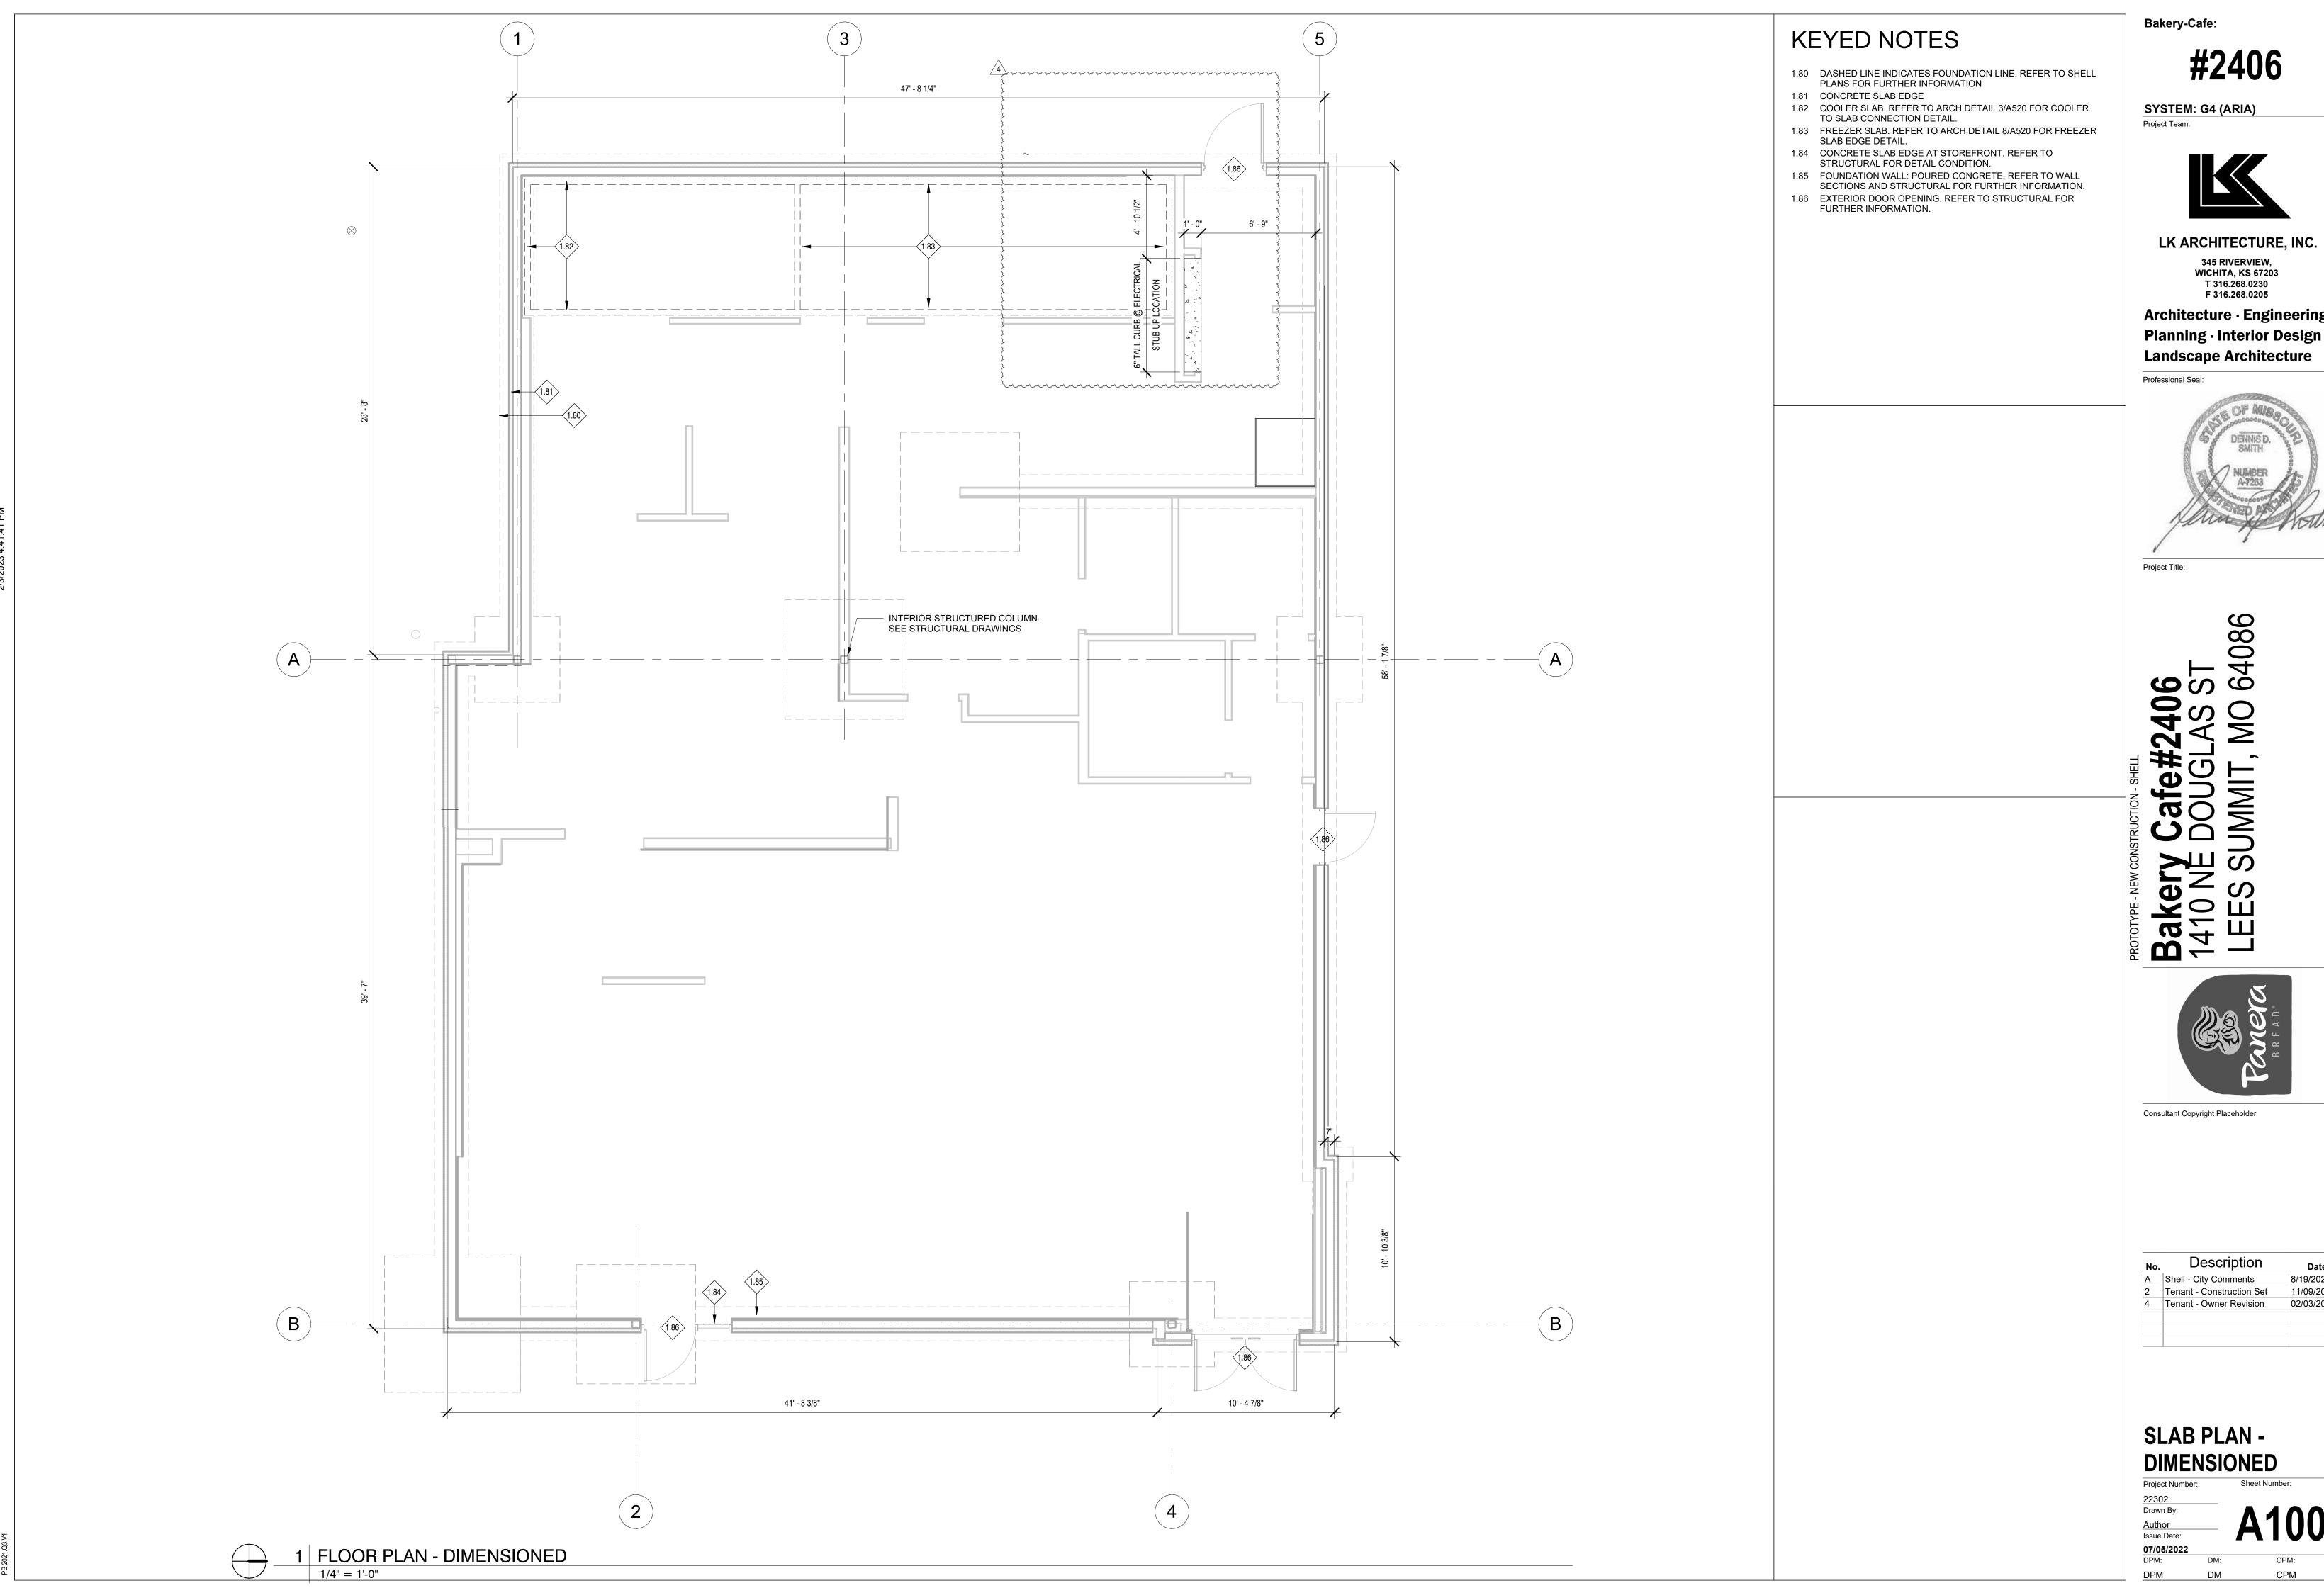
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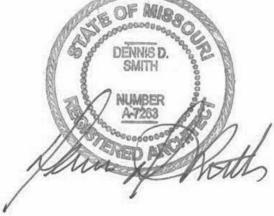


SYSTEM: G4 (ARIA)



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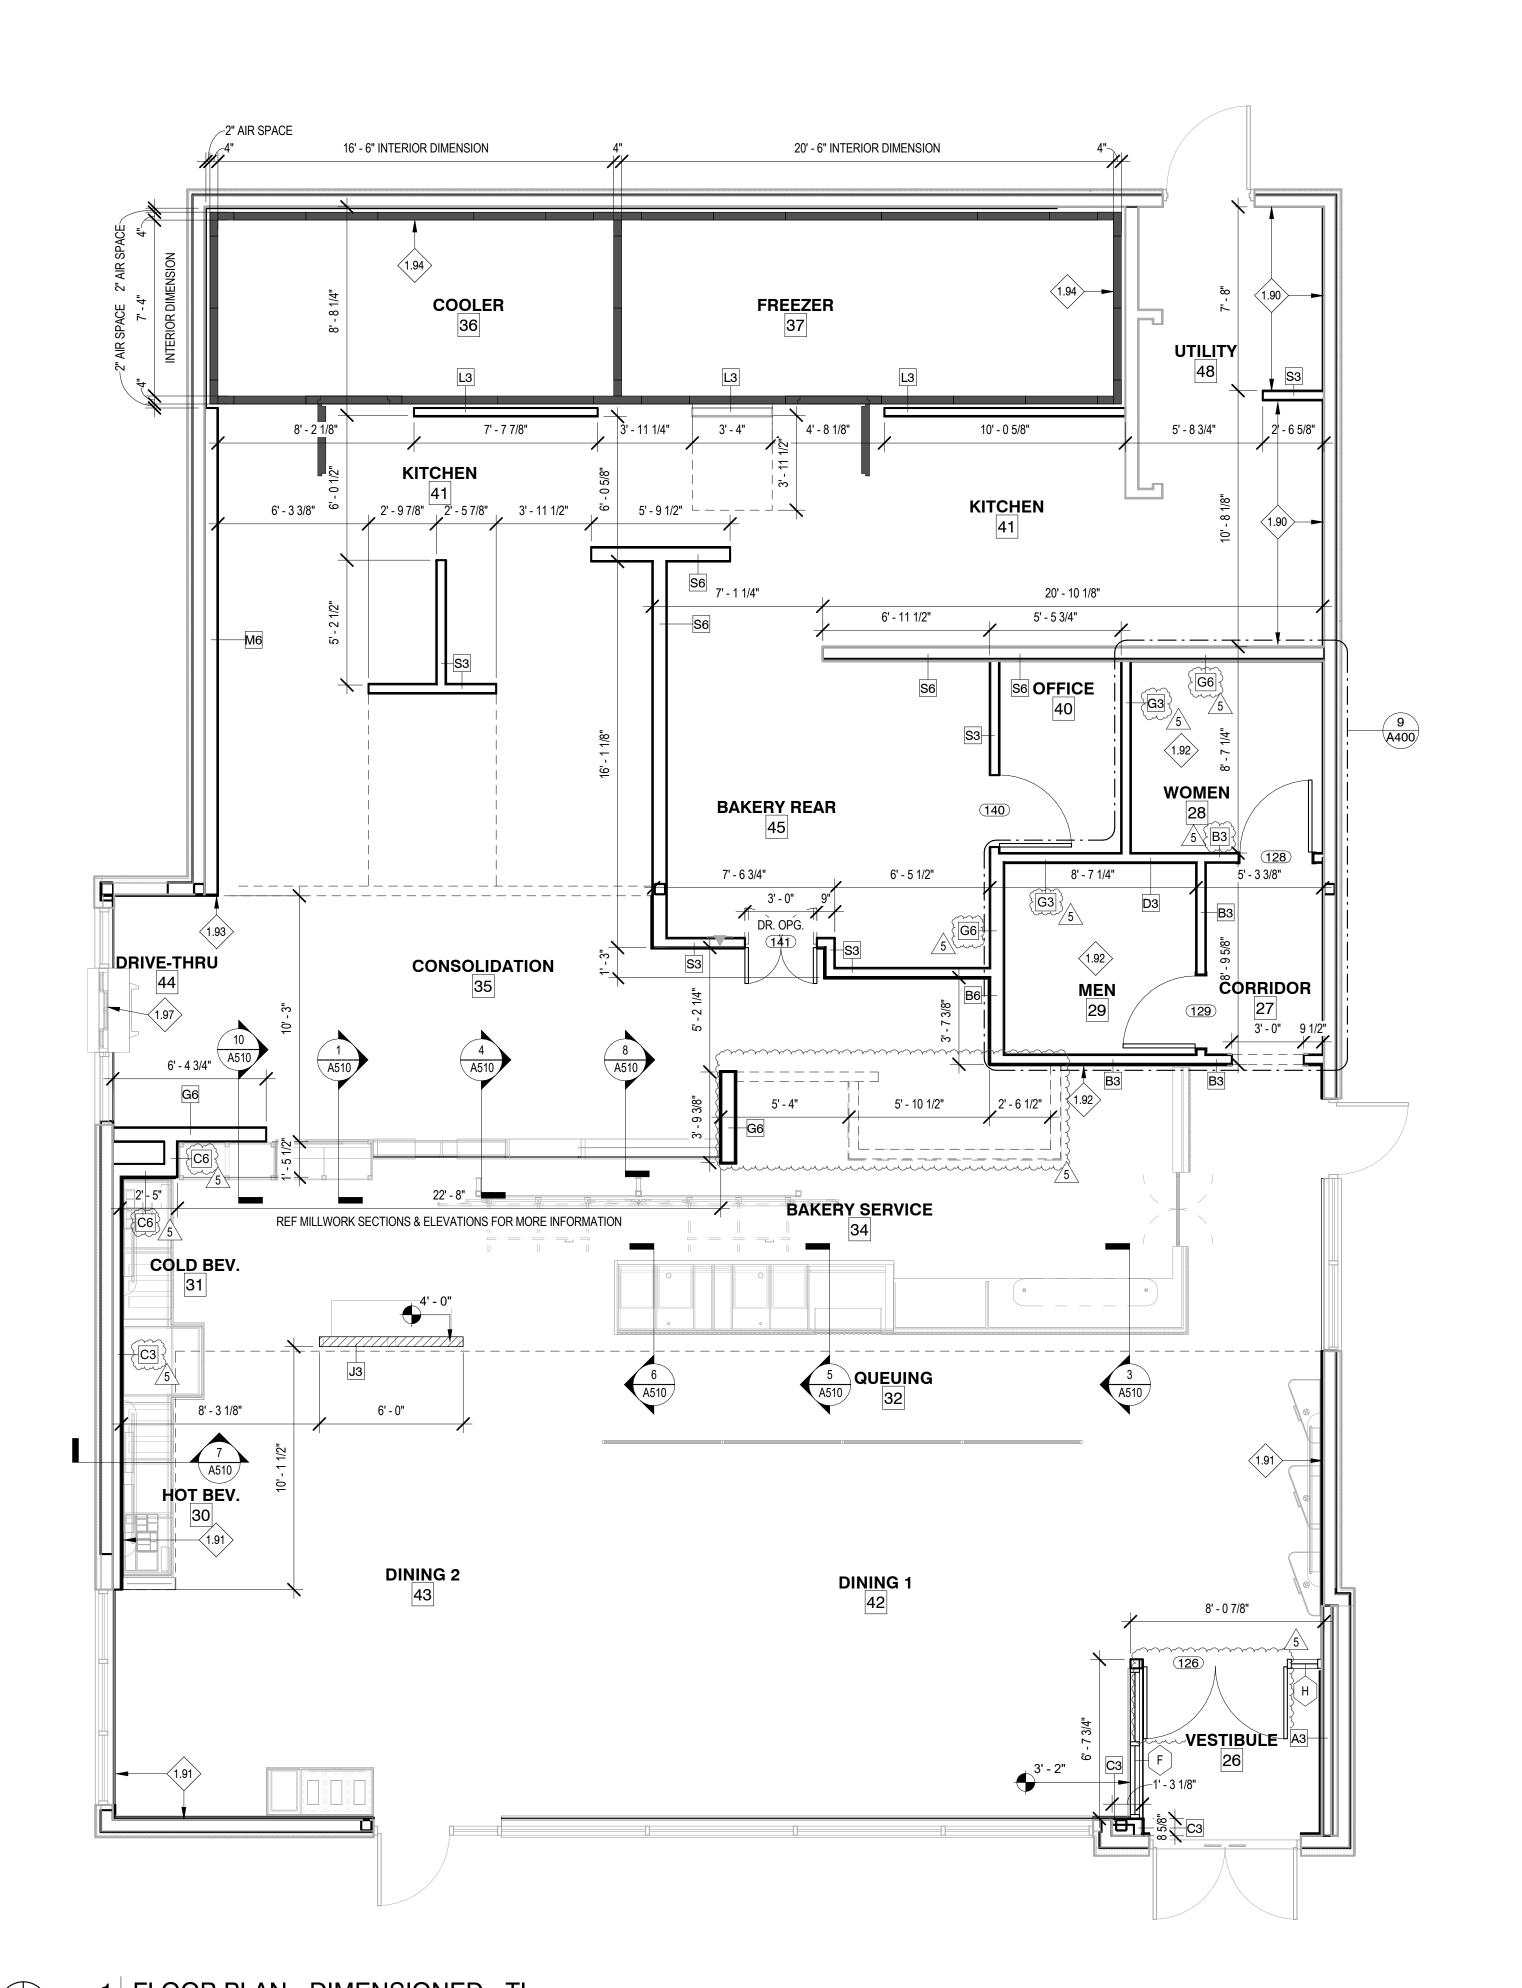
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No.	Description	Date
Α	Shell - City Comments	8/19/2022
2	Tenant - Construction Set	11/09/2022
4	Tenant - Owner Revision	02/03/2023

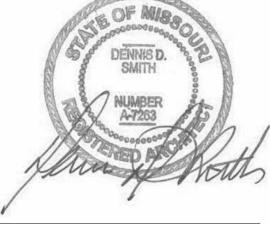**SLAB PLAN -DIMENSIONED** 



- A. PROVIDE 2" AIR SPACE AT SIDE(S) OF OVEN/PROOFER & COOLER/FREEZER (MIN. 3" AT BACK OF OVEN). VERIFY ALL DIMENSIONS & SPECS WITH EQUIPMENT MANUAL. NO FINISH ON WALLS BEHIND OVEN/PROOFER & COOLER/FREEZER (TAPE &
- PRIME ONLY).

  B. OFFICE AREA TO INCLUDE THE FOLLOWING (SUPPLIED AND INSTALLED BY G.C.): ROUGH-INS FOR PHONE, ALARM, SOUND, & MICROS SYSTEM. SEE ELECTRICAL SHEETS; 2'-0" x CUSTOM LENGTH PLASTIC LAMINATE ALMOND DESK TOP CLEATED TO WALL, W/ (2) 2" DIA. GROMMETS; (4) 16" DEEP PLASTIC LAMINATE WHITE SHELVES MOUNTED ON HEAVY-DUTY KV STANDARDS W/
- ADJUSTABLE BRACKETS.
  C. G.C. TO PROVIDE BLOCKING FOR SUPPORT OF RESTROOM ACCESSORIES AS RECOMMENDED BY MANUFACTURER. SEE INTERIOR ELEVATIONS.
- D. PROVIDE 5/8" CEMENT BACKING BOARD ON ALL KITCHEN,
  RESTROOM, & OFFICE WALLS FROM FLOOR TO 2'-0" A.F.F. AT
  WORKROOM WALLS WITH TILE FINISH, PROVIDE CEMENT BOARD
  TO 6'-0" A.F.F.
- E. PROVIDE 5/8" PLYWOOD BACKING BOARD ON KITCHEN & OFFICE WALLS (2'-0" AFF TO CEILING), SEE PARTITION SCHEDULE FOR WORKROOM WALLS W/ TILE FINISH.
- WORKROOM WALLS W/ TILE FINISH.

  F. OCCUPANCY LOAD SIGN SUPPLIED AND INSTALLED BY G.C.
  G. G.C. SHALL SUPPLY AND INSTALL RECESSED FIRE EXTINGUISHERS
- AS REQUIRED BY LOCAL CODES. LOCATION PER LOCAL CODES.

  H. REFERENCE THE FOLLOWING SHEETS: G012.1 GENERAL NOTES, SYMBOLS, AND LEGENDS AND G022.2 ACCESSIBILITY GUIDELINES.

  I. ALL DIMENSIONS NOTED ARE FROM FACE OF DRYWALL TO FACE
- BOOTH/BANQUETTE SEATING SUPPLIED BY FURNITURE SUPPLIER,
  INSTALLED BY G.C.
- INSTALLED BY G.C.
  K. ELECTRICAL EQUIPMENT BY G.C. SEE ELECTRICAL DRAWINGS.
- L. PLUMBING EQUIPMENT BY G.C. SEE PLUMBING DRAWINGS.M. G.C. TO PROVIDE & INSTALL 1/4" CLEAR SAFETY GLASS AT SNEEZE
- GUARDS. VERIFY SIZE OF GLASS W/ SNEEZE GUARD POSTS.

  N. LAP TILE AT OUTSIDE CORNERS, TURN CUT TILE EDGE TOWARD GROUT, ALL EXPOSED EDGES TO BE FACTORY FINISHED.

#### WALL LEGEND:

NEW PARTITION, REFER TO PARTITION TYPES ON SHEET
A121
PARTIAL HEIGHT PARTITION, HEIGHT VARIES. REFER TO

ELEVATIONS ON SHEETS A511 AND A512

COOLER/FREEZER WALL

\_\_ \_ \_ \_ SOFFIT ABOVE, REFER TO REFLECTED CEILING PLAN
\_\_ \_ \_ ON SHEET A301 FOR HEIGHT

#### **KEYED NOTES**

- 1.90 24" DUROCK AT TILE BASE WITH 5/8" PLYWOOD ABOVE AT BOH EXTERIOR WALLS.
- 1.91 5/8" GYP BOARD AT FOH EXTERIOR WALLS, U.N.O.
- 1.91 SEE INTERIOR ELEVATIONS FOR TILE HEIGHT WAINSCOT. PROVIDE
- 5/8" DUROCK AT TILE LOCATION WITH GYP BOARD ABOVE.
   1.93 CONSOLIDATION WALLS AND OR BULKHEADS TO ALIGN WITH EXTERIOR WALL.
- 1.94 PRE-FABRICATED FREEZER/COOLER WALL BY MANUFACTURER, INSTALLED BY TENANT.
- 1.97 DRIVE THRU WINDOW TO BE INSTALLED IN SURROUNDING STOREFRONT, REFER TO SHELL PLANS FOR FURTHER INFORMATION.

Bakery-Cafe:

#2406

SYSTEM: G4 (ARIA)
Project Team:




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Project Title:

**3akery Cafe#2406** 410 NE DOUGLAS ST LEES SUMMIT, MO 6408



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No.	Description	Date
1	Tenant - City Comments	9/22/2022
2	Tenant - Construction Set	11/09/2022
4	Tenant - Owner Revision	02/03/2023
5	Prototype Updates	05/29/2023

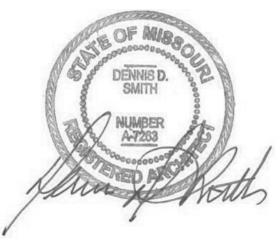
## FLOOR PLAN -DIMENSIONED

Project Number:

22302
Drawn By:
Author
Issue Date:

05/29/2023
DPM: DM: CPM:

1 FLOOR PLAN - DIMENSIONED - TI 1/4" = 1'-0"

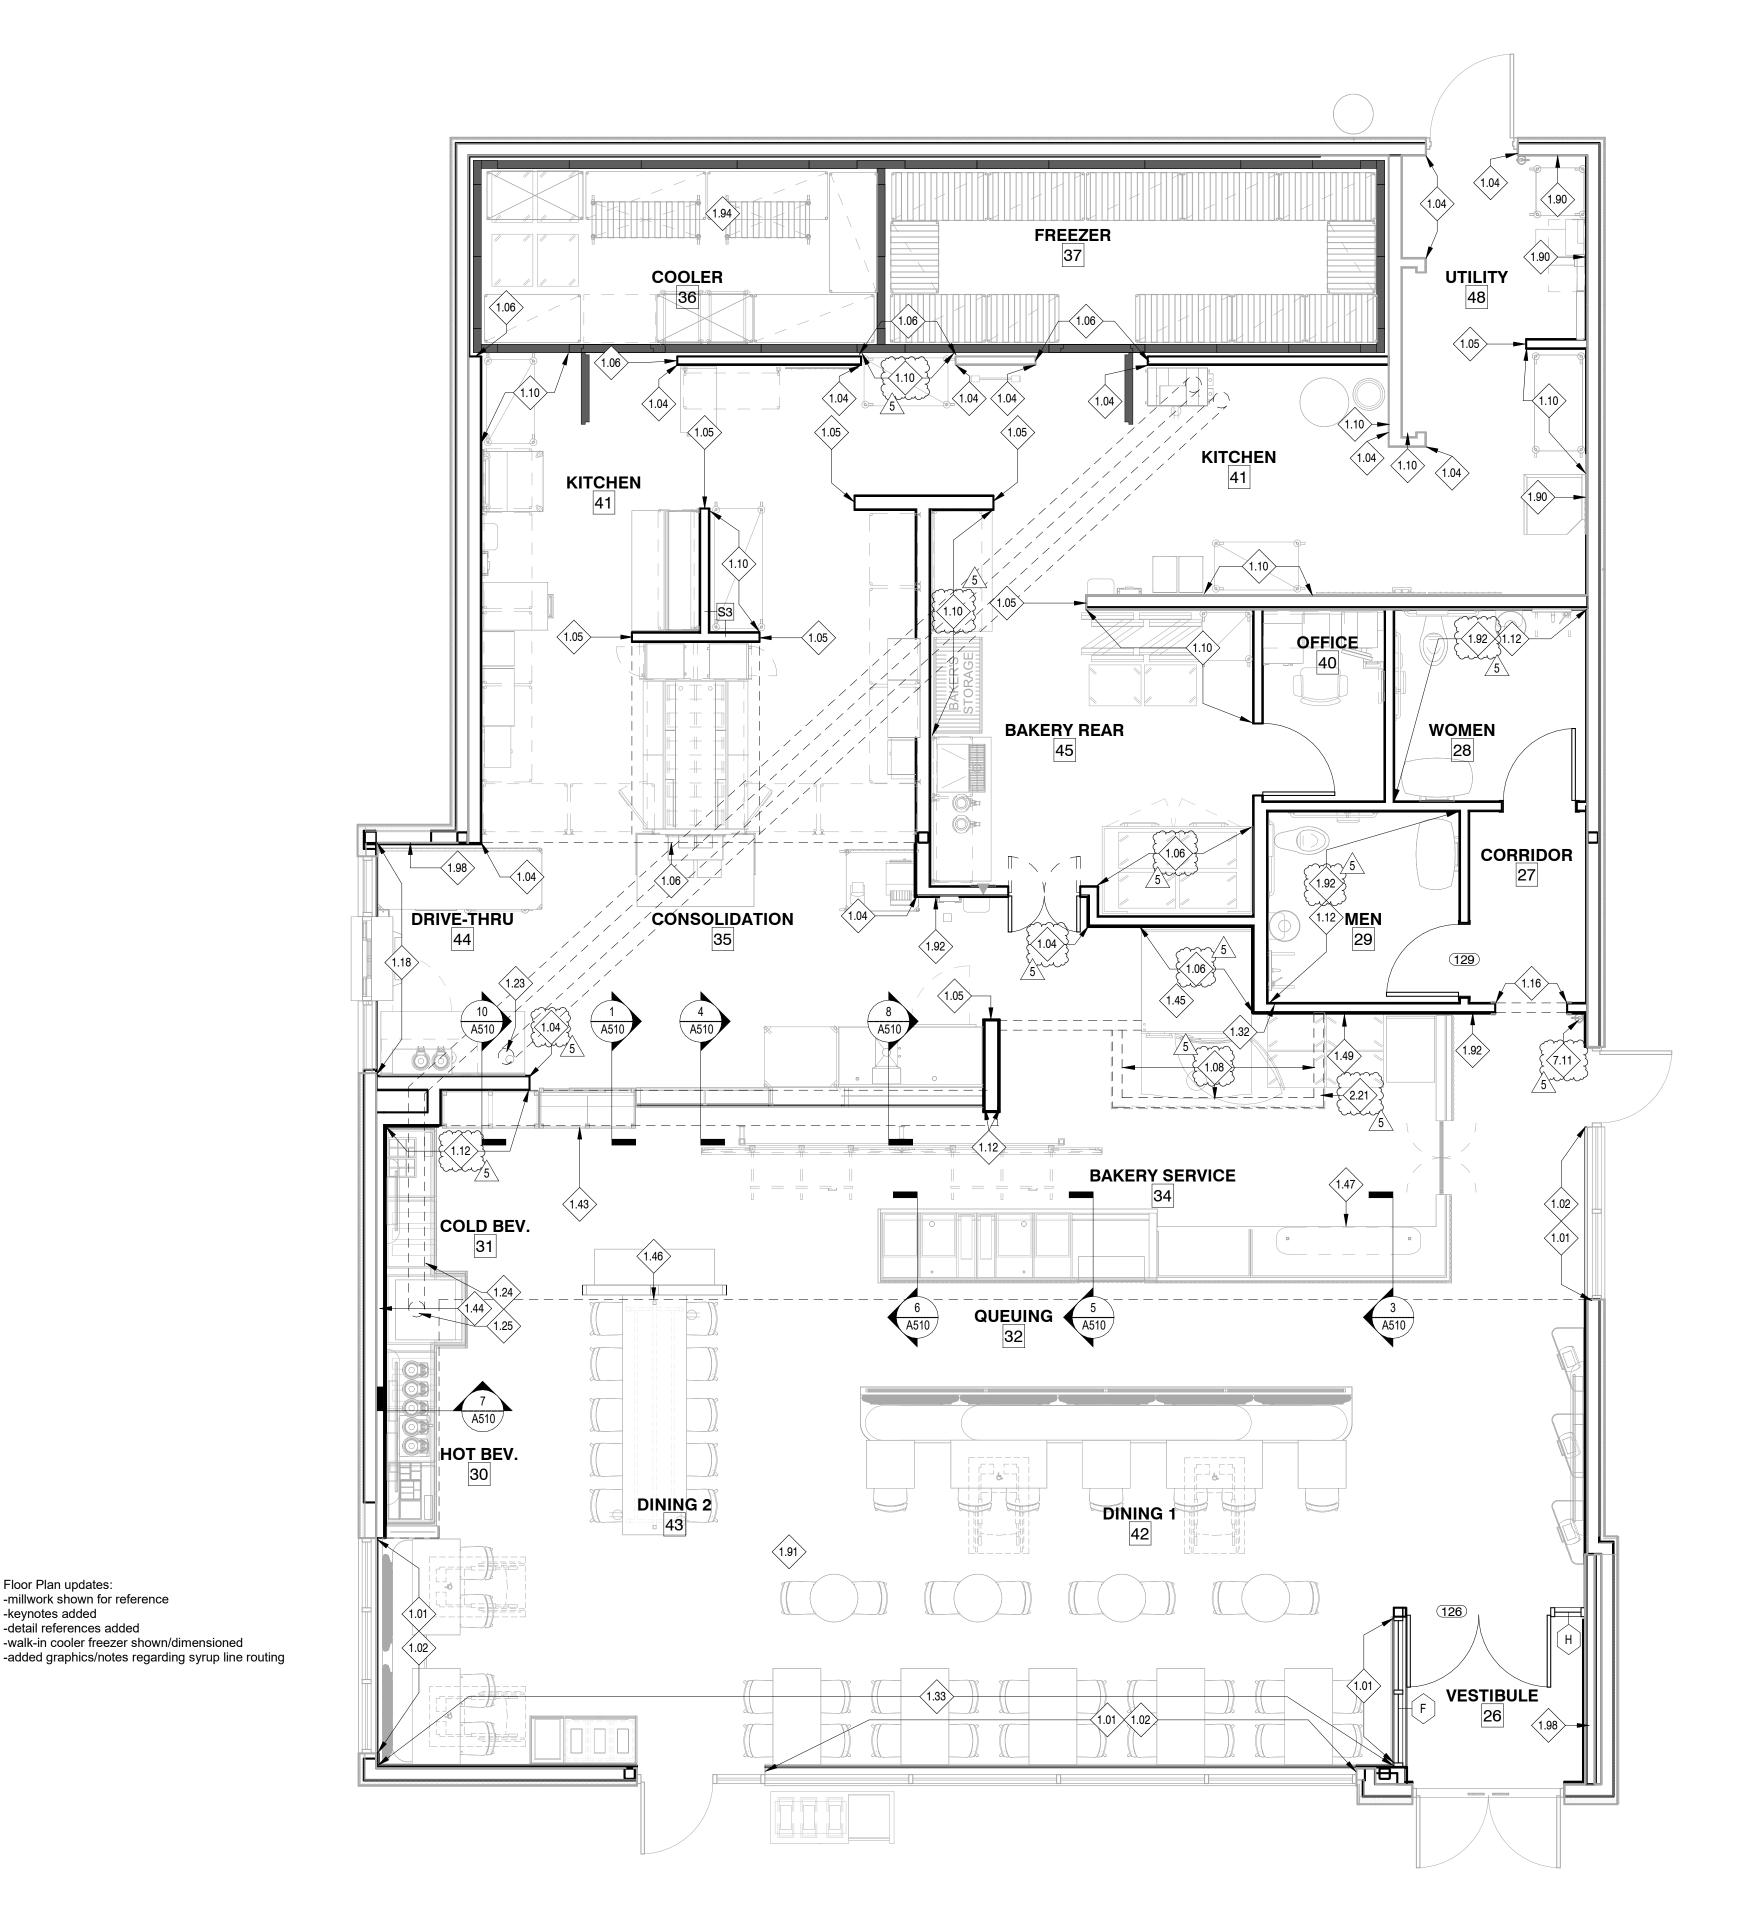

**KEYED NOTES** 

1.01 SOLID SURFACE SILL PROVIDED BY CASEWORK SUPPLIER, INSTALLED BY GC; COLOR: SS23. DIMENSIONS TO BE FIELD

1.02 ROLLER SHADES TO BE INSTALLED - FULL WIDTH OF WINDOW OPENINGS FROM CEILING TO CLOSEST HORIZONTAL MULLION OR 30"AFF (TABLE HEIGHT). SEE FINISH NOTES FOR SPECIFICATION. 1.04 STAINLESS STEEL CORNER GUARD (16 GA.- 1 1/2" RETURNS). INSTALL OVER TILE FROM FLOOR TO 8'-0" A.F.F. B.O.H, 7'-0" F.O.H. OR UNDERSIDE OF BULKHEAD/ ARCH. (SUPPLIED & INSTALLED BY

1.05 STAINLESS STEEL END CAP (16 GA.- 1 1/2" RETURNS). INSTALL OVER TILE FROM FLOOR TO 8'-0" A.F.F. B.O.H, 7'-0" F.O.H. OR UNDERSIDE OF BULKHEAD/ ARCH. (SUPPLIED & INSTALLED BY

1.06 STAINLESS STEEL CLOSURE PLATE (16GA.) FROM FLOOR TO CEILING OR BOTTOM OF BULKHEAD. SUPPLIED & INSTALLED BY

1.08 STAINLESS STEEL CLOSURE PLATE (16 GA.- 1" RETURNS). INSTALL OVER UNDERSIDE OF BULKHEAD. (SUPPLIED & INSTALLED BY

1.10 1" BOSTON-BUMPER GUARDS INSTALLED @ 30" & 60" IN BACK OF HOUSE, SEE INTERIOR ELEV. REFER TO MATERIAL & FINISH LEGEND FOR SPEC. 1.12 SCHLUTER JOLLY TILE TRIM; ANODIZED BRUSHED STAINLESS.

INSTALL ALONG TOP OF TILE/OUTSIDE CORNERS. 1.16 PROVIDE WOOD TRIM AT OPENING JAMBS AND UNDERSIDE OF BULKHEAD, WOOD TO MATCH WD30.

1.18 18 GA STAINLESS STEEL SILL PLATE ALONG STOREFRONT TO ALIGN WITH DRIVE THRU WINDOW SILL. 1.23 SYRUP LINE BUNDLE TO DROP THROUGH CEILING, SEE DETAIL

1.24 6" PVC SODA CONDUIT LINE BY GC TO RUN UNDER SLAB, FROM BAG-N-BOX TO SODA MACHINE WITH SWEEPS, SEE EQUIPMENT

AND PLUMBING DWGS. 1.25 ALIGN CONDUIT PLACEMENT WITH HOLE IN CASEWORK. COORDINATE WITH CASEWORK SHOP DRAWINGS.

1.32 INSTALL WD30A VERTICAL WOOD TRIM PIECE ALONG END OF WALL. REFER TO FINISH PLAN AND INTERIOR ELEVATIONS FOR FURTHER INFORMATION.

1.33 INSTALL WD30A CHAIR RAIL, SEE DETAIL 16/A500 FOR FURTHER INFORMATION AND INTERIOR ELEVATIONS FOR PLACEMENT. NOTE: AT BOOTHS THAT ARE PERPINDICULAR TO WALL WITH CHAIR RAIL, CHAIR RAIL TO BE CUT BETWEEN BOOTH BACKS SO BOOTH IS FLUSH TO WALL.

1.43 RPU TOE KICK TO ALIGN WITH ADJACENT WALL.

1.44 ALL ROUGH-INS BEHIND SODA TO BE CONCEALED IN WALL. 1.45 OVEN WITH HOOD TO BE INSTALLED PRIOR TO FRAMING OF BULKHEAD.

1.46 TABLE ELECTRIC TO RUN UP TABLE LEG. SEE DETAIL SHEETS.

1.47 MIRROR TO ALIGN WITH BACK OF BAKERY CASE. 1.49 GC TO PROVIDE BUMPER GUARDS AT MILLWORK AND WALL. SEE

SPECIFICATION AND FINISH SCHEDULE. 1.90 24" DUROCK AT TILE BASE WITH 5/8" PLYWOOD ABOVE AT BOH

EXTERIOR WALLS.

1.91 5/8" GYP BOARD AT FOH EXTERIOR WALLS, U.N.O. 1.92 SEE INTERIOR ELEVATIONS FOR TILE HEIGHT WAINSCOT. PROVIDE 5/8" DUROCK AT TILE LOCATION WITH GYP BOARD ABOVE.

1.94 PRE-FABRICATED FREEZER/COOLER WALL BY MANUFACTURER, INSTALLED BY TENANT. 1.98 PROVIDE ACCESS PANEL FOR HOSE BIBB PLUMBING, REFER TO PLUMBING DRAWINGS.

2.21 CASEWORK SHROUD AT OVEN HOOD, BY MILLWORK VENDOR OVER BULKHEAD BY GC. INSTALL OVEN BEFORE INSTALLATION OF BULKHEAD. GC TO PROVIDE SS CLOSURE PLATE AT BOTTOM OF BULKHEAD.

7.11 LOCATION OF APPROVED FIRE EXTINGUISHER RATED 2A-10BC. LOCATE WITHIN 30' TRAVEL DISTANCE FROM LIKE EXTINGUISHER. Bakery-Cafe:

#2406

SYSTEM: G4 (ARIA)




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1	Tenant - City Comments	9/22/2022
2	Tenant - Construction Set	11/09/2022
4	Tenant - Owner Revision	02/03/2023
5	Prototype Updates	05/29/2023

## FLOOR PLAN -**KEYED NOTES**

Project Number: 22302 Drawn By: Author Issue Date: 05/29/2023

1/4" = 1'-0"

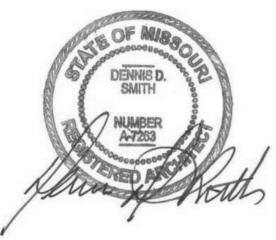24 FLOOR PLAN - KEY NOTED - TI


Floor Plan updates:

-keynotes added

-millwork shown for reference

-walk-in cooler freezer shown/dimensioned

-detail references added

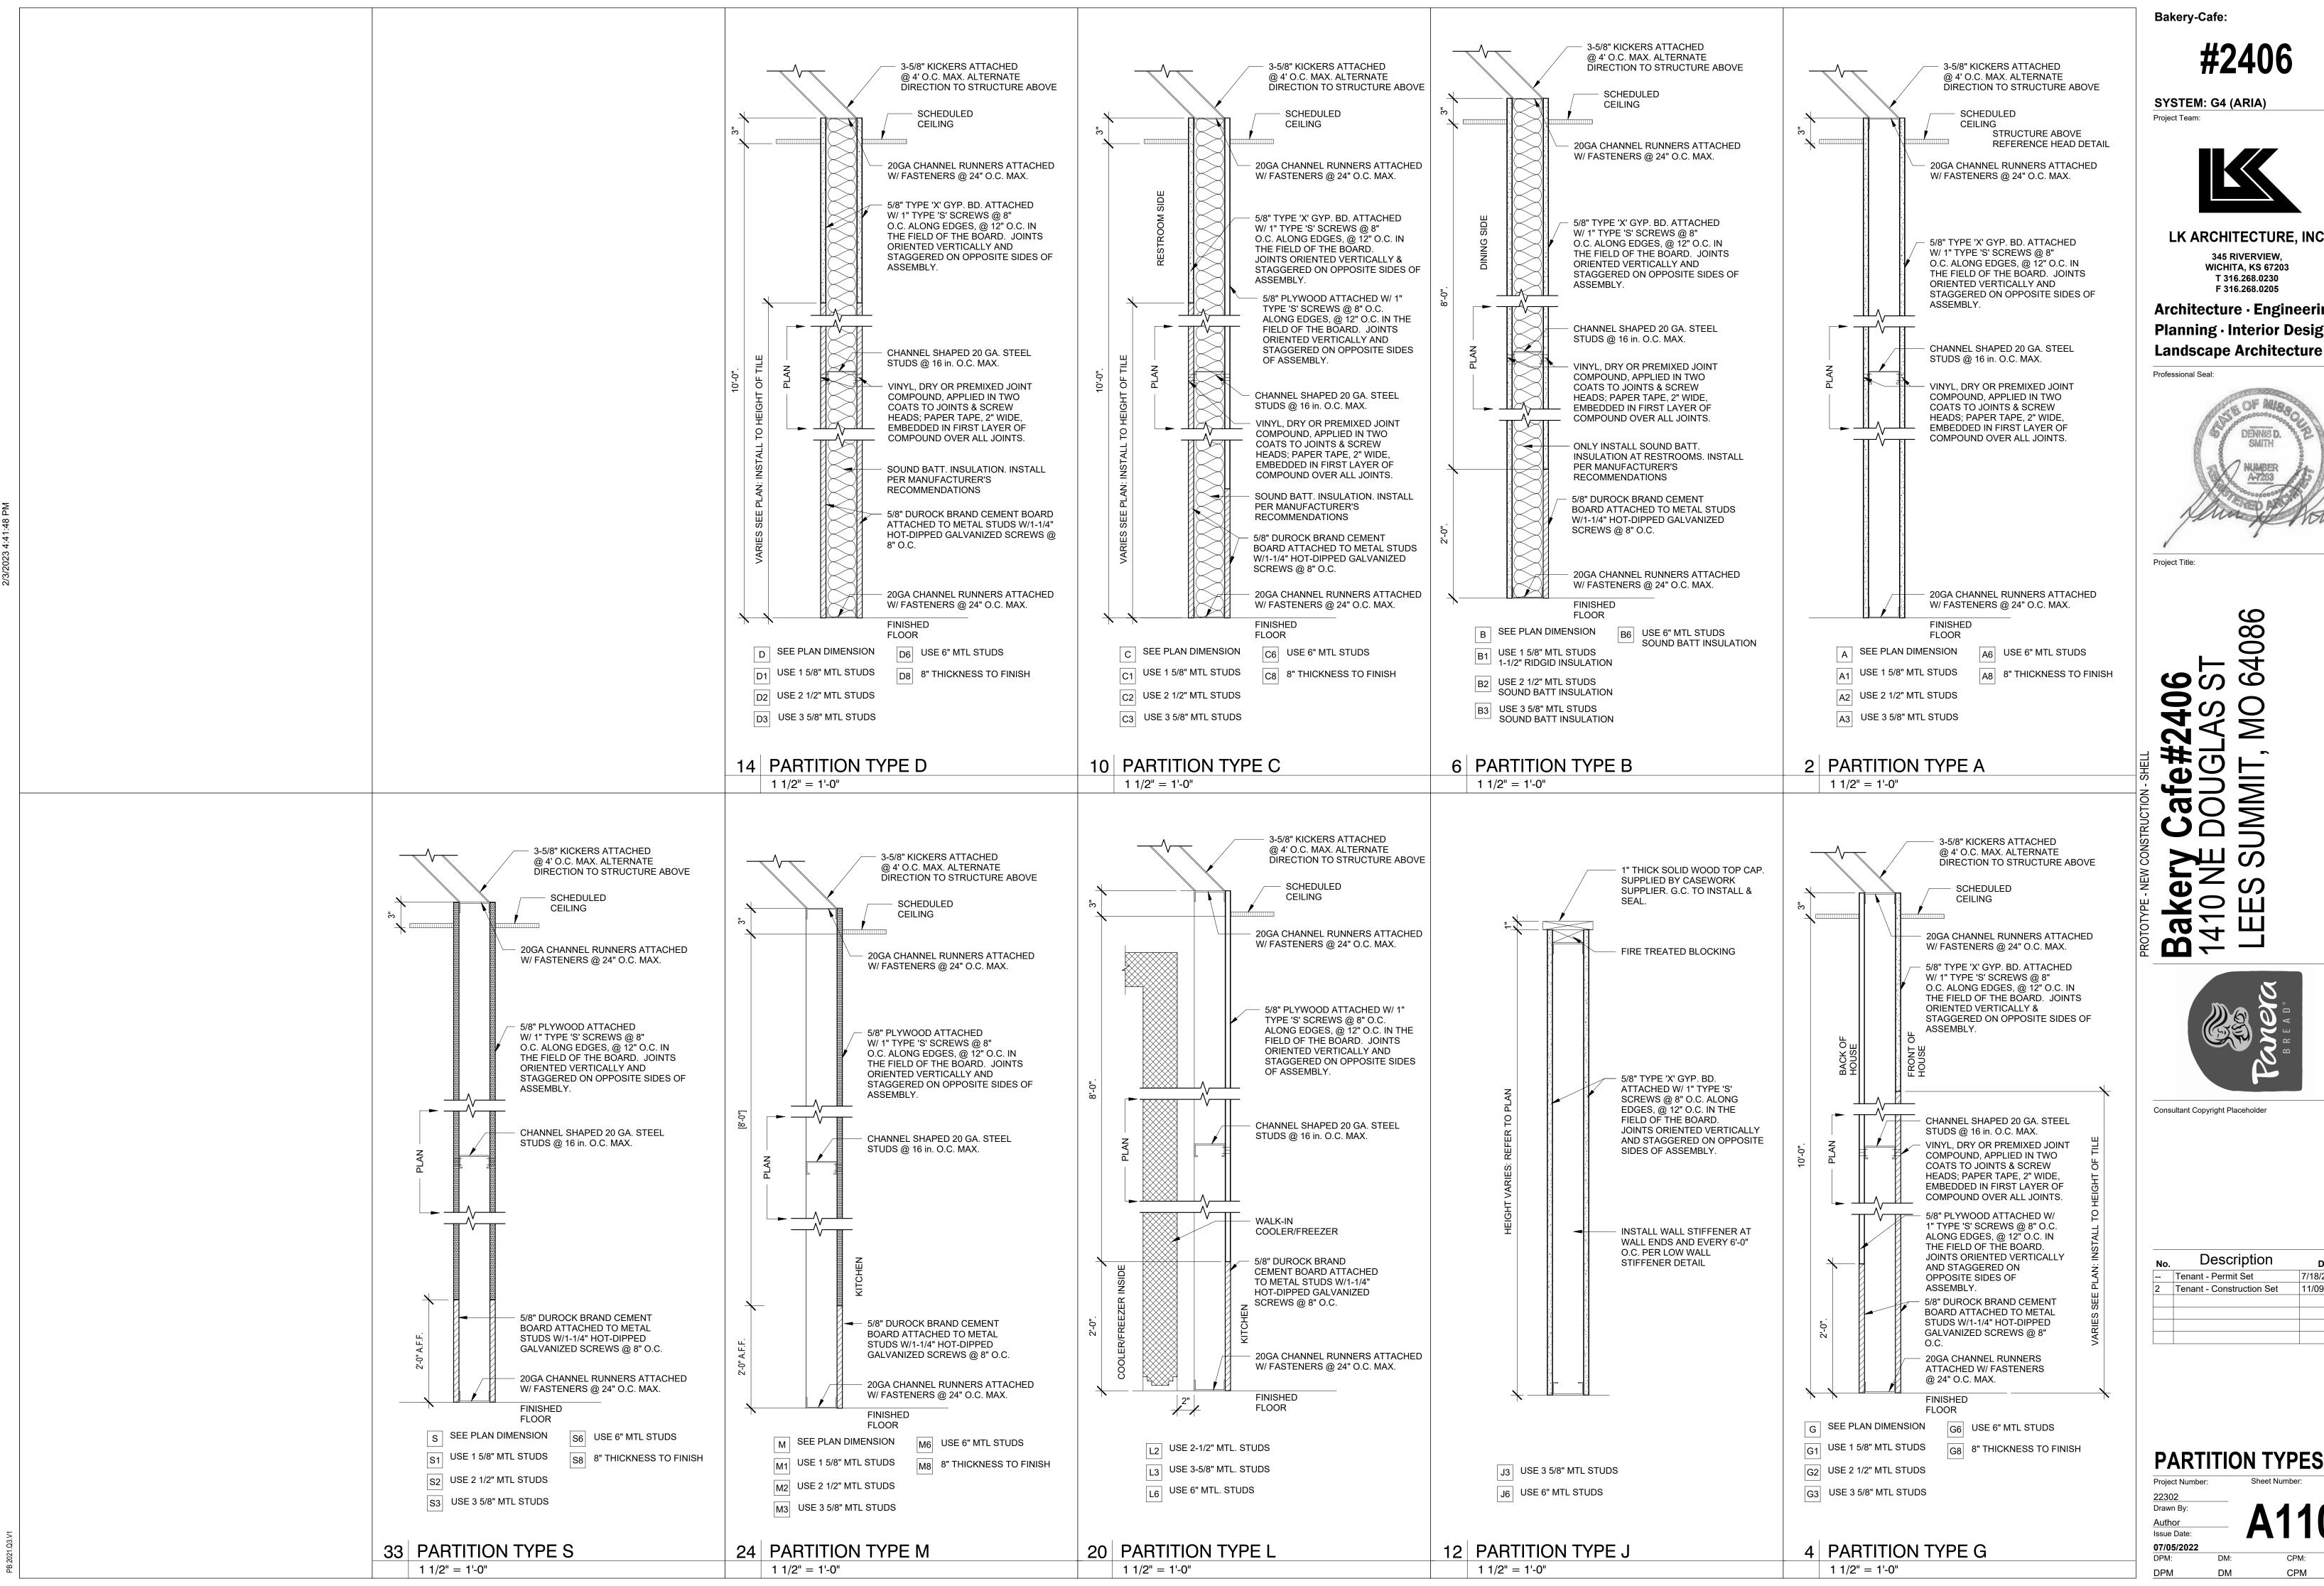


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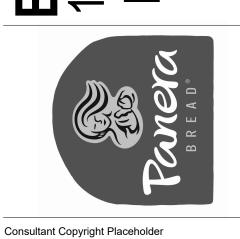


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No.	Description	Date
	Tenant - Permit Set	7/18/2022
2	Tenant - Construction Set	11/09/2022

**PARTITION TYPES** 

- A. IF THERE IS A CONFLICT BETWEEN THE WALL FINISH PLAN AND INTERIOR ELEVATIONS, PLEASE NOTIFY THE CONSTRUCTION PROJECT MANAGER FOR CLARIFICATION.

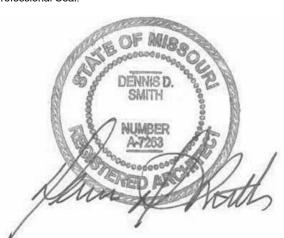   B. REFER TO INTERIOR ELEVATIONS FOR ADDITIONAL WALL FINISH
- INFORMATION. REFER TO THE FLOORING DETAILS & SPECIFCIATION MANUAL FOR TILE DETAILS & CONCRETE EXPANSION/CONTROL JOINTS.

# #2406

SYSTEM: G4 (ARIA)

Bakery-Cafe:




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**WALL FINISH PLAN** 

Drawn By: **05/29/2023** DPM:

24 WALL FINISH PLAN 1/4" = 1'-0"

KEYED NOTES

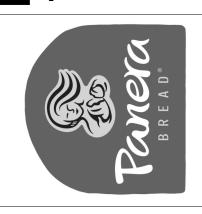2.21 CASEWORK SHROUD AT OVEN HOOD, BY MILLWORK VENDOR OVER BULKHEAD BY GC. INSTALL OVEN BEFORE INSTALLATION OF BULKHEAD. GC TO PROVIDE SS CLOSURE PLATE AT BOTTOM OF BULKHEAD.

**HOT BEV.** 30

24' - 8" SS-23 - SILL TOP

- NEW FLOOR TILES ARE TO BE INSTALLED AS INDICATED ON PLAN WITH FULL TILES WHEREVER POSSIBLE. SEE FINISH SCHEDULE FOR SPECIFICATIONS.
- ALL FLOOR FINISHES SHALL BE INSTALLED WITH TOP EDGES LEVEL W/
  ADJACENT MATERIAL TOP EDGES. CONFIRM TILE THICKNESS AS THESE

  Project Team: MAY VARY. CONFIRM THAT NO OVERALL FLOATING OF FLOOR IS
- COORDINATE FLOORING TRANSITIONS & BASE TILE INSTALLATION W/ MILLWORK SHOP DRAWINGS & FIELD CONDITIONS.
- ALL THRESHOLDS SHALL HAVE A MAX HEIGHT OF 1/2" ABOVE EXISTING CONCRETE SLAB &/OR INTERIOR FINISHES. SEE FINISH SCHEDULE ON SHEET A600 FOR SPECS OF ALL FLOOR
- COVERINGS.

#### TILE TRANSITION BETWEEN ROOMS TO BE CENTERED ON DOOR FRAME SEE PLUMBING DRAWINGS FOR DIMENSIONS & LOCATIONS OF FLOOR DRAINS & FLOOR SINKS.

#### Bakery-Cafe:

SYSTEM: G4 (ARIA)




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5.08 PROVIDE SCHLUTER COVE TILE BASE AT ALL TILE LOCATIONS UNLESS NOTED OTHERWISE. REFER TO 7/A520 FOR FURTHER INFORMATION.

- SHEET A603. 5.10 FLOOR TILE TO BE INSTALLED IN STACKED PLANK PATTERN W/ FULL
- 5.13 NO TILE AT MOP SINK. SEE EQUIPMENT AND PLUMBING SHEETS FOR
- 5.23 ELECTRICAL PANELS. REFERENCE ELECTRICAL DRAWINGS FOR MORE

# KEYED NOTES

- 5.01 LINE OF TOE KICK/TILE TRANSITION AT CABINET TO BE SET DIRECTLY ON CONCRETE SUBFLOOR. 6X12 TILE BASE TO BE INSTALLED ON CUSTOMER SIDE OF CABINET. COORDINATE LOCATION W/ MILLWORK SHOP DRAWINGS & EQUIPMENT CUT SHEETS.
- 5.02 CARPET W/ SCHLUTER-SCHIENE SATIN ALUMINUM TRANSITION STRIP @ ALL TILE-CARPET. INSTALL CARPET FLUSH W/ TILE USE JOHNSONITE TILE-TO-CARPET TRANSITION TO LEVEL CARPET.
- 5.06 FLOAT 1/2" MARINITE STRUCTURAL, INCOMBUSTIBLE INSULATION UNDER RACK OVEN. INSET SHEETS 2" INSIDE OVEN FRAME, LEAVE 1/8" CLEARANCE AT EDGE OF TILE, SEAL GAP WITH HIGH TEMPERATURE CAULK. SEE SHEET A600 FOR VENDOR CONTACT
- 5.07 START FLOOR TILE PATTERN THIS LOCATION
- 5.09 DOOR THRESHOLD MAX. 1/2" ABOVE EXTERIOR CONCRETE SLAB. SEE
- TILES AS SHOWN, REFER TO A121 FOR MORE INFORMATION.
- FURTHER INFORMATION.

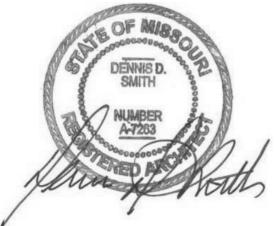**Bake** 1410




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FLOOR FINISH PLAN

Drawn By: **05/29/2023** DPM:

24 FLOOR FINISH PLAN



- A. G.C. SHALL CONFIRM ALL CEILING HEIGHTS. NOTIFY OWNER/ARCHITECT IF SPECIFIED HEIGHTS CANNOT BE ACHIEVED.
- B. SEE ELECTRICAL DRAWINGS FOR POWER & CIRCUIT.
  C. ALL FIXTURES TO BE CENTERED IN 2X2 CEILING TILE (U.N.O.).
  D. ALL FIXTURES TO BE PROVIDED BY, RECEIVED, STORED & INSTALLED
- BY ELECTRICAL CONTRACTOR.

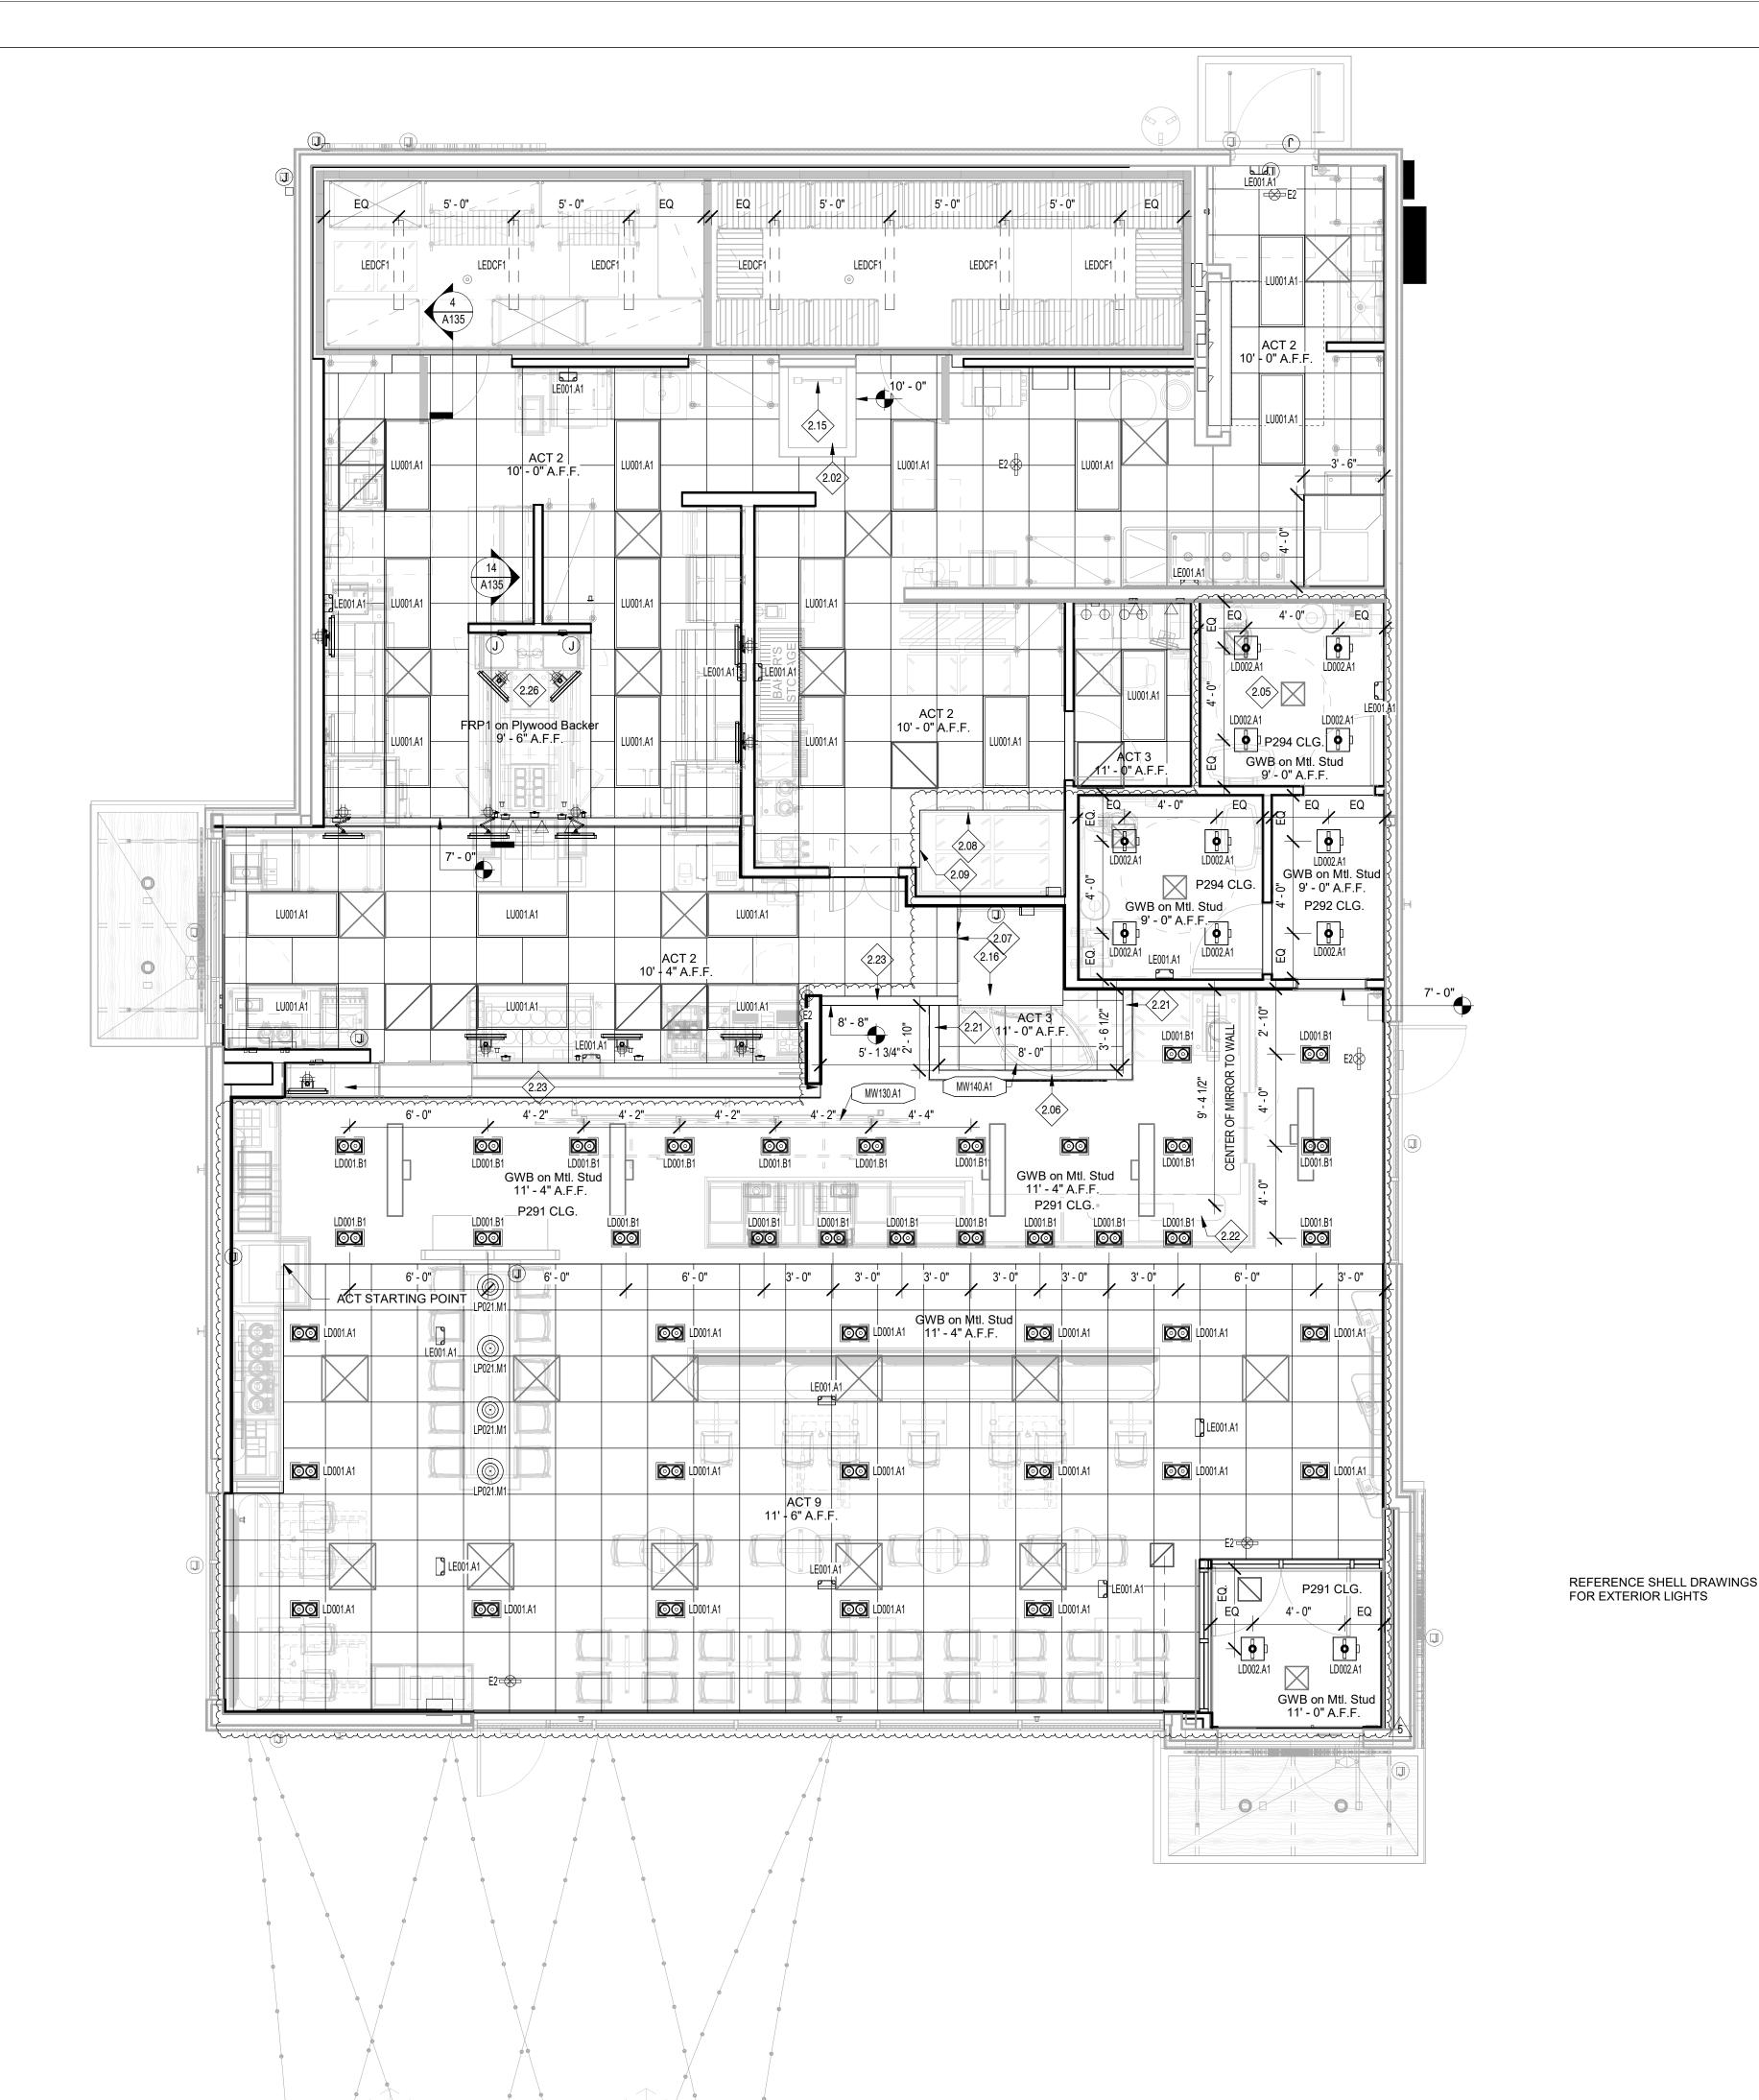  E. (6) WEEK LEAD TIME ON THE ACOUSTICAL CEILING TILES & CEILING
- (6) WEEK LEAD TIME ON THE ACOUSTICAL CEILING TILES & CEILING GRID.

  F. ALL FIXTURES TO BE OBTAINED THROUGH NATIONAL ACCOUNT FROM
- APPROVED PANERA, LLC VENDOR.
  G. SEE FINISH SCHEDULE FOR ACOUSTICAL CEILING TILE SPECIFICATIONS (ACT).
- H. ELECTRICAL CONTRACTOR SHALL SUPPLY 10% ADDITIONAL SPARE, OF ALL LAMP TYPES. TO BE LEFT AT JOB SITE AT END OF JOB.

  MECHANICAL SYSTEM DIFFUSERS NOT SHOWN THIS SHEET & SHALL BE COORDINATED BY G.C PRIOR TO CONSTRUCTION. SEE
- MECHANICAL SHEETS FOR LOCATIONS.

  J. G.C. TO SUPPLY (1) UNOPENED CASE OF EACH TYPE OF CEILING TILE
- USED.
  WHERE APPLICABLE, PENDANTS SHALL BE CENTERED OVER TABLES.
- WHERE APPLICABLE, PANERA VENDOR TO EXTEND SPEAKER SYSTEM INTO EXPANSION AREA; CONNECT INTO EXISTING SYSTEM.
   G.C. TO PLACE BOTTOM OF TRACK AT TRACK LIGHTING AT 11'-0" A.F.F.

#### TYPICAL AT EXPOSED CEILING TO DECK.

#### KEYED NOTES

- 2.02 ARCHITECTURAL BULKHEAD/SOFFIT SEE INTERIOR ELEVATIONS AND DETAILS FOR ADDITIONAL INFORMATION. REFLECTED CEILING PLAN
   2.05 PROVIDE SUSPENDED GYP BD CEILING, MFR: USG OR SIMILAR.
- 2.06 U-SHAPED EXHAUST SHROUD, FROM TOP OF EQUIPMENT, AS PART OF OVEN EQUIPMENT, ACT CEILING ABOVE.

2.08 G.C. SHALL SUPPLY AND INSTALL STAINLESS STEEL CLOSURE

- 2.07 OVEN HOOD (PROVIDED BY OWNER AND INSTALLED BY GC)
  STAINLESS STEEL CLOSURE PANEL ON ALL EXPOSED SIDES, FROM
  TOP OF HOOD TO CEILING FURNISH HOOD WITH LIGHT.
- PANELS AROUND PROOFER FROM TOP OF EQUIPMENT TO 6" ABOVE CEILING. PROVIDE ACCESS PANEL AS REQUIRED.

  2.09 REMOVABLE STAINLESS STEEL ACCESS PANEL (16GA) FROM TOP OF
- EQUIPMENT TO CEILING. SEE DETAIL & ELEVATIONS.

  2.15 ROOF ACCESS LADDER.

  2.16 PROVIDE STUD AND SHEATHING WALL BULKHEAD ABOVE OVEN.
- 2.21 CASEWORK SHROUD AT OVEN HOOD, BY MILLWORK VENDOR OVER BULKHEAD BY GC. INSTALL OVEN BEFORE INSTALLATION OF BULKHEAD. GC TO PROVIDE SS CLOSURE PLATE AT BOTTOM OF BULKHEAD.
- 2.22 BAKERY MIRROR ABOVE BAKERY CASEWORK, BY MILLWORK VENDOR.2.23 WD30A TRIM ALONG BULKHEAD BY GC.
- 2.26 PROVIDE FRP FINISH ON DROPPED SOFFIT AT 9'-6" AFF WITH PLYWOOD BACKER, REFER TO DETAIL 18/A135.

# TYPICAL FIXTURE MOUNTING

# HEIGHTS: PENDANTS AT FIXED BOOTH TABLES & GATHERING TABLES: 30"

- ABOVE TABLE TOP TO BOTTOM OF FIXTURE.
   PENDANTS AT MOVABLE TABLES & TABLES AT BANQUETTES: 6'-8"
- A.F.F. TO BOTTOM OF FIXTURE.

   SPECIALTY PENDANT INSTALLATIONS AT HIGH CEILINGS: REFER TO
- PLANS/ ELEVATIONS FOR FURTHER INFORMATION

  LIGHT TRACK: 11' 0" A F. F. TO BOTTOM OF TRACK
- LIGHT TRACK: 11'-0" A.F.F. TO BOTTOM OF TRACK

  SPEAKERS: 11'-0" A.F.F. TO BOTTOM OF SPEAKER
- SPEAKERS: 11'-0" A.F.F. TO BOTTOM OF SPEAKER
  WALL SCONCES: REFER TO PLANS/ELEVATIONS FOR FURTHER
  INFORMATION

Bakery-Cafe:

#240

SYSTEM: G4 (ARIA)




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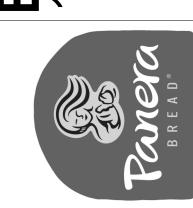
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Professional Seal:



Project Title:

Bakery Cafe#2406 1410 NE DOUGLAS ST LEES SUMMIT, MO 64086

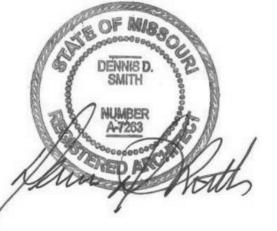

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No.	Description	Date
	Tenant - Permit Set	7/18/2022
Α	Shell - City Comments	8/19/2022
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# REFLECTED CEILING

PLAN

Project Number: Sheet Number:

22302

Drawn By:

Author


Issue Date: A 13

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24 REFLECTED CEILING PLAN



Bakery-Cafe:

#2406

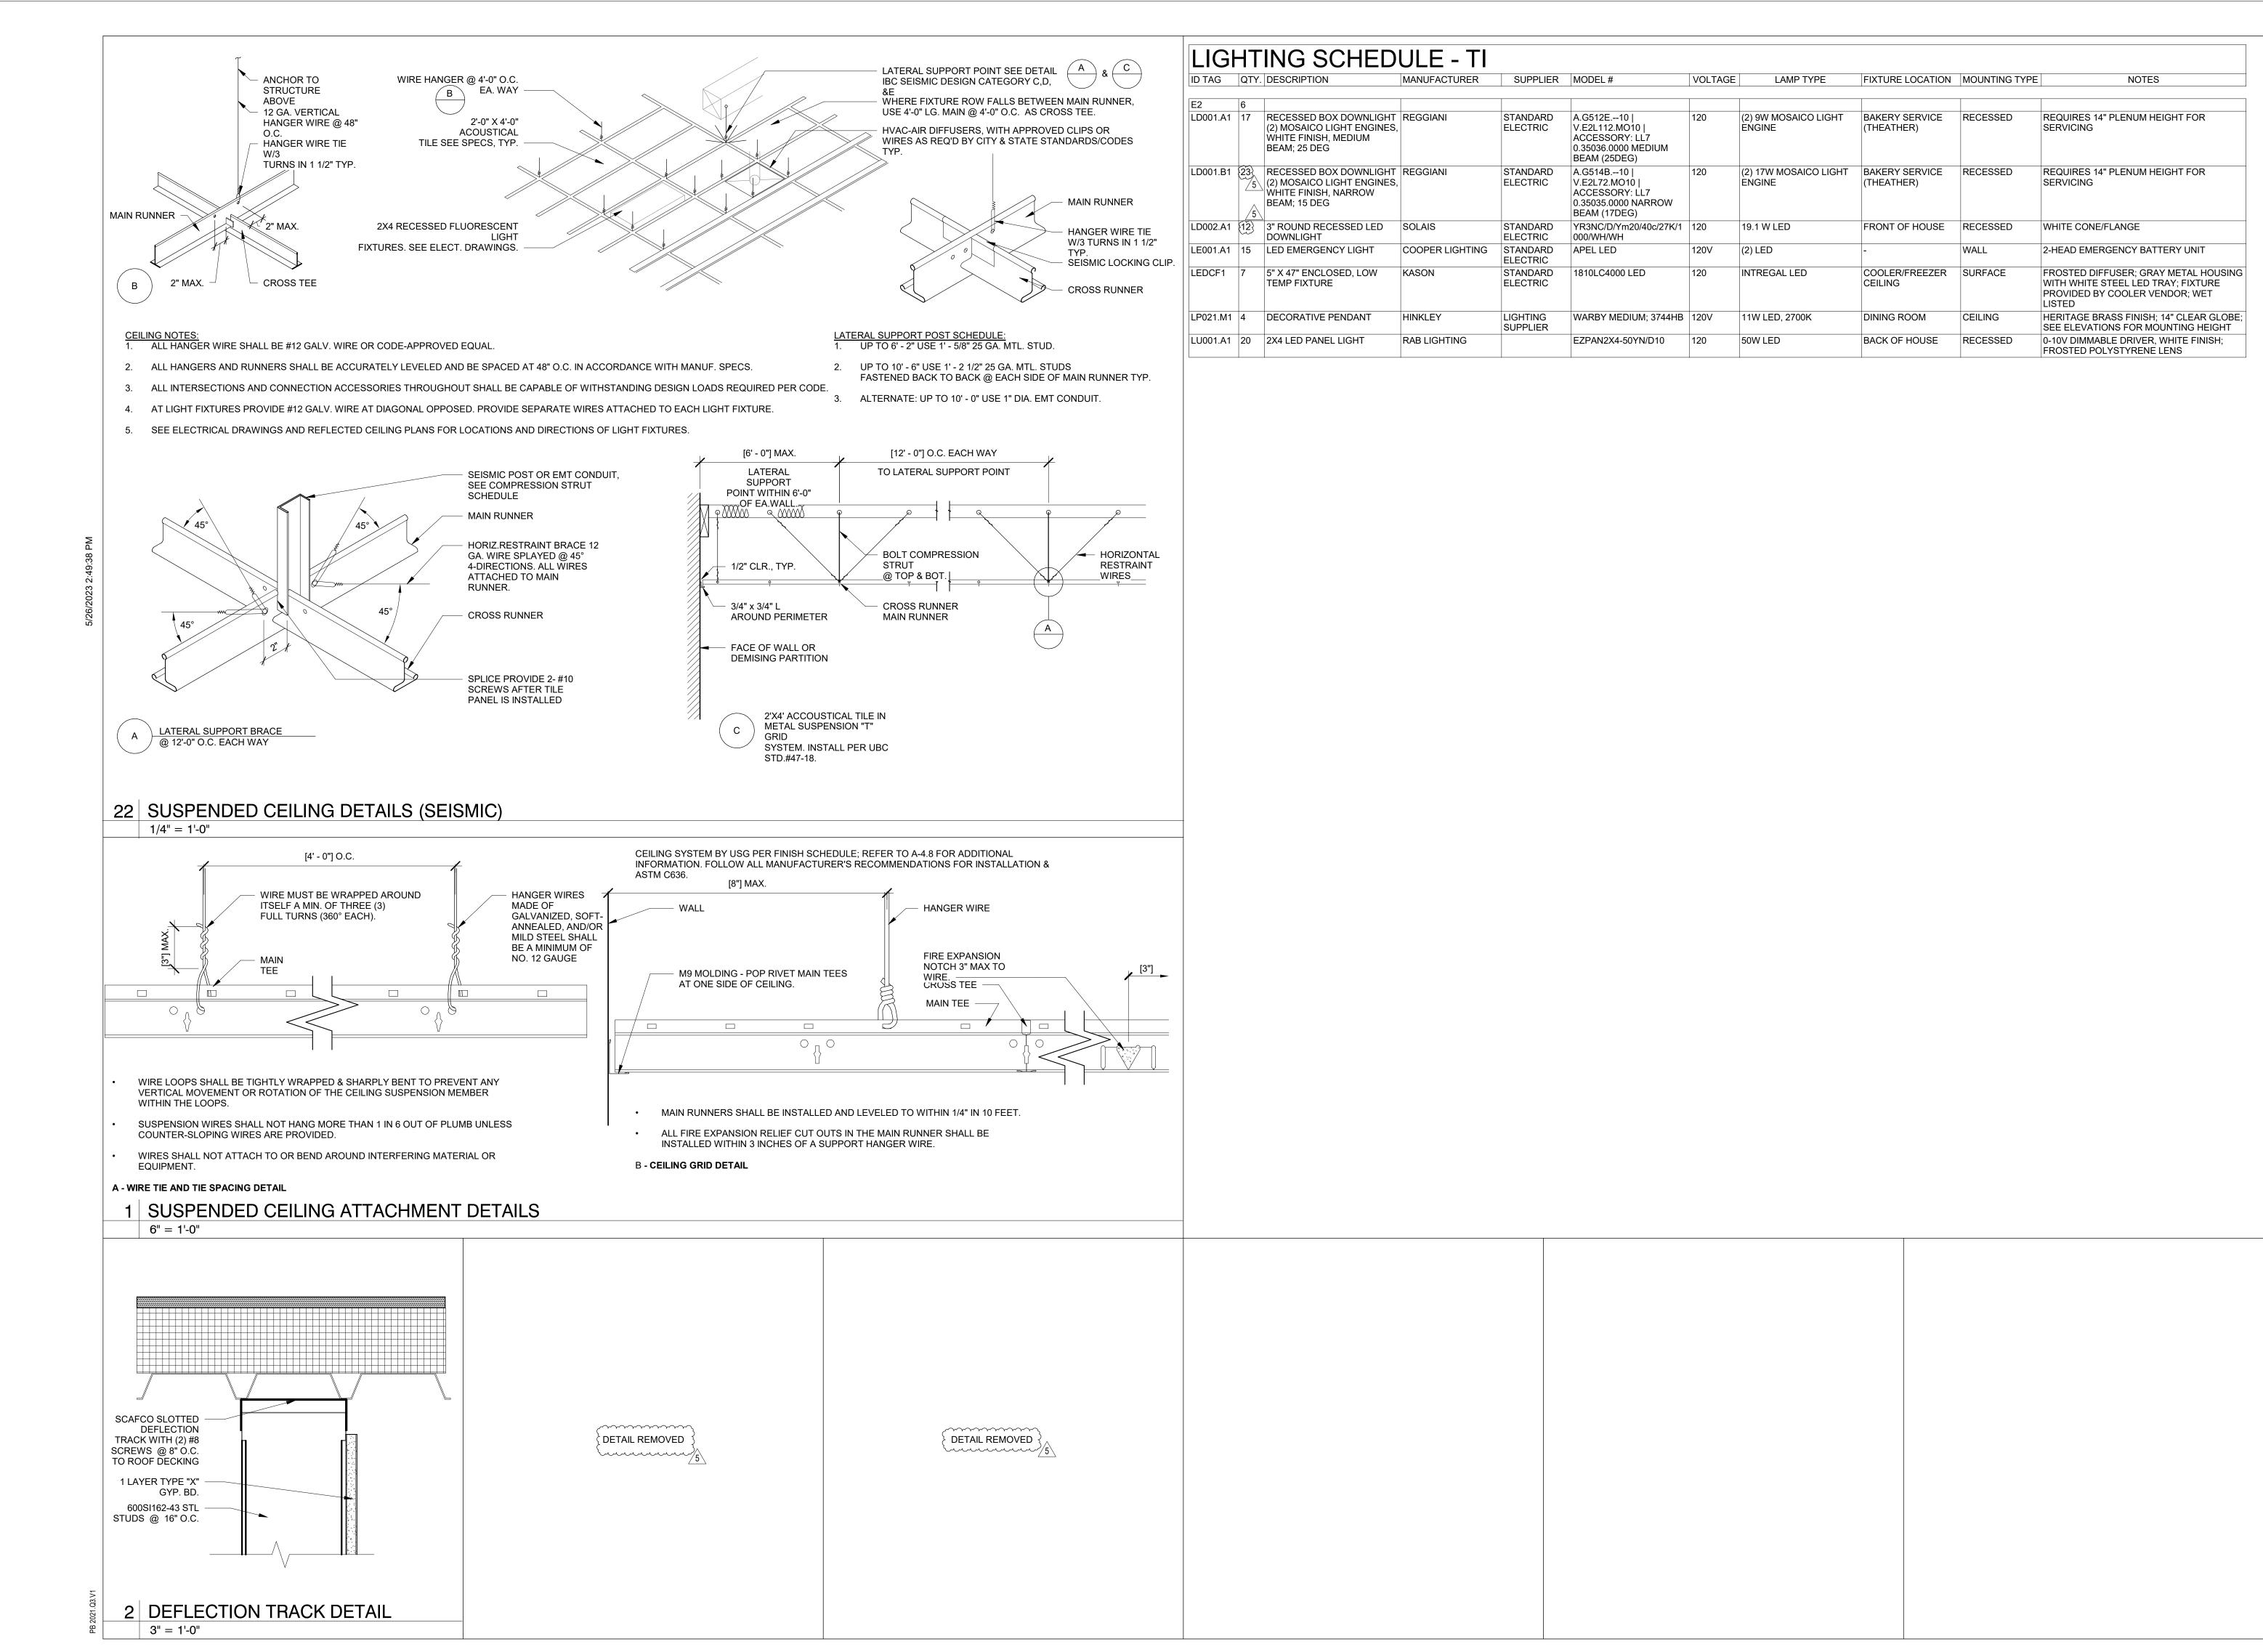SYSTEM: G4 (ARIA)
Project Team:




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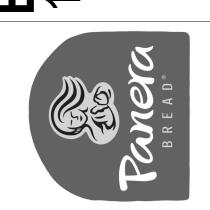
Architecture · Engineering · Planning · Interior Design · Landscape Architecture

Professional Seal:



Project Title:
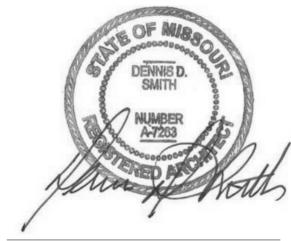
# Bakery Cafe#2406 1410 NE DOUGLAS ST LEES SUMMIT, MO 64086





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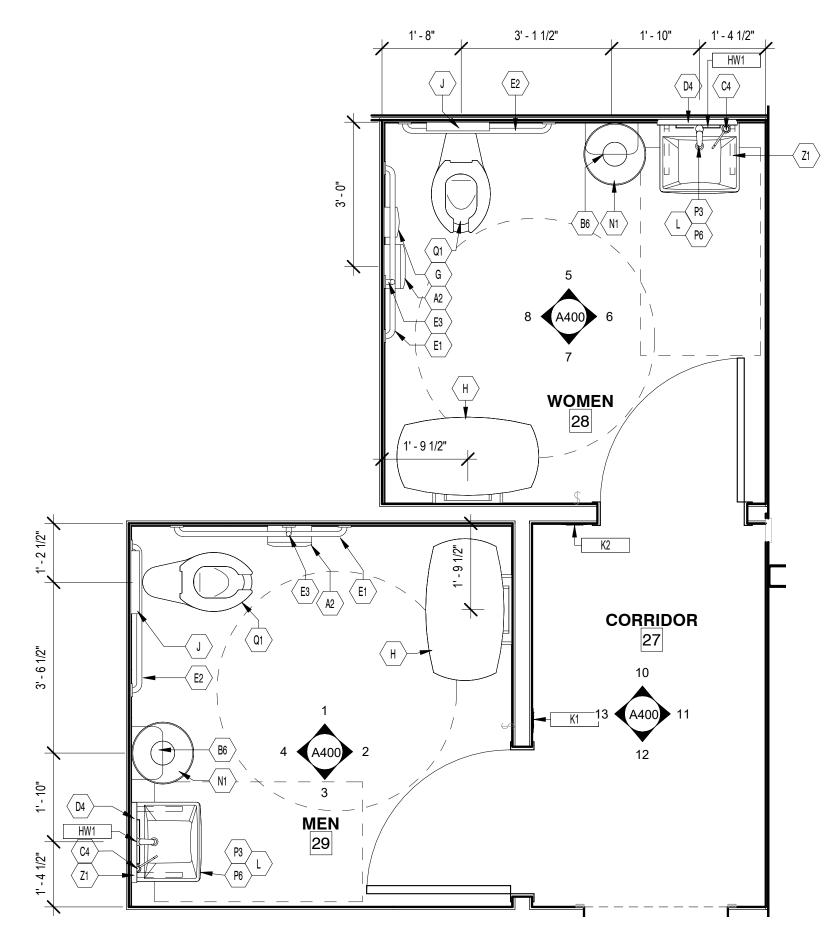
No.	Description	Date		
	Tenant - Permit Set	7/18/2022		
1	Tenant - City Comments	9/22/2022		
2	Tenant - Construction Set	11/09/2022		
4	Tenant - Owner Revision	02/03/2023		
5	Prototype Updates	05/29/2023		

LIGHTING SCHEDULE, DETAILS, & SECTIONS

Project Number:	Sheet Number:
22302	
Drawn By:	
Author	ΔΊ
Issue Date:	$\Delta$ 1 $\checkmark$
05/29/2023	



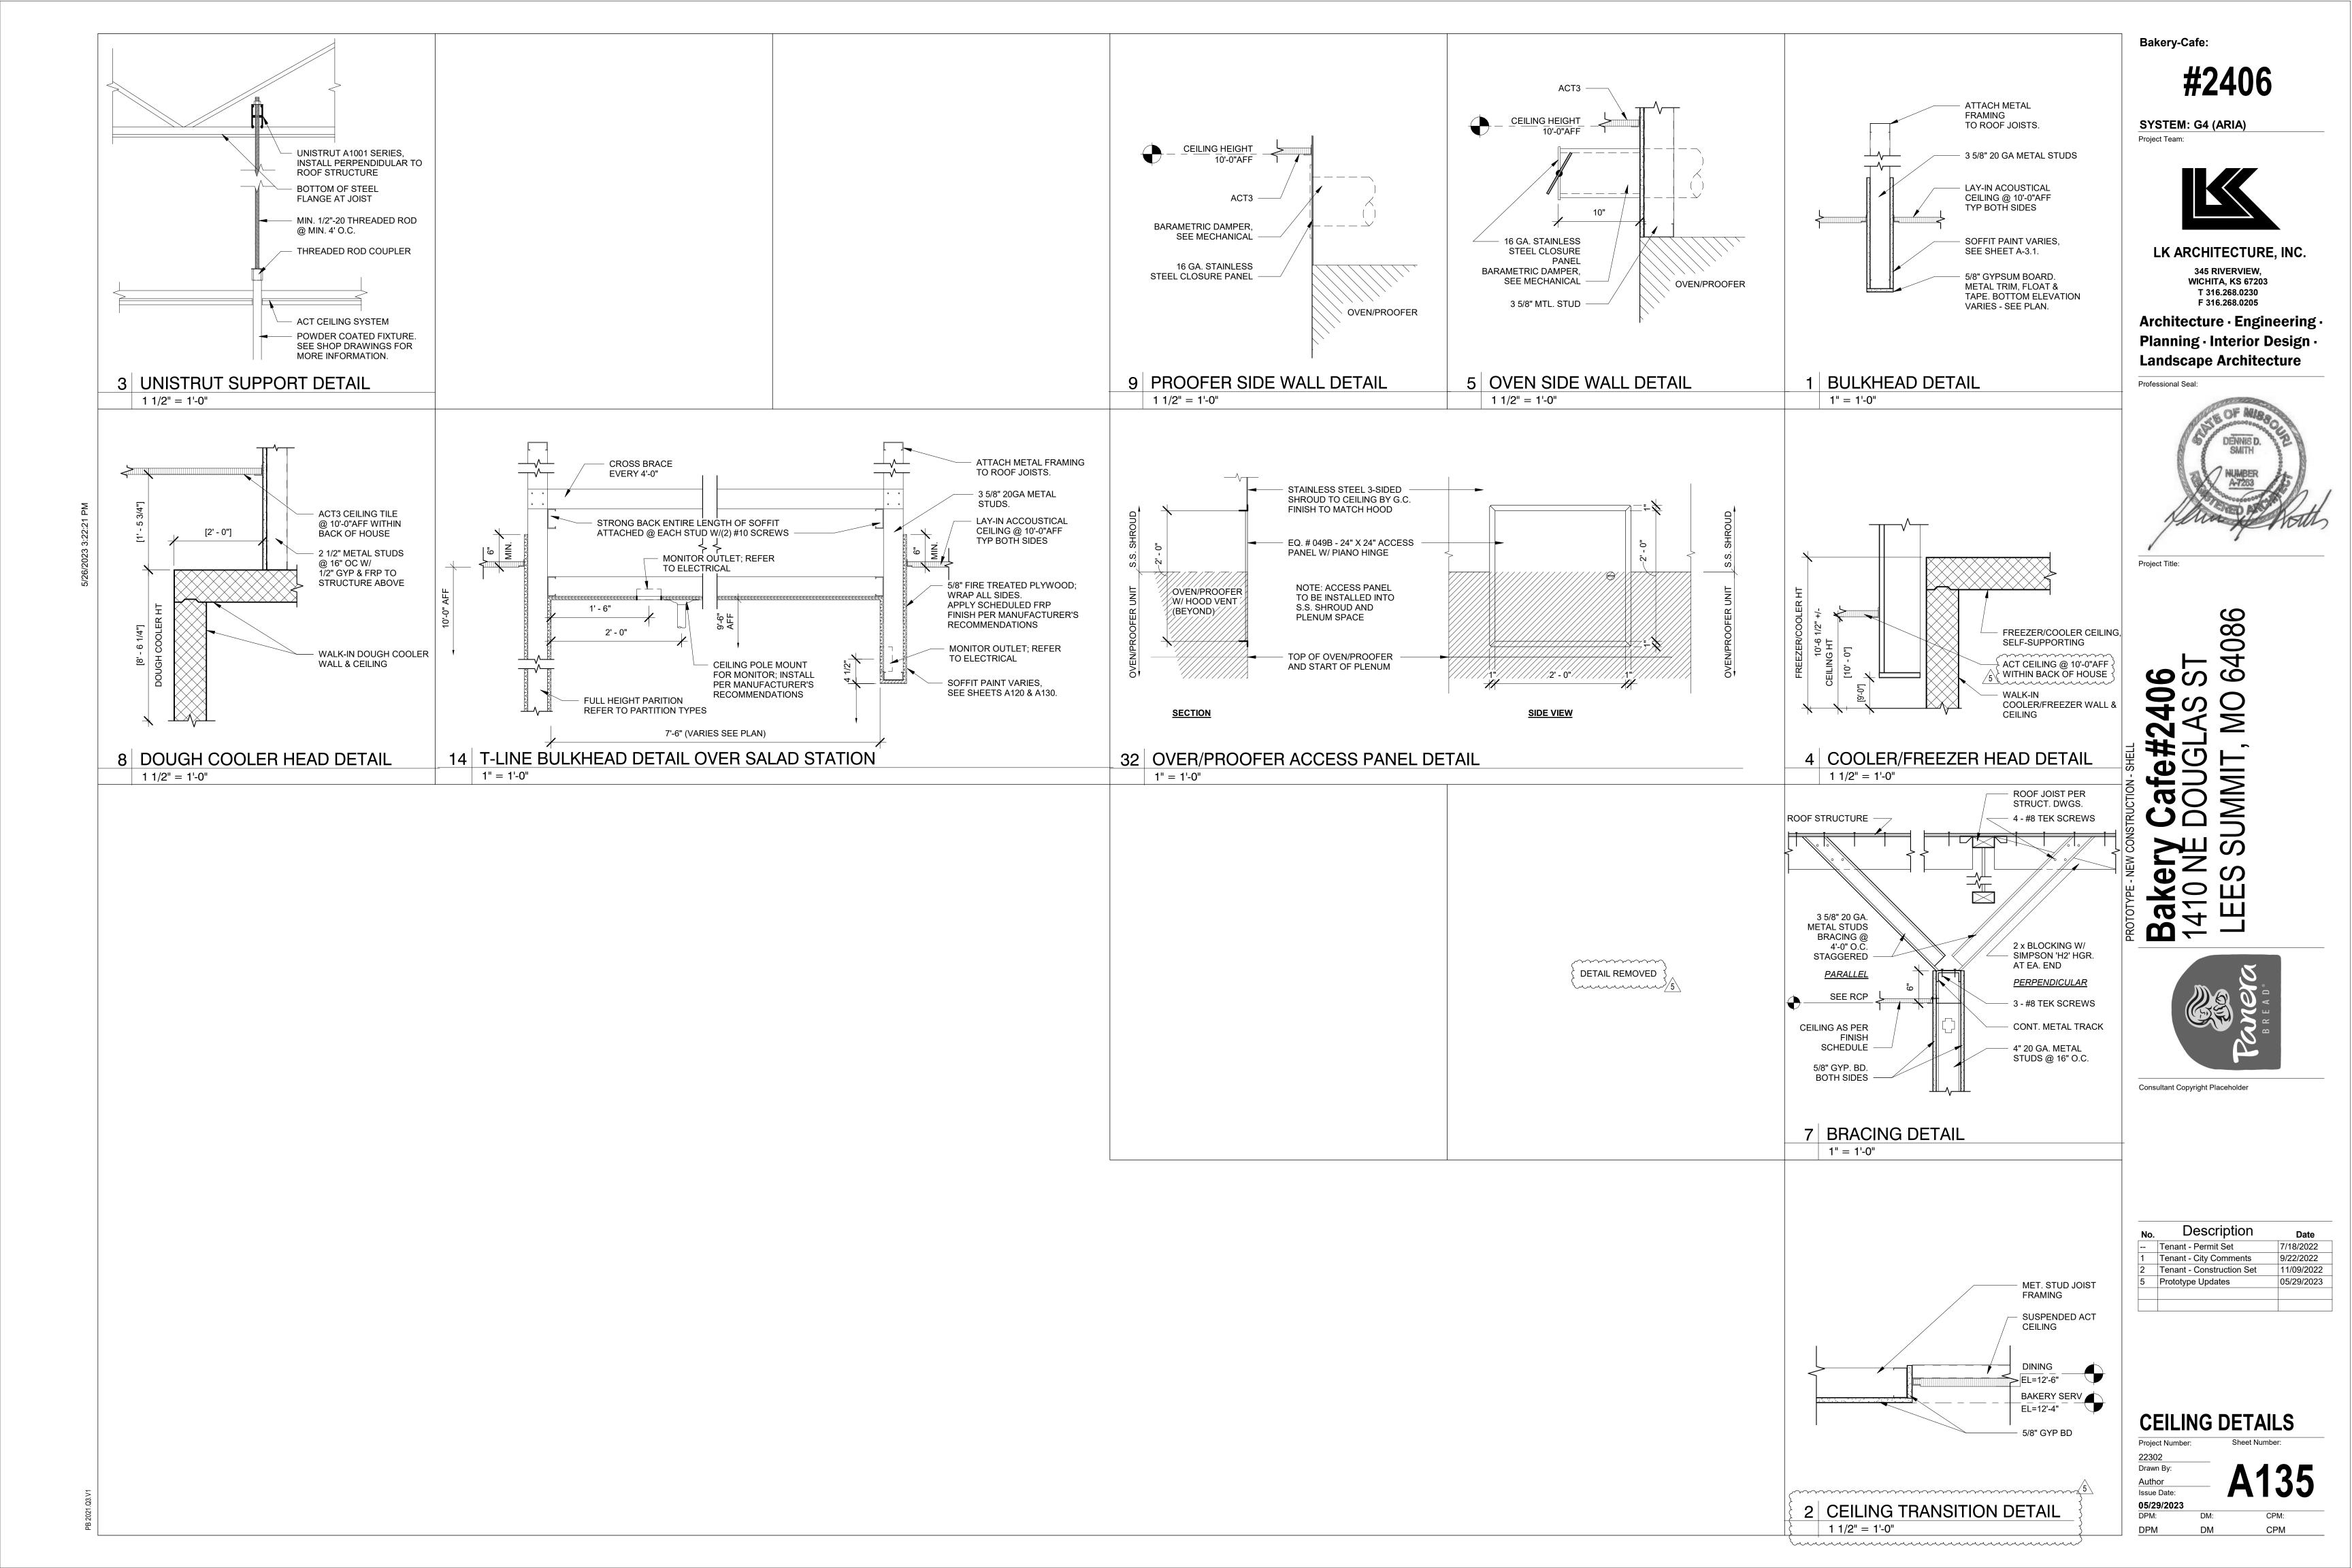

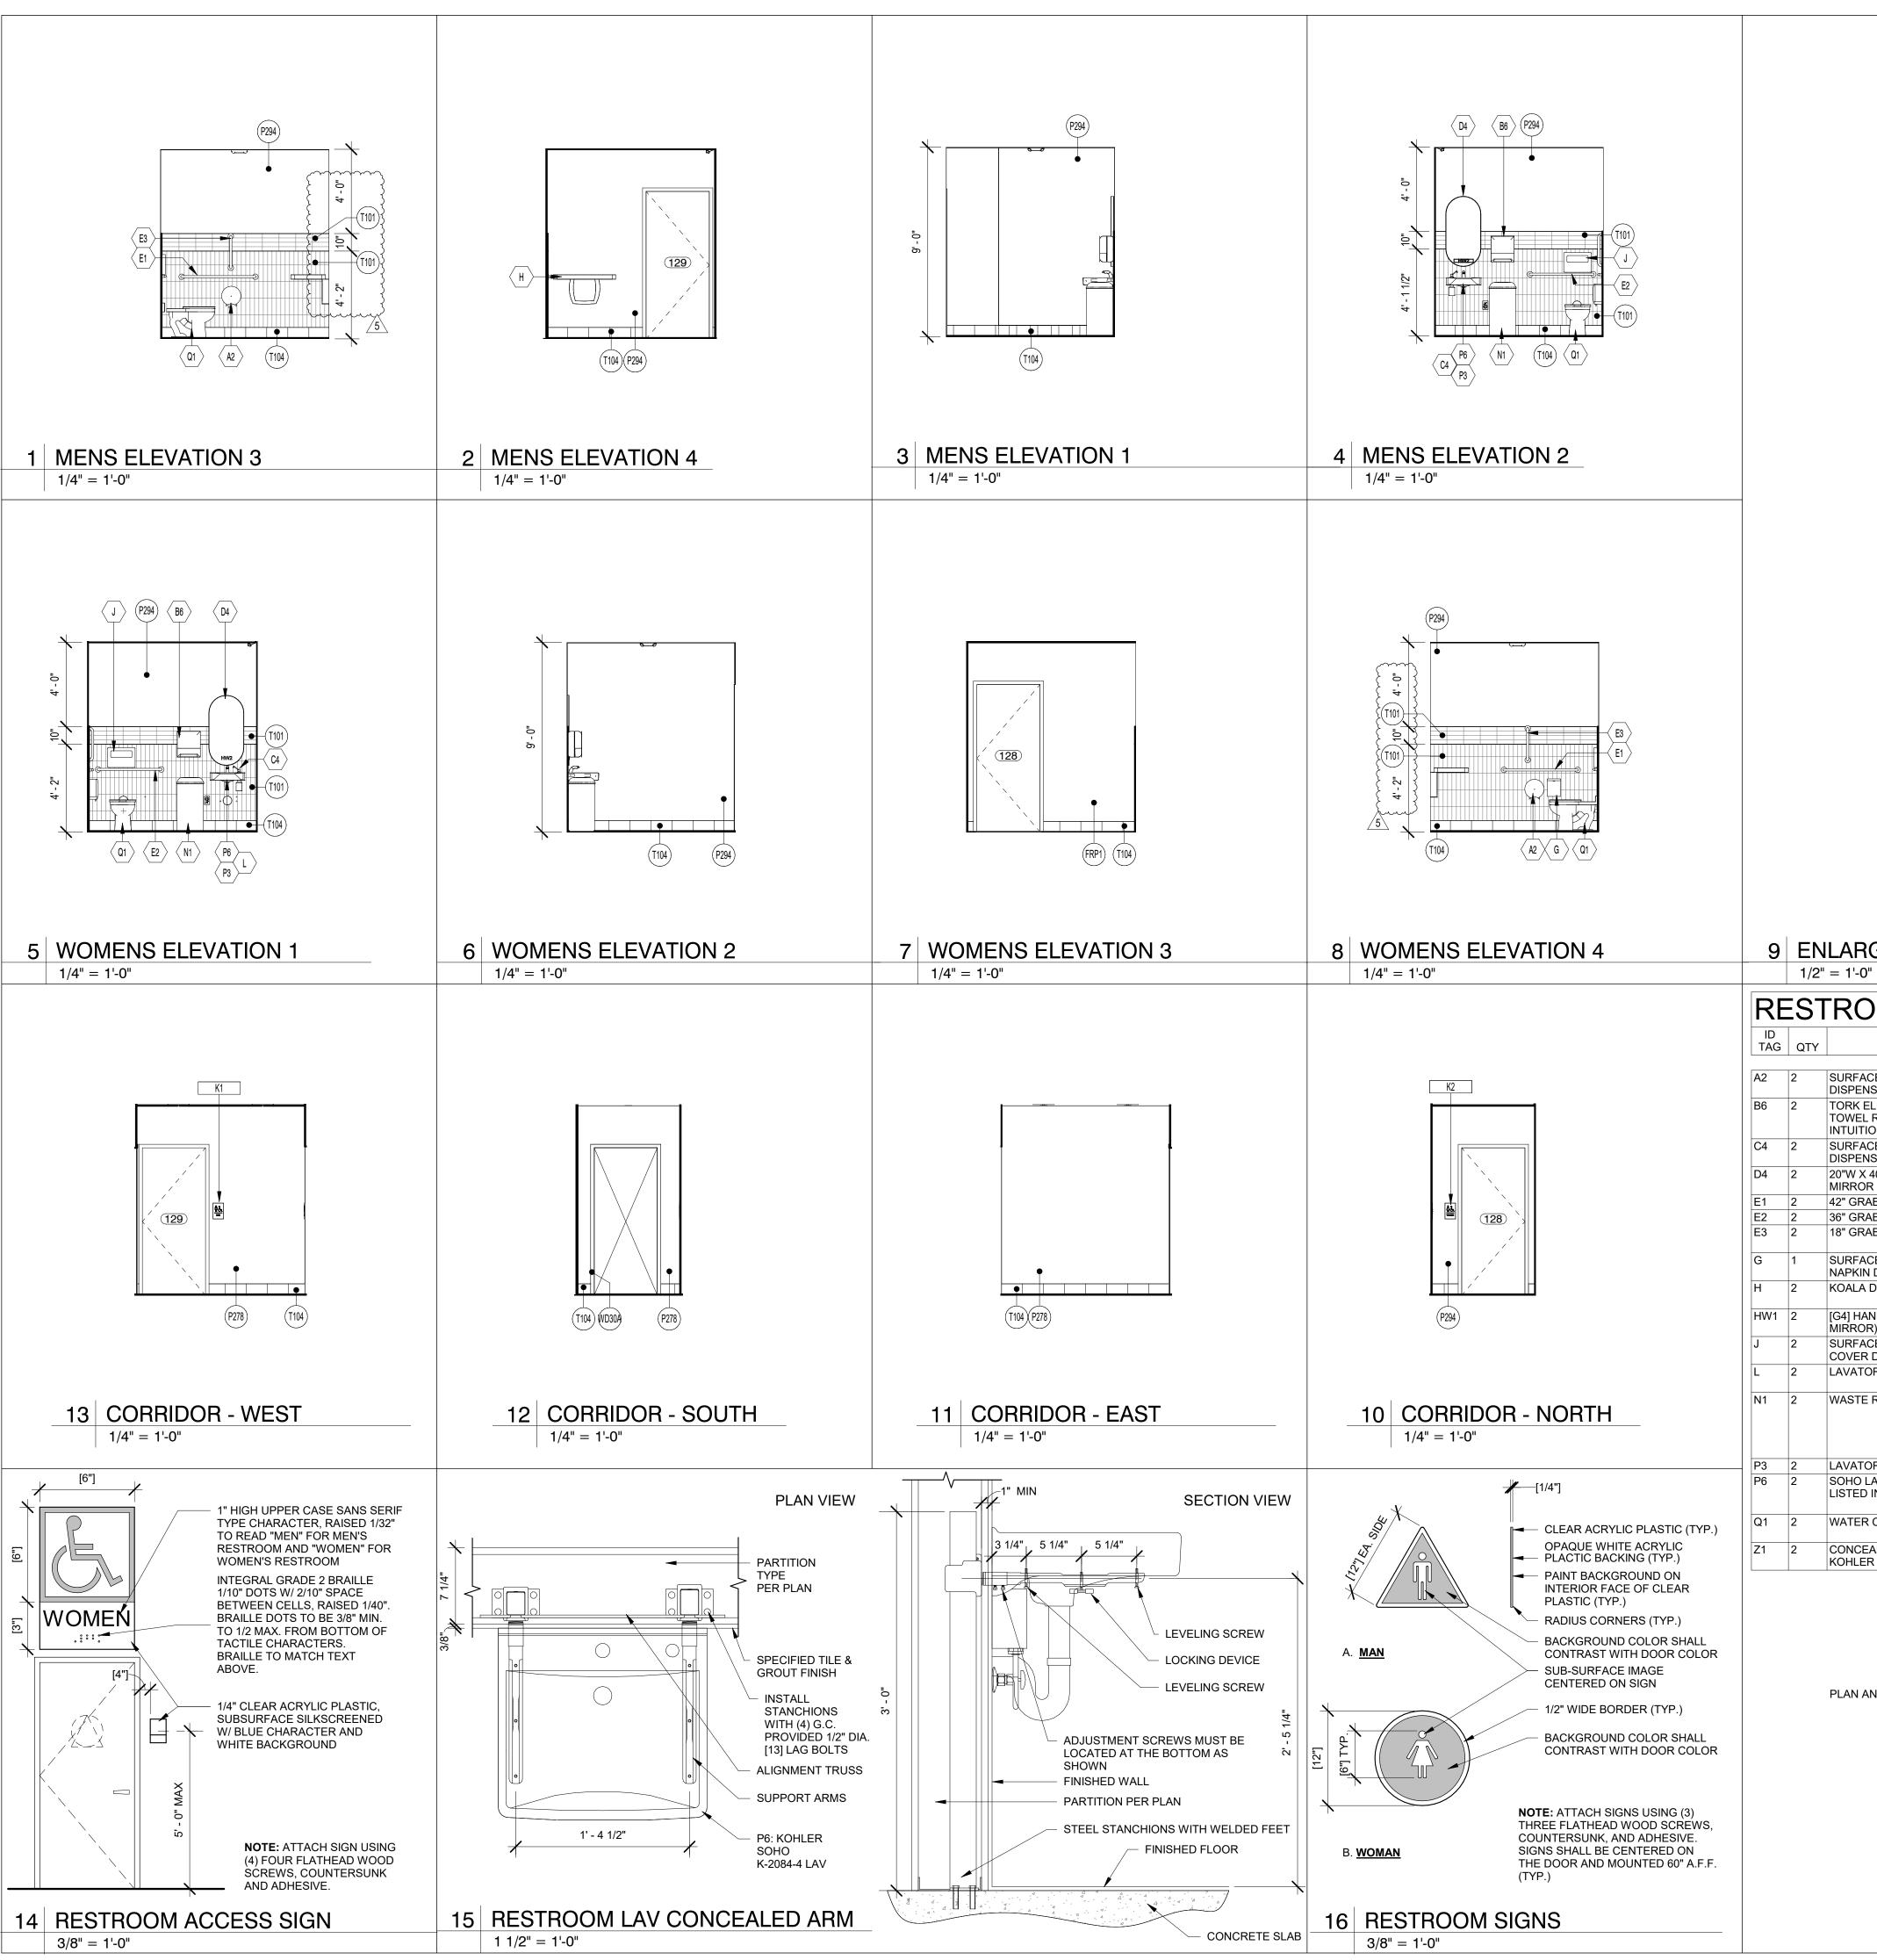

## 9 ENLARGED RESTROOM PLAN

ID TAG	QTY	DESCRIPTION	MODEL	NOTES	MOUNTING LIFTCHT
TAG	QIY	DESCRIPTION	MODEL	NOTES	MOUNTING HEIGHT
A2	2	SURFACE- MOUNTED TOILET PAPER DISPENSER	TORK 66TR		32" AFF TO TOP, C.L. 7'-9" IN FRONT OF W.C.
B6	2	TORK ELEVATION MATIC HAND TOWEL ROLL DISPENSER WITH INTUITION SENSOR	5511202		45.5"
C4	2	SURFACE-MOUNTED SOAP DISPENSER	BOBRICK B-822		MOUNT IN LAVATORY; SPOUT DECK MOUNTED
D4	2	20"W X 40"H CAPSULE SHAPED MIRROR FOR RESTROOM	KOHLER; K-26051; BLACK FRAME		40" AFF TO BOTTOM OF FRAME
E1	2	42" GRAB BAR	BOBRICK B-5806-42		36" TO TOP OF GRIPPING SURFACE
E2	2	36" GRAB BAR	BOBRICK B-5806-36		36" TO TOP OF GRIPPING SURFACE
E3	2	18" GRAB BAR (VERTICAL)	BOBRICK B-5806-18		BOTTOM OF BAR MTD PER ARCHITECT DIRECTION
G	1	SURFACE- MOUNTED SANITARY NAPKIN DISPOSAL	BOBRICK B-270	Satin Finish	30" AFF TO TOP
Н	2	KOALA DIAPER CHANGING STATION	KB200-00-HORIZONTAL PH# 1.888.733.3456		28.75" AFF TO BOTTOM MOST EDGE
HW1	2	[G4] HAND WASH SIGN (RESTROOM MIRROR)			
J	2	SURFACE- MOUNTED TOILET SEAT- COVER DISPENSER	BOBORICK B-4221		32" AFF TO TOP
L	2	LAVATORY PIPE INSULATION	LAVAGUARD TRUEBRO 100SERIES, GREY		INSTALL OVER HOT/COLD WATER & DRAIN PIPES
N1	2	WASTE RECEPTACLE	EX-CELL KAISER #INT1531 D-6 WHT DB	SMALLWARES ITEM; PROVIDED BY PANERA, INSTALLED BY G.C.	FREE STANDING
P3	2	LAVATORY FAUCET	TEL105-D10EM		N/A
P6	2	SOHO LAVATORY (USE WITH Z1 LISTED IN THIS SCHEDULE)	K-2084-R, WHITE		34" AFF TO TOP OF SINK RIM; MIN. 27" CLEAR BELOW SINK; REFER TO INSTALL DETAIL
Q1	2		AMERICAN STANDARD 3043.001, ALTERNATE TOTO CT 705L		FLOOR- MOUNTED; INSTALL FLUSH VALVE ON OPEN (ACCESS) SIDE
Z1	2	CONCEALED ARM CARRIER FOR KOHLER K-2084-R	ZURN Z1231-UNIV-80		INSTALL UPRIGHTS INSIDE WALL; REFER TO INSTALL DETAIL

PLAN AND ELEVATIONS UPDATED TO MATCH NEW LAYOUT

Bakery-Cafe:

#2406

SYSTEM: G4 (ARIA)




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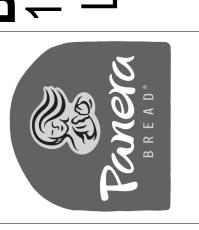
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Project Title:

# Bakery Cafe#2406 1410 NE DOUGLAS ST LEES SUMMIT, MO 6408




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# ENLARGED RESTROOM PLANS & INTERIOR ELEVATIONS

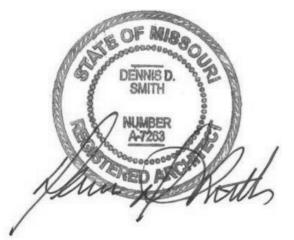Project Number:		Sheet Number:
22302		
Drawn By:		A
Author		A400
Issue Date:		<b>MTUU</b>
05/29/2023		
DPM:	DM:	CPM:
DPM	DM	CPM




SYSTEM: G4 (ARIA)

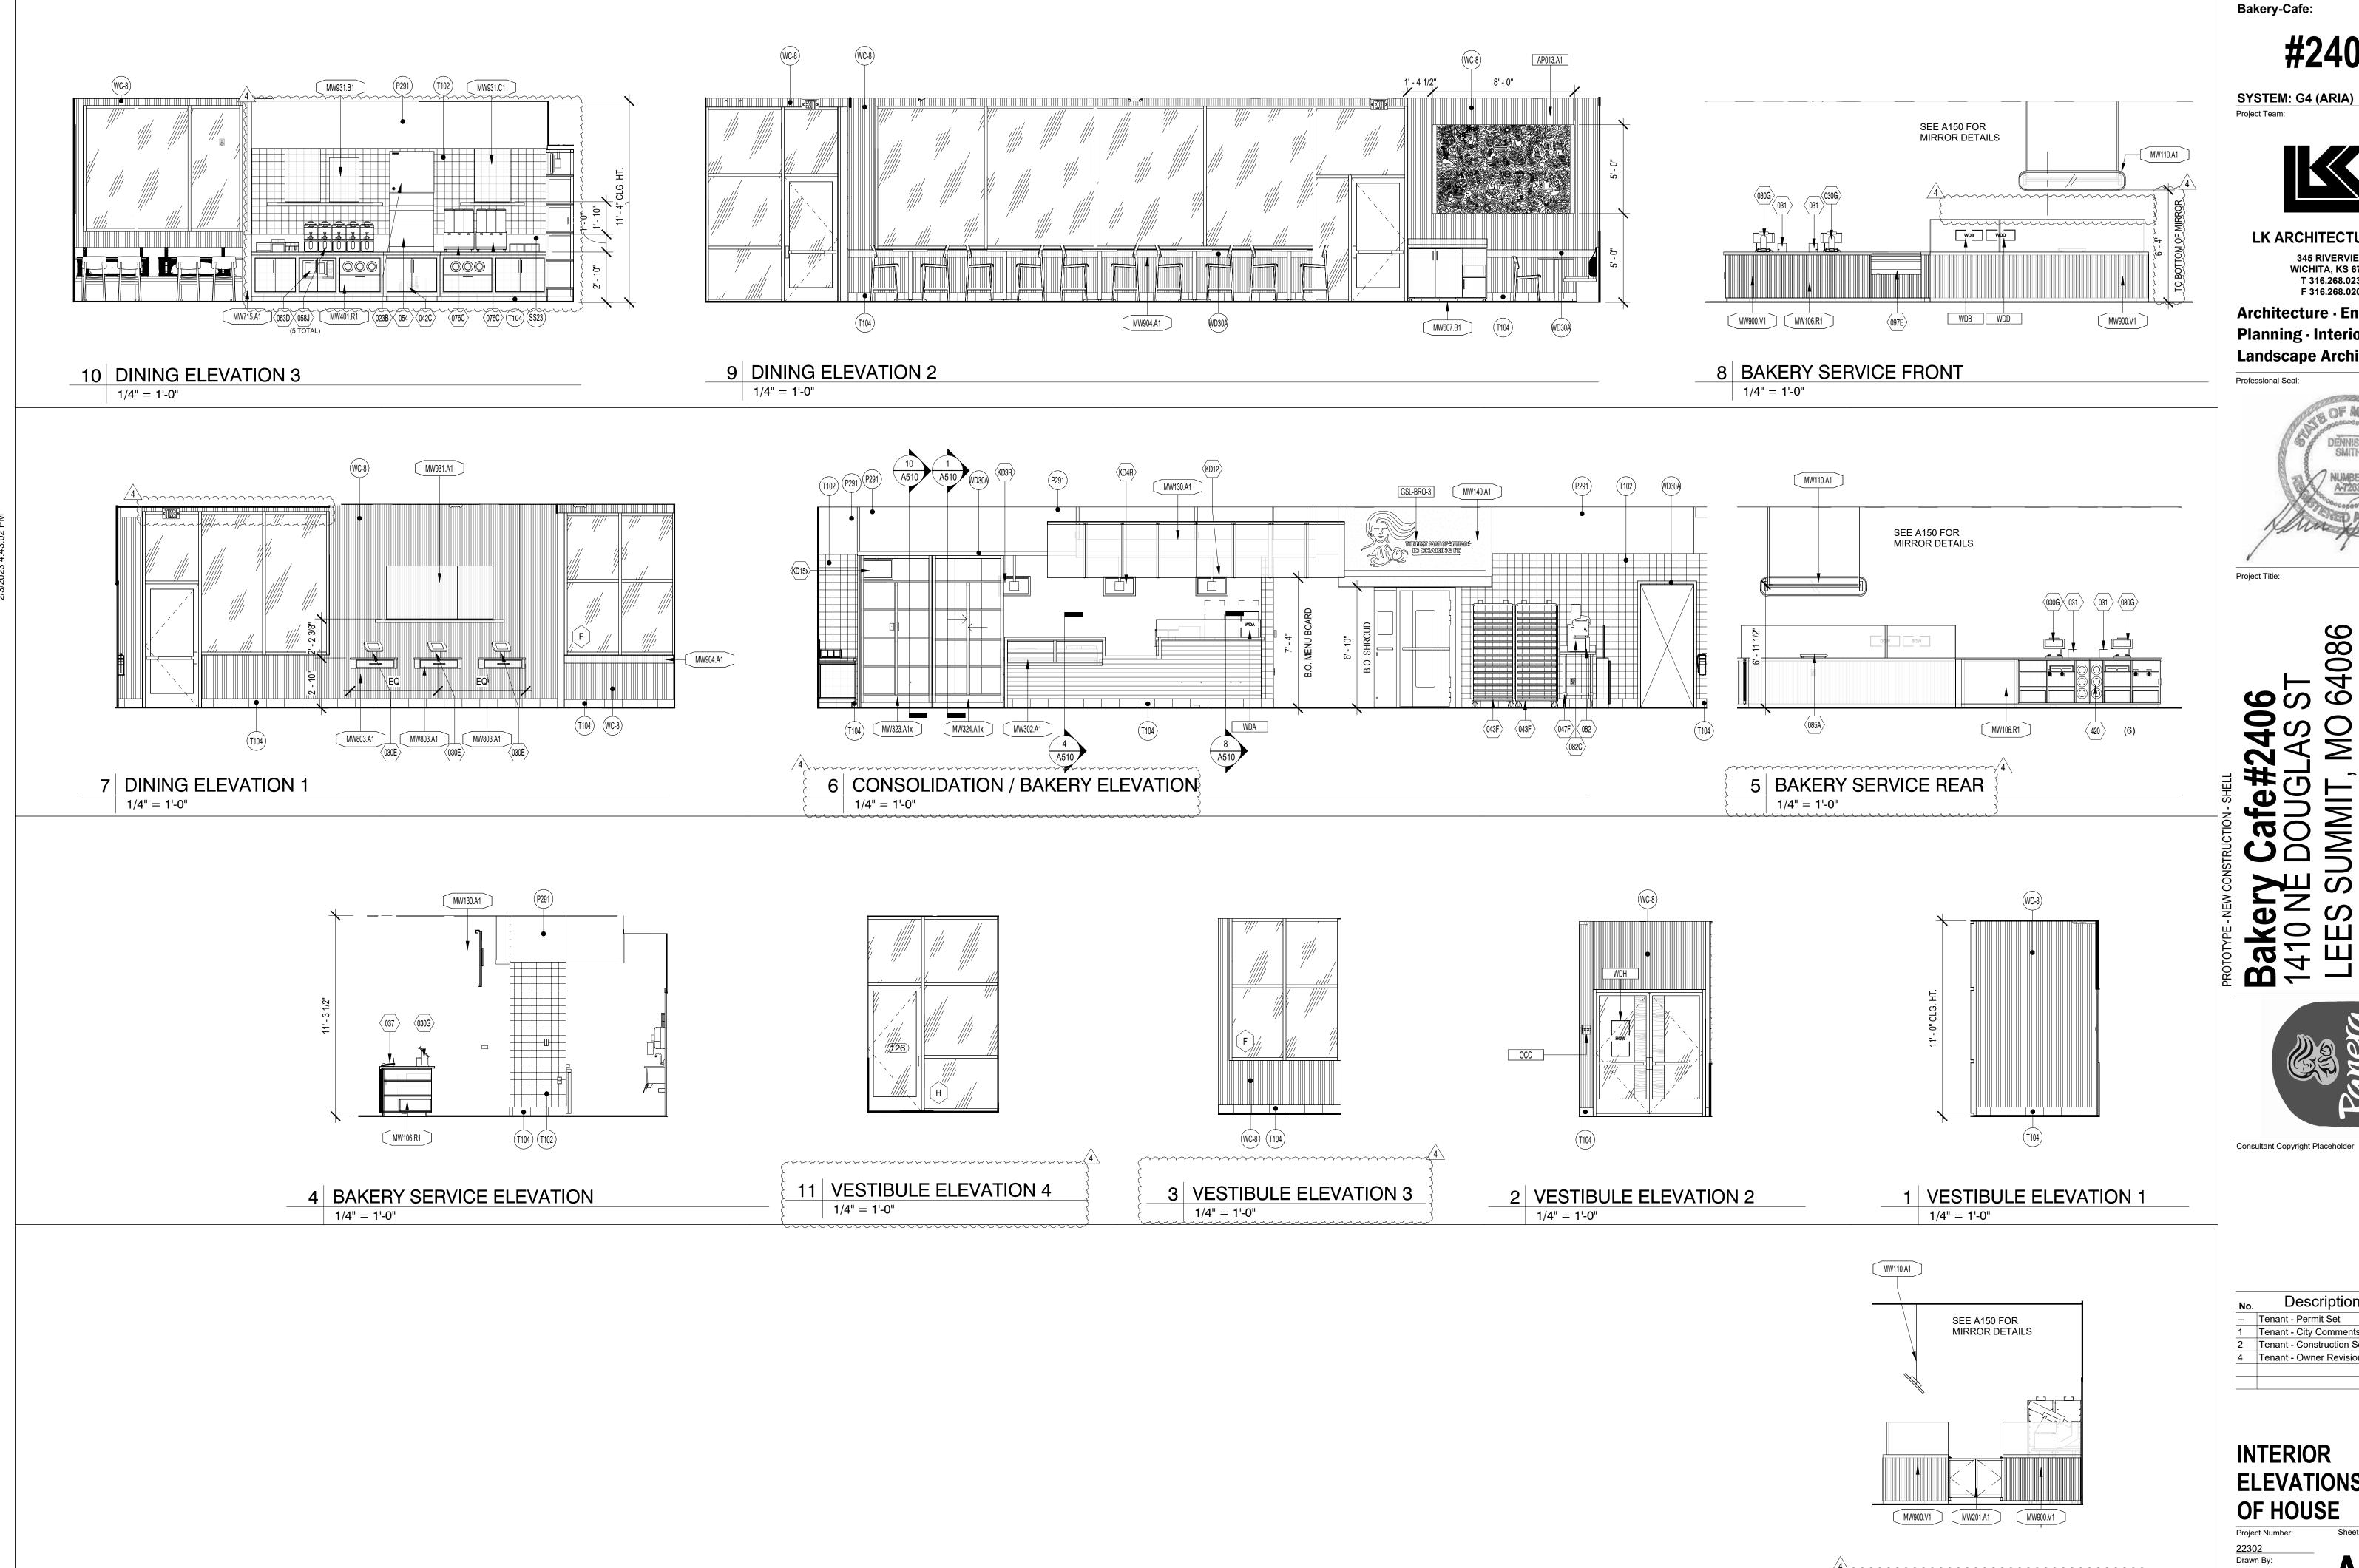

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# 406 48 S 10 64

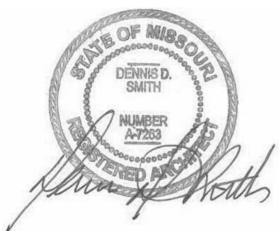


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**INTERIOR ELEVATIONS FRONT** 

Author Issue Date: 07/05/2022 DPM:

12 DINING ELEVATION 4

1/4" = 1'-0"

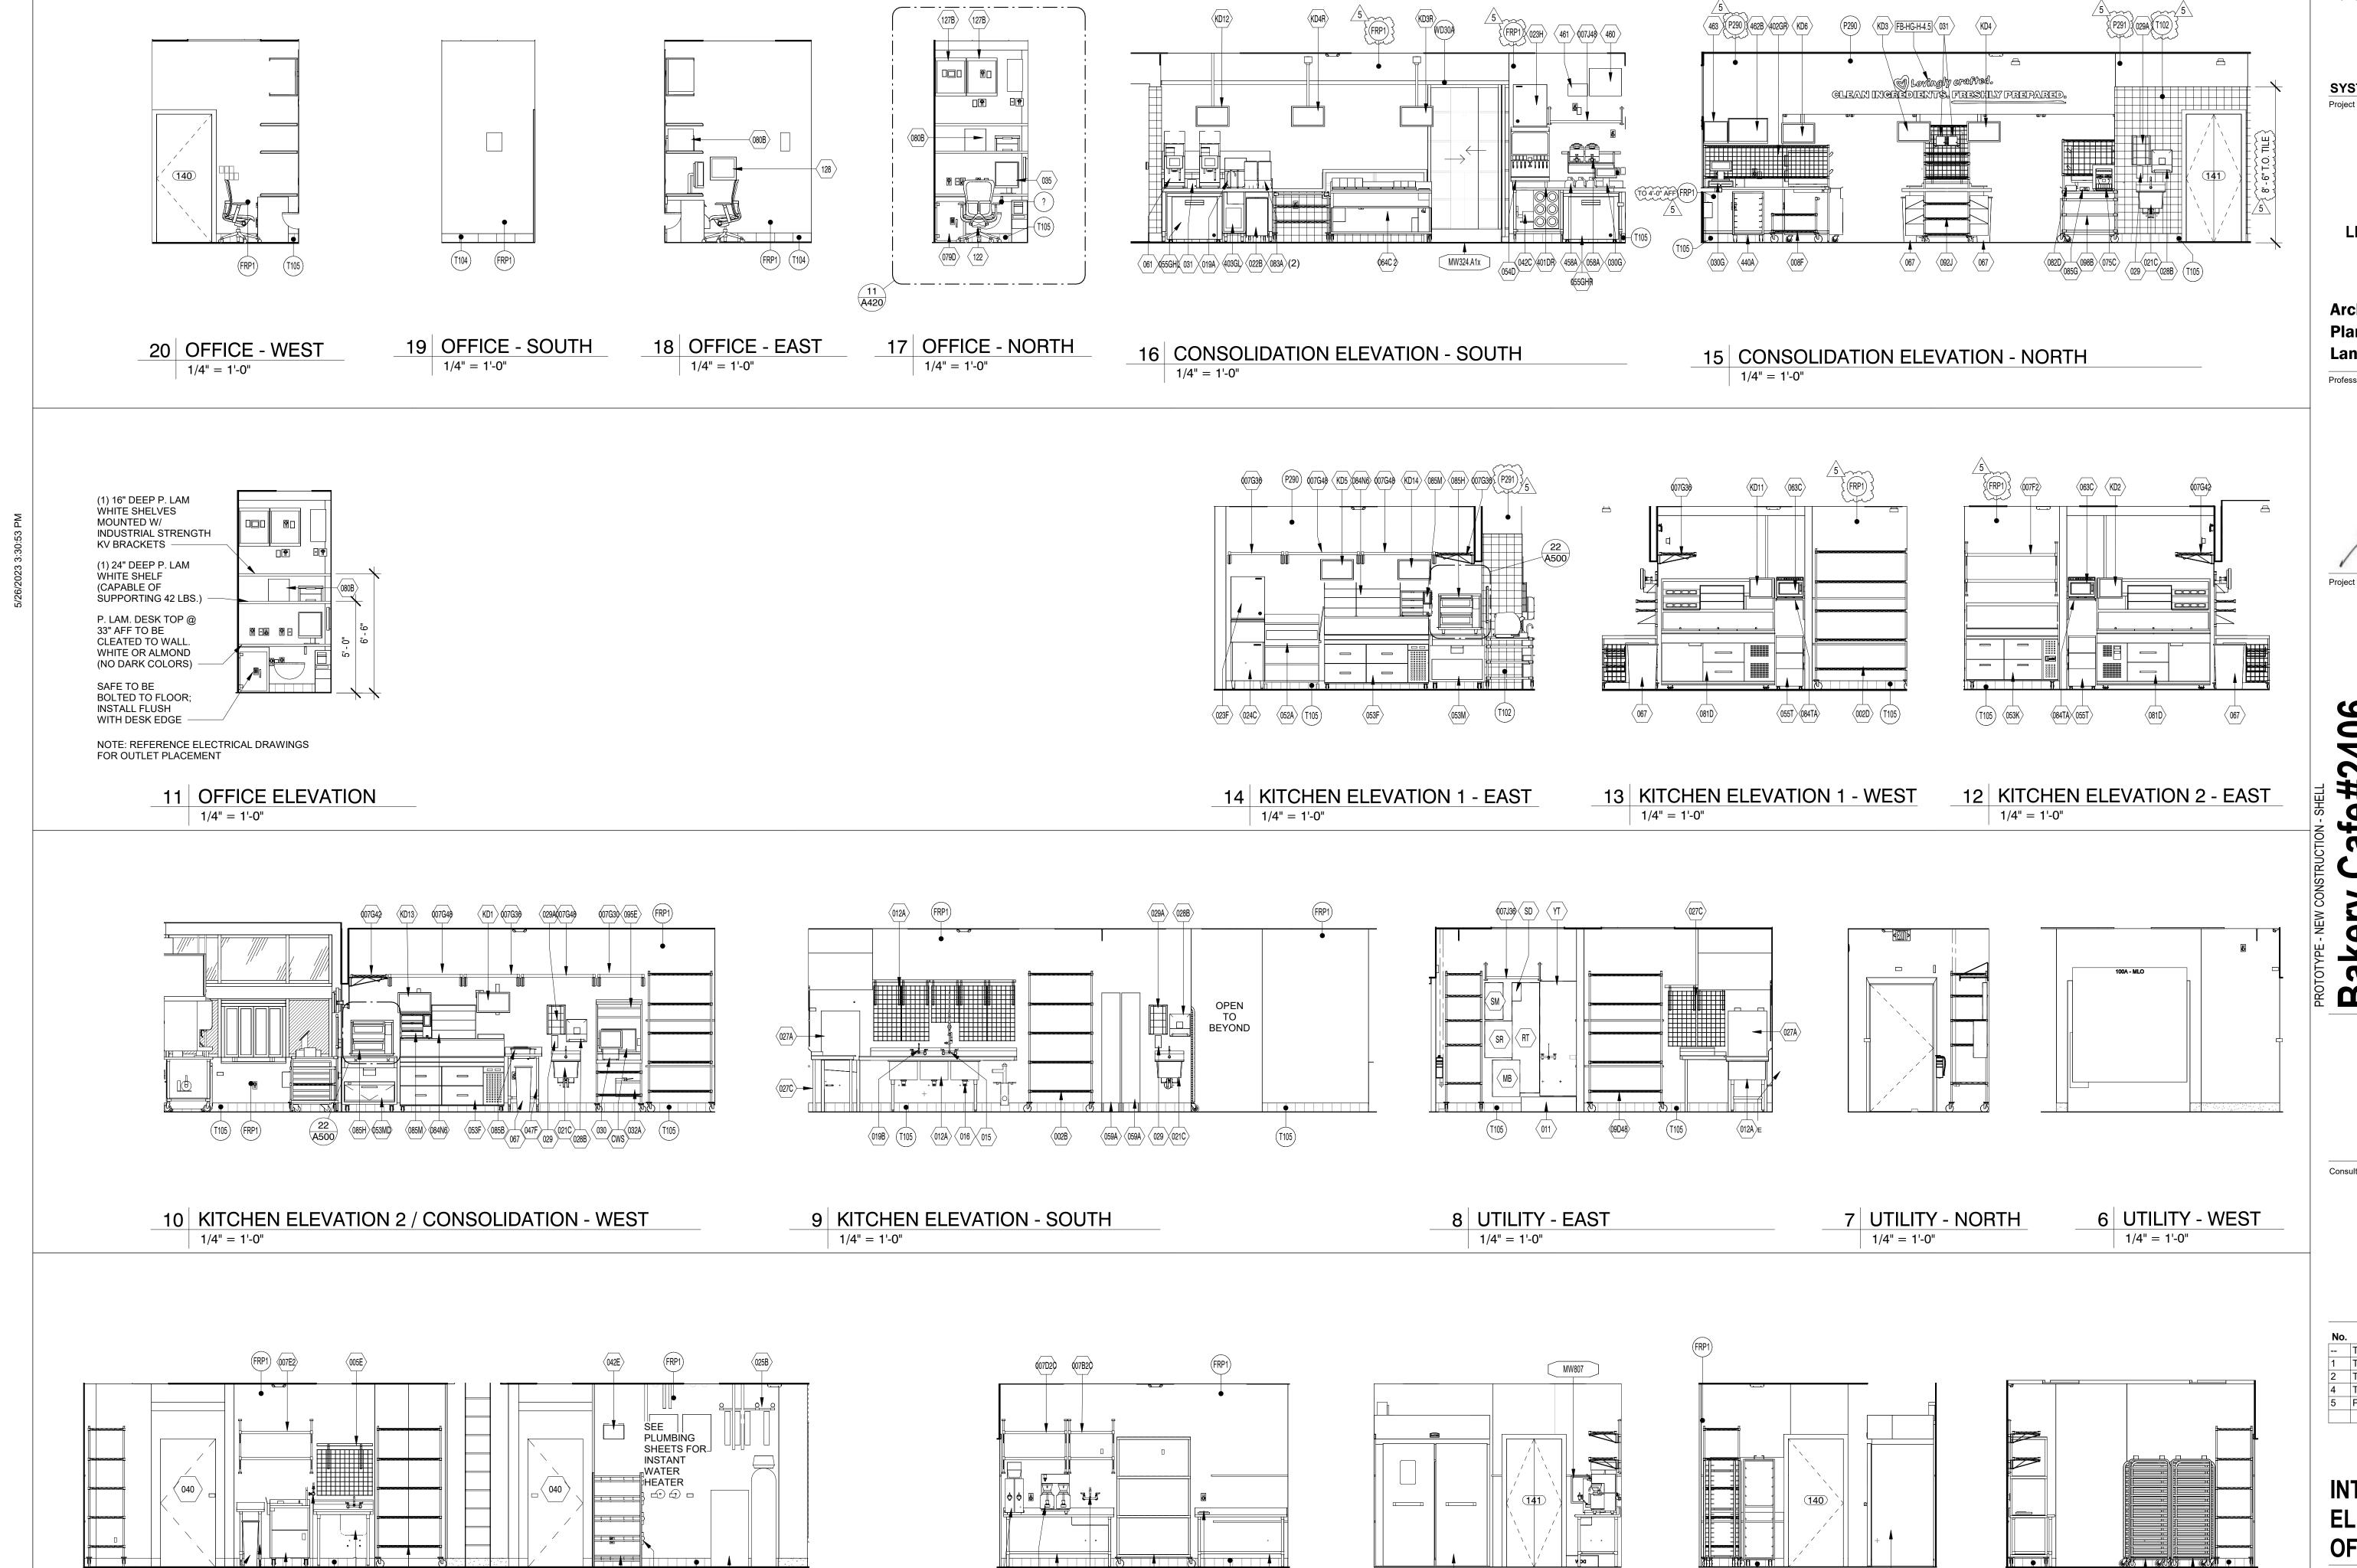

Bakery-Cafe:

SYSTEM: G4 (ARIA)




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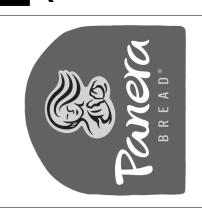
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Professional Seal:



Project Title:

4086 406 \S S MMIT **Bake** 1410

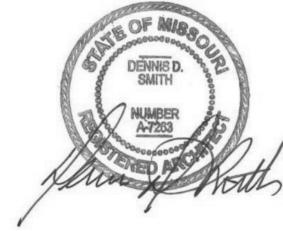

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### **INTERIOR ELEVATIONS BACK** OF HOUSE

Project Number: 22302 Drawn By: Author Issue Date: 05/29/2023 DPM: CPM

043E T105

REAR BAKERY - NORTH

(T105)

1/4" = 1'-0"

044.2B.BR


5 KITCHEN ELEVATION - NORTH 1/4" = 1'-0"

T105 (025D)

042A 042D


067 \ 047G \ 068A \ 019C \ T105 \ 013D(L) \ 019B




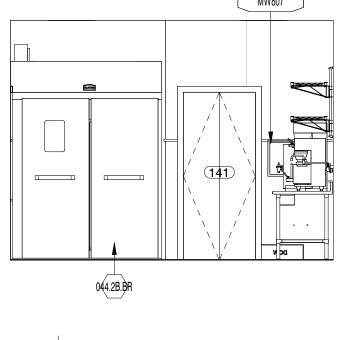



2 REAR BAKERY - EAST 1/4" = 1'-0"

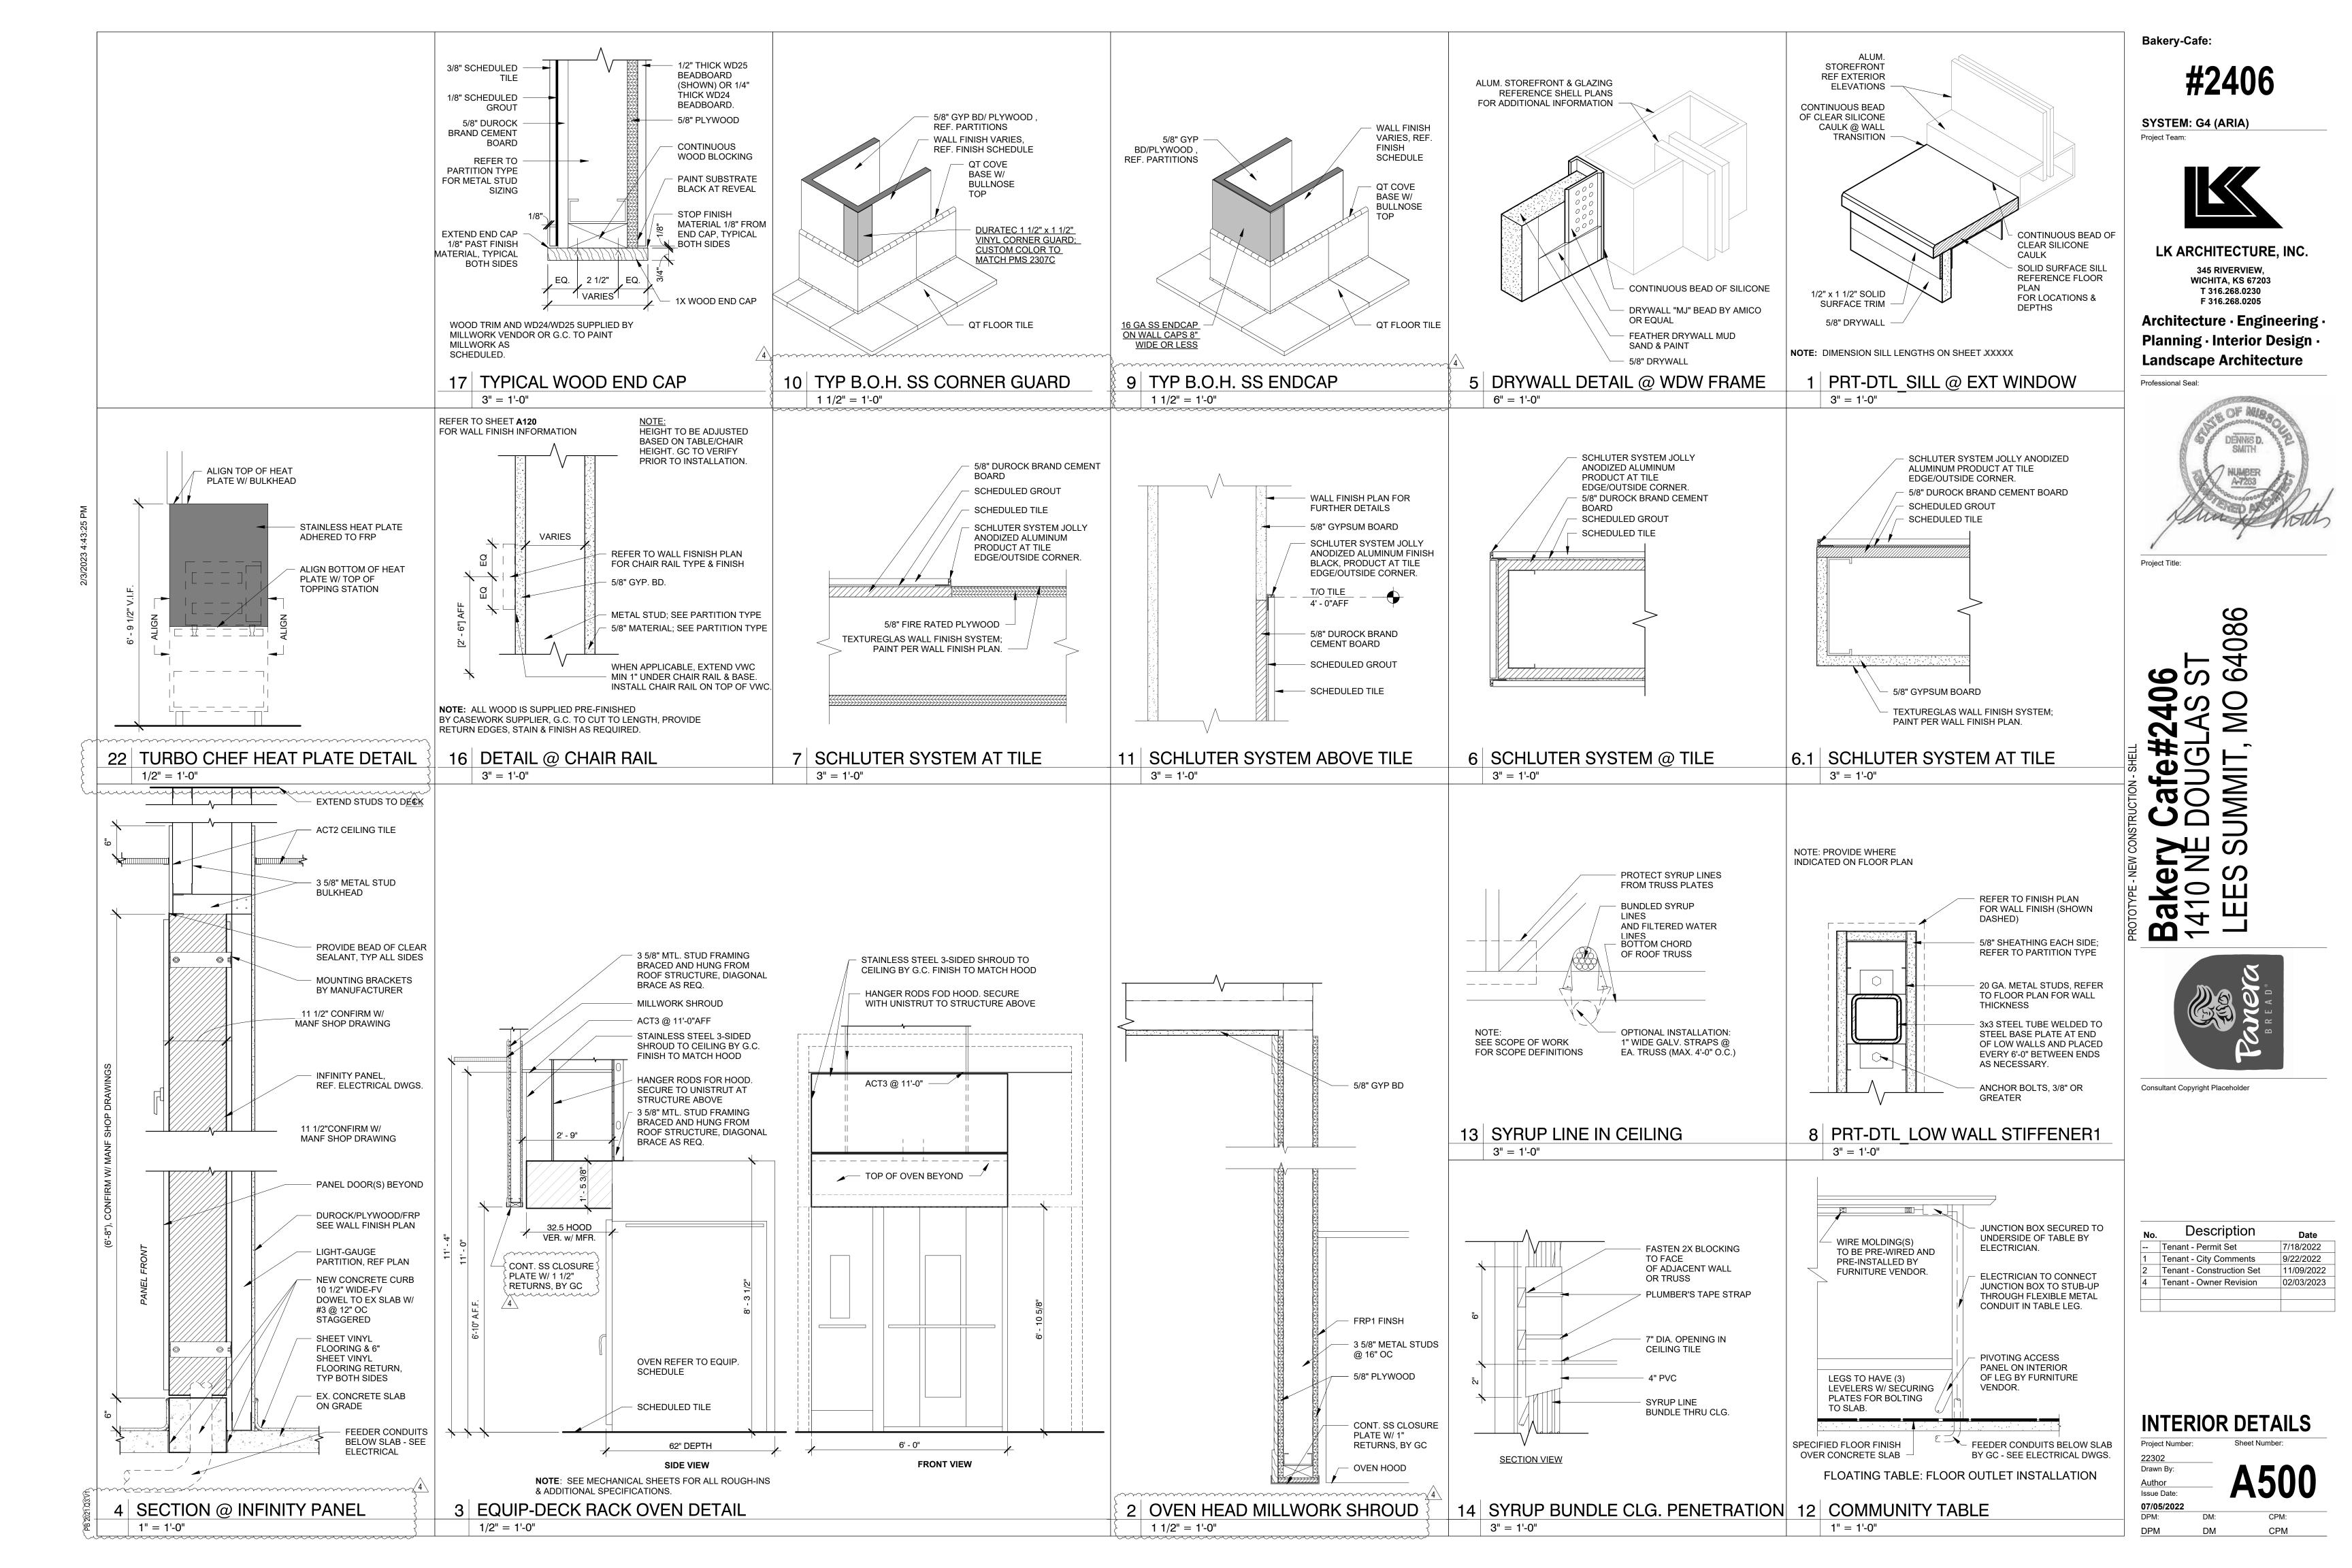

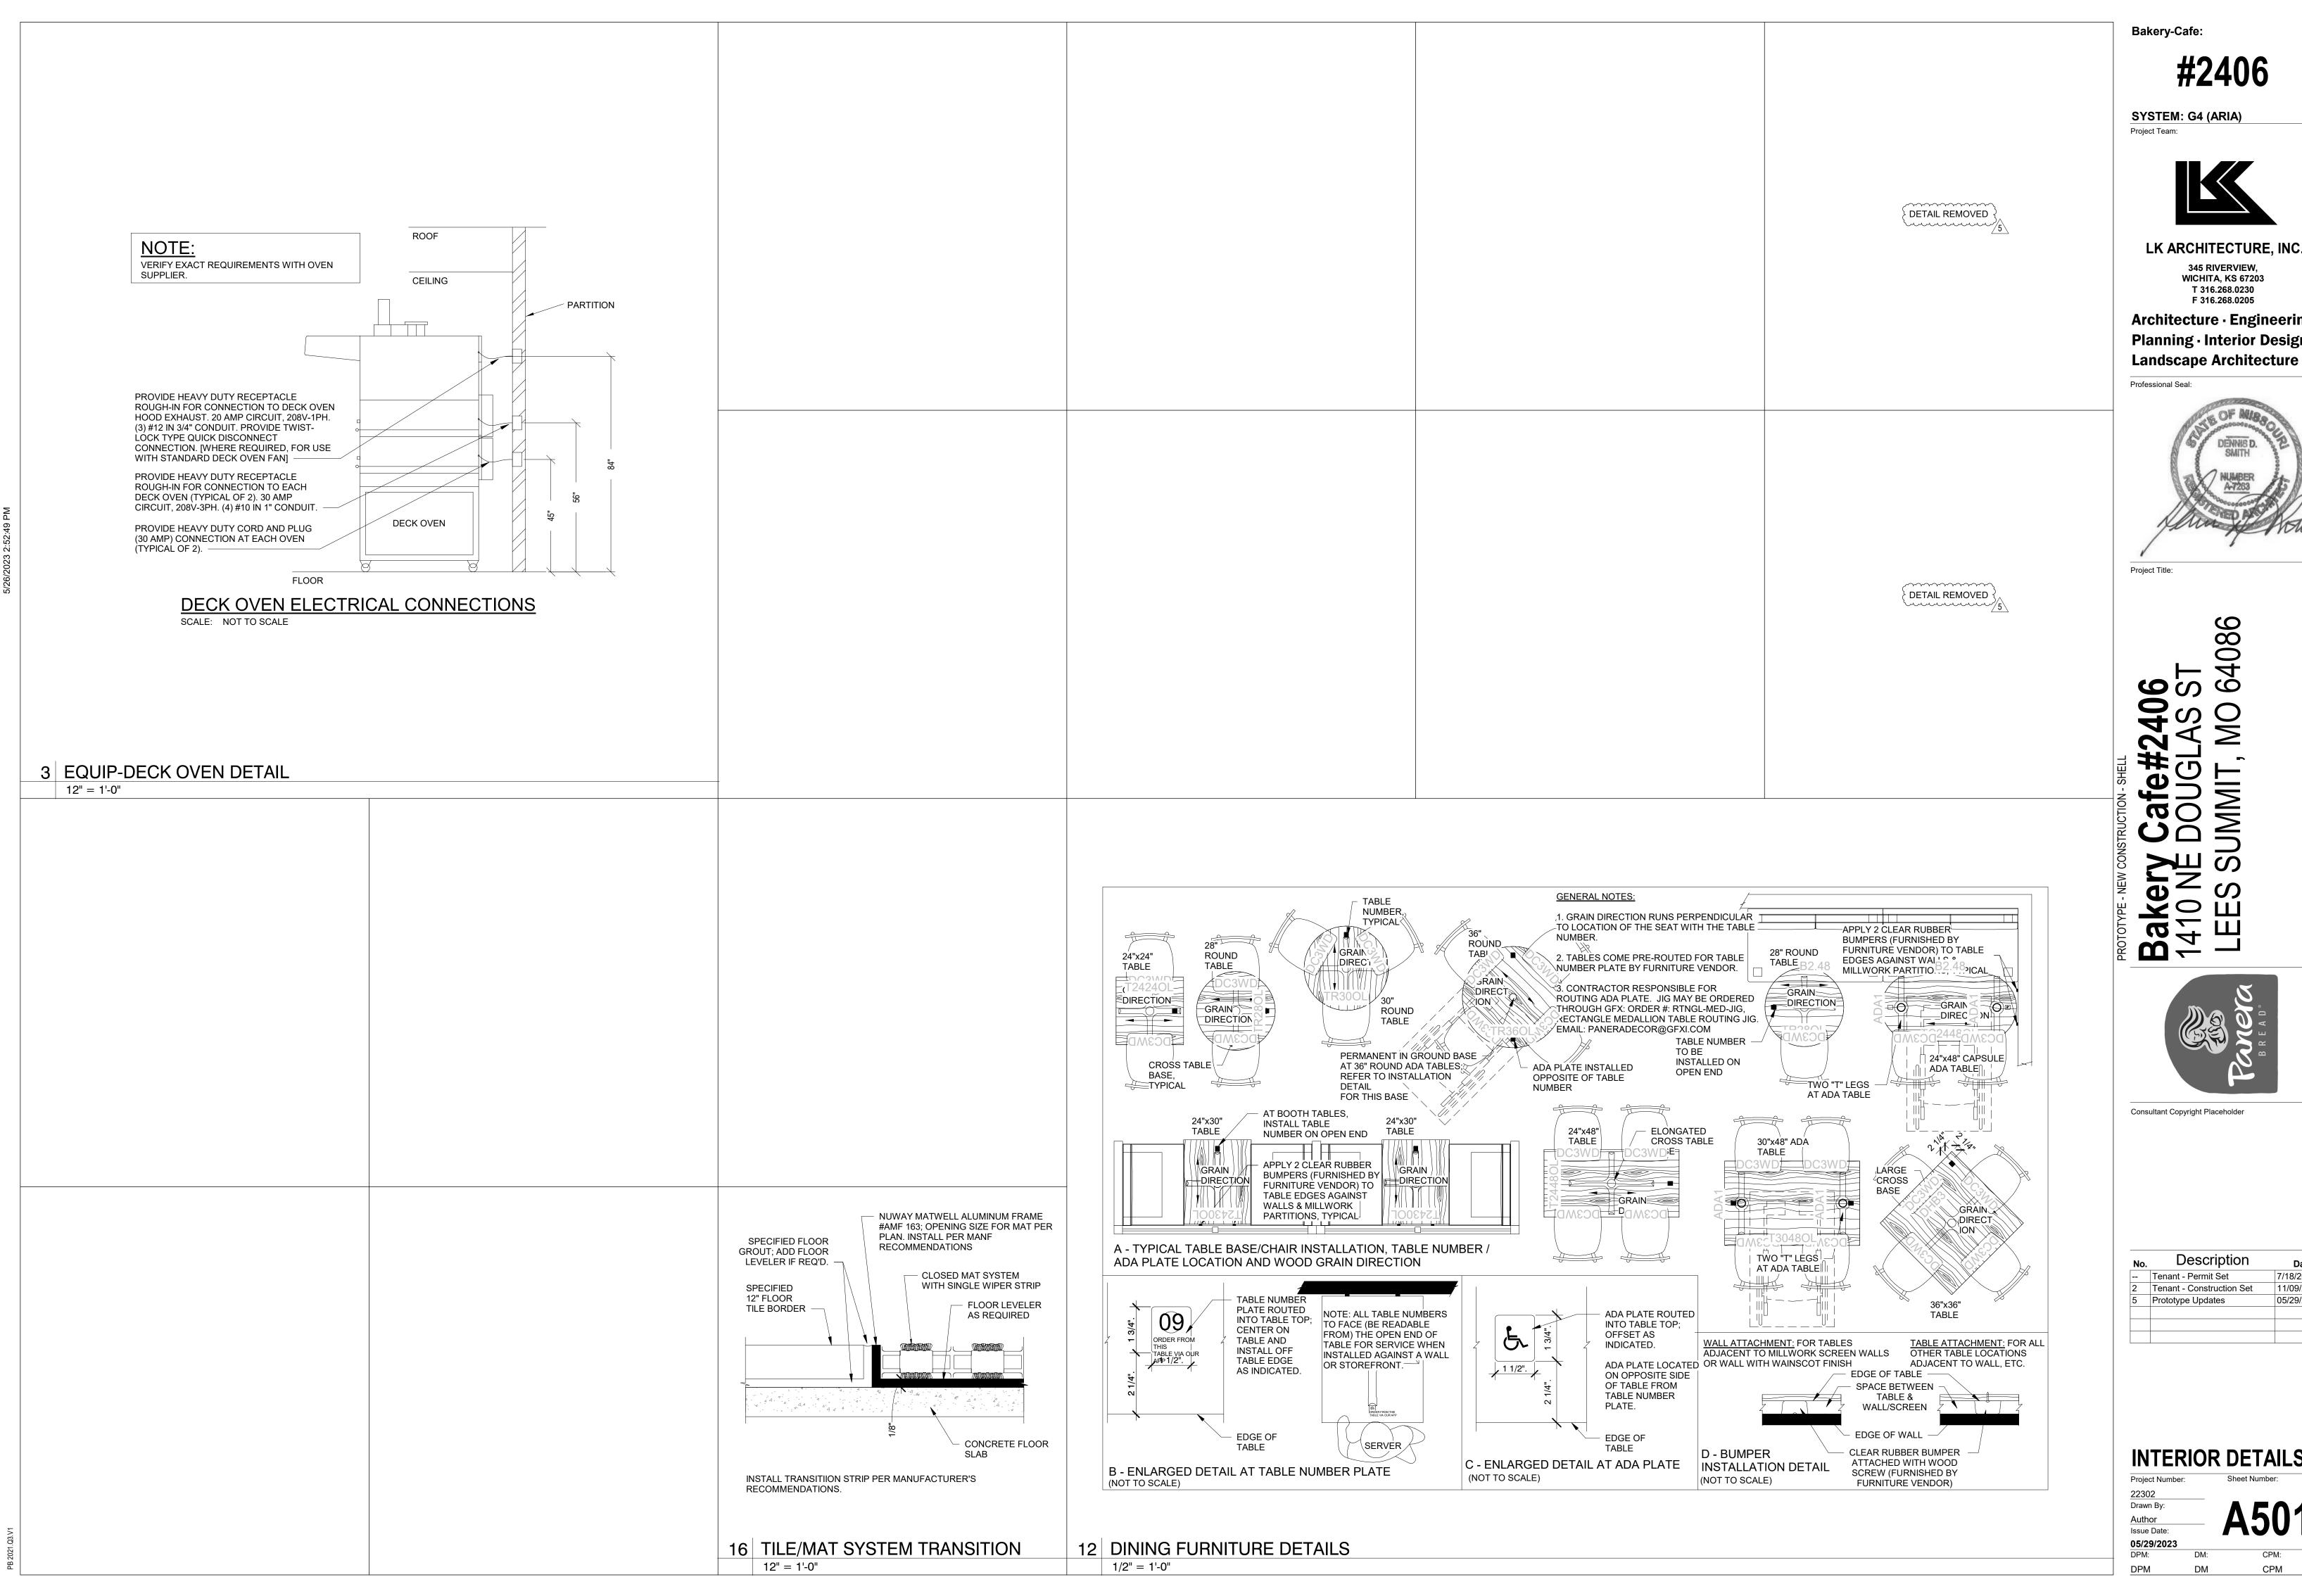


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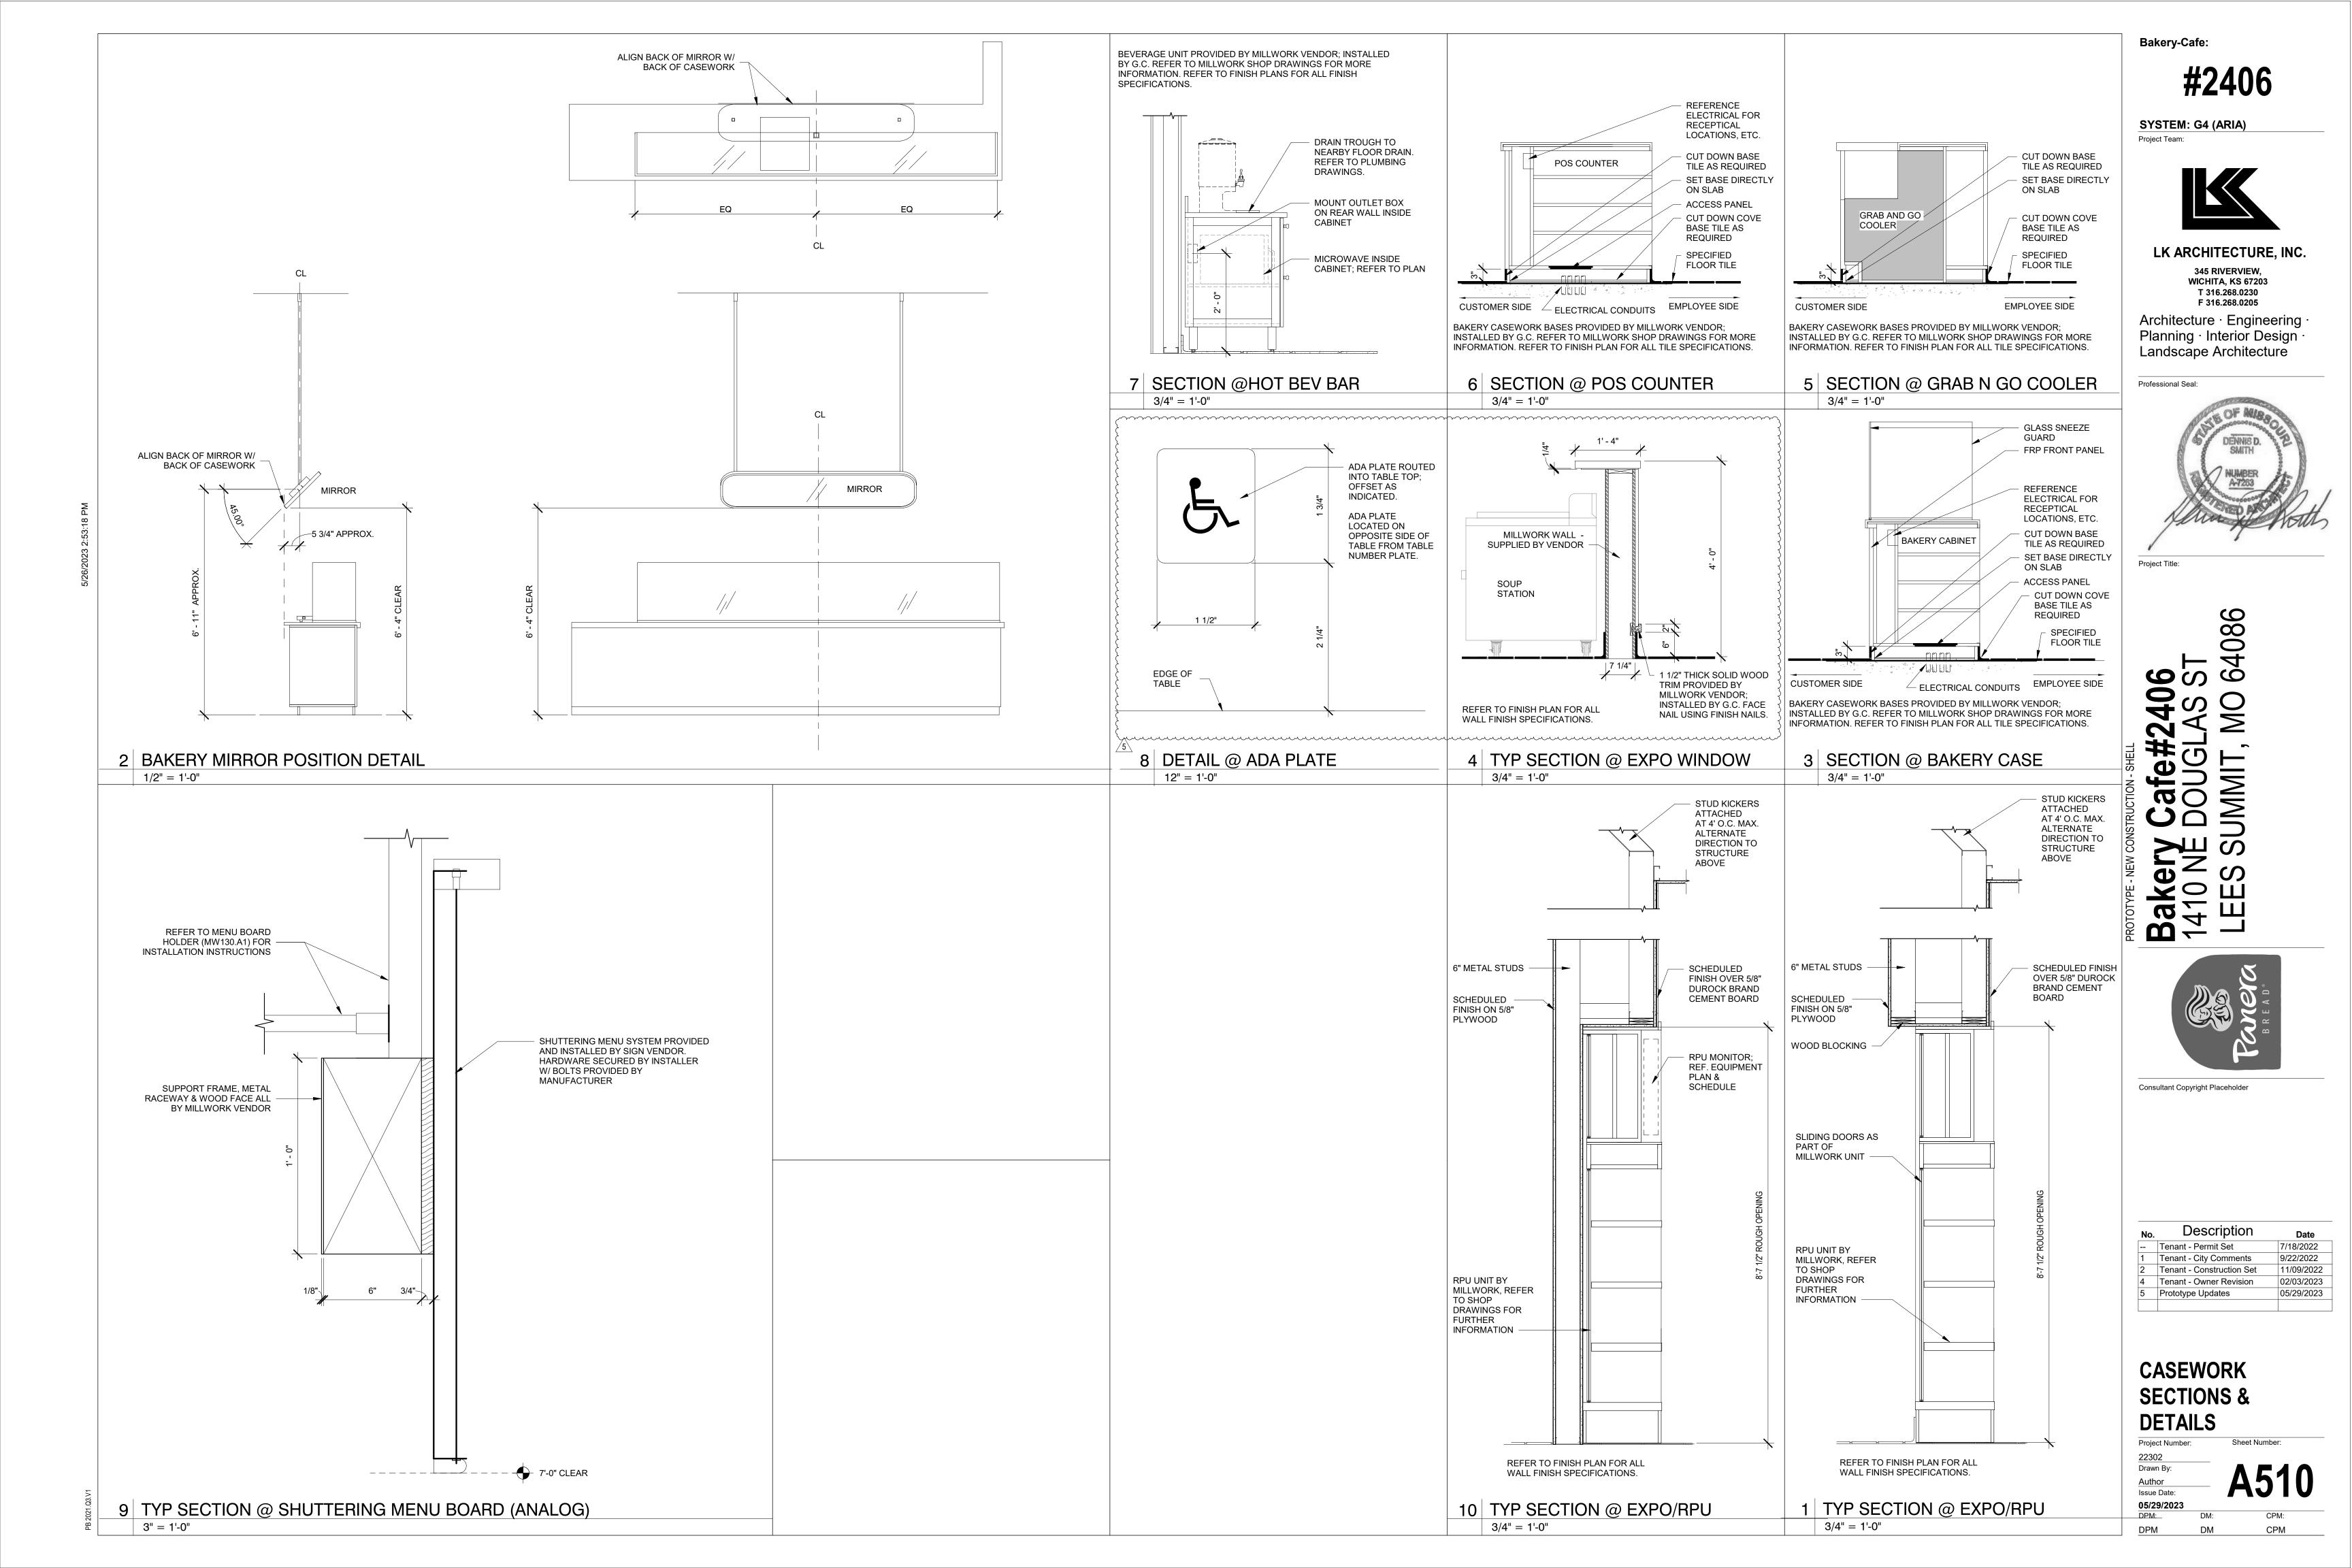
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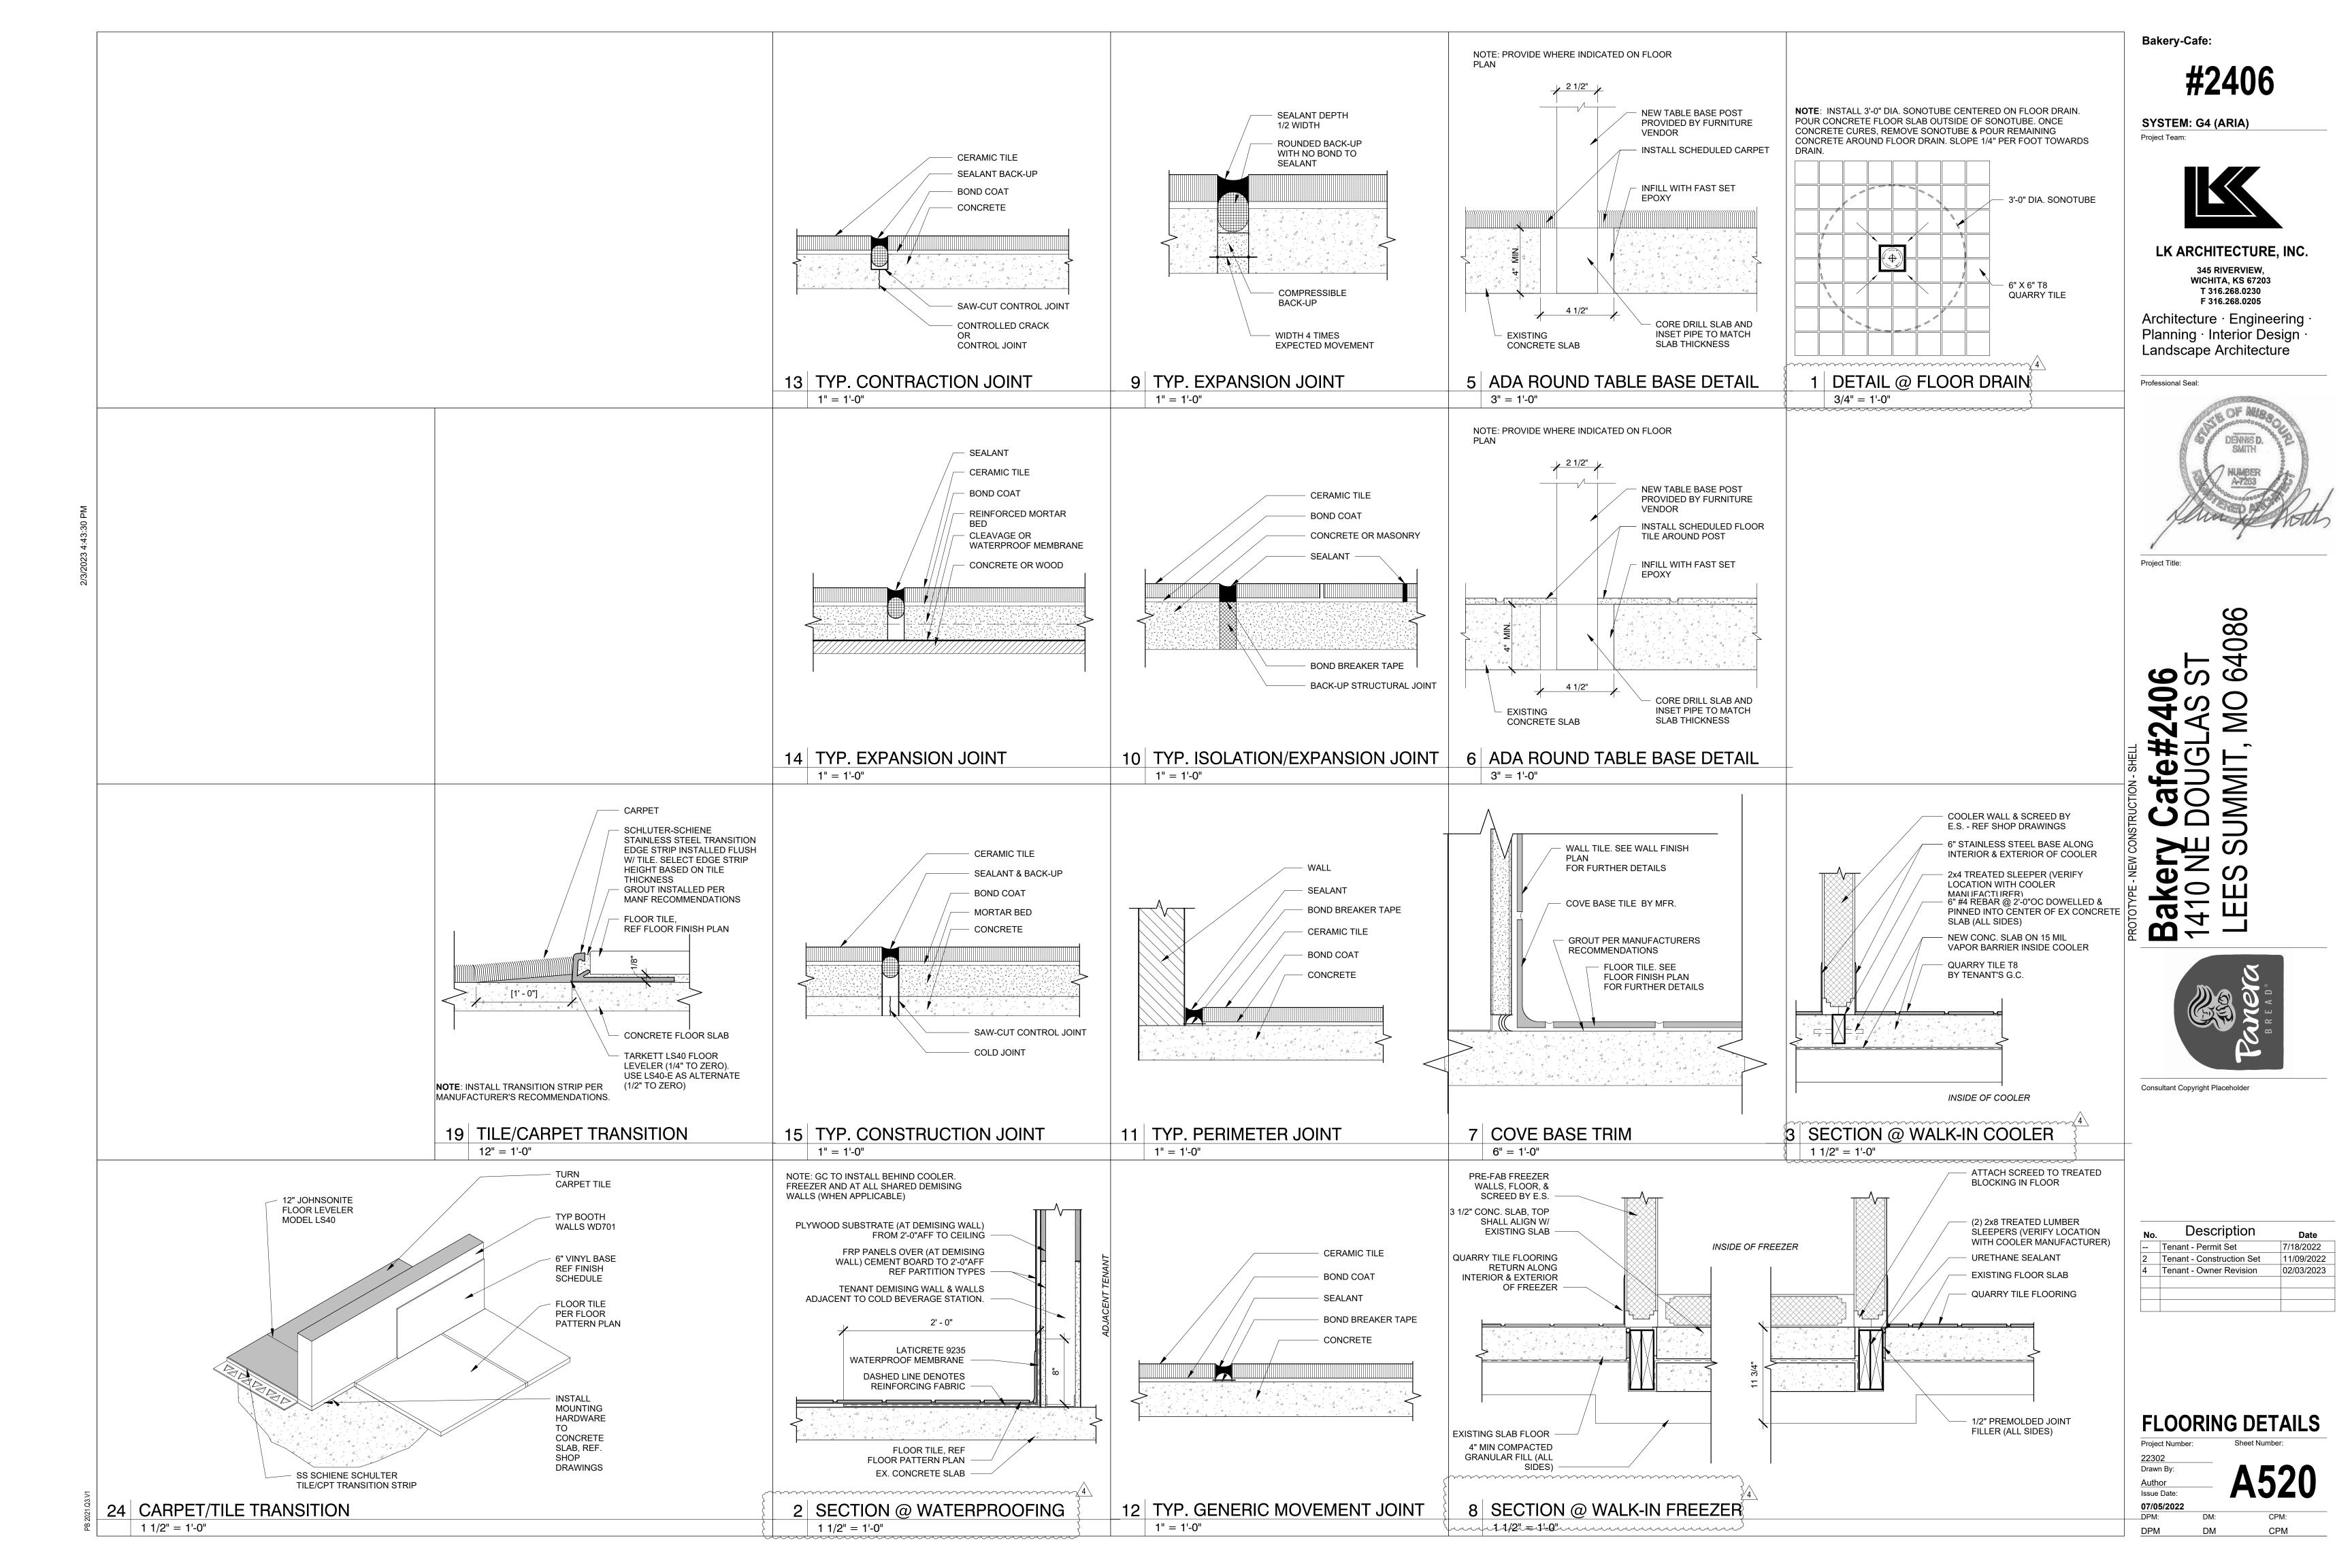


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**INTERIOR DETAILS** 



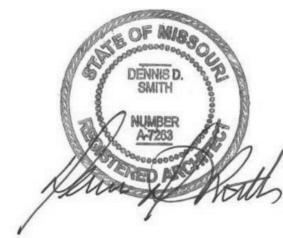

	FINISH SCHED			
NUMBER	DESCRIPTION	MANUFACTURER/DISTRIBUTO	R LOCATION	NOTES
T104B	COLOR: OXIDIZE; BROWN, SIZE: 12" X 24", LAYOUT/PATTERN: STACKED, BASE: COVE			
ACT1	USG FROST #414, SIZE 2' X 2' X 3/4"; EDGE: SLB; GRID: DX; GRID & TILE COLOR: MANILA #246 (PREFINISHED)	USG	DINING & CIRCULATION AREAS	
ACT3	USG SHEETROCK BRAND LAY-IN PANEL CLIMAPLUS, 2' X 4' VINYL, FINE TEXTURED, W/ ALUMINUM CAP GRID # 3270 COLOR: WHITE	USG	ВОН	
ACT6	USG FROST #414, SIZE 2' X 2' X 3/4"; EDGE: SLB; GRID: DX; GRID & TILE COLOR: SANDSTONE #090 (PREFINISHED)	USG	DINING & CIRCULATION AREAS	
ACT7	USG FROST #414, SIZE 2' X 2' X 3/4"; EDGE: SLB; GRID: DX; GRID & TILE COLOR: TAUPE #107 (PREFINISHED)	USG	DINING & CIRCULATION AREAS	
ACT8	USG FROST #414, SIZE 2' X 2' X 3/4"; EDGE: SLB; GRID: DX; GRID & TILE COLOR: STRAW #143 (PREFINISHED)	USG	DINING & CIRCULATION AREAS	
ACT9	USG FROST #414, SIZE 2' X 2' X 3/4"; EDGE: SLB; GRID: DX; GRID & TILE COLOR: FLAT WHITE #050 (PREFINISHED)	USG	DINING & CIRCULATION AREAS	
ACT10	ACCOUSTIC CEILING TILE - CIRRUS SECOND LOOK III - 2X4X3/4 EDGE: BEVELED TEGULAR FOR 9/16" GRID -ITEM #511, COLOR; WHITE, SIZE; 2'W X 4'L X 3/4"TH	ARMSTRONG	FOH	SUSPENSION SYSTEM SUPRAFINE 9/16" GRID
	WOOD FINISH OVER SERVICE LINE (TBD)  USG FROST #414, SIZE 2' X 2' X 3/4"; EDGE: SLB; GRID: DX; GRID & TILE COLOR:PARCHMENT #103	USG	SERVICE LINE	SUPRAFINE 9/10 GRIL
ACT14 ACT15	(PREFINISHED)  USG FROST #414, SIZE 2' X 2' X 3/4"; EDGE: SLB; GRID: DX; GRID & TILE COLOR. PARCHIMENT #103  USG FROST #414, SIZE 2' X 2' X 3/4"; EDGE: SLB; GRID: DX; GRID & TILE COLOR CHARCOAL #534	USG		
	(PREFINISHED) TEST CEILING, NOT ESTABLISHED	039		
BASE, BUM	IPERS, AND FRP	POOTON PETAII	PAKEDWIKITOHEN	
B1	1" BUMPER: ECOFLEX TFC10000-012 W/ BA1000 ALUM BASE, ER1000-012 END CAPS, CN1000-012 90DEG CORNER, CX1000-12 45DEG CORNER. FINISH COLOR: BLACK		BAKERY/KITCHEN	
B2	1" BUMPER: ECOFLEX TFC10000-193 W/ BA1000 ALUM BASE, ER1000-193 END CAPS, CN1000-193 90DEG CORNER, CX1000-193 45DEG CORNER. FINISH COLOR: POLAR WHITE		BAKERY/KITCHEN	
B3	1" BUMPER: ECOFLEX TFC10000-018 W/ BA1000 ALUM BASE, ER1000-018 END CAPS, CN1000-018 90DEG CORNER, CX1000-018 45DEG CORNER. FINISH COLOR: SILVER GRAY		BAKERY/KITCHEN	
FRP1	FIBERGLASS REINFORCED PANELS: GLASBORD-PIF (USE PCI IN CANADA), #85 WHITE, CLASS C FIRE RATED, THICKNESS 0.09", TEXTURE: PEBBLED EMBOSSED.		BACK OF HOUSE	
FRP10	FORMGLAS FRP, CUSTOM "FLUTED" PATTERN W/GELCOAT PAINT FINISH; COLOR: MATCH PMS 2307C, MATTE		EXTERIOR	
MB2 MT1	METAL COVE STRIP #DILEX-AHK, FINISH: ANODIZED ALUMINUM  METAL STRIP PROFILE #JOLLY, FINISH: AGRB, BRUSHED GRAPHITE ANODIZED ALUMINUM	SCHLUTER SCHLUTER	FRONT OF HOUSE	
VB1	RUBBER BASE: 0.80" THICK 6" BASE, COLOR: #8 BLACK	ALLSTATE	DINING & SMART ROOMS, CAFE	
VB2 WB	THERMOPLASTIC VINYL BASE: .125" THICK, 4.5" COVE BASE, COLOR: #949 VERDE WOOD BASE SUPPLIED BY CASEWORK SUPPLIER, INSTALLED BY G.C.	MANNINGTON COMMERCIAL	BAKERY/POS CARPET	
CARPET C5	STYLE: MAGNITUDE, COLOR: BLACK PEARL, SIZE 4X24 TILE, INSTALLATION: BRICK ASHLAR. (REMODEL	MANNINGTON COMMERCIAL	DINING AREAS	
C6	ONLY) STYLE: MATRIX, COLOR: MESA, SIZE 18X36 TILE, INSTALLATION: MONOLITHIC. (REMODEL ONLY)	SHAW / MATRIX MESA	DINING AREAS	
C9	STYLE: NIGHT FLIGHT, COLOR: ROCKY SHORE #105698, SIZE: 19.69"x19.69" TILE, INSTALLATION: QUARTER TURNED (REMODEL ONLY)	INTERFACE	DINING AREAS	
C12	CARPET - SIZE: 24"W x 24"L; ROUGH IDEA SHEAR - ENTRY WAY TILE WITH AFIRMA HARDBACK, COLOR PLOT 800118;	BENTLEY MILLS	ENTRY	
TILE/GROU NOTE	, , , , , , , , , , , , , , , , , , ,			GROUT #:
NOIE	SANDED.			(S)ANDED/(U)NSANDEI JOINT SPACING
DECORATI T49	VE TILE COLOR: FRENCH CLAY; BRONZAGE, SIZE: 4"X12", LAYOUT/PATTERN: 1/3 RUNNING BOND	TRANSCERAMICA	WALL   RESTROOM	G14; (U); 1/8"
T101 T102	COLOR: FORGED; OLIVE GREEN, SIZE: 2.5" X 9.5", LAYOUT/PATTERN: STACK BOND  COLOR: ZELIGE; SPECKLED TAUPE, SIZE: 5" X 5", LAYOUT/PATTERN: STACK BOND	CREATIVE MATERIALS WOW TILE	WALL   FEATURE COLOR WALL   FEATURE WHITE	G14; (US); 1/4"
T103	COLOR: SANTIAGO BLEND, SIZE:3 5/8" X 11 5/8", LAYOUT/PATTERN: STACK BOND	CREATIVE MATERIALS	WALL   FEATURE BRICK	G27; (US); 1/8" G25; (US); 3/8"
T104 T105	COLOR: OXIDIZE; BROWN, SIZE: 12" X 24", LAYOUT/PATTERN: STACKED, BASE: COVE COLOR: ARID GRAY, SIZE: 6" X 6", LAYOUT/PATTERN: STACKED, BASE: COVE	CREATIVE MATERIALS DALTILE	FLOOR   DINING FLOOR   KITCHEN	G28; (US); 1/4" G28; (US); 1/4"
T106 T107	COLOR: BLAZE; DECOR YELLOW, SIZE: 4" X 12", LAYOUT/PATTERN: STACK BOND COLOR: BLAZE; DECOR PINK, SIZE: 4" X 12", LAYOUT/PATTERN: STACK BOND	TRANSCERAMICA TRANSCERAMICA	WALL   ACCENT	
T108 GROUT	COLOR: MATTE-TAUPE, SIZE: 8" X 8 ", LAYOUT/PATTERN: STACKED	CREATIVE MATERIALS	FLOOR   KITCHEN	
G1	COLOR: 39; IVORY. ALTERNATE: LATICRETE GROUT COLOR: 39 MUSHROOM	MAPEL		
G8 G14	COLOR: 09; GRAY. ALTERNATE: LATICRETE GROUT COLOR: 35 MOCHA COLOR: 47; CHARCOAL. ALTERNATE: LATICRETE GROUT COLOR: 45 RAVEN	MAPEI MAPEI		
G25 G27	COLOR: 58; TERRACOTTA COLOR: 00; WHITE	LATICRETE MVIS MORTAR MAPEI		
G28 GX	COLOR: 35; NAVAJO BROWN TEST GROUT, NOT ESTABLISHED	MAPEI		
	ERING NOTES TEXTURGLAS FINAL FINISH TO INCLUDE SCHEDULED PAINT COLOR			
WALL COVI		ROOS INTERNATIONAL	FOH	SHOIW PAINT # HERE
WC2	WALL TEXTURE; TEXTURGLAS, STYLE: TG7550; CROISINE (CLASS A FIRE RATING)	ROOS INTERNATIONAL	FOH	SHOIW PAINT # HERE
WC3 WC7	WALL TEXTURE; TEXTURGLAS, STYLE: TG7710; CREPINE FLORTINES (CLASS A FIRE RATING) STYLE: ALPHA (7998/4755); COLOR: BIG SUR	ROOS INTERNATIONAL MDC	FOH   MAIN	SHOIW PAINT # HERE
WC8 WC9	STYLE: ALPHA (7997/4755); COLOR: EVERGREEN STYLE: BETA (18813/4755); COLOR: DURATEC-PANERA GREEN	MDC MDC	FOH   ACCENT	
	CORNER GUARD; STYLE: BETA (18813/4755); COLOR: DURATEC-PANERA GREEN STYLE: ALPHA (8129); COLOR: DASH-ING CREAM	MDC MDC		
WC17 WC18	STYLE: ALPHA (7867/4755); COLOR: GOLD FROST (REMODEL ONLY) STYLE: DURATEC INTREPID (1086/4755); COLOR: CREME BRULEE	MDC MDC		
WC19 MISCELLAN	(REMODEL ONLY) STYLE: DURATEC IRONWOOD (1022/4755); COLOR: BEECHNUT	MDC		
	SPLIT FACE CMU - 4"X12"X24", CHISELED FACE WITH INTEGRAL COLOR: ARRISCRAFT RENNAISSANCE MASONRY UNIT, COLOR: SANDDRIFT, FINISH: PRESS HAMMERED		TRASH ENCLOSURE	
GL1	EUROPEAN CLEAR, TREE BARK, 5/32" THICKNESS SINGLE PANE GLASS	BENDHEIM SEEDED	INTERIOR SCREEN WALLS	
GL2 GL5	SEEDED, SINGLE PANE GLASS TEXTURED GLASS; REEDED. COLOR: LOW IRON	PILKINGTON	INTERIOR SCREEN WALLS	
IG IGS	1" INSULATED CLEAR GLAZING TYPICAL  1" INSULATED SPANDREL GLAZING TYPICAL, COLOR: BLACK		STOREFRONT STOREFRONT	
MTL8 TREX	METAL BASE FOR MILLWORK TREX PLYWOOD, COLOR: SADDLE	CHEMETAL TREX	MILLWORK TRASH GATE	
TREX2 WOOD	TREX PLYWOOD, COLOR: WINCHESTER GREY	TREX	UTILITY SCREEN	
WD24 WD25	1/4" BEAD BOARD PANELING, 3" 'V' GROVE O.C.; PRIMED (WHITE) & PAINTED IN THE FIELD 1/2" BEAD BOARD PANELING, 3" 'V' GROVE O.C.; PRIMED (WHITE) & PAINTED IN THE FIELD	MILLWORK VENDOR MILLWORK VENDOR	FOH FOH	
WD30	WHITE OAK, NATURAL, WIRE BRUSHED; FINISH: DEAD FLAT	MILLWORK VENDOR	MILLWORK	
	WHITE OAK, NATURAL; FINISH: DEAD FLAT WHITE OAK, DARK STAIN; FINISH: DEAD FLAT	MILLWORK VENDOR MILLWORK VENDOR	MILLWORK MILLWORK	
	WHITE OAK, BLACK STAIN; FINISH: SMOOTH WHITE OAK; COLOR: GALLATIN	MILLWORK VENDOR MILLWORK VENDOR	MILLWORK MILLWORK	
WDX2 PAINT NOT	WHITE OAK; COLOR: WIND RIVER	MILLWORK VENDOR	MILLWORK	
	INTERIOR PAINT: USE FRESH START PRIMER 02300 (WARM). USE SEMI-GLOSS FINISH IN FOOD SERVICE AREAS. USE EGSHELL FINISH FOR ALL OTHER WALLS AND RESTROOM. USE SATIN FINISH			
	ON INTERIOR DOORS & FRAMES. EXTERIOR EIFS: TOP COAT TO MATCH UNIDENTIFIED BENJAMIN			
	MOORE PAINT COLOR. VERSITRIM FASCIA: MATCH BENJAMIN MOORE PAINT AT WALL BELOW, POST		The second secon	1
PAINT				
PAINT P99 P160	MOORE PAINT COLOR. VERSITRIM FASCIA: MATCH BENJAMIN MOORE PAINT AT WALL BELOW, POST COATED, KYNAR 500 OR EQUAL PAINT.  FAIRVIEW TAUPE; #HC-85	BENJAMIN MOORE BENJAMIN MOORE		
P99 P160 P166	MOORE PAINT COLOR. VERSITRIM FASCIA: MATCH BENJAMIN MOORE PAINT AT WALL BELOW, POST COATED, KYNAR 500 OR EQUAL PAINT.  FAIRVIEW TAUPE; #HC-85 SHALE; #861 CHEATING HEART; #1617	BENJAMIN MOORE BENJAMIN MOORE		
P99 P160 P166 P224 P278	MOORE PAINT COLOR. VERSITRIM FASCIA: MATCH BENJAMIN MOORE PAINT AT WALL BELOW, POST COATED, KYNAR 500 OR EQUAL PAINT.  FAIRVIEW TAUPE; #HC-85 SHALE; #861 CHEATING HEART; #1617 DRAGON'S BREATH; #1547 MONTEREY WHITE; #HC-27	BENJAMIN MOORE BENJAMIN MOORE BENJAMIN MOORE BENJAMIN MOORE		
P99 P160 P166 P224 P278	MOORE PAINT COLOR. VERSITRIM FASCIA: MATCH BENJAMIN MOORE PAINT AT WALL BELOW, POST COATED, KYNAR 500 OR EQUAL PAINT.  FAIRVIEW TAUPE; #HC-85 SHALE; #861 CHEATING HEART; #1617 DRAGON'S BREATH; #1547	BENJAMIN MOORE BENJAMIN MOORE BENJAMIN MOORE		
P99 P160 P166 P224 P278 P285	MOORE PAINT COLOR. VERSITRIM FASCIA: MATCH BENJAMIN MOORE PAINT AT WALL BELOW, POST COATED, KYNAR 500 OR EQUAL PAINT.  FAIRVIEW TAUPE; #HC-85  SHALE; #861  CHEATING HEART; #1617  DRAGON'S BREATH; #1547  MONTEREY WHITE; #HC-27  BLACK BEAUTY; #2128-10	BENJAMIN MOORE BENJAMIN MOORE BENJAMIN MOORE BENJAMIN MOORE BENJAMIN MOORE		
P160 P166 P224 P278 P285 P290 P291	MOORE PAINT COLOR. VERSITRIM FASCIA: MATCH BENJAMIN MOORE PAINT AT WALL BELOW, POST COATED, KYNAR 500 OR EQUAL PAINT.  FAIRVIEW TAUPE; #HC-85 SHALE; #861 CHEATING HEART; #1617 DRAGON'S BREATH; #1547 MONTEREY WHITE; #HC-27 BLACK BEAUTY; #2128-10 AVOCADO; #2145-10 BAJA DUNES; #997	BENJAMIN MOORE		

	FINISH SCHEE	DULE		
NUMBER	DESCRIPTION	MANUFACTURER/DISTRIBUTOR	LOCATION	NOTES
UPHOLSTE	ERY			
F133	VACATION; CANYON	FIL DOUX		
F177	KIEV; CASTLE	POLLACK		
F178	RE-FLE; INK WASH	POLLACK		
F185	FLOCK; NETTLE	MOMENTUM		
F187	FLOCK; FERN	MOMENTUM		
F188	FLOCK; HEARTH	MOMENTUM		
F189	FLOCK; FORREST	MOMENTUM		
S10	REIN; SABLE	DESIGNTEX		
S11	REIN; CLAY	DESIGNTEX		
S57	BOUNTY; COFFEE	FIL DOUX		
S69	DIMA; NIGHTFALL	FIL DOUX		
S73	CASSIDY 2.0; PELICAN	CF STINSON		
S74	CASSIDY 2.0; JUNGLE	CF STINSON		
S75	BOUNTY; COCAO	FIL DOUX		
SOLID SUF	RFACING The state of the state			
SS23	CORIAN, COLOR: RAIN CLOUD	CORIAN	SILLS ONLY	
SS40	STYLE: DALMATA; TERRAZZO, COLOR: TERRAZZO MATRIX 412	FORMICA	COUNTER/TABLE TOPS	
SS41	STYLE: LUNA, COLOR: SAIL WHITE	FORMICA	PICK-UP SHELVES	
LAMINATE	S			
L104	WILSONART 1500 - 60 GREY	WILSONART	KITCHEN DOOR	
L105	4155 PEWTER	FORBO	TABLE TOPS	
L107	0717 CASTORO OTTAWA	FENIX	CONSOLIDATION SCREENS	
L108	0724 GRIGIO BROMO	FENIX	CONSOLIDATION / BAKERY	
L109	0750 VERDE COMODORO	FENIX	CONSOLIDATION SCREENS	
L110	4132 ASH	FORBO	TABLE TOPS	
L111	4178 IRON	FORBO	TABLE TOPS	
L112	4166 CHARCOAL	FORBO	TABLE TOPS	
L113	4184 OLIVE	FORBO	TABLE TOPS	
LX	TEST LAMINATE, NOT ESTABLISHED			
BRICK				
BR-1	BRICK - THIN, SIZE: 3-5/8"W X 3/4"TH X 11-5/8"L, COLOR: SANTIAGO CREATIVE MATERIALS BLEND	MCNEAR BRICK & BLOCK	EXTERIOR	
PAVING ST	ONE			
PV-1	HOLLAND PAVING STONE (FIELD), COLOR: RUSTIC RED, PATTERN: HERRINGBONE RECTANGULAR	UNILOCK	OUTDOOR CAFE - FIELD	
EXTERIOR		1		
EF-5	GREEN .SUNBRELLA COLOR: LEAF GREEN; PMS 2411C	SUNBRELLA	AWNING	
EF-6	SLATE. SUNBRELLA COLOR: CHARCOAL; PMS 7540C	SUNBRELLA	AWNING	
		+		

 $\cdots$ 

#### GC ORDERED/COORDINATED ITEMS:

TRANSCERAMICA TILE

EXTERIOR PRODUCTS

AMERISTAR RAILING

(METAL CANOPIES)

MICHAEL CALDERONE

312-506-2856

312-342-4689

JASON GOINS

800.321.8724

813-925-0144

214-232-0079

LIGHTING

JAN WERNER (MAIN CONTACT)

JWERNER@TRANSCERAMICA.COM

NOREEN SCHERTLER (BACKUP)

JASON.GOINS@ASSAABLOY.COM

API (AMERICAN PRODUCTS, INC.)

AWNING & SIGN CONTRACTORS

JSTEMPIEN@BEAGLEONEINC.COM

JOE STEMPIEN: 260-243-6751

DURO-LAST ROOFING, INC.

MOLLY GEHRIS: 989-758-6344

MGEHRIS@DURO-LAST.COM

CHOWARD@TENSHON.COM

(DECORATIVE LIGHTING)

(ROOFING MEMEBRANE)

TENSHON CANOPY

**CULLIN HOWARD** <u>480-663-3166</u>

DOLAN LIGHTING

MICHELLE WEIR

TAMMY MCARTHUR

(LIGHTING FIXTURES)

UTILITY/SECURITY

(HOT WATER HEATER)

704-364-9029 (EXT 228)

BECKYB@CPIPANELS.COM

TONYT@CPIPANELS.COM

HSHEPHERD@NUCO2.COM

800-472-2855 (EXT 3446)

REED STRUTZENBERG

JOHANNA DELONG

BSILAS@NUCO2.COM

PLAYNETWORK

425.531.1513

425-629-2725

HEATHER SHEPHERD

ELECTRICAL CONTROL PANEL

888.506.7383

206.268.3429

978-661-1854

AO SMITH

JEFF GERSTAL

**BECKY BARHAM** 

TONY THORNTON

704-608-8828

919-795-8676

TINA SILAS

NUCO2

412-471-6984

MCALDERONE@AMERICANPROD.COM

TOM ARMSTRONG: 888-665-1521 / 317-409-9440

KNEADSUPPORT@DOLANHOSPTITALITY.COM

TMCARTHUR@DOLANHOSPITALITY.COM

STANDARD ELECTRIC SUPPLY CO.

PANERA@STANDARDELECTRIC.COM

**INTERIOR FINISH** BENJAMIN MOORE - NATIONAL ACCOUNT PANERA ACCT # - NA229 CUSTOMER CARE - 877-623-8484 OPTION 3 FOR MORE INFO

EF-7 SAND. SUNBRELLA COLOR: SAND: PMS 9184C

CRANE COMPOSITES (ASK FOR GLASBOARD) (FIBERGLASS REINFORCED PLASTIC) RYAN MINATO - NATIONAL ACCT. 815.467.8951 PANERAFRP@CRANECOMPOSITES.COM CONTACT FOR STOCKING DISTRIBUTOR APPROVED COLORS: WHITE (85) AND BEIGE (70)

CROSSVILLE (TILE RENOVATION ONLY) DENNIS HOPKINS 704-576-4953 DHOPKINS@CROSSVILLE.INC

877-556-5728 NATIONAL.ACCOUNTS@DALTILE.COM JOANNA WHITTAKER (MAIN CONTACT) 314-629-0125 JOANNA.WHITTAKER@DALTILE.COM

DESIGN & DIRECT SOURCE (TILE)

**BRITTANY HAM** 503-882-0687 BRITTANY@DESIGNANDDIRECTSOURCE.COM

FIRECLAY TILE CAITLYN CHILD: 971-570-2330 / 800-773-2226 x1025 CAITLYN@FIRECLAYTILE.COM ERIC EDELSON: 971-941-5493

INTERFACE CARPET (CARPET) DENNIS ÚPSHAW: 314-378-3197 DENNIS.UPSHAW@INTERFACE.COM STEVE SWEETIN: 913-707-0787 STEVE.SWEETIN@INTERFACE.COM

ERIC@FIRECLAYTILE.COM

MANNINGTON CARPET ERIC DEMINICO ERIC.DEMINICO@MANNINGTON.COM KRISTEN KOMIS 314.250.3040 KRISTEN.KOMIS@MANNINGTON.COM

MATS, INC. (ENTRY MATS) **ROSS BECKER** 508.326.3665 781.436.7525 RBECKER@MATSINC.COM

METROPOLITAN QUARRY BASICS (QUARRY TILE) DIANNE YOUNG 877-358-1970 DYOUNG@IRONROCK.COM

WWW.METROCERAMICS.COM

ROOS INTERNATIONAL (TEXTURGLAS) DEBORAH & DICH ROOS 800-888-2776 / 954-429-3883 DEBORAH@ROOSINTL.COM DICH@ROOSINTL.COM WWW.ROOSINTL.COM

SHAW CARPET

RYAN BEANS

508.277.5487

508.528.0886

(CARPET) TIFFANY PURVIS 706.532.7407 TIFFANY.PURVIS@SHAWINC.COM SMARTSTEP FLOORING BRUCE BEANS 508.528.0886 (OFFICE) 774.571.7454 (CELL) BBEANS@COMCAST.NET

RYAN@SMARTSTEPFLOORINGINC.COM

UAS (SECURITY SYSTEM) MARY ANN SHEILDS (800) 421-6661 EXT 1230 MARYANN.SHIELDS@UAS.COM

JDELONG@PLAYNETWORK.COM

SOUND SYSTEM (PANERA ORDERED)

RSTRUTZENBERG@PLAYNETWORK.COM

RESTOOMS BOBRICK TOILET ACCESSORIES (518) 877-7444

SUNBRELLA

ESSITY PROFESSIONAL HYGIENE (FORMERLY SCA) (PAPER TOWEL/TOILET PAPER DISPENSERS) **BRYAN YOUNG** PHONE +1 303 470 8394 MOBILE +1 720 272 8037 BRYAN.YOUNG@ESSITY.COM

AWNING

**GENERAL PARTITIONS** SUSAN MARCH (573) 696-0178 (P) (573) 696-0071 (F) (573) 489-7495 (C) SMARCHCOMPANY@GMAIL.COM GENERALPARTITIONS.COM

KJA INC. GLOBAL PARTITIONS - SALES REPRESENTATIVES ST. LOUIS JENNIFER WELLS / PRESIDENT CELL: 314-614-3562

TOTO USA (RESTROOM FIXTURES) PETER STANGEL C:415-652-6743 PSTANGEL@TOTO.COM WWW.TOTOUSA.COM

JENNIFER@KJAINC.COM

**MISCELLANEOUS** ARMSTRONG/TECTUM CLG PANELS LISA CAVATAIO 773.882.0299

LYCAVATAIO@ARMSTRONGCEILING.COM

**BIG ASS FANS** (CEILING FANS) JIM VINCENT 859-899-1337(O)

859-519-7467(M)

**BOSTON GROUP** (BOSTON BUMPER GUARDS) DEBBIE MCNEILL: 708-639-2849 D.MCNEILL@BOSTON-GROUP.COM MARK MUCHA: 708-306-4114 M.MUCHA@BOSTON-GROUP.COM

CARDINAL ACOUSTICS, INC. (ACOUSTICAL PANELS) WILLIAM KHOURIE (PRESIDENT) 614-721-3001(O) 614-496-3623(M) CARDINALACOÚSTICS.COM

HILSON INC. (ROLLER BLINDS) MARSHA JONES 314-773-8883

**IMRIE-GIELOW** (MARINITE) CONTACT: CYNTHIA VENT 314.772.4200 CVENT@IMRIEGIELOW.COM MATS INC. (WALK-OFF MAT)

NATIONAL ACCOUNT 800-628-7462 / 781-344-1536 JOHN DUNBAR: 7718-964-5373 JDUNBAR@MATSINC.COM QUIKSERV CORP. (DRIVE-THRU WINDOWS)

**BRIAN MCCLOSKEY** 

713-849-5882(O) 832-792-2646(M) QUICKSERV.COM **VICTORIAN SALES** (FIREPLACE) LAURIE COOK 636-343-4747

LAURIE@VICTORIANSALES.COM

**GENERAL NOTES:** 

- A. CORNER GUARDS TO BE INSTALLED AT ALL OUTSIDE
- ROOM FINISH SCHEDULE & SHEETS FOR LOCATIONS. C. G.C. TO LEAVE ON SITE, UPON COMPLETION OF JOB, (1) BOX EACH OF ALL WALL, FLOOR, CARPET TILE & CEILING TILE
- MEET 70% LIGHT REFLECTIVE VALUE OR GREATER. PAINT FINISHES: INTERIOR PAINT TO BE BENJAMIN MOORE, REGAL SELECT. CEILINGS AND SOFFITS ARE TO BE FLAT, WALLS IN DINING AND GENERAL AREAS TO BE LOW LUSTER (EGGSHELL), WALLS IN KITCHEN AND BATHROOM, IF PAINT
- SURFACE AT FOH. EXTERIOR EIFS PAINT TO BE BENJAMIN MOORE, REGAL SELECT, EXTERIOR LOW LUSTER. EXTERIOR SEALANT TO
- ROLLER SHADES: MANUFACTURER DRAPER, OPERATING MECHANISM - MANUAL FLEX SHADE W/ STAINLESS STEEL BEAD CHAIN CLUTCH OPERATOR & WEIGHTED BAR @ BOTTOM, FABRIC - SHEER WEAVE SERIES 4100 "GREYSTONE" BY PHIFER @ CLEAR ANODIZED ALUMINUM STOREFRONT & SHEER WEAVE SERIES 3000 "CHOCOLATE" BY PHIFER @ BRONZE ALUMINUM STOREFRONT. SET UPPER AND LOWER TRAVEL LIMITS BY INSTALLING STOP BALLS TO BEAD CHAIN (CRIMP CLOSED USING PLIERS), PER MANUFACTURER'S RECOMMENDATIONS. USE STOP BALLS PROVIDED IN HARDWARE PACKET BY DRAPER, DO NOT SUBSTITUTE HARDWARE BY OTHERS AS THIS MAY INTERFERE WITH CLUTCH MECHANISM. MOUNT HOLDER CLIP FOR CHAIN ON MULLION AT 54" AFF, TYP. NOTES CONTAINING AN "X" REFER

- CORNERS IN KITCHEN, BAKERY (1 1/2" X 1 1/2" STAINLESS STEEL). SUPPLIED AND INSTALLED BY G.C.
- B. NOT ALL FINISHES IN SCHEDULE OF FINISHES ARE NECESSARILY INCLUDED IN THIS SCOPE OF WORK. SEE
- USED REFER TO VENDOR LIST. D. ALL FLOORING SHALL BE IN ACCORDANCE WITH APPLICABLE
- ACCESSIBILITY CODE. PRIMARY SURFACES WITHIN FOOD PRODUCTION AREA SHALL
- FINISH, TO BE SEMI GLOSS, FRONT OF HOUSE DOOR FRAMES TO BE SEMI GLOSS AND MATCH THE ADJACENT WALL
- MATCH ADJACENT EIFS COLOR OR BUILDING MATERIAL, TYP.
- TO TEST ITEMS AND ARE NOT STANDARD.

SYSTEM: G4 (ARIA) Project Team:

Bakery-Cafe:




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F 316.268.0205


**Architecture - Engineering Planning · Interior Design Landscape Architecture** 

Professional Seal:

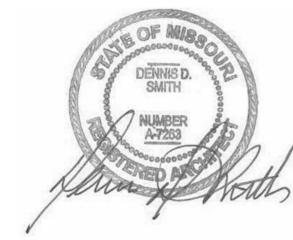

Project Title:

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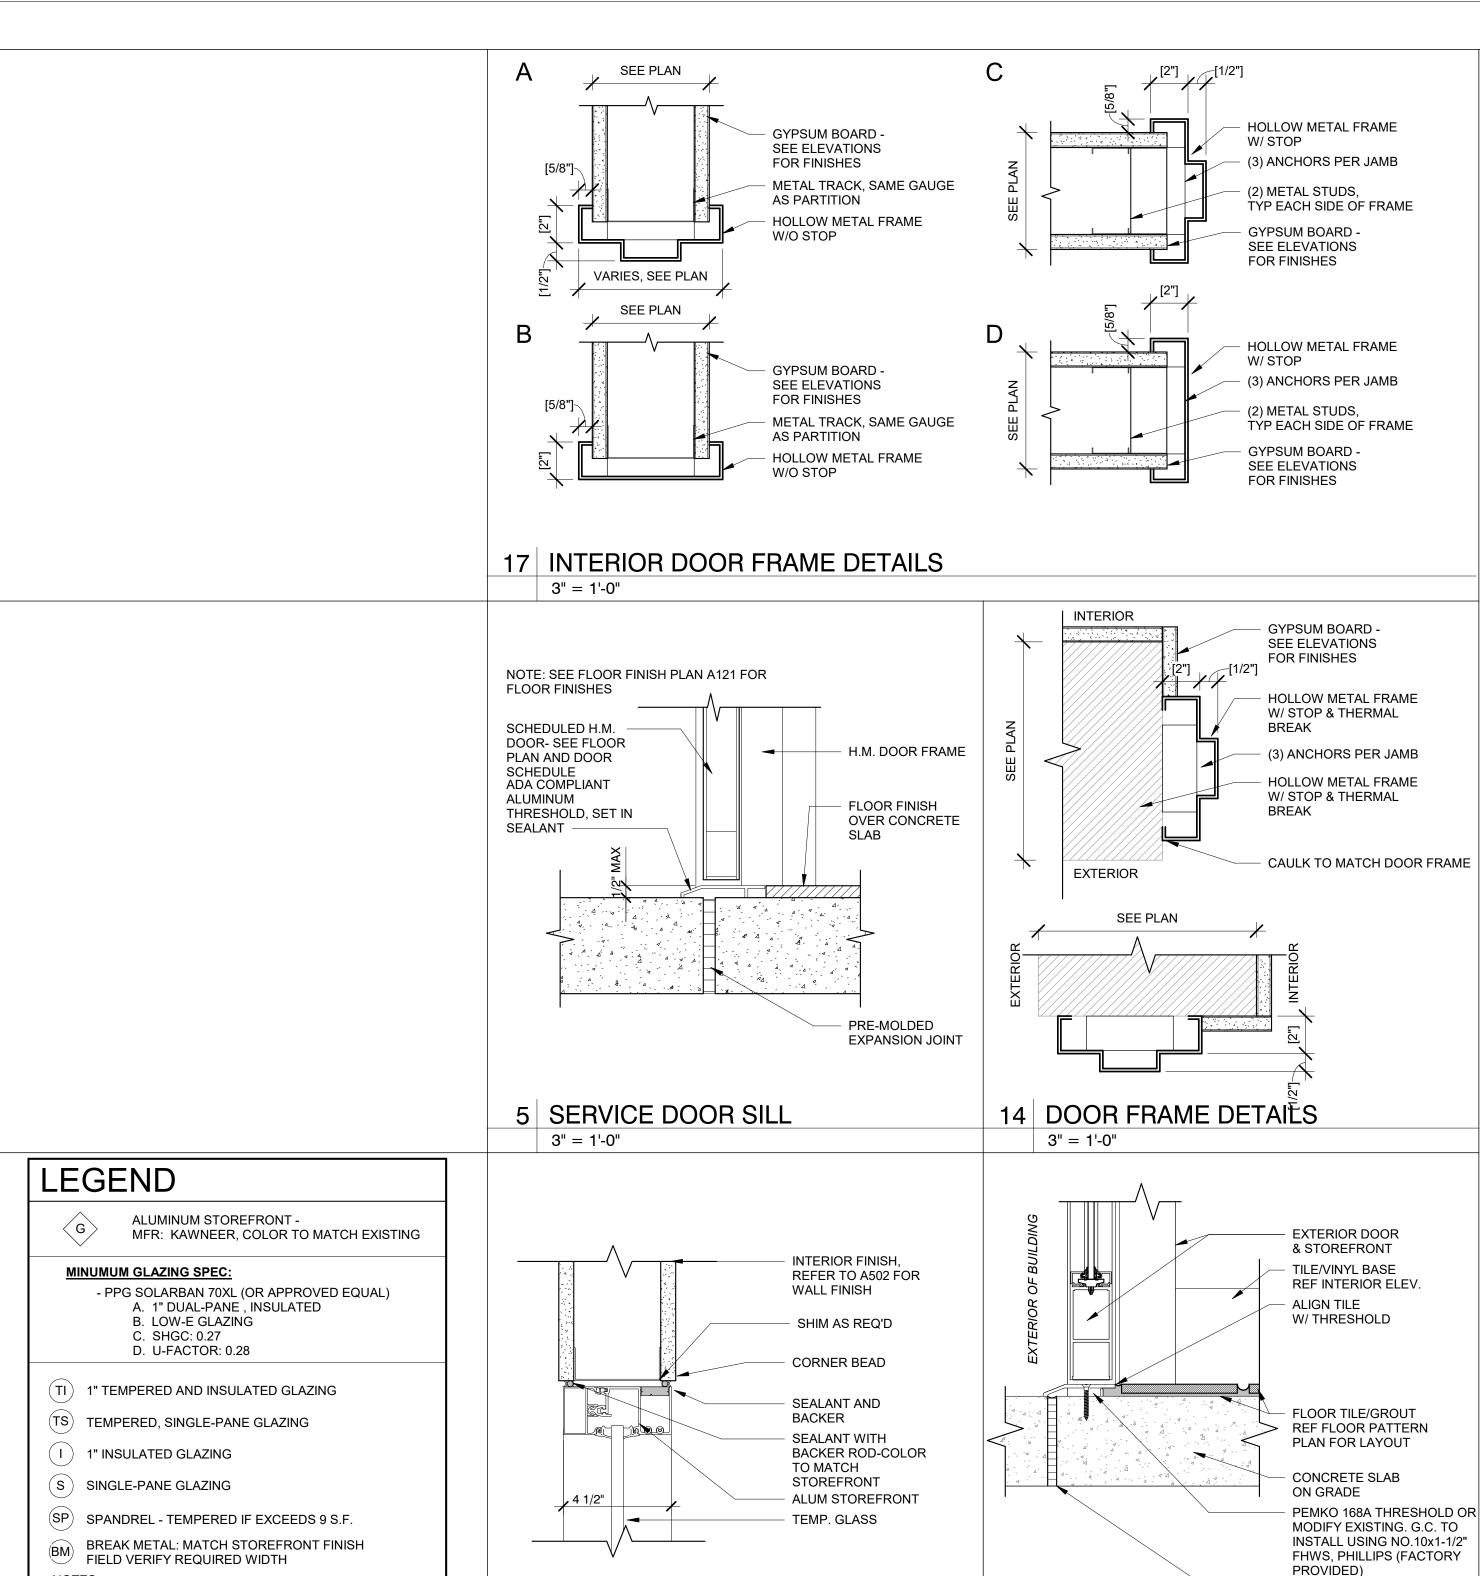
No.	Description	Date
	Tenant - Permit Set	7/18/2022
1	Tenant - City Comments	9/22/2022
2	Tenant - Construction Set	11/09/2022
4	Tenant - Owner Revision	02/03/2023

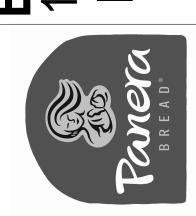
FINISH SCHEDULES,


Project Number: Drawn By: <u>Author</u> Issue Date: 07/05/2022

DPM:

CPM:



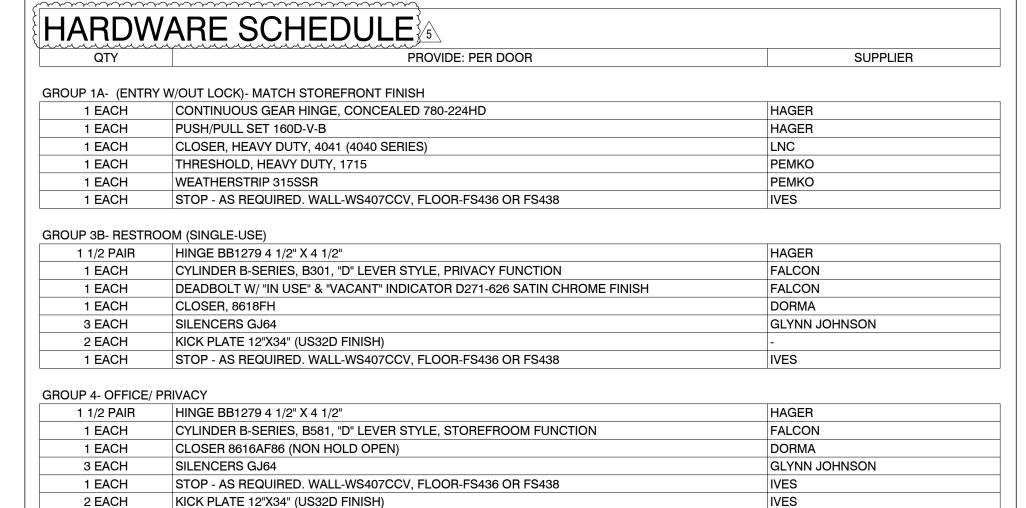

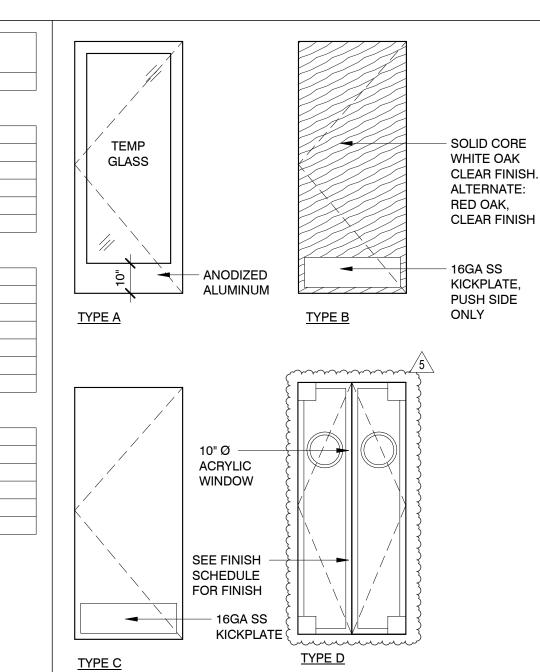

Bakery-Cafe:

SYSTEM: G4 (ARIA)




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**Architecture · Engineering · Planning - Interior Design Landscape Architecture** 

Professional Seal:



Project Title:
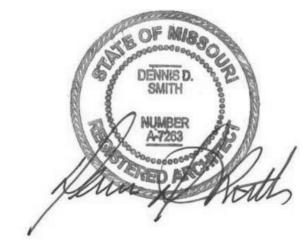
# 



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# **m** ~

HARDWARE. G.C. TO SUPPLEMENT EXISTING HARDWARE AS REQUIRED (FOR EXISTING DOORS) TO MATCH PANERA'S SPECIFICATIONS - REPLACE HINGES IF NECESSARY.

9. NO THRESHOLD REQUIRED AT INTERIOR VESTIBULE DOORS.

# HARDWARE GENERAL NOTES:

- 1. G.C. TO FURNISH & INSTALL FALCON CYLINDER IN ALL PERIMETER DOORS, ALL PERIMETER DOORS TO BE KEYED ALIKE, PROVIDE
- KEYWAY ON EXTERIOR FACE. 2. G.C. TO FURNISH & INSTALL FALCON CYLINDER IN ALL INTERIOR H.M. DOORS. ALL INTERIOR DOORS TO BE KEYED ALIKE. PROVIDE KEYWAY
- ON EXTERIOR FACE. G.C. TO FURNISH & INSTALL PADLOCK WITH 4" SHANK FOR WALK-IN COOLER/FREEZER DOORS. PADLOCK TO BE KEYED ALIKE WITH
- INTERIOR DOORS. ALL HOLLOW METAL DOOR FRAMES ARE TO BE WELDED.
- G.C. TO FURNISH & INSTALL PANIC HARDWARE PER ALL APPLICABLE
- REGULATIONS & CODES HAVING JURISDICTION. DOOR STOPS & BUMPERS TO BE INSTALLED BEHIND ALL DOORS. ALL EXTERIOR HARDWARE TO MATCH STOREFRONT, USE US28 SATIN ALUMINUM FOR CLEAR ANODIZED FINISH, & US10B DARK BRONZE FOR BRONZE STOREFRONT. USE US28 SATIN ALUMINUM FOR ALL INTERIOR

# STOREFRONT COLOR TO MATCH EXISTING

3" = 1'-0"

8 INTERIOR VESTIBULE STOREFRONT 15 THRESHOLD @ VESTIBULE DOOR

3" = 1'-0"

1/4" = 1'-0"

1. OVERALL DIMENSION INCLUDES SHIM AND SEALANT


2. PROVIDE TEMPERED GLAZING ANYWHERE WITHIN 2'

JOINT SPACE. SEE DETAILS FOR FURTHER

INFORMATION.

OF A DOOR.

6 STOREFRONT ELEVATION - SOUTH 1/4" = 1'-0"

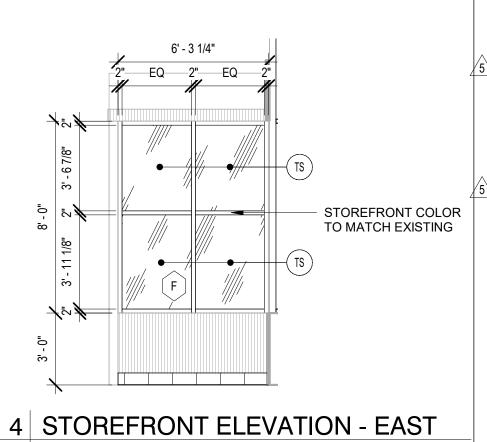

**EXTERIOR EXPANSION JOINT** 

FOR REFERENCE ONLY

	DO	00	R SO	CH	ED	UL	_E - T	-							
			DOOR						FRAME						
		NEW/			SIZE					DET	AILS				
	NUM	EX	LEAVES	W	Н	Т	MATERIAL	TYPE	JAMB	HEAD	JAMB	HARDWARE	COMMENTS	FINISH NOTES	KEYING
Ī			$\sim$		$\sim$	•									
5	126	NEW {	2}	3' - 0"	{ <b>7</b> ' - 0"}	1 3/4"	ALUM	Α	ALUM	22/A601	22/A601	1A	8,9		
	128	NEW	1	3' - 0"	7' - 0"	1 3/4"	WD	В	НМ	18A/A601	18C/A601	3B	7, 9		
	129	NEW	1	3' - 0"	7' - 0"	1 3/4"	WD	В	НМ	18A/A601	18C/A601	3B	7, 9		
	140	NEW	1	3' - 0"	7' - 0"	1 3/4"	НМ	С	НМ	18A/A601	18C/A601	4	6		
5	141	NEW	2	[1'-6"]	7' - 0"	1 3/4"	PLAM	D	HM	18B/A601	18D/A601	-	5,6		

#### **DOOR SCHEDULE NOTES:**

\* - SUPPLEMENT EXISTING HARDWARE AS REQUIRED TO MEET PANERA'S

PERMANENTLY SECURE EXISTING DOOR PRIOR TO INTERIOR FURRING HARDWARE FURNISHED WITH DOOR. CONTRACTOR TO VERIFY CONDITION OF EXISTING DOOR & CONFIRM IF

REPLACEMENT IS REQD. PROVIDE EYE VIEWER INSTEAD OF SECURITY WINDOW. KITCHEN DOORS: ELIASON SCP-8 MODEL (ALTERNATE: CHASE PROLINE 350P) W/ PLAM ANTIQUE WHITE FINISHED BOTH SIDES & 10" ROUND ACRYLIC WINDOW. 18" S.S. BASE (BOTH SIDES) W/ STAINLESS STEEL EDGE TRIM & HINGE COVERS. DOOR FURNISHED WITH BLACK ALUM

BUMPER STRIP (32"AFF) BY MANUFACTURER. BACK OF HOUSE METAL DOORS & METAL FRAMES- (ELIASON, OFFICE & SERVICE), PAINT BENJAMIN MOORE #1457 - WHITE WINGED DOVE

RESTROOM DOOR FRAME, PAINT TO MATCH ADJACENT WALL

ALL PANIC BARS AND PUSH BARS TO BE MOUNTED ON DOORS BETWEEN 30" AND 40" ABOVE FINISHED FLOOR. SEE DOOR CLOSER HARDWARE ITEMS SO THAT ALL INTERIOR DOORS DO NOT REQUIRE MORE THAN 5 LBS. TO OPERATE AND EXTERIOR

DOORS NOT TO EXCEED 8.5 LBS. OF FORCE TO OPERATE. 10. ROOF HATCH: PROVIDE KEYED PADLOCK.

Description

-- Tenant - Permit Set

A Shell - City Comments


Date

7/18/2022

8/19/2022

DOOR ELEVATIONS,						
2CHEDO	SCHEDULES, &					
<b>DETAILS</b>						
Project Number:	Sheet Number:					
00000						

Drawn By: Author Issue Date: 05/29/2023

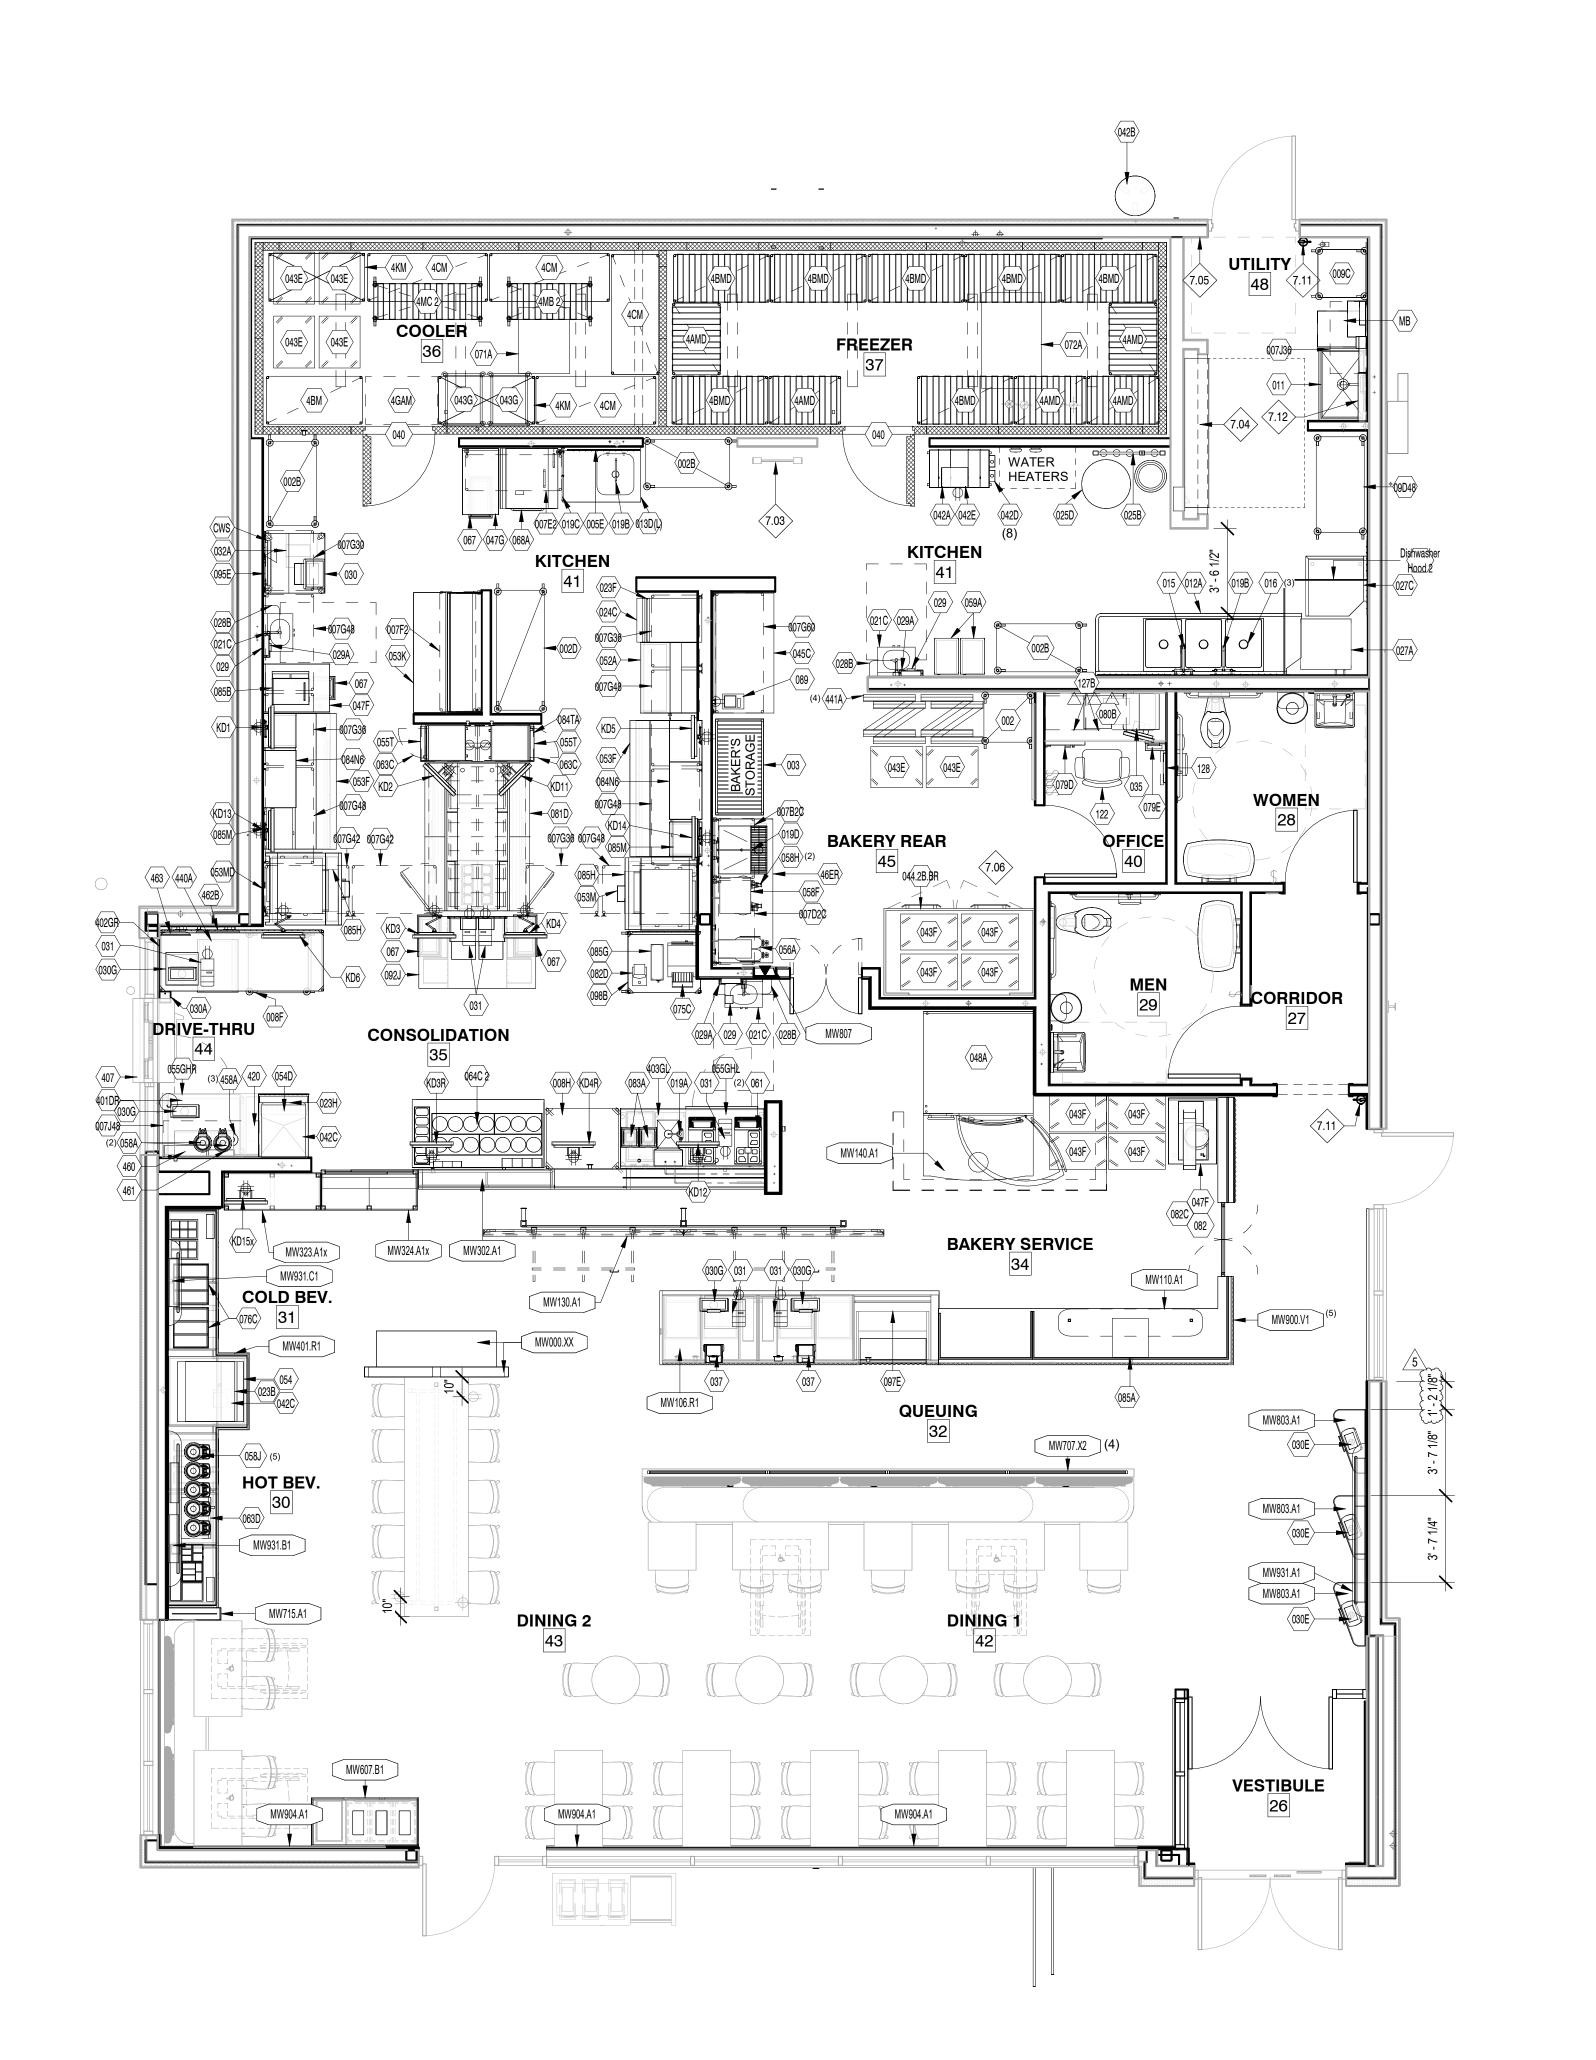

#### KEYED NOTES

7.03 ROOF ACCESS LADDER

7.04 INFINITY PANEL, REFER TO 4/A500 AND ELECTRICAL FOR FURTHER INFORMATION.

7.05 DETEX, SEE ELECTRICAL DRAWINGS

7.11 LOCATION OF APPROVED FIRE EXTINGUISHER RATED 2A-10BC.

LOCATE WITHIN 30' TRAVEL DISTANCE FROM LIKE EXTINGUISHER. 7.12 LOCATE OF UTILITY/MOP AREA SHELVING PROVIDED BY PANERA

Bakery-Cafe:

SYSTEM: G4 (ARIA) Project Team:




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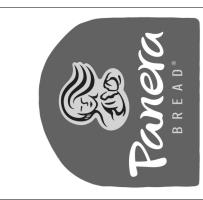
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### **EQUIPMENT PLAN LEGEND:**

XXX ROOM NUMBER SYMBOL

- EQUIPMENT IDENTIFICATION SYMBOL STEEL IDENTIFICATION SYMBOL

WOOD IDENTIFICATION SYMBOL

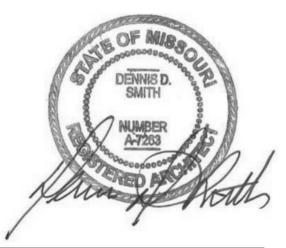RELOCATION INDICATION SYMBOL FURNITURE IDENTIFICATION SYMBOL

- DOOR NUMBER SYMBOL

LAYOUT UPDATED PER DECEMBER PROTO CHANGES

FABRIC DESIGNATION SYMBOL (SEE A-4.8 SHEET)

Description Tenant - Permit Set 7/18/2022 Tenant - City Comments 9/22/2022 Tenant - Construction Set 11/09/2022 Tenant - Owner Revision 02/03/2023 5 Prototype Updates

## **EQUIPMENT PLAN**

22302 Drawn By: Author Issue Date:

**05/29/2023** DPM:

24 EQUIPMENT PLAN 1/4" = 1'-0"

-	ID TAG	QTY	MENT SCHEDUL  DESCRIPTION	MANF.	MODEL#	DIMENSIONS	SUPPLIED	INSTALLED	NOTE
	······	~ <u>,</u>							
_		1 <b>}</b>	24IN STOR SHELVING (Z, 5 SH) 24IN STOR SHELVING (Z, 5 SH)	EAGLE EAGLE	PAN 2424-C PAN 2442-C	24"W x 24"D x 91"H 42"W x 24"D x 91"H	E.S.	E.S.	В
_~	02D 03	1 3	24IN STOR SHELVING (Z, 5 SH) BAKER STORAGE RACK	EAGLE NEW AGE INDUSTRIAL	PAN 2460-C 97191	60"W x 24"D x 91"H 48'W x 24"D x 76"H	E.S. S.W.	E.S. OWNER	ВВ
~	~~~~	<u> </u>		CORP, INC.					Ь
_		5 } 1 }	WALK-IN FREEZER SHELF WALK-IN COOLER SHELF	METRO METRO	PAN862436-F4 PAN862448-C4	36"W x 24"D x 86.625"H 48"W x 24"D x 86.625"H	E.S.	E.S.	
		7 } 4 }	WALK-IN FREEZER SHELF WALK-IN COOLER SHELF	METRO METRO	PAN862448-F3 PAN862460-C3	48"W x 24"D x 86.625"H 60"W x 24"D x 86.625"H	E.S.	E.S. E.S.	
1	GAM	1 }	36" SINGLE BRIDGE SHELF	METRO	PAN2436BS-PRO	36"W x 24"D x 1.5"H	E.S.	E.S.	
_		2 1	STANDING BRIDGE SHELF COOLER TRUNDLE	METRO METRO	PAN862448-C7 PAN2448-RIGTRUNDLE	48"W x 24"D x 86.625"H 43"W x 21.75"D x 9.75"H	E.S.	E.S.	F
1	MC 2	1	COOLER TRUNDLE	METRO	PAN2460-RIGTRUNDLE	55"W x 21.75"D x 9.75"H	E.S.	E.S.	F
_		1	SMARTWALL @ PREP SINK WALL SHELF - 30" (2 SH) - 2C	EAGLE GROUP EAGLE	PAN36-SWPREP PAN 1830-WALL-2C	36"W x 30"H 30"W x 18"D	E.S.	E.S.	-
_	0.520	1	WALL SHELF - 48" (2 SH) - 2C WALL SHELF - 48" (2 SH)	EAGLE EAGLE	PAN 1848-WALL-2C PAN 1860WALL-2	48"W x 18"D 48"W x 18"D	E.S. E.S.	E.S. E.S.	
0	07F2	1	WALL SHELF - 60" (2 SH)	EAGLE	PAN 1860-WALL-2	60"W x 18"D	E.S.	E.S.	
_		3	WALL SHELF OVER DOOR - 30" WALL SHELF OVER DOOR - 36"	EAGLE EAGLE	YPB-0047-30 YPB-0047-36	31-3/16"W x 25-9/32"D 37-3/16"W x 25-9/32"D	E.S.	E.S.	
		2 5	WALL SHELF OVER DOOR - 42"	EAGLE EAGLE	YPB-0047-42	43-3/16"W x 25-9/32"D	E.S.	E.S. E.S.	
_		1	WALL SHELF OVER DOOR - 48" WALL SHELF OVER DOOR - 60"	EAGLE	YPB-0047-48 YPB-0047-60	49-3/16"W x 25-9/32"D 61-3/16"W x 25-9/32"D	E.S.	E.S.	
)	07J36	1	WALL SHELF, SINGLE, UPTURNED BRACKETS - 18" x 48"	EAGLE	1836C SHELF; 18WB1C BRACKETS	36"W x 18"D	E.S.	E.S.	
)	07J48	1	WALL SHELF, SINGLE, UPTURNED	EAGLE	1848C SHELF; 18WB1C	48"W x 18"D	E.S.	E.S.	
)	08F	1 }	BRACKETS - 18" x 24" STORAGE CART	EAGLE	BRACKETS PAN 3030-DSC	30"W x 30"D x 29.75"H	E.S.	E.S.	
_		1 3	ADA PASS-OVER TABLE MOP SINK RACK SHELV (4 SH)	EAGLE EAGLE	CUSTOM YPB-0308-00	36"W x 30"D x 32"H 24"W x 24"D x 92"H	E.S. E.S.	E.S.	-
)	9D48	1	COATED CLEAN DISH RACK SHELVING	EAGLE	PAN DISH SHELVING-C	48"W x 24"D x 91"H	E.S.	E.S.	
)	11	1	MOP SINK W/ THE FOLLOWING ACCESSORIES: MR370 5/8" HOSE 5' LONG W/ CLAMP, MR371 SPEAKMAN FAUCET SC5811RCP, MR374 WEDGE-LOK SEAL FOR 3" DRAIN,	FLORESTONE PROD.	MSR3624	36"W x 24"D	G.C.	G.C.	-
-	12A	1	MR376 DOME STRAINER, CHROME 3 COMP SINK - REDUCED SIZE (SS)	EAGLE	CUSTOM	103"W x 31"D x 42.5"H	E.S.	G.C.	
_		1	1 COMP SINK (LEFT HAND) WITH DRAIN		314-17.5-1-18L	103"W x 31"D x 42.5"H 39"W x 27.75"D x 37.5"H	L.O.	G.C.	
)	15	1	BOARD PRE-RINSE SPRAY UNIT/DISH	FISHER	2210-WB W/ ADD ON SPOUT	37"H x 18"W	E.S.	G.C.	
)	16	3	ROTARY WASTE VALVE (1, 2, 3 COMP)	FISHER	22446	4" DIA, 4.5"H	E.S.	G.C.	
_	-	2	FAUCET (ESPRESSO) FAUCET (1, 2, 3 COMP SINK)	ZURN FISHER	Z812B1-15F 13269	6.5"W x 2"D x 11.9"T 8" CTRS/12" SPOUT	C.S. E.S.	G.C.	-
-		1	FAUCET: POT FILLER	T&S Brass and Bronze Works, Inc.	B-0594	3.125"W x 26.5625"D x 7.6875"T	E.S.	G.C.	
)	19D	1	POT FILLER FAUCET FOR HOT BEV	EAGLE	301003	8" CTRS/18" DBL-JOINTED	E.S.	G.C.	
)	21C	3	WALL MTD SS HANDSINK (knee cntrl)	EAGLE	HSA-10-FK-LRS	SPOUT 18.9"W x 14.75"D x 14.25"H	E.S.	G.C	
		1	MOBILE ICE BIN	EAGLE HOSHIZAKI	YPB-0093-00	14"W x 25"D x 29.6875"H	E.S.	G.C.	
	_	1	ICE MACHINE (w/ remote condenser) ICE MACHINE W/ REMOTE AIR-COOLED		KMD-901MRH w/URC-12F KM-520MRJ	30"W x 24.625"D x 28"H 22"W x 27.375"D x 28"H	OWNER OWNER	G.C.	-
	23H	1	CONDENSER ICE MACHINE W/ REMOTE AIR-COOLED	HOSHIZAKI	KM-660MRJ	22"W x 27.375"D x 28"H	OWNER	GC	
		1	CONDENSER	HOSHIZAKI	B-300PF		OWNER	G.C.	
-	24C 25B	1	ICE STORAGE BIN WATER FILTER (4 POD)	ELGE	SLB4PL	22"W x 32.5"D x 46"H 36"W x 27.25"H	E.S.	G.C.	-
)	25D	1	WATER SOFTENER	ELGE	-	16"DIA x 72.85"H & 24.5"DIA x 50.5"H	ELGE	G.C.	-
)	27A	1	DISHWASHER (UPRIGHT)	JACKSON	ES-2000	25.25"W x 25.25"D x	ECOLAB	G.C.	
)	27C	1	DISH COUNTER (CLEAN)	EAGLE	CUSTOM	66.25"H 30"W x 31"D x 42.5"H	E.S.	G.C.	
_		3	TORK ELEVATION MATIC HAND TOWEL ROLL DISPENSER	TORK	5510202; WHITE	14.7"H X 13.2"W X 8.1"D	SCA	G.C.	
)		3	SOAP DISPENSER	ECOLAB	92633825	4"W x 4"D x 8"H	ECOLAB	ECOLAB	
)	29A	3	GLOVE BOX HOLDER	GLOBAL	WBB2187696	11.9375"W x 3.8125"D x 19"H	S.W.	G.C.	
)	30	1	POS REGISTER W/ COMPACT CASH DRAWER	NCR	POS RealPOS 72XRT	REGISTER - 14.5"W x 10.5"D x 14.5"H DRAWER -	NCR	NCR	
_						16.2"W x 16.3"D x 4.3"H			
		3	CASH DROP BOX KIOSK TABLET W/ SURFACE MOUNTED	AMSEC APPLE & LILITAB	TB0610-1 W/ 4505095	6"W x 10"D x 6"H 12.47"W x 1"D x 8.98"H	E.S. OWNER	G.C. OWNER	
		4	CASE HP POS REGISTER W/ COMPACT CASH		HP ENGAGE ONE	REGISTER - 13.75"W x	HP	HP	
,	30G	4	DRAWER	nr 	HP ENGAGE ONE	6.5"D x 11.5"H; DRAWER (IF APPLICABLE) - 16.2"W x		nP	
	31	6}	PRINTER	EPSON/MICROS	TM-T88	16.3"D x 4.3"H 5.71"W x 7.68"D x 5.83"H	MICROS	MICROS	
	32A	1	PRINTER/FAX/COPIER MACHINE	BROTHER HP	MFC-7340	16.9"W x 15.6"D x 12"H	NCR	NCR	
)	37	2	MANAGER PC AND PRINTER CREDIT CARD READER	Verifone	EVO D510 MX925	8.6"W x 9.1"D x 2.2"H	NCR OWNER	NCR OWNER	
4		2}	WALK-IN COOLER BAG-N-BOX	WALK-IN VENDOR MBS	SEE SHOP DWGS AR-10-2W-GLIDE	SEE SHOP DWGS 32"W x 19"D x 61"H	E.S. PEPSI	G.C. PEPSI	-
)	42B	1	BULK Co2 TANK	NuCO2	CARBO CHARGER 300 LB.	47"H x 20" DIA	NuCO2	NuCO2	
_		2 8	CARBONATOR BAG N BOX PUMP	CORNELIUS SHURFLO	1624 PB8-SF	12"W x 9"D x 10.5"H 5.7"W x 3.8"D x 7.9"H	PEPSI PEPSI	PEPSI PEPSI	
).	42E	1	WATER BOOSTER PUMP	SHURFLO	804-023	10"W x 10"D x 13"H	PEPSI	PEPSI	
	mm	6	SINGLE OVEN RACK (10 PAN CAPACITY) C-LIFT		APR1018/6RORC	20.5"W x 26"D x 73"H	OWNER	OWNER	-
j.	43F	8	SINGLE OVEN RACK (15 PAN CAPACITY) C-LIFT	MAGNA	APR1518/4RORC	18"W x 28.5"D x 73.125"H	OWNER	OWNER	-
_		2}	PULL THAW RACKS (20 PAN CAPACITY)		1331 PDW2S 40.5		OWNER	OWNER	-
_	44.2B.BR	<u></u>	DOUBLE DOOR PROOFER W/ RETARDER; 4 RACK	BAXTER	RPW2S-40.5	75.5"W x 43.3"D x 99.5"H	BAXTER	BAXTER/G.C.	
~	45C 6ER	1 3	SS TABLE (60") BOH HOT BEVERAGE STATION (72"),	EAGLE GROUP EAGLE	T3060SB-BS YPB-T3072-0019-00	60"W X 30"D X 34.5"H 72"W x 30"D x 39"H; 34.5"H	E.S. E.S.	E.S. E.S.	A, (1)L H
_			RIGHT HAND			COUNTER			
-	mmmy	<u>2</u> ) 1	SS. TABLE W/OPEN BASE (24") (BETA) SS. TABLE W/OPEN BASE (18") (BETA)	EAGLE EAGLE	YPB-T3324-0001-00 YPB-T3318-0001-00	24"W x 33"D x 38"H 18"W x 33"D x 38"H	E.S.	E.S.	<b>-</b>
		1	SINGLE RACK OVEN/GAS (BETA) 24X24 ACCESS PANEL	Baxter BEST ACCESS DOORS	OV500G1 BA-AHD	55"W X 83.5"D X 104"H 24"W x 24"H x 1.5"D	REVENT G.C.	BAXTER/GC G.C.	- V, W
		1	DUAL THICKNESS BREAD SLICER	OLIVER	758-N	38.25"W x 29.75"D x	E.S.	E.S.	v, vv
	53F	2	68" SANDWICH PREP TABLE	RANDELL		54.25"H 68"W x 34"D x 48"H	E.S.	E.S.	-
		1	60" CATERING PREP COOLER W/	RANDELL	8260NDWR	60"W x 34"D x 57"H	E.S.	E.S.	
-		1	OVER-SHELF 36" DRIVE THRU TOPPING STATION	RANDELL	11336PR-PANERA	36"W x 38"D x 36"H	E.S.	E.S.	
)	53MD	1	36" DRIVE THRU TOPPING STATION W/DRAWER	RANDELL	11336PR-PANERA	36"W x 38"D x 36"H	E.S.	E.S.	
_		1	SODA/ICE DISP. (8HD)	CORNELIUS	IDC255 #621057438	30"W x 33.125"D x 40"H	PEPSI	PEPSI	-
	54D	1	SODA/ICE DISP. (8HD) W/ ED175 ICE MAKER ADAPTER KIT	CORNELIUS	RENEW 175: #621058581	25.1"W x 31.5"D x 35.6"H	PEPSI	PEPSI	
-		13	U.C. 1 DR REFRIGERATOR; LEFT HAND HINGED	HOSHIZAKI	UR36A	36"W x 31"D x 32.25"H	E.S.	E.S.	N
)	55GHR	1	U.C. 1 DR REFRIGERATOR; RIGHT HAND	HOSHIZAKI	UR36A	36"W x 31"D x 32.25"H	E.S.	E.S.	N
	55T	2	HINGED SALAD CRISPER	SILVER KING	SKDL18-RDUS4	17.62"W x 28.42"D x	E.S.	E.S.	A
						36.39"H			
_		2	TEA BREWER COFFEE SERVER	WILBUR CURTIS BUNN	TCTS10631 42700.0251	12.75"W x 20.75"D x 34"H 9.1"W x 11.9"D x 12.6"H	E.S.	G.C. E.S.	-
)	58F	1	TWIN COFFEE BREWER	WILBUR CURTIS	G4TP1T19A3131	18"W x 16.625"D x 28"H	E.S.	G.C.	-
_		2 5	1 GAL. COFFEE URN COFFEE SERVER W/ STAND	WILBUR CURTIS BUNN	TXSG01 42700.0251 / STAND:	12.375"X9.125"X13.625" 9.1"W x 11.9"D x 12.6"H	E.S.	G.C. E.S.	
J		I			54473.1000			1	

ID TAG	QTY	DESCRIPTION	MANF.	MODEL#	DIMENSIONS	SUPPLIED	INSTALLED	NOTES
								1
061	2	(SEMI-AUTOMATIC)	FRANKE	70009269-PNRA	13.4"W x 21.3"D x 29.5"H	OWNER	OWNER	
063C	2	HYBIRD CONVECTION OVEN	SHARP	RCD1800M	17.5"W x 20.5"D x 13.675"H		E.S.	
063D	1	MICROWAVE COMMERCIAL GRADE, 1550 WATTS, DIAL CONTROL	SHARP	R-21LCFS	20.5" x 16.0"D x 12.125"H	OWNER	E.S.	
064C 2	1	, -	DUKE	HCSS-RH-208V	The state of the s	E.S.	E.S.	
067	~~~~~~~~~~~~~~~~~~~~~~~~~~~~~~~~~~~~~~	HIGH CAPACITY SOUP STATION	DUDDEDMAID	1011	34.1"H WORK SURFACE	CW	CW	
067 068A	43	INDOOR TRASH CONTAINER SOUP RETHERMALIZER	RUBBERMAID ELKAY FOODSERVICE	1011 RTB-14-SL-OPB	20"W x 11"D x 30"H	S.W. E.S.	S.W. G.C.	
071A			KOLPAK	SEE SHOP DWGS	26 1/8"W x 30 1/8"D x 34"H SEE SHOP DWGS	E.S.	G.C.	
	1 }		KOLPAK	SEE SHOP DWGS	SEE SHOP DWGS	E.S.	G.C.	-
072A 075C	ر ال	FREEZER EVAPORATOR TOAST-QWIK ELECTRIC CONVEYOR		TQ3-900H	14.7"W x 20.62"D x 17.13"H		G.C.	-
	-	TOASTERS	HATCO					
076C	2	SIMPLICITY BUBBLER - 3 BOWL	CRATHCO BY GMCW	CS-3L-16	20.4"W X 17.7"D X 29"H	E.S.	E.S.	
079D	1	SAFE	AMSEC	SK2014-857	30"H x 20"W x 20"D	E.S.	E.S.	
079E	1	TIDEL "SMART SAFE"	TIDEL	SERIES 3	10.25"W x 27.25"H x 19"D (28.13"D)	E.S.	E.S.	
080B	1	OFFICE FILE BOX				E.S.	E.S.	
081D	1	DOUBLE SIDED SALAD PREP TOP (74") WITH DOUBLE SIDED OVER SHELF	RANDELL	51368PR-PANERA-OS	74"W x 47.875"D x 38.65"H; 77.125" WITH SHELF	E.S.	E.S.	
082	1	BAGEL SLICER	OLIVER	702-N	30"W X 13"D X 21"H	E.S.	E.S.	
082C	1	BAGEL SLICER CHUTE	OLIVER	-	12.5"W x 33.3"D x 31.4"H	E.S.	E.S.	
082D	1		PRINCE CASTLE	970-A SERIES	7"W x 10.75"W x 3.5"H	E.S.	E.S.	
083A	2	BLENDER	VITAMIX	03066	8.5"W x 10"D x 18"H (24.5"H WITH LID OPENED)	E.S.	E.S.	
084N6	2	MODIFIED BREAD SHELF	RANDELL	4SHEBREAD-68-PANERA-5	68"W x 16.25"D x 22.125"H	E.S.	G.C.	
084TA	1	STAINLESS STEEL WALL SHELF	EAGLE	YPB-0314-00	56"W x 18.875"D x 2.25"H	E.S.	G.C.	
085A	1	HEATED SHELF	Hatco Corporation	GRS-18-I	18"W X 19.5"D X 2.25"H	E.S.	E.S.	
085B	1	EGG STATION	ROUND UP	ES-600	16.6"W x 18.4"D x 7.25"H	ROUNDUP	E.S.	-
085G	1	HEATED SHELF	Hatco	GRSS-1806	6"W x 18"D x 2.523"H	E.S.	E.S.	
085H	2	TURBOCHEF DOUBLE BATCH OVEN	TURBOCHEF	HHD-9500-21	31.7"D x 27.7"W x 23.2"H	E.S.	E.S.	
085M	2	MERCO HOT HOLDING UNIT	MERCO	MHT32SST1W	20.5"W x 13"D x 16.9"H	E.S.	E.S.	
089	1	SCALE	NOT PROVIDED (TAYLOR)	TE10FT/TE32FT	10.5"W x 7.5"D	NOT PROVIDED	NOT PROVIDED	NOT PROVIDED
092J	1	T-LINE CONSOLIDATOR TABLE W/SMART WALL	METRO	INSTR-PAN5836-TLINE	58.5"W x 36"D x 77.5"H	E.S.	G.C.	TROVIDED
095E	1		EAGLE	YPB-0194-00	30"W x 30"D x 72"H	E.S.	E.S.	_
097E	1		STRUCTURAL CONCEPTS		36.25"W x 24.125"D x 32.75"H	E.S.	E.S.	
098B	1	AM PRODUCTION TABLE W/ GRID	METRO	INSTR-3036AMDTPS-WBG	36.25"W x 30.5"D x 67.75"H		E.S.	
122	1	OFFICE CHAIR	-	-	-	OWNER	OWNER	
127B	2	WALL-MOUNT OPEN FRAME RACK	TRIPP-LITE		20.11"W x 18.24"D x 24.8"H		OWNER	
128	1	13" CCTV MONITOR	VIEWSONIC	VA503B	13.2"W x 13.7"D x 5.8"H	UAS	UAS	
401DR	1	RIGHT HAND ORDER TAKER BEVERAGE TABLE; DRIVE THRU		YPB-T3272-0011-00	72"W x 32"D x 40.5"H	E.S.	E.S.	
402GR	1	82" DRIVE THRU CASHIER TABLE WITH GRID; RIGHT HAND	METRO		82"W x 30.75"D x 62.5"H	E.S.	E.S.	
403GL 440A	1 ^	72" LH ESPRESSO BAR DRIVE THRU CONSOLIDATION SWEETS	EAGLE EAGLE	YPB-OB3072-0010-00 YPB-RACK-0005-00	72"W x 30"D x 35.3125"H 20.5"W x 26"D x 33.5"H	E.S.	E.S.	-
441A	4	RACK (7 PAN CAPACITY) Z TYPE NESTING RACK (20 PAN	NEW AGE INDUSTRIAL	51358	21"w x 26"D x 69.625"H	OWNER	OWNER	
mm	4)	CAPACITY)	CORP.					
458A	3	COFFEE SHUTTLES W/O RACK	GRINDMASTER	SS-1.9LD / SS-1.9LR / DR-2SU	DECANTER: 6.5"R x 7.25"H		G.C.	-
460	1		HYPERACTIVE	CUSTOM	21"W x 6"D x 18"H	E.S.	E.S.	-
461	1	WIRELESS DRIVE THRU AUDIO COMMUNICATION SYSTEM	HM ELECTRONICS, INC	WIRELESS 6000	12.8"W x 3.8"D x 7.8"H	E.S.	E.S.	-
462B	1	ORDER READY MONITOR	NEC	EA273WMBK	14.6"W x 24.9"H x 2.5"D	OWNER	OWNER	C - PORTRAIT ORIENTATION
463	1	SECURITY FLAT SCREEN MONITOR 17"	CLINTON ELECTRONICS	V1768U	14.88"W x 1.91"D x 12.50"H	E.S.	E.S.	-
CWS	1	ROPE MONITOR	LG	23MB35PM-B	21.6"W x 2.4"D x 13.2"H	OWNER	OWNER	
KD1	1	SANDWICH 1 MONITOR	LG	23MB35PM-B	21.6"W x 2.4"D x 13.2"H	OWNER	OWNER	С
KD2	1		LG	23MB35PM-B	21.6"W x 2.4"D x 13.2"H	OWNER	OWNER	С
KD3	1		LG	23MB35PM-B	21.6"W x 2.4"D x 13.2"H	OWNER	OWNER	С
KD3R	1	MAIN CONSOLIDATOR MONITOR (REPEATER)	LG	23MB35PM-B	21.6"W x 2.4"D x 13.2"H	OWNER	OWNER	С
KD4	1	,	LG	23MB35PM-B	21.6"W x 2.4"D x 13.2"H	OWNER	OWNER	С
KD4R	1	CONSOLIDATOR MONITOR (REPEATER)	LG	23MB35PM-B	21.6"W x 2.4"D x 13.2"H	OWNER	OWNER	С
KD5	1		LG	23MB35PM-B	21.6"W x 2.4"D x 13.2"H	OWNER	OWNER	С
KD6	1	DRIVE THRU CONSOLIDATOR MONITOR	LG	23MB35PM-B	21.6"W x 2.4"D x 13.2"H	OWNER	OWNER	С
KD11	1	SALAD 2 MONITOR	LG	23MB35PM-B	21.6"W x 2.4"D x 13.2"H	OWNER	OWNER	С
KD12	1	BARISTA MONITOR	LG	23MB35PM-B	21.6"W x 2.4"D x 13.2"H	OWNER	OWNER	С
KD13	1		LG	23MB35PM-B	21.6"W x 2.4"D x 13.2"H	OWNER	OWNER	С
KD14	1		LG	23MB35PM-B	21.6"W x 2.4"D x 13.2"H	OWNER	OWNER	С
KD15x	1	RPU MONITOR	LG	23MB35PM-B	21.6"W x 2.4"D x 13.2"H	OWNER	OWNER	С
		MOP BUCKET				C.S.	C.S.	

- A. ONLY ITEMS WITH QUANTITY NUMBERS LISTED ARE INCLUDED
- IN THIS SCOPE OF WORK. B. STAINLESS STEEL WORK TABLES WITH DROP-IN SINKS ARE TO BE INSTALLED BY THE GC. ESPRESSO SINK INSTALLED BY
- CASEWORK VENDOR. C. G.C. TO COORDINATE THE DELIVERY & INSTALLATION OF ALL EQUIPMENT TO BE SUPPLIED AND/OR INSTALLED BY OTHERS. REFER TO SPEC - SECTION 01010 & 01640 FOR NOTES ON SCOPE OF WORK & ITEMS NOT IN CONTRACT.

KEYED NOTES-EQUIP.SCHED.

PLASTIC LAMINATE DESK TOP CLEATED TO WALLS.INSTALL (2) 2"

EQUIPMENT TO HAVE 4" CASTERS W/ 2 LOCKING EQUIPMENT TO HAVE (2) 5M & (2) 5MB CASTERS

EQUIPMENT TO HAVE 6" CASTERS W/ 2 LOCKING

DIAMETER GROMMET HOLES FOR ELEC WIRES.

EQUIPMENT TO HAVE 2.25" CASTERS W/ 2 LOCKING

SINGLE SHELF SUPPORTS W/ SINGLE DIRECT WALL MTS

SCREW INTO SHROUD WITH STAINLESS STEEL SCREWS

USE "BEST ACCESS DOORS" BUT WILL ACCEPT "APPROVED EQUALS"

WALL MOUNTED

NOT USED

FURNISH W/ RAILS (4) SIDES

CUT OUT FOR DROP-IN SINK FURNISHED W/ STAND

EQUIPMENT TO HAVE 3" CASTERS FURNISH W/ RICHLITE CUTTING BOARD EQUIPMENT TO BE SECURED TO WALL

25' DRAFT INDUCER W/ MOTOR 100' DRAFT INDUCER W/ MOTOR EQUIPMENT TO BE BOLTED TO FLOOR.

**EQUIPMENT TO HAVE 5" CASTERS** FURNISH W/ SIDE SPLASHES FURNISHED W/ SINK AND FAUCET

Bakery-Cafe:

SYSTEM: G4 (ARIA) Project Team:




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**Landscape Architecture** 

Professional Seal:




Project Title:

# **ABBREVIATIONS**

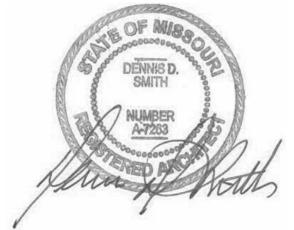В	BOWL
C.S.	CASEWORK SUPPLIER
D	DEPTH
E.S.	EQUIPMENT SUPPLIER
EP.	EPOXY FINISH
F.S.	FURNITURE SUPPLIER
G.C.	GENERAL CONTRACTOR
H.	HEIGHT
S.S.	STAINLESS STEEL
S.W.	SMALL WARES
SH.	SHELF
W	WIDTH
Z	ZINC COATED

INSTALL NOTE: SILICONE INSIDE FLANGE ALL-SIDES (100% SILICONE) AND

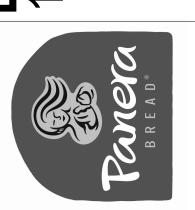


Consultant Copyright Placeholder

lo.	Description	Date
-	Tenant - Permit Set	7/18/2022
	Tenant - City Comments	9/22/2022
	Tenant - Construction Set	11/09/2022
	Tenant - Owner Revision	02/03/2023

## **EQUIPMENT SCHEDULES**

roject Number:		Sheet Number:
2302		
rawn By:		<b>A 7 0</b>
uthor		$\Delta / \Box$
sue Date:		$\Lambda I V$
7/05/2022		
PM:	DM:	CPM:

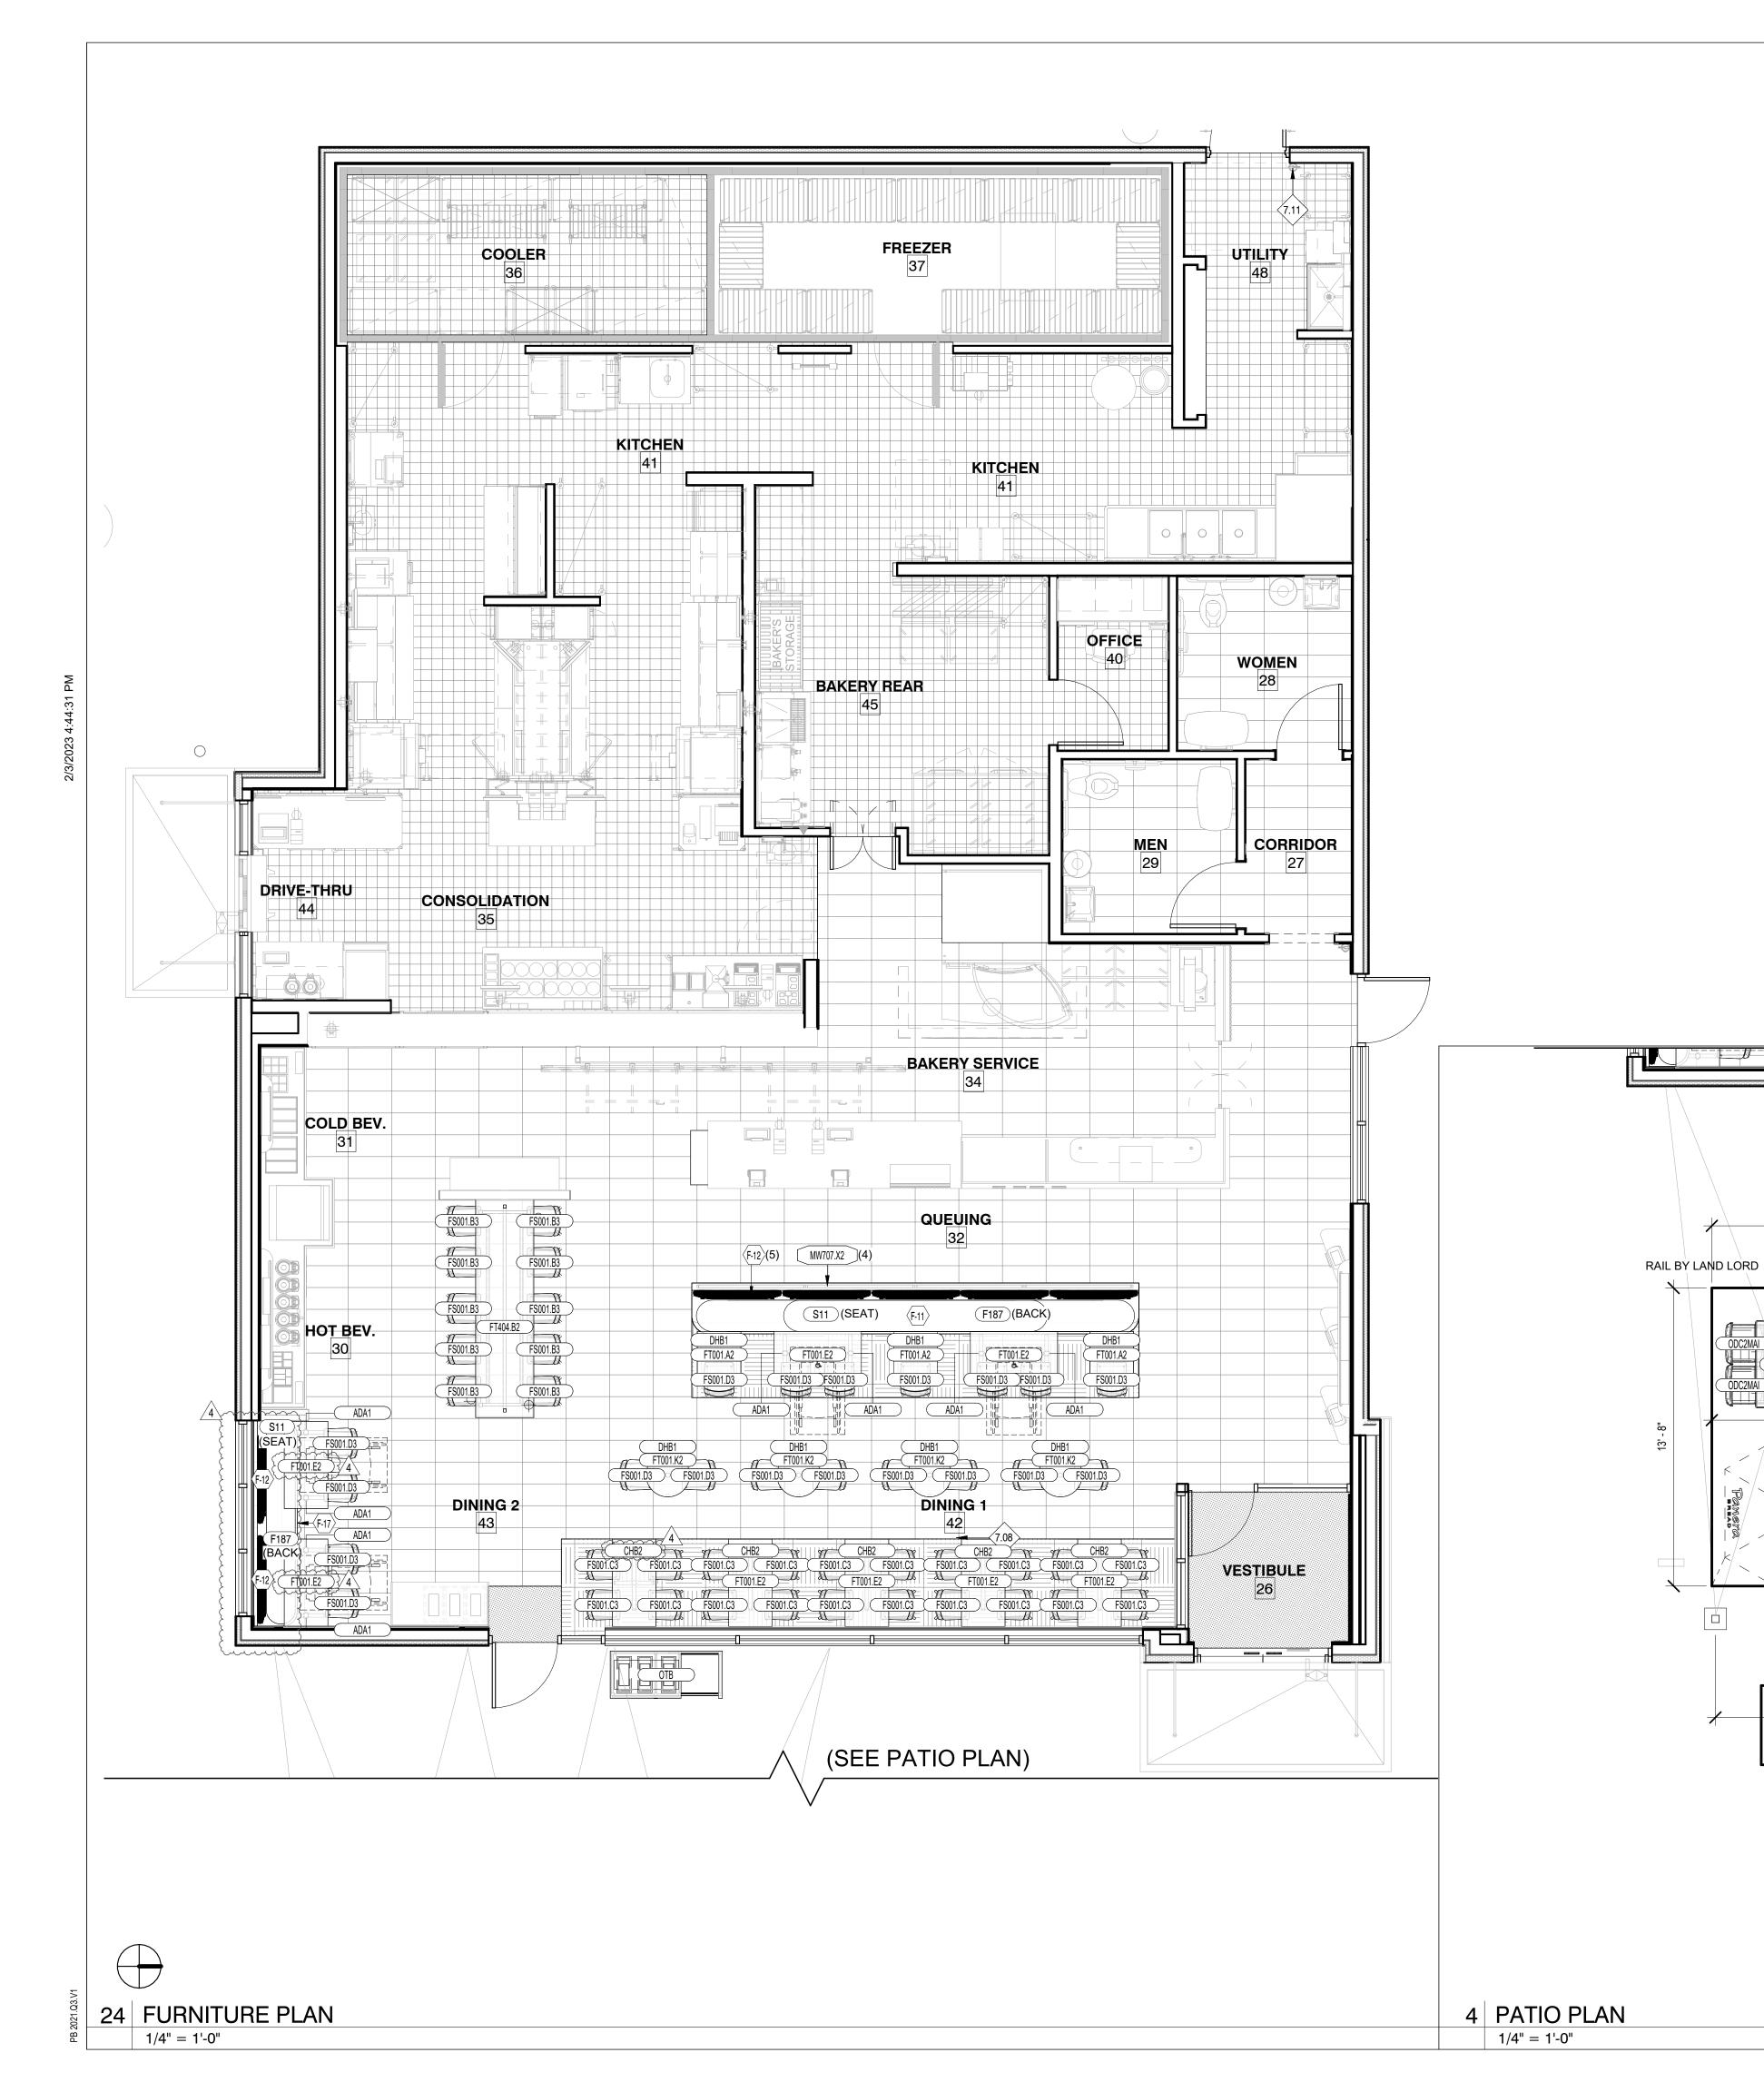

- A. G.C. TO PROVIDE MANAGER OFFICE LAMINATE TOP. ALMOND COLOR PREFERRED; WHITE ALLOWED IF ALMOND IS NOT AVAILABLE. REFER
- TO ELEVATIONS FOR ADDITIONAL INFORMATION.

  B. FIELD CONFIRM LENGTH OF BANQUETTE(S) PRIOR TO PRODUCTION AND INSTALLATION

Bakery-Cafe:

#2406

SYSTEM: G4 (ARIA)
Project Team:



LK ARCHITECTURE, INC.

345 RIVERVIEW,
WICHITA, KS 67203
T 316.268.0230


F 316.268.0205

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Professional Seal:

#### KEYED NOTES

- 7.08 44" WIDE MNIMUM ACCESSIBLE PATH
- 7.11 LOCATION OF APPROVED FIRE EXTINGUISHER RATED 2A-10BC. LOCATE WITHIN 30' TRAVEL DISTANCE FROM LIKE EXTINGUISHER.

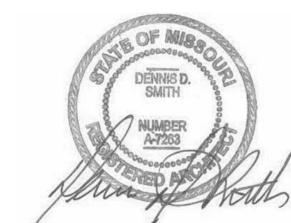

Project Title:

# Bakery Cafe#2406 1410 NE DOUGLAS ST LEES SUMMIT, MO 640

# SERVICE REQUIREMENTS:

TABLE SERVICE:
APPLICABLE TO THIS
MARKET?

CO2 MONITORING:
IS THIS REQUIRED?

CAL133: IS THIS REQUIRED? NO

DESIGN NOTES:



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#### FUNITURE PLAN LEGEND:

xxx —	ROOM NUMBER SYMBOL
REL —	RELOCATION INDICATION, ADDED TO SYMBOLS
FURN-ID	FURNITURE IDENTIFICATION SYMBOL
(XXX)	- DOOP NUMBER SYMBOL

DOOR NUMBER SYMBOL

- FABRIC DESIGNATION SYMBOL (SEE SHEET A600)

TYPICAL TABLE TAGGING EXAMPLE:

6' - 8"

5' - 8"

TR36OD TABLE TOP TAG

TABLE BASE TAG(S)

No.	Description	Date
	Tenant - Permit Set	7/18/2022
1	Tenant - City Comments	9/22/2022
2	Tenant - Construction Set	11/09/2022
4	Tenant - Owner Revision	02/03/2023

# **FURNITURE PLAN**

Project Number:

22302
Drawn By:
Author
Issue Date:

07/05/2022
DPM: DM: CPM:

		WOOD/STEEL SCHEDU	LE
ID TAG	QTY	DESCRIPTION	LOCATION
<u>4</u>	~~~	· · · · · · · · · · · · · · · · · · ·	
{ MW000.XX	1	SCREEN WALL & BENCH S	
MW900.V1	6	MOUNTAIN LUMBER WOOD PANEL; PEAKED	<varies></varies>
MW904.A1	3	STANDARD CHAIR RAIL; 5" X 3/4" (PRICED PER LN.FT.)	FOH
MW106.R1	1	POS GNG COUNTER; (2) REGISTER, 139.5"W; RIGHT HAND	POS
MW110.A1	1	BAKERY MIRROR; 18x72	POS/BAKERY
MW130.A1	1	MENU BOARD HOLDER	POS/BAKERY
MW140.A1	1	OVEN SHROUD W/ ENGRAVED MB LOGO	BAKERY
MW201.A1	1	BAKERY SERVICE DOUBLE-ACTING GATE	BAKERY
MW302.A1	1	EXPO CUBBIES; 64.75" W x 17" H	EXPO
MW323.A1x	1	RPU SHELVING; 18.5x46	POS
MW324.A1x	1	RPU SHELVING; 20x58	EXPO
4 MW401.R1	1	200" COMBINED BEVERAGE STATION; RIGHT HAND	BEVERAGE AREA
MW607.B1	<b>∤</b> 1	(3) BIN TRASH STATION	DINING
( MW707,X2	<b>4</b>	RIBBED GLASS SCREEN TOPPER; 12" H x XX" W	DINING
MW715.A1	1	DIVIDER PANEL	FOH
MW803.A1	3	SINGLE KIOSK DRAWER	FOH
MW807	1	PHONE BOX-RECESSED	AS NEEDED
MW931.A1	1	DISCOVERY SHELF; 87"W	FOH
MW931.B1	1	DISCOVERY SHELF; 78"W	FOH
MW931.C1	1	DISCOVERY SHELF; 43"W	FOH

WD322A-ORDER STATUS MONITOR TRIM: REMOVED FROM SCHEDULE

	T			a			T	
ID TAG	QTY	DESCRIPTION	MANUF.	SUPPLIED BY	FINISH	METAL	LAMINATE	ELECT. RE
ADA1	8	ADA "T" LEG BASE	FDS	FDS		BLACK POWDER COAT	N/A	
CHB2	5	COUNTER HEIGHT 22" X 30" METAL CROSS BASE	FDS	FDS		BLACK POWDER COAT	N/A	
DHB1	7	DINING HEIGHT 22" X 22" METAL CROSS BASE	FDS	FDS		BLACK POWDER COAT	N/A	
F-11	1		CUSTOM BY MW VENDOR.					
F-12	7 }	FB-1 & FB-2, SCREWS TO MATCH PMS 9184C	CUSTOM BY MW VENDOR.					
F-17	1	CORNER BANQUETTE; FINISH: WD-1, BASE: PC-3, SEAT: FB-1	CUSTOM BY MW VENDOR.					
FS001.B3	10	,	MUUTO/ CI SELECT	GROUP O	CLEAR OAK	BLACK	N/A	
FS001.C3	20	ŕ	MUUTO/ CI SELECT	GROUP O	CLEAR OAK	BLACK	N/A	
FS001.D3	19	,	MUUTO/ CI SELECT	GROUP O	CLEAR OAK	BLACK	N/A	
FT001.A2	3	24" SQUARE STAINED WHITE OAK TABLE	VIRIDIAN	GROUP O	OAK - DARK	PER PLAN	N/A	
FT001.E2	9	24" X 48" STAINED WHITE OAK BOOTH TABLE	VIRIDIAN	GROUP O		PER PLAN	N/A	
FT001.K2	4	24" ROUND STAINED WHITE OAK TABLE	VIRIDIAN	GROUP O	-	PER PLAN	N/A	
FT404.B2	1		CHARLES TON FORGE	GROUP O	OAK - DARK	METAL LEGS	N/A	Yes
FU001.A1	2	HEXAGONAL EXTERIOR PATIO UMBRELLA W/ 24" ROUND BASE - 7'x7'	TRESCO	TRESCO	GRASS GREEN	N/A	N/A	
ODC2MAI	16	G4 OUTDOOR DINING CHAIR DARWIN #521	EMU	FDS	ANTIQUE IRON	-	N/A	
OT3248AI	3	EXTERIOR TABLE CAMBI ADA #836: 32" x 48"	EMU	FDS	ANTIQUE IRON	STEEL MESH TOP	N/A	
ОТВ	1	OUTDOOR TRASH & BUSSING	FDS	FDS	WOOD SLAT	-	-	
OTR32AI	2	EXTERIOR TABLE CAMBI #803: 32" ROUND	EMU	FDS	ANTIQUE IRON	STEEL MESH TOP	N/A	

Bakery-Cafe:

#240

SYSTEM: G4 (ARIA)
Project Team:




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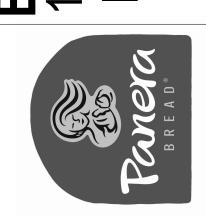
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Professional Seal:



Project Title:

# **3akery Cafe#2406** 410 NE DOUGLAS ST LEES SUMMIT, MO 6408

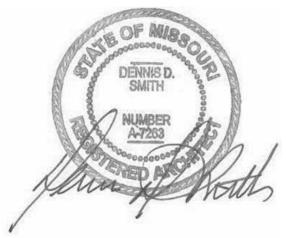

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No.	Description	Date
	Tenant - Permit Set	7/18/2022
1	Tenant - City Comments	9/22/2022
2	Tenant - Construction Set	11/09/2022
4	Tenant - Owner Revision	02/03/2023

FURNITURE & WOOD/STEEL SCHEDULES

Project Number: Sheet Num

ect Number: Sheet Number:

502
wn By:
hor
e Date:
05/2022

- A. ALL SIGNS WILL BE PROVIDED BY OWNER TO G.C. FOR INSTALLATION.
  B. VENDOR WILL VERIFY ALL QUANTITIES AND CURRENT GRAPHIC
- DESIGNS WITH OWNER PRIOR TO FABRICATING.
  REFERENCE INTERIOR ELEVATIONS FOR SIGNAGE PLACEMENT.

#### Bakery-Cafe:

#2406

SYSTEM: G4 (ARIA)




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#### KEYED NOTES

- 7.13 LOCATION OF EXIT SIGN AND SIGN STATING "THIS DOOR TO REMAIN
- UNLOCKED WHEN BUILDING IS OCCUPIED" 7.14 LOCATION OF TACTILE EXIT SIGN, REFER TO 11/A721.
- 7.15 LOCATION OF INTERNATIONAL SYMBOL OF ACCESSIBILITY.

# Bakery Constant 1410 NE DCUM LEES SUM

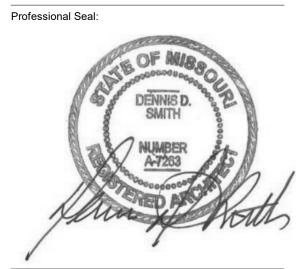

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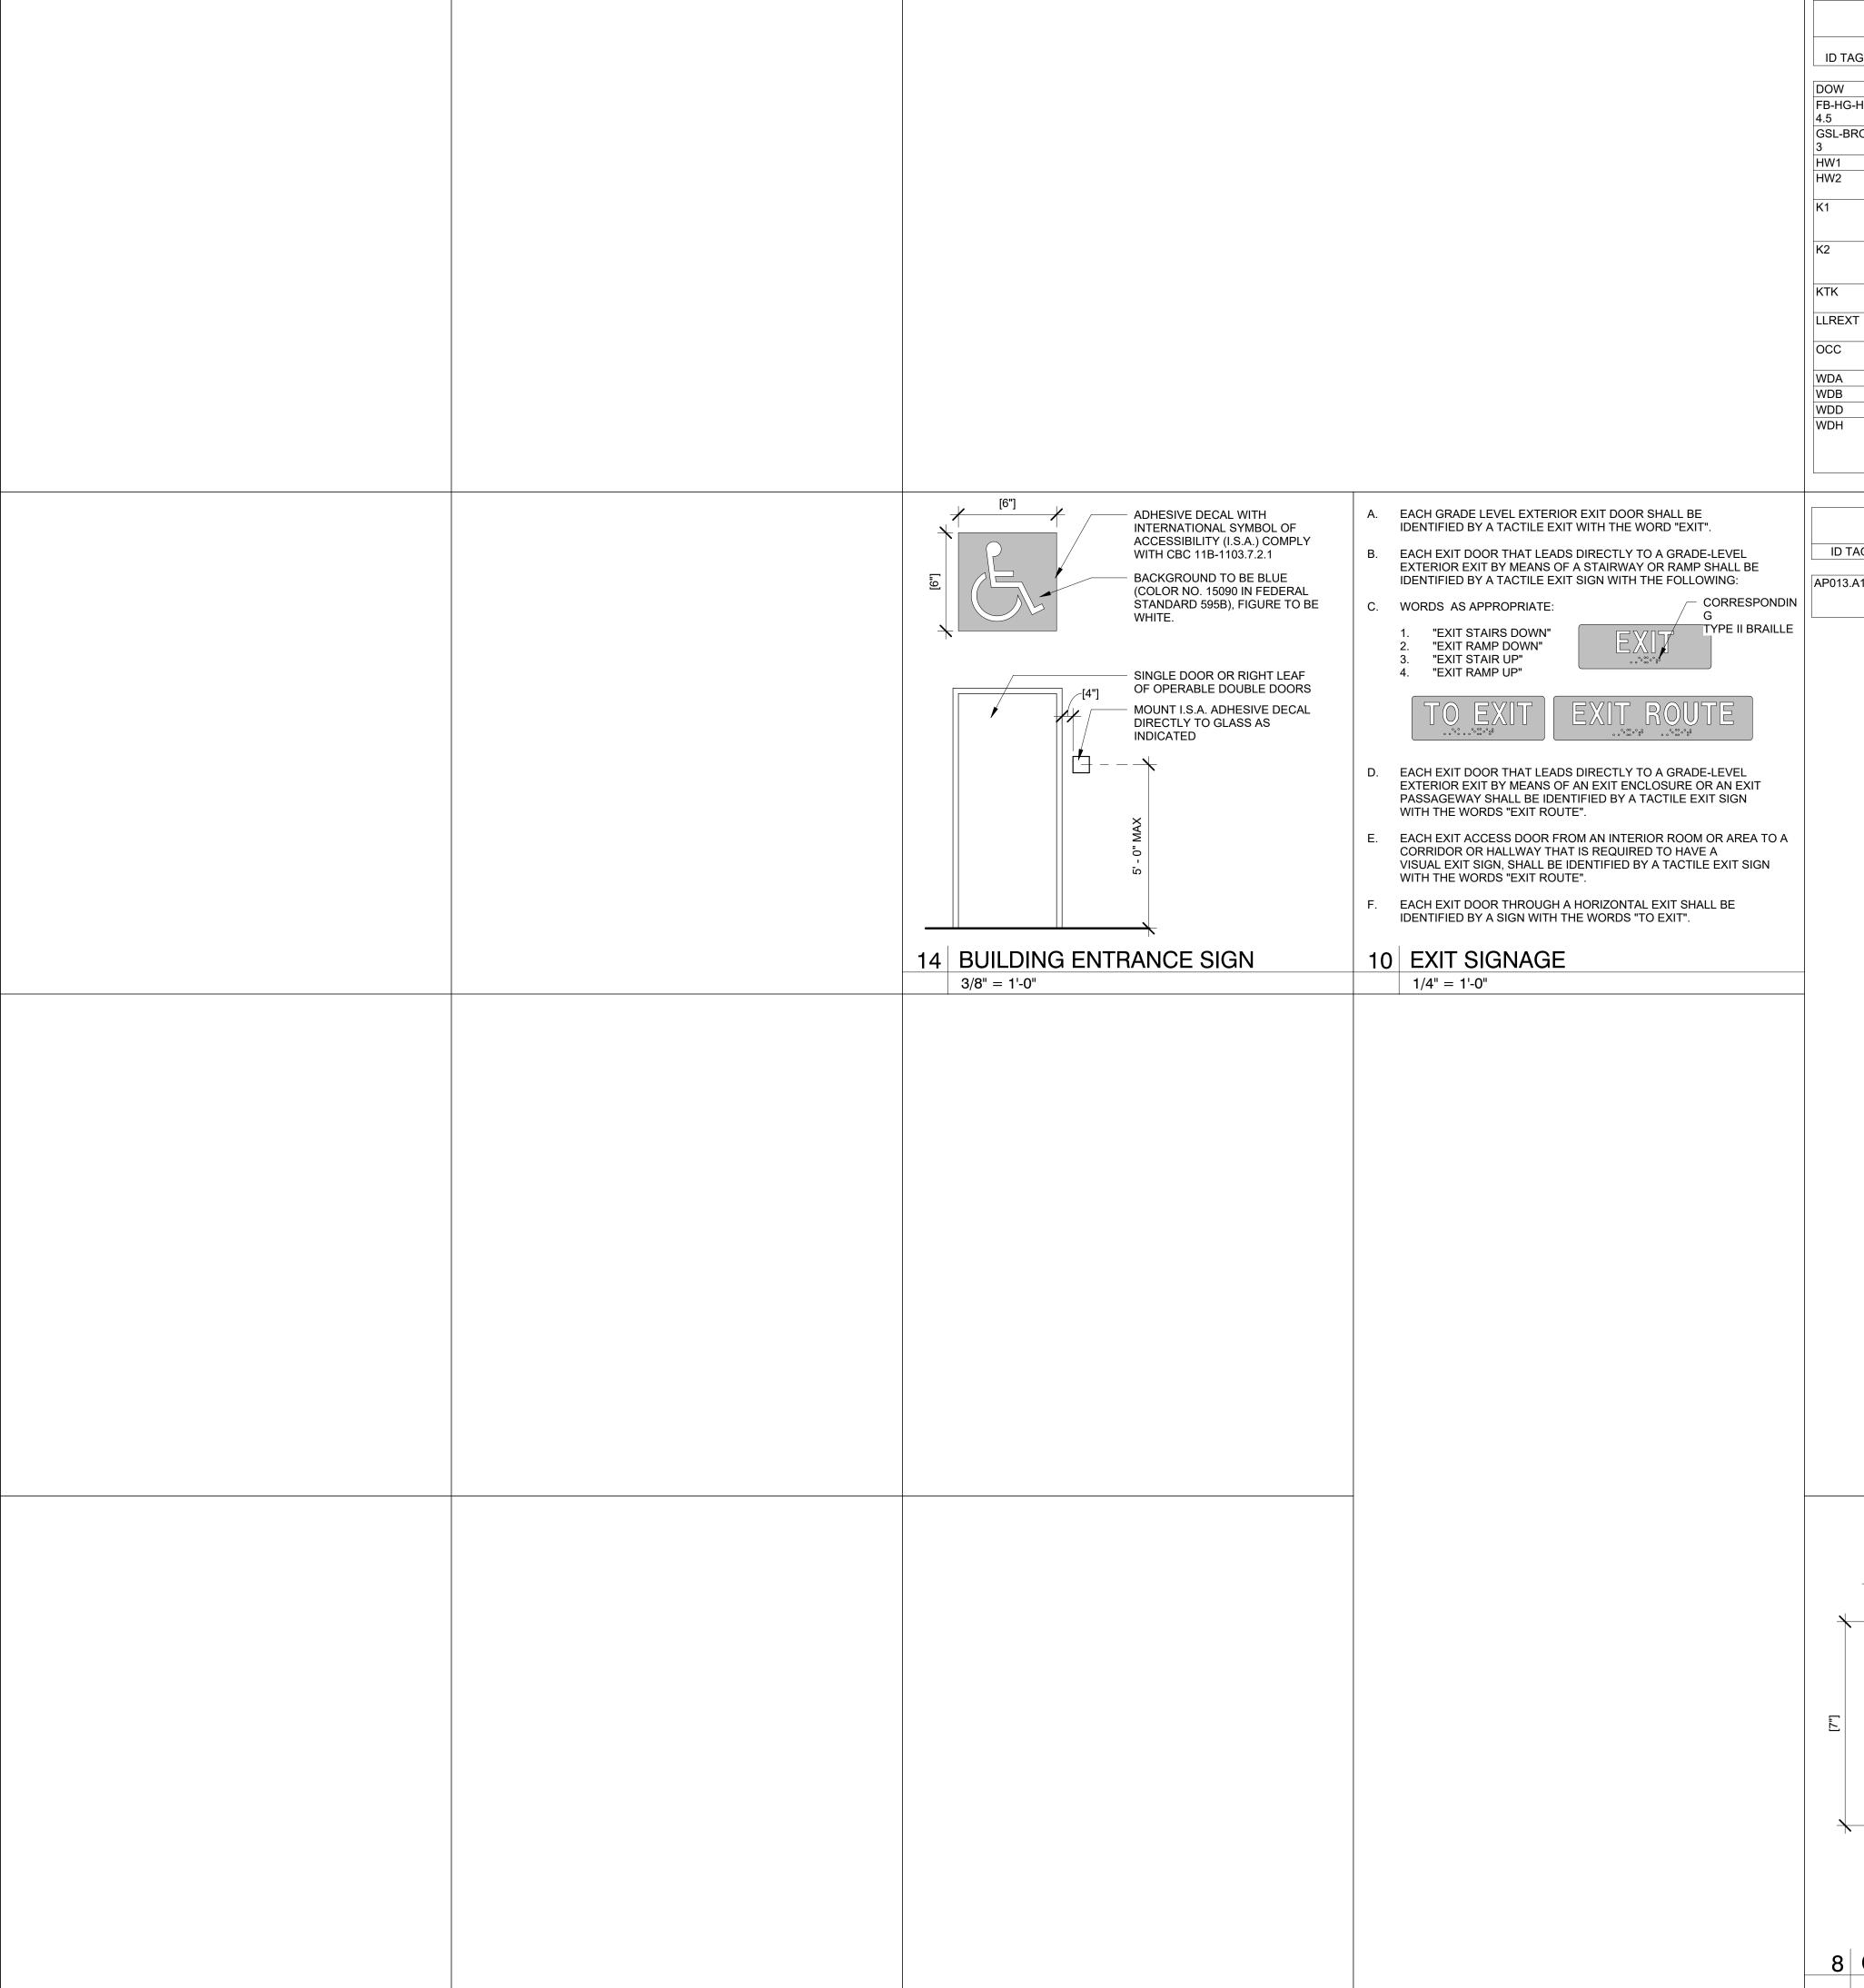
No.	Description	Date
	Tenant - Permit Set	7/18/2022
2	Tenant - Construction Set	11/09/2022
4	Tenant - Owner Revision	02/03/2023
5	Prototype Updates	05/29/2023

## **ARTWORK & GRAPHICS PLAN**

Drawn By: **05/29/2023** DPM:

1/4" = 1'-0"

24 ARTWORK & GRAPHICS PLAN



Bakery-Cafe: SIGNAGE SCHEDULE DETAIL/ ID TAG QTY DESCRIPTION SIZE MOUNTING INSTRUCTIONS REF. DAYS OF THE WEEK [G4] 23"W x 7.67"H MOUNT TO WALL FB-HG-H- 1 HORIZONTAL FOOD BELIEFS STATEMENT; HEARTY 4.5" LETTER HEIGHT MOUNTED NEAR BAKERY SYSTEM: G4 (ARIA) GREEN/SPRING GREEN Project Team: GSL-BRO- 1 GENEROSITY STATEMENT LOCK UP; BROWN/BRASS? 3" LETTER HEIGHT / 37.6"H MOUNTED NEAR BAKERY [G4] HAND WASH SIGN (RESTROOM MIRROR) 11"W x 1.75"H MOUNT ON MIRROR IN RESTROOM MOUNT ON TILE NEXT TO MIRROR HAND WASH 4"W x 4"H IN RESTROOM MEN'S ACCESSIBLE TOILET SIGN 6"W x 9"H 60" AFF TO CENTER OF SIGN; 48" MIN. & 60" MAX. TO BASE LINE OF LOWEST TACTILE CHARACTER WOMEN'S ACCESSIBLE TOILET SIGN 6"W x 9"H 60" AFF TO CENTER OF SIGN; 48" MIN. & 60" MAX. TO BASE LINE OF LOWEST TACTILE CHARACTER KNEAD TO KNOW COMMUNICATION BOARD 48"W x 36"H 5'-0" CENTERLINE OF BOARD, PROVIDED & INSTALLED BY OWNER LLREXT LANDFILL, LANDFILL & RECYCLE TAGS FOR EXTERIOR 8"W x 1"H; 3 TOTAL MOUNT ON TRASH/BUSSING TRASH/BUSSING UNIT STATION TRASH HOOD OCCUPANCY SIGN [G4] MOUNT ON WALL NEAR MAIN 6"W x 6"H ENTRANCE 12"W x 17.25"H MOUNT ON BAKERY CASE GLASS [G4] WINDOW DECAL - ALLERGY MOUNT TO BAKERY CASE GLASS [G4] WINDOW DECAL - BAKERY 18"W x 6.75"H [G4] WINDOW DECAL - DONATION 19.5"W x 6.85"H MOUNT ON BAKERY CASE GLASS [G4] WINDOW DETAL - HOURS 12"W x 24"H MOUNT OUTSIDE ON RIGHT SIDELIGTH, IF NO SIDELIGHT, MOUNT ON RIGHT DOOR BELOW DOOR HANDLE

# ARTWORK SCHEDULE


SIŹE SÚBSŤRATÉ & MOÚNTING ID TAG QTY DESCRIPTION FRAME MATTE Y/N AP013.A1 CARMI GRAU FULL PRINT; 8'-0" X 5'-0" SUBSTRATE : CANVAS WHITE OAK NO MONOCHROME COLORWAY W/ FRAME

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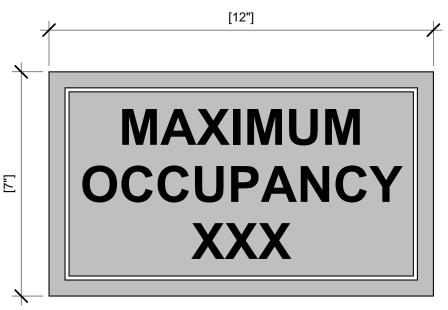
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12" x 7" ACRYLIC PANEL OCCUPANCY SIGN WHITE GRAPHICS ON BLUE BACKGROUND. INSTALL AT 60" A.F.F. ADJACENT TO ENTRANCE DOORS

8 OCCUPANCY SIGN 1/4" = 1'-0"

BACKGROUND

# **GENERAL NOTES:**

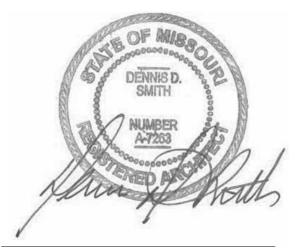- ALL SIGNS WILL BE PROVIDED BY OWNER TO G.C. FOR INSTALLATION.
- VENDOR TO VERIFY ALL QUANTITIES AND CURRENT GRAPHIC DESIGNS WITH OWNER PRIOR TO FABRICATING.
- REFERENCE SHEET A511 FOR SIGNAGE ELEVATIONS.

**ARTWORK & SIGNAGE** SCHEDULES, DETAIL O NOTEC

& NOI	ES	
Project Number:		Sheet Number:
22302		
Drawn By:		A 70
Author		$\Delta I I'$
Issue Date:		
07/05/2022		
DPM:	DM:	CPM:
DPM	DM	CPM

- THE CONTRACTOR SHALL COORDINATE WITH ALL OTHER TRADES IN LOCATING DUCTWORK, PIPING AND EQUIPMENT TO AVOID ANY INTERFERENCE.
- COORDINATE INSTALLATION OF NEW DUCT W/ STRUCTURE.
- CONTRACTOR TO INSTALL ALL WORK IN STRICT COMPLIANCE WITH LOCAL CODES AND ORDINANCES.
- MECHANICAL CONTRACTOR SHALL SUBMIT SHOP DRAWINGS AND EQUIPMENT SUBMITTAL PRIOR TO INSTALLING OR FABRICATING ANY DUCTWORK.
- PAINT INSIDE OF DIFFUSERS BLACK TO MINIMIZE VIEWING OF DUST AND DIRT.
- PROVIDE FIBERGLASS INSULATION BLANKET ABOVE TOPS OF ALL SUPPLY AIR DIFFUSERS.
- PROVIDE ADJUSTABLE VOLUME DAMPER AT ALL BRANCH DUCTWORK.
- PROVIDE TURNING VANES AT ALL RECTANGULAR ELBOWS (TYPICAL).
- MECHANICAL CONTRACTOR TO REPLACE FILTER AFTER CONSTRUCTION IS COMPLETED.
- CONTRACTOR TO PAINT ANY EXPOSED DUCT/DIFFUSERS WITHIN F.O.H. REFER TO ARCHITECTURAL RCP FOR

### **KEYED NOTES:**

- (MO1)> SHELL CONTRACTOR PROVIDED ROOF TOP UNIT AS SHOWN IN SCHEDULE ON SHEET M201.
- ⟨MO2⟩ SHELL CONTRACTOR PROVIDED U.L. LISTED IONIZATION TYPE SMOKE DETECTORS INTERLOCKED W/ RTU CONTROLS TO SHUT RTU DOWN UPON ACTIVATION OF DETECTOR. FIRE ALARM RESETS NEED TO BE CEILING
- <M03> CONTRACTOR TO PROVIDE AND INSTALL ONE PIECE THERMOSTAT (C0STAT06FF1L COMML TOUCHSCREEN TSTAT) WITH WALL MOUNTED SENSOR AND CONTROLLER MOUNTED IN THE INFINITY PANEL. COORDINATE LOCATIONS WITH OTHER ELEMENTS OF WALL/COLUMN. VERIFY EXACT LOCATION IN FIELD, COORDINATE WITH OWNER REPRESENTATIVE. MOUNT SENSOR AS SHOWN ON PLAN (54" A.F.F.). ON PROJECTS USING ONE-PIECE THERMOSTATS, THE MOUNTING HEIGHT IS 48" PER ADA. DO NOT LOCATE SENSOR/T-STAT ON WALL TILE. T-STAT WIRING SHALL ROUTE THRU CPI PANEL. COORDINATE EXACT REQUIREMENTS WITH CPI REPRESENTATIVE. THERMOSTATS MOUNTED ON EXTERIOR WALLS SHALL BE INSTALLED ON AN INSULATED BASE.
- <MOA> MANUFACTURER INSTALLED TYPE-II HOOD FOR RACK OVEN. EXTEND NEW 8" DIA ID. TO 12" DIA. DOUBLE WALL GALVANIZED STEEL EXHAUST DUCT PER MANUFACTURER'S RECOMMENDATIONS UP THRU ROOF WITH FLUE SHEET M201 AND OVEN DETAILS ON SHEET M301 AND M402. FAN IS PURCHASED BY G.C. AND INSTALLED BY CONTRACTOR. BALANCE EF-1 TO 690 CFM. SEE ELECTRICAL DRAWINGS THIS SET FOR HOOD LIGHT SWITCH LOCATION. INSTALL ALL COMPONENTS IN STRICT COMPLIANCE WITH LOCAL CODES PER MFGR'S RECOMMENDATIONS. LOCATE FAN OUTLET 10' MIN. FROM ANY AIR INTAKE.
- M05> DIRECT VENT CLOSED COMBUSTION FLUE AND COMBUSTION PVC LINES FROM WATER HEATER UP THROUGH ROOF. TERMINATE PER MANUFACTURER'S RECOMMENDATIONS, MINIMUM 4 FEET CLEARANCE BETWEEN INTAKE AND EXHAUST / FLUE. VERIFY LOCATION. SEE DETAIL SHEET M401.
- <MOô> RUN 10" DIA. EXHAUST DUCT DOWN FROM EF-3 ON ROOF (SEE SHEET M501). CONNECT TO EXHAUST GRILLES IN TOILET ROOM. BALANCE AS INDICATED. PROVIDE BACK DRAFT DAMPER AT EACH GRILLE. SEE FAN DETAIL SHEET M401 AND FAN SCHEDULE ON SHEET M201. PROVIDE CONTROL RELAY AND INTERLOCK WITH KITCHEN LIGHTING CIRCUIT. SEE WIRING DIAGRAM ON SHEET M301. FIELD VERIFY.
- ROUTE DUCTWORK THROUGH JOIST WEBBING. COORDINATE EXACT LOCATIONS IN FIELD.
- <M08> SEE ARCHITECTURAL DRAWING FOR DIFFUSER COLOR. PROVIDE AIRTECH CEILING TILE PROTECTOR ON ALL DIFFUSERS IN DINING ROOM. SEE NOTES ON AIR DEVICE SCHEDULE.
- (MO9) DISHWASHER TYPE II HOOD BY "CAPTIVE-AIRE". SEE FAN SCHEDULE SHEET AND DETAIL SHEET M201 AND M302. INSTALL NEW 10" DIA. (22 Ga. STAINLESS STEEL OR ALUMINUM) EXHAUST DUCT TO EF-2 ON ROOF BY CONTRACTOR (SEE SHEET M501). SEE SHEET E107 FOR WIRING INTERCONNECTION DIAGRAM. SUCH THAT FAN ONLY RUNS WHEN DISHWASHER IS ON. DISHWASHER HOOD IS PURCHSED BY OWNER FROM "CAPTIVE-AIRE" AND INSTALLED BY CONTRACTOR. SEE SHEET M302 FOR DISHWASHER VENTILATION INFORMATION..
- M10> PROVIDE A YOUNG REGULATOR IN GYPSUM BOARD CEILING WHERE INDICATED FOR ACCESS TO VOLUME DAMPERS.REFER TO DETAIL 7, SHEET M401.
- PROVIDE AIRTECH CEILING TILE PROTECTOR ON ALL DIFFUSERS IN DINING ROOM. SEE NOTES ON AIR DEVICE

 $oldsymbol{u}$ 

**Bakery-Cafe:** 

SYSTEM: G4 (ARIA) Project Team:




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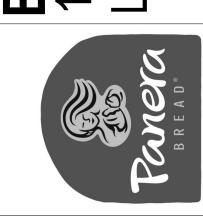
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Professional Seal:



Project Title:

64086 406 \S S **Bake** 1410 LEES

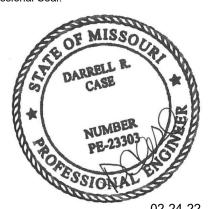

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St. Louis, MO 63026 CERTIFICATE OF AUTHORITY NO. 001498

Description 1 PERMIT SET - TI 7/18/2022 2 TI UPDATES 9/22/2022 3 CONSTRUCTION SET 11/09/2022 4 OWNER REVISION 02/03/2023 05/26/2023 5 MEP UPDATES

F 636.349.1730

**MECHANICAL PLAN** & NOTES Project Number: Sheet Number: LKA-MO-01-22 Drawn By:

07/05/2022 DPM:

NOTE: MANUFACTURERS' NAMES ON WHICH THIS SPECIFICATION IS BASED INDICATE THE MINIMUM QUALITY OF PRODUCT REQUIRED. SUB-STITUTION MAY BE MADE TO THOSE SPECIFIED IF DEEMED EQUIVALENT BY THE OWNER'S REPRESENTATIVE. ALL WORK AND PRODUCTS SHALL MEET THE REQUIREMENTS OF THE OWNER AND GOVERNING CODES.

- L WORK SHALL BE PERFORMED IN CONFORMANCE WITH ALL APPLICABLE CODES AND THE OWNER'S MINIMUM REQUIREMENTS AS STATED HEREIN OR OTHERWISE INDICATED BY THE OWNER.
- SEE ARCHITECTURAL GENERAL AND SPECIAL CONDITIONS. ALL ONDITION REQUIREMENTS SHALL APPLY UNLESS OTHERWISE NOTED.
- LL WORK SHALL BE PERFORMED AS INDICATED ON DRAWINGS
- UNLESS FIELD CONDITIONS REQUIRE MINOR CHANGES BE MADE. MINOR CHANGES SHALL BE MADE WITH NO ADDITIONAL COST.
- ALL WORK SHALL BE GUARANTEED FOR A PERIOD OF ONE YEAR FTER FINAL ACCEPTANCE OF THE WORK BY THE OWNER.
- CONTRACTOR SHALL PREPARE AND SUBMIT AS-BUILT DRAWINGS TO THE OWNER WITHIN 90 DAYS. AS-BUILT DRAWINGS SHALL INDICATE THE ACTUAL MANUFACTURER OF THE EQUIPMENT THAT WAS INSTALLED. THE EXACT LOCATION OF THE EQUIPMENT AND PERTINENT CAPACITIES FOR HEATING, COOLING, ETC.
- PORTED FROM CEILING, SOFFIT, NEUTRAL PIERS, PIPING, DUCT-WORK, METAL ROOF DECK, LATERAL BRACING, BRIDGING OR CONDUIT. ITEMS SHALL ONLY BE SUPPORTED FROM STRUCTURE VHICH HAS BEEN APPROVED BY THE ARCHITECT FOR SUPPORT

EQUIPMENT, FIXTURES, AND ACCESSORIES SHALL NOT BE SUP-

- LL ROOF WORK PENETRATIONS AND REPAIRS SHALL BE TOTALLY PERFORMED BY ONLY THOSE ROOFING CONTRACTORS APPROVED BY THE GENERAL CONTRACTOR.
- INSTALLATION OF ROOF MOUNTED EQUIPMENT SHALL BE COOR-DINATED WITH THE GENERAL CONTRACTOR AND OTHER TRADES.
- DEFICIENCIES AND NON-CONFORMING ITEMS SHALL BE CORRECTED BY THE CONTRACTOR. FAILURE TO CORRECT SUCH ITEMS SHALL PERMIT THE LANDLORD TO CORRECT SAME AT A COST TO THE
- THE CONTRACTOR SHALL BE RESPONSIBLE FOR SECURING ALL PERMITS AND PAYING FOR SAME. HE SHALL INCLUDE IN HIS BID CHARGES FOR ALL FEES ASSOCIATED WITH THE CONSTRUCTION OF THE SPACE INCLUDING BUT NOT LIMITED TO LOCAL, COUNTY OR STATE SERVICE CHARGES AND PERMIT FEES, AND UTILITY AND/OR EQUIPMENT CHARGES.
- 11. THE SCOPE OF WORK OF THIS CONTRACT INCLUDES, BUT SHALL NOT BE LIMITED TO:
- PROVIDE AND INSTALL ALL EQUIPMENT, APPLIANCES, CON-TROL DEVICES, ACCESSORIES, MATERIAL AND LABOR.
- PROVIDE AND INSTALL ALL DUCTWORK, INSULATION, AIR DEVICES, DUCT ACCESSORIES, MATERIAL AND LABOR. PROVIDE AND INSTALL ALL PIPING, FITTINGS, VALVES, IN-
- SULATION, ACCESSORIES, MATERIAL AND LABOR. PROVIDE AND INSTALL EXHAUST SYSTEM(S) INDICATED.
- PROVIDE AND INSTALL ALL ROOF WORK, INCLUDING EQUIP-MENT SUPPORTS, ROOF PENETRATIONS, PATCHING AND WATERPROOFING OF ROOF.
- PROVIDE ALL EQUIPMENT SUPPORTS AND HANGERS INCLUD-ING ANY AUXILIARY STEEL REQUIRED. ANY STRUCTURAL MOD-IFICATION TO THE BUILDING STRUCTURE SHALL BE MADE ONLY WITH THE WRITTEN APPROVAL OF THE LANDLORD.
- CLEAN, TEST AND PUT INTO SERVICE ALL SYSTEMS SPECIFIED. PROVIDE A BALANCE REPORT PREPARED BY AN INDEPENDENT AABC OR NEBB CERTIFIED AIR BALANCE CONTRACTOR.
- AND ENGINEER OF RECORD UPON COMPLETION. WARRANTY ALL WORK AND MATERIALS HEREIN SPECIFIED FOR A PERIOD OF NOT LESS THAN ONE YEAR. MATERIALS

PROVIDE CERTIFIED BALANCE REPORT TO BUILDING OFFICIAL

1 ALL MATERIALS SHALL BE NEW AND OF RECOGNIZED COM-MERCIAL QUALITY. USED MATERIALS WILL NOT BE PERMITTED.

12.2 DUCTWORK

- EXPOSED ROUND/SPIRAL DUCTWORK SHALL BE CONSTRUCTED OF NEW DOUBLE WALL INSULATED GALVANIZED PRIME GRADE SHEET STEEL.
- ALL DUCTWORK SHALL BE DESIGNED IN ACCORDANCE WITH THE PROCEDURES DESCRIBED IN THE LATEST EDITION OF THE AMERICAN SOCIETY OF HEATING REFRIGERATION AND AIR CONDITIONING ENGINEERS GUIDE (ASHRAE), FABRICATED AND INSTALLED IN ACCORDANCE WITH THE METHODS RECOMMENDED IN THE SHEET METAL AND AIR CONDITIONING CONTRACTORS NATIONAL ASSOCIATION (SMACNA) LOW VELOCITY DUCT MANUAL LATEST EDITION, DUCT WORK SHALL BE SHEETMETAL EXTERNALLY WRAPPED WITH 2-1/2" THICK FIBERGLASS (.75 LB. DENSITY) INSULATION HAVING A MIN. R VALUE OF 8.0; FOIL FACED, INSULATION HAVING A MIN. R VALUE OF 6.0.
- NEW 2-1/2" THICK EXTERNALLY (.75 "LB. DENSITY) WITH MIN. VALUE OF R-6.0 INSULATED "LOW PRESSURE" SUPPLY AIR DUCT INSTALLED BY HVAC CONTRACTOR, PROVIDE TRANSITIONS AS REQUIRED, DUCT DIMENSIONS ARE CLEAR INTERNAL AIR PATH DIMENSIONS.
- FLEXIBLE AIR DUCT FOR CONNECTIONS BETWEEN S.M. DUCT AND DIFFUSER SHALL BE AIR DUCT LISTED BY UNDERWRITERS LABORATORIES UNDER UL STANDARD 181 AS A CLASS 1 FLEXIBLE AIR DUCT AND COMPLYING WITH NFPA STANDARDS 90A AND 90B. DUCT SHALL BE FACTORY MADE AND COMPOSED OF A CPE LINER DUCT PERMANENTLY BOUNDED TO A COATED SPRING STEEL WIRE HELIX AND SUPPORTING A FIBER GLASS INSULATING BLANKET. R.-6.0. LOW PERMEABILITY OUTER VAPOR BARRIER OF FIBER GLASS REINFORCED FILM LAMINATE SHALL COMPLETE THE
- DUCTWORK 18" WIDTH AND LARGER SHALL BE CROSS-BROKEN OR RIBBED AND STIFFENED SO THAT IT WILL NOT "BREATHE", RATTLE, VIBRATE OR SAG.
- FIBERGLASS DUCTWORK WILL ONLY BE PERMITTED WITH THE APPROVAL OF THE OWNER, ARCHITECT, AND ENGINEER.
- ALL JOINTS, LONGITUDINAL AND TRANSVERSE SEAMS, AND CONNECTIONS IN DUCTWORK MUST BE SECURELY SEALED USING WELDMENTS; MECHANICAL FASTENERS WITH SEALS, GASKETS, OR TAPES, TAPES MUST BE LISTED AND LABELED IN ACCORDANCE WITH UL 181A OR UL 181B. ALL LONGITUDINAL AND TRANSVERSE JOINTS. SEAMS AND CONNECTIONS OF SUPPLY AND RETURN DUCTS OPERATING AT STATIC PRESSURES LESS THAN OR EQUAL TO 2" W.G. SHALL BE SECURELY FASTENED AND SEALED WITH WELDS GASKETS OR TAPES MECHANICAL FASTENERS AND SEALS OR GASKETS MUST BE USED WHEN CONNECTING DUCTS TO FANS AND OTHER AIR DISTRIBUTION
- INSTALLED IN ACCORDANCE WITH MANUFACTURER'S INSTALLATION AND ANSI/SMACNA 006-2006 HVAC DUCT CONSTRUCTION STANDARDS.
- FLEXIBLE DUCTWORK:
- SHALL HAVE AN IMPERVIOUS INNER CORE WITH WIRE REIN FORCEMENT. THE INNER DUCT SHALL BE COVERED WITH 1.5" THICK FIBERGLASS DUCT INSULATION WITH A POLY-ETHYLENE VAPOR-PROOF JACKET. FLEXIBLE DUCT SHALL BE UL-181 LISTED, CLASS 1, AND SHALL MEET ALL APPLICABLE CODES AND THE REQUIREMENTS OF THE LANDLORD.
- FITTINGS TO CONNECT THE FLEX DUCT TO THE TRUNK DUCT SHALL BE OF THE 45° LEAD-IN TYPE PER THE LATEST OF SMACNA STANDARDS AND SHALL HAVE AN OPPOSED BLADE VOLUME DAMPER, SQUARE-TO-ROUND TRANSITION AND SHALL HAVE THE SAME FREE AREA AS THE SPECIFIED FLEX DUCT.
- FLEX DUCT SHALL BE THE PRODUCT OF AN ESTABLISHED MANUFACTURER OF SUCH PRODUCTS AND EQUIVALENT TO CERTAINTEED MODEL G-25. WIREMOLD WGC. OR PPG

#### 12.4 DUCT INSULATION

ALL SUPPLY AND RETURN AIR DUCTWORK (EXCEPT FLEXIBLE DUCTS) SHALL BE INSULATED EXTERNALLY UNLESS SPECIFICALLY NOTED OTHERWISE ON THE DRAWINGS. EXTER-NAL DUCT INSULATION (DUCT WRAP) SHALL BE 1-1/2" THICK FIBERGLASS DUCT WRAP WITH VINYL OR FSK FACING. DUCT WRAP SHALL HAVE A K-FACTOR OF .28 AT 75°F MEAN AND A DENSITY OF .75 LB./C.F.

ALL DUCT INSULATION SHALL BE UL LABELED FOR FIRE AND

DUCT INSULATION SHALL BE EQUAL TO PRODUCTS MANUFAC-TURED BY CERTAINTEED AND SHALL BE INSTALLED IN STRICT ACCORDANCE WITH THE MANUFACTURER'S RECOMMENDATIONS. NOTE: ALL RESTAURANT DUCTWORK SHALL BE EXTERNALLY INSULATED - NO INTERNAL INSULATION ALLOWED.

#### 12.5 PIPING AND FITTINGS

CONDENSATE DRAIN PIPING SHALL BE TYPE L COPPER WITH SOLDERED JOINTS AND WROUGHT COPPER FITTINGS.

#### EQUIPMENT

HVAC EQUIPMENT SHALL BE AS SCHEDULED ON THE DRAWINGS AND/OR SPECIFIED HEREIN. EQUIVALENT EQUIPMENT AND/OR COMPONENTS THEREOF MAY BE SUBSTITUTED FOR SPECIFIED EQUIPMENT ONLY AS APPROVED BY THE OWNER AND/OR THE PROJECT ENGINEER.

#### 14. EXECUTION

#### 14.1 GENERAL

- ACCESSIBILITY ALL EQUIPMENT SHALL BE INSTALLED IN SUCH A MANNER THAT ALL COMPONENTS REQUIRING ACC-ESS ARE LOCATED AND INSTALLED THAT THEY MAY BE SER-VICED, RESET, REPLACED, OR RECALIBRATED, ETC., BY SER-VICE PEOPLE WITH NORMAL SERVICE TOOLS AND EQUIPMENT.
- WORK BY OTHER TRADES FOR THE WORK REQUIRED BY OTHER TRADES FOR CHANGES MADE BY THIS CONTRACTOR IN TYPE OR SIZE OF EQUIPMENT PURCHASED, ANY CUTTING PATCHING, FURRING, PAINTING, ELECTRICAL OR PLUMBING WORK SHALL BE DONE BY THE AFFECTED TRADE AT THIS CONTRACTOR'S EXPENSE.
- WORK NOT INCLUDED POWER WIRING, INCLUDING FINAL CONNECTIONS, IS BY THE ELECTRICAL CONTRACTOR. THE
- FURNISH THE STARTING EQUIPMENT TO THE ELECTRICAL CONTRACTOR FOR INSTALLATION. CONTROL WIRING, INCLUD-ING 115V FROM POWER SOURCE, CONDUIT AND SWITCHES SHALL BE FURNISHED BY THE MECHNICAL CONTRACTOR. CONTROL DEVICES, THERMOSTATS, INTERLOCKS, ETC. SHALL BE FURNISHED BY THE MECHANICAL CONTRACTOR, WIRING DIAGRAMS AND INSTALLATION INSTRUCTIONS SHALL BE FURNISHED TO THE OWNER UPON PROJECT COMPLETION.
- EARLY START-UP THIS CONTRACTOR SHALL ENSURE THAT ALL MECHANICAL EQUIPMENT IS CONNECTED WITH ELECTRICAL POWER AS EARLY AS POSSIBLE SO THAT BALANCING AND TESTING CAN BEGIN AT THE EARLIEST DATE AVAILABLE.
- CLEANING AND PAINTING THOROUGHLY CLEAN ALL EQUIP-MENT AND REMOVE ALL TRASH, CARTONS, ETC., FROM THE WORK AREA. MAKE ANY NECESSARY CORRECTIONS OR REPAIR REPLACE ANY DAMAGED MATERIALS OR EQUIPMENT. LEAVE THE ENTIRE LEASE SPACE IN A THOROUGHLY CLEAN AND ORDERLY MANNER. ANY FINISHED SURFACES THAT HAVE BEEN SCRATCHED OR DISCOLORED SHALL BE TOUCHED UP OR REPAINTED TO MATCH THE ORIGINAL COLOR. IF ANY PART HAS BEEN BENT, BROKEN OR OTHERWISE DAMAGED, IT SHALL BE REPLACED PRIOR TO PROJECT CLOSEOUT. ALL METAL ITEMS INSIDE THE BUILDING SUBJECT TO RUSTING, AND ALL FERROUS METAL EXPOSED TO THE WEATHER SHALL BE GIVEN ONE COAT OF RUST PREVENTIVE PRIMER AS SOON

#### 14.2 EQUIPMENT INSTALLATION

ALL EQUIPMENT AND RELATED PIPING, DUCTWORK, CONTROL WIRING AND ACCESSORIES SHALL BE INSTALLED PARALLEL OR PERPENDICULAR TO BUILDING LINES AND JE INSTALLED WITHIN THE BUILDING ENVELOPE SHALL BE INSTALLED AS HIGH AS POSSIBLE TO ALLOW THE MAXIMUM AMOUNT OF HEADROOM FOUIPMENT THAT REQUIRES ROUTINE MAINTEN ANCE SUCH AS FILTER REPLACEMENT SHALL BE INSTALLED AND ARRANGED TO BE ACCESSIBLE. PROVIDE ACCESS PANEL(S) AS REQUIRED AND/OR AS RECOMMENDED BY THE EQUIPMENT MANUFACTURER. ALL EQUIPMENT SHALL BE INSTALLED WITH THE REQUIRED CLEARANCES AS RECOMMENDED BY THE EQUIPMENT MANUFACTURER OR AS REQUIRED BY GOVERNING CODES, WHICHEVER IS GREATER.

#### 14.3 DUCTWORK

LOW PRESSURE DUCTWORK AND FITTINGS SHALL BE MADE TIGHT FOR MINIMUM AIR LEAKAGE. DUCT TAPE SHALL NOT BE USED TO SEAL JOINTS, TO MAKE TRANSITIONS OR FOR ANY OTHER REASON ON THE OUTSIDE OF WRAPPED INSULATION.

#### INSTALL DUCTWORK AS HIGH AS POSSIBLE.

- PROVIDE TURNING VANES AT ALL CHANGES IN DIRECTION.
- PROVIDE VANED TEES AT BRANCH CONNECTIONS SERVING SERVING MORE THAN ONE DIFFUSER.
- PROVIDE VOLUME CONTROL DAMPERS AND BALANCING DE-VICES AS REQUIRED TO DISTRIBUTE THE AIR AND AS INDI-CATED ON THE DRAWINGS.
- NOTE: DUCT DIMENSIONS INDICATED ON THE DRAWINGS ARE INSIDE CLEAR OR "FREE AREA" DIMENSIONS CONTRACTOR SHALL MAKE ALLOWANCE FOR INTERNAL DUCT LINER (WHERE SPECIFIED) WHEN ORDERING PRE-FABRICATED DUCTWORK OR WHEN FABRICATING DUCTS IN THE FIELD.

#### 14.4 FLEXIBLE DUCTWORK

- DUCTWORK SHALL BE LIMITED IN LENGTH TO THAT NECESS-ARY TO MAKE CONNECTIONS BETWEEN TRUNK OR BRANCH DUCTS AND AIR DEVICES. FLEX DUCT LENGTH SHALL NOT EXCEED 5'-0".
- ALL FLEX DUCT SHALL BE FULLY STRETCHED OUT TO RE-DUCE AIR RESISTANCE
- CONNECTIONS TO FITTINGS OR AIR DEVICES SHALL BE MADE WITH TWO (2) STAINLESS STEEL BANDS. THE INNER LINER SHALL BE CLAMPED TIGHT WITH THE FIRST BAND. THEN THE INSULATION AND VAPOR-PROOF JACKET PULLED TO BE TIGHT AGAINST THE DUCT FITTING OR AIR DEVICE AND SECURED WITH THE SECOND BAND. INSTALLATION SHALL BE AS RE-COMMENDED BY THE DUCT MANUFACTURER AND SMACNA.
- SUPPORT THE FLEXIBLE DUCT WITH ADEQUATE HANGERS TO RELIEVE STRAIN ON ANY FITTING. UNNECESSARY BENDS, SAGS, TWISTS, ETC., WILL NOT BE ALLOWED.

#### 14.5 DUCT LINER & WRAP

- ALL DUCTWORK DESIGNATED TO RECEIVE DUCT LINER SHALL BE COMPLETELY COVERED WITH LINER. TRAVERSE JOINTS SHALL BE NEATLY BUTTED AND THERE SHALL BE NO INTER-
- DUCT LINER SHALL BE CUT AS REQUIRED TO ENSURE OVER-LAPPED AND COMPRESSED LONGITUDINAL CORNER JOINTS.
- FASTENERS SHALL START WITHIN 3" OF THE UPSTREAM TRAVERSE EDGES OF THE LINER AND 3" FROM THE LONG-ITUDINAL JOINTS AND SHALL BE SPACED AT A MAXIMUM OF 12" o.c. AROUND THE PERIMETER OF THE DUCT. ELSE-WHERE THEY SHALL BE SPACED AT A MAXIMUM OF 18" o.c. EXCEPT THAT THEY SHALL BE PLACED NOT MORE THAN 6" FROM A LONGITUDINAL JOINT OF THE LINER OR 12" FROM A CORNER BREAK
- DUCT WRAP SHALL BE INSTALLED IN A NEAT AND COMPE-TENT MANNER WITH ALL EDGES NEATLY COVERED WITH AN APPROVED METALLIC DUCT TAPE TO VAPOR-PROOF THE ENTIRE DUCT. LAPS AND JOINTS SHALL BE SECURED WITH INSULATION STAPLES AND THEN COVERED WITH APPROVED

DUCT WRAP SHALL BE INSTALLED IN A NEAT AND COMPE-TENT MANNER WITH ALL EDGES NEATLY COVERED WITH AN APPROVED METALLIC DUCT TAPE TO VAPOR-PROOF THE ENTIRE DUCT, LAPS AND JOINTS SHALL BE SECURED WITH INSULATION STAPLES AND THEN COVERED WITH APPROVED

#### 14.6 AIR DEVICES

INSTALL ALL GRILLES AND DIFFUSERS TO BE FLUSH WITH THE PENETRATED SURFACE AND LEVEL OR STRAIGHT WITH WITH SURROUNDING FEATURES. ALL CEILING MOUNTED AIR DEVICES BE LOCATED IN THE CEILING TILE INDICATED ON THE DRAWINGS. SUPPORT CEILING MOUNTED GRILLES AND DIFFUSERS AT THE PROPER HEIGHT TO HOLD IT SNUG AGAINST THE CEILING.

14.7 DUCT SEALANT PROVIDE DUCT SEALANT OF 2" WIDE, WOVEN-FIBER TAPE IMPREGNATED WITH GYPSUM MINERAL COMPOUND AND MODIFIED ACRYLIC/SILICONE ACTIVATOR TO REACT EXOTHERMICALLY WITH

TAPE TO FORM HARD, DURABLE, AIRTIGHT SEAL.

- SEAL DUCT TRAVERSE JOINTS FOR PRESSURE CLASS LESS THAN 2" AND PERFORM LEAKAGE TEST PRIOR TO INSTALLATION
- 15. INSTALL ROOF MOUNTED EQUIPMENT SUPPORT RAILS OR ROOF CURB AS REQUIRED FOR THE JOB CONDITIONS AND AS RECOM-MENDED BY THE MANUFACTURER FOR THE INSTALLATION OF ROOF MOUNTED EQUIPMENT. THE EXACT LOCATION OF ALL ROOF MOUNTED EQUIPMENT IS SUBJECT TO SITE CONDITIONS AND THE APPROVAL OF THE GENERAL CONTRACTOR COORDINATE THE ENTIRE INSTALLATION WITH THE GENERAL CONTRACTOR AND OTHER TRADES ELECTRICAL CONTRACTOR FOR INSTALLATION. CONTROL WIRING, INCLUDING CONTRACTOR SHALL PROVIDE A TEMPORARY PLYWOOD WORK PLATFORM THAT COMPLETELY SURROUNDS THE AREA WHERE NEW ROOF MOUNTED EQUIPMENT AND/OR DUCTS ARE TO BE INSTALLED. THE ENTIRE WORK AREA SHALL REMAIN ON THE ROOF DURING THE ENTIRE PERIOD OF INSTALLATION AND SHALL BE REMOVED FROM THE ROOF AND THE SITE BY THIS CONTRACTOR UPON COMPLETION OF THE INSTALLATION.
- ALL ROOF PENETRATIONS FOR POWER AND CONTROL WIRING CON-DUITS AND GAS, CONDENSATE, OR REFRIGERANT PIPING SHALL BE MADE WITH WATERPROOF PIPE SLEEVES.
- 16. THIS CONTRACTOR SHALL ENGAGE THE SERVICES OF AN AABC OR NEBB CERTIFIED AIR BALANCE CONTRACTOR TO ADJUST AND COMPLETELY BALANCE THE INSTALLED SYSTEM(S) TO THE DESIGN AIR QUANTITIES. CONTRACTOR SHALL PROVIDE THE OWNER. THE ARCHITECT AND AHJ A COPY OF THE CERTIFIED AIR BALANCE REPORT SHOWING DESIGN AND MEASURED AIR QUANTITIES. STATIC PRESSURES, FAN MOTOR RPM AND MOTOR CURRENT. DEVIATION BETWEEN DESIGN AND MEASURED QUANTITIES SHALL NOT BE GREATER THAN 10%.
- 17. ALL MATERIALS, EQUIPMENT AND INSTALLATION SHALL BE GUARANTEED FOR A MINIMUM PERIOD OF ONE (1) YEAR FROM THE DATE OF ACCEPTANCE BY THE OWNER. DEFECTS WHICH APPEAR DURING THAT PERIOD SHALL BE CORRECTED AT THIS CONTRACTOR'S EXPENSE
  - FOR THE SAME PERIOD. THIS CONTRACTOR SHALL BE RESPON-SIBLE FOR ANY DAMAGE CAUSED TO THE PREMISES BY DEFECTS IN HIS WORKMANSHIP OR WORK AND/OR EQUIPMENT INSTALLED BY OTHERS UNDER HIS CONTRACT

CONTRACTOR SHALL DEMONSTRATE OPERATION OF SYSTEM TO FULL SATISFACTION OF TENANT, SHALL BALANCE AIR FLOW IN ACCORDANCE WITH AIR QUANTITIES ON DRAWINGS AND SHALL RECORD VOLUME READINGS IN ACCORDANCE WITH ASHRAE AND PROVIDE SAME TO TENANT, OPERATION AND MAINTENANCE DOCUMENTATION MUST BE PROVIDED TO THE OWNER THAT INCLUDES AT LEAST THE FOLLOWING INFORMATION:

- A. EQUIPMENT CAPACITY (INPUT AND OUTPUT) AND REQUIRED MAINTENANCE ACTIONS. B. EQUIPMENT OPERATION AND MAINTENANCE MANUALS WITHIN 90 DAYS. C. HVAC SYSTEM CONTROL MAINTENANCE AND CALIBRATION INFORMATION. INCLUDING
- WIRING DIAGRAMS, SCHEMATICS, AND CONTROL SEQUENCE DESCRIPTIONS; OR FIELD-DETERMINED SET POINTS MUST BE PERMANENTLY RECORDED ON DRAWINGS, AT CONTROL DEVICES, OR, FOR DIGITAL CONTROL SYSTEMS, IN PROGRAMMING COMMENTS.
- D. COMPLETE NARRATIVE OF HOW EACH SYSTEM IS INTENDED TO OPERATE. ALL PIPING SHALL WITHSTAND AIR PRESSURE TESTING PER GOVERNING PLUMBING CODE.

#### FOR COMPANY BAKERY CAFES, THE GC IS RESPONSIBLE FOR SCHEDULING AND PROVIDING A TEST AND BALANCE REPORT TO PANERA REPRESENTATIVE PRIOR TO TURNOVER. G.C. SHALL USE AN AABC OR NEBB INDEPENDANT THIRD PARTY AIR BALANCE

#### **HVAC LEGEND** SYMBOL DESCRIPTION SUPPLY AIR DIFFUSER RETURN AIR GRILLE TOILET ROOM EXHAUST GRILL SPRINKLER HEAD DUCT MOUNTED SMOKE (SD) DETECTOR DIRECTION OF AIR FLOW VOLUME DAMPER THERMOSTAT (CONTOLLER) TEMPERATURE SENSOR FURNISH BY OWNER F.O.I.C INSTALL BY CONTRACTOR **FURNISH BY CONTRACTOR**

INSTALL BY CONTRACTOR

F.C.I.C

#### AIR BALANCE SCHEDULE (CFM) (CFM) PRESSURE EF-1 EF-2 400 EF-3 225 RTU-1 2000 RTU-2 2000 500 RTU-3 1000 4000 TOTALS: 8000 2000

ALL RTU FANS SHALL RUN CONTINUOUSLY DURING STORE OPERATION HOURS INCLUDING NIGHT BAKERY SHIFT.

BRANCH DUCT SCHEDULE								
SUPPLY AIR (CFM)	ROUND DUCT SIZE (Ø")							
0 TO 100	6"Ø							
100 TO 200	8"Ø							
200 TO 400	10"Ø							
400 TO 600	12"Ø							
600 TO 700	14"Ø							

EXHAUST FANS AND CURBS ARE SUPPLIED BY OWNER AND INSTALLED BY CONTRACTOR. ALL HOODS SUPPLIED BY OWNER AND INSTALLED BY CONTRACTOR. DUCTWORK IS SUPPLIED AND INSTALLED BY CONTRACTOR

## EXHAUST FAN SCHEDULE (EXISTING INSTALLED BY SHELL CONTRACTOR)

		10011711100	, ilbott	- ( -/ \			STALLED BY GIT	LLL GOITHUR	01011)	
	PLAN MARK	MANUFACTURER	MODEL	TYPE	SP	CFM	ELECTRICAL	OPTIONS	REMARKS {	
{	FF-1	CAPTIVEAIRE	DU50 FLA	UPBLAST	0.5	690	120/1/60 1/2 HP	ROOF CURB	F.O.I.C.	C
٩	EF-2	CAPTIVEAIRE	DU50 HFA	UPBLAST	0.5	400	120/1/60 1/3 HP	ROOF CURB	F.O.I.C.	7
	EF-3	GREENHECK	G-070-VG	ROOF MTD	0.5	150	120/1/60 1/6 HP	ROOF CURB	1	

1. FAN TO BE INTERLOCKED WITH MOTION SENSOR, FAN TO RUN 5 MINUTES AFTER LIGHTS TURN OFF.

#### PACKAGED ROOF TOP UNIT SCHEDULE - DX / GAS (EXISTING INSTALLED BY SHELL CONTRACTOR) COOLING (DX) - 95° F EVAP FAN **HEATING - GAS** MIN E.S.P. INPUT OUTPUT APPROX TAG LOCATION SERVICE TONS CFM OA (in. wg) HP TMBH SMBH EER MBH MBH BAT LAT VOLT PH MCA MOCP STARTER WEIGHT (LBS) DESIGN EQUIPMENT REMARKS RTU-1 ROOF 5 | 2000 | 500 | 1.00 | 1 | 60.1 | 42.2 | 12 | 150.0 | 120.0 | 55.4 °F | 88.6 °F | 208 | 3 | 35.0 | 50 RTU-2 ROOF 5 | 2000 | 500 | 1.00 | 1 | 60.1 | 42.2 | 12 | 150.0 | 120.0 | 55.4 °F | 88.6 °F | 208 | 3 | 35.0 | 50 1172 LENNOX LGH060S4B 1, 2, 3, 4, 5

REMARKS: 1. UNIT SHALL BE CLASSIFIED IN ACCORDANCE WITH ANSI-Z21.47, ARI 210 & 270.

RTU-3

ROOF

MINIMUM FRESH AIR CFM REQUIRED PER CODE

OTAL OF ALL FRESH AIR INTRODUCED INTO SPACE

- 2. UNIT SHALL HAVE MANUFACTURER'S 14" HIGH ROOF CURB, RETURN AIR SMOKE DETECTOR, UNIT MOUNTED DISCONNECT, THRU BASE ELECTRICAL SERVICE AND HINGED ACCESS DOORS.
- 3. MANUFACTURER SHALL FURNISH UNIT WITH DIFFERENTIAL ENTHALPY CONTROL ECONOMIZER WITH BAROMETRIC RELIEF DAMPER, 0 TO 100% FULLY MODULATING MOTORIZED OUTSIDE AIR DAMPERS, OUTSIDE AIR HOOD & ADJUSTABLE POSITION POTENTIOMETER. DAMPER ACTUATOR SHALL BE SPRING RETURN TYPE TO FULLY CLOSE OUTSIDE AIR DAMPER WHEN UNIT IS SHUT DOWN.

10 | 4000 | 1000 | 1.00 | 3.0 | 99.0 | 72.0 | 11.2 | 240.0 | 180.0 | 55.4 °F | 88.6 °F | 208 | 3 | 46.0 | 50 | PKGD.

4. COOLING CAPACITY IS BASED UPON 95°F AMBIENT AND 80/67 COIL ENTERING CONDITIONS, PROVIDE HIGH EFFICIENCY UNIT IF STANDARD EFFICIENCY UNIT DOES NOT MEET SCHEDULED VALUES. 5. LANDLORD CONTRACTOR SHALL PURCHASE FROM NATIONAL ACCOUNT. SEE CONTACTS ON THIS SHEET.

ENTILATION REQ	PER IMC 2015 TAB	PER IMC 2015 TABLE 403.3*								
ROOM NAME	Area (SF)	People/1000 SF	People	CFM/Person	CFM/SF	Ez	People X CFM/Person	SF X CFM/SF	REQUIRED O.A. CFM	PROVIDED O.A. CFM
TU-1 & RTU-2	000	70			0.40		500.0	470.0		000.00
INING	996	70	70	7.5	0.18	0.8	522.9	179.3	877.7	900.00
UEUING	100	15	2	7.5	0.06	0.8	11.3	6.0	21.6	25.00
AKERY SERVICE	293	15	4	7.5	0.12	0.8	33.0	35.2	85.2	90.00
OLD BEV	51	15	1	7.5	0.06	0.8	5.7	3.1	11.0	12.00
OT BEV	51	15	1	7.5	0.06	0.8	5.7	3.1	11.0	12.00
ORR, M, W TLT	244	15	4	7.5	0.12	0.8	27.5	29.3	70.9	75.00
TU-3										
ONSOLIDATION	264	15	4	7.5	0.12	0.8	29.7	31.7	76.7	8.00
ITCHEN	590	15	9	7.5	0.12	0.8	66.4	70.8	171.5	9.00
AKERY REAR	73	15	1	7.5	0.12	0.8	8.2	8.8	21.2	10.00
FFICE	29	15	0	7.5	0.06	0.8	3.3	1.7	6.3	11.00
TILITY	113	15	2	7.5	0.12	0.8	12.7	13.6	32.8	13.00

Bakery-Cafe:

AIR DEVICE SCHEDULE

MODULE

24x24

24x24

12x12

NOTE 1: PROVIDE WITH SBD INSULATED PLENUM, 1" SLOT

WIDTH, 2-SLOT, 8" LONG, 7" INLET

ADDITIONAL ORDERING INFORMATION:

\*MUST ORDER FRAME ADDITIONALLY

PROVIDE WITH INSULATION BOOT

\*\*THE FRAME IS INCLUDED W/ PART CAN BE USED

WITH (DRYWALL) OR WITHOUT (LAY-IN) FRAME

CTP1- CEILING TILE PROTECTOR - SINGLE

CTP5- CEILING TILE PROTECTOR - 5 PACK

AIR DEVICE LEGEND

y a fina a sur a s

SUPPLY

XXX CFM

LENNOX LGH120S4B 1, 2, 3, 4, 5

1386

556-104 - UNIVERSAL ADAPTER

556-100 556-113

RETURN / EXHAUST

XXX CFM

AIR FLOW

DIRECTION

4-WAY

3-WAY

**PERFORATED** 

2-WAY

**FRAME** 

LAY-IN

LAY-IN

LAY-IN

LAY-IN

DRYWAL

DRYWALL

LAY-IN

DRYWALL

DRYWALL

PLAN | MANUFACTURER\

MARK | MODEL NUMBER

EGER PRODUCTS FMP #556-100(X)

EGER PRODUCTS FMP #556-100(X)

FMP #556-113(Y)

EGER PRODUCTS FMP #556-109(B)

S100 (NOTE 1

EGER PRODUCTS FMP #556-113(Y)

EGER PRODUCTS FMP #556-109(B)

MILL HARDWARE

NECK DIA.(X) (Y) (B)

12"Ø 3

16"Ø

14"Ø 4

3T46(B)

SYSTEM: G4 (ARIA)




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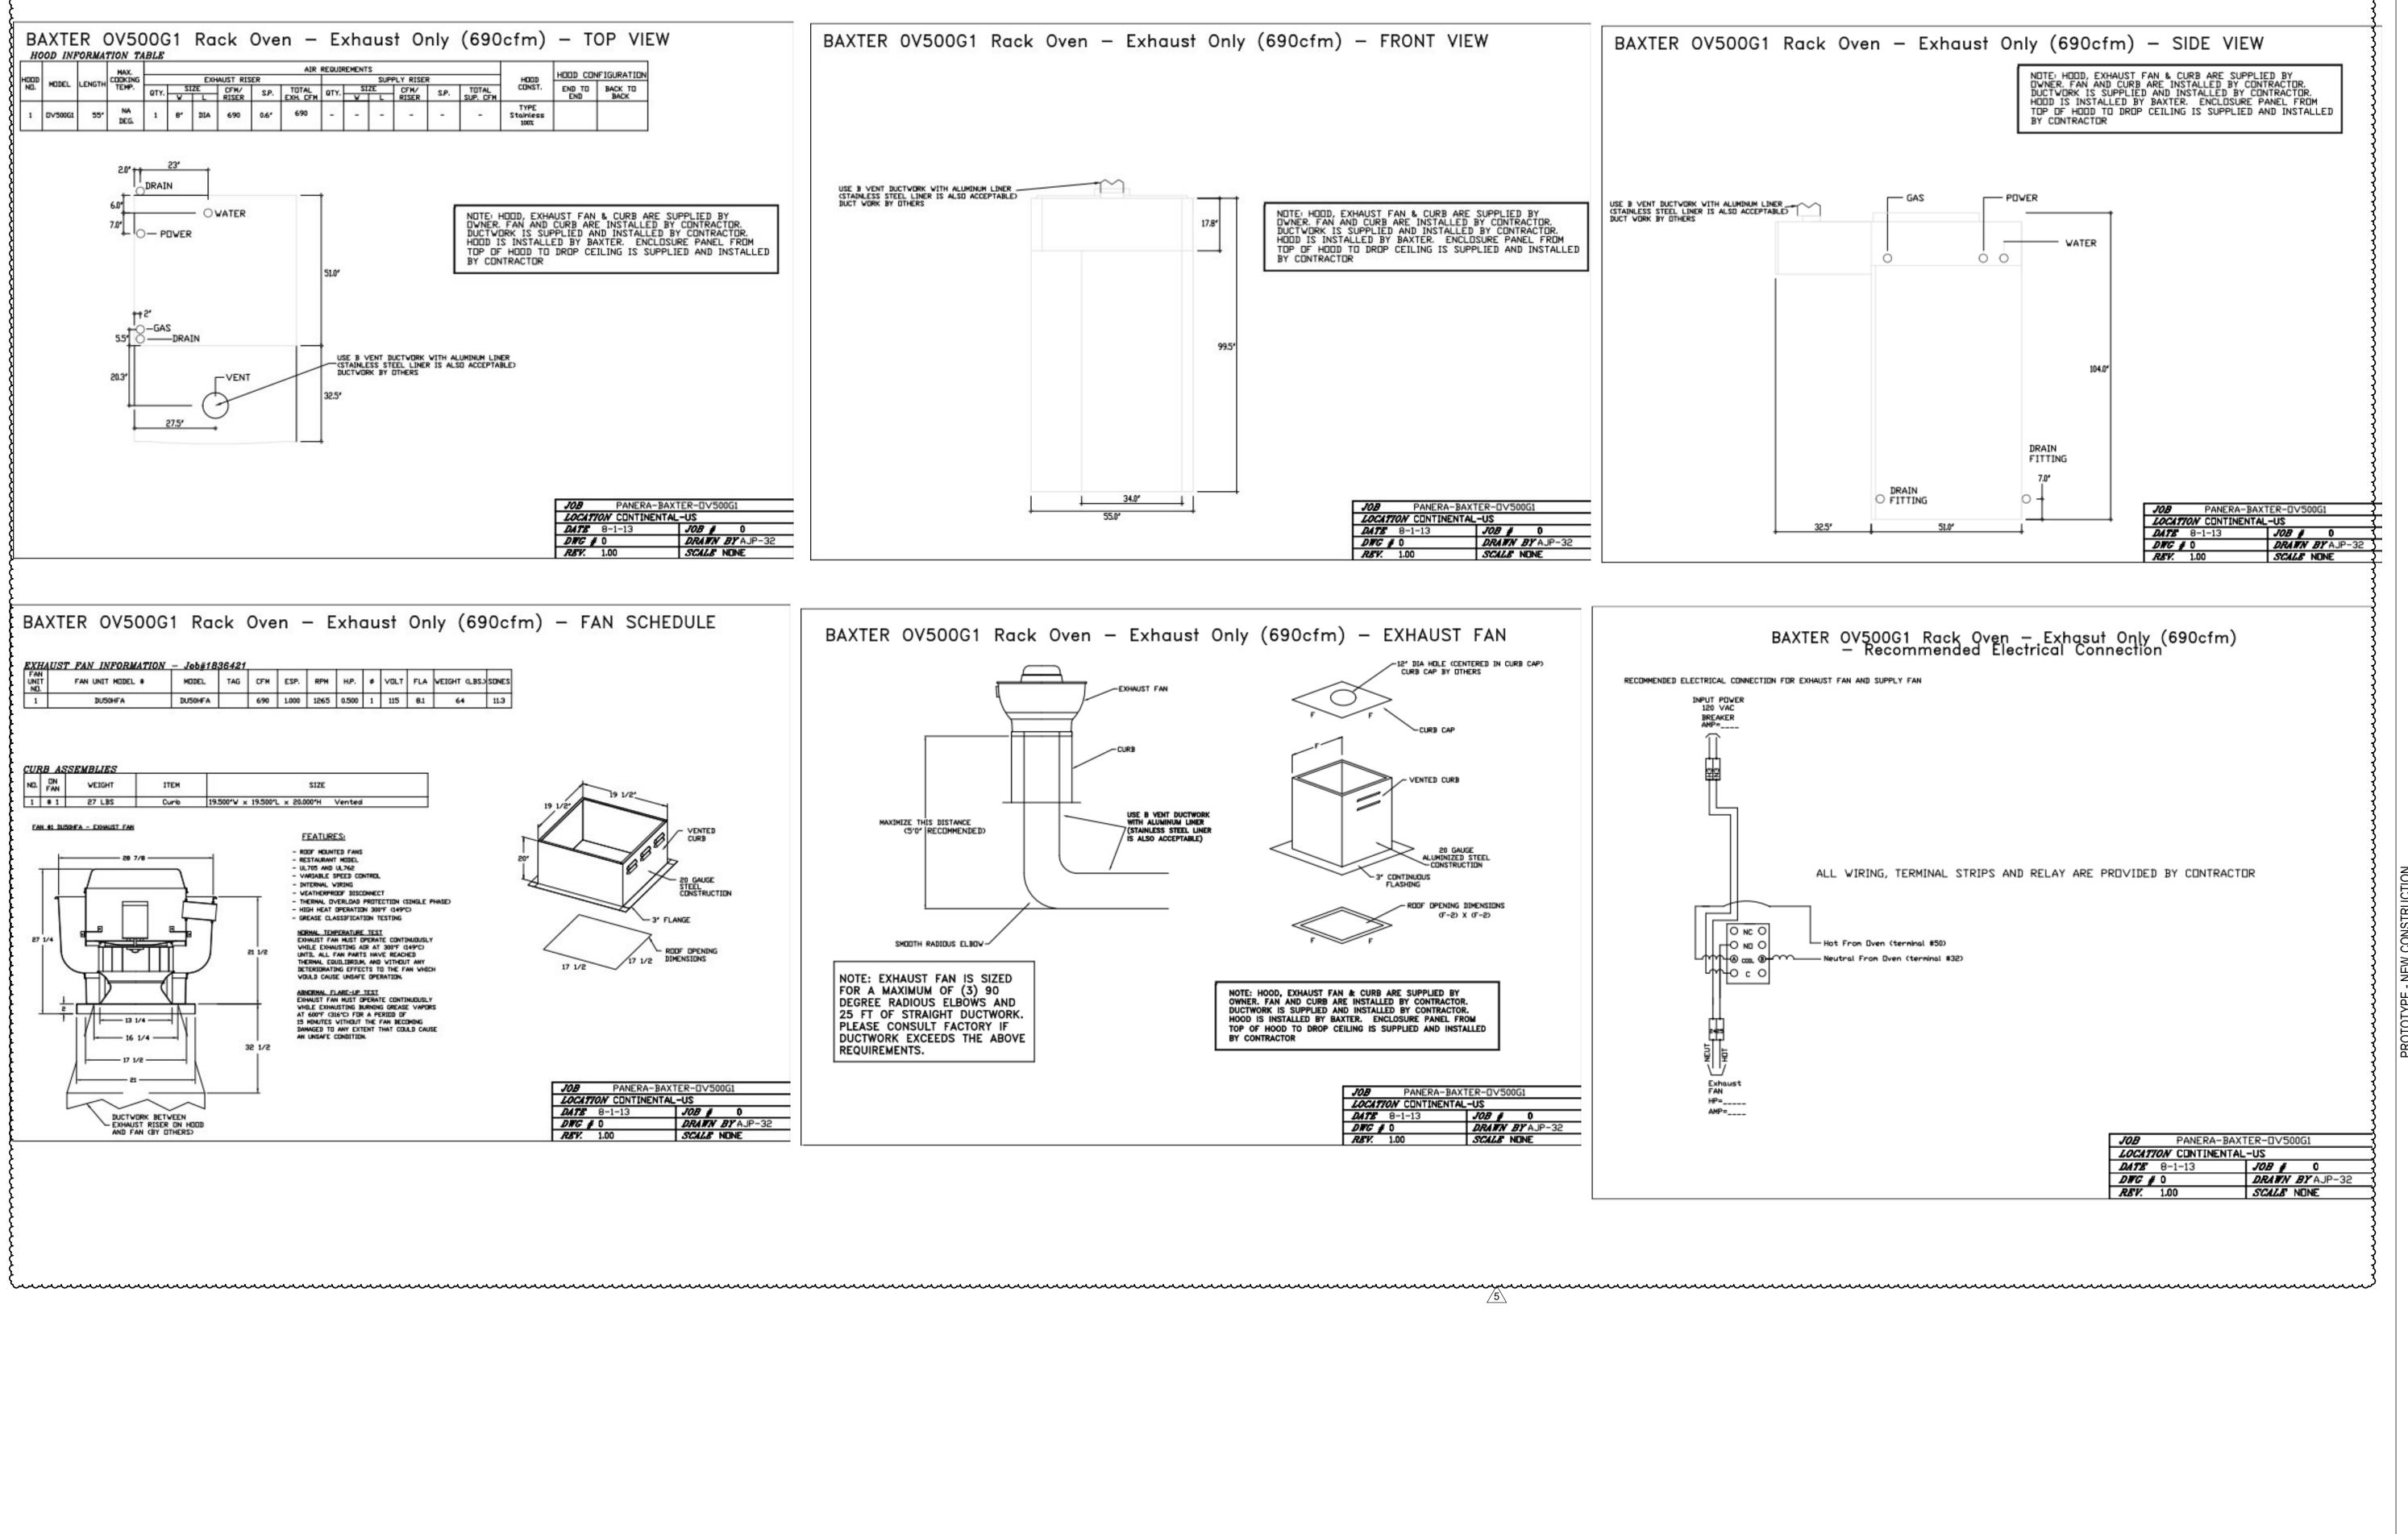
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).	Description	Date
	PERMIT SET - TI	7/18/2022
	OWNER REVISION	12/09/2022
	MEP UPDATES	05/26/2023

**MECHANICAL SCHEDULES** 

Project Number: LKA-MO-01-22 Drawn By: 07/05/2022



Bakery-Cafe:

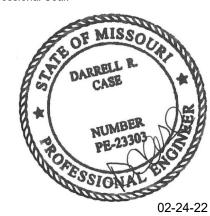2406

SYSTEM: G4 (ARIA)




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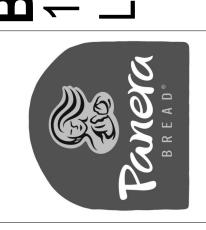
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No.	Description	Date
1	PERMIT SET - TI	7/18/2022
5	MEP UPDATES	05/26/2023

VENTILATION DETAILS & SCHEDULES

Project Number:

LKA-MO-01-22

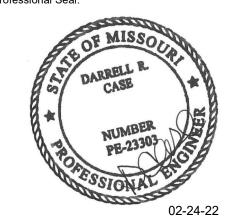Drawn By:


IAF

Issue Date:

07/05/2022

DPM: DM: CPM:

B 2021 O3 V/1

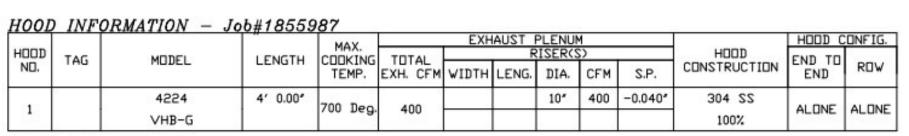

HOOD INFORMATION

		FILTER	(2	.32	26		LIGHT(S)	,s. 8		3 3333		NET(S)		FIRE	нппп
HOOD	TAG							WIRE		FI	RE SYSTEM	ELECTRICAL	SWITCHES	SYSTEM	HANGING
ND.	ING	TYPE	QTY	. HEIGHT	LENGTH	QTY.	TYPE	GUARD	LOCATION	TYPE	SIZE	MODEL #	QUANTITY	PIPING	WGHT
1			_			0								NO	169 LBS

FAN #1 DU30HFA - EXHAUST FAN

25 1/4

OPTION FIELD WRAPPER 16.00" High Front, Left, Right

DUCTWORK BETWEEN

EXHAUST RISER ON HOOD
AND FAN (BY OTHERS)


EVULLIST PAN INFORMATION JANUAREOUS

FAN UNIT ND.	TAG	FAN UNIT MODEL #	CFM	ESP.	RPM	H.P.	ø	VOLT	FLA	WEIGHT (LBS.)	SONE
1		DU30HFA	400	0.500	1124	0.250	1	115	4.0	59	6.8


CURB ASSEMBLIES SIZE 19.500'W x 19.500'L x 22.000'H Vented 1 # 1 30 LBS


NOTE: HOOD, EXHAUST FAN & CURB ARE SUPPLIED BY OWNER AND INSTALLED BY CONTRACTOR.

DUCT WORK IS SUPPLIED AND INSTALLED BY CONTRACTOR

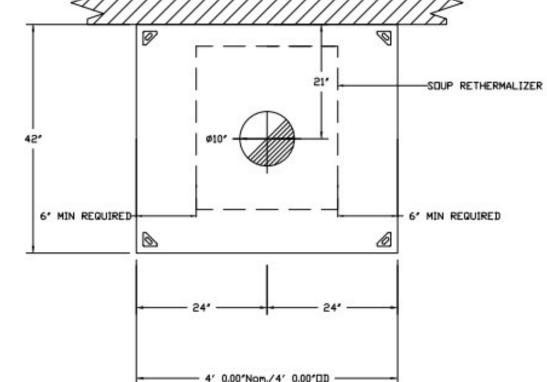

PLAN VIEW - Hood #1 4' 0.00" LONG 4224VHB-G

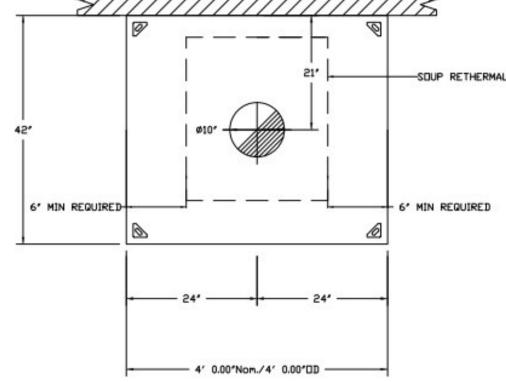

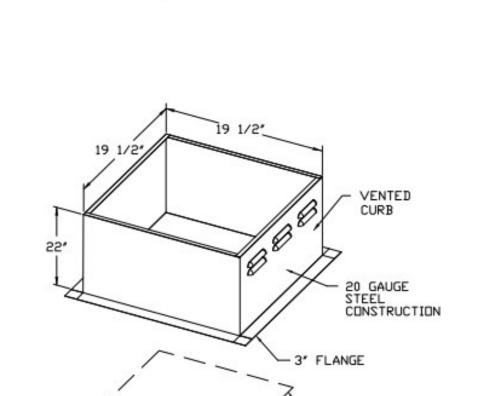

ROOF OPENING
DIMENSIONS

- HIGH HEAT OPERATION 300°F (149°C) - GREASE CLASSIFICATION TESTING NORMAL TEMPERATURE TEST EXHAUST FAN MUST OPERATE CONTINUOUSLY WHILE EXHAUSTING AIR AT 300°F (149°C) UNTIL ALL FAN PARTS HAVE REACHED

FEATURES:

- ROOF MOUNTED FANS - RESTAURANT MODEL - UL705 AND UL762 - VARIABLE SPEED CONTROL - INTERNAL VIRING


- WEATHERPROOF DISCONNECT

THERMAL EQUILIBRIUM, AND WITHOUT ANY DETERIORATING EFFECTS TO THE FAN WHICH VOULD CAUSE UNSAFE OPERATION. ABNORMAL FLARE-UP TEST EXHAUST FAN MUST OPERATE CONTINUOUSLY WHILE EXHAUSTING BURNING GREASE VAPORS AT 600°F (316°C) FOR A PERIOD OF


15 MINUTES WITHOUT THE FAN BECOMING DAMAGED TO ANY EXTENT THAT COULD CAUSE

AN UNSAFE CONDITION.

- THERMAL OVERLOAD PROTECTION (SINGLE PHASE)

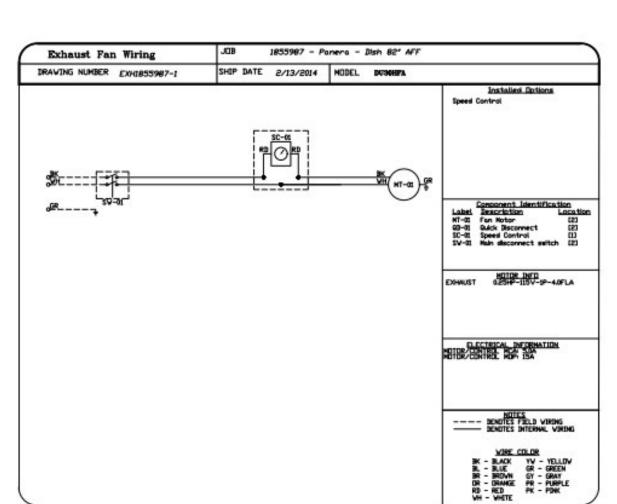

FOR QUESTIONS, CALL CAPTIVE-AIRE 2221 KANSAS AVENUE SILVER SPRING, MD 20910 PHDNE: (800) 988-0881 FAX: (919) 227-5931

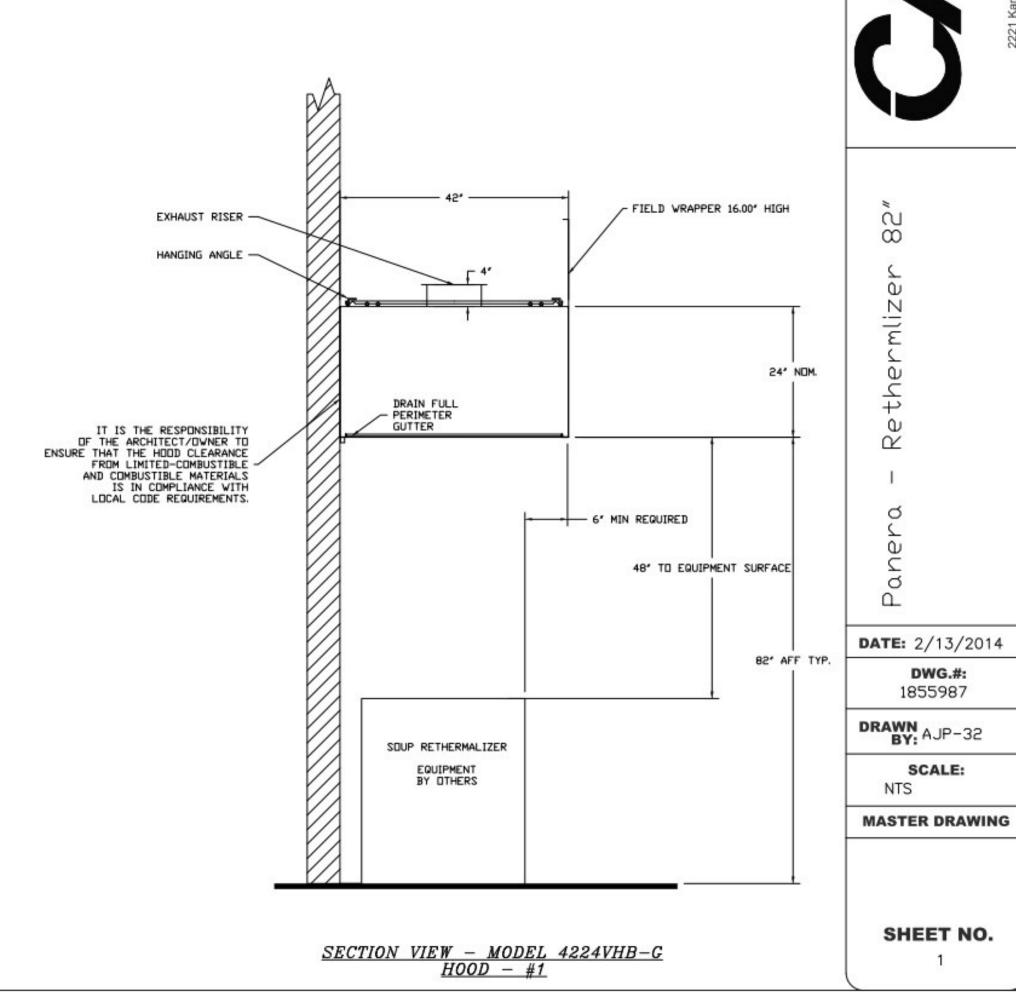

REVISIONS DESCRIPTION DATE:

> **3ake**, 410 N **m** 7

Bakery-Cafe:

Project Team:

SYSTEM: G4 (ARIA)

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**VENTILATION DETAILS &** 


**SCHEDULES** Project Number: LKA-MO-01-22 Drawn By: Issue Date: 07/05/2022 DPM:

ETL LISTING DESCRIPTION BLOCK


THE CAPTIVE-AIRE MODEL VHB HAS BEEN TESTED, LISTED AND APPROVED TO EXHAUST A MINIMUM OF 100 CFM PER LINEAR FOOT OVER 700 DEGREE EQUIPMENT FOR NON-GREASE APPLICATIONS





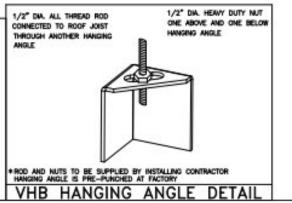

1/2" DA. ALL THREAD ROD CONNECTED TO ROOF JOIST THROUGH ANOTHER HANGING

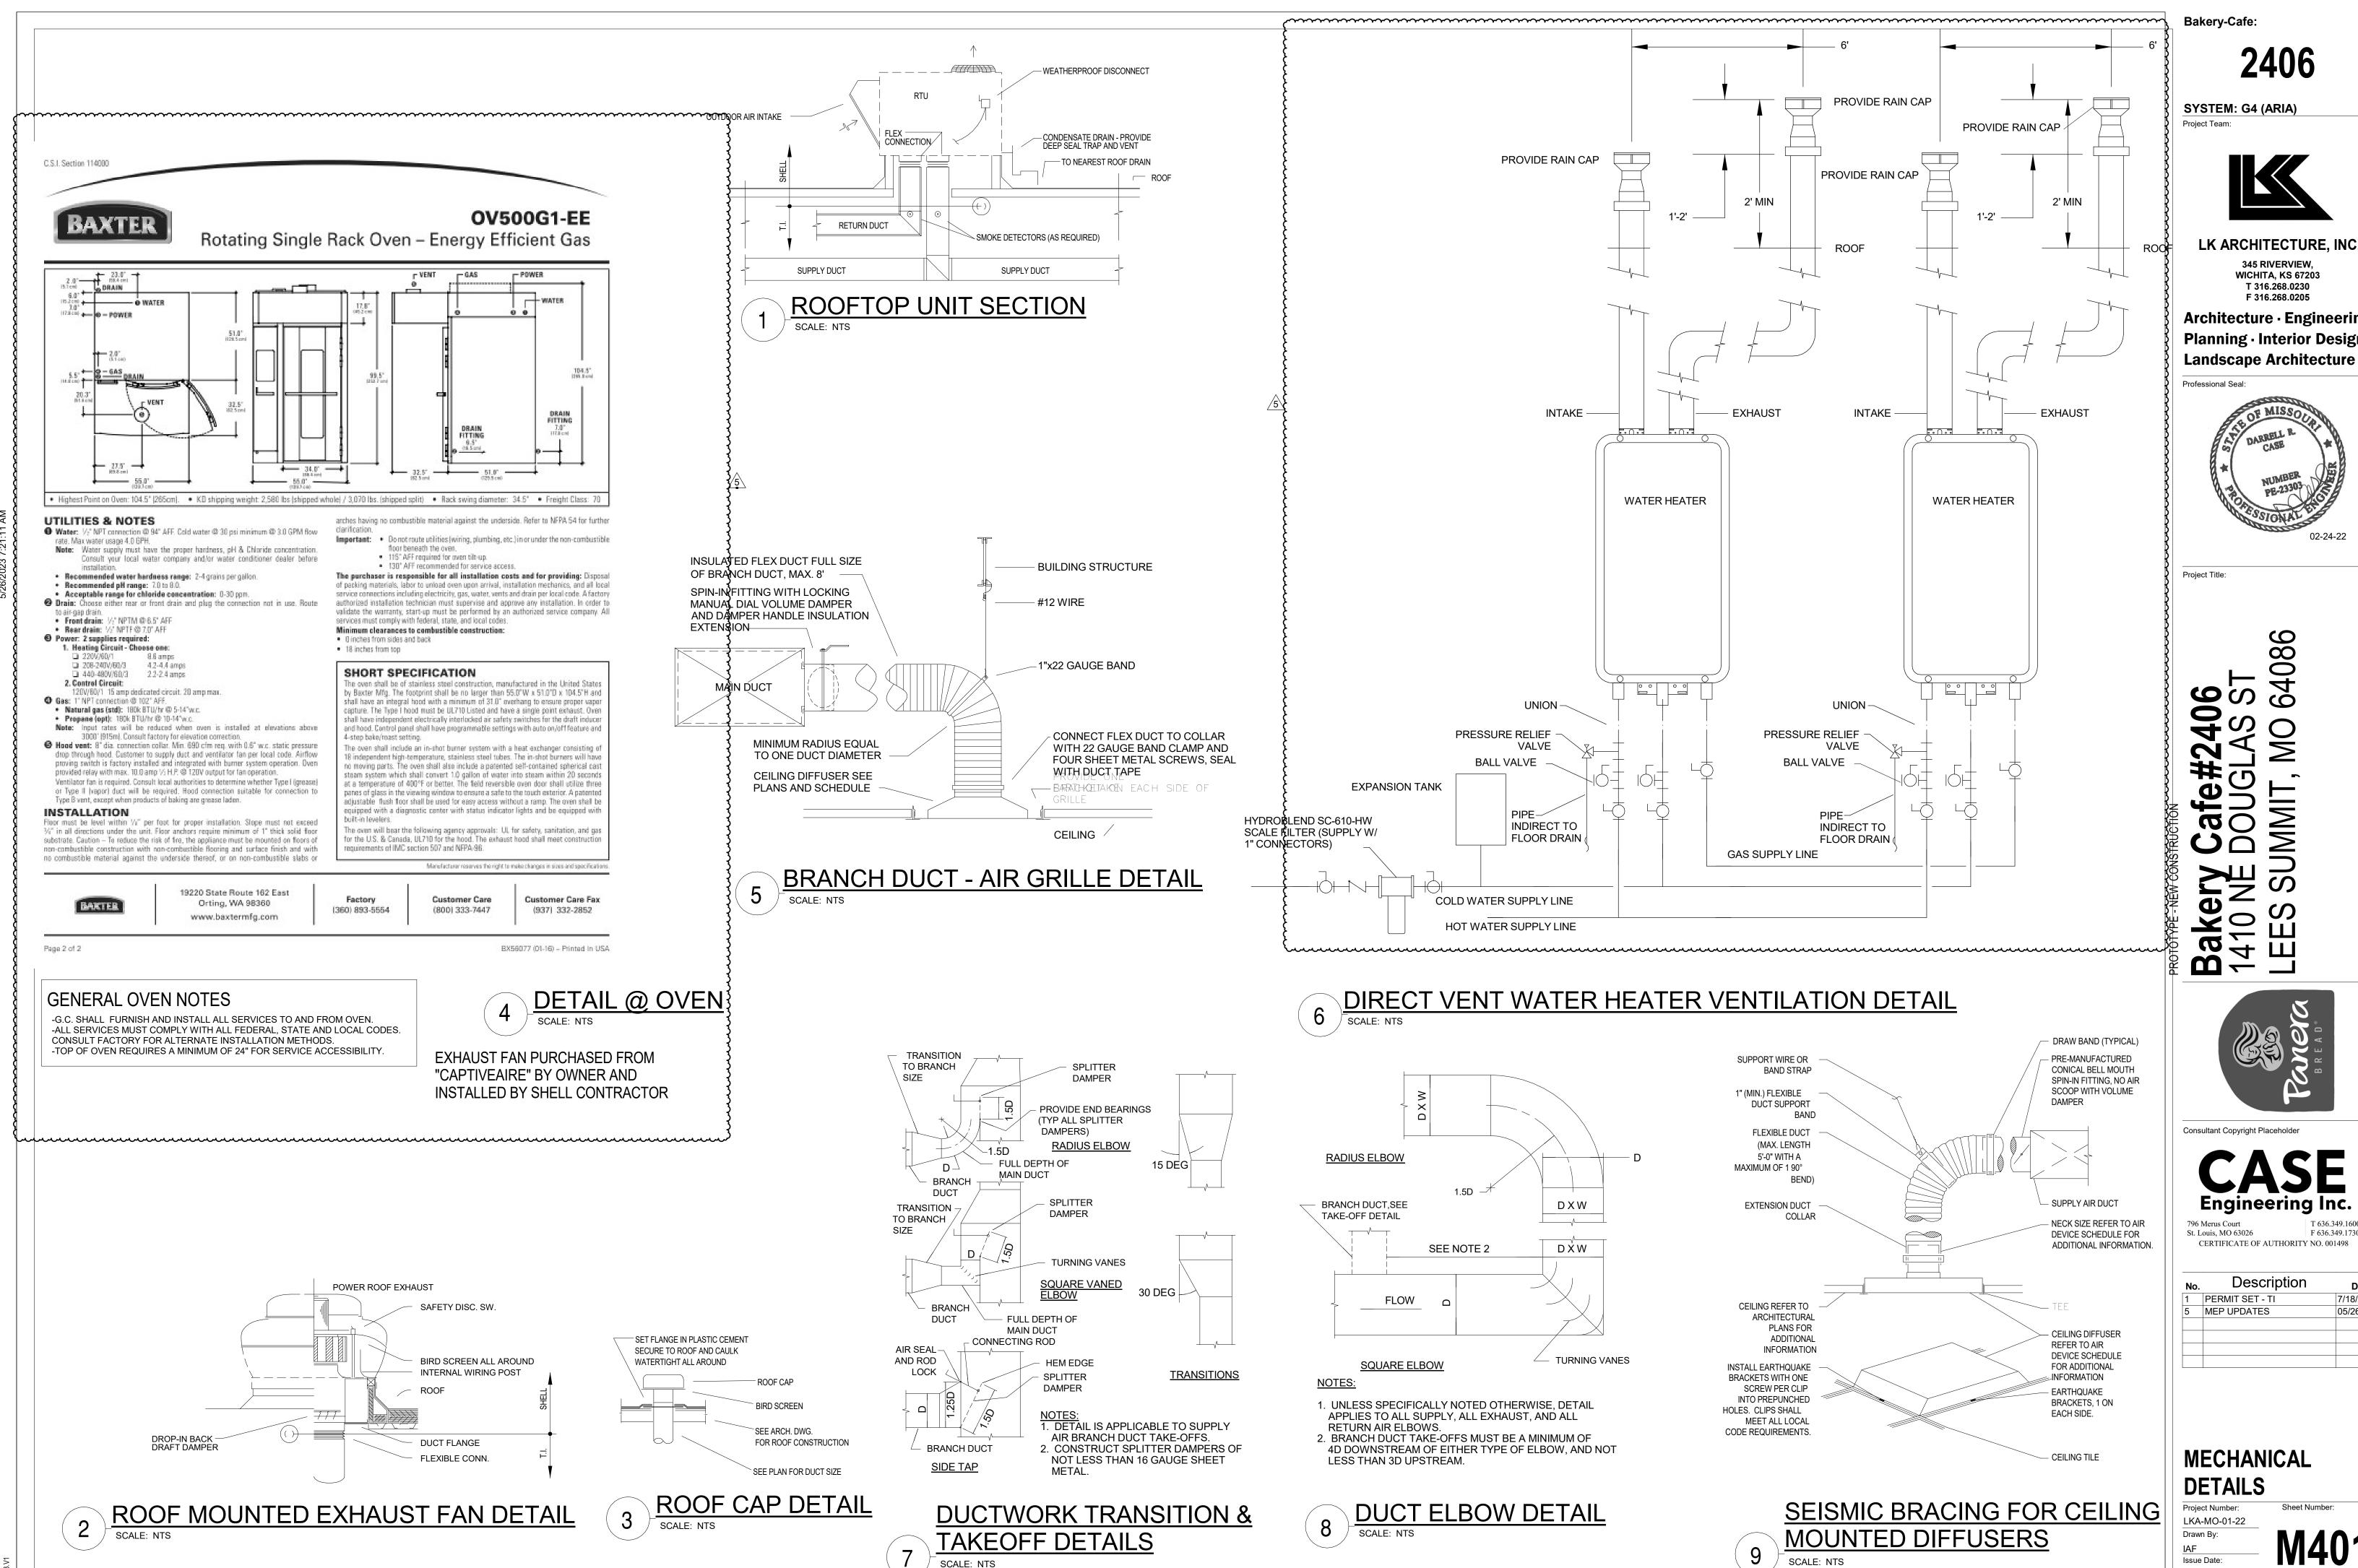

Bakery-Cafe:


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Description 1 PERMIT SET - TI 7/18/2022 MEP UPDATES 05/26/2023

**MECHANICAL DETAILS** 

LKA-MO-01-22 Issue Date: 07/05/2022 DPM: DPM

#### **KEYED NOTES**

- PROVIDE ROUGH-IN AND FINAL CONNECTION TO ROOFTOP UNIT. ROOFTOP UNIT-MOUNTED DISCONNECTING MEANS SUPPLIED BY EQUIPMENT MANUFACTURER. ELECTRICAL CONTRACTOR TO PROVIDE AND MAKE FINAL CONNECTION TO UNIT-MOUNTED WEATHERPROOF GFI SERVICE RECEPTACLE. COORDINATE WITH MECHANICAL CONTRACTOR AND EQUIPMENT MANUFACTURER. COORDINATE ALL WORK WITH MECHANICAL CONTRACTOR IN FIELD.
- 2 PROVIDE ROUGH-IN AND FINAL CONNECTION TO RACK OVEN HOOD EXHAUST FAN, DRAFT INDUCER MOTOR, AND PRESSURE SWITCH. DISCONNECTING MEANS SUPPLIED BY EQUIPMENT MANUFACTURER. FAN SHALL BE INTERLOCKED WITH OVEN TO RUN WHEN OVEN IS ON. SEE WIRING DETAILS ON MECHANICAL SHEETS. COORDINATE WITH MECHANICAL CONTRACTOR AND EQUIPMENT MANUFACTURER.
- $\langle$  3 $\rangle$  PROVIDE ROUGH-IN AND FINAL CONNECTION TO RESTROOM EXHAUST FAN. DISCONNECTING MEANS SUPPLIED BY EQUIPMENT MANUFACTURER. VERIFY AND COORDINATE REQUIREMENTS WITH MECHANICAL CONTRACTOR AND MECHANICAL
- 4 PROVIDE ROUGH-IN AND FINAL CONNECTION TO COOLER/FREEZER COMPRESSOR. EXTEND POWER FROM COMPRESSOR TO EVAPORATOR. COORDINATE WITH G.C. AND COOLER/FREEZER MANUFACTURER.
- $\langle 5 \rangle$  PROVIDE ROUGH-IN AND FINAL CONNECTION TO HOOD FAN. DISCONNECTING MEANS SUPPLIED BY EQUIPMENT MANUFACTURER. FAN TO BE CONTROLLED VIA "ECOLAB" SYSTEM. COORDINATE LOCATION OF SYSTEM WITH G.C. IN FIELD. COORDINATE HOOD CONNECTION WITH MECHANICAL CONTRACTOR.
- MAKER AND REMOTE CONDENSER. COORDINATE WITH G.C. AND EQUIPMENT
- (7) CONTRACTOR PROVIDED ROOF TOP UNIT AS SHOWN IN SCHEDULE ON SHEET M201. UNIT SHALL BE LOCATED SUCH THAT SUPPLY AND RETURN DUCTWORK DROP BETWEEN JOISTS. SEE SHEET M101 FOR CONTINUATION. RUN CONDENSATE LINE TO NEAREST DRAIN. REFER TO PLUMBING DRAWINGS.
- $\langle$  8 $\rangle$  CONTRACTOR TO PROVIDE AND INSTALL U.L. LISTED IONIZATION TYPE SMOKE DETECTOR INTERLOCKED W/ RTU CONTROLS TO SHUT RTU DOWN UPON ACTIVATION OF DETECTOR. LOCATE IN RETURN AIR DUCTWORK. DETECTORS SHALL BE ACCESSORIZED WITH VISIBLE AND AUDIBLE SIGNALS IN AN APPROVED
- ig< 9 ig> RACK OVEN EXHAUST FAN-1 F.O.I.C. INSTALLED BY SHELL CONTRACTOR. (SEE SCHEDULE AND DETAIL ON SHEET M01, M301, M302, M401) RUN EXHAUST DUCT DOWN TO RACK OVEN EXHAUST HOOD SEE SHEET M101 FOR CONTINUATION. LOCATE FAN OUTLET 10' MIN. FROM ANY AIR INTAKE. (DUCT SHALL BE "B-VENT" WITH ALUMINUM OR STAINLESS STEEL LINER).
- > DISHWASHER EXHAUST FAN-2 F.O.I.C. INSTALLED BY SHELL CONTRACTOR. (SEE SCHEDULE AND DETAIL ON SHEET M01, M301, M302, M401). RUN EXHAUST DUCT DOWN TO DISHWASHER EXHAUST HOOD. SEE SHEET M101 FOR CONTINUATION. LOCATE FAN OUTLET 10' MIN. FROM ANY AIR INTAKE. (DUCT SHALL BE ALUMINUM OR STAINLESS STEEL).
- <11> PVC LINES (FLUE OUTLET AND COMBUSTION INLET) FROM WH BELOW (SEE SHEET) M101 FOR CONTINUATION) UP THRU ROOF BY SHELL CONTRACTOR. TERMINATE PER ,MANUFACTURER'S RECOMMENDATION W/ 4 FEET MIN. CLEARANCE BETWEEN FLUE OUTLET AND ANY AIR INTAKE. SEE DETAIL ON SHEET M401.
- (12) RESTROOM EXHAUST FAN-3 BY CONTRACTOR (SEE SCHEDULE ON SHEET M201 AND DETAIL ON SHEET M301). LOCATE 10 FEET MIN. FROM ANY AIR INTAKE. VERIFY
- $\langle$ 13 $\rangle$  REMOTE CONDENSERS ON ROOF FOR FREEZER, COOLERS AND ICE MACHINES. TAKE OFF FOR PIPING RUNS TO BE COORDINATED WITH GENERAL CONTRACTOR. G.C. TO RUN WIRING FOR COOLERS AND FREEZER AND FOR REMOTE COMPRESSORS. MECHANICAL/ELECTRICAL SUBCONTRACTOR TO PERFORM FINAL CONNECTION FOR THESE UNITS. COORDINATE LOCATION W/ OWNER. FOR BIDDING PURPOSES REFRIGERANT PIPING COMES IN PRE CHARGED LENGTHS OF 25 ft AND 50 ft. (COOLER AND FREEZER ONLY). ALL REFRIGERATION LINES SHALL BE ROUTED
- <14> PROVIDE DISCONNECT SWITCH, ROUGH-IN, AND ALL CONDUIT, WIRING, AND CONNECTIONS TO COMPLETE INSTALLATION OF PROOFER CONDENSER PER MANUFACTURER SPECIFICATIONS AND N.E.C. REGULATIONS. CONDENSER SHALL BE INTERLOCKED WITH PROOFER, SEE CONDENSER MANUFACTURERS CUT-SHEETS AND WIRING DIAGRAMS. COORDINATE ALL WORK AND REQUIREMENTS WITH G.C., MECHANICAL CONTRACTOR, AND EQUIPMENT MANUFACTURER.
- REMOTE CONDENSER ON ROOF FOR PROOFER/RETARDER. CONDENSING UNIT AND LINE SET TO BE PROVIDED BY GENERAL CONTRACTOR. TAKE OFF FOR PIPING RUNS TO BE COORDINATED WITH GENERAL CONTRACTOR.

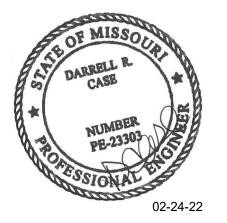**Bakery-Cafe:** 

SYSTEM: G4 (ARIA) Project Team:




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Project Title:

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Description	Date
PERMIT SET - TI	7/18/2022
CONSTRUCTION SET	11/09/2022
OWNER REVISION	02/03/2023
MEP UPDATES	05/26/2023
	CONSTRUCTION SET OWNER REVISION

#### **MEP ROOF PLAN**

LKA-MO-01-22

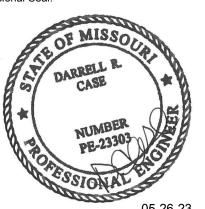07/05/2022

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TI UPDATES	9/22/2022


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3	CONSTRUCTION SET	11/09/202
4	OWNER REVISION	02/03/202
5	MEP UPDATES	05/26/202

SANITARY **PLUMBING ROUGH-IN PLAN** 

LKA-MO-01-22

1 PLUMBING PLAN - WASTE ROUGH-IN 1/4" = 1'-0"

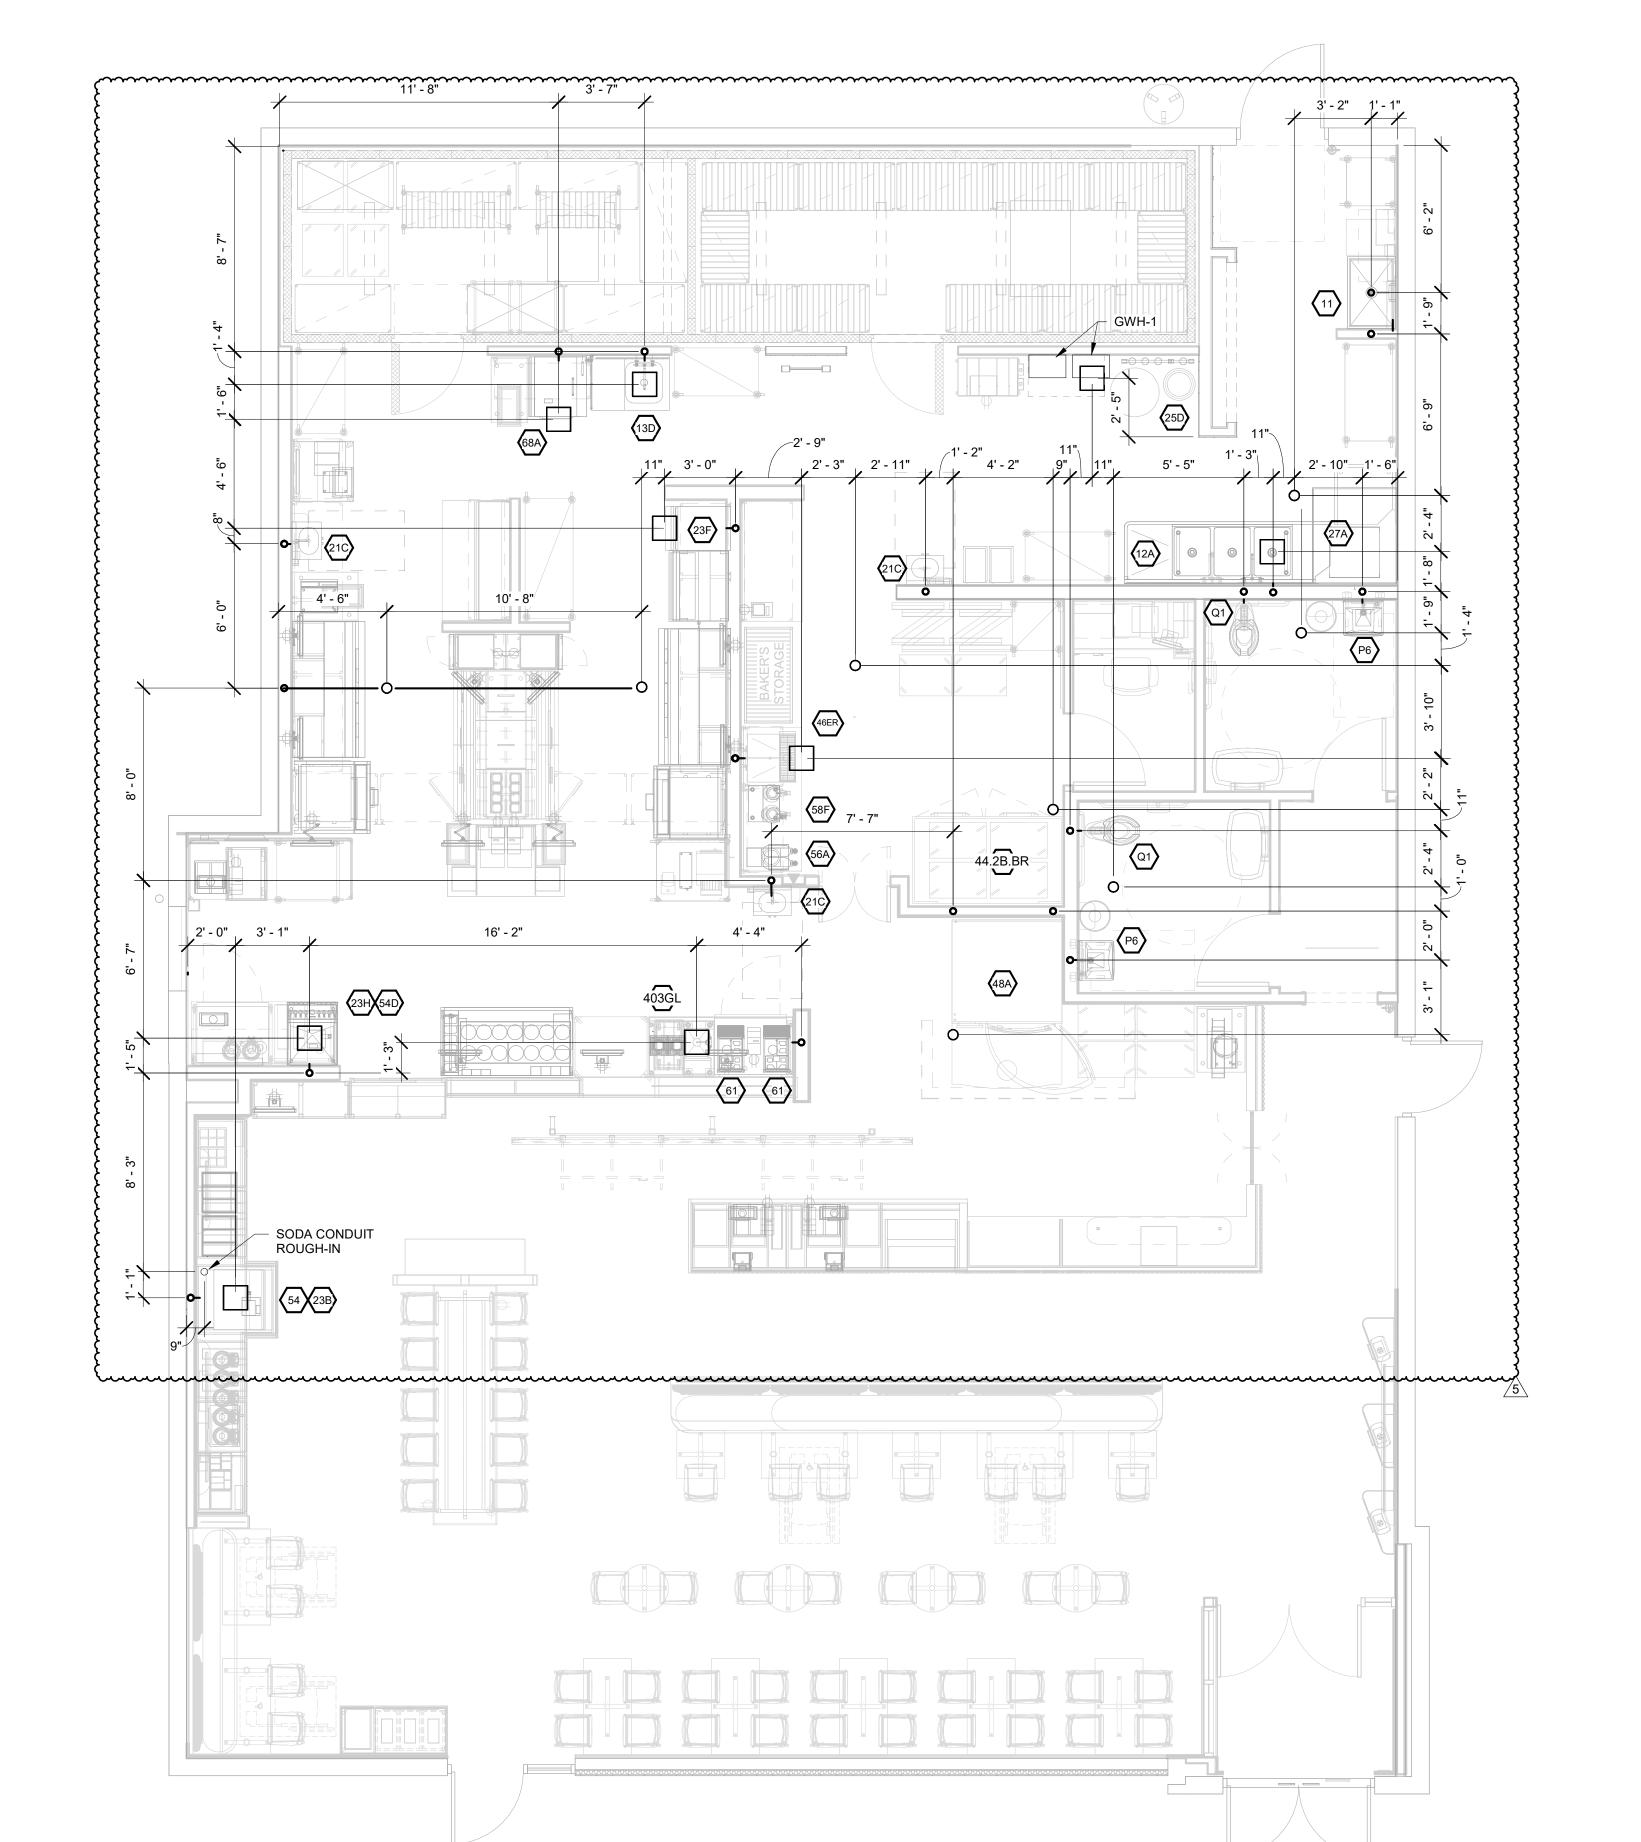

SCHEDULE: ROUGH-IN SYMBOLS

- # NUMERICAL SYMBOL CORRESPONDS TO EQUIPMENT IDENTIFICATION NUMBER. SEE SHEET P303 FOR REFERENCE.
- WATER CLOSET (ADA):  $\langle Q1 \rangle$  1" CW SUPPLY AT 28 3/4" A.F.F. AND OFFSET
- 4 3/4" FROM <sup>©</sup> OF FIXTURE
- $\langle$  P6 $\rangle$  1/2" CW & HW SUPPLY AT 22 3/4" A.F.F. AND EACH ONE OFFSET 4" FROM LOF FIXTURE
- URINAL (ADA): 1" SUPPLY AT 40 7/8" A.F.F. AND OFFSET 4 3/4" FROM GOF FIXTURE
- SUPPLY ROUGH-IN SEE DOMESTIC WATER ROUGH-IN SCHEDULE FOR SIZE & HEIGHT
- EQUIPMENT CONNECTION SEE DOMESTIC WATER ROUGH-IN SCHEDULE FOR SIZE SEE EQUIPMENT MANUAL FOR FITTING REQUIREMENTS

NOTE: REFER TO ARCHITECTURAL FLOOR PLAN FOR ALL INTERIOR PARTITION LOCATIONS \* ROUGH-INS ARE BASED ON FIXTURES SHOWN IN SCHEDULE ON SHEET P-303. CONTRACTOR TO VERIFY REQUIREMENTS FOR ANY SUBSTITUTION PRIOR TO INSTALLATION.

SCHEDULE: ROUGH-IN SYMBOLS

NUMERICAL SYMBOL CORRESPONDS TO EQUIPMENT IDENTIFICATION NUMBER. SEE SHEET P303 FOR REFERENCE.

WATER CLOSET (ADA):
1" CW SUPPLY AT 28 3/4" A.F.F. AND OFFSET

4 3/4" FROM <sup>©</sup> OF FIXTURE

LAVATORY:
1/2" CW & HW SUPPLY AT 22 3/4" A.F.F. AND EACH ONE OFFSET 4" FROM © OF FIXTURE

URINAL (ADA):

1" SUPPLY AT 40 7/8" A.F.F. AND OFFSET 4 3/4" FROM OF FIXTURE

SUPPLY ROUGH-IN - SEE DOMESTIC WATER ROUGH-IN SCHEDULE FOR SIZE & HEIGHT

EQUIPMENT CONNECTION - SEE DOMESTIC WATER ROUGH-IN SCHEDULE FOR SIZE - SEE EQUIPMENT MANUAL FOR FITTING REQUIREMENTS

\* ROUGH-INS ARE BASED ON FIXTURES SHOWN IN SCHEDULE ON SHEET P-303. CONTRACTOR TO VERIFY REQUIREMENTS FOR ANY SUBSTITUTION PRIOR TO INSTALLATION.

NOTE: REFER TO ARCHITECTURAL FLOOR PLAN FOR ALL INTERIOR PARTITION LOCATIONS

Bakery-Cafe:

SYSTEM: G4 (ARIA)




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4	OWNER REVISION	02/03/2023
5	MEP UPDATES	05/26/2023

## **DOMESTIC WATER ROUGH-IN PLAN & NOTES**

Project Number: Sheet Number: LKA-MO-01-22

07/05/2022

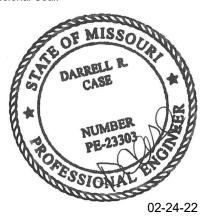1 PLUMBING PLAN - SUPPLY ROUGH-IN 1/4" = 1'-0"

#### PLUMBING KEYED NOTES

- 1 POINT OF CONNECTION TO SITE 4" GREASE WASTE STUB TO SPACE ROUTED TO GB-250 GREASE INTERCEPTOR PROVIDED IN SHELL PACKAGE. FIELD VERIFY EXACT LOCATION, SIZE AND INVERT ELEVATION PRIOR TO WORK.
- (2) EXTEND INDIRECT WASTE TO RECEPTACLE. FIELD VERIFY EXACT ROUTING OF PIPING.
- (3) EXTEND DRAIN LINES FROM FREEZER, COOLER, OVEN AND PROOFER TO FLOOR/HUB DRAIN LOCATED NEARBY. FIELD VERIFY EXACT ROUTING OF PIPING.
- 4 PROVIDE 6" CONDUIT RUN OVERHEAD FROM SODA DISPENSER TO BAG-N-BOX FOR SODA LINES. CONDUIT TO BE OF MATERIALS APPROVED BY LOCAL CODE. NO PVC ALLOWED IN PLENUM
- $\left<5\right>$  SECURE DRAIN LINES FOR ICE MACHINE AND SODA DISPENSER TO THE SIDE OF THE CABINET WITH BRACKETS.
- $\langle 6 \rangle$  CAST IRON PIPE SHALL BE USED FOR THE FIRST 8' OF DISCHARGE PIPING FOR SOUP RETHERMALIZER AND
- √ 7 > 1 1/2" CONDENSATE DRAIN DOWN WALL AND TERMINATE THRU WALL INTO HUB DRAIN WITH A CODE APPROVED AIR GAP.
- $\langle$  8  $\rangle$  POINT OF CONNECTION TO EXISTING 4" SANITARY STUB PROVIDED IN SHELL PACKAGE. FIELD VERIFY EXACT LOCATION, SIZE AND INVERT ELEVATION PRIOR TO WORK.
- $\langle$  9  $\rangle$  1/2"CW FROM TRAP PRIMER. PRECISION PLUMBING PRODUCTS MODEL PP500 OR APPROVED EQUAL.
- 10 POINT OF CONNECTION TO EXSITING 4" VENT THROUGH ROOF. FIELD VERIFY EXACT LOCATION AND SIZE PRIOR TO WORK.
- $\langle 11 \rangle$  Coordinate routing of Sanitary Piping in Field with STRUCTURAL FOOTINGS APPROXIMATLY IN THIS AREA. SEE STRUCTURAL DRAWINGS FOR LOCATIONS.
- (12) PROVIDE 6" CONDUIT RUN UNDERSLAB FROM SELF SERVICE BEVERAGE BAR TO BAG-N-BOX FOR SODA LINES. CONDUIT TO BE OF MATERIALS APPROVED BY LOCAL CODE.
- (13) 1" CONDENSATE DRAIN UP TO ROOF TOP UNITS. FIELD VERIFY EXACT LOCATION.
- $\langle$  14 $\rangle$  1-1/2" CONDENSATE DRAIN DOWN WALL AND TERMINATE THRU WALL INTO MOP SINK BASIN WITH CODE APPROVED AIR GAP.

- -HOLD CONDENSATE WASTE PIPES 1" AWAY FROM THE WALLS AND GRAVITY DRAIN TO HUB DRAINS WITH THE DRAIN LINE HELD
  - -ALL CONDENSATE LINES TO BE COPPER WITH CODE APPROVED
- -ENSURE CONDENSATE LINES AT COOLER/FREEZER ARE PROPERLY SEALED AT PENETRATIONS.

#### **GENERAL NOTES**

ALL PLUMBING WORK SHALL BE PERFORMED IN FULL COMPLIANCE WITH THE LOCALPLUMBING CODE, HEALTH REGULATIONS, AND LOCAL ORDINANCES.

THE PLUMBING CONTRACTOR IS RESPONSIBLE FOR ALL PERMIT FEES, UTILITY TAP FEES, AND INSPECTION FEES AS REQUIRED.

THE CONTRACTOR SHALL COORDINATE THE LOCATION OF HIS FLOOR DRAINS, HUB DRAINS AND CONNECTION POINTS WITH THE GENERAL CONTRACTOR. THE PLUMBING CONTRACTOR SHALL FIELD VERIFY EXISTING CONDITIONS PRIOR TO SUBMITTING HIS

ALL PLUMBING PIPING SHALL BE ROUTED UNDER THE FLOOR, ABOVE THE CEILING, OR LOCATED WITHIN WALLS OR PLUMBING CHASES. EXPOSE PIPING ONLY WHERE NECESSARY TO CONNECT TO EQUIPMENT.

PROVIDE INSULATION ON ALL EQUIPMENT CONDENSATE DRAIN LINES INCLUDING FREEZER AND COOLER. PROVIDE HEAT TAPE ON CONDEN- SATE DRAIN LINE AT FREEZER AND FOR ALL PIPING THAT MAY RUN THROUGH FREEZER.

PROVIDE CHROME FINISHED P-TRAPS FOR ALL SINKS WHERE TRAPS WILL BE VISIBLE TO THE PUBLIC.

PROVIDE COPPER CONDENSATE DRAIN LINE FOR RACK OVEN. DRAIN LINE IS NOT TO BE SUPPORTED FROM OVEN.

REFER TO THE GENERAL CONDITIONS ON SHEET G-SL FOR FIRE STOPPING REQUIREMENTS.

#### GREASE INTERCEPTOR CALCULATIONS

Reference No. 38894

Reviewed by: Andy Project Name: Panera Bread

Step 1: Flow rate to grease interceptor Fixture flow rate: (cu in / 231) = gal x 0.75 / 2 min = 2 min flow rate

NAME	TYPE	DIMENSIONS	QTY	CUIN	FLOW RATE
11	Mop Basin	24" x 24" x 10"	1	5,760	9.35 GPM
12B	3 Compartment Sink	21" x 21" x 14" (3)	1	18,522	30 GPM
13B	Prep Sink Two Bowls	21" x 21" x 14" (2)	1	12,348	20 GPM
21C	Hand Sink	10' x 14" x 5'	2	1,400	2.26 GPM
27A	Door Type (Dishwasher)	N/A	1	2,310	5 GPM
68A (Rethermalizer)	Soup Kettle	10 gal.	1	2,310	5 GPM
FD	Floor Drain	N/A	5	N/A	N/A

71.61 GPM

Step 2: Grease Production

Servings per day x Grease production value x Days between pump-outs = Grease output

Number of meals served per day: 400 Grease production value: 0.0455 lbs per serving (Family Restaurant: High / Flatware) Days between pump-outs: 90 days

400 x 0.0455 x 90 = 1638 lbs of FOG

GB-250

**Description:** Polyethylene Grease Interceptor Dimensions: Length: 87", Width: 33", Height: 44" Flow Rates/Grease Capacities: 100 GPM / 1895.0 lbs

Liquid Capacity: 277 gal

**Bakery-Cafe:** 

Project Team:

SYSTEM: G4 (ARIA)




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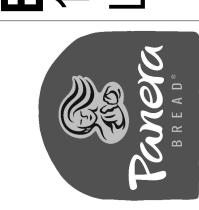
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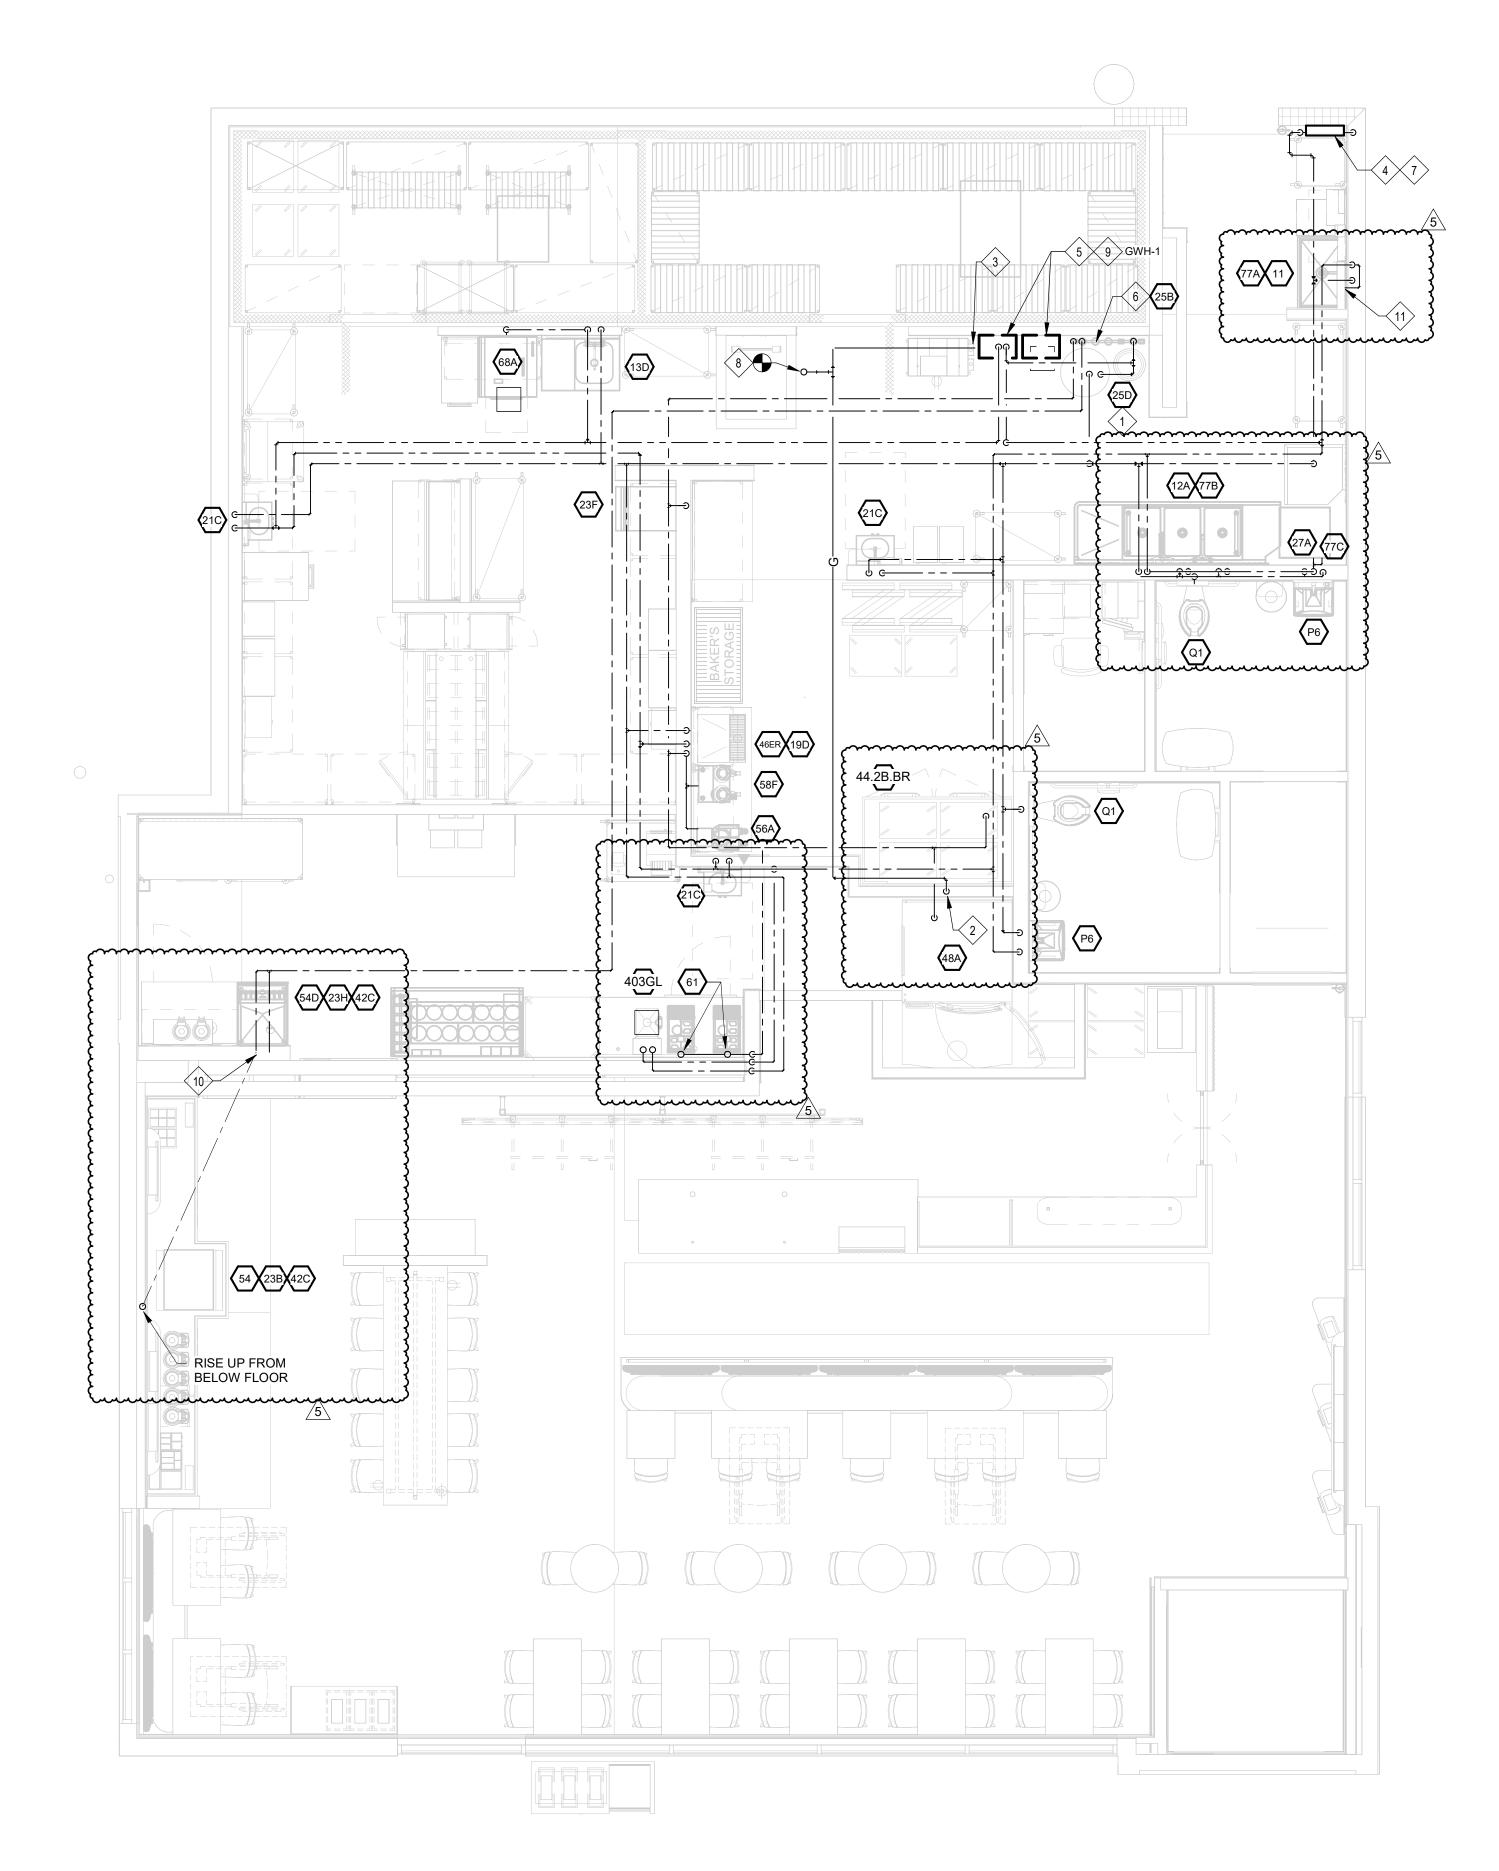
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**SANITARY PLUMBING PLAN** 

Project Number: LKA-MO-01-22



#### PLUMBING KEYED NOTES

- CONTRACTOR SHALL PERFORM A WATER TEST TO DETERMINE WATER HARDNESS. IF RESULT IS BELOW THE MAXIMUM REQUIREMENTS FOR THE KITCHEN EQUIPMENT, CONTRACTOR IS TO FURNISH AND INSTALL WATER SOFTENER AS INDICATED AND SPECIFIED. SEE DETAIL P301. IF RESULT IS ABOVE THE MAXIMUM REQUIREMENTS FOR THE KITCHEN EQUIPMENT, CONTRACTOR IS TO FURNISH AND INSTALL ALTERNATE WATER SOFTENER AND MODIFY PIPING AS INDICATED ON DETAIL 10/P301.
- 2 1-1/2"NG CONNECTION TO OVEN (180 MBH). SEE OVEN DETAIL ON SHEET M402.
- 3 3/4"NG CONNECTION TO WATER HEATER (199 MBH). SEE DETAIL 11 ON SHEET P301.
- NEW 2" DOMESTIC WATER SERVICE. SEE PROJECT CIVIL DRAWINGS FOR CONTINUATION. VERIFY THAT SERVICE IS ADEQUATE TO SUPPPLY 45 PSI AFTER METER AND BACKFLOW PREVENTER. ENTIRE INSTALLATION SHALL BE IN ACCORDANCE WITH LOCAL CODES. CONTRACTOR SHALL FIELD VERIFY REQUIREMENTS PRIOR TO BID. BID TO INCLUDE ALL WORK NECESSARY FOR A FULLY OPERATIONAL SYSTEM.
- 5 PROVIDE AND INSTALL TANKLESS WATER HEATERS AS SHOWN.
- 6 INSTALL COLD WATER FILTRATION SYSTEM SEE DETAIL ON SHEET P301. SEE EQUIPMENT PLAN AND SCHEDULE FOR MORE INFORMATION.
- 7 2" PRESSURE REDUCING BACKFLOW PREVENTER (ZURN/WILKINS MODEL 950XLT2, OR APPROVED EQUAL) INSTALLED IN THE HORIZONTAL POSITION.
- 8 POINT OF CONNECTION TO 2" GAS STUB TO SPACE. VERIFY EXACT SIZE, LOCATION, AND DELIVERY PRESSURE IN FIELD PRIOR TO WORK.
- 9 PROVIDE GRUNDFOS 59896877 ALPHA 15-55F RECIRCULATION PUMP.
- 10 1/2" SUPPLY PIPING DOWN WALL TO BE ROUTED BELOW GRADE TO SERVE SODA DISPENSER. PROVIDE SHUT-OFF VALVE PRIOR TO ROUTING BELOW GRADE.
- PROVIDE SEPERATE HOT WATER CONNECTION FOR CHEMICAL DISPENSER INSTALLATION. SEE SHEET P304 FOR BACKFLOW INFORMATION.
- 12 1" CONDENSATE DRAIN UP TO ROOF TOP UNITS. FIELD VERIFY EXACT LOCATION.
- 13 1-1/2" CONDENSATE DRAIN DOWN WALL AND TERMINATE THRU WALL INTO MOP SINK BASIN WITH CODE APPROVED AIR GAP.
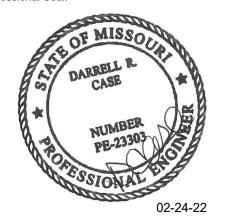
#### **GENERAL NOTES**

1. PLUMBING CONTRACTOR SHALL VERIFY WITH THE LOCAL HEALTH DEPARTMENT AND/OR WATER COMPANY AS TO THE METER AND VALVING ARRANGEMENTS OF THE DOMESTIC WATER SERVICE WHICH ENTERS THE BUILDING. IF A BACKFLOW PREVENTER AND/OR PRESSURE REDUCING VALVE IS REQUIRED, THE PLUMBER SHALL FURNISH AND INSTALL SAME PER LOCAL AND STATE REQUIREMENTS. CONTRACTOR SHALL VERIFY WATER SERVICE (NEW OR EXISTING) IS CAPABLE OF PROVIDING A MAXIMUM OF 75 G.P.M. AT A MINIMUM OF 45 P.S.I. DOWNSTREAM OF METERING AND VALVING. IN THE EVENT THAT THE SERVICE CANNOT PROVIDE ADEQUATE VOLUME/PRESSURE THE CONTRACTOR SHALL CONTACT THE OWNERS REPRESENTATIVE PRIOR TO COMMENCING ANY WORK.

2. PLUMBING CONTRACTOR SHALL PROVIDE AND INSTALL STOP VALVES AT FINISHED WALL SURFACE.

3. ALL PIPING SHOWN ON THIS PLAN IS CONCEALED ABOVE THE LAY-IN CEILING, BELOW THE FLOOR AND IN WALLS. EXPOSE PIPING IN SPACE ONLY AT EQUIPMENT AND FIXTURES.

4. PROVIDE WATER CONNECTIONS AS REQUIRED, ANGLE STOP AND ESCUTCHEON PLATE FOR ALL FINAL WATER CONNECTIONS.

5. PROVIDE AIR CHAMBER TYPE WATER HAMMER ARRESTORS OR ACCEPTABLE FACTORY MANUFACTURED SUBSTITUTES AT ALL WATER ROUGH-IN LOCATIONS.

6. ALL PLUMBING WORK SHALL BE PERFORMED IN FULL COMPLIANCE WITH LOCAL PLUMBING CODE, HEALTH REGULATIONS AND LOCAL ORDINANCES.

7. THE PLUMBING CONTRACTOR IS RESPONSIBLE FOR ALL PERMIT FEES, UTILITY TAP FEES AND INSPECTION FEES AS REQUIRED.

8. THE CONTRACTOR SHALL COORDINATE THE LOCATION OF HIS DRAINS, HUB DRAINS AND CONNECTION POINTS WITH THE GENERAL CONTRACTOR. THE PLUMBING CONTRACTOR SHALL FIELD VERIFY EXISTING CONDITIONS PRIOR TO SUBMITTING HIS

9. ALL PLUMBING PIPING SHALL BE ROUTED UNDER THE FLOOR, ABOVE THE CEILING OR LOCATED WITHIN WALLS OR PLUMBING CHASES. EXPOSED PIPING ONLY WHERE NECESSARY TO CONNECT TO EQUIPMENT.

Bakery-Cafe:

240

SYSTEM: G4 (ARIA)
Project Team:



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5 MEP UPDATES

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 2
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## DOMESTIC WATER & GAS PLUMBING

Project Number:
LKA-MO-01-22
Drawn By:

P104

05/26/2023

DM: CPM: DM CPM

1 PLUMBING PLAN - SUPPLY 1/4" = 1'-0"

1 Waste Isometric

PLAN MARK	MANUFACTURER	MODEL	ACCESSORIES	NOTES
FLOOR DRAINS (TYPICAL)	WADE OR EQUAL	1103STD6 W/6" STRAINER	P-TRAP TRAP PRIMER (RESTROOMS ONLY)	FURNISH FULL GRATE AND 4" HIGH FUNNEL FOR INDIRECT DRAIN FIXTURES
+ FLOOR CLEANOUT	WADE OR EQUAL	6000		NICKEL BRONZE SECURED TOP
FLOOR SINK	WATTS	FS-740	1/2 GRATE	12"x12"x8" W/PORCELAIN GRATE
LAV P	тото	LT307	1-1/4x1-1/2 P-TRAP STOP VALVES	MOUNTING HGT PER ADA, SEE ARCH SHEET A112
LAV (P6)	KOHLER	5-2084-R	1-1/4x1-1/2 P-TRAP STOP VALVES	MOUNTING HGT PER ADA, SEE ARCH SHEET A112
FAUCET (FOR LAV)	тото	LET105-D10EM	BLADE TYPE HANDLES AM. STD. 0000.172V	CHROME
MSB	FLORESTONE	MSR-2424	W/ MOEN FAUCET 8230 MR 372 MOP HANGER, STRAINER, TILE FLANGES	24" X 24" SEE ARCH PLANS TERRAZZO FINISH
WC (ADA) Q	тото	CT 705ELN	WHITE-OPEN FRONT SEAT. NO COVER	W/ AM. STD. MANUAL FLUSH VALVE 6047.161.02
WC (ADA)	тото	CT 705ELN	WHITE-OPEN FRONT SEAT. NO COVER	W/ TOTO TET1LA32#CP FLUSH VALVE
GREASE INTERCEPTOR	SCHIER	GB-250	EQUIP WITH TELE GLIDE AJDUSTABLE RISERS AND HEAVY DUTY TRAFFIC RATED LID	100 G.P.M., 1,076 LB. VENT PER LOCAL CODE
GWH (GAS WATER HEATER)	A.O. SMITH	BTH-199	DIRECT VENT SEALED COMBUSTION	100 GAL. 199,900 BTU, 230 GPH RECOVERY
FPWH (FREEZEPROOF WALL HYDRANT)	JAY R. SMITH	5609QT OR EQUAL	KEY OPERATED INTEGRAL VACUUM BREAKER	1/2" FEMALE INLET 3/4" HOSE CONNECTION

Bakery-Cafe:

2406

SYSTEM: G4 (ARIA)



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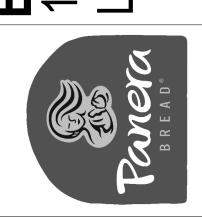
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Project Number: Sheet Number:

Project Number: Sh

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JSP

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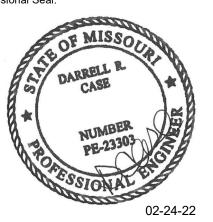


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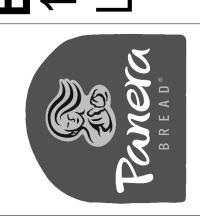
Architecture · Engineering · Planning · Interior Design · Landscape Architecture

Professional Seal:



Project Ti

## akery Cafe#2406 410 NE DOUGLAS ST EES SUMMIT, MO 64086



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## CASE Engineering Inc.

796 Merus Court T 636.349.1600 St. Louis, MO 63026 F 636.349.1730 CERTIFICATE OF AUTHORITY NO. 001498

No.	Description	Date
1	PERMIT SET - TI	7/18/2022
2	TI UPDATES	9/22/2022
3	CONSTRUCTION SET	11/09/202
4	OWNER REVISION	02/03/202
5	MEP UPDATES	05/26/202

PLUMBING SUPPLY
RISER

Project Number:

LKA-MO-01-22


Drawn By:

JSP
Issue Date:

07/05/2022

DPM: DM: CPM:

GAS METER, ROOFTOP UNITS AND ASSOCIATED GAS PIPING FURNISHED UNDER SHELL PACKAGE.

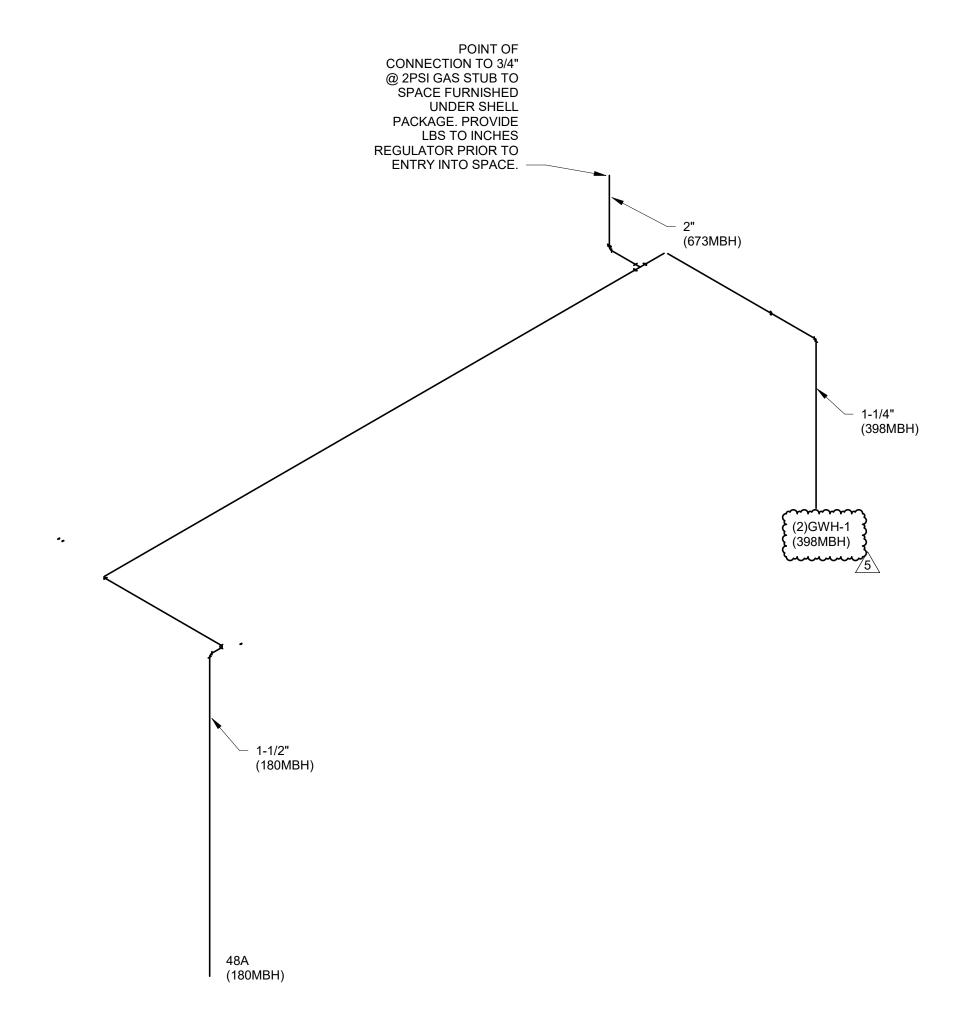

Gas Isometric

	GAS LOAD SUMMAR	RY				
SYSTEM	DESIGNATION EQUIPMENT		MBH			
PLUMBING	GWH-1	(2)WATER HEATERS	398			
HVAC	RTU-1	ROOFTOP UNIT	120			
	RTU-2	ROOFTOP UNIT	120			
	RTU-3	ROOFTOP UNIT	180			
KITCHEN	48A	OVEN	180			
TOTAL NATU	IRAL GAS CONNECTED	LOAD	998			
	MBH CAPACITY	998				
GAS METER REQUIREMENTS	TOTAL DEVELOPED LE EQUIVALENT PIPE LEN AND VALVE FRICTION METER.	75 FT X 1.2 = 90FT				
	CONSULT GAS UTILITY COMPANY FOR REGULATOR RATING					

Bakery-Cafe:

2406

SYSTEM: G4 (ARIA)
Project Team:



LK ARCHITECTURE, INC.

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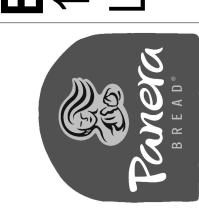
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Project Title:

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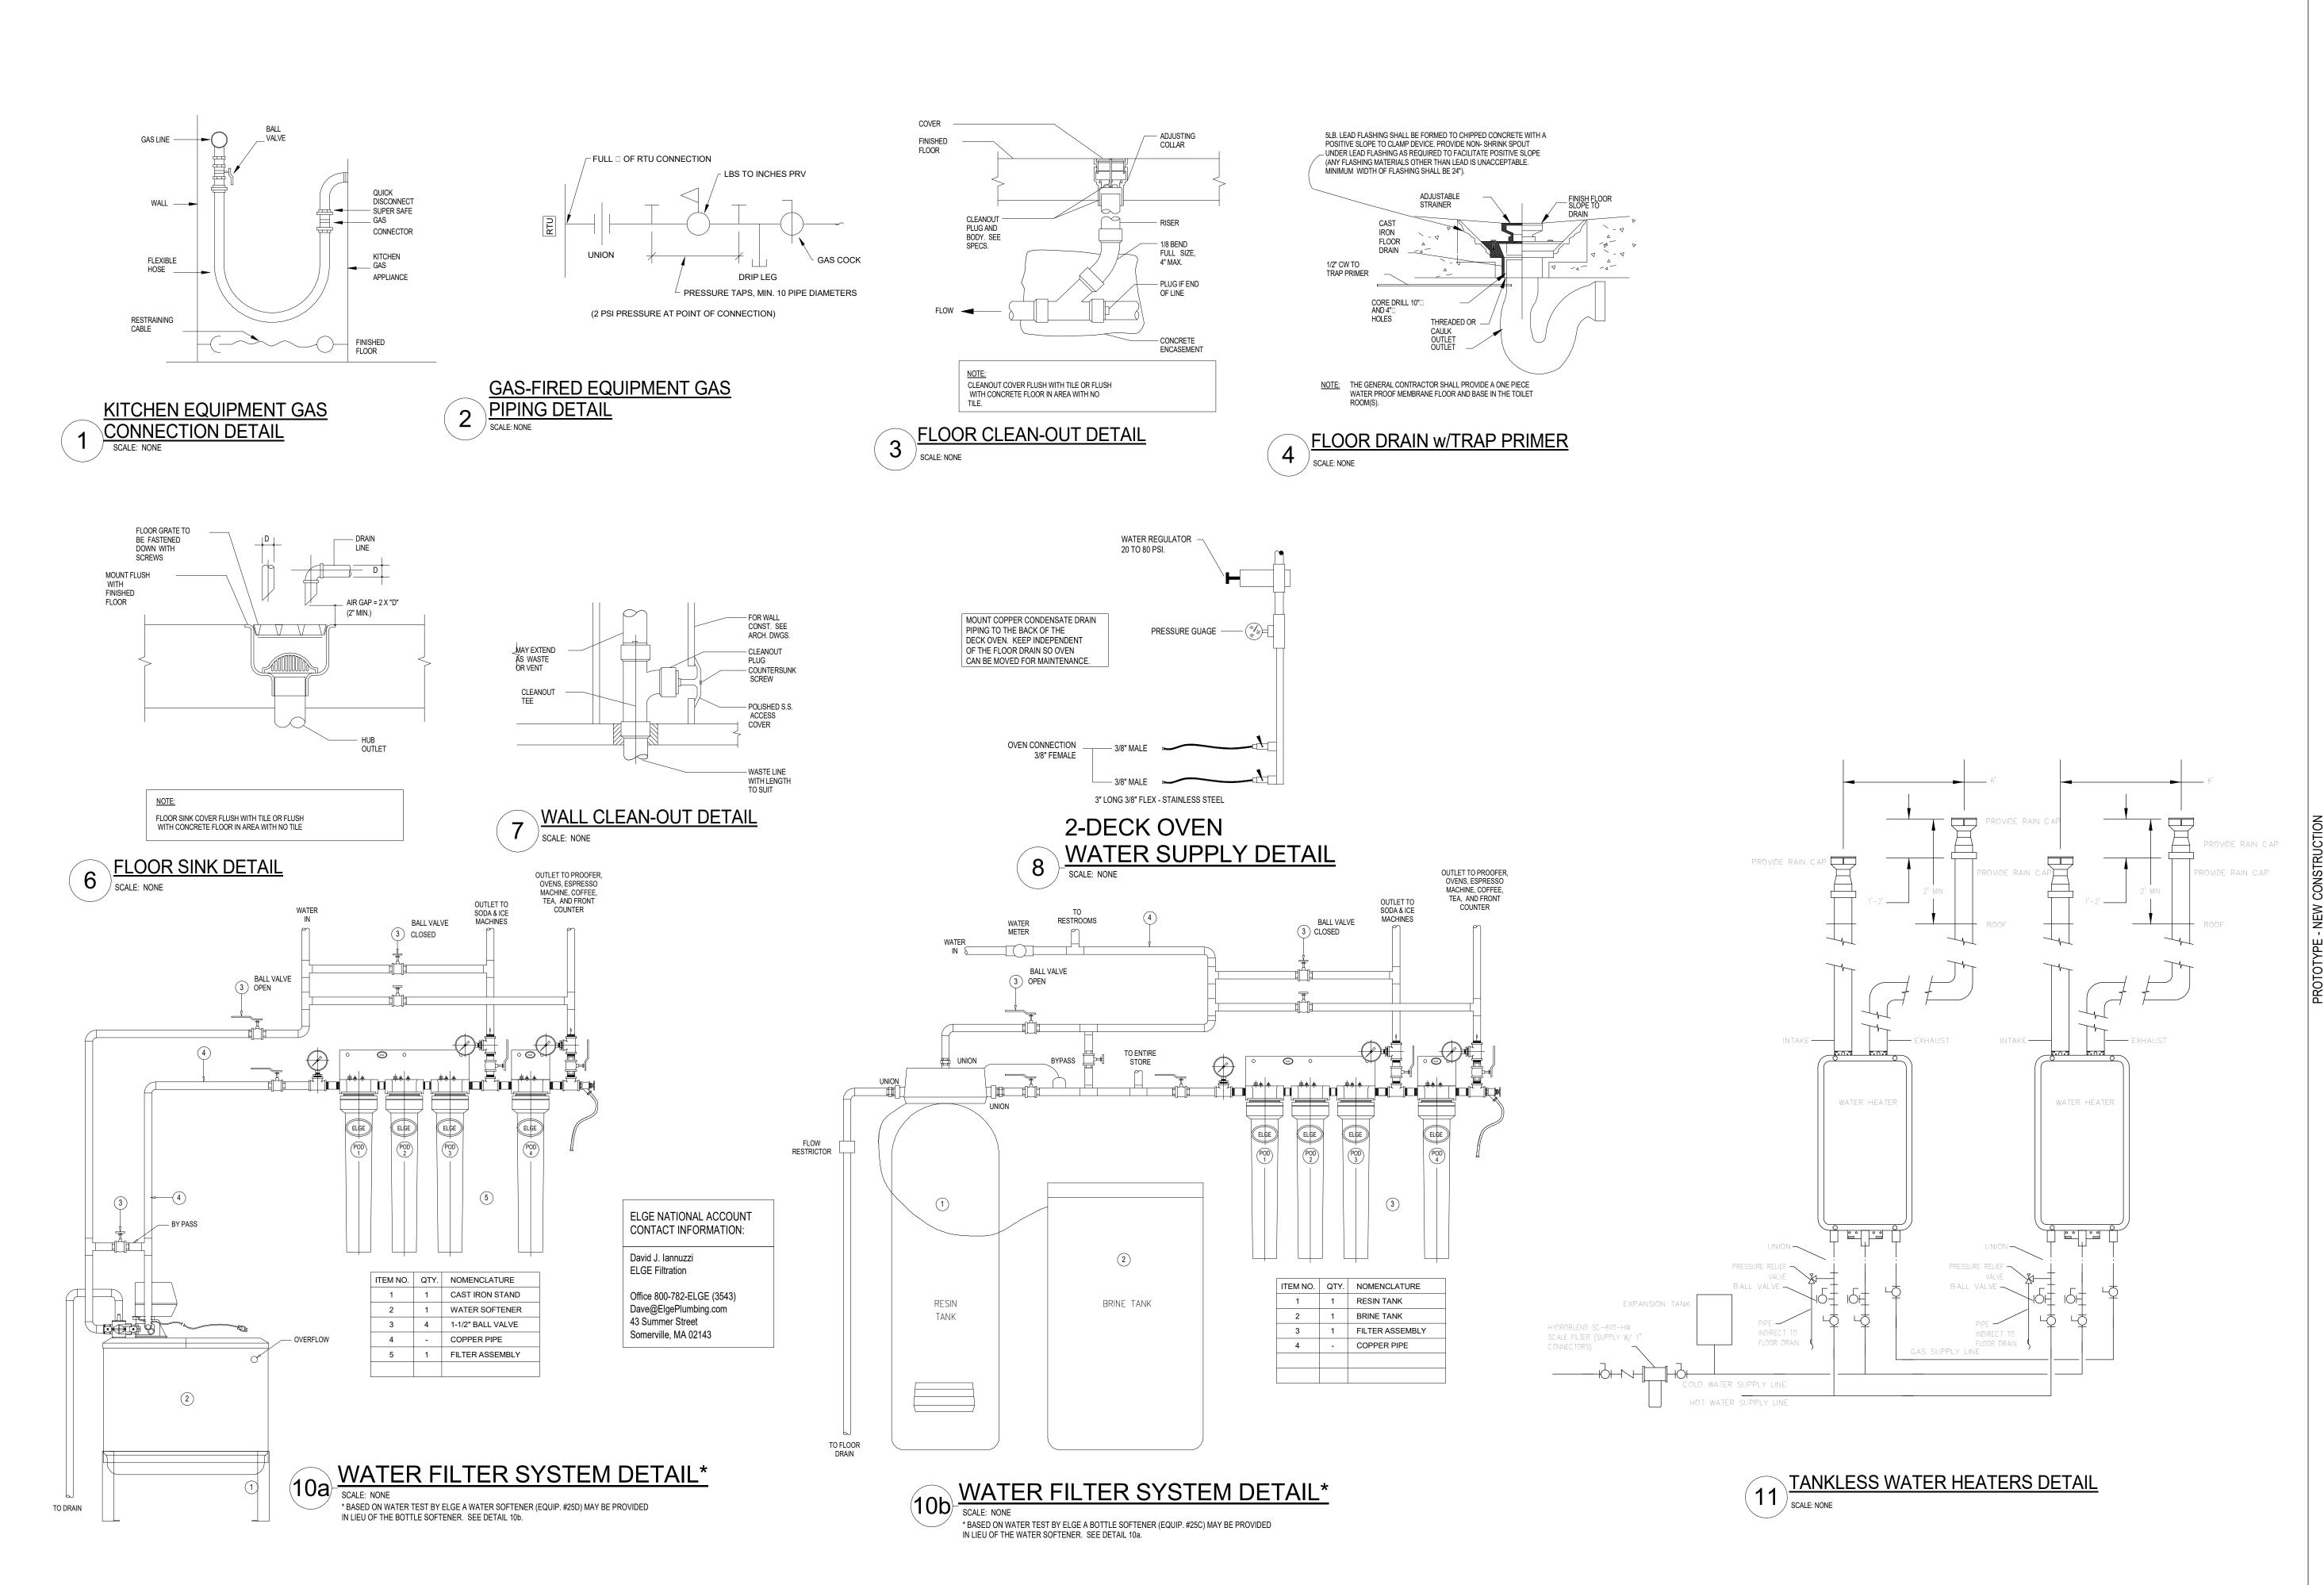
No.	Description	Date
1	PERMIT SET - TI	7/18/2022
3	CONSTRUCTION SET	11/09/2022
4	OWNER REVISION	02/03/2023
5	MEP UPDATES	05/26/2023

**GAS RISER** 

Project Number: Sheet Number: LKA-MO-01-22
Drawn By: JSP
Issue Date:

P200 P201 P2022 DM: CPM:

021 03 V1



2406

SYSTEM: G4 (ARIA)




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Project Title:

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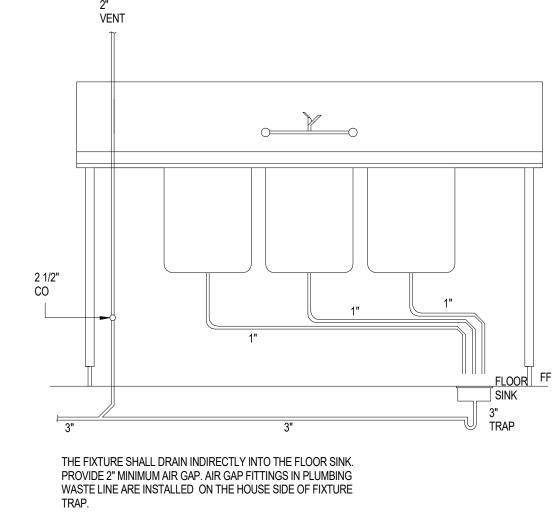
CASE Engineering Inc

796 Merus Court T 636.349.1600 St. Louis, MO 63026 F 636.349.1730 CERTIFICATE OF AUTHORITY NO. 001498


No.	Description	Date
1	PERMIT SET - TI	7/18/2022
3	CONSTRUCTION SET	11/09/2022

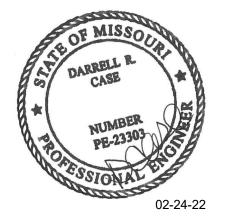Project Number: Sheet Number: I KA-MO-01-22

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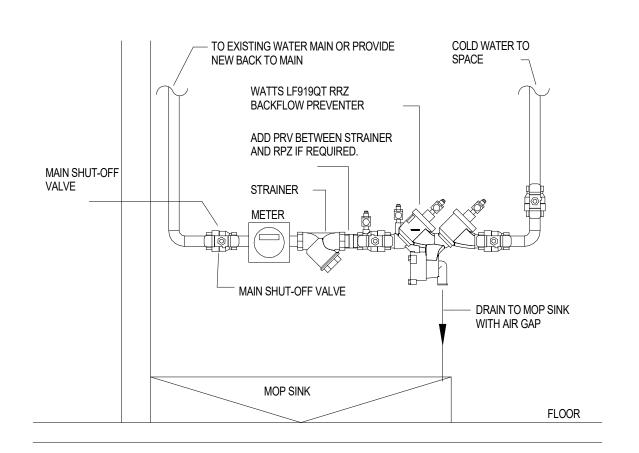


2 3 COMPARTMENT SINK DETAIL
SCALE: NONE

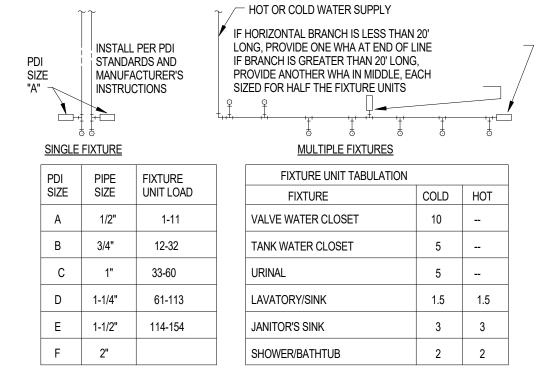

PC TO PROVIDE WATER HAMMER ARRESTERS BY SIOUX CHIEF, PRECISION PLUMBING PRODUCTS, WATTS OR APPROVED EQUIVALENT WITH PISTON AND 0-RING CONSTRUCTION, HAVING PDI #WH- 201, ASSE #1010 AND ANSI #A112.26.1M CERTIFICATION. INSTALL IN HORIZONTAL OR VERTICAL POSITION, BUT NEVER UPSIDE DOWN. INSTALL IN LINE WITH WATER FLOW DIRECTION IF POSSIBLE. SIZE THE UNITS AS SHOWN ON THE DRAWINGS AND/OR PER THE TABLES SHOWN ABOVE. PROVIDE ACCESS PANEL FOR SERVICING OR REPLACEMENT, WHERE REQUIRED.





WATER SERVICE PIPING DETAIL

Bakery-Cafe:

SYSTEM: G4 (ARIA)

Project Team:




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No.	Description	Date
1	PERMIT SET - TI	7/18/2022
3	CONSTRUCTION SET	11/09/2022

F 636.349.1730

PLUMBING DETAILS LKA-MO-01-22 Drawn By:

07/05/2022

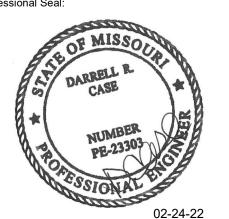PIPE HANGER DETAIL

CIRCUIT SOLVER SHALL BE FACTORY ADJUSTABLE FROM 105 F (40.5C) TO 140F (60C) AS REQUIRED BY PROJECT CONDITIONS. (OTHER SETPOINTS AVAILABLE, CONSULT FACTORY) A. CIRCUIT SOLVER SHALL MODULATE BETWEEN OPEN AND CLOSED POSITION WITHIN A 10F (5.5C) RANGE. iii. CIRCUIT SOLVER SHALL BÈ AVÁILABLE IN SIZES RANGING FROM ½ INCH NPT CIRCUIT SOLVER BODY AND ALL INTERNAL COMPONENTS SHALL BE CONSTRUCTED OF STAINLESS STEEL WITH MAJOR COMPONENTS CONSTRUCTED OF TYPE 303 STAINLESS STEEL. A. CIRCUIT SOLVER SIZES ½ INCH THROUGH 2 INCH SHALL BE RATED TO 200 PSIG THERMOMEGATECH MAXIMUM WORKING PRESSURE. I. ALL CIRCUIT SOLVERS SHALL BE STANDARD CIRCUIT SOLVER TAPERED FEMALE PIPE THREAD, NPT. BALL VALVE B. ALL CIRCUIT SOLVERS SHALL BE RATED TO 300F (148.9C) MAXIMUM WORKING TEMPERATURE. SEE PLANS CIRCUIT SOLVER SHALL BE ANSI/AWWA C800 COMPLIANT. ALL CIRCUIT SOLVERS SHALL BE NSF-61 COMPLIANT WITH ZERO LEAD CONTENT FOR USE IN ALL DOMESTIC WATER SYSTEMS. THERMAL ACTUATOR SHALL BE SPRING OPERATED AND SELF CLEANING. DELIVERING CLOSING THRUST SUFFICIENT TO KEEP ORIFICE OPENING FREE OF SCALE DEPOSITS. I. THERMAL ACTUATOR SHALL BE RATED FOR A MINIMUM OF 200,000 3. INSTALLATION OF CIRCUIT SOLVER SHALL BE MADE BY QUALIFIED TRADESMEN. INSTALL CIRCUIT SOLVER IN EACH DOMESTIC HOT WATER RETURN PIPING BRANCH BEYOND LAST HOT WATER DEVICE IN THAT BRANCH, A, PROVIDE SUITABLE LINE SIZE ISOLATION VALVES, UNIONS, AND STRAINER AS INDICATED IN PIPING DETAIL SHOWN ON THE DRAWINGS. B. PROVIDE SUITABLE ACCESS PANEL AS REQUIRED IN NON-ACCESSIBLE CEILINGS

1. FURNISH AND INSTALL AS INDICATED ON THE PLANS, CIRCUIT SOLVER IN THE DOMESTIC HOT WATER PIPING. CIRCUIT SOLVER SHALL BE SELF CONTAINED AND FULLY AUTOMATIC WITHOUT ADDITIONAL PIPING OR CONTROL MECHANISMS. VALVE SHALL BE A CIRCUIT SOLVER AS MANUFACTURED BY THERM-OMEGA-TECH, INC., OR EQUIVALENT. A. CIRCUIT SOLVER SHALL REGULATE THE FLOW OF RECIRCULATED DOMESTIC HOT WATER BASED ON WATER TEMPERATURE ENTERING CIRCUIT SOLVER

I. WHEN FULLY CLOSED CIRCUIT SOLVER SHALL BYPASS A MINIMUM FLOW TO MAINTAIN DYNAMIC CONTROL OF THE RECIRCULATING LOOP AND PROVIDE A MEANS

REGARDLESS OF SYSTEM OPERATING PRESSURE.

FOR SYSTEM SANITIZING.



PLUN	MBING FIXTURE CONNECTION SCHED	ULE								
ITEM	DESCRIPTION	WASTE	VENT	CW	FCW	HW	GAS	FURN.I BY	NST. BY	SPECIFICATIONS & REMARKS
<b>(1)</b>	FRONT OF HOUSE WATER CLOSET FLOOR SET-FLUSH VALVE ADA	4"	2"	1-1/2"	-		-	P.C.	P.C.	AMERICAN STANDARD 3043.001 WHITE-OPEN FRONT SEAT. NO COVER W/SLOAN ROAL #111-1.28GPF FLUSH VALVE PER ADA
<b>®</b>	FRONT OF HOUSE LAVATORY-WALL HUNG ADA	1-1/2"	1-1/2"	1/2"	ı	1/2"	ı	P.C.	P.C.	KOHLER #K-2084-R, SOHO, 20"X18" WALL HUNG LAVATORY WITH SINGLE HOLE FAUCET CENTER. DRILLED FOR CONCEALED ARM CARRIER. CARRIER; ZURN #Z-1231. SUPPLIES; BRASS CRAFT #SCR-1912-A. TRAP; SPEEDWAY #CR-1915-A. FAUCET; TOTO MODEL TEL105-D10EM. INSULATE ALL PIPING BELOW SINK WITH PLUMBEREX TRAP-GEAR. MOUNTED AT ADA HEIGHT. INSTALL SHUT-OFF VALVES SO THE HANDLES ARE FACING IN TOWARDS THE CENTER OF THE SINK TO MAKE ROOM FOR SOAP DISPENSER CANISTER.
FD-1	FLOOR DRAIN	4"	2"	1	1		1	P.C.	P.C.	WADE #1103STD6 (OR EQUAL), CAST IRON BODY w/FLANGE, INTEGRAL CLAMPING COLLAR, SEEPAGE OPENINGS, AND ADJUSTABLE 6"x6" SQUARE NICKEL BRONZE STRAINER WITH VANDAL PROOF SCREWS. AND ADJUSTABLE 6"x6" SQUARE NICKEL BRONZE STRAINER WITH VANDAL PROOF SCREWS. PROVIDE PREASSEMBLED INLINE FLOOR DRAIN TRAP SEALER, EQUAL TO SURE SEAL, ON ALL FLOOR DRAINS.
FD-2	FLOOR DRAIN w/FUNNEL	4"	2"	ı	ı	-	1	P.C.	P.C.	WADE #1103G6-EF4 (OR EQUAL), CAST IRON BODY w/FLANGE, INTEGRAL CLAMPING COLLAR, SEEPAGE OPENINGS,ADJUSTABLE 6"x6" SQUARE NICKEL BRONZE STRAINER WITH VANDAL PROOF SCREWS AND 4" FUNNEL. PROVIDE PREASSEMBLED INLINE FLOOR DRAIN TRAP SEALER, EQUAL TO SURE SEAL, ON ALL FLOOR DRAINS.
FS-1	FLOOR SINK	4"	2"				-	P.C.	P.C.	WATTS #FS-740, 12"x12" SQUARE FLOOR SINK WITH 8" DEEP SUMP, WHITE PORCELAIN ENAMEL COATED INTERIOR, LOOSE SET PORCELAIN ENAMEL COATED CAST IRON GRATE, ALUMINUM DOME BOTTOM STRAINER,NO HUB (STANDARD) OUTLET.
GWH-1 (2)	(2) GAS FIRED TANKLESS WATER HEATERS		(2) 3"	1-1/2"	1	1-1/2"	1"	P.C.	P.C.	(2) RU199I TANKLESS WATER HEATERS, 199 BTUH INPUT, SEALED COMBUSTION DIRECT VENT, 4 GPM @ 90°F RISE, 96% EFFICIENCY.
FCO	FLOOR CLEANOUT	REFER TO DWGS			-1			P.C.	P.C.	ZURN #ZN1400 TUF-TOP ADJUSTABLE FLOOR CLEANOUT WITH DURA-COATED CAST IRON BODY, WITH GAS & WATERTIGHT ABS TAPERED THREAD PLUG, AND SCORIATED NICKEL BRONZE COVER AND PLATE.
GCO	CLEANOUT TO GRADE	REFER TO DWGS						P.C.	P.C.	ZURN #Z1406-HD-VP, EXTERIOR CLEANOUT, HEAVY DUTY WITH VANDAL PROOF SCREWED TOP.
FWH-1	WALL HYDRANT FREEZE PROOF		1	3/4"	ı		ı	P.C.	P.C.	WOODFORD #67 "ANTI-SIPHON" AUTOMATIC DRAINING WALL HYDRANT FOR FLUSH INSTALLATION.FURNISH COMPLETE WITH INTEGRAL BACKFLOW PREVENTER, LOOSE KEY, NON-TURNING OPERATING ROD WITH COMPRESSION CLOSURE VALVE. BRONZE SEAT AND SEAT WASHER, 3/4" INLET & HOSE CONNECTION.

CROSS CONNE	CTION CONTR	OL SCHEDULE	
FIXTURE	MAKE	MODEL	ASSE, ASME OF ANSI STANDARI
MOP SINK (FAUCET CONTAINS INTERGRAL BACKFLOW DEVICE)	INTEGRAL	-	ASME A112.18. ANSI/NSF 61/9
DISHWASHER	WATTS	LF008PCQT	ASSE 1056
ICE MAKER (ABOVE SODA)	AIR GAP	INTERNAL	ASME A112.1.2
ICE MACHINE	AIR GAP	INTERNAL	ASME A112.1.2
CARBONATOR	WATTS	9D	ASSE 1022
COFFEE BREWER	WATTS	SD-3	ASSE 1022
TEA BREWER	WATTS	SD-3	ASSE 1022
SOUP RETHERMALIZER	AIR GAP	-	ASME A112.1.2
ESPRESSO	WATTS	SD-3	ASSE 1022
BOTTLE SOFTENER	WATTS	LF009QT	ASSE 1013
WATER FILTER SYSTEM	WATTS	LF009QT	ASSE 1013
RACK OVEN	WATTS	LF007QT	ASSE 1015
DECK OVEN	WATTS	LF007QT	ASSE 1015
PROOFER	WATTS	LF007QT	ASSE 1015
CHEMICAL DISPENSER	WATTS	LF009 W/ AIR GAP FITTING LF909AGA	-
FREEZEPROOF HOSEBIBB	WATTS	-	ASSE 1011
3-COMPARTMENT SINK	AIR GAP	-	ASME A112.1.2
VEGETABLE PREP SINK	AIR GAP	-	ASME A112.1.2
HAND SINKS	AIR GAP	-	ASME A112.1.2
DROP-IN SINKS	AIR GAP	-	ASME A112.1.2
LAVATORIES	AIR GAP	-	ASME A112.1.2
WATER CLOSETS (FLUSH VALVE)	INTEGRAL	-	ASSE 1001
URINAL (FLUSH VALVE)	INTEGRAL	-	ASSE 1001
WATER HEATER	WATTS	LFN360	ANSI Z21.22

PROVIDE APPROPRIATE BACK FLOW PREVENTER AT OTHER EQUIPMENT AS REQUIRED BY CODE.


GREASE INTE	RCEPTOR SI	ZING PER INSTITUTE		MBING DRA	AINAGE			
Length X Width X D	Compartments=		Interceptor		Number of			
<u>FIXTURE</u> <u>DESCRIPTION</u>	<u>LENGTH</u>	<u>WIDTH</u>	<u>HEIGHT</u>	<u>GALLONS</u>	FLOW RAT (GPM)			
3 COMPARTMENT SINK	24	18	12	22.4	50.49			
	(	OTHER FIXTURE	ES					
FIXTURE DESCIPTION	QTY	QTY FIXTURE DFU TOTAL GPM						
FS	1	3	3	1.5	1.5			
MOP SINK	1	3	3.0	1.5	1.5			
3 COMPARTMENT SINK USE GPM CALCULATION FROM ABOVE								
		TOTAL RE	QUIRED FLOW	RATING GPM=	53.5			

TA	BLE TO CALCULATE HOT WA	TER GPH	
PLUMBING FIXTURE	NO. OF FIXTURES	TOTAL HOT WATER GPM	
3-COMP SINK	45	1	45
2-COMP SINK	20	1	20
DISWASHER	35	1	35
MOP SINK / LAUNDRY TUB	10	1	10
SINKS / LAVATORIES	5	6	30
TOTA	L HOT WATER GALLONS PER	HOUR FOR ALL FIXTURES:	140 GPH
100	- 75 GALLONS		
TOTAL HOT	WATER GALLONS PER HOUR	NEEDED FOR RECOVERY:	65.0 GPH
		TEMPERATURE RISE (°F)	100 °F
GPH RECOVERY x 8.33 x TEMP. RISE	THERMAL EFFICIENCY	X (DEMAND FACTOR %)	TOTAL BTU NEEDED FOR RECOVERY
56,401 BTU	0.75	42,301 BTU	
BTU -> KW CONVER	RSION	3,413 BTU / KW	12.4 kW

ЕМ	DESCRIPTION	IW	WASTE	VENT	CW	FCW	HW	GAS	FURN BY	INSTALL BY	ROUGH-IN LOCATION	SPECIFICATIONS & REMARKS
11	MOP SINK		3"	1-1/2"	1/2"		1/2" (110°)		G.C.	G.C.	36"A.F.F.	FLORESTONE #MSR-3624. HOSE #MR370, 5 F LONG w/o CLAMP. DOME STRAINER #MR376. FAUCET #MR-371. MOP HANGER #MR-372. WEDGE-LOK SEAL FOR 3" DRAIN #MR374.
	3-COMPARTMENT SINK (REDUCED SIZE)	2"							E.S.	G.C.		EAGLE; CUSTOM WASTE VALVE; FISHER #22446 WASTE THRU GREASE TRAP
ر ا	#15 PRE-RINSE SPRAY UNIT AT 3-COMPARTMENT SINK					1/2"	1/2" (140°)		E.S.	G.C.	14"A.F.F.	FISHER #2210-WB w/ADD-ON SPOUT
(2A)	#16 ROTARY WASTE VALVE AT 3-COMPARTMENT SINK	2"							E.S.	G.C.	-	FISHER #22446
	#19B FAUCET AT 3-COMPARTMENT SINK					1/2"	1/2"		E.S.	G.C.	45"A.F.F.	FISHER #13269
	1-COMPARTMENT SINK (REDUCED SIZE)	2"							E.S.	G.C.		EAGLE GROUP #314-17.5-1-18L WASTE VALVE; FISHER #22446 WASTE THRU GREASE TRAP
3B>	#16 ROTARY WASTE VALVE AT 2-COMPARTMENT SINK	2"							E.S.	G.C.		FISHER #22446
	#19D FAUCET AT 2-COMPARTMENT SINK					1/2"	1/2"		E.S.	G.C.	45"A.F.F.	FISHER #13269
(1C)	HAND SINK (WALL MOUNTED S.S.)		2"	1-1/2"	1/2"		1/2" (110°)		E.S.	G.C.	24"A.F.F.	EAGLE #HSA-10-FK-LRS
3B	ICE MACHINE w/REMOTE CONDENSER	3/8" & 3/4"				1/2" DFCW			E.S.	G.C.	96"A.F.F.	HOSHIZAKI #KMD-901MRH w/URC-12F
3F <b>&gt;</b>	ICE MACHINE (AIR COOLED)	3/8" & 3/4"				1/2" DFCW			OWNER	G.C.	72"A.F.F.	HOSHIZAKI #KM-515MAH
3H <b>&gt;</b>	ICE MACHINE (AIR COOLED)	3/8" & 3/4"				1/2" DFCW			OWNER	G.C.	96"A.F.F.	HOSHIZAKI #KM-660MRJ
5B	4-POD COLD WATER FILTER				3/4"				E.S.	G.C.	96"A.F.F.	ELGE #SLB4PL, 4-POD, WALL MOUNTED
5D	WATER SOFTENER				3/4"				E.S.	G.C.	90"A.F.F.	HOSHIZAKI #KMD-901MRH w/URC-12F
7A	DISHWASHER (UPRIGHT)	1-1/2"					(140°)		ECOLAB	G.C.	72"A.F.F.	JACKSON #ES-2000
2A	BAG-N-BOX	-							PEPSI	PEPSI		MBS #AR-10-2W-GLIDE
2C <b>&gt;</b>	CARBONATOR								PEPSI	PEPSI		CORNELIUS 1624
2B. <b>B</b> R	DOUBLE WIDE 6 RACK PROOFER	1/2"				1/2"			BAXTER	BAXTER	84"A.F.F.	BAXTER RPW2E-40.5
ER)	HOT BEV TABLE W/URN TROUGH	1/2"				1/2"			EAGLE	EAGLE		EAGLE YPBT3072-0019-00
= 7	#19D POT FILLER FAUCET AT HOT BEV TABLE					1/2"	1/2"		KROWNE	G.C.	45"A.F.F.	KROWNE #16-252L
8A	SINGLE RACK OVEN/GAS (BETA)	3/4"				1/2"		1 1/2"	BAXTER	BAXTER	86"A.F.F.	BAXTER #OV500G1
4E	SODA/ICE DISPENSER (DINING ROOM)	3/4"				1/2" DFCW FROM #42C			PEPSI	PEPSI	24"A.F.F.	ELEVATE; IDC 255
4D <b>&gt;</b>	SODA/ICE DISPENSER (DRIVE THRU)	3/4"			-	1/2" DFCW FROM #42C			PEPSI	PEPSI	24"A.F.F.	CORNELIUS 621058581
6A	TEA BREWER					1/2"			E.S.	G.C.	46"A.F.F.	WILBUR CURTIS #TCTS10631
F)	TWIN COFFEE BREWER					1/2"			E.S.	G.C.	46"A.F.F.	WILBUR CURTIS #G4TP1T19A3131
1	ESPRESSO MACHINE (AUTO)	3/8"				1/2"			OWNER		45"A.F.F.	FRANKE EVOLUTION 2-STEP
BA	SOUP RETHERMALIZER	1-1/2"				1/2"			E.S.	G.C.	12"A.F.F.	SSP (FAUSSEETT INTERNATIONAL) #RTB-14-SL
7A>	CHEMICAL DISPENSER @ MOP SINK						1/2"		E.S.	G.C.	48"A.F.F.	INSTALL 1/2" 140° HW HOSEBIBB W/ VACUUM BREAKER & BFP
7B	CHEMICAL DISPENSER @ 3-COMP					1/2"	1/2"		E.S.	G.C.	10"A.F.F.	INSTALL 1/2" 140 DEG. HW & CW ROUGH-INS BELOW SINK /WVACUUM BREAKERS & BFPS.PROVIDE SHUT OFF VALVES AND TEMPERING VALVE PER ECOLAB TEMPERING VALVE INSTALLATION GUIDE. INSTALL TEMPERING VALVE BELOW SINK AND PROVIDE SHUT-OFF VALVE ON TEMPERED LINE. DELIVERY WATER TEMPERATURE TO DISPENSER AFTER TEMPERING VALVE SHALL BE BETWEEN 70 DEG.AND 120 DEGF
7C>	CHEMICAL DISPENSER @ DISHWASHER						1/2"		E.S.	G.C.	48"A.F.F.	INSTALL 1/2" 140° HW HOSEBIBB W/ VACUUM BREAKER & BFP
寸	ESPRESSO BAR LH	1-1/2"			1/2"		1/2"		E.S.	E.S.		EAGLE; YPB-OB3072-0010-00
3GL <b>&gt;</b>	# 19A FAUCET AT ESPRESSO BAR				1/2"		1/2" (110°)		E.S.	G.C.	14"A.F.F.	ZURN #Z812B1-15F

NOTE: 2-COMPARTMENT SINK FAUCET (19B), COFFEE SINK FAUCET (18), ESPRESSO BAR FAUCET (19A), HAND SINK (21C), AND LAVATORIES SHALL

BE SERVED BY POWERS HYDROGUARD SERIES LFe480 THERMOSTATIC TEMPERING VALVE, SET TO 110°F.

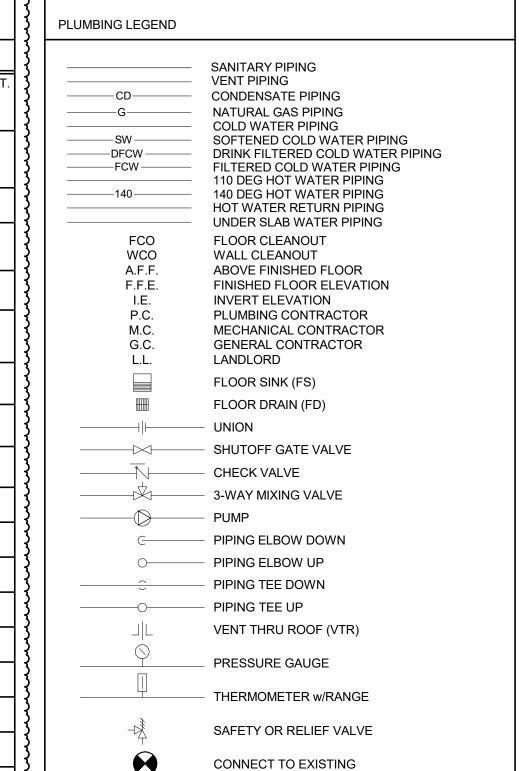

MAXIMUM SPACING FOR GAS PIPE SUPPORTS							
STEEL PIPE							
(HORIZONTAL)	SPACING IN FEET	MIN. ROD SIZE - INCHES					
1/2	53/8						
3/4 TO 1-1/4	8	3/8					
1-1/2 TO 3	10	1/2					
(VERTICAL)							
3-1/2 TO 5	EVERY FLOOR						

Bakery-Cafe:

SYSTEM: G4 (ARIA) Project Team:




LK ARCHITECTURE, INC.

345 RIVERVIEW, WICHITA, KS 67203 T 316.268.0230 F 316.268.0205

**Architecture - Engineering -**Planning · Interior Design · **Landscape Architecture** 

Professional Seal:

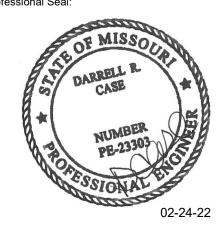

Project Title:



Consultant Copyright Placeholder

796 Merus Court St. Louis, MO 63026 CERTIFICATE OF AUTHORITY NO. 001498

Description 1 PERMIT SET - TI 7/18/2022 2 TI UPDATES 9/22/2022 3 CONSTRUCTION SET 11/09/2022 5 MEP UPDATES 05/26/2023

T 636.349.1600 F 636.349.1730

**PLUMBING** SCHEDULES

Project Number: LKA-MO-01-22

#### INSPECTION AND COOPERATION

NO DEVIATION FROM THE DRAWINGS AND /OR SPECIFICATIONS WILL BE ALLOWED WITHOUT PRIOR WRITTEN APPROVAL OF ARCHITECT OR ENGINEER. THIS CONTRACTOR SHALL COOPERATE WITH THE OTHER CONTRACTORS TO ALLOW FOR THE INSTALLATION OF THEIR WORK AS WELL AS HIS OWN.

THIS CONTRACTOR SHALL BE RESPONSIBLE FOR HIS WORK FITTING IN PLACE WITHOUT CONFLICT WITH THE OTHER TRADES, WHERE PROPER PLANNING COULD AVOID

NOTHING IN THE DRAWINGS AND/OR SPECIFICATIONS SHALL BE INTERPRETED TO CONFLICT WITH ANY CITY OR PROVINCIAL LAW, REGULATION, CODE, ORDINANCE, RULING, OR FIRE UNDERWRITER'S REQUIREMENT APPLICABLE TO THIS CLASS OF

SHOULD THE DRAWINGS AND/OR SPECIFICATIONS CONFLICT WITH SUCH LAWS OR ORDINANCES, THE CONFLICTING PORTION OF THE WORK SHALL BE INSTALLED STRICTLY IN ACCORDANCE WITH SUCH LAWS AND ORDINANCES WITHOUT EXTRA COST.

THIS CONTRACTOR SHALL SECURE AND PAY FOR ALL NECESSARY PERMITS AND INSPECTIONS REQUIRED FOR THIS INSTALLATION OF HIS WORK.

THE INFORMATION GIVEN HEREIN AND ON THE DRAWINGS IS AS EXACT AS COULD BE SECURED, BUT ITS EXTREME ACCURACY IS NOT GUARANTEED. THIS CONTRACTOR SHALL EXAMINE THE LOCATIONS AND VERIFY ALL MEASUREMENTS, DISTANCES, ELEVATIONS AND EXISTING PIPE SIZES BEFORE STARTING THE WORK.

THIS CONTRACTOR SHALL PROVIDE ALL NECESSARY OFFSETS, RAISED AND DROPS IN PIPING AND DUCTWORK AS REQUIRED BY BUILDING CONDITIONS AT NO ADDITIONAL

MECHANICAL DRAWINGS SHALL NOT BE USED FOR GENERAL CONSTRUCTION DIMENSIONS OR FOR TYPE OF MATERIAL USED. FOR EXACT BUILDING LAYOUT, DIMENSIONS AND BUILDING MATERIAL USED, THIS CONTRACTOR SHALL REFER TO THE ARCHITECTURAL DRAWINGS.

FIVE (5) COPIES OF ALL SHOP OR INSTALLATION DRAWINGS, FOUNDATION PLANS, EQUIPMENT OR APPARATUS DRAWINGS SHALL BE FURNISHED BY THIS CONTRACTOR THESE DRAWINGS SHALL BE CLEARLY MARKED INDICATING WHICH ITEMS ARE TO BE SUPPLIED AND SHALL STATE CAPACITIES, SIZES AND GENERAL DESCRIPTION OF ALL EQUIPMENT. ANY CHANGES FROM THE SPECIFIED ITEMS SHALL BE NOTED ON THE SUBMITTALS.

SHOP DRAWINGS OF SPECIAL APPARATUS OR EQUIPMENT WHICH IS TO BE FABRICATED INDIVIDUALLY FOR THIS PROJECT AND IS NOT DESCRIBED BY STANDARD MANUFACTURER'S DRAWINGS OR BULLETINS SHALL BE SUBMITTED FOR PROCESSING BEFORE FABRICATION.

#### THESE DRAWINGS SHALL BE SUBMITTED IN A TIMELY MANNER.

IT SHALL BE THIS CONTRACTORS RESPONSIBILITY TO MAINTAIN LIAISON WITH ALL PARTIES CONCERNED WITH THE MATERIAL SUBMITTED. THIS CONTRACTOR SHALL NOT PURCHASE ANY EQUIPMENT UNTIL SHOP DRAWINGS HAVE BEEN PROCESSED.

THIS CONTRACTOR SHALL SUBMIT NO DRAWINGS WITHOUT NOTATION OF EACH COPY INDICATING DATE OF CONTRACTOR'S REVIEW AND SIGNATURE OF CHECK FOR CONTRACTOR TOGETHER WITH CONTRACTOR'S NAME AND PROJECT IDENTIFICATION.

ARCHITECT'S PROCESSING WILL NOT CONSTITUTE A COMPLETE CHECK BUT WILL INDICATE ONLY THAT GENERAL METHOD OF CONSTRUCTION AND DETAILING IS

ARCHITECT'S PROCESSING WILL NOT RELIEVE THE CONTRACTOR OF RESPONSIBILITY FOR ERRORS SINCE THIS CONTRACTOR IS SOLELY RESPONSIBLE FOR DIMENSIONS AND DESIGNS OF ADEQUATE CONNECTIONS, DETAILS AND SATISFACTORY CONSTRUCTION OF ALL WORK, AS WELL AS FURNISHING MATERIALS AND WORKMANSHIP REQUIRED BY DRAWINGS AND SPECIFICATIONS WHICH MAY NOT BE INDICATED ON THE SUBMITTALS WHEN APPROVED.

#### 6. SUBSTITUTIONS OF EQUIPMENT OR MATERIAL

THE BRAND NAMES OF EQUIPMENT OR MATERIALS SPECIFIED HEREIN SHALL ESTABLISH QUALITY, CAPACITY, TYPE AND DIMENSIONS TO BE INCLUDED IN THE BASE

APPROVAL OF SUBSTITUTED ITEMS WILL BE BASED ON ABILITY AND CAPACITY TO PERFORM FUNCTION SERVED. QUALITY AND AVAILABILITY OF PARTS AND SERVICE. QUALITY OF EQUIPMENT, DELIVERY SCHEDULE, ETC. THE ARCHITECT SHALL REVIEW ALL SUCH REQUESTS BUT RESERVES THE SOLE RIGHT OF JUDGEMENT TO APPROVE OR REJECT THE PROPOSED SUBSTITUTIONS.

ACCEPTANCE OR REJECTION OF PROPOSED SUBSTITUTIONS SHALL NOT CAUSE ADDITIONAL COST. ANY CHANGES OF PIPING, DUCTWORK, ELECTRICAL CONTROLS OR INSTALLATION REQUIRED BECAUSE OF THE SUBSTITUTION OR EQUIPMENT SHALL BE PAID FOR BY THIS CONTRACTOR PROPOSING THE SUBSTITUTION.

#### 7. ERECTION OF APPARATUS

ALL WORK SHALL BE DONE UNDER THE PERSONAL SUPERVISION OF THIS CONTRACTOR WHO SHALL PROVIDE A COMPETENT FOREMAN TO LAY OUT ALL WORK. ALL WORK SHALL BE LAID OUT WITH DUE REGARD FOR THE SPACE REQUIREMENTS OF THE OTHER CONTRACTORS. THIS CONTRACTOR SHALL REPORT ANY CONFLICTS OR DIFFICULTIES IN REGARD TO THE INSTALLATION IMMEDIATELY.

WHERE CROWDED LOCATIONS EXIST OR WHERE THERE IS A POSSIBILITY OF CONFLICT BETWEEN TRADES, THIS CONTRACTOR SHALL MAKE COMPOSITE DRAWINGS SHOWING THE EXACT LOCATIONS OF PIPES, DUCT, CONDUIT AND EQUIPMENT. DRAWINGS SHALL BE BASED ON FIELD MEASUREMENTS AND AFTER CONSULTATION AND AGREEMENT BETWEEN THE TRADES.

EQUIPMENT OF A TYPE TO REQUIRE REPLACEMENT, SERVICING, ADJUSTING OR MAINTENANCE SHALL BE LOCATED TO ALLOW EASY ACCESS AND SPACE FOR REMOVAL OF INTERNAL ASSEMBLIES, IT REQUIRED.

#### 8. EXCAVATION AND BACKFILL

THIS CONTRACTOR SHALL DO ALL EXCAVATION REQUIRED TO INSTALL PIPES AND EQUIPMENT SHOWN ON THE PLANS OR REQUIRED FOR PROPER OPERATION. EXCESS EXCAVATION BELOW THE REQUIRED LEVEL SHALL BE BACKFILLED WITH EARTH AND THOROUGHLY TAMPED. UTILITIES SERVICES LINES SHALL BE INSPECTED AND APPROVED BY THE PROPER INSPECTION AUTHORITY BEFORE BACKFILLING.

THE BOTTOM OF TRENCHES SHALL BE TAMPED HARD AN GRADED TO SECURE THE REQUIRED FALL. ROCK, WHERE ENCOUNTERED SHALL BE EXCAVATED TO A DEPTH OF SIX INCHES (6") BELOW THE BOTTOM OF THE PIPE, AND BEFORE THE PIPE IS LAID, THE SPACE BETWEEN BOTTOM PIPE AND ROCK SURFACE SHALL BE FILLED WITH GRAVEL. IF TRENCHES ARE DEEPER THAN BOTTOM OF FLOORING OR CLOSER THAN THREE FEET (3'0") TO FOOTING THEY MUST BE FILLED WITH COHESIVE SOIL AND COMPACTED TO 95% OF MAXIMUM DENSITY, STANDARD PROCTOR, ASTM D- 698. ALL OTHER EXCAVATIONS UNDER FLOOR SLABS COMPACTED TO 95% STANDARD PROCTOR.

WHEN EXCESS DIRT HAS BEEN REMOVED, THE TRENCH SHALL BE BROUGHT TO THE REQUIRED LEVEL WITH SAND AND GRAVEL FIRMLY COMPACTED.

TRENCHES AND EXCAVATION SHALL BE BACKFILLED IN 6" LAYERS OF EARTH, FREE FROM CLODS, AND STONES THOROUGHLY TAMPED TO A DEPTH OF 12" ABOVE THE PIPE. AFTER THAT DEPTH HAS BEEN REACHED, BACKFILLING SHALL BE DONE IN 12" LAYERS, THOROUGHLY TAMPED.

#### 9. EQUIPMENT SUPPORTS

ANY STRUCTURAL STEEL MEMBERS REQUIRED TO ADAPT THE EQUIPMENT AND PIPING AS FURNISHED BY THIS CONTRACTOR, TO THE BUILDING STEEL OR STRUCTURE, SHALL BE INCLUDED IN THE BID OF THE CONTRACTOR FURNISHING THE EQUIPMENT OR PIPING. HANGING OF ALL EQUIPMENT AND REQUIRED SUPPORTING STEEL AND BRACING SHALL BE FURNISHED BY THE CONTRACTOR WHO SUPPLIES THE EQUIPMENT.

THIS CONTRACTOR SHALL INCLUDE ALL CUTTING, PATCHING AND PAINTING OF PATCHED AREAS REQUIRED FOR AND RESULTING FROM THE INSTALLATION OF ALL OF THIS CONTRACTOR'S WORK, EXCEPT WHERE NOTED OTHERWISE.

ALL OPENINGS AROUND PIPE PENETRATIONS THROUGH SMOKE OR FIRE-RATED FLOORS, CEILINGS OR WALLS SHALL BE SEALED AIRTIGHT WITH MATERIAL HAVING A RATING EQUAL TO THE MATERIAL OF THE WALL, CEILING AND/OR FLOOR PENETRATED.

ALL PATCHING SHALL BE NEATLY FINISHED TO THE SATISFACTION OF THE ARCHITECT.

THIS CONTRACTOR SHALL LOCATE AND FURNISH FOR INSTALLATION BY THE GENERAL CONTRACTOR, ALL ACCESS PANELS AS REQUIRED FOR ACCESS TO VALVES, AND THE PROPER SERVICING OF EQUIPMENT AND LINES INSTALLED UNDER THE CONTRACT.

ALL PANELS SHALL BE MILCOR, STYLE "M" FOR MASONRY, "A" FOR ACOUSTICAL TILE AND "K" FOR PLASTER; EXCEPT FOR FIRE-RATED UL 1-1/2 HOUR AND "B" LABEL ACCESS PANELS SHALL BE FURNISHED IN FIRE-RATED WALLS AND CEILINGS AS INDICATED ON THE DRAWINGS. ACCESS DOORS SHALL BE 12" X 12" MINIMUM SIZE FOR VALVES.

FOR THE PREVENTION OF ELECTROLYTIC CORROSION AT CONNECTIONS BETWEEN PIPE OF DISSIMILAR METALS OR BETWEEN PIPE AND EQUIPMENT CONNECTIONS OF DISSIMILAR METALS, PROVIDE DIELECTRIC UNIONS OR FLANGES.

#### 13. MOTORS, STARTERS AND DISCONNECTS

UNLESS SPECIFIED TO BE FURNISHED WITH EQUIPMENT, ALL MOTOR STARTERS AND DISCONNECT SWITCHES SHALL BE FURNISHED AND INSTALLED BY THE ELECTRICAL CONTRACTOR.

#### 14. JOINTS AND FITTINGS

THREADS ON SCREWED PIPE SHALL BE STANDARD, CLEAN BUTT AND TAPERED. PIPE SHALL BE REAMED OF BURRS AND KEPT CLEAN OF SCALE, DIRT AND SHAVINGS. TREADS SHALL BE MADE WITH FLAKED GRAPHITE AND LUBRICATING OIL OR APPROVED PIPE COMPOUND ON THE MALE THREAD ONLY.

COPPER-TO-STEEL AND COPPER-TO-BRASS JOINTS SHALL BE MADE WITH SILVER SOLDER. ALL OTHER COPPER-TO-COPPER JOINTS ABOVE GROUND SHALL BE MADE WITH LEAD FREE SOLDER. COPPER PIPE SHALL BE CUT SQUARE, BURRS REMOVED AND CARE SHALL BE GIVEN TO KEEP THE LINES FREE OF DIRT AND MOISTURE. ALL TUBING AND FITTINGS SHALL BE THOROUGHLY CLEANED.

WELDED PIPE SHALL HAVE BUTT WELDED SINGLE "V" TYPE JOINTS FOR WHICH PIPE HAS BEEN BEVELED TO 45 DEGREES. WELD SHALL BE ONE-FOURTH GREATER THICKNESS THAN THE PIPE. CONNECTIONS TO EQUIPMENT, ACCESSORIES, ETC. SHALL BE MADE BY MEANS OF FLANGES AND/OR ADAPTERS.

UNIONS SHALL BE PROVIDED AT EACH SCREWED VALVE AND UNIONS OR FLANGES AT EACH EQUIPMENT CONNECTION.

FURNISH AND INSTALL FLEXONICS EXPANSION JOINTS IN PIPING SYSTEM WHERE SHOWN OR NECESSARY FOR EXPANSION AND CONTRACTION.

EXPANSION JOINTS IN PIPE 4" AND GREATER SHALL BE THE PACKLESS TYPE WITH STAINLESS STEEL BELLOWS AND HAVE WELDED OR FLANGED END. JOINTS SHALL HAVE TRAVERSE AS INDICATED ON THE PLANS. EXPANSION JOINTS SHALL BE OF THE CONTROLLED FLEXING TYPE.

EXPANSION JOINTS IN COPPER PIPE UNDER 4" IN SIZE SHALL BE OF THE COMPENSATOR TYPE CONSTRUCTED OF TWO-PLY STAINLESS STEEL BELLOWS AND CARBON STEEL SHROUDS AND END FITTINGS, INTERNAL GUIDES AND ANTI-TORQUE DEVICES.

EXPANSION JOINTS IN STEEL PIPE UNDER 4" IN SIZE SHALL BE OF THE COMPENSATOR TYPE CONSTRUCTED OF TWO-PLY STAINLESS STEEL ELBOWS AND CARBON STEEL SHROUDS AND END FITTINGS, INTERNAL GUIDES AND ANTI-TORQUE DEVICES.

PROVIDE GUIDES ON EACH SIDE OF EXPANSION JOINT, AT 4 PIPE DIAMETERS, 14 PIPE DIAMETERS, AND A THIRD GUIDE AS RECOMMENDED BY THE MANUFACTURER.

#### 16. PIPE FLEXIBLE CONNECTIONS

FLEXIBLE PIPE CONNECTIONS SHALL BE RESISTOFLEX #R6904 OR APPROVED EQUAL FLEXIBLE CONNECTIONS MADE FROM TEFLON.

PROVIDE FOR MOVEMENT IN PIPING BY USE OF SWING JOINTS AT CONNECTION OF ALL BRANCHES TO MAINS AND RISERS. ALL BRANCHES FROM MAINS AND RISERS SHALL HAVE 1/4" CLEARANCE BETWEEN PIPE INSULATION AND SLEEVE TO PERMIT PIPE MOVEMENT.

#### 17. VALVES

THIS CONTRACTOR SHALL FURNISH AND INSTALL ALL VALVES OF ONE MANUFACTURER, FIGURE NUMBER AND TYPE THROUGHOUT THE ENTIRE INSTALLATION OF THE WORK, UNLESS OTHERWISE SPECIFIED. THE FOLLOWING NUMBERS ARE FROM THE CRANE CATALOG. EQUAL VALVES OF REPUTABLE MANUFACTURERS, SUCH AS HAMMOND, NIBCO-SCOTT AND/OR JENKINS WILL BE CONSIDERED EQUIVALENT.

ALL VALVES SHALL BE BUILT FOR A MINIMUM OF 125 PSIG WORKING PRESSURE. GATE VALVES 2-1/2" AND SMALLER SHALL BE #438 (SCREWED ENDS) OR #1320 (SOLDER-JOINT ENDS) WITH BRONZE BODY, BRONZE TRIM AND RISING STEM.

CHECK VALVES 2-1/2" AND SMALLER SHALL BE #36 (SCREWED ENDS) OR #1342 (SOLDER-JOINT ENDS) SWING-TYPE WITH BRONZE BODY AND BRONZE TRIM.

BUTTERFLY VALVES 2" AND LARGER SHALL BE #12F, IRON BODY, CAST-IRON WAFER W/LOCK LEVER.

BALL VALVE UP TO 3" IN SIZE SHALL BE APOLLO SERIES #70 BRONZE VALVE WITH CHROME-PLATED BALL AND TEFLON SEAT.

#### GAS LINE COCKS UP TO 4" SHALL BE #320.

HOSE END VALVES SHALL BE #438 GATE VALVES WITH HOSE END NIPPLES.

#### 18. PIPE SLEEVES AND COLLARS

THIS CONTRACTOR SHALL LAY OUT ALL HIS WORK AND SET SLEEVES IN NEW CONSTRUCTION AS CONCRETE FORMS AND WALL ARE ERECTED SO AS TO BE ABLE TO INSTALL HIS WORK WITHOUT CUTTING OR BREAKING OF FLOORS OR WALLS. ALL SLEEVES FOR INSULATED PIPING SHALL BE LARGE ENOUGH TO ALLOW INSULATION TO PASS THROUGH SLEEVE.

ALL SLEEVES PASSING THROUGH FLOORS WHICH ARE WATERPROOFED SHALL BE COPPER TUBING SLEEVES EXTENDING 1" ABOVE FINISHED FLOOR, ALL OTHER SLEEVES SHALL BE 24 GAUGE GALVANIZED PIPES AND SLEEVES TO BE THOROUGHLY PACKED WITH OAKUM AND THE REMAINING SPACE FILLED WITH MASTIC AND MUST BE

ALL SLEEVES PASSING THROUGH INNER WALLS SHALL BE STANDARD PIPE THIMBLES EQUAL TO THE THICKNESS OF THE WALL.

SPACES BETWEEN PIPES AND SLEEVES THROUGH OUTSIDE WALLS, ABOVE GRADE, SHALL BE CAULKED WITH CAULKING COMPOUND; THOSE BELOW GRADE SHALL BE MADE WATERTIGHT.

SPACE AROUND ALL PIPING THROUGH FIRE OR SMOKE RATED PARTITIONS OR FLOORS

ALL PIPE PENETRATIONS OF SLABS ON GRADE SHALL BE WRAPPED WITH #15 BUILDING FELTS OR FOAM WRAP.

A. PIPE HANGER AND SUPPORT PRODUCTS INSTALLATION

- a. VERTICAL PIPING: MSS TYPE 8 OR 42 CLAMPS. INDIVIDUAL, STRAIGHT, HORIZONTAL PIPING RUNS: 100 FEET AND LESS: MSS TYPE 1, ADJUSTABLE, STEEL CLEVIS HANGERS. LONGER THAN 100 FEET: MSS TYPE 43, ADJUSTABLE ROLLER HANGERS. LONGER THAN 100 FEET IF INDICATED: MSS TYPE 49, SPRING CUSHION
- ROLLS. c. MULTIPLE, STRAIGHT, HORIZONTAL PIPING RUNS 100 FEET OR LONGER:MSS TYPE 44, PIPE ROLLS. SUPPORT PIPE ROLLS ON TRAPEZE.
- d. BASE OF VERTICAL PIPING: MSS TYPE 52, SPRING HANGERS.
- B. SUPPORT VERTICAL PIPING AND TUBING AT BASE AND AT EACH FLOOR. C. ROD DIAMETER MAY BE REDUCED ONE SIZE FOR DOUBLE-ROD HANGERS, TO A MINIMUM OF 3/8 INCH D. INSTALL HANGERS FOR COPPER TUBING WITH THE FOLLOWING MAXIMUM
- HORIZONTAL SPACING AND MINIMUM ROD DIAMETERS: a. NPS 3/4 AND SMALLER: 60 INCHES WITH 3/8-INCH ROD.
- b. NPS 1 AND NPS 1-1/4: 72 INCHES WITH 3/8-INCH ROD. c. NPS 1-1/2 AND NPS 2: 96 INCHES WITH 3/8-INCH ROD.
- d. NPS 2-1/2: 108 INCHES WITH 1/2-INCH ROD. e. NPS 3 TO NPS 5: 10 FEET WITH 1/2-INCH ROD.
- E. INSTALL SUPPORTS FOR VERTICAL COPPER TUBING EVERY 10 FEET. F. INSTALL HANGERS FOR STEEL PIPING WITH THE FOLLOWING MAXIMUM HORIZONTAL SPACING AND MINIMUM ROD DIAMETERS:
- a. NPS 1-1/4 AND SMALLER: 84 INCHES WITH 3/8-INCH ROD. b. NPS 1-1/2: 108 INCHES WITH 3/8-INCH ROD.
- c. NPS 2: 10 FEET WITH 3/8-INCH ROD. d. NPS 2-1/2: 11 FEET WITH 1/2-INCH ROD.
- e. NPS 3 AND NPS 3-1/2: 12 FEET WITH 1/2-INCH ROD. f. NPS 4 AND NPS 5: 12 FEET WITH 5/8-INCH ROD.
- G. INSTALL SUPPORTS FOR VERTICAL STEEL PIPING EVERY 15 FEET. H. SUPPORT PIPING AND TUBING NOT LISTED IN THIS ARTICLE ACCORDING TO MSS SP-69 AND MANUFACTURER'S WRITTEN INSTRUCTIONS.

THIS CONTRACTOR SHALL BE RESPONSIBLE FOR DAMAGES TO THE GROUNDS, WALKS, ROADS, ALL BUILDING COMPONENTS AND FINISHES, PIPING SYSTEMS, ELECTRICAL SYSTEMS AND THEIR EQUIPMENT AND CONTENT, CAUSED BY LEAKS IN THE PIPING SYSTEMS BEING INSTALLED OR HAVING BEEN INSTALLED HEREIN. ALL REPAIRS WILL BE MADE AT THIS CONTRACTOR'S EXPENSE.

FURNISH AND INSTALL BRADY #B-350 THIN FILM OR APPROVED EQUAL PIPE MARKERS MARKERS SHALL BE 1-1/8" HIGH FOR PIPES 3" AND UNDER AND 2-1/4" HIGH FOR PIPES OVER 3". MARKERS SHALL INDICATE TYPE OF SERVICE AND DIRECTION OF FLOW.

PIPE MARKERS SHALL BE LOCATED:

• AT EQUIPMENT CONNECTIONS AT ACCESS DOORS

 AT BRANCH MAINS • ON ALL ACCESSIBLE PIPE A MAXIMUM OF 75' BETWEEN MARKERS.

#### 22. FLOOR, WALL AND CEILING PLATES

PIPES PASSING THROUGH FLOORS AND FINISHED CEILINGS, FITTED WITH CHROME-PLATED PLATES OR ESCUTCHEONS LARGE ENOUGH TO COMPLETELY CLOSE OPENING AROUND PIPE OR PIPE COVERING AND FLOOR SUPPORT IN THE CASE OF VERTICAL PIPING, SECURELY HELD IN PLACE; CAULK WATERTIGHT AROUND PIPE IN UNFINISHED

THE PENETRATIONS OF FIRE AND/OR SMOKE RATED WALLS OR FLOORS SHALL BE PROTECTED BY A UL APPROVED MATERIAL TO RETAIN THE INTEGRITY OF THE TIME-RATED CONSTRUCTION BY MAINTAINING AS EFFECTIVE BARRIER AGAINST THE SPREAD OF FLAME, SMOKE AND GASES. IT SHALL BE USED IN ALL DUCT CABLE, CONDUIT AND PIPING PENETRATIONS THROUGH FLOOR SLABS AND TIME-RATED WALLS, AND/OR FLOORS. THE RATING OF THE FIRESTOPPING SHALL EQUAL THE RATING OF THE TIME-RATED ASSEMBLY.

FIRESTOPPING MATERIAL SHALL BE 3M FIRE BARRIER SEALING SYSTEM OF APPROVED EQUAL. FIRESTOPPING MATERIAL SHALL CONSTITUTE ONE OR MORE OF THE FOLLOWING PRODUCTS:

• CAULK: CP-25

• PUTTY: #303

• WRAP/STRIP: FS195 • COMPOSITE SHEET: CS195

• PENETRATING SEALING SYSTEMS: 7900 SERIES INSTALLATION OF FIRESTOPPING SHALL BE INSTALLED IN ACCORDANCE WITH AND IN STRICT CONFORMITY WITH MANUFACTURER'S PRINTED INSTRUCTIONS AS TO SURFACE PREPARATION, INSTALLATION AND QUALITY CONTROL. AREAS OF WORK SHALL REMAIN ACCESSIBLE UNTIL INSPECTION AND APPROVAL BY THE APPLICABLE

CODE AUTHORITIES. ON INSULATED PIPES, THE FIRE-RATING CLASSIFICATION SHALL NOT REQUIRE

#### REMOVAL OF THE INSULATION.

QUALITY ASSURANCE: SUBMIT MANUFACTURER'S PRODUCT DATA, LETTER OF CERTIFICATION OR CERTIFIED LABORATORY TEST REPORT THAT THE MATERIAL OR COMBINATION OF MATERIALS MEET THE REQUIREMENTS SPECIFIED IN ASTM E814 AND ARE SO CLASSIFIED IN UL'S BUILDING MATERIALS DIRECTORY. MATERIALS SHALL MEET AND BE ACCEPTABLE FOR USE BY ALL MODEL BUILDING CODES. MATERIALS SHALL MEET THE REQUIREMENTS OF NFPME61- LIFE SAFETY CODE

SUBMITTALS: SUBMIT SHOP DRAWINGS, PRODUCT DATA, CERTIFICATES AND MANUFACTURER'S INSTALLATION INSTRUCTIONS. SUBMIT MANUFACTURER'S PRODUCT DATA FOR ALL MATERIALS AND PREFABRICATED DEVICES, PROVIDING DESCRIPTIONS SUFFICIENT FOR IDENTIFICATION AT THE JOB SITE. INCLUDE MANUFACTURER'S INSTRUCTIONS FOR INSTALLATION.

SUBMIT SHOP DRAWINGS SHOWING PROPOSED MATERIAL, REINFORCEMENT. ANCHORAGE, FASTENINGS, AND METHOD OF INSTALLATION. CONSTRUCTION DETAILS SHALL ACCURATELY REFLECT ACTUAL JOB CONDITIONS.

#### 24. CLEANUP AND ADJUSTMENT

ALL PARTS WORK LEFT CLEAN: EQUIPMENT, FIXTURES, VALVES, PIPES AND FITTINGS CLEANED OF GREASE AND METAL CUTTINGS. ANY DISCOLORATION OR OTHER DAMAGE TO PORTIONS OF BUILDING, ITS FINISH OR FURNISHING DUE TO THIS CONTRACTORS FAILURE TO PROPERLY CLEAN INTERIOR OF PIPING, REPAIRED AT THIS CONTRACTOR'S EXPENSE. ALL AUTOMATIC CONTROL DEVICES ADJUSTED FOR PROPER OPERATION. ALL SURPLUS MATERIALS AND ANY RUBBISH REMOVED AS IT ACCUMULATES. ALL EQUIPMENT LEFT IN SAFE, PROPER OPERATING CONDITION.

DAMAGE TO ANY PORTIONS MUST BE REPAIRED OF THE PART REPLACED BY THIS CONTRACTOR AND ALL PARTS LEFT WITHOUT DENTS, SCRATCHES, THROUGH THE FINISH PAINT, LOOSE PLASTER, STAINS OR OTHER BLEMISHES.

#### 25. PIPE TESTING AND START-UP

ALL PIPING TO BE TESTED IN ACCORDANCE WITH THE FOLLOWING:

• WATER - 100 PSI WATER PRESSURE ALL TESTING MUST HOLD FOR AT LEAST 24 HOURS WITHOUT LOSS OF PRESSURE OR VACUUM. ALL CONCEALED PIPING SHALL BE TESTED IN THE PRESENCE OF THE OWNER'S REPRESENTATIVE PRIOR TO COVERING. BEFORE STARTING ANY SYSTEM, ALL MECHANICAL AND ELECTRICAL EQUIPMENT SHALL BE LUBRICATED BY THIS CONTRACTOR, TEST ENTIRE PLANT FOR HEATING, VENTILATING, AND AIR CONDITIONING UNDER FULL LOAD CONDITIONS FOR A PERIOD OF NOT LESS THAT ONE (1) WEEK DURING WHICH TIME THE AARON BROTHERS OPERATING PERSONNEL SHALL

#### 26. TESTING AND BALANCING

THIS CONTRACTOR SHALL AT THE TIME OF INSTALLATION ENSURE THAT ALL DEVICES TO COMPLETE TESTING AND BALANCING AS DIRECTED HEREIN ARE FURNISHED AND INSTALLED DURING FABRICATION AND INSTALLATION OF WORK.

#### 27. SEISMIC RESTRAINTS ON MECHANICAL EQUIPMENT

ALL PLUMBING EQUIPMENT SHALL BE PROVIDED WITH SEISMIC RESTRAINING SERVICES AS REQUIRED BY LOCAL BUILDING CODES. CONTRACTOR SHALL HAVE LOCAL BUILDING OFFICE REVIEW EACH PIECE OF EQUIPMENT WHEN INSTALLED AND THE CONTRACTOR SHALL INSTALL ALL REQUIRED TIE DOWN, ANCHORS, STRAPS OR OTHER DEVICES REQUIRED.

THIS CONTRACTOR SHALL GUARANTEE ALL EQUIPMENT, MATERIALS, AND LABOR FURNISHED UNDER THIS CONTRACT TO BE FREE FROM DEFECTS FOR A PERIOD OF ONE (1) YEAR FROM THE DATE OF SUBSTANTIAL COMPLETION AND SHALL REPAIR OR REPLACE ANY EQUIPMENT OR MATERIAL WHICH IS DEFECTIVE OR IMPROPERLY INSTALL FD. IN ADDITION, THIS CONTRACTOR SHALL ASSUME FULL RESPONSIBILITY FOR ANY DAMAGE TO THE BUILDINGS AND ITS CONTENTS OR OTHER EQUIPMENT, CAUSED BY DEFECTS OR IMPROPER INSTALLATION OF EQUIPMENT OR MATERIALS INSTALLED UNDER THIS SECTION OF THE SPECIFICATIONS.

#### 29. TEMPORARY WATER

TEMPORARY WATER SERVICE TO THE BUILDING SHALL BE PROVIDED BY THIS CONTRACTOR TO THE BUILDING FOR CONSTRUCTION PURPOSES. THIS CONTRACTOR TO MAINTAIN WATER SERVICE AS REQUIRED DURING CONSTRUCTION.

#### 30. DOMESTIC WATER SERVICE

PROVIDE PRESSURE REDUCING VALVE WITH STRAINER IN SERVICE LINE IF REQUIRED BY LOCAL CODES OR PRESSURE IS ABOVE 80 PSI.

JOINTS SHALL BE CLEANED AND DEBURRED AS RECOMMENDED BY THE MANUFACTURER AND FEDERAL, STATE, AND LOCAL CODES AND SOLDERED AS LISTED BELOW. FLUX SHALL BE NON-CORROSIVE.

ABOVE GRADE - WHERE FITTINGS ARE SOLDERED BOTH FITTINGS AND TUBING SHALL BE CLEANED AS DESCRIBED ABOVE. UNDER NO CIRCUMSTANCES SHALL DISSIMILAR METALS COME INTO DIRECT CONTACT WITH COPPER TUBING; E.G., GALVANIZED STRAPPING, HANGERS, OR CLAMPS TO SECURE THE TUBING.

BELOW GRADE, OR FLOOR SLAB ON EARTH OR STONE FILL - HIGH TEMPERATURE, SOLDER, 1200 DEG. F OR GREATER MELTING POINT.

NOTE: WATER PIPE TO BE PROPERLY SECURED AND ALIGNED SO AS NOT TO EXERT VERTICAL OR HORIZONTAL STRESSES ON THE SEATING OF THE MATING (MALE AND FEMALE) SURFACES OF THE UNIONS. MATERIALS - UNDERGROUND: TYPE "K" COPPER TUBE, SOFT TEMPE MATERIALS - ABOVEGROUND: TYPE "L" COPPER TUBE, HARD DRAWN. ALTERNATE MATERIALS - CPVC AND OR PEX PIPING IS AN ACCEPTABLE ALTERNATE IF NOT INSTALLED IN A PLENUM AND APPROVED BY LOCAL CODE OFFICIALS. VIEGA. PROPRESS COPPER ½-INCH THROUGH 4-INCH WITH EPDM SEALING ELEMENT

#### 31. STERILIZATION OF DOMESTIC WATER SYSTEM

THE ENTIRE DOMESTIC WATER DISTRIBUTION SYSTEM SHALL BE THOROUGHLY STERILIZED WITH A SOLUTION CONTAINING NOT LESS THAN 100 PARTS PER MILLION OF AVAILABLE CHLORINE. THE SOLUTION SHALL REMAIN IN THE SYSTEM FOR TWO (2) HOURS DURING WHICH TIME ALL VALVES AND FAUCETS SHALL BE OPENED AND CLOSED SEVERAL TIMES. AFTER STERILIZATION, THE SOLUTION SHALL BE FLUSHED FROM THE SYSTEM WITH CLEAN WATER UNTIL THE RESIDUE CHLORINE CONTENT IS NOT GREATER THAN THE CHLORINE LEVEL OF THE AVAILABLE WATER SUPPLY.

AND/OR VIEGA, PROPRESS 304 OR 316 STAINLESS 1/2-INCH THROUGH 4-INCH WITH

EPDM OR FKM SEALING ELEMENT IS ACCEPTABLE IF ALLOWED BY LOCAL CODE

THIS CONTRACTOR SHALL HAVE THE WATER TESTED AND APPROVED BY THE HEALTH DEPARTMENT.

THIS CONTRACTOR SHALL CONNECT SANITARY SEWER AS INDICATED ON THE DRAWINGS. VERIFY DIRECTION OF FLOW PRIOR TO ANY ROUGH-IN WORK.

EACH PIPE SHALL BE LAID TO THE LINE AND GRADE INDICATED ON THE PLANS AND SUCH A MANNER AS TO FORM A CLOSE CONCENTRIC JOINT WITH THE ADJOINING PIPE AND TO PRESENT OFFSETS IN FLOW LINE. ALL PIPE SHALL BE LAID WITH THE BELLS

THE SUB-GRADES SHALL BE KEPT FREE FROM WATER WHILE PIPES ARE BEING LAID. ALL PIPE SHALL BE LAID WITH ENDS ABUTTING AND TRUE TO LINE AND GRADE. THEY SHALL BE FITTED AND MATCHED SO THAT THEY WILL FORM A SEWER WITH A SMOOTH AND UNIFORM INVERT.

EACH JOINT SHALL BE CLEANED AS IT IS LAID AND ALL BELLS SHALL BE CLEANED BEFORE PIPES ARE JOINED.

PVC SEWER PIPE MAY BE USED IN LIEU OF THAT SPECIFIED ABOVE IF ALLOWED BY

#### LOCAL CODES. 33. WASTE, SOIL, DRAIN AND VENT PIPING

DEFECTS.

THE DRAINS, SOIL WASTE AND VENT PIPE AND FITTINGS INCLUDING EXTENSIONS TO SEWERS SHALL BE OF SAND SPUN SERVICE WEIGHT CAST IRON PIPE OF THE SIZES INDICATED ON THE DRAWINGS. PIPE AND FITTINGS TO BE COATED ON THE INSIDE AND OUTSIDE WITH COAL TAR PITCH, CYLINDRICAL AND FREE FROM CRACKS OR OTHER

ALL TRENCHES TO BE DUG WITH GRADUAL FALL, THE PIPING TO BE STRAIGHT AND THOROUGHLY YARNED WITH OAKUM AND POURED WITH MOLTEN LEAD AND THOROUGHLY CAULKED WITH CAULKING IRONS.

THE ARRANGEMENT OF THE SYSTEM SHALL BE AS SHOWN ON THE DRAWINGS AND AS DIRECT AS POSSIBLE, AVOIDING ALL UNNECESSARY OFFSETS. THE STACKS SHALL BE FIRMLY SECURED IN POSITION WITH WROUGHT IRON CLAMPS AT EACH FLOOR. ALL CHANGES IN DIRECTION OF SOIL OR WASTE PIPE SHALL BE MADE BY MEANS OF "Y"

BRANCHES AND 1/8 BENDS. NINETY DEGREE SHORT TURN FITTINGS WILL NOT BE

FROM THE HORIZONTAL TO THE VERTICAL. HANDHOLES WITH CAST IRON FERRULES AND HEAVY BRASS SCREWS FOR CLEANOUTS SHALL BE PLACED AT ENDS AND ALL CHANGES IN DIRECTION OF SOIL AND WASTE PIPE WHERE NOT OTHERWISE SHOWN OR WHERE REQUIRED AND BROUGHT UP TO THE

FLOOR LINE WHERE PIPING IS CONCEALED BY MEANS OF "Y"S OR SUITABLE BENDS.

PERMITTED EXCEPT TO INDIVIDUAL FIXTURE CONNECTIONS OR WHERE THE FLOW IS

ALL TRAP SCREWS MUST BE OF FULL SIZE OF PIPE UP TO 4" AND 4" FOR ALL OVER THIS SIZE. CONNECTIONS BETWEEN OUTLETS OF FIXTURES AND SOIL OR WASTE PIPE SHALL BE MADE WITH "Y" BRANCHES TO "TY" BRANCHES WHEREVER POSSIBLE. ALL HORIZONTAL SOIL WASTE AND VENT PIPE SHALL BE GRADED TOWARD OUTLETS AND PIPE NOT BURIED SHALL BE INSTALLED ABOVE THE CEILING OR CLOSE AS POSSIBLE TO THE CONSTRUCTION ABOVE WHERE THERE IS NO CEILING.

THE STACKS SHALL BE EXTENDED THROUGH ROOF OF BUILDING TO POINTS NOT LESS THAT 12" ABOVE ROOF. EXTENSIONS THROUGH ROOF SHALL BE MADE WATER-TIGHT BY MEANS OF A LEAD FLASHING OF FOUR POINTS SHEET LEAD SPREAD OVER A DISTANCE OF NOT LESS THAN TWELVE INCHES (12") AROUND PIPE. THIMBLE TO BE SOLDERED TO BASE AND EXTENDED OVER AND TURNED DOWN INTO END OF PIPE IN AN APPROVED MANNER.

ALL CLEANOUTS IN FLOORS TO BE JOSAM #8360 OR AMERICAN FOUNDRY #427 ADJUSTABLE CLEANOUT WITH CAST IRON BODY, CAST BRASS SCORIATED COVER WITH LETTERS C.O. CAST IN TOP AND CONCEALED BRASS PLUG.

CLEANOUTS SHALL BE INSTALLED IN BASE OF EACH STACK. CONCEALED CLEANOUTS

SHALL HAVE JOSAM #8600 OR AMERICAN FOUNDRY #71-F CAST BRASS CHROMIUM

FERRULES SHALL BE EXTRA HEAVY RED BRASS, EXTRA LONG AND SMOOTH ON THE INSIDE. FOR WASTE, SOIL AND VENT CONNECTION THE LEAD SHALL EXTEND THROUGH THE FERRULES. BE TURNED BACK. WIPED WITH SOLDER AND CAULKED INTO THE HUB.

PLATED FLAT ACCESS COVER PLATES.

ALL JOINTS OF CAST IRON PIPE SHALL BE MADE WITH JUTE AND PURE SOFT LEAD BEDDED IN WITH HAMMER AND CAULKING IRON, USING FOR EACH JOINT TWELVE OUNCES OF LEAD TO EACH INCH OF DIAMETER OF PIPE ON WHICH THE JOINT IS MADE. ALL JOINTS SHALL BE FILLED AT ONE POURING, IF IT FAILS TO RUN FULL IT SHALL BE DUG OUT AND RE-POURED AND CAULKED WITH PROPER TOOLS. JOINTS BETWEEN LEAD AND CAST IRON SHALL BE MADE WITH BRASS FERRULES, WIPED TO THE LEAD PIPE AND CAULKED INTO THE HUB OF THE CAST IRON FITTINGS. AT THE

AT THE CONTRACTOR'S OPTION, DWV COPPER PIPING AND FITTINGS MAY BE USED IF APPROVED BY LOCAL CODES AND ORDINANCES.

IN LIEU OF LEAD JOINTS IF APPROVED BY THE LOCAL CODES AND ORDINANCES.

CONTRACTOR'S OPTION HE MAY USE NO-HUB PIPE, FITTINGS, COUPLING AND GASKETS

IF APPROVED BY THE LOCAL CODES, SCHEDULE 40 PVC PIPE WITH DWV FITTINGS MAY BE USED FOR THE WASTE AND VENT SYSTEM. PVC PIPE AND FITTINGS SHALL BE INSTALLED IN STRICT ACCORDANCE WITH ALL CODES. ENCASEMENT OF PVC PIPES WITHIN RATED SHAFTS SHALL BE THE COST OF THIS CONTRACTOR.

EACH VENT FLASHING SHALL BE MADE WATER-TIGHT WITH THE ROOF BY PROPER LEAD FLASHING. FLASHING SHALL BE LEAD FOUR (4) POUNDS PER SQUARE FOOT.

THE MINIMUM SIZE OF WASTE, VENT, AND WATER CONNECTION TO THE INDIVIDUAL

35. WASTE, VENT AND WATER CONNECTIONS

FIXTURES SHALL BE AS FOLLOWS:

WATER CLOSETS LAVATORIES 1-1/2" 1-1/2" 1-1/2" 1-1/2" 1/2" 1/2" WALL HYDRANTS

WHERE FIXTURES ARE GROUPED PIPES SHALL BE INCREASED IN PROPORTION: IN ALL CASES THE SIZE ARRANGEMENTS AND CONNECTIONS OF WATER AND VENT PIPING SHALL NOT BE LESS THAN SIZE OF OPENINGS SPECIFIED FOR FIXTURES AND APPEARING IN FIXTURE LIST. NO WATER PIPE LESS THAN 1/2" SHALL BE INSTALLED IN CONCEALED PLACES SUCH AS IN PARTITIONS OR WALLS ETC.

#### 36. PLUMBING FIXTURES AND TRIM

PLUMBING FIXTURES SHALL BE FURNISHED AND INSTALLED IN A NEAT AND WORKMANLIKE MANNER WITH PROPER CONNECTIONS TO SUPPLY AND DRAINAGE PIPING. ALL FIXTURES SHALL BE FREE OF FLAWS AND DEFECTS OF ANY SORT IN MATERIAL AND WORKMANSHIP AND SHALL OPERATE PERFECTLY WHEN INSTALLED IN ACCORDANCE WITH MANUFACTURER'S DIRECTION.

MATERIALS: FIXTURES SHALL BE THE STANDARD PRODUCT OF ONE OF THE MANUFACTURER'S LISTED BELOW, OR ANY EQUAL UNIT APPROVED BY THE ENGINEER.

ZURN, KOHLER, CRANE, AMERICAN STANDARD, ELJER, GROHE, DELTA, ELKAY

INSTALLATION: THIS CONTRACTOR SHALL BE RESPONSIBLE FOR PROTECTION OF THE PLUMBING FIXTURES AND ACCESSORIES DURING CONSTRUCTION. HE SHALL REPLACE AT HIS EXPENSE ANY MATERIAL THAT IS MARRED, SCRATCHED, DEFACED AND/OR BROKEN. FIXTURES SHALL BE COVERED WITH BUILDING PAPER AND WOODEN CRATES DURING CONSTRUCTION.

CONTRACTOR SHALL PROVIDE ROUGH-IN AND SHALL CONNECT ALL FIXTURES TO THE PLUMBING SYSTEM. ALL FIXTURES TO BE INSTALLED TO DIMENSIONS WITH CHROME-PLATED SUPPLIES WITH STOPS.

ALL FIXTURES INSTALLED TO DIMENSIONS SHOWN ON THE DRAWINGS. ALL WATER

CLOSETS SHALL HAVE CAULKING BETWEEN THE FLOOR AND UNDERSIDE OF THE WATER CLOSET.

PLUMBING EQUIPMENT: (REFER TO SCHEDULE ON THE DRAWINGS)

#### ALL INSULATION SHALL HAVE COMPOSITE (INSULATION, JACKET OR FACINGS AND ADHESIVE USED TO ADHERE THE FACING OR JACKET TO THE INSULATION) FIRE AND

AND REGULATIONS.

**EXCEEDING:** 

FLAME SPREAD 25 SMOKE DEVELOPED 50

SMOKE HAZARD RATINGS AS TESTED BY PROCEDURE ASTM E-84, NFPA 225 UL 723 NOT

ALL ACCESSORIES SUCH AS ADHESIVES, MASTICS, CEMENTS, TAPES AND CLOTH FOR FITTINGS SHALL HAVE THE SAME COMPONENTS RATINGS AS LISTED ABOVE. INSULATION SHALL BE APPLIED ON CLEAN, DRY SURFACES AND AFTER INSPECTION AND RELEASE FOR INSULATION APPLICATION. ALL INSULATION SHALL BE CONTINUOUS THROUGH WALL AND CEILING OPENINGS AND SLEEVES. INSULATION ON ALL COLD SURFACES WHERE VAPOR BARRIER JACKETS ARE USED, WILL BE APPLIED WITH A CONTINUOUS, UNBROKEN VAPOR SEAL, INCLUDING ALL FITTINGS AND VALVES. ALL INSULATION TO BE INSTALLED IN ACCORDANCE WITH MANUFACTURER'S. FITTINGS

DOMESTIC COLD WATER - 1" THICK ARMAFLEX (FLAME SPREAD 25/ SMOKE DEVELOPED

DOMESTIC HOT WATER - 1" THICK ARMAFLEX (FLAME SPREAD 25/ SMOKE DEVELOPED

#### ALL MATERIALS USED SHALL COMPLY WITH SECTIONS 1712 AND 1713 OF THE UBC.

INACCESSIBLE CEILING IS TO BE WELDED WITH WELDED FITTINGS.

SHALL BE FINISHED WITH 1/4" COAT OF INSULATING CEMENT AND CANVAS.

38. NATURAL GAS PIPING SYSTEM ALL PIPING FROM GAS METER TO GAS-FIRED EQUIPMENT SHALL BE FURNISHED AND INSTALLED BY THIS CONTRACTOR.

ALL GAS PIPING SHALL BE SCHEDULE 40 BLACK OR GALVANIZED STEEL WITH BLACK OR GALVANIZED WITH MALLEABLE SCREWED FITTINGS. USE TEFLON TAPE ON ALL THREADED JOINTS. FITTINGS LARGER THAN TWO INCHES (2") SHALL BE WELDED. PROVIDE UNIONS AND GAS SHUT-OFF VALVES AT EACH PIECE OF GAS FIRED EQUIPMENT OR APPLIANCE. ANY GAS PIPING CONCEALED IN CHASES AND/OR

ALL GAS PIPING TO BE IN ACCORDANCE WITH LOCAL CODES, NFPA-54, IFGC AND UPC

ALL GAS PIPING SHALL BE INSTALLED IN ACCORDANCE WITH NFPA-54, LOCAL CODES,

SYSTEM: G4 (ARIA) Project Team:


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St. Louis, MO 63026

CERTIFICATE OF AUTHORITY NO. 001498

F 636.349.1730

Description 1 PERMIT SET - TI 7/18/2022 CONSTRUCTION SET 11/09/2022

Project Number: LKA-MO-01-22 Drawn By: 07/05/2022

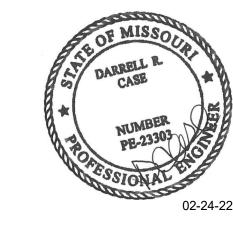SHALL BE SEALED AIRTIGHT WITH MATERIAL AS SPECIFIED UNDER FIRESTOPPING.

BE FULLY INSTRUCTED IN THE OPERATION AND MAINTENANCE OF THE PLANT. AFTER

THE PLANT IS IN FULL OPERATION, THIS CONTRACTOR IS TO FURNISH WHATEVER ADDITIONAL SERVICE IS REQUIRED TO RECALIBRATE AND RESET CONTROLS, VALVES, BALANCING COCKS, ETC. TO ENSURE PROPER OPERATION OF THIS SYSTEM.

SYSTEM: G4 (ARIA)




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No.	Description	Date
1	PERMIT SET - TI	7/18/2022
2	TI UPDATES	9/22/2022
3	CONSTRUCTION SET	11/09/2022
4	OWNER REVISION	02/03/2023
5	MEP UPDATES	05/26/2023

F 636.349.1730

**ELECTRICAL ROUGH-IN PLAN** 

Project Number: LKA-MO-01-22 Drawn By:

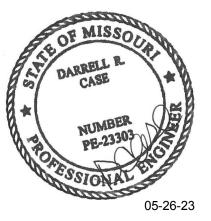07/05/2022 DPM:

SEE SHEET E601 FOR DRIVE THRU KITCHEN EQUIPMENT DIMENSIONS.

SEE SHEET E403 FOR ROUGH-IN REQUIREMENTS AT

SCHEDULE: ROUGH-IN SYMBOLS

HEAVY DUTY RECEPTACLE - VERIFY NEMA CONFIGURATION

ROUGH-IN FOR TELEPHONE VOICE LINE UNLESS NOTED OTHERWISE

ROUGH-IN FOR TELEPHONE DATA LINE OR DATACOM UNLESS NOTED OTHERWISE

SEE SHEET E202 FOR ROUGH-IN EQUIPMENT SCHEDULE

ALL EQUIPMENT MUST BE LISTED AND LABELED FOR ITS USE.

MANUFACTURER'S INSTALLATION INSTRUCTIONS SHALL BE ON-SITE AT TIME OF INSPECTION. TYPICAL PER NEC SECTION

ISOLATED GROUND DUPLEX RECEPTACLE (HUBBELL IG5392CN ORANGE

DUPLEX RECEPTACLE

G.F.I. DUPLEX RECEPTACLE

J JUNCTION BOX

DISCONNECT SWITCH

110.3 & 2012 ICC CODES.

							г							
ELE	CTRICAL ROUGH-IN MASTER S ITEM NAME	CHEDULE (	KITCH PH	1	QUIPMENT) ROUGH-IN	DEV.	-	EL MARK	ECTRICAL ROUGH-IN MASTER ITEM NAME	SCHEDULE V	(DRIVI	E-THR A	U EQUIP.) ROUGH-IN	DEV.
KD15	KDS ORDER READY	120	1	A 4	@ 70" AFF	Φ	+	(KD1)	KDS SANDWICH	120	1	4	@ 80" AFF	⊕ ⊕
cws	MONITOR  ROPE MONITOR	120	1	4	VERIFY @ 46" AFF VERIFY	Φ	-	KD2	MONITOR  KDS SALAD STN MONITOR	120	1	4	@ 90" AFF	<b>→</b>
023B N	ICE MACHINE	208**	1	10.0	96"	J	ŀ	KD3	KDS MAIN	120	1	4	@ 68"/ 90" AFF	<b>+</b>
		W	W	W	ON ROOF		+	KD4	CONSOLIDATOR MONITOR  KDS TO GO	120	1	4	VERIFY @ 68"/ 90" AFF	_ п ————————————————————————————————————
023F	ICE MACHINE - REMOTE CONDENSER ICE MACHINE	120	1	11.7	@ 72" AFF	(J)	-	KD5	CONSOLIDATOR MONITOR KDS TO GO	120	1	4	VERIFY  @ 80" AFF	— — — — — — — — — — — — — — — — — — —
(023H)	W/REMOTE CONDENSER ICE MACHINE	120	1	15.2			}	$\overline{}$	SANDWICH STN MONITOR KDS DT MASTER	120	1	4	@ 68" AFF	_ π ————————————————————————————————————
سيس	W/REMOTE CONDENSER	<del>~~~</del>	u į	w	<del></del>	سيس	3	(KD6)	CONSOLIDATOR MONITOR KDS MAIN		•			11
(025D)	WATER SOFTNER	120	1	4.3	@ 24" AFF	Ψ	-	(KD1)	CONSOLIDATOR MONITOR KDS DT ESPRESSO	120	1	4	@ 90" AFF	#
(027A)	DISHWASHER	120	1	12	@ 66" AFF	J	-	(KD12)	STN MONITOR	120	1	4	@ 68" AFF	<b>*</b>
027D H	EXHAUST HOOD	120	1	Н	VERIFY IN CASEWORK VIF/	J	-	(KD13)	KDS PANINI MONITOR  KDS DT PANINI	120	1	4	@ 80" AFF	<b>+</b>
(030)	CASH REGISTER	120	1	5	@46" AFF @ WALL	Ψ		(KD1)	MONITOR	120	1	4	@ 80" AFF	#
(030E)	KIOSK TABLET, TABLE TRACKER CHARGER	120	1	1.5	IN CASEWORK @24" AFF - VERIFY	Ф		KD15	KDS MONITOR	120	1	4	SEE PLAN	#
(030F)	CASH REGISTER	120	1	5	IN CASEWORK VIF/ @46" AFF @ WALL	Ψ		023B <sub>N</sub>	ICE MACHINE	120/208	1	10	@ 72" AFF	J
(031)	PRINTER	120	1	2	IN CASEWORK VIF/ @46" AFF @ WALL	$  \Phi  $		(023B) <sub>V</sub>	ICE MACHINE - REMOTE CONDENSER	W	W	W	ON ROOF	
(032A)	FAX MACHINE	120	1	2.16	@ 46" AFF	Ф		(030F)	CASH REGISTER	120	1	5	@ 46" AFF	φ
(035)	MGR PC & PRINTER	120	1	5	SEE MGR OFFICE DETAIL	Ф		(031)	PRINTER	120	1	2	46"/68"/90" AFF VERIFY	SEE PLAN
			~~~	~~~		~~}		042C <sub>X</sub>	CARBONATOR	120	1	3.5	@ 24" AFF	Φ
(037)	CREDIT CARD	120	1	1	IN CASEWORK VIF/	ر (سب	-	(053F)	SANDWICH PREP 72"	120	1	9	@ 24" AFF	Φ
(042C)	CARBONATOR	120	1	10.0	@46" AFF @ WALL  * FLOOR	Φ	-	(053M)	TOPPING STATION	120	1	5	@ 24" AFF	0
044.2B.2R		208	3	21	@ 85" AFF		ŀ	054 x	SODA/ICE DISPENSER	120	1	9.3	@ 24" AFF	Φ
044.2B.2R	PROOFER-REMOTE	208	1	8	ON ROOF		+	^	UNDER-COUNTER	120	1	3.9	@ 24" AFF	Φ
	CONDENSER						-	0550	REFRIGERATOR UNDER-COUNTER		•			
	RACK OVEN	208	3	4.4	@ 96" AFF		-	055CHR	REFRIGERATOR	120	1	4.7	@ 24" AFF	SEE
	OVEN CONTROLS	120	1	7.4	@ 96" AFF	J O	ļ	(055T)	SALAD CRISPER	120	1	1.7	@ 24" AFF	PLAN
(052A)	BREAD SLICER	120	1	7	@ 24" AFF	Ψ		(061) <sub>Z</sub>	ESPRESSO MACHINE	208	1	21.15	@ 24" AFF	Φ.
(053K)	CATERING PREP COOLER	120	1	9	@ 24" AFF	Ψ		(063C) Y	MICROWAVE	208	1	13.5	VERIFY	Φ
054X	SODA/ICE DISPENSER	120	1	9.3				(0640)	Z3 SOUP STATION	208	1	11	@ 24" AFF	$\Phi$
(056)	TEA BREWER	120	1	14.2	@ 24" AFF	Ψ		(075C)	Z4 CONVEYOR TOASTER	208	1	14.5	@ 24" AFF	$\Phi$
058F N	COFFEE MAKER	120/220	3	20	@ 46" AFF	<u> </u>		(076D)	SIMPLICITY BUBBLER	120	1	8.5	@ 46" AFF	Φ
							<b>{</b>	(081D)	DUAL-SIDED SALAD PREP	120	1	9	@ 15" AFF VERIFY	Φ
063D	MICROWAVE	120	1	13.0	IN CASEWORK VIF	<b>P</b>	<b>'</b>	(083A)	BLENDER	120	1	15	@ 24" AFF	Φ
(068A)	SOUP RETHERMALIZER	208	3	25	@ 24" AFF	<b>b</b>		085B) Z1	EGG STATION	208	1	12.6	@ 24" AFF	$\Diamond$
(071)	COOLER COMPRESSOR	120/208	3	14.2	* ON ROOF			085G	HEATED SHELF	120	1	0.8	@ 46" AFF	Φ
(071A)	COOLER EVAPORATOR	120	1	М	@ C00LER CLG	J		085H) Z2	DOUBLE BATCH OVEN	208	1	40	@ 24" AFF VERIFY	Φ
								(085K)	HOLDING UNIT	120	1	10	@ 46" AFF	Φ
072	FREEZER COMPRESSOR	208	3	19.5	* ON ROOF			407	DRIVE THRU WINDOW	120	1	1	VERIFY	J
(072A)	FREEZER EVAPORATOR	208	1	М	@ FREEZER CLG	J		408B	AIR CURTAIN- HEATED	208	1	30	VERIFY	J
(076C)	SIMPLICITY BUBBLER	120	1	8.5	18"AFF	Φ	f	460	DRIVE-THRU TIMER	120	1	1	12" BELOW CEILING	<b>*</b>
(082)	BAGEL SLICER	120	1	6.8	@ 24" AFF	Φ	ŀ	461	HME DIGITAL	120	1	3	@ 24" BELOW	Φ
						"	+	462B	COMMUNICATION SYSTEM TIMER FLAT SCREEN	120	1	3	CEILING VERIFY HEIGHT	——————————————————————————————————————
(085D)	HEATED SHELF	120	1	5.3	IN CASEWORK	Φ	-	463	SECURITY FLAT SCREEN	120	1	1.5	@ 68" AFF	Φ
(089)	SCALE	120	1	1	VIF @ 46"AFF	Ф	-	466A	SECURITY CAMERA	120	1	*	ROUGH-IN BY BLDG CONTRACTOR,	J
(097C)	REFRIG. SELF-SERVE	120	1	14.58	IN CASEWORK	Φ	L				'		INSTALLED BY VENDOR	
	COOLER CASE AIR CURTAIN -		•		VEDIEV		١	V - PRO	JTRAL REQUIRED FOR EQUIPM DVIDE WITH PLASTIC COVER					
(102)	DELIVERY DOOR DIGITAL INTERNET	120	1	5.1	VERIFY SEE MGR	<u>J</u>			ECTRICAL SUPPLY FOR REMOT RBONATOR PUMP & SODA DISP					KER
(109)	RECEIVER/AMP (DMX)	120	1	2	OFFICE DETAIL SEE MGR	Φ	`	Y - CON	NTRACTOR VERIFY CONNECTION	ON DEVICE V				URER
128	CCTV MONITOR	120	1	1	OFFICE DETAIL SEE MGR		— Z1 - NEMA L6-20R RECEPTACLE (TWIST-LOCK)							

CCTV CONTROLLER

120

1 6

SEE MGR

OFFICE DETAIL

Z1 - NEMA L6-2UR RECEPTACLE

Z2 - NEMA 6-50R RECEPTACLE

Z3 - NEMA 6-20R RECEPTACLE

₹ Z4 - NEMA 6-30R RECEPTACLE

H - ELECTRICAL POWER FOR HOOD SUPPLIED WITH DISHWASHER EXHAUST FAN -

REFER TO E203, E502, AND MECHANICAL DRAWINGS. M - ELECTRICAL POWER SUPPLY FOR EVAPORATOR SUPPLIED FROM REMOTE CONDENSER. CONTRACTOR TO PROVIDE ALL REQ'D INTER-CONNECT WIRING.

N - NEUTRAL REQUIRED FOR EQUIPMENT

T - ELECTRICAL CONTRACTOR TO SUPPLY LOW VOLTAGE TRANS. AS REQUIRED W - ELECTRICAL SUPPLY FOR REMOTE CONDENSER SUPPLIED FROM ICE MAKER

X - CARBONATOR PUMP & SODA DISPENSER SHARE SAME RECEPTACLE Y - CONTRACTOR VERIFY CONNECTION DEVICE WITH EQUIPMENT MANUFACTURER

+ - VERIFY WIRE SIZE WITH MANUFACTURER

++ - PROVIDE 30A BREAKER PER MANUFACTURER

\* VERIFY \*\* - F.O.H.

MARK	ITEM NAME	V	PH	Α	ROUGH-IN DEV.		REMARKS
$\langle A \rangle$	RECEPTACLES	120	1	20	@ 15" AFF	φ	TAMPER RESISTANT DUPLEX RECEPTACLE W/ USB - HUBBELL CATALOG NO. USB15X2W - COLOR WHITE
$\langle B \rangle$	RECEPTACLES	120	1	20	@ 42" AFF	$ \emptyset $	GFI RECEPTACLES
D	RECEPTACLES	120	1	20	VERIFY, BASE OF BOOTH, HORIZONTALLY	φ	ROUTE WIRE INSIDE BOOTH TO HALF-WALL, THEN RUN CONDUIT BELOW FLOOR TO NEAREST WALL EXTENDING TO CEILING. TAMPER RESISTANT DUPLEX RECEPTACLE W/ USB - HUBBELL CATALOG NO. USB15X2BK - COLOR BLACK
(E)	RECEPTACLES	120	1	20	VERIFY, @ SCREEN WALL, HORIZONTALLY	φ	ROUTE CONDUIT BELOW FLOOR TO NEAREST WALL WHICH ENGAGES CEILING. TAMPER RESISTANT DUPLEX RECEPTACLE W/ USB -HUBBELL CATALOG NO. USB15X2BK -COLOR BLACK
F	RECEPTACLES	120	1	20	@ 48" AFF (UNO)	$ \emptyset $	GFI RECEPTACLES
(BTL)	BAKERY TOWER LIGHTING	120	1	1.5	IN CASEWORK VIF	Ф	RECEPTACLE MOUNTED IN CASEWORK TO POWER PLUG-IN BAKERY TOWER LIGHTS. PROVIDE ROUGH-IN AND FINAL CONNECTION
CBD	CAFE BASE DELIVERY SYSTEM	120	1	1.5	@ 15" AFF	#	PROVIDE ROUGH-IN AND FINAL CONNECTION
cws	ROPE MONITOR	120	1	4	@ 46" AFF	Ф	GFI RECEPTACLES
(FP)	FIREPLACE	120	1	4	VERIFY	J	PROVIDE ROUGH-IN AND FINAL CONNECTION
$\langle H \rangle$	HEAT TAPE	120	1	4	VERIFY	Φ	FOR FREEZER CONDENSATE LINE OR WATER LINE. PROVIDE GROUND FAULT CIRCUIT BREAKER.
(HT)	HAND TOWEL	120	1	1	VERIFY	φ	VERIFY HEIGHT WITH ADA REQUIREMENTS. SEE ARCHITECTURAL PLANS FOR MORE INFORMATION.
MBD	MOBILE BAGEL DISPLAY	120	1	1	VERIFY	$\Phi$	PROVIDE RECEPTACLE, VERIFY EXACT ROUGH-IN LOCATION AND PLUG/RECEPTACLE REQUIREMENTS WITH MANUFACTURER AND PANERA REPRESENTATIVE.
РВ	PAGE BUMP	120	1	2	@ 24" AFF	φ	IG RECEPTACLE MOUNTED IN CASEWORK.
(PM1)	MULTI-OUTLET PLUGMOLD	120	1	15	VERIFY	J	PROVIDE ROUGH-IN AND FINAL CONNECTION TO FACTORY INSTALLED PLUGMOLD AT TABLE. ROUTE CONDUIT BELOW FLOOR TO NEAREST WALL WHICH ENGAGES CEILING. COORDINATE EX LOCATION WITH PANERA CM AND TABLE VENDOR PRIOR TO ROUGH-IN.
$\langle RP \rangle$	RECIRCULATING PUMP	120	1	2.4	VERIFY	J	PROVIDE ROUGH-IN AND FINAL CONNECTION.
SYP	SYRUP PUMP	120	1	2.4	@ 24" AFF	φ	PROVIDE ROUGH-IN AND FINAL CONNECTION
TDM	TABLE DELIVERY MONITOR	120	1	20	@ 24" AFF	φ	VERIFY EXACT LOCATION AND HEIGHT OF RECEPTACLES LOCATED IN CASEWORK FOR TABLE SERVICE WITH PANERA CM PRIOR TO ROUGH-IN.
TSC	TABLE LOCATOR TRANSMITTER	120	1	20	@ 90" AFF	Φ	VERIFY EXACT LOCATION AND HEIGHT OF RECEPTACLES LOCATED IN CASEWORK FOR TABLE SERVICE WITH PANERA CM PRIOR TO ROUGH-IN.
TSA	TABLE SERVICE	120	1	20	ABOVE CEILING	φ	VERIFY EXACT LOCATION FOR RECEPTACLE LOCATED ABOVE CEILING FOR TABLE SERVICE WITH PANERA CM PRIOR TO ROUGH-IN. RECEPTACLE TO BE LOCATED AS CLOSE AS POSSIBLE TO WINDOW AT PATIO DINING.
(WH)	WATER HEATER CONTROLS	120	1	5	VERIFY	(J)	PROVIDE ROUGH-IN AND FINAL CONNECTION.

Bakery-Cafe:

SYSTEM: G4 (ARIA)




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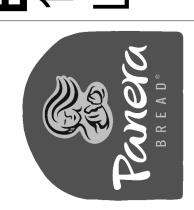
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Project Title:

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4	OWNER REVISION	02/03/2023
5	MEP UPDATES	05/26/2023

T 636.349.1600 F 636.349.1730

#### **ELECTRICAL ROUGH-IN** SCHEDULES

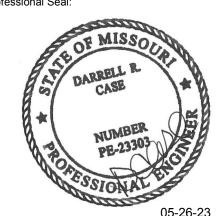Project Number: LKA-MO-01-22

07/05/2022 DPM:

#### **GENERAL NOTES:**

- E.C. SHALL RUN NEUTRAL AND GROUNDING WIRES TO ALL KITCHEN EQUIPMENT. NO SHARED NEUTRALS SHALL BE USED.
- ALL KITCHEN EQUIPMENT SHALL BE FURNISHED BY OTHERS. ELECTRICAL CONTRACTOR SHALL SET IN PLACE AND MAKE FINAL CONNECTIONS.
- ALL CONDUIT PASSING THROUGH WALL OF COOLER/FREEZER SHALL BE SEALED WITH SILICONE.
- ALL RECEPTACLES SHALL BE NEMA GROUNDING TYPE. RECEPTACLES IN DINING AREA SHALL HAVE BLACK WIRING DEVICES AND BLACK COVERS. RECEPTACLES IN KITCHEN AREA SHALL HAVE BLACK WIRING DEVICES AND BRUSHED STAINLESS STEEL COVERS.
- ALL KITCHEN EQUIPMENT JUNCTION BOXES SHOWN SHALL INCLUDE FINAL CONNECTION TO THEIR RESPECTIVE KITCHEN EQUIPMENT.
- VERIFY ELECTRICAL REQUIREMENTS, CONNECTIONS, AND EXACT LOCATION OF CONNECTIONS. COORDINATE WITH EQUIPMENT SUPPLIER/CONTRACTOR.
- ALL 120V OUTLETS IN KITCHEN AREA ARE TO BE GFCI PROTECTED, EITHER BY RATED BREAKERS OR DEVICES.
- REFER TO THE GENERAL CONDITIONS ON SHEET G011 FOR FIRE STOPPING REQUIREMENTS.

CONDUITS INSTALLED EXPOSED AND NOT CONCEALED IN WALLS OR MOUNTED ABOVE FINISHED CEILINGS SHALL BE INSTALLED A MINIMUM OF 1" CLEAR SPACING FROM WALL AND 6" ABOVE FINISHED FLOOR FOR CLEANING PURPOSES. INSALLATION OF EXPOSED FLEXIBLE CONDUIT IS NOT ACCEPTABLE.

#### **KEYED NOTES**

- ALL WIRING DEVICES IN FRONT COUNTER/CONSOLIDATION WALL SHALL BE INSTALLED IN CABINETRY OR IN CASING AND ACCESSED FROM THE FRONT CEILING FOR CIRCUITING "HOME RUNS". EACH ISOLATED GROUND CIRCUIT
  - RECEPTACLES FOR EQUIPMENT (IN THE FRONT LINE) SHALL BE FLUSH-MOUNTED AND RECESSED INTO CASEWORK.
- PROVIDE ROUGH-IN AND FINAL CONNECTION TO COFFEE MACHINE. PROVIDE "LOCK-OUT" TYPE CIRCUIT BREAKER IN PANEL K2. CONTRACTOR TO PROVIDE 8/4 BLACK SEOOW FLEXIBLE CORD AND MAKE FINAL CONNECTION TO EQUIPMENT. CORD TO ALLOW 2'-6" MOVEMENT OF EQUIPMENT MINIMUM.
- COMPRESSOR. COORDINATE WITH G.C. AND COOLER/FREEZER MANUFACTURER. SEE SHEET M501 FOR LOCATION.
- VERIFY LOCATION. COORDINATE WITH G.C. AND COOLER/FREEZER MANUFACTURER.
- ELECTRICAL CONTRACTOR TO MAKE ELECTRICAL CONNECTION BETWEEN ICE MAKER AND REMOTE CONDENSER ON ROOF. COORDINATE WITH G.C. AND EQUIPMENT MANUFACTURER. ROUGH-IN FOR FUTURE ROOF PENETRATION AT
- PROVIDE ROUGH-IN AND FINAL CONNECTION TO EVAPORATOR. EXTEND CIRCUIT FROM COMPRESSOR ON ROOF. COORDINATE WITH G.C. AND COOLER/FREEZER
- PROVIDE ROUGH-IN AND FINAL CONNECTION TO DOUBLE BATCH OVEN. VERIFY RECEPTACLE ORIENTATION AND CORD AND PLUG REQUIREMENTS WITH
- VERIFY REQUIREMENTS OF DETEX DOOR ALARM WITH EQUIPMENT SUPPLIER.
- INSTALLATION SHALL BE IN COMPLIANCE WITH MANUFACTURER RECOMMENDATIONS. COORDINATE REQUIREMENTS WITH PLUMBING
- PROVIDE ROUGH-IN AND FINAL CONNECTION TO RACK OVEN HOOD EXHAUST 16 FAN, DRAFT INDUCER MOTOR, AND PRESSURE SWITCH. FAN SHALL BE INTERLOCKED WITH OVEN TO RUN WHEN OVEN IS ON. SEE WIRING DETAILS ON MECHANICAL SHEETS. COORDINATE WITH MECHANICAL CONTRACTOR AND EQUIPMENT MANUFACTURER.
- PROVIDE DOOR SWITCH/SENSOR TO ACTIVATE DELIVERY DOOR AIR CURTAIN WHEN DOOR IS OPENED.
- HME WIRELESS TRANSMITTER LOCATED @ 24" BELOW CEILING. VERIFY LOCATION AND REQUIREMENTS WITH GENERAL CONTRACTOR IN FIELD.
- PROVIDE ROUGH-IN FOR AIR CURTAIN. (WHERE REQUIRED) AIR CURTAIN TO BE
- PROVIDE ROUGH-IN AND FINAL CONNECTION TO NEW SECURITY CAMERA  $raket{22}$  SHOWN. VERIFY CONNECTION REQUIREMENTS IN FIELD WITH EQUIPMENT SUPPLIER. WHERE 120V CIRCUIT IS REQUIRED USE 20 AMP CIRCUIT LOCATED IN
- PROVIDE ROUGH-IN AND FINAL CONNECTION FOR IRRIGATION CONTROLLER.

COORDINATE LOCATION WITH PANERA REPRESENTATIVE.

- PROVIDE ROUGH-IN AND FINAL CONNECTION TO TIME CLOCK FOR WATER RECIRCULATING PUMP. COORDINATE LOCATION WITH G.C. IN FIELD AND TIME PROGRAMMING WITH PANERA REPRESENTATIVE
- 26 ELECTRIC METER) LOCATIONS. 800 AMP, 3 PHASE, 4 WIRE ELECTRICAL SERVICE, REFER TO ONE-LINE DIAGRAM ON SHEET E501.
- ELECTRICAL CONNECTIONS BETWEEN PROOFER WITH RETARDER AND REMOTE CONDENSER ON THE ROOF PER MANUFACTURERS SPECIFICATIONS. SEE ROOF PLAN, SHEET M501, FOR ADDITIONAL INFORMATION. COORDINATE WITH G.C. AND EQUIPMENT
- RECEPTACLE TO POWER CARBON DIOXIDE (CO2) DETECTOR, SEE SHEET E401 FOR DIRECTION ON SENSOR. INSTALL RECEPTACLE AT 18"AFF OR AS DIRECTED PER CO2 DETECTOR MANUFACTURER INSTALLATION INSTRUCTIONS. PROVIDE LOCK-ON BRANCH CIRCUIT BREAKER AND INDICATE CO2 ALARM AT PANEL.

- $\langle$   $^{1}
  angle$  -SEE ONE-LINE DIAGRAM AND PANEL SCHEDULES ON SHEET E501.
- SEE DETAILS ON SHEET E403 FOR LOCATION AND CIRCUIT OF RECEPTACLES IN OFFICE AREA.
- REMOVABLE PANELS. INSTALL GROMMETS IN WALL TO CONNECT EQUIPMENT TO DEVICES. RUN CONDUIT BELOW SLAB TO NEAREST WALL WHICH ENGAGES SHALL BE RUN IN SEPARATE CONDUIT. ROUTING OF CONDUIT BELOW FLOOR SHALL BE IN SUCH A WAY AS TO MINIMIZE CHANNELING OF SLAB AND AMOUNT
- RECEPTACLE FOR ESPRESSO MACHINE PROVIDED BY MANUFACTURER. MOUNT ESPRESSO RECEPTACLE SIDEWAYS IN CASEWORK CHASE SO CORD AND PLUG DOES NOT INTERFERE WITH REFRIGERATOR LOCATION.
- VERIFY WIRE SIZE WITH OVEN SUPPLIER.
- PROVIDE ROUGH-IN AND FINAL CONNECTION TO COOLER/FREEZER
- PROVIDE ROUGH-IN AND FINAL CONNECTION TO COOLER/FREEZER DOOR. FIELD

- MANUFACTURER AND PANERA REPRESENTATIVE.
- PROVIDE ROUGH-IN AND FINAL CONNECTION TO WATER HEATER. COMPLETE

- INSTALL ENTIRE DISHWASHER HOOD CONTROL SYSTEM. COMPONENTS PROVIDED BY ECOLAB, WIRING PROVIDED AND INSTALLED BY ELECTRICAL CONTRACTOR, SEE SHEET E502 THIS SET FOR CONTROL WIRING DIAGRAM COORDINATE CONNECTION OF HOOD CONTROLS TO EXHAUST FAN WITH MECHANICAL CONTRACTOR IN FIELD.
- PROVIDE JBOX TO FEED POWER TO DRIVE THRU WINDOW. COORDINATE LOCATION WITH WINDOW SUPPLIER AND INSTALLATION MANUAL.

(21) ACTIVATED WHEN DRIVE-THRU WINDOW IS OPENED.

"IGP" PANEL AS INDICATED ON PLANS.

- EXISTING SERVICE ENTRANCE EQUIPMENT (CT CABINET, MAIN DISCONNECT SWITCH AND
- VERIFY EXACT REQUIREMENTS WITH EQUIPMENT MANUFACTURER. PROVIDE ALL HARDWARE AND CONDUIT, WIRING, AND CONNECTIONS TO COMPLETE INSTALLATION
- ELECTRICAL CONTRACTOR TO PROVIDE ALL CONDUIT, WIRING, AND MAKE ALL
- PROVIDE JUNCTION BOX AND 120V CIRCUIT AT CEILING FOR FUTURE CONNECTION TO
- DIGITAL MENU BOARD.

Description 1 PERMIT SET - TI 7/18/2022 TI UPDATES 9/22/2022 CONSTRUCTION SET 11/09/2022

OWNER REVISION

MEP UPDATES

CERTIFICATE OF AUTHORITY NO. 001498

F 636.349.1730

02/03/2023

05/26/2023

**Bakery-Cafe:** 

Project Team:

SYSTEM: G4 (ARIA)

LK ARCHITECTURE, INC.

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**Architecture** · **Engineering** ·

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Planning · Interior Design

**Landscape Architecture** 

Professional Seal:

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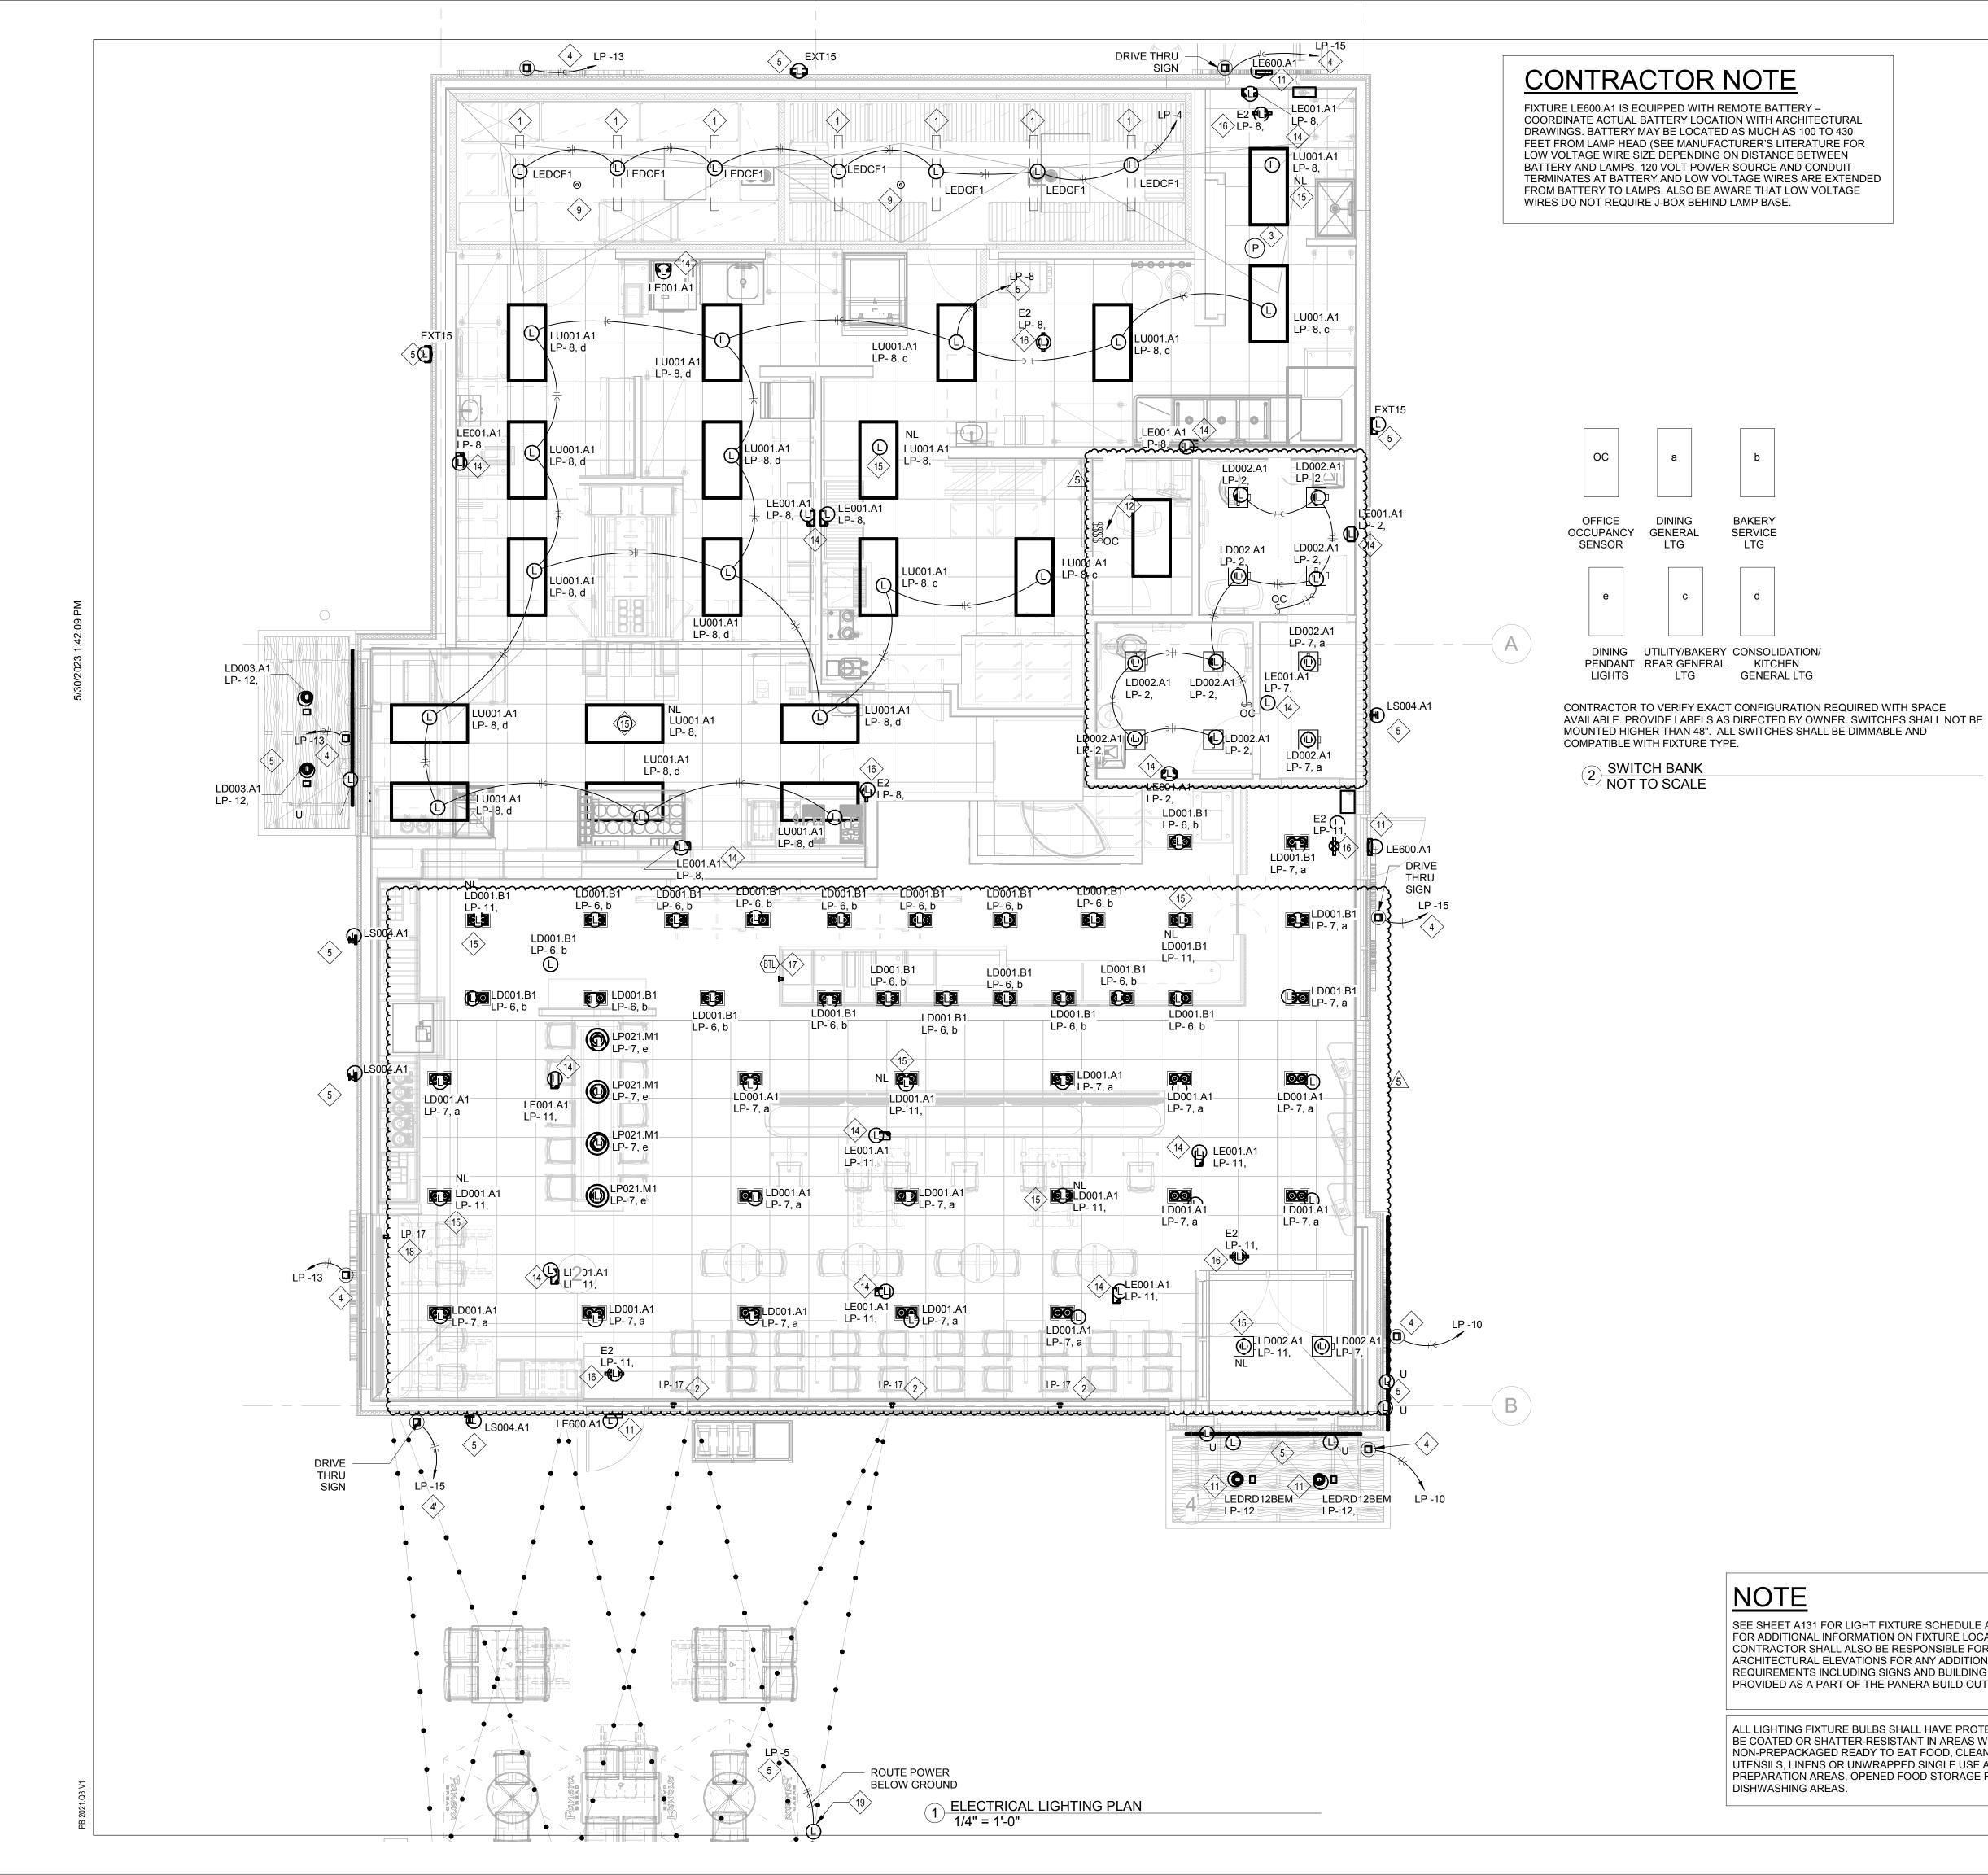
St. Louis, MO 63026

#### **ELECTRICAL POWER PLAN**

Project Number: Sheet Number: LKA-MO-01-22 Drawn By:

DPM:

07/05/2022



#### LIGHTING GENERAL NOTES

OTHERWISE NOTED.

- INSTALL LIGHT FIXTURES IN ACCORDANCE WITH THE MANUFACTURER'S INSTRUCTIONS AND THE LATEST EDITION OF THE NEC.
- ALL WIRING SHALL BE COPPER, #12 THHN IN 3/4" CONDUIT UNLESS
- WHERE CONDUCTORS ARE NOT INDICATED (FOR CLARITY) INSTALL

INSTALLED BY THE ELECTRICAL CONTRACTOR. ALL FIXTURE LAMPS

CONDUCTORS AS INDICATED BY THE CORRESPONDING HOMERUN. ALL FIXTURES TO BE PROVIDED BY, RECEIVED, STORED, AND

SHALL BE SUPPLIED AND INSTALLED BY THE ELECTRICAL

- ELECTRICAL CONTRACTOR SHALL SUPPLY 10% ADDITIONAL SPARE LAMPS FOR ALL LAMP TYPES.
- F. 'NL' REFERS TO NIGHT LIGHT FIXTURE.
- 'EM' REFERS TO LIGHT FIXTURE WITH EMERGENCY BALLAST.

#### **KEYED NOTES**

- 1 COORDINATE CONNECTION OF COOLER/FREEZER LIGHTING WITH COOLER/FREEZER EQUIPMENT SUPPLIER AND CONTRACTOR. MANUFACTURER PROVIDES FIXTURE, AND CONTRACTOR PROVIDES LOW TEMP BALLAST.
- $\langle 2 
  angle$  PROVIDE RECEPTACLE ABOVE STOREFRONT WINDOW (TYPICAL MOUNT AT 6" ABOVE WINDOW ) FOR WINDOW DISPLAY. CIRCUIT VIA LIGHTING CONTACTOR AND TIME CLOCK FURNISHED WITH CPI PANEL. COORDINATE WITH CPI REPRESENTATIVE.
- (3) INSTALL PHOTOCELL (INCLUDED W/CPI PACKAGE) IN UNOBSTRUCTED LOCATION ON ROOF. LOCATE W/SENSOR POINTING NORTH. CONNECT TO CPI LIGHTING CONTROL EQUIPMENT.
- $\langle _4 
  angle$  JUNCTION BOX AND CIRCUIT FOR SIGNAGE PROVIDED IN SHELL PACKAGE. CONNECT SIGN COMPLETE AND READY FOR OPERATION..
- $\left\langle _{5}
  ight
  angle$  EXTERIOR LIGHTING FURNISHED AS PART OF SHELL PACKAGE.
- 6 NOT USED.
- 7 NOT USED.
- (8) NOT USED.
- PROVIDE HUBBELL WSP-SM-UNV-LTWT OCCUPANCY SENSOR W/WSPLENS-360-LTWT LENS.
- ⟨10⟩ NOT USED
- (11) EXTERIOR EGRESS FIXTURE FURNISHED AS PART OF SHELL PACKAGE.
- APPROXIMATE LOCATION OF SWITCHBANK. SEE DETAIL THIS SHEET. COORDINATE EXACT LOCATION AND SWITCH CONFIGURATION WITH OWNER.
- EMERGENCY EGRESS FIXTURE, CONNECT TO UNSWITCH LEG OF CIRCUIT NOTED
- 15 CONNECT NIGHT LIGHT TO UNSWITCHED LEG OF CIRCUIT NOTED.
- $\stackrel{\textstyle ullet}{}_{16}
  angle$  EMERGENCY EXIT SIGN, CONNECT TO UNSWITCH LEG OF CIRCUIT NOTED.
- RECEPTACLE FOR PLUG-IN LED STRIP LIGHTS INSIDE OF BAKERY TOWERS, CONNECT TO BAKERY SERVICE LIGHT CIRCUIT AND SWITCH ON/OFF WITH TOGGLE SWITCH INDICATED. VERIFY AND COORDINATE ALL BAKERY TOWER LIGHT FIXTURE LOCATIONS AND REQUIREMENTS WITH CASEWORK AND PANERA REPRESENTATIVES.
- PROVIDE CEILING MOUNTED RECEPTACLE FOR WINDOW DISPLAY. CIRCUIT VIA LIGHTING CONTACTOR AND TIME CLOCK FURNISHED BY EC.
- PATIO STRING LIGHTS, VERIFY INSTALLATION REQUIREMENTS WITH MANUFACTURER, PROVIDE DUPLEX RECEPTACLE WITH WEATHERPROOF IN-USE COVER FOR PLUG-IN CONNECTION AT EXTERIOR POST AND ALL WIRING. CONNECTIONS, AND APPURTENANCES TO COMPLETE INSTALLATION PER MANUFACTURERS SPECIFICATIONS AND N.E.C. REGULATIONS. CONDUIT SHALL BE ROUTED WITHIN POST, DOWN BELOW SLAB, AND STUBBED UP INTO BUILDING. SEE ARCHITECTURAL DETAIL SHEET FOR ADDITIONAL INSTALLATION INFORMATION AND COORDINATE WITH PANERA REPRESENTATIVE PRIOR TO START OF WORK.

**Bakery-Cafe:** 

Project Team:

SYSTEM: G4 (ARIA)



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**Architecture** · **Engineering** · **Planning · Interior Design Landscape Architecture** 

Professional Seal:



Project Title:

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1	PERMIT SET - TI	7/18/2022
2	TI UPDATES	9/22/2022
3	CONSTRUCTION SET	11/09/202
4	OWNER REVISION	02/03/202
5	MEP UPDATES	05/26/202

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#### **ELECTRICAL** LIGHTING PLAN

Project Number: LKA-MO-01-22

07/05/2022

DPM:

**NOTE** 

ALL FIXTURES (NO EXCEPTIONS) TO BE OBTAINED THROUGH NATIONAL ACCOUNT AT: STANDARD ELECTRICAL SUPPLY COMPANY #14 JEWEL DRIVE WILMINGTON, MA 01887

CONTACT: PANERA ACCOUNT REPRESENTATIVE 800-370-5050 x3176 CITY LIGHTING 4307 WEST PAPIN ST. ST. LOUIS, MO 63110

CONTACT: DON SCHWEITZER 314-566-5312

#### NOTE

KITCHEN

SEE SHEET A131 FOR LIGHT FIXTURE SCHEDULE AND SHEET A130 FOR ADDITIONAL INFORMATION ON FIXTURE LOCATIONS. CONTRACTOR SHALL ALSO BE RESPONSIBLE FOR REVIEWING ARCHITECTURAL ELEVATIONS FOR ANY ADDITIONAL POWER REQUIREMENTS INCLUDING SIGNS AND BUILDING LIGHTING BEING PROVIDED AS A PART OF THE PANERA BUILD OUT.

ALL LIGHTING FIXTURE BULBS SHALL HAVE PROTECTIVE COVERS. BE COATED OR SHATTER-RESISTANT IN AREAS WHERE THERE IS NON-PREPACKAGED READY TO EAT FOOD, CLEAN EQUIPMENT, UTENSILS, LINENS OR UNWRAPPED SINGLE USE ARTICLES, FOOD PREPARATION AREAS, OPENED FOOD STORAGE ROOMS, AND DISHWASHING AREAS.

#### **KEYED NOTES**

- S1 SEE "POS SYSTEM DIAGRAM" ON SHEET E403 FOR ALL WIRING AND CONNECTION INFORMATION.
- S2 AT FREEZER AND COOLER PROVIDE TWO SINGLE GANG JUNCTION BOXES ADJACENT TO STRIKE SIDE OF DOOR WITH 1/2" CONDUIT W/PULLWIRE STUBBED OUT ABOVE ACCESSIBLE CEILING. ONE BOX FOR ALARM SYSTEM HOLD-UP PUSHBUTTON AND ONE FOR TEMPERATURE SENSOR. FIELD VERIFY EXACT LOCATIONS W/OWNERS REPRESENTATIVE. COORDINATE WORK WITH SECURITY SYSTEM CONTRACTOR AND FREEZER/COOLER EQUIPMENT MANUFACTURER. PROVIDE ALL NECESSARY CONTROL WIRING FOR FREEZER AND COOLER PER MANUFACTURERS REQUIREMENTS.
- PROVIDE 1/2" CONDUIT W/PULLWIRE CONCEALED IN PARTITON RUN UP FROM TOP EDGE OF DOOR FRAME AND STUBBED OUT ABOVE ACCESSIBLE CEILING FOR DOOR CONTACT. CONDUIT SHALL BE AT STRIKE SIDE OF DOOR, NOT HINGED SIDE. COORDINATE WORK WITH SECURITY SYSTEM CONTRACTOR.
- S4 COORDINATE INSTALLATION OF ROPE TERMINAL AND PRINTER. CONTRACTOR TO PROVIDE PATCH CABLES FROM OFFICE (MINIMUM 3 PLUS EXTRAS AS BACKUP).
- PROVIDE CONDUIT FROM ALL PHONE OUTLETS AT HEIGHT INDICATED TO THE TELEPHONE SYSTEM IN THE OFFICE. TELEPHONE CONDUITS SHALL HAVE A PULL WIRE INSTALLED. STUB 3/4" CONDUIT FROM TELEPHONE OUTLET TO ABOVE FINISHED CEILING. PROVIDE INSULATED BUSHING ON CONDUIT END. CURVE CONDUIT TOWARDS DIRECTION OF TELEPHONE SERVICE. COORDINATE WITH TELEPHONE COMPANY PRIOR TO INSTALLATION.
- \$6\times HME WIRELESS TRANSMITTER LOCATED @ 24" BELOW CEILING. VERIFY LOCATION AND REQUIREMENTS WITH GENERAL CONTRACTOR IN FIELD.
- S7> ROUTE POS SYSTEM CONDUIT(S) UNDER FLOOR OR THROUGH CASEWORK TO NEAREST FULL HEIGHT PARTITION - THEN UP ABOVE ACCESSIBLE CEILING. PROVIDE W/ PULL WIRE. SEE POS SYSTEM NOTES ON SHEET E403 FOR QUANTITY, SIZES, AND REQUIREMENTS.
- S8 PROVIDE PUSH BUTTON AT MAIN BAKERY REGISTER WITH CHIME IN REAR AREA. CHIME TONE SHALL BE DIFFERENT FROM THAT OF THE DOOR CHIME. RUN WIRING IN CABINETRY AND/OR IN CONDUIT BELOW FLOOR (IF REQUIRED) TO STUB OUT ABOVE ACCESSIBLE CEILING. VERIFY REQUIREMENTS IN FIELD.
- S9 PROVIDE ROUGH-IN AND FINAL CONNECTION TO SMOKE DETECTOR MOUNTED IN RETURN AIR DUCT. DETECTOR SHOULD SHUT DOWN RTU UPON ACTIVATION. (WHEN FIRE ALARM IS PROVIDED SMOKE DETECTOR SHALL NOTIFY CONTROL PANEL AND SHUT DOWN RTU).
- (\$10) VIDEO MONITOR, COMPLETE WITH VDU CONTROLLER BOX, IS SUPPLIED AND INSTALLED BY VENDOR.
- PROVIDE RECESSED SINGLE GANG JUNCTION BOX AT 60" AFF WITH 1/2" CONDUIT W/ PULLWIRE UP IN PARTITION STUBBED OUT ABOVE ACCESSIBLE CEILING FOR ALARM SYSTEM CONTROL KEYPAD. LOCATE THE KEYPAD ON THE CUSTOMER SIDE OF THE WALL NEAR THE DOORWAY INTO THE KITCHEN CLOSEST TO THE CAFE'S FRONT ENTRY. COORDINATE WORK WITH SECURITY SYSTEM CONTRACTOR.
- PROVIDE DOOR BUZZER SYSTEM AT REAR ENTRY DOOR. PROVIDE PUSHBUTTON AT 48" AFF ADJACENT TO STRIKE SIDE OF ENTRY DOOR. PROVIDE BUZZER MOUNTED JUST BELOW CEILING IN KITCHEN AREA. FIELD VERIFY EXACT LOCATION. PUSHBUTTON SHALL BE EDWARDS 632 OR EQUAL BUZZER SHALL BE EDWARDS 725 OR EQUAL.
- (\$13) PROVIDE SEPARATE CONDUIT RUN BELOW FLOOR OR IN CASEWORK FOR SOUND SYSTEM WIRING TO MICROPHONES - VERIFY REQUIREMENTS IN FIELD. (WHERE REQUIRED)
- (\$14) PROVIDE ROUGH-IN AND FINAL CONNECTION TO SECURITY SYSTEM MONITOR. VERIFY CONNECTION REQUIREMENTS WITH SECURITY SYSTEM PROVIDER. (WHERE REQUIRED)
- (\$15) JBOX/CONDUIT FOR DRIVE THRU WINDOW SECURITY WIRING. VERIFY LOCATION AND REQUIREMENTS WITH EQUIPMENT PROVIDER PRIOR TO INSTALLATION OF CONDUIT.
- (\$16) JBOX/CONDUIT FOR DRIVE THRU SECURITY CAMERAS. VERIFY LOCATION AND REQUIREMENTS WITH EQUIPMENT PROVIDER PRIOR TO
- (\$17) CONTRACTOR TO PROVIDE A SURFACE MOUNTED CARBON DIOXIDE (CO2) DETECTOR WITH ALARM. VERIFY DETECTOR MODEL AND EXACT INSTALLATION REQUIREMENTS WITH THE A.H.J., PANERA REPRESENTATIVE, BEVERAGE EQUIPMENT DISTRIBUTOR, AND DETECTOR MANUFACTURER INSTALLATION INSTRUCTIONS (PROVIDE ALL CONDUIT. WIRING, APPURTENANCES, AND CONNECTIONS AS DIRECTED). SENSOR UNIT TO BE INSTALLED 18"AFF IN LOCATION SHOWN UNLESS DIRECTED OTHERWISE. IF APPLICABLE INSTALL APPROVED COVER OVER SENSOR UNIT TO PREVENT DAMAGE. UTILIZE NEARBY DUPLEX RECEPTACLE FOR POWER TO UNIT, SEE POWER PLAN SHEET E203. PROVIDE LOCK-ON BRANCH CIRCUIT BREAKER AND INDICATE CO2 ALARM AT PANEL.
- (\$18) SEE DETAILS ON SHEET E403 FOR INFORMATION AND LOCATION OF 'SPECIAL SYSTEMS' EQUIPMENT/ DEVICES IN OFFICE AREA.

SPEAKER SYSTEM TO BE INSTALLED ON A DESIGN BUILD

BASIS BY PANERA'S VENDOR AND SHALL INCLUDE

INTERIOR AND EXTERIOR APPLICATIONS.

**KEYED NOTES** 

- PROVIDE 1" CONDUIT TO SPEAKER POST AT PATIO. VERIFY EXACT LOCATION PRIOR TO
- PROVIDE 1" CONDUIT TO LANSCAPING AREA FOR IRRIGATION SYSTEM BOX. VERIFY EXACT LOCATION PRIOR TO ROUGH-IN.
- PROVIDE 2" CONDUIT FROM MENU BOARD TO MANAGER'S OFFICE. COORDINATE EXACT LOCATION WITH OWNER'S REPRESENTATIVE.

**Bakery-Cafe:** 

Project Team:

SYSTEM: G4 (ARIA)




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### **SPECIAL SYSTEMS**

Project Number: Sheet Number: LKA-MO-01-22 Drawn By: 07/05/2022

DPM:

2400

SYSTEM: G4 (ARIA)

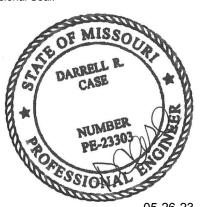


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POS DIAGRAM AND

NOTES

Project Number: Sheet Note 
LKA-MO-01-22

Drawn By:

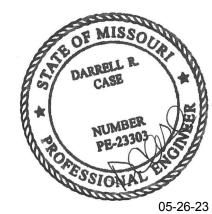07/05/2022

DPM:

Sheet Number:

CALE

TELEPHONE SYSTEM IN THE OFFICE. TELEPHONE CONDUITS SHALL HAVE A PULL WIRE INSTALLED. STUB 3/4" CONDUIT FROM TELEPHONE OUTLET TO ABOVE FINISHED CEILING. PROVIDE INSULATED BUSHING ON CONDUIT END. CURVE CONDUIT TOWARDS DIRECTION OF TELEPHONE SERVICE. COORDINATE WITH TELEPHONE COMPANY PRIOR TO

)21.Q3.V1

**EXTERIOR** 

(M)

3/0 CU -

800A SERVICE ENTRANCE RATED

NEMA 3R DISCONNECT SWITCH, CT

FROM UTILITY COMPANY, PROVIDED

1 ONE-LINE DIAGRAM NTS

BY SHELL CONTRACTOR

CABINET AND METER PROVIDED BY -

SHELL CONTRACTOR. COMPLY

WITH ALL UTILITY STANDARDS

#### **Branch Panel: LP** Volts: 120/208 Wye A.I.C. Rating: 65/22K SERIES RATED Location: UTILITY 48 Supply From: MDP Mains Type: Phases: 3 Mounting: SURFACE Mains Rating: 125 A Wires: 4 Enclosure: NEMA 1 MCB Rating: 0 A DE MA ND | 1 SITE LTG 3 MONUMENT SIGN 5 PATIO STRING LIGHTS 200 VA 380 VA 1 T4 20 A DINING LTG 7 DINING LTG 20 A T2 1 620 VA 1244 VA 1 T1 20 A BUILDING MTD SIGNAGE 9 TIME CLOCK 570 VA 684 VA 1 20 A EXTERIOR WALL PACKS 11 EM/EXIT LTG | 20 A | T1 | 1 | 1500 VA | 1464 VA | | 1 | 20 A | SITE LIGHTS | 20 A | T1 | 1 | 1500 VA | 0 VA | 1 | -- 20 A | 20 A | T2 | 1 | 720 VA | 1000 VA | 1 | 20 A | LTG. SIGNAGE | Table and the state of the 13 BUILDING MTD SIGNAGE . 15 DT SIGNAGE BUILDING 17 SHOW WINDOW REC **Total Load:** 5314 VA 3526 VA 3554 VA Total Amps: 44 A 29 A 30 A G = GFCI (5mA), GE = GF Equipment Protection (30mA), ST = Shunt Trip, A = AFCI Breaker, AG = AFCI / GFCI Combo Breaker, L = Lock On Device, R = Red Mark On Breaker, SW = SWD Rated, T/C=Time Clock Controlled

CURRENT AT THE PANEL AND THE ARC FLASH HAZARD AT THE PANEL IN ACCORDANCE WITH APPLICABLE NEC REQUIREMENTS. TIME CLOCK ALL WORK SHALL BE IN ACCORDANCE WITH UTILITY COMPANY LIGHTING REQUIREMENTS AND LOCAL CODE. CONTRACTOR BID SHALL **CONTACTORS** INCLUDE ALL WORK NECESSARY FOR A FULLY OPERATIONAL PHASE LOSS MOINTOR TOGGLE SWITCH RELAYS EC IS RESPONSIBLE FOR A COMPLETE AND OPERATIONAL SYSTEM IN COMPLIANCE WITH NEC AND ALL STATE AND LOCAL CODES PANEL 'MDP'

4 --

14 -KIT

20 -HVAC

18 -KIT

28 -KIT

KITCHEN HALLWAY

PANEL

'S'

**PANEL** 

'K2'

TWO SETS OF (4) 600KCMIL, #1/0G, #

8IG, IN 4" CONDUITS PROVIDED BY

SHELL CONTRACTOR.

PANEL

'IGP'

PANEL

'LP'

**PANEL** 

'K1'

12

22

28

30

PANEL TOTALS

ONE-PIECE POWER DISTRIBUTION CENTER PURCHASED FROM INFINITY INDUSTRIAL. (TEL. 727-216-6416) PROVIDED BY PANERA. SEE THE SUPPLIER'S SHOP DRAWINGS FOR DETAILS AND SPECIFIC INFORMATION ABOUT THE POWER DISTRIBUTION CENTER. THE POWER DISTRIBUTION CENTER CONTAINS PANELS MDP, K1, K2, IGP, S AND LP. THE POWER DISTRIBUTION CENTER ALSO CONTAINS THE HVAC CONTROLS. TVSS. LIGHTING CONTROLS. TIME CLOCK. CONTACTORS AND RELAYS FOR THE CONTROLS OF INTERIOR AND THE EXTERIOR LIGHTING AND SIGNAGE. INSTALLED AND ENERGIZED BY CONTRACTOR.

PANELS SHALL BE LABELED TO IDENTIFY THE AVAILABLE FAULT

**Branch Panel: K1** 

-R... 1 RESTROOM REC

-KIT 3 EQ 53M

-KIT 7 EQ 48F

-KIT 11 EQ 52A

-KIT 13 EQ 53M

-KIT 15 EQ 85B

-KIT 19 EQ 85H

-KIT 23 EQ 85K

-KIT 25 EQ 48A

-KIT 33 EQ 61 (FUTURE)

-KIT 41 BAKERY HEAT SHELF #085D 20 A G

-R... 37 CONV. REC.

-- 17 --

-KIT 5 85G

Location: Supply From: MDP Mounting: SURFACE

Enclosure: NEMA 1

Volts: 120/208 Wye Phases: 3 Wires: 4

20 A G 1 600 VA 1200 VA 1 G 20 A EQ 55C

2200 VA 960 VA

516 VA 500 VA

17470 VA

Volts: 120/208 Wye

Phases: 3

Wires: 4

600 VA 540 VA

600 VA 360 VA

540 VA | 1000 VA |

13280 VA

118 A

20 A 1 7200 VA 1000 VA 1

20 A G 1 480 VA 1080 VA 1 G 20 A KD1 KD13

20 A G 1 720 VA 720 VA 1 G 20 A KD3 KD4

200 VA 500 VA 1 G 20 A #55GHR

1310 VA 2200 VA 2 30 A EQ 61

176 VA 1080 VA 1 G 20 A #53K

636 VA -- 1 -- -

1200 VA 4160 VA --

500 VA

17634 VA

147 A

840 VA 1800 VA 1 G 20 A EQ 83A

2 20 A EF-2

1 360 VA 468 VA

20 A G 2 1310 VA 1508 VA

-- -- 4160 VA 4160 VA

-- -- 176 VA 180 VA

20 A G 1 888 VA 2316 VA

20 A G 1 1200 VA 1508 VA

50 A 2 4160 VA 2200 VA

20 A 3 176 VA 0 VA

20 A 1 360 VA 960 VA

20 A 1 500 VA 612 VA

20 A G 1

Total Load: 17260 VA

20 A G 1 3600 VA 540 VA

20 A G 1 1080 VA 1000 VA

Total Load: 8500 VA

Total Amps:

180 VA

78 A

20 A G 1

1 720 VA 832 VA

30 A 2

Total Amps:

Location: KITCHEN-3 41-3

-KIT 7 CREDIT CARD READER 37 20 A G 1 360 VA 180 VA

Supply From: MDP

Mounting: SURFACE

**Enclosure: NEMA 1** 

A.I.C. Rating: 65/22K SERIES RATED Mains Type: Mains Rating: 225 A MCB Rating: 0 A

50 A EQ 85H

20 A #76C

20 A #76C

2200 VA 832 VA 2 15 A PROOFER CONDENSER

1 20 A EQ 102 AIR CURTAIN

20 A IRRIGATION

DOOR ALARM

A.I.C. Rating: 65/22K SERIES RATED

Mains Type:

Mains Rating: 100 A

MCB Rating: 0 A

1 G 20 A OFFICE REC

20 A DRIVE THRU

20 A MENU BOARD

20 A HEADSET CHARGER

A.I.C. Rating: 65/22K SERIES RATED

Mains Type:

1 | G | 20 A | EQ 42C

1 G 20 A EQ 55T

2 20 A EQ 63C FUTURE

5148 VA

43 A

1404 VA 1404 VA 2 20 A EQ 63C

Mains Rating: 100 A MCB Rating: 0 A

1 G 20 A EQ 31

360 VA 180 VA 1 G 20 A CASH REGISTER #030F

1 20 A DT CAMERAS

0 VA 180 VA 1 20 A IT REC

2720 VA

23 A

180 VA 500 VA 1 20 A EQ 407

180 VA 360 VA 1 G 20 A OFFICE REC #031

2 -KIT

SYSTEM: G4 (ARIA)

**Bakery-Cafe:** 

Project Team:

4 -KIT

6 -KIT

8 -R...

12 -KIT

14 -KIT

26 -M.. 28 -R...

30 -KIT

32 -KIT

34 -KIT

36 -H...

46 -M..

DE MA ND 2 -R...

4 -KIT

10 -KIT

14 -KIT

18 -KIT

4 -KIT

6 -KIT

8 -KIT

12 -KIT

16 -KIT

LK ARCHITECTURE. INC.


T 316.268.0230 F 316.268.0205 **Architecture** · **Engineering** · **Planning · Interior Design** 

**Landscape Architecture** 

345 RIVERVIEW,

**WICHITA, KS 67203** 

Professional Seal:

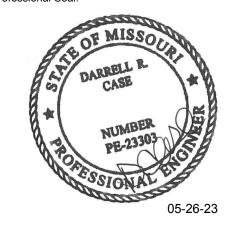

Project Title:

**)6** ST 64086 **40** \S\S ikery 10 NE ES SU 16 -KIT **3ak** 41(

**m** ~

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No.	Description	Date
1	PERMIT SET - TI	7/18/2022
2	TI UPDATES	9/22/2022
3	CONSTRUCTION SET	11/09/2022
4	OWNER REVISION	02/03/2023

PANEL SCHEDULES **AND ONE-LINE DIAGRAM** Project Number:

LKA-MO-01-22 07/05/2022 DPM:

EQ 25D G = GFCI (5mA), GE = GF Equipment Protection (30mA), ST = Shunt Trip, A = AFCI Breaker, AG = AFCI / GFCI Combo Breaker, L = Lock On Device, R = Red Mark On Breaker, SW = SWD Rated **Branch Panel: IGP** Notes: ISOLATED GROUND BAR . | ND | 6 Li... 8 Li... ND L -KIT 1 KD12 -KIT 3 EQ 30F -KIT 5 EQ 461

-R... 27 OFFICE REC -- 29 SPARE G = GFCI (5mA), GE = GF Equipment Protection (30mA), ST = Shunt Trip, A = AFCI Breaker, AG = AFCI / GFCI Combo Breaker, L = Lock On Device, R = Red Mark On Breaker, SW = SWD Rated

-KIT 9 CASH REGISTER #030,

-KIT 13 CASH REGISTER #030

-KIT 11 TABLET KIOSK

-KIT 15 KD2,11,5,14

-KIT 21 MENU BOARD

-R... 17 EQ 128

-KIT 23 FAX

-KIT 19 CWS, 301

**Branch Panel: S** Location: UTILITY 48 Supply From: MDP

**Volts:** 120/208 Wye Phases: 3

-- -- 1144 VA 1116 VA 1 G 20 A EQ 54

20 A 1 1 1080 VA 180 VA 1 G 20 A EQ 55C

1404 VA 1404 VA

1404 VA | 300 VA |

6772 VA

59 A

Mounting: SURFACE Enclosure: NEMA 1

2 1144 VA 840 VA

63 A

20 A G 1 1080 VA 1404 VA

20 A 2

-KIT 1 EQ 64C -KIT 5 EQ 53F -KIT 7 EQ 53F -KIT 9 EQ 63C FUTURE -KIT 13 EQ 63C

20 A 2 1404 VA 1404 VA -KIT 17 EQ 81D Total Load: 7276 VA Total Amps:

G = GFCI (5mA), GE = GF Equipment Protection (30mA), ST = Shunt Trip, A = AFCI Breaker, AG = AFCI / GFCI Combo Breaker, L = Lock On Device, R = Red Mark On Breaker, SW = SWD Rated

INFINITY PANEL FURNISHED BY PANERA,

INSTALLED BY EC.

	1 11 11 11 11 11 11 11 11 11 11 11 11 1					
	PUV	VER				
SYMBOL DESCRIPTION						
Ф	DUPLEX RECEPTACLE MOUNTED UNLESS NOTED OTHERWISE	O AT 15"AFF				
#	QUAD PLEX RECEPTACLE MOUN UNLESS NOTED OTHERWISE	ITED AT 15"AFF				
•	DUPLEX ISOLATED GROUND TYP MOUNTED AT 15"AFF UNLESS NO					
<b>+</b>	QUAD PLEX ISOLATED GROUND AT 15"AFF UNLESS NOTED OTHE		CLE MOUNTED			
Ö	DUPLEX GROUND FAULT INTERF	RUPTING TYPE F	RECEPTACLE			
<b>0</b>	JUNCTION BOX					
<b>♦</b>	MOTOR CONNECTION					
ㅁ	DISCONNECT SWITCH					
	SINGLE SECTION PANELBOARD					
<del></del>	BRANCH CIRCUIT WIRING CONC	EALED ABOVE (	CEILING OR IN PARTITION			
#	CIRCUIT HOME RUN					
<b>(A)</b>	VERIFY NEMA CONFIGURATION F	REQUIRED WITH	H EQUIPMENT SUPPLIER			
		CATION	 S			
ROUGH-IN FOR TELEPHONE VOICE LINE MOUNTED AT 15"AFF						
	UNLESS NOTED OTHERWISE  ROUGH-IN FOR TELEPHONE DATA LINE OR DATACOM					
<u> </u>	MOUNTED AT 15"AFF UNLESS NOTED OTHERWISE  EMPTY CONDUIT FOR TELEPHONE CABLES TO BE INSTALLED BY					
-   — 	COMMUNICATINS SUB CONTRACTOR					
——D—— EMPTY CONDUIT FOR DATA CABLES TO BE INSTALLED BY DATA COM SUB CONTRACTOR						
	LIGHTING	CONTRO	DL 			
\$ <sub>oc</sub>	WALL MOUNTED TOGGLE SWITC TECHNOLOGY	CH, OC=OCCUPA	NCY SENSING DUAL			
\$₃	3-WAY WALL MOUNTED TOGGLE	SWITCH				
ф	SLIDING DIMMER SWITCH (LEVIT	ON OR EQUAL)				
	PROGRAMMABLE TIME SWITCH ( LIGHTING CIRCUITS)	(TO CONTROL S	TOREFRONT			
0	OCCUPANCY SENSING CONTROL LAYOUT AND OWNER IN FIELD (L					
<u> </u>	CEILING MOUNTED MOTION SEN	SING CONTROL	, VERIFY LOCATION WITH			
 P	PHOTO SENSING CONTROL, VER					
	ABBREV	IATIONS	<u> </u>			
AFF	ABOVE FINISHED FLOOR	J-BOX	JUNCTION BOX			
A	AMPERE	KW	KILOWATT			
AWG	AMERICAN WIRE GAUGE	NIC	NOT IN CONTRACT			
СВ	CIRCUIT BREAKER	PNL	PANEL			
ELEC	ELECTRICAL	SPECS	SPECIFICATIONS			
EXIST	EXISTING	SW	SWITCH			
EQUIP	EQUIPMENT	TEL	TELEPHONE			
FA	FIRE ALARM	TYP	TYPICAL			
FOIC	FURNISHED BY OWNER, INSTALLED BY ELEC. CONTR.	V	VOLT			
G,GND	GROUND	W	WIRE			
GFI	GROUND FAULT INTERUPTER	WP	WEATHERPROOF			
HP	HORSEPOWER	PH	PHASE			
IG VIF	ISOLATED GROUND  VERIFY IN FIELD	XFMR -	TRANSFORMER			

#### **ELECTRICAL SPECIFICATIONS**

- THE GENERAL CONDITIONS AND SUPPLEMENTARY GENERAL CONDITIONS
   SHALL BE CONSIDERED AS PART OF THIS SPECIFICATION.
- ALL WORK TO BE IN ACCORDANCE WITH THE RULES AND REGULATION OF THE LOCAL AUTHORITIES HAVING JURISDICTION AND THE MOST RECENT EDITION OF NATIONAL ELECTRIC CODE.
- FURNISH ALL MATERIALS, EQUIPMENT, LABOR, & SERVICES REQUIRED FOR THE INSTALLATION OF ALL ELECTRICAL WORK & AS REQUIRED TO PROVIDE A COMPLETE & OPERABLE ELECTRICAL SYSTEM AS INDICATED ON THE DRAWINGS.
- MATERIALS SHALL BE NEW W/ MANUFACTURERS NAME PRINTED THEREON & UNDERWRITERS LABORATORY LISTED. THE SELECTION OF MATERIALS SHALL BE IN STRICT ACCORDANCE W/ THE DRAWINGS AND/OR SPECIFICATIONS. SELECTION OF MATERIALS SHALL BE IN STRICT ACCORDANCE W/ THE DRAWINGS AND/OR SPECIFICATIONS.
- 4. SUBMIT MATERIAL LISTS AND SHOP DRAWINGS FOR MAJOR EQUIPMENT TO THE OWNER'S REPRESENTATIVE FOR REVIEW. SUBMITTALS SHALL BE IN ACCORDANCE WITH GENERAL CONDITIONS AND SHALL BEAR THE STAMP OF THE ELECTRICAL CONTRACTOR SHOWING THAT HE HAS REVIEWED AND APPROVED THEM. LACK OF SUCH CONTRACTOR'S APPROVAL WILL BE CAUSE FOR REJECTION WITHOUT REVIEW BY THE OWNER.
- 5. CONTRACTOR SHALL GUARANTEE WORK INSTALLED UNDER THE CONTRACT TO BE FREE FROM DEFECTIVE WORKMANSHIP & MATERIALS, USUAL WEAR EXCEPTED, & SHOULD ANY SUCH DEFECTS DEVELOP W/IN A PERIOD OF ONE YEAR ACCEPTANCE OF THE BLDG. BY THE YEAR, THIS CONTRACTOR SHALL REPAIR AND/OR REPLACE ANY DEFECTIVE ITEMS & DAMAGE RESULTING FROM FAILURE OF THESE ITEMS, AT NO EXPENSE TO THE OWNER.
- 6. INCIDENTAL ITEMS NOT INDICATED ON THE DRAWINGS, NOR MENTIONED IN THE SPECIFICATIONS, THAT CAN BE LEGITIMATELY & REASONABLE BE INFERRED TO BELONG TO THE WORK DESCRIBED OR BE NECESSARY IN GOOD PRACTICE TO PROVIDE A COMPLETE SYSTEM, SHALL BE FURNISHED & INSTALLED AS THOUGH ITEMIZED HERE IN EVERY DETAIL.
- 7. NOTIFY ARCHITECT IMMEDIATELY OF POSSIBLE CONFLICTS WITH STRUCTURE, MECHANICAL, OR OTHER FEATURES. WHERE JOB CONDITIONS REQUIRE REASONABLE CHANGES IN LOCATIONS & ARRANGEMENT OF INDICATED EQUIP., CONDUIT, OUTLETS, OR WIRING, CONTRACTOR SHALL MAKE SUCH CHANGES WITHOUT COST TO OWNER.
- 8. CONTRACTOR SHALL FILE PLANS WITH AND OBTAIN APPROVALS FROM MUNICIPAL AGENCIES. ALL PERMITS AND CERTIFICATES OF INSPECTION SHALL BE OBTAINED AND PAID FOR BY THE CONTRACTOR.

PERTINENT CERTIFICATES SHALL BE DELIVERED TO THE OWNER'S REPRESENTATIVE, PRIOR TO FINAL BILLING.

ANY FEES ASSOCIATED WITH CONSTRUCTION AND INSPECTION SHALL BE BORNE BY THE CONTRACTOR IN ORDER TO DELIVER TO THE OWNER A FINISHED BUILDING, READY FOR OCCUPANCY AND 100% OPERATION.

9. CONTRACTOR SHALL VISIT SITE PRIOR TO BIDDING. BIDS SHALL SERVE AS EVIDENCE OF KNOWLEDGE OF EXISTING CONDITIONS.

HE SHALL CAREFULLY EXAMINE THE EXISTING CONDITIONS AND LIMITATIONS THEREOF. HE SHALL ASCERTAIN CONDITIONS UNDER WHICH THE WORK MUST BE PERFORMED, INCLUDING THE HANDLING OF MATERIALS, SECURITY AND LIMITING FIELD DIMENSIONS. FURTHER, THIS CONTRACTOR SHALL PROVIDE FIELD VERIFICATION OF LOCATION OF POINTS OF CONNECTION TO LANDLORD'S ELECTRICAL AND TELEPHONE EQUIPMENT AND DISTANCE FROM LEASED SPACE

ANY DISCREPANCIES WITH THE CONSTRUCTION DOCUMENTS DISCOVERED AS A RESULT OF THE AFOREMENTIONED FIELD SURVEY, SHALL BE BROUGHT TO THE ATTENTION OF THE OWNER'S REPRESENTATIVE, PRIOR TO COMMENCING ANY WORK. ANY ADDITIONAL COSTS RESULTING FROM CONTRACTOR'S FAILURE TO DO SO SHALL BE HIS RESPONSIBILITY AND SHALL BE BORNE BY HIM.

- 10. ANY DEVIATION FROM PLANS WITHOUT PRIOR APPROVAL OF THE ARCHITECT SHALL BE CAUSE FOR THE REJECTION OF MATERIALS AND/OR METHODS, AND ANY COST INCURRED TO CORRECT SUCH DEVIATION TO THE SATISFACTION OF THE A/E SHALL BE BORNE BY THE CONTRACTOR.
- 11. THE SUBMISSION OF A PROPOSAL SHALL BE CONSTRUED AS EVIDENCE THAT THE CONTRACTOR HAS FAMILIARIZED HIMSELF WITH THE PLANS AND BUILDING SITE. CLAIMS MADE SUBSEQUENT TO THE PROPOSAL FOR MATERIALS AND LABOR, BECAUSE OF DIFFICULTIES ENCOUNTERED, WILL NOT BE RECOGNIZED IF THEY COULD HAVE BEEN FORSEEN HAD PROPER EXAMINATION BEEN MADE.
- 12. ANY COSTS INCURRED DUE TO LACK OF COOPERATION AMONG THE TRADES SHALL BE BORNE BY THE CONTRACTOR.
- 13. CONTRACTOR SHALL SUBMIT 6 COPIES OF SHOP DRAWINGS TO THE ARCHITECT/ENGINEER FOR APPROVAL FOR ALL EQUIPMENT AND DEVICES INSTALLED.THERE WILL BE NO DRAW UNTIL SHOP DRWGS. HAVE BEEN SUBMITTED & REVIEWED BY ARCH/ENGR..
- 14. THE EQUIPMENT ROUGH-INS AS SHOWN ARE ACCURATE TO THE BEST OF OUR KNOWLEDGE. HOWEVER, IN SOME INSTANCES, THE OWNER OR SUPPLIER MAY SUBSTITUTE OR THE EQUIPMENT MAY VARY FROM WHAT IS SHOWN. THEREFORE, THE CONTRACTOR SHALL VERIFY ALL CRITICAL DIMENSIONS WITH THE OWNER PRIOR TO CONSTRUCTION. FAILURE OF THE CONTRACTOR TO VERIFY THESE DIMENSIONS SHALL PLACE THE RESPONSIBILITY FOR ANY SUB-SEQUENT RELOCATION DIRECTLY UPON THE CONTRACTOR.
- 15. PLAN & INSTALL WORK IN SUCH A MANNER AS TO CONFORM TO THE STRUCTURE, AVOID OBSTRUCTIONS, PRESERVE HEADROOM, & KEEP OPENINGS & PASSAGEWAYS CLEAR
- ELECTRICAL CONTRACTOR SHALL RECORD ALL FIELD CHANGES IN HIS WORK AS THE JOB PROGRESSES; AN ACCURATE RECORD OF ALL WORK AS ACTUALLY INSTALLED.

UPON COMPLETION OF THE WORK AND BEFORE FINAL PAYMENT IS

AUTHORIZED, SHALL TURN OVER TO THE OWNER'S REPRESENTATIVE A RECORD SET OF PRINTS SHOWING THESE CHANGES.

17. THIS CONTRACTOR SHALL DO ALL CUTTING, CHASING, OR CHANNELING AND PATCHING REQUIRED FOR ANY WORK HEREIN SPECIFIED.

ALL OPENINGS THROUGH STRUCTURALLY SUPPORTED SLABS MUST BE COREBORED, SLEEVED, GROUTED, SEALED AND MADE WATERPROOF. SLEEVES MUST EXTEND AT LEAST 2" AFF.

ALL SLEEVES, OPENINGS, ETC. THROUGH FIRE RATED WALLS AND FLOORS SHALL BE SEALED AFTER CONDUIT INSTALLATION TO RETAIN FIRE RATING.

18. ALL ELECTRICAL WORK SHALL BE INSTALLED SO AS TO BE READILY ACCESSIBLE FOR OPERATING, SERVICING, MAINTAINING AND REPAIR.

HANGERS SHALL INCLUDE ALL MISCELLANEOUS STEEL, SUCH AS CHANNELS, RODS, ETC., NECESSARY FOR THE INSTALLATION OF WORK AND SHALL BE SECURED TO THE BUILDING STRUCTURE, NOT TO PIPING OR DUCTWORK.

ALL CONDUIT SHALL BE CONCEALED WHERE POSSIBLE. EXPOSED CONDUIT SHALL BE RUN IN STRAIGHT LINES PARALLEL WITH OR AT RIGHT ANGLES TO COLUMN LINES AND SEPARATED AT LEAST 3" FROM WATER LINES WHEREVER THEY RUN ALONG SIDE OR ACROSS SUCH LINES.

19. EVERY PART OF THE INSTALLATION SHALL BE TESTED, OPERATED AND LEFT IN PERFECT WORKING ORDER.

TEST ALL WIRES AND CABLES INSTALLED UNDER THIS CONTRACT WITH A 1,000 VOLT MEGOHM METER. ANY READINGS THAT ARE LOWER THAN REQUIRED BY GOOD PRACTICE OR APPLICABLE CODES, PROMPTLY REPLACE THE MATERIALS OR EQUIPMENT INVOLVED.

SHOULD TESTING REVEAL ANY OTHER DEFECTS, PROMPTLY CORRECT SUCH DEFECTS AND RERUN TESTS UNTIL THE ENTIRE INSTALLATION IS SATISFACTORY IN ALL RESPECTS.

- 20. ALL ITEMS IN THE NOTES, SCHEDULES AND LEGEND MAY NOT NECESSARILY APPEAR ON THESE DRAWINGS.
- 21. TWO COPIES OF OPERATION AND MAINTENANCE MANUALS FOR THE EQUIPMENT HEREIN INSTALLED SHALL BE GIVEN TO THE OWNER PRIOR TO ACCEPTANCE OF THE BUILDING FOR OCCUPANCY.
- 22. GUARANTEE:

CONTRACTOR IS TO GUARANTEE ALL WORK FOR A PERIOD OF ONE YEAR AFTER THE DATE OF ACCEPTANCE OF THE PROJECT BY THE OWNER. IT IS UNDERSTOOD BY HIS ACCEPTANCE OF THE CONTRACT THAT THIS CONTRACTOR WILL MAKE GOOD ANY AND ALL WORK WHICH IN ANY WAY HAS BECOME DEFECTIVE AS TO THE QUALITY OF MATERIALS AND WORKMANSHIP FOR ANY CAUSE OTHER THAN ORDINARY WEAR AND TEAR.

FOR THE SAME PERIOD, ELECTRICAL CONTRACTOR SHALL BE RESPONSIBLE FOR ANY DAMAGE TO THE PREMISES CAUSED BY DEFECTS IN WORKMANSHIP OR IN THE WORK OR EQUIPMENT FURNISHED AND/OR INSTALLED BY HIM.

- 23. THE CONTRACTOR, BEFORE FINAL ACCEPTANCE BY THE OWNER WILL BE GRANTED, SHALL CLEAN ALL LIGHTING FIXTURES, DEVICE PLATES, SERVICE FITTINGS AND OTHER ITEMS FURNISHED UNDER THIS CONTRACT. HE SHALL INSURE THAT ALL DIRECTORIES ARE IN PLACE WITH COMPLETED OR REVISED SCHEDULES AND ALL IDENTIFICATIONS AND MARKINGS OF EQUIPMENT, CABLES AND OTHER ITEMS ARE COMPLETED.
- 24. THIS CONTRACTOR SHALL COORDINATE SEQUENCE OF WORK WITH ALL OTHER TRADES. CONTRACTOR SHALL VERIFY VOLTAGE OF MECHANICAL EQUIPMENT AND FLUORESCENT FIXTURE BALLASTS, PRIOR COMMENCING ANY WORK.
- NO REMOVALS SHALL BE MADE WITHOUT OWNER'S APPROVAL. ALL EXISTING EQUIPMENT, MATERIALS, ETC. THAT ARE NOT TO BE REUSED SHALL BE REMOVED COMPLETELY AND DISPOSED OF BY THIS CONTRACTOR.
- 25. IT SHALL BE THIS CONTRACTOR'S RESPONSIBILITY, PRIOR TO ANY INDIVIDUAL CIRCUIT'S INSTALLATION, TO VERIFY WITH ALL OTHER TRADES CONCERNED THAT THE CIRCUIT WITH DEVICES AS DRAWN IS ADEQUATE IN SIZE AND MAKE-UP FOR THE MECHANICAL AND/OR KITCHEN EQUIPMENT TO BE INSTALLED. IF ANY CONFLICT IN VOLTAGE, PHASE OR LOAD IS ENCOUNTERED WHICH WOULD ALTER THE CIRCUIT SIZE, THIS CONTRACTOR SHALL NOTIFY THE ENGINEER OR OWNER IMMEDIATELY. FAILURE TO DO SO SHALL PLACE THE RESPONSIBILITY FOR ANY SUBSEQUENT CIRCUIT CHANGE DIRECTLY UPON THE CONTRACTOR
- 26. REFER TO THE MECHANICAL DRAWINGS FOR THE LOCATION OF THER-MOSTATS, UNITS AND OTHER SPECIAL EQUIPMENT. ELECTRICAL CONTRACTOR IS RESPONSIBLE FOR THE INSTALLATION OF ALL CONDUITS, JUNCTION BOXES AND DISCONNECT SWITCHES, THERMOSTAT AND CONTROL WIRING.
- 27. THIS CONTRACTOR SHALL MAKE ARRANGEMENTS FOR TEMPORARY POWER AND SHALL PAY THE COST FOR THE UTILITY CONNECTION AND SHALL BE RESPONSIBLE FOR THE PROPER MAINTENANCE OF THE TEMPORARY WORK AND FOR THE REMOVAL OF SAME

CONTRACTOR SHALL PAY ALL UTILITY CHARGES IN CONNECTION WITH THE TEMPORARY POWER

CONTRACTOR SHALL PROVIDE GROUND FAULT PROTECTION FOR ALL POWER EQUIPMENT USED ON THE PREMISES DURING CONSTRUCTION.

28. GENERAL SCOPE OF WORK

CONTRACTOR SHALL FURNISH ALL LABOR, MATERIALS, SUPPLIES, EQUIPMENT AND FEES REQUIRED TO COMPLETELY INSTALL, TEST AND PLACE THE HEREIN SPECIFIED EQUIPMENT, COMPONENTS, CONTROLS, AND SYSTEMS IN SERVICE.

COMPLETE POWER AND LIGHTING DISTRIBUTION SYSTEMS INCLUDING ALL PANELS AND COMPLETE BRANCH CIRCUIT WIRING SYSTEM

TEMPORARY ELECTRICAL SERVICE AS REQUIRED FOR CONSTRUCTION

COMPLETE LIGHTING FIXTURE INSTALLATION

COMPLETE UTILITY MOTOR WIRING SYSTEM (EXCEPT AS NOTED)

COMPLETE TELEPHONE CONDUIT SYSTEM INCLUDING CONDUIT FROM POINT OF CONNECTION TO UTILITY COMPANY SERVICE AND ALL TERMINAL DEVICES, BOXES, CONDUIT, PLATES, ETC.

PROVISIONS FOR FIRE ALARM SYSTEM AS REQUIRED BY CODE

WIRING AND FINAL CONNECTION TO ALL SIGNS AND GRAPHICS
TESTING OF ALL CABLES AND CIRCUIT WIRING AFTER INSTALLATION

WARRANTY OF ALL WORK FOR A PERIOD OF ONE YEAR FROM DATE OF PROJECT

29. ELECTRICAL SERVICE

PROVIDE ELECTRICAL AS INDICATED ON THE DRAWING.

TESTING OF ALL ELECTRICAL EQUIPMENT

ALL WORK NOT SPECIFICALLY NOTED AS BEING BY THE LANDLORD OR THE POWER COMPANY SHALL BE PROVIDED BY THE ELECTRICAL CONTRACTOR

CLOSELY COORDINATE ENTIRE INSTALLATION WITH THE POWER COMPANY.

MALL/SHOPPING CENTER POWER SOURCE. THE SERVICE EQUIPMENT SHALL MEET OR

CONTRACTOR SHALL MAKE ARRANGEMENTS WITH THE LOCAL UTILITY FOR INSTALLATION OF METERING.

THE CONTRACTOR SHALL BE RESPONSIBLE TO VERIFY THE AVAILABLE SHORT CIRCUIT

CURRENT AT THE SUPPLY TERMINALS FROM THE POWER COMPANY &/OR

EXCEED THIS RATING PER N.E.C.

30. THE CONTRACTOR SHALL MAKE ARRANGEMENTS WITH THE LOCAL TELEPHONE UTILITY COMPANY FOR TELEPHONE SERVICE TO THE SPACE, CONDUIT SYSTEM FOR TELEPHONE DISTRIBUTION TO THE LEASED PREMISES SHALL BE PROVIDED WHERE

REQUIRED FOR UTILITY COMPANY WIRES.

COORDINATE INSTALLATION OF TELEPHONE WORK AND INSTALL ALL CONDUIT FOR TELEPHONE SYSTEM.

OUTLET BOXES SHALL BE 4" SQUARE MINIMUM WITH SINGLE DEVICE COVER AND TELEPHONE PLATE.

PROVIDE INTERIOR TYPE 4-D PLYWOOD 24" X 24" TO SERVE AS TELEPHONE TERMINAL BOARD

GROUNDING FOR ALL EQUIPMENT AND STRUCTURES. A GOOD MECHANICAL AND ELECTRICAL CONNECTION SHALL BE MADE WITH APPROVED GROUNDING CONNECTORS.

ELECTRICAL SYSTEM AND EQUIPMENT GROUNDS SHALL COMPLY WITH ALL LOCAL, STATE AND NEC CODES AND REGULATIONS.

31. THIS CONTRACTOR SHALL PROVIDE, INSTALL AND CONNECT A COMPLETE SYSTEM OF

PANELS, CONDUIT SYSTEMS, MOTOR FRAMES, LIGHTING FIXTURES AND OTHER EQUIPMENT THAT ARE A PART OF THIS INSTALLATION SHALL BE SECURELY GROUNDED BOTH MECHANICALLY AND ELECTRICALLY IN ACCORDANCE WITH ALL

MAIN GROUNDING SYSTEM SHALL BE SIZED TO CONFORM WITH SECTION 250, TABLE 250-94 OF THE NATIONAL ELECTRICAL CODE. PROVIDE CONDUIT TO PROTECT GROUND WIRE FROM DAMAGE TO AN AREA 6 FT. ABOVE FLOOR.

MAKE ALL JOINTS AND CONNECTIONS OF THE CONDUIT SYSTEM TIGHT TO MAINTAIN CONTINUITY OF MECHANICAL AND ELECTRICAL GROUND THROUGHOUT ENTIRE SYSTEM.

GROUND ALL 3 WIRE RECEPTACLES TO THE OUTLET BOXES.

GROUND NEUTRAL FROM THE TRANSFORMER CONNECTED TO WATER LINE.

GROUND CONDUCTOR SHALL BE SUPPLIED IN ALL NON-METALLIC CONDUIT.

32 IF REQUIRED: PROVIDE DRY-TYPE TRANSFORMER WHICH SHALL BE ENCLOSED

VENTILATED TYPE WITH KVA AND VOLTAGE RATINGS AS CALLED FOR ON THE DRAWING AS MANUFACTURED BY SQUARE-D OR EQUAL.

TRANSFORMER SHALL HAVE A MINIMUM OF 150 DEGREE, CLASS H INSULATION AND A

TRANSFORMER SHALL HAVE A MINIMUM OF 150 DEGREE, CLASS H INSULATION AND A MINIMUM OF (4) 2-1/2% TAPS BELOW AND (2) 2-1/2% TAPS ABOVE RATED PRIMARY VOLTAGE.

SOUND LEVEL SHALL BE LOW AND INSTALLATION SHALL INCLUDE VIBRATION DAMPENING MOUNTS AND FLEXIBLE STEEL CONDUIT FOR PRIMARY AND SECONDARY

33. LIGHTING FIXTURES:

THE CONTRACTOR SHALL PROVIDE A NEW LIGHTING FIXTURE OF THE TYPE SPECIFIED FOR EACH LIGHTING OUTLET SHOWN WITH COMPLETE LAMPS OR TUBES. ALL FIXTURES SHALL BE HUNG AND MOUNTED IN PLACE, PROPERLY WIRED, TESTED AND

CONTRACTOR SHALL VERIFY LOCATION OF ALL PARKING LOT LIGHTS, MONUMENT SIGNS, AND PYLON SIGNS ON INDIVIDUAL SITE PLAN.

34. PANELBOARDS AND BREAKERS SHALL BE BY SQUARE-D OR EQUAL

PANEL SHALL BE CIRCUITED SP THAT THE LOAD IS DISTRIBUTED EVENLY
ACROSS ALL THREE PHASES.

LEFT READY FOR OPERATION.

ALL PANELBOARDS AND EMERGENCY LIGHTING DISCONNECT SWITCHES SHALL BE LABELED WITH RESPECT TO THEIR TITLE, VOLTAGE AND PHASE; I.E. PANEL "A" 120/208/3  $\square$ . LABEL SHALL BE PHENOLIC SHALL BE PERMANENTLY FIXED TO THE EQUIPMENT.

35. LIGHTING PANELBOARD SHALL BE 3-PHASE, 4-WIRE DISTRIBUTED PHASE TYPE W/SOLID NEUTRAL GROUND LUG, GROUND BUS AND ALL BREAKERS SHALL BE BOLTED TYPE, THERMAL MAGNETIC WITH ALL TWO OR THREE POLE BREAKERS HAVING COMMON TRIP.

CIRCUIT BREAKERS SHALL BE RATED FOR MINIMUM 10,000 AMP SYMMETRICAL SHORT CIRCUIT AT 120/208V.

CIRCUIT BREAKERS SERVING LIGHTING CIRCUITS SHALL BE RATED FOR SWITCH SERVICE.

36. WIRING DEVICES:

WALL SWITCHES, SINGLE POLE, DOUBLE POLE, AND THREE WAY SHALL BE GENERAL DUTY, FLUSH, TOGGLE SWITCHES; SPECIFICATION GRADE, 20A, 120/277V, WITH SCREW TERMINALS: MANUFACTURERS SHALL BE HUBBELL, BRYANT, PASS & SEYMORE, OR LEVITRON.

GENERAL DUTY DUPLEX RECEPTACLES SHALL BE 2-POLE, 3-WIRE GROUNDING TYPE, SPECIFICATION GRADE, 20A, 125V, NEMA 5-20R UNLESS OTHERWISE INDICATED. MANUFACTURERS SHALL BE HUBBELL, BRYANT, PASS & SEYMORE, OR LEVITED N.

GROUND FAULT INTERRUPTER RECEPTACLE SHALL BE GENERAL DUTY, DUPLEX RECEPTACLES, GROUND FAULT CIRCUIT INTERRUPTER, DOWNSTREAM RECEPTACLES ON A SINGLE CIRCUIT, GROUNDING TYPE UL-RATED CLASS A, GROUP 1, 20A, 120V, 60 HZ; WITH SOLID-STATE GROUND FAULT SENDING AND SIGNALING; WITH 5 MILLIAMPERES GROUND-FAULT TRIP LEVEL; IN NEMA 5-15R CONFIGURATION. MANUFACTURERS SHALL BE HUBBELL, BRYANT, PASS &

DUPLEX ISOLATED GROUND TYPE RECEPTACLE SHALL BE 2-POLE, 4-WIRE, 15A STRAIGHT BLADE DEVICE WITH SEPARATE ISOLATED GROUND AND BUILDING GROUND CONNECTIONS, IN NEMA 5-15R CONFIGURATION, AS MANUFACTURED BY HUBBELL IG-5362.

WIRING DEVICE ACCESSORIES INCLUDING ALL WALL PLATES SHALL BE PROVIDED AT EACH DEVICE. WALL PLATES SHALL BE SAME COLOR AS DEVICE AND MANUFACTURED AS A COMPANION TO THE DEVICE.

ANY ELECTRICAL OUTLETS WITHIN 6 FEET OF A SINK SHALL BE GFI PROTECTED. PROVIDE EITHER INDIVIDUAL GFI DEVICES OR GFI CIRCUIT BREAKERS, UNLESS SPECIFICALLY NOTED ON THE DRAWINGS OR SCHEDULES.

PROVIDE A 120 VOLT RECEPTACLE WITHIN 25 FEET OF ALL HVAC EQUIPMENT

ALL EXTERIOR RECEPTACLES AND DEVICES SHALL BE WEATHERPROOF
ELECTRICAL DEVICES, DISCONNECT SWITCHES, ETC. SHALL BE SUPPORTED

INDEPENDENT OF & ISOLATED FROM EQUIP. VIBRATIONS.

37. PROVIDE SAFETY AND DISCONNECT SWITCHES, FUSED OR NON-FUSED AS REQUIRED BY CODE OR SHOWN ON DRAWINGS. SWITCHES SHALL BE SQUARE-D, GENERAL ELECTRICAL, OR EQUAL.

FURNISH AND INSTALL DUAL ELEMENT CURRENT LIMITING FUSES OF TYPE AND

AMPICITY DESIGNED TO PROTECT SYSTEMS AGAINST AVAILABLE SHORT

CIRCUIT FAULT CURRENT.

38. COORDINATE ALL EQUIP. CONNECTIONS W/EQUIP. SUPPLIER PRIOR TO ROUGH-IN. PROVIDE ADDITION FUSED DISCONNECT SWITCHES & CONTROLS, IF

OVERCURRENT PROTECTION OR CONTROLS ARE NOT INTEGRAL W/UNITS.

ALL ELECTRICAL EQUIP. ON ROOF OR OUTSIDE THE BLDG. SHALL BE IN NEMA-3R OR NEMA-4 ENCLOSURES.

ALL EQUIP. SHALL BE FUSE SIZED PER MANUF. RECOMMENDATIONS & U.L. APPROVAL.

ALL VIBRATING EQUIP. CONN. SHALL BE SEAL TYPE FLEX, 30" MAX.

STARTERS AND RELATED WIRING SHALL BE INSTALLED BY ELECTRICAL

CONTRACTOR. OVERLOAD UNITS SHALL BE INSTALLED AS PER NAME PLATE

CONTRACTOR. OVERLOAD UNITS SHALL BE INSTALLED AS PER NAME PLATE DATA ON EQUIPMENT. EXCEPT FOR SUCH ITEMS AS ARE NORMALLY SUPPLIES WITH STARTERS INSTALLED (HVAC UNITS, DISHWASHERS ETC.). AT THEIR POINT OF MANUFACTURE, ALL STARTERS SHALL BE SUPPLIED AND INSTALLED BY THE ELECTRICAL CONTRACTOR. THE ELECTRICAL CONTRACTOR WILL MOUNT ALL SUCH STARTERS, AS DIRECTED, FURNISHING SUPPORTING STRUCTURES WHERE NECESSARY.

ALL REMOTE EQUIPMENT ON ROOF OR GROUNDS SHALL HAVE A DISCONNECT SWITCH AT EACH PIECE OF EQUIPMENT. FURNISH FUSED DISCONNECTS AS REQUIRED BY N.E.C.

FULL LOAD AMPS (FLA) SIZES ARE BASED ON SPECIFIED EQUIP. DATA. CONTRACTOR SHALL VERIFY NAMEPLATE FLA OF EQUIP. SUPPLIED & COORDINATE ACCORDINGLY PER EQUIP. SUPPLIERS RECOMMENDATIONS.

39. CONDUIT SHALL BE STANDARD STEEL, RIGID, IMC OR EMT (THIN WALL) ACCORDING TO LOCAL CODE.

ALL CONDUIT & J-BOXES SHOWN SHALL BE CONCEALED WHEN POSSIBLE. WHEN NOT POSSIBLE, CONDUIT & J-BOXES MAY BE SURFACE MOUNTED W/PERMISSION OF THE ARCHITECT.

INSULATE ALL CONDUIT PASSING THROUGH WALK-IN COOLER, FILL AROUND CONDUIT WITH DUCT-IN SEAL WHERE IT PASSES THROUGH COOLER WALL OR CEILING.

ALL EXTERIOR CONDUIT FOR WIRING SHOULD BE MINIMIZED BY ROUTING IN CEILING SPACE. NO EXTERIOR CONDUIT WILL BE ACCEPTED, UNLESS OTHERWISE NOTED.

PAINTING OR ELECTRICAL CONDUITS, ETC., IF REQUIRED, WILL BE BY THE GENERAL CONTRACTOR.

- 40. RACEWAYS SHALL BE SURFACE METAL TYPE OF THE SIZE AND CHANNEL REQUIRED FOR SERVICE, CONSTRUCTED OF GALVANIZED STEEL WITH SNAP-ON COVERS, WITH 1/8" MOUNTING SCREW KNOCKOUTS IN BASE APPROXIMATELY 8" O.C. PROVIDE FITTINGS INDICATED WHICH MATCH AND MATE WITH RACEWAY. FINISH WITH MANUFACTURER'S STANDARD PRIME COATING SUITABLE FOR
- 41. OUTLET BOXES AND COVERS SHALL BE ONE PIECE, GALVANIZED STEEL
  JUNCTION BOXES, PULL BOXES AND COVERS SHALL BE GALVANIZED STEEL,
- 42. ALL FEEDERS & BRANCH CIRCUITS SHALL BE THHN/TWHN (90° C). DESIGN IS BASED ON COPPER CONDUCTORS & ALL BRANCH CIRCUIT WIRING SHALL BE COPPER. ALL WIRING SHALL BE IN CONDUIT OR MC TYPE.
- ALL WIRE AND CABLE SHALL BE NEW AND SHALL BE BROUGHT TO THE SITE IN UNBROKEN PACKAGES.

ADDITIONAL CONDUCTOR SPECIFICATIONS:

#10 AND SMALLER - SOLID WITH SINGLE BRAID.


#8 AND LARGER - STRANDED WITH AT LEAST DOUBLE BRAID.

MINIMUM WIRE SIZE SHALL BE #12 (#14 MAY BE USED FOR CONTROLS)

WIRES SHALL BE COLOR CODED IN KEEPING WITH NEC STANDARDS

PROVIDE IMC FOR FEEDER CONDUIT WHERE INSTALLED ABOVE GRADE. FITTINGS SHALL BE STEEL, THREADED, SET SCREW TYPE W/INSULATED THROATS. FURNISH EMT CONDUIT OP BX OR MC FOR INTERIOR WIRING NOT SUBJECT TO PHYSICAL DAMAGE, MIN. CONDUIT SIZE SHALL BE 1/2 UNLESS SPECIFICALLY NOTED OTHERWISE. CONDUIT SHALL BE CONCEALED WHEREVER POSSIBLE & SHALL RUN PARALLEL OR PERPENDICULAR TO BLDG. WALLS OR CEILING. PCV SCHEDULE 40 CONDUIT MAY BE USED FOR UTILITY FEEDERS WHERE BURIED UNDERGROUND. SEE ADDITIONAL RATES ON ELECTRICAL SERVICE SCHEMATIC.

- A SEPARATE GREEN INSULATED EQUIP. GROUNDED CONDUCTOR (BOND) SHALL BE INSTALLED W/IN EVERY RACEWAY.
- WIRING SHOWN IN THE PANEL SCHEDULE IS THE MINIMUM REQUIRED. RUNS IN EXCESS OF 90'-0" (ONE-WAY) SHALL BE SIZED PER THE N.E.C. MAXIMUM 2% V.D.
- 43. TEST ELECTRICAL SYSTEM FOR SHORT CIRCUITS & MEGGAR TEST FEEDERS & BRANCH CIRCUIT WIRING. INSURE LOW IMPEDANCE GROUND PATH SYSTEM.
- 44. FINALLY: IT IS THE INTENT THAT THE FOREGOING WORK SHALL BE COMPLETE IN EVERY RESPECT AND THAT ANY MATERIAL OR WORK NOT SPECIFICALLY MENTIONED OR SHOWN ON THE DRAWINGS, BUT NECESSARY TO FULLY COMPLETE THE WORK SHALL BE FURNISHED.
  - THE LOCATION OF THE RECEPTACLES AND FIXTURES SHOWN ON THE DRAWING IS APPROXIMATE AND THE OWNER SHALL HAVE THE RIGHT TO RELOCATE ANY DEVICES BEFORE THEY ARE INSTALLED WITHOUT ANY ADDITIONAL COSTS.

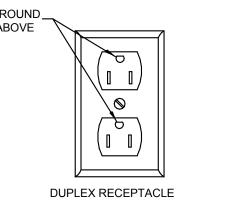


DUPLEX RECEPTACLE

@ 37" AND BELOW

RECEPTACLE GROUND LOCATION

DETIAL

NTS

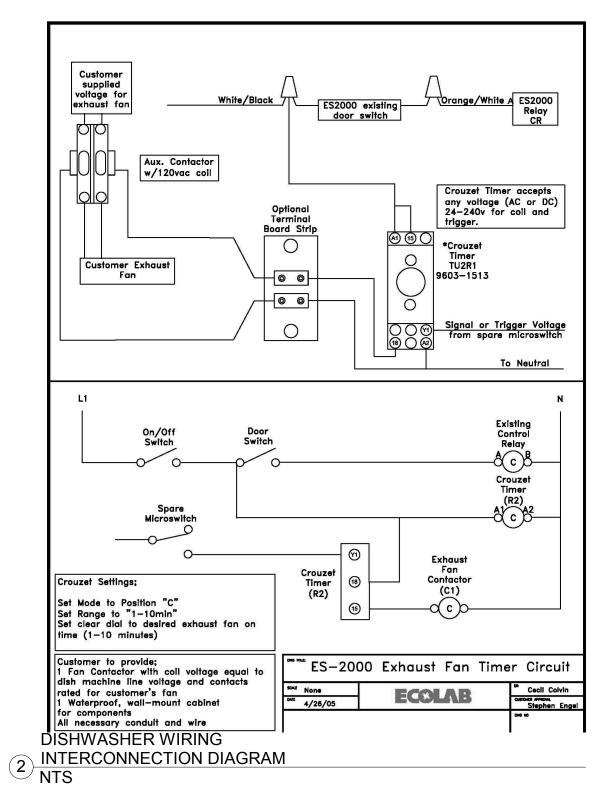

GROUND
BELOW

LK ARCHITECTURE, INC.

345 RIVERVIEW,
WICHITA, KS 67203
T 316.268.0230


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Professional Seal:

**Bakery-Cafe:** 

SYSTEM: G4 (ARIA)



Project Title:

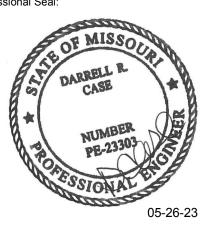akery Cafe#2406 410 NE DOUGLAS ST EES SUMMIT, MO 640

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CASE

Engineering Inc.

 No.
 Description
 Date

 1
 PERMIT SET - TI
 7/18/2022

 3
 CONSTRUCTION SET
 11/09/2022

ELECTRICAL
SPECIFICATIONS
Project Number: Sheet Number:
LKA-MO-01-22

Project Number:

LKA-MO-01-22

Drawn By:

MBN

Issue Date:

07/05/2022

DPM:


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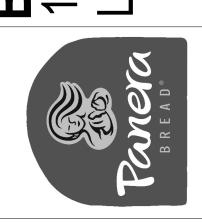
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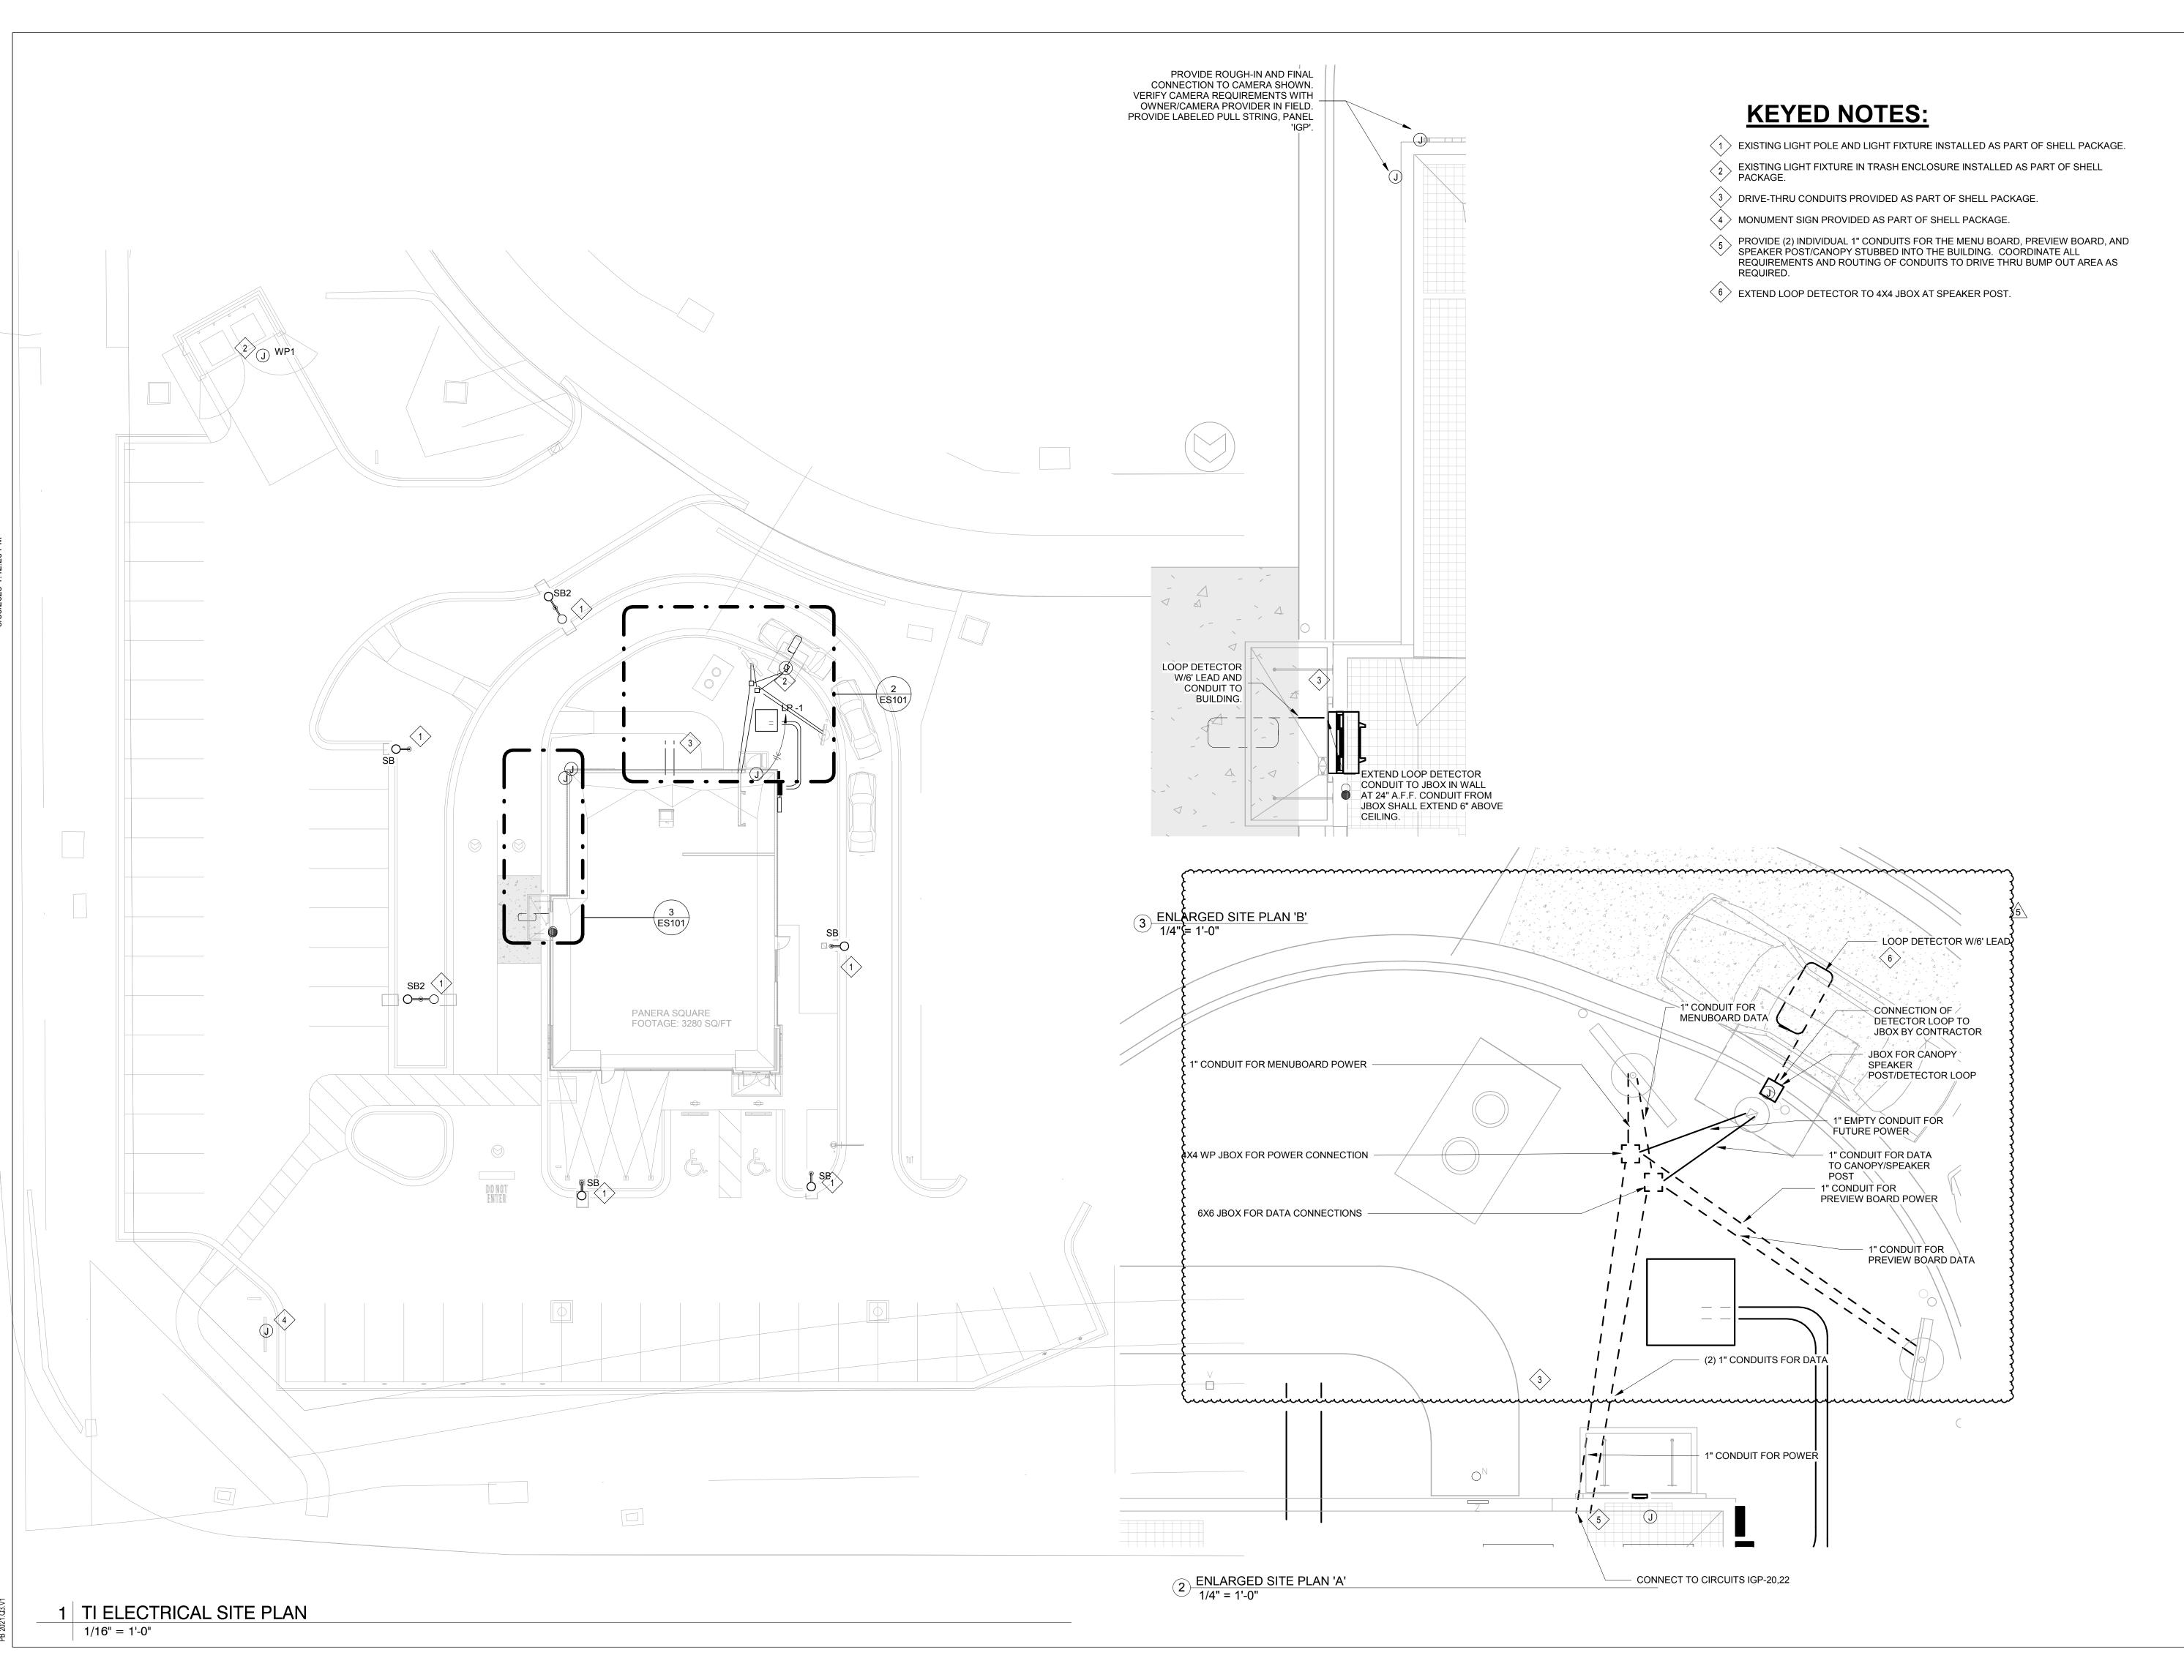
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T 636.349.1600 F 636.349.1730 St. Louis, MO 63026 CERTIFICATE OF AUTHORITY NO. 001498

No.	Description	Date
1	PERMIT SET - TI	7/18/2022
2	TI UPDATES	9/22/2022
3	CONSTRUCTION SET	11/09/2022
5	MEP UPDATES	05/26/2023

**ELEVATIONS** 

LKA-MO-01-22

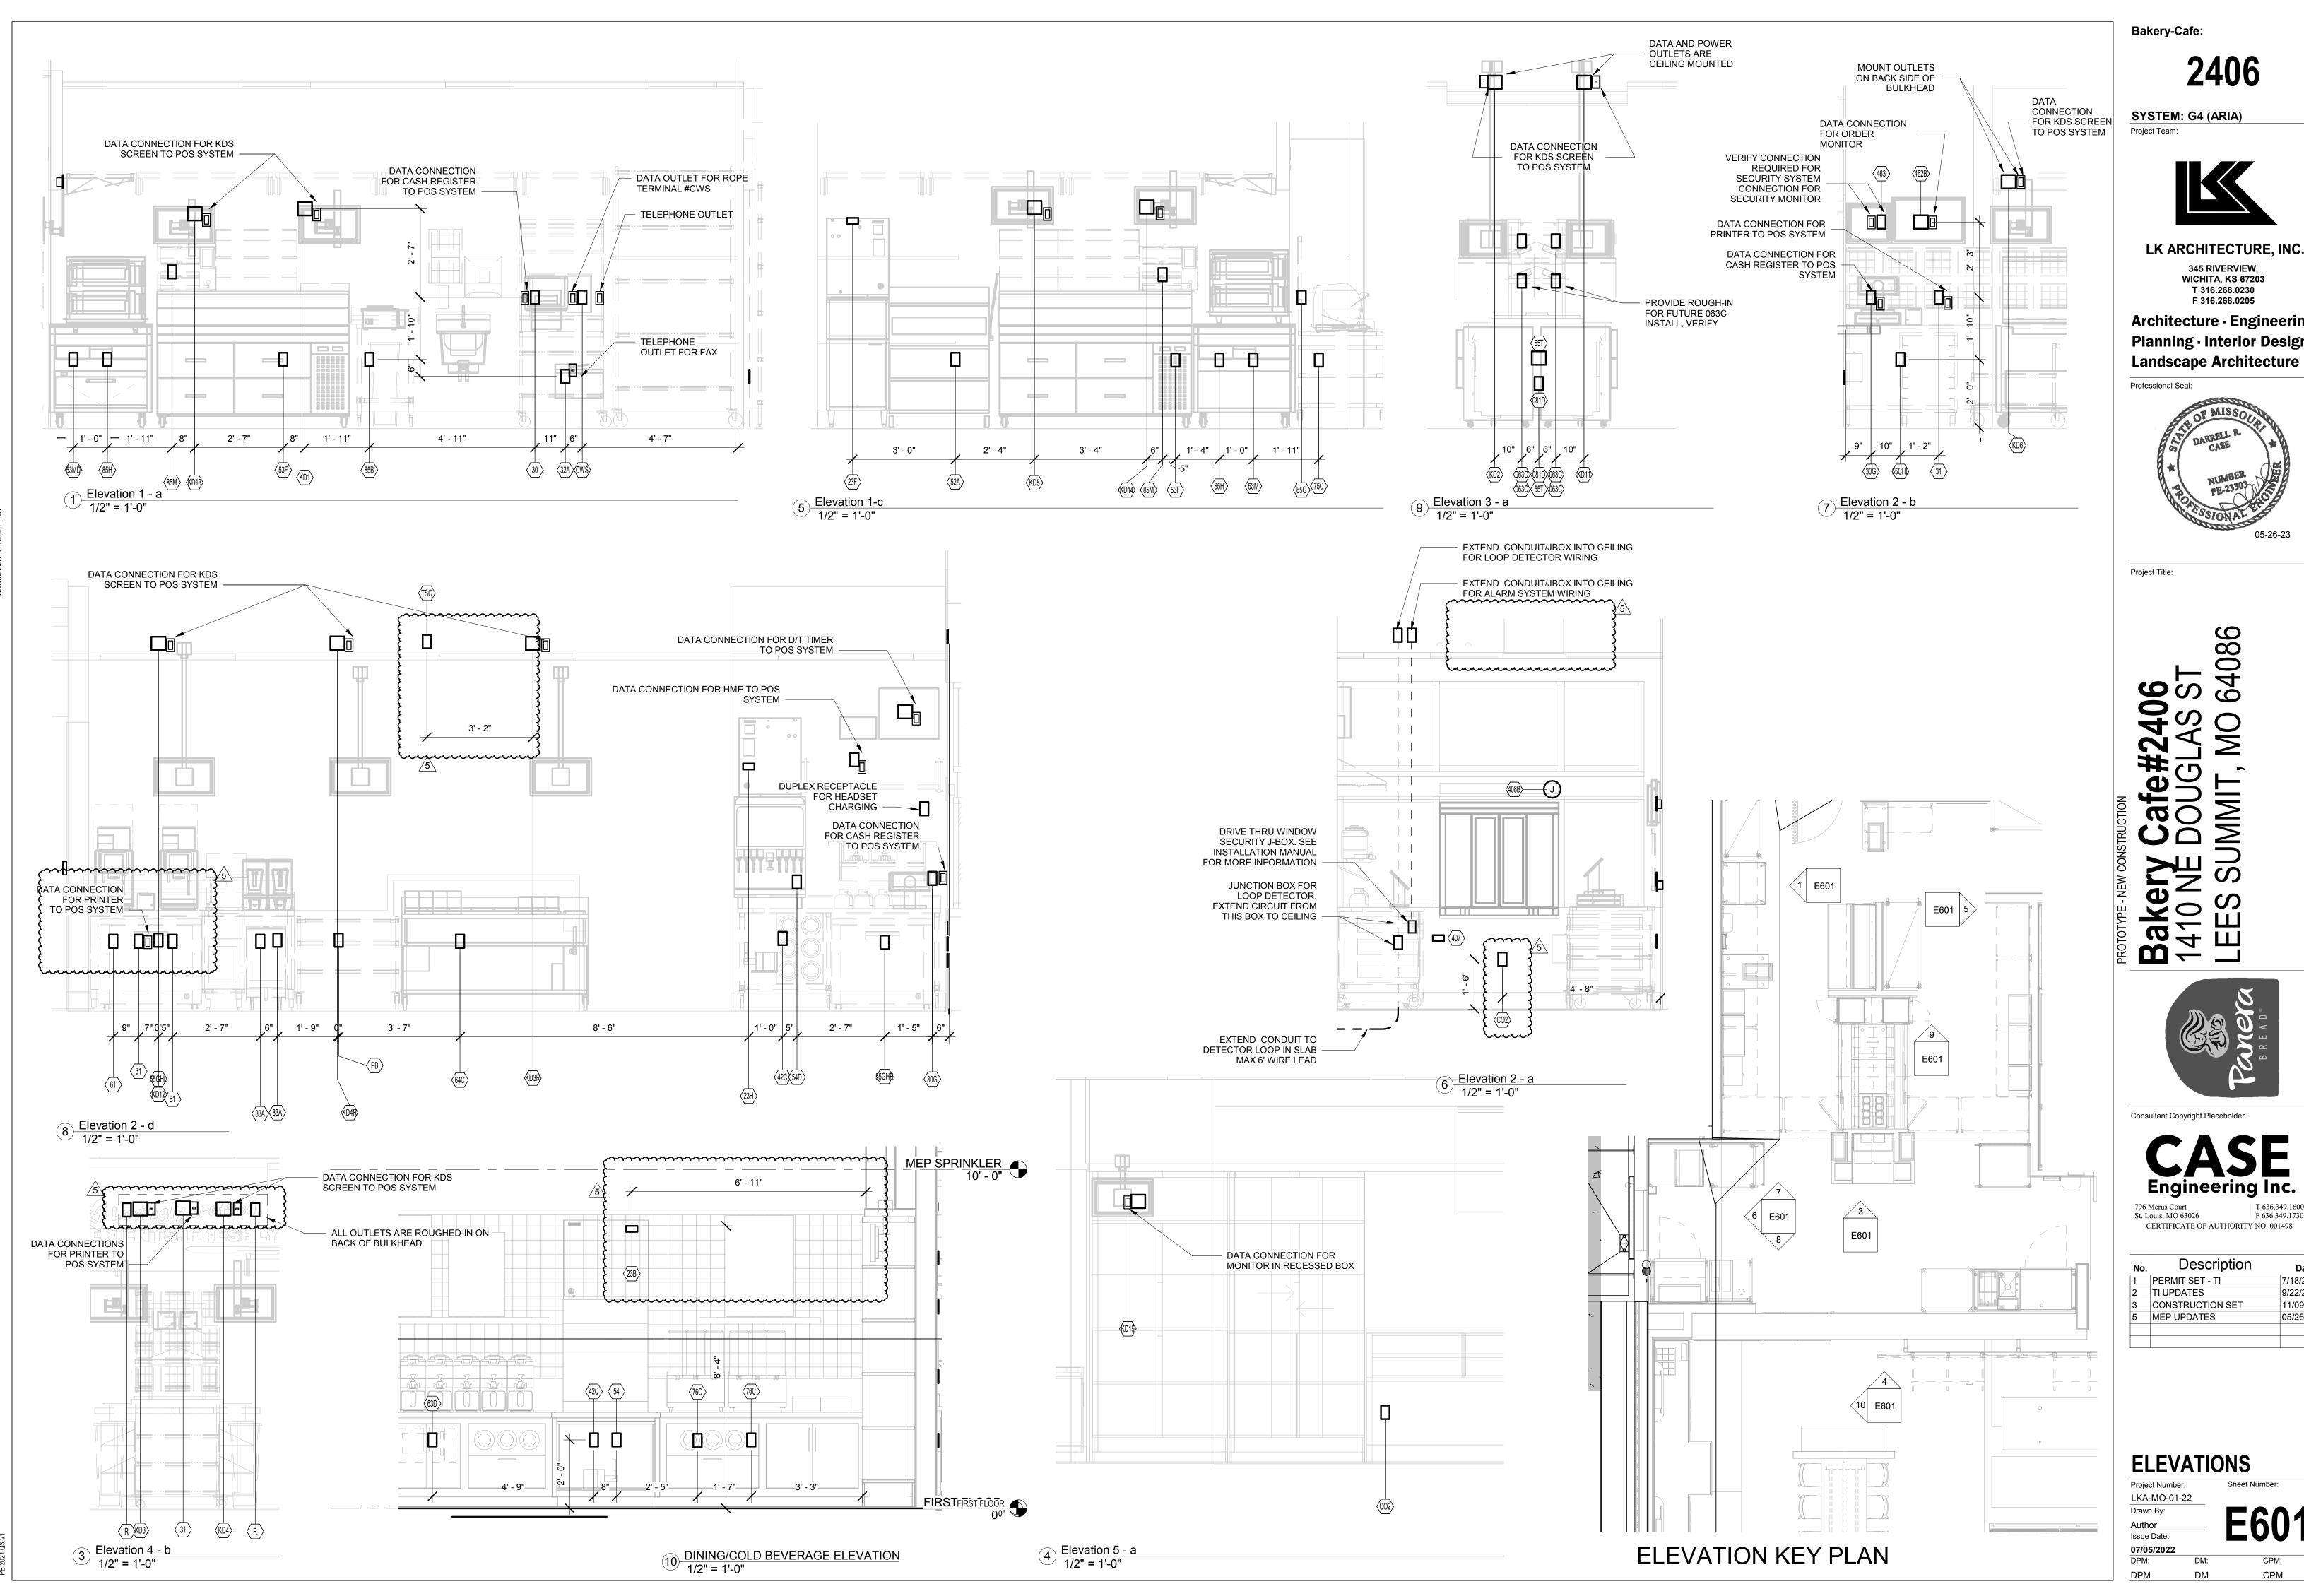

Project Team:

2400

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796 Merus Court T 636.349.160 St. Louis, MO 63026 F 636.349.173 CERTIFICATE OF AUTHORITY NO. 001498

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1	PERMIT SET - TI	7/18/2022
3	CONSTRUCTION SET	11/09/2022
5	MEP UPDATES	05/26/2023

ELECTRICAL SITE PLAN

PLAN

Project Number: Sheet

LKA-MO-01-22

Drawn By:

Author

Issue Date:

Author
Issue Date:

07/05/2022

DPM: DM: CPM: