

RIGHT ELEVATION

SCALE: 1/4"=1'-0"

REFERENCE KEYNOTES

01 - FOUNDATION

01.12 - TOP OF FOOTING DEPTH DETERMINED PER SITE.

CONCRETE WINDOW WELL FOR EGRESS WITH

01.71 - LADDER. PROVIDE SLEEVE THROUGH WALL FOR FOUNDATION DRAIN. TOP OF WINDOW WELL TO BE 3" BELOW TOP OF FOUNDATION.

02 - TRIM

03 - SIDING

02.61 - 5/4"X8" LP SMART TRIM.
UNLESS NOTED OTHERWISE ON ELEVATION.

UNLESS NOTED OTHERWISE.

LP SMART LAP SIDING WITH 5/4X6 LP SMART TRIM
O3.11 - AROUND DOORS, WINDOWS, AND CORNERS
UNLESS NOTED OTHERWISE.

LP SMART PANEL SIDING WITH 3/4X4 LP SMART TRIM AROUND DOORS, WINDOWS, AND CORNERS UNLESS NOTED OTHERWISE. BOTTOM OF SIDING SHALL BE A MINIMUM OF 6" ABOVE GRADE.

03.15 - LP SMART BOARD AND BATTEN.

03.17 - MANUFACTURED STONE VENEER.

03.18 - CAST STONE CAP
6X6 CEDAR POST. 1X6 TRIM AT BASE.

03.38 - 1X4 TRIM AT TOP.

03.57 - 26"X6" CEDAR BRACKET

04 - ROOF

MINIMUM ROOFING COMPOSITION
04.11 - 30 YR COMPOSITE SHINGLES ON 15# FELT ON

7/16" OSB SHEATHING OR AS REQUIRED BY CODE.

GENERAL NOTES - ELEVATIONS

DIMENSIONAL LUMBER IS LABELED PER INDUSTRY STANDARD TERMINOLOGY. ACTUAL LUMBER SIZING IS

WINDOW SIZES ARE WRITTEN IN FEET AND INCHES

SINGLE HUNG, 3066 FIX = 3'-0" X 6'-6" FIXED.

PER INDUSTRY STANDARDS. EX: 3050 SH = 3'-0" X 5'-0"

EXPECTED TO VARY PER VENDOR.

07 - MISCELLANEOUS & PLAN NOTES 07.67 - BACK WALL OF GARAGE. CPG DBA

clover



hive

120 SE 30TH ST. LEE'S SUMMIT, MO 64082 816-246-6700

COPYRIGHT 2020


THIS DRAWING HAS BEEN PREPARED BY CLOVER AND HIVE, OR UNDER THEIR DIRECT SUPERVISION AS AN INSTRUMENT OF SERVICE AND IS INTENDED FOR USE ONLY ON THIS PROJECT. ALL DRAWINGS, SPECIFICATIONS, AND DESIGNS, INCLUDING THE OVERALL LAYOUT, FORM, AND COMPOSITION OF SPACES ARE PROTECTED BY COPYRIGHT REGISTERED TO CPG, INC. ANY REPRODUCTION, USE, OR DISCLOSURE OF THE INFORMATION CONTAINED HEREIN WITHOUT THE WRITTEN CONSENT FROM CPG, INC. D/B/A SUMMIT HOMES EXCEPT AS REQUIRED FOR BIDDING AND CONSTRUCTION OF THIS PROJECT IS STRICTLY PROPUBLIFED.

ADDRESS: 2129 SW RUTHERFORD DR

> LEES SUMMIT MO 64082

OSAGE, Lot 69 RMALADE - FARMHOUSE

PROFESSIONAL SEAL

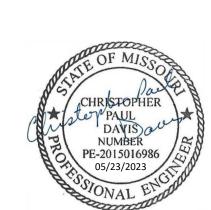

EVERSTEAD IS RESPONSIBLE FOR STRUCTURAL SPECIFICATIONS ONLY.
ARCHITECTURAL PLANS WERE PRODUCED BY OTHERS.

EVERSTEAD
3741 NE TROON DRIVE
SUITE 200
LEE'S SUMMIT, MO 64064
816-399-4901

DRAWN BY:

R2.0

ISSUE DATE:

06/01/2022

SHEET NUMBER:

A1.1

ALL CONSTRUCTION SHALL CONFORM TO 2018 INTERNATIONAL RESIDENTIAL CODE OR ATTACHED ENGINEER SPECIFICATIONS WHERE APPLICABLE.

FOUNDATION NOTES:

18"

(4) VERTICAL #4

(4) VERTICAL #4


COLUMN AND PAD SIZES ARE FOR A MAXIMUM COLUMN HEIGHT OF 10'.

COLUMNS GREATER THAN 10' REQUIRE A SEPARATE ENGINEERED DESIGN. FOOTINGS A-F SPACING OF 6" O.C. WITH 3" CLEAR COVER.

ALL FOOTINGS MEET OR EXCEED MINIMUM FROST DEPTH OF 36".

SOIL BEARING CAPACITY SHALL BE 1500 PSF.

- COMPRESSIVE STRENGTH OF CONCRETE F'C COMPRESSIVE STRENGTH SHALL BE AS SPECIFIED IN IRC TABLE R402.2. REQUIRED AIR ENTRAINMENT
- ALL FOUNDATION WALLS ENCLOSING BELOW GRADE SPACE SHALL BE DAMPPROOFED. DAMPPRROFING SHALL EXTEND FROM THE EDGE OF THE FOOTING TO THE FINISHED GRADE (R-406.1). METHOD OF DAMPPROOFING OR WATERPROOFING SHALL BE A MINIMUM 6-MIL THICK MOISTURE BARRIER OVER POROUS GRAVEL BASE UNDER BASEMENT FLOOR SLAB PER R405.2.2. LAP JOINTS SHALL BE A MINIMUM 6".
- FOUNDATION WALLS SHALL BE DAMPPROOFED PER IRC SECTION R406. • FOUNDATION DRAINAGE WILL BE IN ACCORDANCE WITH WITH IRC SECTION
- BASEMENT EGRESS OPENINGS SHALL BE IN ACCORDANCE WITH IRC SECTION
- ALL INTERIOR FOOTINGS OF LOAD BEARING WALLS AND COLUMNS SHALL BE ISOLATED FROM THE BASEMENT FLOOR SLAB.
- ALL ANCHOR BOLTS SHALL NOT BE SPACED MORE THAN 3' O.C. AND BE EMBEDDED INTO THE CONCRETE A MINIMUM OF 7".

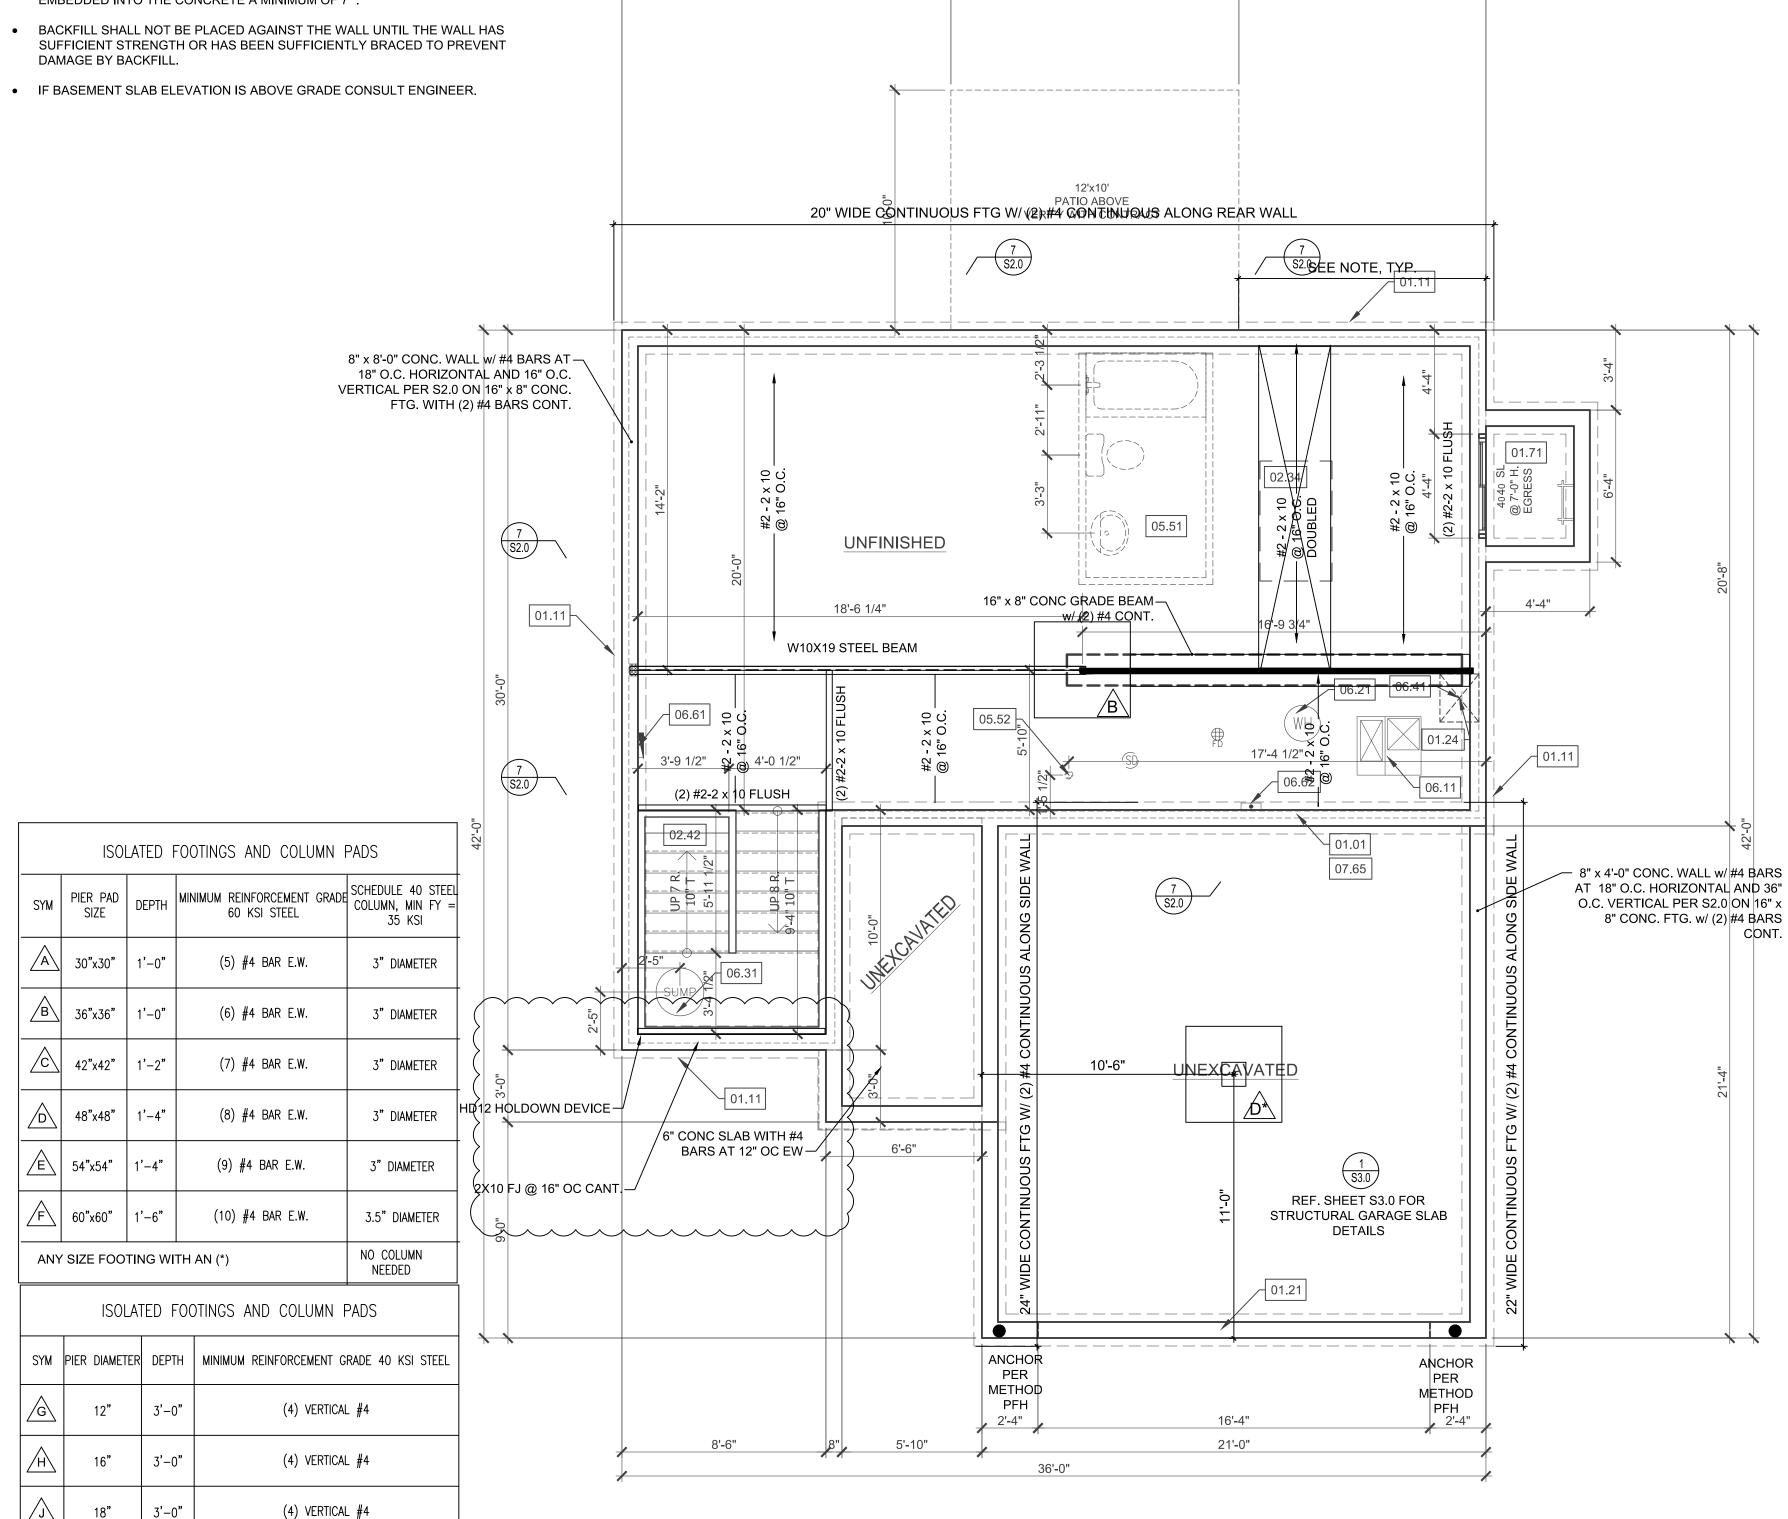

13'-8 1/2"

12'-0"

10'-3 1/2"

DEAD MEN SPACING:

- ALL DEAD MEN SHALL BE SPACED NO MORE THAN 16' FROM EGRESS WELL, REAR GARAGE WALL, 24" RETURN ON FOUNDATION WALL OR ANOTHER DEAD MAN.
- DEAD MEN ARE NOT REQUIRED ON EXTERIOR GARAGE WALLS OR FOUNDATION WALLS THAT ARE 5' OR LESS.
- WALL TRANSITIONING FROM LESS THAN 5' TALL TO MORE THAN 5' TALL WITH STEP DOWNS: A DEAD MAN IS REQUIRED WITHIN 8' OF STEP DOWN (TRANSITIONING FROM LESS THAN 5' TALL TO MORE THAN 5' TALL WALL LOCATION) ON WALL 5' TALL OR MORE

REFERENCE KEYNOTES

01 - FOUNDATION

01.01 - HOLD SILL PLATE BACK 4"

01.11 - CONTINUOUS CONCRETE FOOTING

01.21 - RECESS TOP OF FOUNDATION WALL

02.34 - PROVIDE ADDITIONAL BRACING FOR ISLAND ABOVE.

DRAIN LINE ONLY FOR FUTURE USE. 05.51 - LOCATION TO BE MARKED WITH REBAR

AND CUT FLUSH TO FLOOR FINISH.

05.52 - PLUMBING FLANGE ABOVE. HEADER JOISTS AS NEEDED

DIRECT FURNACE. FUEL BURNING APPLIANCES 06.11 - SHALL BE DIRECT VENTED TO EXTERIOR FOR

HOT WATER HEATER WITH THERMAL EXPANSION

SUMP PIT AND PUMP. PROVIDE ELECTRICAL GFCI

200 AMP ELECTRICAL PANEL.

UFER GROUND- VERIFY LOCATION WITH

07.65 - LINE OF FLOOR ABOVE

09.01 - PROVIDE GFCI RECEPTACLE AND SWITCH FOR HUMIDIFIER.

GENERAL NOTES - FOUNDATION BASEMENT

PLUMBING FIXTURES. PROVIDE MEANS OF CONTROLLING

ALL SILLS & SLEEPERS SUPPORTED ON CONCRETE OR

MASONRY SHALL BE OF DECAY-RESISTANT MATERIALS.

DIMENSIONAL LUMBER IS LABELED PER INDUSTRY STANDARD TERMINOLOGY. ACTUAL LUMBER SIZING IS

ALL INTERIOR NON-LOAD BEARING, NON-BRACED, NON-CABINET WALLS ARE ALLOWED AT 24" O.C.

SMOKE AND CARBON MONOXIDE DETECTORS SHOW ON

WINDOW SIZES ARE WRITTEN IN FEET AND INCHES PER

INDUSTRY STANDARDS. EX: 3050 SH = 3'-0" X 5'-0" SINGLE

PLANS ARE TO BE CONSIDERED RECOMMENDATIONS

ONLY. FINAL PLACEMENT IS TO BE DETERMINED BY

EXPECTED TO VARY PER VENDOR.

MUNICIPAL REQUIREMENTS.

HUNG, 3066 FIX = 3'-0" X 6'-6" FIXED.

BACK WATER VALVES REQUIRED ON ALL BASEMENT

PRESSURE CAUSED BY THERMAL EXPANSION.

09.04 -AT BOTTOM OF STAIRS.

BLOCK OUT FOUNDATION FOR VENTILATION AS REQUIRED.

CONCRETE WINDOW WELL FOR EGRESS WITH LADDER. PROVIDE SLEEVE THROUGH WALL FOR FOUNDATION DRAIN, TOP OF WINDOW WELL TO BE 3" BELOW TOP OF FOUNDATION.

02 - TRIM

02.42 - FIRE RATED SHEETROCK UNDER STAIRS

05 - PLUMBING

06 - MECHANICAL

COMBUSTION AIR.

CONTROL DEVICE

06.31 PROTECTION, PROVIDE SLEEVE THROUGH FOOTING.

06.41 - HVAC CHASE ABOVE

LOCATION TO BE DETERMINED ON SITE.

PROJECT MANAGER.

07 - MISCELLANEOUS & PLAN NOTES

09 - ELECTRICAL - SEE ELECTRICAL PLANS

CONTINUE SWITCH CIRCUIT DOWN TO SWITCH

PROFESSIONAL SEAL:

CPG DBA

clover

hive

120 SE 30TH ST.

LEE'S SUMMIT, MO 64082

816-246-6700

COPYRIGHT 2020

AND HIVE. OR UNDER THEIR DIRECT SUPERVISION AS AN INSTRUMENT OF SERVICE AND IS INTENDED

FOR USE ONLY ON THIS PROJECT. ALL DRAWINGS, SPECIFICATIONS, AND DESIGNS, INCLUDING THE

OVERALL LAYOUT, FORM, AND COMPOSITION OF SPACES ARE PROTECTED BY COPYRIGHT REGISTERED TO CPG, INC. ANY REPRODUCTION, USE, OR DISCLOSURE OF THE INFORMATION CONTAINED HEREIN WITHOUT THE WRITTEN CONSENT FROM CPG, INC. D/B/A SUMMIT HOMES

EXCEPT AS REQUIRED FOR BIDDING AND CONSTRUCTION OF THIS PROJECT IS STRICTLY

ADDRESS:

2129 SW RUTHERFORD DR

LEES SUMMIT

MO 64082

\$

HIS DRAWING HAS BEEN PREPARED BY CLOVER



EVERSTEAD IS RESPONSIBLE FOR STRUCTURAL SPECIFICATIONS ONLY. ARCHITECTURAL PLANS WERE PRODUCED BY OTHERS.

> EVERSTEAD 3741 NE TROON DRIVE SUITE 200 LEE'S SUMMIT, MO 64064 816-399-4901

> > DRAWN BY:

ISSUE DATE:

06/01/2022

SHEET NUMBER:

WINDOW SCHEDULE

STYLE WIDTH | HEIGHT | TEMP | QUANTITY SL BASEMENT EGRESS SLIDER 4'-0" 4'-0"

DOOR SCHEDULE STYLE | WIDTH | HEIGHT | FRAME DEPTH | QUANTITY |

FOUNDATION PLAN

SCALE: 1/4"=1'-0"

- ALL CONSTRUCTION SHALL CONFORM TO 2018 INTERNATIONAL RESIDENTIAL CODE OR ATTACHED ENGINEER SPECIFICATIONS WHERE APPLICABLE.
- ALL UNMARKED HEADERS SHALL BE A MINIMUM #2 DOUGLAS FIR LARCH (2) 2 X 10 ON LOAD BEARING WALLS.

DETAILS AND NOTES:

- BASEMENT EGRESS WINDOWS ARE TO COMPLY WITH IRC
- WINDOW FALL PROTECTION REQUIREMENTS TO COMPLY WITH SECTION R612.2.
- STAIRS SHALL COMPLY WITH IRC R311.7. THE MAXIMUM RISER HEIGHT OF STAIRWAYS SHALL NOT EXCEED 7-3/4" AND THE TREADS SHALL PROVIDE A MINIMUM TREAD DEPTH OF 10" (IRC 2018 R311.7.5.1).
- SELF CLOSING DEVICES ARE REQUIRED FOR GARAGE TO
- DWELLING SEPARATION DOORS. STEEL COLUMNS WILL BE A MINIMUM OF SCHEDULE 40.
- ENERGY REQUIREMENTS SHALL CONFORM TO THE IRC CHAPTER 11.
- SECURITY SHALL CONFORM TO IRC R326/KCBRC. AN ACCESSIBLE CONNECTION POINT WILL BE PROVIDED TO A 20 FOOT CONCRETE ENCASED ELECTRODE (FOOTING REBAR) FOR THE ELECTRICAL SERVICE GROUNDING ELECTRODE

13'-8 1/2"

4'-1 3/4" 3'-4 1/2" 3'-4 1/2"

12'**-**8"

(2) #**2-2**/x 10 FLÚSH

@ 10'-0" H.

TEMP

@ 12'-6" H.

3020 FX

BWL B

@ 15'-0" H.

3'-2"

 $(3) 2 \times 4$ -

05.05

2 x 4 @ 16" STUD WALL

FULL HEIGHT BLOCK

WALL AT BASE AND

MINDOM —

12'-0"

PATIO

VERIFY WITH CONTRACT

8'-9 3/4"

9'-4"

- CONDUCTOR (UFER GROUND). CARBON MONOXIDE DETECTORS WILL BE PROVIDED IN
- ACCORDANCE WITH IRC SECTION R315. THE BUILDING THERMAL ENVELOPE IS REQUIRED TO BE
- SEALED(2018 IRC SECTION N1102.4.1 AND TABLE N1102.4.1.1). DUCTS, AIR HANDLERS, FILTER BOXES AND BUILDING CAVITIES USED AS DUCTS SHALL BE SEALED (2018 IRC SECTION N1103.2.2)

- FLOOR PLANS: LEDGERS(FLOOR AND CEILING) SHALL BE IN ACCORDANCE
- ALL CANTILIEVERS SHALL HAVE AT LEAST A 3:1 BACK SPAN. A MINIMUM OF DOUBLE JOIST UNDER EACH BEARING WALL IS REQUIRED.
- ALL WALLS UNDER 12' SHALL BE DOUGLAS FIR LARCH #2 2X4 STUDS AT 16" O.C. FULL HEIGHT CONTINUOUS (UNLESS
- OTHERWISE NOTED). ALL WALLS 12' AND OVER SHALL BE DOUGLAS FIR #2 (M-12) LUMBER 2x6 STUDS AT 16" O.C. FULL HEIGHT CONTINUOUS
- (UNLESS OTHERWISE NOTED). EXTERIOR WALL SHEATHING SHALL BE AS FOLLOWS:
- 3" THICK OSB FOR METHODS: WSP, CS-WSP AND PFH
- $\frac{7}{16}$ " THICK OSB FOR METHOD CS-PF.
- SPECIFIED THICKNESS OF OSB SHALL BE INSTALLED UNDERNEATH LP LAP SIDING AND/OR ENGINEERED BRACED
- LP PANEL SIDING 7/16" GROOVED SHALL BE EQUIVALENT TO 3" THICK OSB. OSB MAY BE OMITTED UNDERNEATH 7/16" GROOVED
- PANEL SIDING IN AREAS REQUIRING $\frac{3}{8}$ " THICK OSB. INSTALL FASTENERS AND NAILING PATTERN PER 2018 IRC

SECTION R602.10.

WALL PANELS.

STUD PACK OF (4) 2 x 4 OR (4) 2 x 6 DOUGLAS FIR LARCH #2 (DEPENDING ON WALL THICKNESS) BELOW EACH BEARING <u>OINT OF EACH GIRDER TRUSS, UNLESS OTHERWISE NOTED</u> STUD PACKS SHALL BE CARRIED DOWN TO FOUNDATION OR LOAD SUPPORTING MEMBER.

PROVIDE 2X SOLID BLOCKING SUPPORT BELOW ALL POINT LOADS CONTINUOUS TO BEARING STRUCTURE AND/OR FOUNDATION BELOW.

LVL'S SHALL BE: BOISE CASCADE VERSA-LAM 3100 FB PROVIDE FULL BEARING FOR DOUBLE, TRIPLE JOISTS, LVL'S AND

#2 2x10 @ 16" O¢ 🖧 CANTILIEVER FLOOR JOISTS AT LANDING TO

WALL FULL HEIGHT 2X4 BRACING METHODS EXTERIOR BRACING CS-PF PER IRC R602.10 FOR CS-PF ABOVE: WOOD STRUCTURAL PANEL SHEATHING
CONTINUOUS OVER BAND JOIST OR RIM JOIST WITH MINIMUM LAP
OF 9-1/4". ATTACH SHEATHING WITH MINIMUM 8D COMMON NAILS AT 3" O.C. AT TOP AND BOTTOM OF BAND/RIM JOIST.

INTERIOR BRACING LIB PER IRC R602.10

(INCLUDES PARTIAL PANELS PER IRC R602.10.5.2)

EXTERIOR BRACING CS-WSP PER IRC R602.10

MINIMUM LIB LENGTH PER 2018 IRC TABLE R602.10.5 55" - 8' TALL WALL HEIGHT 62" - 9' TALL WALL HEIGHT 69" - 10' TALL WALL HEIGHT EXTERIOR BRACING PFH (SEE DETAILS) PER IRC R602.10.5

EXTERIOR BRACING WSP PER IRC R602.10

CONTINUOUSLY SHEATHED EXTERIOR WALL BRACING 3/8" PANEL

MARINE

THICKNESS OSB WITH 24/0 STRUCTURAL PANEL SPAN RATING. 1-3/8" MIN PEN, 8d FASTENERS AT 3" FOR PANEL EDGES AND 12" IN FIELD. INSTALL BLOCKING @ 3' O.C. VERTICALLY. WOOD STRUCTURAL PANEL SHEATHING CONTINUOUS OVER BAND JOIST OR RIM JOIST WITH MINIMUM LAP OF 9-1/4". ATTACH SHEATHING WITH MINIMUM 8D COMMON NAILS AT 3" O.C. AT TOP AND BOTTOM OF BAND/RIM JOIST.

INTERIOR LOAD BEARING WALL (EXTERIOR WALLS ARE ASSUMED LOAD BEARING)

CATCH 2X4 FURRING

STUD\$-

2 x 6 CONTINUOUS STUD

IRC TABLE N1102.1.2 (R402.1.2) INSULATION AND FENESTRATION REQUIREMENTS BY COMPONENT (PARTIAL) SLAB R-VALUE & | CRAWL SPACE WALL |MASS WALL | FLOOR BASEMENT WALL FENESTRATION SKYLIGHT WOOD FRAME WALL CLIMATE ZONE U-FACTOR U-FACTOR FENESTRATION SHGC | R-VALUE R-VALUE R-VALUE R-VALUE R-VALUE 8/13 10/13 10, 2 FT 10/13 20 OR 13+5

BWL 1 @ 7'-0" H. @ 7'-0" H. @ 7'-0" H. @ 7'^{_l}0" H. (2) #2-2 x 10 CONTINUOUS -(2) #**2**-2 x 10 (2) #2-2 x 10 SHELVES KITCHEN **DINING ROOM GREAT ROOM** 05.52 16" (G) #2 08.11 W8 X 15 STEEL BEAM (2) #2-2 x 10 (2) *\2-2 \x 1\0 |⁸||¥® ∷|PANTŔY (4) 12" "L" SHELVES / / BWL 2 G.T. BEARING -_G.T. BEARING ♀ ♡ FROM ABOVE FROM ABOVE —(3)2X4 - UP TO 9' HT COVERED 3" SCℍ 40 STL COL - UP TO 10' HT -EXTENSE AND LETTERS AND A PROPERTY A GARAGE BWL 3 W12 X 16 STEEL BEAM 3'-2" -2X4 NOTE: 5/8" FIRE RATED GYP. BD ON GARAGE WALLS ADJACENT TO LIVING AREAS, CEILINGS, BEAMS, AND WALLS. 30 20 FX 03.38 60 # (2)1-3/4" X 14" LVL CONT CORNER-TO-CORNER TBWL 4

10'-3 1/2"

6'-11 1/2"

2'-6"

BWL C

WINDOW SCHEDULE TYPE STYLE | WIDTH | HEIGHT | TEMP | QUANTITY

| DOOR SCHEDULE | | | | | | | | | |
|---------------|----------------------------------|--------|--------|-------------|----------|--|--|--|--|
| | STYLE | WIDTH | HEIGHT | FRAME DEPTH | QUANTITY | | | | |
| | HINGED - SINGLE | 2'-8" | 6'-8" | 4 1/2" | 1 | | | | |
| | GARAGE DOOR - 16 - 32 PANEL | 16'-0" | 7'-0" | 4 1/2" | 1 | | | | |
| | SLIDING - DOUBLE - FULL LITE | 5'-0" | 6'-8" | 4" | 1 | | | | |
| | HINGED - DOUBLE | 3'-4" | 6'-8" | 4 1/2" | 1 | | | | |
| | FRONT DOOR - 2 PANEL - CRAFTSMAN | 3'-0" | 6'-8" | 4 1/2" | 1 | | | | |
| | HINGED - SINGLE - GARAGE | 2'-8" | 6'-8" | 4 5/8" | 1 | | | | |
| | HINGED - SINGLE | 2'-4" | 6'-8" | 4 1/2" | 2 | | | | |
| | DRYWALL OPENING | 3'-0" | 6'-8" | 4 1/2" | 1 | | | | |

MAIN LEVEL PLAN

SCALE: 1/4"=1'-0"

REFERENCE KEYNOTES

01 - FOUNDATION

01.22 - EXPOSED TOP OF FOUNDATION WALL.

02 - TRIM

02.12 - 2X6 STUD WALL

02.41 - CURB STAIR SYSTEM WITH OPEN HANDRAILS

02.51 - 3 STUDS BETWEEN WINDOW UNITS

03 - SIDING

6X6 CEDAR POST. 1X6 TRIM AT BASE. 03.38 -1X4 TRIM AT TOP.

05 - PLUMBING

05.05 - HOSE BIBB

05.52 - PLUMBING FLANGE ABOVE. HEADER JOISTS AS NEEDED

07 - MISCELLANEOUS & PLAN NOTES

07.65 - LINE OF FLOOR ABOVE

20 MINUTE FIRE RATED SOLID CORE WITH SELF-CLOSING HINGES

08 - CABINETRY

24" CABINET + 12" OVERHANG FLAT ISLAND. VERIFY LOCATION WITH PERSONAL BUILDER.

08.44 - BENCH WITH COAT HOOKS

09 - ELECTRICAL - SEE ELECTRICAL PLANS

CONTINUE SWITCH CIRCUIT DOWN TO SWITCH AT BOTTOM OF STAIRS.

09.05 - SWITCH AND POWER FOR GARBAGE DISPOSAL. 09.06 - PROVIDE POWER BELOW COUNTER FOR DISHWASHER.

GENERAL NOTES - FLOOR PLAN

WINDOWS TO COMPLY WITH IRC R312.2 FOR FALL PROTECTION.

ALL EXTERIOR WALLS, INTERIOR BEARING WALLS, AND INTERIOR BRACED WALLS ARE AT 16" O.C. UNLESS NOTED OTHERWISE.

ALL INTERIOR NON-LOAD BEARING, NON-BRACED, NON-CABINET WALLS ARE ALLOWED AT 24" O.C.

ROOF AND CEILING FRAMING ARE PRE-ENGINEERED WOOD TRUSSES UNLESS NOTED OTHERWISE.

DIMENSIONAL LUMBER IS LABELED PER INDUSTRY STANDARD TERMINOLOGY. ACTUAL LUMBER SIZING IS EXPECTED TO VARY PER VENDOR.

HVAC DUCTWORK RUNNING THROUGH THE ATTIC SPACE SHALL BE HUNG FROM ABOVE TO ALLOW COMPLETE INSULATION SURROUND.

PROVIDE BLOCKING AT ALL CEILING JUMPS FOR INSULATION.

2X6 EXTERIOR WALL OVER 12' SHALL BE DOUGLAS FIR

SMOKE AND CARBON MONOXIDE DETECTORS SHOW ON PLANS ARE TO BE CONSIDERED RECOMMENDATIONS ONLY. FINAL PLACEMENT IS TO BE DETERMINED BY MUNICIPAL REQUIREMENTS.

WINDOW SIZES ARE WRITTEN IN FEET AND INCHES PER INDUSTRY STANDARDS. EX: 3050 SH = 3'-0" X 5'-0" SINGLE HUNG, 3066 FIX = 3'-0" X 6'-6" FIXED.

CPG DBA

clover

hive


120 SE 30TH ST. LEE'S SUMMIT, MO 64082 816-246-6700

COPYRIGHT 2020 HIS DRAWING HAS BEEN PREPARED BY CLOVER AND HIVE. OR UNDER THEIR DIRECT SUPERVISION AS AN INSTRUMENT OF SERVICE AND IS INTENDED FOR USE ONLY ON THIS PROJECT. ALL DRAWINGS PECIFICATIONS, AND DESIGNS, INCLUDING TH OVERALL LAYOUT, FORM, AND COMPOSITION OF SPACES ARE PROTECTED BY COPYRIGHT REGISTERED TO CPG, INC. ANY REPRODUCTION, USE, OR DISCLOSURE OF THE INFORMATION CONTAINED HEREIN WITHOUT THE WRITTEN CONSENT FROM CPG, INC. D/B/A SUMMIT HOMES EXCEPT AS REQUIRED FOR BIDDING AND CONSTRUCTION OF THIS PROJECT IS STRICTLY

ADDRESS: 2129 SW RUTHERFORD DR

> LEES SUMMIT MO 64082

 \leq

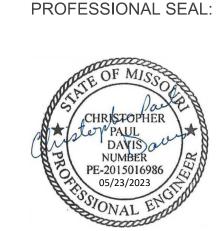

EVERSTEAD IS RESPONSIBLE FOR STRUCTURAL SPECIFICATIONS ONLY. ARCHITECTURAL PLANS WERE PRODUCED BY OTHERS.

EVERSTEAD 3741 NE TROON DRIVE SUITE 200 LEE'S SUMMIT, MO 64064 816-399-4901

DRAWN BY:

ISSUE DATE:

06/01/2022

SHEET NUMBER:

 ALL CONSTRUCTION SHALL CONFORM TO 2018 INTERNATIONAL RESIDENTIAL CODE OR ATTACHED ENGINEER SPECIFICATIONS WHERE APPLICABLE.

• ALL UNMARKED HEADERS SHALL BE A MINIMUM #2 DOUGLAS FIR LARCH (2) 2 X 10 ON LOAD BEARING WALLS.

DETAILS AND NOTES:

• BASEMENT EGRESS WINDOWS ARE TO COMPLY WITH IRC R310.2.

• WINDOW FALL PROTECTION REQUIREMENTS TO COMPLY WITH SECTION R612.2.

 STAIRS SHALL COMPLY WITH IRC R311.7. THE MAXIMUM RISER HEIGHT OF STAIRWAYS SHALL NOT EXCEED 7-3/4" AND THE TREADS SHALL PROVIDE A MINIMUM TREAD DEPTH OF 10" (IRC 2018 R311.7.5.1).

• SELF CLOSING DEVICES ARE REQUIRED FOR GARAGE TO DWELLING SEPARATION DOORS.

STEEL COLUMNS WILL BE A MINIMUM OF SCHEDULE 40.

• ENERGY REQUIREMENTS SHALL CONFORM TO THE IRC CHAPTER 11.

 SECURITY SHALL CONFORM TO IRC R326/KCBRC. AN ACCESSIBLE CONNECTION POINT WILL BE PROVIDED TO A 20 FOOT CONCRETE

ENCASED ELECTRODE (FOOTING REBAR) FOR THE ELECTRICAL SERVICE GROUNDING

ELECTRODE CONDUCTOR (UFER GROUND). CARBON MONOXIDE DETECTORS WILL BE PROVIDED IN ACCORDANCE WITH IRC SECTION

THE BUILDING THERMAL ENVELOPE IS REQUIRED TO BE SEALED(2018 IRC SECTION

N1102.4.1 AND TABLE N1102.4.1.1). • DUCTS, AIR HANDLERS, FILTER BOXES AND BUILDING CAVITIES USED AS DUCTS SHALL BE SEALED (2018 IRC SECTION N1103.2.2)

FLOOR PLANS:

• LEDGERS(FLOOR AND CEILING) SHALL BE IN ACCORDANCE WITH IRC 507.

 ALL CANTILIEVERS SHALL HAVE AT LEAST A 3:1 BACK SPAN. • A MINIMUM OF DOUBLE JOIST UNDER EACH BEARING WALL IS REQUIRED.

ALL WALLS UNDER 12' SHALL BE DOUGLAS FIR LARCH #2 2X4 STUDS AT 16" O.C. FULL HEIGHT CONTINUOUS (UNLESS OTHERWISE NOTED).

• ALL WALLS 12' AND OVER SHALL BE DOUGLAS FIR #2 (M-12) LUMBER 2x6 STUDS AT 16" O.C. FULL HEIGHT CONTINUOUS (UNLESS OTHERWISE NOTED).

• EXTERIOR WALL SHEATHING SHALL BE AS FOLLOWS:

• $\frac{3}{8}$ " THICK OSB FOR METHODS: WSP, CS-WSP AND PFH

• $\frac{7}{16}$ " THICK OSB FOR METHOD CS-PF.

ENGINEERED BRACED WALL PANELS.

SPECIFIED THICKNESS OF OSB SHALL BE INSTALLED UNDERNEATH LP LAP SIDING AND/OR


• LP PANEL SIDING - 7/16" GROOVED SHALL BE EQUIVALENT TO $\frac{3}{8}$ " THICK OSB. OSB MAY BE OMITTED UNDERNEATH 7/16" GROOVED PANEL SIDING IN AREAS REQUIRING 3" THICK OSB.

• INSTALL FASTENERS AND NAILING PATTERN PER 2018 IRC SECTION R602.10.

STUD PACK OF (4) 2 x 4 OR (4) 2 x 6 DOUGLAS FIR LARCH #2 (DEPENDING ON WALL THICKNESS) BELOW EACH BEARING POINT OF EACH GIRDER TRUSS, UNLESS OTHERWISE NOTED. STUD PACKS SHALL BE CARRIED DOWN TO FOUNDATION OR LOAD SUPPORTING

EXTERIOR BRACING PFH (SEE DETAILS) PER IRC R602.10.5

INTERIOR LOAD BEARING WALL (EXTERIOR WALLS ARE ASSUMED LOAD BEARING)

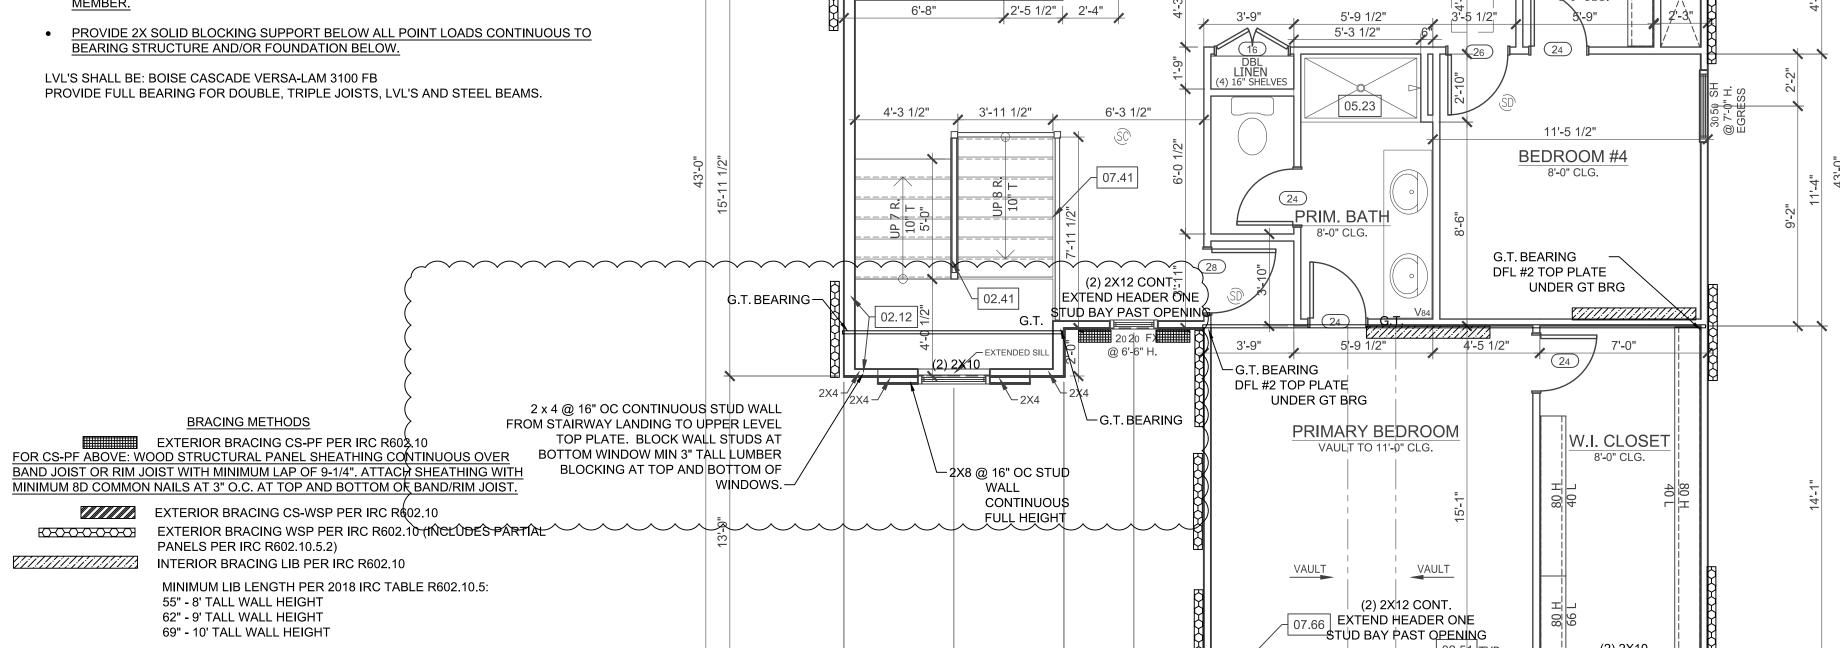

BWL A

11'-4"

BEDROOM #2

@ 7'-0" H.

(2) 2X10

EGRESS ------

9'-2"

KCCCCCCC

40 BY-PASS

80 H/40 L

5'-7 1/2"

32" X 60" TUB

BATH #2

SHOWER UNIT

7'-7"

CLOSET

LAUNDRY

2'-11" 2'-11" 3'-7 1/2" 3'-4 1/2" 3'-4 1/2" 3'-7 1/2" 3'-6"

BWL B

JRY

11'-5 1/2"

BEDROOM #3

40 L/80 H

CLOSET

@ 7'-0" H.

(2) 2X10

06.51

EGRESS SEGRESS

9'-0"

80000000

| WINDOW SCHEDULE | | | | | | | | |
|-----------------|-------------|-------|--------|------|----------|--|--|--|
| TYPE | STYLE | WIDTH | HEIGHT | TEMP | QUANTITY | | | |
| SH | SINGLE HUNG | 3'-0" | 5'-0" | | 6 | | | |
| FX | FIXED | 2'-0" | 2'-0" | | 1 | | | |
| FY | FIXED | 2' 0" | 5' O" | | 1 | | | |

BWL 2

BWL 3

| DOOR SCHEDULE | | | | | | | | |
|------------------|-------|--------|-------------|---------|--|--|--|--|
| STYLE | WIDTH | HEIGHT | FRAME DEPTH | QUANTIT | | | | |
| SLIDING - DOUBLE | 4'-0" | 6'-8" | 4 1/2" | 1 | | | | |
| HINGED - DOUBLE | 3'-0" | 6'-8" | 4 1/2" | 1 | | | | |
| HINGED - SINGLE | 2'-6" | 6'-8" | 4 1/2" | 3 | | | | |
| HINGED - SINGLE | 2'-4" | 6'-8" | 4 1/2" | 6 | | | | |
| HINGED - SINGLE | 2'-8" | 6'-8" | 4 1/2" | 2 | | | | |

IRC TABLE N1102.1.2 (R402.1.2) INSULATION AND FENESTRATION REQUIREMENTS BY COMPONENT (PARTIAL) FENESTRATION | SKYLIGHT WOOD FRAME WALL MASS WALL | FLOOR | BASEMENT WALL | SLAB R-VALUE & CRAWL SPACE WAL | R-VALUE | R-VALUE | U-FACTOR FENESTRATION SHGC R-VALUE R-VALUE DEPTH R-VALUE 8/13 10/13 20 OR 13+5 MARINE

UPPER LEVEL PLAN

SCALE: 1/4"=1'-0"

REFERENCE KEYNOTES

02 - TRIM

02.12 - 2X6 STUD WALL

SIX SIDED TUB ASSEMBLY INCLUDING THERMOPLY 02.31 - ON EXTERIOR WALL TO 2" ABOVE TOP OF TUB DECK OR TUB/SHOWER UNIT

02.41 - CURB STAIR SYSTEM WITH OPEN HANDRAILS

02.51 - 3 STUDS BETWEEN WINDOW UNITS

05 - PLUMBING

05.23 - FIBERGLASS UNIT

06 - MECHANICAL

HVAC FLOOR OPENING. HEADER OFF FLOOR JOISTS 06.42 - AS REQUIRED. BUMP TRUSSES AS NECESSARY

FOR HVAC ACCESS. 1'-10"X3'-0" MINIMUM ATTIC ACCESS WITH 3/4"

06.51 - BACKER BOARD AND 2 LATCHES. BUMP TRUSSES FOR ATTIC ACCESS.

07 - MISCELLANEOUS & PLAN NOTES

07.41 - OPEN HANDRAILS 07.66 - LINE OF FLOOR BELOW

09 - ELECTRICAL - SEE ELECTRICAL PLANS

CONTINUE SWITCH CIRCUIT DOWN TO SWITCH AT BOTTOM OF STAIRS.

CPG DBA

clover

hive

120 SE 30TH ST. LEE'S SUMMIT, MO 64082 816-246-6700

COPYRIGHT 2020 HIS DRAWING HAS BEEN PREPARED BY CLOVER AND HIVE. OR UNDER THEIR DIRECT SUPERVISION AS AN INSTRUMENT OF SERVICE AND IS INTENDED FOR USE ONLY ON THIS PROJECT. ALL DRAWINGS SPECIFICATIONS, AND DESIGNS, INCLUDING TH OVERALL LAYOUT, FORM, AND COMPOSITION OF SPACES ARE PROTECTED BY COPYRIGHT REGISTERED TO CPG, INC. ANY REPRODUCTION, USE, OR DISCLOSURE OF THE INFORMATION CONTAINED HEREIN WITHOUT THE WRITTEN CONSENT FROM CPG, INC. D/B/A SUMMIT HOMES EXCEPT AS REQUIRED FOR BIDDING AND CONSTRUCTION OF THIS PROJECT IS STRICTLY

ADDRESS: 2129 SW RUTHERFORD DR

> LEES SUMMIT MO 64082

 \leq

PROFESSIONAL SEAL:



EVERSTEAD IS RESPONSIBLE FOR STRUCTURAL SPECIFICATIONS ONLY. ARCHITECTURAL PLANS WERE PRODUCED BY OTHERS.

EVERSTEAD

SUITE 200

816-399-4901

ALL INTERIOR NON-LOAD BEARING, NON-BRACED, 3741 NE TROON DRIVE NON-CABINET WALLS ARE ALLOWED AT 24" O.C. LEE'S SUMMIT, MO 64064

ROOF AND CEILING FRAMING ARE PRE-ENGINEERED WOOD TRUSSES UNLESS NOTED OTHERWISE.

GENERAL NOTES - FLOOR PLAN

ALL EXTERIOR WALLS, INTERIOR BEARING WALLS, AND

INTERIOR BRACED WALLS ARE AT 16" O.C. UNLESS

WINDOWS TO COMPLY WITH IRC R312.2 FOR FALL

PROTECTION.

NOTED OTHERWISE.

DIMENSIONAL LUMBER IS LABELED PER INDUSTRY STANDARD TERMINOLOGY. ACTUAL LUMBER SIZING IS EXPECTED TO VARY PER VENDOR.

HVAC DUCTWORK RUNNING THROUGH THE ATTIC SPACE SHALL BE HUNG FROM ABOVE TO ALLOW COMPLETE INSULATION SURROUND.

PROVIDE BLOCKING AT ALL CEILING JUMPS FOR INSULATION.

2X6 EXTERIOR WALL OVER 12' SHALL BE DOUGLAS FIR

SMOKE AND CARBON MONOXIDE DETECTORS SHOW

ON PLANS ARE TO BE CONSIDERED RECOMMENDATIONS ONLY. FINAL PLACEMENT IS TO BE DETERMINED BY MUNICIPAL REQUIREMENTS.

WINDOW SIZES ARE WRITTEN IN FEET AND INCHES PER INDUSTRY STANDARDS. EX: 3050 SH = 3'-0" X 5'-0" SINGLE HUNG, 3066 FIX = 3'-0" X 6'-6" FIXED.

DRAWN BY:

ISSUE DATE:

06/01/2022

SHEET NUMBER: