

RELEASE FOR CONSTRUCTION AS NOTED ON PLANS REVIEW DEVE LEE'S MIT, MISSOURI 05/17/2023 4:22:06

NOTE:

ALL CONSTRUCTION SHALL CONFORM TO 2018 INTERNATIONAL RESIDENTIAL CODE OR ATTACHED ENGINEER SPECIFICATIONS WHERE APPLICABLE.

FOUNDATION NOTES:

ALL FOOTINGS MEET OR EXCEED MINIMUM FROST DEPTH OF 36".

SOIL BEARING CAPACITY SHALL BE 1500 PSF. COMPRESSIVE STRENGTH OF CONCRETE F'C COMPRESSIVE STRENGTH SHALL BE AS SPECIFIED IN IRC TABLE R402.2. REQUIRED AIR ENTRAINMENT SHALL BE 5-7%. ALL FOUNDATION WALLS ENCLOSING BELOW GRADE SPACE SHALL BE DAMPPROOFED. DAMPPRROFING SHALL EXTEND FROM THE EDGE OF THE FOOTING TO THE FINISHED GRADE (R-406.1). METHOD OF DAMPPROOFING OR WATERPROOFING SHALL BE A MINIMUM 6-MIL THICK MOISTURE BARRIER OVER POROUS GRAVEL BASE UNDER BASEMENT FLOOR SLAB PER R405.2.2. LAP JOINTS SHALL BE A MINIMUM 6".

FOUNDATION WALLS SHALL BE DAMPPROOFED PER IRC SECTION R406. FOUNDATION DRAINAGE WILL BE IN ACCORDANCE WITH WITH IRC SECTION R405. BASEMENT EGRESS OPENINGS SHALL BE IN ACCORDANCE WITH IRC SECTION R310.1

ALL INTERIOR FOOTINGS OF LOAD BEARING WALLS AND COLUMNS SHALL BE ISOLATED FROM THE BASEMENT FLOOR SLAB. ALL ANCHOR BOLTS SHALL NOT BE SPACED MORE THAN 3' O.C. AND BE EMBEDDED INTO THE CONCRETE A MINIMUM OF 7".

ALL UNMARKED HEADERS SHALL BE A MINIMUM #2 DOUGLAS FIR LARCH (2) 2 X 10 ON LOAD BEARING WALLS.

BACKFILL SHALL NOT BE PLACED AGAINST THE WALL UNTIL THE WALL HAS SUFFICIENT STRENGTH OR HAS BEEN SUFFICIENTLY BRACED TO PREVENT DAMAGE BY BACKFILL.


IF BASEMENT SLAB ELEVATION IS ABOVE GRADE CONSULT ENGINEER.

DEAD MEN SPACING:

- ALL DEAD MEN SHALL BE SPACED NO MORE THAN 16' FROM EGRESS WELL, REAR GARAGE WALL, 24" RETURN ON FOUNDATION WALL OR ANOTHER DEAD MAN.
- DEAD MEN ARE NOT REQUIRED ON EXTERIOR GARAGE WALLS OR FOUNDATION WALLS THAT ARE 5' OR LESS.
- WALL TRANSITIONING FROM LESS THAN 5' TALL TO MORE THAN 5' TALL WITH STEP DOWNS: A DEAD MAN IS REQUIRED WITHIN 8' OF STEP DOWN (TRANSITIONING FROM LESS THAN 5' TALL TO MORE THAN 5' TALL WALL LOCATION) ON WALL 5' TALL OR MORE

ISOLATED FOOTINGS AND COLUMN PADS							
SYM	PIER PAD SIZE	DEPTH		ORCE	NIMUM Ement Si sti	GRADE	SCHEDULE 40 STEEL COLUMN, MIN FY = 35 KSI
	30″×30″	1'-0″	(5) #4	BAR	E.W.	3″ DIAMETER
B	36″×36″	1'-0″	(6) #4	BAR	E.W.	3″ DIAMETER
Â	42″×42″	1′-2″	(7) #4	BAR	E.W.	3″ DIAMETER
	48″×48″	1'-4″	(8) #4	BAR	E.W.	3″ DIAMETER
Æ	54″×54″	1'-4″	(9)	#4	BAR	E.W.	3″ DIAMETER
F	60″×60″	1'-6″	<10) #4	BAR	E.W.	3.5″ DIAMETER
ANY SIZE FOOTING WITH AN (*) NO COLUMN NEEDED							
ISOLATED FOOTINGS AND COLUMN PADS							
SYM	PIER DIAMETE	R DEP		IMUM		NFORCEN <si ste<="" td=""><td>1ENT GRADE 40 EL</td></si>	1ENT GRADE 40 EL
G	12″	3'-0	D″		(4)	VERTIC	AL #4
	16″	3'-0	D″		(4)	VERTIC	AL #4
\bigtriangleup	18″	3'-1	D″		(4)	VERTIC	AL #4
k	24″	3'-1	D″		(4)	VERTIC	AL #4
\land	28″	3'-(D″		(4)	VERTIC	AL #4

COLUMN AND PAD SIZES ARE FOR A MAXIMUM COLUMN HEIGHT OF 10'. COLUMNS GREATER THAN 10' REQUIRE A SEPARATE ENGINEERED DESIGN. FOOTINGS A-F SPACING OF 6" O.C. WITH 3" CLEAR COVER.

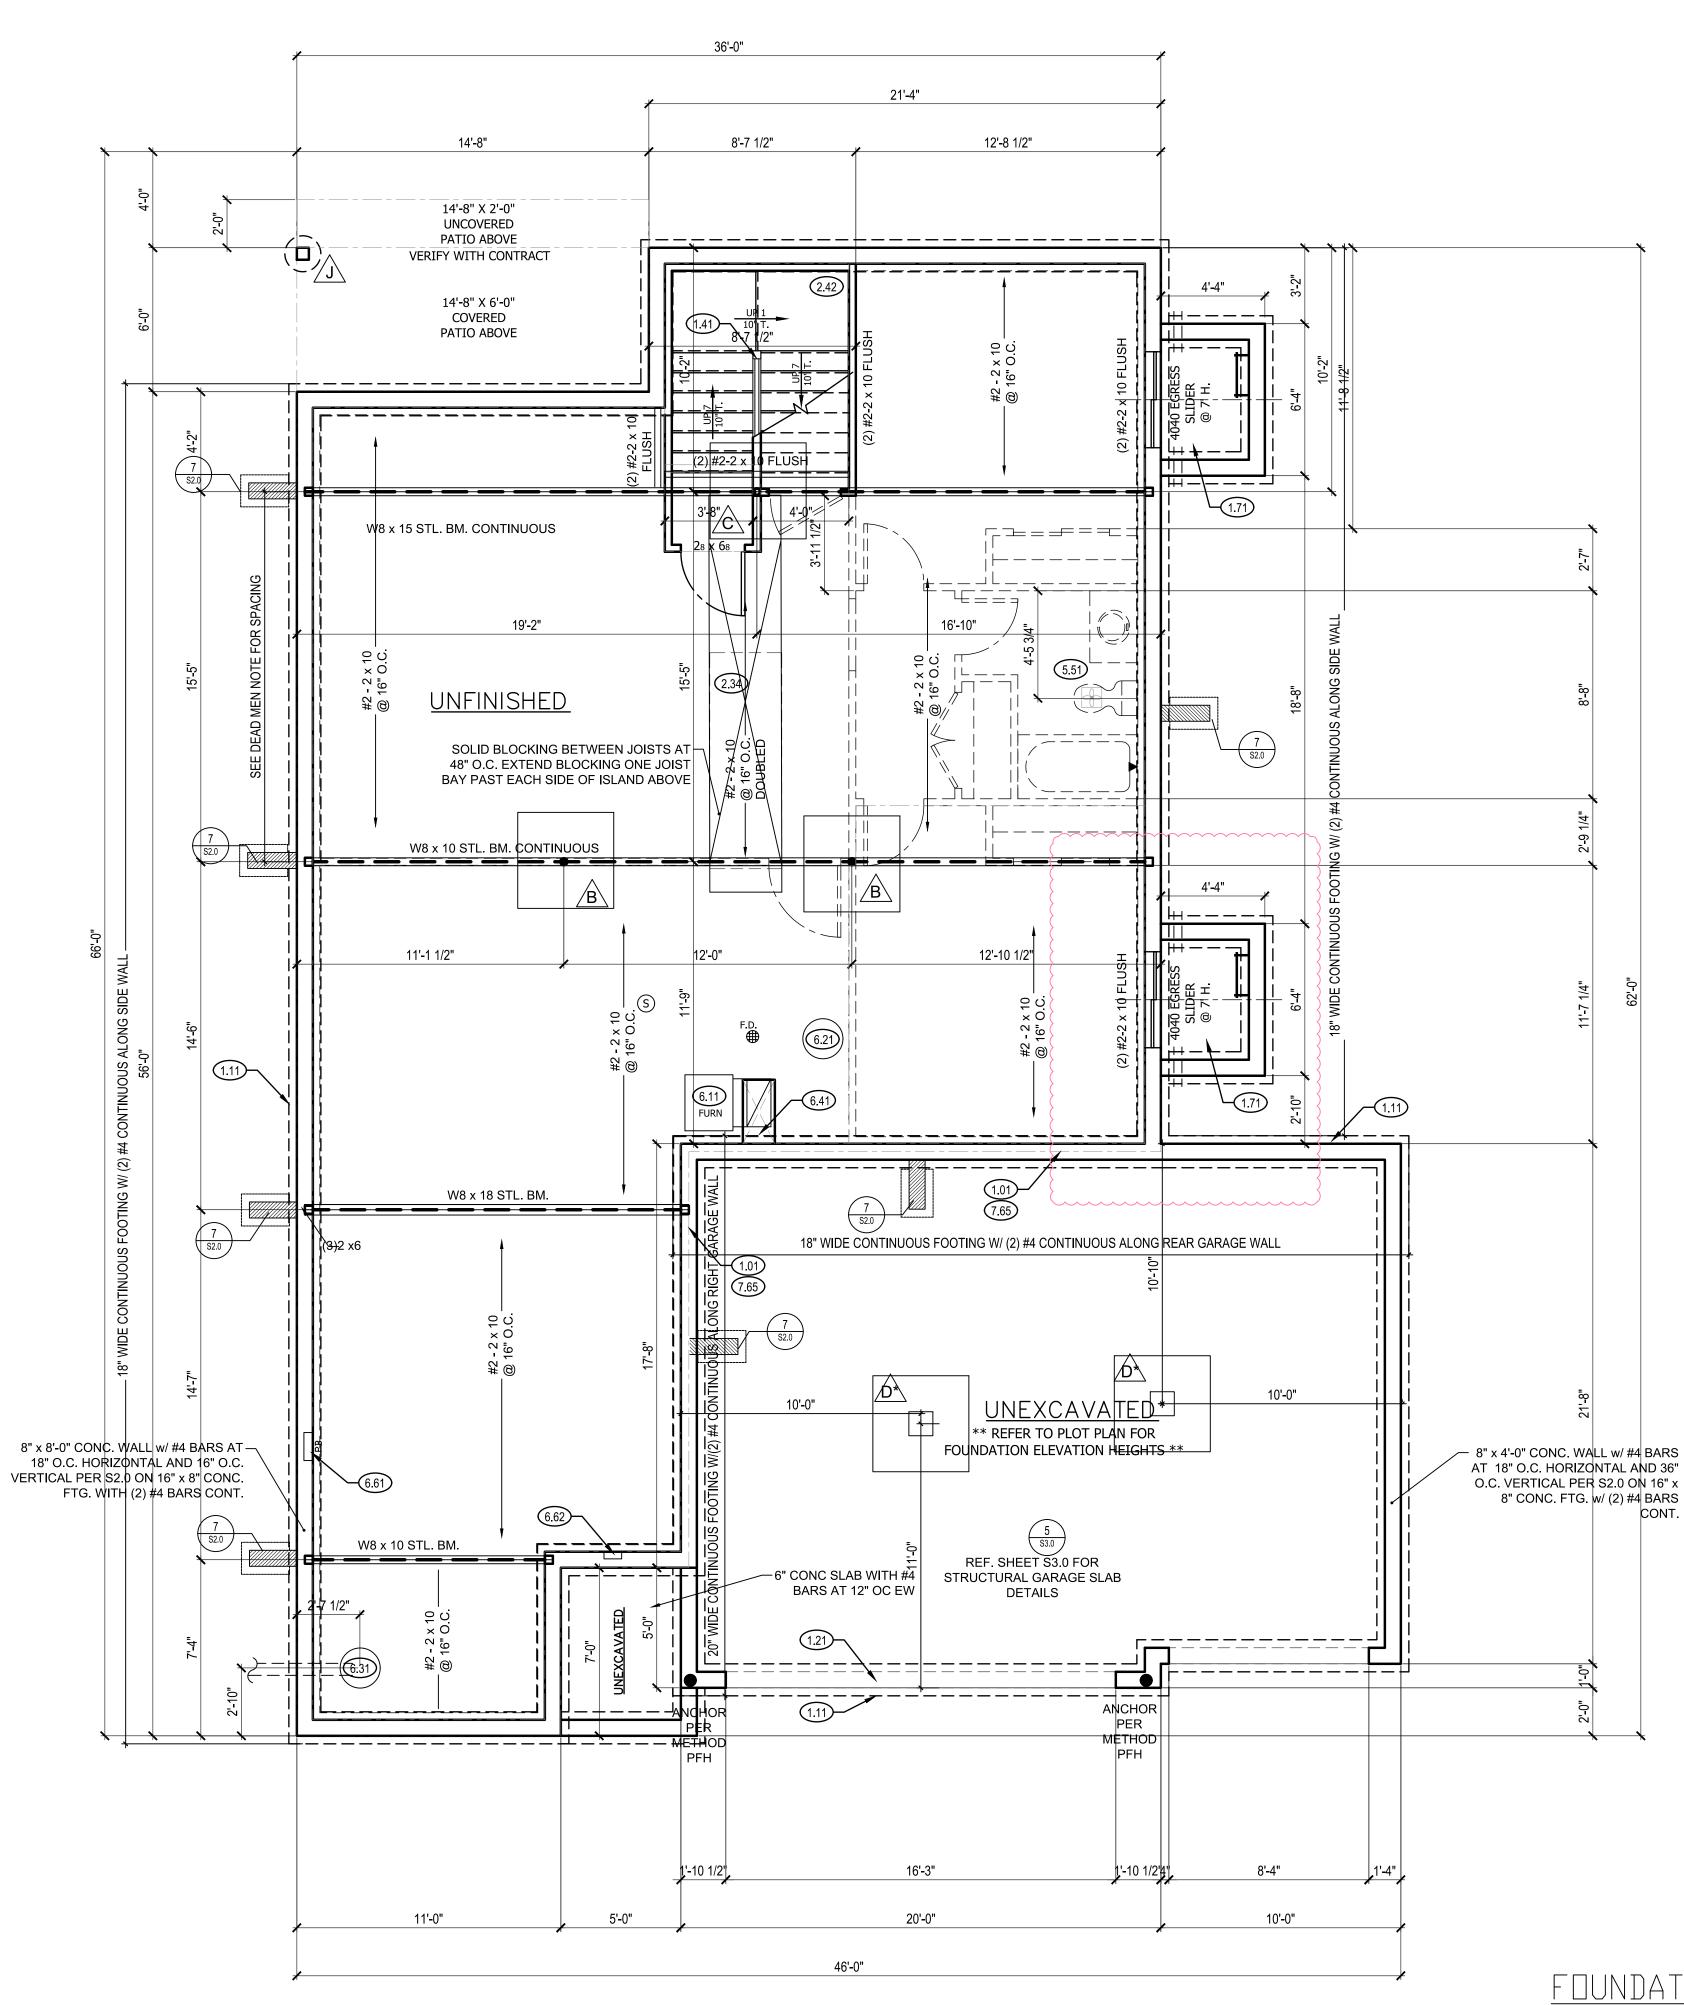

	FOUNDATION PLAN NOTES	CPG DBA
	1.01 HOLD SILL PLATE BACK 4"1.11 CONTINUOUS CONCRETE FOOTING	clover
	 1.21 RECESS TOP OF FOUNDATION WALL 1.71 CONCRETE WINDOW WELL FOR EGRESS WITH LADDER. PROVED SLEEVE THROUGH WALL FOR FOUNDATION 	53
	DRAIN. TOP OF WINDOW WELL TO BE 3" BELOW TOP OF FOUNDATION.	hive
	2.34 PROVIDE ADDITIONAL BRACING FOR ISLAND ABOVE.2.41 CURB STAIR SYSTEM WITH OPEN HANDRAILS2.42 FIRE DATED SUFETBOOK UNDED STAIRS	120 SE 30TH ST.
	2.42 FIRE RATED SHEETROCK UNDER STAIRS5.51 STUB OUT ONLY FOR FUTURE FULL BATH. DRAIN LOCATION TO BE MARKED WITH REBAR AND CUT	LEE'S SUMMIT, MO 64082 816-246-6700
	FLUSH TO FLOOR FINISH.6.11 DIRECT FURNACE. FUEL BURNING APPLIANCES SHALLBE DIRECT VENTED TO EXTERIOR FOR COMBUSTION	COPYRIGHT 2020
	AIR. 6.21 HOT WATER HEATER WITH THERMAL EXPANSION	THIS DRAWING HAS BEEN PREPARED BY CLOVER AND HIVE, OR UNDER THEIR DIRECT SUPERVISION AS AN INSTRUMENT OF SERVICE AND IS INTENDED FOR USE ONLY ON THIS PROJECT. ALL DRAWINGS, SPECIFICATIONS, AND DESIGNS, INCLUDING THE
	CONTROL DEVICE 6.31 SUMP PIT AND PUMP. PROVIDE ELECTRICAL GFCI PROTECTION. PROVIDE SLEEVE THROUGH FOOTING.	OVERALL LAYOUT, FORM, AND COMPOSITION OF SPACES ARE PROTECTED BY COPYRIGHT REGISTERED TO CPG, INC. ANY REPRODUCTION, USE, OR DISCLOSURE OF THE INFORMATION CONTAINED HEREIN WITHOUT THE WRITTEN CONSENT FROM CPG, INC.
	6.41 HVAC CHASE ABOVE6.61 200 AMP ELECTRICAL PANEL. LOCATION TO BE	D/B/A SUMMIT HOMES EXCEPT AS REQUIRED FOR BIDDING AND CONSTRUCTION OF THIS PROJECT IS STRICTLY PROHIBITED.
	DETERMINED ON SITE. 6.62 UFER GROUND- VERIFY LOCATION WITH PROJECT MANAGER.	
	7.65 LINE OF FLOOR ABOVE	ADDRESS: 3433 SW CORBIN DR LEES SUMMIT, MO
		WILDFLOWER FARMHOUSE COBEY CREEK #12
		LD FAF
		N N
		PROFESSIONAL SEAL:
		NTE OF MISSO
		CHRISTOPHER A ster PAUL DAVIS auto
		NUMBER PE-2015016986 05/17/2023
		STONAL ENDER
		EVERSTEAD IS RESPONSIBLE FOR STRUCTURAL SPECIFICATIONS ONLY. ARCHITECTURAL PLANS
		WERE PRODUCED BY OTHERS. EVERSTEAD
		3741 NE TROON DRIVE SUITE 200 LEE'S SUMMIT, MO 64064
		816-399-4901
	GENERAL NOTES BACK WATER VALVES REQUIRED ON ALL BASEMENT PLUMBING	VERSION #:
	FIXTURES. PROVIDE MEANS OF CONTROLLING PRESSURE CAUSED BY THERMAL EXPANSION.	V1.2
	ALL SILLS & SLEEPERS SUPPORTED ON CONCRETE OR MASONRY SHALL BE OF DECAY-RESISTANT MATERIALS.	
	DIMENSIONAL LUMBER IS LABELED PER INDUSTRY STANDARD TERMINOLOGY. ACTUAL LUMBER SIZING IS EXPECTED TO VARY PER VENDOR.	ISSUE DATE: 03.22.23
	ALL INTERIOR NON-LOAD BEARING, NON-BRACED, NON-CABINET WALLS ARE ALLOWED AT 24" O.C.	SHEET NUMBER:
	SMOKE AND CARBON MONOXIDE DETECTORS SHOW ON PLANS ARE TO BE CONSIDERED RECOMMENDATIONS ONLY. FINAL PLACEMENT IS TO BE DETERMINED BY MUNICIPAL REQUIREMENTS.	
1000000000000000000000000000000000000	WINDOW SIZES ARE WRITTEN IN FEET AND INCHES PER INDUSTRY STANDARDS. EX: 3050 SH = 3'-0" X 5'-0" SINGLE	A3.0
SCALE: 1/4" = 1'-0"	HUNG, 3066 FIX = 3'-0" X 6'-6" FIXED.	

CONT.