

GENERAL DESCRIPTION		
PROJECT LOCATION:	3516 SW MARKET ST LEE'S SUMMIT, MISSOURI 64064	
ENGINEERING AND DESIG		
EVERSTEAD 3741 NE TROON DRIVE, ST	E 200	
LEE'S SUMMIT, MISSOURI		
APPLICABLE CODES" 2018 INTERNATIONAL BUIL 2018 INTERNATIONAL PLUI 2018 INTERNATIONAL MEC 2018 INTERNATIONAL FUE	MBING CODE HANICAL CODE L GAS CODE	
2018 INTERNATIONAL FIRE 2017 INTERNATION ELECT		
ICC/ANSI A117.1-2009, ACC	ESSIBLE AND USABLE BUILDINGS AND FACILITIES	
CODE INFORMATION		
BUILDING/PROJECT USE	ASSEMBLY	
CONSTRUCTION TYPE OCCUPANCY CLASSIFICAT	TYPE V B FION ASSEMBLY GROUP A-2	
BASE ALLOWABLE AREA A	N-2 24,000 SQ FT - S1	
EXISTING BUILDING AREA	2,429 SQ FT	
NEW BUILDING AREA	1,160 SQ FT	
CEILING HEIGHT NOTES: (
2. OCCUPIED SPACES, HAI	TO HAVE A MINIMUM CEILING HEIGHT OF 7'-6" AFF., NOR SHALL HAVE ANY PROJECTION FROM THE CEILING BE LESS THAN 6'-8" BITABLE SPACES AND CORRIDORS SHALL HAVE A CEILING HEIGHT OF NOT LESS THAN 7'-6" A.F.F. DOMS, KITCHENS, STORAGE ROOMS AND LAUNDRY ROOMS SHALL HAVE A CEILING HEIGHT OF NOT LESS THAN 7'-0" A.F.F.	
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	TABLE OF CONTENTS		
	SHEET NUMBER	SHEET NAME	
	0-CV	COVER	
G201FLOOR PLANSG202ELECTRICAL AND REFLECTED CEILING PLANS			
		ELECTRICAL AND REFLECTED CEILING PLAN	
	G900	DETAILS	

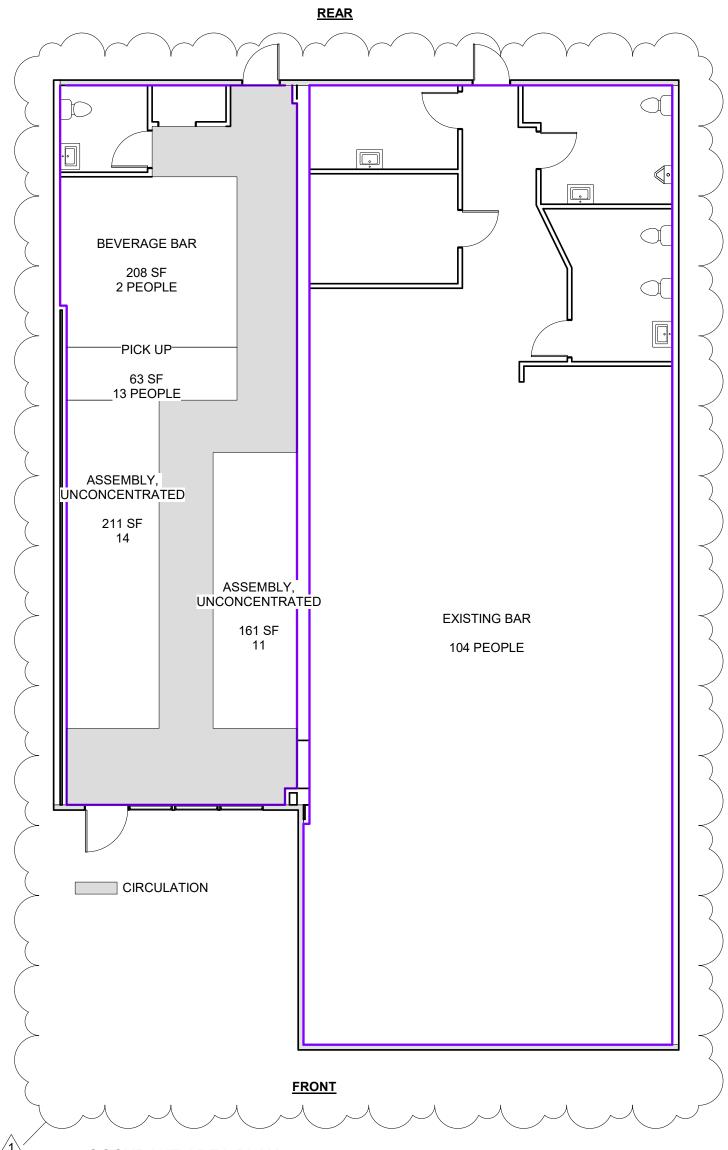


1 OCCUPANT AREA PLAN 1/8" = 1'-0"

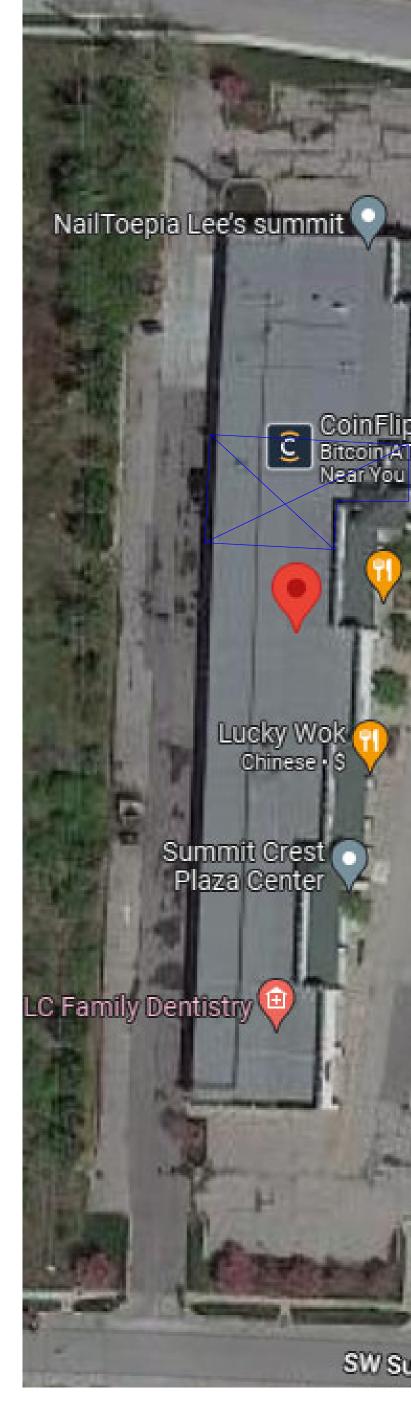


2 SITE PLAN 12" = 1'-0"



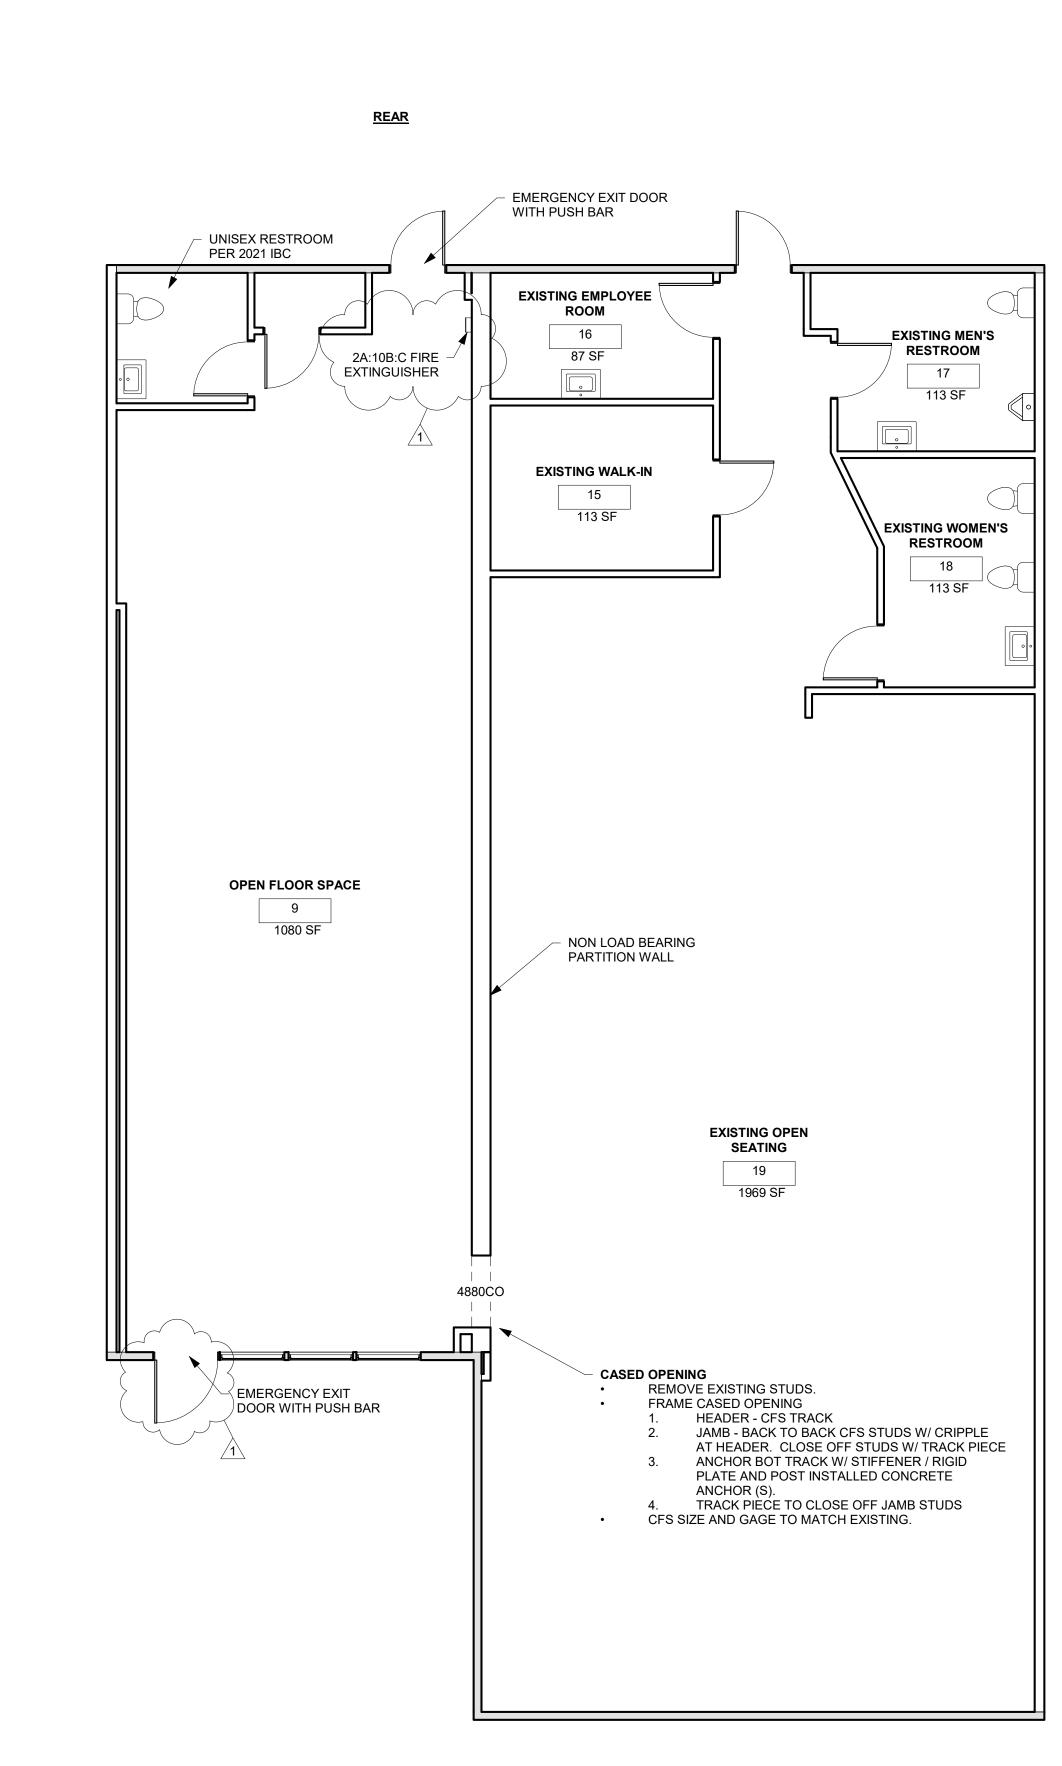

FRONT

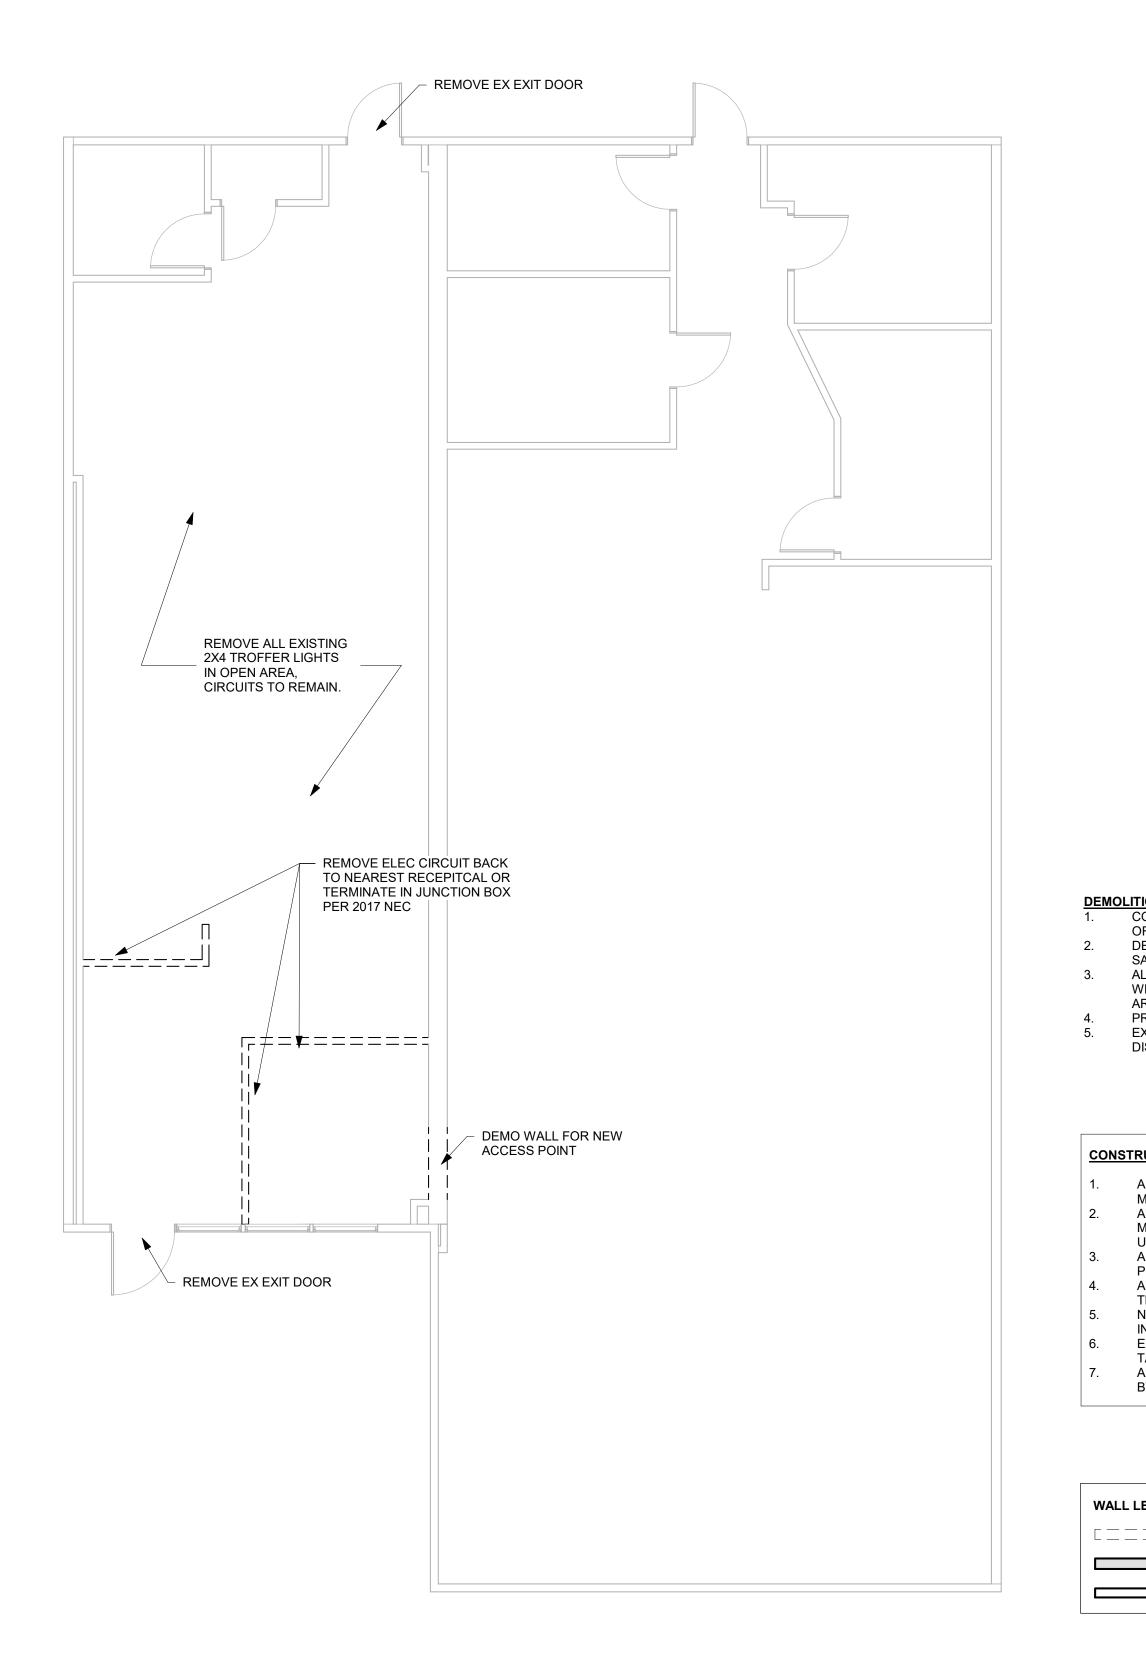

2 DEMO MAIN LEVEL 3/16" = 1'-0"



 DEMOLITION NOTES

 1.
 COORDINATE WITH MECHANICAL, ELECTRICAL, AND PLUMBING CONTRACTORS ON THE DEMOLITION
OF MEP FIXTURES AND ROUTES. 2. DEMOLITION OF WALLS INCLUDES ALL ITEMS ATTACHED TO THE WALL, UNLESS NOTED TO BE SALVAGED.

ALL EXTERIOR SURFACES TO BE DEMOLISHED AND REPLACED SHALL MAINTAIN APPROPRIATE WEATHER PROTECTION AND TO VERIFY THAT ALL MEMBERS COMPOSING STRUCTURAL INTEGRITY ARE SUITABLE FOR THE NEW DESIGN. PROTECT ALL EXISTING MATERIALS AND SURFACES THAT ARE TO REMAIN DURING THE DEMOLITION. EXISTING DOORS AND DOOR FRAMES MAY BE RE-LOCATED AND RE-USED BASED ON THE DISCRETION OF THE CLIENT.

CONSTRUCTION NOTES

ALL INTERIOR WALL DIMENSIONS ARE MEASURED TO THE INSIDE FACE OF STUD U.N.O. ALL EXTERIOR WALL DIMENSIONS ARE MEASURED TO THE OUTSIDE FACE OF STUD U.N.O.

ALL EXISTING WALLS ARE MEASURED TO THE PRESUMED FINISHED FACE OF WALL. ALL STRUCTURAL BEAMS ARE MEASURED TO THE CENTER OF THE MEMBER. NEW DOORS AND WINDOWS ARE TAGGED IN

INCHES. EXISTING DOORS AND WINDOWS ARE NOT TAGGED.


ALL CRITICAL DIMENSIONS TO BE FIELD VERIFIED BY CONTRACTOR.

WALL LEGEND - ADDITION

DEMO WALL
EXISTING EXTERIOR WALL
EXISTING INTERIOR PARTITION


G201

DATE SCALE 4/5/2023 12:19:44 PM As indicated

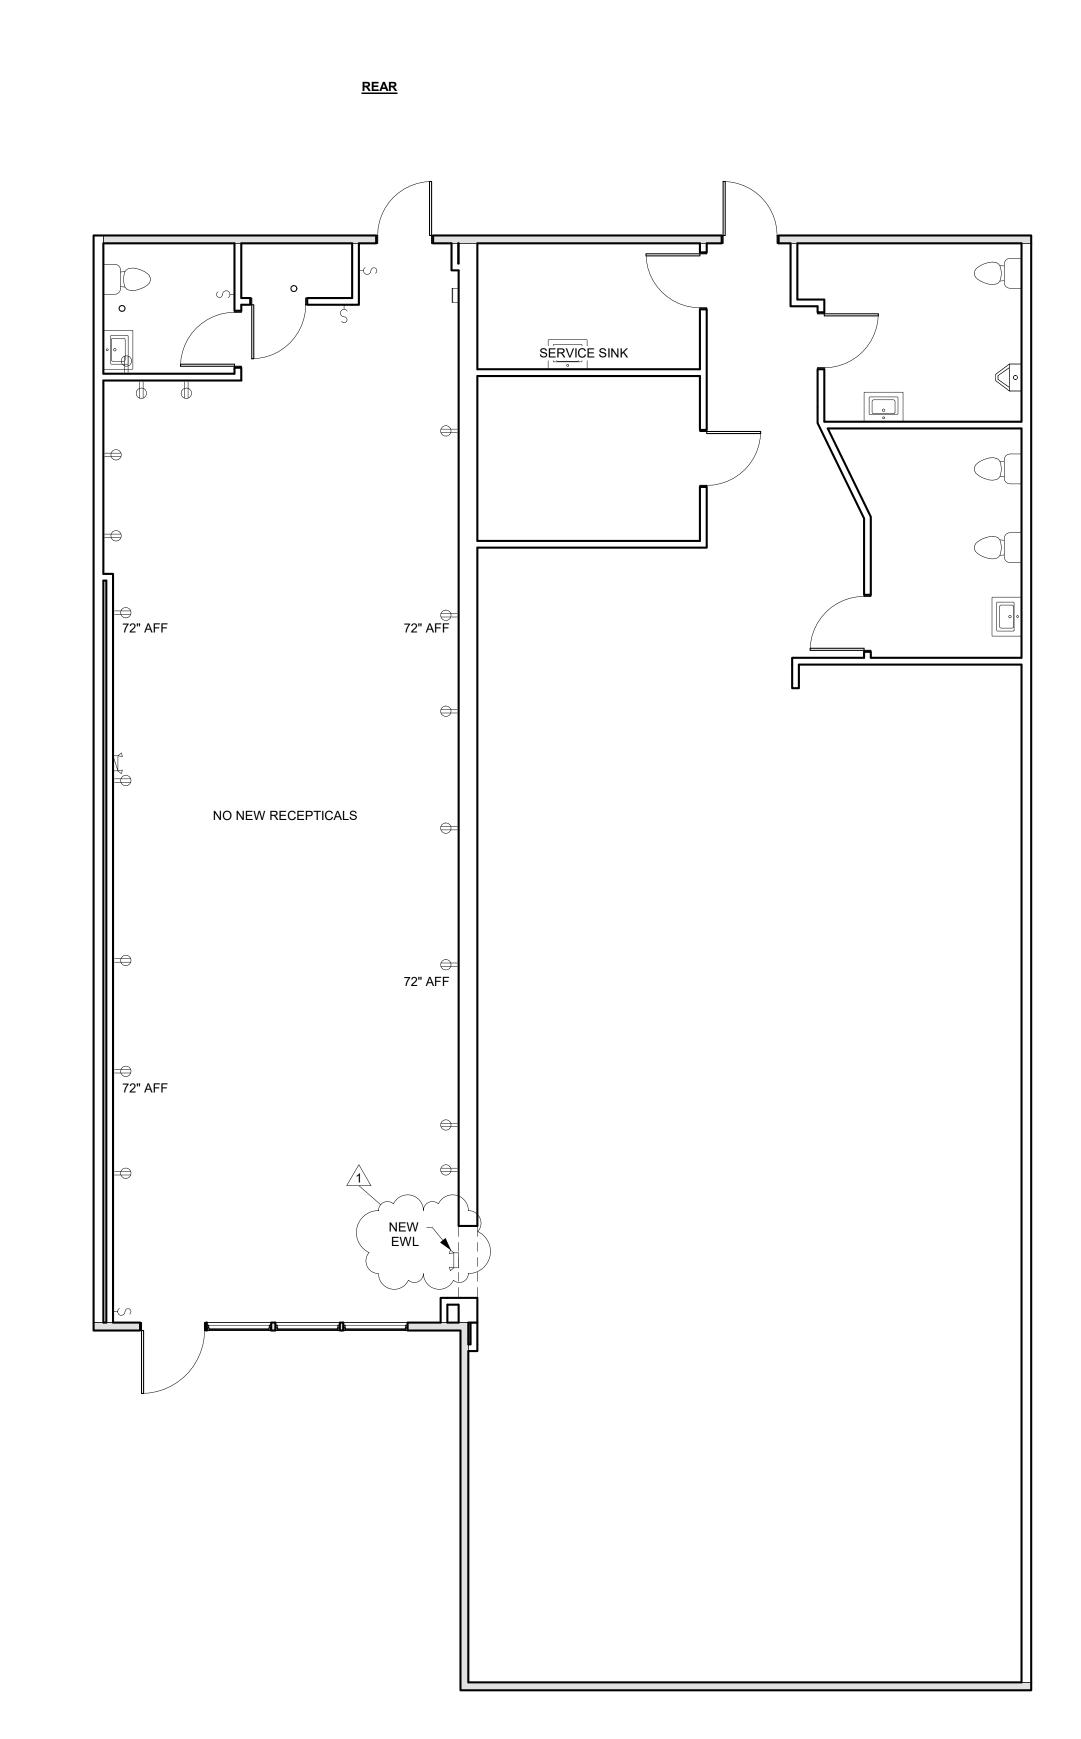

FRONT

1 PLUMBING AND ELECTRICAL PLAN 3/16" = 1'-0"

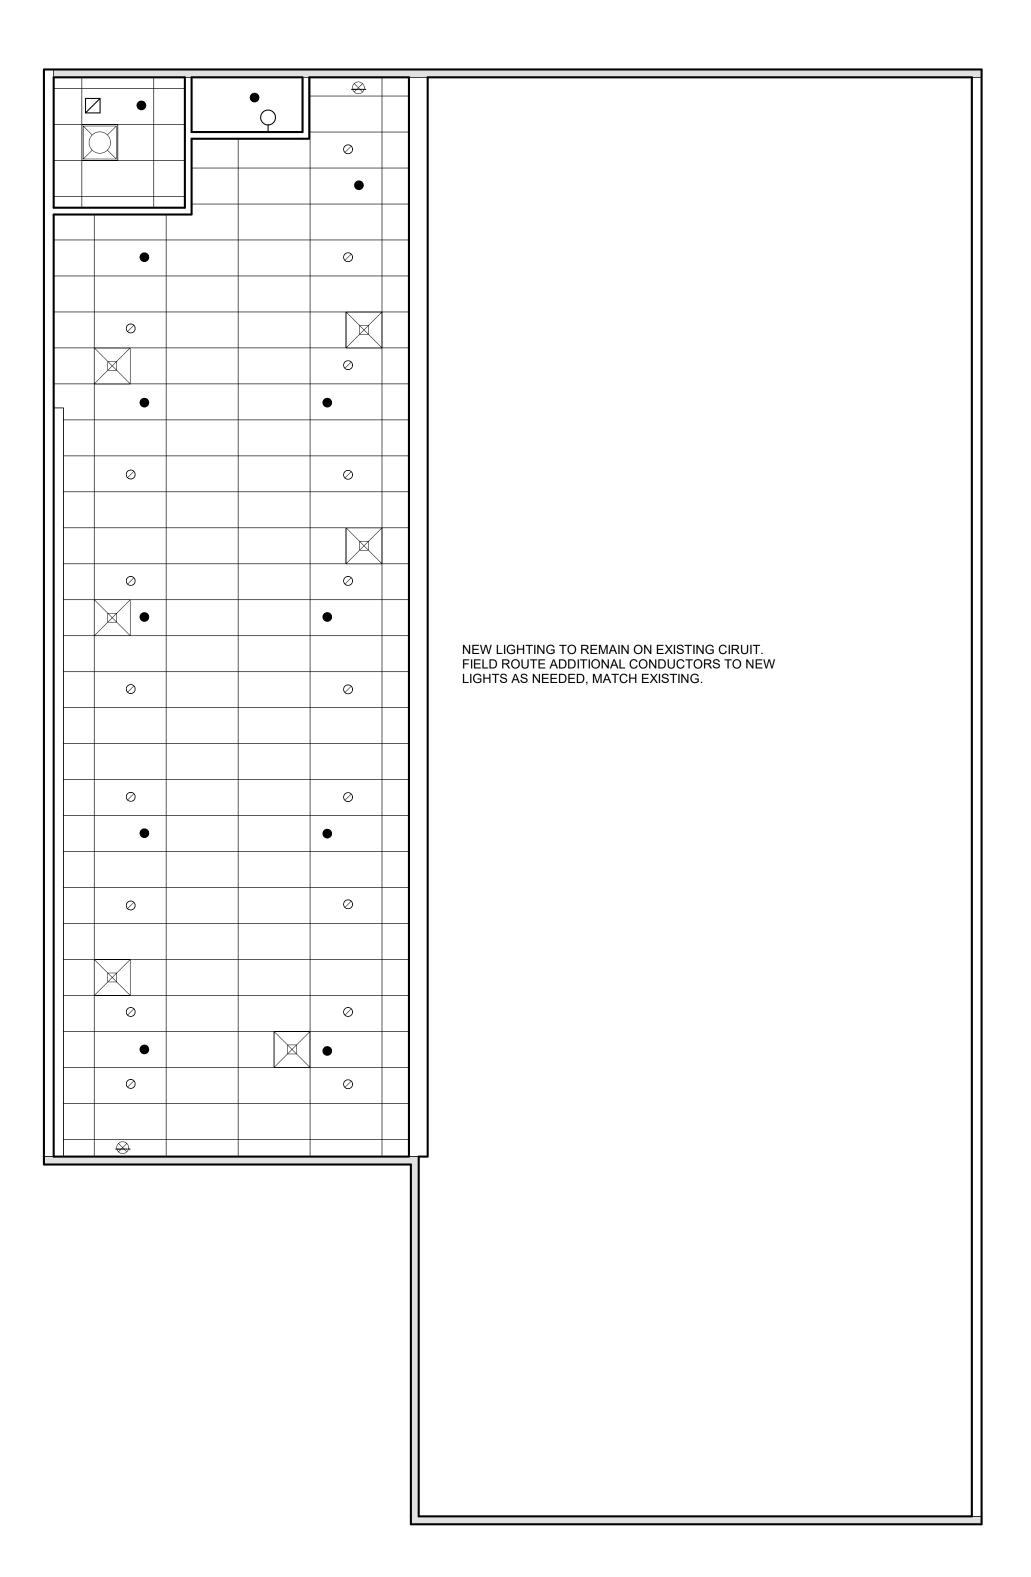

FRONT

2 REFLECTED CEILING PLAN 3/16" = 1'-0"

<u>REAR</u>



4/5/2023 12:19:45 PM

As indicated

DATE

SCALE

REFLECTED CEILING PLAN NOTES

4

- PATCH AND REPAIR CEILING GRID AS NECESSARY. PATCH AND REPAIR CEILING TILE S NECESSARY. CEILING GRID TO BE INSTALLED IN CONTINUOUS PATTERN. RECESSED LIGHTING BASED OFF OF 12 WATT, 600
- LUMEN, 6" CAN. FINAL LIGHTING PLAN TO BE PROVIDED BY CONTRACTOR IN COMPLIANCE WITH 2018 IBC.


REFLECTED CEILING LEDGEND

EXISTING EXHUAST FAN

- EXISTING SUPPLY VENT EXISTING EXIT SIGN
- EXISTING EMERGENCY WALL LIGHT
- NEW EMERGENCY WALL LIGHT

ELECTRICAL + PLUMBING LEDGEND

- EXISTING DUPLEX RECEPTCALE
- S EXISTING 1 WAY LIGHT SWITCH

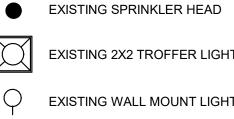

•

EXISTING 2X2 TROFFER LIGHTING

- C EXISTING WALL MOUNT LIGHT
- NEW RECESSED LIGHTING
- O EXISTING FLOOR DRAIN
 - EXISTING MOP SINK

GENERAL NOTES

1.	THE GENERAL SCOPE OF WORK INCLUDES THE INTERIOR REMODEL OF THE MAIN LEVEL OF AN EXISTING OFFICE BUILDING. REMODEL WORK IS ANTICIPATED TO INCLUDE, BUT NOT LIMITED TO:
	A. DEMOLITION OF EXISTING NONLOAD-BEARING WALLS, DOORS, INTERIOR FINISHES,
	MECHANICAL (SUPPLY/RETURN DUCTS AND VENTS), AND ELECTRICAL (LIGHTING, RECEPTACLES, CONDUCTORS, ETC.).
	B. CONSTRUCTION OF INTERIOR PARTITION WALLS.
	C. CONSTRUCTION OF NEW RESTROOM FACILITIES.
	D. INSTALLATION OF NEW INTERIOR FINISHES AND FURNISHINGS.
	E. INSTALLATION OF NEW ELECTRICAL COMPONENTS AS INDICATED ON THE PLANS.
	F. INSTALLATION OF NEW MECHANICAL PER MECHANICAL DRAWINGS BY OTHERS.
2.	ALL WORK SHALL BE PERFORMED IN COMPLIANCE WITH THE 2018 INTERNATIONAL BUILDING CODE,
	AS ADOPTED BY THE CITY OF LEE'S SUMMIT, MISSOURI, ORDINANCE #8536.
3.	NO STRUCTURAL COMPONENTS OF THE EXISTING BUILDING ARE ANTICIPATED TO BE REMOVED
	AND/OR MODIFIED AS A PORTION OF THIS REMODEL PROJECT. CONTRACTOR SHALL NOT REMOVE,
	CHANGE, OR MODIFY ANY LOAD BEARING MEMBER (WALL, BEAM, JOIST, COLUMN, ETC.) WITHOUT
	CONSULTING THE OWNER AND WRITTEN PLAN FROM THE ENGINEER.

FIRE & LIFE SAFETY

1.	CONTRACTOR SHALL ENSURE THAT ALL EXISTING EMERGENCY WALL LIGHTING IS OPERATIONAL. ANY NON-OPERATIONAL EMERGENCY LIGHT FIXTURES MUST BE REPLACED
	WITH AN EQUAL OR BETTER FIXTURE.
2.	ANY EXISTING EMERGENCY WALL LIGHTING MOUNTED TO AN EXISTING WALL, SCHEDULED
	FOR DEMOLITION, MUST BE REMOVED, AND RELOCATED TO A POINT THAT PROVIDES THE
	SAME OR BETTER ILLUMINATION OF THE EGRESS PATH.
3.	CONTRACTOR TO PROVIDE A-B-C DRY CHEMICAL PORTABLE FIRE EXTINGUISHERS, AS
	REQUIRED BY CODE.


PLUMBING

3.


- ALL NEW PLUMBING MUST BE INSTALLED TO MEET THE 2018 INTERNATIONAL PLUMBING CODE PROVIDE A 2" VENT FOR SANITARY SEWER DRAINAGE. TRANSITION VENT TO 4" AT ROOF 1 2. PENETRATION.
- INSTALL A CLEAN OUT AT THE BEGINNING OF EACH DRAINAGE RUN. PROVIDE THE FOLLOWING MINIMUM DRAIN SIZES FOR EACH FIXTURE. INCREASE THE SIZE OF DRAINPIPE AT EACH CONNECTION, AS REQUIRED TO MEET THE 2018 IPC. 4.

Plumbing Fixture	Drain (inch) ¹
Lavatory	1.25
Sink	1.5
Dishwasher ²	1.5
Water Closet	4
Urinal	2
Floor Drain	2
Shower	2
1 Trap to match drain diameter unless integrated in fixt	ure


2 Dishwasher discharge can be integrated into sink drain upstream of trap.

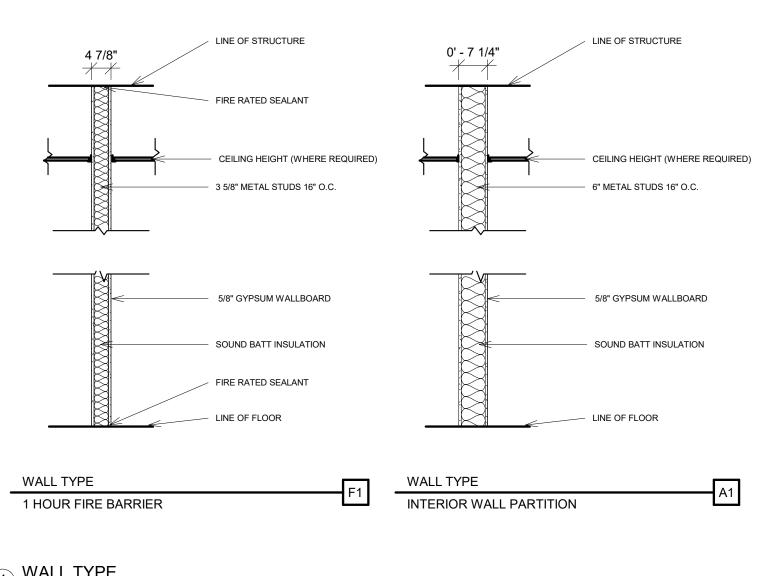


1 WALL TYPE 1/2" = 1'-0"

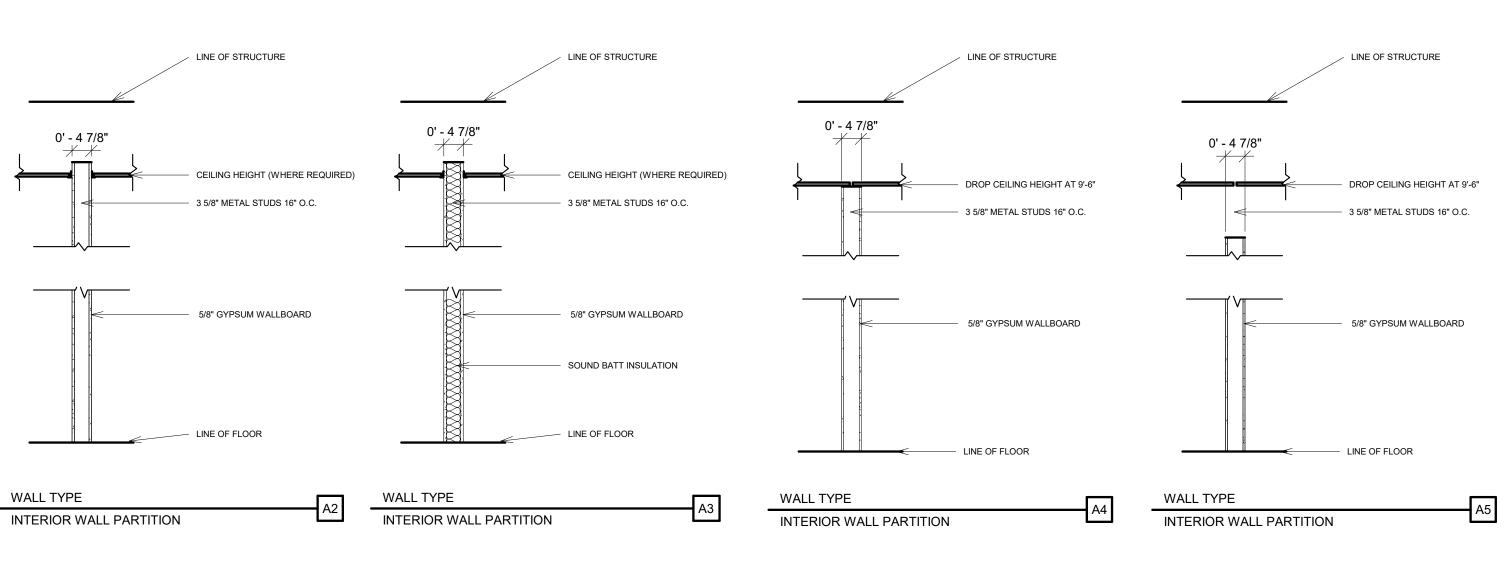



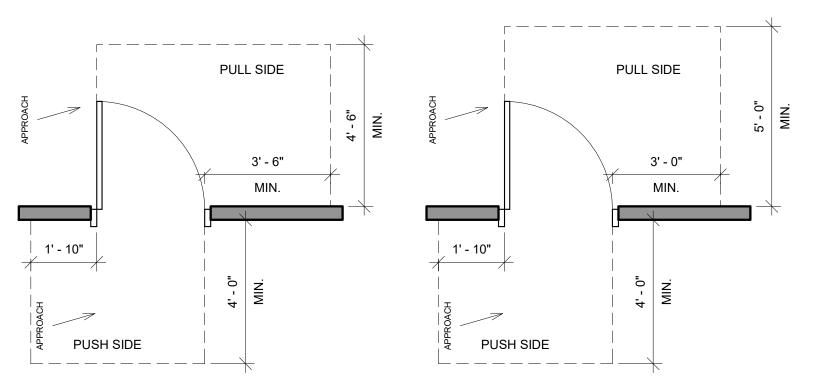

3 SINK IN COUNTER CLEARANCE 1/2" = 1'-0"

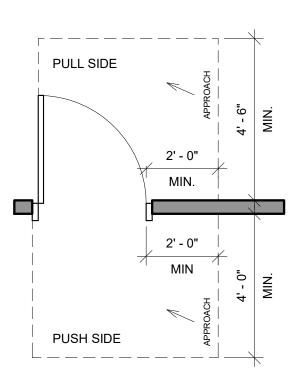

4 ACCESSIBLE CLEAR FLOOR SPACE 1/2" = 1'-0"

