
# CITY OF LEE'S SUMMIT

# FIRE STATION #5

801 MISSOURI HIGHWAY 150 LEE'S SUMMIT, MISSOURI 64082

# ISSUED FOR CONSTRUCTION



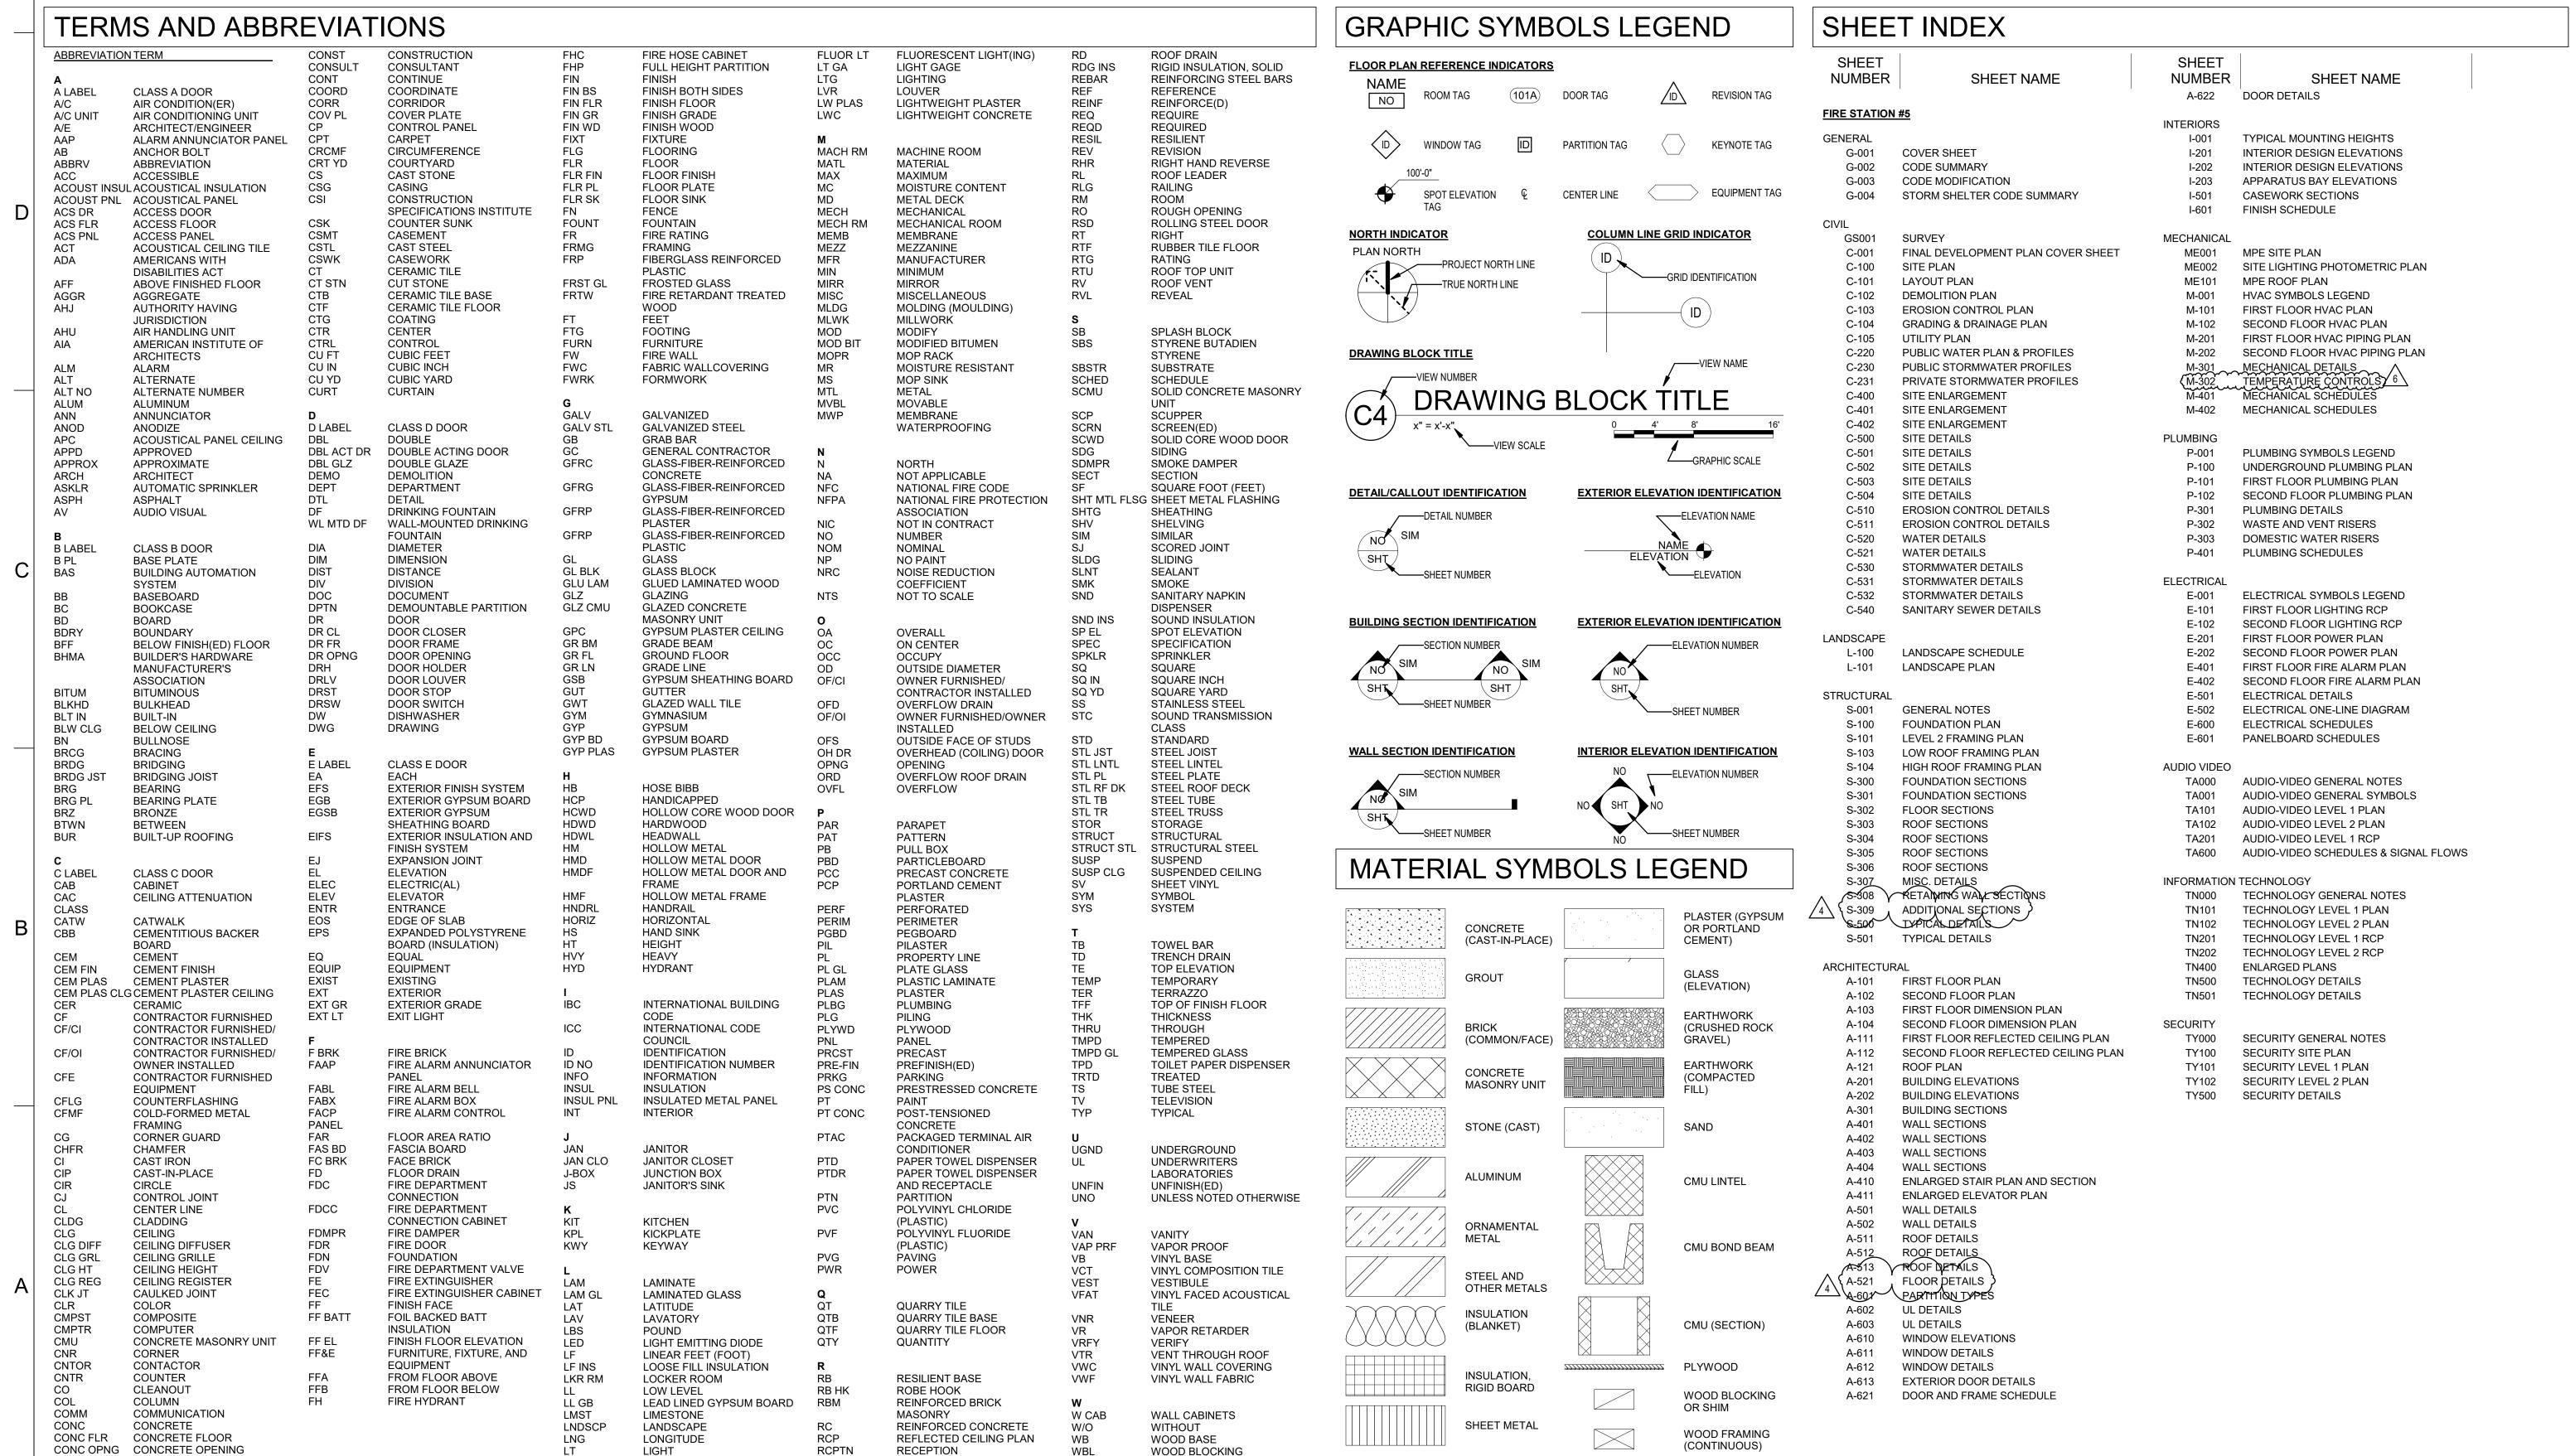

9229 WARD PARKWAY
SUITE # 210
KANSAS CITY, MO 64114
TEL: (816) 444-4200
FAX: (316) 265-5646
www.glmv.com
GLMV ARCHITECTURE, INC.
MISSOURI STATE CERTIFICATE OF AUTHORIT
#000305

CONSULTING ARCHITECT
FGMA ARCHITECTS
11250 ROGER BACON DRIVE, SUITE 10
RESTON, VIRGINIA 20190

CIVIL ENGINEER & LANDSCAPE ARCH.
GLMV ARCHITECTURE, INC
MISSOURI CIVIL COA #2018033898
MISSOURI LANDSCAPE COA #000008
9229 WARD PARKWAY, SUITE # 210
KANSAS CITY, MO 64114

STRUCTURAL ENGINEER
LEIGH + O'KANE
MISSOURI COA #001644
250 NE MULBERRY, SUITE 201

LEE'S SUMMIT, MO 64086 (816) 444-3144

MECH., ELECT. & PLMG. ENGINEERS HOSS & BROWN ENGINEERS MISSOURI COA #01022 15902 MIDLAND DRIVE

(913) 362.9090

SECURITY & IT ENGINEERS
HENDERSON ENGINEERS
MISSOURI COA #000556
1801 MAIN STREET, SUITE 300
KANSAS CITY, MO 64108

SHAWNEE, KS 66217

(816) 663-8700

150 1 64082 FOR CONSTRUCTION

T OF LEE'S SUMMIT 1 MISSOURI HIGHWAY E'S SUMMIT, MISSOUR

REVISIONS:

# Description Date
4 ASI 04 02/01/2023
6 ASI 06 02/22/2023

ОШ



MO# A-2018024473

The Professional Architects seal affixed to this sheet applies only to the material and items shown on this sheet. All drawings, instruments or other documents not exhibiting this seal shall not be considered prepared by this architect, and this architect expressly disclaims any and all responsibility for such plan, drawings, or documents not exhibiting this seal.

PROJECT NO: 18225R21001

DATE: 02.22.2023


DRAWN BY: CRB

CHK'D BY: PJM

© GLMV Architecture, Inc.
All work herein is the property of GLMV
Architecture, Inc. and is not to be copied or used in any way without the express written consent of GLMV Architecture, Inc.

COVER SHEET

G-001

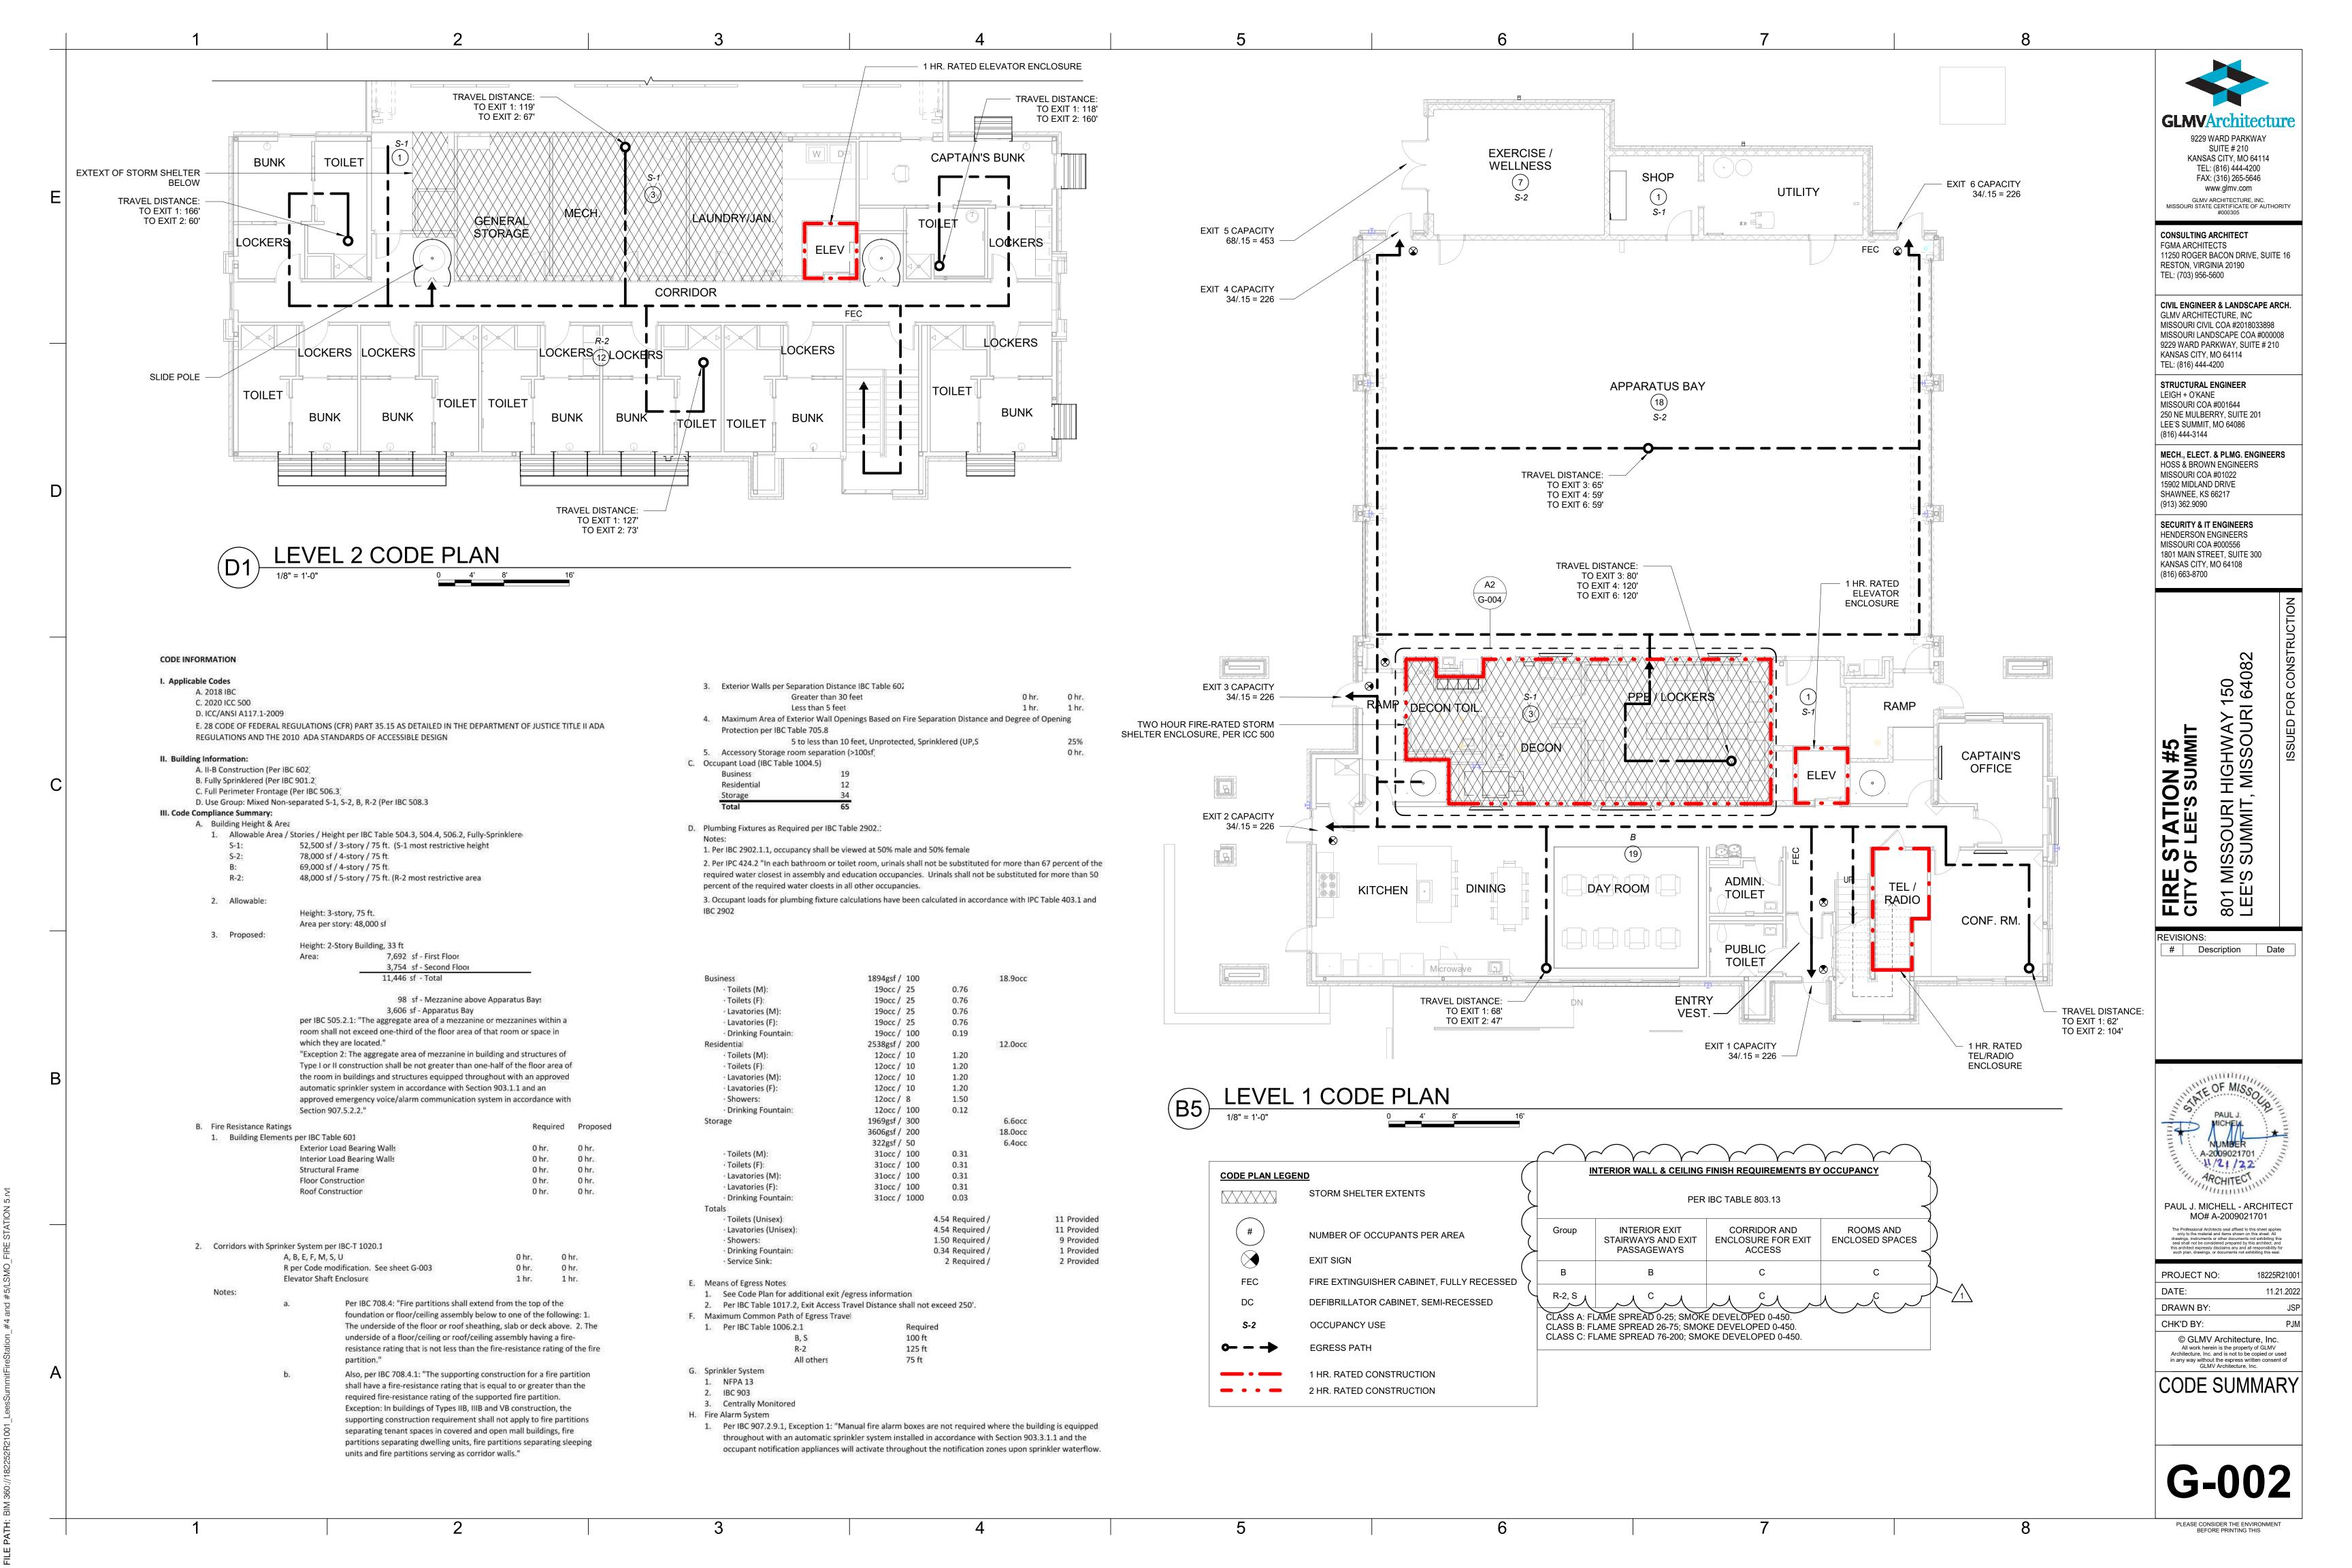



Reston, Virginia 20190 703.956.5600 T 703.956.5601 F

8 of 655

#### § 35.151(e) Social service center establishments

installation at a later date.

In the NPRM, the Department proposed a new Sec. 35.151(e) requiring group homes, halfway houses, shelters, or similar social service center establishments that provide temporary sleeping accommodations or residential dwelling units to comply with the provisions of the 2004 ADAAG that apply to residential facilities. including, but not limited to, the provisions in sections 233 and 809.

The NPRM explained that this proposal was based on two important changes in the 2004 ADAAG. First, for the first time, residential dwelling units are explicitly covered in the 2004 ADAAG in section 233. Second, the 2004 ADAAG eliminates the language contained in the 1991 Standards addressing scoping and technical requirements for homeless shelters, group homes, and similar social service cente establishments. Currently, such establishments are covered in section 9.5 of the transient lodging section of the 1991 Standards. The deletion of section 9.5 creates an ambiguity of coverage that must be addressed.

The NPRM explained the Department's belief that transferring coverage of social service center establishments from the transient lodging standards to the residential facilities standards would alleviate conflicting requirements for social service center providers. The Department believes that a substantial percentage of social service center establishments are recipients of Federal financial assistance from the Department of Housing and Urban Development (HUD). The Department of Health and Human Services (HHS) also provides financial assistance for the operation of shelters through the Administration for Children and Families programs. As such, these establishments are covered both by the ADA and section 504 of the Rehabilitation Act. UFAS is currently the design standard for new construction and alterations for entities subject to section 504. The two design standards for accessibility--the 1991 Standards and UFAS--have confronted many social service

12/10/2021, 9:57 AM

vertical egress elements are located on the second floor and provide egress paths that allow for remote ways of exiting the building safely and address the intent of the code.

TRAVEL DISTANCE TO EXIT 7: 69° TO EXIT 3: 70°

Toilets (M): Toilets (F): Lovatories (M): Lovatories (F): Drinking Fountain:

LECTRICAL SPRINKLER COMPR SHOP

------

TRAVEL DISTANCE TO EXIT 3: 72' TO EXIT 7: 72'

ران المراجعة المراجعة

INTERIOR FINISH REQUIREMENTS

ADMIN. TOILET

EXIT 1 CAPACITY 34/.15 = 226

EXIT 3 GAPACITY 34/.15 = 226

TWO HOUR FIRE-RATED STORM SHELTER ENCLOSURE, PER ICC 500

EVSICHS Description Date

ARCHITECT NAME - ARCHITECT MOR A-XXXXXXX

CODE SUMMARY

G-002

SLIDE POLE WITH 1-HR RATE FLOOR ENCLOSURE, TYP.

\_\_\_\_

1 LEVEL 1 CODE PLAN

(XXXXXX)

STORM SHELTER USABL

EGRESS PATH

1/2 HR. RATED CONSTRUCTION

1 HR. RATED CONSTRUCTION

2 HR. RATED CONSTRUCTION

FIRE EXTINGUISHER CABINET, FULLY RECESS DEFIBRILLATOR CABINET, SEMI-RECESSED OCCUPANCY USE

Matthew Fadel, AIA, LEED AF Project Manager

2 LEVEL 2 CODE PLAN



SUITE # 210 KANSAS CITY, MO 64114 TEL: (816) 444-4200 FAX: (316) 265-5646 www.glmv.com GLMV ARCHITECTURE, INC. MISSOURI STATE CERTIFICATE OF AUTHORITY #000305

9229 WARD PARKWAY

CONSULTING ARCHITECT FGMA ARCHITECTS 11250 ROGER BACON DRIVE, SUITE 16 RESTON, VIRGINIA 20190 TEL: (703) 956-5600

CIVIL ENGINEER & LANDSCAPE ARCH. GLMV ARCHITECTURE, INC MISSOURI CIVIL COA #2018033898 MISSOURI LANDSCAPE COA #000008 9229 WARD PARKWAY, SUITE # 210 KANSAS CITY, MO 64114 TEL: (816) 444-4200

STRUCTURAL ENGINEER LEIGH + O'KANE MISSOURI COA #001644 250 NE MULBERRY, SUITE 201 LEE'S SUMMIT. MO 64086 (816) 444-3144

MECH., ELECT. & PLMG. ENGINEERS HOSS & BROWN ENGINEERS MISSOURI COA #01022 15902 MIDLAND DRIVE SHAWNEE, KS 66217 (913) 362.9090

SECURITY & IT ENGINEERS HENDERSON ENGINEERS MISSOURI COA #000556 1801 MAIN STREET, SUITE 300 KANSAS CITY, MO 64108 (816) 663-8700

FIRE STAT S ОШ

REVISIONS: # Description

A-2009021701 11/21/22 ARCHITECT

PAUL J. MICHELL - ARCHITECT MO# A-2009021701

PROJECT NO: 18225R21001 DATE: 11.21.2022 DRAWN BY: CHK'D BY: © GLMV Architecture, Inc. All work herein is the property of GLMV

CODE **MODIFICATION** 

Architecture, Inc. and is not to be copied or used in any way without the express written consent of GLMV Architecture, Inc.

PLEASE CONSIDER THE ENVIRONMENT BEFORE PRINTING THIS

eliminate the requirement for the "B" and "R-2" occupancies to have 1-hour fire rated separation between

the main stair to be open and communicate between the first and second floors and would also allow the


Matthew Fadel, AIA, LEED AP

Project Manager

occupancies and to eliminate the continuous 1/2-hour fire rating for egress to an exit. This would allow for

two response fire poles to serve as the secondary means of egress from the second floor to the building

Reston, Virginia 20190 703.956.5600 T 703.956.5601 F

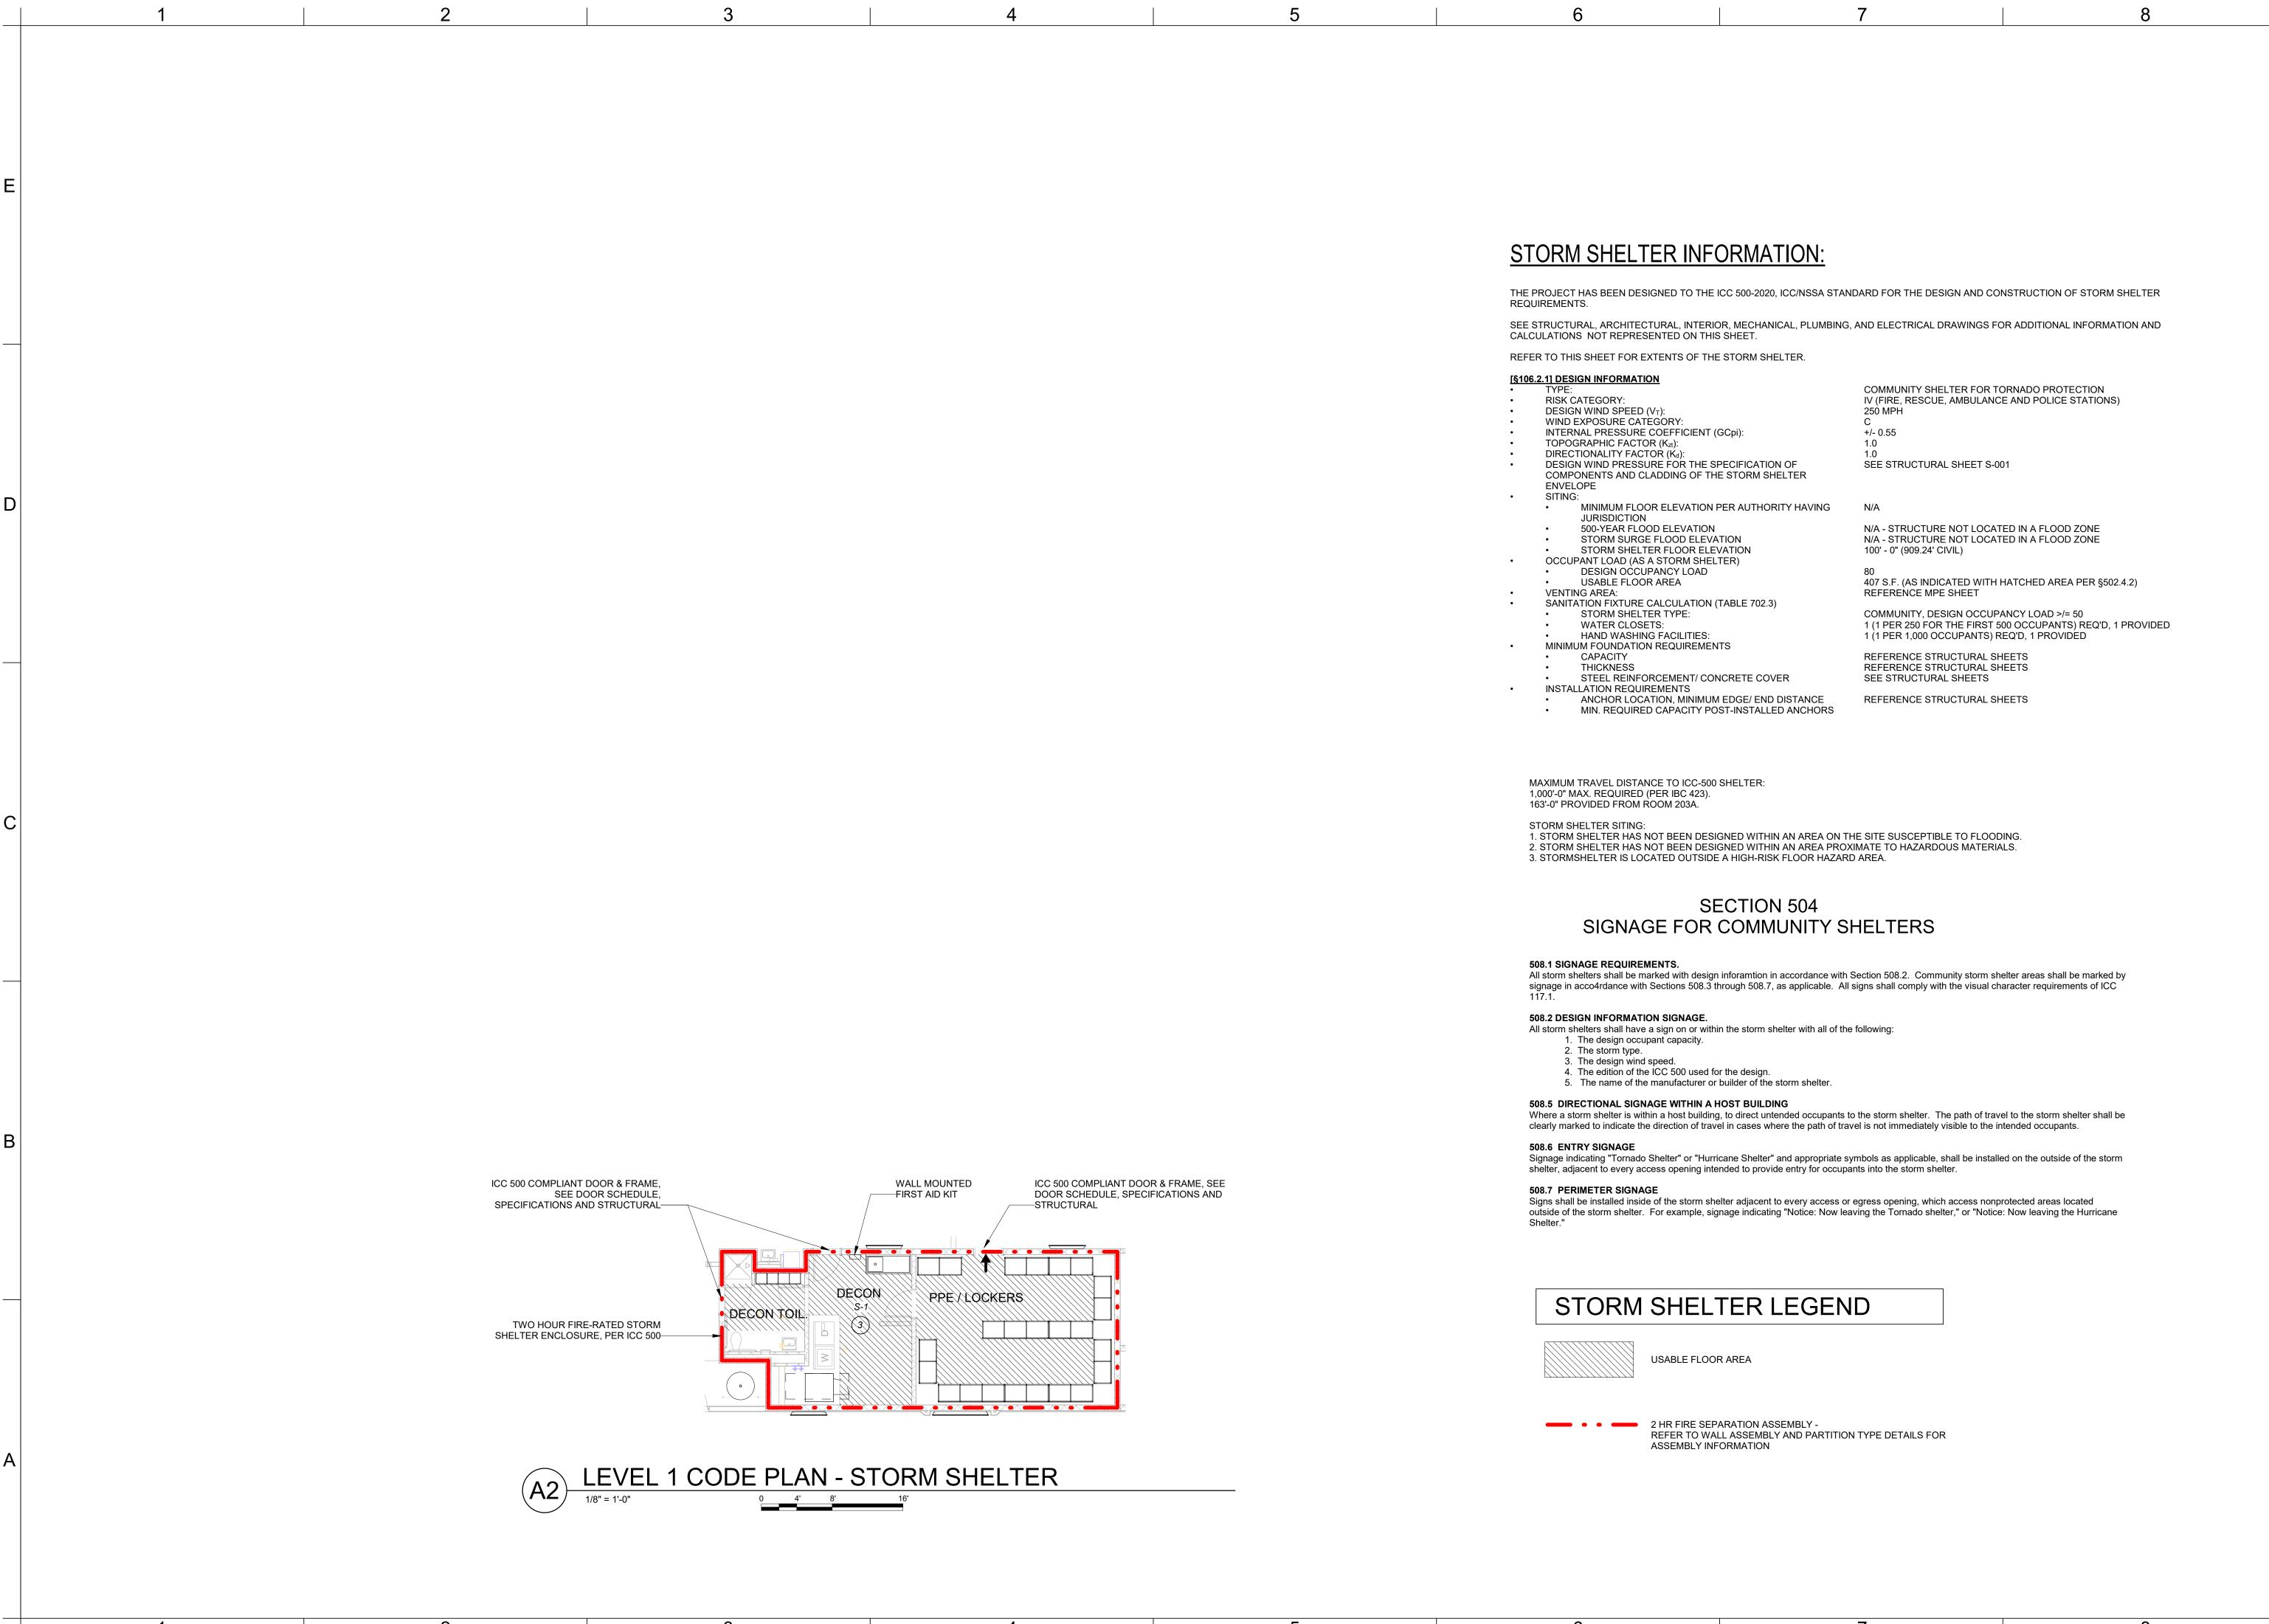



SUITE # 210

KANSAS CITY, MO 64114

TEL: (816) 444-4200

FAX: (316) 265-5646

www.glmv.com

GLMV ARCHITECTURE, INC.

MISSOURI STATE CERTIFICATE OF AUTHORITY

#000305

9229 WARD PARKWAY

CONSULTING ARCHITECT
FGMA ARCHITECTS
11250 ROGER BACON DRIVE, SUITE 16
RESTON, VIRGINIA 20190

TEL: (703) 956-5600

CIVIL ENGINEER & LANDSCAPE ARCH.
GLMV ARCHITECTURE, INC
MISSOURI CIVIL COA #2018033898
MISSOURI LANDSCAPE COA #000008
9229 WARD PARKWAY, SUITE # 210

MISSOURI LANDSCAPE COA #000008 9229 WARD PARKWAY, SUITE # 210 KANSAS CITY, MO 64114 TEL: (816) 444-4200 STRUCTURAL ENGINEER LEIGH + O'KANE

250 NE MULBERRY, SUITE 201 LEE'S SUMMIT, MO 64086 (816) 444-3144 MECH., ELECT. & PLMG. ENGINEERS HOSS & BROWN ENGINEERS

MISSOURI COA #001644

MISSOURI COA #01022 15902 MIDLAND DRIVE SHAWNEE, KS 66217 (913) 362.9090 SECURITY & IT ENGINEERS

SECURITY & IT ENGINEERS
HENDERSON ENGINEERS
MISSOURI COA #000556
1801 MAIN STREET, SUITE 300
KANSAS CITY, MO 64108
(816) 663-8700

AY 150 URI 64082

FIRE STATION #5
CITY OF LEE'S SUMMIT
801 MISSOURI HIGHWAY
LEE'S SUMMIT, MISSOUR

REVISIONS:

# Description Date



PAUL J. MICHELL - ARCHITECT MO# A-2009021701


The Professional Architects seal affixed to this sheet applies only to the material and items shown on this sheet. All

PROJECT NO:	18225R21001
DATE:	11.21.2022
DRAWN BY:	JSP
CHK'D BY:	PJM
© GLMV Archite	ecture, Inc.

TORM SHELTER

All work herein is the property of GLMV Architecture, Inc. and is not to be copied or used

G-004

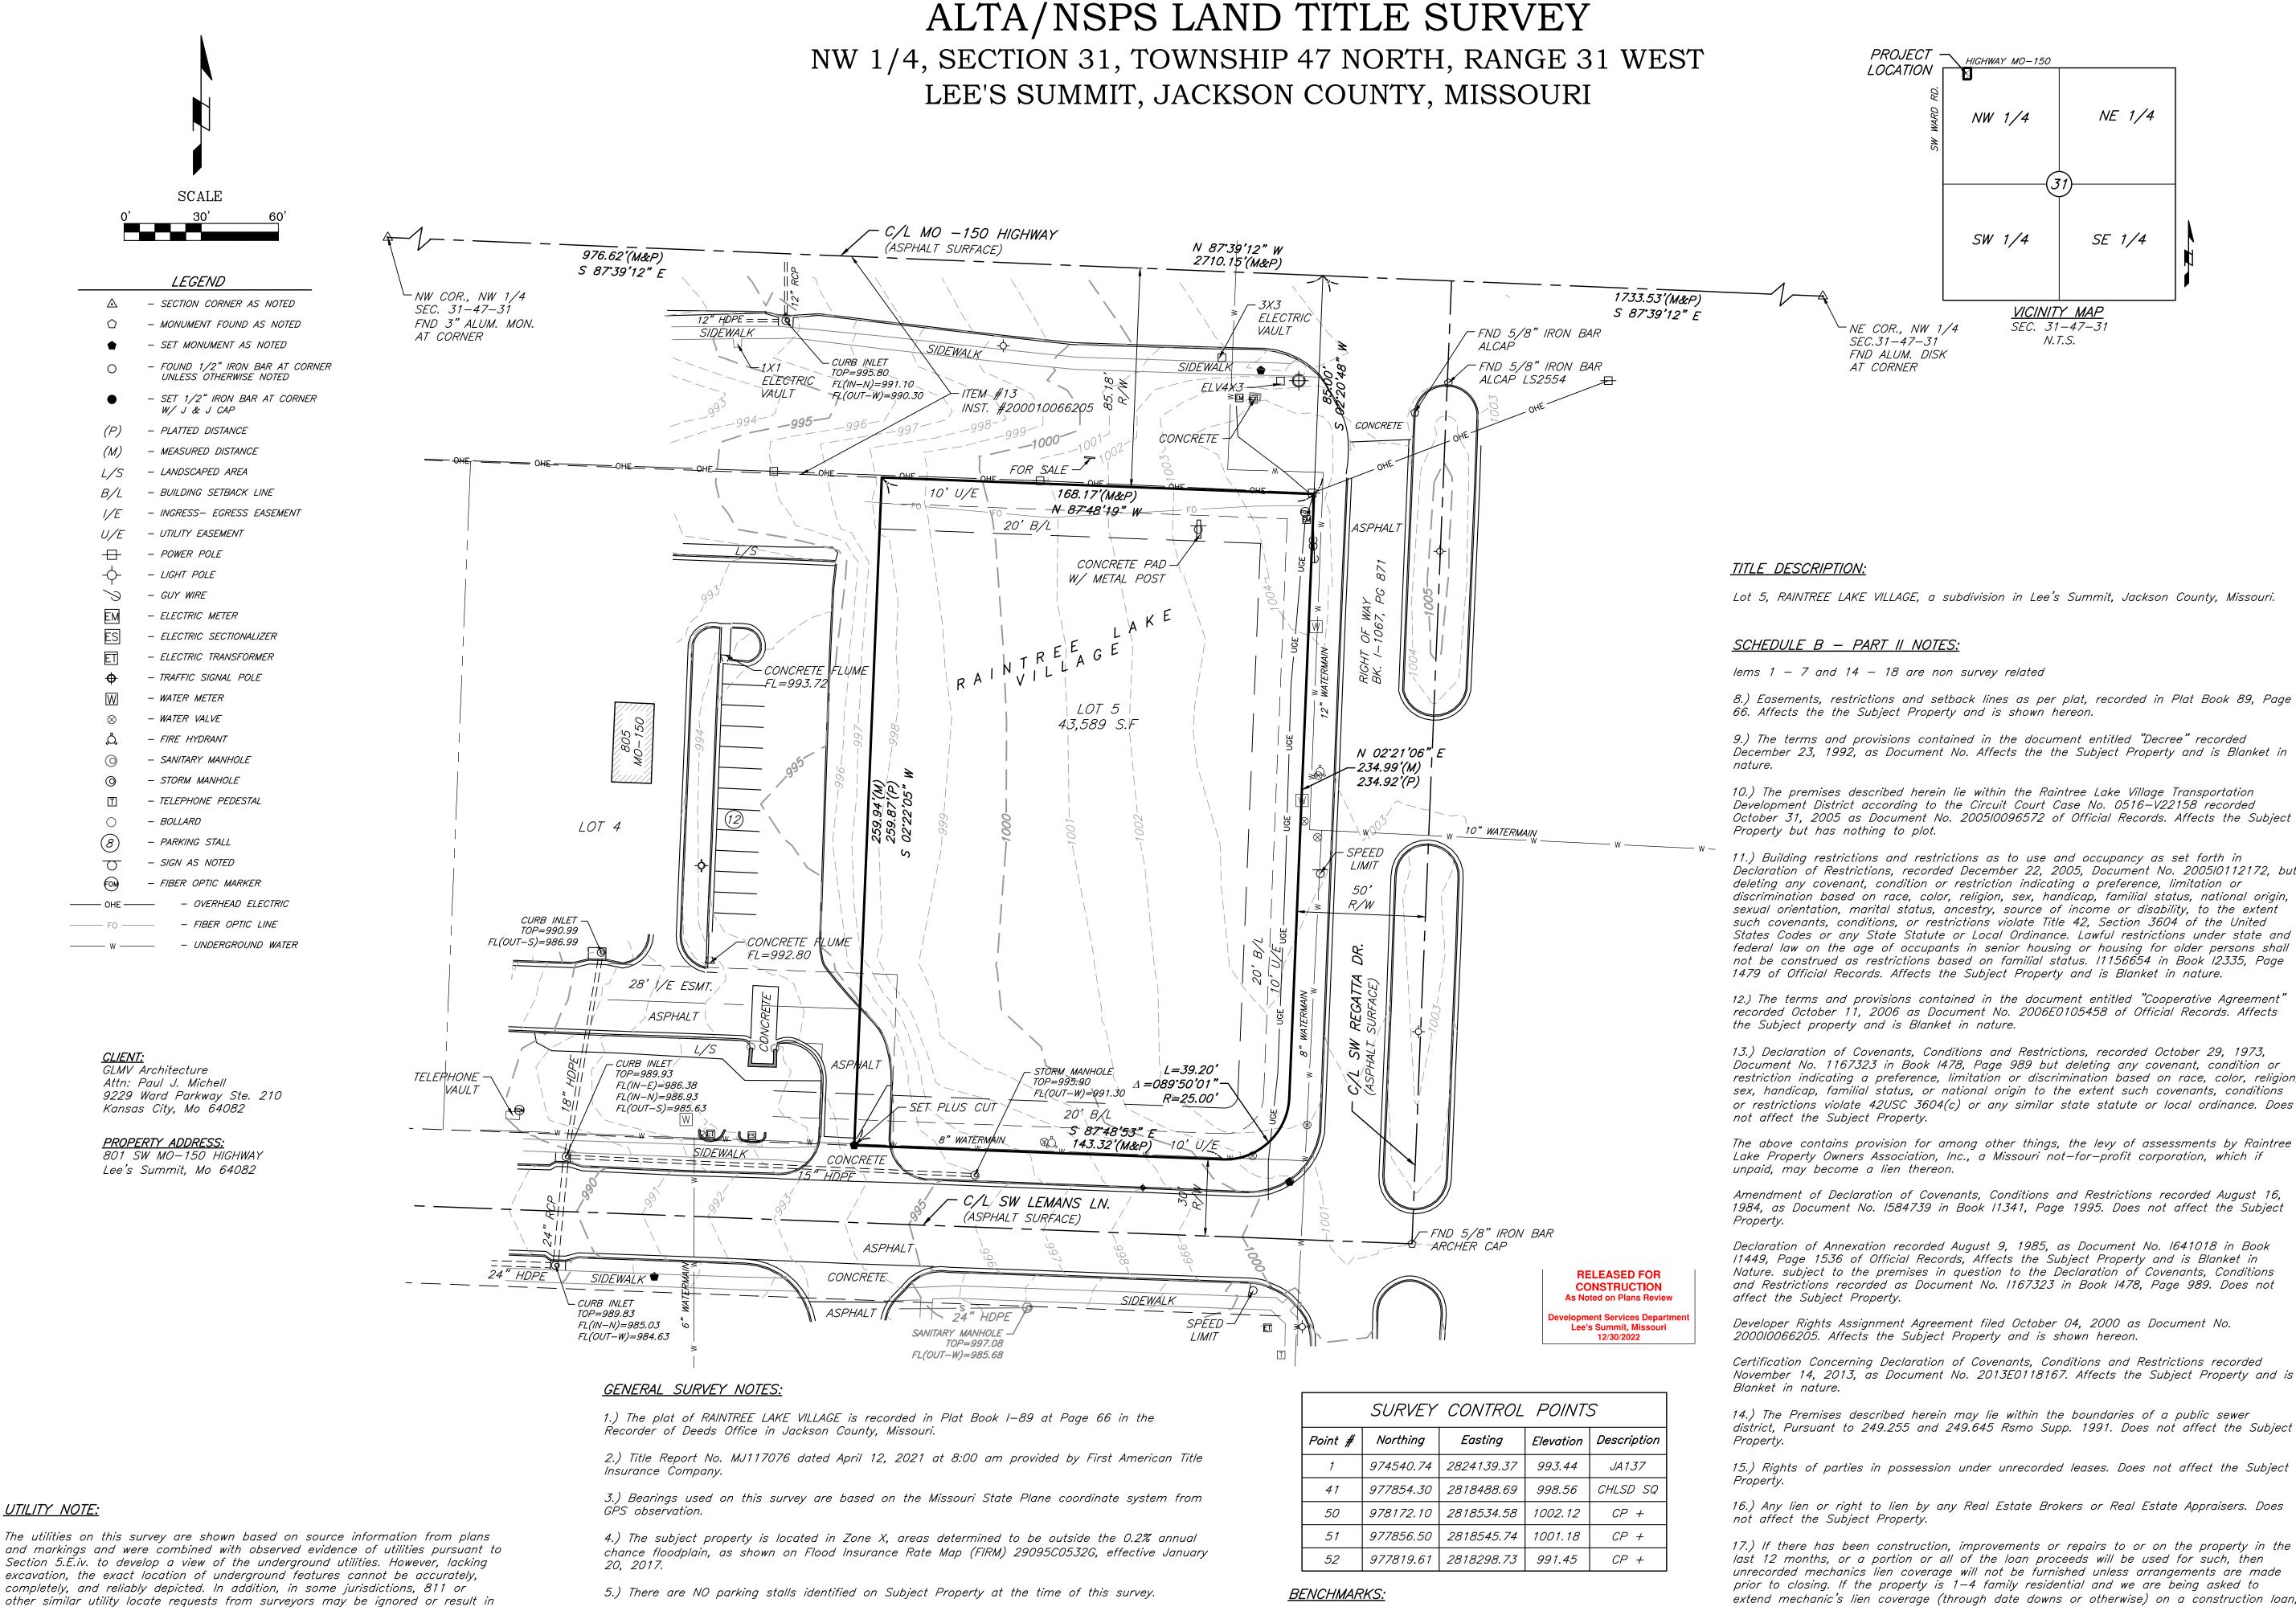

6.) There were no Wetland delineation at the time of survey.

7.) This property is Zoned CP-2, Planned Community Commercial

8.) Water utilities are based on the City Map image provided by City of Lee's Summit, Missouri,

an incomplete response, in which case the surveyor shall note on the plat or

utilities. Where additional or more detailed information is required, the client is

map how this affected the surveyor's assessment of the location of the

advised that excavation and/or a private utility locate request may be

necessary.

8.) Easements, restrictions and setback lines as per plat, recorded in Plat Book 89, Page 66. Affects the the Subject Property and is shown hereon.

PROJECT — HIGHWAY MO-150

NW 1/4

SW 1/4

<u>VICINITY MAP</u>

SEC. 31-47-31

N. T. S.

NE 1/4

9.) The terms and provisions contained in the document entitled "Decree" recorded December 23, 1992, as Document No. Affects the the Subject Property and is Blanket in

10.) The premises described herein lie within the Raintree Lake Village Transportation Development District according to the Circuit Court Case No. 0516-V22158 recorded October 31, 2005 as Document No. 2005/0096572 of Official Records. Affects the Subject Property but has nothing to plot.

11.) Building restrictions and restrictions as to use and occupancy as set forth in Déclaration of Restrictions, recorded December 22, 2005, Document No. 2005/0112172, but deleting any covenant, condition or restriction indicating a preference, limitation or discrimination based on race, color, religion, sex, handicap, familial status, national origin, sexual orientation, marital status, ancestry, source of income or disability, to the extent such covenants, conditions, or restrictions violate Title 42, Section 3604 of the United States Codes or any State Statute or Local Ordinance. Lawful restrictions under state and federal law on the age of occupants in senior housing or housing for older persons shall not be construed as restrictions based on familial status. I1156654 in Book I2335, Page 1479 of Official Records. Affects the Subject Property and is Blanket in nature.

12.) The terms and provisions contained in the document entitled "Cooperative Agreement" recorded October 11, 2006 as Document No. 2006E0105458 of Official Records. Affects the Subject property and is Blanket in nature.

13.) Declaration of Covenants, Conditions and Restrictions, recorded October 29, 1973, Document No. 1167323 in Book 1478, Page 989 but deleting any covenant, condition or restriction indicating a preference, limitation or discrimination based on race, color, religion, sex, handicap, familial status, or national origin to the extent such covenants, conditions or restrictions violate 42USC 3604(c) or any similar state statute or local ordinance. Does not affect the Subject Property.

The above contains provision for among other things, the levy of assessments by Raintree Lake Property Owners Association, Inc., a Missouri not-for-profit corporation, which if unpaid, may become a lien thereon.

Amendment of Declaration of Covenants, Conditions and Restrictions recorded August 16, 1984, as Document No. 1584739 in Book 11341, Page 1995. Does not affect the Subject

Declaration of Annexation recorded August 9, 1985, as Document No. 1641018 in Book 11449, Page 1536 of Official Records, Affects the Subject Property and is Blanket in Nature. subject to the premises in question to the Declaration of Covenants, Conditions and Restrictions recorded as Document No. 1167323 in Book 1478, Page 989. Does not affect the Subject Property.

Developer Rights Assignment Agreement filed October 04, 2000 as Document No. 2000/0066205. Affects the Subject Property and is shown hereon.

Certification Concerning Declaration of Covenants, Conditions and Restrictions recorded November 14, 2013, as Document No. 2013E0118167. Affects the Subject Property and is

14.) The Premises described herein may lie within the boundaries of a public sewer district, Pursuant to 249.255 and 249.645 Rsmo Supp. 1991. Does not affect the Subject

16.) Any lien or right to lien by any Real Estate Brokers or Real Estate Appraisers. Does

not affect the Subject Property.

17.) If there has been construction, improvements or repairs to or on the property in the last 12 months, or a portion or all of the loan proceeds will be used for such, then unrecorded mechanics lien coverage will not be furnished unless arrangements are made prior to closing. If the property is 1-4 family residential and we are being asked to extend mechanic's lien coverage (through date downs or otherwise) on a construction loan, a Mechanic's Lien Indemnity Agreement secured by a satisfactory Letter of Credit will need to be furnished to the company. If the transaction is not a residential construction loan, either the aforesaid secured indemnity or satisfactory financial statements, indemnities, affidavits and possibly lien waivers, will need to be furnished to the company. Failure to notify the company in writing before closing will invalidate any mechanic's lien coverage given in the policy. Does not affect the Subject Property.



STATION JA 137: Alum Disk, Located about 0.7 miles South of the intersection of highway 150 and highway 291 of Lee's Summit.

ELEVATION = 993.44

# LEE'S SUMMIT FIRE STATION NO. 5 PRCOM20225393

# 801 SW MO 150 HIGHWAY LEE'S SUMMIT, MISSOURI 64082

# FINAL DEVELOPMENT PLAN

### **CONSULTANT:**



9229 WARD PKWY
KANSAS CITY, MISSOURI 64114
DERICK HOLMES
DERICK.HOLMES@GLMV.COM
T (816) 444-4200

#### PARCEL INFORMATION:

ACREAGE: 1.00

ADDRESS: 801 SW M0 150 HIGHWAY LEE'S SUMMIT, MO 64082

LEGAL DESCRIPTION ALL OF LOT 5, RAINTREE LAKE VILLAGE, A

SUBDIVISON IN THE NW 1/4 OF SECTION 31, T-47 N, R-31 W, LEE'S SUMMIT, JACKSON

COUNTY, MISSOURI

FEMA FLOODPLAIN

THE SUBJECT PROPERTY IS LOCATED IN ZONE X, AREAS DETERMINED TO BE OUTSIDE THE 0.2% ANNUAL CHANCE

FLOODPLAIN, AS SHOWN ON FLOOD INSURANCE RATE MAP (FIRM) 29095C0532G,

EFFECTIVE JANUARY 20, 2017.

OIL AND GAS WELLS

NO EVIDENCE OF OIL OR GAS WELLS WERE
FOUND ON LOT 6-A AND THE PORTION OF
LOT 7 PROPOSED TO BE REPLATTED AS
EVIDENCED BY THE FOLLOWING SOURCES

1. ATLAS/NSPS LAND SURVEY PERFORMED
BY J&J SURVEYING LLC, DATED AUGUST


12, 2021.2. MISSOURI SPATIAL DATA INFORMATION SERVICE (FEBRUARY 20, 2022), MO 2018 STATE PERMITTED OIL AND GAS WELLS.

RETRIEVED FROM HTTP://DATA-MSDIS.OPENDATA.ARCGIS.COM/DATASETS


ZONING CP-2, PLANNED COMMUNITY COMMERCIAL

LAND USE SCHEDULE		
TOTAL FLOOR AREA	12,189 SF	
NUMBER OF DWELLING UNITS	8	
LAND AREA	1.00 ACRES	
REQUIRED PARKING	DIRECTED BY FIRE CHIEF	
PROPOSED PARKING	13 SPACES	
IMPERVIOUS COVERAGE	25,745 SF (.59 ACRES)	
FLOOR AREA RATIO (FAR)	0.28	
PERMITTED LAND USE	FIRE STATION - MUNICIPAL = CONDITIONAL	
DWELLING UNITS PER ACRE WITH COMMON AREA	8	
DWELLING UNITS PER ACRE WITHOUT COMMON AREA	8	


### **VICINITY MAP:**

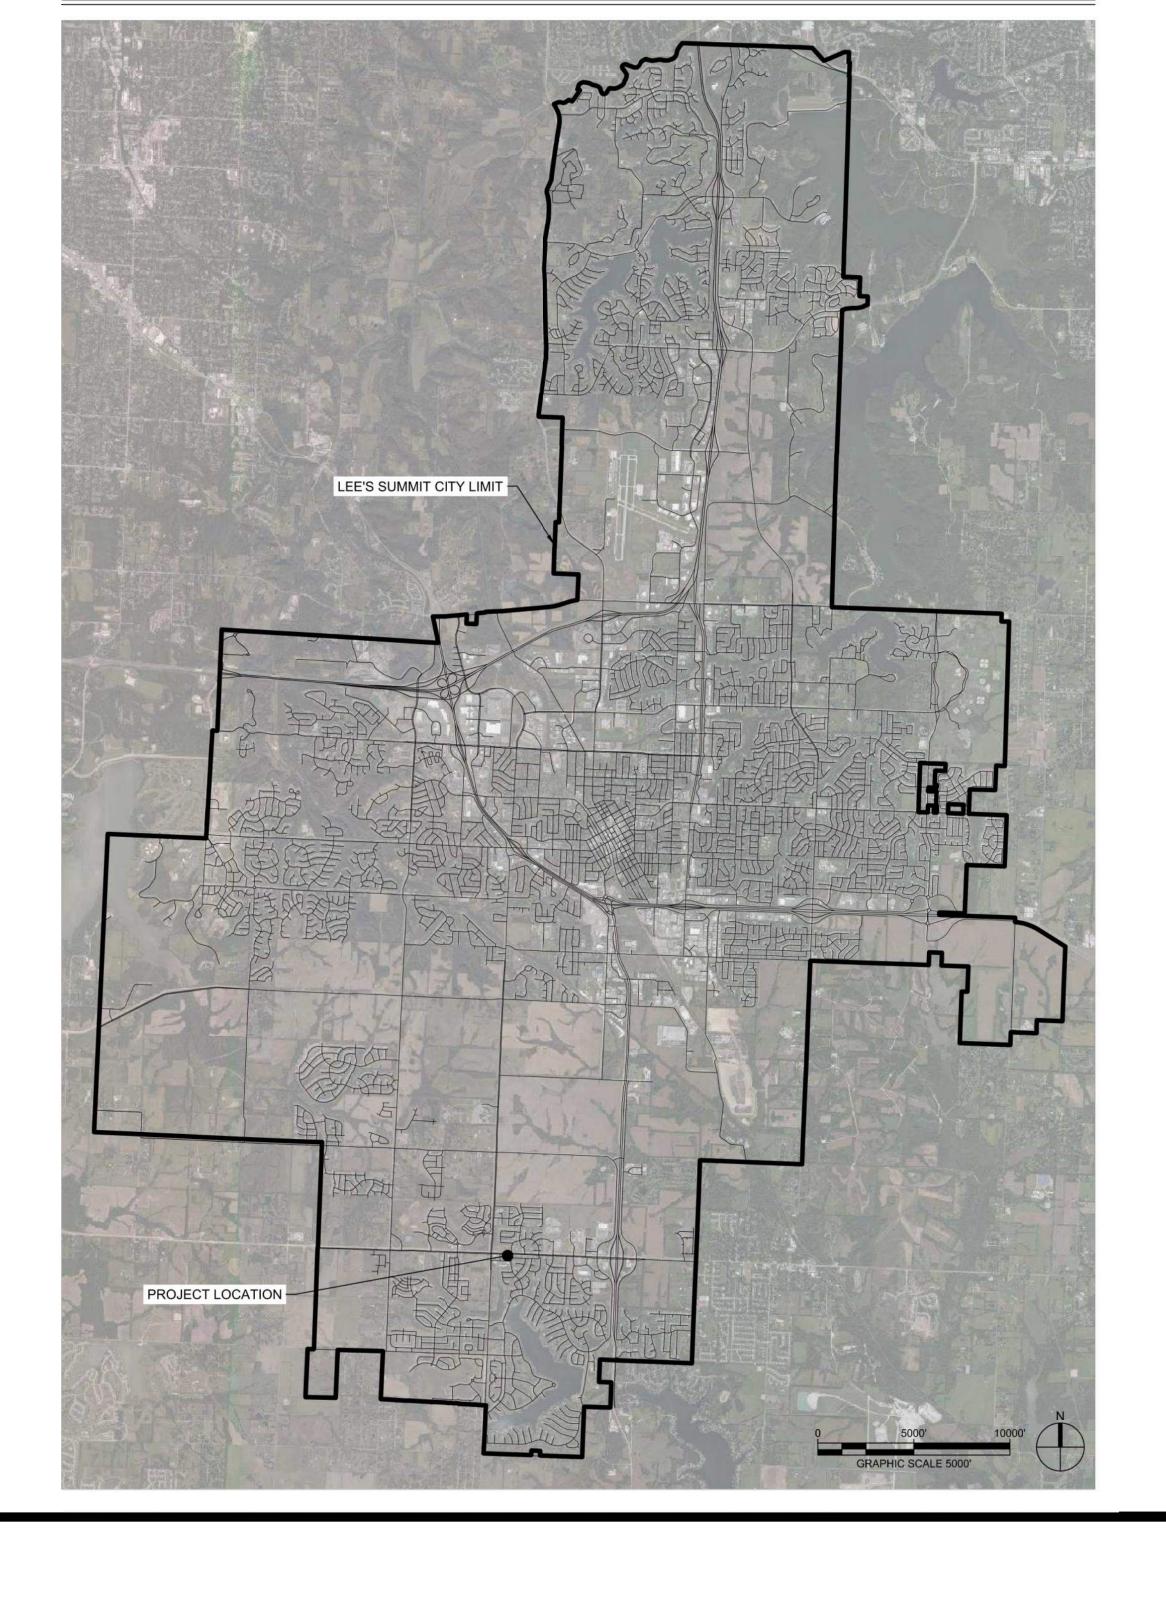

#### SITE LOCATION MAP:

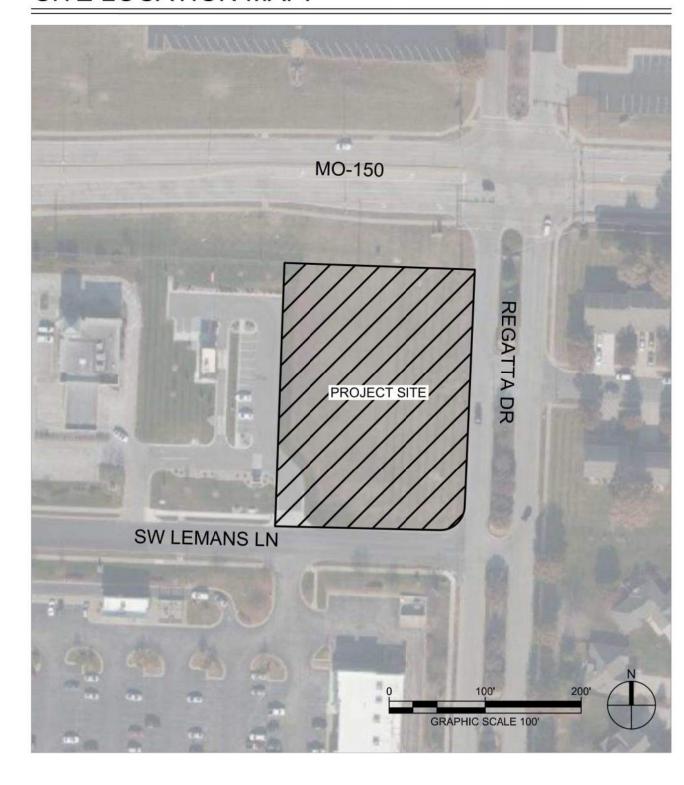

INDEX OF DRAWINGS		
SHEET NO.	SHEET NAME	
C-001	COVER SHEET	
GS001	ALTA/NSPS LAND TITLE SURVEY	
A-101	FIRST FLOOR PLAN	
A-102	SECOND FLOOR PLAN	
A-201	BUILDING ELEVATIONS	
A-202	BUILDING ELEVATIONS	
C-100	SITE PLAN	
C-101	LAYOUT PLAN	
C-102	DEMOLITION PLAN	
C-103	EROSION CONTROL PLAN	
C-104	GRADING & DRAINAGE PLAN	
C-105	UTILITY PLAN	
C-220	PUBLIC WATER PLAN & PROFILE	
C-231	PUBLIC STORMWATER PROFILES	
C-231	PRIVATE STORMWATER PROFILES	
C-400	SITE ENLARGEMENTS	
C-401	SITE ENLARGEMENTS	
C-402	SITE ENLARGEMENTS	
C-500	SITE DETAILS	
C-501	SITE DETAILS	
C-502	SITE DETAILS	
C-503	SITE DETAILS	
C-504	SITE DETAILS	
C-510	EROSION CONTROL DETAILS	
C-511	EROSION CONTROL DETAILS	
C-520	WATER DETAILS	
C-521	WATER DETAILS	
C-530	STORMWATER DETAILS	
C-531	STORMWATER DETAILS	
C-532	STORMWATER DETAILS	
C-540	SANITARY SEWER DETAILS	
ME001	MPE SITE PLAN	
ME002	SITE LIGHTING PHOTOMETRIC PLAN	
L-100	LANDSCAPE SCHEDULE	
L-101	LANDSCAPE PLAN	

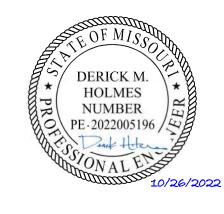





# Description Date


ISSUED FOR
PERMITTING

PROJECT NO: 18225R21001

DATE: 10.26.2022

COVER

C-001

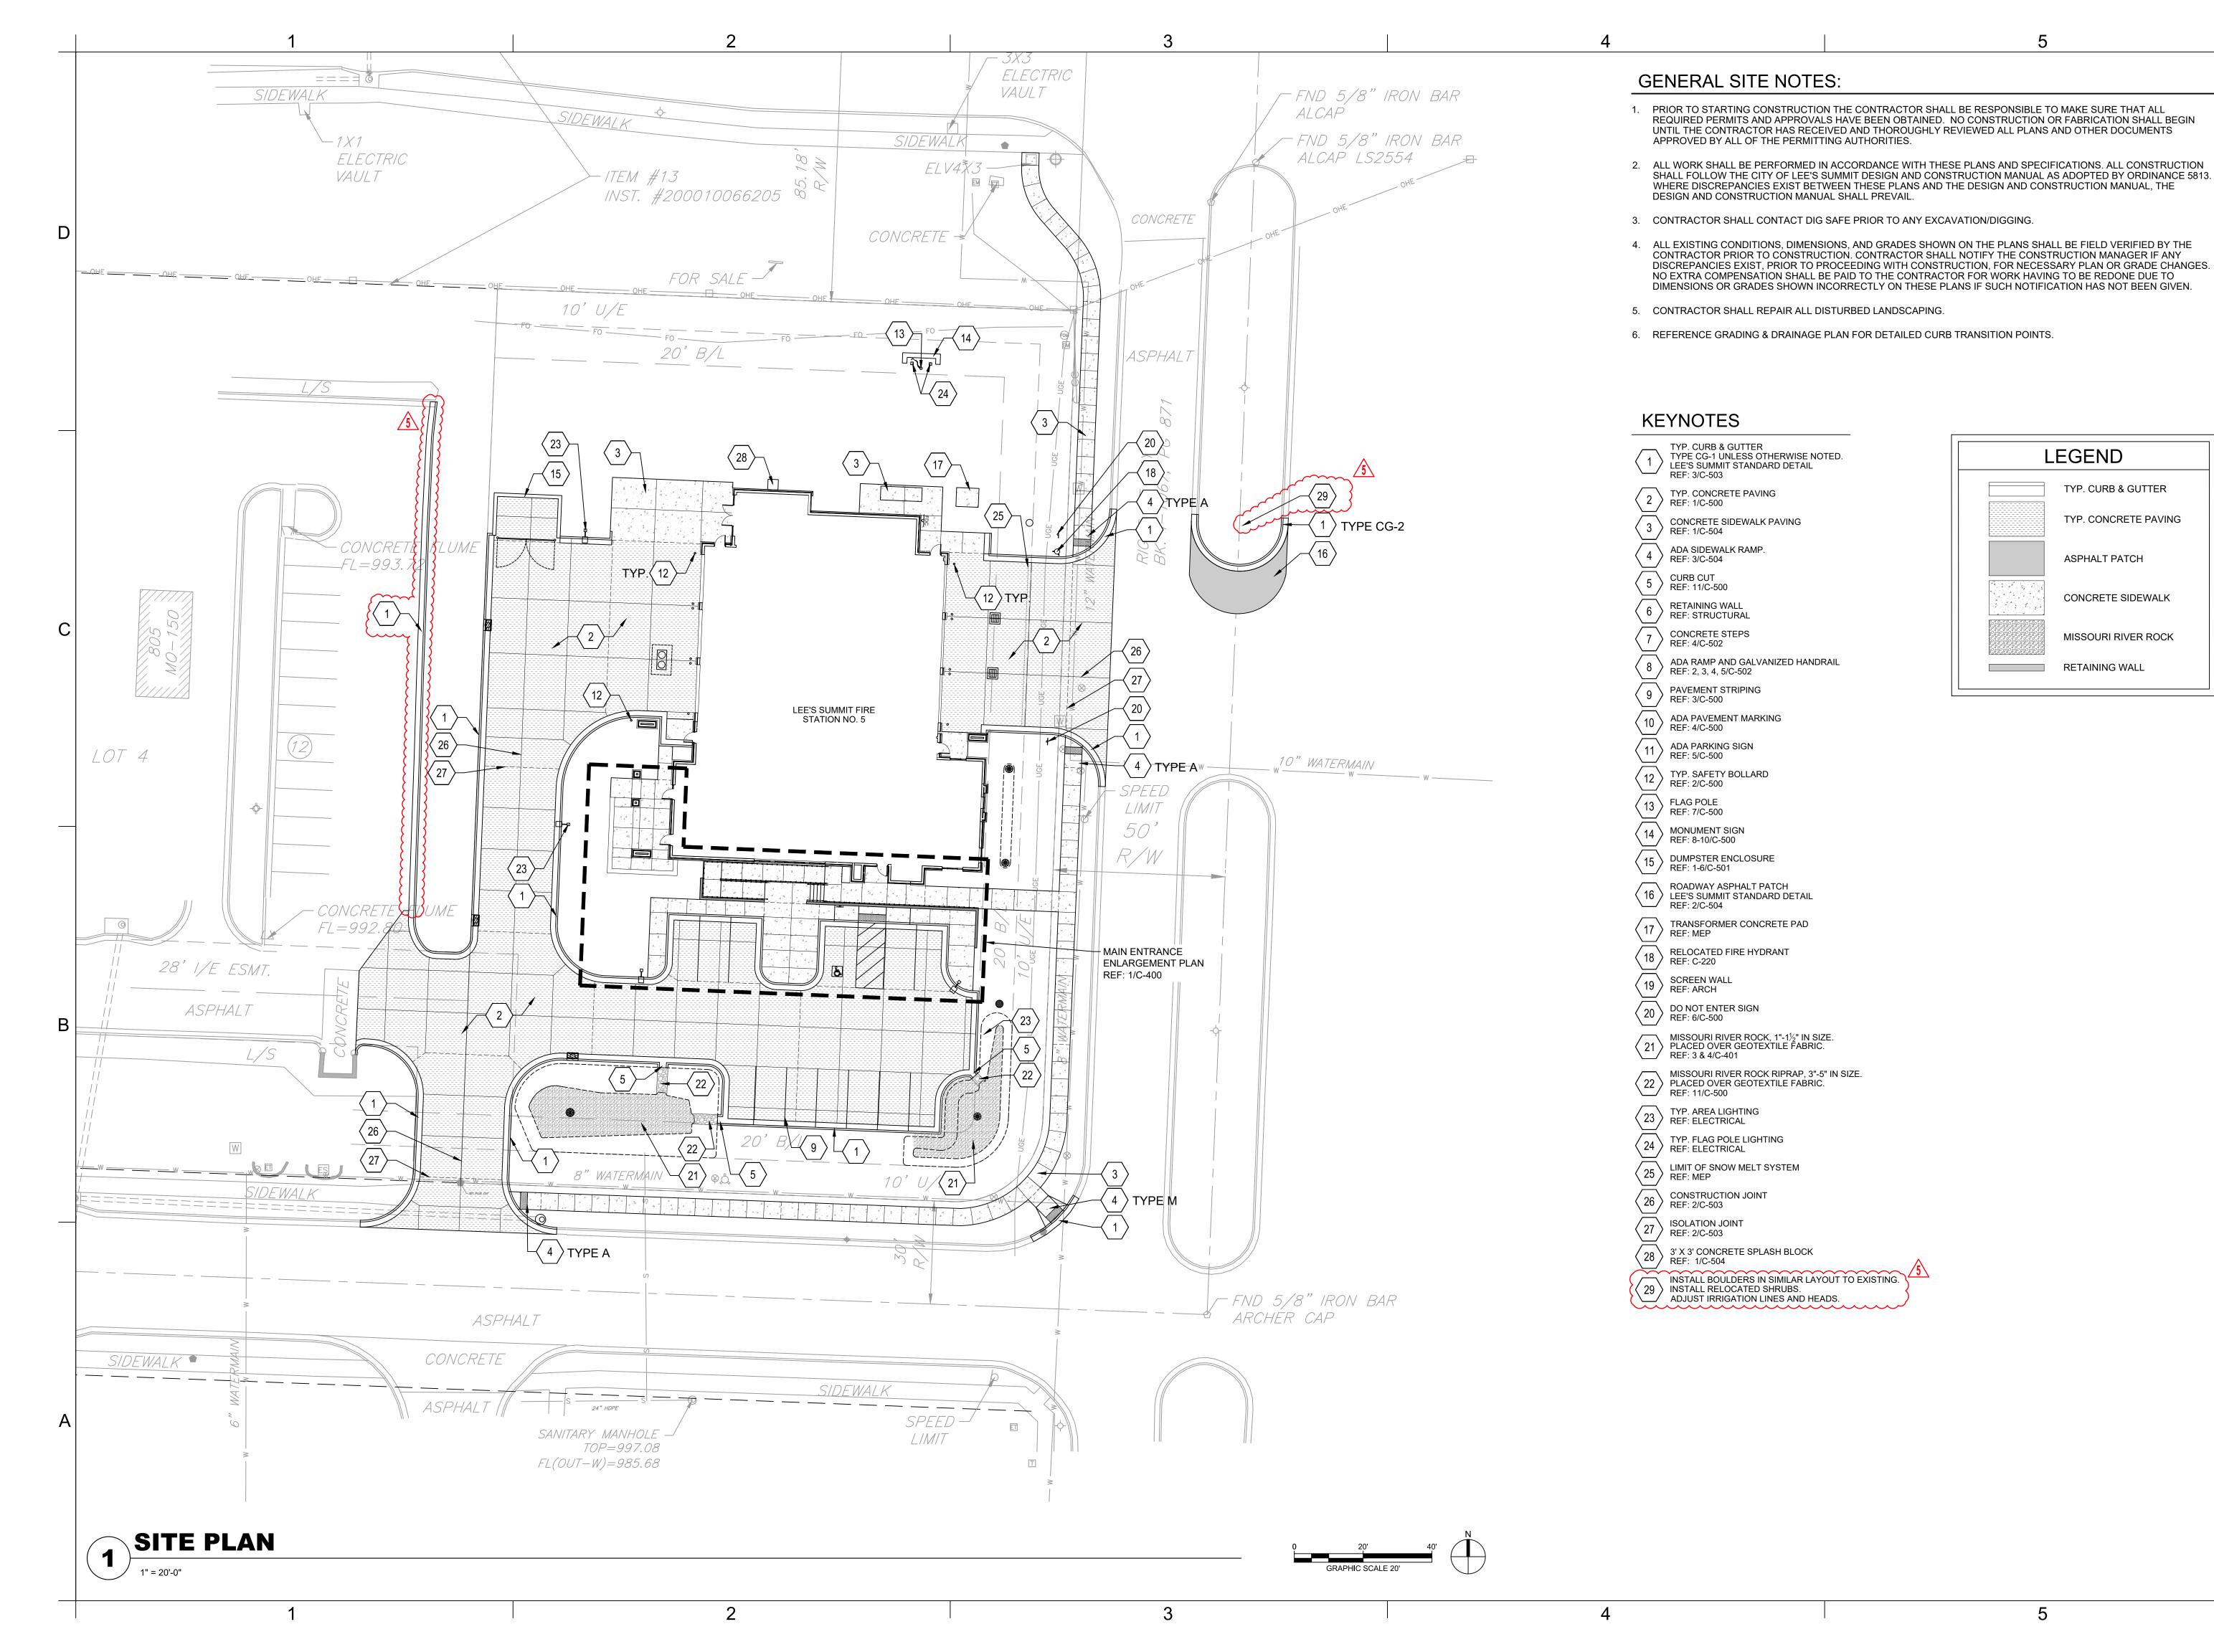



9229 WARD PARKWAY SUITE # 210 KANSAS CITY, MO 64114 TEL: (816) 444-4200 FAX: (316) 265-5646

www.glmv.com

**GLMV**Architecture

GLMV ARCHITECTURE, INC. MISSOURI STATE CERTIFICATE OF AUTHORITY

CIVIL ENGINEER & LANDSCAPE ARCH. GLMV ARCHITECTURE, INC MISSOURI CIVIL COA #2018033898 MISSOURI LANDSCAPE COA #000008 9229 WARD PARKWAY, SUITE # 210 KANSAS CITY, MO 64114 TEL: (816) 444-4200

STRUCTURAL ENGINEER LEIGH + O'KANE MISSOURI COA #001644 250 NE MURBERRY, SUITE 201

LEE'S SUMMIT, MO, 64086 (816) 444-3144 PHONE MECH., ELEC. & PLUMBING ENGINEERS

HOSS & BROWN ENGINEERS MISSOURI COA #01022 15902 MIDLAND DRIVE SHAWNEE, KS 66217 (913) 362-9090 PHONE


SECURITY & IT ENGINEERS HENDERSON ENGINEERS MISSOURI COA # 000556 1801 MAIN STREET. SUITE 300 KANSAS CITY, MO 64108 (816) 663-8700 PHONE

150 I 64082

FIRE STATIC CITY OF LEE'S SUN MISSOURI HIG S SUMMIT, M

REVISIONS: # Description Date

ASI 02 11.22.2022 ASI 05 02.08.2023

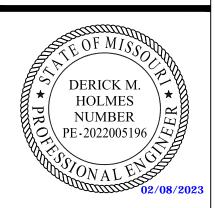


DERICK HOLMES - CIVIL ENGINEER MO# PE-2022005196


PROJECT NO: 18225R21001 DATE: 10.26.2022 DRAWN BY: KDW CHK'D BY:

© GLMV Architecture, Inc. All work herein is the property of GLMV Architecture, Inc. and

SITE PLAN

C-100

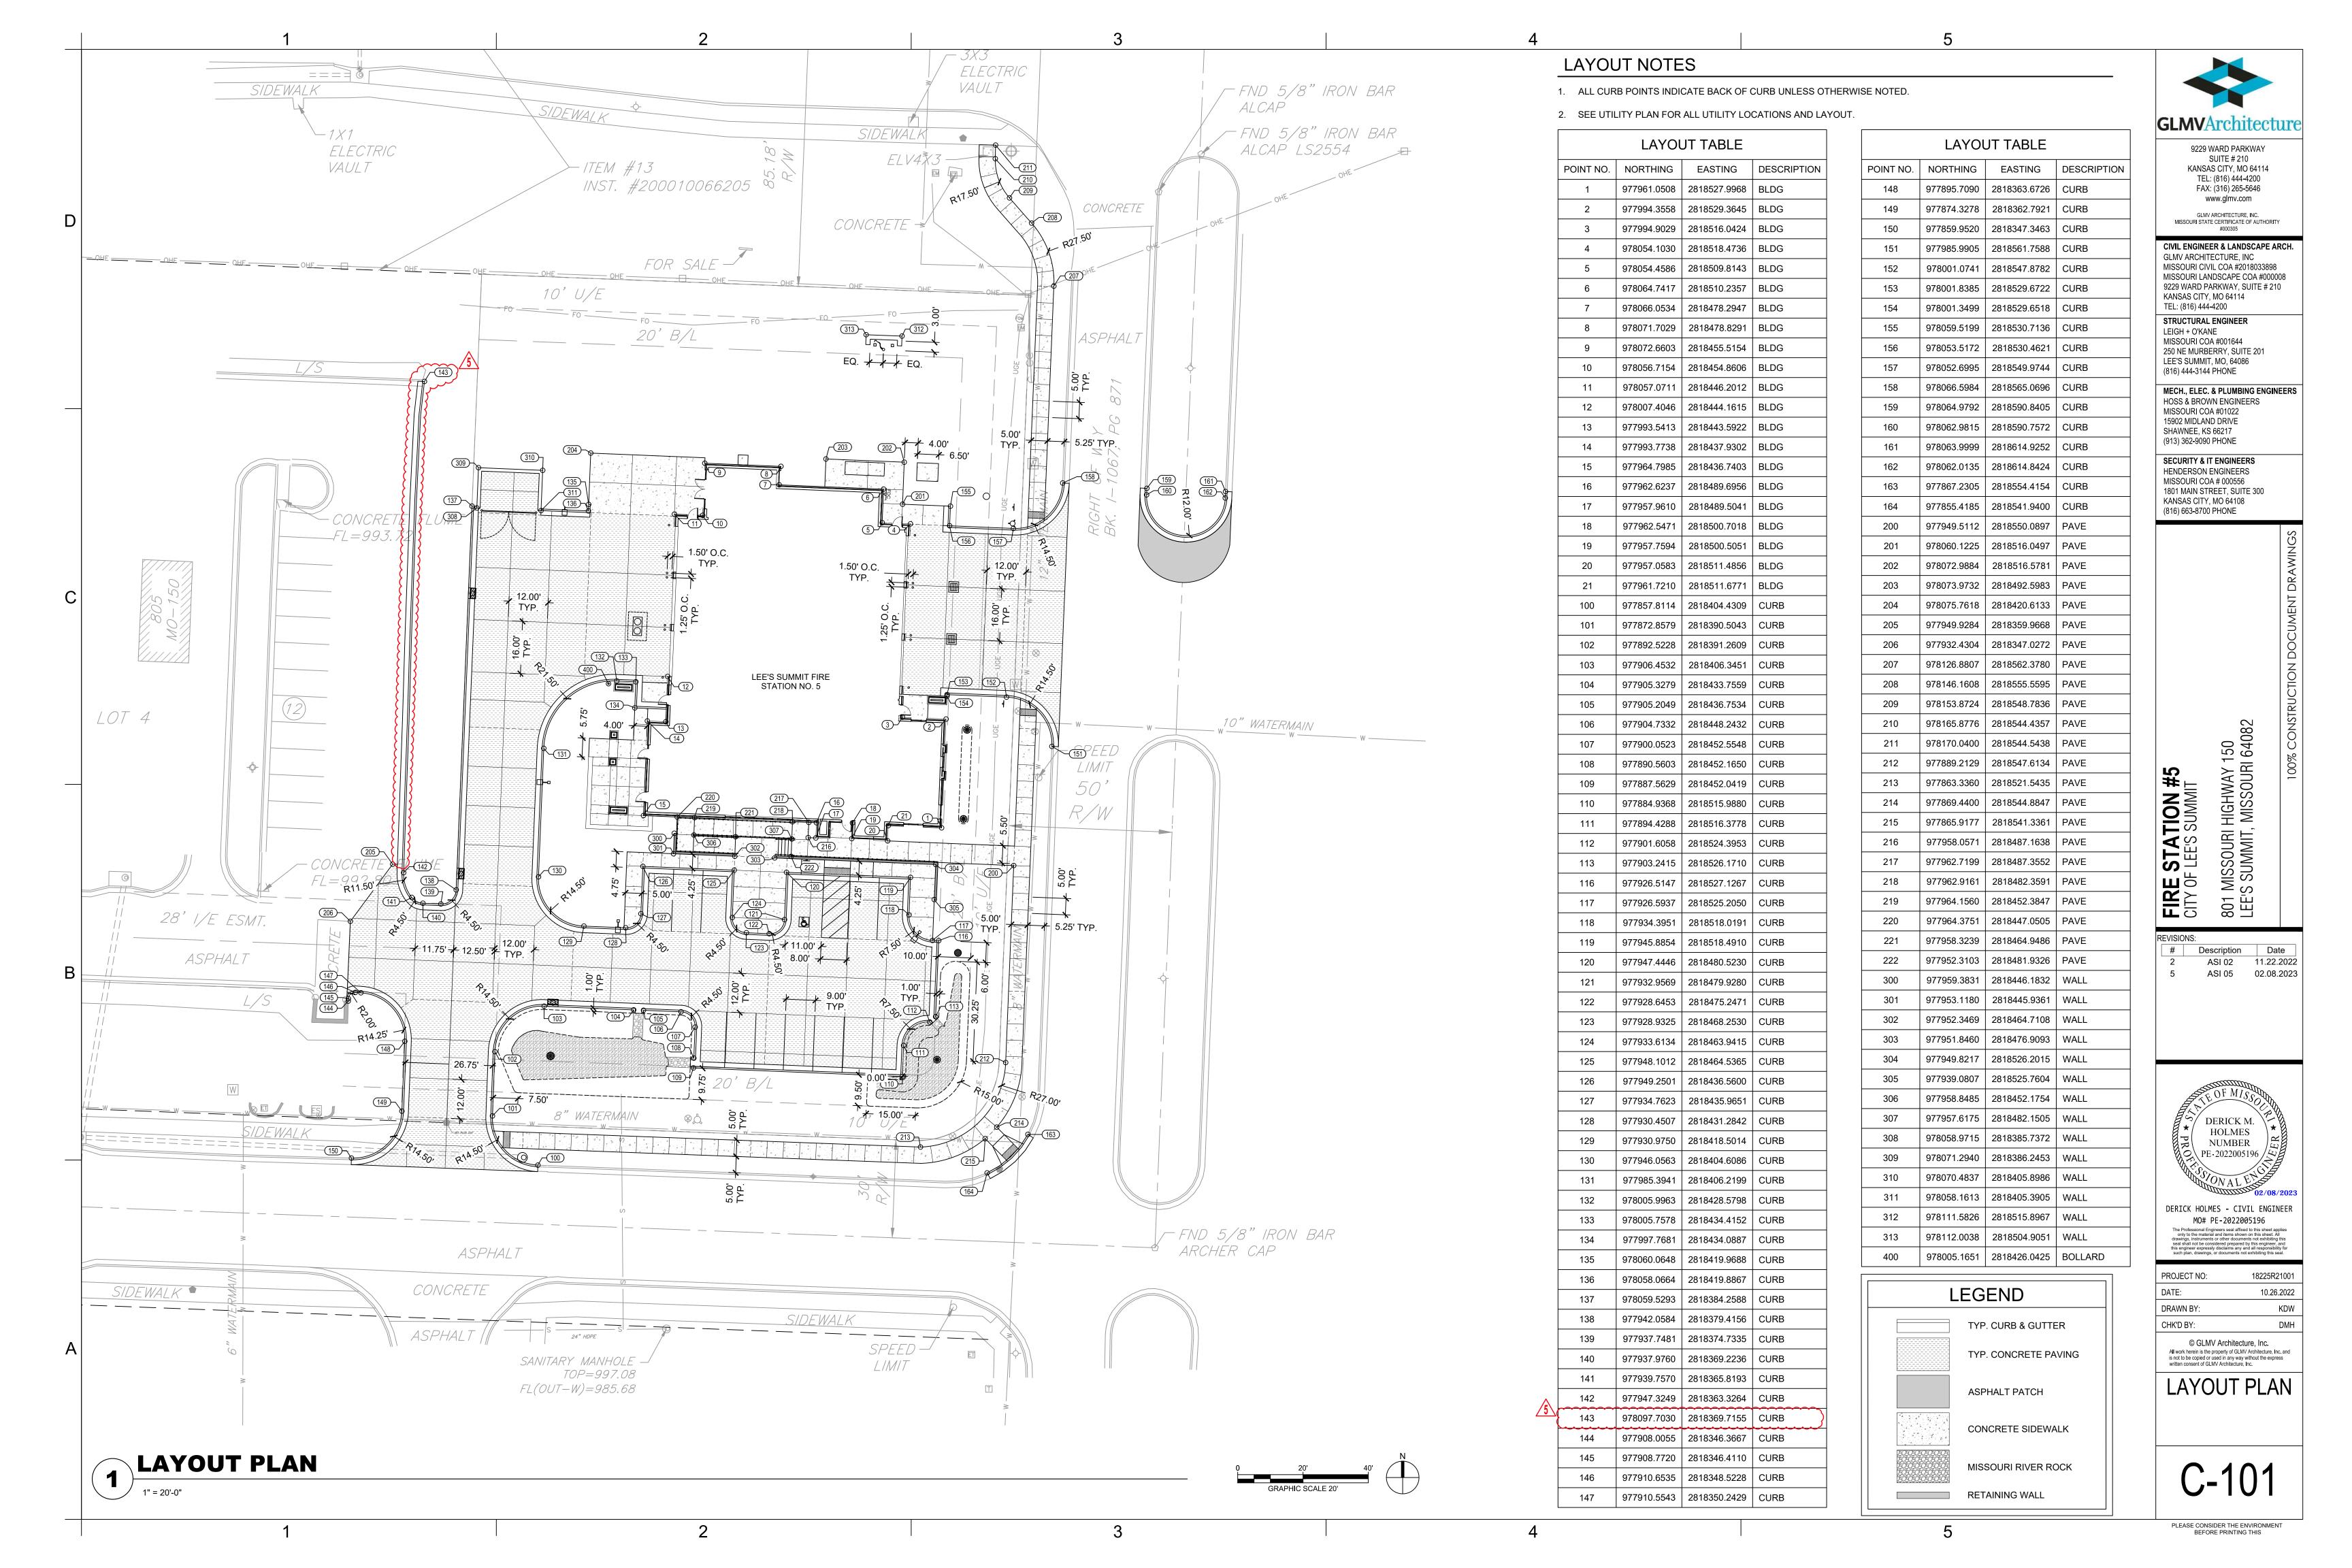

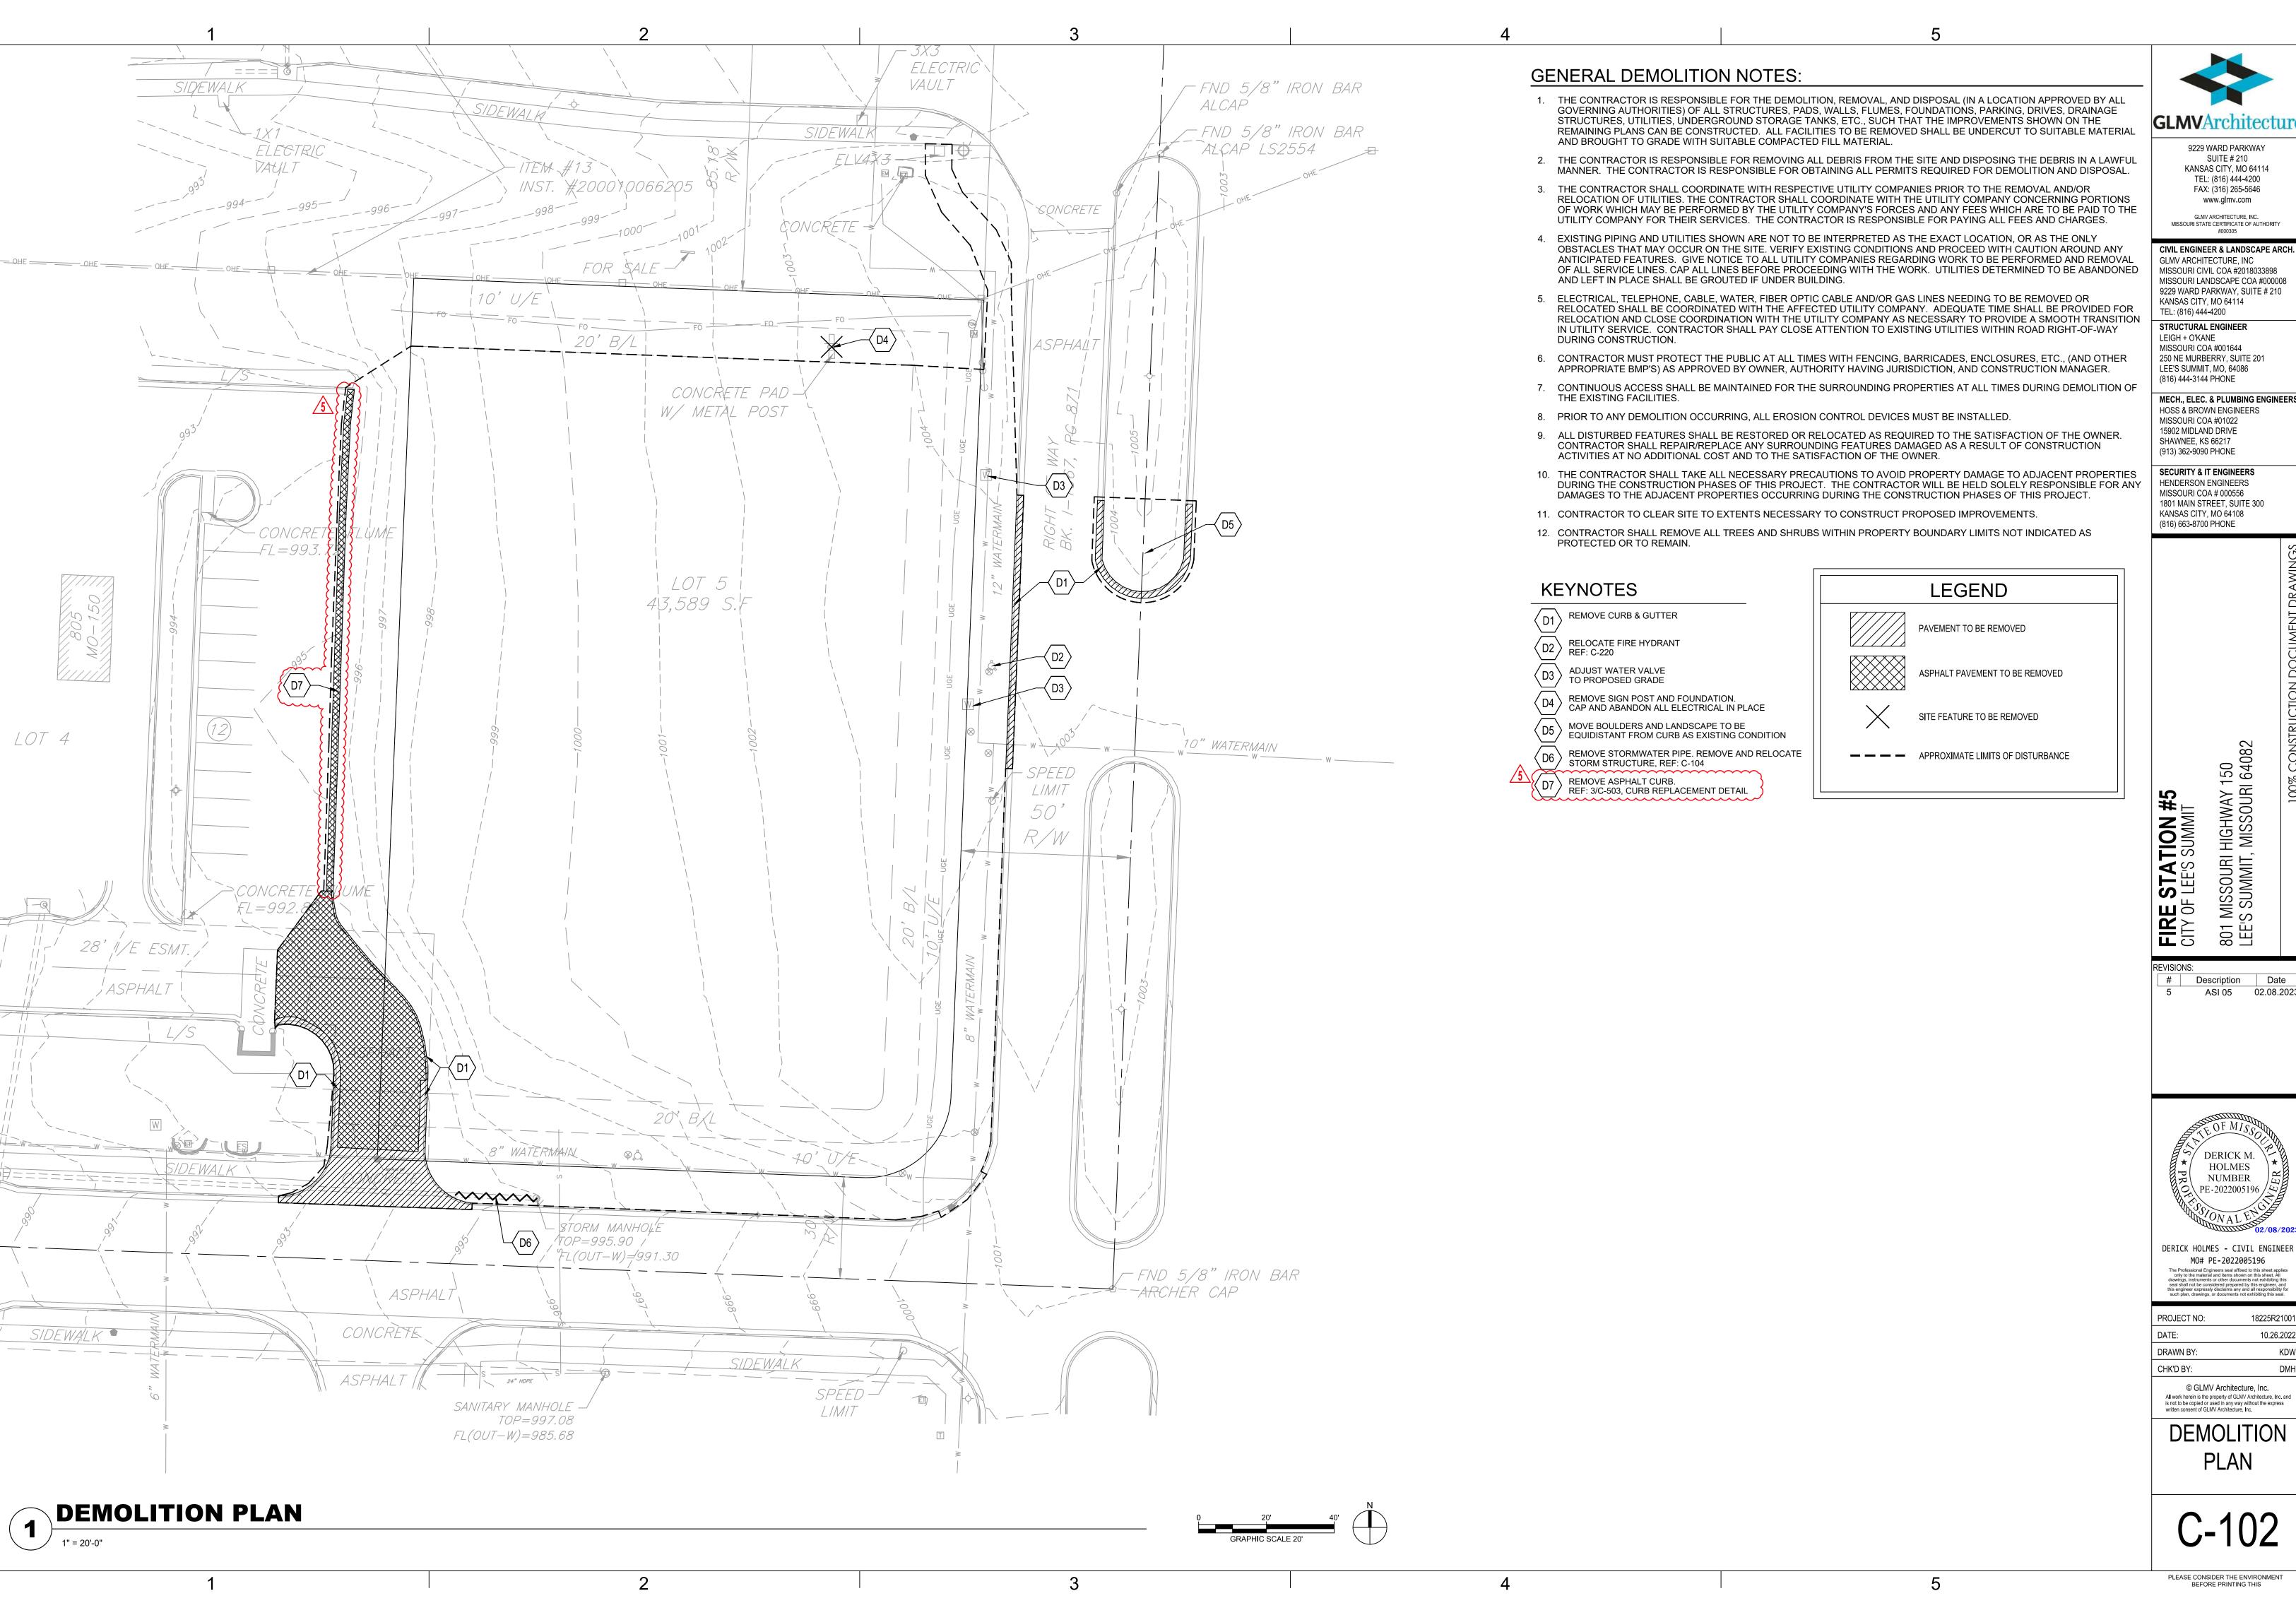

9229 WARD PARKWAY

SUITE # 210 KANSAS CITY, MO 64114 TEL: (816) 444-4200 FAX: (316) 265-5646

GLMV ARCHITECTURE, INC MISSOURI CIVIL COA #2018033898 MISSOURI LANDSCAPE COA #000008 9229 WARD PARKWAY, SUITE # 210

STRUCTURAL ENGINEER 250 NE MURBERRY, SUITE 201

MECH., ELEC. & PLUMBING ENGINEERS

SECURITY & IT ENGINEERS 1801 MAIN STREET, SUITE 300

# Description Date 5 ASI 05 02.08.2023

HOLMES NUMBER PE-2022005196 /

DERICK HOLMES - CIVIL ENGINEER MO# PE-2022005196

18225R21001 10.26.2022 KDW

© GLMV Architecture, Inc. All work herein is the property of GLMV Architecture, Inc. and

#### GENERAL EROSION AND SEDIMENT CONTROL NOTES:

THIS SHEET OUTLINES MINIMUM STORMWATER PRACTICES TO BE FOLLOWED BY THE CONTRACTOR DURING ALL PHASES OF CONSTRUCTION OF THE PROJECT. THE CONTRACTOR WILL BE RESPONSIBLE FOR PREVENTION OF SOIL OR SEDIMENT LOSS FROM THE CONSTRUCTION SITE. THE CONTRACTOR SHALL SUBMIT A SITE-SPECIFIC SEDIMENT AND EROSION CONTROL SCHEDULE. THESE NOTES ARE TO BE USED AS A GUIDELINE ONLY. THE PROJECT IS NOT CONSIDERED COMPLETE UNTIL ALL PERMANENT EROSION AND SEDIMENT CONTROLS AND STORMWATER MANAGEMENT PRACTICES ARE IN PLACE TO THE SATISFACTION OF THE OWNER AND ENGINEER. ALL TEMPORARY PRACTICES MUST BE

IN ACCORDANCE WITH LOCAL AND STATE REGULATIONS PURSUANT TO THE GENERAL NPDES PERMIT FOR CONSTRUCTION STORMWATER, A STORMWATER POLLUTION PREVENTION PLAN (SWPPP) HAS BEEN DEVELOPED FOR THIS SITE. THE PLAN WAS DEVELOPED TO MINIMIZE THE EFFECTS OF SOIL EROSION AND RESULTING SEDIMENT LOSS. PREVENTION WILL BE PROVIDED THROUGH THE USE OF PROPER CONSTRUCTION TECHNIQUES. THESE TECHNIQUES WILL INCLUDE BOTH TEMPORARY AND PERMANENT MANAGEMENT PRACTICES. TO PREVENT EROSION AND SEDIMENT

- 1. PRIOR TO STARTING ANY SOIL DISTURBING ACTIVITIES, THE CONTRACTOR SHALL INSTALL PERIMETER EROSION AND SEDIMENT CONTROL MEASURES AND GRAVEL CONSTRUCTION ENTRANCES.
- 2. EROSION AND SEDIMENT CONTROL DEVICES SHALL BE CONSTRUCTED IN ACCORDANCE WITH THE KANSAS CITY METRO CHAPTER OF THE AMERICAN PUBLIC WORKS ASSOCIATION. INSTALL SILT FENCE AT INDICATED LOCATIONS AND OTHER LOCATIONS AS DIRECTED BY THE ENGINEER TO CONTROL SOIL EROSION. SILT FENCE SHALL BE KEPT IN
- 3. CONSTRUCTION ENTRANCE SHALL BE MAINTAINED BY THE CONTRACTOR IN A CONDITION THAT WILL PREVENT TRACKING OR FLOWING OF SEDIMENT ONTO PUBLIC RIGHT-OF-WAYS AND PAVED STREETS. THIS MAY INCLUDE PERIODIC TOP DRESSING WITH ADDITIONAL CRUSHED STONE AS CONDITIONS WARRANT. REPAIR OF ENTRANCE(S) AND CLEANING OF RIGHT-OF-WAYS AND PAVED STREETS THAT HAVE BEEN SOILED BY CONSTRUCTION ACTIVITIES
- 4. DURING ALL SOIL DISTURBING ACTIVITIES, THE CONTRACTOR SHALL TAKE APPROPRIATE STEPS USING ACCEPTED CONSTRUCTION METHODS TO MINIMIZE THE TIME OF EXPOSURE OF UNPROTECTED SOIL AND OTHER CONSTRUCTION MATERIALS TO RAINFALL. PARTICULAR CARE MUST BE EXERCISED WHEN DEALING WITH STOCKPILES OF TOPSOIL
- 5. SOIL STOCKPILED FOR MORE THAN 7 DAYS WILL HAVE SILT FENCE PLACED ON THE DOWNHILL SIDE TO TRAP
- 6. NO GROUND SHALL BE LEFT DISTURBED FOR MORE THAN 14 DAYS OF NON-ACTIVITY WITHOUT BEING TEMPORARILY
- 7. EROSION CONTROLS SHALL BE INSPECTED AND MAINTAINED BY THE CONTRACTOR NOT LESS THAN WEEKLY AND WITHIN 24 HOURS AFTER A RAINFALL EVENT OF 0.5 INCHES OR MORE. MAINTENANCE SHALL INCLUDE BUT NOT BE
- 8. WHENEVER DIRT, ROCK, OR OTHER MATERIALS ARE EXPORTED FOR PLACEMENT IN AREAS OFF THE PRIMARY CONSTRUCTION SITE. THE CONTRACTOR IS RESPONSIBLE FOR DETERMINING THAT ALL JURISDICTIONAL AUTHORITY REQUIREMENTS ARE MET. PRIOR TO THE REMOVAL OF ANY MATERIALS FROM THE SITE THE CONTRACTOR WILL FURNISH THE ENGINEER WITH A WRITTEN AGREEMENT, SIGNED BY EACH LANDOWNER WHO WILL RECEIVE
- 9. CONTRACTOR SHALL BE RESPONSIBLE FOR ALL COSTS AND EXPENSES OF PROVIDING EROSION AND SEDIMENT
- 10. CONTRACTOR SHALL KEEP A WRITTEN LOG OF WHEN CONSTRUCTION ACTIVITIES BEGIN, EROSION AND SEDIMENT

	EROSION AND SEDIMENT CONTROL PHASING SCHEDULE
PRIOR TO CONSTRUCTION	INSTALL TEMPORARY GRAVEL CONSTRUCTION ENTRANCES.     INSTALL TEMPORARY PERIMETER SILT FENCE.     INSTALL TEMPORARY EXISTING CURB INLET PROTECTION.
DURING CONSTRUCTION	1. INSTALL THE FOLLOWING AS SITE IMPROVEMENTS ARE COMPLETED: A. TEMPORARY CURB AND AREA INLET PROTECTION. B. TEMPORARY EROSION AND SEDIMENT CONTROL BLANKETS. C. PERMANENT TURF REINFORCEMENT MATS.  2. TEMPORARY SEED AREAS OF SITE, AS REQUIRED (SEE NOTE 6).
AFTER CONSTRUCTION	SEED, FERTILIZE, AND MULCH ALL SLOPES AND DISTURBED AREAS.     PERFORM SITE CLEANUP.     REMOVE TEMPORARY PRACTICES AND PERIMETER CONTROLS ONCE FINAL

- E6 TEMPORARY EROSION CONTROL BLANKET REF: 2 / C-510
- E7 PERMANENT TURF REINFORCEMENT MAT REF: 2 / C-510
- E8 RIPRAP REF: C-100

LEGEND **\_\_\_\_ \_\_ LIMITS OF DISTURBANCE** ---- SF ---- SILT FENCE AREA INLET PROTECTION CONCRETE WASHOUT CURB INLET PROTECTION CONSTRUCTION ENTRANCE



**GLMV**Architecture

9229 WARD PARKWAY SUITE # 210 KANSAS CITY, MO 64114 TEL: (816) 444-4200 FAX: (316) 265-5646 www.glmv.com

GLMV ARCHITECTURE, INC. MISSOURI STATE CERTIFICATE OF AUTHORITY

CIVIL ENGINEER & LANDSCAPE ARCH. GLMV ARCHITECTURE, INC MISSOURI CIVIL COA #2018033898 MISSOURI LANDSCAPE COA #000008 9229 WARD PARKWAY, SUITE # 210 KANSAS CITY, MO 64114

TEL: (816) 444-4200 STRUCTURAL ENGINEER LEIGH + O'KANE MISSOURI COA #001644 250 NE MURBERRY, SUITE 201

LEE'S SUMMIT, MO, 64086 (816) 444-3144 PHONE MECH., ELEC. & PLUMBING ENGINEERS

**HOSS & BROWN ENGINEERS** MISSOURI COA #01022 15902 MIDLAND DRIVE SHAWNEE, KS 66217


(913) 362-9090 PHONE SECURITY & IT ENGINEERS HENDERSON ENGINEERS MISSOURI COA # 000556

1801 MAIN STREET, SUITE 300 KANSAS CITY, MO 64108 (816) 663-8700 PHONE

Z S S

STATIC FLEE'S SU MISSOURI I'S SUMMIT, FIRE CITY OF

REVISIONS: # Description Date ASI 02 11.22.2022

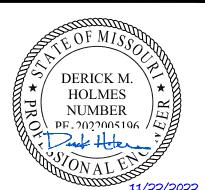


DERICK HOLMES - CIVIL ENGINEER MO# PE-2022005196

PROJECT NO: 18225R21001 DATE: 10.26.2022 DRAWN BY:

CHK'D BY: © GLMV Architecture, Inc. All work herein is the property of GLMV Architecture, Inc. and is not to be copied or used in any way without the express written consent of GLMV Architecture, Inc.

**EROSION CONTROL PLAN** 

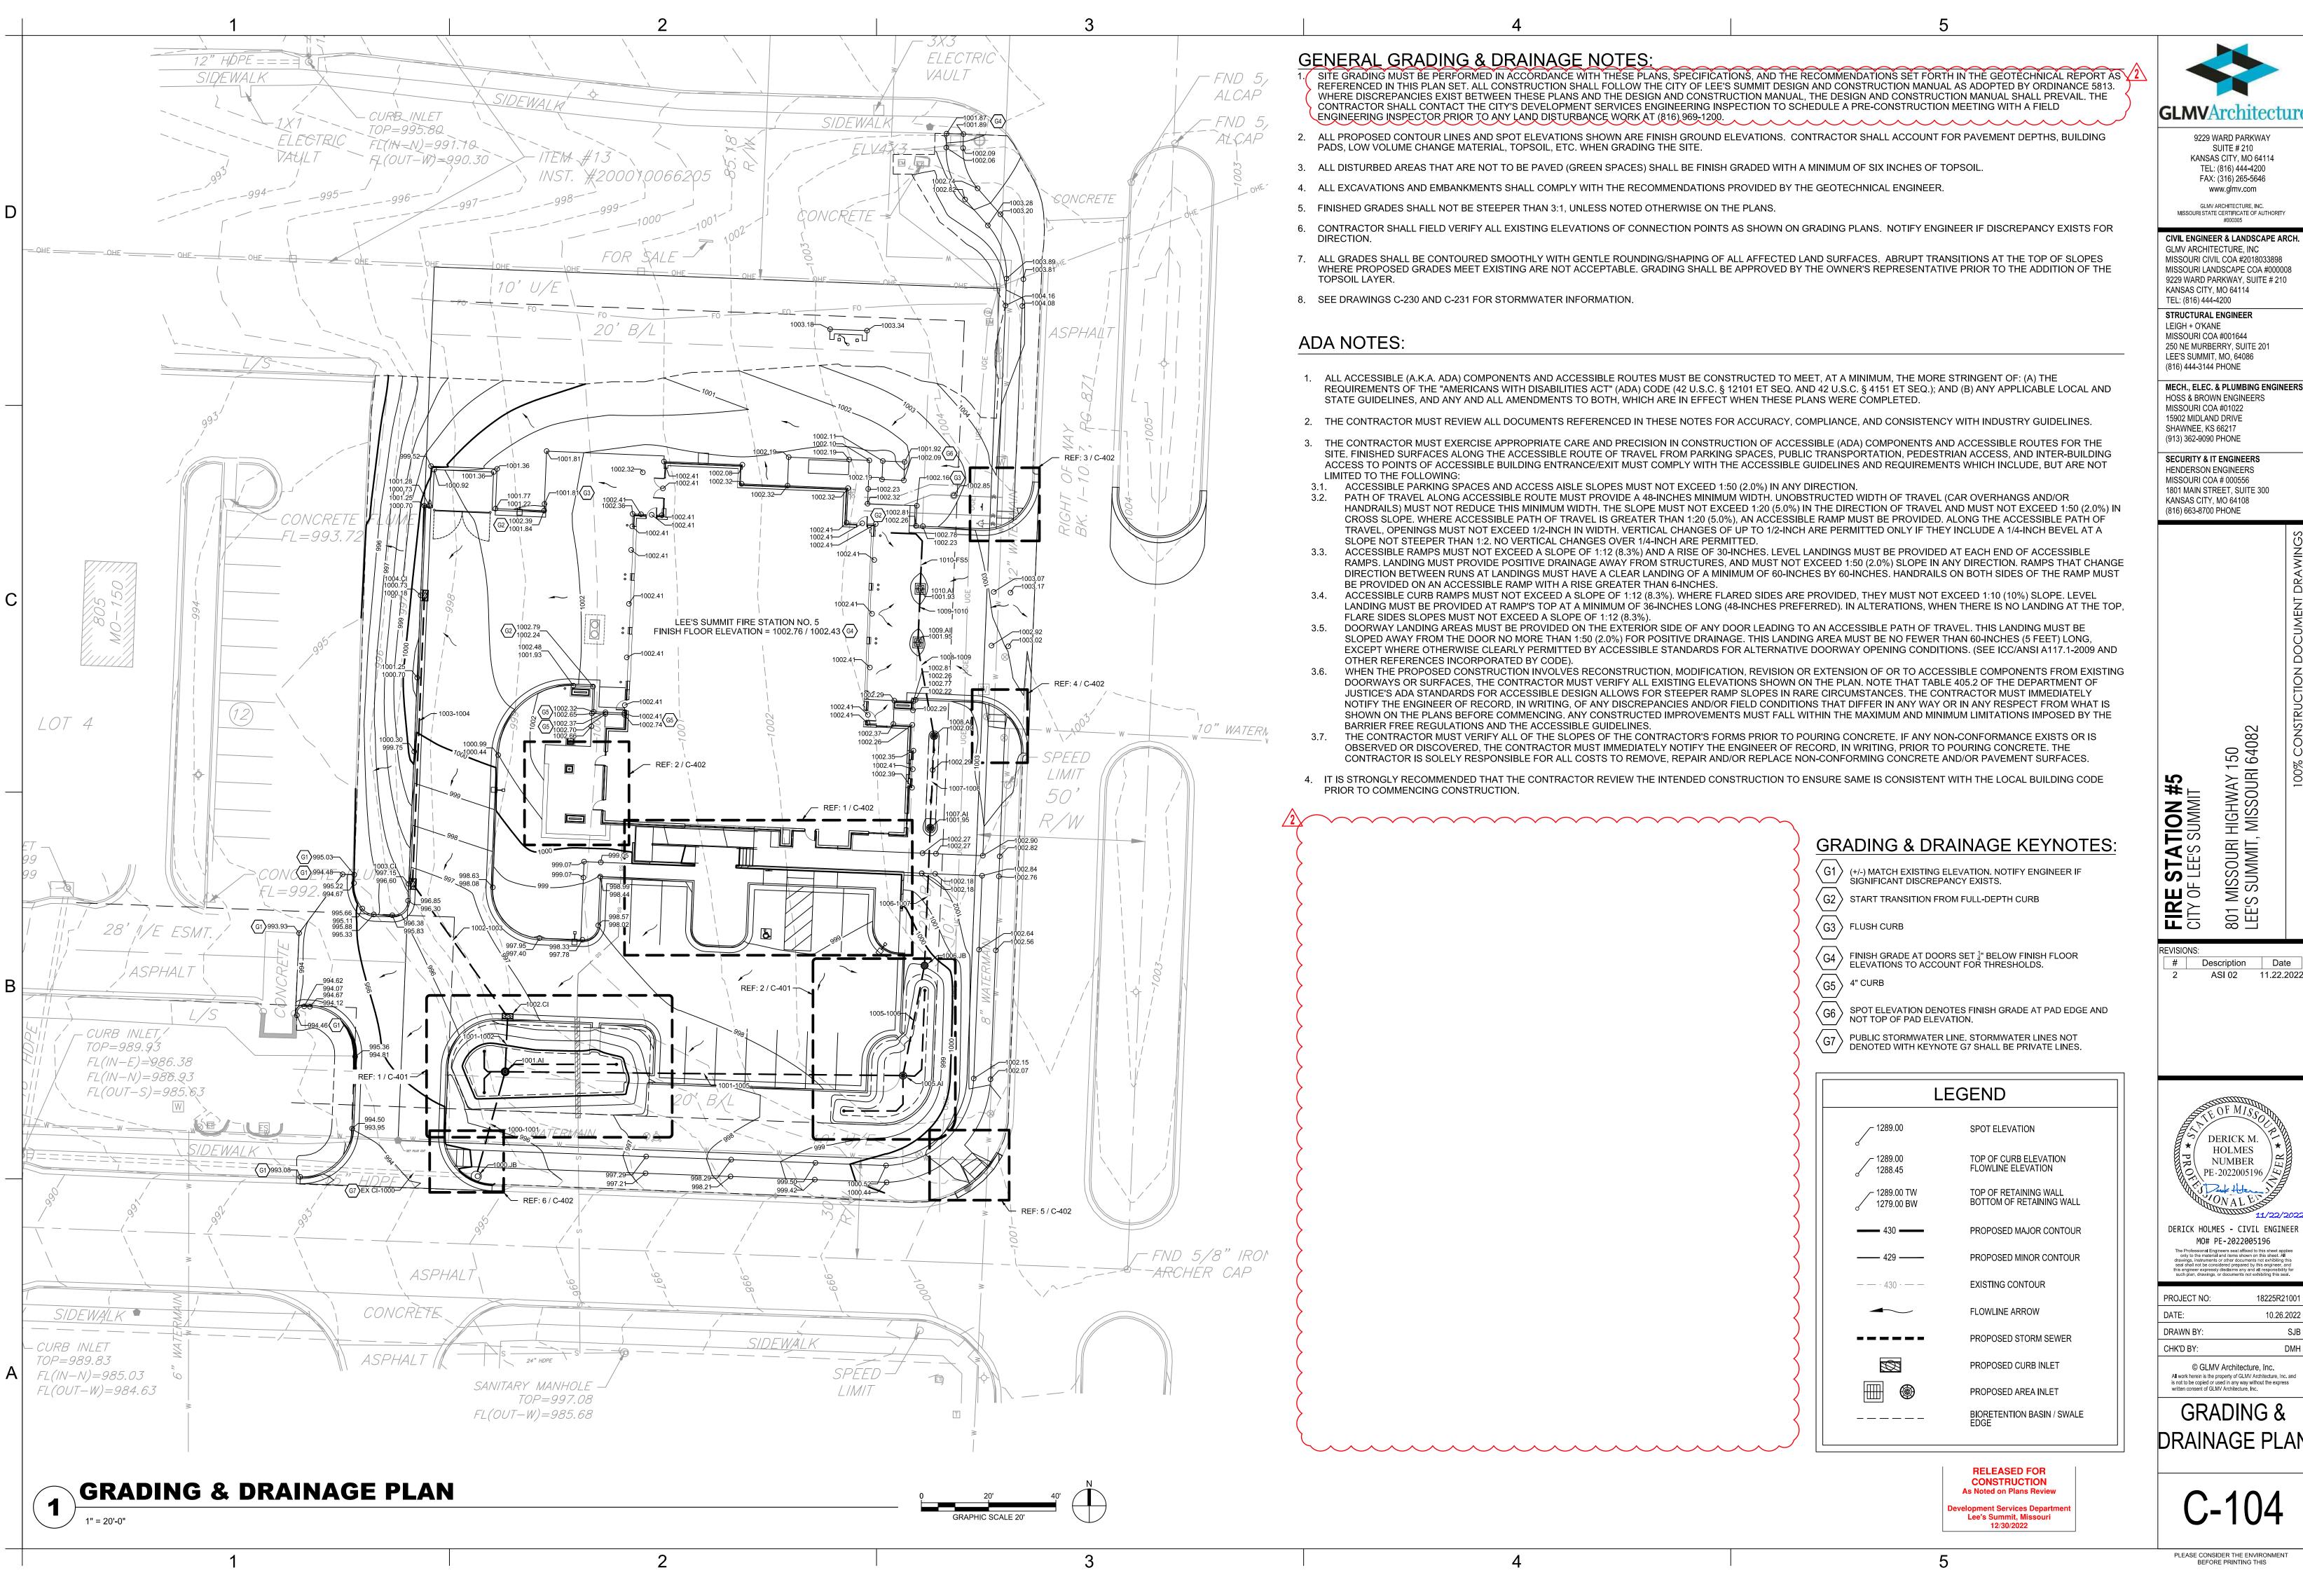

9229 WARD PARKWAY KANSAS CITY, MO 64114 TEL: (816) 444-4200 FAX: (316) 265-5646

CIVIL ENGINEER & LANDSCAPE ARCH. MISSOURI CIVIL COA #2018033898 MISSOURI LANDSCAPE COA #000008 9229 WARD PARKWAY, SUITE # 210

250 NE MURBERRY, SUITE 201

MECH., ELEC. & PLUMBING ENGINEERS

1801 MAIN STREET, SUITE 300

MISSOURI I'S SUMMIT,

Description Date ASI 02 11.22.2022


O PE-2022005196 /

DERICK HOLMES - CIVIL ENGINEER MO# PE-2022005196

18225R21001 10.26.2022

© GLMV Architecture, Inc. All work herein is the property of GLMV Architecture, Inc. and is not to be copied or used in any way without the express written consent of GLMV Architecture, Inc.

DRAINAGE PLAN

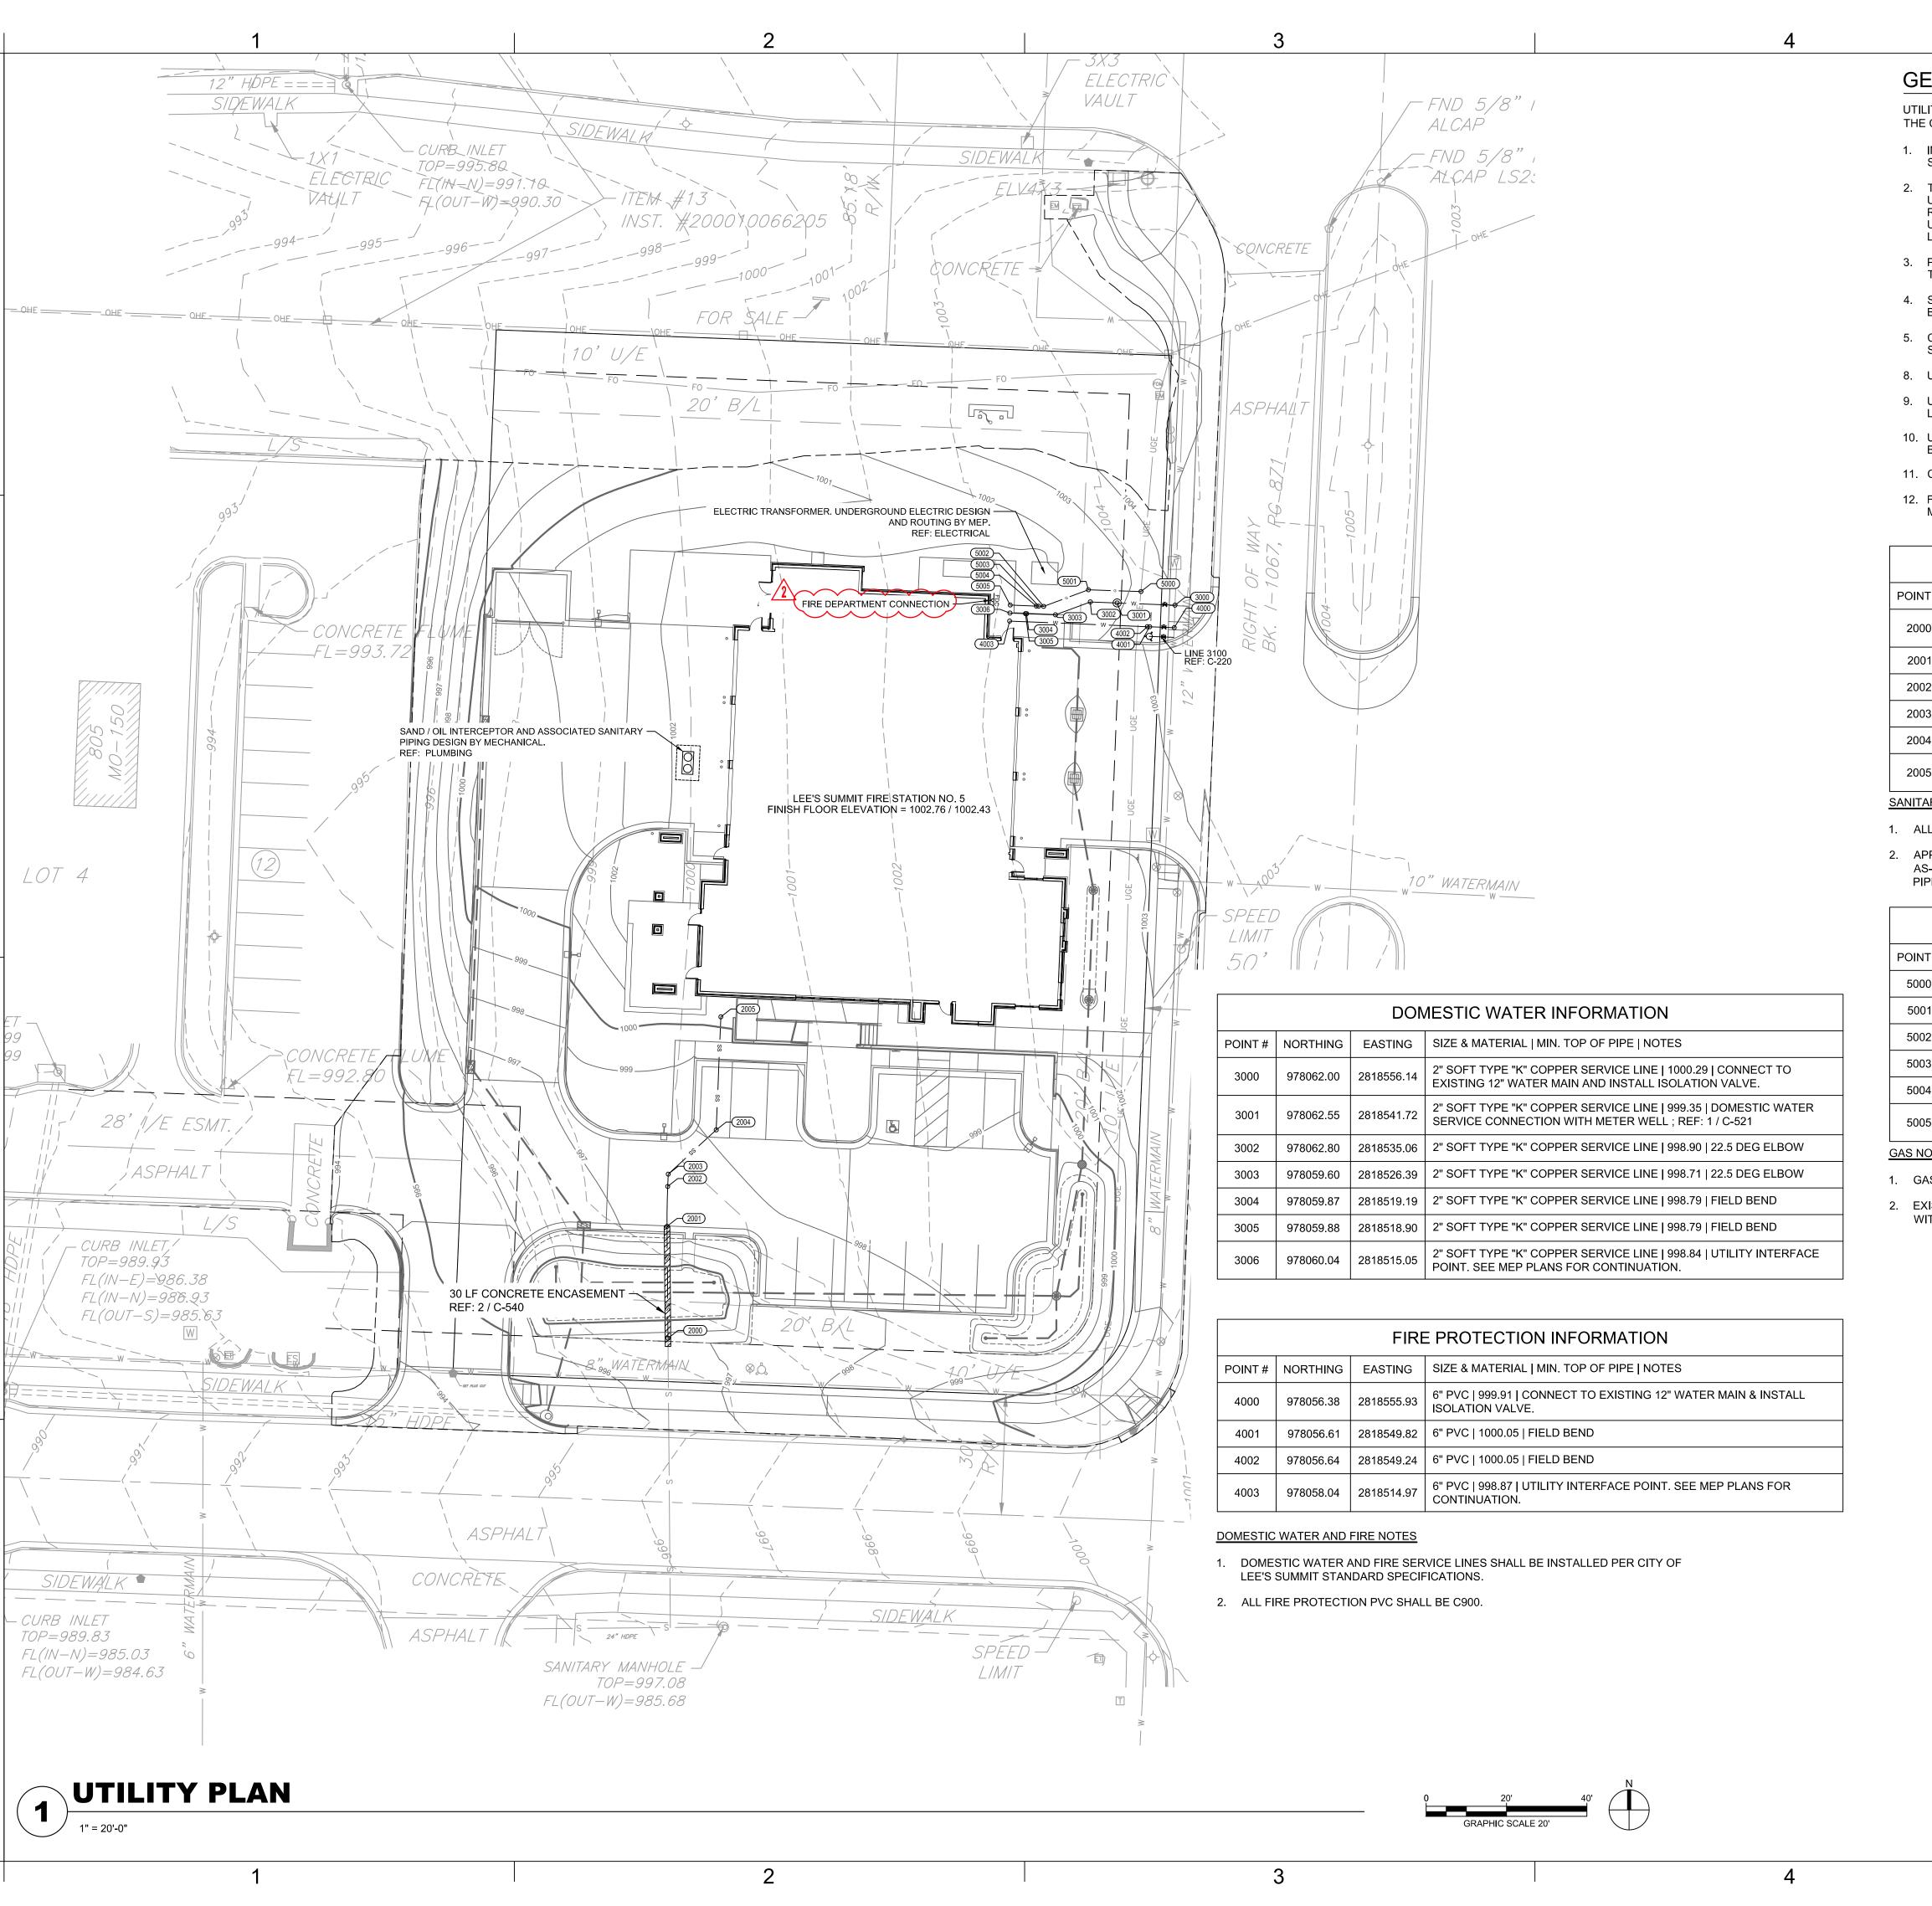

#### **GENERAL UTILITY NOTES:**

UTILITY CONSTRUCTION SHALL COMPLY WITH THE STANDARD SPECIFICATIONS, CODES, AND DETAILS OF THE CITY OF LEE'S SUMMIT, MO AND UTILITY PROVIDERS.

1. INSTALLATION, BEDDING, & TESTING OF UTILITY INSTALLATIONS SHALL BE AS PER CITY OF LEE'S SUMMIT, MO STANDARD SPECIFICATIONS AND STANDARD SPECIAL PROVISIONS.

- 2. THE INFORMATION SHOWN ON THESE PLANS CONCERNING THE TYPE AND LOCATION OF UNDERGROUND UTILITIES IS NOT GUARANTEED TO BE ACCURATE OR ALL INCLUSIVE. THE CONTRACTOR IS RESPONSIBLE FOR CONTACTING ALL UTILITY COMPANIES FOR FIELD LOCATION OF ALL UNDERGROUND UTILITY LINES PRIOR TO ANY EXCAVATION AND FOR MAKING HIS OWN VERIFICATION AS TO TYPE AND LOCATION OF UNDERGROUND UTILITIES AS MAY BE NECESSARY TO AVOID DAMAGE THERETO.
- 3. PROTECT ALL COMPONENTS DURING DEMOLITION / CONSTRUCTION PROCESS. MAINTAIN BMP'S THROUGHOUT THE DURATION OF CONSTRUCTION.
- 4. STUB ALL CONNECTIONS TO WITHIN 5' OF THE BUILDING TO PROVIDE CONNECTION INTO THE BUILDING BY MECHANICAL PLUMBING CONTRACTOR.
- 5. CONTRACTOR TO PROVIDE DETAILED AS-BUILT DRAWINGS TO OWNER, ENGINEER, AND CITY OF LEE'S SUMMIT, MO UPON COMPLETION OF ALL UTILITIES.
- 8. UTILITY TRENCH BACKFILL SHALL BE PER PROJECT SPECIFICATIONS.
- 9. UTILITY PIPE LENGTHS ARE PROVIDED FOR INFORMATION ONLY. CONTRACTOR TO VERIFY ACTUAL LENGTHS OF PIPE REQUIRED PRIOR TO BIDDING & INSTALLING UTILITIES.
- 10. UTILITY CONTRACTOR TO COORDINATE BUILDING CONNECTION POINTS WITH PLUMBING PLAN AND BUILDING CONTRACTOR.
- 11. CONTRACTOR TO ADJUST EXISTING WATER VALVES TO PROPOSED GRADE, AS REQUIRED.
- 12. FIELD BEND INFORMATION IS PROVIDED FOR REFERENCE ONLY. CONTRACTOR TO FOLLOW PIPE MANUFACTURER'S RECOMMENDATIONS FOR FIELD ADJUSTMENTS OF PIPE BETWEEN FITTINGS.

	SANITARY SEWER INFORMATION				
POINT #	NORTHING	EASTING	SIZE & MATERIAL   SLOPE DOWNSTREAM   INV. EL.   NOTES		
2000	977879.55	2818429.96	4" PVC   N/A   989.58   CONNECTION TO EXISTING SERVICE. SEE SANITARY SEWER NOTE 2		
2001	977907.40	2818429.72	4" PVC   4.32%   990.78   FIELD BEND		
2002	977917.33	2818429.88	4" PVC   4.32%   991.21   FIELD BEND		
2003	977920.39	2818430.01	4" PVC   4.32%   991.34   45 DEG ELBOW		
2004	977931.40	2818441.95	4" PVC   13.19%   993.49   45 DEG ELBOW		
2005	977959.53	2818443.11	4" PVC   13.19%   997.20   CLEANOUT UTILITY INTERFACE POINT. SEE MEP PLANS FOR CONTINUATION		


#### SANITARY SEWER NOTES

- 1. ALL PVC PIPE SHALL BE SDR 26.
- 2. APPROXIMATE LOCATION OF EXISTING SANITARY SEWER STUB (PER CITY AS-BUILTS). CONTRACTOR TO FIELD VERIFY PRIOR TO INSTALLING UPSTREAM

GAS INFORMATION			
POINT#	NORTHING	EASTING	FINISHED GRADE   NOTES
5000	978065.39	2818547.67	1003.19   SEE GAS NOTE 2
5001	978065.83	2818534.58	1002.30   22.5 DEG ELBOW
5002	978061.70	2818523.44	1002.22   22.5 DEG ELBOW
5003	978061.75	2818522.21	1002.23   FIELD BEND
5004	978061.77	2818521.63	1002.24   FIELD BEND
5005	978062.04	2818515.13	1002.30   UTILITY INTERFACE POINT. SEE MEP PLANS FOR CONTINUATION.

### **GAS NOTES**

- 1. GAS LINE DESIGN AND INSTALLATION PER SERVICE PROVIDER.
- 2. EXISTING GAS NOT PICKED UP ON SITE SURVEY. CONTRACTOR TO COORDINATE WITH SERVICE PROVIDER FOR SERVICING SITE WITH NATURAL GAS.

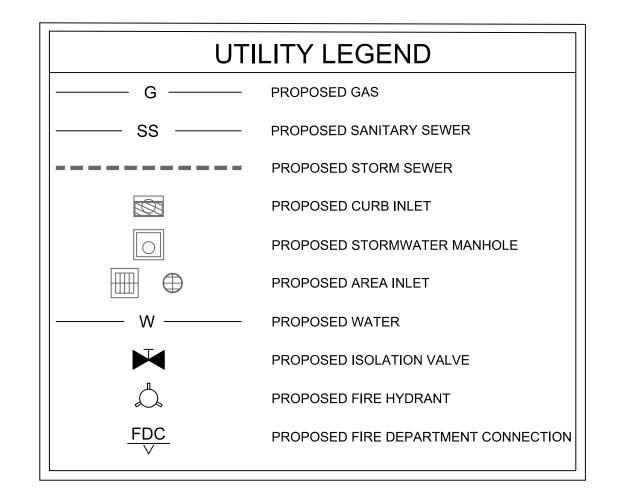

RELEASED FOR CONSTRUCTION As Noted on Plans Review Lee's Summit, Missouri 12/30/2022

9229 WARD PARKWAY SUITE # 210 KANSAS CITY, MO 64114 TEL: (816) 444-4200 FAX: (316) 265-5646 www.glmv.com

GLMV ARCHITECTURE, INC. MISSOURI STATE CERTIFICATE OF AUTHORITY

CIVIL ENGINEER & LANDSCAPE ARCH. GLMV ARCHITECTURE, INC MISSOURI CIVIL COA #2018033898 MISSOURI LANDSCAPE COA #000008 9229 WARD PARKWAY, SUITE # 210 KANSAS CITY, MO 64114

TEL: (816) 444-4200 STRUCTURAL ENGINEER LEIGH + O'KANE MISSOURI COA #001644 250 NE MURBERRY, SUITE 201

LEE'S SUMMIT, MO, 64086 (816) 444-3144 PHONE MECH., ELEC. & PLUMBING ENGINEERS

HOSS & BROWN ENGINEERS MISSOURI COA #01022 15902 MIDLAND DRIVE SHAWNEE, KS 66217

**SECURITY & IT ENGINEERS** HENDERSON ENGINEERS MISSOURI COA # 000556 1801 MAIN STREET, SUITE 300 KANSAS CITY, MO 64108

(913) 362-9090 PHONE

(816) 663-8700 PHONE

Z O E STATIC LEE'S SU FIRE CITY OF

|REVISIONS: # Description Date ASI 02 11.22.2022


DERICK M. HOLMES NUMBER ON PE-2022005196 / 5


DERICK HOLMES - CIVIL ENGINEER MO# PE-2022005196

PROJECT NO: 18225R21001 DATE: 10.26.2022 DRAWN BY: SJB CHK'D BY:

© GLMV Architecture, Inc. All work herein is the property of GLMV Architecture. Inc. and

**UTILITY PLAN** 

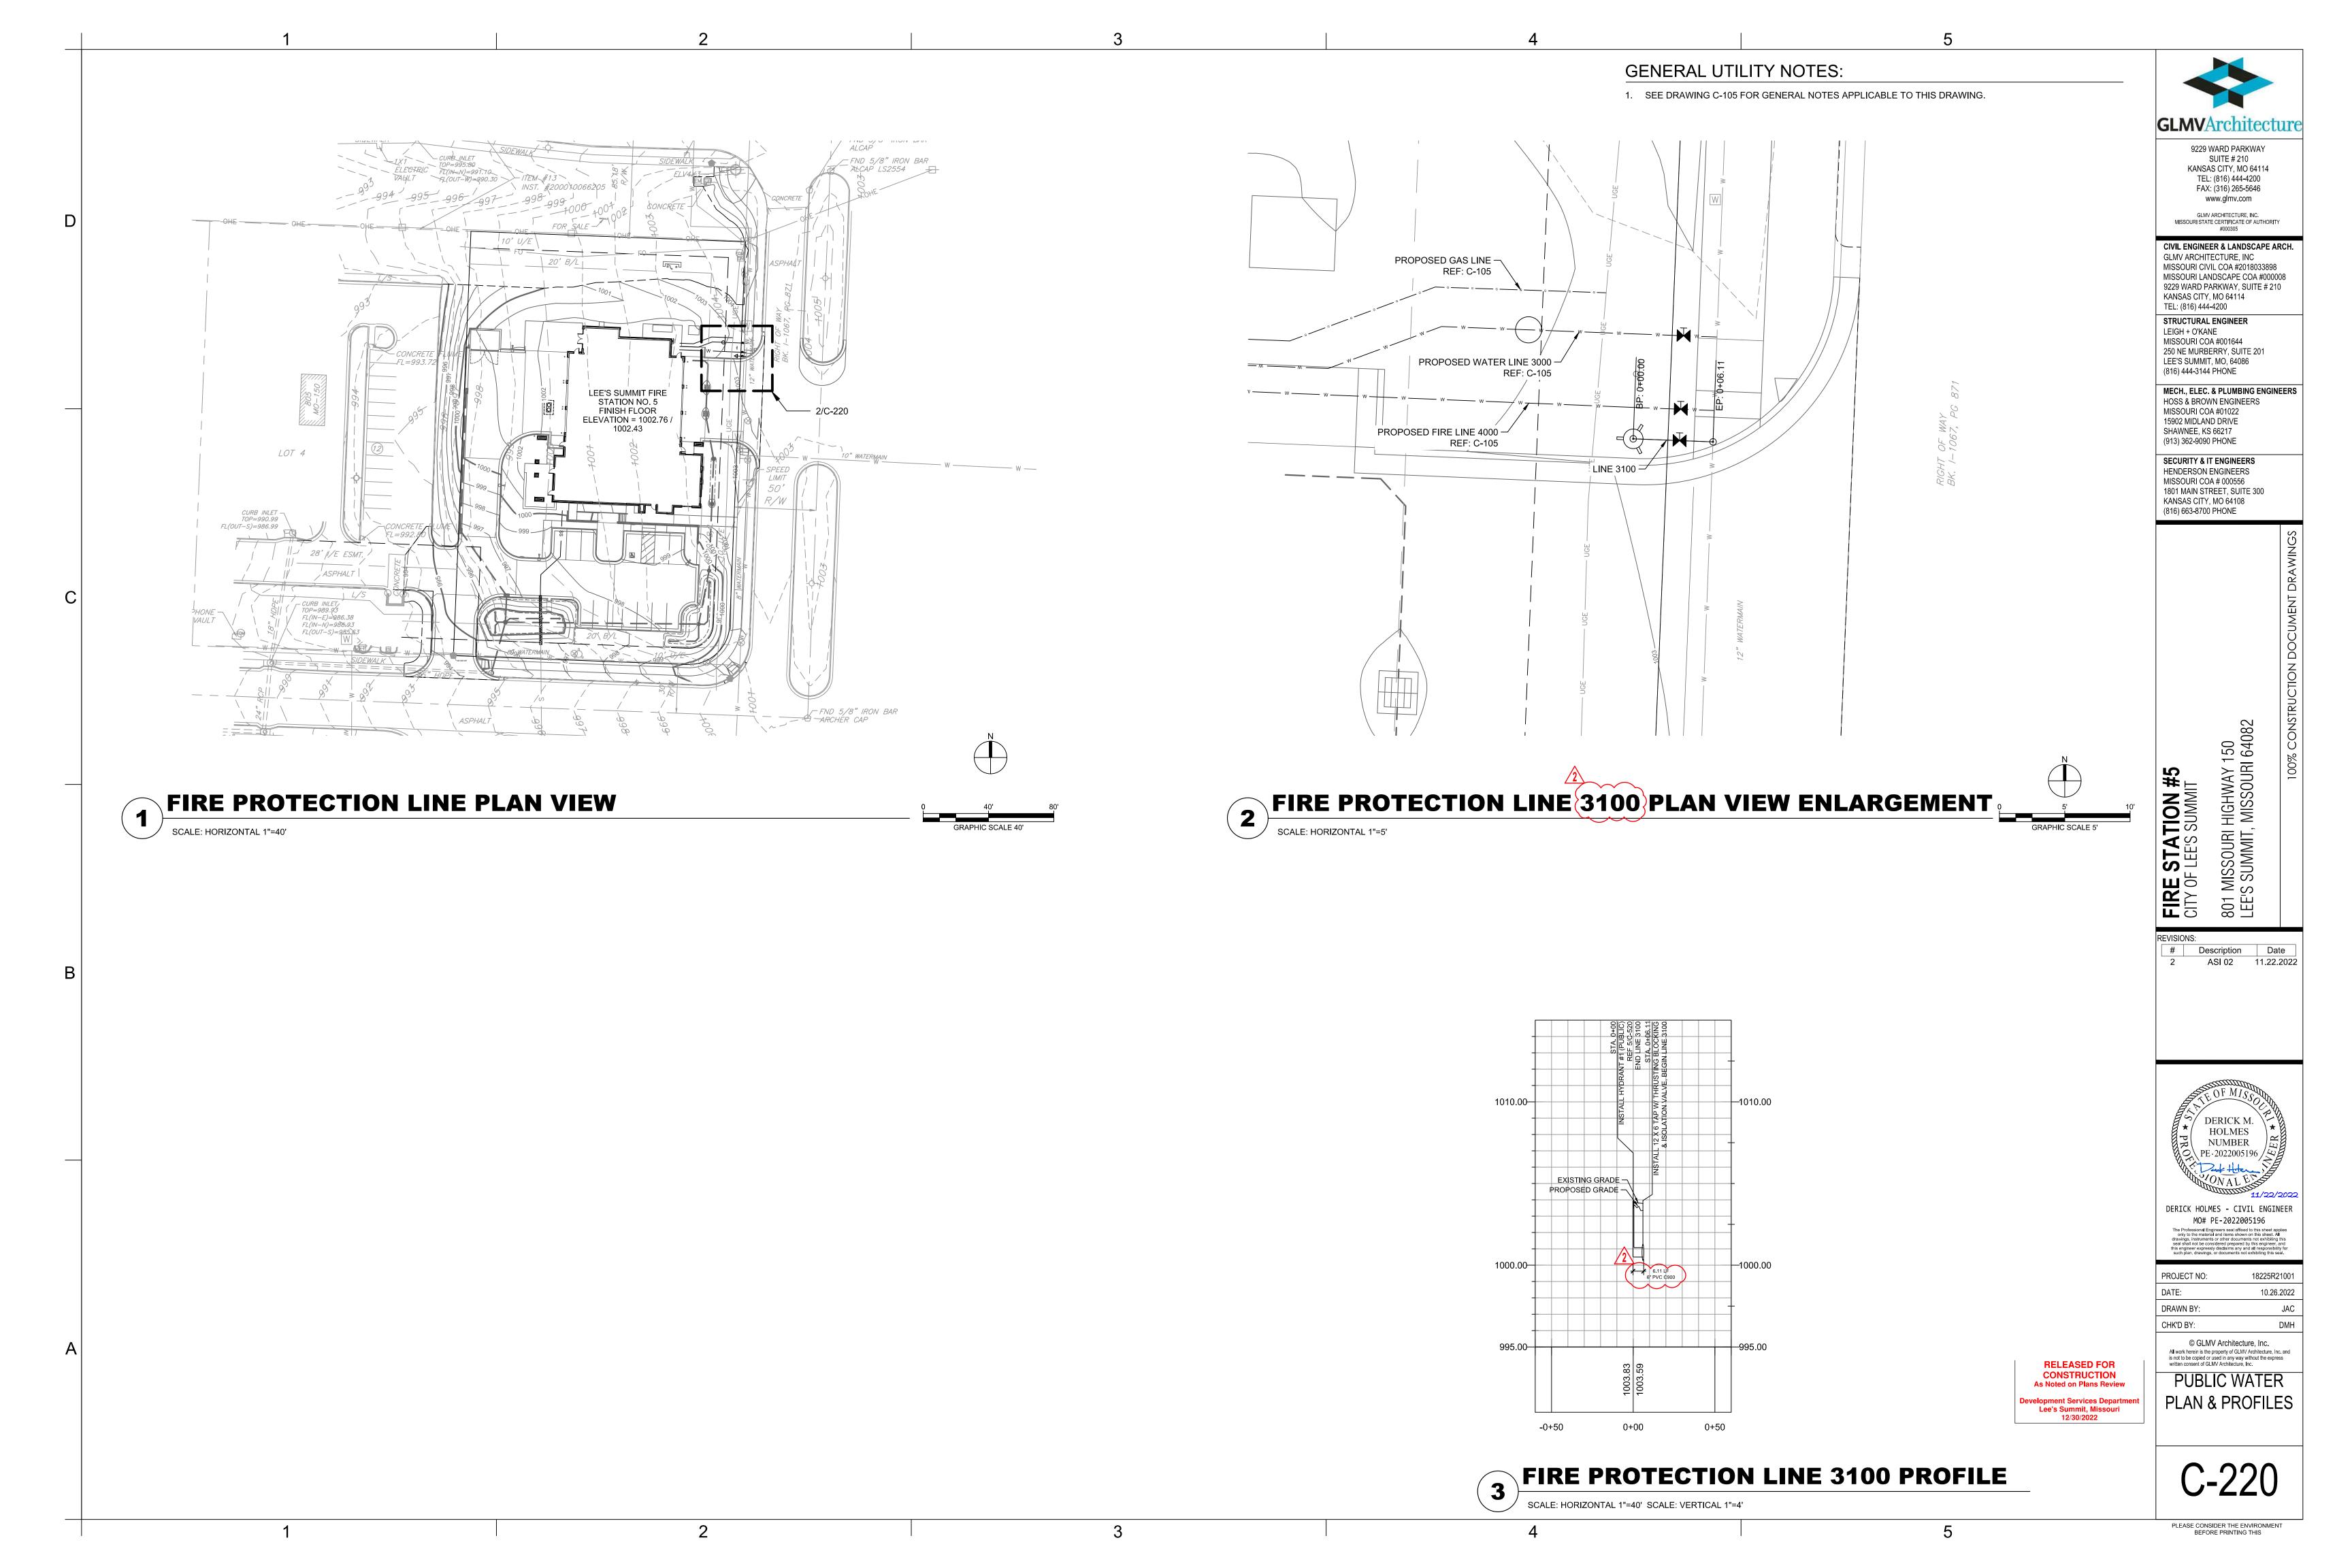

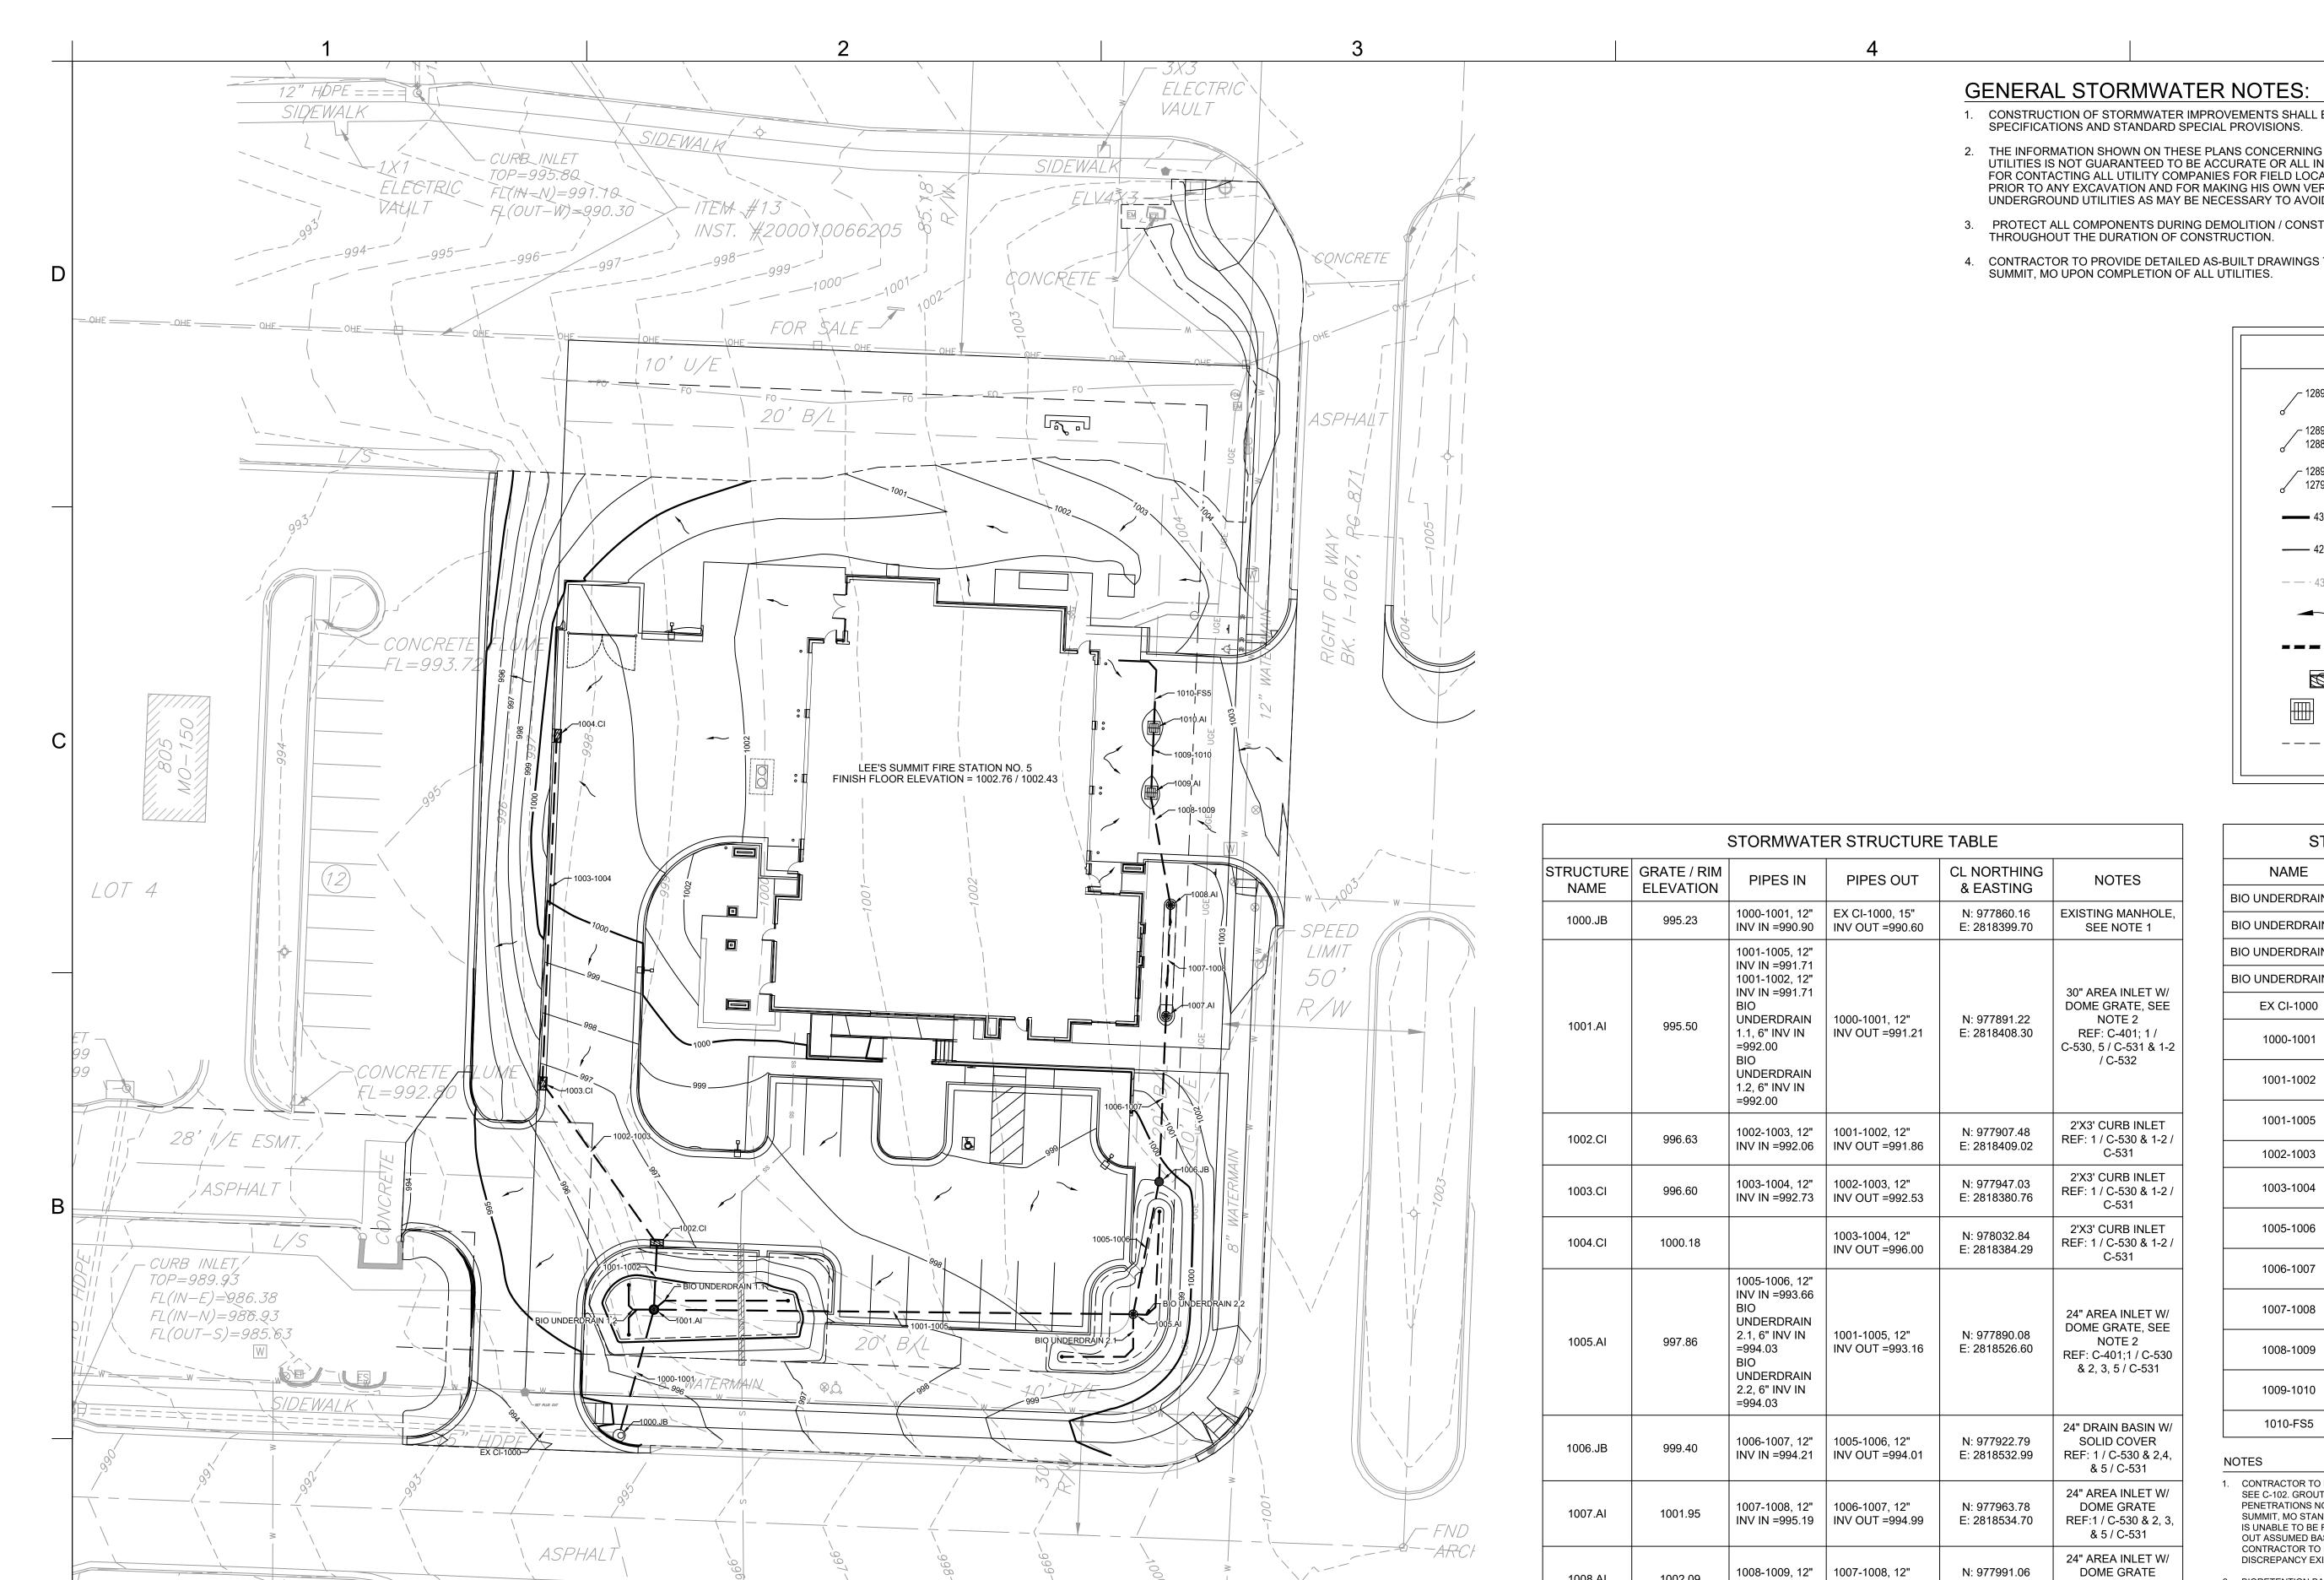

SIDEWALK

L/M/T

CONCRETE

SANITARY MANHOLE

FL(OUT-W) = 985.68

TOP=997.08

SIDEWALK •

FL(IN-N)=985.03

FL(OUT-W) = 984.63

**STORMWATER PLAN** 

- CURB INLET

TOP=989.83

- CONSTRUCTION OF STORMWATER IMPROVEMENTS SHALL BE AS PER CITY OF LEE'S SUMMIT, MO STANDARD
- 2. THE INFORMATION SHOWN ON THESE PLANS CONCERNING THE TYPE AND LOCATION OF UNDERGROUND UTILITIES IS NOT GUARANTEED TO BE ACCURATE OR ALL INCLUSIVE. THE CONTRACTOR IS RESPONSIBLE FOR CONTACTING ALL UTILITY COMPANIES FOR FIELD LOCATION OF ALL UNDERGROUND UTILITY LINES PRIOR TO ANY EXCAVATION AND FOR MAKING HIS OWN VERIFICATION AS TO TYPE AND LOCATION OF UNDERGROUND UTILITIES AS MAY BE NECESSARY TO AVOID DAMAGE THERETO.
- 3. PROTECT ALL COMPONENTS DURING DEMOLITION / CONSTRUCTION PROCESS. MAINTAIN BMP'S THROUGHOUT THE DURATION OF CONSTRUCTION.

4.	CONTRACTOR TO PROVIDE DETAILED AS-BUILT DRAWINGS TO OWNER, ENGINEER, AND CITY OF LEE'S SUMMIT, MO UPON COMPLETION OF ALL UTILITIES.

L	EGEND
1289.00	SPOT ELEVATION
1289.00 1288.45	TOP OF CURB ELEVATION FLOWLINE ELEVATION
1289.00 TW 1279.00 BW	TOP OF RETAINING WALL BOTTOM OF RETAINING WALL
430	PROPOSED MAJOR CONTOUR
<del></del> 429 <del></del>	PROPOSED MINOR CONTOUR
— · 430 · — —	EXISTING CONTOUR
_	FLOWLINE ARROW
	PROPOSED STORM SEWER
	PROPOSED CURB INLET
	PROPOSED AREA INLET
	BIORETENTION BASIN / SWALE EDGE

STORMWATER STRUCTURE TABLE					
STRUCTURE NAME	GRATE / RIM ELEVATION	PIPES IN	PIPES OUT	CL NORTHING & EASTING	NOTES
1000.JB	995.23	1000-1001, 12" INV IN =990.90	EX CI-1000, 15" INV OUT =990.60	N: 977860.16 E: 2818399.70	EXISTING MANHOLE, SEE NOTE 1
1001.AI	995.50	1001-1005, 12" INV IN =991.71 1001-1002, 12" INV IN =991.71 BIO UNDERDRAIN 1.1, 6" INV IN =992.00 BIO UNDERDRAIN 1.2, 6" INV IN =992.00	1000-1001, 12" INV OUT =991.21	N: 977891.22 E: 2818408.30	30" AREA INLET W/ DOME GRATE, SEE NOTE 2 REF: C-401; 1 / C-530, 5 / C-531 & 1-2 / C-532
1002.CI	996.63	1002-1003, 12" INV IN =992.06	1001-1002, 12" INV OUT =991.86	N: 977907.48 E: 2818409.02	2'X3' CURB INLET REF: 1 / C-530 & 1-2 / C-531
1003.CI	996.60	1003-1004, 12" INV IN =992.73	1002-1003, 12" INV OUT =992.53	N: 977947.03 E: 2818380.76	2'X3' CURB INLET REF: 1 / C-530 & 1-2 / C-531
1004.CI	1000.18		1003-1004, 12" INV OUT =996.00	N: 978032.84 E: 2818384.29	2'X3' CURB INLET REF: 1 / C-530 & 1-2 / C-531
1005.AI	997.86	1005-1006, 12" INV IN =993.66 BIO UNDERDRAIN 2.1, 6" INV IN =994.03 BIO UNDERDRAIN 2.2, 6" INV IN =994.03	1001-1005, 12" INV OUT =993.16	N: 977890.08 E: 2818526.60	24" AREA INLET W/ DOME GRATE, SEE NOTE 2 REF: C-401;1 / C-530 & 2, 3, 5 / C-531
1006.JB	999.40	1006-1007, 12" INV IN =994.21	1005-1006, 12" INV OUT =994.01	N: 977922.79 E: 2818532.99	24" DRAIN BASIN W/ SOLID COVER REF: 1 / C-530 & 2,4, & 5 / C-531
1007.AI	1001.95	1007-1008, 12" INV IN =995.19	1006-1007, 12" INV OUT =994.99	N: 977963.78 E: 2818534.70	24" AREA INLET W/ DOME GRATE REF:1 / C-530 & 2, 3, & 5 / C-531
1008.AI	1002.09	1008-1009, 12" INV IN =995.90	1007-1008, 12" INV OUT =995.70	N: 977991.06 E: 2818535.81	24" AREA INLET W/ DOME GRATE REF: 1 / C-530 & 2, 3, & 5 / C-531
1009.AI	1001.95	1009-1010, 12" INV IN =996.62	1008-1009, 12" INV OUT =996.42	N: 978018.84 E: 2818531.05	STANDARD DOUBLE GRATE INLET REF: 2 / C-530
1010.AI	1001.93	1010-FS5, 6" INV IN =997.09	1009-1010, 12" INV OUT =996.89	N: 978034.78 E: 2818531.72	STANDARD DOUBLE GRATE INLET REF: 2 / C-530
EX CI	989.93	EX CI-1000, 15" INV IN =986.38		N: 977866.28 E: 2818263.15	EXISTING CURB INLET, SEE NOTE 3 REF: 3-4 / C-530

STORMWATER PIPE TABLE		
NAME	PIPE DESCRIPTION	
BIO UNDERDRAIN 2.2	28.85 L.F. OF PERFORATED 6" PVC @ 0.5%	
BIO UNDERDRAIN 2.1	25.92 L.F. OF PERFORATED 6" PVC @ 0.5%	
BIO UNDERDRAIN 1.2	17.72 L.F. OF PERFORATED 6" PVC @ 0.5%	
BIO UNDERDRAIN 1.1	32.74 L.F. OF PERFORATED 6" PVC @ 0.5%	
EX CI-1000	133.81 LF OF 15" HDPE @ 3.16%	
1000-1001	5 31.21 LF OF 12"(HDPE)@ 1.00%	
1001-1002	5 14.52 LF OF 12"(HDPE)@ 1.00%	
1001-1005	5 116.32 LF OF 12 (HDPE)@ 1.25%	
1002-1003	47.13 LF OF 12"(HDPE@ 1.00%	
1003-1004	5 84.45 LF OF 12"(HDPE)@ 3.88%	
1005-1006	5 31.33 LF OF 12"(HDPE)@ 1.12%	
1006-1007	5 39.03 LF OF 12"(HDPE)@ 2.00%	
1007-1008	25.31 LF OF 12 (HDPE)@ 2.00%	
1008-1009	5 26.08 LF OF 12 (HDPE)@ 2.00%	
1009-1010	5 13.70 LF OF 12"(HDPE)@ 2.00%	
1010-FS5	23.28 LF OF 6" HDPE @ 1.13%	

1. CONTRACTOR TO REUSE EXISTING MANHOLE, IF POSSIBLE. SEE C-102. GROUT AND REPAIR EXISTING PIPE PENETRATIONS NO LONGER NECESSARY PER CITY OF LEE'S SUMMIT, MO STANDARDS. NOTIFY ENGINEER IF STRUCTURE IS UNABLE TO BE REUSED. EXISTING INVERT ELEVATION OUT ASSUMED BASED ON LINEAR INTERPOLATION.
CONTRACTOR TO FIELD VERIFY AND CONTACT ENGINEER IF DISCREPANCY EXISTS.

- 2. BIORETENTION BASIN OUTLET CONTROL STRUCTURE. SEE
- 3. THIS STRUCTURE HAS ADDITIONAL EXISTING PIPES NOT SHOWN IN THIS STRUCTURE TABLE.

<b>GLMV</b> Architecture

9229 WARD PARKWAY SUITE # 210 KANSAS CITY, MO 64114 TEL: (816) 444-4200 FAX: (316) 265-5646 www.glmv.com

GLMV ARCHITECTURE, INC. MISSOURI STATE CERTIFICATE OF AUTHORITY

CIVIL ENGINEER & LANDSCAPE ARCH. GLMV ARCHITECTURE, INC MISSOURI CIVIL COA #2018033898 MISSOURI LANDSCAPE COA #000008 9229 WARD PARKWAY, SUITE # 210 KANSAS CITY, MO 64114 TEL: (816) 444-4200

STRUCTURAL ENGINEER LEIGH + O'KANE MISSOURI COA #001644 250 NE MURBERRY, SUITE 201 LEE'S SUMMIT, MO, 64086 (816) 444-3144 PHONE

MECH., ELEC. & PLUMBING ENGINEERS HOSS & BROWN ENGINEERS MISSOURI COA #01022 15902 MIDLAND DRIVE SHAWNEE, KS 66217 (913) 362-9090 PHONE

SECURITY & IT ENGINEERS HENDERSON ENGINEERS MISSOURI COA # 000556 1801 MAIN STREET, SUITE 300 KANSAS CITY, MO 64108

(816) 663-8700 PHONE

801 MISSOURI HIG LEE'S SUMMIT, M

FIRE STATION # REVISIONS: # Description Date ASI 02 11.22.2022

ASI 05 02.08.2023

HOLMES NUMBER 多く PE 2022005196 / 点

DERICK HOLMES - CIVIL ENGINEER MO# PE-2022005196

PROJECT NO: 18225R21001 DATE: 10.26.2022 DRAWN BY: CHK'D BY:

© GLMV Architecture, Inc. All work herein is the property of GLMV Architecture, Inc. and is not to be copied or used in any way without the express written consent of GLMV Architecture, Inc.

STORMWATER PLAN

PLEASE CONSIDER THE ENVIRONMENT BEFORE PRINTING THIS

#### **GENERAL NOTES:**

- 1. SEE DRAWING C-230 FOR GENERAL NOTES APPLICABLE TO THIS DRAWING.
- 2. ALL STORMWATER STRUCTURES AND PIPES SHOWN ON THIS DRAWING ARE PRIVATE, UNLESS NOTED OTHERWISE.
- 3. 18" MINIMUM CLEARANCE REQUIRED.


\_ EXISTING GRADE 1006-1007 39.03 LF OF-12"(HDPE)@ 2.00% /--13.70 LF OF 12"(HDPE)@ 2.00% PROPOSED -1000.00 1000.00 BIORETENTION FINAL GRADE -BASIN 2 PROPOSED -BIORETENTION BASIN 1 31.33 LF ØF— 26.08 LF OF 12 HDPE @ 2.00% 100-YR, 24-HR HGL (TYP) |--25.31 LF OF 1001-1005 12"(HDPE)@ 2.00% 5 116.32 LF OF — 12"(HDPE)@ 1.25% <del>--</del>990.00 PROPOSED 4" SANITARY INV. EL: 990.08 STA.=0+21.56 PIPE ENCASEMENT PER 2 / C-540 -

 FINAL GRADE EXISTING GRADE 1000.00-COMPACTED FILL SHALL BE PLACED TO A MINIMUM 18" ABOVE THE TOP OF THE PIPE PRIOR TO INSTALLATION. PROPOSED BIORETENTION BASIN 1 1001-1002 --14.52 LF OF 12"(HDPE)@ 1.00% 1003-1004 84.45 LF OF 12"(HDPE @ 3.88%), 47.13 LF OF 12"(HDPE)@ 1.00% 990.00 5 1000-1001 31.21 LF OF 12" HDPE @ 1.00% 990.00 - 100-YR, 24-HR HGL (TYP) EXISTING 8" WATERLINE \_ INV. EL: UNKNOWN, CONTRACTOR TO FIELD VERIFY ADEQUATE CLEARANCE EXISTS -STA.=0+10.63 SEE NOTE 3 -980.00-0+00 0+50 1+00 1+50 2+00 2+50 1000.JB - 1004.CI PROFILE

## 1001.AI - 1010.AI PROFILE

0+00

SCALE: HORIZONTAL 1"=40' SCALE: VERTICAL: 1"=4'

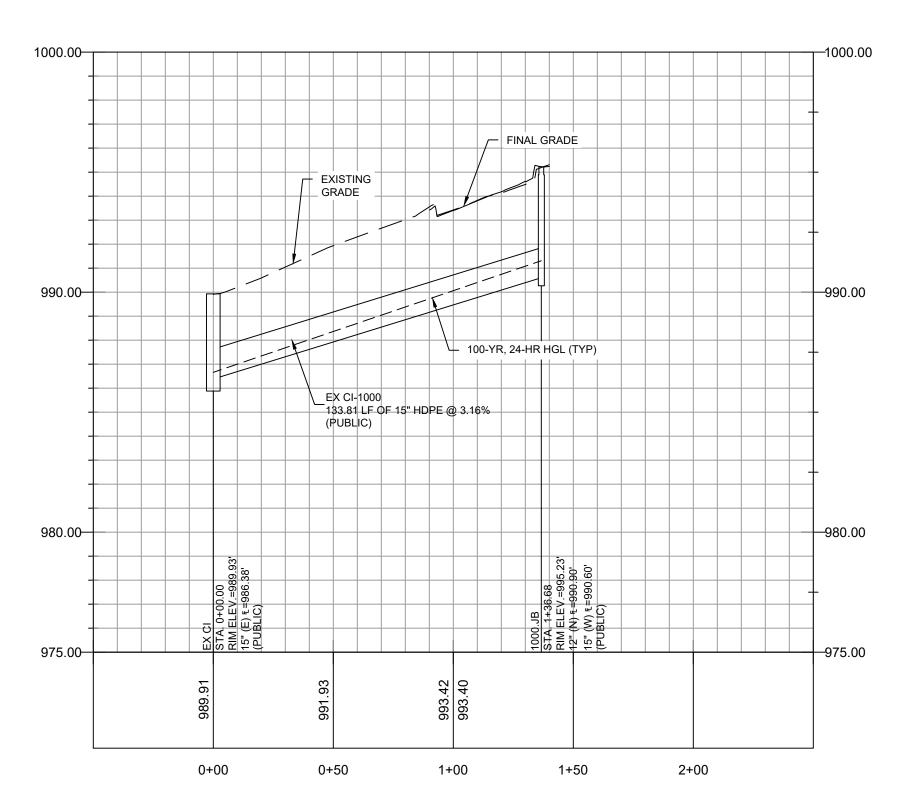

0+50

1+00

1+50

2+00

2+50

3+00

3+50

2	EX CI - 1000.JB PROFILE
3	SCALE: HORIZONTAL 1"=40' SCALE:VERTICAL: 1"=4'

								100-YR, 24-HR	STORM EVE	NT								
PIPE NAME	UPSTREAM NODE	DOWNSTREAM NODE	LENGTH (FT)	INLET INVERT ELEVATION (FT)	OUTLET INVERT ELEVATION (FT)	SLOPE (%)	PIPE DIAMETER (INCHES)	MANNING'S ROUGHNESS (N)	ENTRANCE LOSSES	EXIT/BEND LOSSES	PEAK FLOW (CFS)	TIME OF PEAK FLOW OCCURRENCE (DAYS HH:MM)	MAX FLOW VELOCITY (FT/SEC)	TRAVEL TIME (MIN)	DESIGN FLOW CAPACITY (CFS)	MAX FLOW / DESIGN FLOW RATIO	MAX FLOW DEPTH (FT)	MAX FLOW DEPTH / TOTAL DEPTH RATIO
1000-1001	1001.AI	1000.JB	31.21	991.21	990.90	1.00	12	0.012	0.50	0.80	1.36	0 12:01	4.47	0.12	3.85	0.35	0.41	0.41
1001-1002	1002.CI	1001.AI	14.52	991.86	991.71	1.00	12	0.012	0.50	1.00	0.28	0 12:00	3.02	0.08	4.18	0.07	0.18	0.18
1001-1005	1005.AI	1001.AI	116.32	993.16	991.71	1.25	12	0.012	0.50	1.00	0.77	0 12:01	4.18	0.46	4.31	0.18	0.29	0.29
1002-1003	1003.CI	1002.CI	47.13	992.53	992.06	1.00	12	0.012	0.50	0.60	0.21	0 12:00	2.69	0.29	3.94	0.05	0.16	0.16
1003-1004	1004.CI	1003.CI	84.45	996.00	992.73	3.88	12	0.012	0.50	0.60	0.17	0 12:05	3.91	0.36	7.60	0.02	0.11	0.11
1005-1006	1006.JB	1005.AI	31.33	994.01	993.66	1.12	12	0.012	0.50	0.80	0.59	0 12:00	3.70	0.14	4.08	0.14	0.26	0.26
1006-1007	1007.AI	1006.JB	39.03	994.99	994.21	2.00	12	0.012	0.50	0.55	0.59	0 12:00	4.58	0.14	5.49	0.11	0.22	0.22
1007-1008	1008.AI	1007.AI	25.31	995.70	995.19	2.00	12	0.012	0.50	0.50	0.57	0 12:00	4.54	0.09	5.53	0.10	0.22	0.22
1008-1009	1009.AI	1008.AI	26.08	996.42	995.90	2.00	12	0.012	0.50	0.55	0.54	0 11:20	4.50	0.10	5.55	0.10	0.21	0.21
1009-1010	1010.AI	1009.AI	13.70	996.89	996.62	2.00	12	0.012	0.50	0.50	0.47	0 11:20	4.42	0.05	5.71	0.08	0.19	0.19
EX CI - 1000.JB	1000.JB	EX CI	133.81	990.60	986.38	3.16	15	0.012	0.50	0.50	1.36	0 12:02	6.66	0.33	12.43	0.11	0.28	0.22

100-YR, 24-HR STORM EVENT					
STRUCTURE NAME	MAX HGL ELEVATION (FT)				
1000.JB	991.31				
1001.AI	992.00				
1002.CI	992.22				
1003.CI	992.83				
1004.CI	996.11				
1005.AI	993.92				
1006.JB	994.43				
1007.AI	995.41				
1008.AI	996.11				
1009.AI	996.81				
1010.AI	997.11				
EX CI	986.66				

							100-YR, 24-HR	STORM EVEN	NT							
M	DOWNSTREAM NODE	LENGTH (FT)	INLET INVERT ELEVATION (FT)	OUTLET INVERT ELEVATION (FT)	SLOPE (%)	PIPE DIAMETER (INCHES)	MANNING'S ROUGHNESS (N)	ENTRANCE LOSSES	EXIT/BEND LOSSES	PEAK FLOW (CFS)	TIME OF PEAK FLOW OCCURRENCE (DAYS HH:MM)	MAX FLOW VELOCITY (FT/SEC)	TRAVEL TIME (MIN)	DESIGN FLOW CAPACITY (CFS)	MAX FLOW / DESIGN FLOW RATIO	MAX FL DEP

9229 WARD PARKWAY SUITE # 210 KANSAS CITY, MO 64114 TEL: (816) 444-4200

FAX: (316) 265-5646 www.glmv.com

GLMV ARCHITECTURE, INC. MISSOURI STATE CERTIFICATE OF AUTHORITY

CIVIL ENGINEER & LANDSCAPE ARCH. GLMV ARCHITECTURE, INC MISSOURI CIVIL COA #2018033898 MISSOURI LANDSCAPE COA #000008 9229 WARD PARKWAY, SUITE # 210 KANSAS CITY, MO 64114 TEL: (816) 444-4200

STRUCTURAL ENGINEER LEIGH + O'KANE MISSOURI COA #001644 250 NE MURBERRY, SUITE 201 LEE'S SUMMIT, MO, 64086

(816) 444-3144 PHONE MECH., ELEC. & PLUMBING ENGINEERS


HOSS & BROWN ENGINEERS MISSOURI COA #01022 15902 MIDLAND DRIVE SHAWNEE, KS 66217

(913) 362-9090 PHONE SECURITY & IT ENGINEERS HENDERSON ENGINEERS MISSOURI COA # 000556 1801 MAIN STREET, SUITE 300 KANSAS CITY, MO 64108

(816) 663-8700 PHONE

FIRE STATION #

REVISIONS: # Description Date
2 ASI 02 11.22.2022 ASI 05 02.08.2023

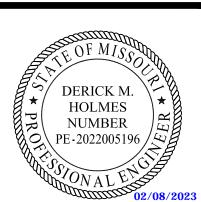

DERICK HOLMES - CIVIL ENGINEER MO# PE-2022005196

PROJECT NO:	18225R21001
DATE:	10.26.2022
DRAWN BY:	HFL
CHK'D BY:	DMH


© GLMV Architecture, Inc.

All work herein is the property of GLMV Architecture, Inc. and is not to be copied or used in any way without the express written consent of GLMV Architecture, Inc.

STORMWATER **PROFILES** 

PLEASE CONSIDER THE ENVIRONMENT BEFORE PRINTING THIS

SCALE: HORIZONTAL 1"=40' SCALE:VERTICAL: 1"=4'

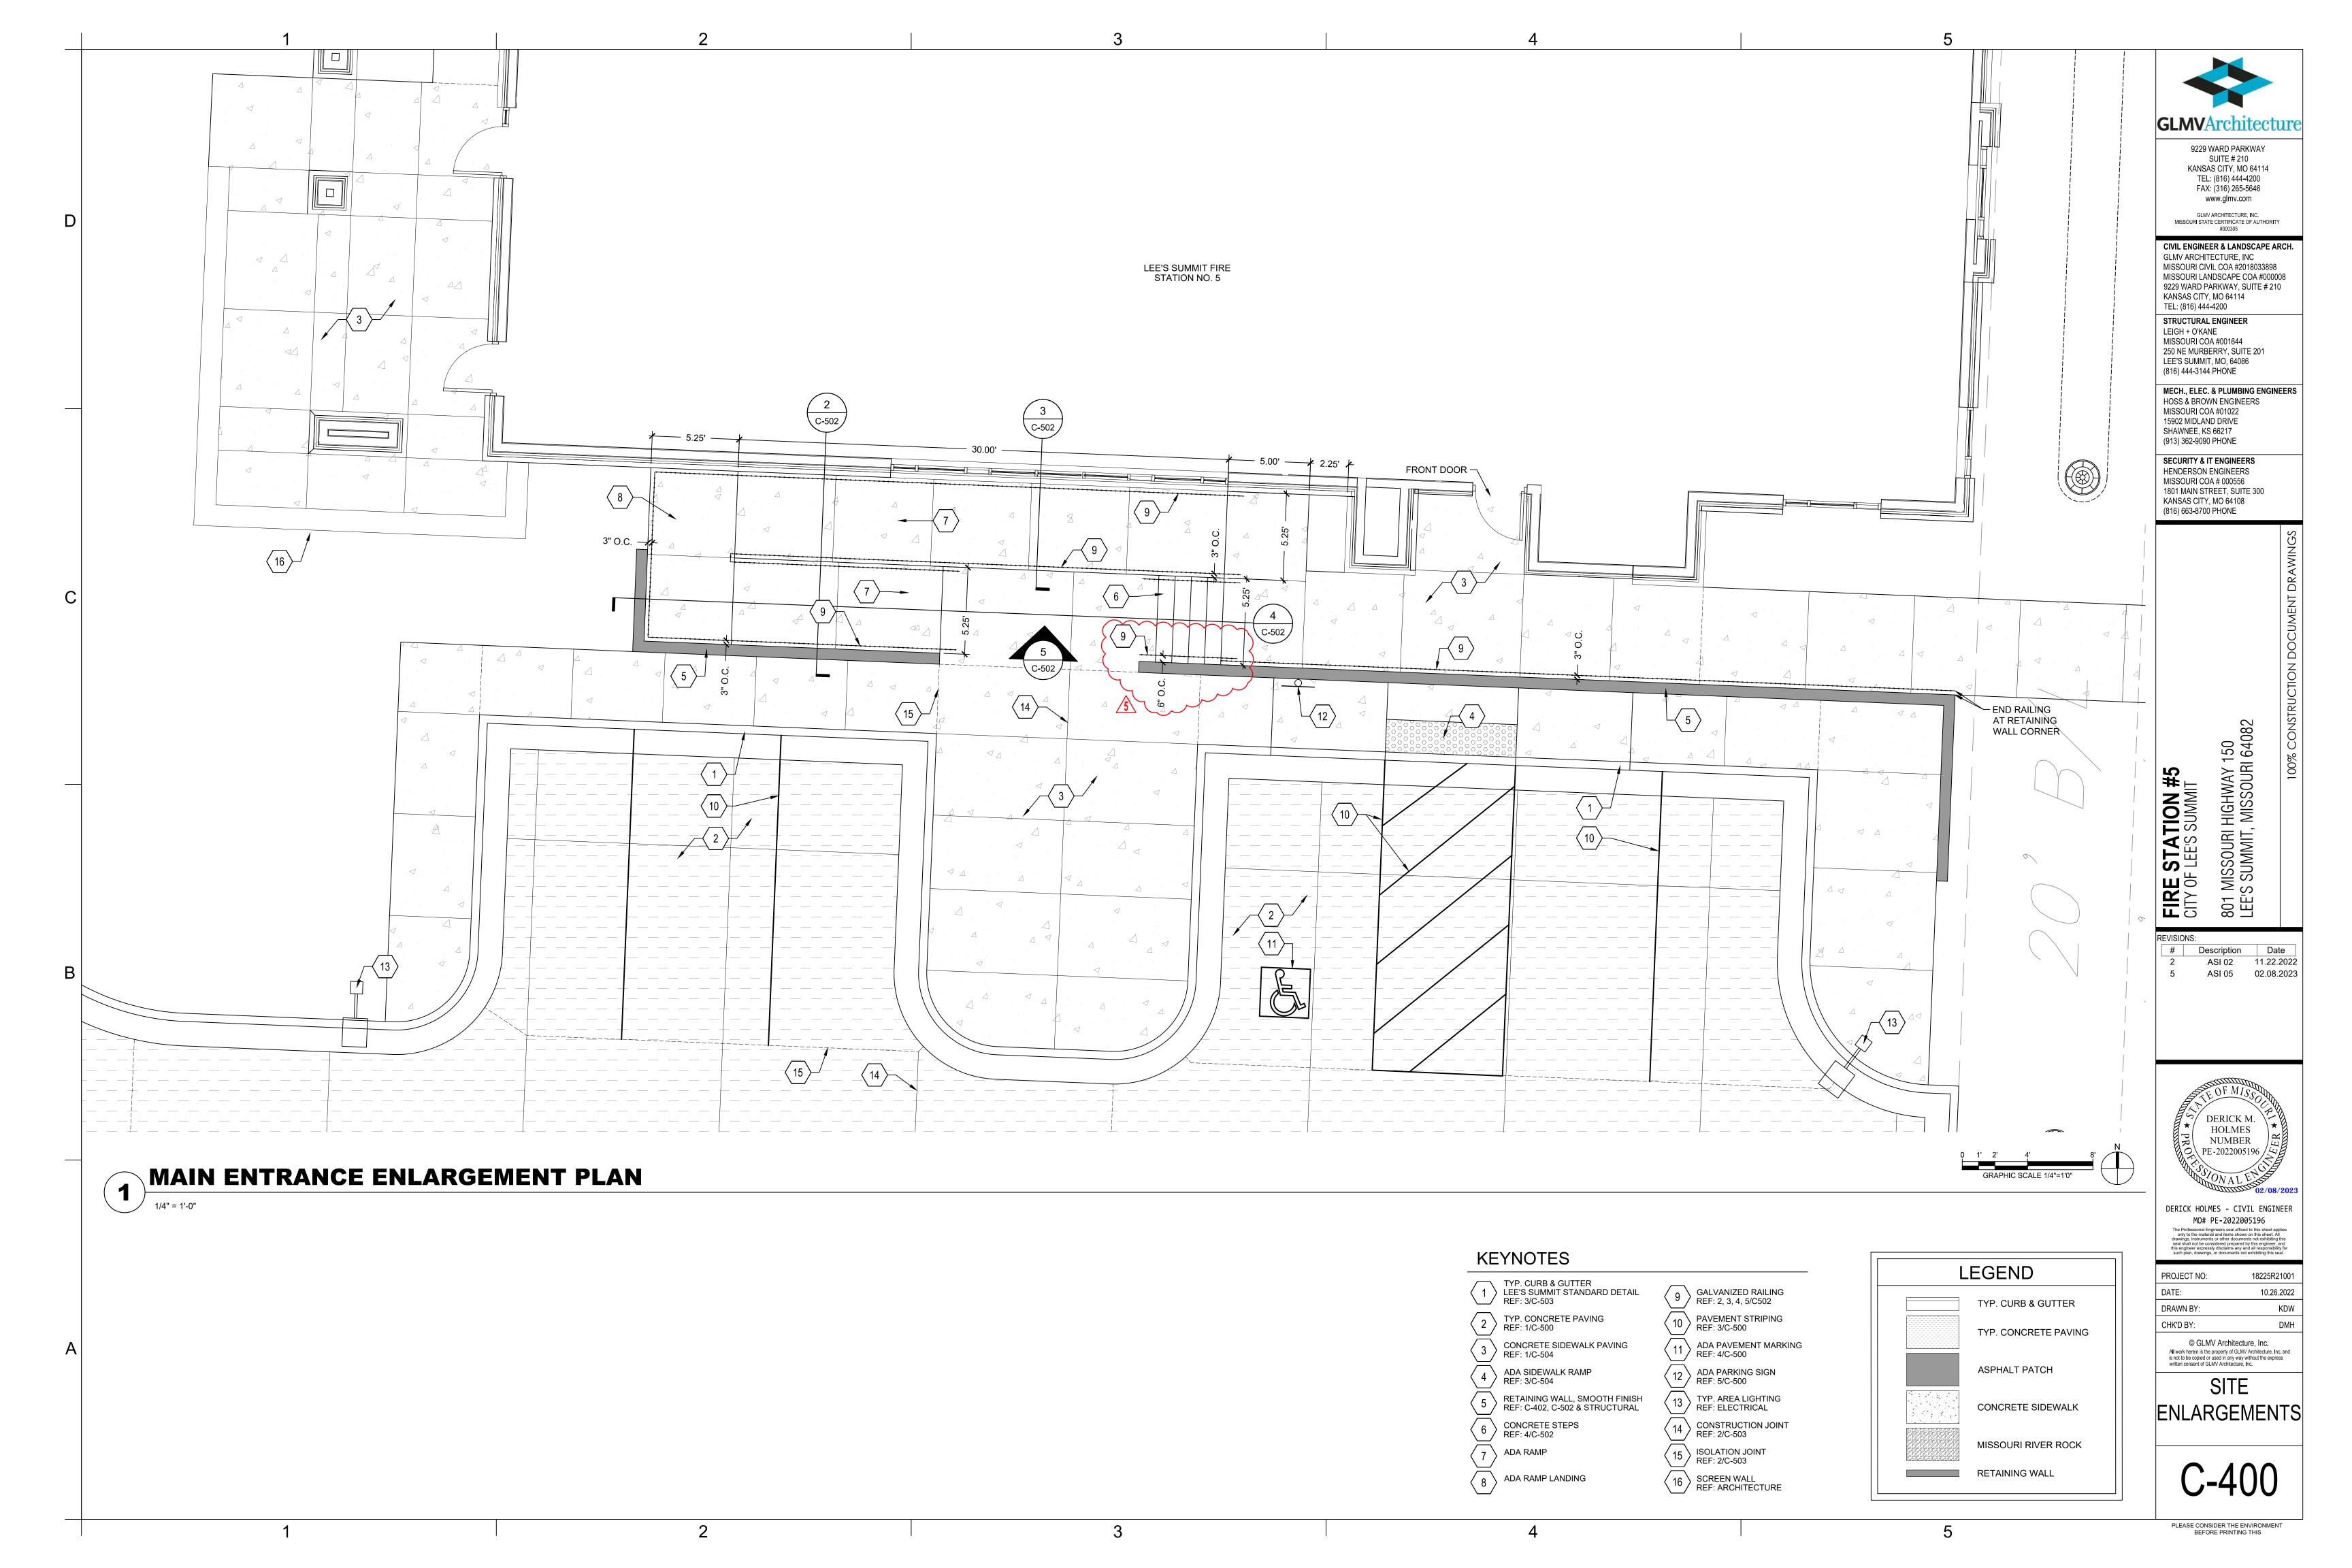

- BIO UNDERDRAIN 2.2

- BIỢ UNDEŖDRAIN 2.1

C-401

<del>∽CLEANOUT 2.</del>1—

₋ INV EL = 994.16


TOP = 997.95

998.63

998.19-

**BIORETENTION BASIN 2 ENLARGEMENT PLAN** 

### SCH. 40 PVC SLOPED AT 0.5% MIN. PIPE 1000-1005 (SEE C-104)

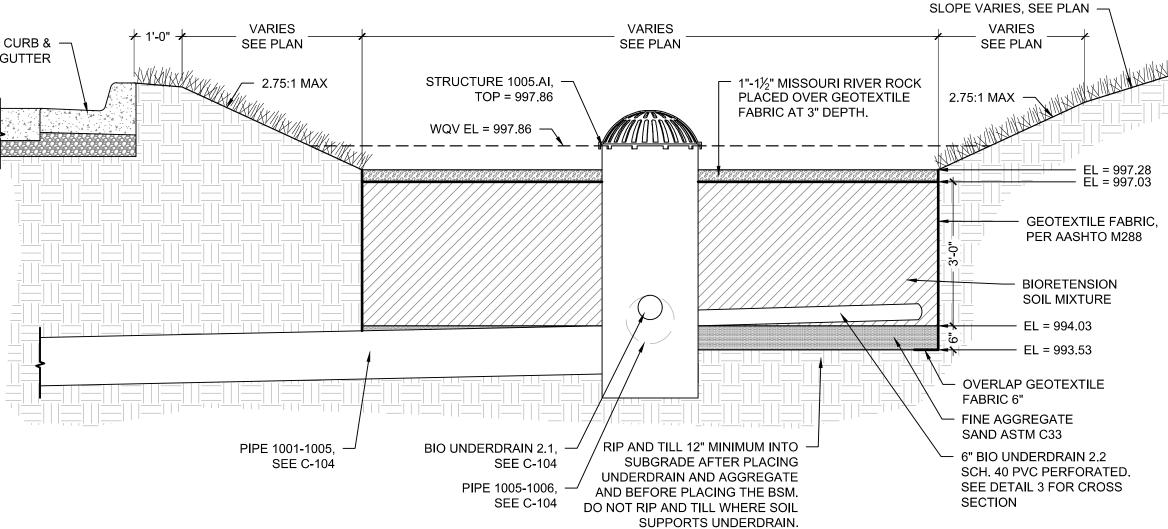

- 6" PVC THREADED CAP

BIORETENSION

6" PVC PIPE

WYE CONNECTION

6" PERFORATED

1/8 BEND

PVC PIPE

VARIES

SEE PLAN

3:1 MAX

GEOTEXTILE FABRIC PER AASHTO M288

OVERLAP GEOTEXTILE

- EL = 991.50

FABRIC 6"

GEOTEXTILE FABRIC, TOP ONLY

- ASTM NO.57 AGGREGATE, DOUBLE WASHED

BIO UNDERDRAIN 1.1, 6" PERFORATED

STOPPER AND JOINTING MATERIAL

**BASIN SURFACE** 

#### **GENERAL NOTES:**

- BIORETENTION FACILITIES SHALL NOT BE CONSTRUCTED UNTIL ALL CONTRIBUTING DRAINAGE AREAS ARE PERMANENTLY STABILIZED AGAINST EROSION AND SEDIMENTATION. ANY DISCHARGE OF SEDIMENT THAT AFFECTS THE PERFORMANCE OF THE CELL WILL REQUIRE RECONSTRUCTION OF THE CELL TO RESTORE ITS DEFINED
- 2. NO HEAVY EQUIPMENT SHALL OPERATE WITHIN THE BIORETENTION FACILITY DURING UNDERDRAIN PLACEMENT, BACKFILLING, OR PLANTING OF THE FACILITY.
- 3. IF THE BIORETENTION FACILITY IS TO BE USED AS A SEDIMENT BASIN, THE BIORETENTION FACILITY SHALL BE EXCAVATED TO THE DIMENSIONS. SIDE SLOPES. AND 1 FOOT ABOVE THE BOTTOM OF THE BIORETENSION SOIL MIXTURE. ANY SEDIMENT FROM CONSTRUCTION OPERATIONS DEPOSITED IN THE BIORETENTION FACILITY SHALL BE COMPLETELY REMOVED FROM THE FACILITY AFTER ALL VEGETATION HAS BEEN ESTABLISHED. THE EXCAVATION LIMITS SHALL THEN BE FINAL GRADED TO THE DIMENSIONS. SIDE SLOPES. AND FINAL ELEVATIONS. LOW GROUND-CONTACT PRESSURE EQUIPMENT IS TO BE USED WHEN CONSTRUCTING THE BIORETENTION FACILITIES TO MINIMIZE DISTURBANCE TO ESTABLISH AREAS AROUND PERIMETER OF CELL. NO HEAVY EQUIPMENT SHALL BE USED WITHIN THE PERIMETER OF THE BIORETENTION FACILITY BEFORE, DURING, OR AFTER THE PLACEMENT OF THE BSM.
- 4. THE BIORETENTION SOIL MIXTURE (BSM) SHALL BE PLACED IN LAYERS NOT TO EXCEED 12 INCHES. THE BSM SHALL BE SATURATED OVER THE ENTIRE AREA OF THE FACILITY AFTER EACH LIFT OF BSM IS PLACED UNTIL WATER FLOWS FROM THE UNDERDRAIN TO LIGHTLY CONSOLIDATE THE BSM MIXTURE. WATER FOR SATURATION SHALL BE APPLIED BY SPRAYING OR SPRINKLING TO AVOID SEPARATION OF THE BSM COMPONENTS. FINAL GRADING OF THE BSM SHALL BE PERFORMED AFTER A 24-HOUR SETTLING PERIOD. UPON FINAL GRADING THE SURFACE OF THE BSM SHALL BE ROTO-TILLED TO A DEPTH OF 6".
- 5. SEE DRAWING L-100 AND L-101 FOR PLANTING SCHEDULE. PESTICIDES, HERBICIDES, AND FERTILIZER SHALL NOT BE APPLIED DURING PLANTING UNDER ANY CIRCUMSTANCES.

### BIORETENTION SOIL MIXTURE (BSM) SPECIFICATIONS:

#### MATERIALS

TYP. CURB &

A. BIORTENTION SOIL MIXUTRE: THE BIORETENTION SOIL MIXTURE (BSM) IS A MIXTURE OF PLANTING SOIL, COMPOST, AND SAND CONSISTING OF THE FOLLOWING:

ITEM	COMPOSITION BY VOLUME	REFERENCE
PLANTING SOIL	30%	SEE BELOW
ORGANIC COMPOST	20%	SEE BELOW
SAND	50%	ASTM C33 FINE AGGREGATE

B. PLANTING SOIL: THE USDA TEXTURAL CLASSIFICATION OF THE PLANTING SOIL FOR THE BSM SHALL BE LOAMY SAND OR SANDY LOAM. THE PLANTING SOIL SHALL BE TESTED AND MEET THE FOLLOWING CRITERIA:

ITEM	PERCENT BY WEIGHT	TEST METHOD
SAND (2.0 - 0.050 MM)	50-85%	AASHTO T88
SILT (0.050 - 0.002 MM)	0-50%	AASHTO T88
CLAY (LESS THAN 0.002 MM)	2-5%	AASHTO T88
ORGANIC MATTER	3-10%	AASHTO T194

THE TEXTURAL ANALYSIS OF THE PLANTING SOIL SHALL BE AS FOLLOWS:

ASTM E11 SIEVE SIZE	MINIMUM PERCENT PASSING BY WEIGHT
2 IN.	100%
NO. 4	90
NO. 10	80

AT LEAST 45 DAYS PRIOR TO THE START OF CONSTRUCTION OF THE BIORETENTION FACILITIES, THE CONTRACTOR SHALL SUBMIT THE SOURCE AND TESTING RESULTS OF THE PLANTING SOIL FOR THE BSM TO THE ENGINEER FOR

#### C. ORGANIC COMPOST

COMPOST IS DEEMED ACCEPTABLE IF IT MEETS 2 OF THE FOLLOWING REQUIREMENTS:

- 1. C/N RATIO <= 25; 2. OXYGEN UPTAKE RATE <= 150 mg/ O2/kg VOLATILE SOLIDS PER HOUR
- 3. COMPOST MUST NOT CONTAIN MORE THAN 1 PERCENT FOREIGN MATTER. FOREIGN MATTER IS DEFINED AS: "ANY MATTER OVER A 2 MM DIMENSION THAT RESULTS FROM HUMAN INTERVENTION AND HAVING ORGANIC OR INORGANIC CONSTITUENTS SUCH AS METAL, GLASS AND SYNTHETIC POLYMERS (E.G., PLASTIC OR RUBBER) THAT MAY BE PRESENT IN THE COMPOST BUT EXCLUDING MINERAL SOILS, WOODY MATERIAL AND ROCKS."
- 4. FOREIGN MATTER LESS THAN 1 PERCENT BY WEIGHT MUST NOT EXCEED 12.5 MM IN ANY DIMENSION.
- D. THE BIORETENTION SOIL MIXTURE (BSM) SHALL BE A UNIFORM MIX, FREE OF PLANT RESIDUE, STONES, STUMPS, ROOTS OR OTHER SIMILAR OBJECTS LARGER THAN TWO INCHES EXCLUDING MULCH. NO OTHER MATERIALS OR SUBSTANCES SHALL BE MIXED OR DUMPED WITHIN THE BIORETENTION AREA THAT MAY BE HARMFUL TO PLANT GROWTH, OR PROVE A HINDRANCE TO THE PLANTING OR MAINTENANCE OPERATIONS.
- 1. THE BIORETENTION SOIL MIXTURE SHALL BE TESTED AND MEET THE FOLLOWING CRITERIA:

ITEM	CRITERIA	TEST METHOD
CORRECTED pH	5.5 - 7.5	ASTM D4972
MAGNESIUM	MINIMUM 32 PPM	*
PHOSPHORUS (PHOSPHATE - P <sub>2</sub> O <sub>5</sub> )	NOT TO EXCEED 60 PPM PLANT AVAILABLE PHOSPHORUS	*
POTASSIUM (K <sub>2</sub> O)	MINIMUM 78 PPM	*
SOLUBLE SALTS	NOT TO EXCEED 500 PPM	*

\*USE AUTHORIZED SOIL TEST PROCEDURES

- 2. SHOULD THE pH FALL OUTSIDE OF THE ACCEPTABLE RANGE, IT MAY BE MODIFIED WITH LIME (TO RAISE) OR AMMONIUM SULFATE (TO LOWER). THE LIME OR AMMONIUM SULFATE MUST BE MIXED UNIFORMLY INTO THE BSM PRIOR TO USE IN BIORETENTION FACILITIES.
- 3. SHOULD THE BSM NOT MEET THE MINIMUM REQUIREMENT FOR MAGNESIUM, IT MAY BE MODIFIED WITH MAGNESIUM SULFATE. LIKEWISE, SHOULD THE BSM NOT MEET THE MINIMUM REQUIREMENT FOR POTASSIUM, IT MAY BE MODIFIED WITH POTASH. MAGNESIUM SULFATE AND POTASH MUST BE MIXED UNIFORMLY INTO THE BSM PRIOR TO USE IN BIORETENTION FACILITIES.
- 4. PLANTING SOIL AND/OR BSM THAT FAILS TO MEET THE MINIMUM REQUIREMENTS SHALL BE REPLACED AT THE CONTRACTOR'S EXPENSE. MIXING OF THE CORRECTIVE ADDITIVES TO THE BSM IS INCIDENTAL AND SHALL BE AT THE CONTRACTOR'S EXPENSE.
- 5. MIXING OF THE BSM TO A HOMOGENOUS CONSISTENCY SHALL BE DONE TO THE SATISFACTION OF THE ENGINEER, UPON APPROVAL OF ALL REQUIREMENTS AND TESTING ABOVE, THE BSM SHALL BE STOCKPILED, AND NO MATERIAL SHALL BE ADDED TO THE BSM IN THE STOCKPILE OR DURING TRANSPORT TO THE BIORETENTION FACILITY.

RELEASED FOR CONSTRUCTION As Noted on Plans Review 12/30/2022



9229 WARD PARKWAY SUITE # 210 KANSAS CITY, MO 64114 TEL: (816) 444-4200 FAX: (316) 265-5646

GLMV ARCHITECTURE, INC.

CIVIL ENGINEER & LANDSCAPE ARCH. MISSOURI LANDSCAPE COA #000008 9229 WARD PARKWAY, SUITE # 210

# STRUCTURAL ENGINEER

MISSOURI COA #001644 250 NE MURBERRY, SUITE 201 LEE'S SUMMIT, MO, 64086


MECH., ELEC. & PLUMBING ENGINEERS

MISSOURI COA #01022

MISSOURI COA # 000556 1801 MAIN STREET, SUITE 300

KANSAS CITY, MO 64108 (816) 663-8700 PHONE

FIRE CITY OF REVISIONS

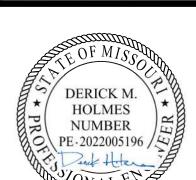

MO# PE-2022005196

PROJECT NO:	18225R21001
DATE:	10.26.2022
DRAWN BY:	KDW
CHK'D BY:	DMH

© GLMV Architecture, Inc. All work herein is the property of GLMV Architecture, Inc. and is not to be copied or used in any way without the express written consent of GLMV Architecture, Inc.

1/2" = 1'-0"

BIORETENTION BASIN 2 CROSS SECTION

www.glmv.com

GLMV ARCHITECTURE, INC

MISSOURI CIVIL COA #2018033898

LEIGH + O'KANE

(816) 444-3144 PHONE **HOSS & BROWN ENGINEERS** 

SHAWNEE, KS 66217 (913) 362-9090 PHONE **SECURITY & IT ENGINEERS** HENDERSON ENGINEERS

Z O E


# Description

DERICK HOLMES - CIVIL ENGINEER

MISSOURI STATE CERTIFICATE OF AUTHORITY

KANSAS CITY, MO 64114 TEL: (816) 444-4200

15902 MIDLAND DRIVE

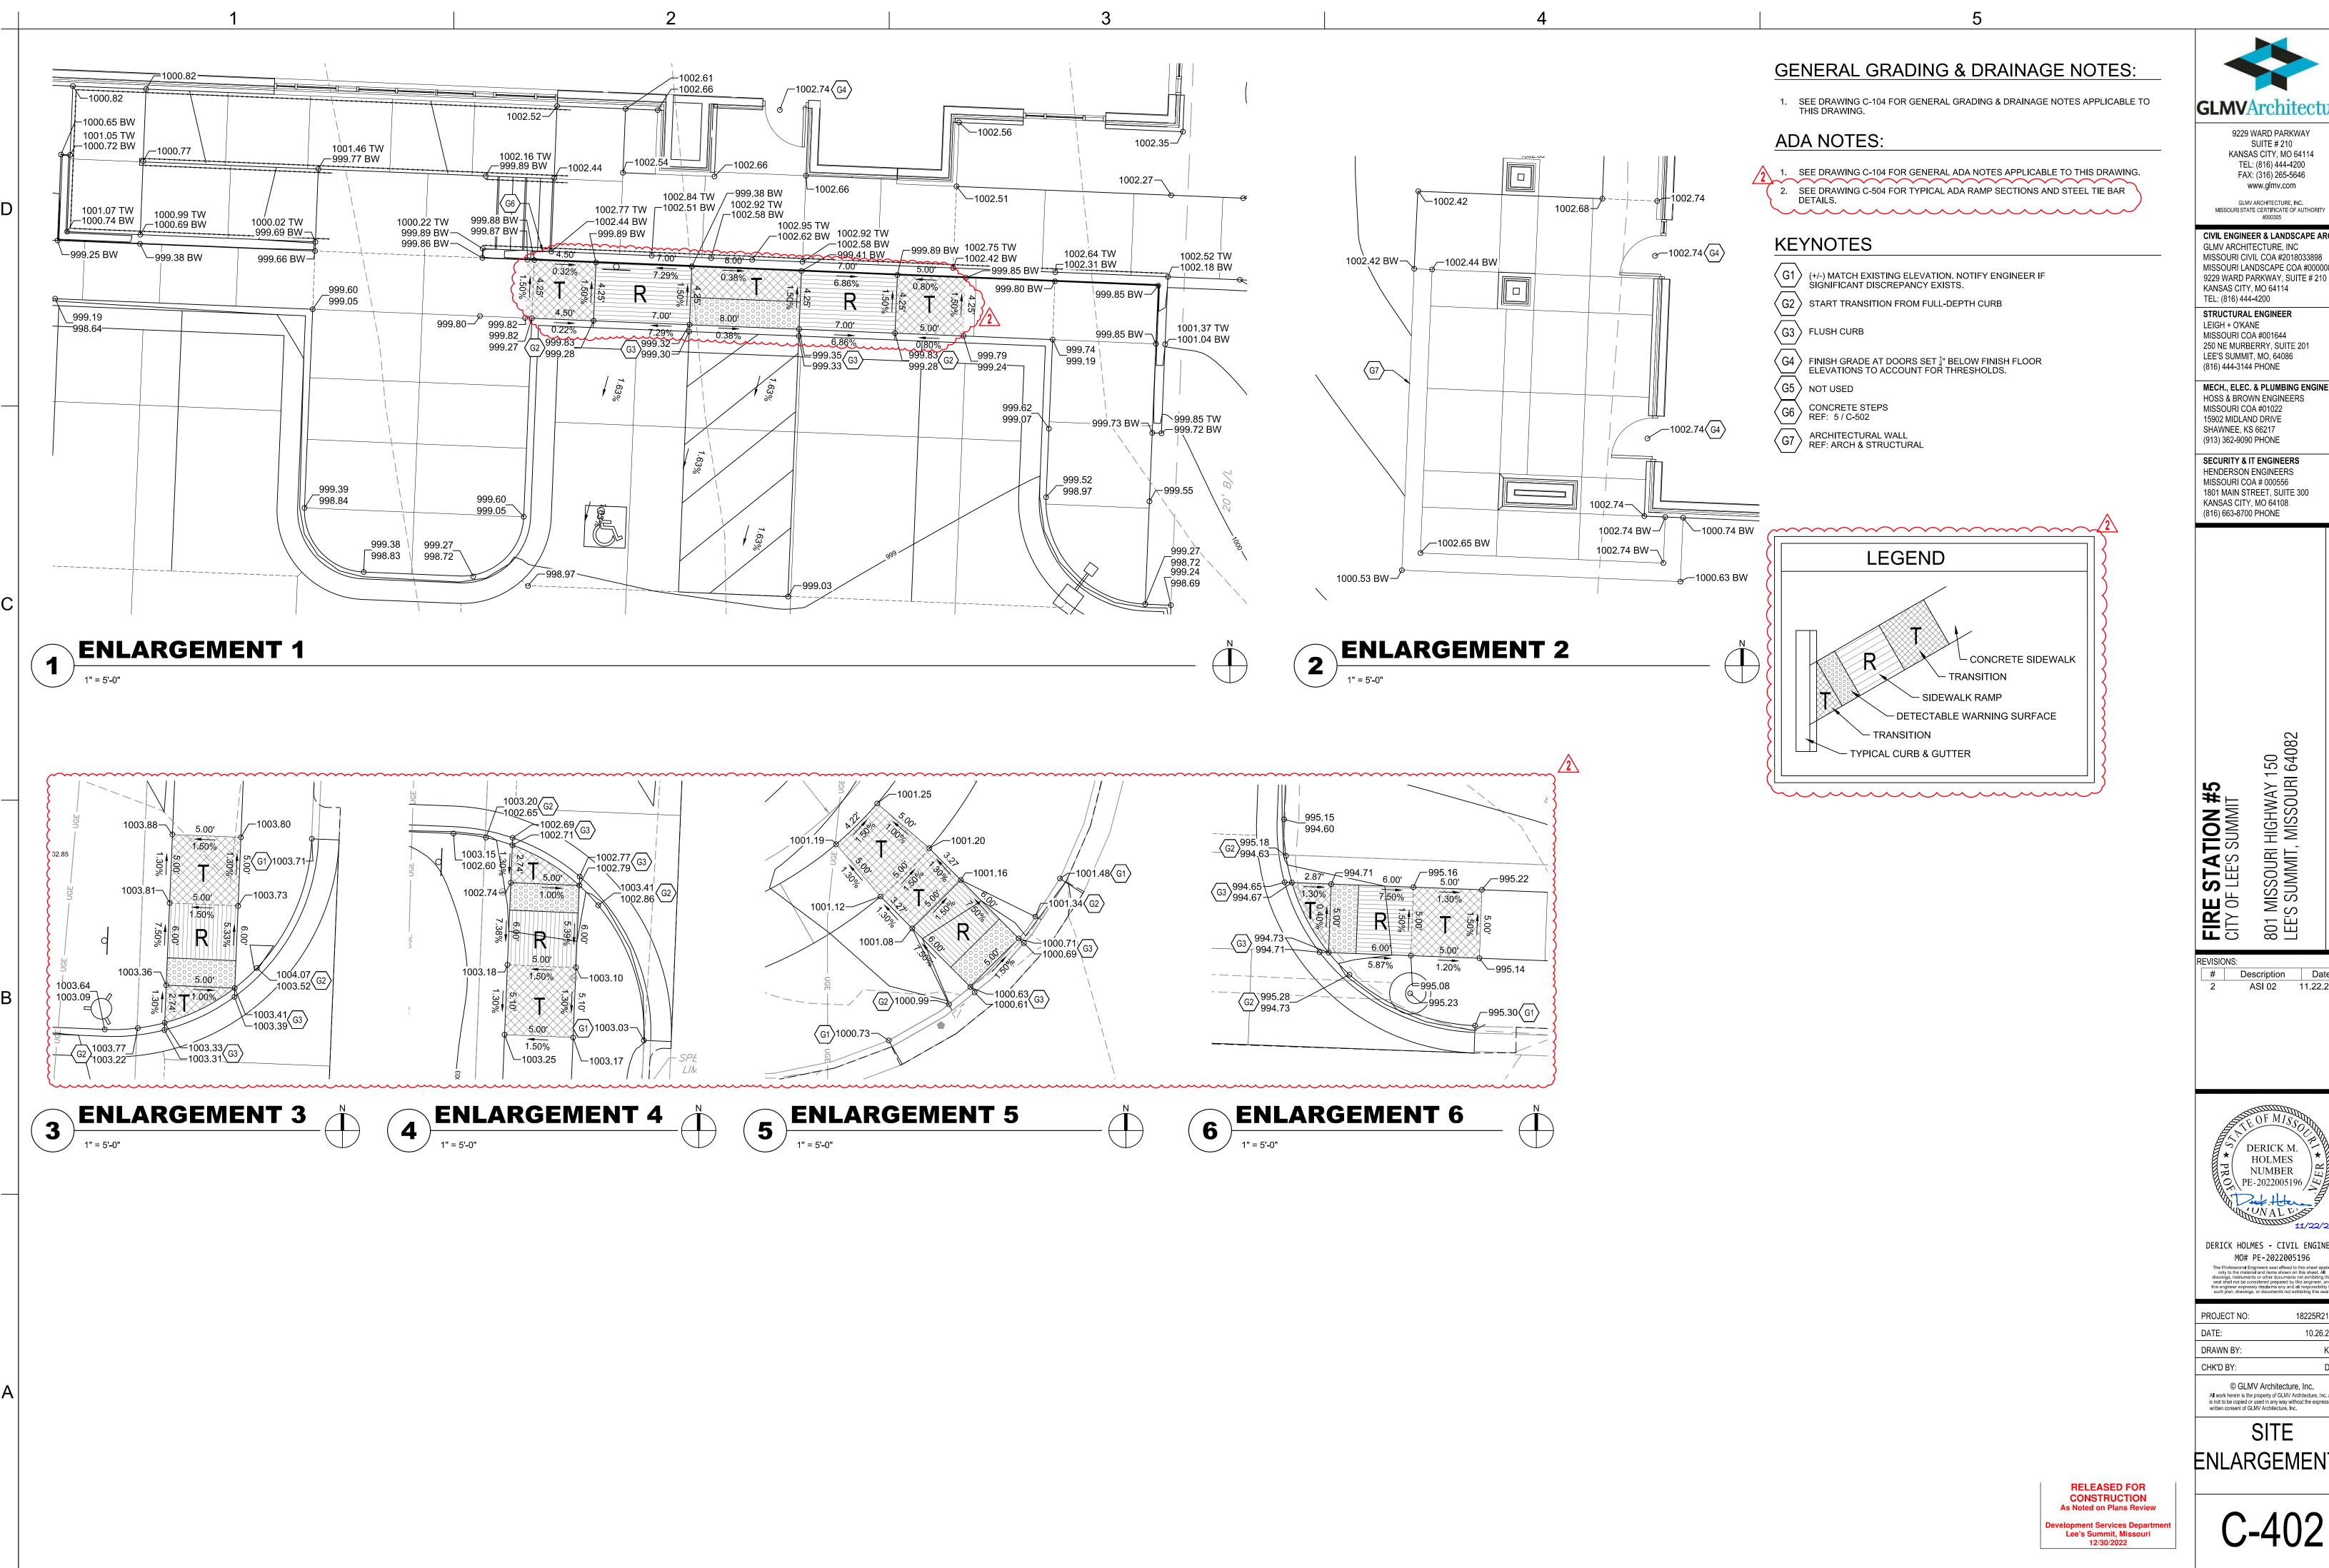

**GLMV**Architecture

9229 WARD PARKWAY SUITE # 210 KANSAS CITY, MO 64114 TEL: (816) 444-4200 FAX: (316) 265-5646 www.glmv.com

GLMV ARCHITECTURE, INC.

CIVIL ENGINEER & LANDSCAPE ARCH. GLMV ARCHITECTURE, INC MISSOURI CIVIL COA #2018033898 MISSOURI LANDSCAPE COA #000008 9229 WARD PARKWAY, SUITE # 210 KANSAS CITY, MO 64114

STRUCTURAL ENGINEER LEIGH + O'KANE MISSOURI COA #001644 250 NE MURBERRY, SUITE 201 LEE'S SUMMIT, MO, 64086

MECH., ELEC. & PLUMBING ENGINEERS HOSS & BROWN ENGINEERS MISSOURI COA #01022

(913) 362-9090 PHONE SECURITY & IT ENGINEERS HENDERSON ENGINEERS MISSOURI COA # 000556 1801 MAIN STREET, SUITE 300

KANSAS CITY, MO 64108 (816) 663-8700 PHONE

# Description Date
2 ASI 02 11.22.2022


DERICK M.
HOLMES
NUMBER
PE-2022005196


DERICK HOLMES - CIVIL ENGINEER MO# PE-2022005196


PROJECT NO: 18225R21001 10.26.2022

All work herein is the property of GLMV Architecture, Inc. and is not to be copied or used in any way without the express written consent of GLMV Architecture, Inc.

SITE ENLARGEMENTS

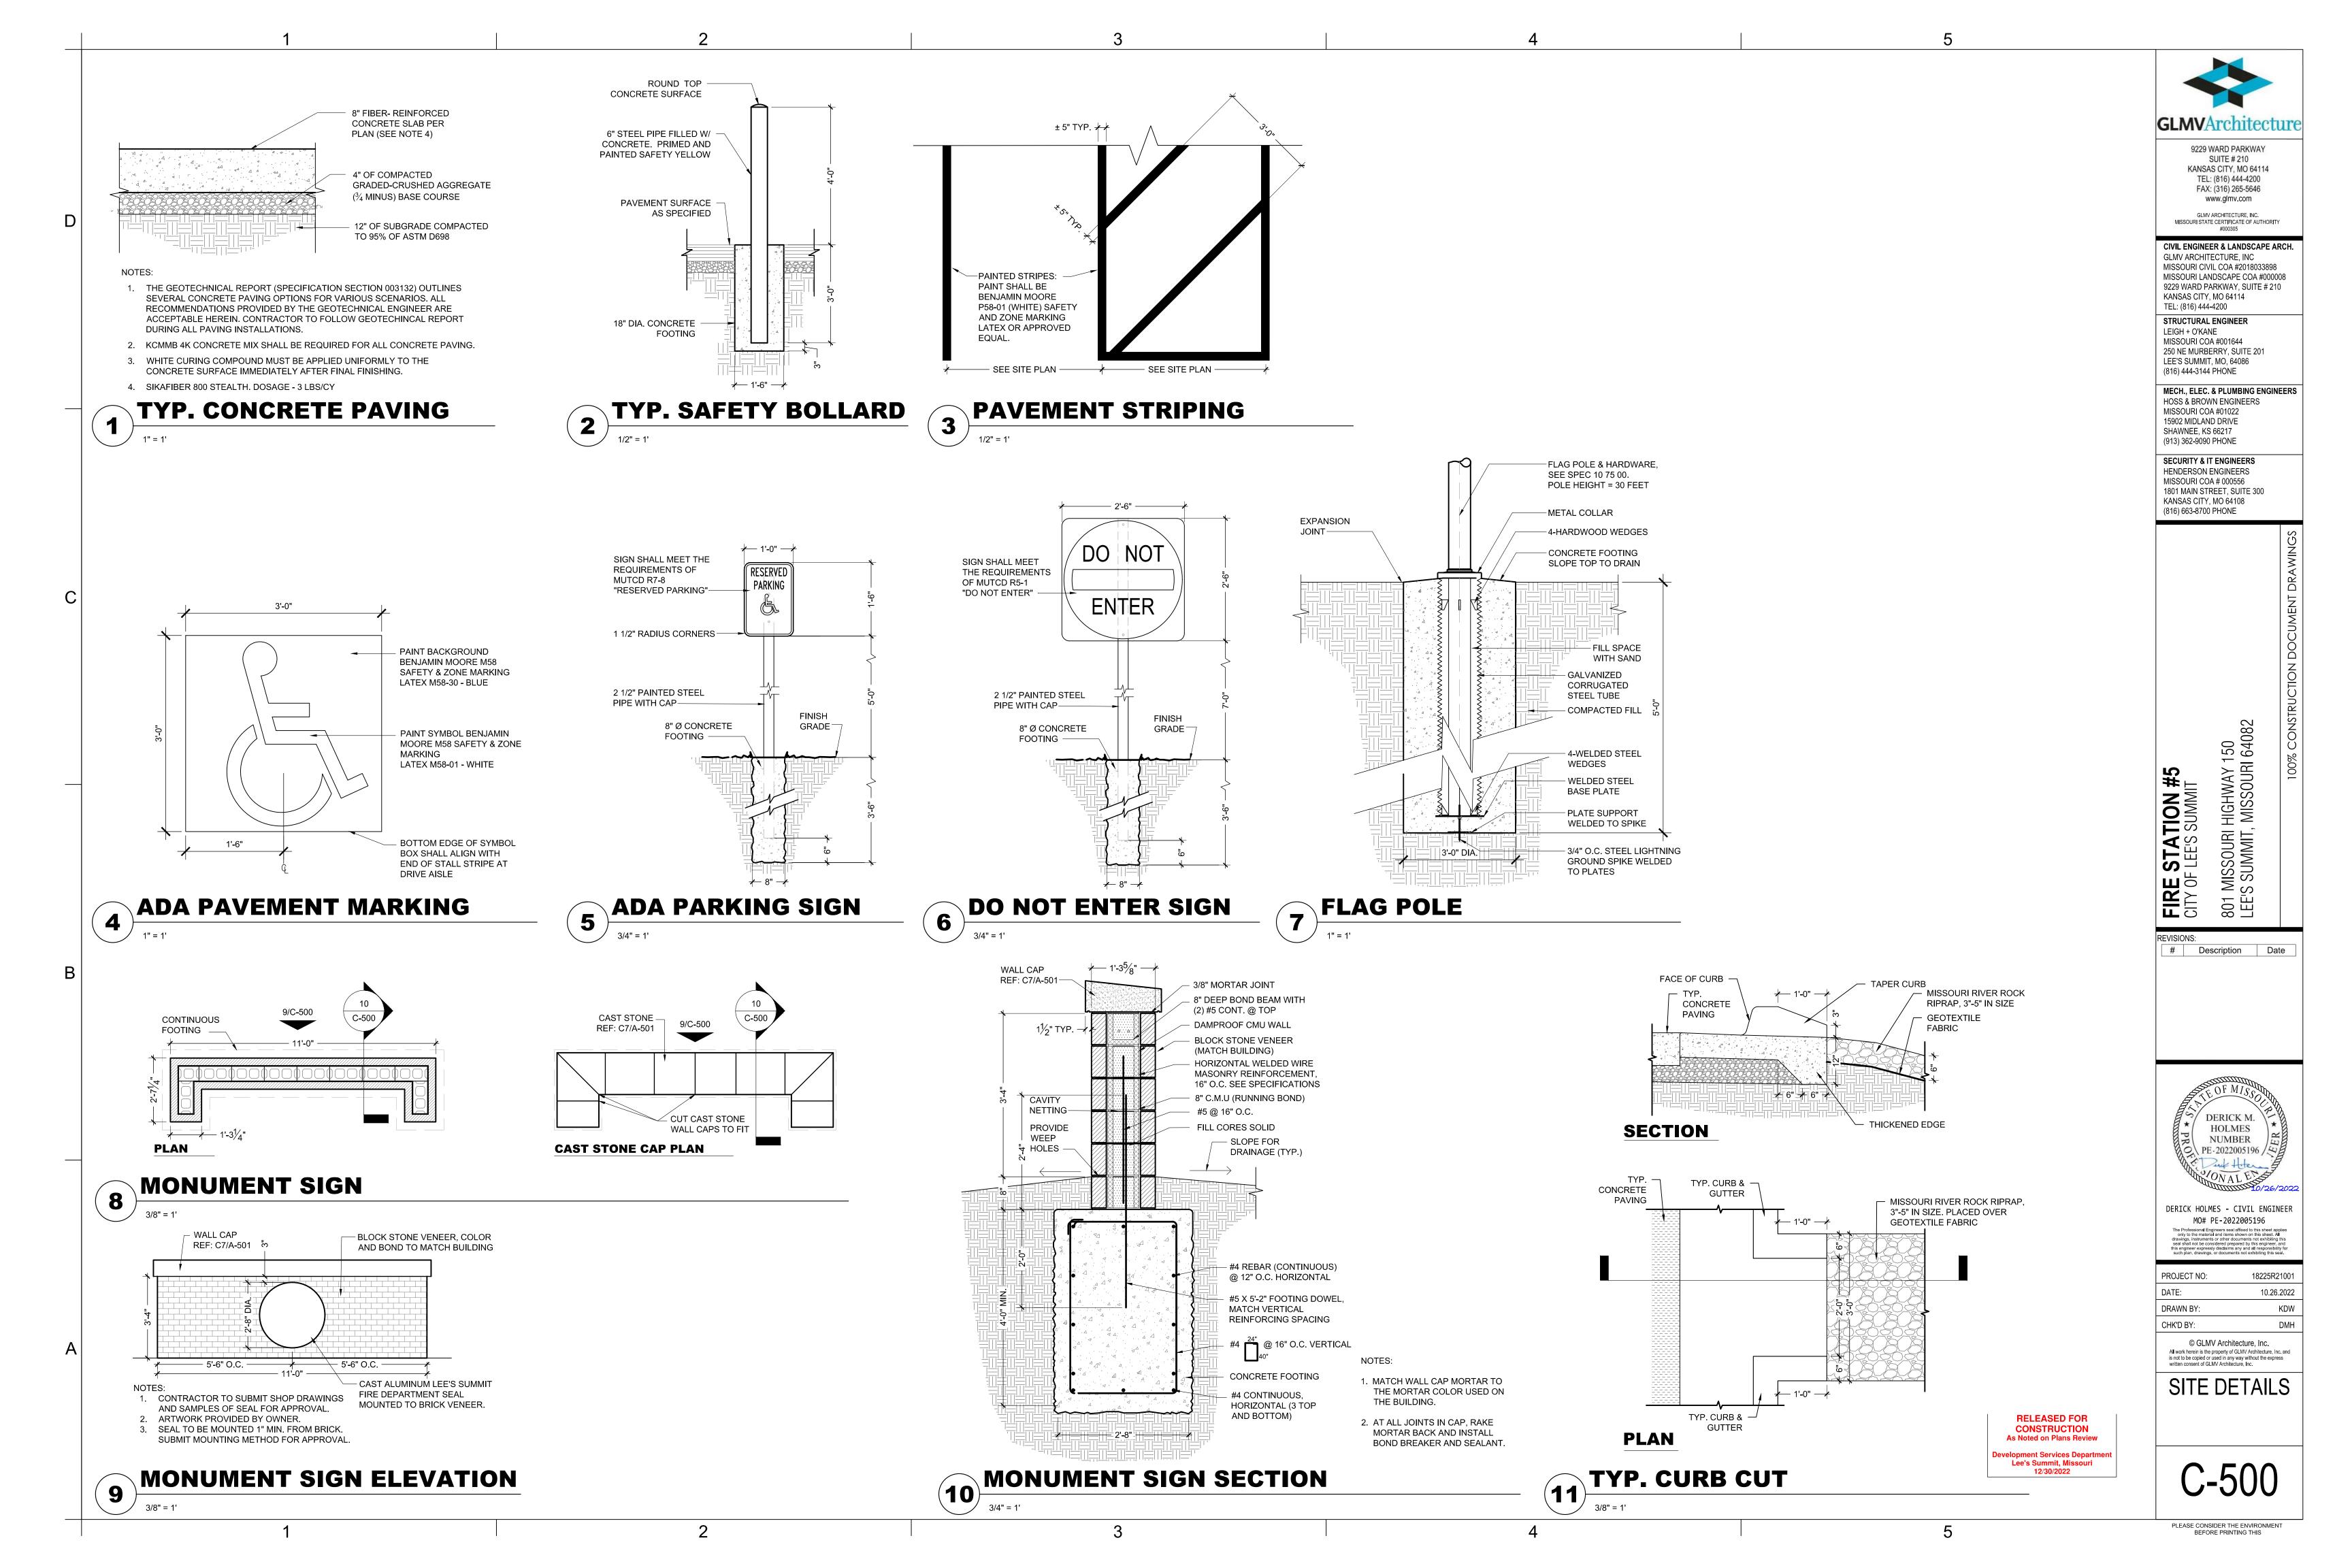

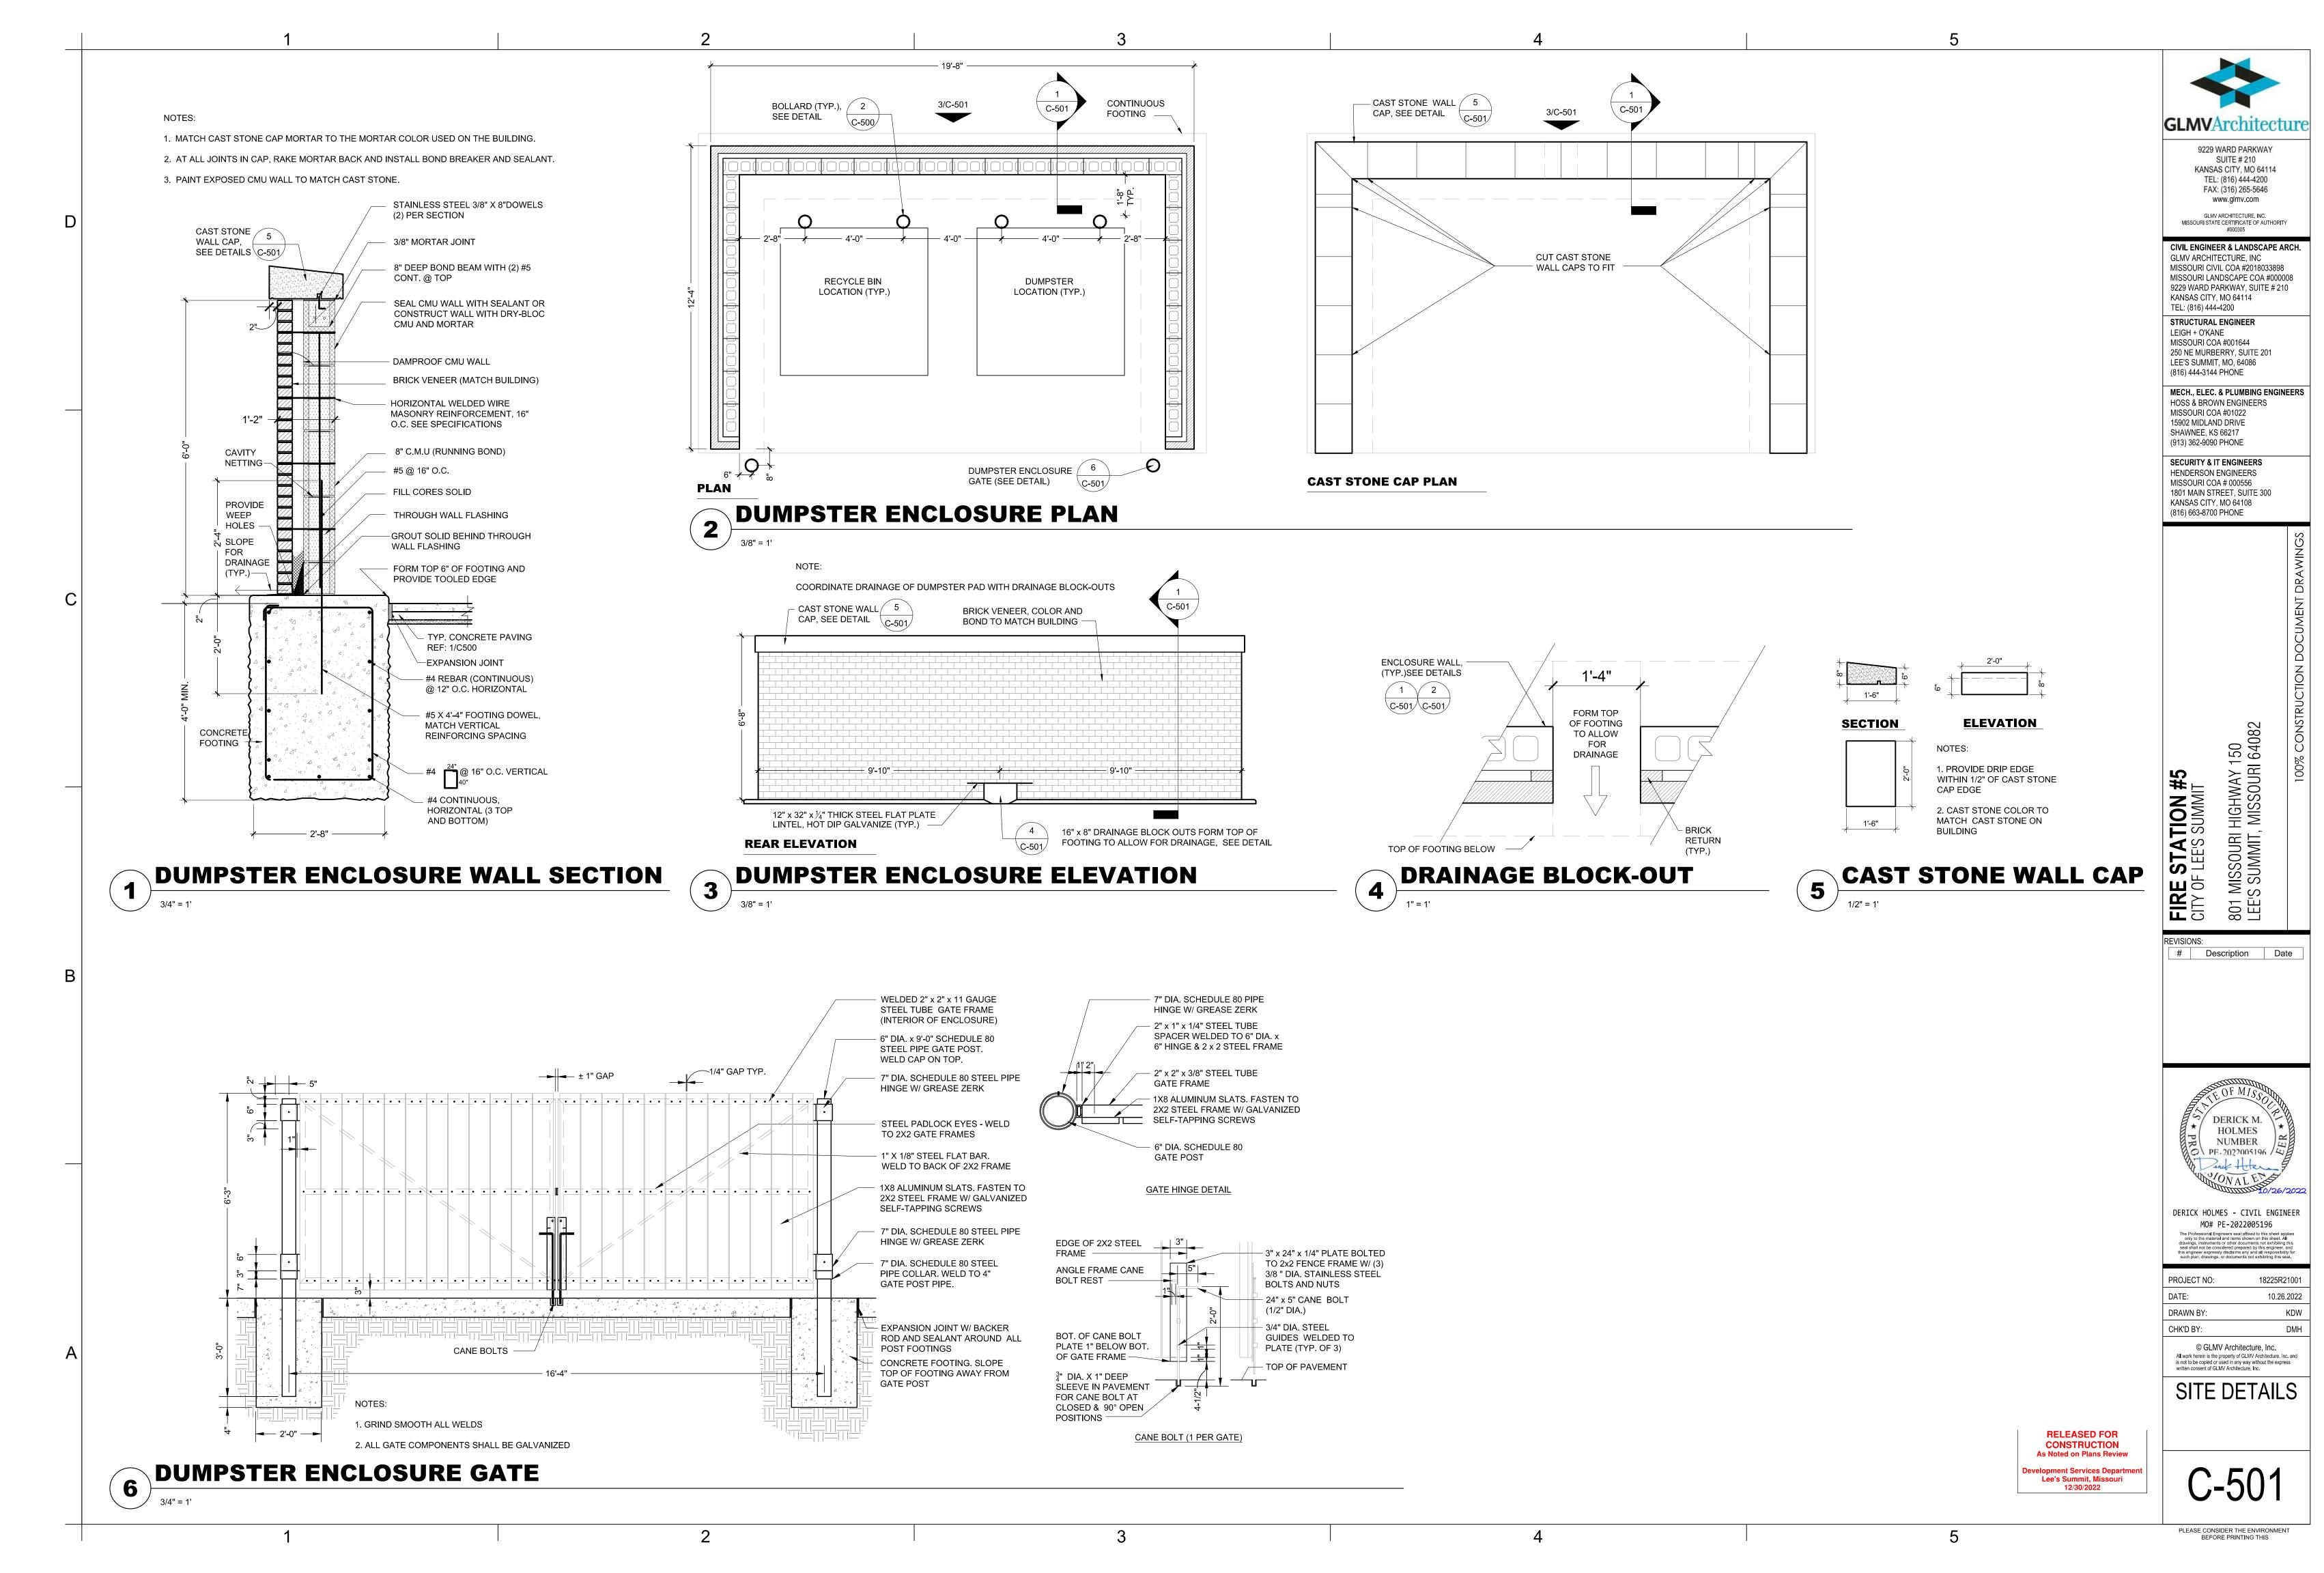

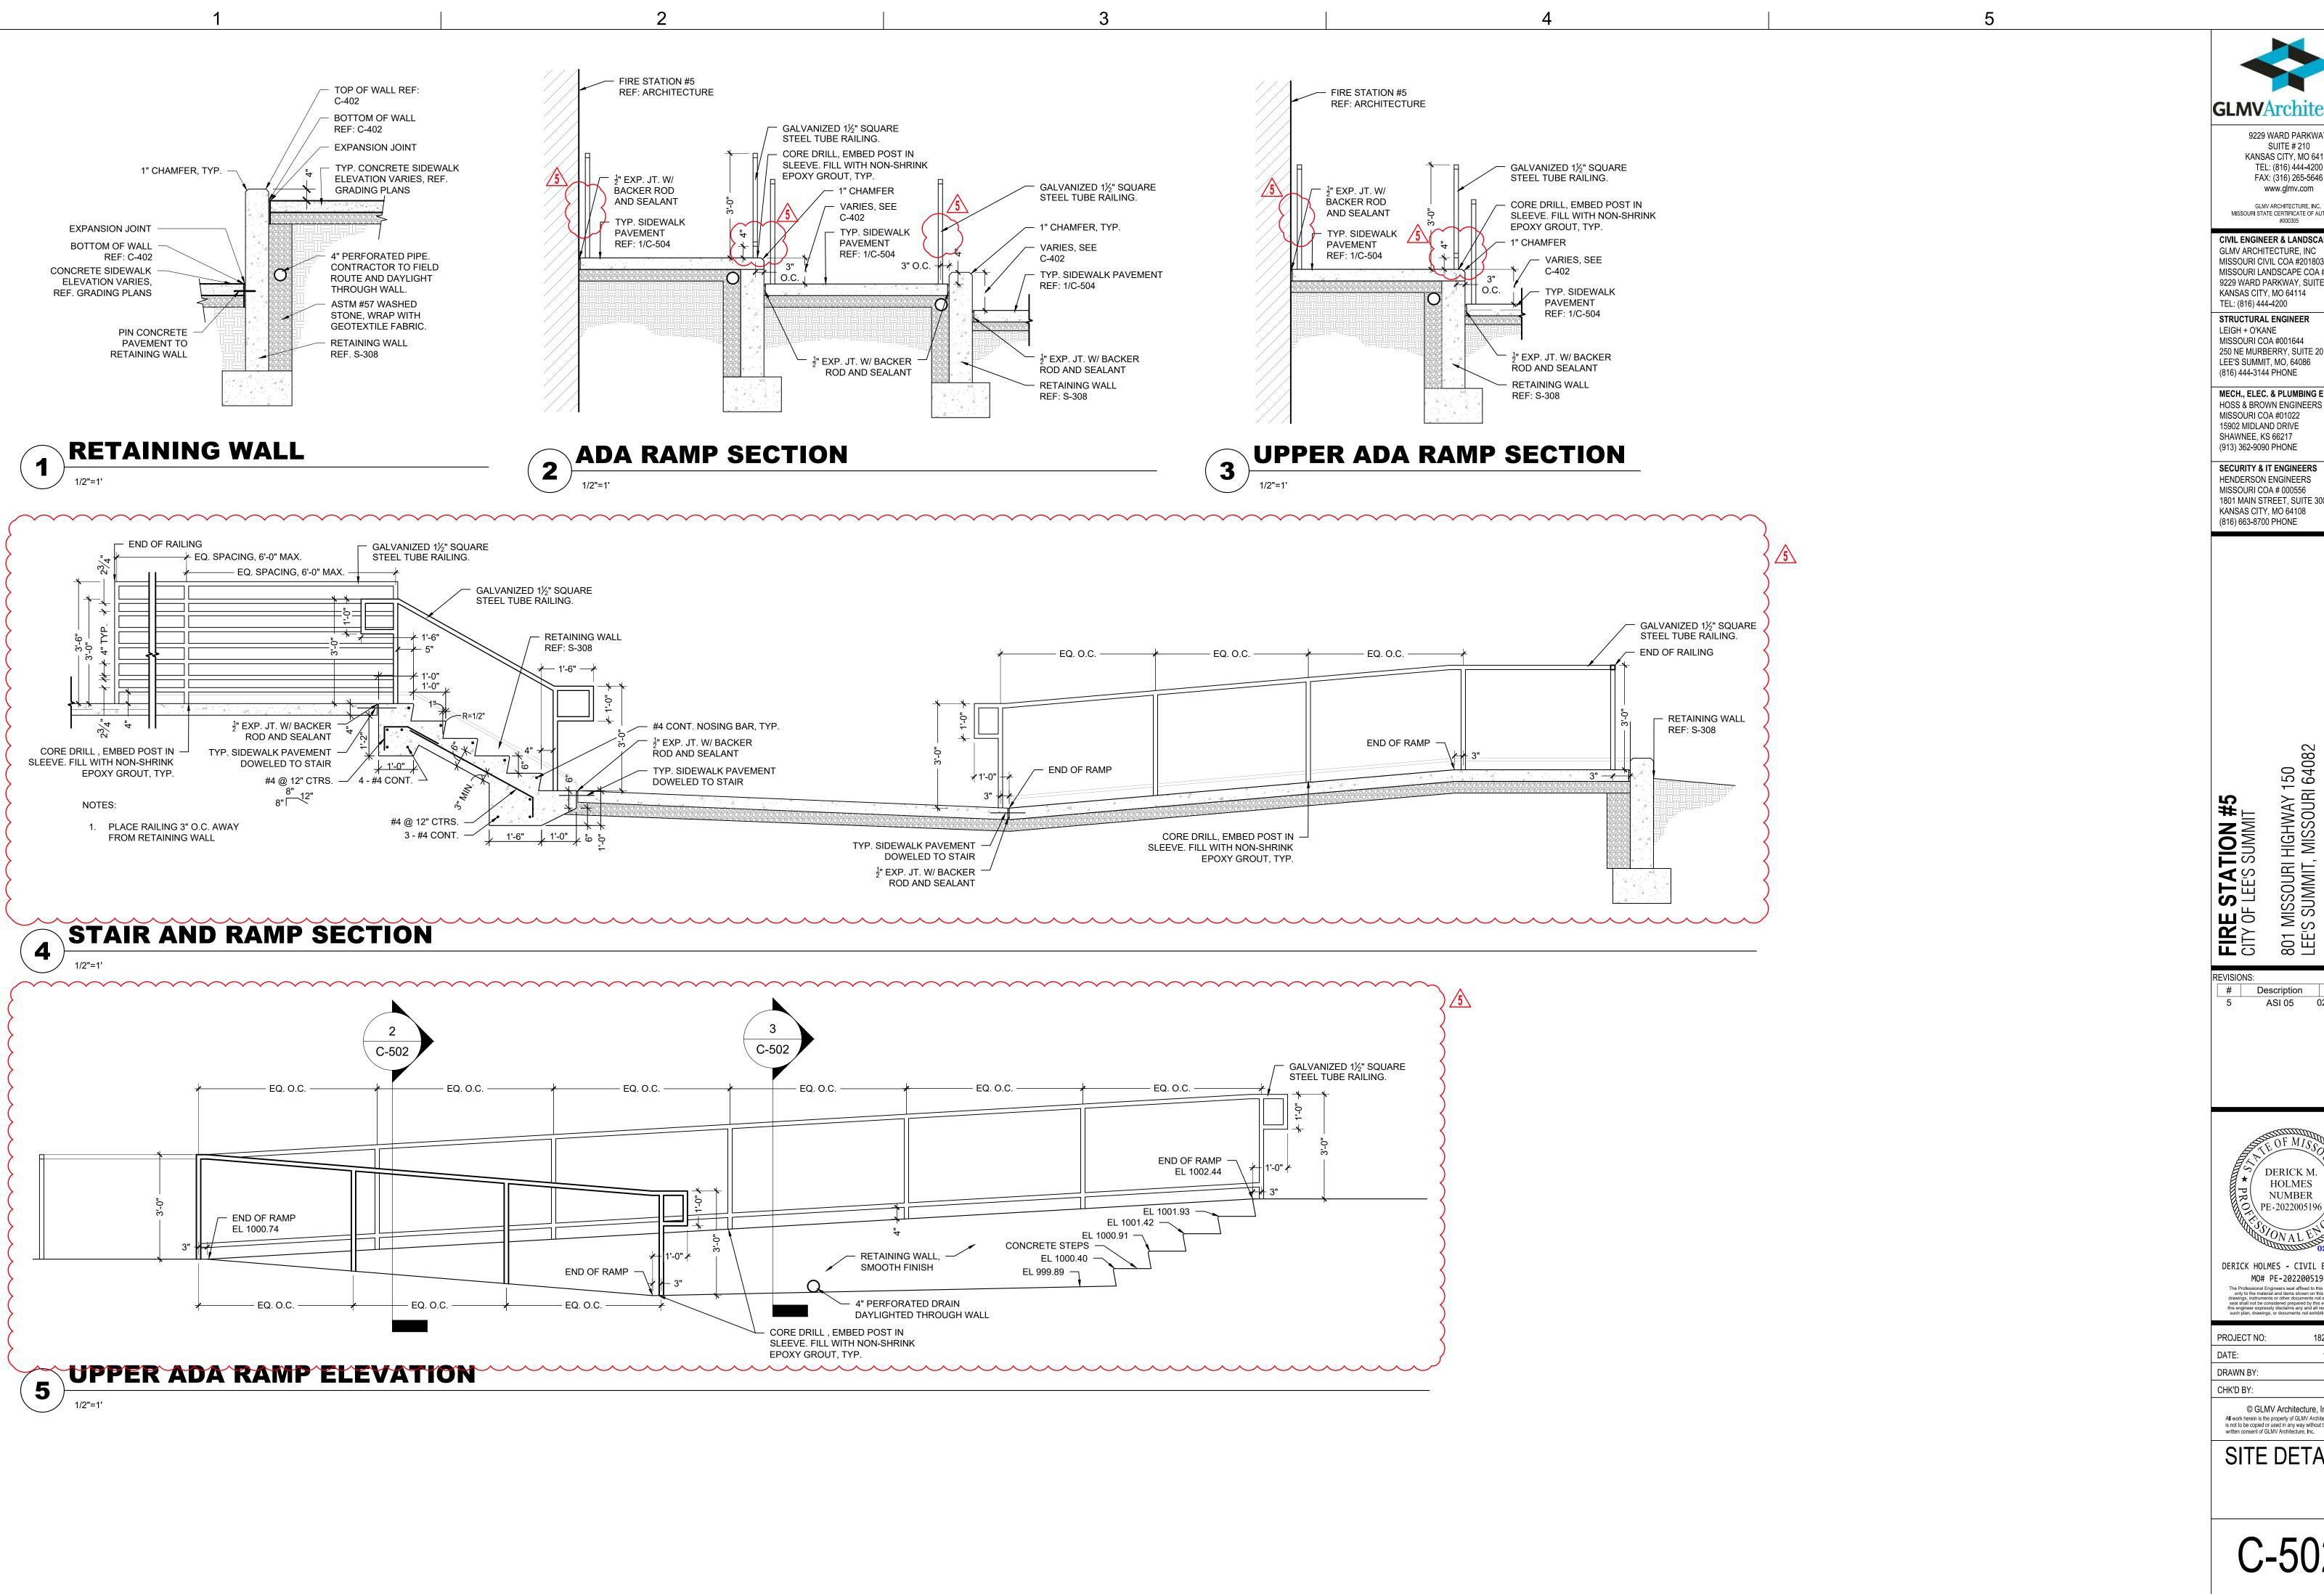

9229 WARD PARKWAY SUITE # 210 KANSAS CITY, MO 64114 TEL: (816) 444-4200 FAX: (316) 265-5646 www.glmv.com

GLMV ARCHITECTURE, INC. MISSOURI STATE CERTIFICATE OF AUTHORITY

CIVIL ENGINEER & LANDSCAPE ARCH. GLMV ARCHITECTURE, INC MISSOURI CIVIL COA #2018033898 MISSOURI LANDSCAPE COA #000008 9229 WARD PARKWAY, SUITE # 210 KANSAS CITY, MO 64114

STRUCTURAL ENGINEER LEIGH + O'KANE MISSOURI COA #001644 250 NE MURBERRY, SUITE 201 LEE'S SUMMIT, MO, 64086

(816) 444-3144 PHONE MECH., ELEC. & PLUMBING ENGINEERS

(913) 362-9090 PHONE SECURITY & IT ENGINEERS HENDERSON ENGINEERS MISSOURI COA # 000556 1801 MAIN STREET, SUITE 300

# Description Date 5 ASI 05 02.08.2023

HOLMES NUMBER PE-2022005196 /

DERICK HOLMES - CIVIL ENGINEER MO# PE-2022005196


18225R21001


10.26.2022 KDW DMH


© GLMV Architecture, Inc. All work herein is the property of GLMV Architecture. Inc. and is not to be copied or used in any way without the express written consent of GLMV Architecture, Inc.


SITE DETAILS

PLEASE CONSIDER THE ENVIRONMENT BEFORE PRINTING THIS

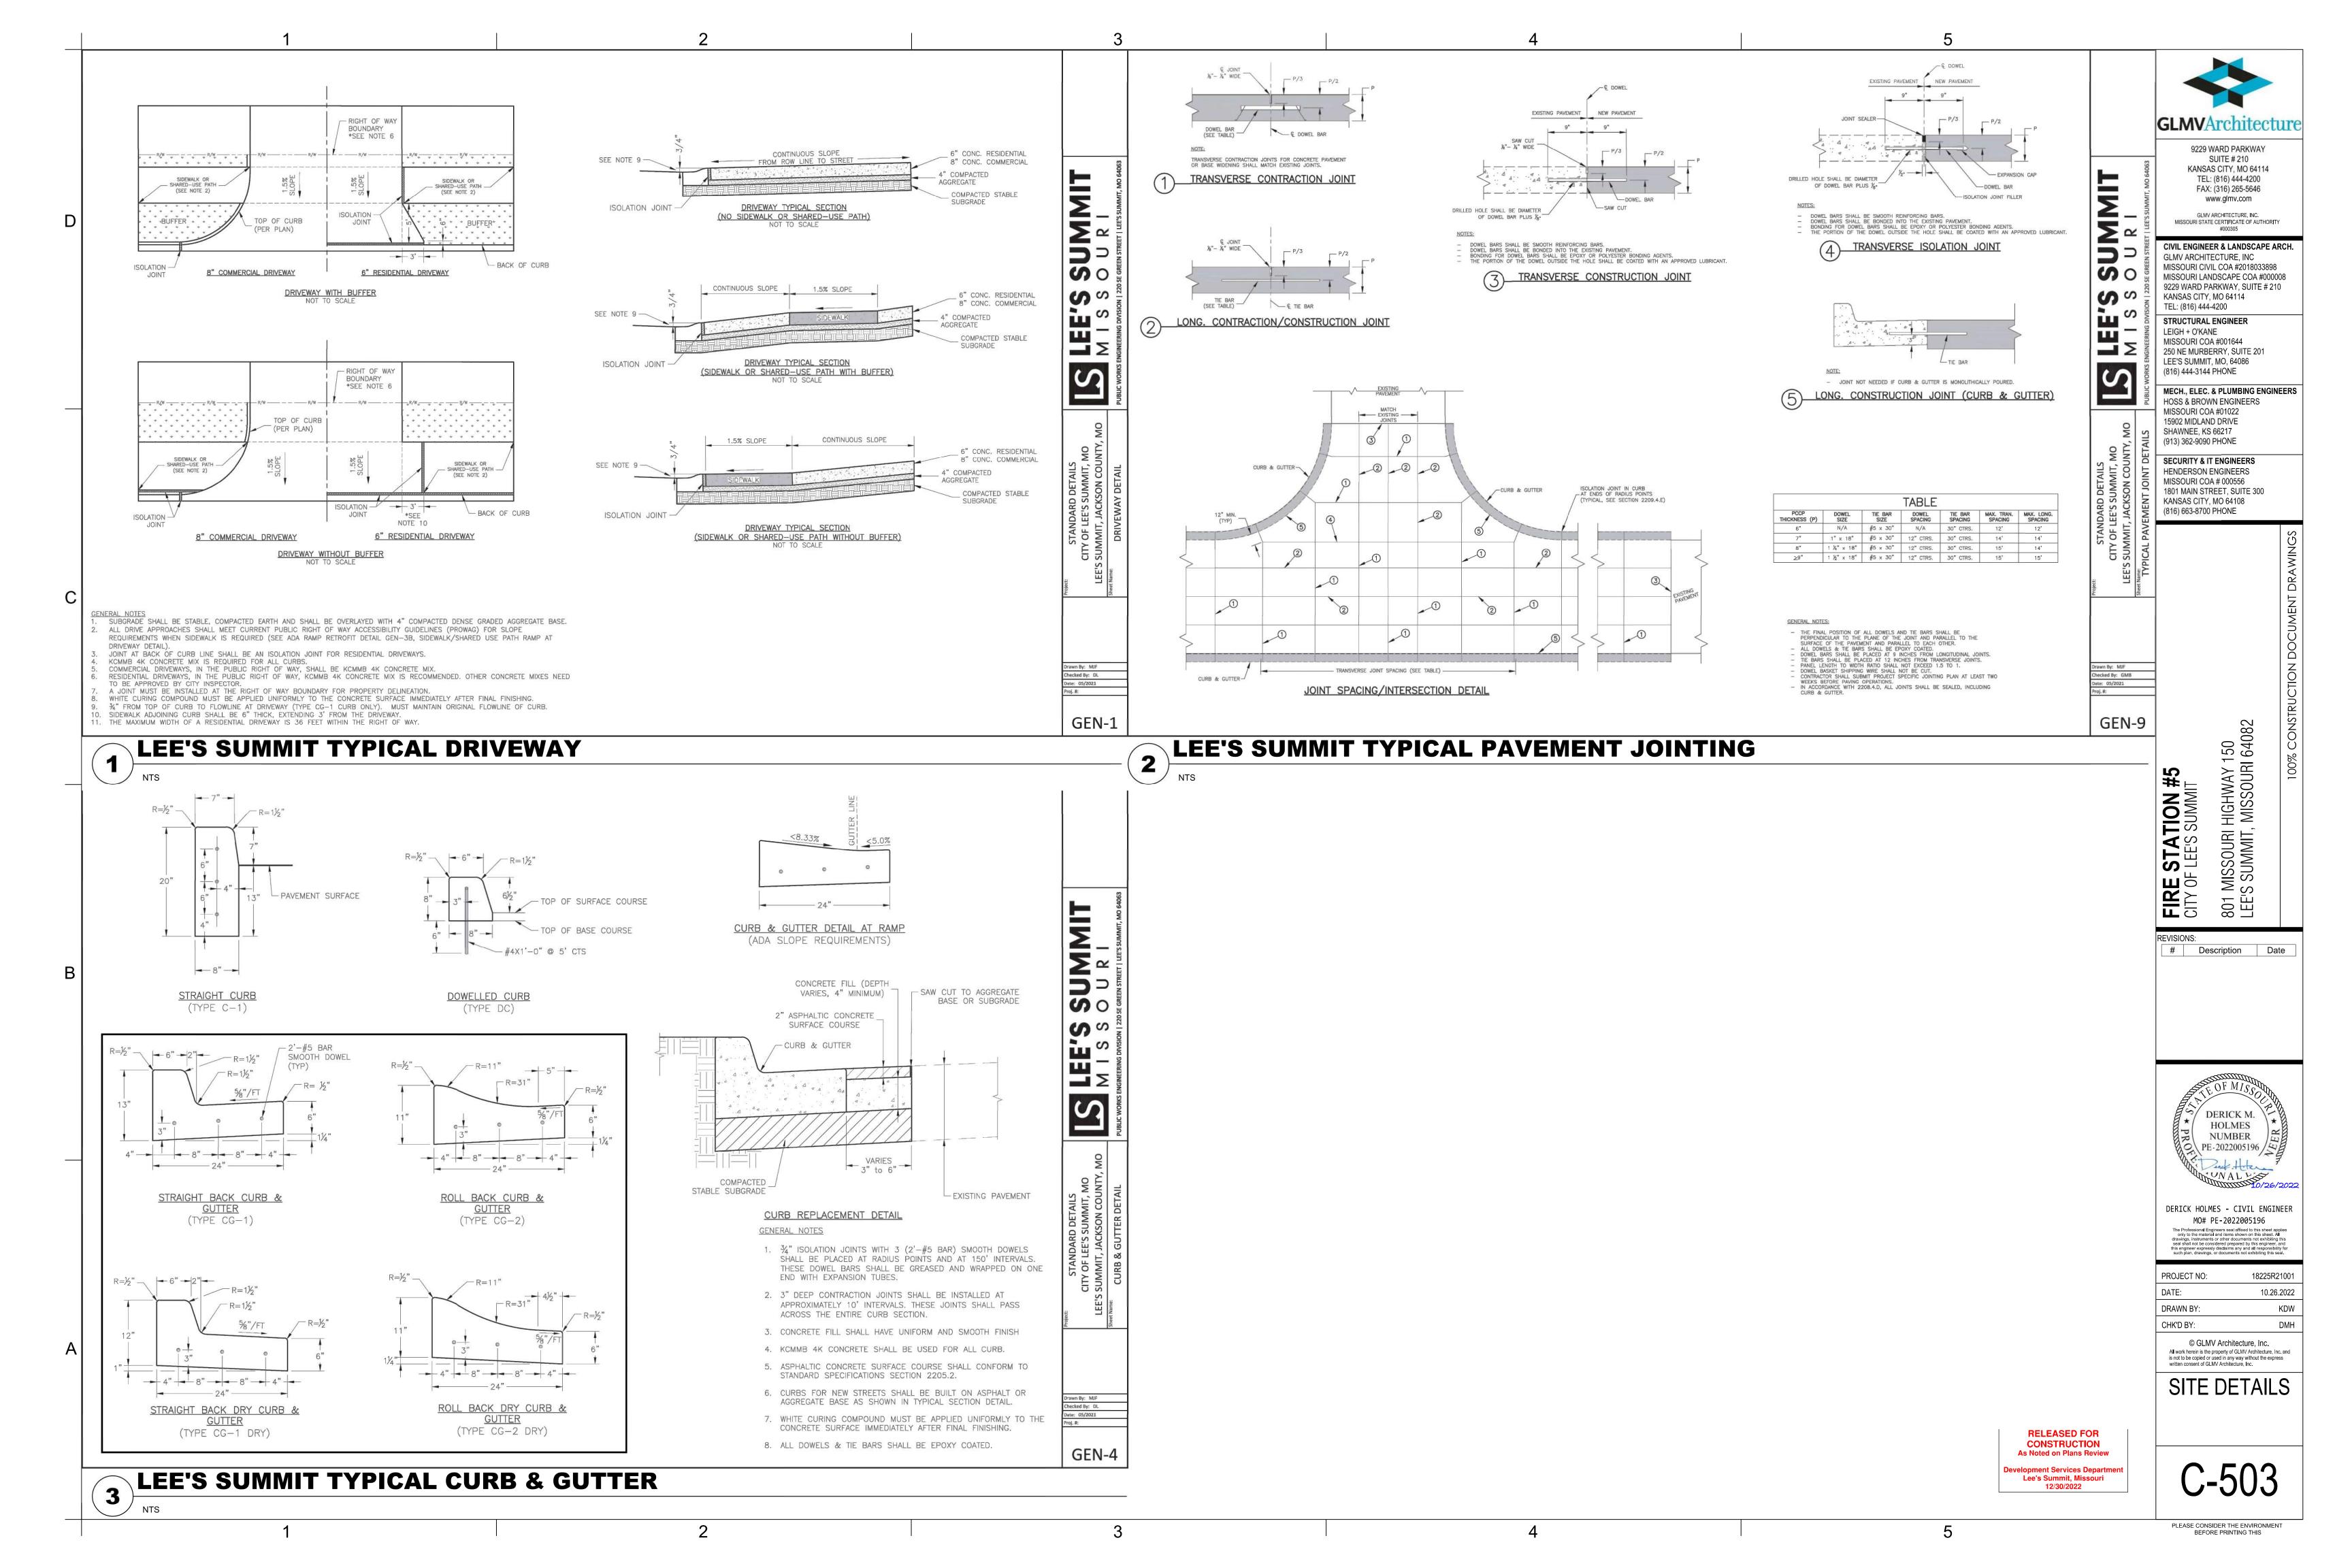


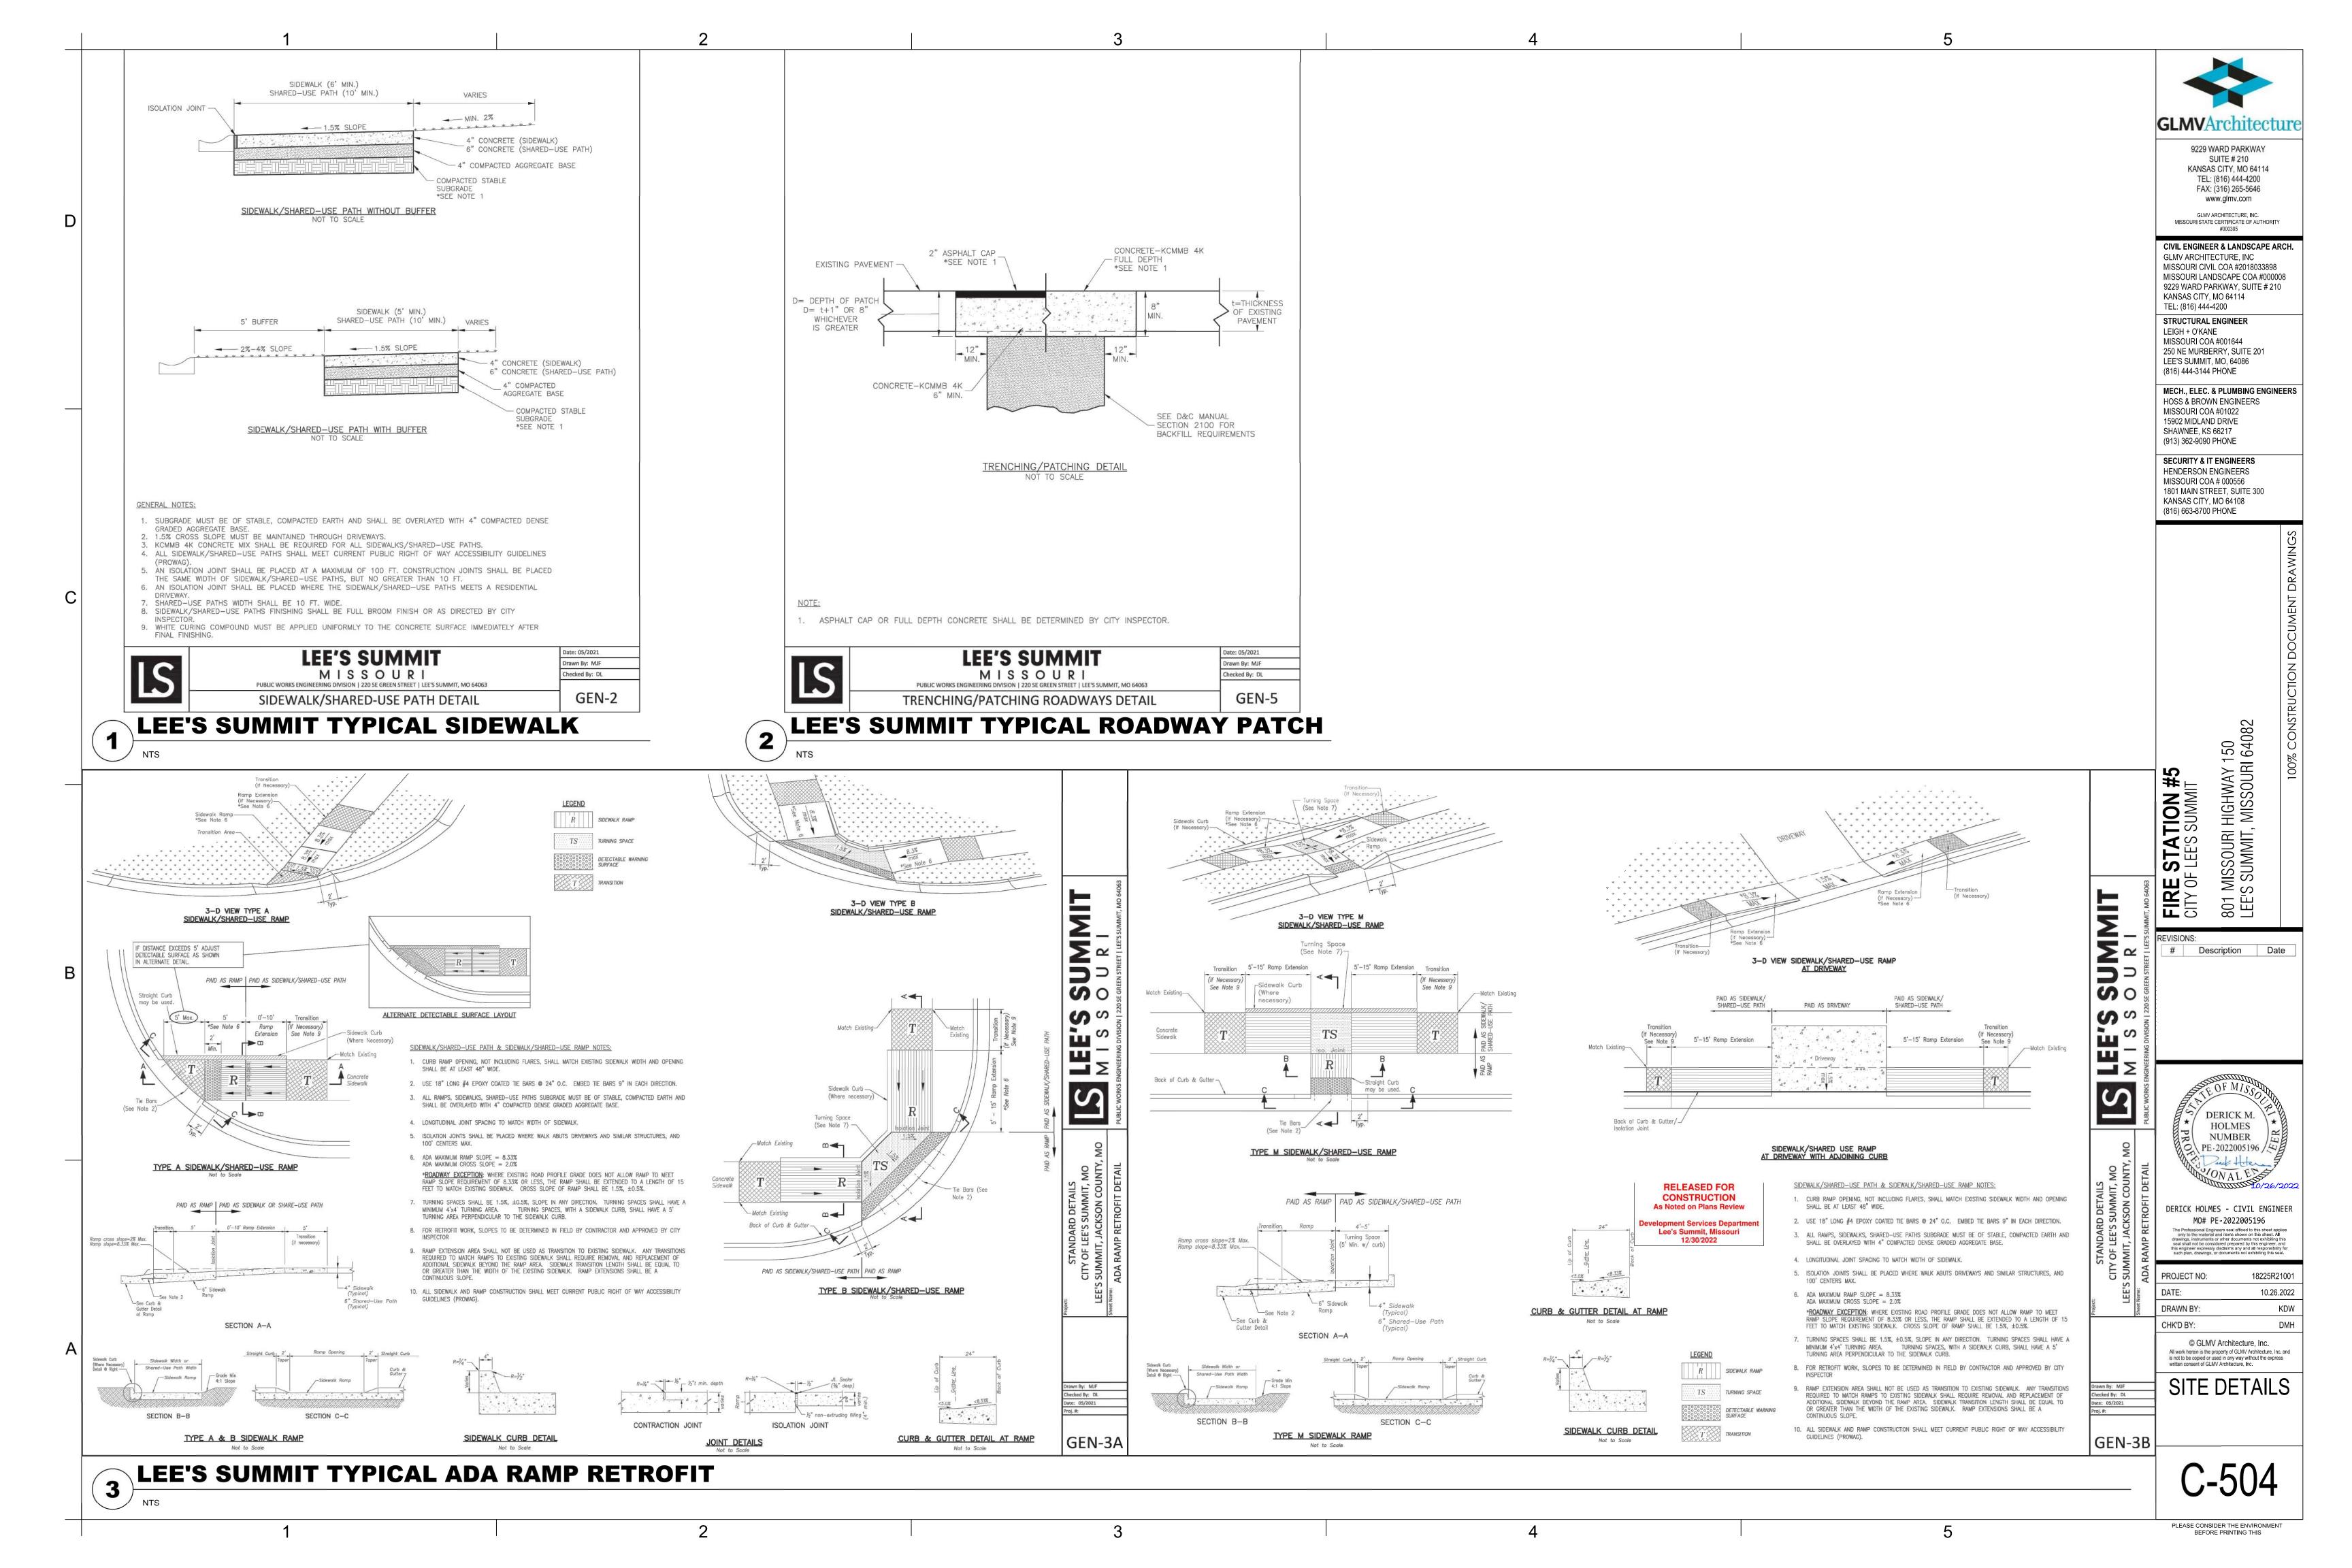


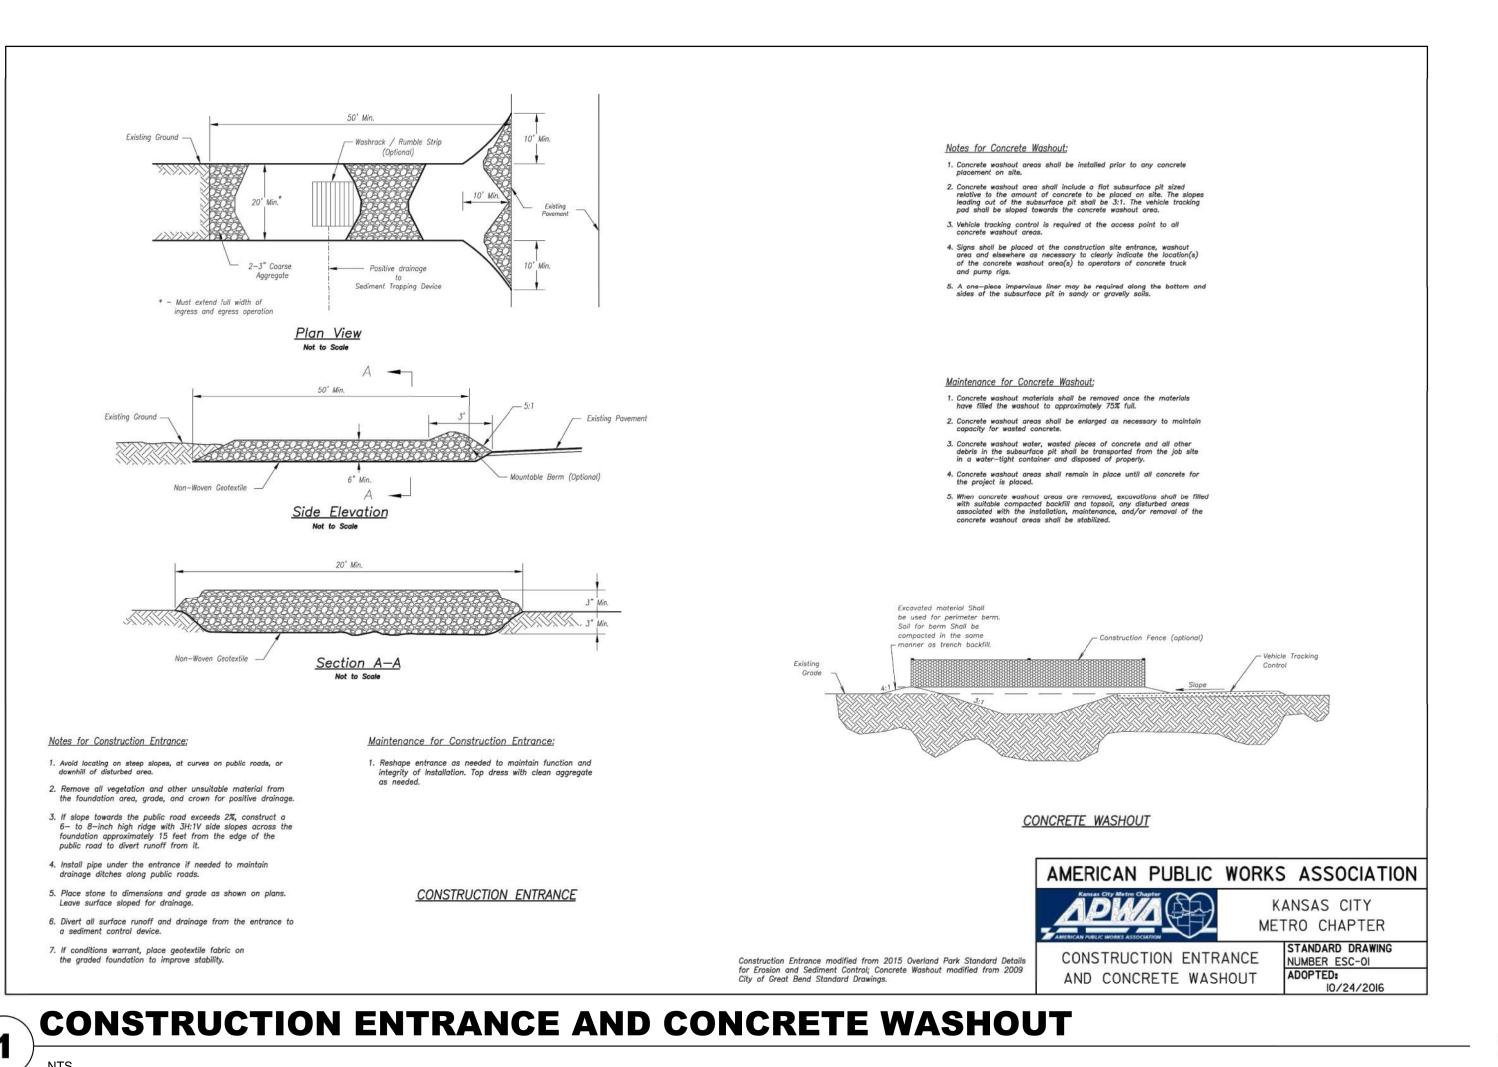

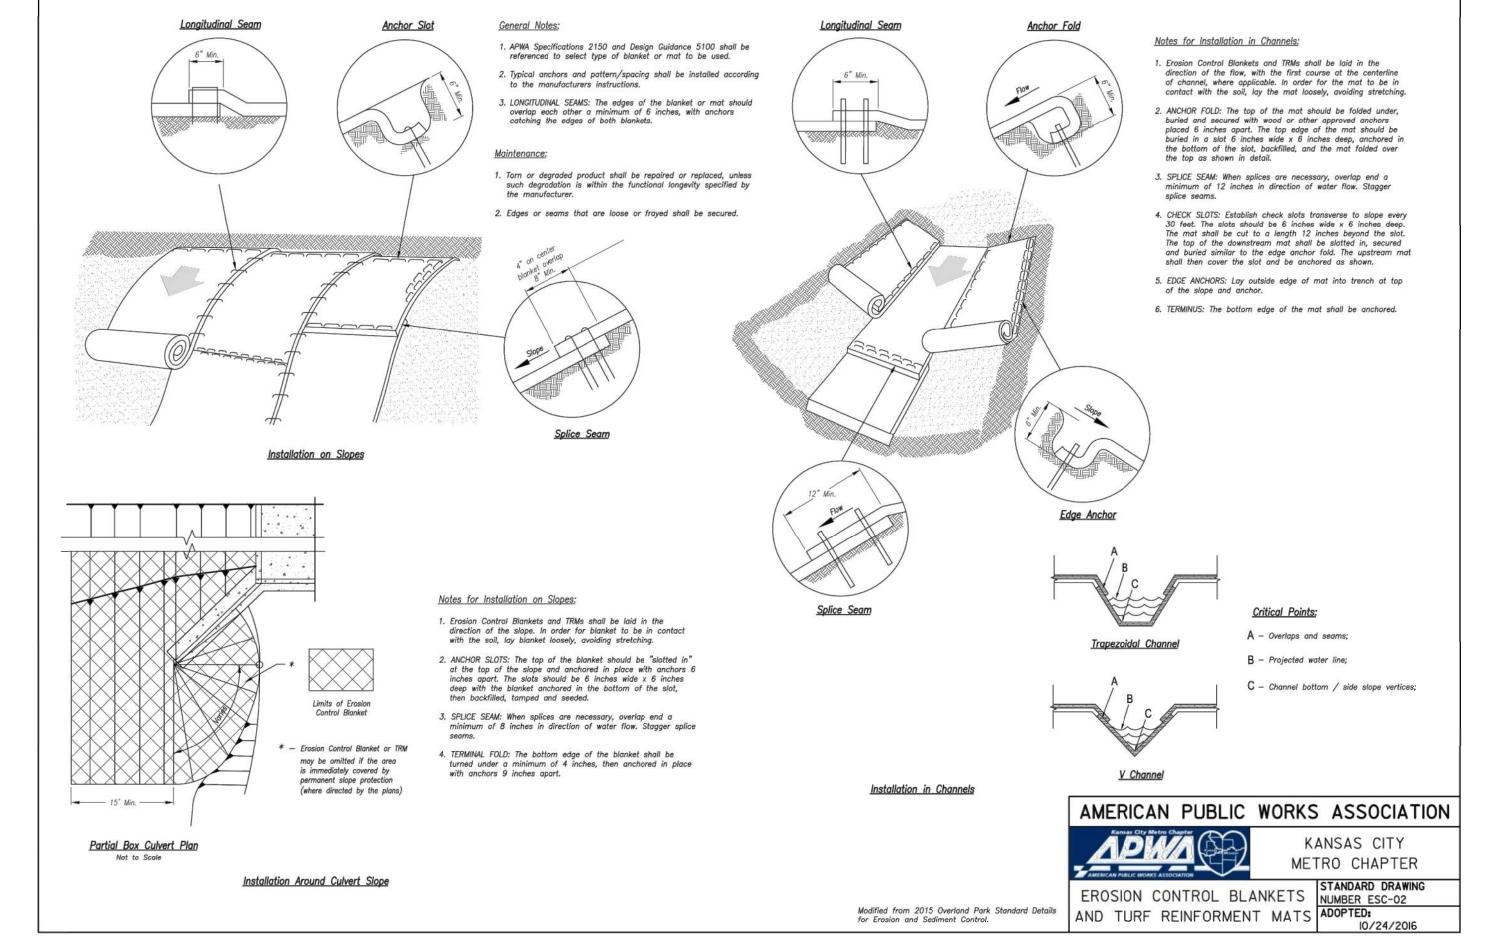

EROSION CONTROL BLANKETS AND TURF REINFORCEMENT MATS

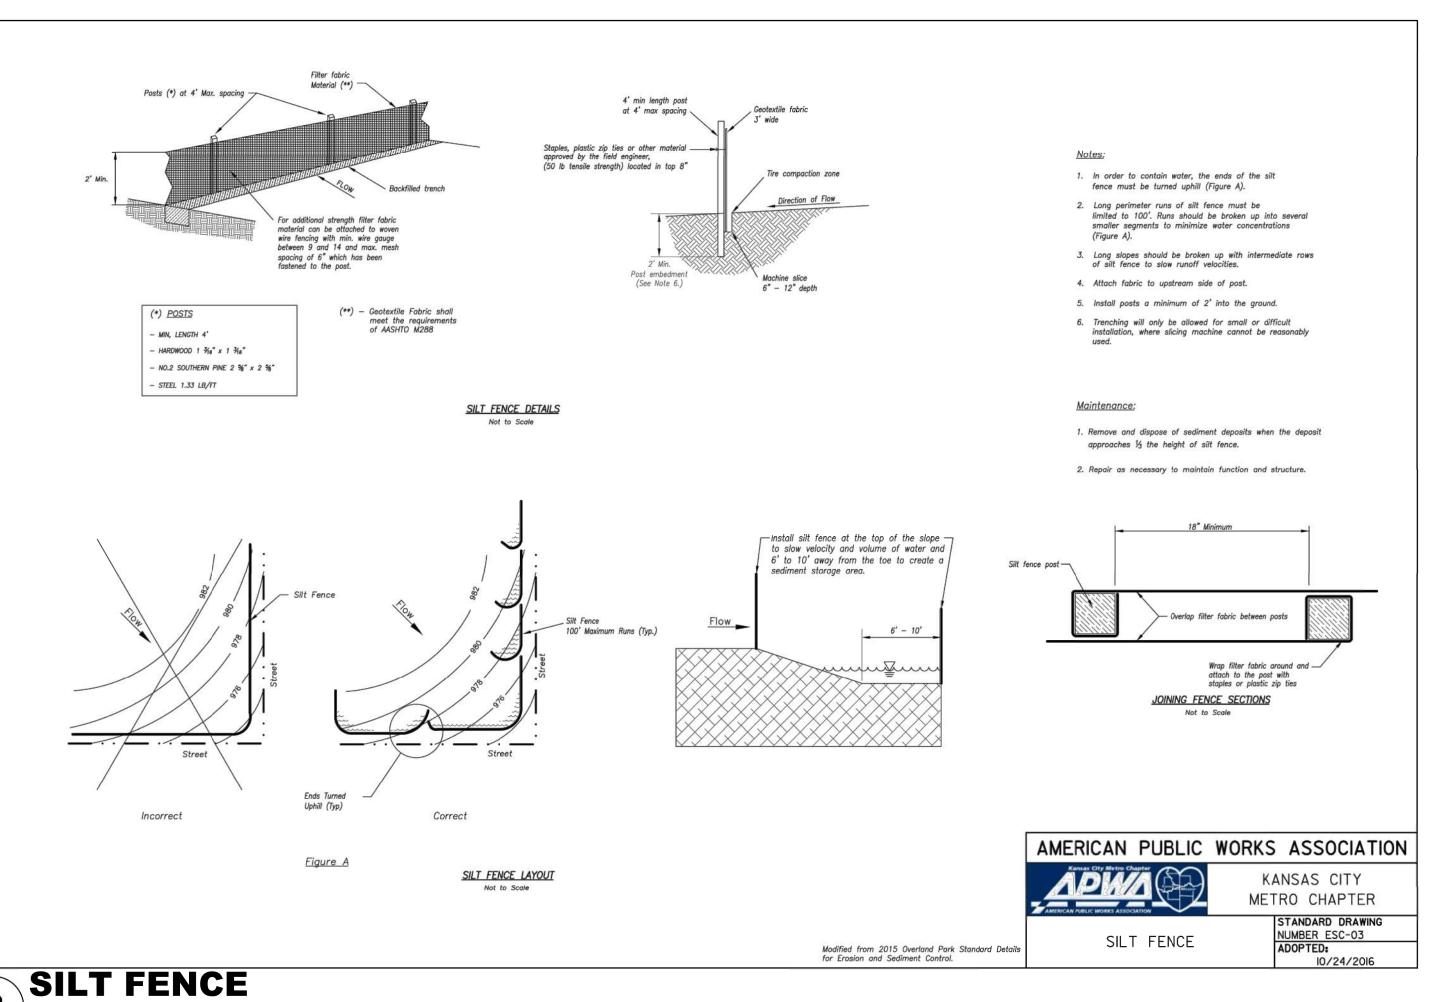

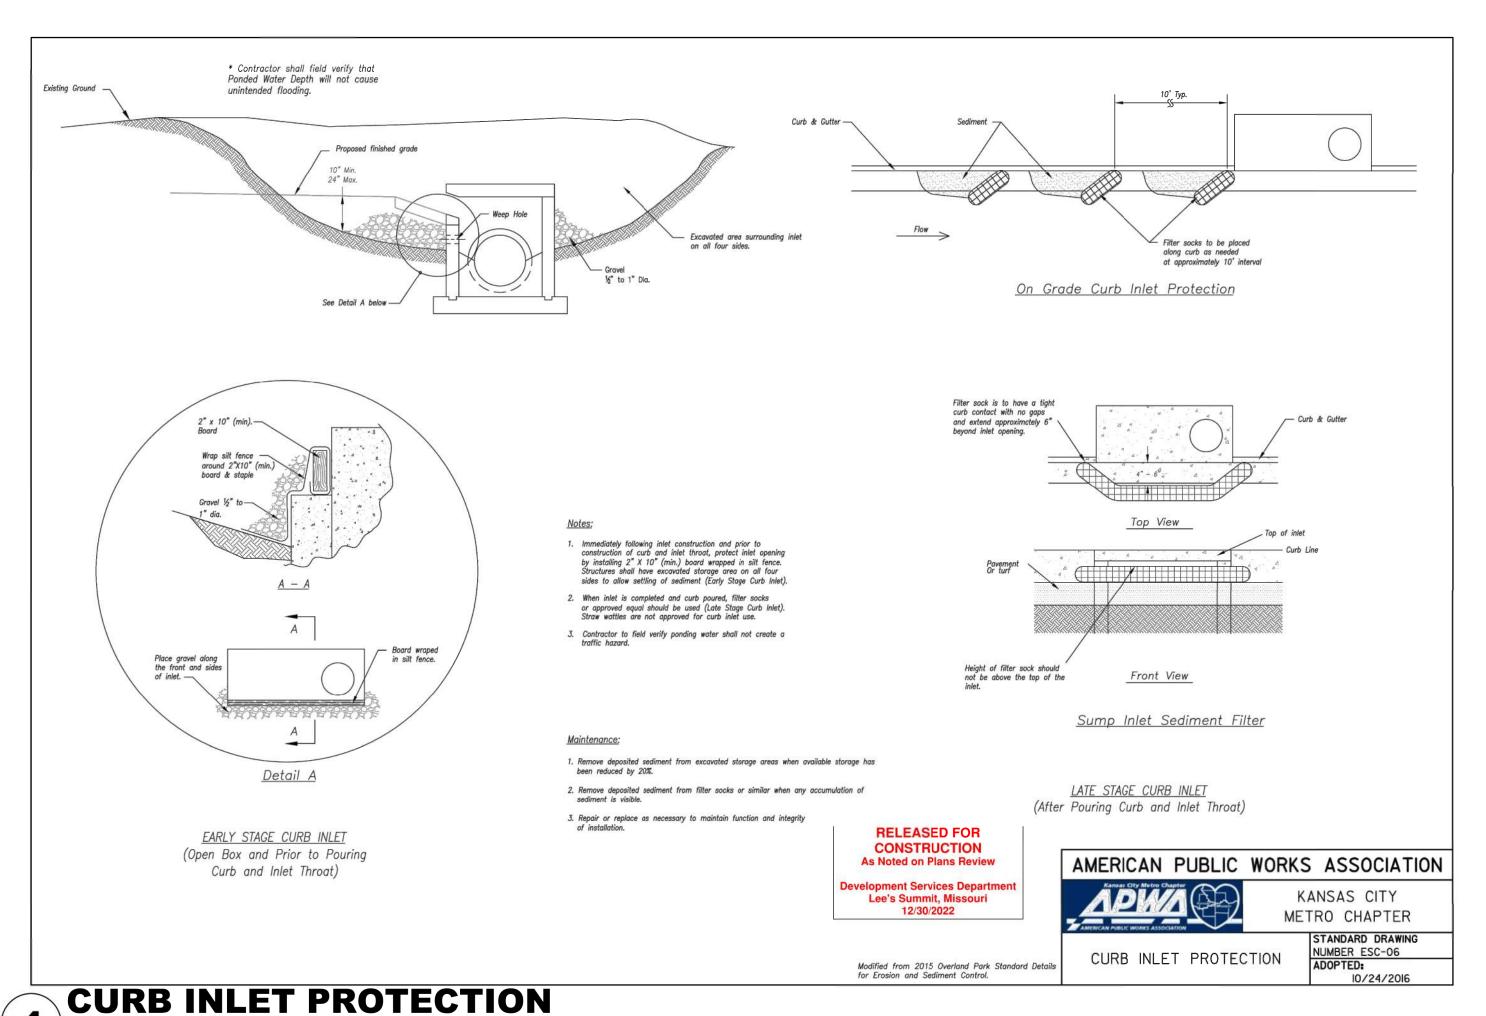

**GLMV**Architecture 9229 WARD PARKWAY SUITE # 210 KANSAS CITY, MO 64114 TEL: (816) 444-4200 FAX: (316) 265-5646 www.glmv.com MISSOURI STATE CERTIFICATE OF AUTHORITY CIVIL ENGINEER & LANDSCAPE ARCH. GLMV ARCHITECTURE, INC MISSOURI CIVIL COA #2018033898 MISSOURI LANDSCAPE COA #000008 9229 WARD PARKWAY, SUITE # 210 KANSAS CITY, MO 64114 TEL: (816) 444-4200 MECH., ELEC. & PLUMBING ENGINEERS

STRUCTURAL ENGINEER LEIGH + O'KANE MISSOURI COA #001644 250 NE MURBERRY, SUITE 201 LEE'S SUMMIT, MO, 64086 (816) 444-3144 PHONE

HOSS & BROWN ENGINEERS MISSOURI COA #01022 15902 MIDLAND DRIVE SHAWNEE, KS 66217 (913) 362-9090 PHONE

SECURITY & IT ENGINEERS HENDERSON ENGINEERS MISSOURI COA # 000556 1801 MAIN STREET, SUITE 300 KANSAS CITY, MO 64108 (816) 663-8700 PHONE

|REVISIONS: # Description


> DERICK M. **HOLMES NUMBER** PE-2022005196 /A

DERICK HOLMES - CIVIL ENGINEER MO# PE-2022005196 The Professional Engineers seal affixed to this sheet applic only to the material and items shown on this sheet. All

PROJECT NO: 18225R21001 DATE: 10.26.2022 DRAWN BY: SJB CHK'D BY: DMH

© GLMV Architecture, Inc. All work herein is the property of GLMV Architecture. Inc. and is not to be copied or used in any way without the express written consent of GLMV Architecture, Inc.

**EROSION CONTROL** 

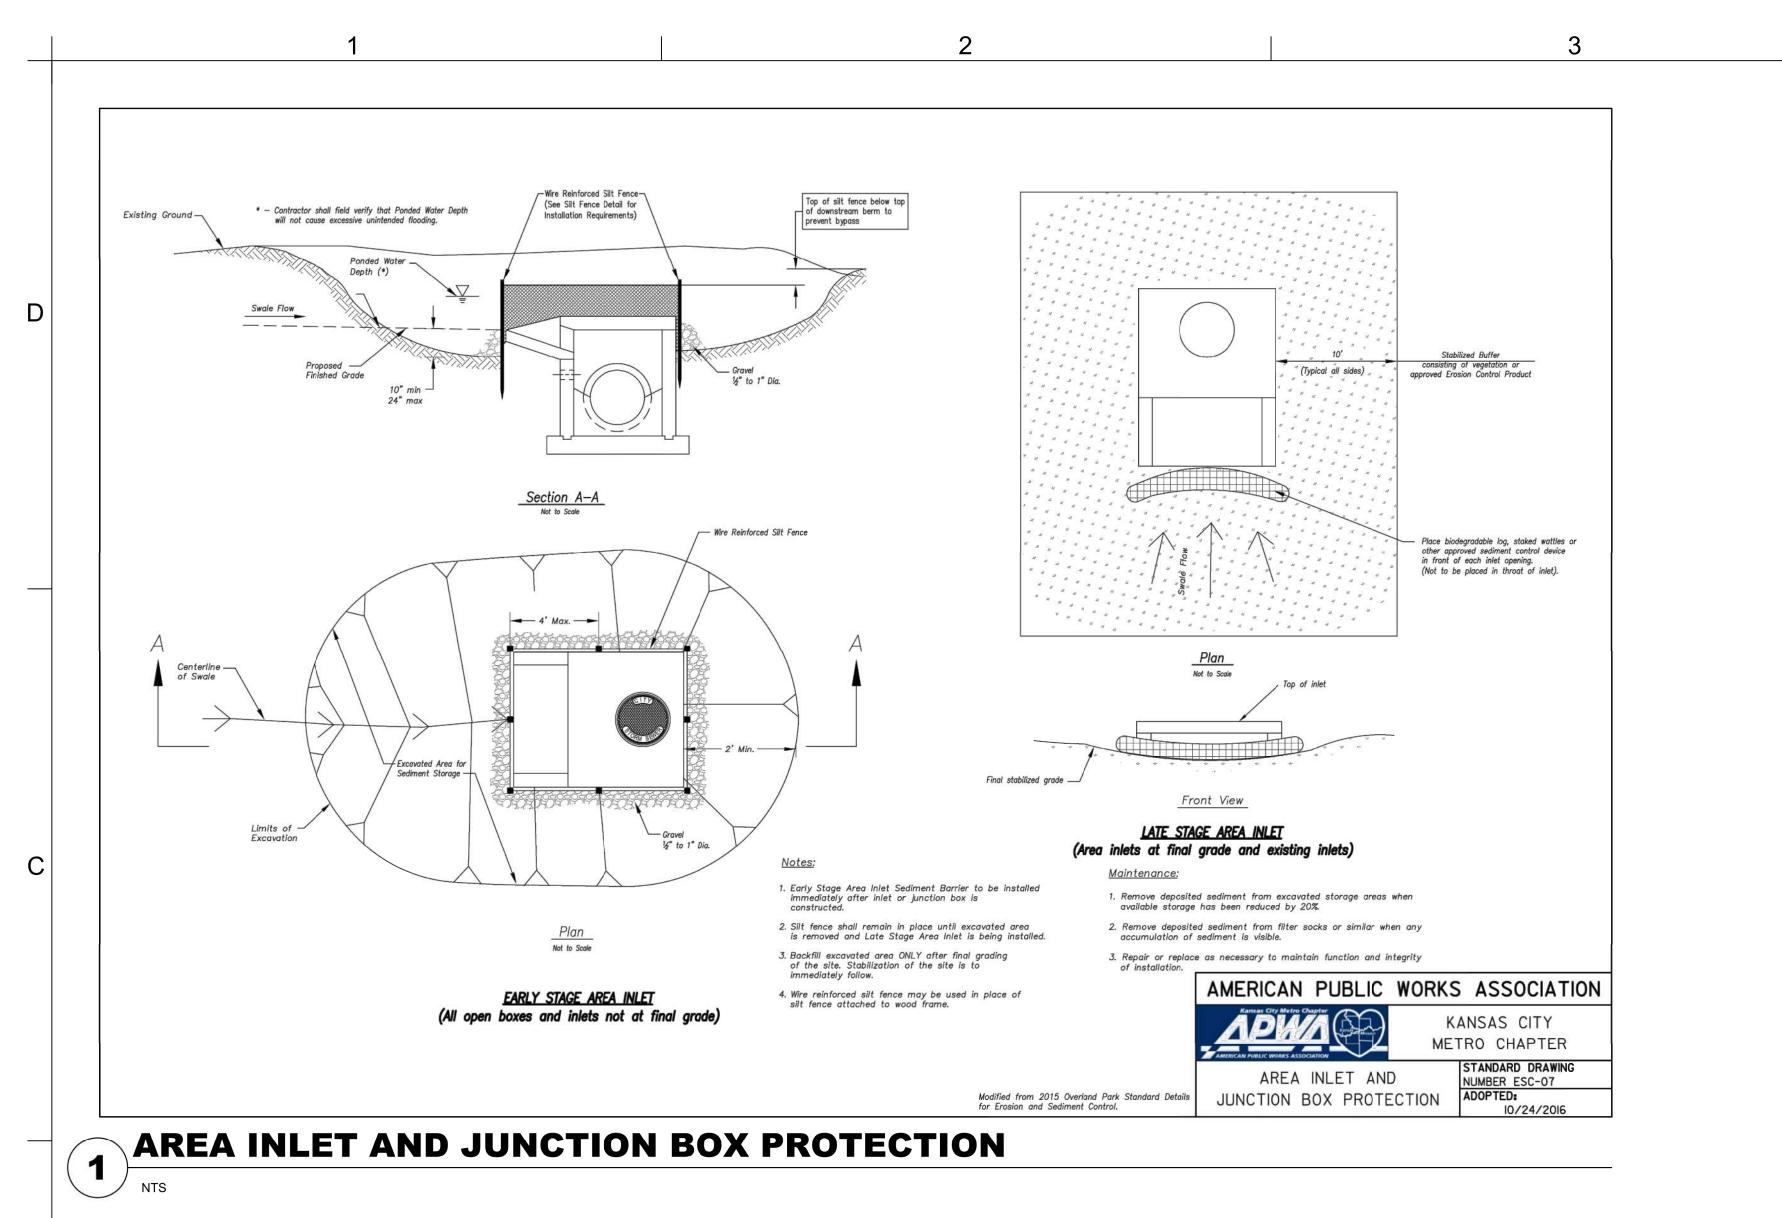

9229 WARD PARKWAY SUITE # 210 KANSAS CITY, MO 64114 TEL: (816) 444-4200 FAX: (316) 265-5646 www.glmv.com

GLMV ARCHITECTURE, INC. MISSOURI STATE CERTIFICATE OF AUTHORITY #000305

CIVIL ENGINEER & LANDSCAPE ARCH. GLMV ARCHITECTURE, INC MISSOURI CIVIL COA #2018033898 MISSOURI LANDSCAPE COA #000008 9229 WARD PARKWAY, SUITE # 210 KANSAS CITY, MO 64114 TEL: (816) 444-4200

STRUCTURAL ENGINEER LEIGH + O'KANE MISSOURI COA #001644 250 NE MURBERRY, SUITE 201 LEE'S SUMMIT, MO, 64086

MISSOURI COA #01022 15902 MIDLAND DRIVE

KANSAS CITY, MO 64108 (816) 663-8700 PHONE

(816) 444-3144 PHONE MECH., ELEC. & PLUMBING ENGINEERS HOSS & BROWN ENGINEERS

SHAWNEE, KS 66217 (913) 362-9090 PHONE SECURITY & IT ENGINEERS HENDERSON ENGINEERS MISSOURI COA # 000556 1801 MAIN STREET, SUITE 300

FIRE STATION #5 CITY OF LEE'S SUMMIT

REVISIONS: # Description Date

> DERICK M. HOLMES NUMBER PE-2022005196 UNAL E 55

DERICK HOLMES - CIVIL ENGINEER MO# PE-2022005196 The Professional Engineers seal affixed to this sheet applies only to the material and items shown on this sheet. All drawings, instruments or other documents not exhibiting this seal shall not be considered prepared by this engineer, and this engineer expressly discladims any and all responsibility for such plan, drawings, or documents not exhibiting this seal.

PROJECT NO: 18225R21001 DATE: 10.26.2022 DRAWN BY: SJB

CHK'D BY: DMH © GLMV Architecture, Inc.

AI work herein is the property of GLMV Architecture, Inc. and is not to be copied or used in any way without the express written consent of GLMV Architecture, Inc.


EROSION


CONTROL

**RELEASED FOR** CONSTRUCTION As Noted on Plans Review


Development Services Departmen Lee's Summit, Missouri 12/30/2022


PLEASE CONSIDER THE ENVIRONMENT BEFORE PRINTING THIS

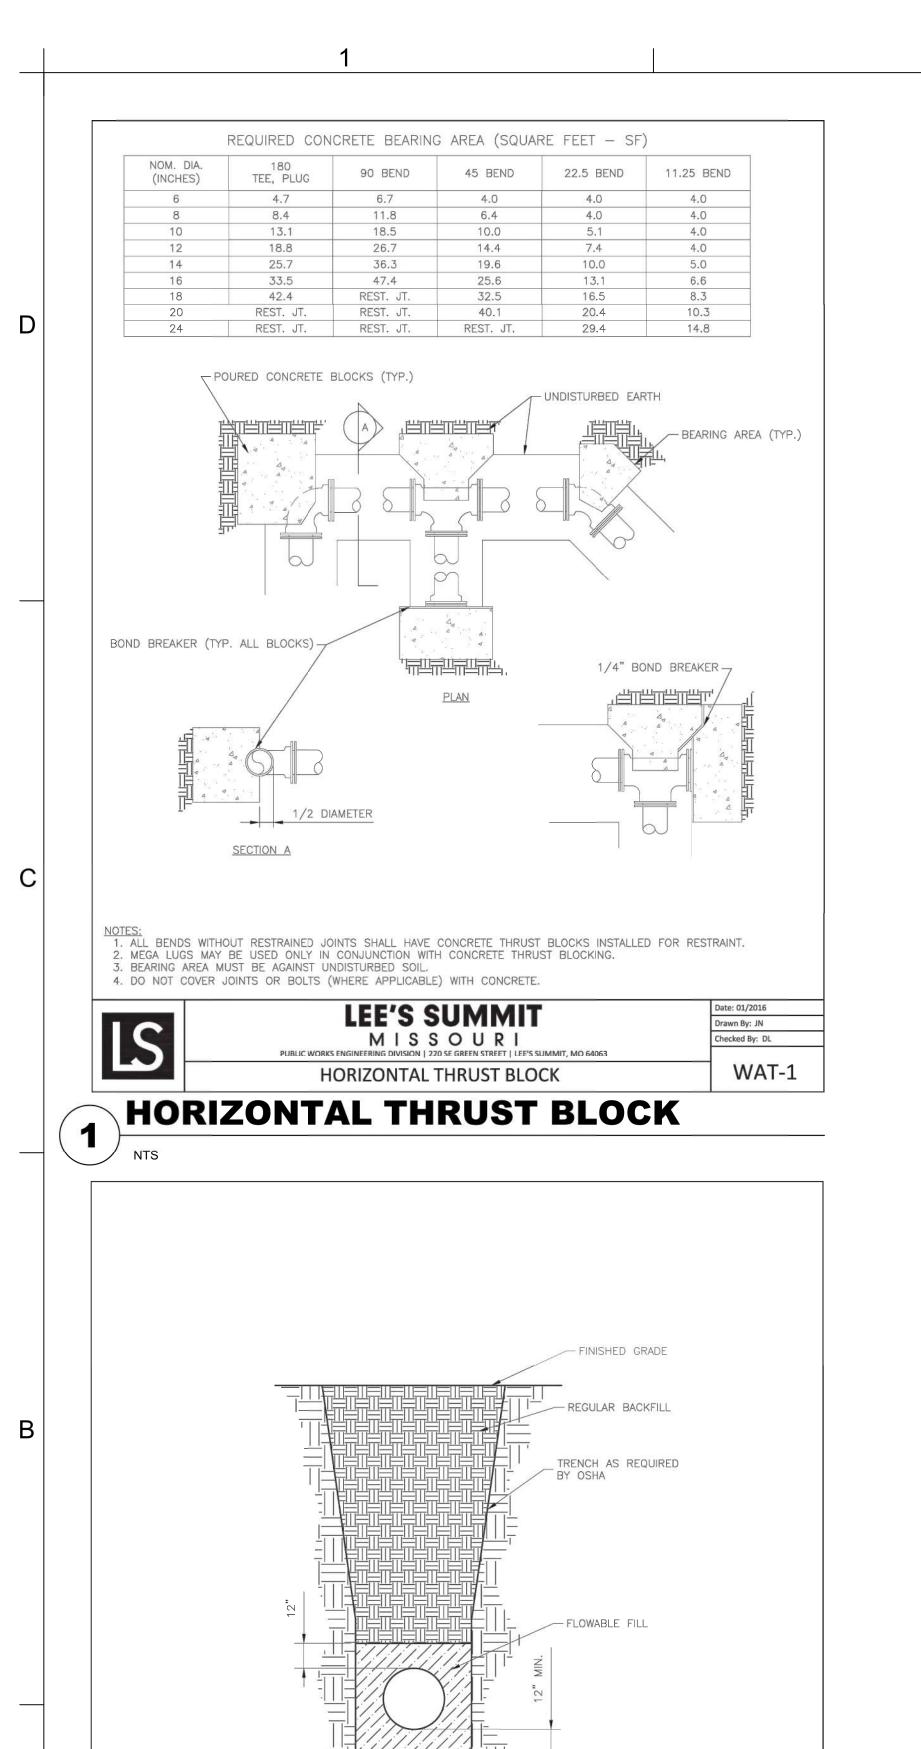

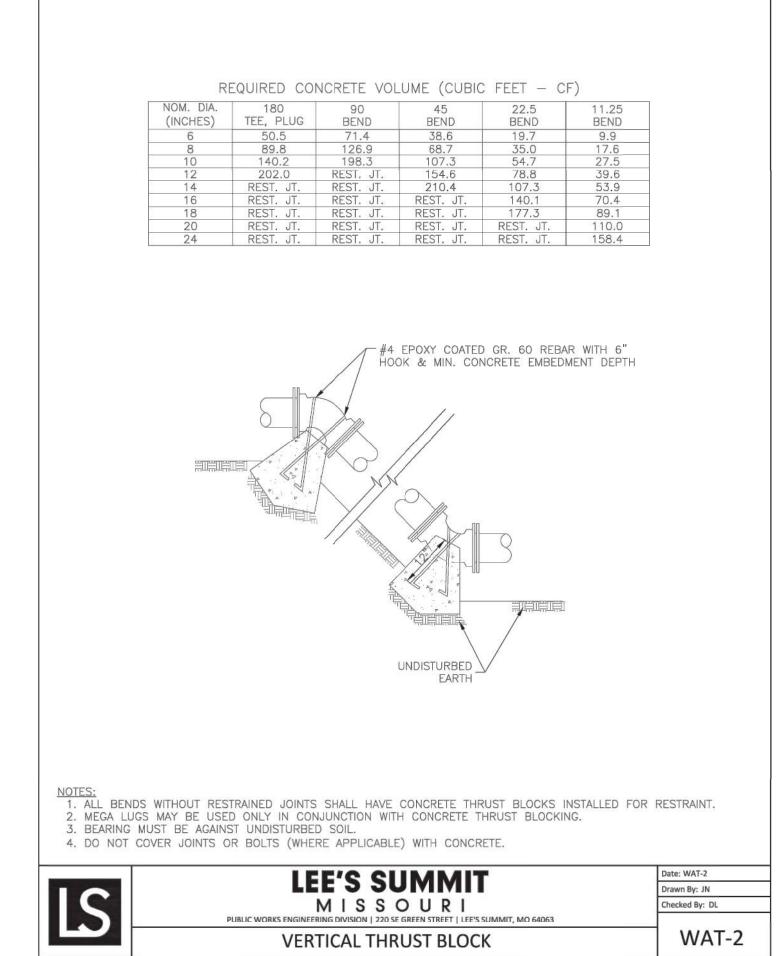


**VERTICAL THRUST BLOCK** 

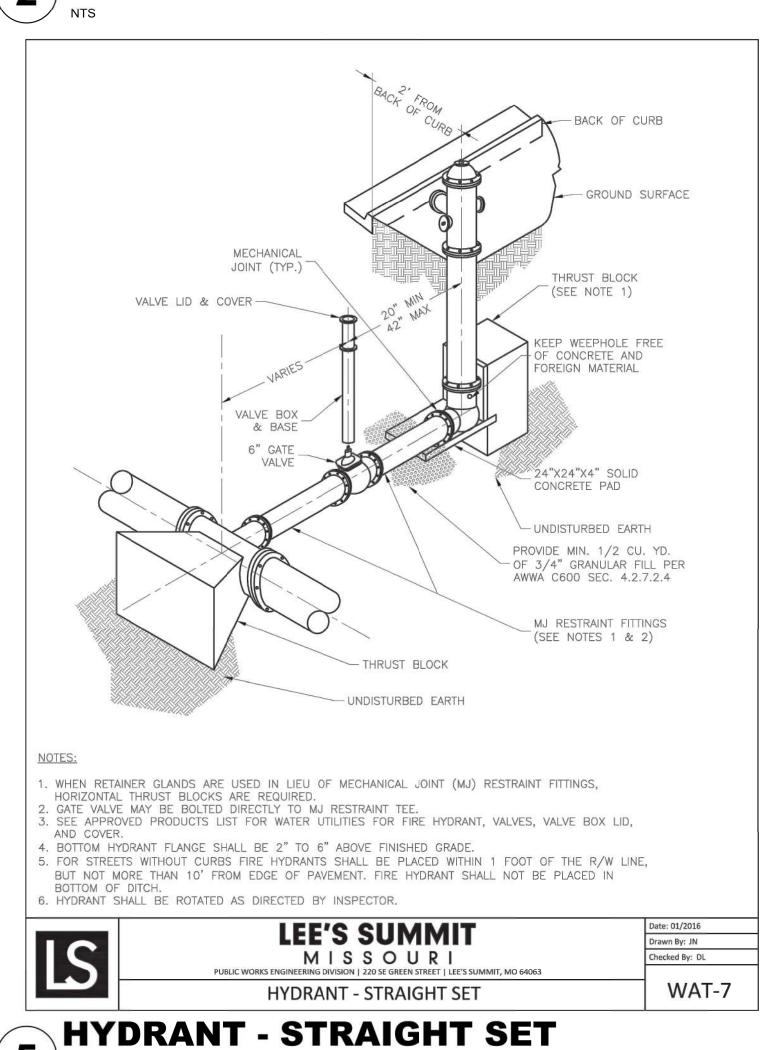

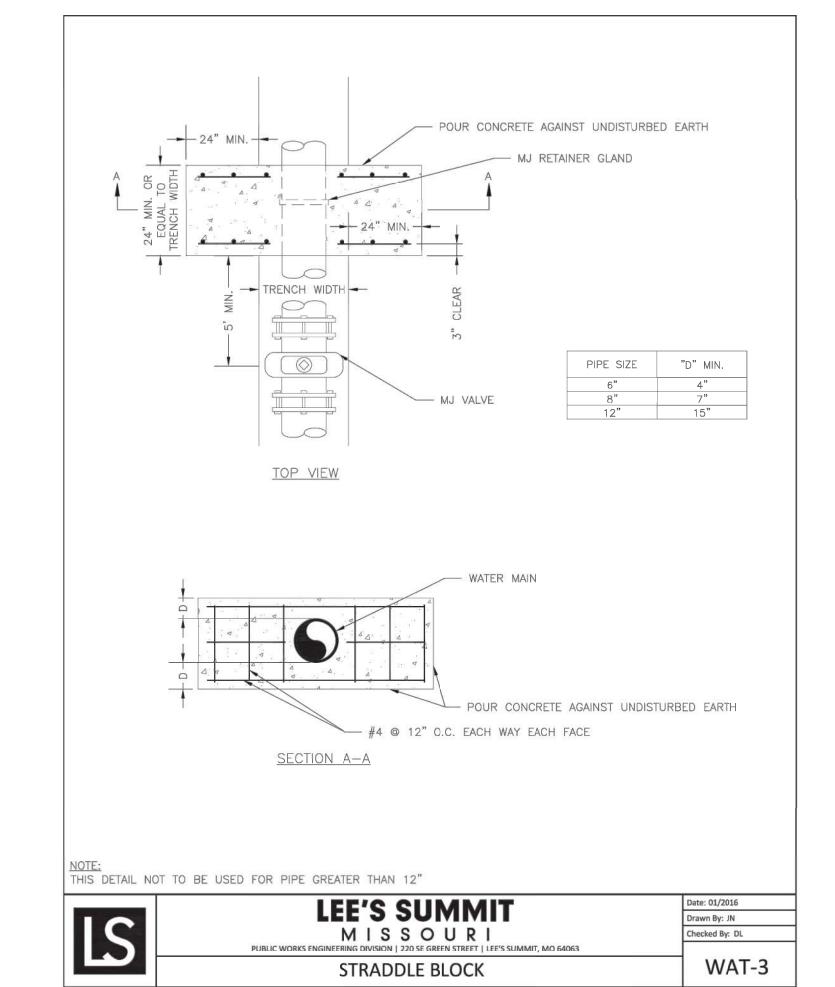

STRADDLE BLOCK

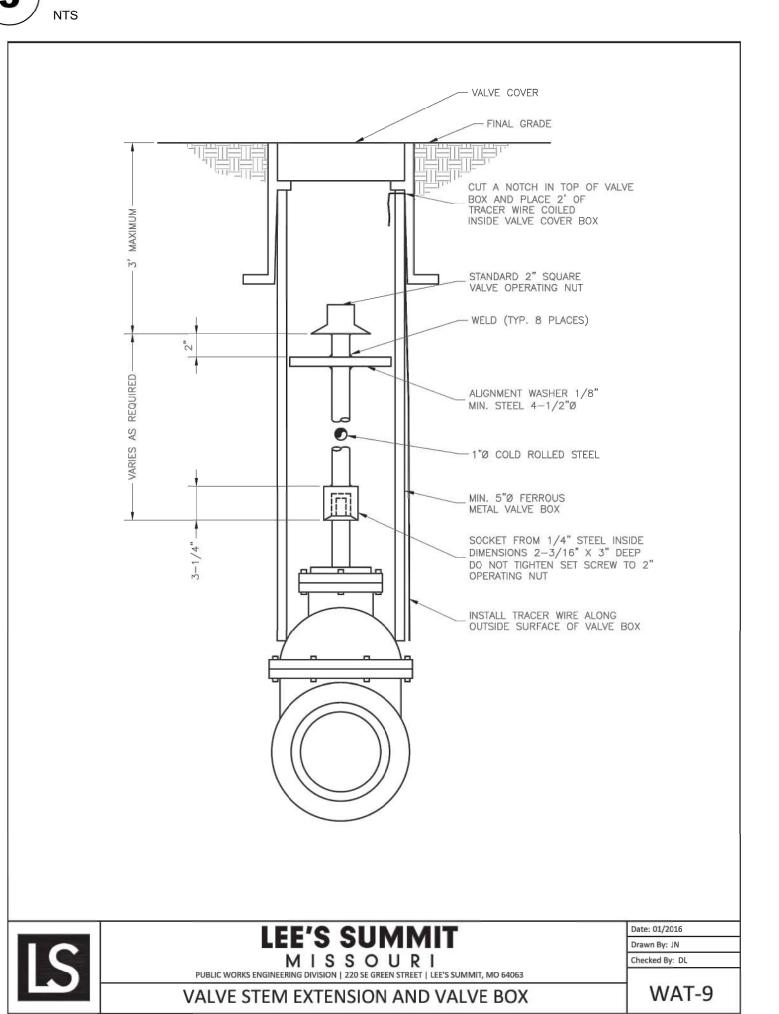

**As Noted on Plans Review** Lee's Summit, Missouri 12/30/2022

RELEASED FOR

CONSTRUCTION

9229 WARD PARKWAY SUITE # 210 KANSAS CITY, MO 64114 TEL: (816) 444-4200 FAX: (316) 265-5646 www.glmv.com

MISSOURI STATE CERTIFICATE OF AUTHORITY #000305

CIVIL ENGINEER & LANDSCAPE ARCH. GLMV ARCHITECTURE, INC MISSOURI CIVIL COA #2018033898 MISSOURI LANDSCAPE COA #000008 9229 WARD PARKWAY, SUITE # 210 KANSAS CITY, MO 64114 TEL: (816) 444-4200

STRUCTURAL ENGINEER LEIGH + O'KANE MISSOURI COA #001644 250 NE MURBERRY, SUITE 201 LEE'S SUMMIT, MO, 64086

(816) 444-3144 PHONE MECH., ELEC. & PLUMBING ENGINEERS HOSS & BROWN ENGINEERS MISSOURI COA #01022

SHAWNEE, KS 66217 (913) 362-9090 PHONE SECURITY & IT ENGINEERS HENDERSON ENGINEERS MISSOURI COA # 000556

15902 MIDLAND DRIVE

1801 MAIN STREET, SUITE 300 KANSAS CITY, MO 64108 (816) 663-8700 PHONE

STATIC FLEE'S SU FIRE (CITY OF

|REVISIONS: # Description Date

> DERICK M. **HOLMES** NUMBER PE-2022005196 / E

DERICK HOLMES - CIVIL ENGINEER MO# PE-2022005196

PROJECT NO: 18225R21001 10.26.2022 DRAWN BY: CHK'D BY:

© GLMV Architecture, Inc. All work herein is the property of GLMV Architecture, Inc. and is not to be copied or used in any way without the express written consent of GLMV Architecture, Inc.

> WATER **DETAILS**

**VALVE STEM EXTENSION & VALVE BOX** 6

WATER TRENCH CHECK DETAIL

**LEE'S SUMMIT** 

MISSOURI

WATER TRENCH CHECK DETAIL

hecked By: DL

WAT-6

5

FLOWABLE FILL SHALL MEET THE REQUIREMENTS OF THE CITY OF LEE'S SUMMIT DESIGN AND

REGULAR BACKFILL ABOVE THE TRENCH CHECK SHALL BE FREE OF DEBRIS, ORGANIC MATTER,


3. TOP OF FLOWABLE BACKFILL SHALL EXTEND 12" ABOVE THE TOP OF THE PIPE.

CONSTRUCTION MANUAL.

AND STONES > 6" IN ANY DIMENSION.

4. LENGTH OF TRENCH CHECK SHALL BE A MINIMUM OF 12".

PLEASE CONSIDER THE ENVIRONMENT BEFORE PRINTING THIS

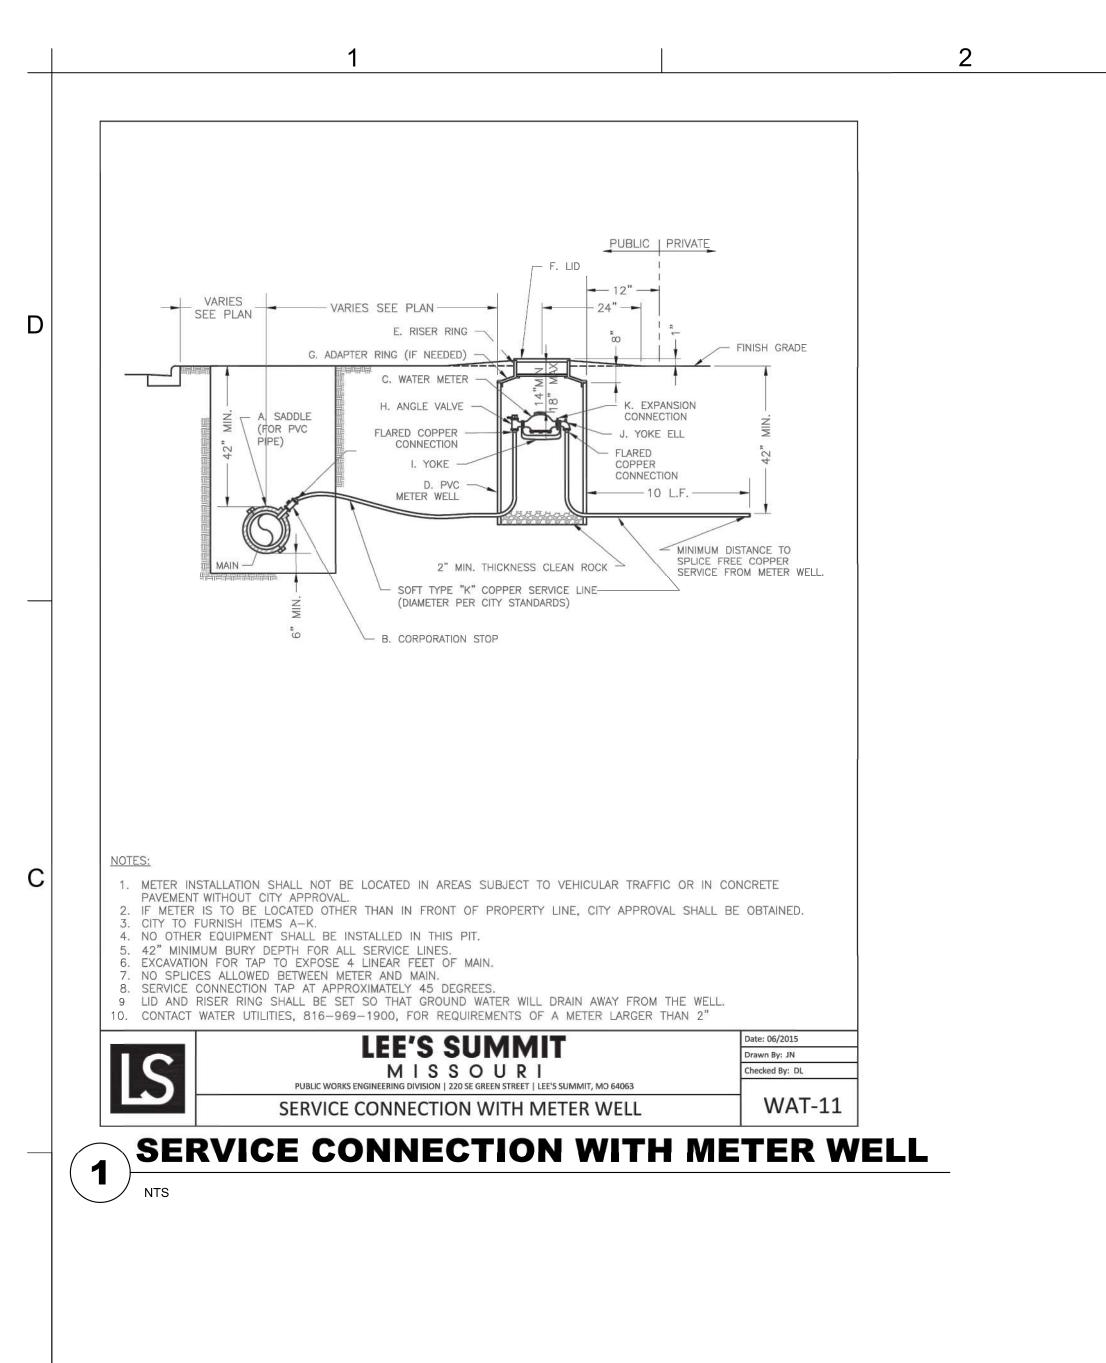

2

GLMVArchitecture

9229 WARD PARKWAY SUITE # 210 KANSAS CITY, MO 64114 TEL: (816) 444-4200 FAX: (316) 265-5646 www.glmv.com

GLMV ARCHITECTURE, INC. MISSOURI STATE CERTIFICATE OF AUTHORITY #000305

CIVIL ENGINEER & LANDSCAPE ARCH.
GLMV ARCHITECTURE, INC
MISSOURI CIVIL COA #2018033898
MISSOURI LANDSCAPE COA #000008
9229 WARD PARKWAY, SUITE # 210
KANSAS CITY, MO 64114

TEL: (816) 444-4200

STRUCTURAL ENGINEER

LEIGH + O'KANE

MISSOURI COA #001644

250 NE MURBERRY, SUITE 201

MISSOURI COA #001644 250 NE MURBERRY, SUITE 201 LEE'S SUMMIT, MO, 64086 (816) 444-3144 PHONE MECH., ELEC. & PLUMBING ENGINEERS

HOSS & BROWN ENGINEERS

MISSOURI COA #01022

15902 MIDLAND DRIVE SHAWNEE, KS 66217 (913) 362-9090 PHONE SECURITY & IT ENGINEERS HENDERSON ENGINEERS

SECURITY & IT ENGINEERS
HENDERSON ENGINEERS
MISSOURI COA # 000556
1801 MAIN STREET, SUITE 300
KANSAS CITY, MO 64108
(816) 663-8700 PHONE

ON DOCUMENT DRA

)URI 64082

FIRE STATION #5
CITY OF LEE'S SUMMIT
801 MISSOURI HIGHWAY 1
I FF'S SUMMIT MISSOURI BI

REVISIONS:
# Description Date

DERICK M.

HOLMES

NUMBER

PE-2022005196

ON AL L

ON AL

DERICK HOLMES - CIVIL ENGINEER

MO# PE-2022005196

The Professional Engineers seal affixed to this sheet applies only to the material and items shown on this sheet. All drawings, instruments or other documents not exhibiting this seal shall not be considered prepared by this engineer, and this engineer expressly disclaims any and all responsibility for such plan, drawings, or documents not exhibiting this seal.

 PROJECT NO:
 18225R21001

 DATE:
 10.26.2022

 DRAWN BY:
 SJB

 CHK'D BY:
 DMH

© GLMV Architecture, Inc.

All work herein is the property of GLMV Architecture, Inc. and is not to be copied or used in any way without the express written consent of GLMV Architecture, Inc.

WATER DETAILS

C-52′

PLEASE CONSIDER THE ENVIRONMENT BEFORE PRINTING THIS

RELEASED FOR
CONSTRUCTION
As Noted on Plans Review

Development Services Department
Lee's Summit, Missouri
12/30/2022

#### Section 2721

#### **Engineered Surface Drainage Products**

#### **GENERAL**

PVC surface drainage inlets shall include the drain basin type as indicated on the contract drawing and referenced within the contract specifications. The ductile iron grates for each of these fittings are to be considered an integral part of the surface drainage inlet and shall be furnished by the same manufacturer. The surface drainage inlets shall be as manufactured by Nyloplast a division of Advanced Drainage Systems, Inc., or prior approved equal.

The drain basins required for this contract shall be manufactured from PVC pipe stock, utilizing a thermoforming process to reform the pipe stock to the specified configuration. The drainage pipe connection stubs shall be manufactured from PVC pipe stock and formed to provide a watertight connection with the specified pipe system. This joint tightness shall conform to ASTM D3212 for joints for drain and sewer plastic pipe using flexible elastomeric seals. The flexible elastomeric seals shall conform to ASTM F477. The pipe bell spigot shall be joined to the main body of the drain basin or catch basin. The raw material used to manufacture the pipe stock that is used to manufacture the main body and pipe stubs of the surface drainage inlets shall conform to ASTM D1784 cell class 12454.

The grates and frames furnished for all surface drainage inlets shall be ductile iron for structure sizes 8", 10", 12", 15", 18", 24", 30" and 36" and shall be made specifically for each basin so as to provide a round bottom flange that closely matches the diameter of the surface drainage inlet. Grates for drain basins shall be capable of supporting various wheel loads as specified by Nyloplast. 12" and 15" square grates will be hinged to the frame using pins. Ductile iron used in the manufacture of the castings shall conform to ASTM A536 grade 70-50-05. Grates and covers shall be provided painted black.

#### INSTALLATION

The specified PVC surface drainage inlet shall be installed using conventional flexible pipe backfill materials and procedures. The backfill material shall be crushed stone or other granular material meeting the requirements of class 1, class 2, or class 3 material as defined in ASTM D2321. Bedding and backfill for surface drainage inlets shall be well placed and compacted uniformly in accordance with ASTM D2321. The drain basin body will be cut at the time of the final grade. No brick, stone or concrete block will be required to set the grate to the final grade height. For load rated installations, a concrete slab shall be poured under and around the grate and frame. The concrete slab must be designed taking into consideration local soil conditions, traffic loading, and other applicable design factors. For other installation considerations such as migration of fines, ground water, and soft foundations refer to ASTM D2321 guidelines.

IIS PRINT DISCLOSES SUBJECT MATTER IN WHICH	DRAWN BY C
LOPLAST HAS PROPRIETARY RIGHTS. THE RECEIPT	
R POSSESSION OF THIS PRINT DOES NOT CONFER,	DATE 3-10-
ANSFER, OR LICENSE THE USE OF THE DESIGN OR	
CHNICAL INFORMATION SHOWN HEREIN	REVISED BY N
PRODUCTION OF THIS PRINT OR ANY INFORMATION	
INTAINED HEREIN, OR MANUFACTURE OF ANY	DATE 02-2
TICLE HEREEROM FOR THE DISCLOSURE TO OTHERS	DAIL OLL


	DRAWN BY CJA DATE 3-10-00	MATERIAL	Nyloplast	3130 VERONA A BUFORD, GA 30: PHN (770) 932-24 FAX (770) 932-24
	REVISED BY NMH DATE 02-21-18	PROJECT NO./NAME	TITLE	www.nyloplast-u
C	DATE 02 21 10		8 IN - 36 IN DRAIN BASIN S	PECIFICATIONS

7001-110-011


DWG SIZE A SCALE 1:1 SHEET 1 OF 1 DWG NO.

## 8 IN - 36 IN DRAIN BASIN SPECIFICATIONS


IS FORBIDDEN, EXCEPT BY SPECIFIC WRITTEN

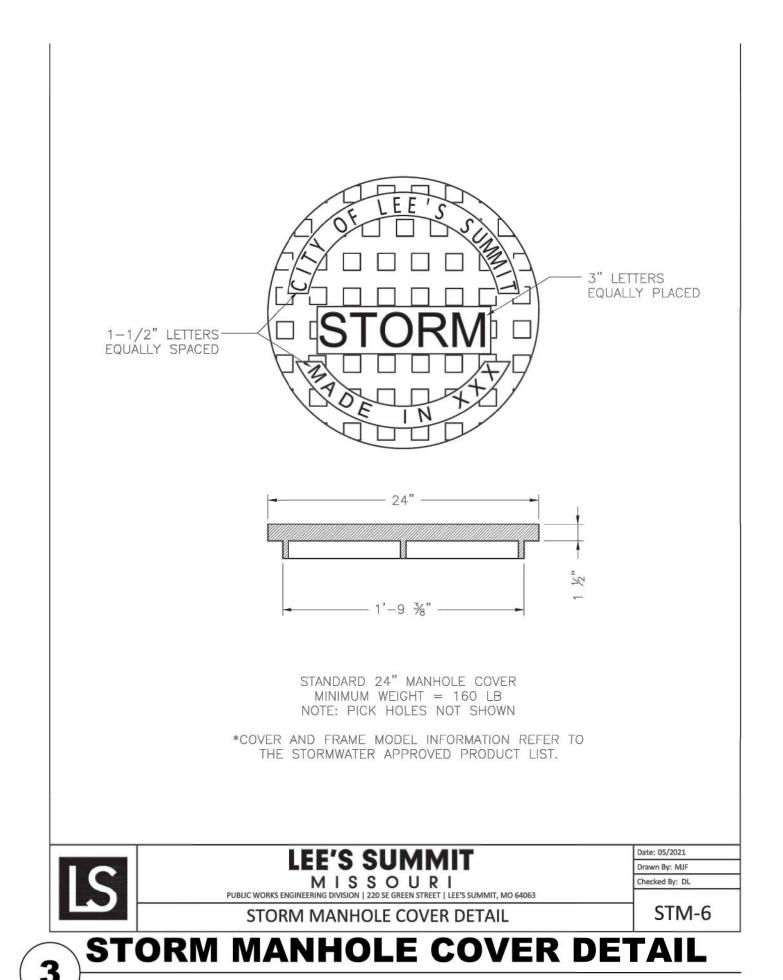


2

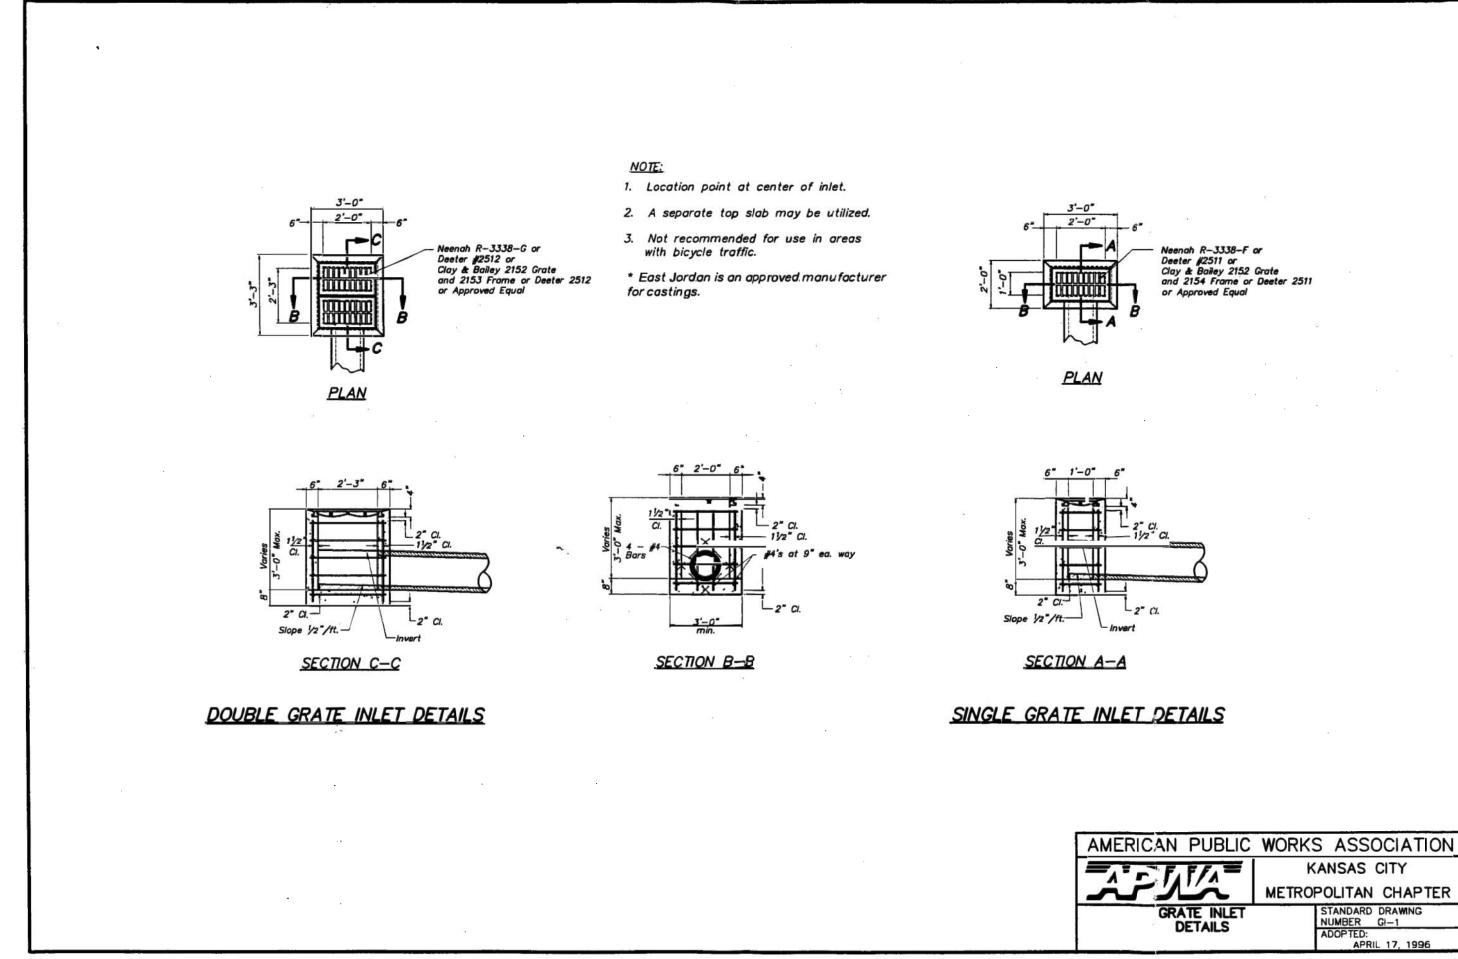

### **GRATE INLET DETAIL**

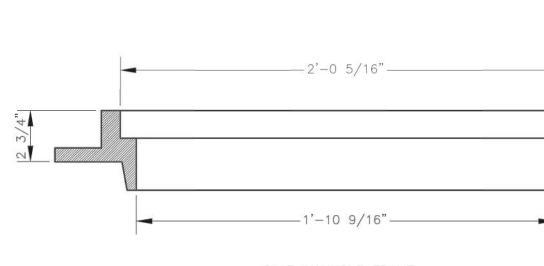

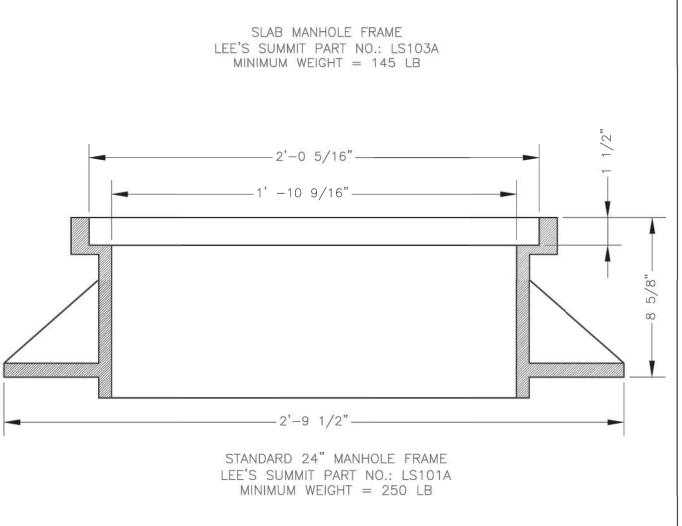

**LEE'S SUMMIT** Date: 05/2021 Drawn By: MJF MISSOURI Checked By: DL DWG-7 STORM MANHOLE FRAME DETAIL STORM MANHOLE FRAME DETAIL

\*COVER AND FRAME MODEL INFORMATION REFER TO

THE STORMWATER APPROVED PRODUCTS LIST.

CONSTRUCTION As Noted on Plans Review Lee's Summit, Missouri 12/30/2022

RELEASED FOR

9229 WARD PARKWAY **SUITE # 210** KANSAS CITY, MO 64114 TEL: (816) 444-4200 FAX: (316) 265-5646 www.glmv.com

MISSOURI STATE CERTIFICATE OF AUTHORITY #000305

CIVIL ENGINEER & LANDSCAPE ARCH. GLMV ARCHITECTURE, INC MISSOURI CIVIL COA #2018033898 MISSOURI LANDSCAPE COA #000008 9229 WARD PARKWAY, SUITE # 210

KANSAS CITY, MO 64114 TEL: (816) 444-4200 STRUCTURAL ENGINEER LEIGH + O'KANE MISSOURI COA #001644

250 NE MURBERRY, SUITE 201 LEE'S SUMMIT, MO, 64086 (816) 444-3144 PHONE MECH., ELEC. & PLUMBING ENGINEERS

HOSS & BROWN ENGINEERS MISSOURI COA #01022 15902 MIDLAND DRIVE SHAWNEE, KS 66217

(913) 362-9090 PHONE SECURITY & IT ENGINEERS HENDERSON ENGINEERS MISSOURI COA # 000556 1801 MAIN STREET, SUITE 300

KANSAS CITY, MO 64108 (816) 663-8700 PHONE

FIRE STATIC CITY OF LEE'S SUI

REVISIONS: # Description Date

> DERICK M. HOLMES NUMBER 0 PF. 2022005106 / E Danck Hotera ONALE

DERICK HOLMES - CIVIL ENGINEER MO# PE-2022005196


PROJECT NO: 18225R21001 DATE: 10.26.2022 DRAWN BY: SJB CHK'D BY: DMH

© GLMV Architecture, Inc. All work herein is the property of GLMV Architecture, Inc. and is not to be copied or used in any way without the express written consent of GLMV Architecture, Inc.


STORMWATER **DETAILS** 

PLEASE CONSIDER THE ENVIRONMENT


BEFORE PRINTING THIS

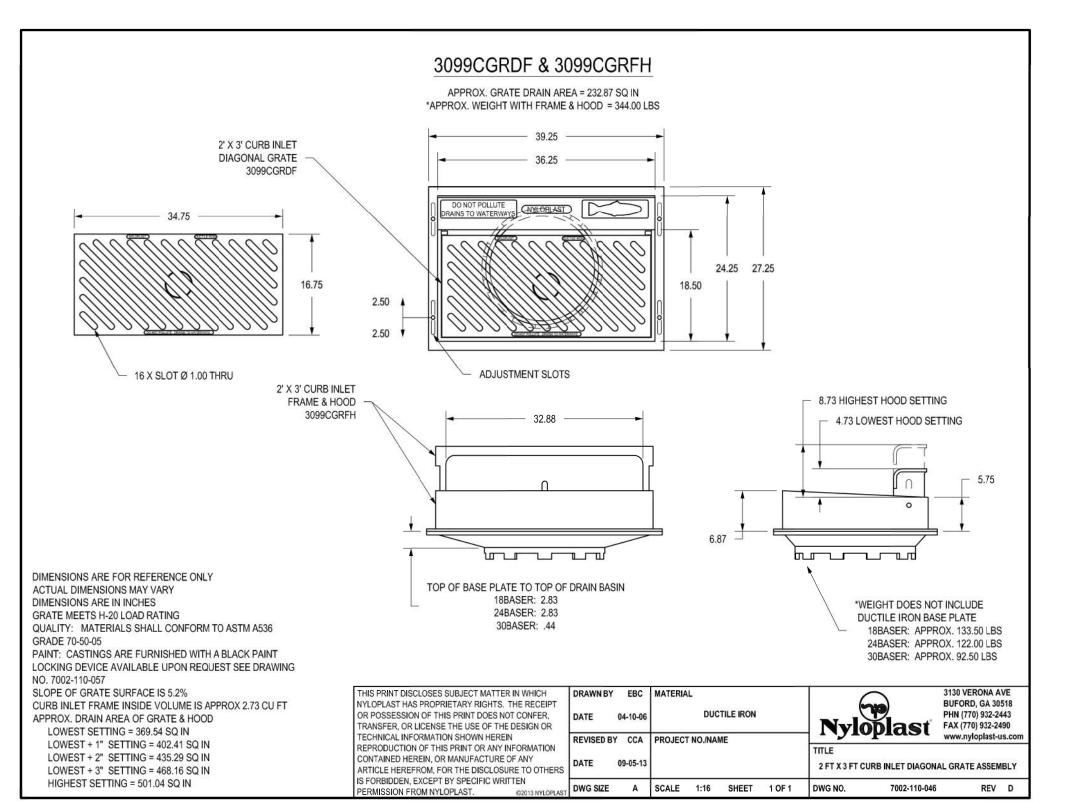

2'x3' CURB INLET DIAGONAL GRATE ASSEMBLY

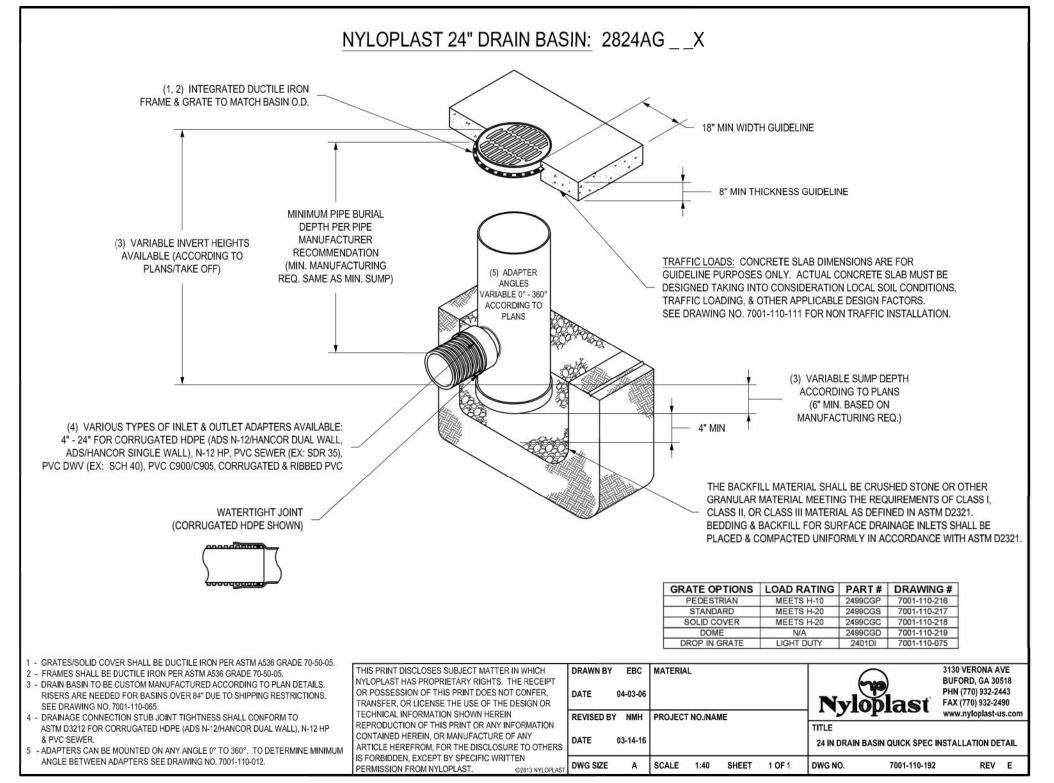


24" DRAIN BASIN QUICK SPEC INSTALLATION DETAIL

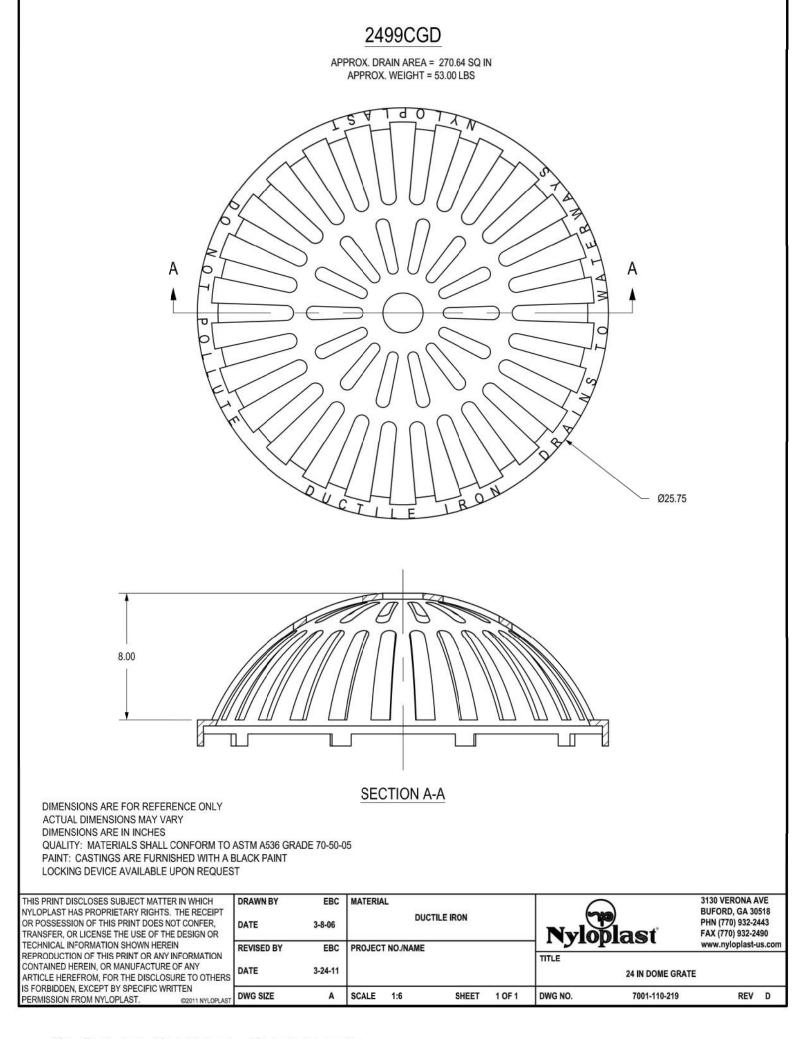

24" DOME GRATE

APPROX. WEIGHT WITH FRAME = 138.00 LBS DIMENSIONS ARE FOR REFERENCE ONLY THIS PRINT DISCLOSES SUBJECT MATTER IN WHICH ACTUAL DIMENSIONS MAY VARY **BUFORD, GA 30518** NYLOPLAST HAS PROPRIETARY RIGHTS. THE RECEIPT OR POSSESSION OF THIS PRINT DOES NOT CONFER, PHN (770) 932-2443 DIMENSIONS ARE IN INCHES FAX (770) 932-2490 GRATE MEETS H-20 LOAD RATING CHNICAL INFORMATION SHOWN HEREIN QUALITY: MATERIALS SHALL CONFORM TO ASTM A536 GRADE 70-50-05 PRODUCTION OF THIS PRINT OR ANY INFORMATION PAINT: CASTINGS ARE FURNISHED WITH A BLACK PAINT ONTAINED HEREIN, OR MANUFACTURE OF ANY LOCKING DEVICE AVAILABLE UPON REQUEST SEE DRAWING NO.

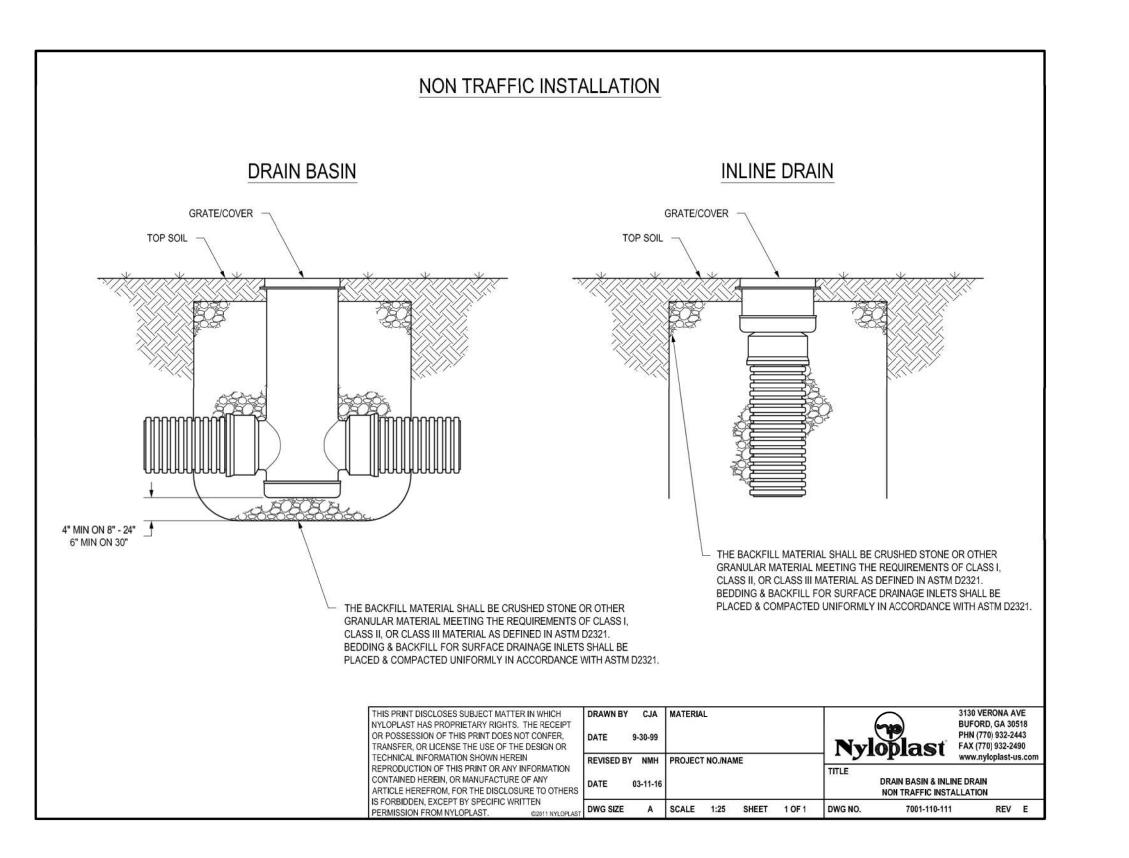

**RELEASED FOR** CONSTRUCTION As Noted on Plans Review Lee's Summit, Missouri 12/30/2022 9229 WARD PARKWAY

SUITE # 210 KANSAS CITY, MO 64114 TEL: (816) 444-4200 FAX: (316) 265-5646 www.gimv.com

MISSOURI STATE CERTIFICATE OF AUTHORITY

CIVIL ENGINEER & LANDSCAPE ARCH. GLMV ARCHITECTURE, INC MISSOURI CIVIL COA #2018033898 MISSOURI LANDSCAPE COA #000008 9229 WARD PARKWAY, SUITE # 210 KANSAS CITY, MO 64114 TEL: (816) 444-4200

STRUCTURAL ENGINEER LEIGH + O'KANE MISSOURI COA #001644 250 NE MURBERRY, SUITE 201 LEE'S SUMMIT, MO, 64086 (816) 444-3144 PHONE

MECH., ELEC. & PLUMBING ENGINEERS HOSS & BROWN ENGINEERS MISSOURI COA #01022 15902 MIDLAND DRIVE

SHAWNEE, KS 66217 (913) 362-9090 PHONE SECURITY & IT ENGINEERS HENDERSON ENGINEERS MISSOURI COA # 000556

1801 MAIN STREET, SUITE 300 KANSAS CITY, MO 64108 (816) 663-8700 PHONE

FIRE STATIC

|REVISIONS: # Description

HOLMES NUMBER

DERICK HOLMES - CIVIL ENGINEER MO# PE-2022005196

PROJECT NO: 18225R21001 10.26.2022 DRAWN BY: CHK'D BY:

All work herein is the property of GLMV Architecture, Inc. and is not to be copied or used in any way without the express written consent of GLMV Architecture, Inc.

STORMWATER **DETAILS** 

DRAIN BASIN & INLINE DRAIN NON-TRAFFIC INSTALLATION

24" SOLID COVER ASSEMBLY - TYPE B

FORBIDDEN, EXCEPT BY SPECIFIC WRITTEN

DWG SIZE A SCALE 1:10 SHEET 1 OF 1 DWG NO.

7001-110-218

©2013 NYLOPLAST DWG SIZE A SCALE 1:40 SHEET 1 OF 1 DWG NO.


REV G

7001-110-193



PERMISSION FROM NYLOPLAST.

ANGLE BETWEEN ADAPTERS SEE DRAWING NO. 7001-110-012.

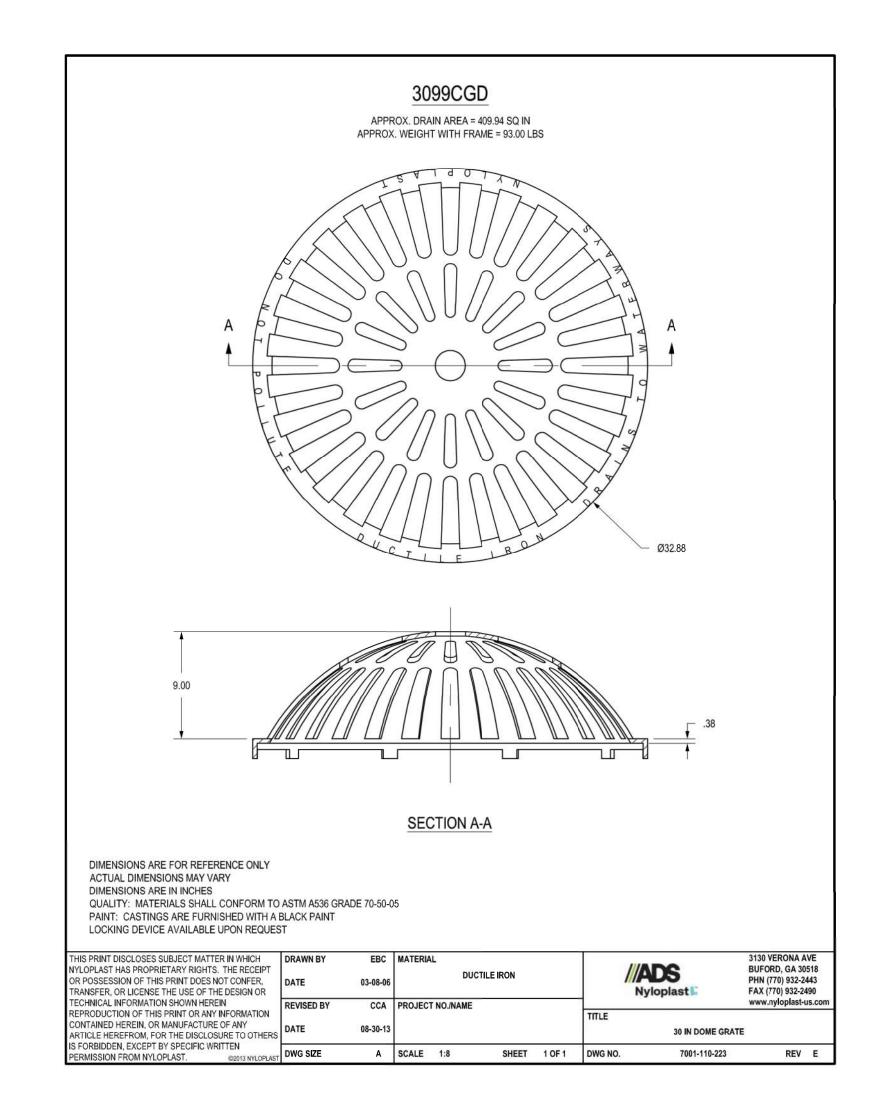

30" DOME GRATE



9229 WARD PARKWAY SUITE # 210 KANSAS CITY, MO 64114 TEL: (816) 444-4200 FAX: (316) 265-5646 www.glmv.com

GLMV ARCHITECTURE, INC. MISSOURI STATE CERTIFICATE OF AUTHORITY #000305

CIVIL ENGINEER & LANDSCAPE ARCH.
GLMV ARCHITECTURE, INC
MISSOURI CIVIL COA #2018033898
MISSOURI LANDSCAPE COA #000008
9229 WARD PARKWAY, SUITE # 210
KANSAS CITY, MO 64114

STRUCTURAL ENGINEER LEIGH + O'KANE MISSOURI COA #001644 250 NE MURBERRY, SUITE 201 LEE'S SUMMIT, MO, 64086

TEL: (816) 444-4200

250 NE MURBERRY, SUITE 201 LEE'S SUMMIT, MO, 64086 (816) 444-3144 PHONE

MECH., ELEC. & PLUMBING ENGINEERS HOSS & BROWN ENGINEERS

MISSOURI COA #01022

15902 MIDLAND DRIVE

SHAWNEE, KS 66217
(913) 362-9090 PHONE

SECURITY & IT ENGINEERS
HENDERSON ENGINEERS
MISSOURI COA # 000556
1801 MAIN STREET, SUITE 300

KANSAS CITY, MO 64108

(816) 663-8700 PHONE

DRAWINGS

% CONSTRUCTION D

FIRE STATION #5
CITY OF LEE'S SUMMIT
801 MISSOURI HIGHWAY 18
LEE'S SUMMIT, MISSOURI (

REVISIONS:
# Description Date

DERICK M.

\* HOLMES
NUMBER
PE-2022005196

DERICK HOLMES - CIVIL ENGINEER

MO# PE-2022005196

The Professional Engineers seal affixed to this sheet applies only to the material and items shown on this sheet. All drawings, instruments or other documents not exhibiting this seal shall not be considered prepared by this engineer, and this engineer expressly idisclaims any and all responsibility for

 PROJECT NO:
 18225R21001

 DATE:
 10.26.2022

 DRAWN BY:
 SJB

CHK'D BY: DMH

© GLMV Architecture, Inc.

All work herein is the property of GLMV Architecture, Inc. and

STORMWATER


DETAILS

C-532

PLEASE CONSIDER THE ENVIRONMENT

CONSTRUCTION
As Noted on Plans Review
Development Services Department
Lee's Summit, Missouri
12/30/2022

3 5

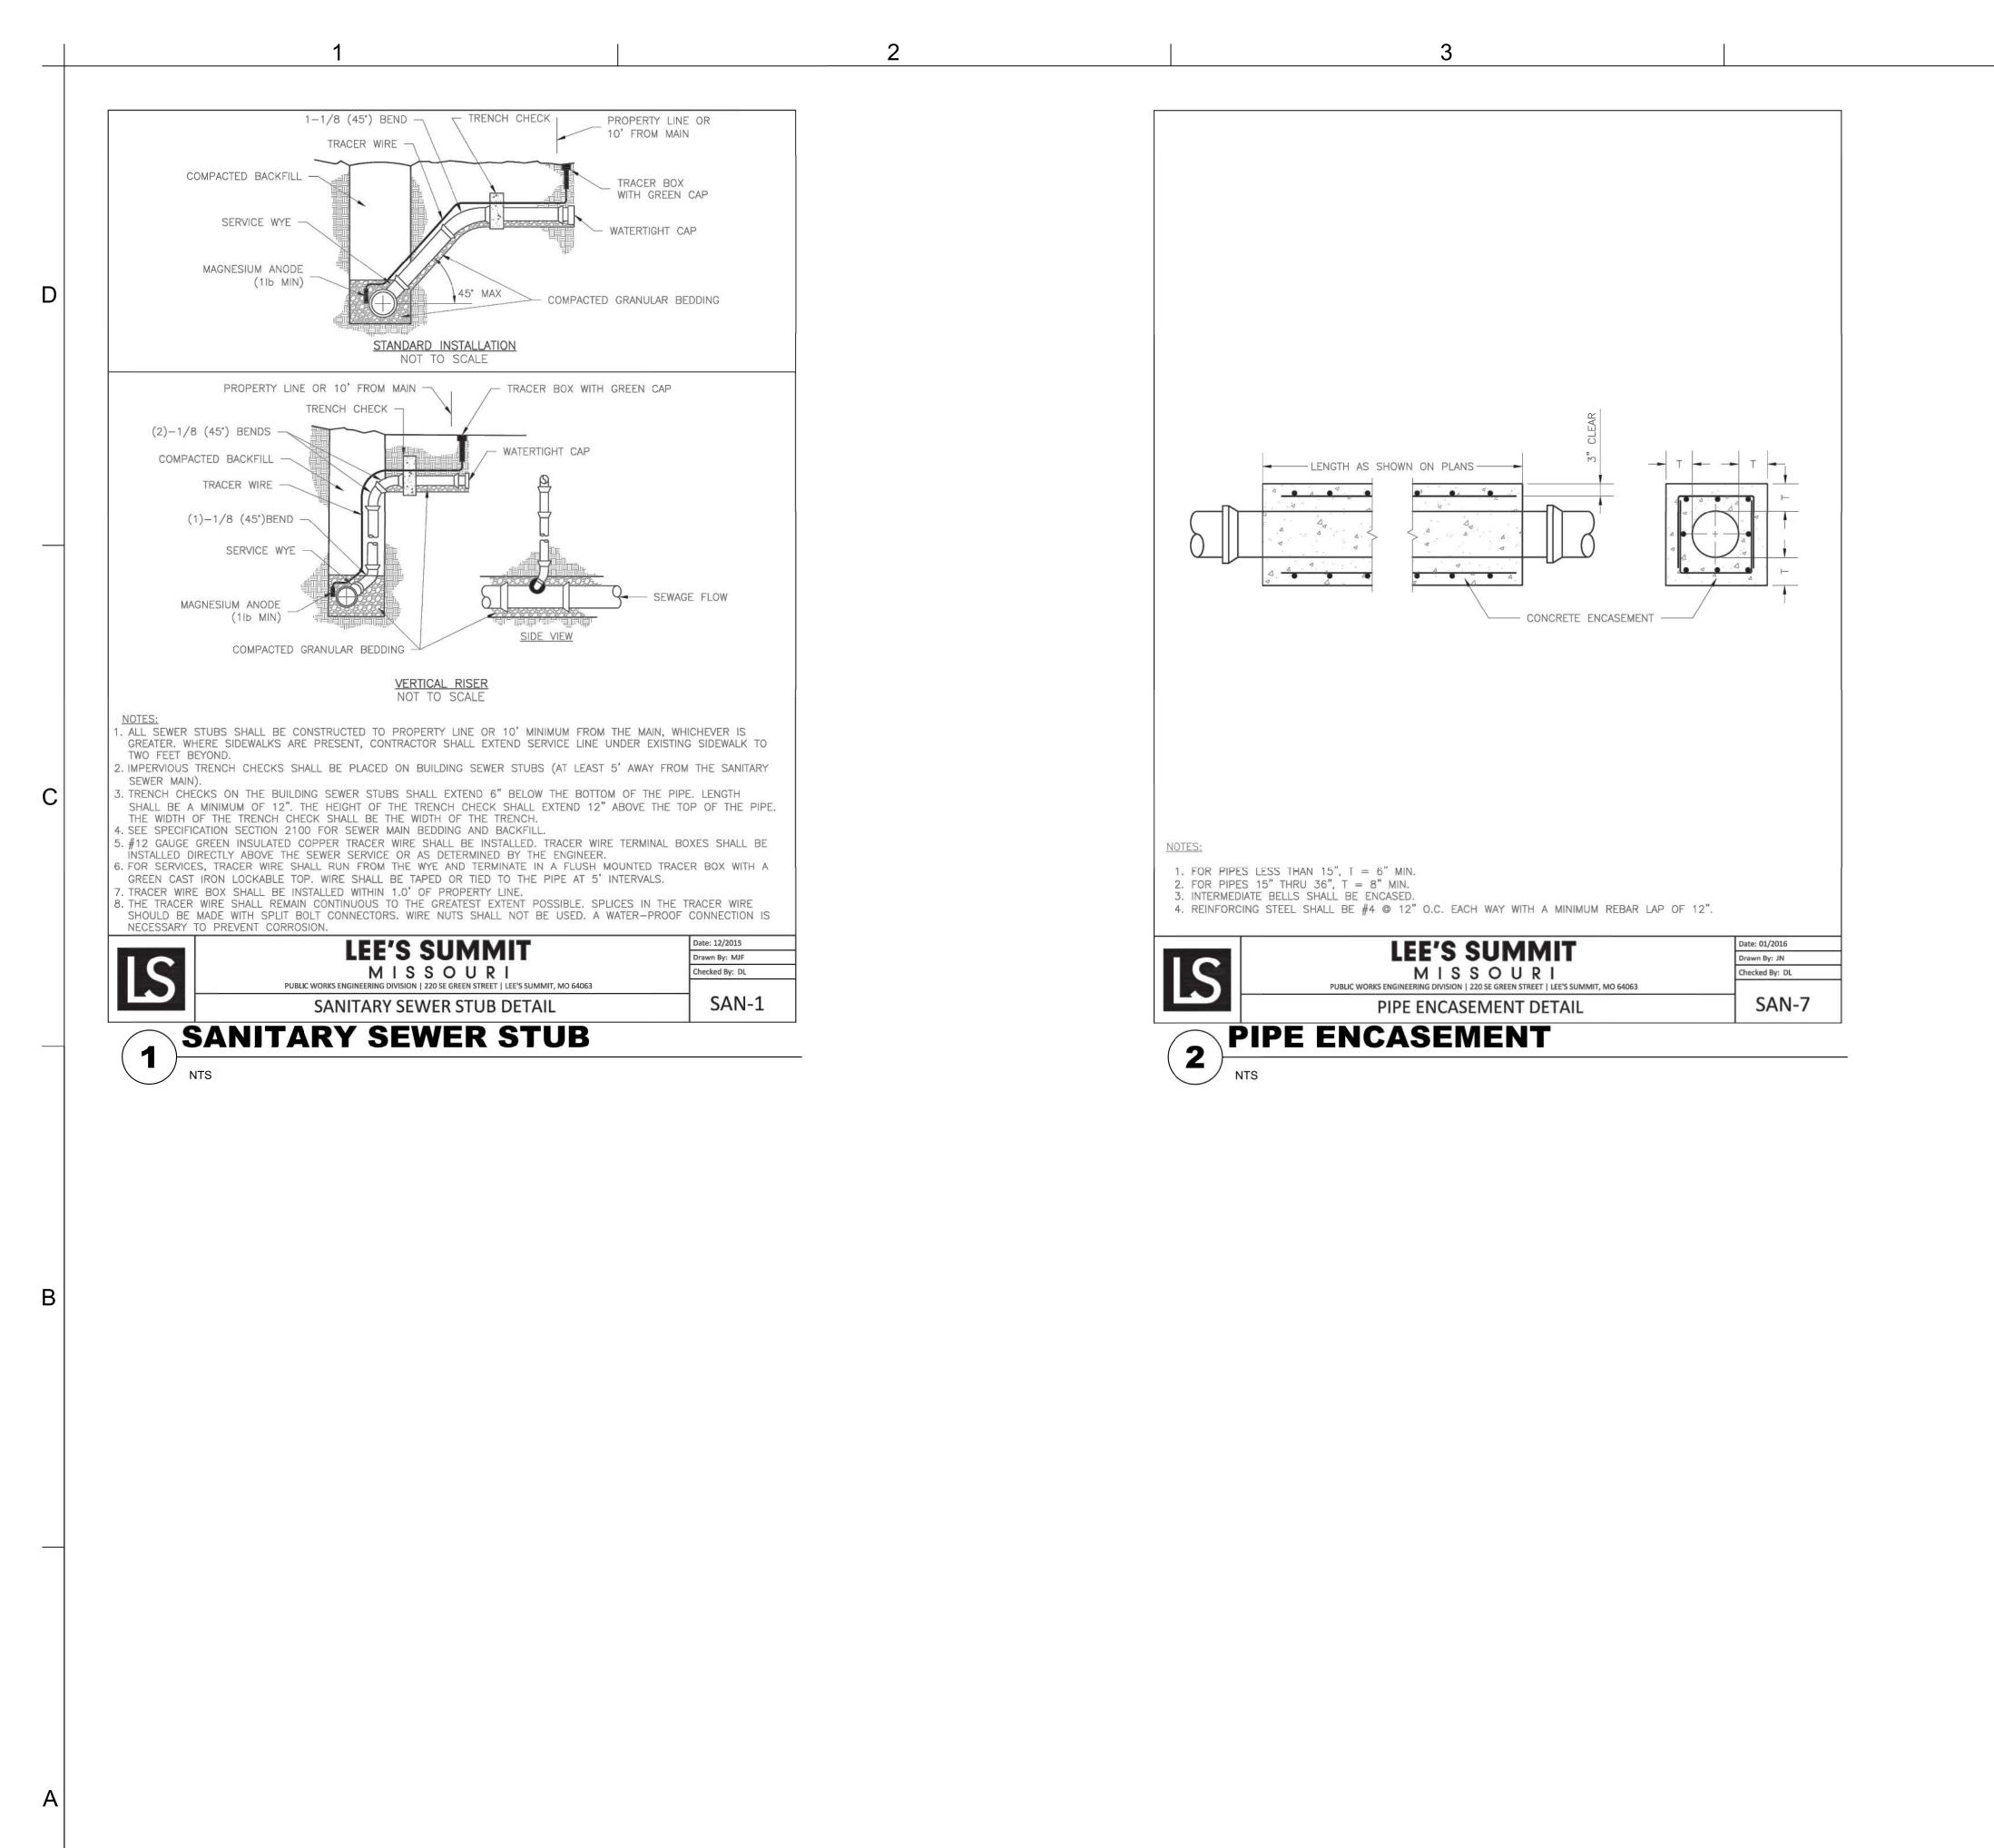

2

RELEASED FOR
CONSTRUCTION
As Noted on Plans Review
Development Services Department
Lee's Summit, Missouri
12/30/2022

GLMVArchitecture
9229 WARD PARKWAY

SUITE # 210

KANSAS CITY, MO 64114

TEL: (816) 444-4200 FAX: (316) 265-5646

www.glmv.com

GLMV ARCHITECTURE, INC.

MISSOURI STATE CERTIFICATE OF AUTHORITY

#000305

CIVIL ENGINEER & LANDSCAPE ARCH.
GLMV ARCHITECTURE, INC
MISSOURI CIVIL COA #2018033898
MISSOURI LANDSCAPE COA #000008
9229 WARD PARKWAY, SUITE # 210
KANSAS CITY, MO 64114

STRUCTURAL ENGINEER
LEIGH + O'KANE
MISSOURI COA #001644
250 NE MURBERRY, SUITE 201
LEE'S SUMMIT, MO, 64086

TEL: (816) 444-4200

(816) 444-3144 PHONE

MECH., ELEC. & PLUMBING ENGINEERS
HOSS & BROWN ENGINEERS
MISSOURI COA #01022

15902 MIDLAND DRIVE SHAWNEE, KS 66217 (913) 362-9090 PHONE

SECURITY & IT ENGINEERS
HENDERSON ENGINEERS
MISSOURI COA # 000556
1801 MAIN STREET, SUITE 300
KANSAS CITY, MO 64108
(816) 663-8700 PHONE

CTION DOCUMENT D

//AY 150 OURI 64082

FIRE STATION #5
CITY OF LEE'S SUMMIT
801 MISSOURI HIGHWAY
LEE'S SUMMIT, MISSOUF

REVISIONS:

# Description Date

DERICK M.

HOLMES

NUMBER

PE-2022005196

DERICK HOLMES - CIVIL ENGINEER

MO# PE-2022005196

The Professional Engineers seal affixed to this sheet applies only to the material and items shown on this sheet. All drawings, instruments or other documents not exhibiting this seal shall not be considered prepared by this engineer, and this engineer expressly disclaims any and all responsibility for such plan, drawings, or documents not exhibiting this seal.

 PROJECT NO:
 18225R21001

 DATE:
 10.26.2022

 DRAWN BY:
 SJB

CHK'D BY: DMH

© GLMV Architecture, Inc.


All work herein is the property of GLMV Architecture, Inc. and is not to be copied or used in any way without the express written consent of GLMV Architecture, Inc.

SEWER DETAILS

C-540

PLEASE CONSIDER THE ENVIRONMENT BEFORE PRINTING THIS

3 5

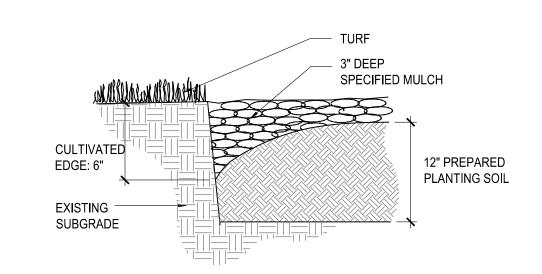

## **CULTIVATED EDGE**

#### GENERAL LANDSCAPE SITE NOTES


- 1. PRIOR TO COMMENCEMENT OF WORK, THE CONTRACTOR SHALL GIVE 48 HOURS ADVANCE NOTICE TO ALL THOSE COMPANIES/UTILITIES THAT HAVE FACILITIES IN THE NEAR VICINITY OF THE CONSTRUCTION TO BE PERFORMED.
- 2. CONTRACTOR SHALL VERIFY ALL PLANT COUNTS, QUANTITIES AND AREAS AND REPORT ANY DISCREPANCIES TO THE LANDSCAPE ARCHITECT PRIOR TO ORDERING OR INSTALLING MATERIALS SPECIFIED.
- 3. SEE PLANT SCHEDULE FOR PLANT LEGEND AND QUANTITIES.
- 4. SYMBOLS INDICATED ON THE PLAN TAKE PRIORITY OVER WRITTEN QUANTITIES AND LABELS.
- 5. PLANTS CALLED OUT IN PLAN ARE CONSIDERED IN CLUSTERS EVEN IF NOT ATTACHED BY CONNECTING LINES. CALLOUTS HAVE TOTAL COUNTS NEEDED.
- 6. CONTRACTOR SHALL MAINTAIN THE LANDSCAPE UNTIL SUBSTANTIAL COMPLETION. MAINTENANCE WORK SHALL CONSIST OF APPLYING WATER, WEEDING, AND FERTILIZING.
- 7. CONTRACTOR SHALL BE RESPONSIBLE FOR DISEASE AND PEST CONTROL DURING THE MAINTENANCE PERIOD.
- 8. CONTRACTOR TO VERIFY, WITH SOIL ANALYSIS, THE SOIL AMENDMENT NEEDED AND CONTACT THE LANDSCAPE ARCHITECT IF THERE ARE ANY INADEQUATE AMENITIES.
- 9. PLANT MATERIAL SHALL NOT BE DELIVERED TO THE SITE NOR INSTALLED WHEN TEMPERATURES ARE ABOVE 90°F OR BELOW 40°F AT THE TIME OF PLANTING AND FORECASTED FOR A PERIOD OF 2 WEEKS AFTER INSTALLATION.
- 10. CONTRACTOR TO PROVIDE A 1-YEAR WARRANTY ON ALL INSTALLED PLANTINGS FROM POINT OF SUBSTANTIAL COMPLETION.

#### **PLANTING NOTES**

- 1. ALL PLANT MATERIAL SHALL BE OF EXCELLENT QUALITY, FREE OF DISEASE AND INFESTATION, AND TRUE TO TYPE, VARIETY, SIZE SPECIFIED, AND FORM PER THE AMERICAN STANDARD FOR NURSERY STOCK (ANSI Z60.1, CURRENT VERSION), PUBLISHED BY THE AMERICAN NURSERYMEN'S ASSOCIATION.
- 2. PLANT MATERIAL SHALL BE PLANTED AND MAINTAINED TO ASNS
- 4. NO SUBSTITUTIONS FOR VARIETY OR CULTIVAR SHALL BE ACCEPTED WITHOUT FIRST OBTAINING WRITTEN APPROVAL FROM LANDSCAPE ARCHITECT.
- 5. ALL TREES AND SHRUBS SHALL BE LAID OUT IN A UNIFORM AND CONSISTENT PATTERN, FOLLOWING THE LANDSCAPE PLAN ACCURATELY, PAYING ATTENTION TO EVEN SPACING IN THE ROW OR COVERAGE AREA OF THE
- 6. ALL PLANTING BEDS ABUTTING LAWN AREAS SHALL HAVE A CULTIVATED EDGE
- ALL PLANTINGS SHALL BE THOROUGHLY WATERED IN WITH A GARDEN HOSE, TWICE. THE SAME DAY AS INSTALLATION TO ELIMINATE AIR POCKETS IN THE
- CURB TO ALLOW FOR VEHICLE BUMPER OVERHANG.
- 9. PROPOSED TREES SHALL NOT BE PLACED OVER EXISTING OR PROPOSED UTILITY SERVICE LINES. IT IS THE CONTRACTOR'S RESPONSIBILITY TO UNDERSTAND UTILITY LOCATIONS AND HAVE THEM MARKED DURING TREE PLANTING OPERATIONS. IF UTILITY IS DAMAGED DURING PLANTING, CONTRACTOR IS RESPONSIBLE FOR NOTIFYING THE GENERAL CONTRACTOR AND OWNER OF UTILITY AND PAYING FOR REPAIR OF THE DAMAGED UTILITY.
- MULCH UNLESS OTHERWISE SPECIFIED.

- - SPECIFICATIONS.
- 3. CONTRACTOR SHALL VERIFY ALL LANDSCAPE MATERIAL QUANTITIES AND SHALL REPORT ANY DISCREPANCIES IMMEDIATELY TO THE LANDSCAPE ARCHITECT.
- INDIVIDUAL SPECIES AND HOW IT IS BEING USED.
- (SEE DETAIL, THIS SHEET).
- 8. NO PLANTINGS SHALL BE PLACED CLOSER THAN 3' FROM THE BACK OF THE
- 10. ALL PLANTING BEDS WILL HAVE 3-INCHES OF SHREDDED BROWN HARDWOOD

#### PLANT SCHEDULE

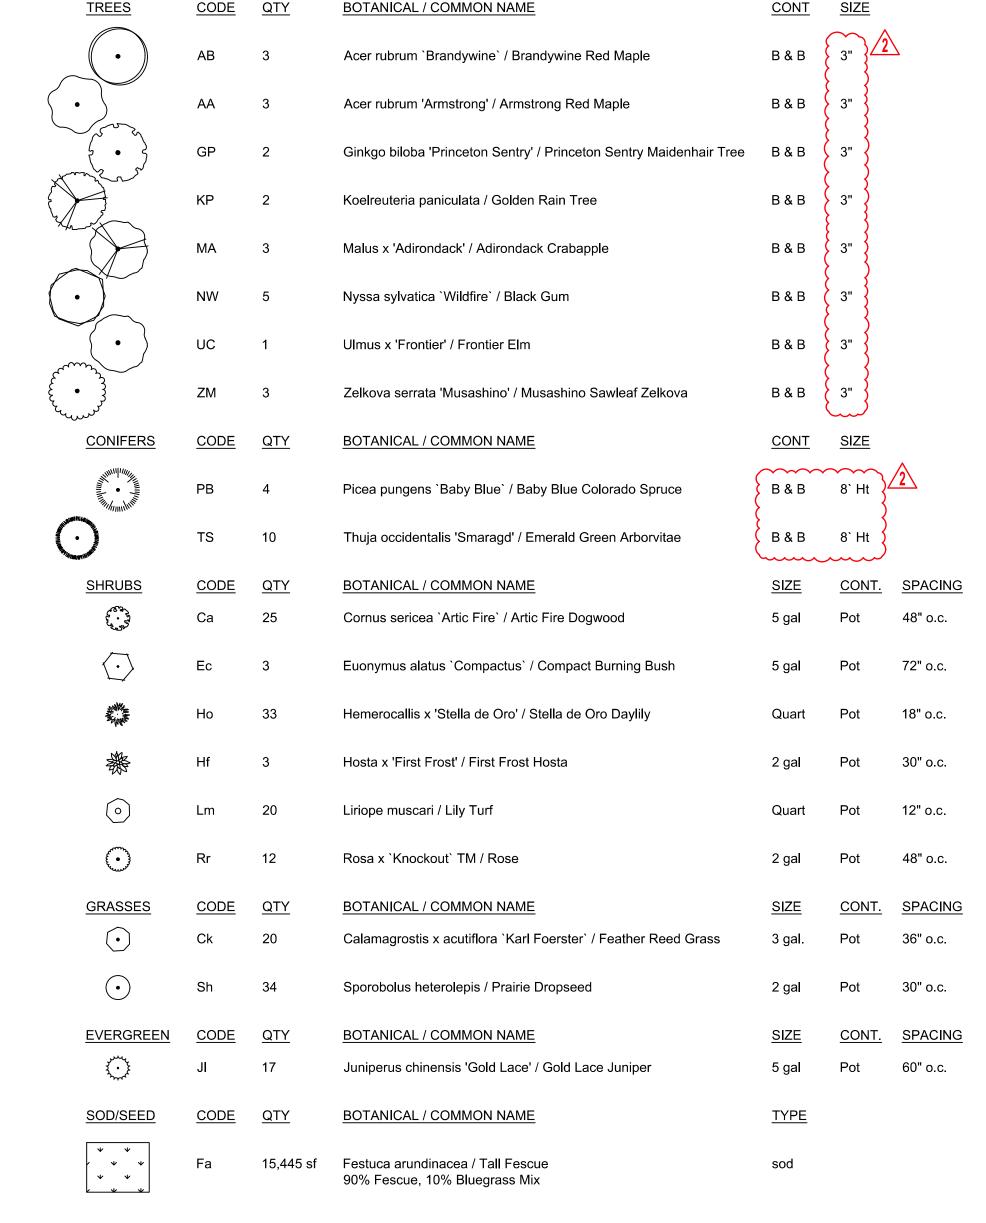

DRAWN BY: CHK'D BY: © GLMV Architecture, Inc. All work herein is the property of GLMV Architecture, Inc. and is not to be copied or used in any way without the express written consent of GLMV Architecture, Inc. LANDSCAPE CONSTRUCTION

As Noted on Plans Review

Lee's Summit, Missouri 12/30/2022

SCHEDULE

**GLMV**Architecture

9229 WARD PARKWAY

SUITE # 210

KANSAS CITY, MO 64114

TEL: (816) 444-4200 FAX: (316) 265-5646

www.glmv.com

GLMV ARCHITECTURE, INC. MISSOURI STATE CERTIFICATE OF AUTHORITY

CIVIL ENGINEER & LANDSCAPE ARCH.

MISSOURI CIVIL COA #2018033898

MISSOURI LANDSCAPE COA #000008

9229 WARD PARKWAY, SUITE # 210

GLMV ARCHITECTURE, INC

KANSAS CITY, MO 64114

STRUCTURAL ENGINEER

MISSOURI COA #001644

(816) 444-3144 PHONE

MISSOURI COA #01022

15902 MIDLAND DRIVE

SHAWNEE, KS 66217

(913) 362-9090 PHONE

**SECURITY & IT ENGINEERS** 

HENDERSON ENGINEERS

MISSOURI COA # 000556

KANSAS CITY, MO 64108

(816) 663-8700 PHONE

1801 MAIN STREET, SUITE 300

150 64082

Description Date

WARD

KYLE WARD - LANDSCAPE ARCHITECT

MO# PLA-2016002020

18225R21001

10.26.2022

KDW

PROJECT NO:

DATE:

ASI 02 11.22.2022

Z O ≥

STATIC - LEE'S SU

FIRE CITY OF

REVISIONS:

250 NE MURBERRY, SUITE 201

**MECH., ELEC. & PLUMBING ENGINEERS** 

LEE'S SUMMIT, MO, 64086

**HOSS & BROWN ENGINEERS** 

TEL: (816) 444-4200

LEIGH + O'KANE

PLEASE CONSIDER THE ENVIRONMENT

PLANTING BED EDGING (NOT-

REF: 6/L-100

COMPACTED PLANTING SOIL

**SHRUB PLANTING** 

MIXTURE ON WHICH TO

POSITION SHRUB -

REQUIRED IN PLANTING BEDS SURROUNDED BY PAVEMENT)

GRADE

NOTE: PRUNE ALL BROKEN AND DAMAGED

PLANTING SOIL BACKFILL

PLANTING SOIL BACKFILL

3" DEPTH HARDWOOD MULCH

REMOVE TOP 1/3 OF BURLAP

REMOVE CONTAINER AND SLASH

SIDES OF ROOTBALL WITH (4) TO

AND ROPE FROM BALL OR


UNDISTURBED SUBGRADE

(5) 1" DEEP CUTS.

BRANCHES, AFTER PLANTING

ANDSCAPE SCHEDULE

BEFORE PRINTING THIS

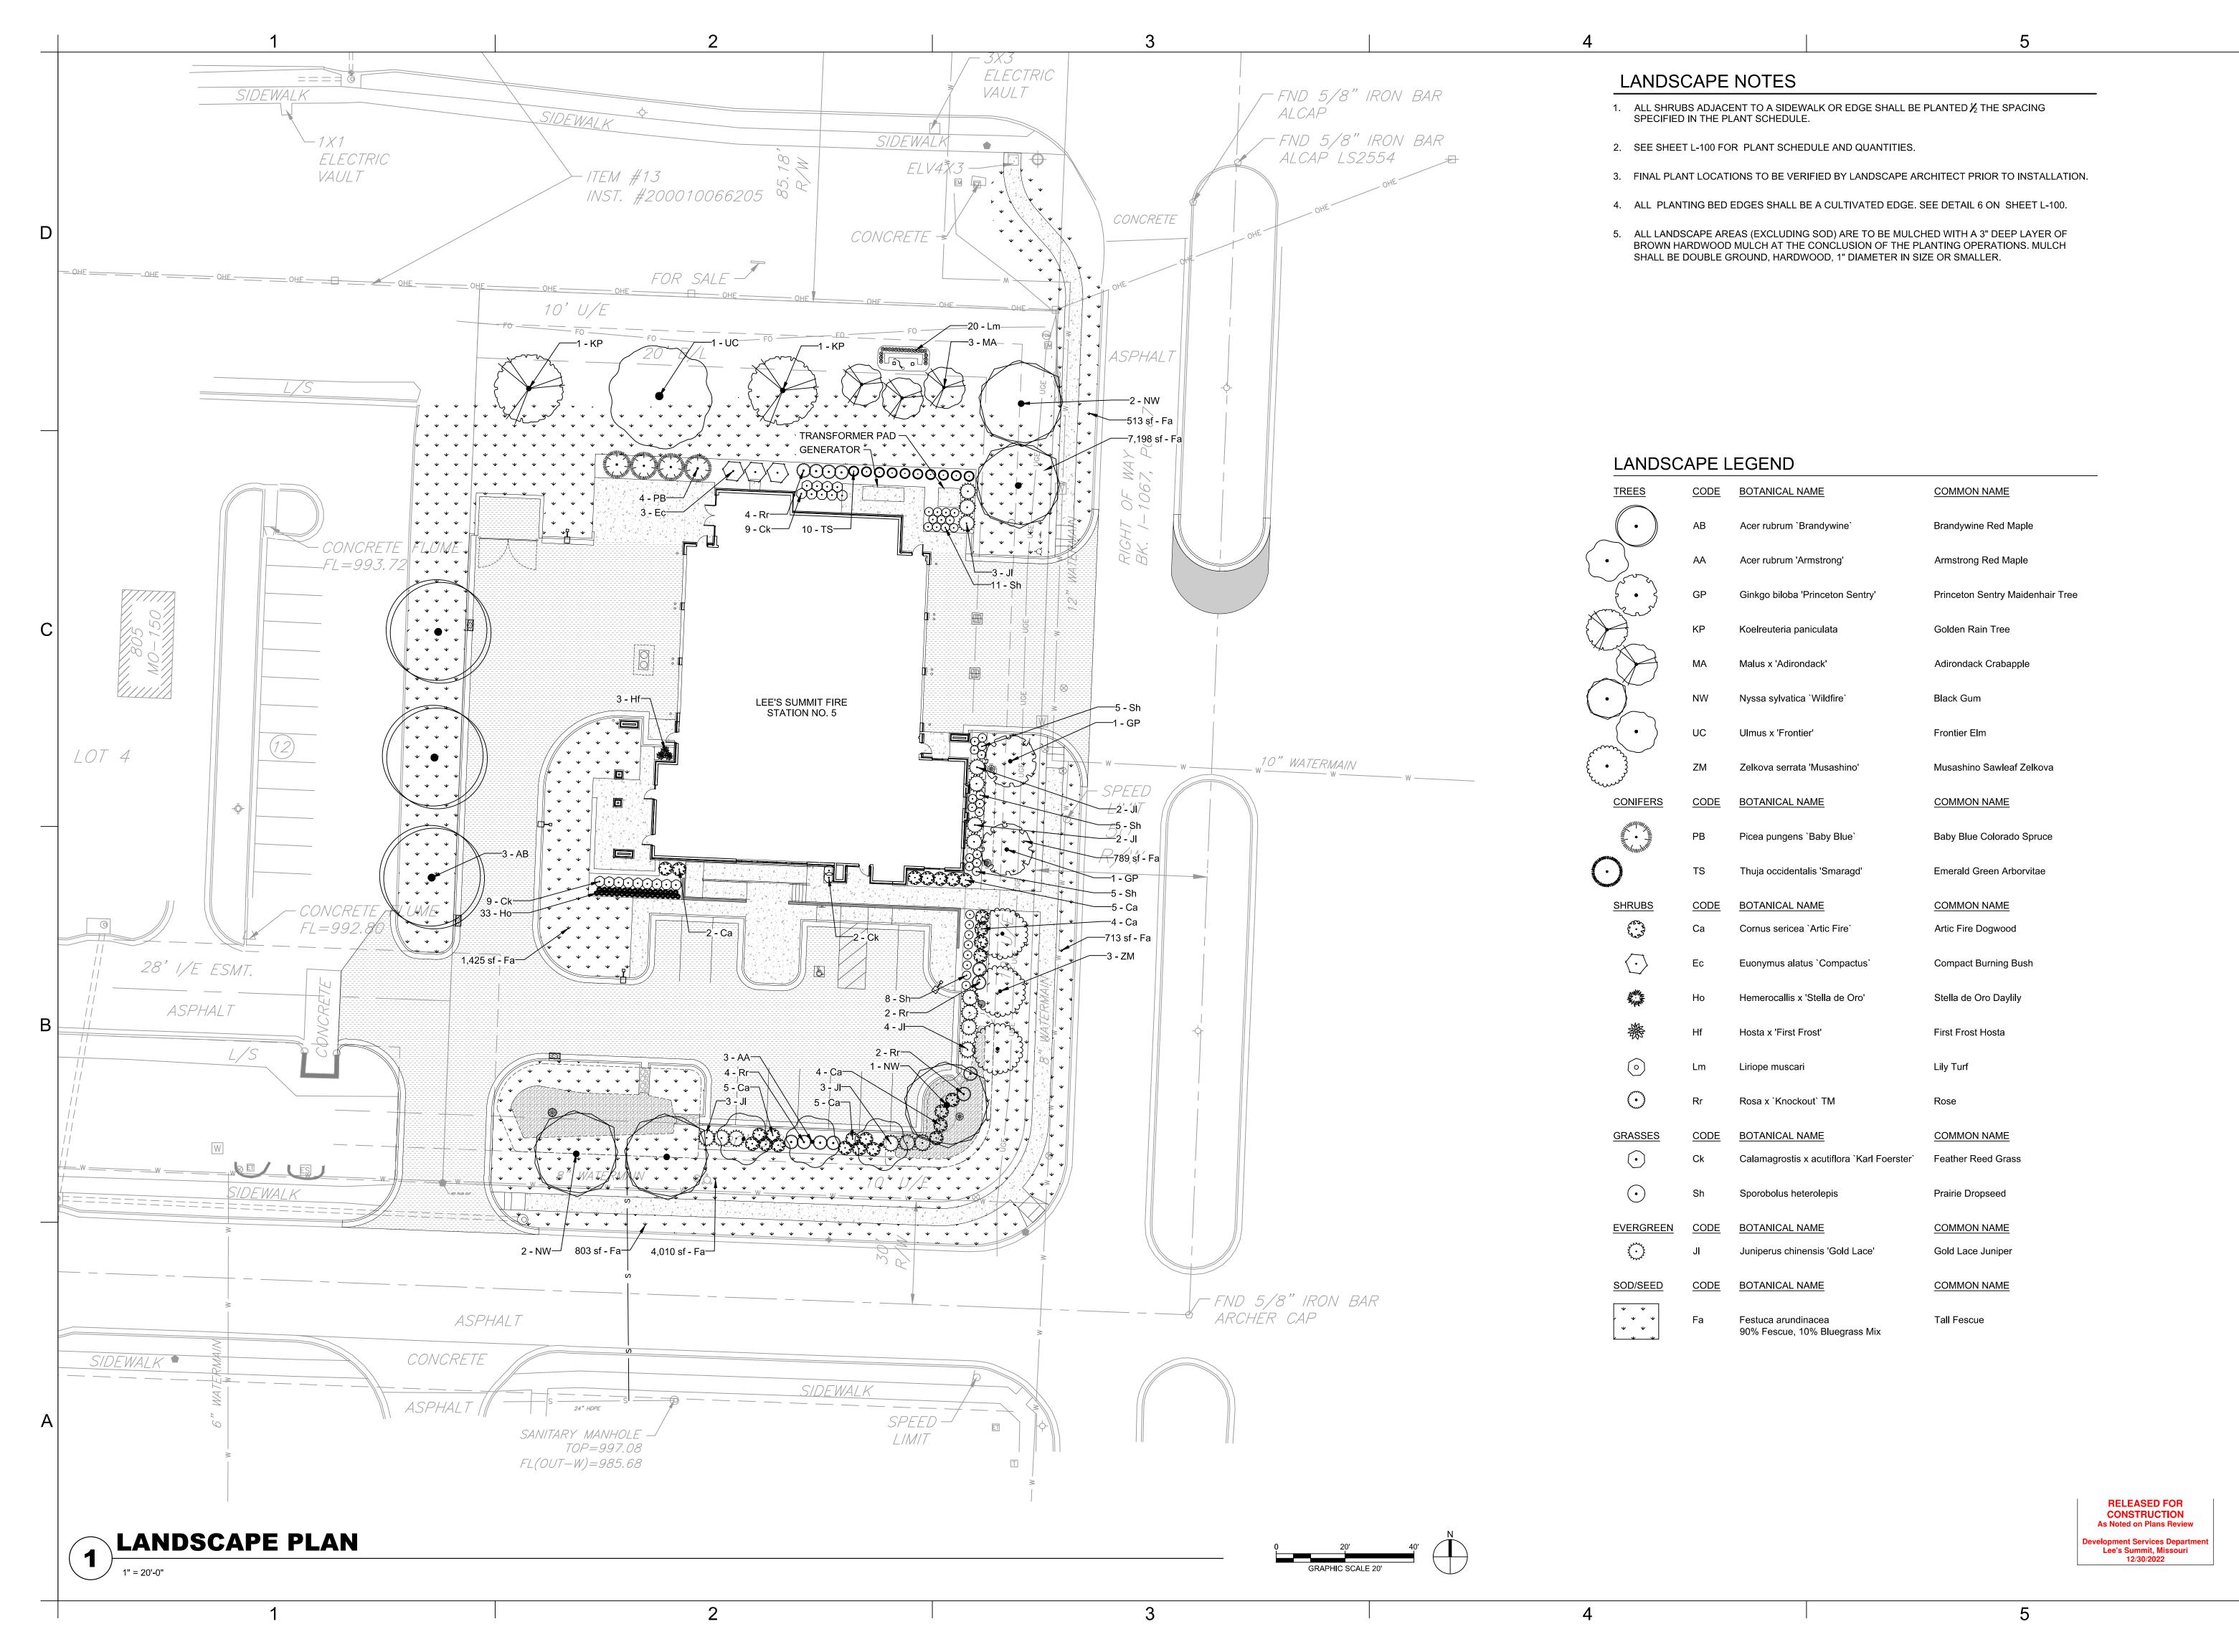

**GLMV**Architecture

9229 WARD PARKWAY SUITE # 210 KANSAS CITY, MO 64114 TEL: (816) 444-4200 FAX: (316) 265-5646 www.glmv.com

GLMV ARCHITECTURE, INC. MISSOURI STATE CERTIFICATE OF AUTHORITY #000305

CIVIL ENGINEER & LANDSCAPE ARCH. GLMV ARCHITECTURE, INC MISSOURI CIVIL COA #2018033898 MISSOURI LANDSCAPE COA #000008 9229 WARD PARKWAY, SUITE # 210 KANSAS CITY, MO 64114 TEL: (816) 444-4200

STRUCTURAL ENGINEER LEIGH + O'KANE MISSOURI COA #001644 250 NE MURBERRY, SUITE 201 LEE'S SUMMIT, MO, 64086

15902 MIDLAND DRIVE SHAWNEE, KS 66217


(816) 444-3144 PHONE MECH., ELEC. & PLUMBING ENGINEERS HOSS & BROWN ENGINEERS MISSOURI COA #01022

(913) 362-9090 PHONE SECURITY & IT ENGINEERS HENDERSON ENGINEERS MISSOURI COA # 000556

1801 MAIN STREET, SUITE 300 KANSAS CITY, MO 64108 (816) 663-8700 PHONE

IIGHWAY 150 MISSOURI 64082 801 MISSOURI HIC LEE'S SUMMIT, MI FIRE STATIC

REVISIONS: # Description Date

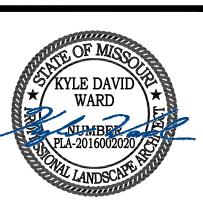

KYLE WARD - LANDSCAPE ARCHITECT MO# PLA-2016002020

PROJECT NO: 18225R21001 DATE: 10.26.2022 DRAWN BY: KDW CHK'D BY: CDW

© GLMV Architecture, Inc. All work herein is the property of GLMV Architecture, Inc. and is not to be copied or used in any way without the express written consent of GLMV Architecture, Inc.

LANDSCAPE **PLAN** 

STRUCTURE AND, EXCEPT WHERE SPECIFICALLY SHOWN, DO NOT INDICATE THE METHOD OR MEANS OF CONSTRUCTION. THE CONTRACTOR SHALL SUPERVISE AND DIRECT THE WORK AND SHALL BE SOLELY RESPONSIBLE FOR ALL CONSTRUCTION MEANS, METHODS, PROCEDURES, TECHNIQUES, AND SEQUENCES. THE ENGINEER SHALL NOT HAVE CONTROL NOR CHARGE OF, AND SHALL NOT BE RESPONSIBLE FOR, CONSTRUCTION MEANS, METHODS, PROCEDURES, TECHNIQUES, OR SEQUENCES, FOR SAFETY PRECAUTIONS AND PROGRAMS IN CONNECTION WITH THE WORK, FOR THE ACTS OR OMISSION OF THE CONTRACTOR, SUBCONTRACTOR, OR AN OTHER PERSONS PERFORMING ANY OF THE WORK, OR THE FAILURE OF ANY OF THEM TO CARRY OUT THE WORK IN ACCORDANCE WITH THE CONTRACT DOCUMENTS. PERIODIC SITE OBSERVATION BY FIELD REPRESENTATIVES OF LEIGH & O'KANE L.L.C. IS SOLELY FOR THE PURPOSE OF DETERMINING IF THE WORK OF THE CONTRACTOR IS PROCEEDING IN ACCORDANCE WITH THE STRUCTURAL CONTRACT DOCUMENTS. THIS LIMITED SITE OBSERVATION SHOULD NOT BE CONSTRUED AS EXHAUSTIVE OR CONTINUOUS TO CHECK THE QUALITY OR QUANTITY OF WORK, BUT RATHER PERIODIC IN AN EFFORT TO GUARD THE OWNER AGAINST DEFECTS AND DEFICIENCIES IN THE WORK OF THE CONTRACTOR. ALL SHOP DRAWINGS AND SUBMITTALS MUST BE REVIEWED AND APPROVED BY THE CONTRACTOR PRIOR TO SUBMITTAL. ENGINEER'S REVIEW OF SHOP DRAWINGS IS LIMITED TO CHECKING FOR GENERAL CONFORMANCE WITH DESIGN DRAWINGS AND STRENGTH OF COMPONENTS AND MATERIALS. CONTRACTOR IS RESPONSIBLE FOR ANY CHANGES FROM THE DESIGN DRAWINGS, QUANTITIES, DIMENSIONAL ERRORS, OR OMISSIONS IN THE SHOP DRAWINGS. ALL SHOP DRAWINGS MUST BE ORIGINAL DOCUMENTS AND SHALL NOT BE REPRODUCTIONS OF THESE CONTRACT DOCUMENTS. SUBMIT SHOP DRAWINGS DETAILING FABRICATION OF EACH MEMBER AND ITS CONNECTIONS. DETAIL DRAWINGS ARE TO BE PREPARED UNDER THE SUPERVISION OF A LICENSED PROFESSIONAL ENGINEER IN THE STATE OF MISSOURI FOR THE FOLLOWING ITEMS. LIGHT GAGE METAL FRAMING COLD FORMED BAR JOISTS CONTRACTOR SHALL SUBMIT STRUCTURAL SHOP DRAWINGS FOR THE FOLLOWING ITEMS. CONCRETE MIX DESIGN AND MATERIALS CONCRETE REINFORCING STEEL MASONRY REINFORCING STEEL LIGHT GAGE METAL FRAMING COLD FORMED ROOF, FLOOR JOISTS AND JOIST GIRDERS PROVIDE A FINAL, "FOR CONSTRUCTION" SET OF ALL SHOP DRAWINGS TO THE ENGINEER OF RECORD PRIOR TO FABRICATION OR CONSTRUCTION OF THOSE ITEMS SPECIAL INSPECTIONS THE FOLLOWING MINIMUM ITEMS REQUIRE SPECIAL INSPECTION IN ACCORDANCE WITH THE BUILDING CODE. LOCAL CITY MAY REQUIRE ADDITIONAL SPECIAL INSPECTIONS. CONCRETE PLACING CONCRETE REINFORCING STEEL BOLTING STEEL WELDING BOLTS EMBEDDED IN CONCRETE / POST-INSTALLED ANCHORS ANCHOR RODS ROOF DIAPHRAGM ATTACHMENT MASONRY SOIL VERIFICATION THE CONTRACTOR SHALL REQUEST SPECIAL INSPECTION OF THE ITEMS LISTED ABOVE PRIOR TO THOSE ITEMS BECOMING INACCESSIBLE AND UNOBSERVABLE DUE TO PROGRESSION OF STRUCTURAL OBSERBATIONS SHALL BE PROVIDED DURING CONSTRUCTION OF THE SHELTER BY A REGISTERED PROFESSIONAL

THE CONTRACT STRUCTURAL DRAWINGS AND SPECIFICATIONS REPRESENT THE FINISHED

STRUCTURAL ENGINEER SITE OBSERVATIONS

CONN. CONNECTION CONT CONTINUOUS CONTROL JOINT DETAIL DIAMETER DIM. DIMENSION DWG(S) DRAWING(S) EACH ELEV. **ELEVATION ELEVATION EQUAL** EQUIP **EQUIPMENT EXIST EXISTING** EXT. EXTERIOR FAR SIDE FINISH **FLOOR** FOOTING FOUND. FOUNDATION GALV. **GALVANIZED** GYP. **GYPSUM** HATCH PATTERN KEY HEADED STUD HIGH HORIZONTAL HORIZ. = CONCRETE IN SECTION INSUL. **INSULATION** INTERIOR LOC. LOCATION LONG LEG HORIZONTAL LONG LEG OUT LONG LEG VERTICAL LONG. LONGITUDINAL LOW MSRY. MASONRY MAX. **MAXIMUM** MECH. **MECHANICAL MINIMUM MIRRORED NEAR SIDE** NOT APPLICABLE N.T.S. NOT TO SCALE ON CENTER OPNG. OPENING PLATE RADIUS REFERENCE **REINF** REINFORCING REQ'D **REQUIRED** SCHED. **SCHEDULE** SEC. **SECTION** SHT. SHEET SIMILAR **SQUARE** STAINLESS STEEL STEEL T&B TOP & BOTTOM TOP OF TRANS. TRANSVERSE TYP. TYPICAL U.N.O. **UNLESS NOTED** 

STANDARD ABBREVIATIONS

ALTERNATE

ARCHITECT

BOTTOM

**BOTTOM OF** 

**CENTER LINE** 

BUILDING

CLEAR

COLUMN

CONCRETE

**OTHERWISE** 

VERTICAL

WITH WITHOUT

VERT.

ARCH.

BLDG.

CONC.

**ANCHOR BOLT** 

**GLMVArchitecture** 

9229 WARD PARKWAY SUITE # 210 KANSAS CITY, MO 64114 TEL: (816) 444-4200 FAX: (316) 265-5646 www.glmv.com

GLMV ARCHITECTURE, INC.

MISSOURI STATE CERTIFICATE OF AUTHORITY #000305

LANDSCAPE ARCHITECT GLMV ARCHITECTURE, INC MISSOURI COA #000008 9229 WARD PARKWAY, SUITE # 210 KANSAS CITY, MO 64114 TEL: (816) 444-4200

CIVIL ENGINEER GLMV ARCHITECTURE, INC MISSOURI COA #2018033898 9229 WARD PARKWAY, SUITE # 210 KANSAS CITY, MO 64114 TEL: (816) 444-4200


STRUCTURAL ENGINEER LEIGH + O'KANE MISSOURI COA #001644 250 NE MULBERRY, SUITE 201 LEE'S SUMMIT, MO 64086

(816) 444-3144 MECH., ELECT. & PLMG. ENGINEERS **HOSS & BROWN ENGINEERS** MISSOURI COA #01022 15902 MIDLAND DRIVE SHAWNEE, KS 66217

(913) 362.9090 SECURITY & IT ENGINEERS HENDERSON ENGINEERS MISSOURI COA #000556 1801 MAIN STREET, SUITE 300 KANSAS CITY, MO 64108 (816) 663-8700

**ш** 5 ≥ ഗ

Description

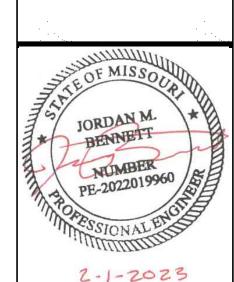

PROJECT NO: 18225R21001 02/01/2023 DRAWN BY CHK'D BY:

All work herein is the property of GLMV Architecture, Inc. and is not to be copied or used in any way without the express written consent of GLMV Architecture, Inc.

© GLMV Architecture, Inc.


**GENERAL NOTES** 

BEFORE PRINTING THIS

= EARTH IN SECTION = EPOXY IN SECTION = EXISTING IN PLAN AND SECTION = GRANULAR FILL IN SECTION = GRATING IN PLAN AND SECTION = GROUT IN SECTION = INSULATION IN SECTION = OPENINGS IN PLAN = PLYWOOD IN SECTION = SNOW DRIFT LOADING IN PLAN = STEEL IN SECTION = TOPPING IN SECTION

= WOOD END GRAIN IN SECTION

= WOOD FACE GRAIN IN SECTION

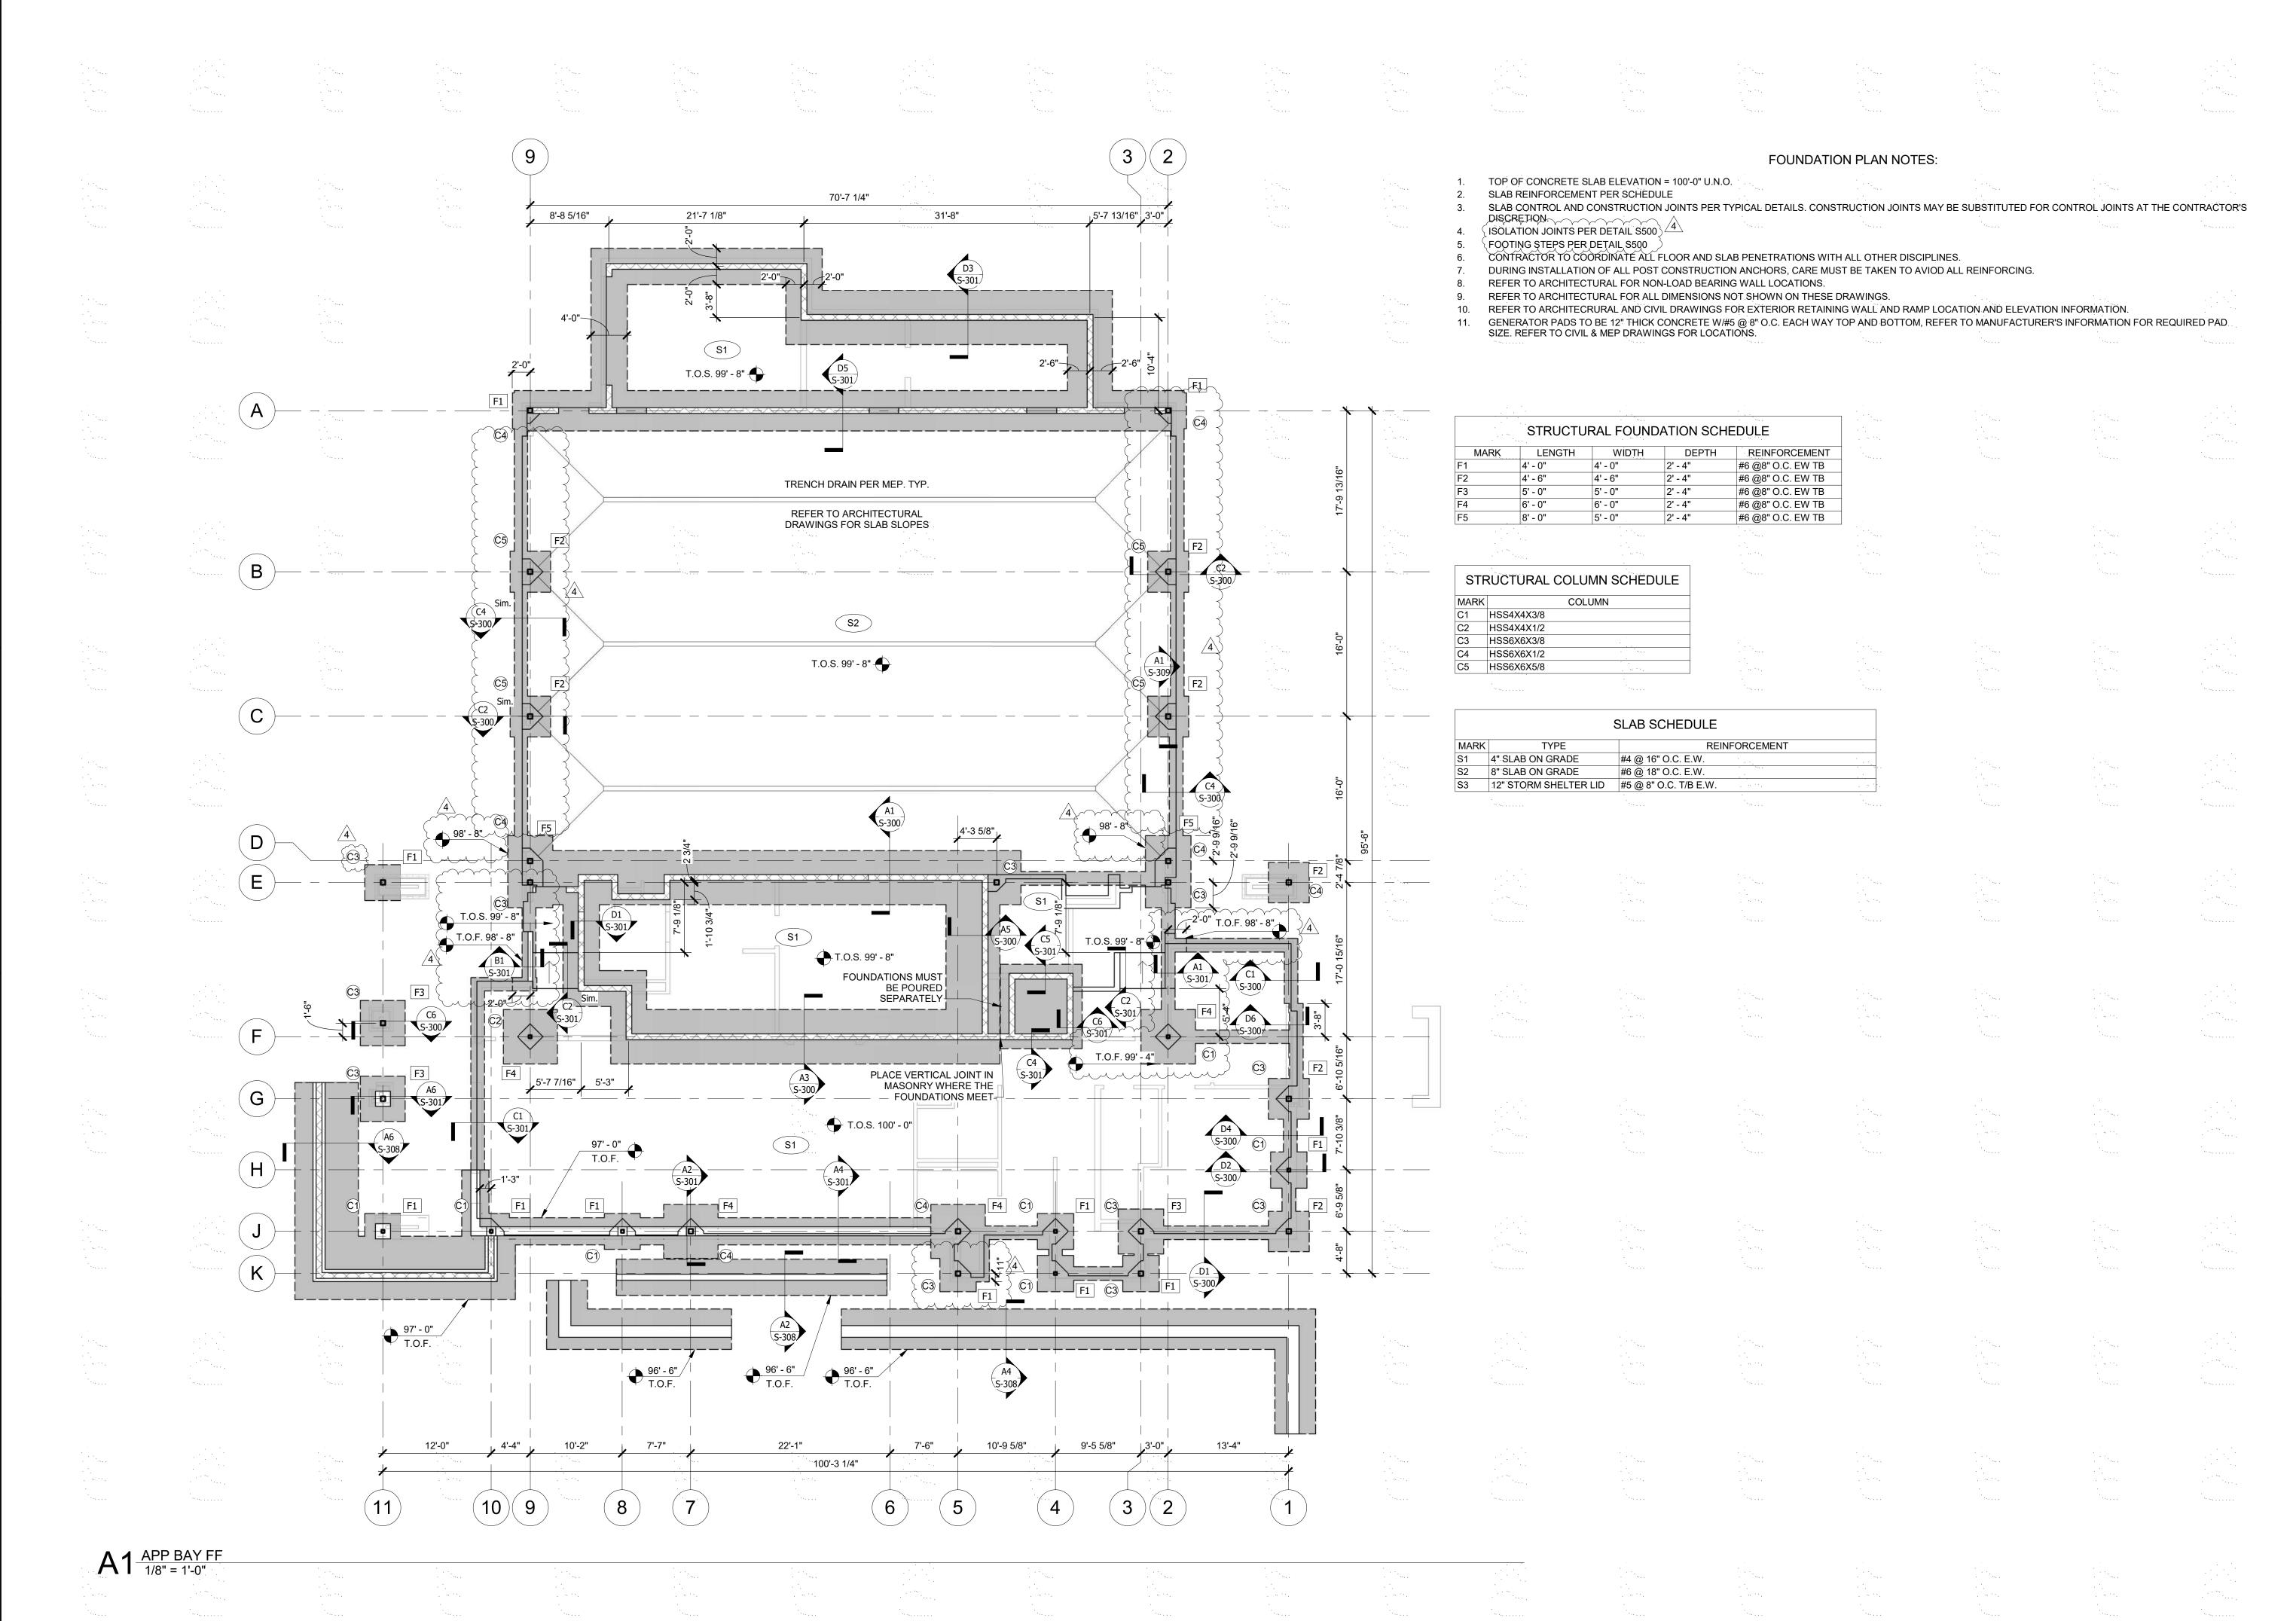



9229 WARD PARKWAY SUITE # 210 KANSAS CITY, MO 64114 TEL: (816) 444-4200 FAX: (316) 265-5646 www.glmv.com

GLMV ARCHITECTURE, INC.
MISSOURI STATE CERTIFICATE OF AUTHORITY
#000305

LANDSCAPE ARCHITECT
GLMV ARCHITECTURE, INC
MISSOURI COA #000008
9229 WARD PARKWAY, SUITE # 210
KANSAS CITY, MO 64114
TEL: (816) 444-4200

CIVIL ENGINEER
GLMV ARCHITECTURE, INC
MISSOURI COA #2018033898
9229 WARD PARKWAY, SUITE # 210

KANSAS CITY, MO 64114 TEL: (816) 444-4200 STRUCTURAL ENGINEER LEIGH + O'KANE MISSOURI COA #001644

250 NE MULBERRY, SUITE 201

LEE'S SUMMIT, MO 64086
(816) 444-3144

MECH., ELECT. & PLMG. ENGINEERS
HOSS & BROWN ENGINEERS
MISSOURI COA #01022
15902 MIDLAND DRIVE


SHAWNEE, KS 66217
(913) 362.9090

SECURITY & IT ENGINEERS
HENDERSON ENGINEERS
MISSOURI COA #000556
1801 MAIN STREET, SUITE 300

HENDERSON ENGINEERS MISSOURI COA #000556 1801 MAIN STREET, SUITE 300 KANSAS CITY, MO 64108 (816) 663-8700

> HIGHWAY 150 , MISSOURI 64082

FIRE STATIC CITY OF LEE'S SU

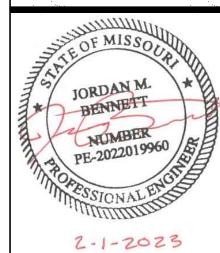


PROJECT NO:	18225R21001					
DATE:	02/01/2023					
DRAWN BY:	JMB					
CHK'D BY:	WNH					
•	© GLMV Architecture, Inc. All work herein is the property of GLMV Architecture, Inc. and					

written consent of GLMV Architecture, Inc.

PLAN

**0**-100

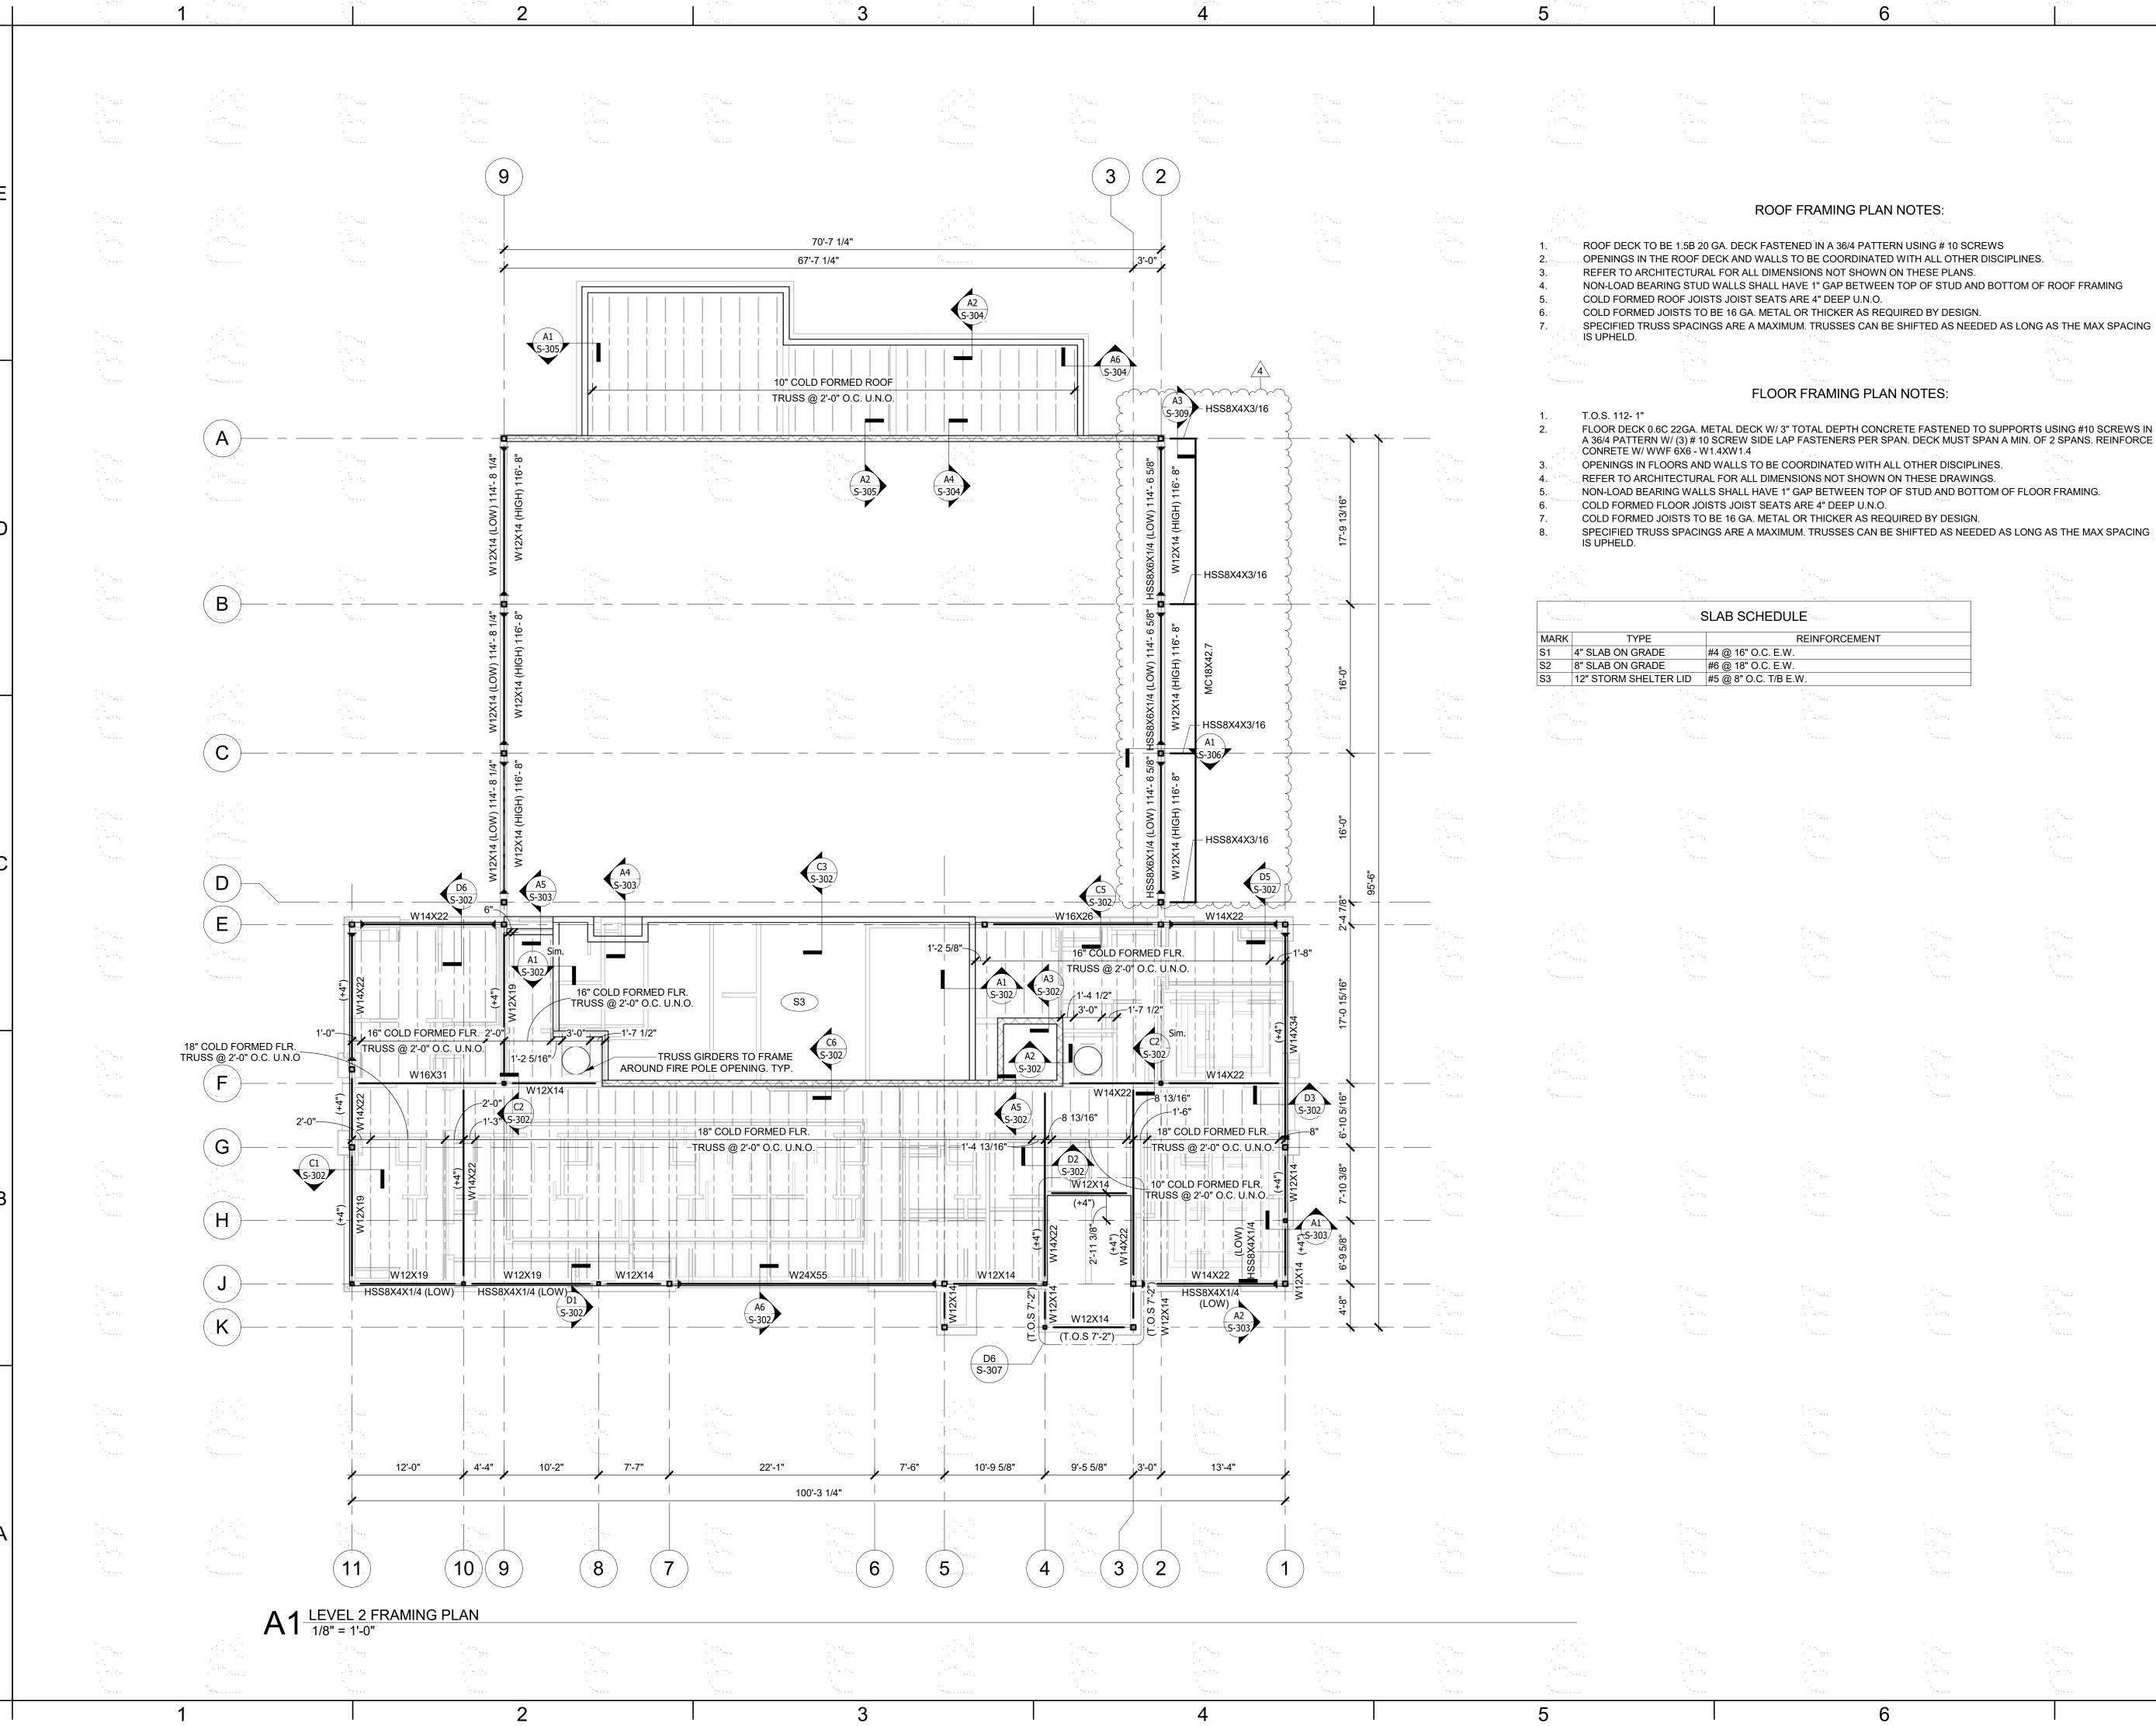



- ROOF DECK TO BE 1.5B 20 GA. DECK FASTENED IN A 36/4 PATTERN USING # 10 SCREWS
- OPENINGS IN THE ROOF DECK AND WALLS TO BE COORDINATED WITH ALL OTHER DISCIPLINES.
- REFER TO ARCHITECTURAL FOR ALL DIMENSIONS NOT SHOWN ON THESE PLANS.
- NON-LOAD BEARING STUD WALLS SHALL HAVE 1" GAP BETWEEN TOP OF STUD AND BOTTOM OF ROOF FRAMING
- COLD FORMED ROOF JOISTS JOIST SEATS ARE 4" DEEP U.N.O.
- COLD FORMED JOISTS TO BE 16 GA. METAL OR THICKER AS REQUIRED BY DESIGN.
- SPECIFIED TRUSS SPACINGS ARE A MAXIMUM. TRUSSES CAN BE SHIFTED AS NEEDED AS LONG AS THE MAX SPACING

- FLOOR DECK 0.6C 22GA. METAL DECK W/ 3" TOTAL DEPTH CONCRETE FASTENED TO SUPPORTS USING #10 SCREWS IN
- CONRETE W/ WWF 6X6 W1.4XW1.4
- OPENINGS IN FLOORS AND WALLS TO BE COORDINATED WITH ALL OTHER DISCIPLINES. REFER TO ARCHITECTURAL FOR ALL DIMENSIONS NOT SHOWN ON THESE DRAWINGS.
- NON-LOAD BEARING WALLS SHALL HAVE 1" GAP BETWEEN TOP OF STUD AND BOTTOM OF FLOOR FRAMING.
- COLD FORMED FLOOR JOISTS JOIST SEATS ARE 4" DEEP U.N.O.
- SPECIFIED TRUSS SPACINGS ARE A MAXIMUM. TRUSSES CAN BE SHIFTED AS NEEDED AS LONG AS THE MAX SPACING

$\circ$	۸ D	$\circ$	11	

******		
MARK	TYPE	REINFORCEMENT
S1	4" SLAB ON GRADE	#4 @ 16" O.C. E.W.
S2	8" SLAB ON GRADE	#6 @ 18" O.C. E.W.



9229 WARD PARKWAY SUITE # 210 KANSAS CITY, MO 64114 TEL: (816) 444-4200 FAX: (316) 265-5646 www.glmv.com

GLMV ARCHITECTURE, INC. MISSOURI STATE CERTIFICATE OF AUTHORITY #000305

LANDSCAPE ARCHITECT GLMV ARCHITECTURE, INC MISSOURI COA #000008 9229 WARD PARKWAY, SUITE # 210 KANSAS CITY, MO 64114 TEL: (816) 444-4200

CIVIL ENGINEER GLMV ARCHITECTURE, INC MISSOURI COA #2018033898 9229 WARD PARKWAY, SUITE # 210 KANSAS CITY, MO 64114


TEL: (816) 444-4200 STRUCTURAL ENGINEER LEIGH + O'KANE MISSOURI COA #001644 250 NE MULBERRY, SUITE 201


LEE'S SUMMIT, MO 64086 (816) 444-3144 MECH., ELECT. & PLMG. ENGINEERS HOSS & BROWN ENGINEERS MISSOURI COA #01022 15902 MIDLAND DRIVE

SHAWNEE, KS 66217 (913) 362.9090 **SECURITY & IT ENGINEERS** HENDERSON ENGINEERS MISSOURI COA #000556

1801 MAIN STREET, SUITE 300 KANSAS CITY, MO 64108 (816) 663-8700

FIRE STATIC CITY OF LEE'S SU

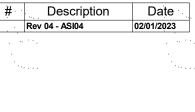


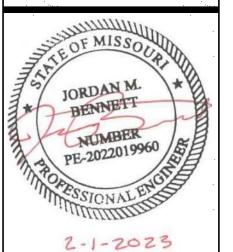

DATE	
DATE:	02/01/2023
DRAWN BY:	JMB
CHK'D BY:	WNH

is not to be copied or used in any way without the express written consent of GLMV Architecture, Inc. LEVEL 2

FRAMING PLAN

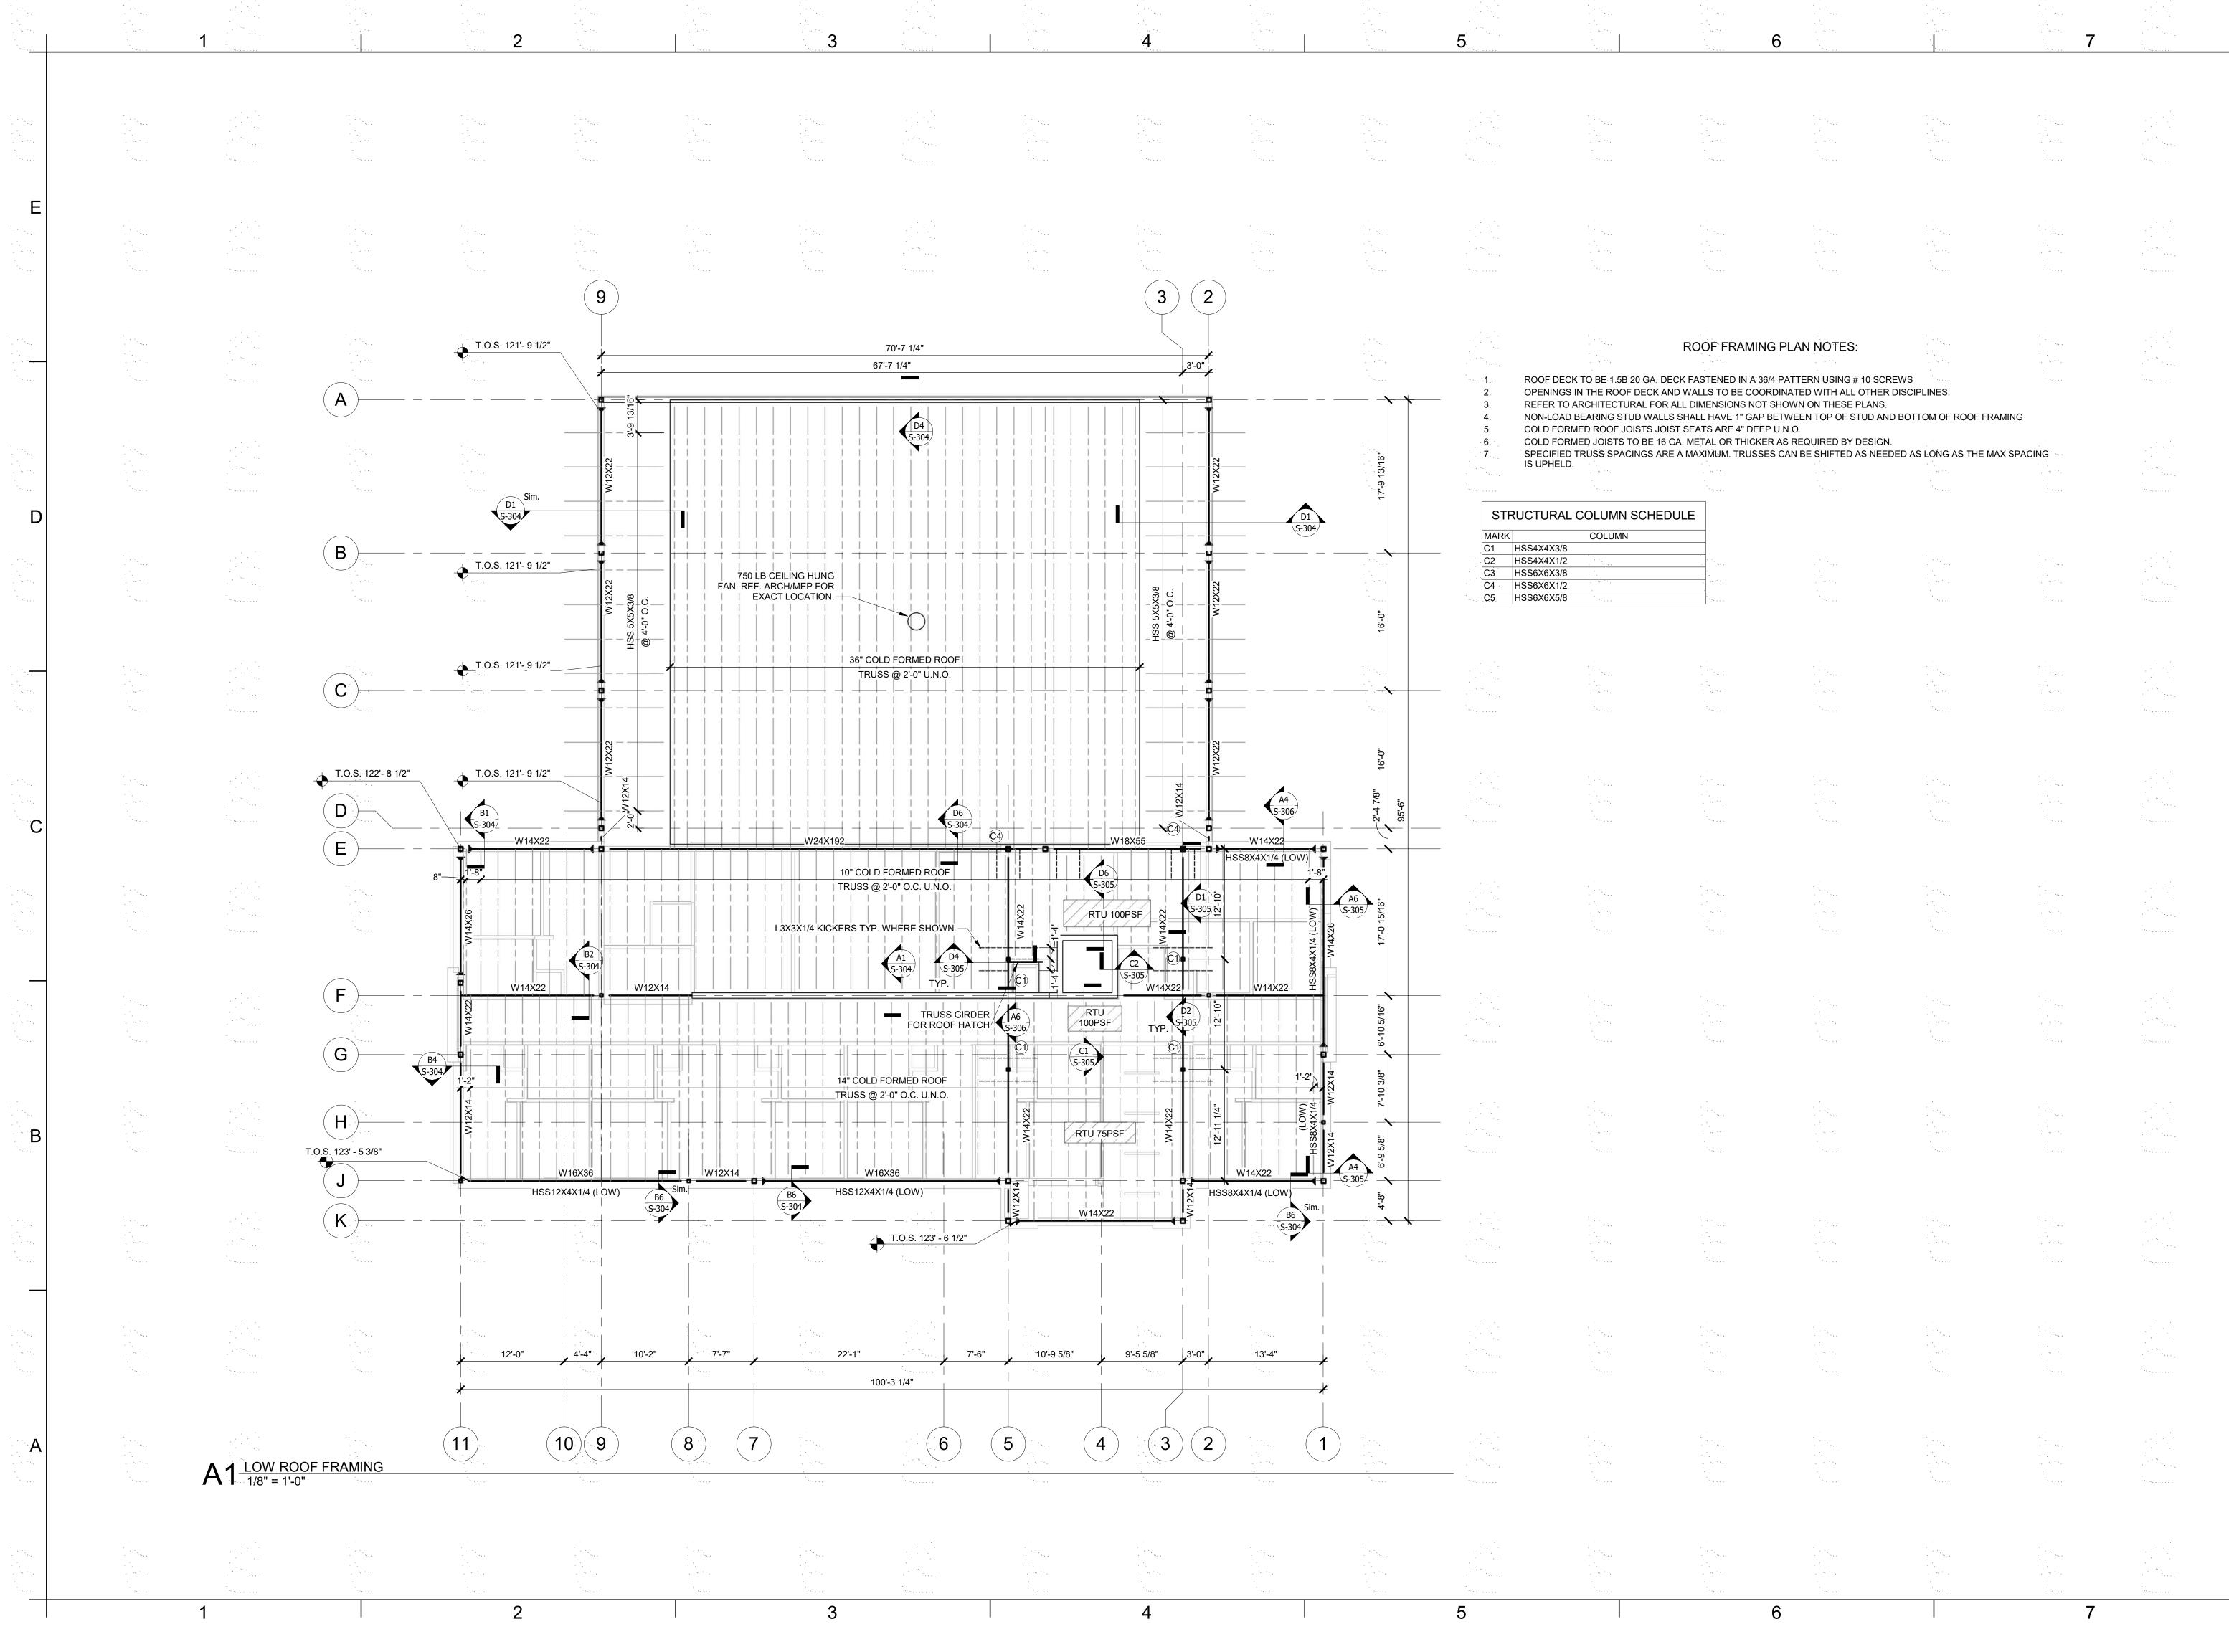



9229 WARD PARKWAY SUITE # 210 KANSAS CITY, MO 64114 TEL: (816) 444-4200 FAX: (316) 265-5646 www.glmv.com

GLMV ARCHITECTURE, INC.
MISSOURI STATE CERTIFICATE OF AUTHORITY
#000305

LANDSCAPE ARCHITECT
GLMV ARCHITECTURE, INC
MISSOURI COA #000008
9229 WARD PARKWAY, SUITE # 210
KANSAS CITY, MO 64114
TEL: (816) 444-4200

CIVIL ENGINEER
GLMV ARCHITECTURE, INC
MISSOURI COA #2018033898
9229 WARD PARKWAY, SUITE # 210
KANSAS CITY, MO 64114
TEL: (816) 444-4200

STRUCTURAL ENGINEER
LEIGH + O'KANE
MISSOURI COA #001644
250 NE MULBERRY, SUITE 201
LEE'S SUMMIT, MO 64086

(816) 444-3144


MECH., ELECT. & PLMG. ENGINEERS HOSS & BROWN ENGINEERS MISSOURI COA #01022 15902 MIDLAND DRIVE SHAWNEE, KS 66217 (913) 362.9090

SECURITY & IT ENGINEERS
HENDERSON ENGINEERS
MISSOURI COA #000556
1801 MAIN STREET, SUITE 300
KANSAS CITY, MO 64108
(816) 663-8700

IIGHWAY 150 MISSOURI 64082

FIRE STATION #5
CITY OF LEE'S SUMMIT
801 MISSOURI HIGHWAY
LEE'S SUMMIT, MISSOUR


|SIONS: | Description Date | ASI 01 | 11/16/2022

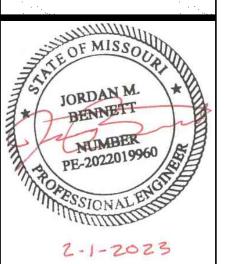



PROJECT NO:	18225R21001	
DATE:	02/01/2023	
DRAWN BY:	JMB	
CHK'D BY:	WNH	
	© GLMV Architecture, Inc.	


All work herein is the property of GLMV Architecture, Inc. and is not to be copied or used in any way without the express written consent of GLMV Architecture, Inc.


FRAMING PLAN

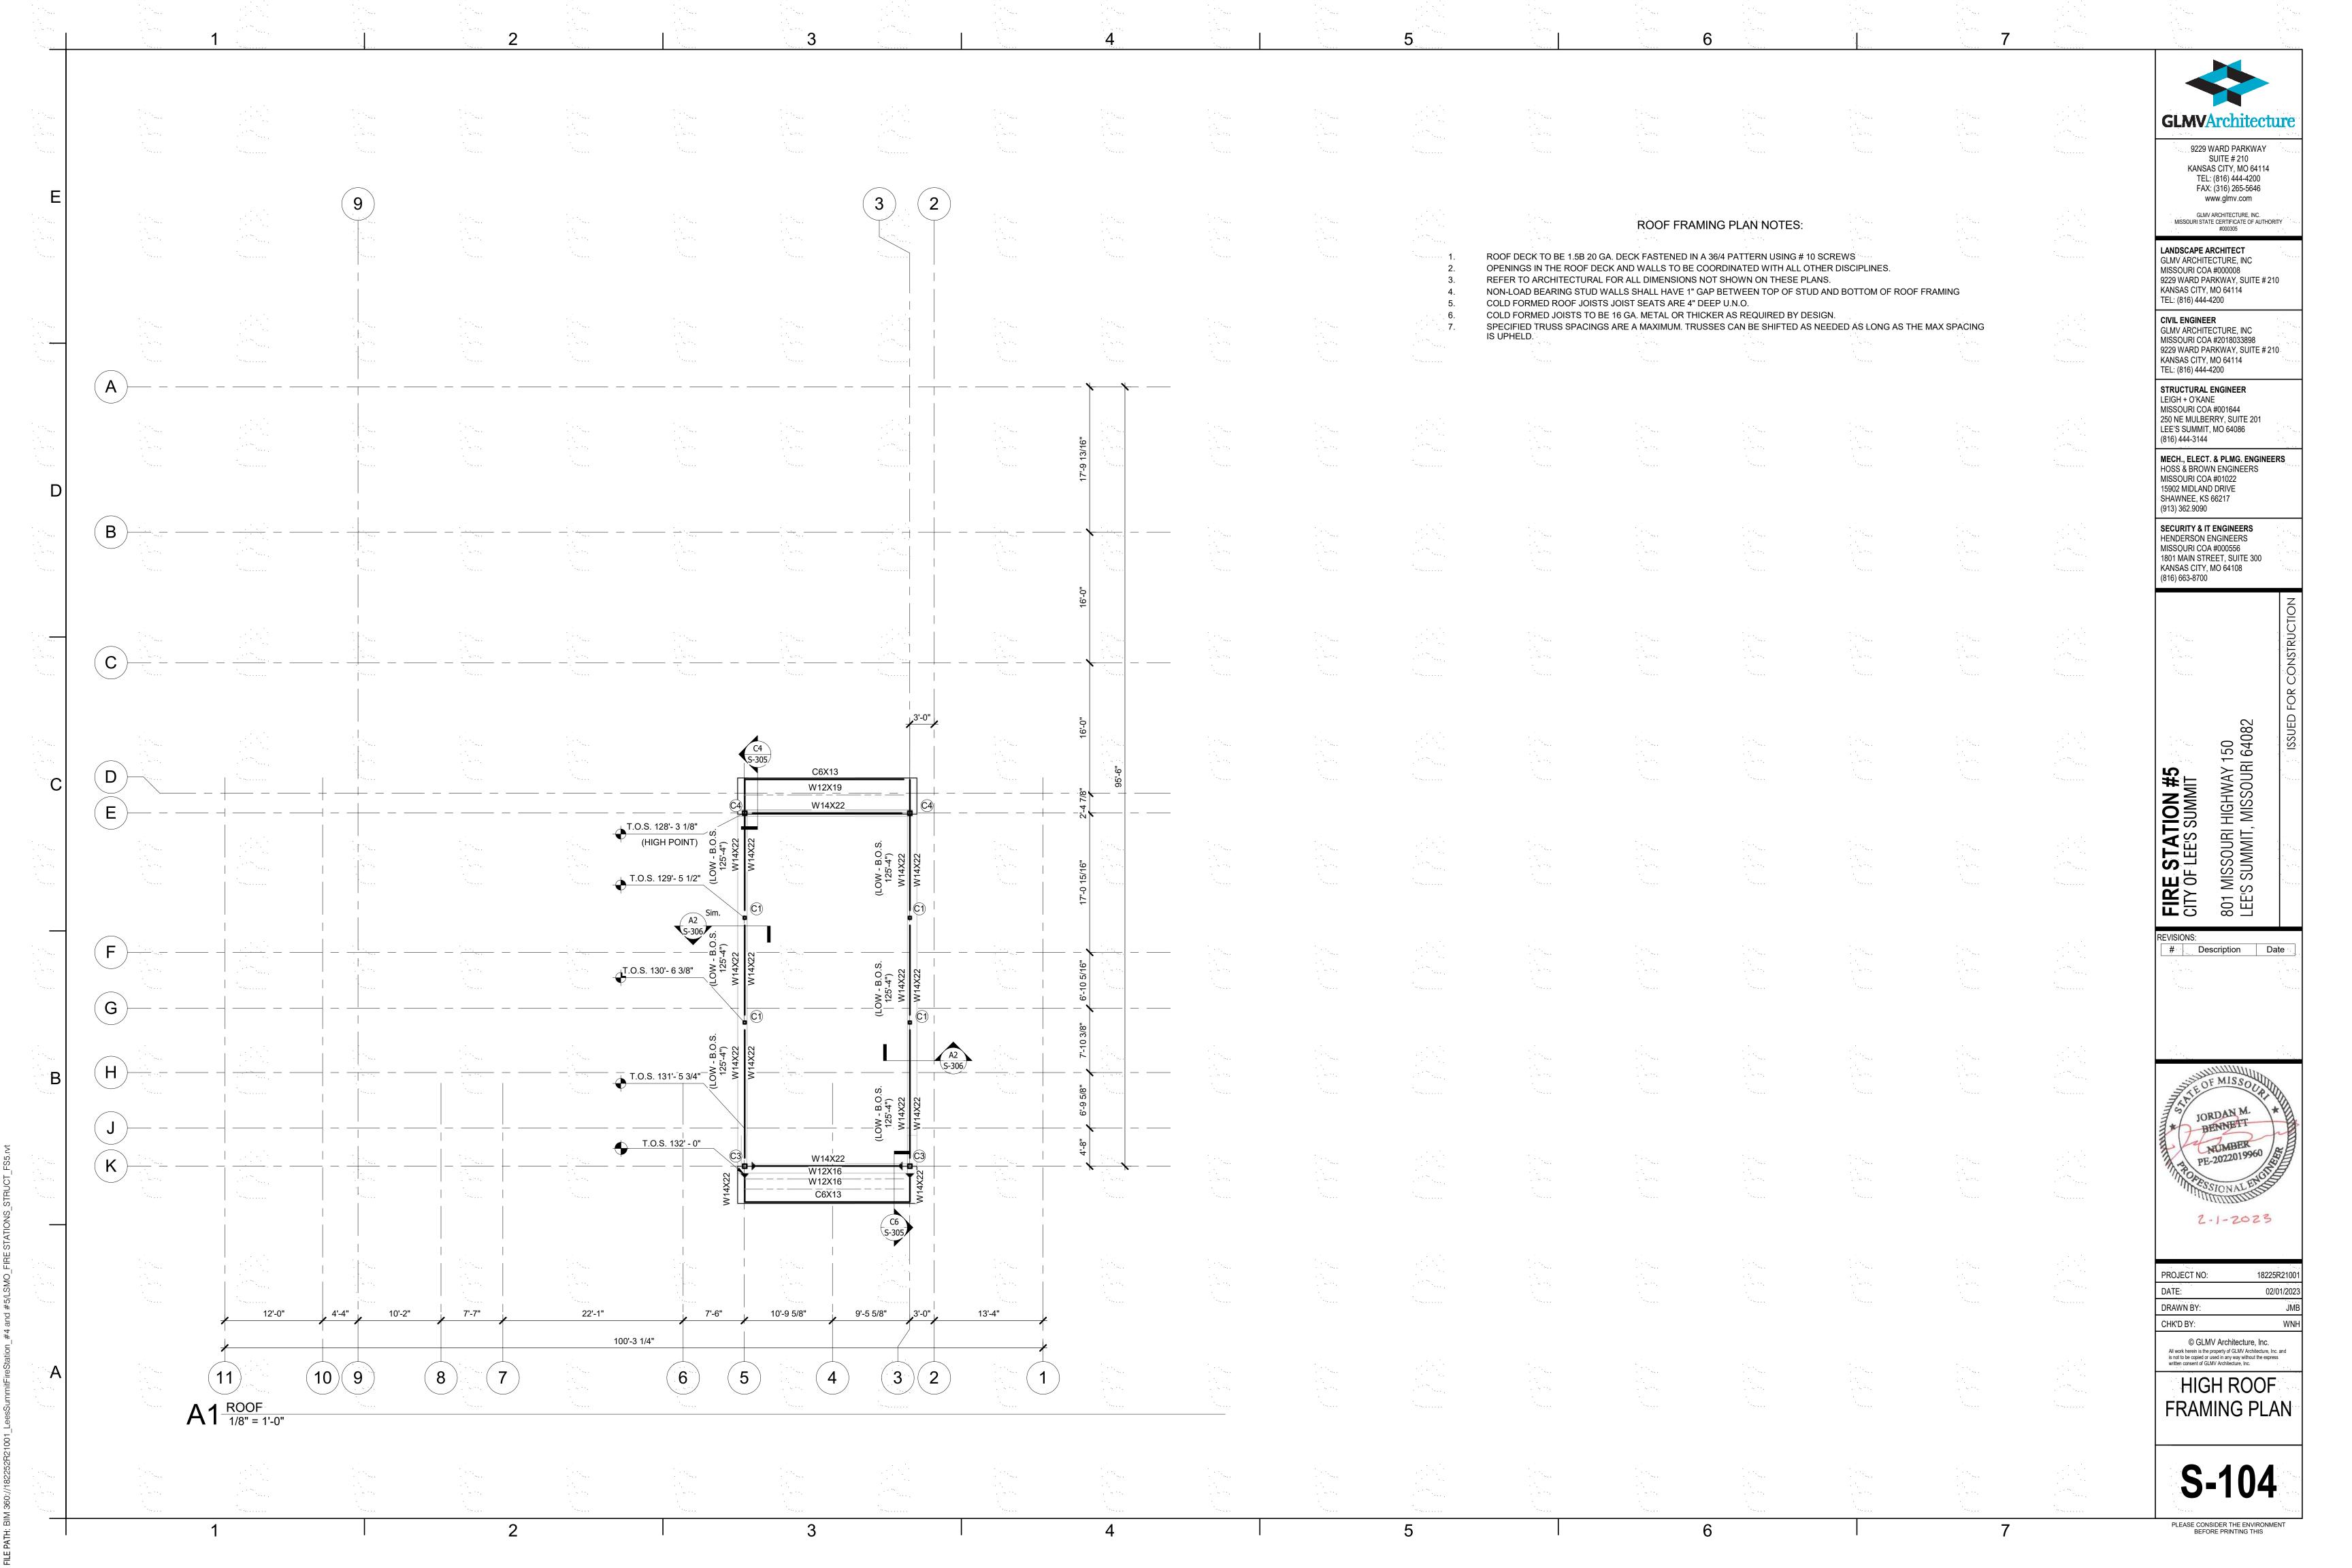


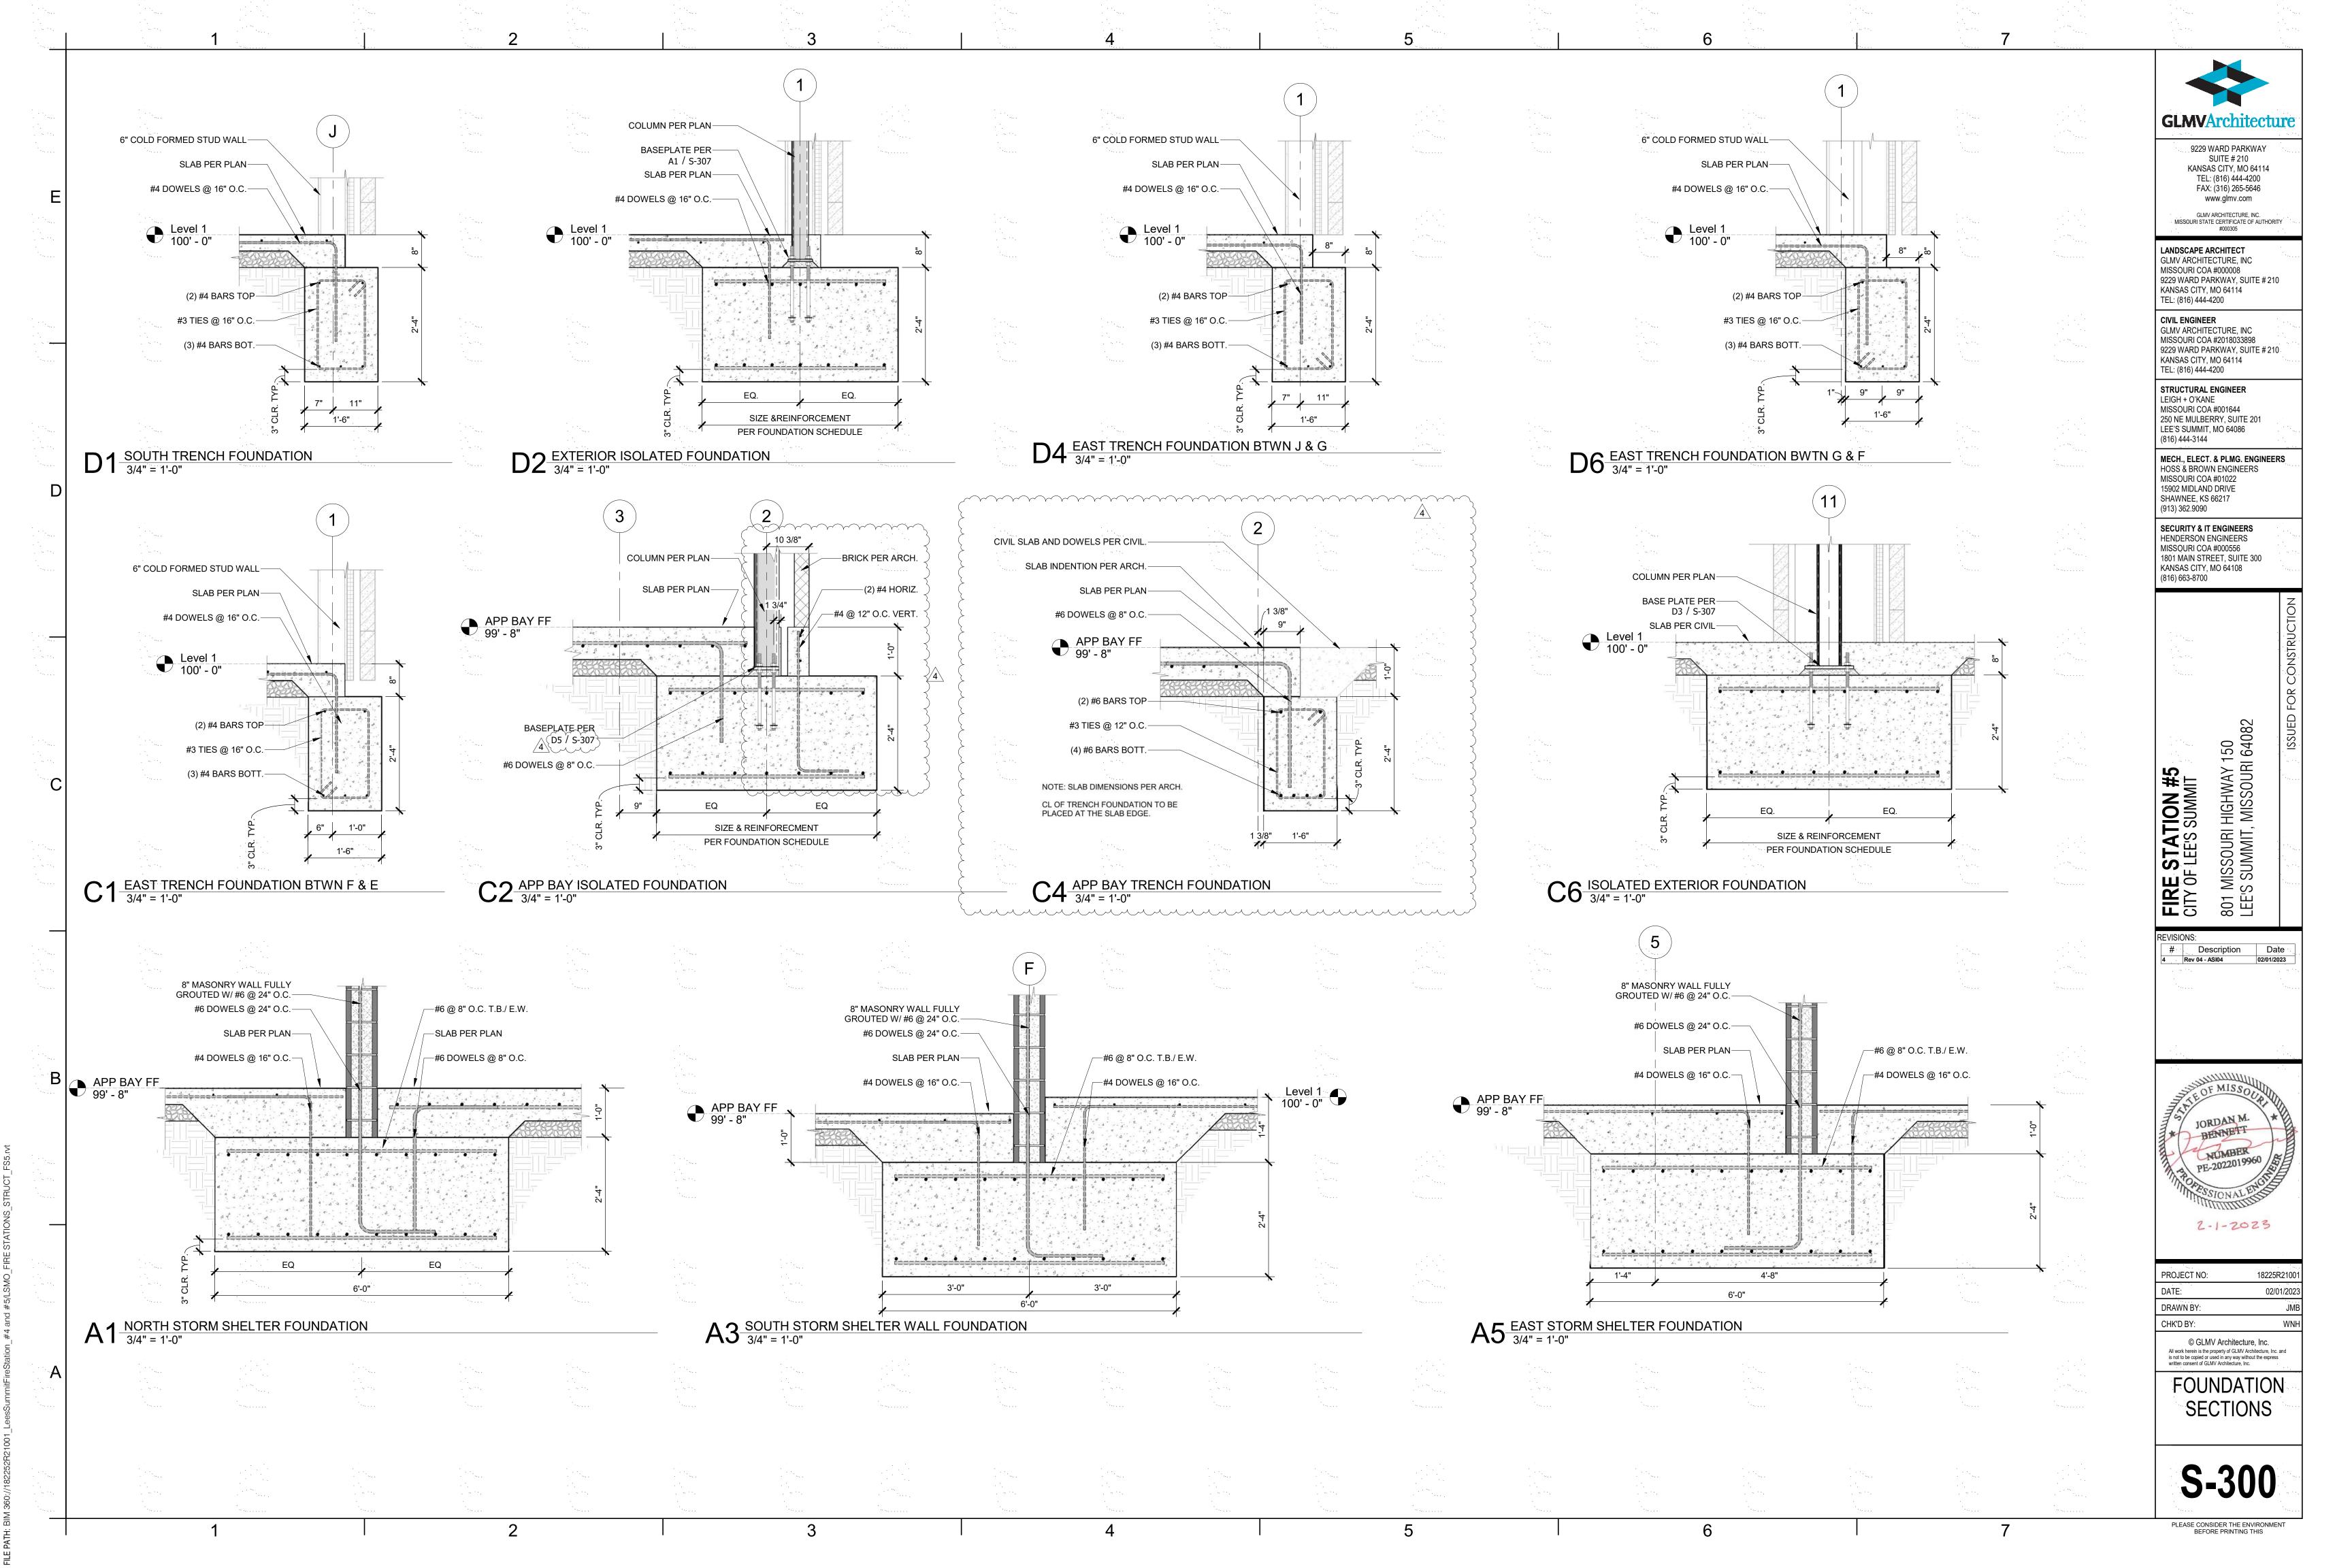


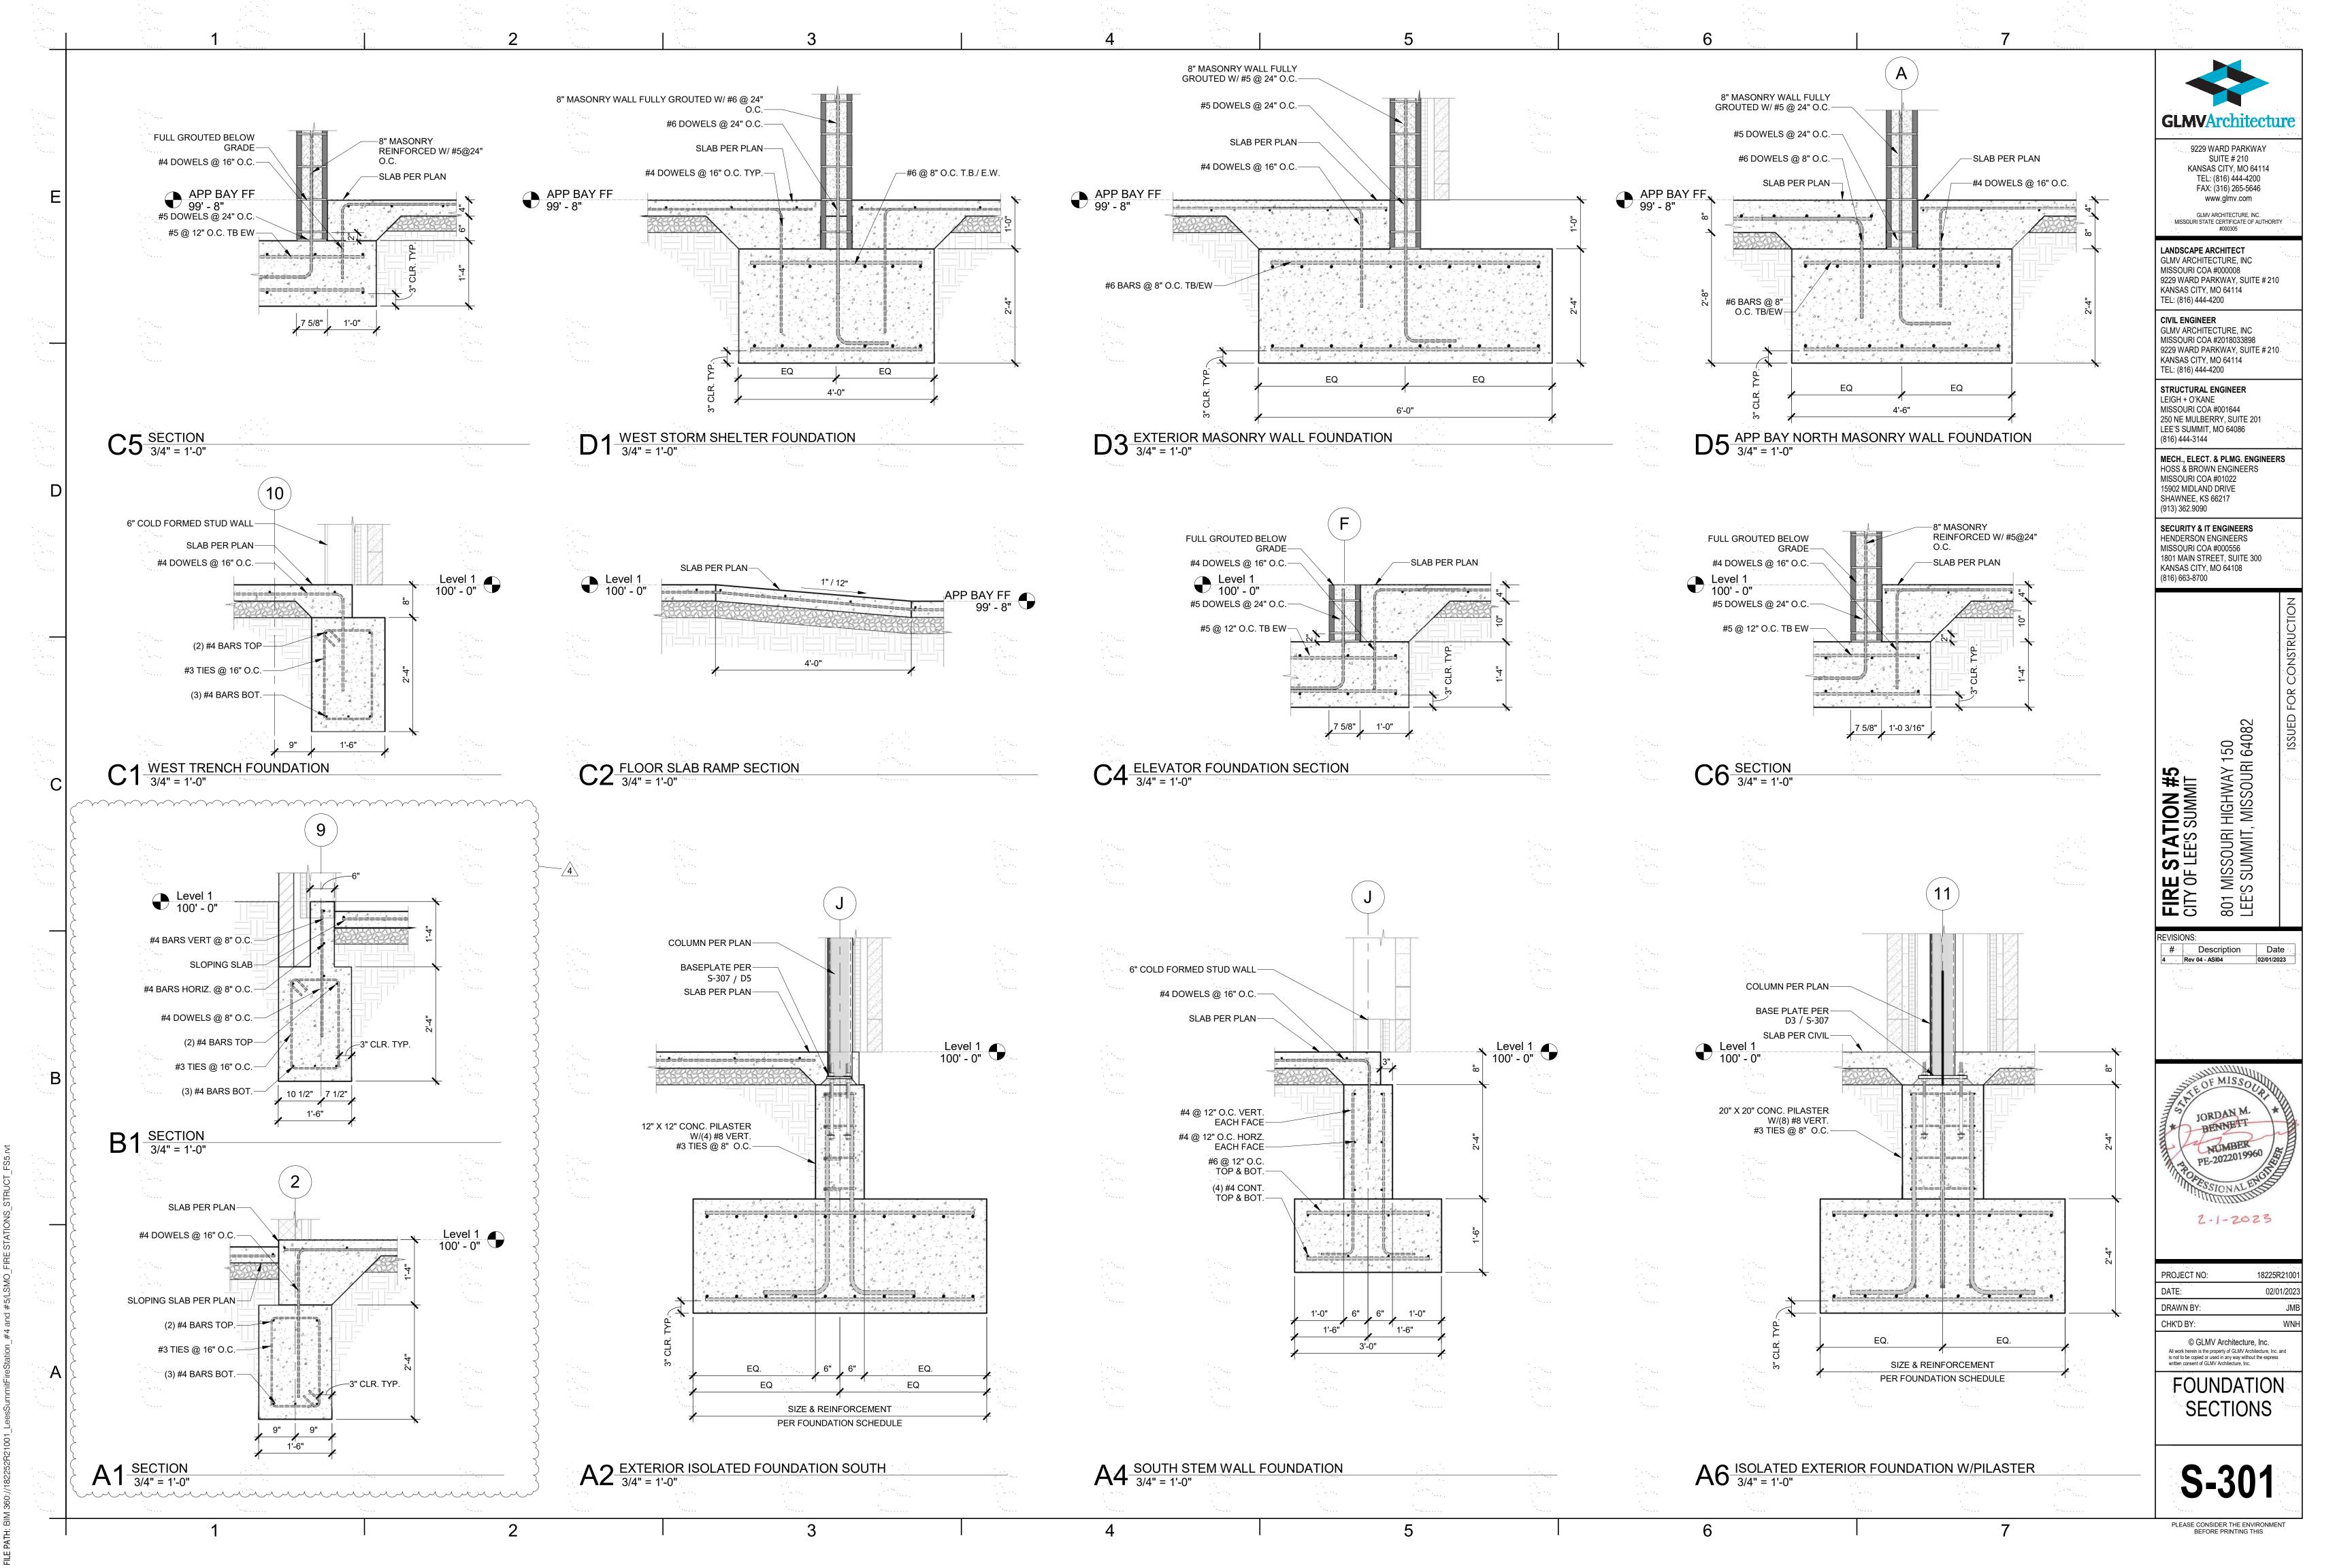


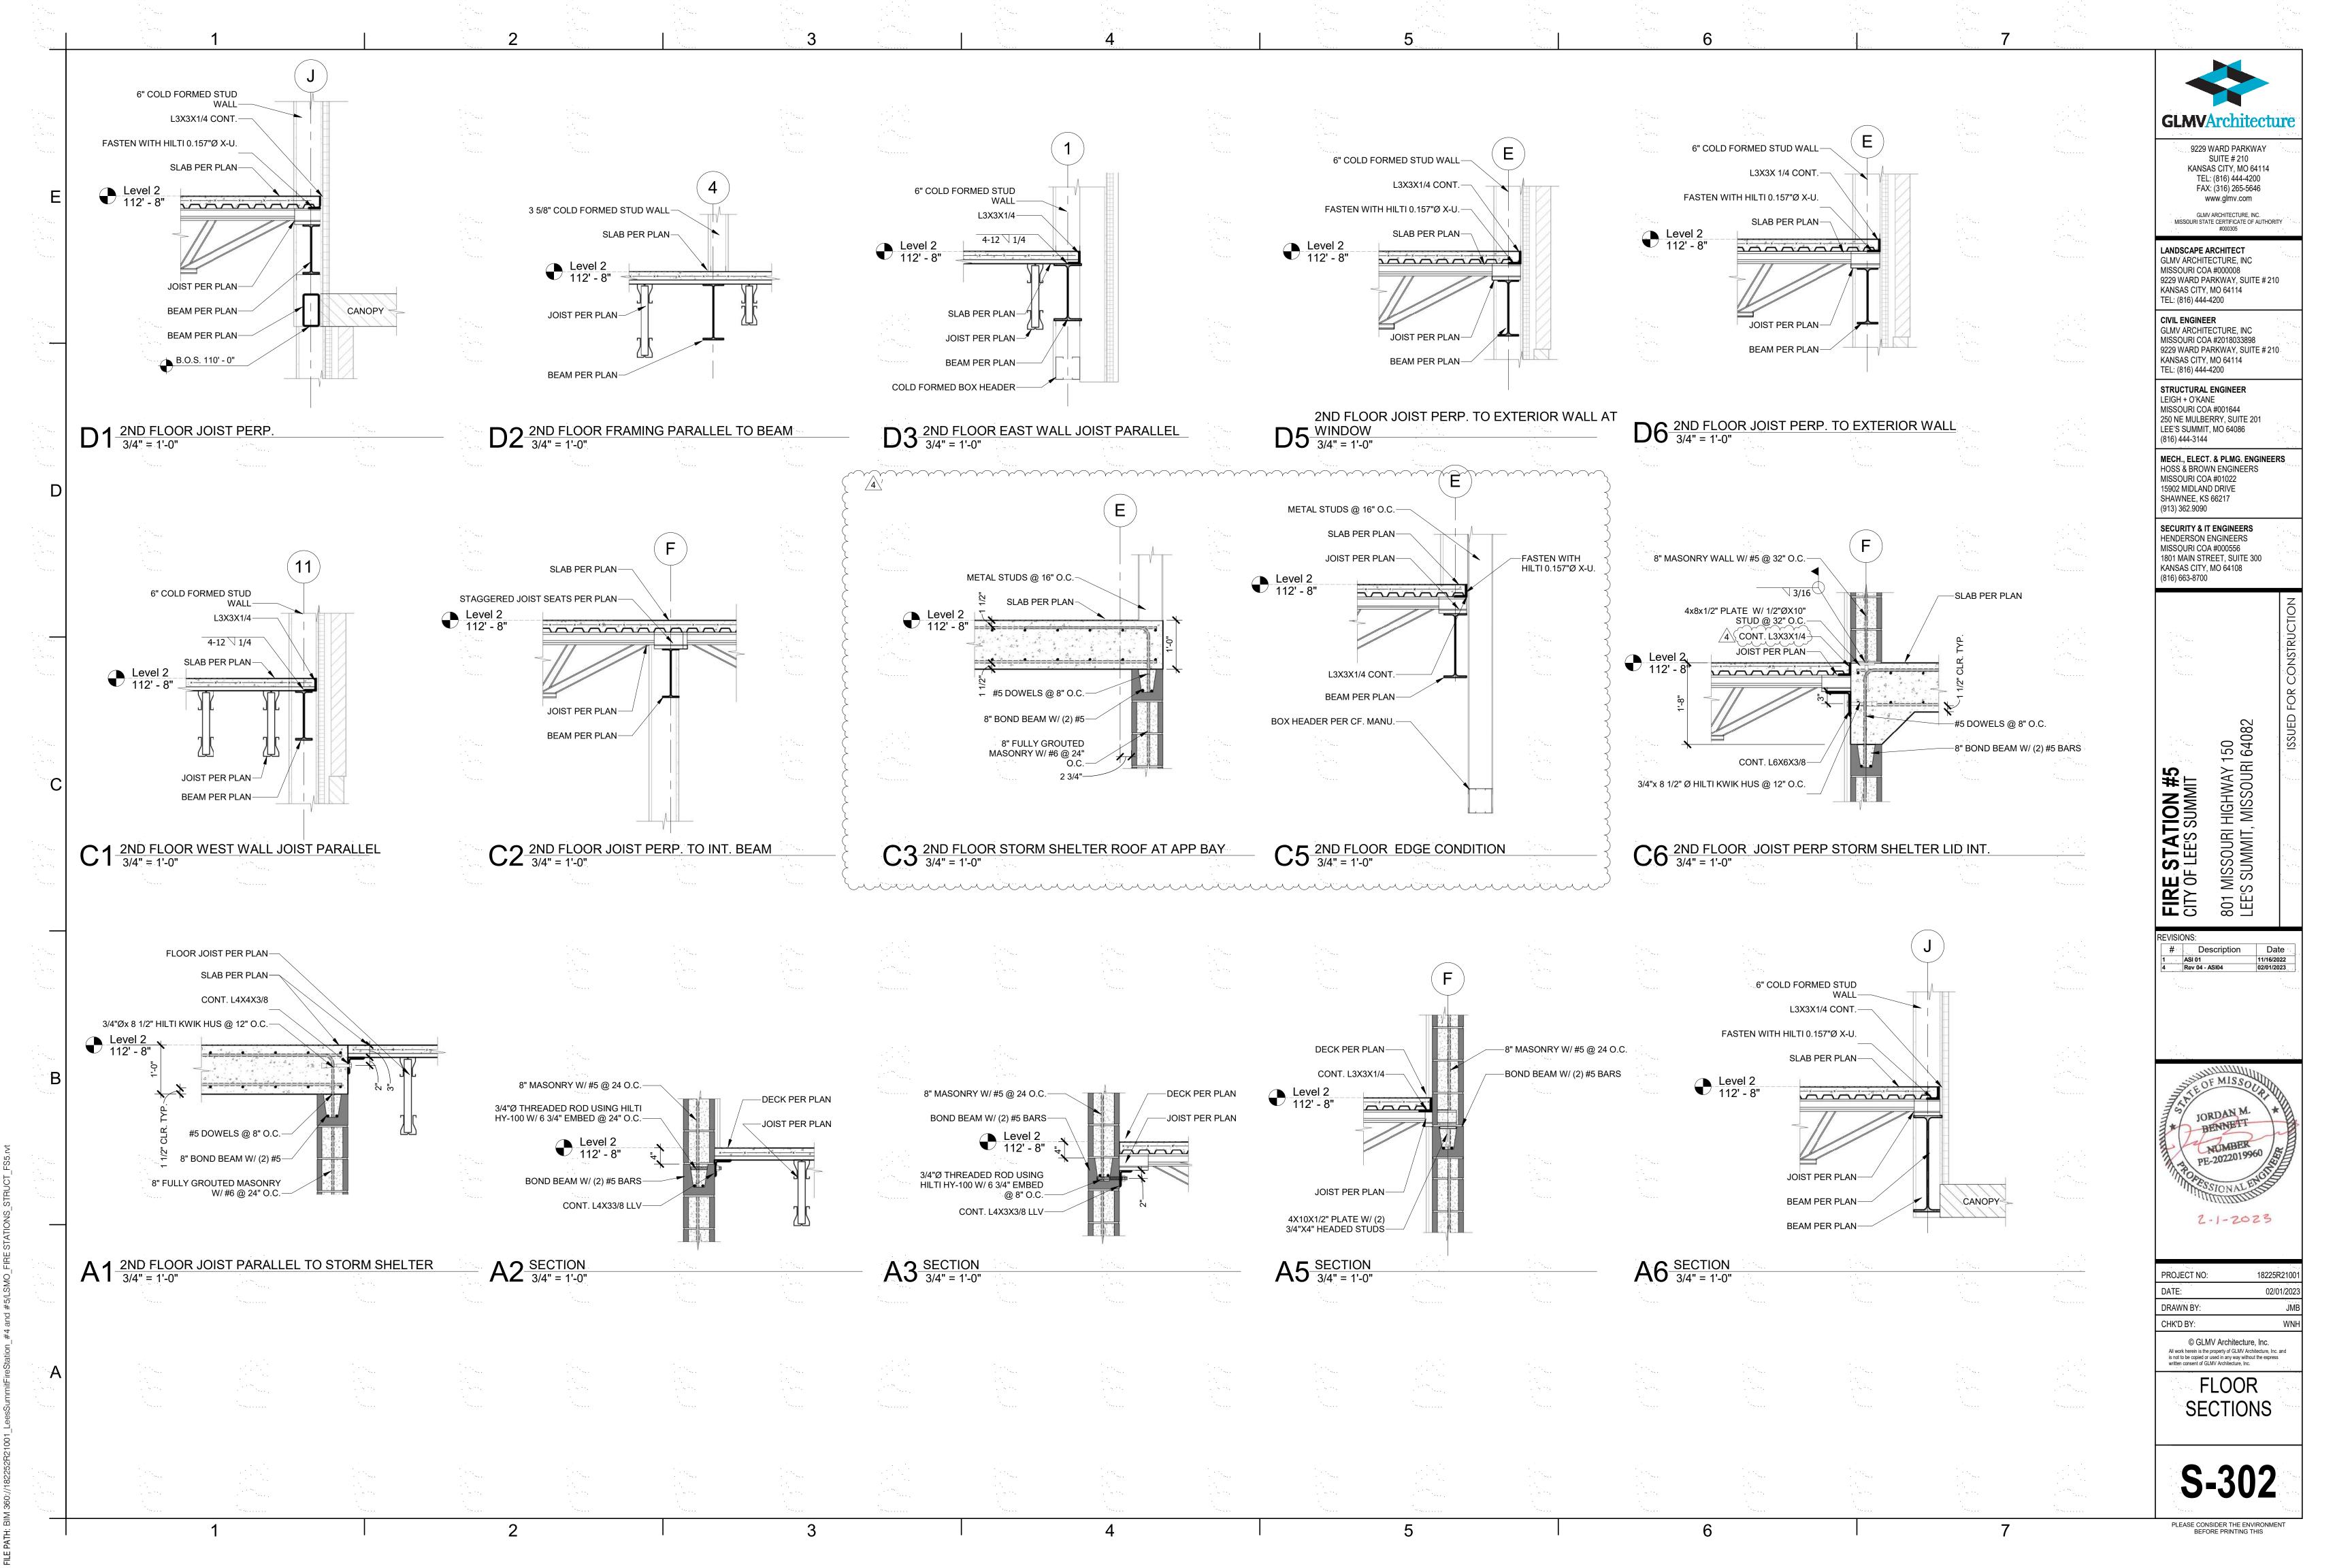


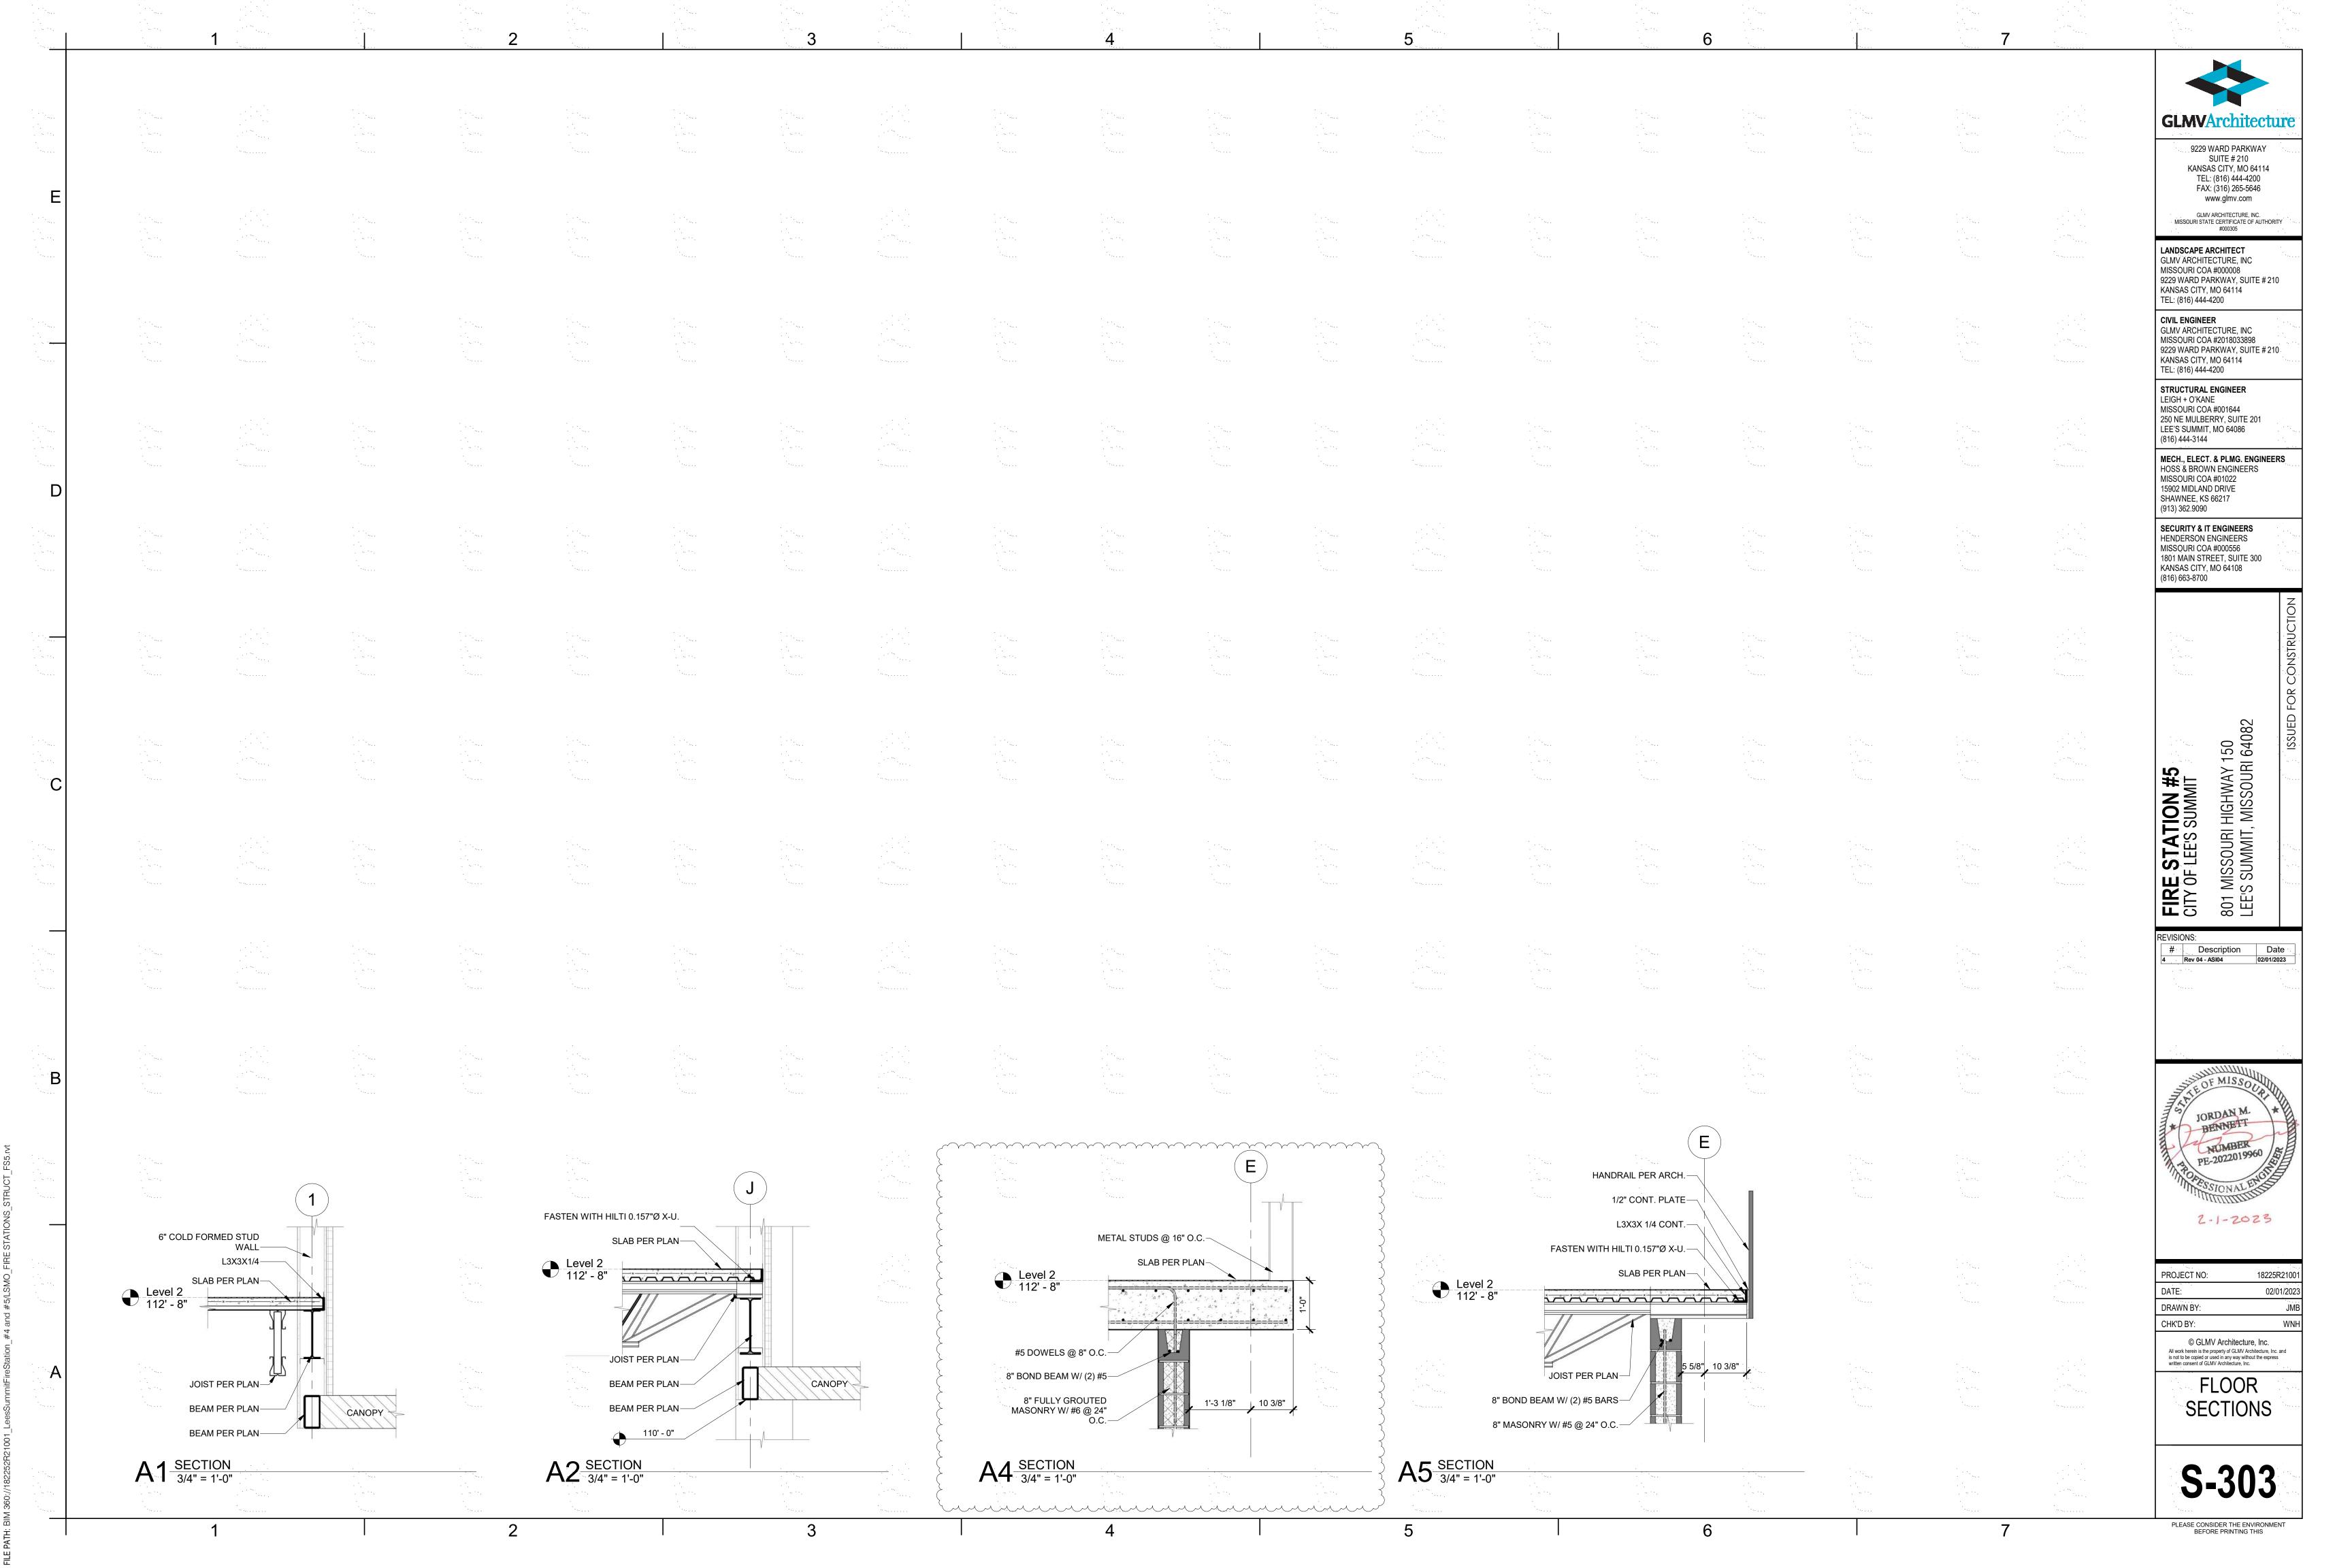


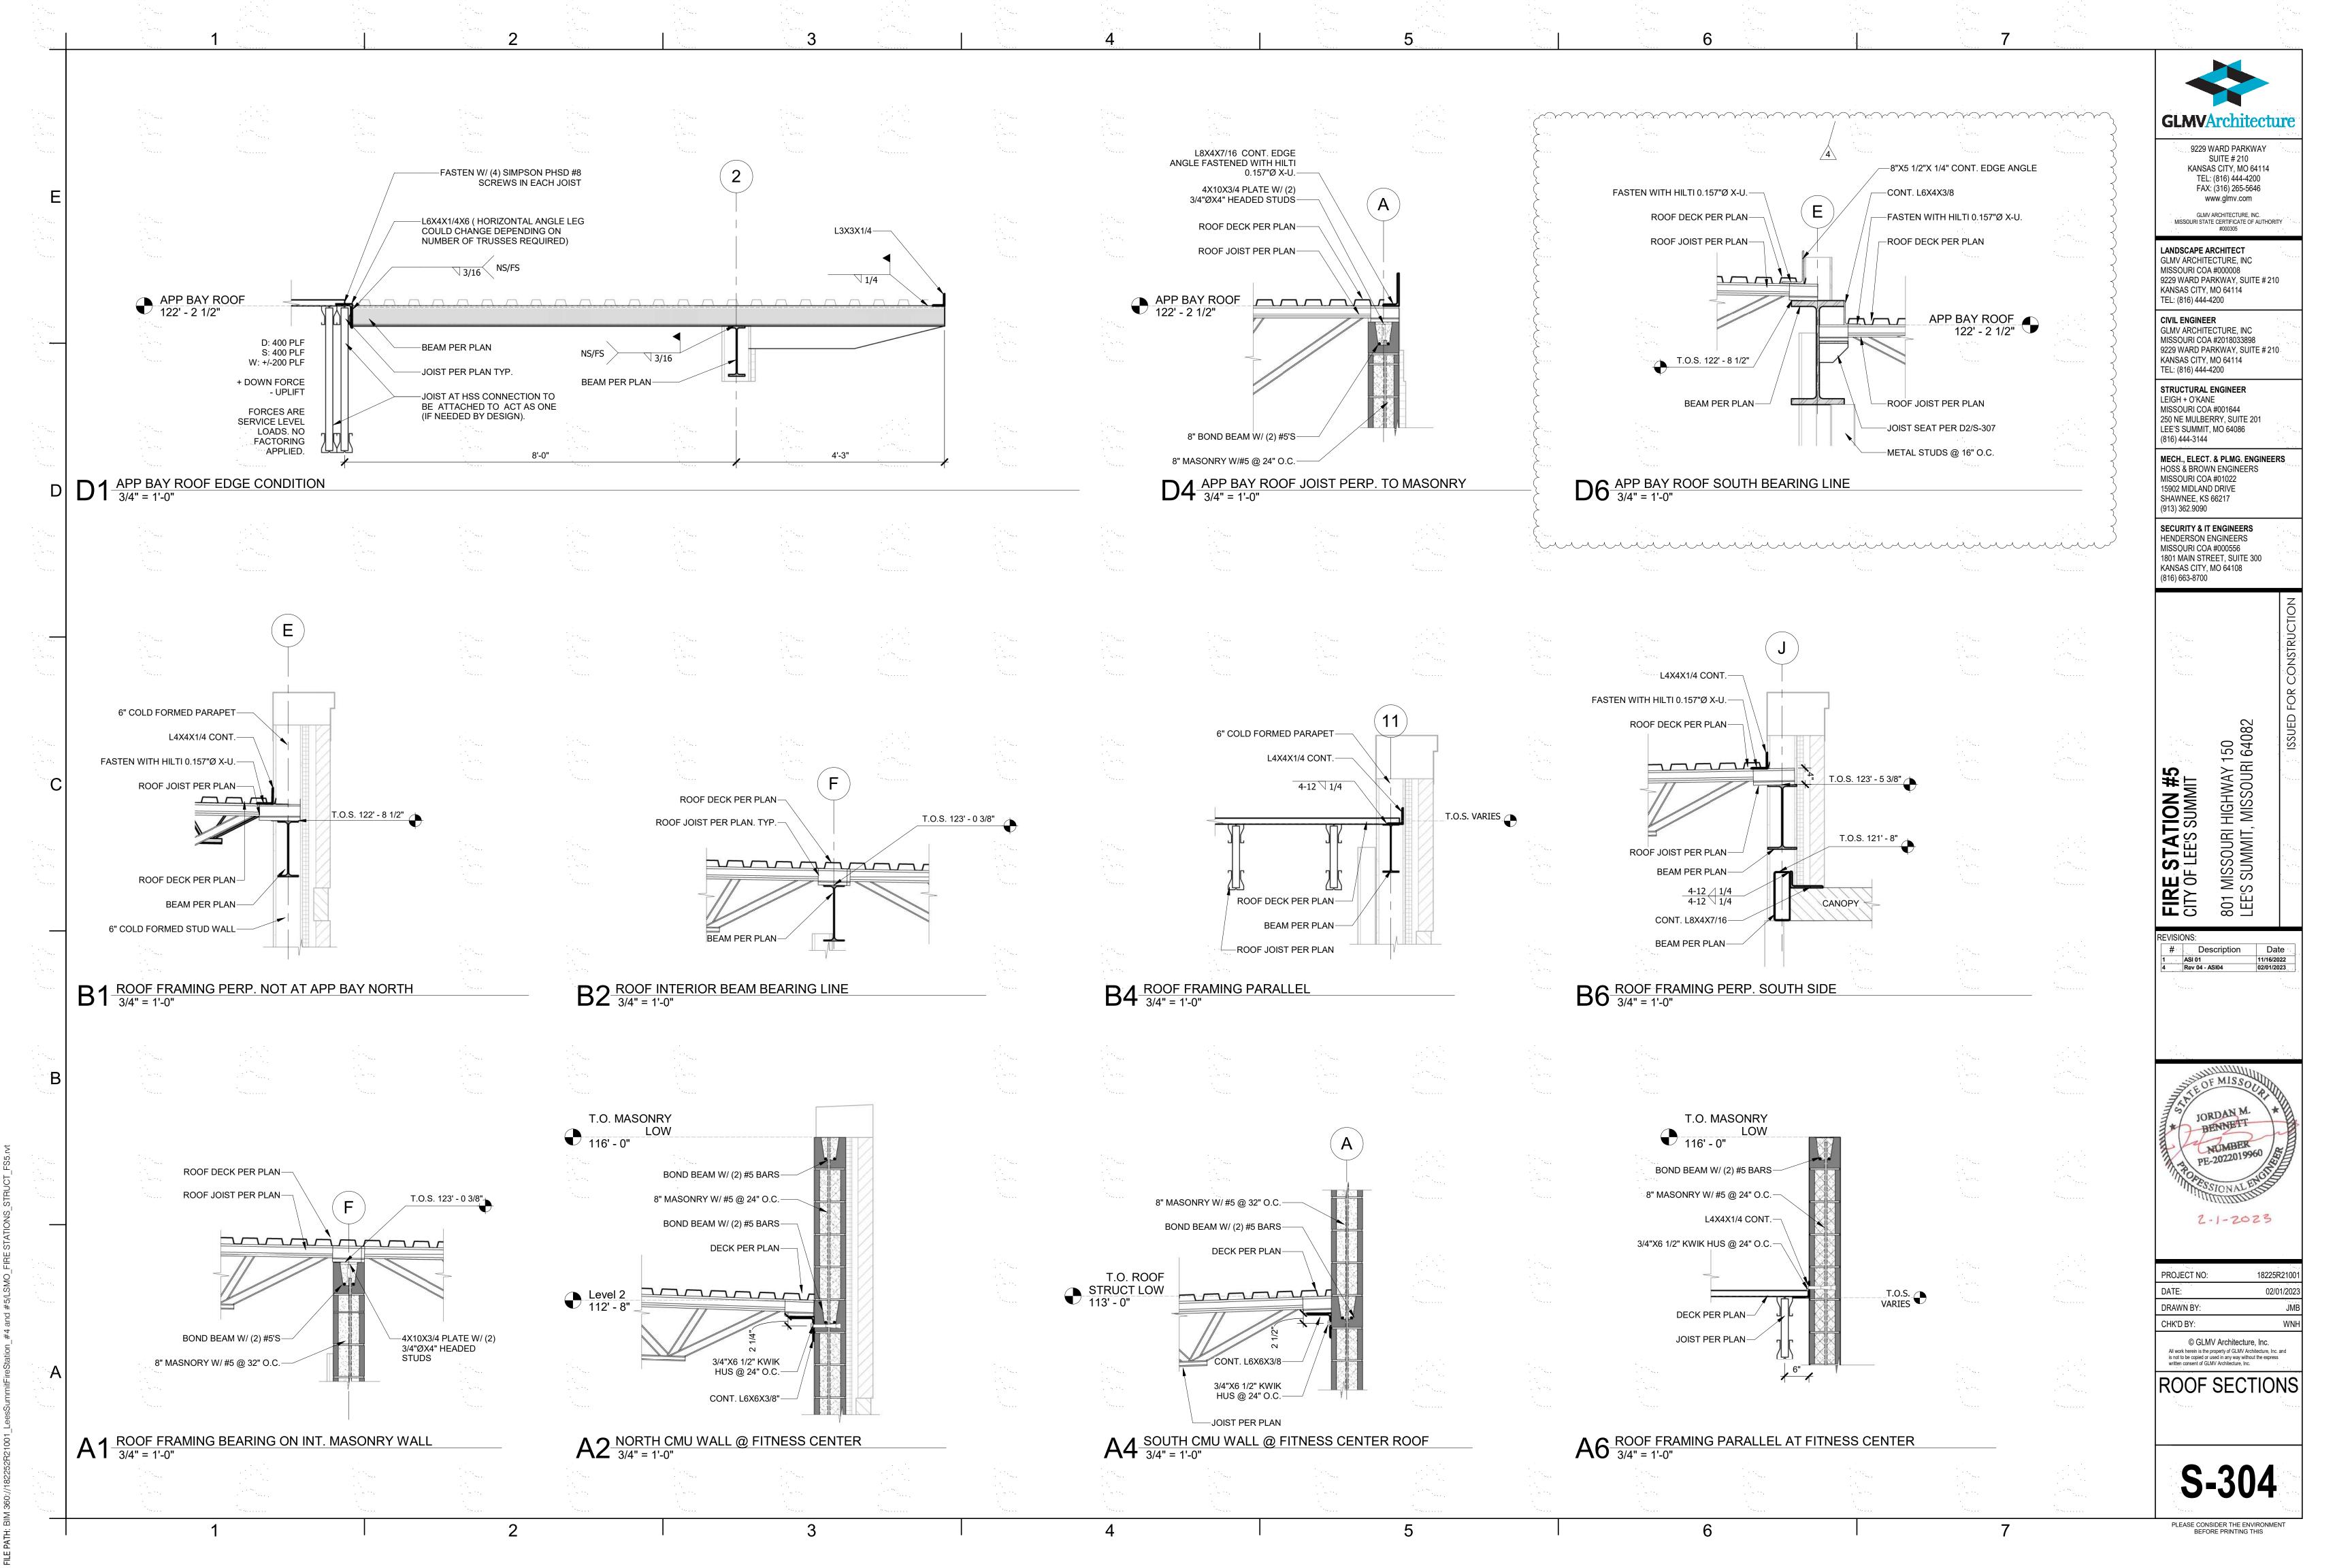


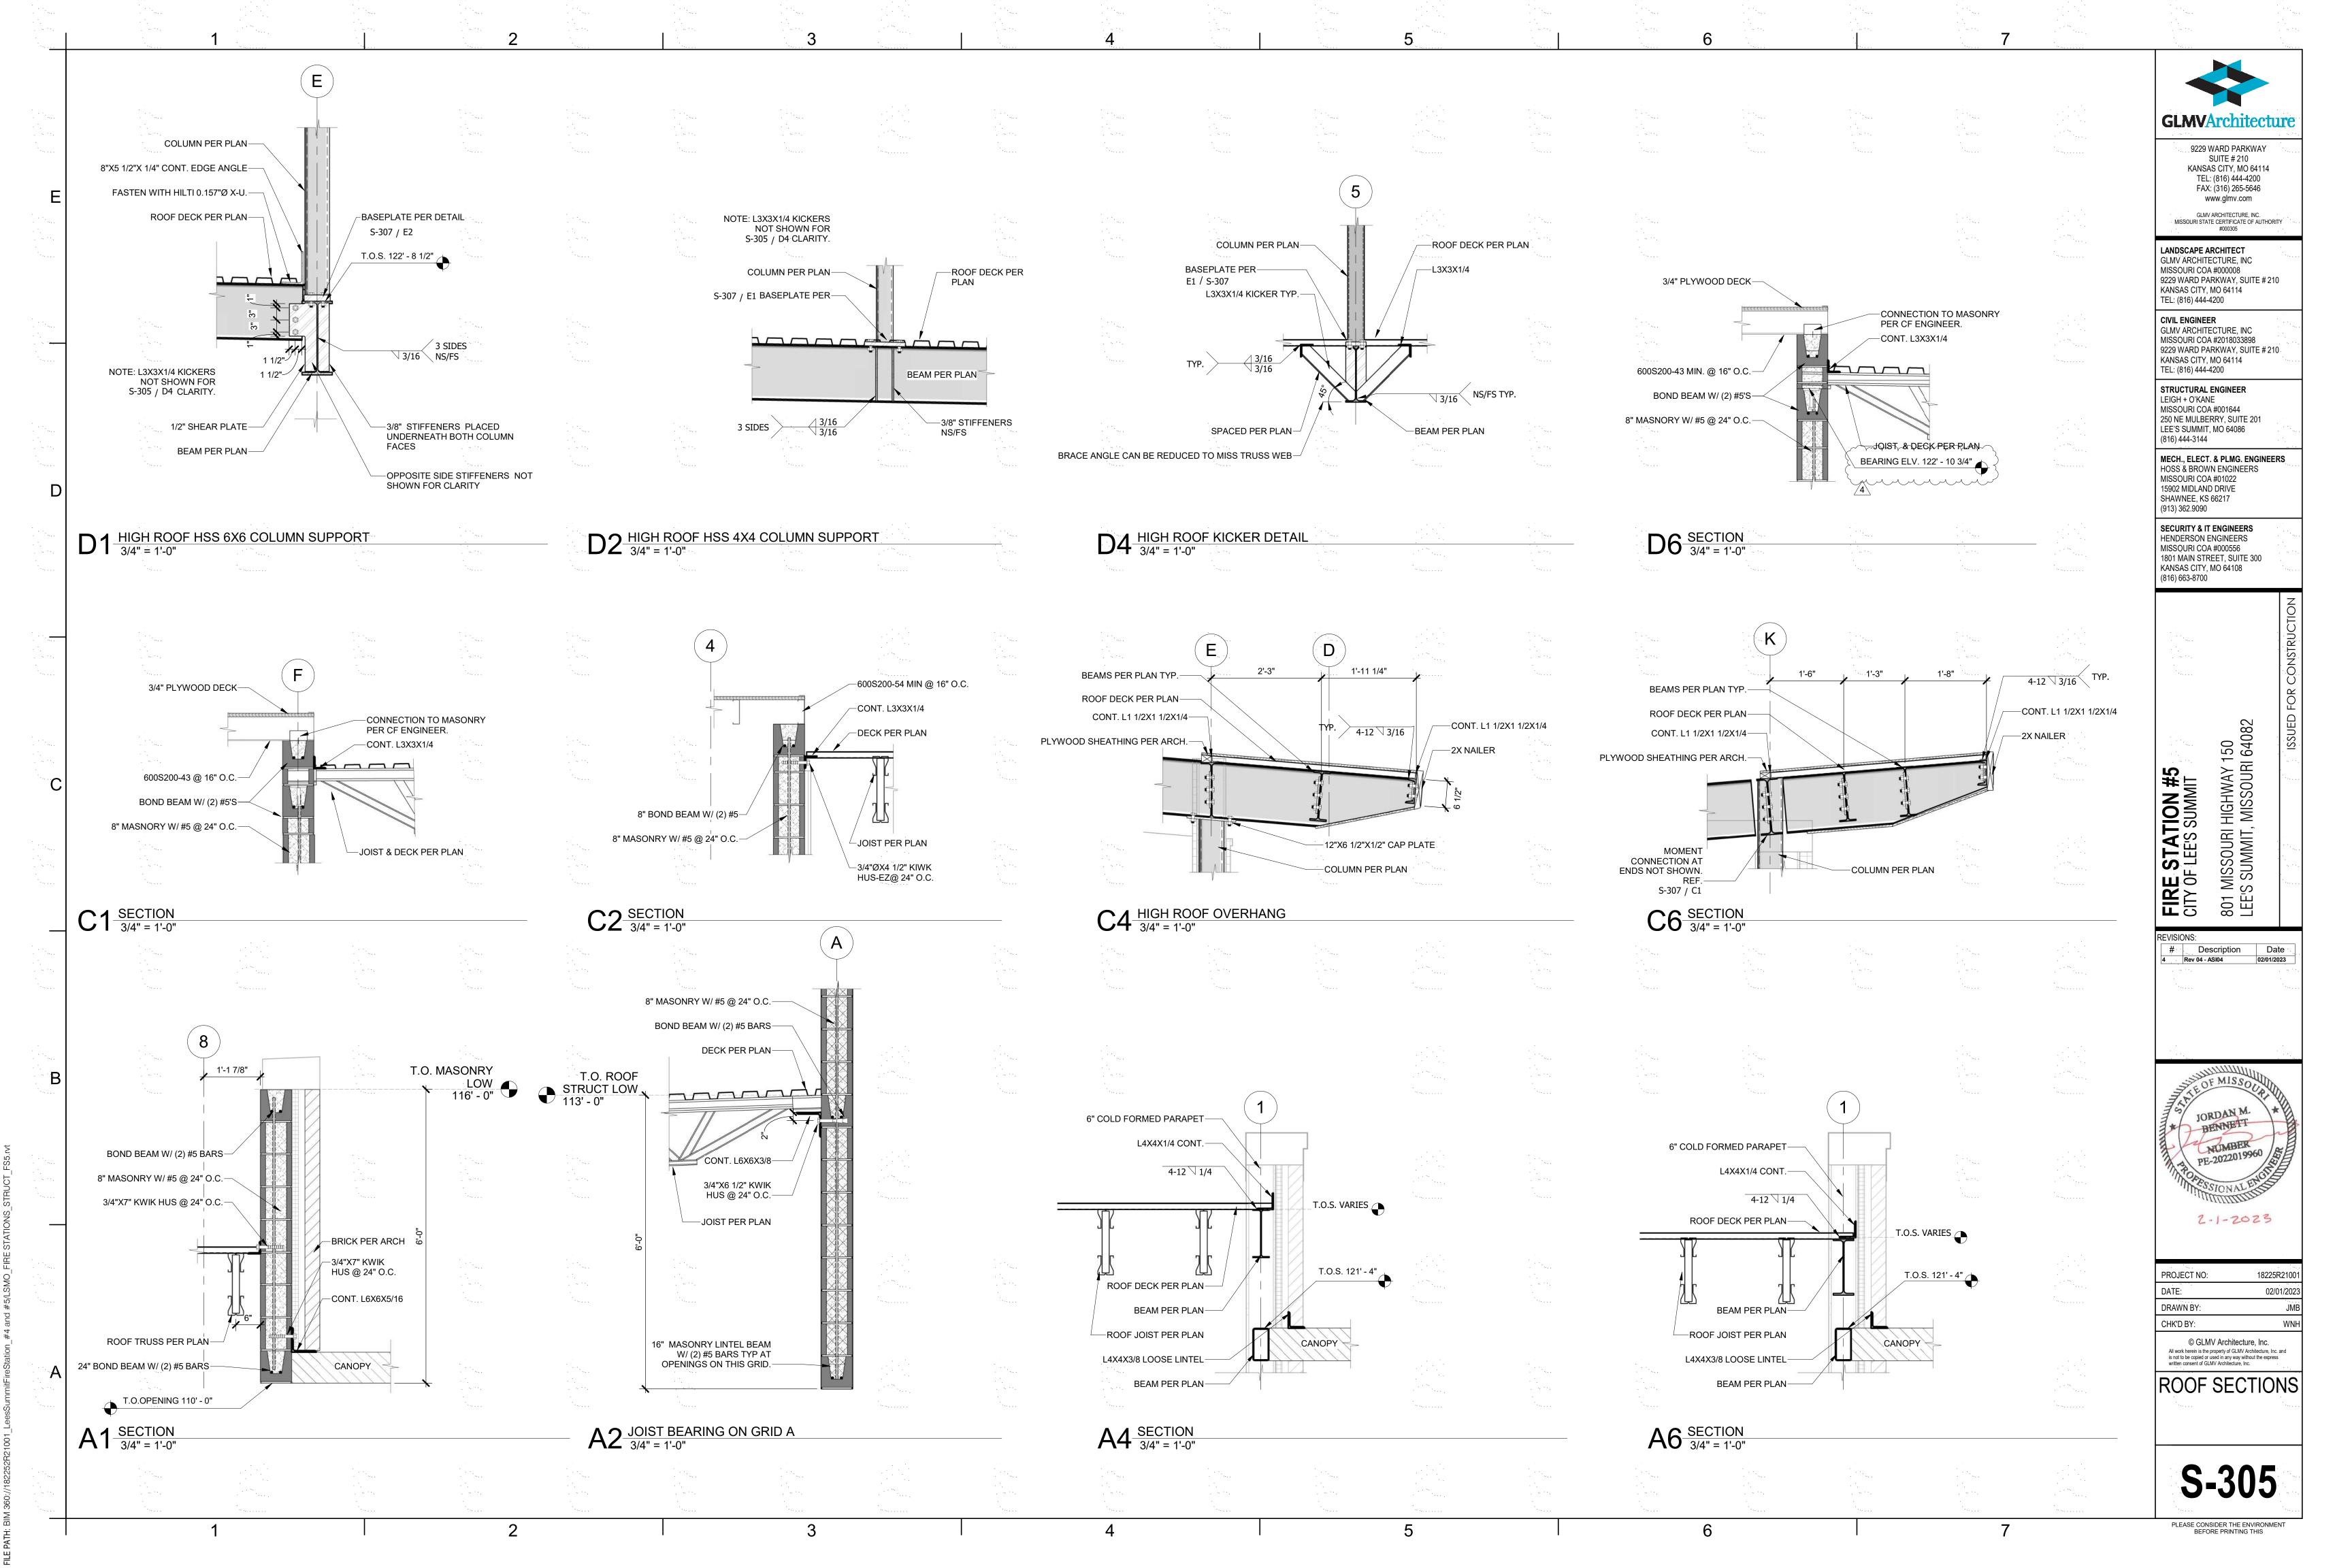


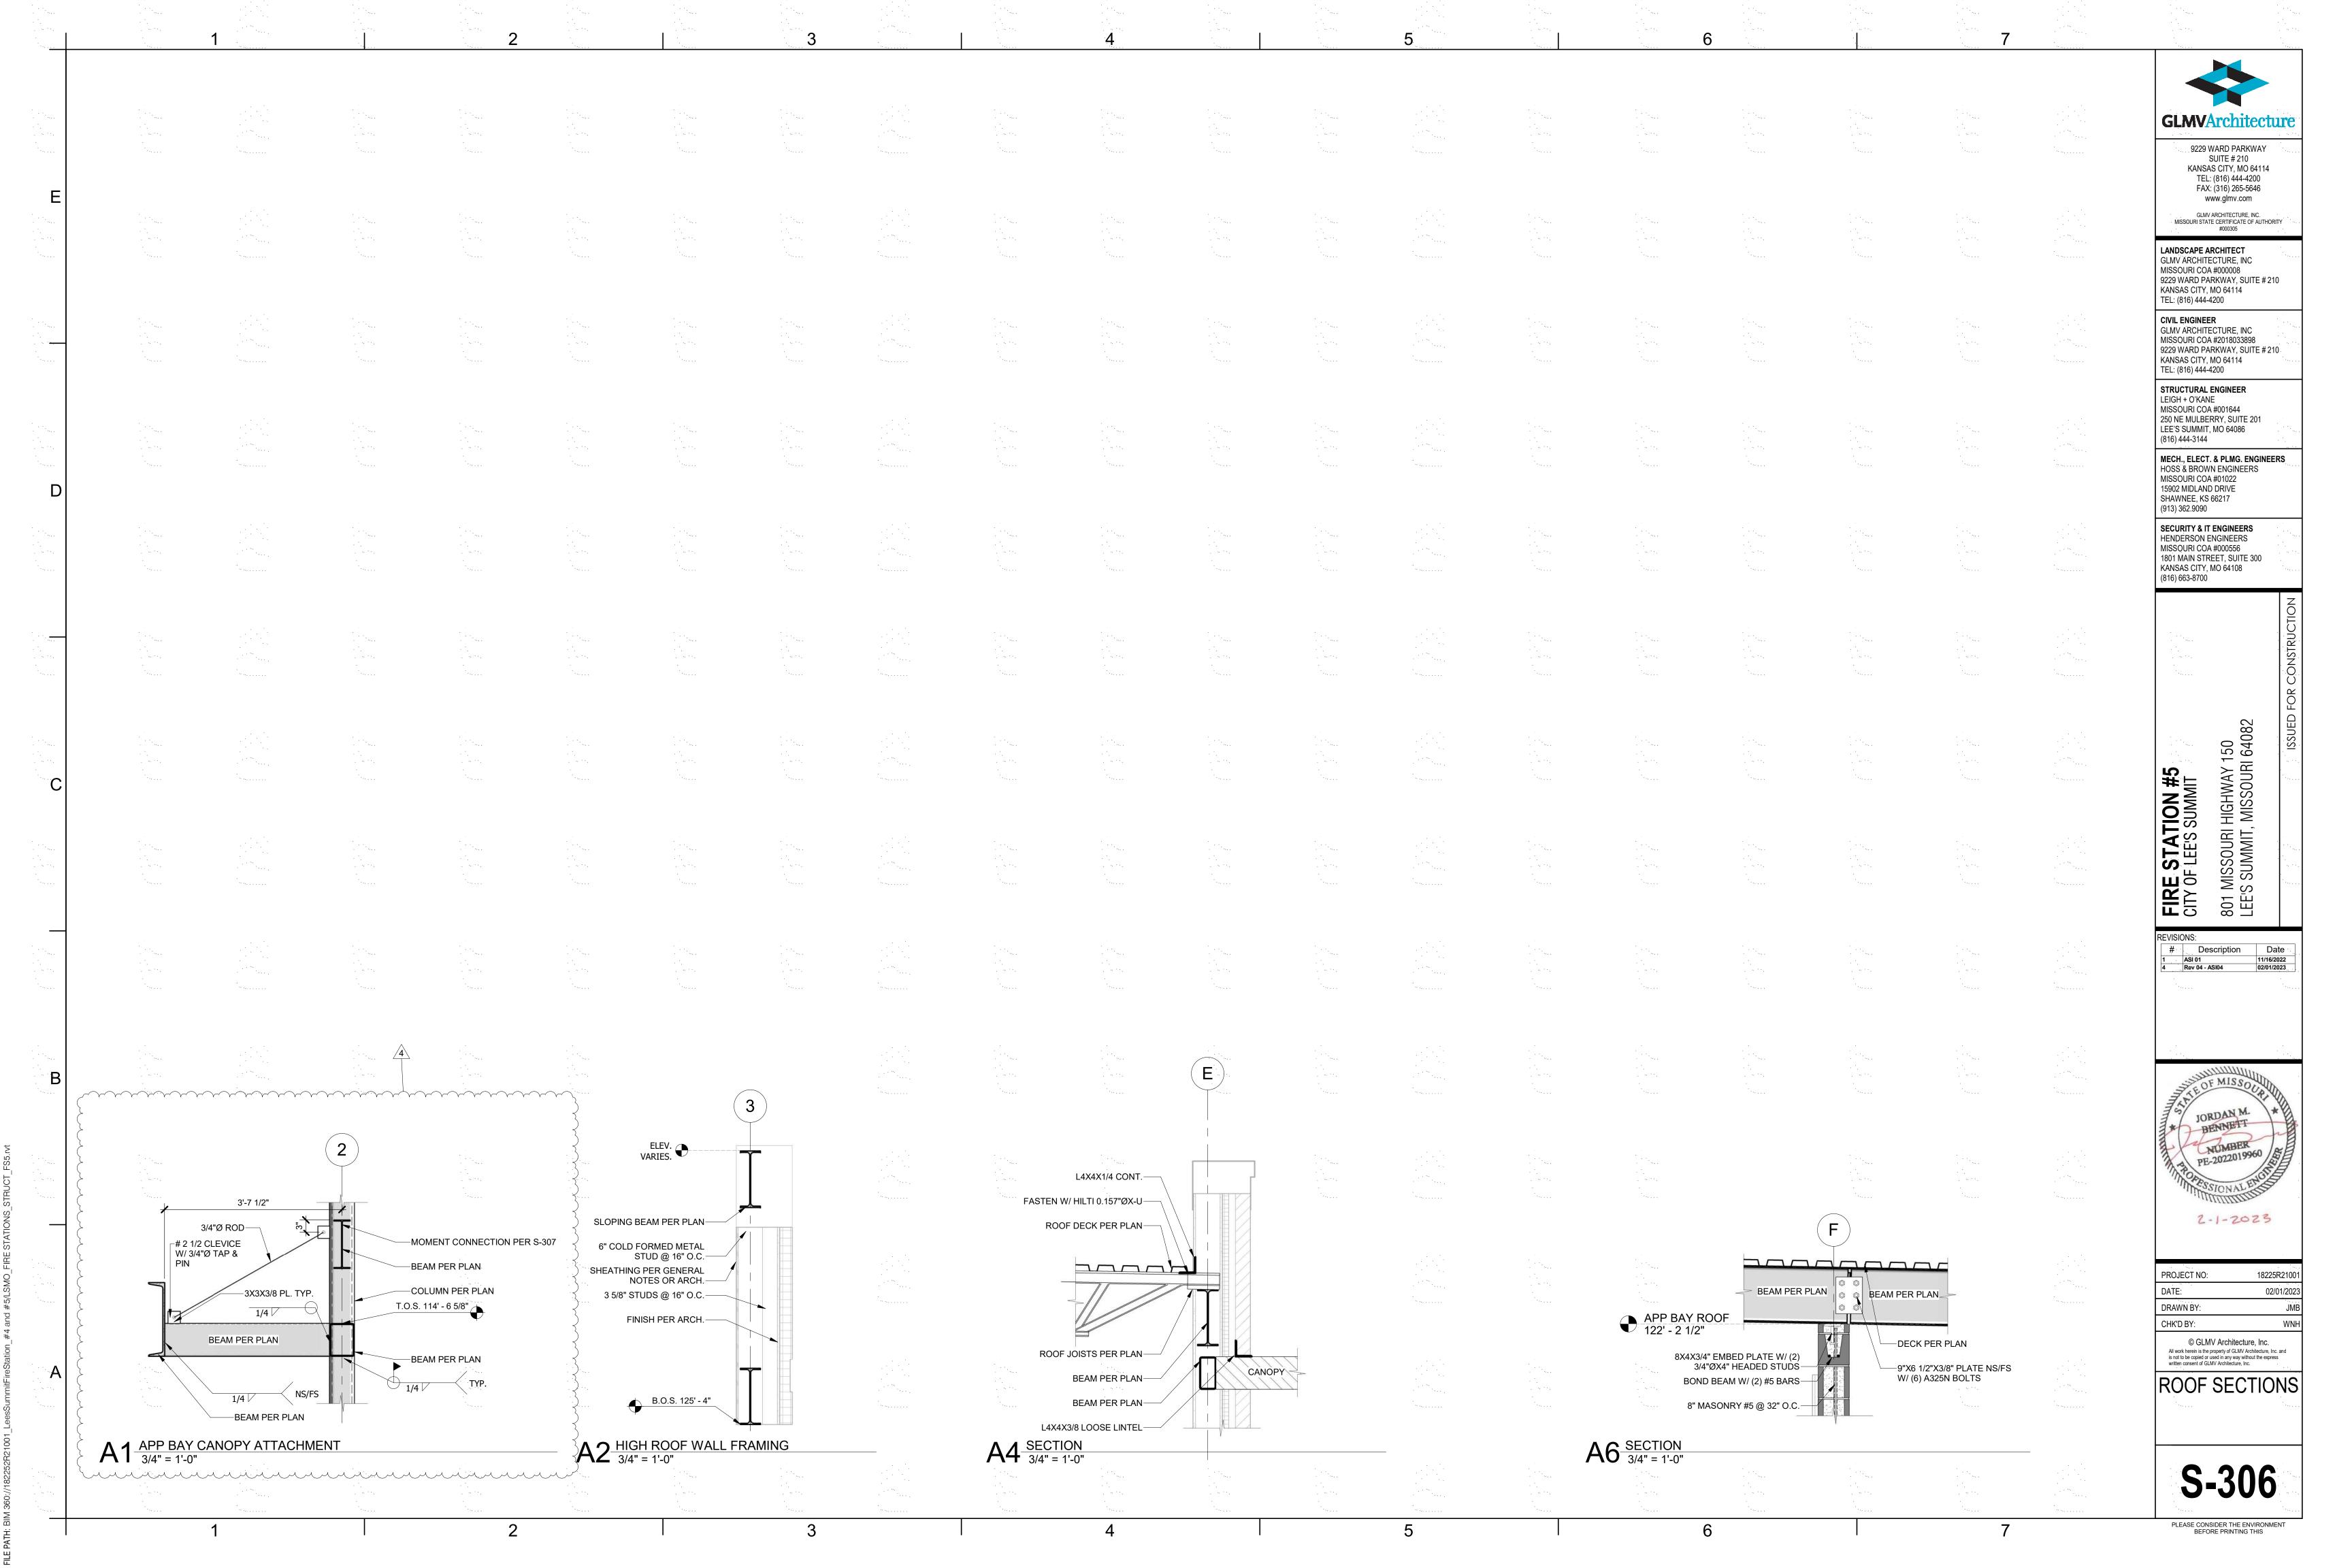


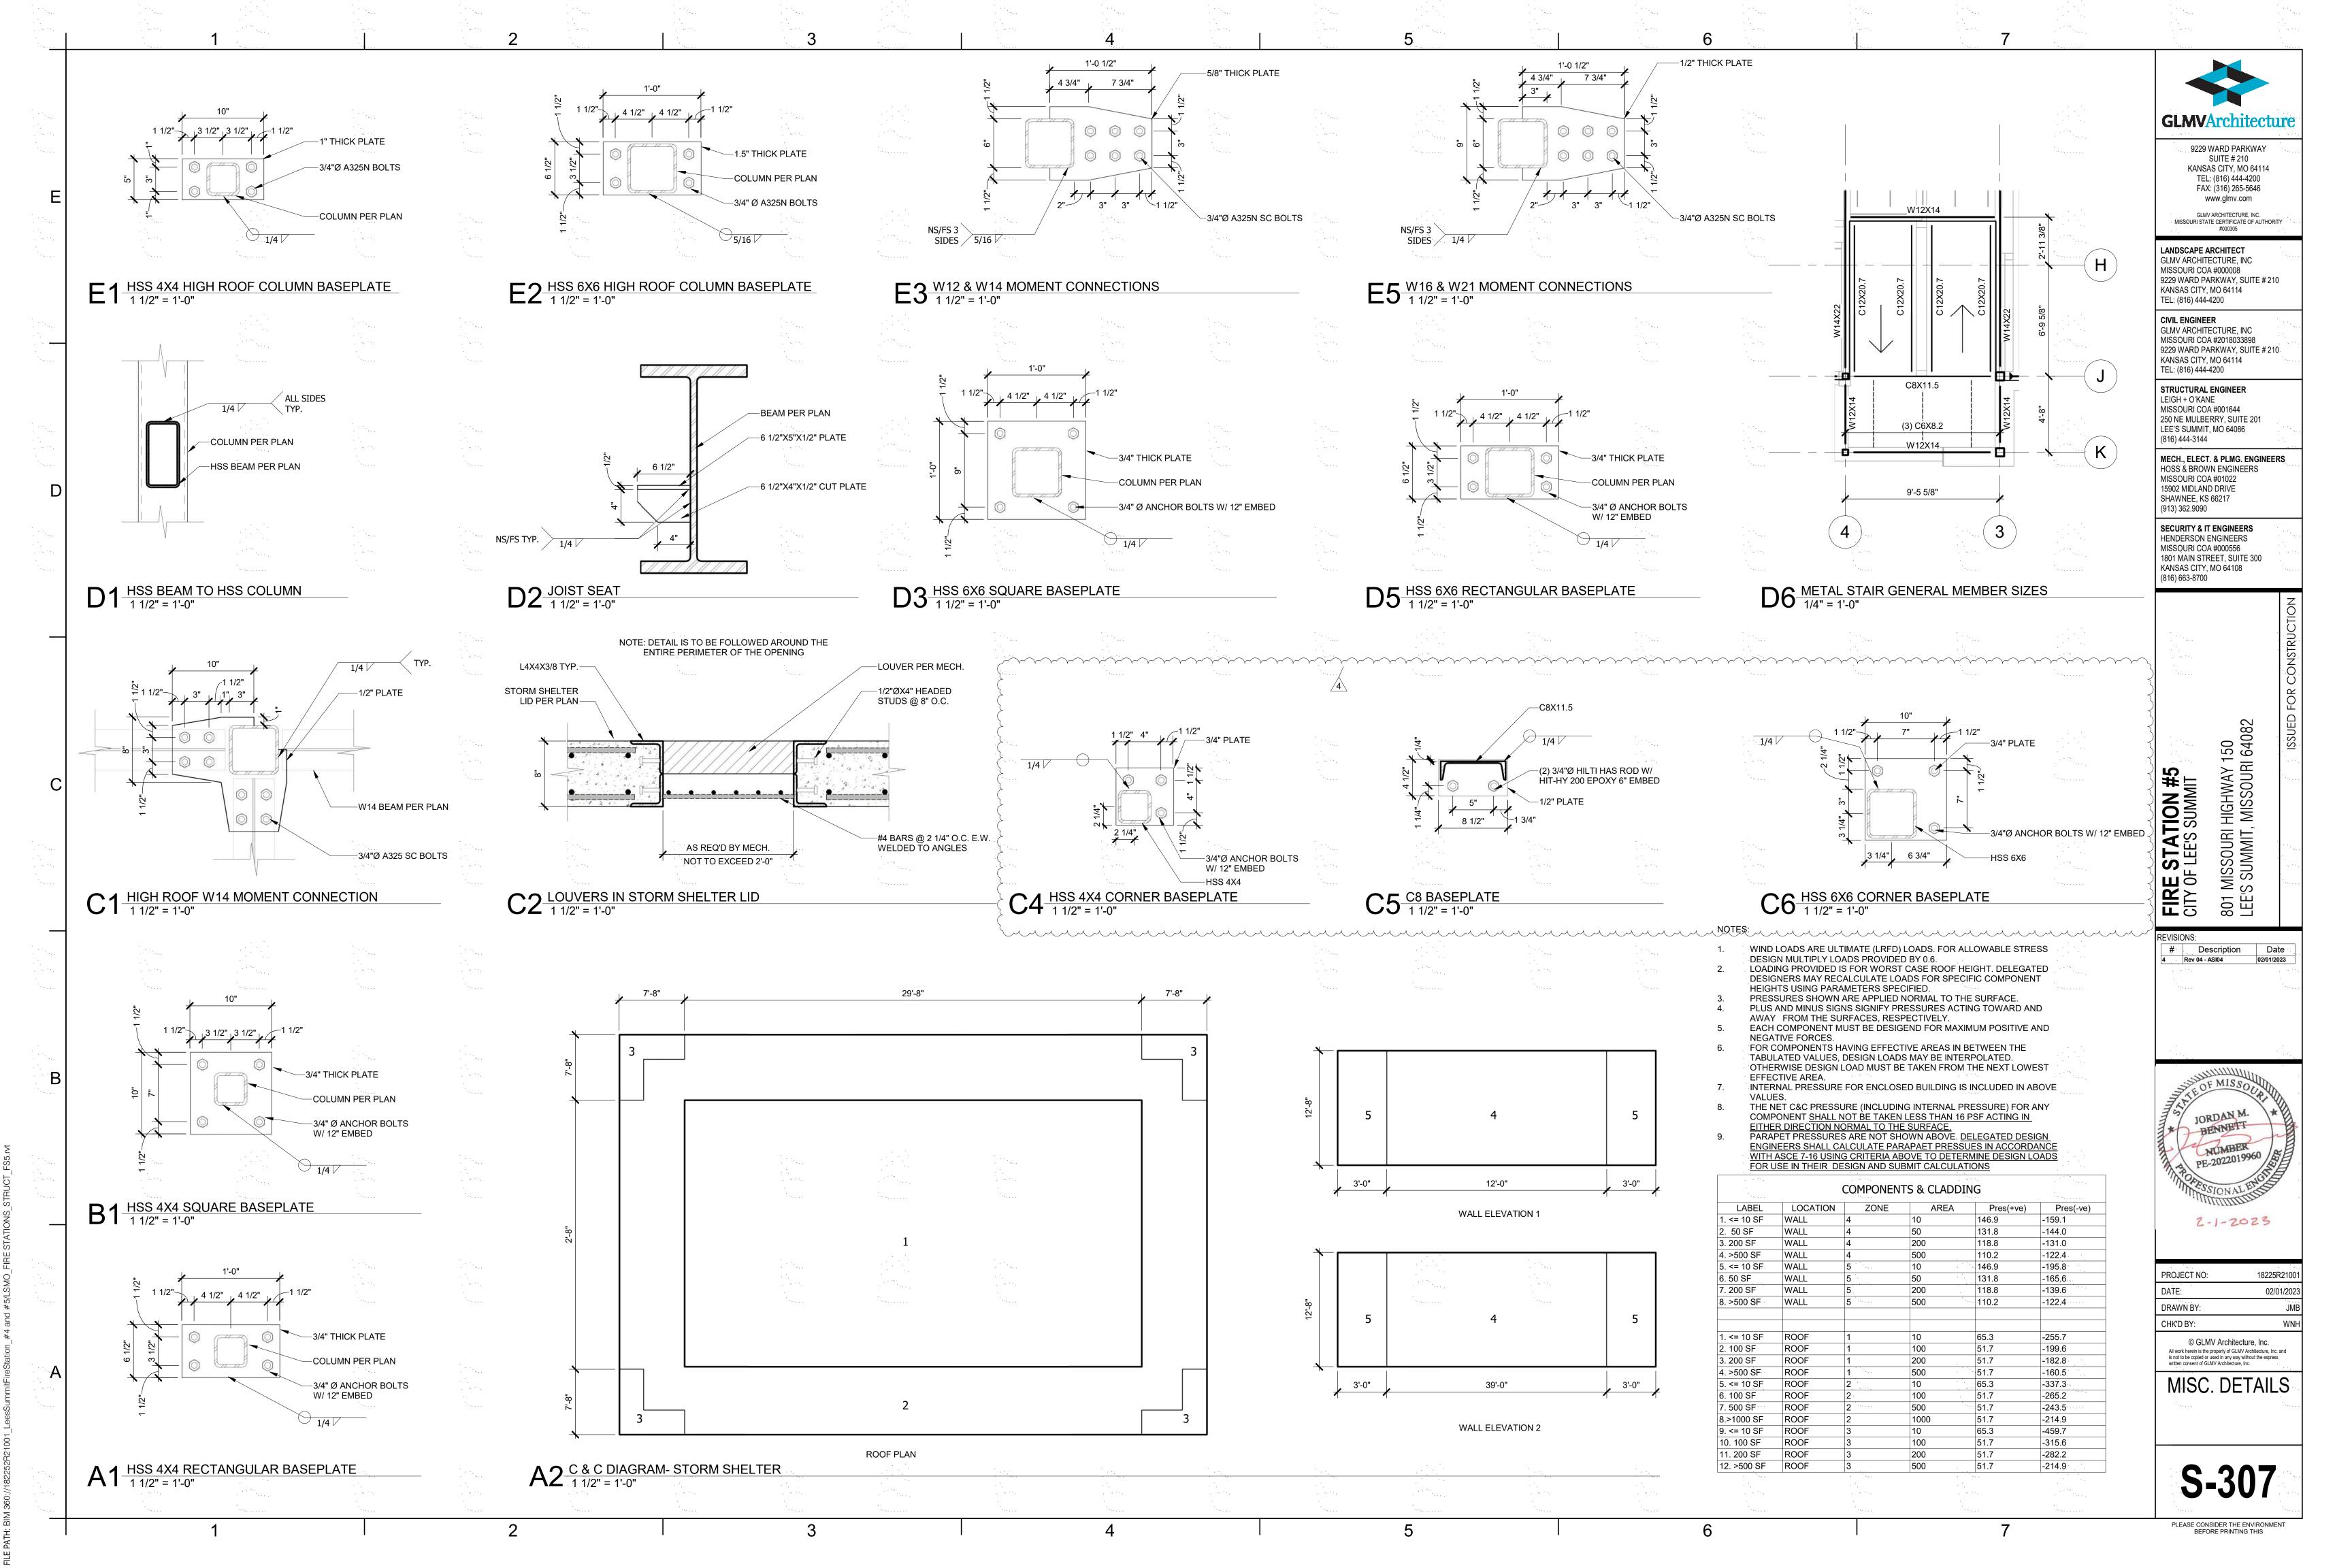

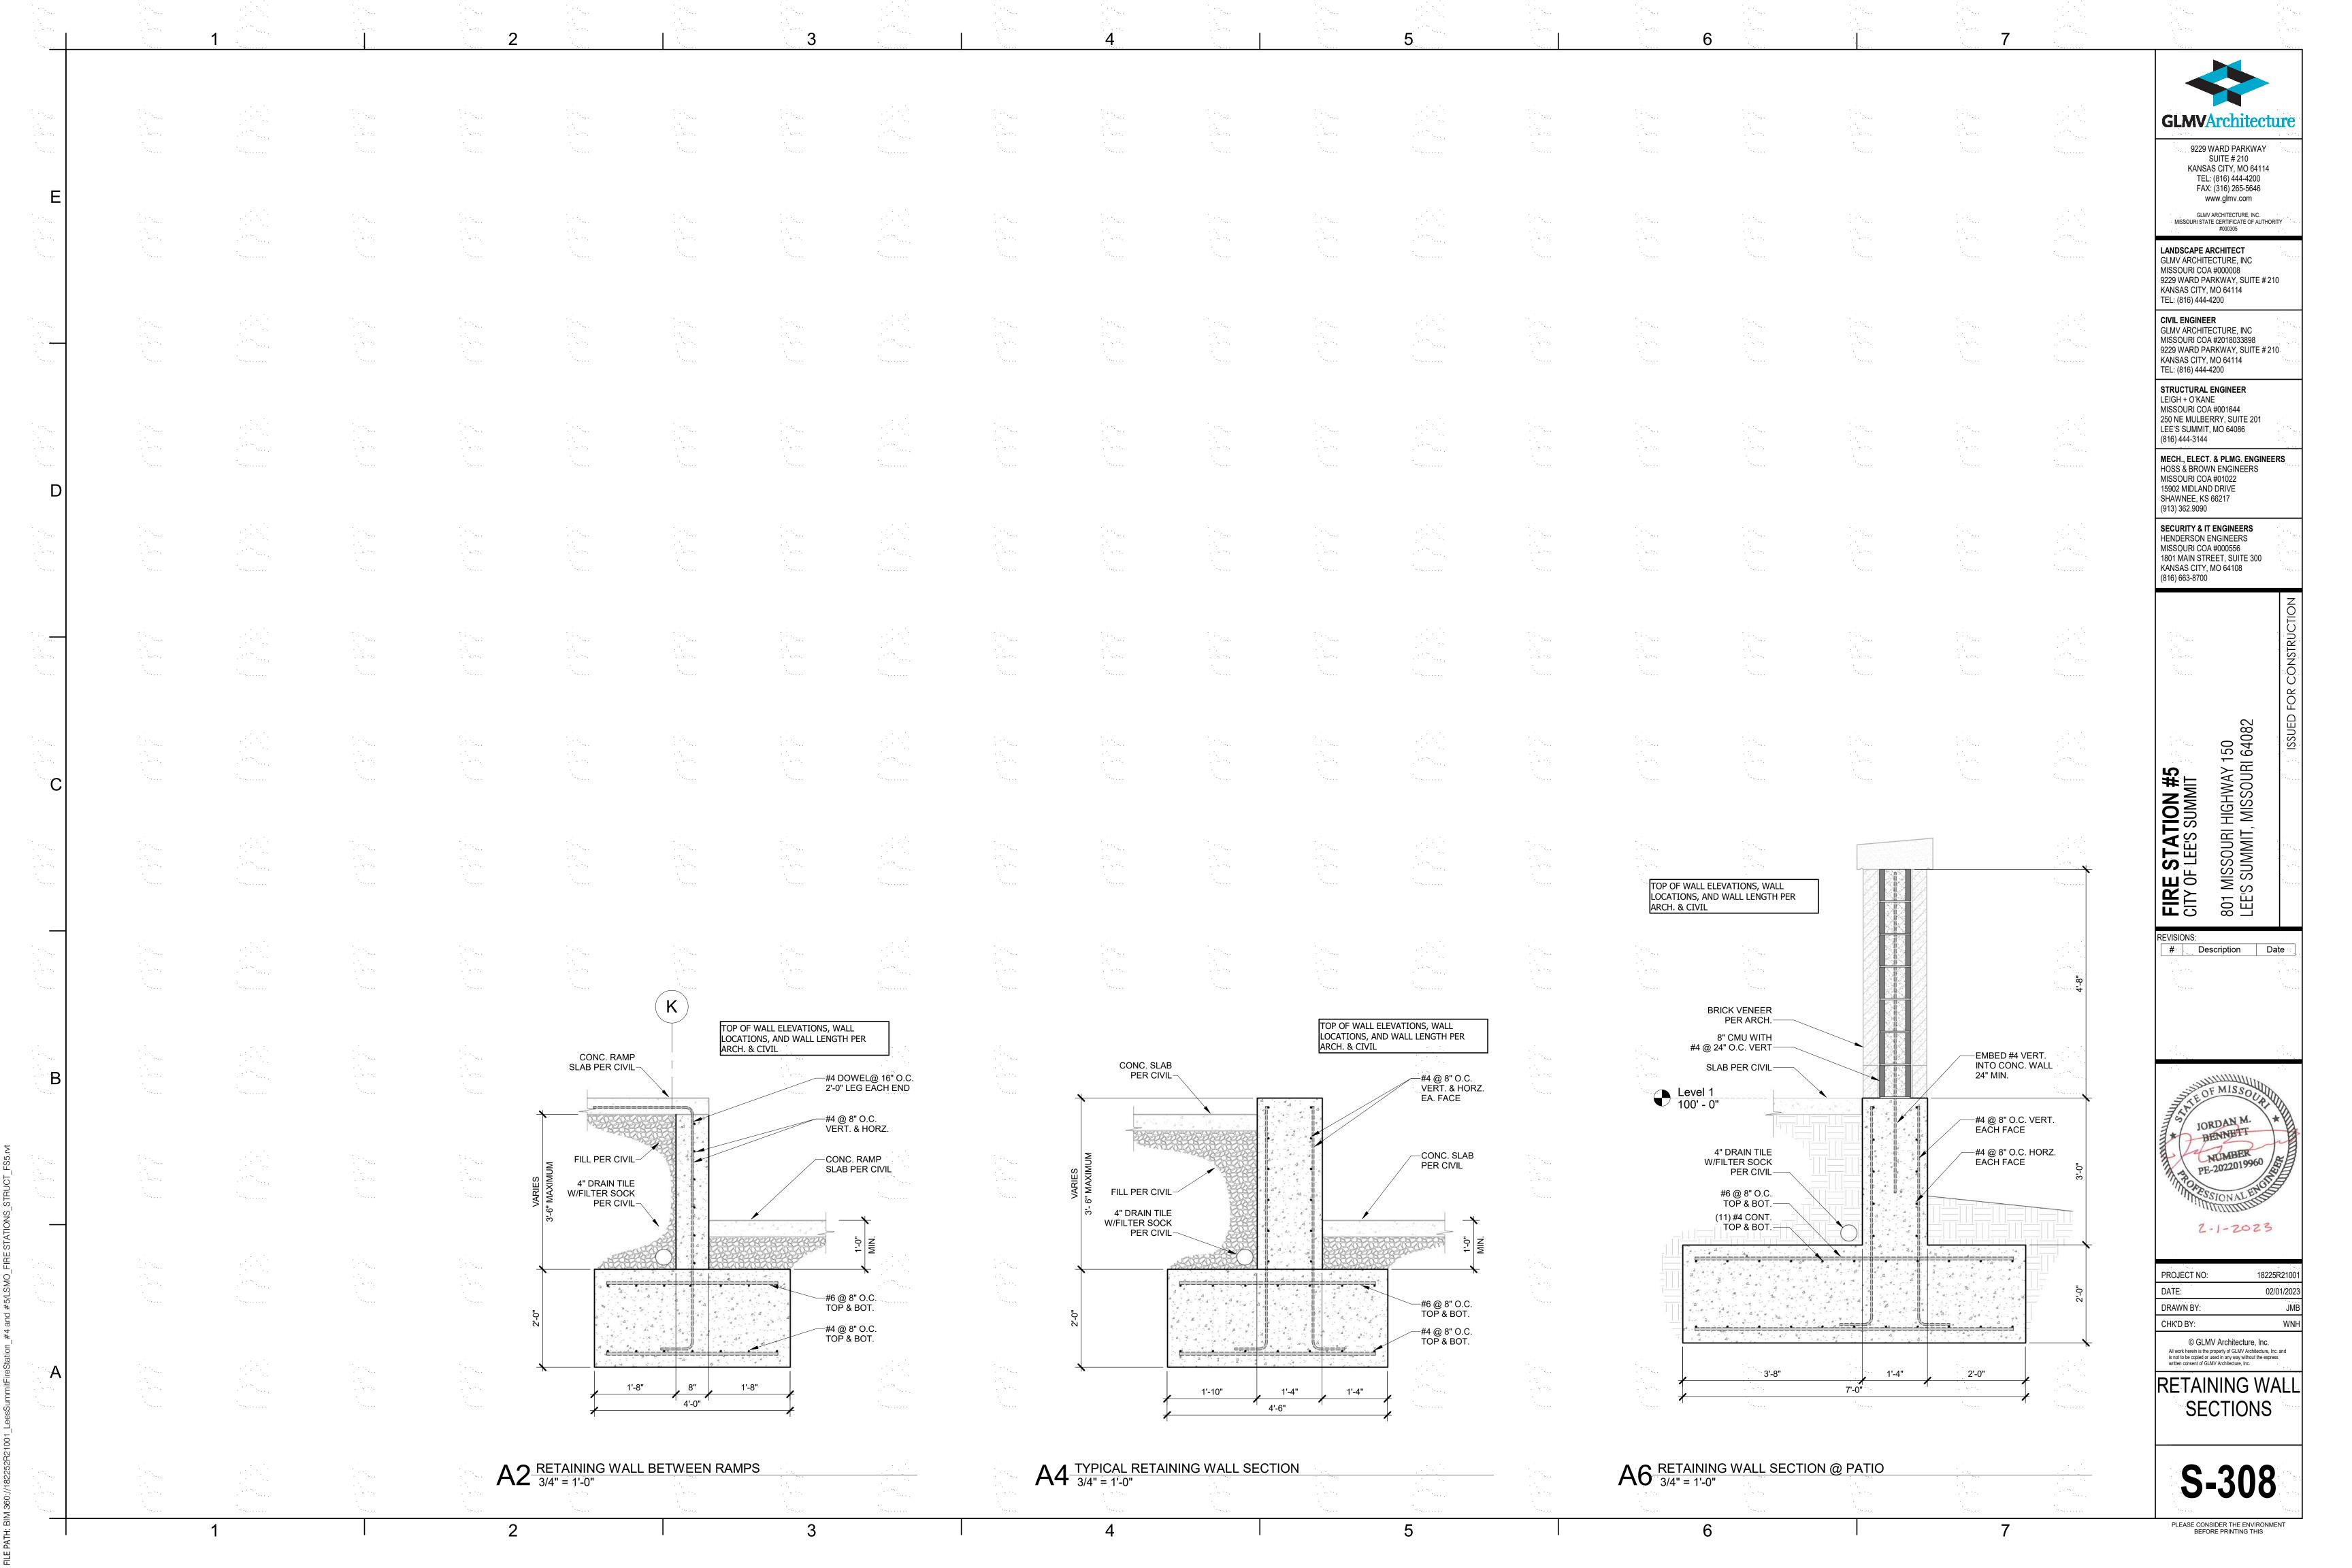

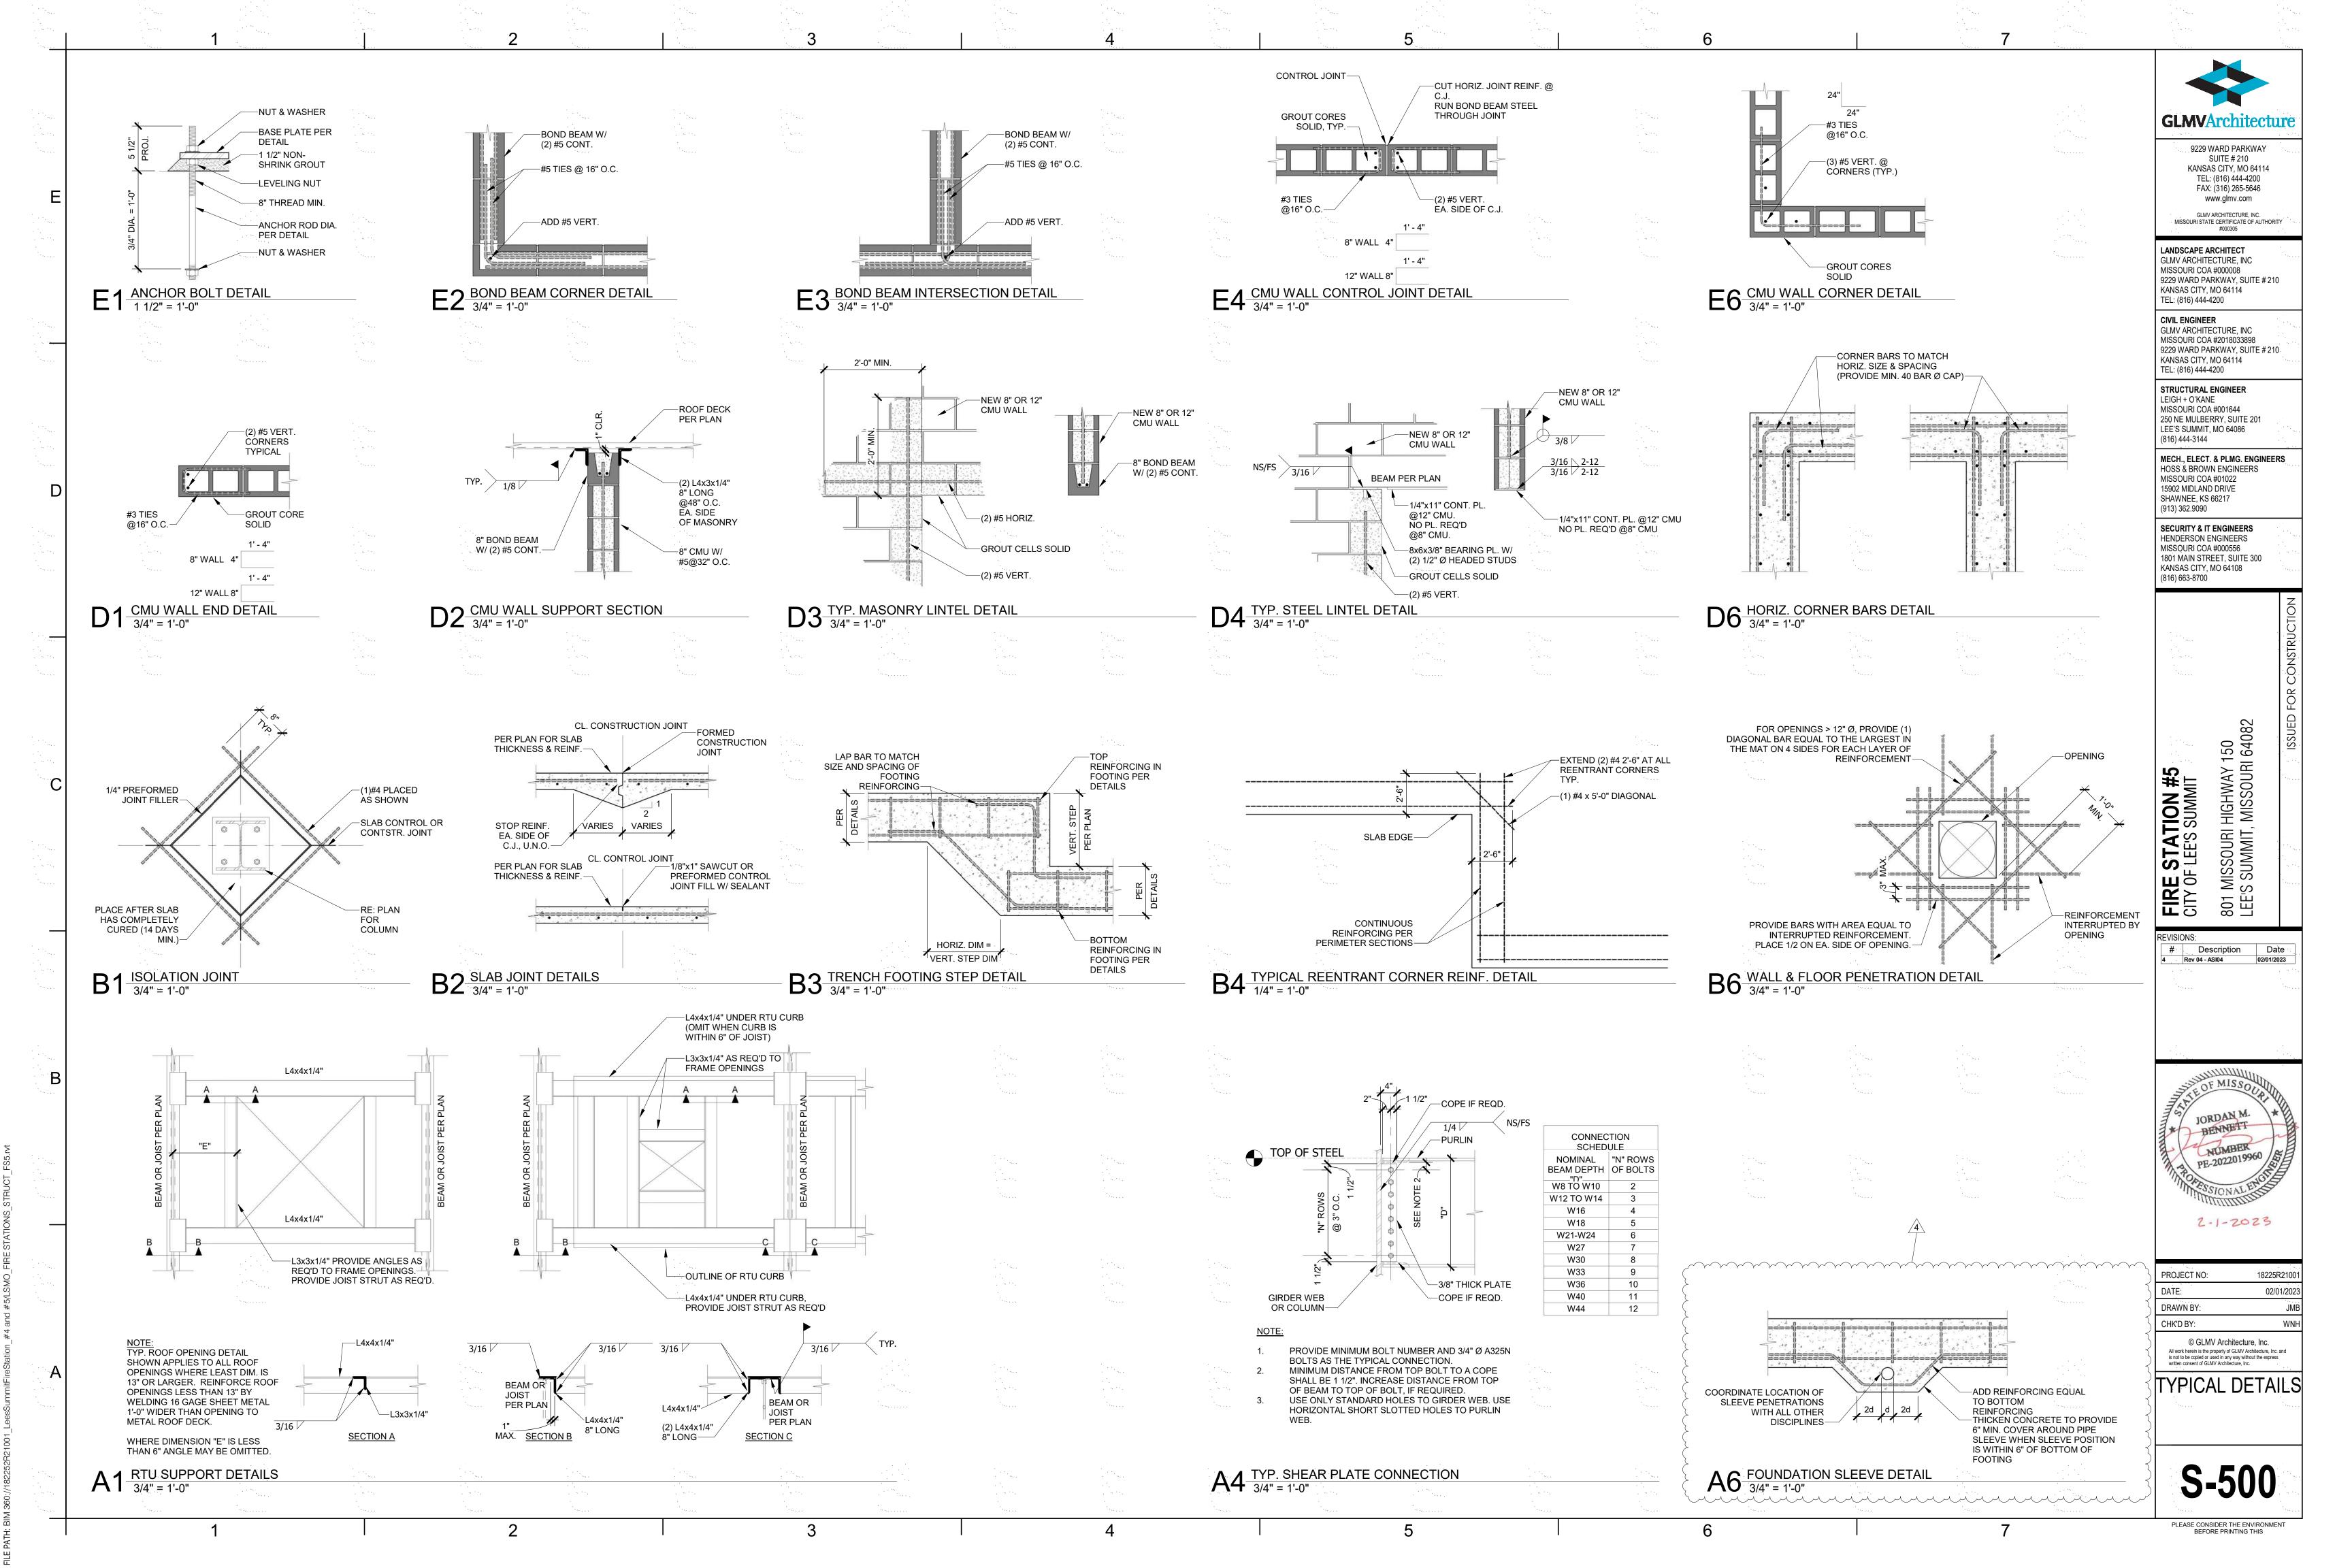

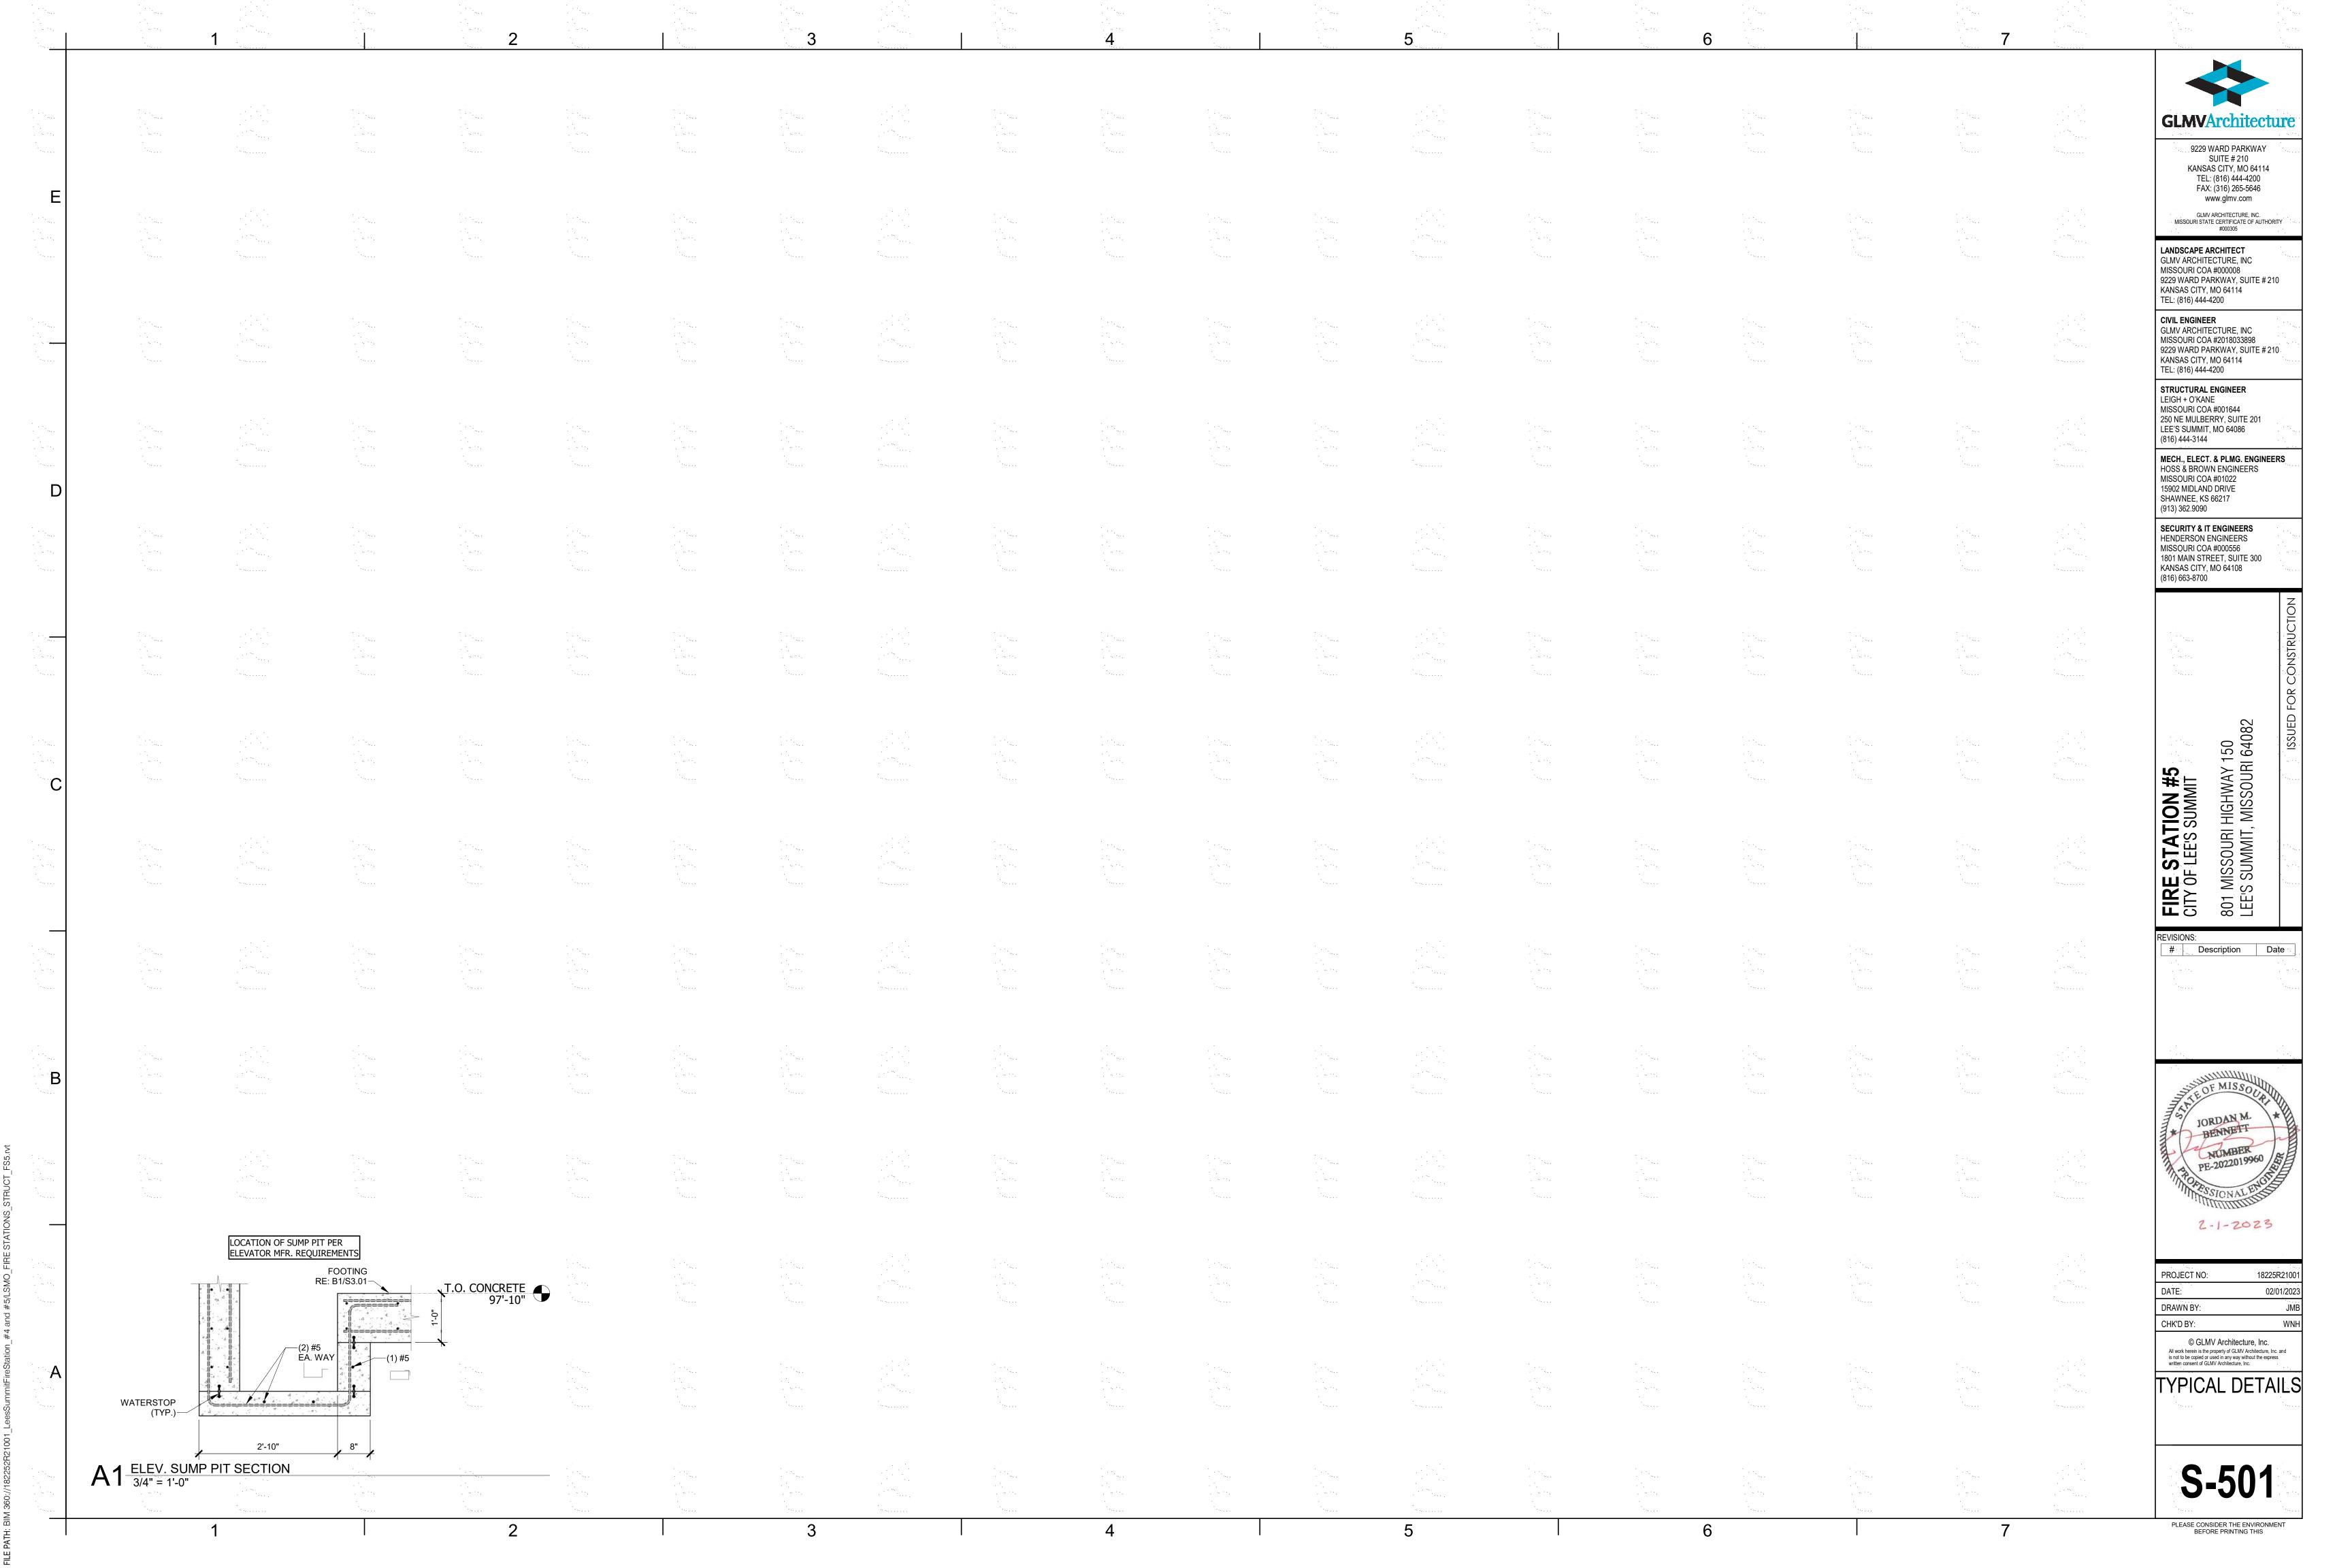

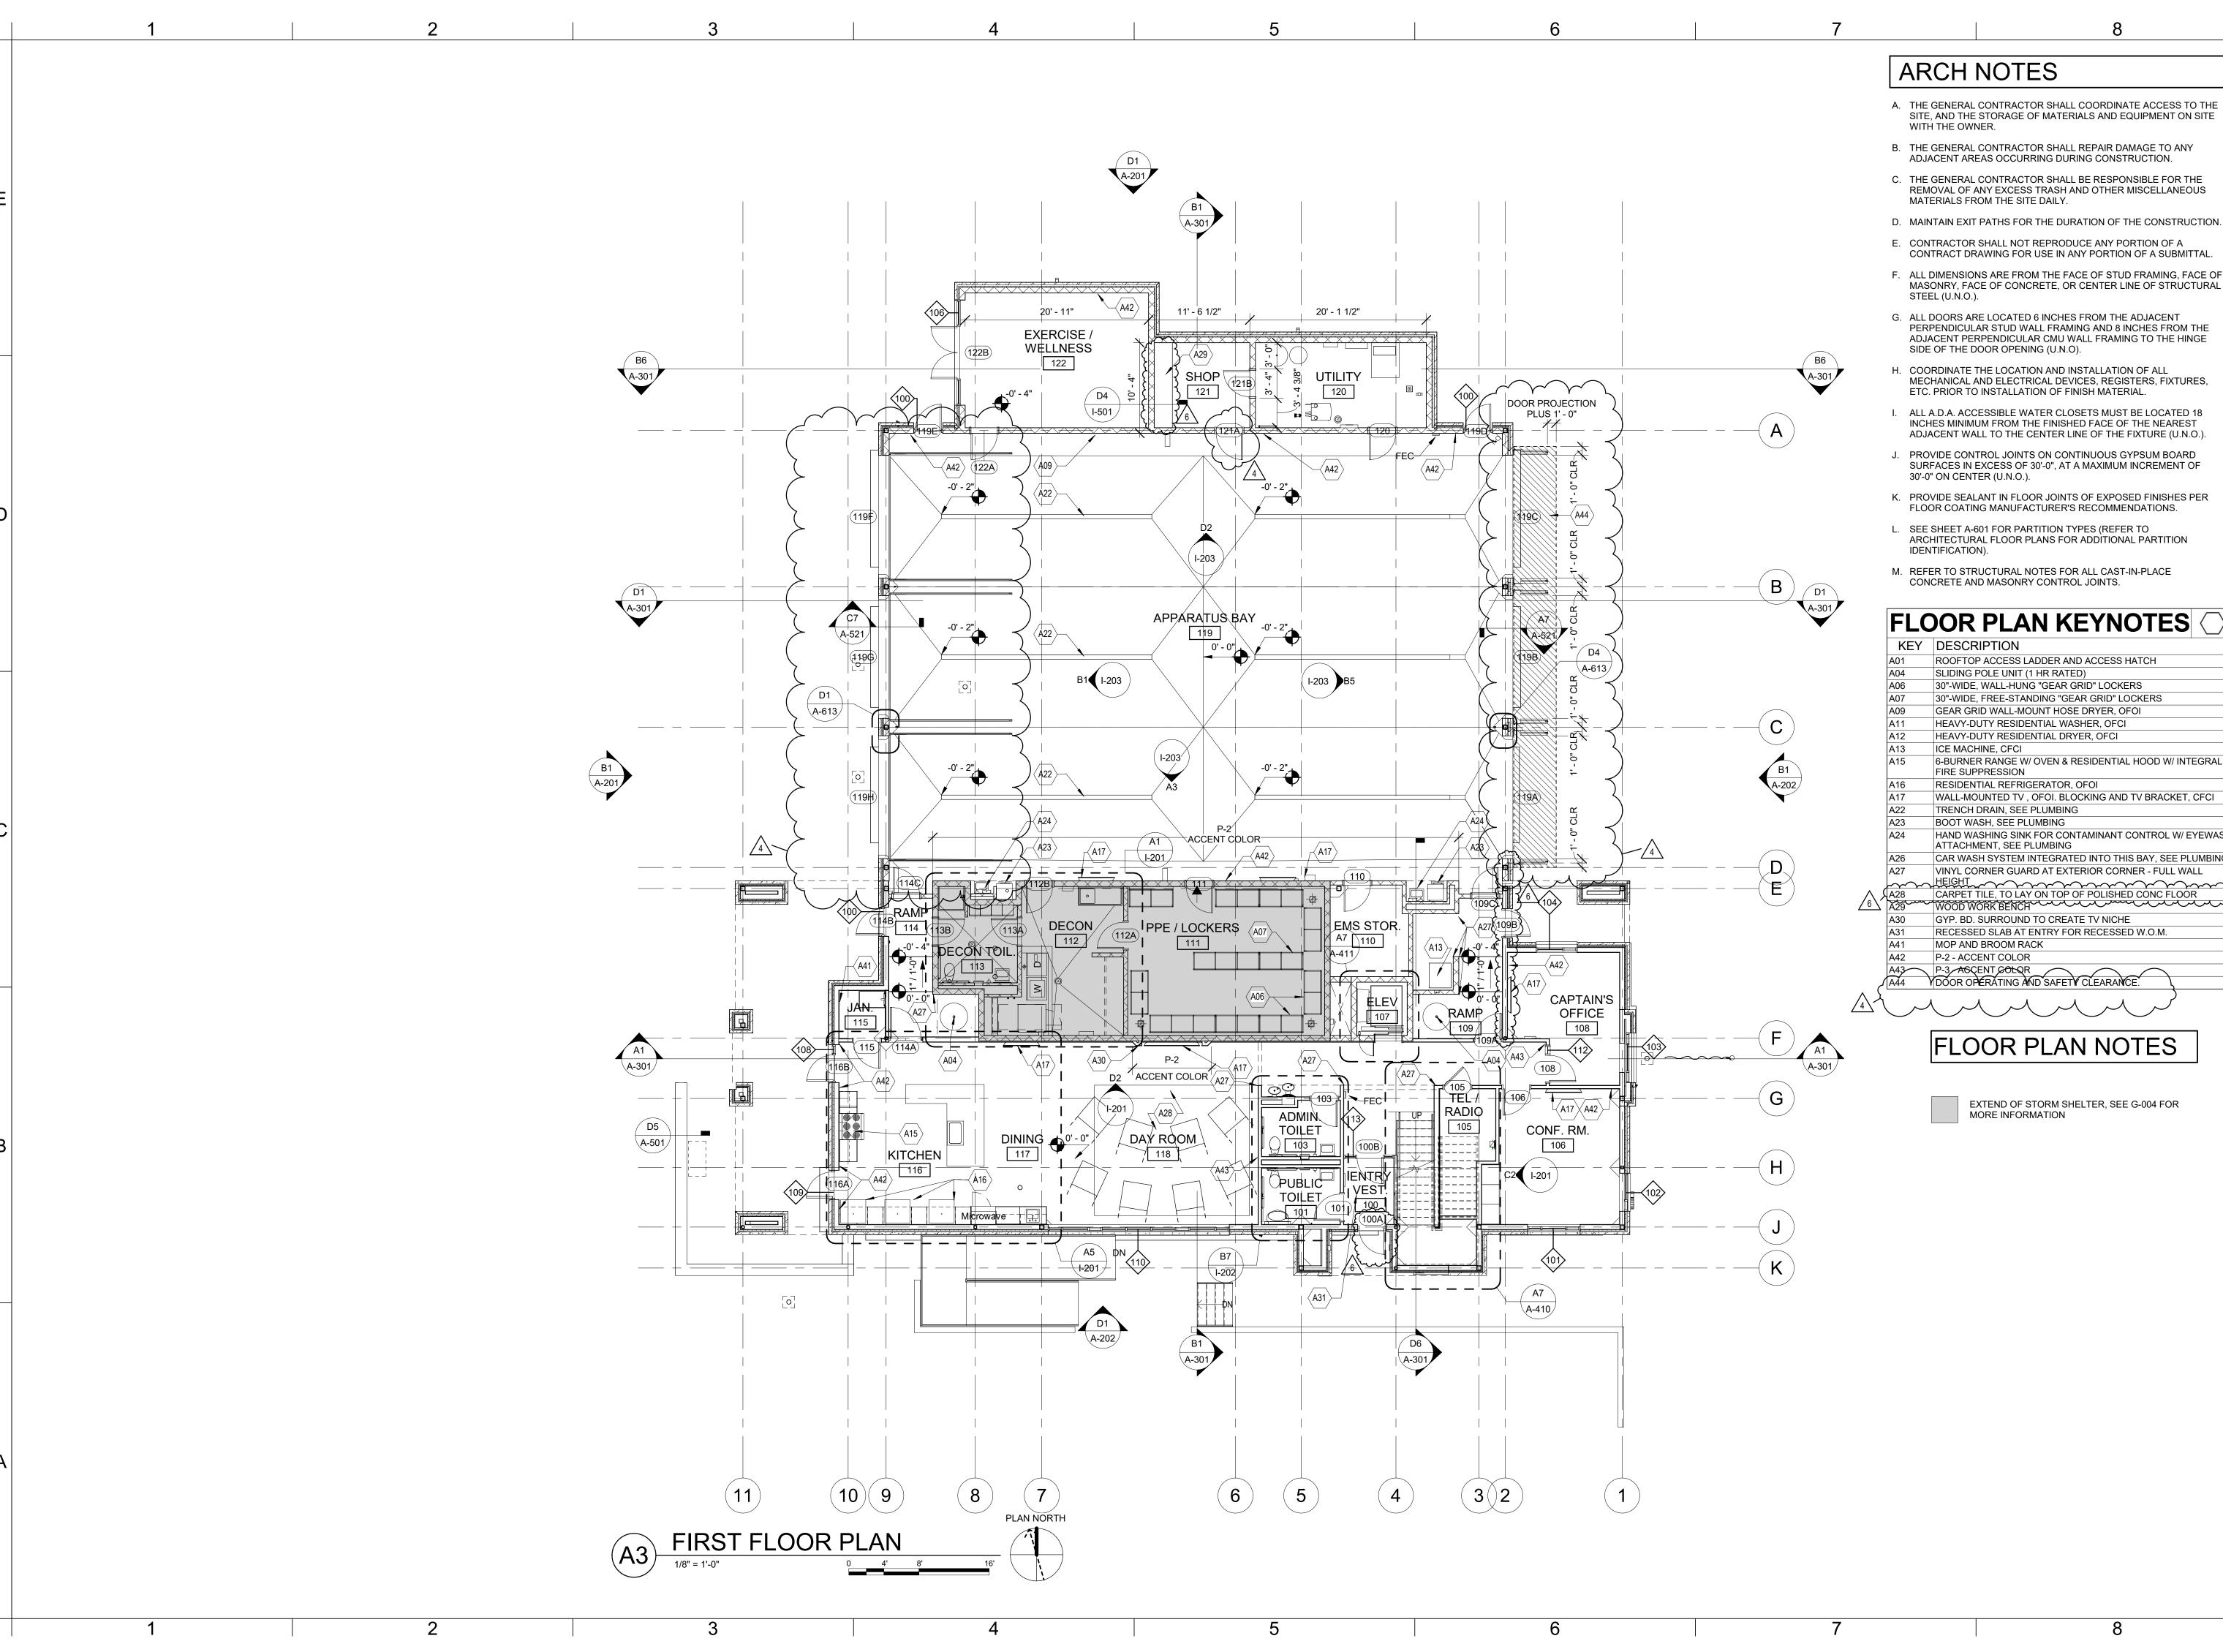

- A. THE GENERAL CONTRACTOR SHALL COORDINATE ACCESS TO THE SITE, AND THE STORAGE OF MATERIALS AND EQUIPMENT ON SITE
- B. THE GENERAL CONTRACTOR SHALL REPAIR DAMAGE TO ANY
- C. THE GENERAL CONTRACTOR SHALL BE RESPONSIBLE FOR THE REMOVAL OF ANY EXCESS TRASH AND OTHER MISCELLANEOUS
- E. CONTRACTOR SHALL NOT REPRODUCE ANY PORTION OF A CONTRACT DRAWING FOR USE IN ANY PORTION OF A SUBMITTAL.
- F. ALL DIMENSIONS ARE FROM THE FACE OF STUD FRAMING, FACE OF MASONRY, FACE OF CONCRETE, OR CENTER LINE OF STRUCTURAL
- G. ALL DOORS ARE LOCATED 6 INCHES FROM THE ADJACENT PERPENDICULAR STUD WALL FRAMING AND 8 INCHES FROM THE ADJACENT PERPENDICULAR CMU WALL FRAMING TO THE HINGE
- H. COORDINATE THE LOCATION AND INSTALLATION OF ALL MECHANICAL AND ELECTRICAL DEVICES, REGISTERS, FIXTURES,
- I. ALL A.D.A. ACCESSIBLE WATER CLOSETS MUST BE LOCATED 18 INCHES MINIMUM FROM THE FINISHED FACE OF THE NEAREST
- J. PROVIDE CONTROL JOINTS ON CONTINUOUS GYPSUM BOARD SURFACES IN EXCESS OF 30'-0", AT A MAXIMUM INCREMENT OF
- K. PROVIDE SEALANT IN FLOOR JOINTS OF EXPOSED FINISHES PER
- L. SEE SHEET A-601 FOR PARTITION TYPES (REFER TO ARCHITECTURAL FLOOR PLANS FOR ADDITIONAL PARTITION
- M. REFER TO STRUCTURAL NOTES FOR ALL CAST-IN-PLACE CONCRETE AND MASONRY CONTROL JOINTS.

# FLOOR PLAN KEYNOTES

	KEY	DESCRIPTION	
	A01	ROOFTOP ACCESS LADDER AND ACCESS HATCH	
	A04	SLIDING POLE UNIT (1 HR RATED)	
	A06	30"-WIDE, WALL-HUNG "GEAR GRID" LOCKERS	
	A07	30"-WIDE, FREE-STANDING "GEAR GRID" LOCKERS	
	A09	GEAR GRID WALL-MOUNT HOSE DRYER, OFOI	
	A11	HEAVY-DUTY RESIDENTIAL WASHER, OFCI	
	A12	HEAVY-DUTY RESIDENTIAL DRYER, OFCI	
	A13	ICE MACHINE, CFCI	
	A15	6-BURNER RANGE W/ OVEN & RESIDENTIAL HOOD W/ INTEFIRE SUPPRESSION	EGRAL
	A16	RESIDENTIAL REFRIGERATOR, OFOI	
	A17	WALL-MOUNTED TV , OFOI. BLOCKING AND TV BRACKET,	CFCI
	A22	TRENCH DRAIN, SEE PLUMBING	
	A23	BOOT WASH, SEE PLUMBING	
	A24	HAND WASHING SINK FOR CONTAMINANT CONTROL W/ E'ATTACHMENT, SEE PLUMBING	YEWASH
	A26	CAR WASH SYSTEM INTEGRATED INTO THIS BAY, SEE PLI	JMBING
	A27	VINYL CORNER GUARD AT EXTERIOR CORNER - FULL WA	LL
6	A28	CARPET TILE, TO LAY ON TOP OF POLISHED CONC FLOOR	<del>~~~~</del>
	A29	WOOD WORK BENCH	
	A30	GYP. BD. SURROUND TO CREATE TV NICHE	
	A31	RECESSED SLAB AT ENTRY FOR RECESSED W.O.M.	
	A41	MOP AND BROOM RACK	
	A42	P-2 - ACCENT COLOR	
	A43	P-3 AGCENT COLOR	
/	1.74		

# FLOOR PLAN NOTES

EXTEND OF STORM SHELTER, SEE G-004 FOR MORE INFORMATION



**GLMV**Architecture 9229 WARD PARKWAY SUITE # 210

KANSAS CITY, MO 64114 TEL: (816) 444-4200

FAX: (316) 265-5646 www.glmv.com

GLMV ARCHITECTURE, INC. MISSOURI STATE CERTIFICATE OF AUTHORITY #000305 CONSULTING ARCHITECT FGMA ARCHITECTS

11250 ROGER BACON DRIVE, SUITE 16 RESTON, VIRGINIA 20190 TEL: (703) 956-5600

CIVIL ENGINEER & LANDSCAPE ARCH. GLMV ARCHITECTURE, INC MISSOURI CIVIL COA #2018033898 MISSOURI LANDSCAPE COA #000008 9229 WARD PARKWAY, SUITE # 210

KANSAS CITY, MO 64114 TEL: (816) 444-4200 STRUCTURAL ENGINEER

LEIGH + O'KANE MISSOURI COA #001644 250 NE MULBERRY, SUITE 201 LEE'S SUMMIT, MO 64086 (816) 444-3144

MECH., ELECT. & PLMG. ENGINEERS HOSS & BROWN ENGINEERS MISSOURI COA #01022 15902 MIDLAND DRIVE SHAWNEE, KS 66217


SECURITY & IT ENGINEERS HENDERSON ENGINEERS MISSOURI COA #000556 1801 MAIN STREET, SUITE 300 KANSAS CITY, MO 64108 (816) 663-8700

(913) 362.9090

801 MISSOUF LEE'S SUMMI

FIRE STAT CITY OF LEE'


REVISIONS: 1 ASI 01 4 ASI 04 6 ASI 06 11/21/2022 02/01/2023 02/22/2023

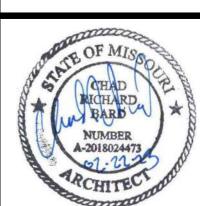

CHAD R. BARD - ARCHITECT MO# A-2018024473

PROJECT NO: 18225R21001 DATE: 02.22.2023 DRAWN BY: CHK'D BY: © GLMV Architecture, Inc. All work herein is the property of GLMV
Architecture, Inc. and is not to be copied or used
in any way without the express written consent of
GLMV Architecture, Inc.

FIRST FLOOR

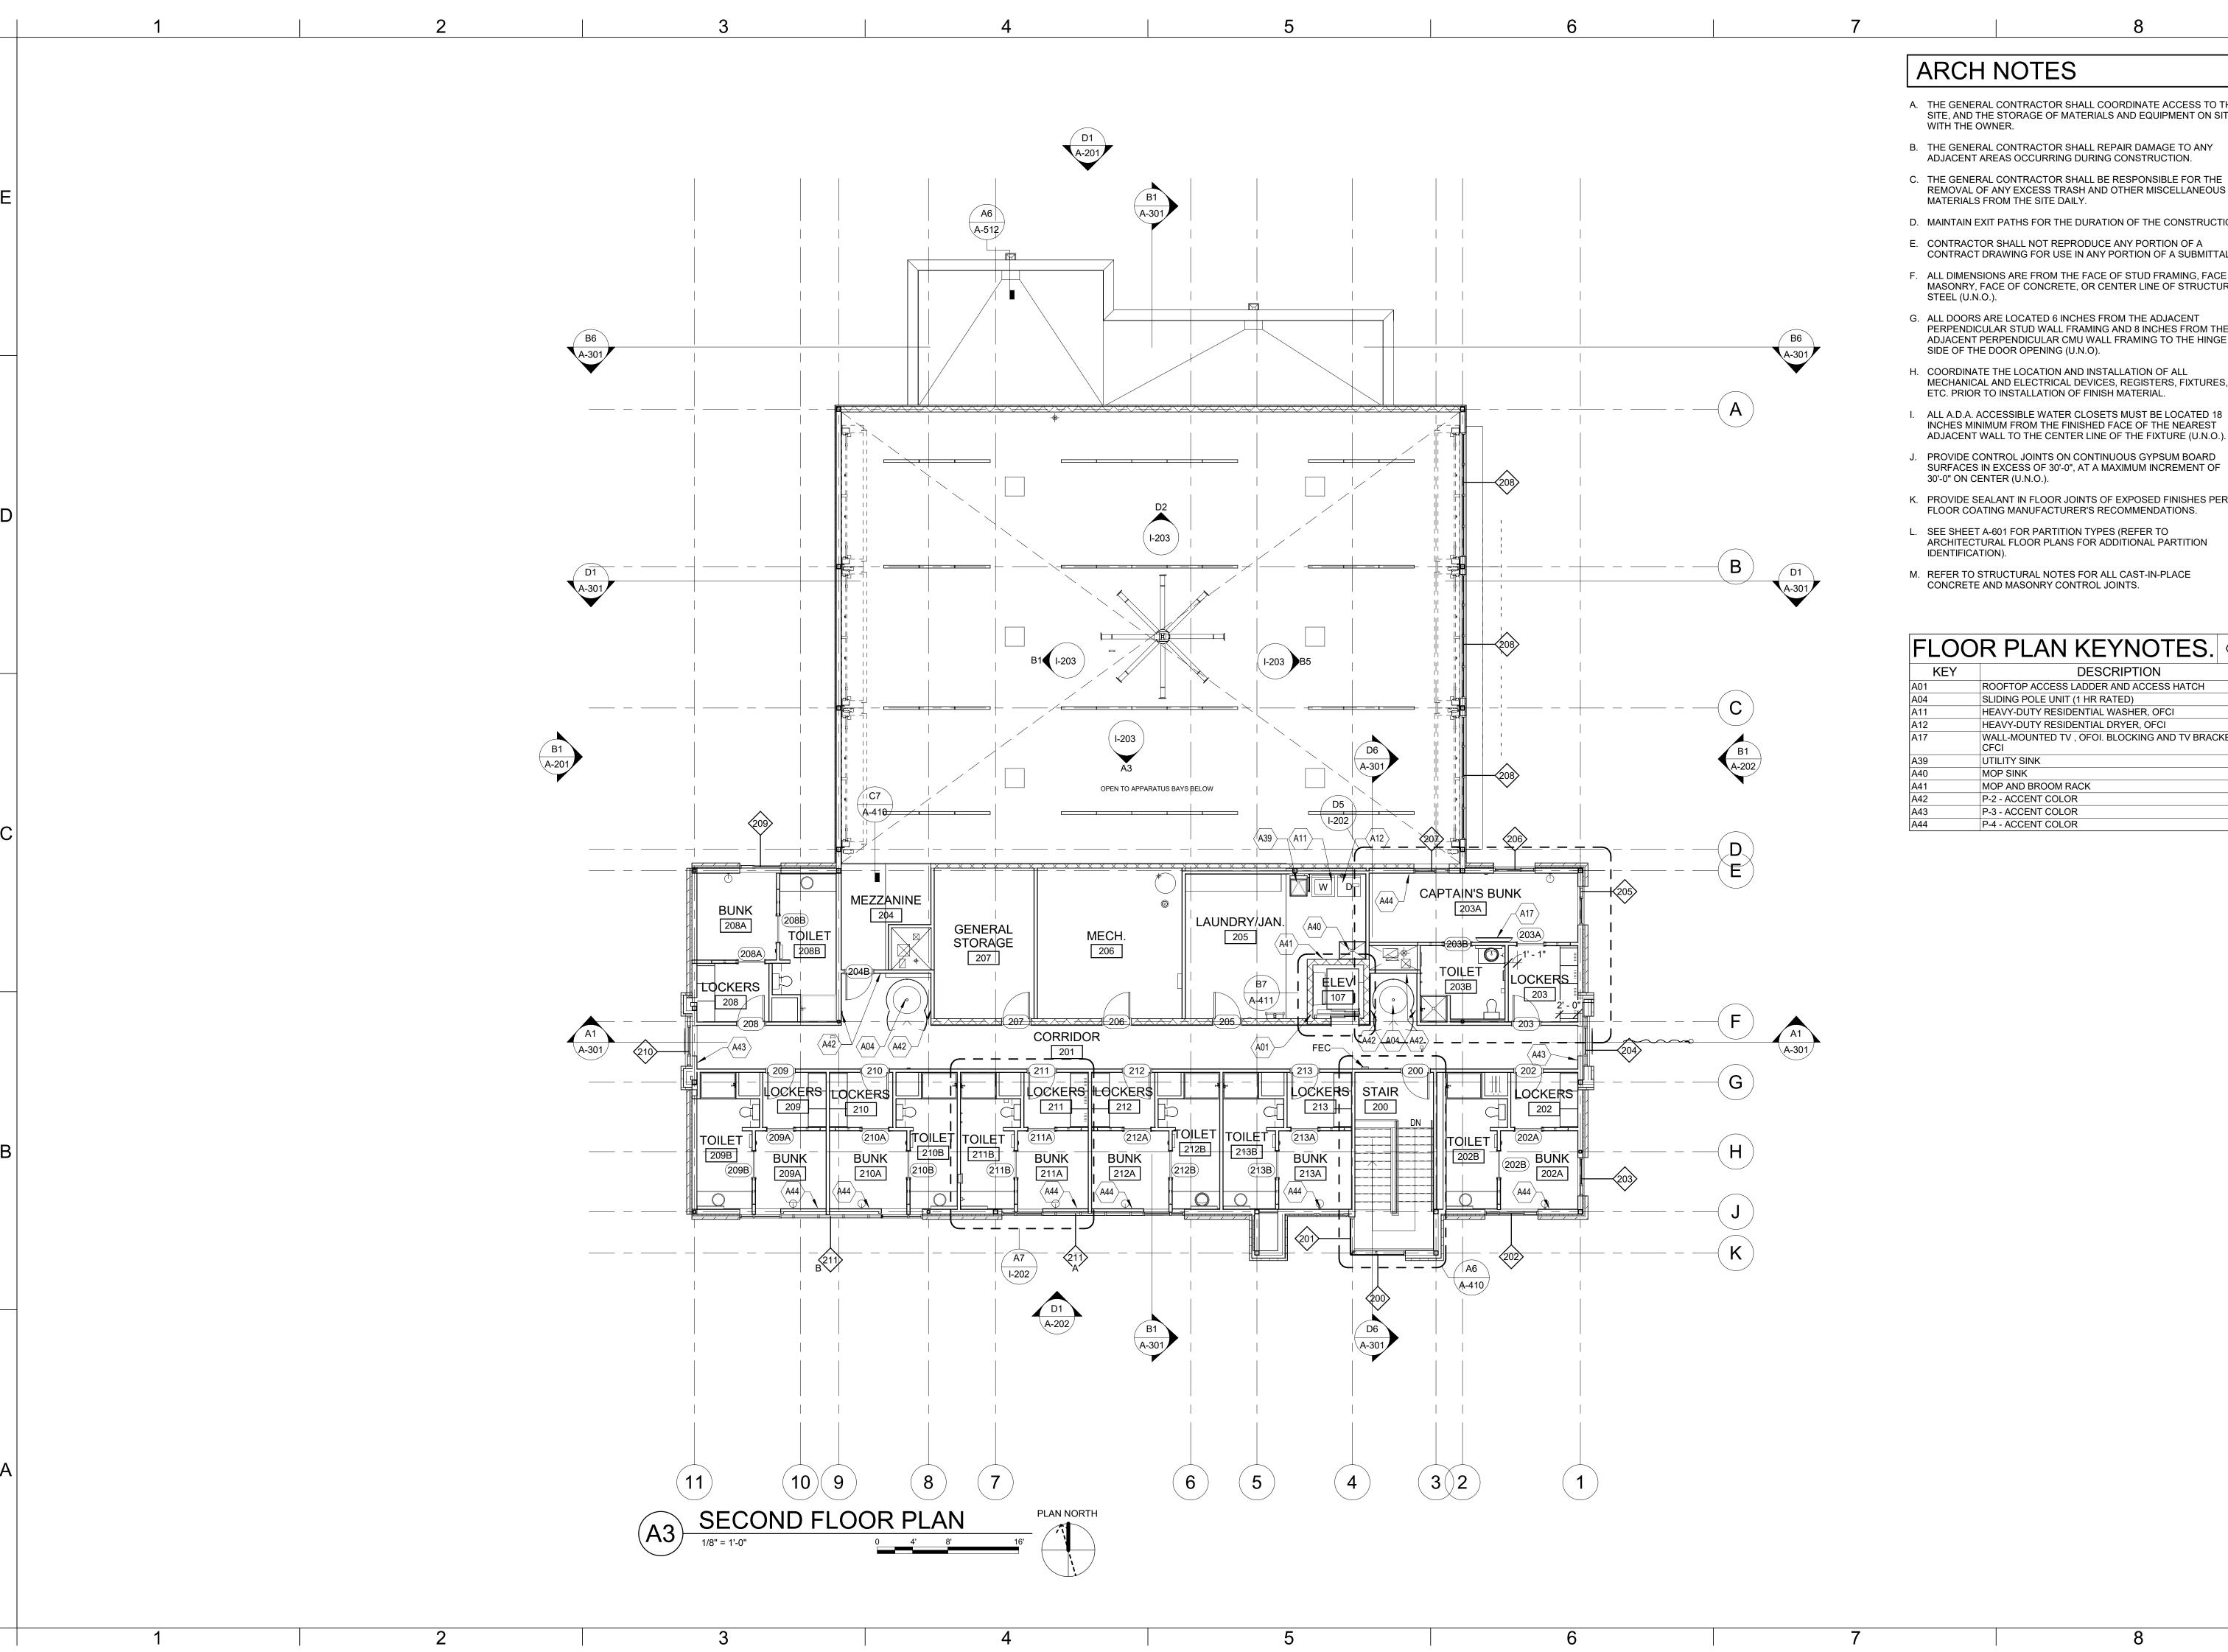

### **ARCH NOTES**

- A. THE GENERAL CONTRACTOR SHALL COORDINATE ACCESS TO THE SITE, AND THE STORAGE OF MATERIALS AND EQUIPMENT ON SITE
- B. THE GENERAL CONTRACTOR SHALL REPAIR DAMAGE TO ANY ADJACENT AREAS OCCURRING DURING CONSTRUCTION.
- C. THE GENERAL CONTRACTOR SHALL BE RESPONSIBLE FOR THE REMOVAL OF ANY EXCESS TRASH AND OTHER MISCELLANEOUS MATERIALS FROM THE SITE DAILY.
- D. MAINTAIN EXIT PATHS FOR THE DURATION OF THE CONSTRUCTION.
- CONTRACTOR SHALL NOT REPRODUCE ANY PORTION OF A CONTRACT DRAWING FOR USE IN ANY PORTION OF A SUBMITTAL.
- F. ALL DIMENSIONS ARE FROM THE FACE OF STUD FRAMING, FACE OF MASONRY, FACE OF CONCRETE, OR CENTER LINE OF STRUCTURAL
- G. ALL DOORS ARE LOCATED 6 INCHES FROM THE ADJACENT PERPENDICULAR STUD WALL FRAMING AND 8 INCHES FROM THE ADJACENT PERPENDICULAR CMU WALL FRAMING TO THE HINGE SIDE OF THE DOOR OPENING (U.N.O).
- H. COORDINATE THE LOCATION AND INSTALLATION OF ALL MECHANICAL AND ELECTRICAL DEVICES, REGISTERS, FIXTURES,
- ALL A.D.A. ACCESSIBLE WATER CLOSETS MUST BE LOCATED 18 INCHES MINIMUM FROM THE FINISHED FACE OF THE NEAREST
- PROVIDE CONTROL JOINTS ON CONTINUOUS GYPSUM BOARD SURFACES IN EXCESS OF 30'-0", AT A MAXIMUM INCREMENT OF
- K. PROVIDE SEALANT IN FLOOR JOINTS OF EXPOSED FINISHES PER FLOOR COATING MANUFACTURER'S RECOMMENDATIONS.
- L. SEE SHEET A-601 FOR PARTITION TYPES (REFER TO ARCHITECTURAL FLOOR PLANS FOR ADDITIONAL PARTITION IDENTIFICATION).
- M. REFER TO STRUCTURAL NOTES FOR ALL CAST-IN-PLACE CONCRETE AND MASONRY CONTROL JOINTS.

## FLOOR PLAN KEYNOTES.

KEY	DESCRIPTION	
A01	ROOFTOP ACCESS LADDER AND ACCESS HATCH	
A04	SLIDING POLE UNIT (1 HR RATED)	
A11	HEAVY-DUTY RESIDENTIAL WASHER, OFCI	
A12	HEAVY-DUTY RESIDENTIAL DRYER, OFCI	
A17	WALL-MOUNTED TV , OFOI. BLOCKING AND TV BRACKET, CFCI	
A39	UTILITY SINK	
A40	MOP SINK	
A41	MOP AND BROOM RACK	
A42	P-2 - ACCENT COLOR	
A43	P-3 - ACCENT COLOR	
A44	P-4 - ACCENT COLOR	



FAX: (316) 265-5646 www.glmv.com

GLMV ARCHITECTURE, INC. MISSOURI STATE CERTIFICATE OF AUTHORITY #000305 CONSULTING ARCHITECT

9229 WARD PARKWAY SUITE # 210

KANSAS CITY, MO 64114

TEL: (816) 444-4200

FGMA ARCHITECTS 11250 ROGER BACON DRIVE, SUITE 16 RESTON, VIRGINIA 20190 TEL: (703) 956-5600

CIVIL ENGINEER & LANDSCAPE ARCH. GLMV ARCHITECTURE, INC MISSOURI CIVIL COA #2018033898

MISSOURI LANDSCAPE COA #000008 9229 WARD PARKWAY, SUITE # 210 KANSAS CITY, MO 64114 TEL: (816) 444-4200

STRUCTURAL ENGINEER LEIGH + O'KANE MISSOURI COA #001644 250 NE MULBERRY, SUITE 201 LEE'S SUMMIT, MO 64086 (816) 444-3144

MECH., ELECT. & PLMG. ENGINEERS HOSS & BROWN ENGINEERS MISSOURI COA #01022 15902 MIDLAND DRIVE SHAWNEE, KS 66217

SECURITY & IT ENGINEERS HENDERSON ENGINEERS MISSOURI COA #000556 1801 MAIN STREET, SUITE 300 KANSAS CITY, MO 64108 (816) 663-8700

(913) 362.9090

801 MISSOUF LEE'S SUMMI


REVISIONS: # Description



PAUL J. MICHELL - ARCHITECT MO# A-2009021701

PROJECT NO: 11.21.2022 DRAWN BY: CHK'D BY:

All work herein is the property of GLMV
Architecture, Inc. and is not to be copied or used
in any way without the express written consent of
GLMV Architecture, Inc. SECOND FLOOR

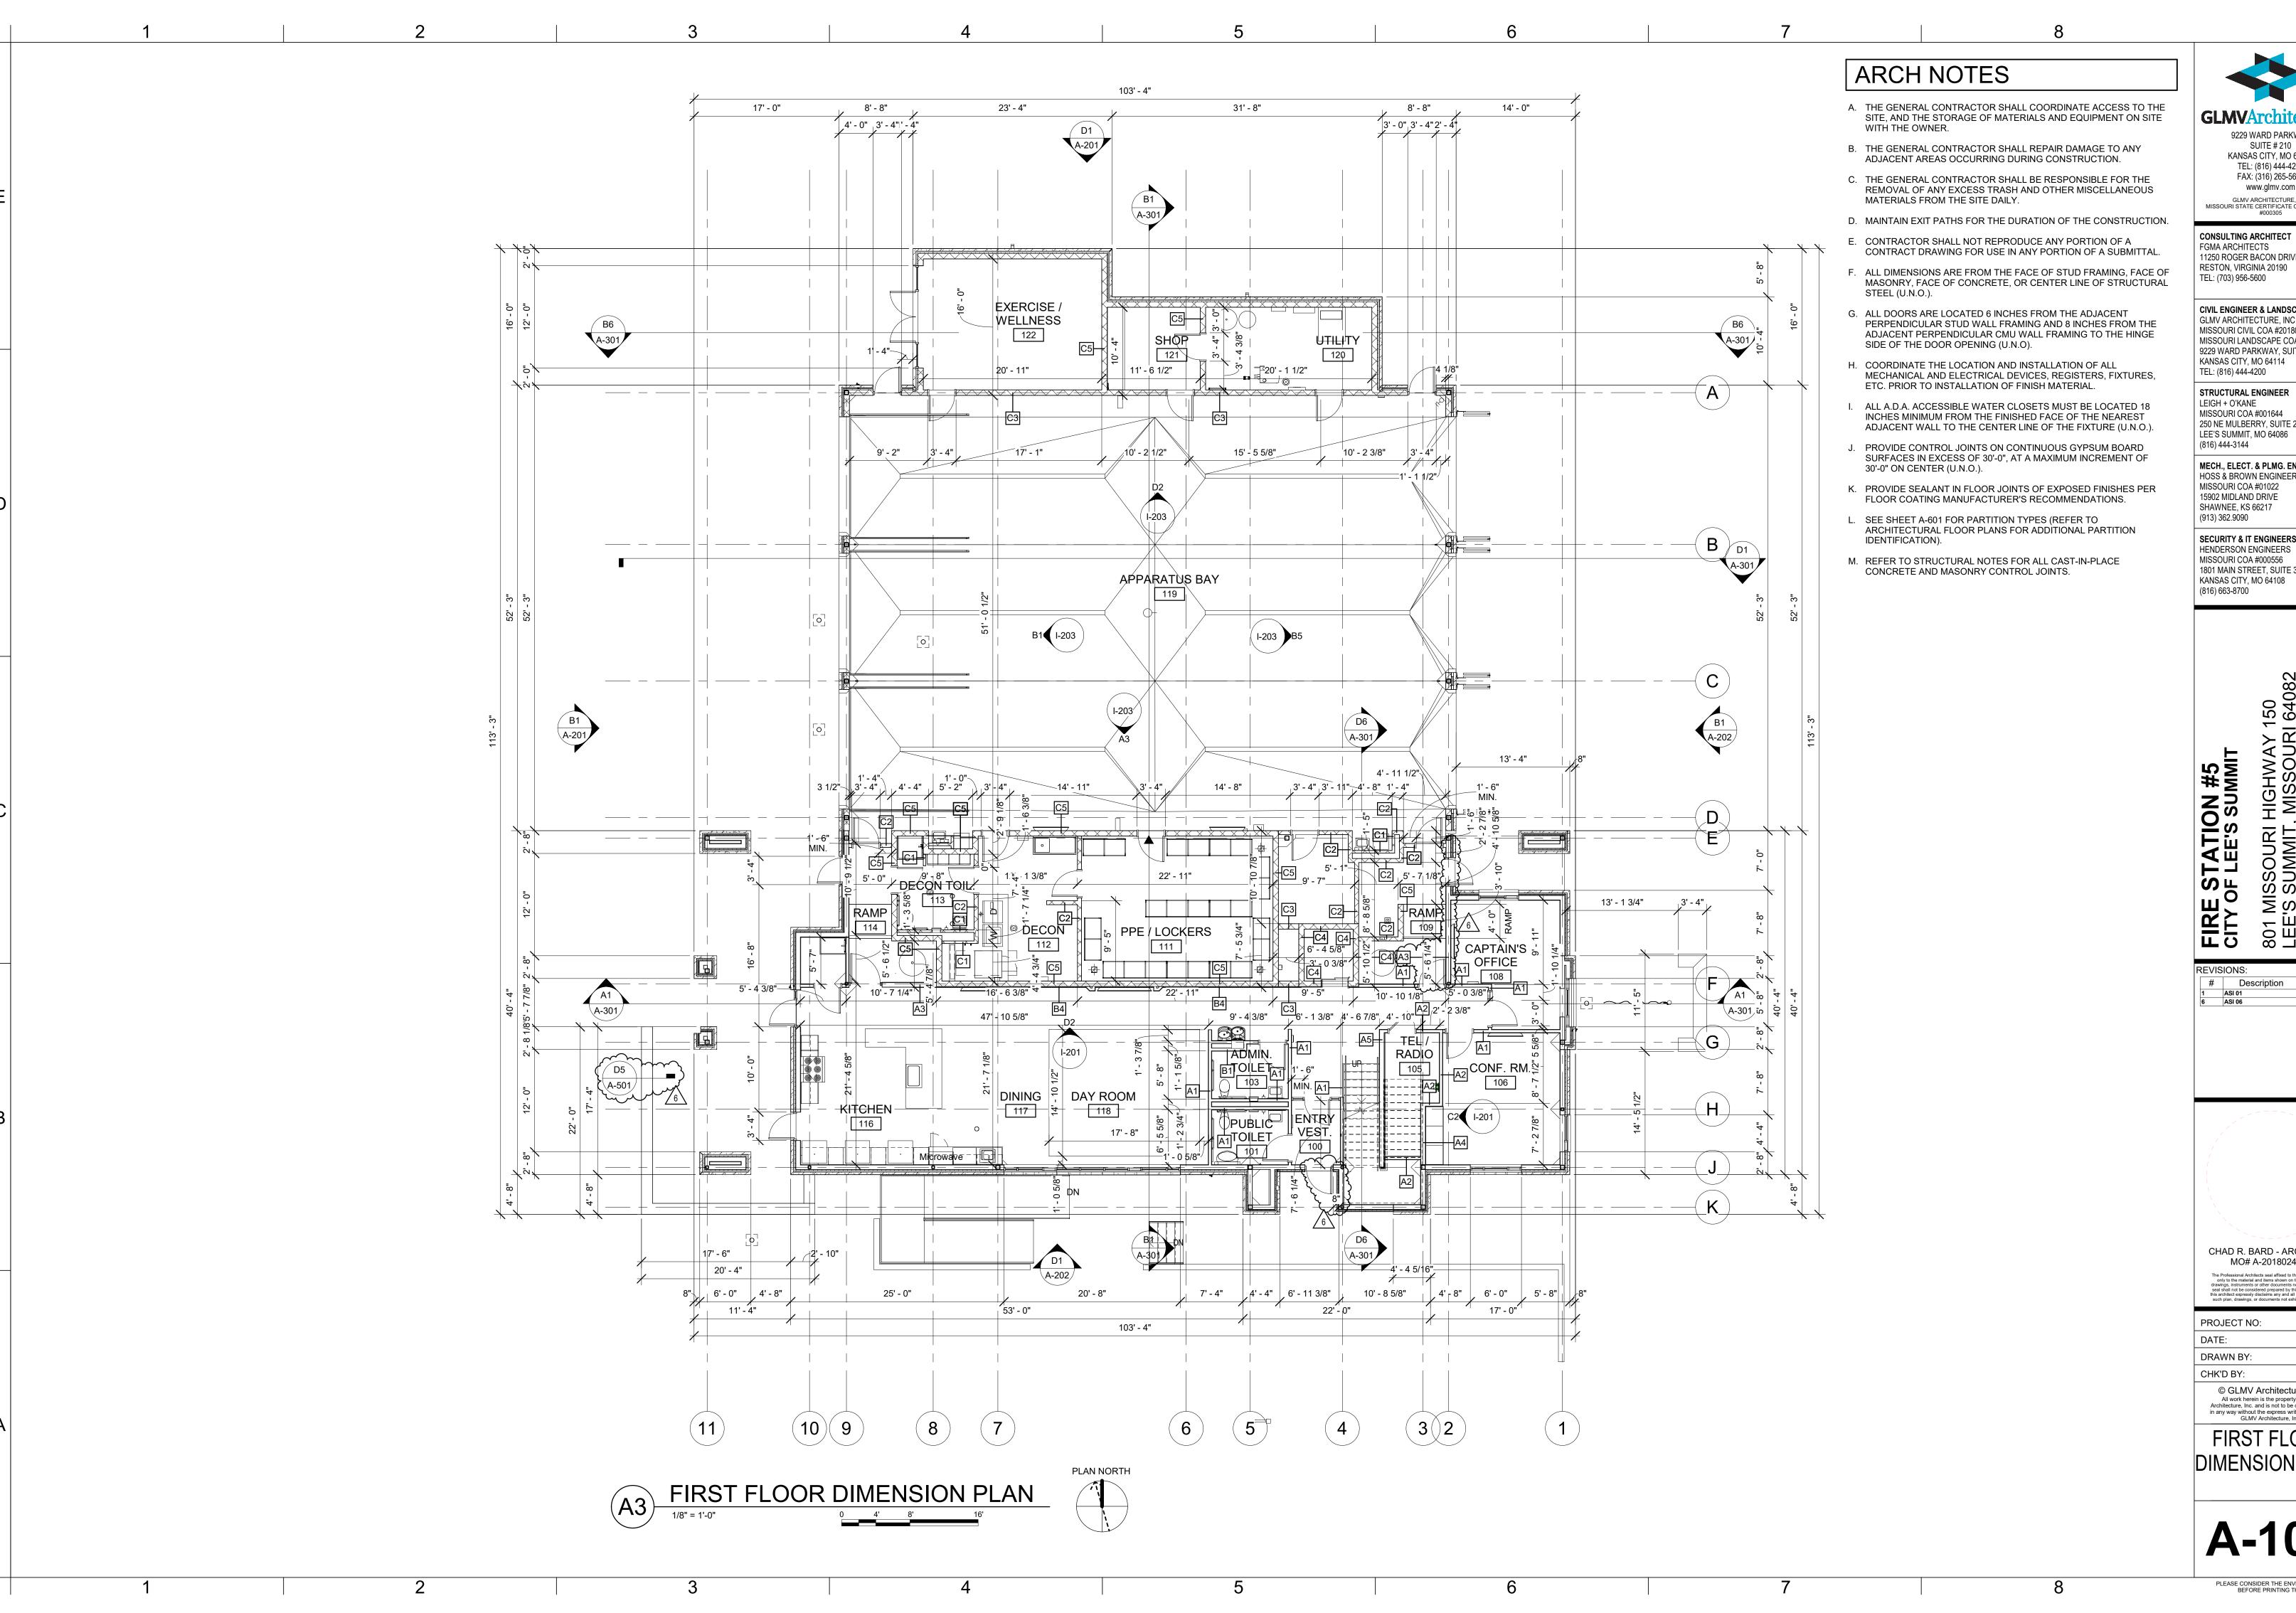

9229 WARD PARKWAY

FAX: (316) 265-5646 www.glmv.com GLMV ARCHITECTURE, INC. MISSOURI STATE CERTIFICATE OF AUTHORITY #000305

SUITE # 210

KANSAS CITY, MO 64114

TEL: (816) 444-4200

CONSULTING ARCHITECT FGMA ARCHITECTS 11250 ROGER BACON DRIVE, SUITE 16 RESTON, VIRGINIA 20190

TEL: (703) 956-5600 CIVIL ENGINEER & LANDSCAPE ARCH.

GLMV ARCHITECTURE, INC MISSOURI CIVIL COA #2018033898 MISSOURI LANDSCAPE COA #000008 9229 WARD PARKWAY, SUITE # 210 KANSAS CITY, MO 64114

STRUCTURAL ENGINEER LEIGH + O'KANE MISSOURI COA #001644 250 NE MULBERRY, SUITE 201

(816) 444-3144 MECH., ELECT. & PLMG. ENGINEERS HOSS & BROWN ENGINEERS MISSOURI COA #01022 15902 MIDLAND DRIVE

SHAWNEE, KS 66217 (913) 362.9090 SECURITY & IT ENGINEERS HENDERSON ENGINEERS MISSOURI COA #000556

1801 MAIN STREET, SUITE 300 KANSAS CITY, MO 64108

801 MISSOUF LEE'S SUMMI


# Description
1 ASI 01
6 ASI 06

CHAD R. BARD - ARCHITECT MO# A-2018024473

PROJECT NO: DATE: 02.22.2023

DRAWN BY: CHK'D BY: © GLMV Architecture, Inc. All work herein is the property of GLMV
Architecture, Inc. and is not to be copied or used
in any way without the express written consent of
GLMV Architecture, Inc.

FIRST FLOOR **DIMENSION PLAN** 

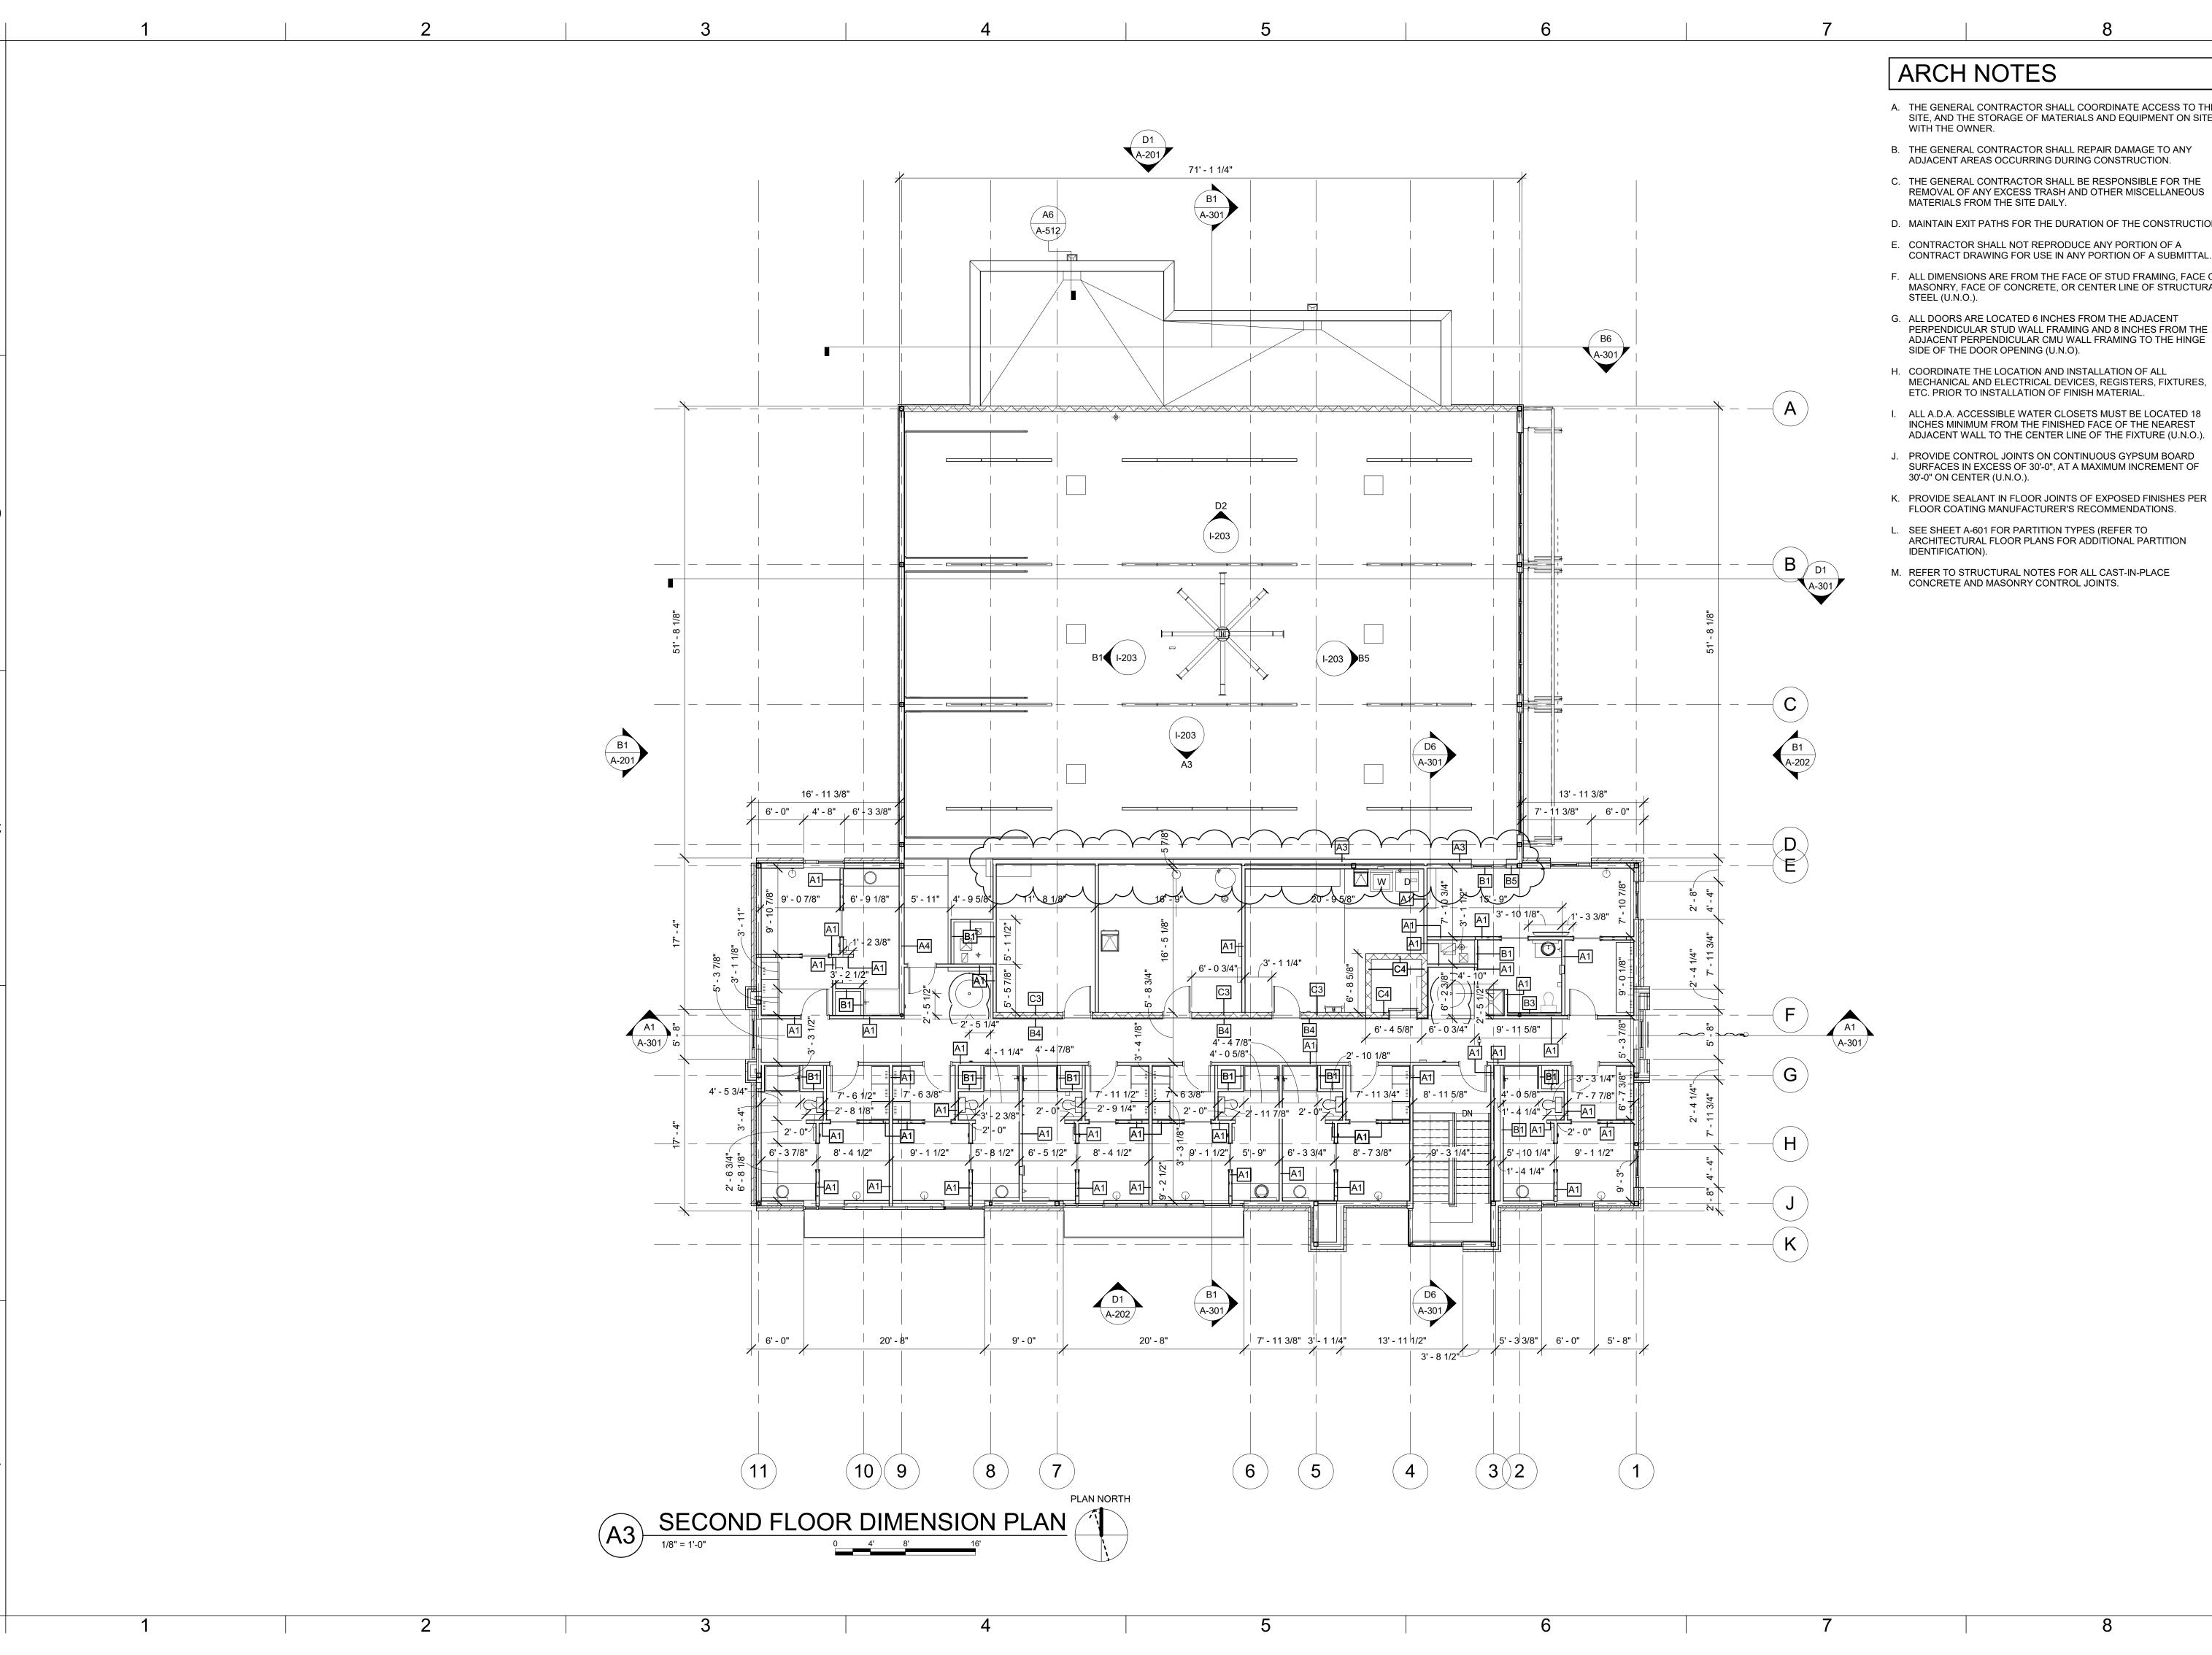

- A. THE GENERAL CONTRACTOR SHALL COORDINATE ACCESS TO THE SITE, AND THE STORAGE OF MATERIALS AND EQUIPMENT ON SITE
- B. THE GENERAL CONTRACTOR SHALL REPAIR DAMAGE TO ANY
- C. THE GENERAL CONTRACTOR SHALL BE RESPONSIBLE FOR THE REMOVAL OF ANY EXCESS TRASH AND OTHER MISCELLANEOUS
- D. MAINTAIN EXIT PATHS FOR THE DURATION OF THE CONSTRUCTION.
- E. CONTRACTOR SHALL NOT REPRODUCE ANY PORTION OF A
- F. ALL DIMENSIONS ARE FROM THE FACE OF STUD FRAMING, FACE OF MASONRY, FACE OF CONCRETE, OR CENTER LINE OF STRUCTURAL
- G. ALL DOORS ARE LOCATED 6 INCHES FROM THE ADJACENT PERPENDICULAR STUD WALL FRAMING AND 8 INCHES FROM THE ADJACENT PERPENDICULAR CMU WALL FRAMING TO THE HINGE
- H. COORDINATE THE LOCATION AND INSTALLATION OF ALL
- I. ALL A.D.A. ACCESSIBLE WATER CLOSETS MUST BE LOCATED 18 INCHES MINIMUM FROM THE FINISHED FACE OF THE NEAREST
- J. PROVIDE CONTROL JOINTS ON CONTINUOUS GYPSUM BOARD SURFACES IN EXCESS OF 30'-0", AT A MAXIMUM INCREMENT OF
- K. PROVIDE SEALANT IN FLOOR JOINTS OF EXPOSED FINISHES PER
- L. SEE SHEET A-601 FOR PARTITION TYPES (REFER TO ARCHITECTURAL FLOOR PLANS FOR ADDITIONAL PARTITION



SUITE # 210

KANSAS CITY, MO 64114

TEL: (816) 444-4200

9229 WARD PARKWAY

FAX: (316) 265-5646 www.glmv.com GLMV ARCHITECTURE, INC. MISSOURI STATE CERTIFICATE OF AUTHORITY #000305

CONSULTING ARCHITECT FGMA ARCHITECTS 11250 ROGER BACON DRIVE, SUITE 16

RESTON, VIRGINIA 20190 TEL: (703) 956-5600

CIVIL ENGINEER & LANDSCAPE ARCH. GLMV ARCHITECTURE, INC MISSOURI CIVIL COA #2018033898 MISSOURI LANDSCAPE COA #000008 9229 WARD PARKWAY, SUITE # 210

KANSAS CITY, MO 64114 TEL: (816) 444-4200


STRUCTURAL ENGINEER LEIGH + O'KANE MISSOURI COA #001644 250 NE MULBERRY, SUITE 201 LEE'S SUMMIT. MO 64086 (816) 444-3144

MECH., ELECT, & PLMG, ENGINEERS HOSS & BROWN ENGINEERS MISSOURI COA #01022 15902 MIDLAND DRIVE SHAWNEE, KS 66217 (913) 362.9090

SECURITY & IT ENGINEERS HENDERSON ENGINEERS MISSOURI COA #000556 1801 MAIN STREET, SUITE 300 KANSAS CITY, MO 64108 (816) 663-8700

801 MISSOUF LEE'S SUMMI

REVISIONS: # Description
1 ASI 01
4 ASI 04

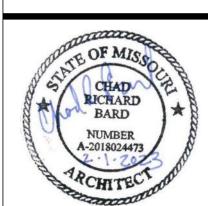


CHAD R. BARD - ARCHITECT MO# A-2018024473

PROJECT NO: 18225R21001 DATE: 11.21.2022 DRAWN BY: CHK'D BY:

© GLMV Architecture, Inc.
All work herein is the property of GLMV
Architecture, Inc. and is not to be copied or used in any way without the express written consent of GLMV Architecture, Inc. SECOND FLOOR

**DIMENSION PLAN** 

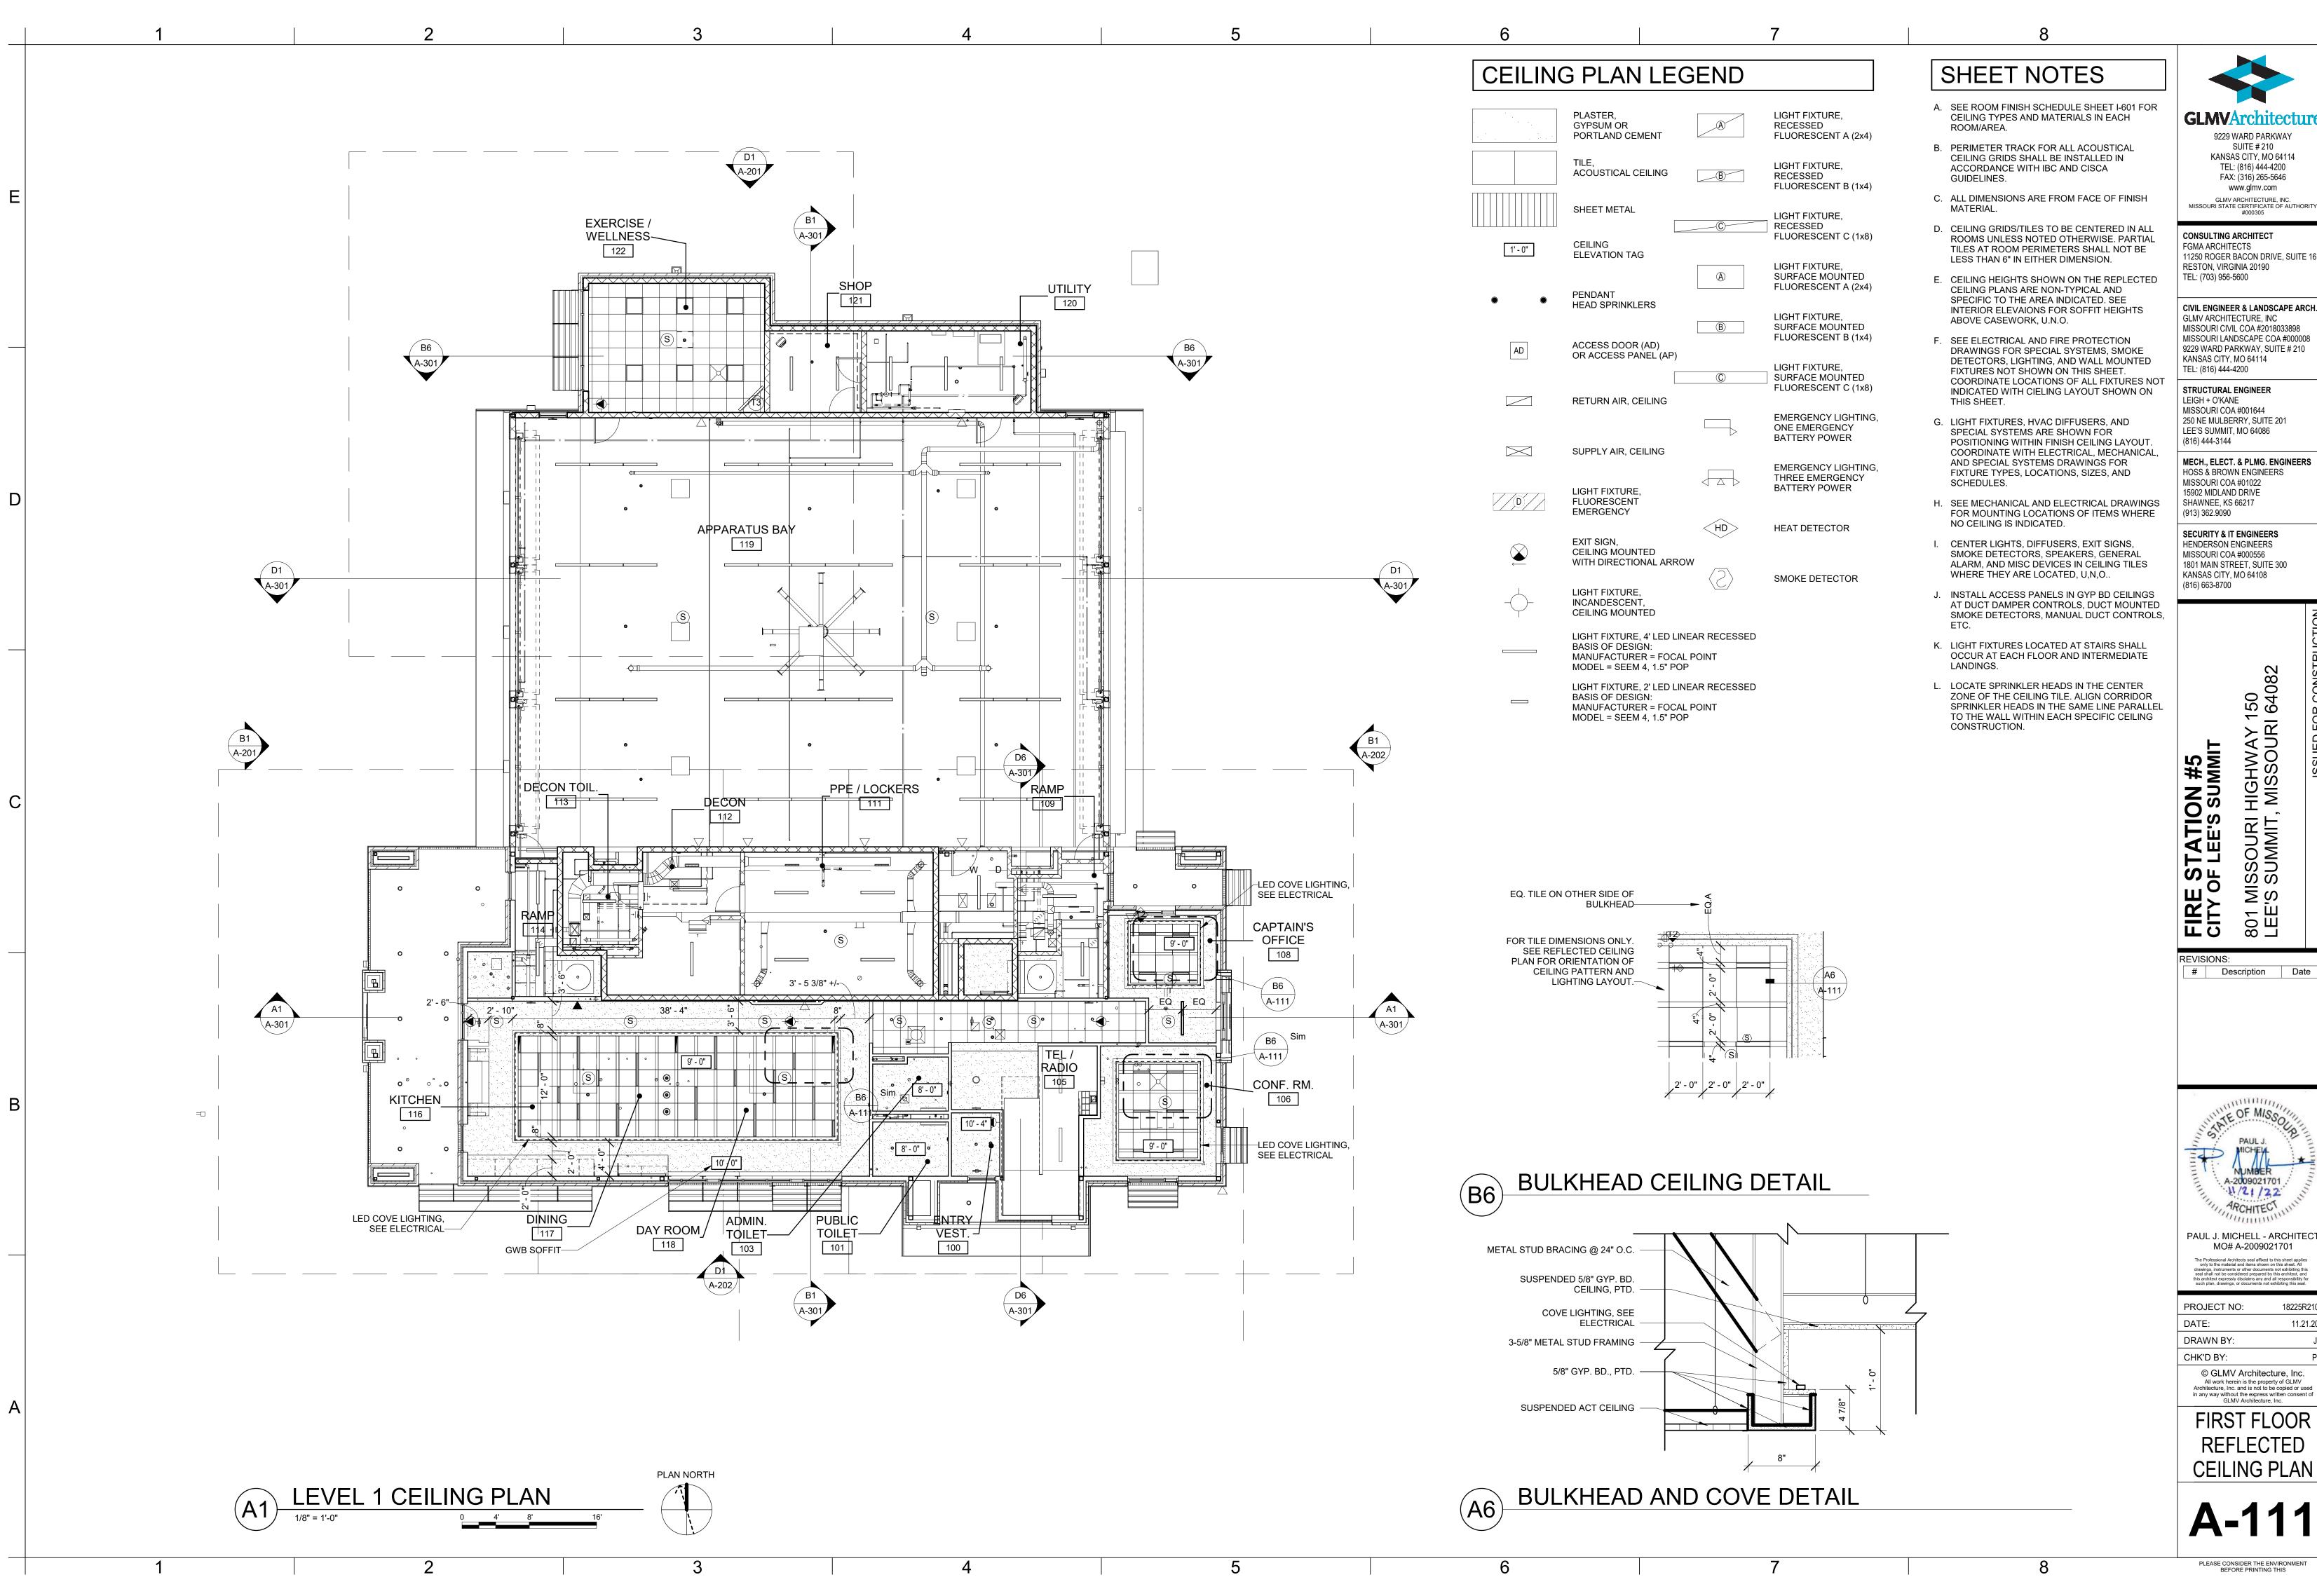

**GLMV**Architecture

9229 WARD PARKWAY SUITE # 210 KANSAS CITY, MO 64114 TEL: (816) 444-4200 FAX: (316) 265-5646

www.glmv.com GLMV ARCHITECTURE, INC. MISSOURI STATE CERTIFICATE OF AUTHORITY #000305

FGMA ARCHITECTS 11250 ROGER BACON DRIVE, SUITE 16 RESTON, VIRGINIA 20190

CIVIL ENGINEER & LANDSCAPE ARCH. GLMV ARCHITECTURE, INC MISSOURI CIVIL COA #2018033898 MISSOURI LANDSCAPE COA #000008 9229 WARD PARKWAY, SUITE # 210 KANSAS CITY, MO 64114

STRUCTURAL ENGINEER MISSOURI COA #001644 250 NE MULBERRY, SUITE 201 LEE'S SUMMIT, MO 64086

MECH., ELECT. & PLMG. ENGINEERS HOSS & BROWN ENGINEERS MISSOURI COA #01022 15902 MIDLAND DRIVE

SECURITY & IT ENGINEERS HENDERSON ENGINEERS MISSOURI COA #000556 1801 MAIN STREET, SUITE 300 KANSAS CITY, MO 64108

801 MISSOUF LEE'S SUMMI


# Description




PAUL J. MICHELL - ARCHITECT MO# A-2009021701

18225R21001 11.21.2022 © GLMV Architecture, Inc.

FIRST FLOOR REFLECTED **CEILING PLAN** 

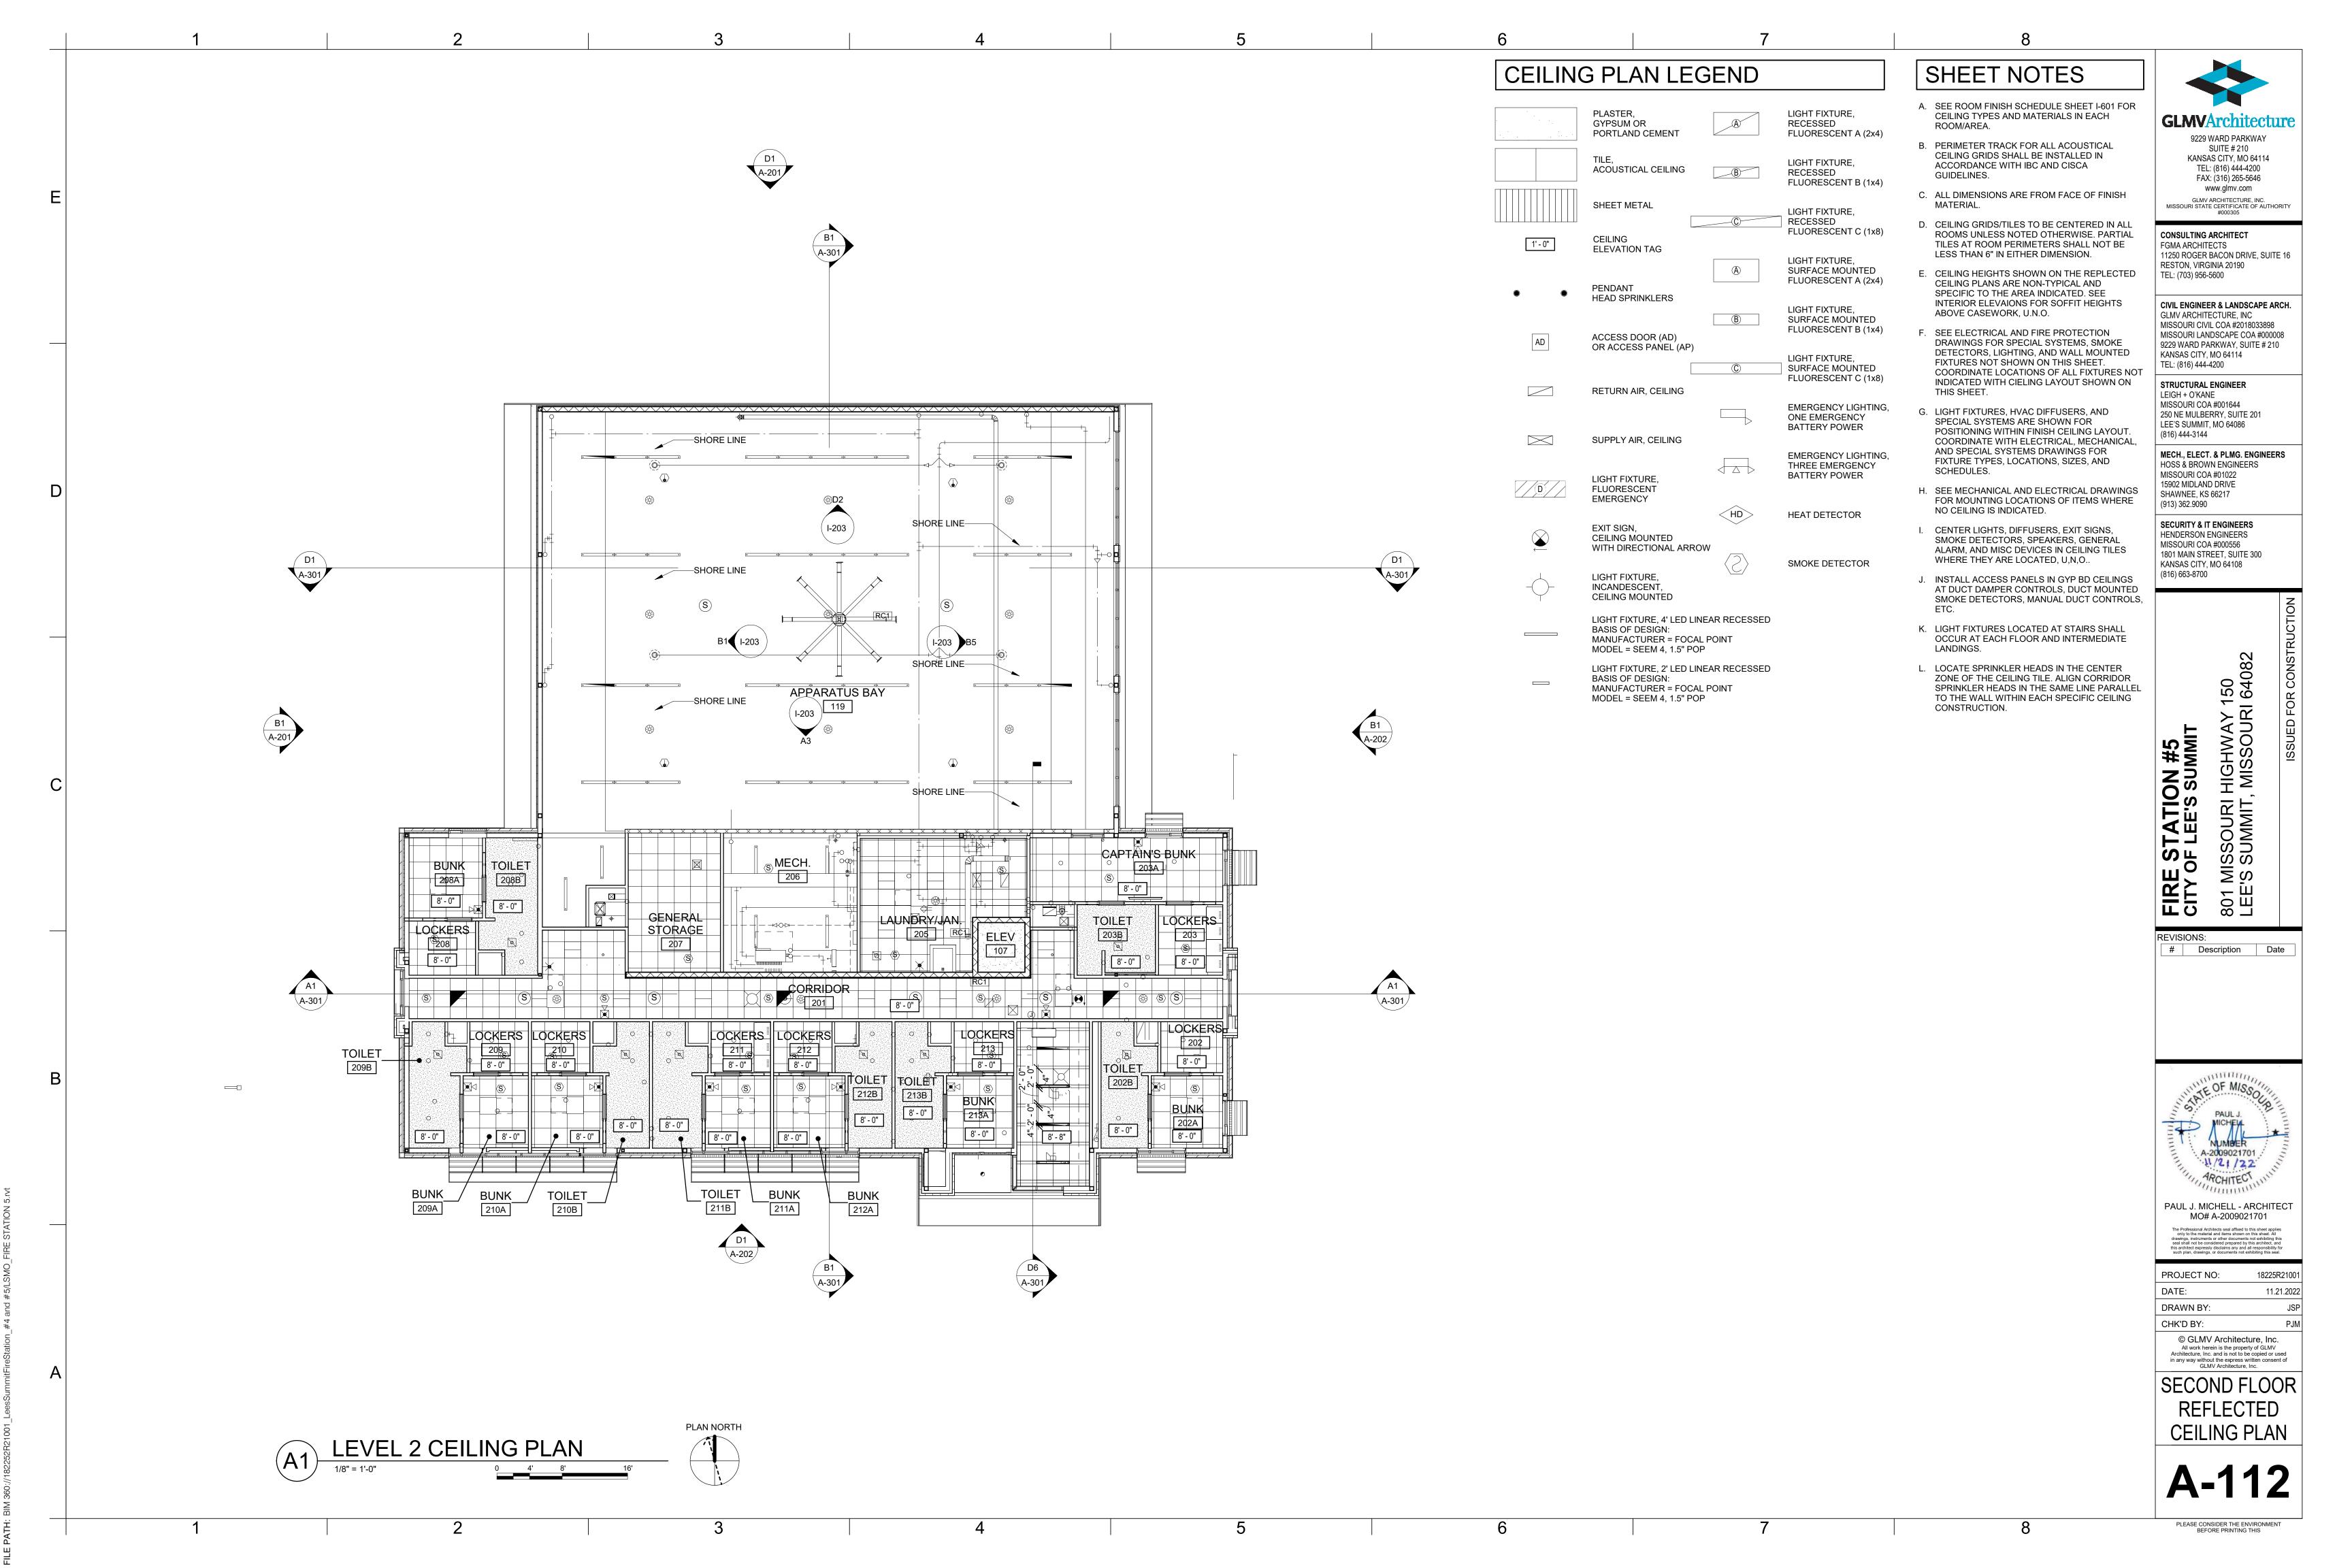

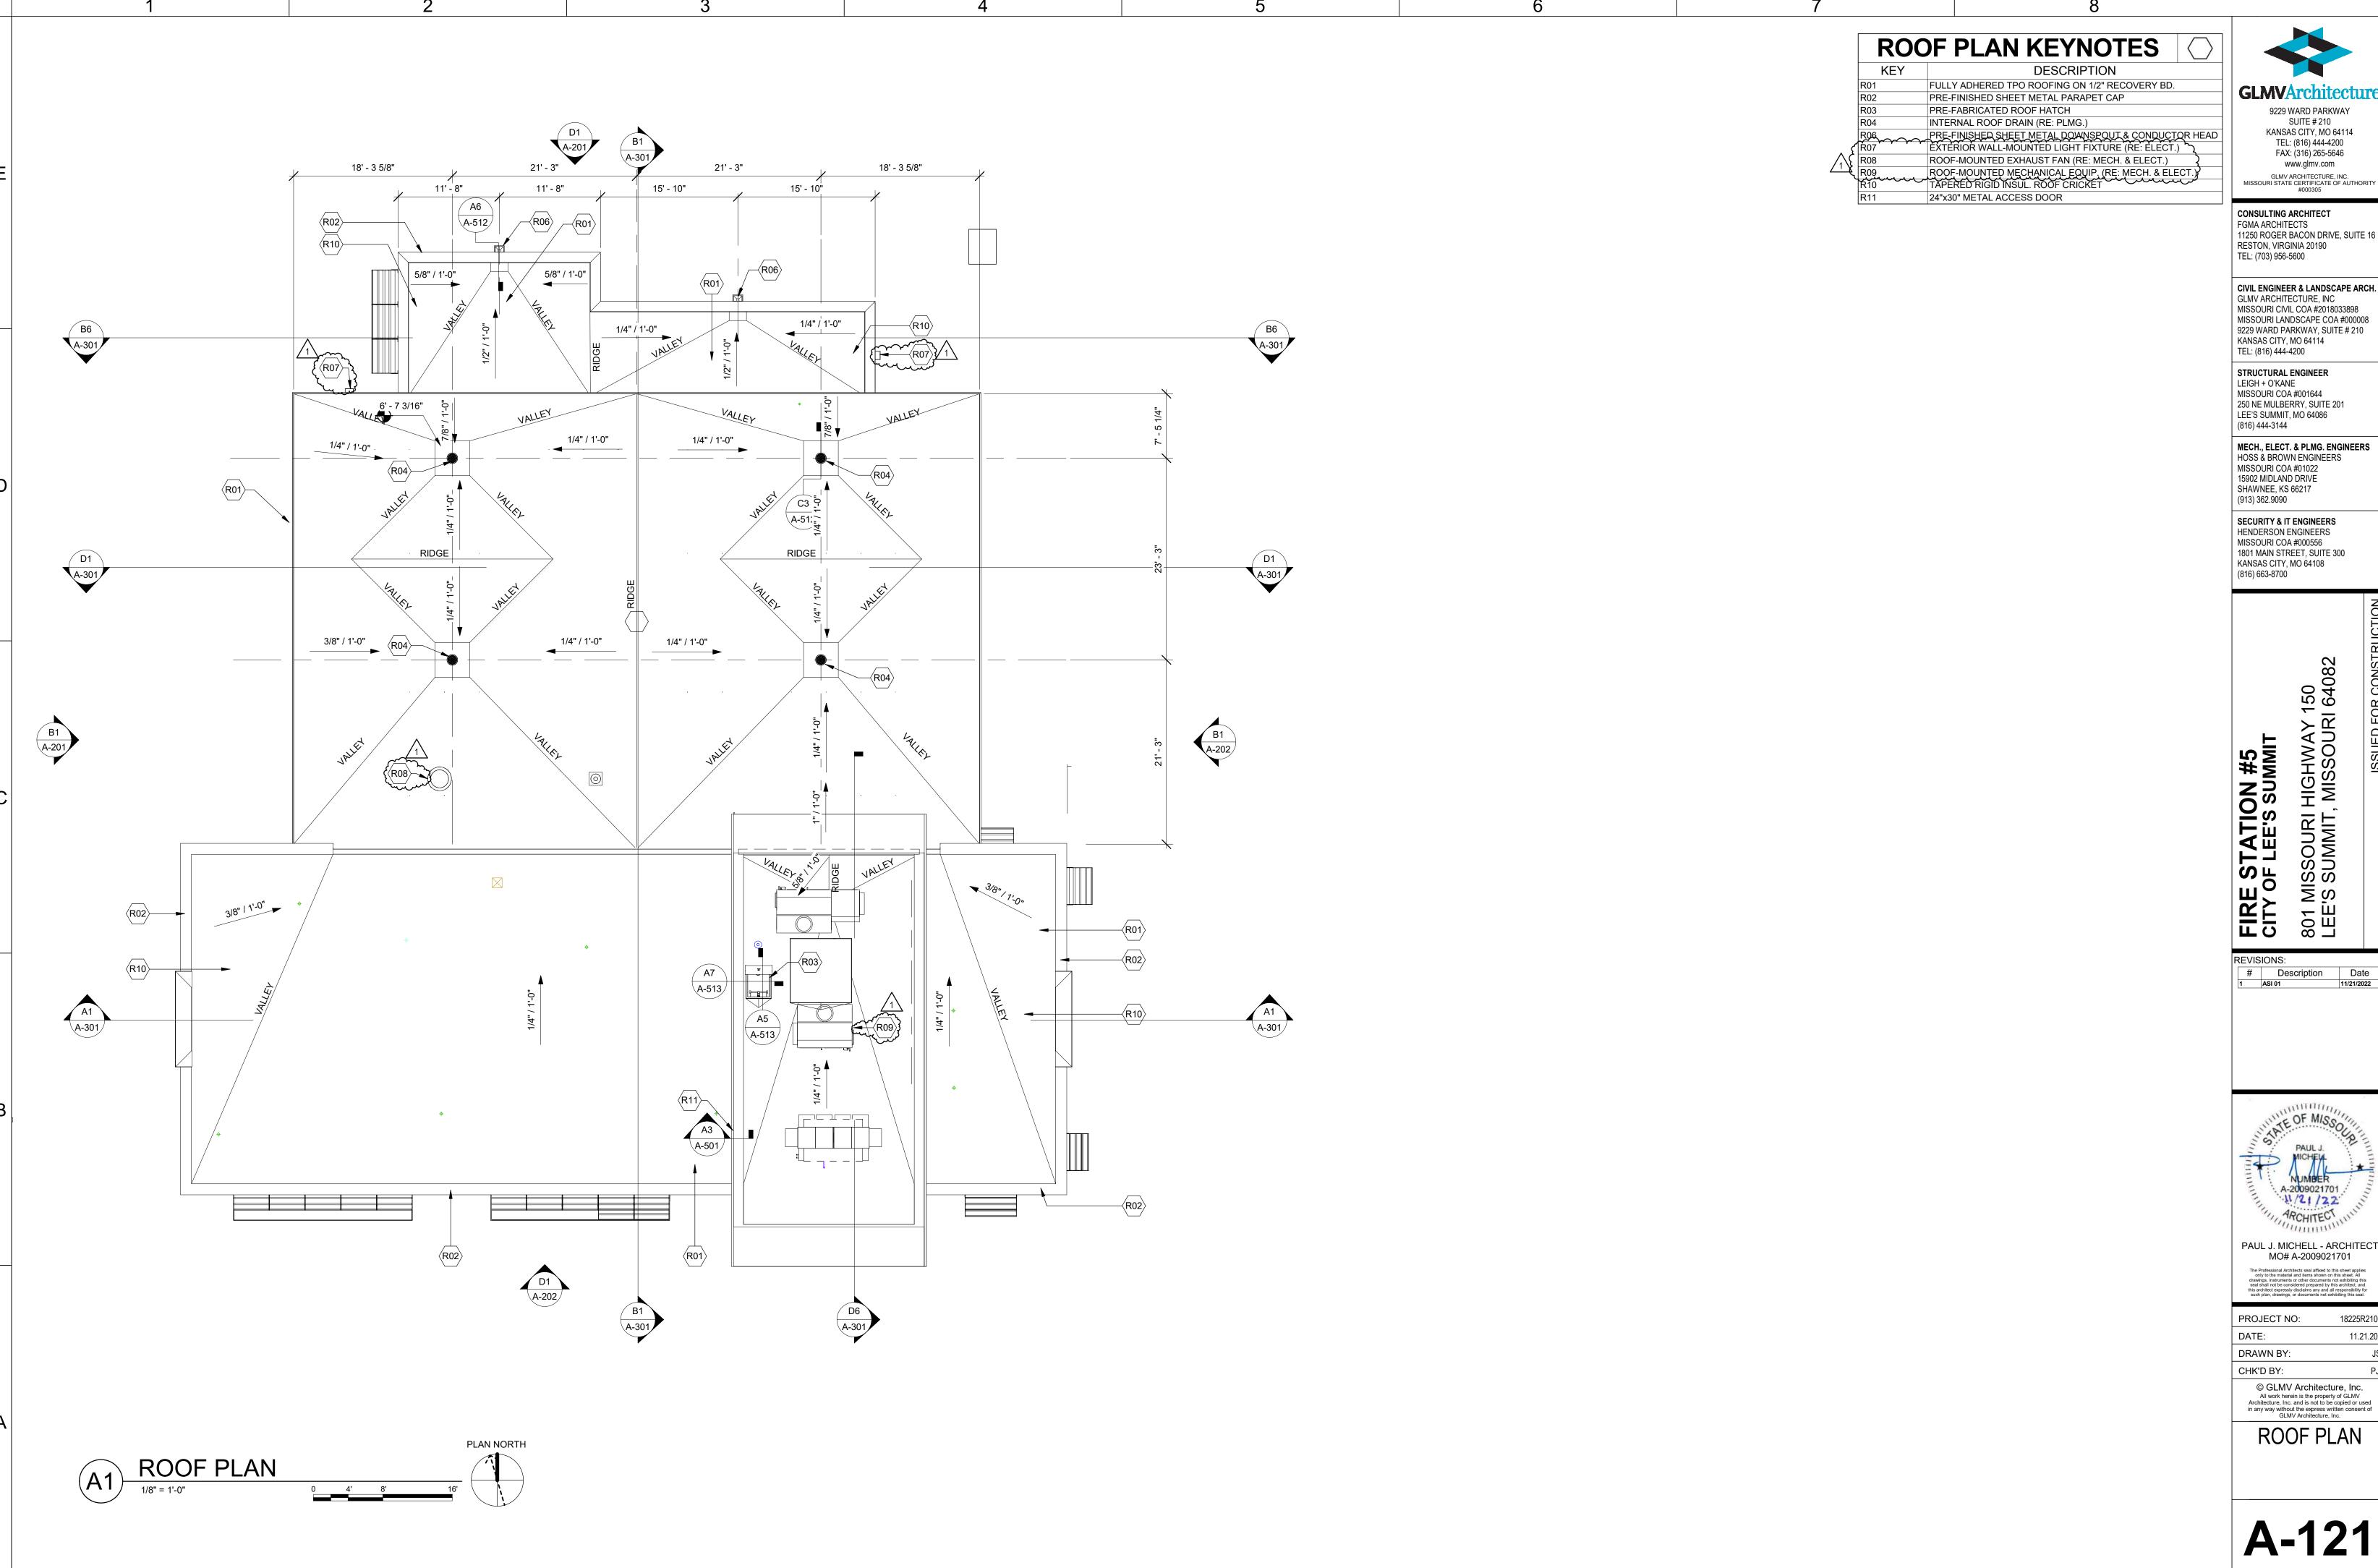

5

2

**GLMVArchitecture** 9229 WARD PARKWAY SUITE # 210 KANSAS CITY, MO 64114

TEL: (816) 444-4200 FAX: (316) 265-5646 www.glmv.com GLMV ARCHITECTURE, INC. MISSOURI STATE CERTIFICATE OF AUTHORITY #000305

11250 ROGER BACON DRIVE, SUITE 16 RESTON, VIRGINIA 20190 TEL: (703) 956-5600

CIVIL ENGINEER & LANDSCAPE ARCH. GLMV ARCHITECTURE, INC MISSOURI CIVIL COA #2018033898 MISSOURI LANDSCAPE COA #000008 9229 WARD PARKWAY, SUITE # 210

STRUCTURAL ENGINEER LEIGH + O'KANE MISSOURI COA #001644 250 NE MULBERRY, SUITE 201 LEE'S SUMMIT, MO 64086

MECH., ELECT. & PLMG. ENGINEERS HOSS & BROWN ENGINEERS MISSOURI COA #01022 15902 MIDLAND DRIVE SHAWNEE, KS 66217

SECURITY & IT ENGINEERS HENDERSON ENGINEERS MISSOURI COA #000556 1801 MAIN STREET, SUITE 300 KANSAS CITY, MO 64108 (816) 663-8700

RI HIGHWAY 150 IIT, MISSOURI 64082


801 MISSOUF LEE'S SUMMI



PAUL J. MICHELL - ARCHITECT MO# A-2009021701


PROJECT NO:	18225R21001	
DATE:	11.21.2022	
DRAWN BY:	JSP	
CHK'D BY:	PJM	
© GLMV Architecture, Inc. All work herein is the property of GLMV		

**ROOF PLAN** 

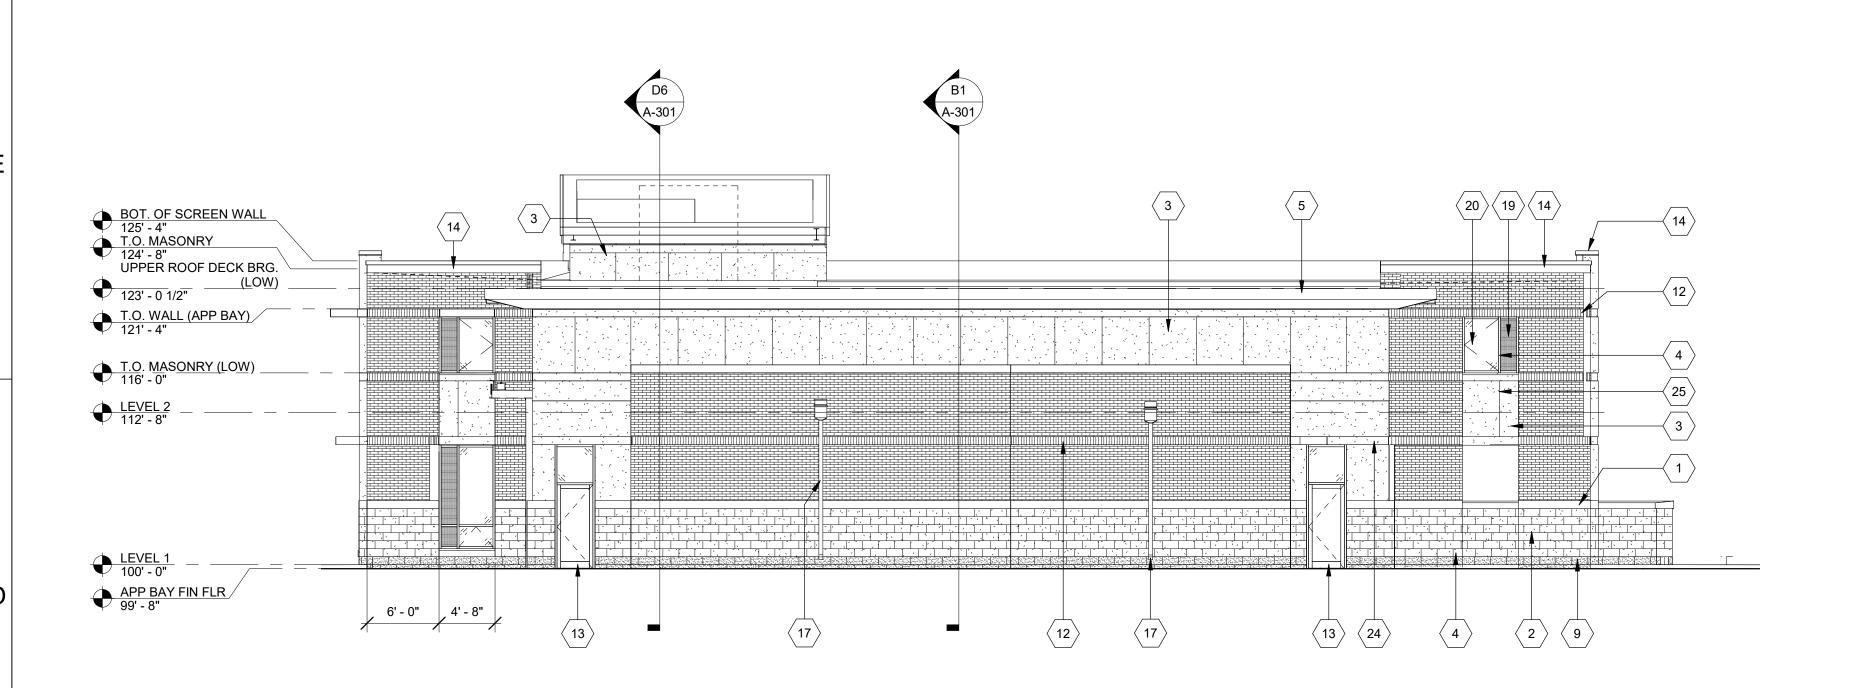

NORTH ELEVATION

EAST ELEVATION

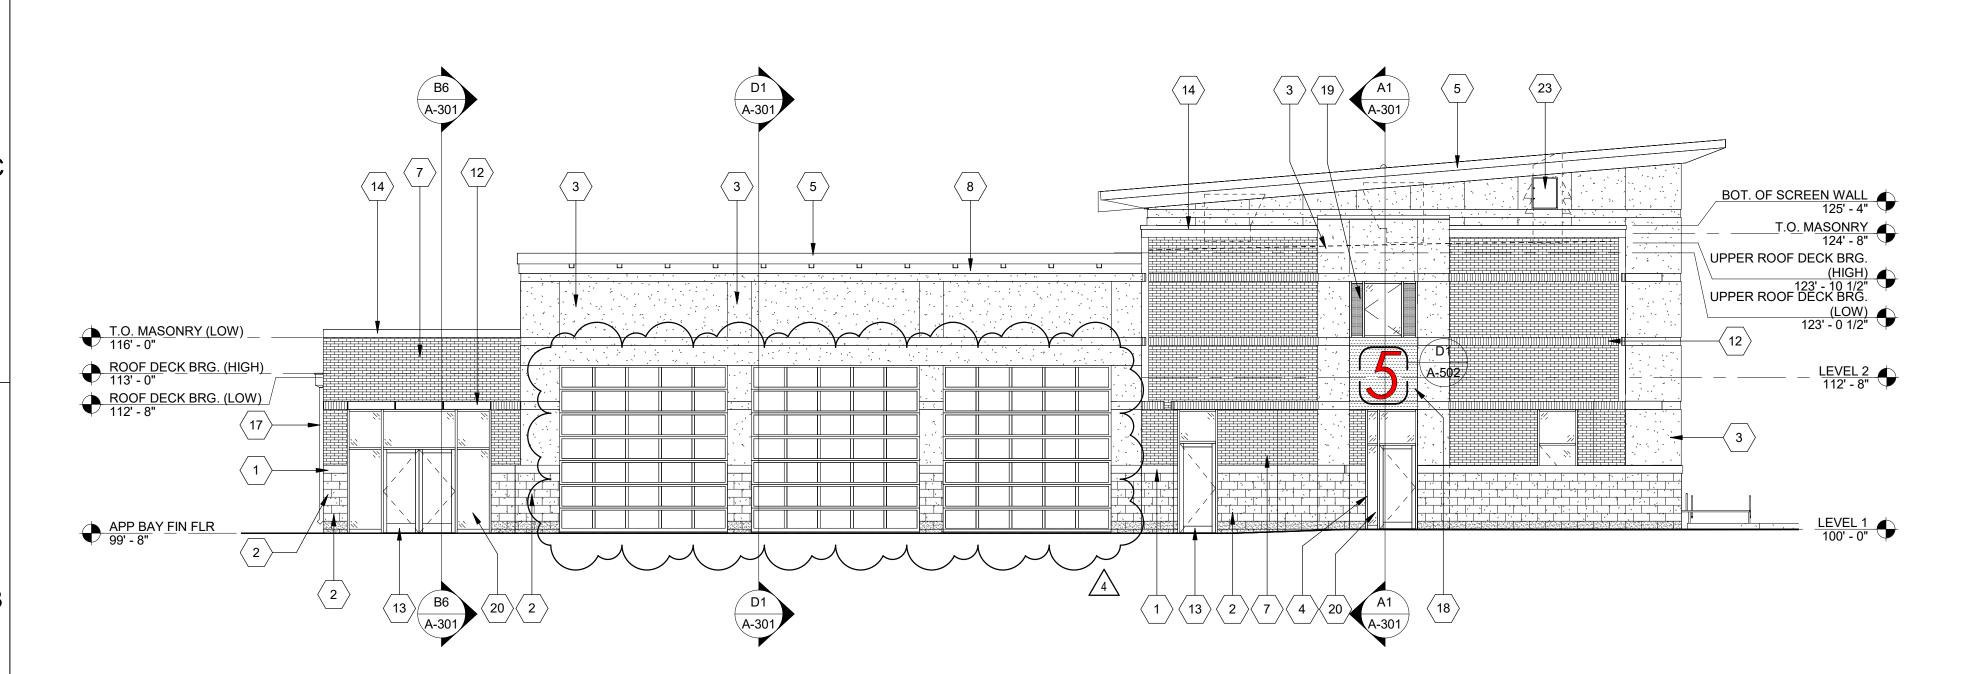



1 CAST STONE MASONRY SILL
2 ANCHORED STONE MASONRY VENEER (TYPE 1)
3 EIFS
4 PRE-EINISHED ALLIMINUM-FRAMED STOREFRONT

4 PRE-FINISHED ALUMINUM-FRAMED STOREFRONT
5 PRE-FINISHED SHEET METAL FASCIA
6 PRE-FINISHED ALUMINUM-FRAMED STOREFRONT
7 4" MASONRY VENEER (COMMON BOND)
8 PRE-FINISHED SHEET METAL SOFFIT PANELS
9 ANCHORED STONE MASONRY VENEER (TYPE 2)

8 PRE-FINISHED SHEET METAL SOFFIT PANELS
9 ANCHORED STONE MASONRY VENEER (TYPE 2)
12 4" MASONRY VENEER (SOLDIER)
13 PRE-FINISHED ALUMINUM-FRAMED ENTRANCE
14 PRE-FINISHED SHEET METAL PARAPET CAP
16 3/8" FIBER-CEMENT PANEL GAP (TYP.)

24 1/2" DEEP EIFS RECESS

17 PRE-FINISHED SHEET METAL CONDUCTOR HEAD & DOWNSPOUT
18 PRE-FINISHED METAL PLATE WALL PANELS
19 METAL-FACED INSULATED WINDOW PANEL
20 1" INSULATED GLASS UNIT
23 24"x30" METAL ACCESS DOOR

3/4" DEEP V-GROOVE EIFS REVEAL
 BACK-LIT STAINLESS STEEL POST-MOUNTED FIRE DEPARTMENT CREST
 1/2" METAL PANEL REVEAL

28 STEM MOUNTED SIGNAGE LIGHT. RE: ELEC.

GLMVArchitecture

9229 WARD PARKWAY SUITE # 210 KANSAS CITY, MO 64114 TEL: (816) 444-4200 FAX: (316) 265-5646 www.glmv.com

GLMV ARCHITECTURE, INC. MISSOURI STATE CERTIFICATE OF AUTHORITY #000305

CONSULTING ARCHITECT
FGMA ARCHITECTS
11250 ROGER BACON DRIVE, SUITE 16
RESTON, VIRGINIA 20190
TEL: (703) 956-5600

CIVIL ENGINEER & LANDSCAPE ARCH.
GLMV ARCHITECTURE, INC
MISSOURI CIVIL COA #2018033898
MISSOURI LANDSCAPE COA #000008
9229 WARD PARKWAY, SUITE # 210

KANSAS CITY, MO 64114
TEL: (816) 444-4200

STRUCTURAL ENGINEER
LEIGH + O'KANE
MISSOURI COA #001644

250 NE MULBERRY, SUITE 201 LEE'S SUMMIT, MO 64086 (816) 444-3144 MECH., ELECT. & PLMG. ENGINEERS

HOSS & BROWN ENGINEERS
MISSOURI COA #01022
15902 MIDLAND DRIVE
SHAWNEE, KS 66217
(913) 362.9090


SECURITY & IT ENGINEERS
HENDERSON ENGINEERS
MISSOURI COA #000556
1801 MAIN STREET, SUITE 300
KANSAS CITY, MO 64108
(816) 663-8700

GHWAY 150 ISSOURI 64082

FIRE STATION #5
CITY OF LEE'S SUMMIT
801 MISSOURI HIGHWA
LEE'S SUMMIT, MISSOU

REVISIONS:

# Description Date
1 ASI 01 11/21/2022
4 ASI 04 02/01/2023

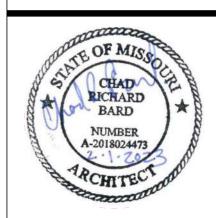

CHAD R. BARD - ARCHITECT MO# A-2018024473

The Professional Architects seal affixed to this sheet applies only to the material and Items shown on this sheet. All drawings, instruments or other documents not exhibiting this seal shall not be considered prepared by this architect, and

PROJECT NO: 18225R21001

DATE: 11.21.2022

DRAWN BY: JSP


CHK'D BY: GLW


© GLMV Architecture, Inc.
All work herein is the property of GLMV
Architecture, Inc. and is not to be copied or used in any way without the express written consent of GLMV Architecture, Inc.

BUILDING

ELEVATIONS

A-201

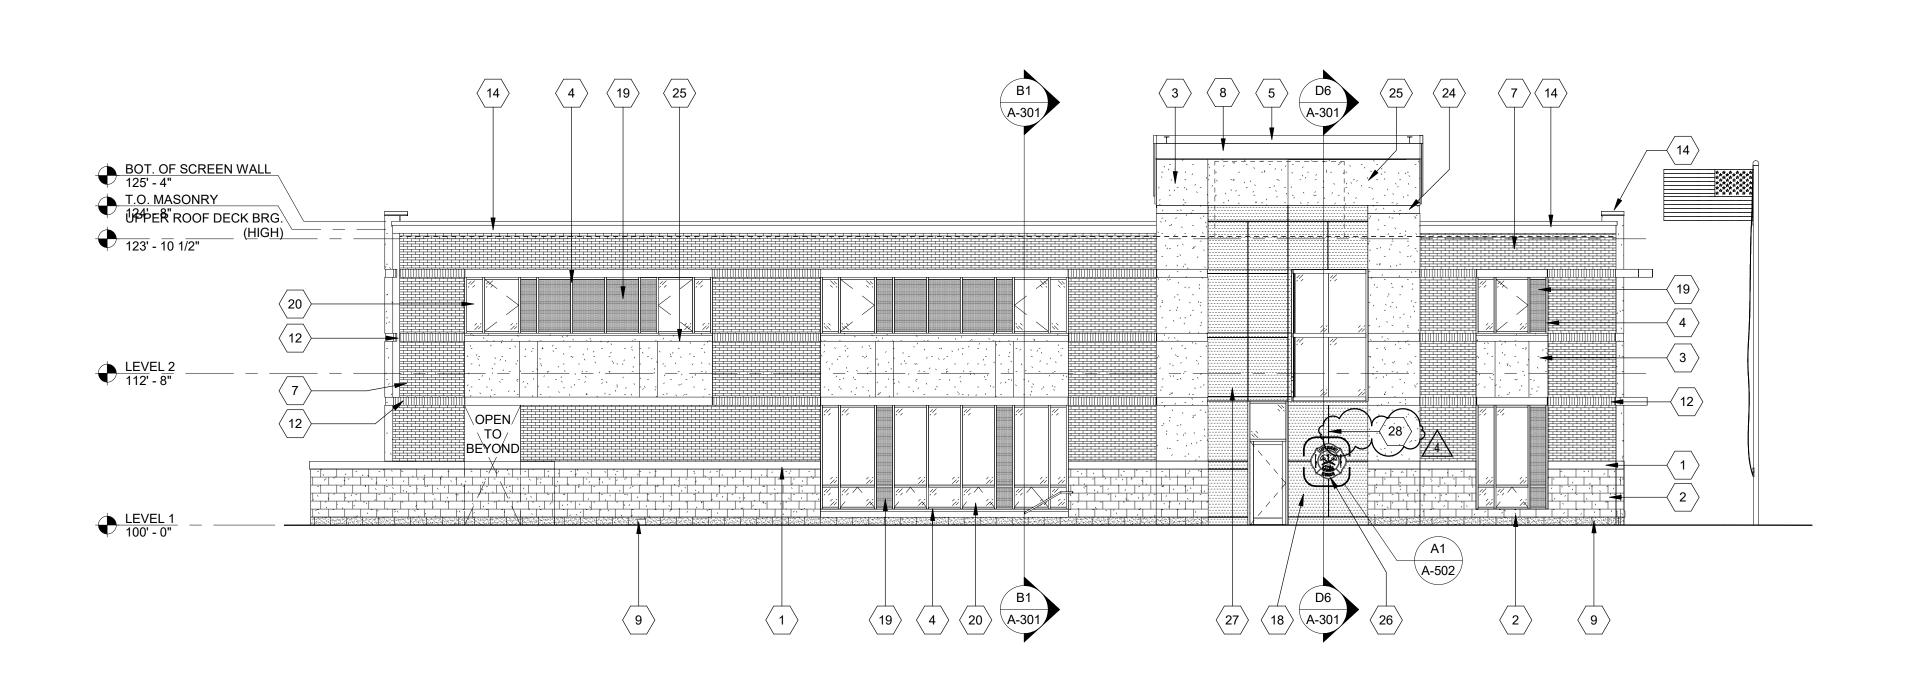

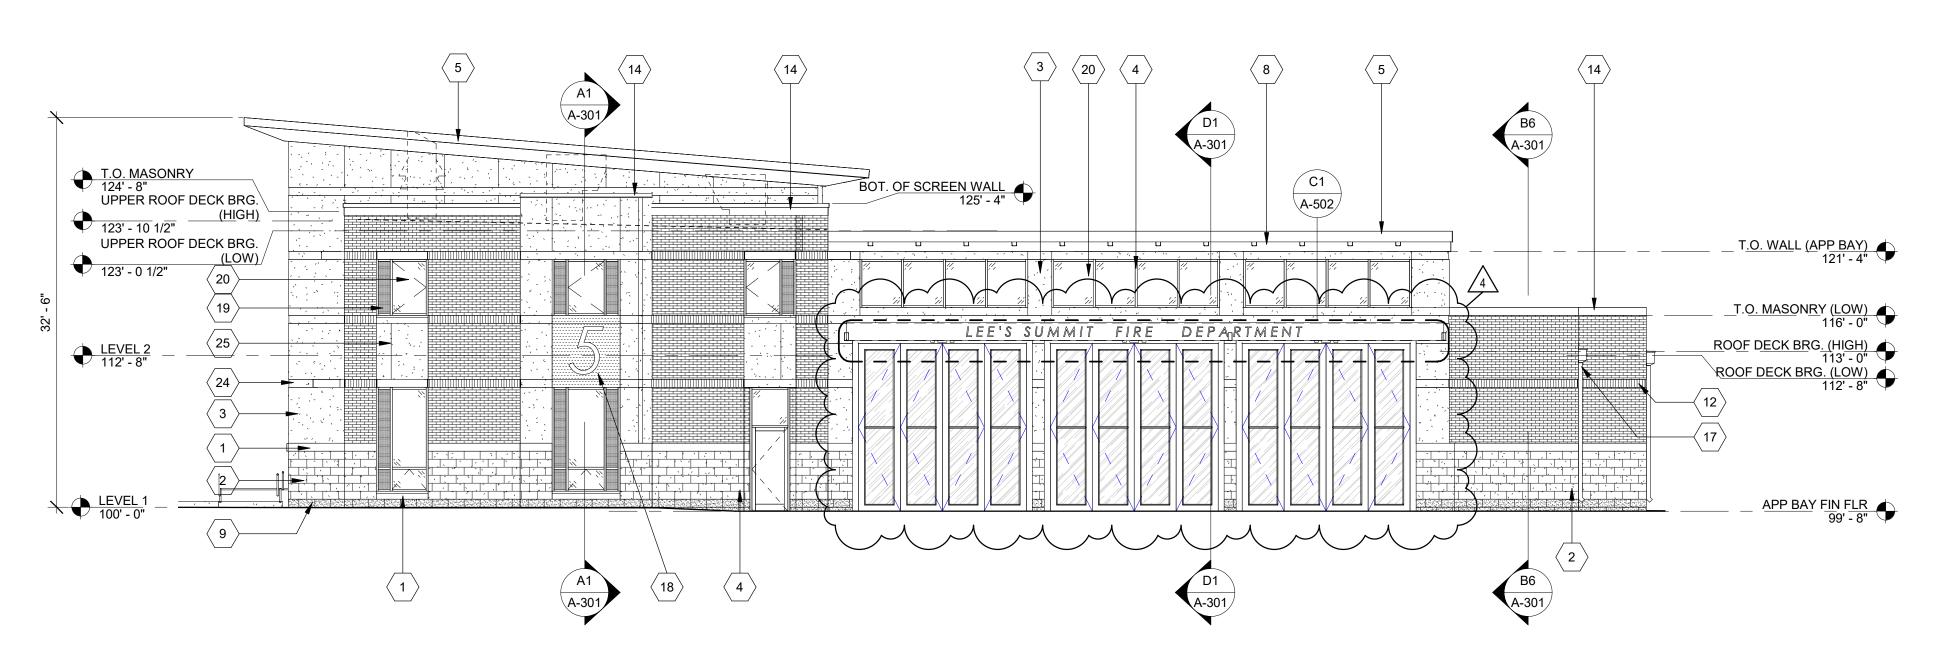

WEST ELEVATION

SOUTH ELEVATION

**BUILDING ELEVATION...** KEY DESCRIPTION 1 CAST STONE MASONRY SILL 2 ANCHORED STONE MASONRY VENEER (TYPE 1) 4 PRE-FINISHED ALUMINUM-FRAMED STOREFRONT 5 PRE-FINISHED SHEET METAL FASCIA 6 PRE-FINISHED ALUMINUM-FRAMED STOREFRONT 7 4" MASONRY VENEER (COMMON BOND) 8 PRE-FINISHED SHEET METAL SOFFIT PANELS 9 ANCHORED STONE MASONRY VENEER (TYPE 2) 12 4" MASONRY VENEER (SOLDIER) 13 PRE-FINISHED ALUMINUM-FRAMED ENTRANCE 14 PRE-FINISHED SHEET METAL PARAPET CAP 16 3/8" FIBER-CEMENT PANEL GAP (TYP.) 17 PRE-FINISHED SHEET METAL CONDUCTOR HEAD & DOWNSPOUT 18 PRE-FINISHED METAL PLATE WALL PANELS 19 METAL-FACED INSULATED WINDOW PANEL 20 1" INSULATED GLASS UNIT 23 24"x30" METAL ACCESS DOOR 24 1/2" DEEP EIFS RECESS 25 3/4" DEEP V-GROOVE EIFS REVEAL 26 BACK-LIT STAINLESS STEEL POST-MOUNTED FIRE DEPARTMENT 112" METAL PANEL REVEAL STEM MOUNTED SIGNAGE LIGHT. RE: ELEC

**GLMVArchitecture** 

9229 WARD PARKWAY SUITE # 210 KANSAS CITY, MO 64114 TEL: (816) 444-4200

FAX: (316) 265-5646 www.glmv.com GLMV ARCHITECTURE, INC. MISSOURI STATE CERTIFICATE OF AUTHORITY #000305

FGMA ARCHITECTS 11250 ROGER BACON DRIVE, SUITE 16 RESTON, VIRGINIA 20190 TEL: (703) 956-5600

CONSULTING ARCHITECT

CIVIL ENGINEER & LANDSCAPE ARCH.
GLMV ARCHITECTURE, INC MISSOURI CIVIL COA #2018033898 MISSOURI LANDSCAPE COA #000008 9229 WARD PARKWAY, SUITE # 210 KANSAS CITY, MO 64114 TEL: (816) 444-4200

STRUCTURAL ENGINEER LEIGH + O'KANE MISSOURI COA #001644 250 NE MULBERRY, SUITE 201 LEE'S SUMMIT, MO 64086

(816) 444-3144

MECH., ELECT. & PLMG. ENGINEERS HOSS & BROWN ENGINEERS MISSOURI COA #01022 15902 MIDLAND DRIVE SHAWNEE, KS 66217 (913) 362.9090

SECURITY & IT ENGINEERS HENDERSON ENGINEERS MISSOURI COA #000556 1801 MAIN STREET, SUITE 300 KANSAS CITY, MO 64108 (816) 663-8700

801 MISSOUF LEE'S SUMMI

REVISIONS: # Description
1 ASI 01
4 ASI 04





CHAD R. BARD - ARCHITECT MO# A-2018024473

PROJECT NO: 18225R21001 DATE: 11.21.2022 DRAWN BY: CHK'D BY: © GLMV Architecture, Inc.

All work herein is the property of GLMV
Architecture, Inc. and is not to be copied or used in any way without the express written consent of GLMV Architecture, Inc. BUILDING

**ELEVATIONS** 

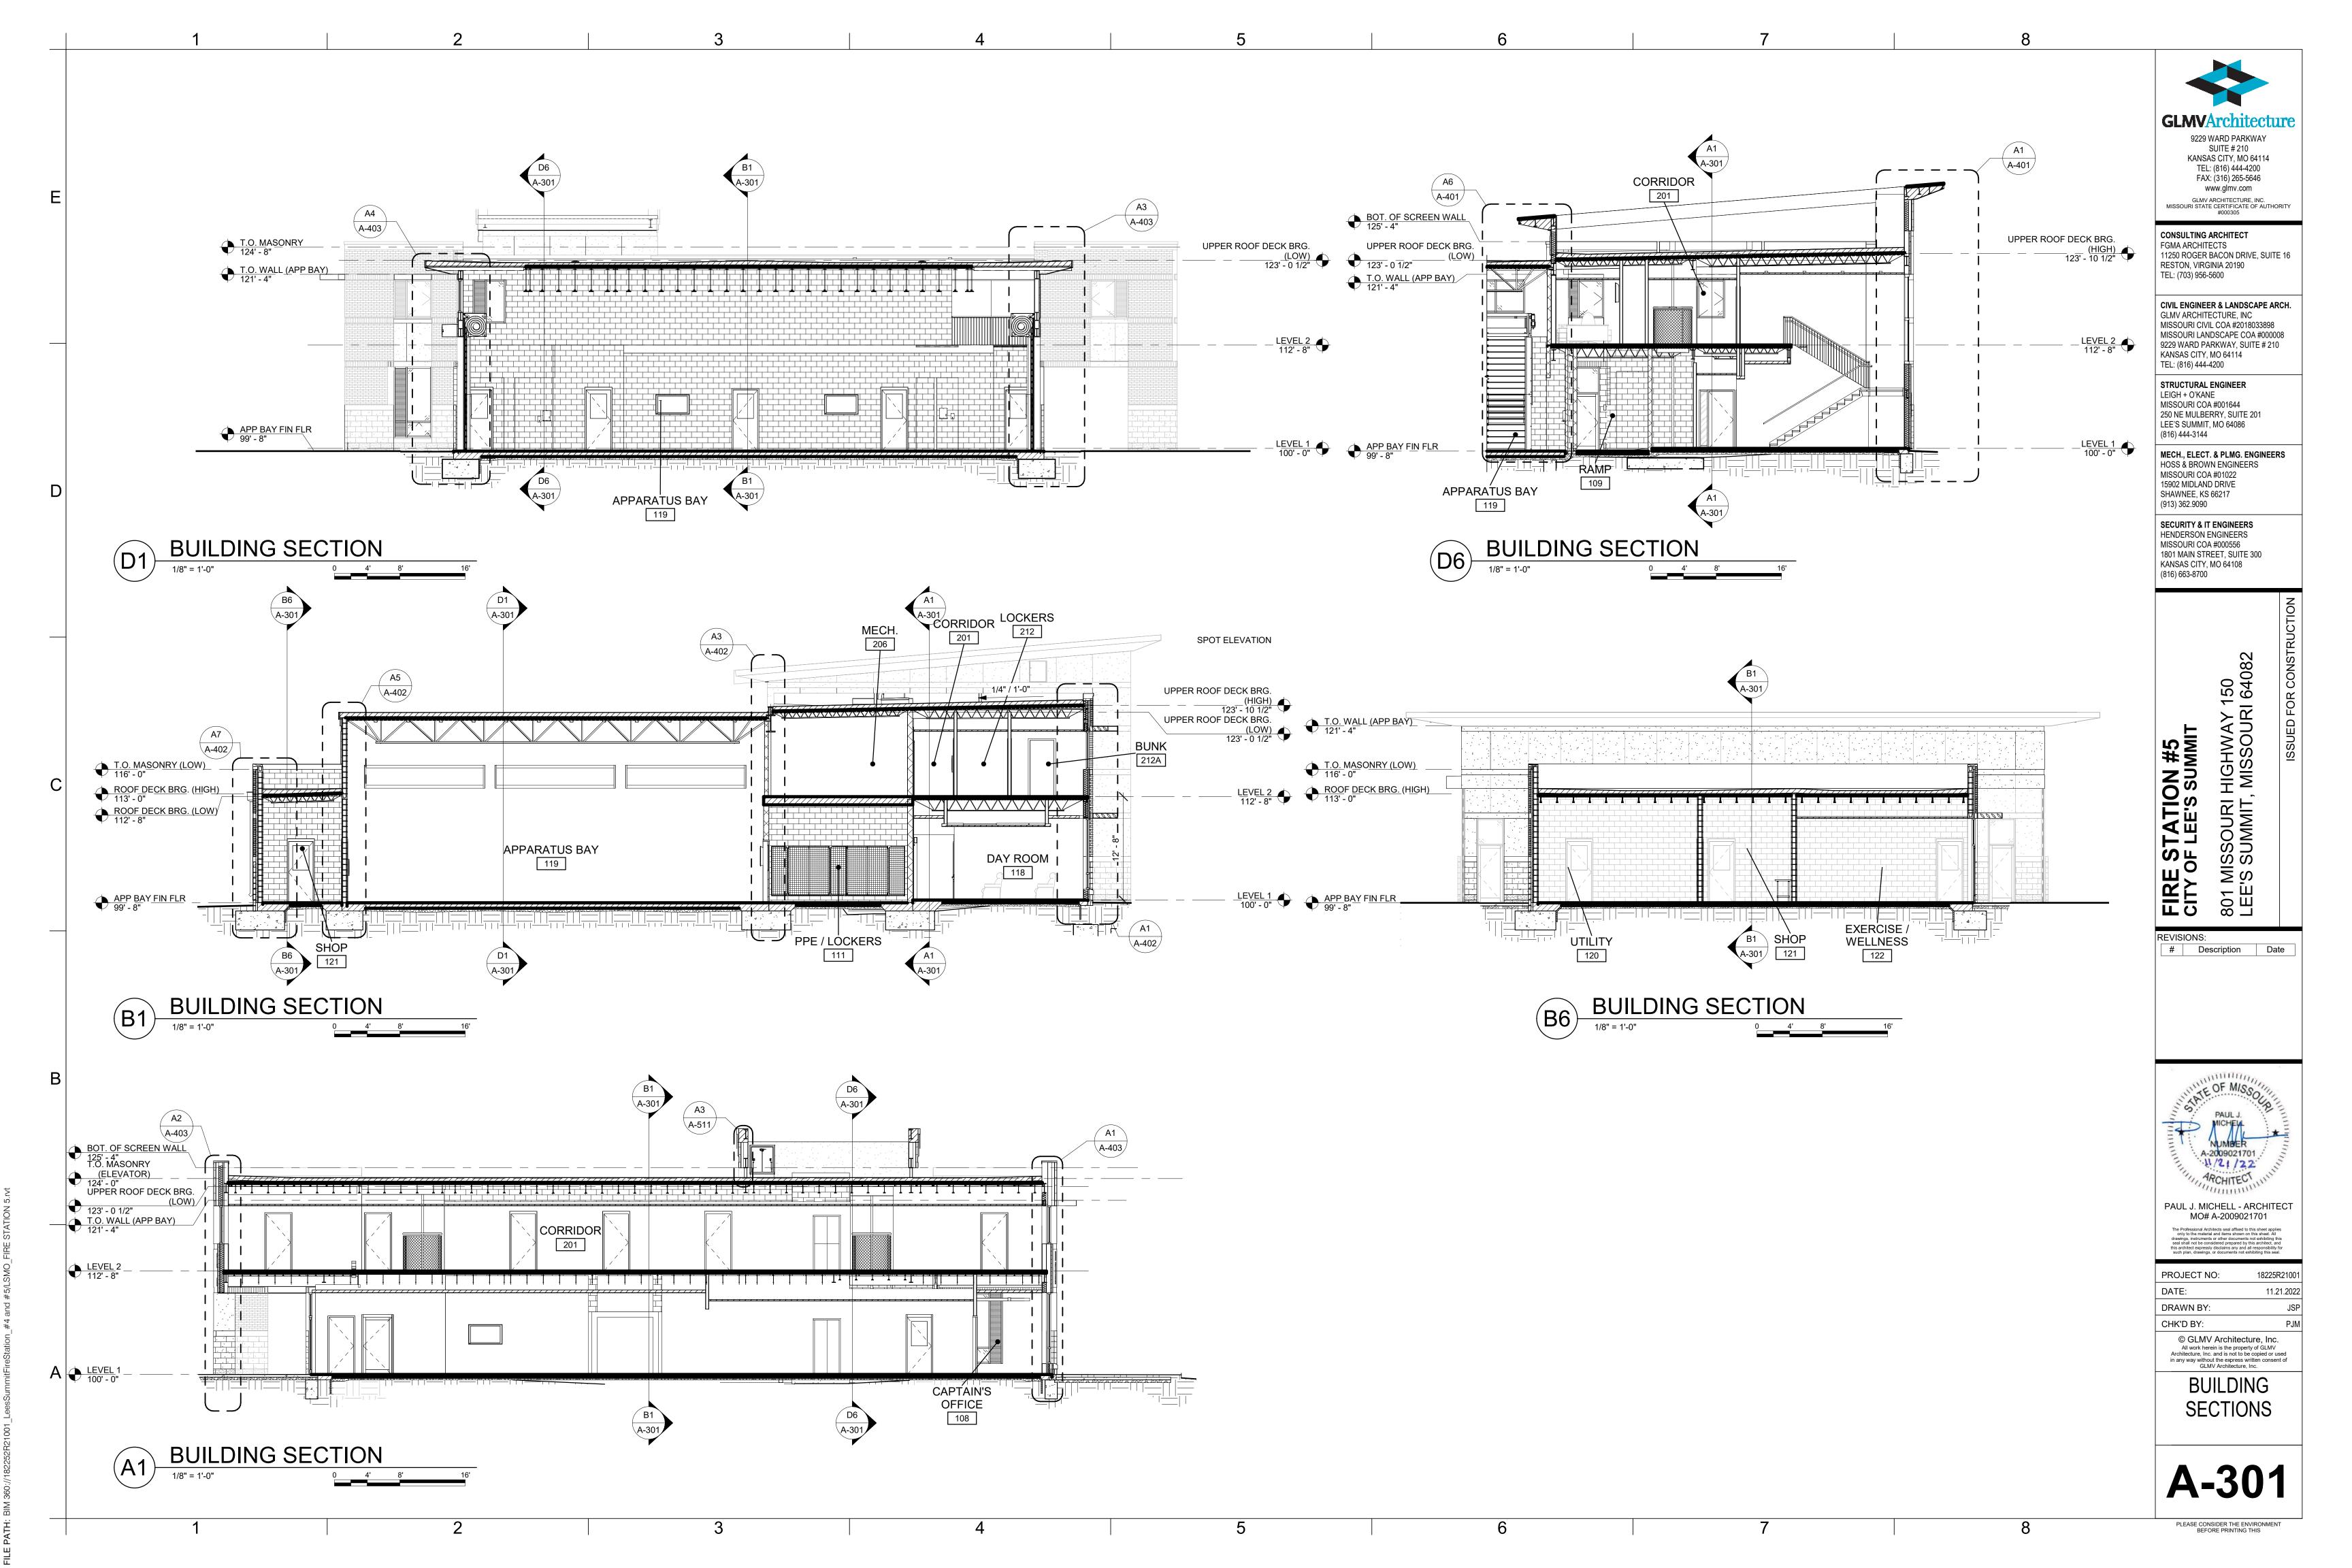

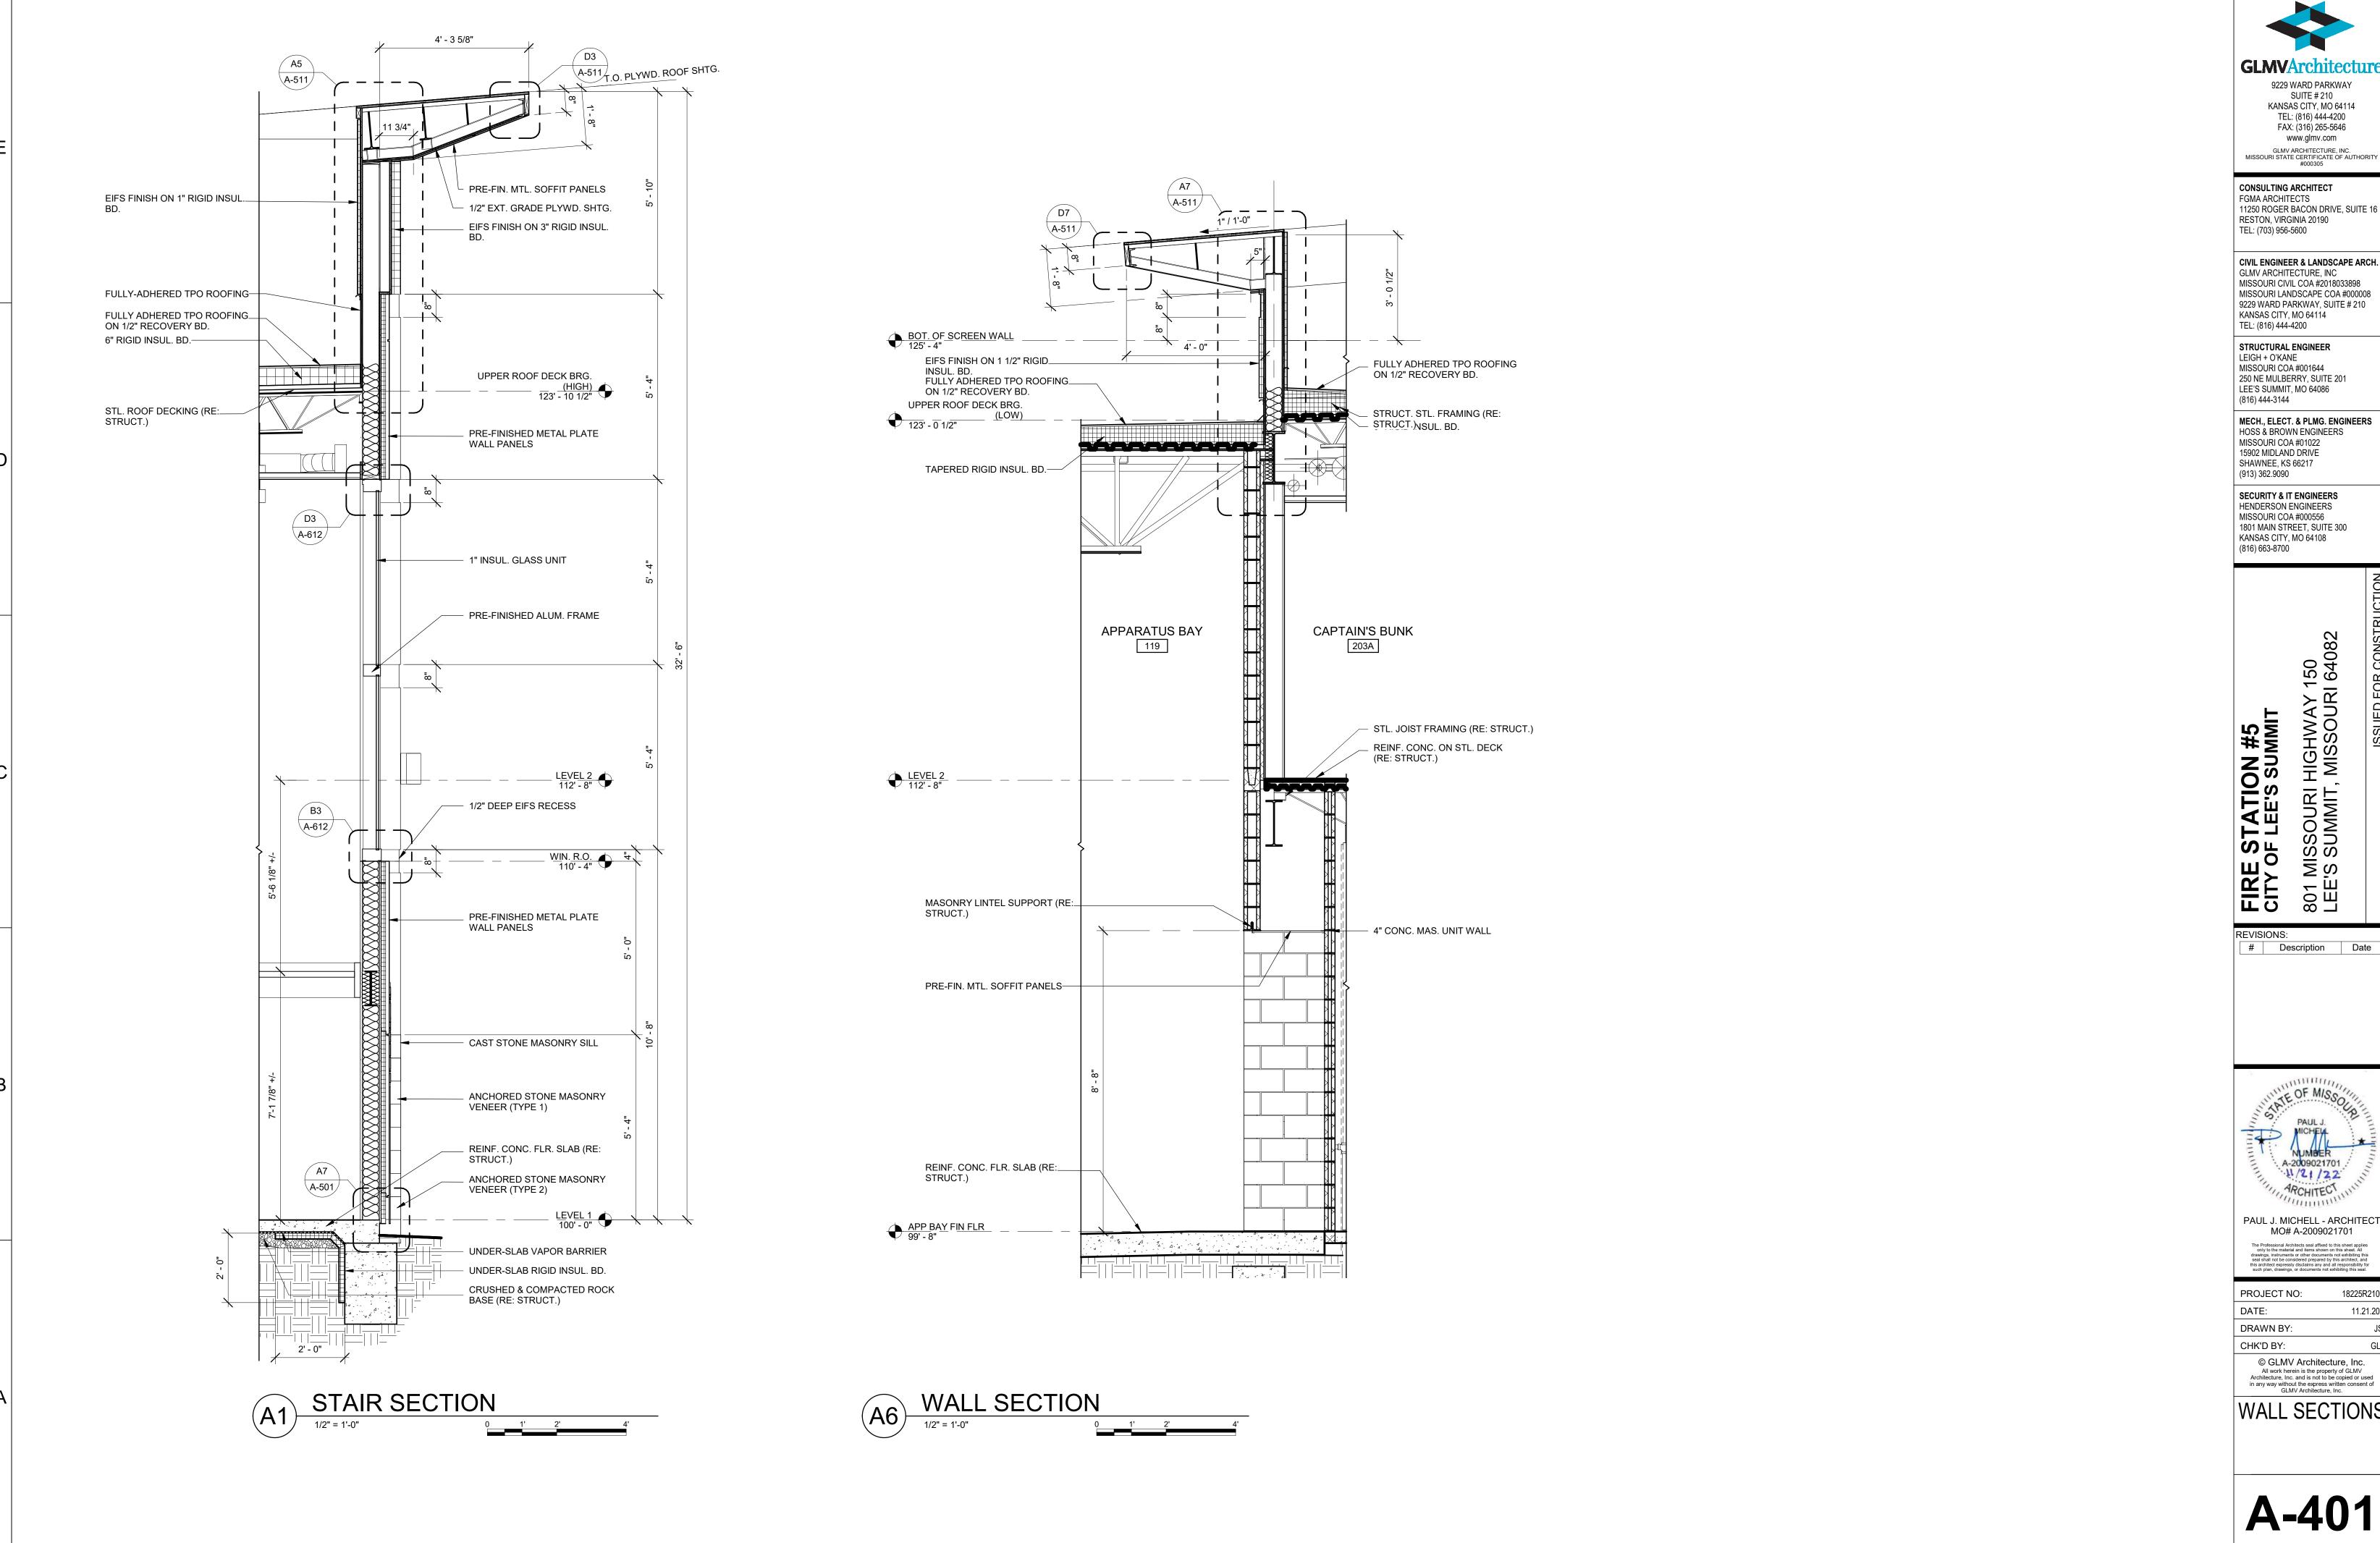

9229 WARD PARKWAY SUITE # 210 KANSAS CITY, MO 64114 TEL: (816) 444-4200

FAX: (316) 265-5646 www.glmv.com GLMV ARCHITECTURE, INC. MISSOURI STATE CERTIFICATE OF AUTHORITY #000305

CONSULTING ARCHITECT FGMA ARCHITECTS 11250 ROGER BACON DRIVE, SUITE 16 RESTON, VIRGINIA 20190

CIVIL ENGINEER & LANDSCAPE ARCH.
GLMV ARCHITECTURE, INC MISSOURI CIVIL COA #2018033898 MISSOURI LANDSCAPE COA #000008 9229 WARD PARKWAY, SUITE # 210

STRUCTURAL ENGINEER LEIGH + O'KANE MISSOURI COA #001644 250 NE MULBERRY, SUITE 201 LEE'S SUMMIT, MO 64086

MECH., ELECT. & PLMG. ENGINEERS HOSS & BROWN ENGINEERS MISSOURI COA #01022 15902 MIDLAND DRIVE SHAWNEE, KS 66217

SECURITY & IT ENGINEERS HENDERSON ENGINEERS MISSOURI COA #000556 1801 MAIN STREET, SUITE 300 KANSAS CITY, MO 64108 (816) 663-8700

HIGHWAY 150 MISSOURI 64082

801 MISSOUF LEE'S SUMMI


# Description Date





PAUL J. MICHELL - ARCHITECT MO# A-2009021701


PROJECT NO:	18225R21001
DATE:	11.21.2022
DRAWN BY:	JSF
CHK'D BY:	GLW
© GLMV Architecture, Inc. All work herein is the property of GLMV	


WALL SECTIONS

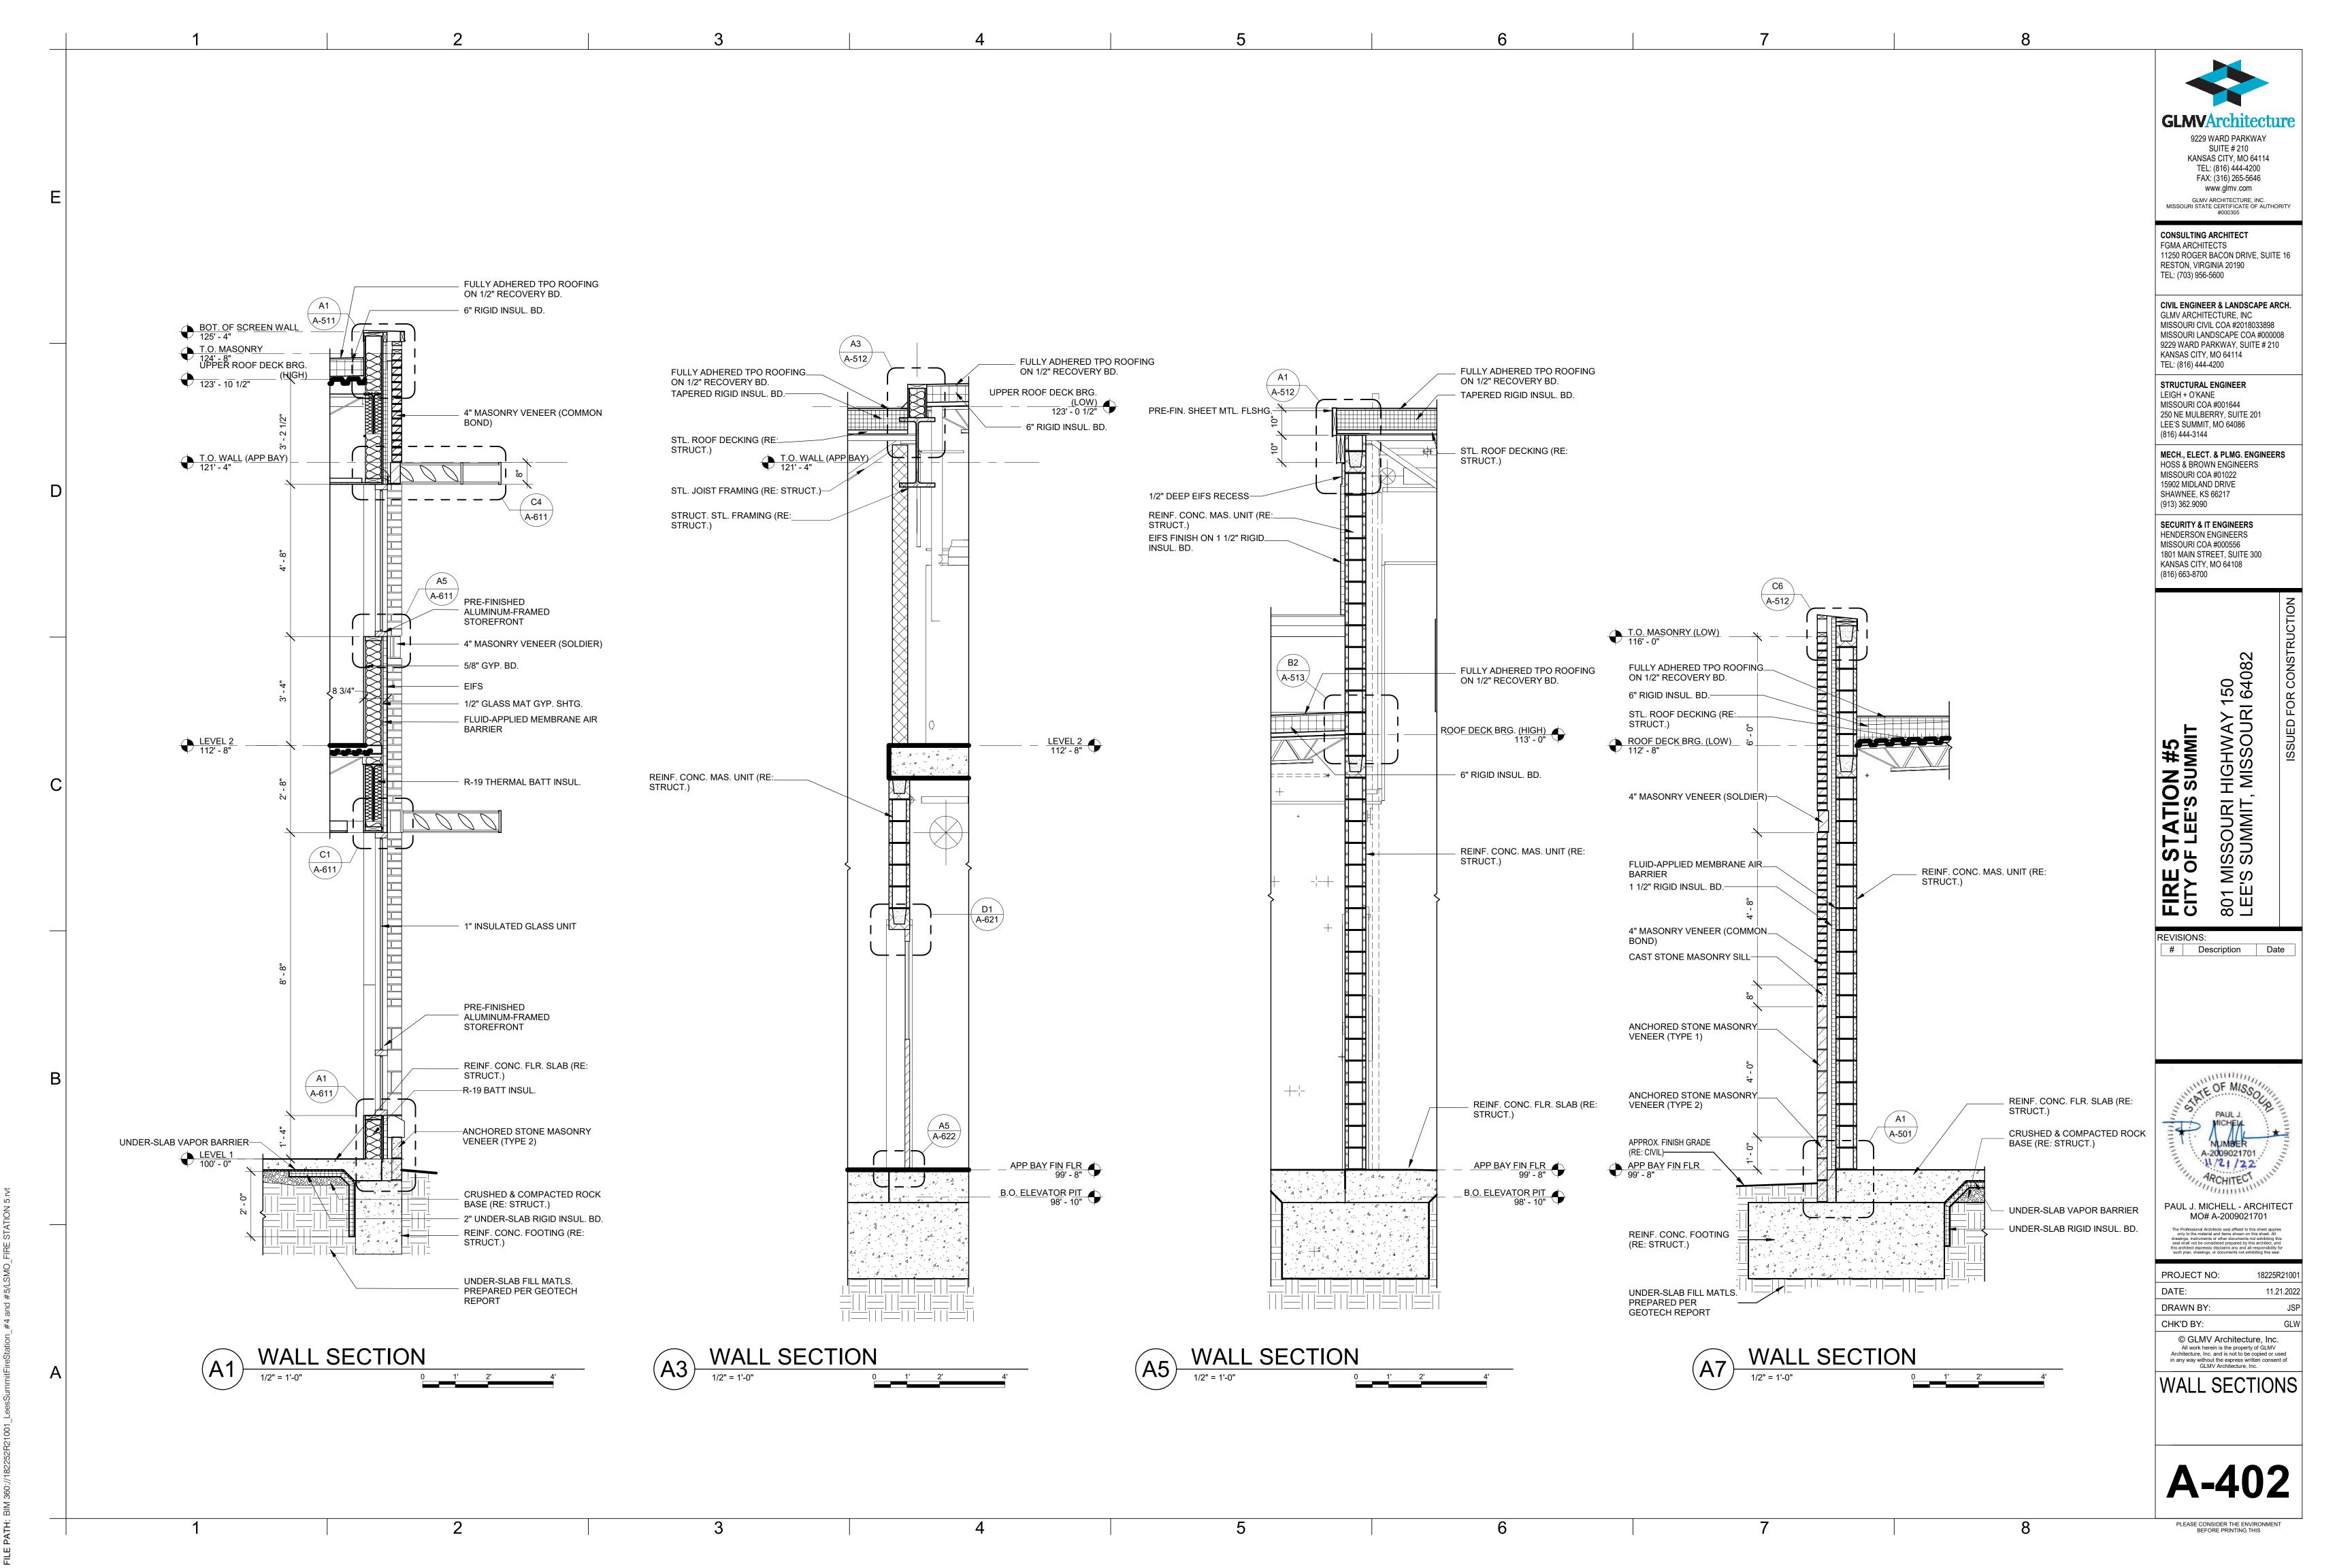


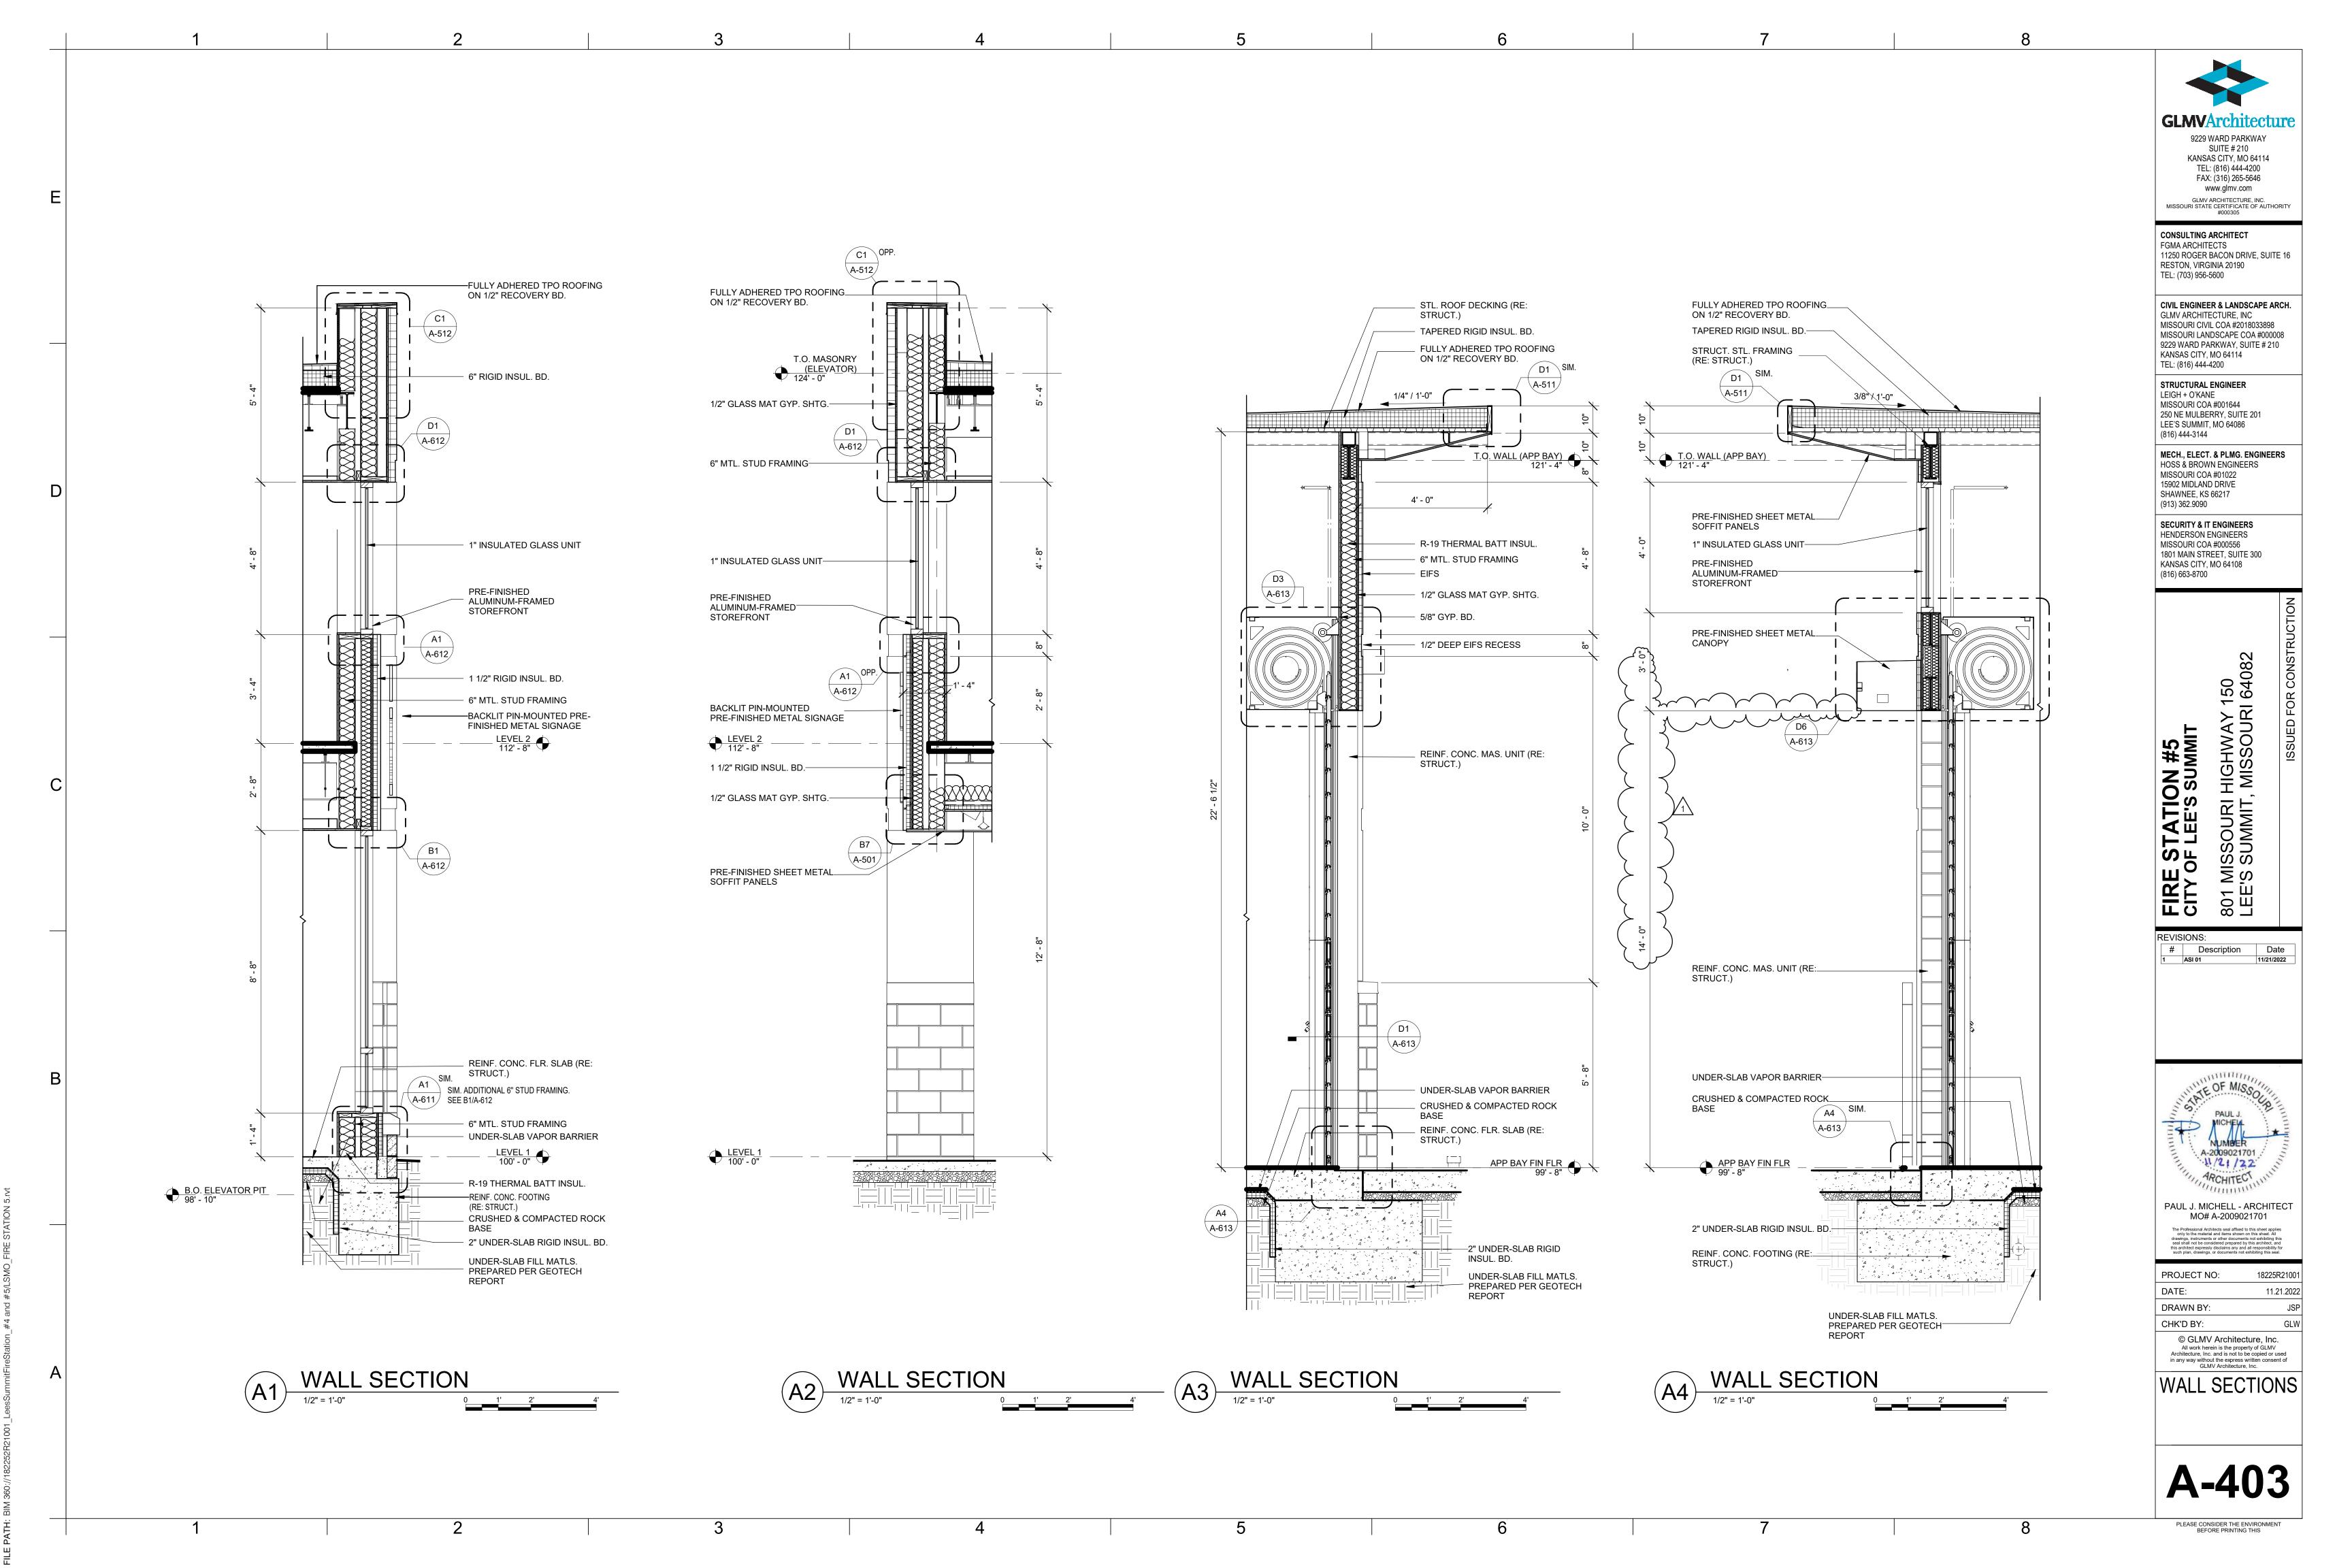


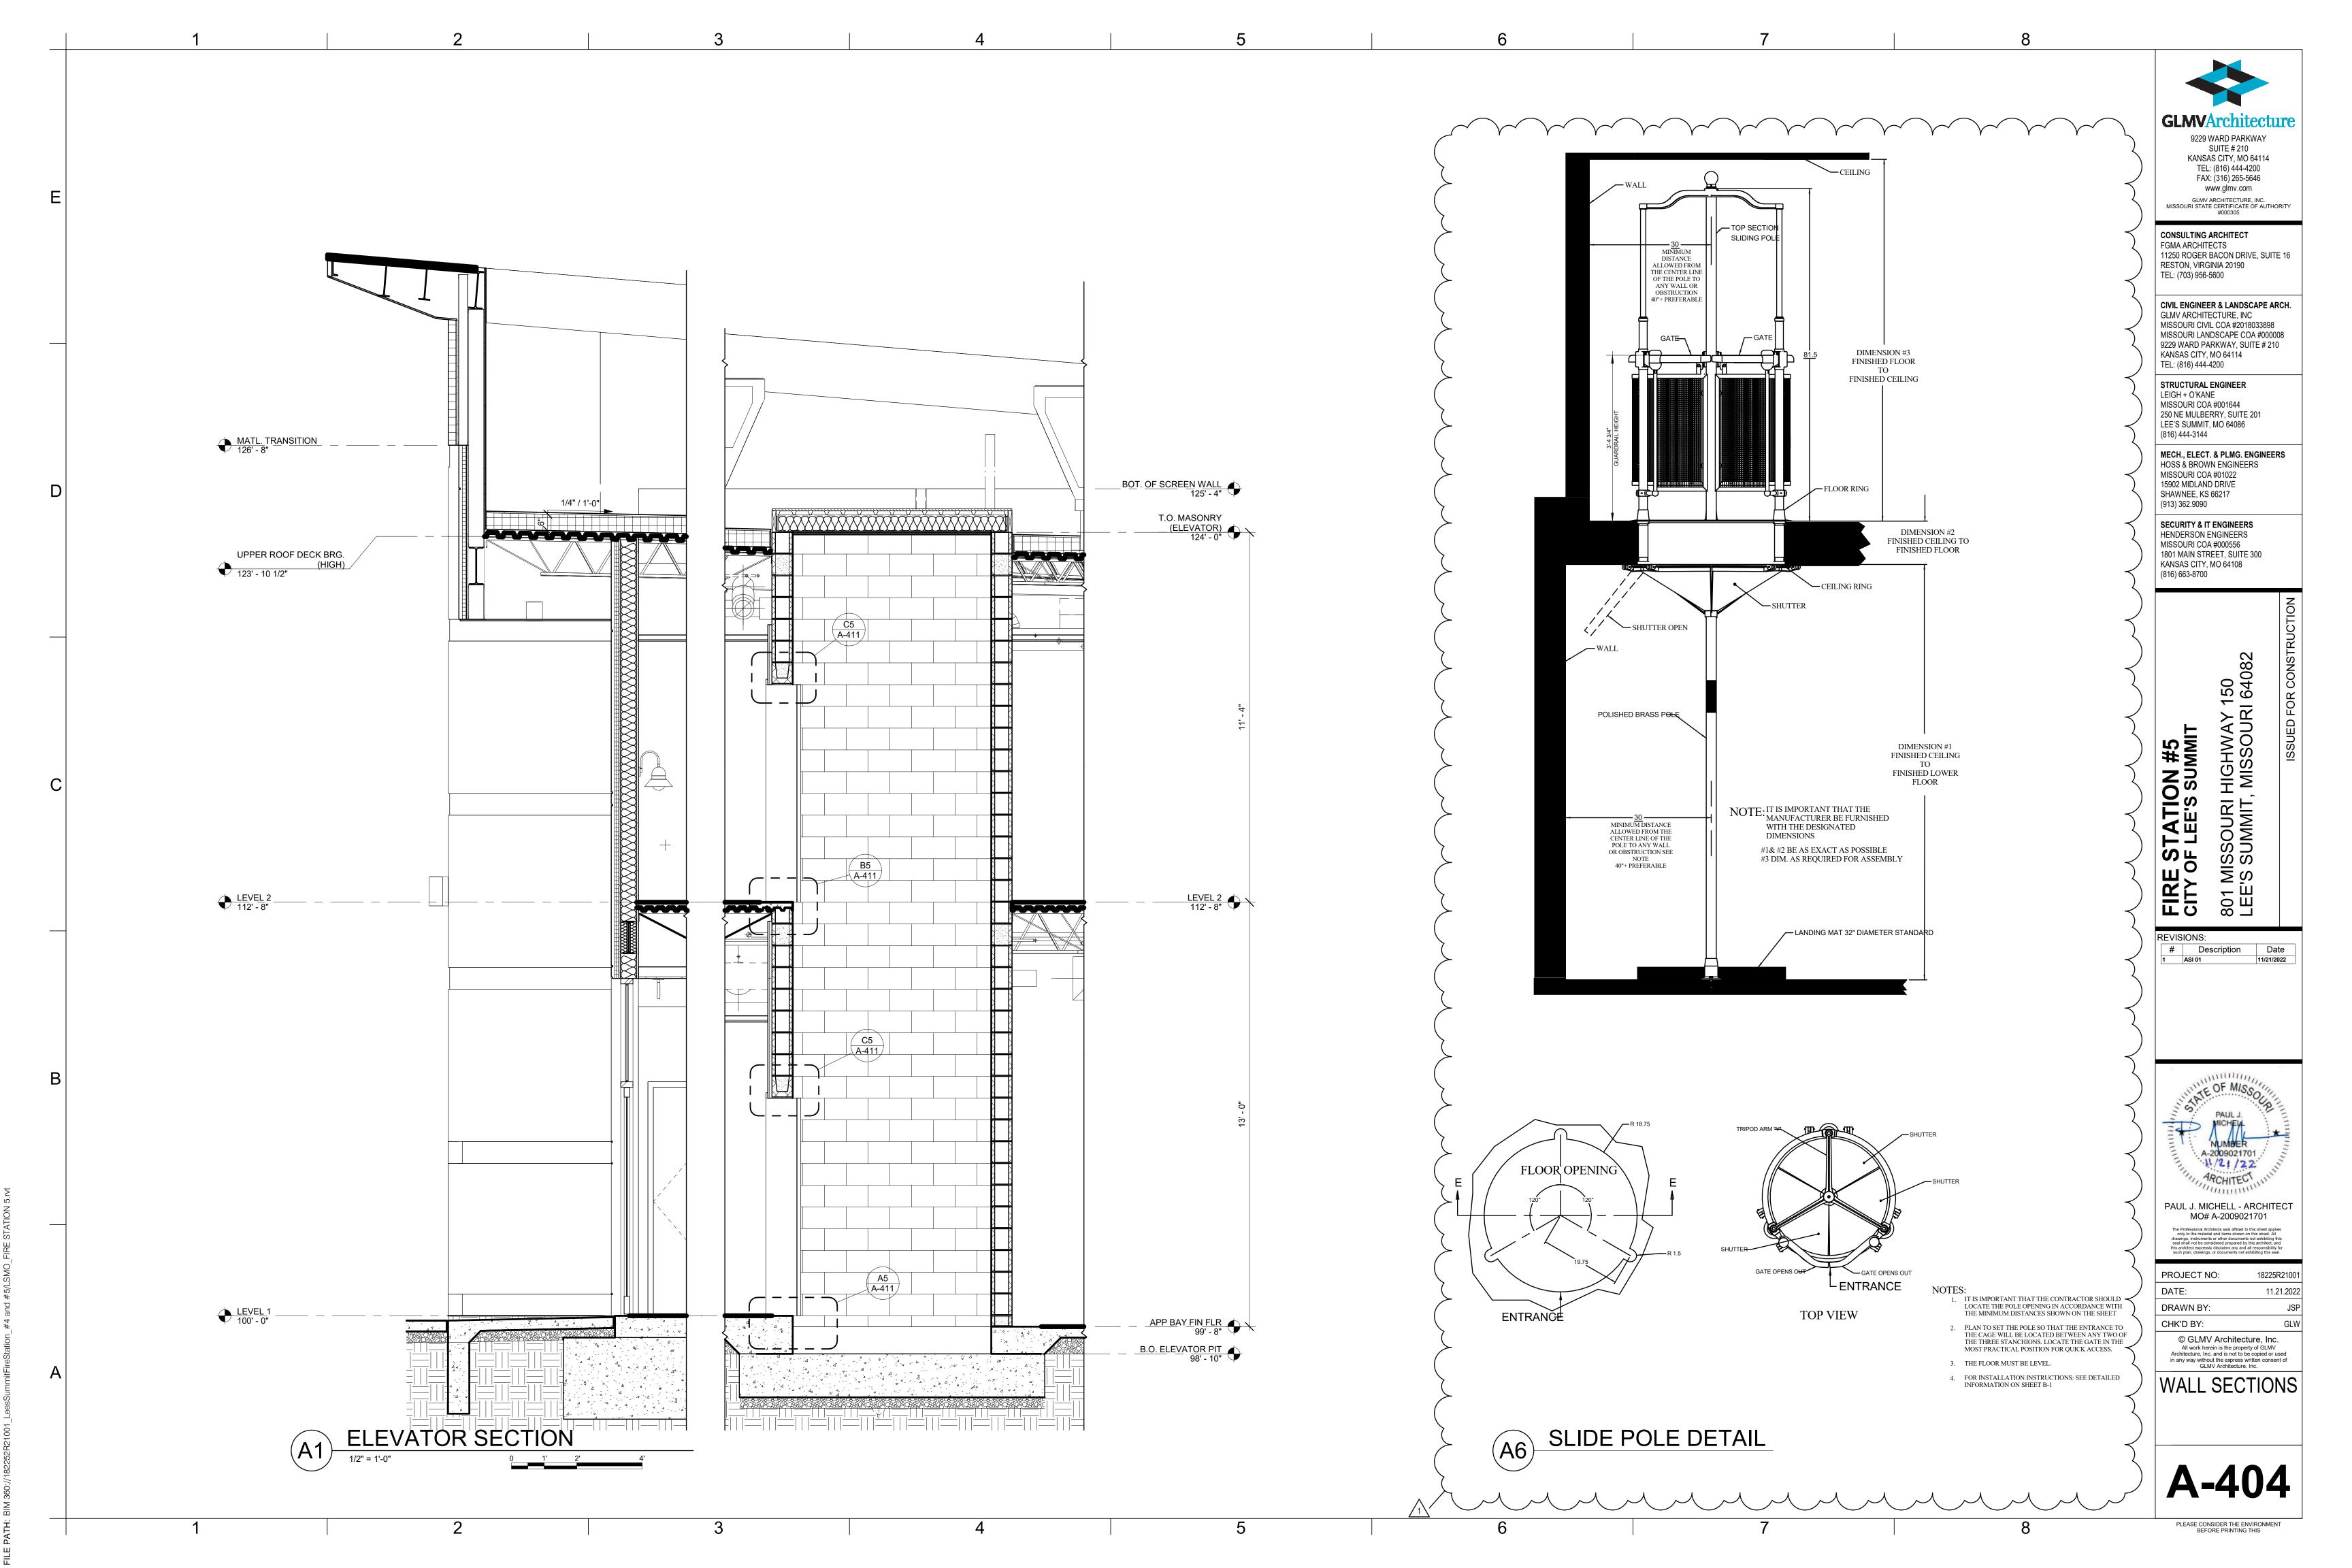

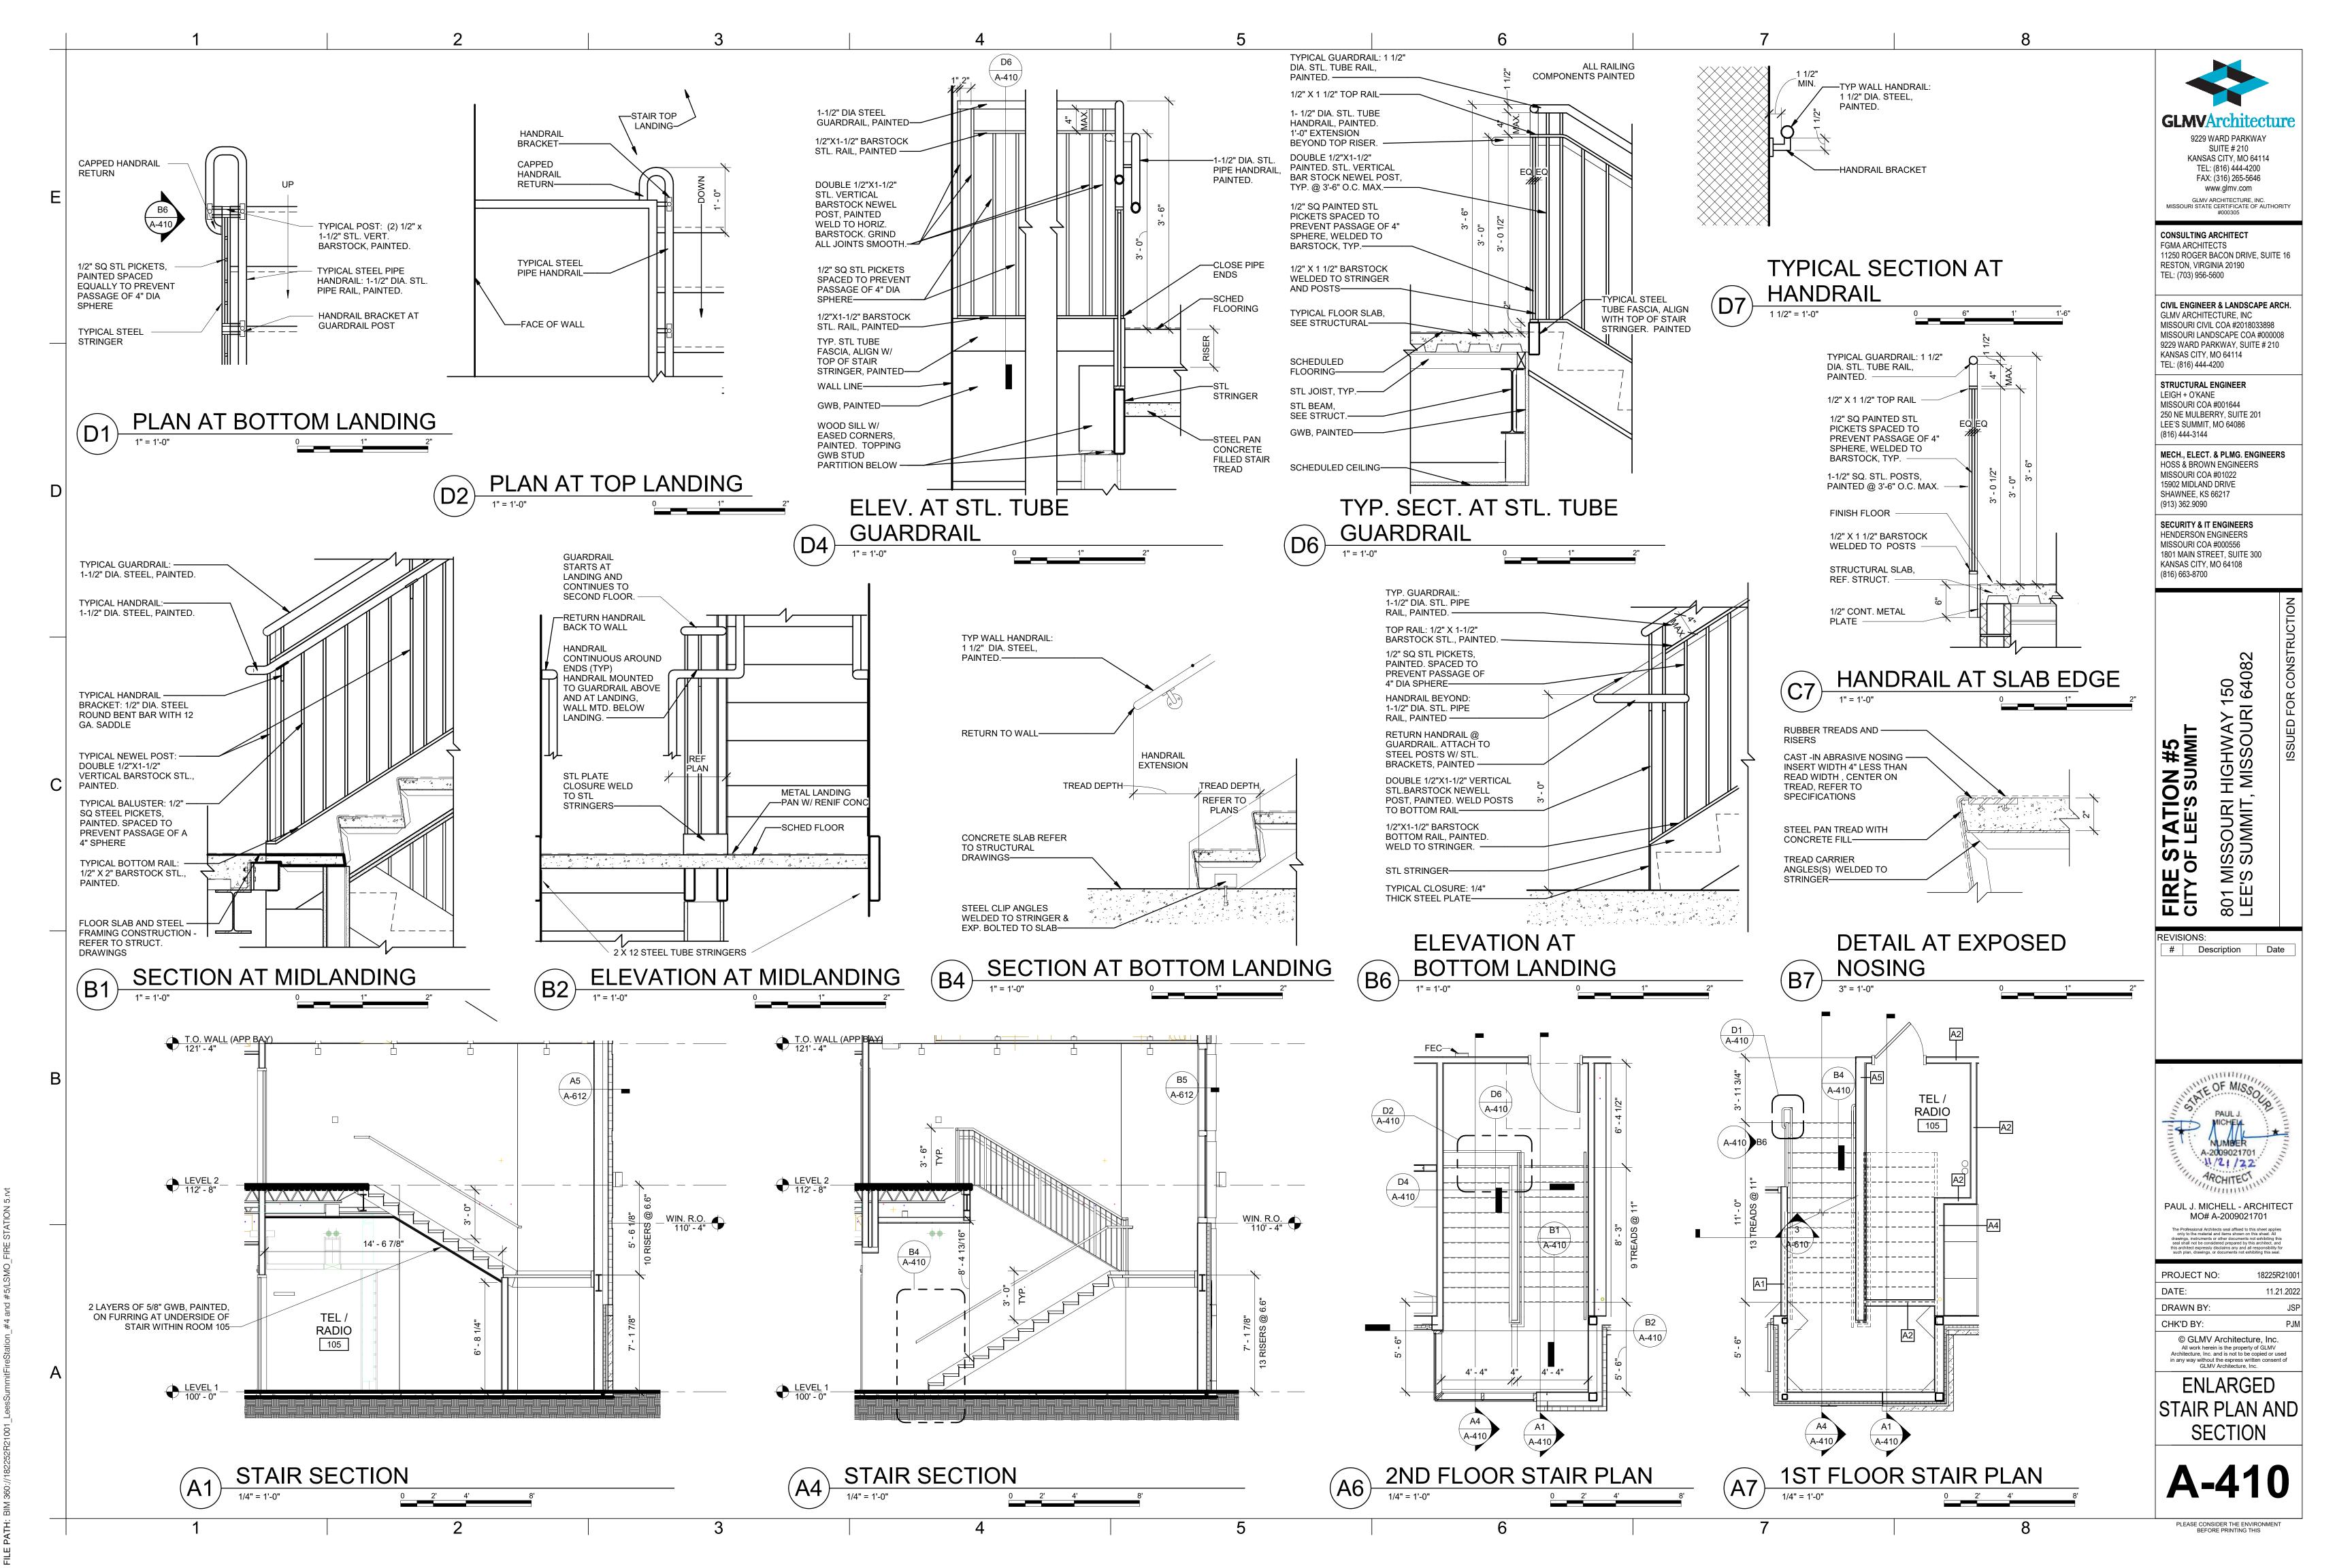

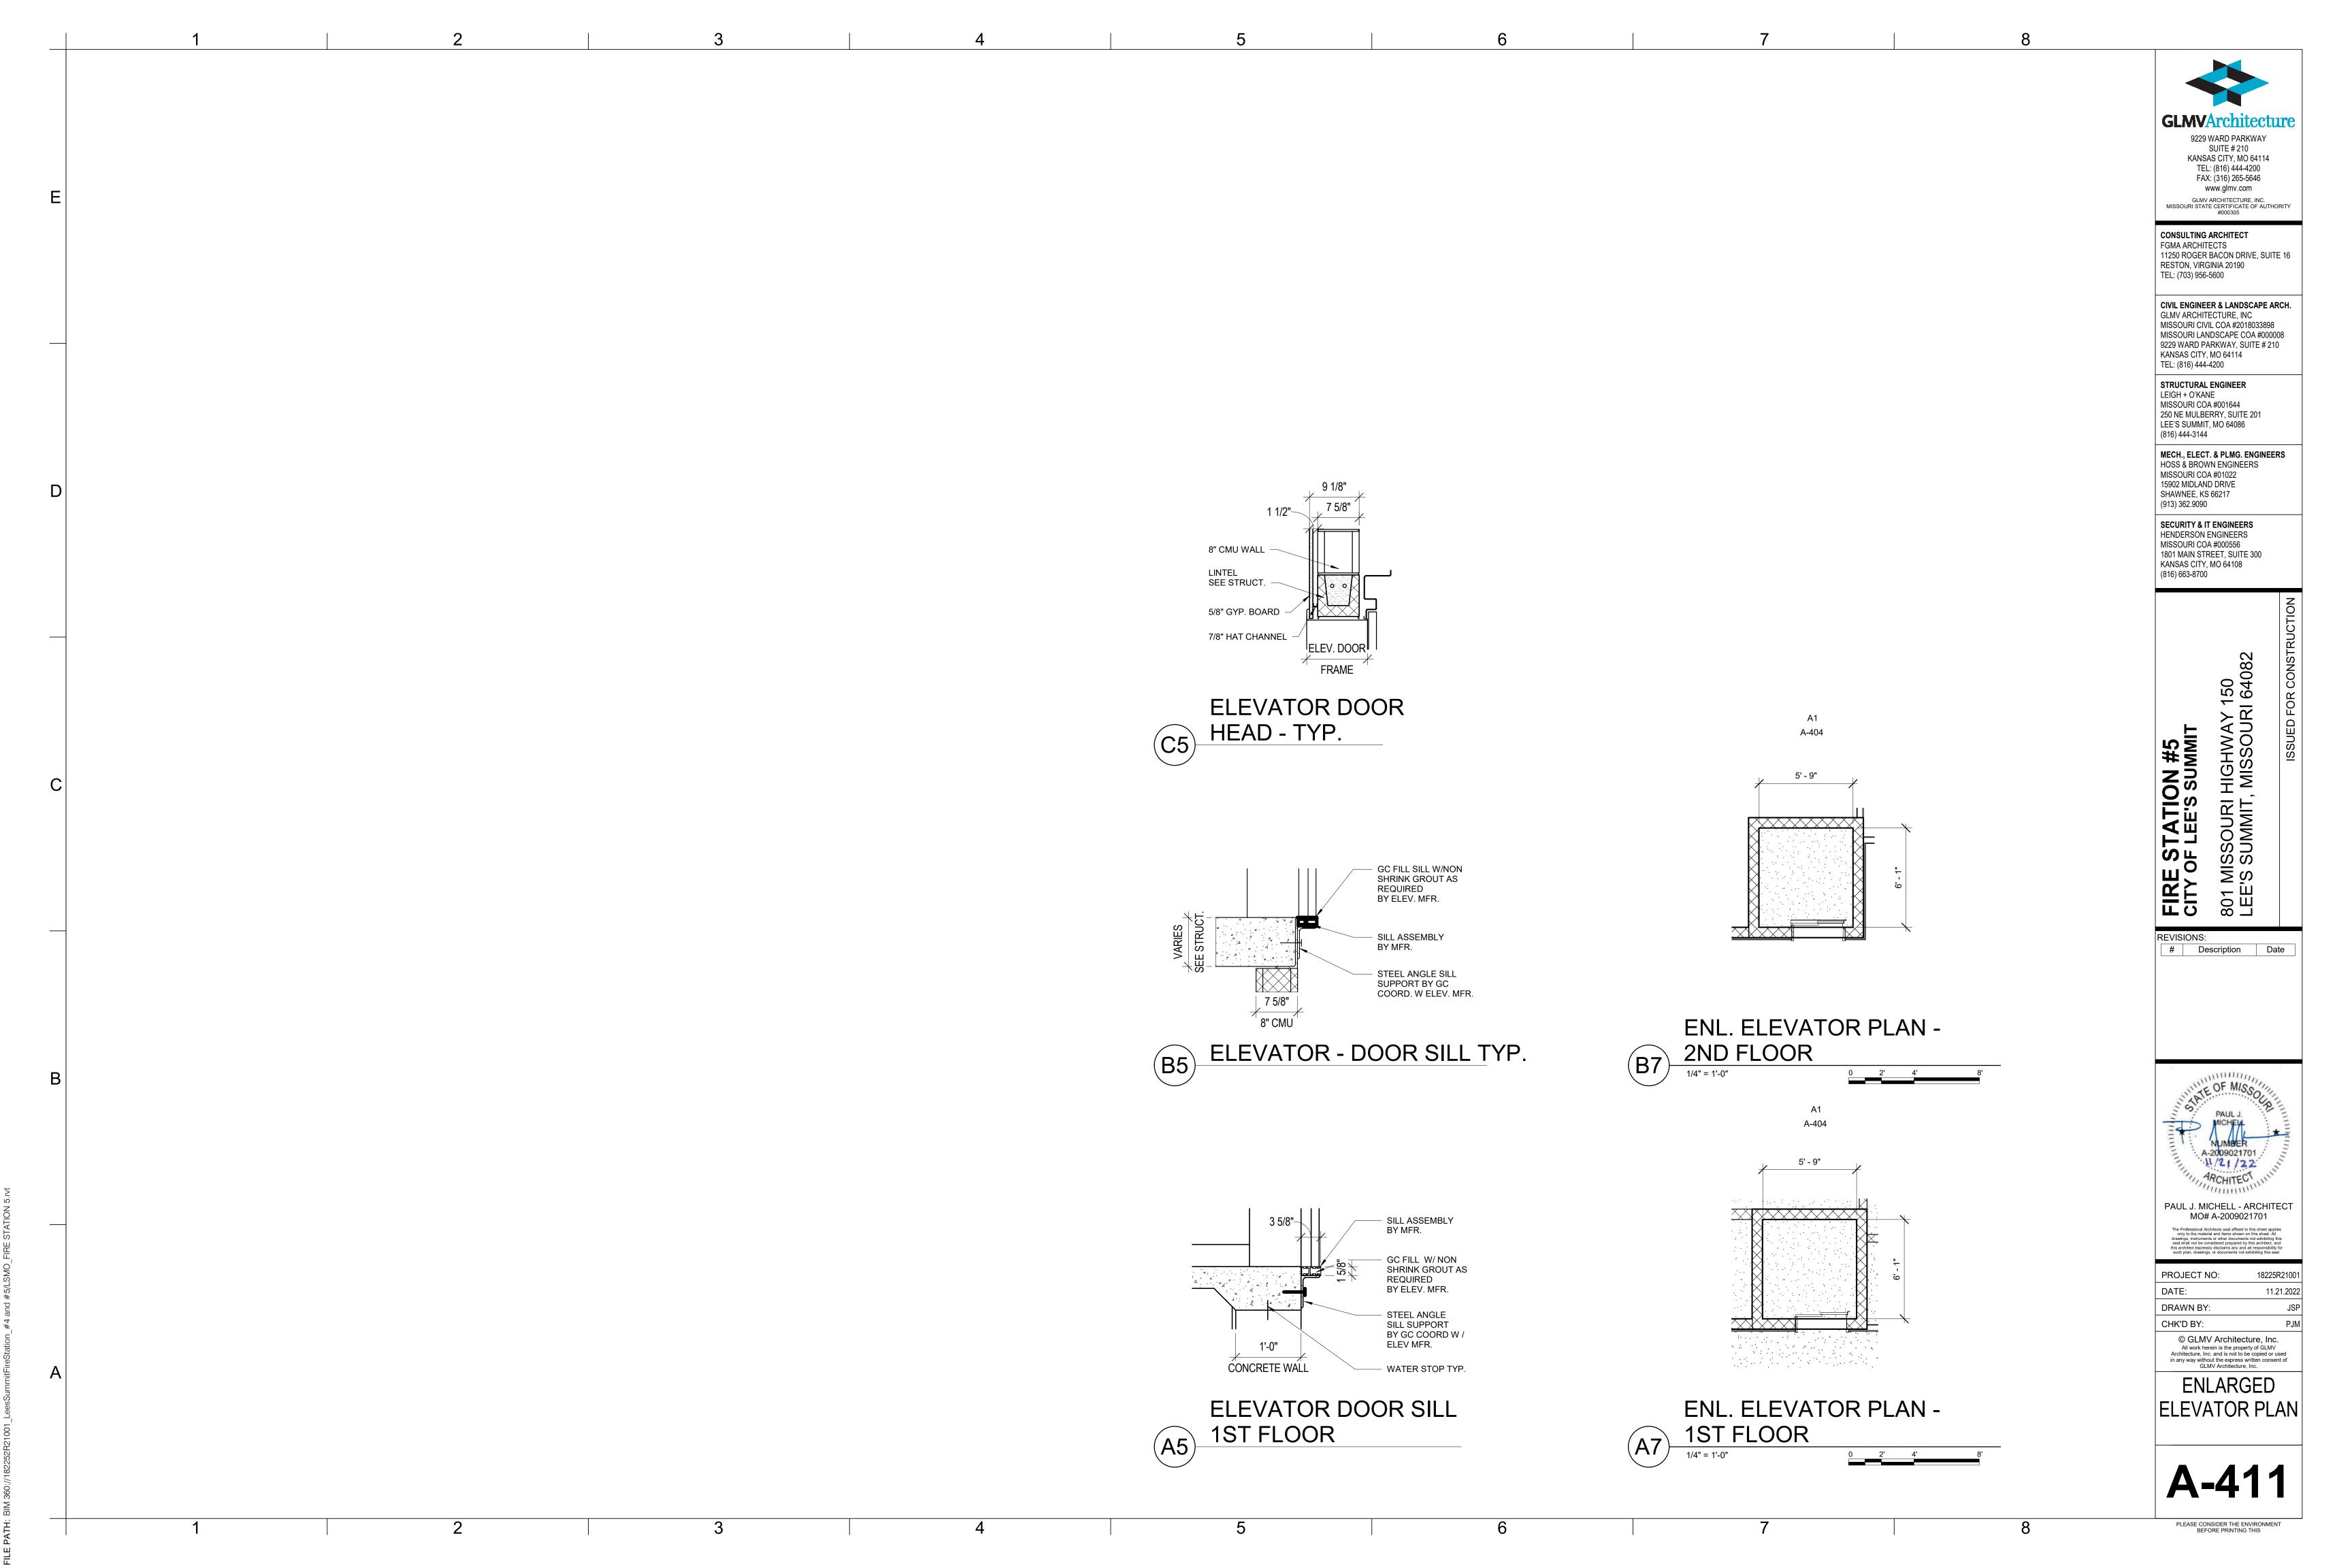

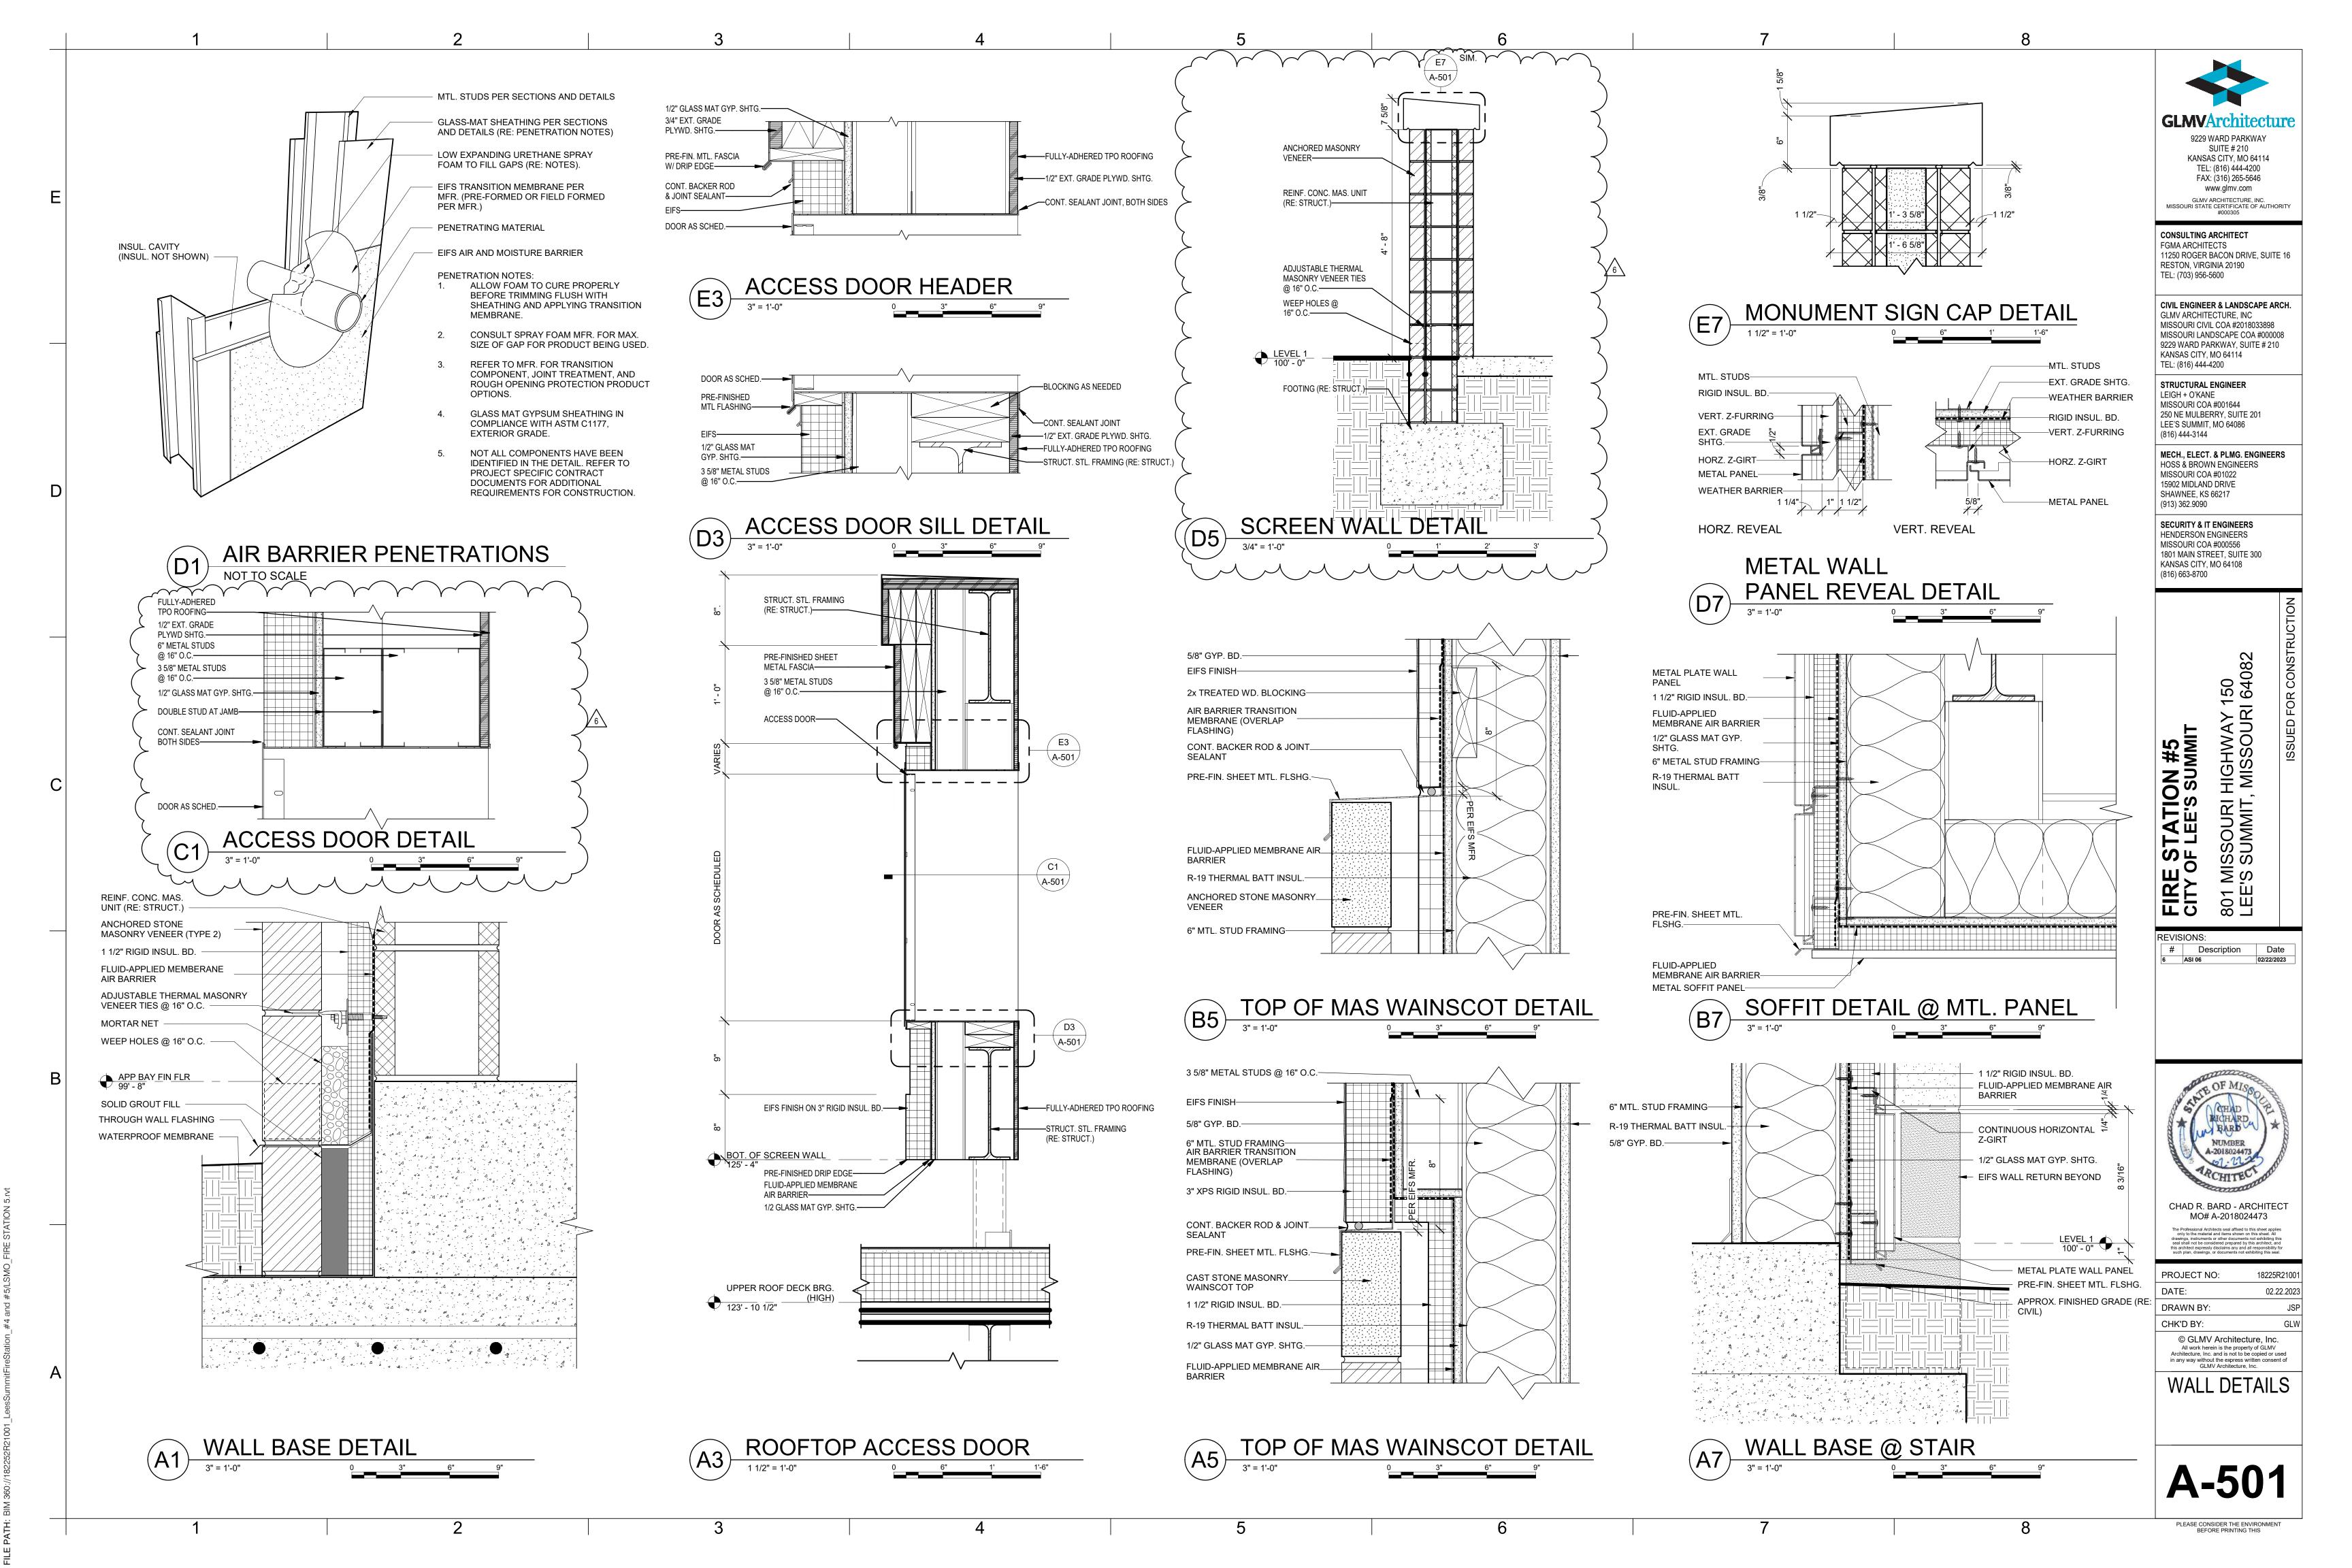


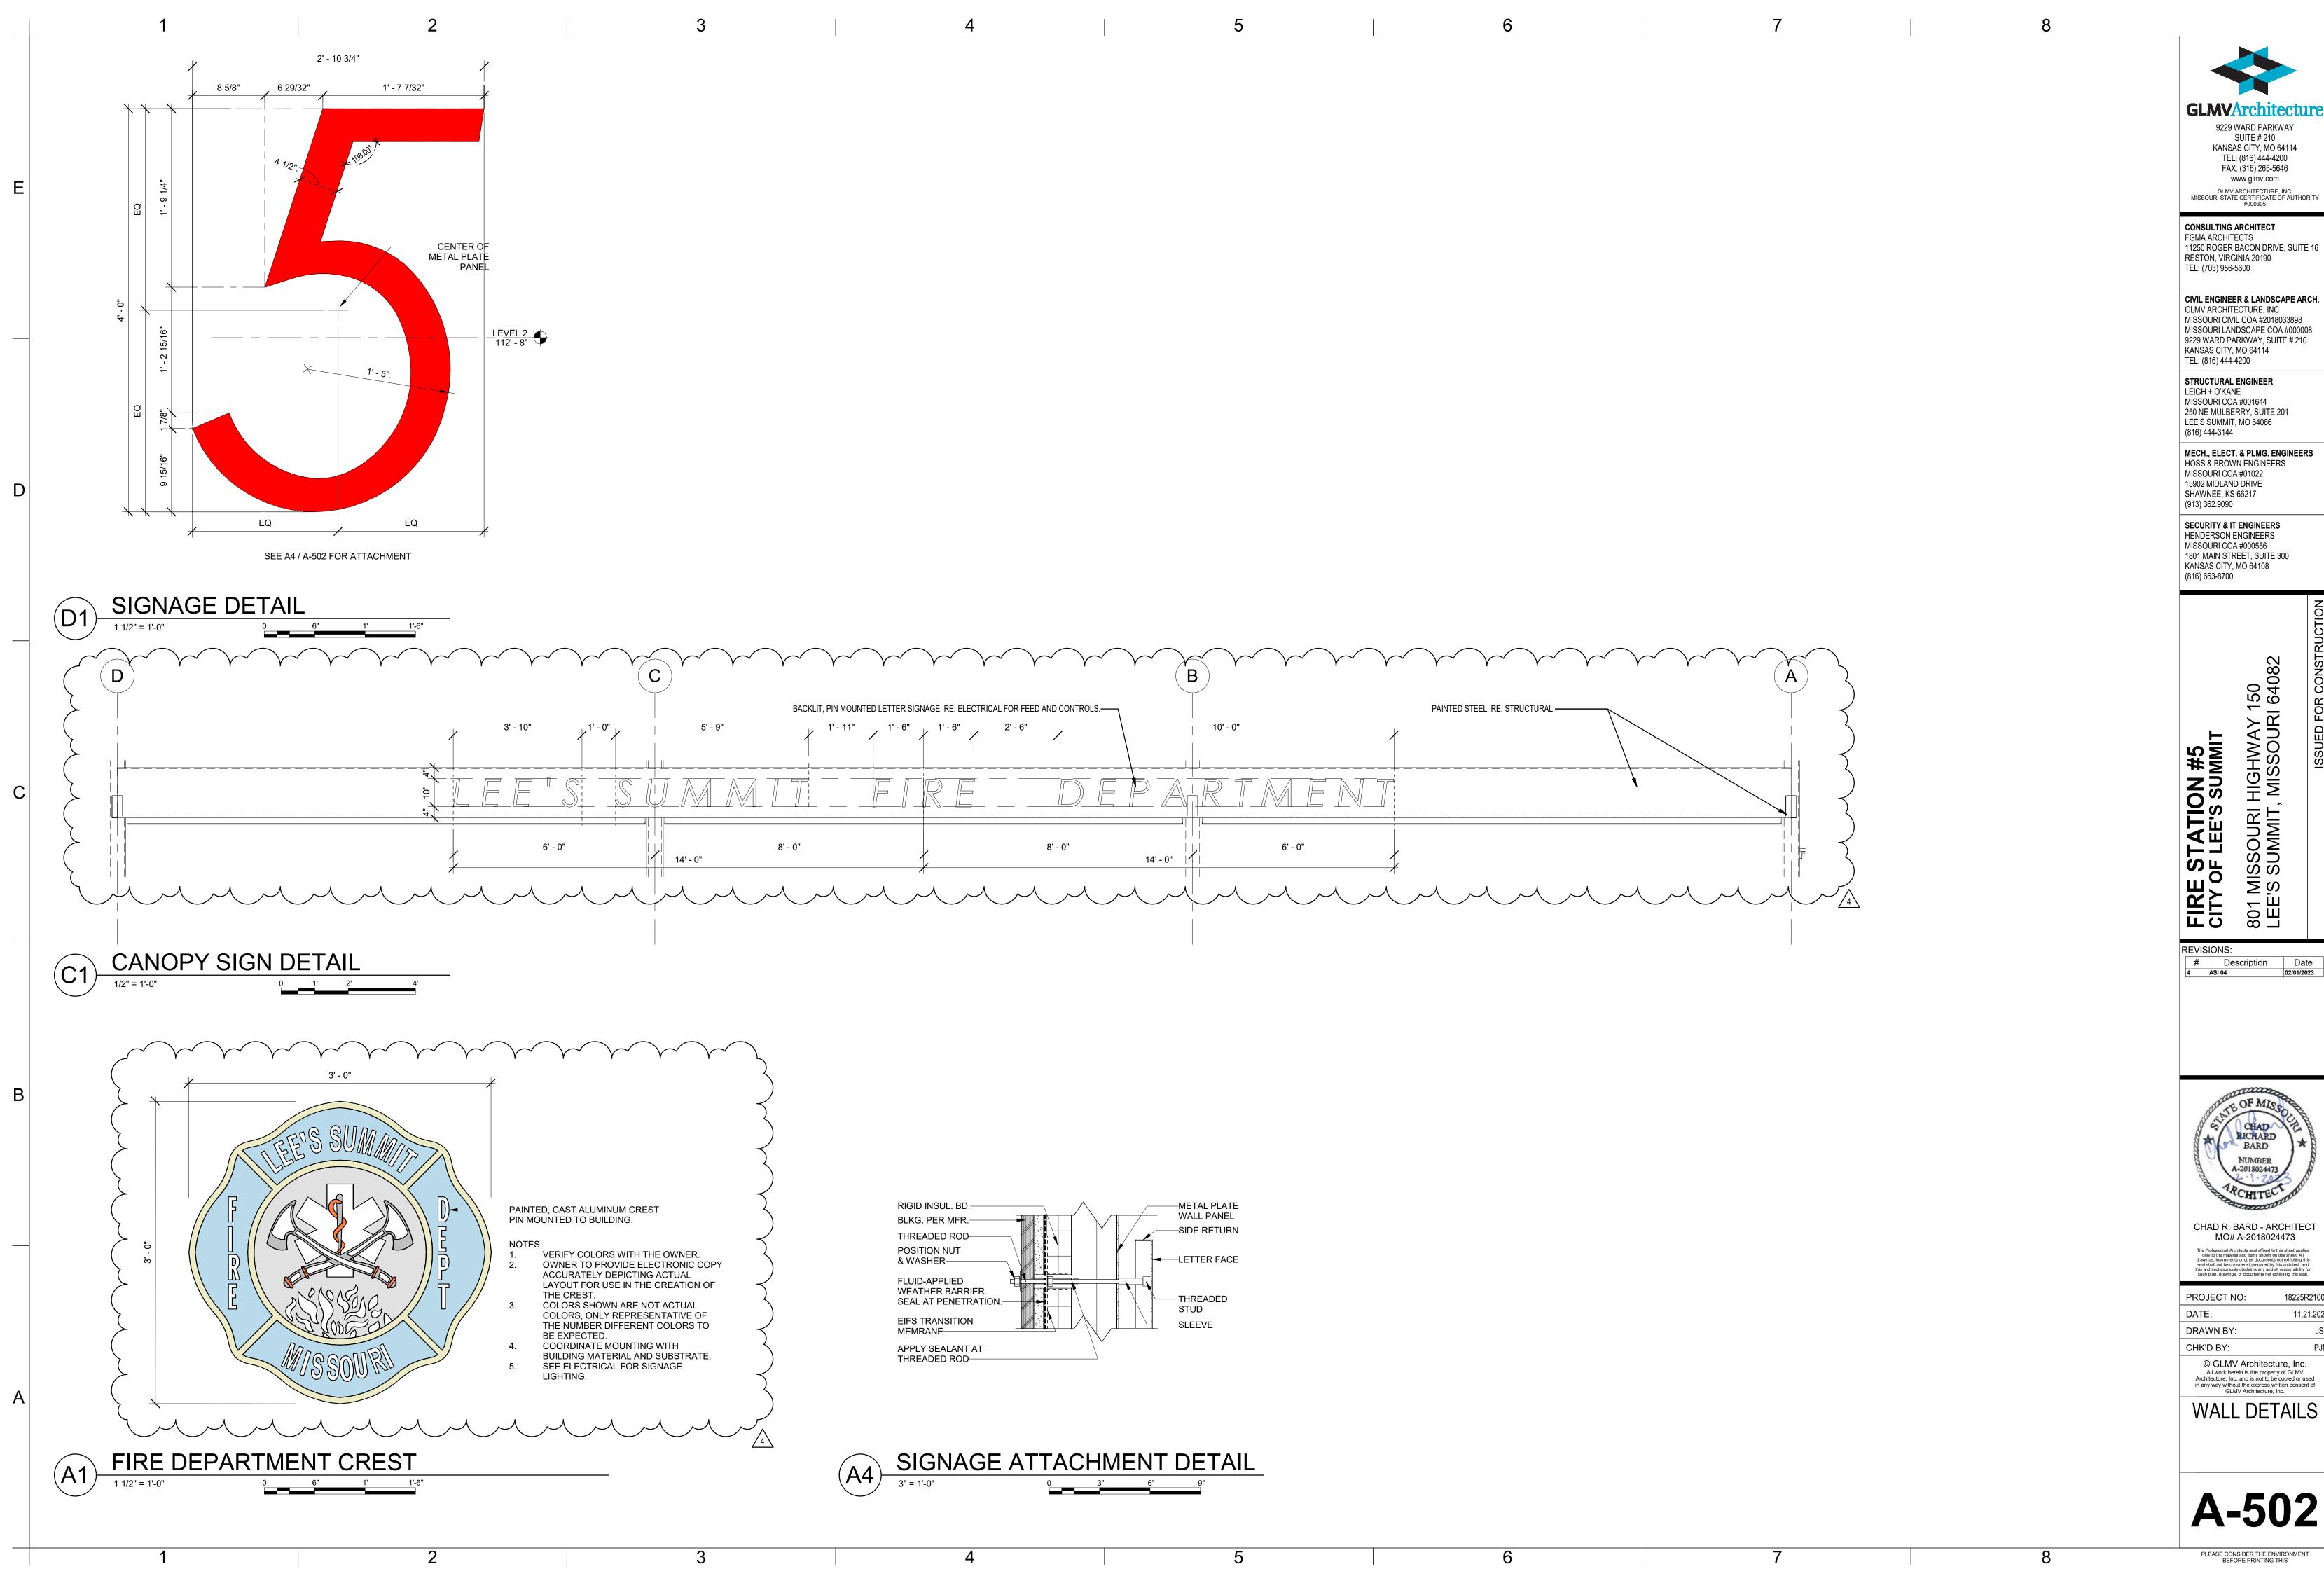



Date 02/01/2023


18225R21001


11.21.2022

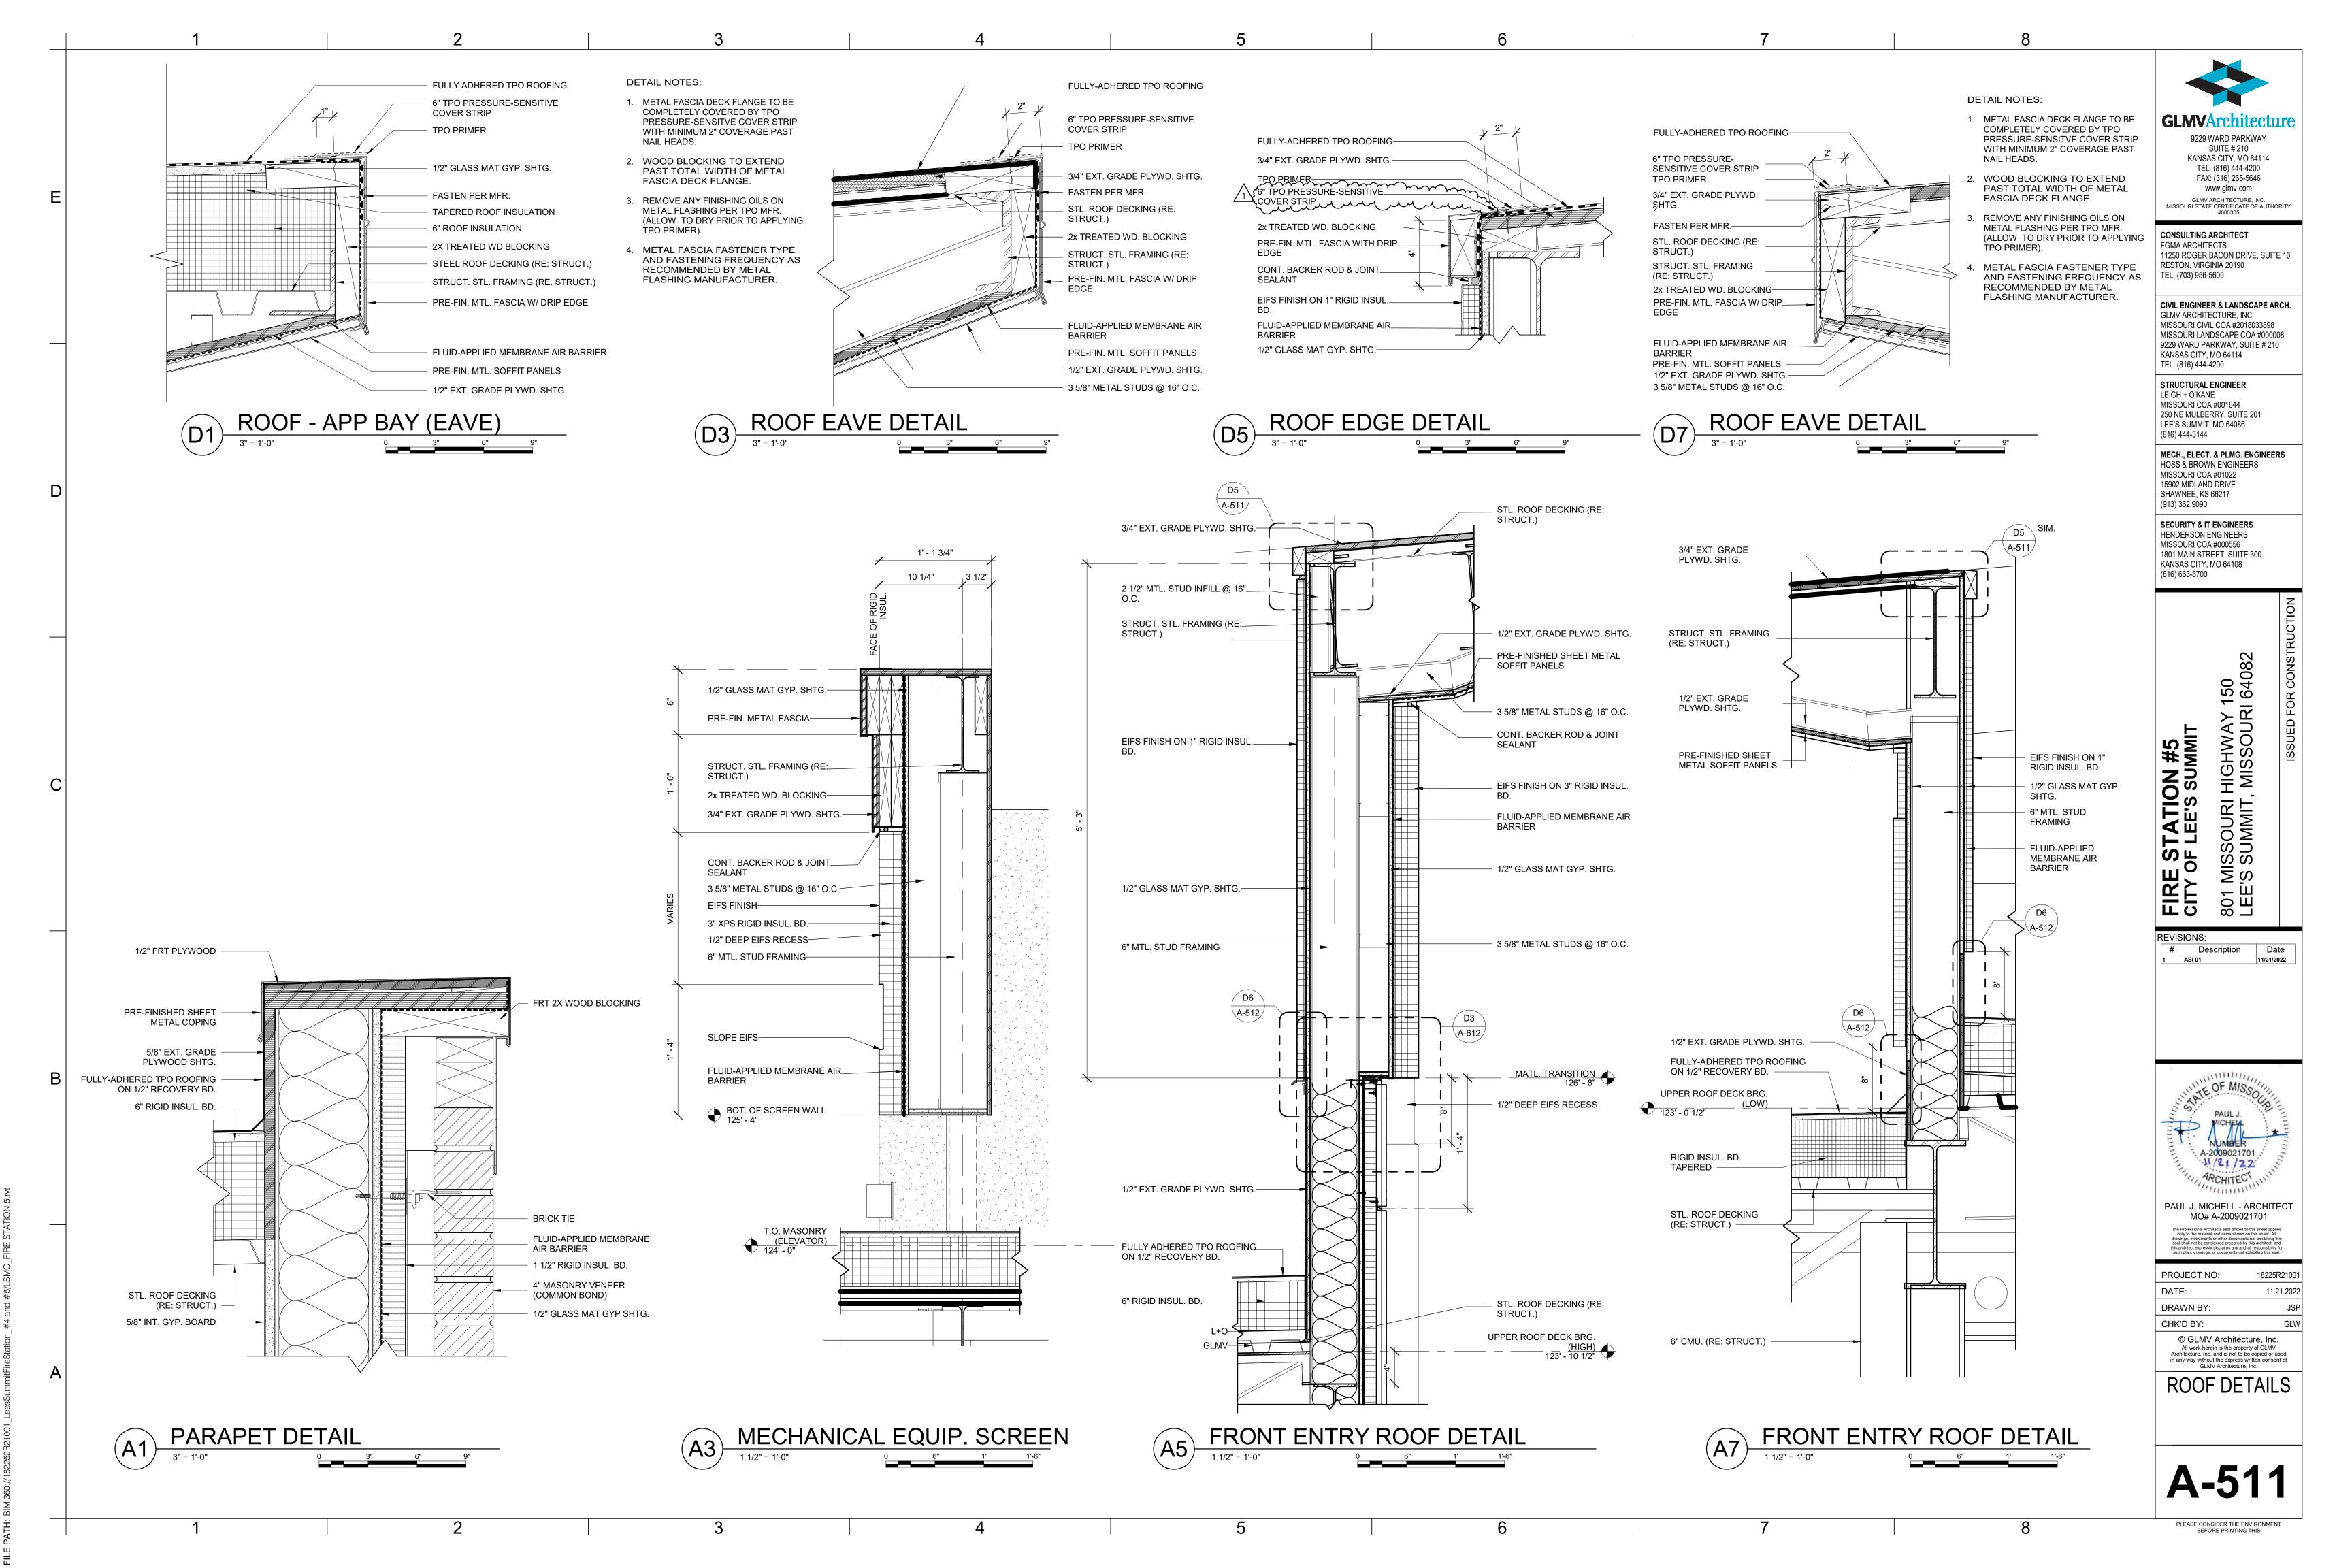

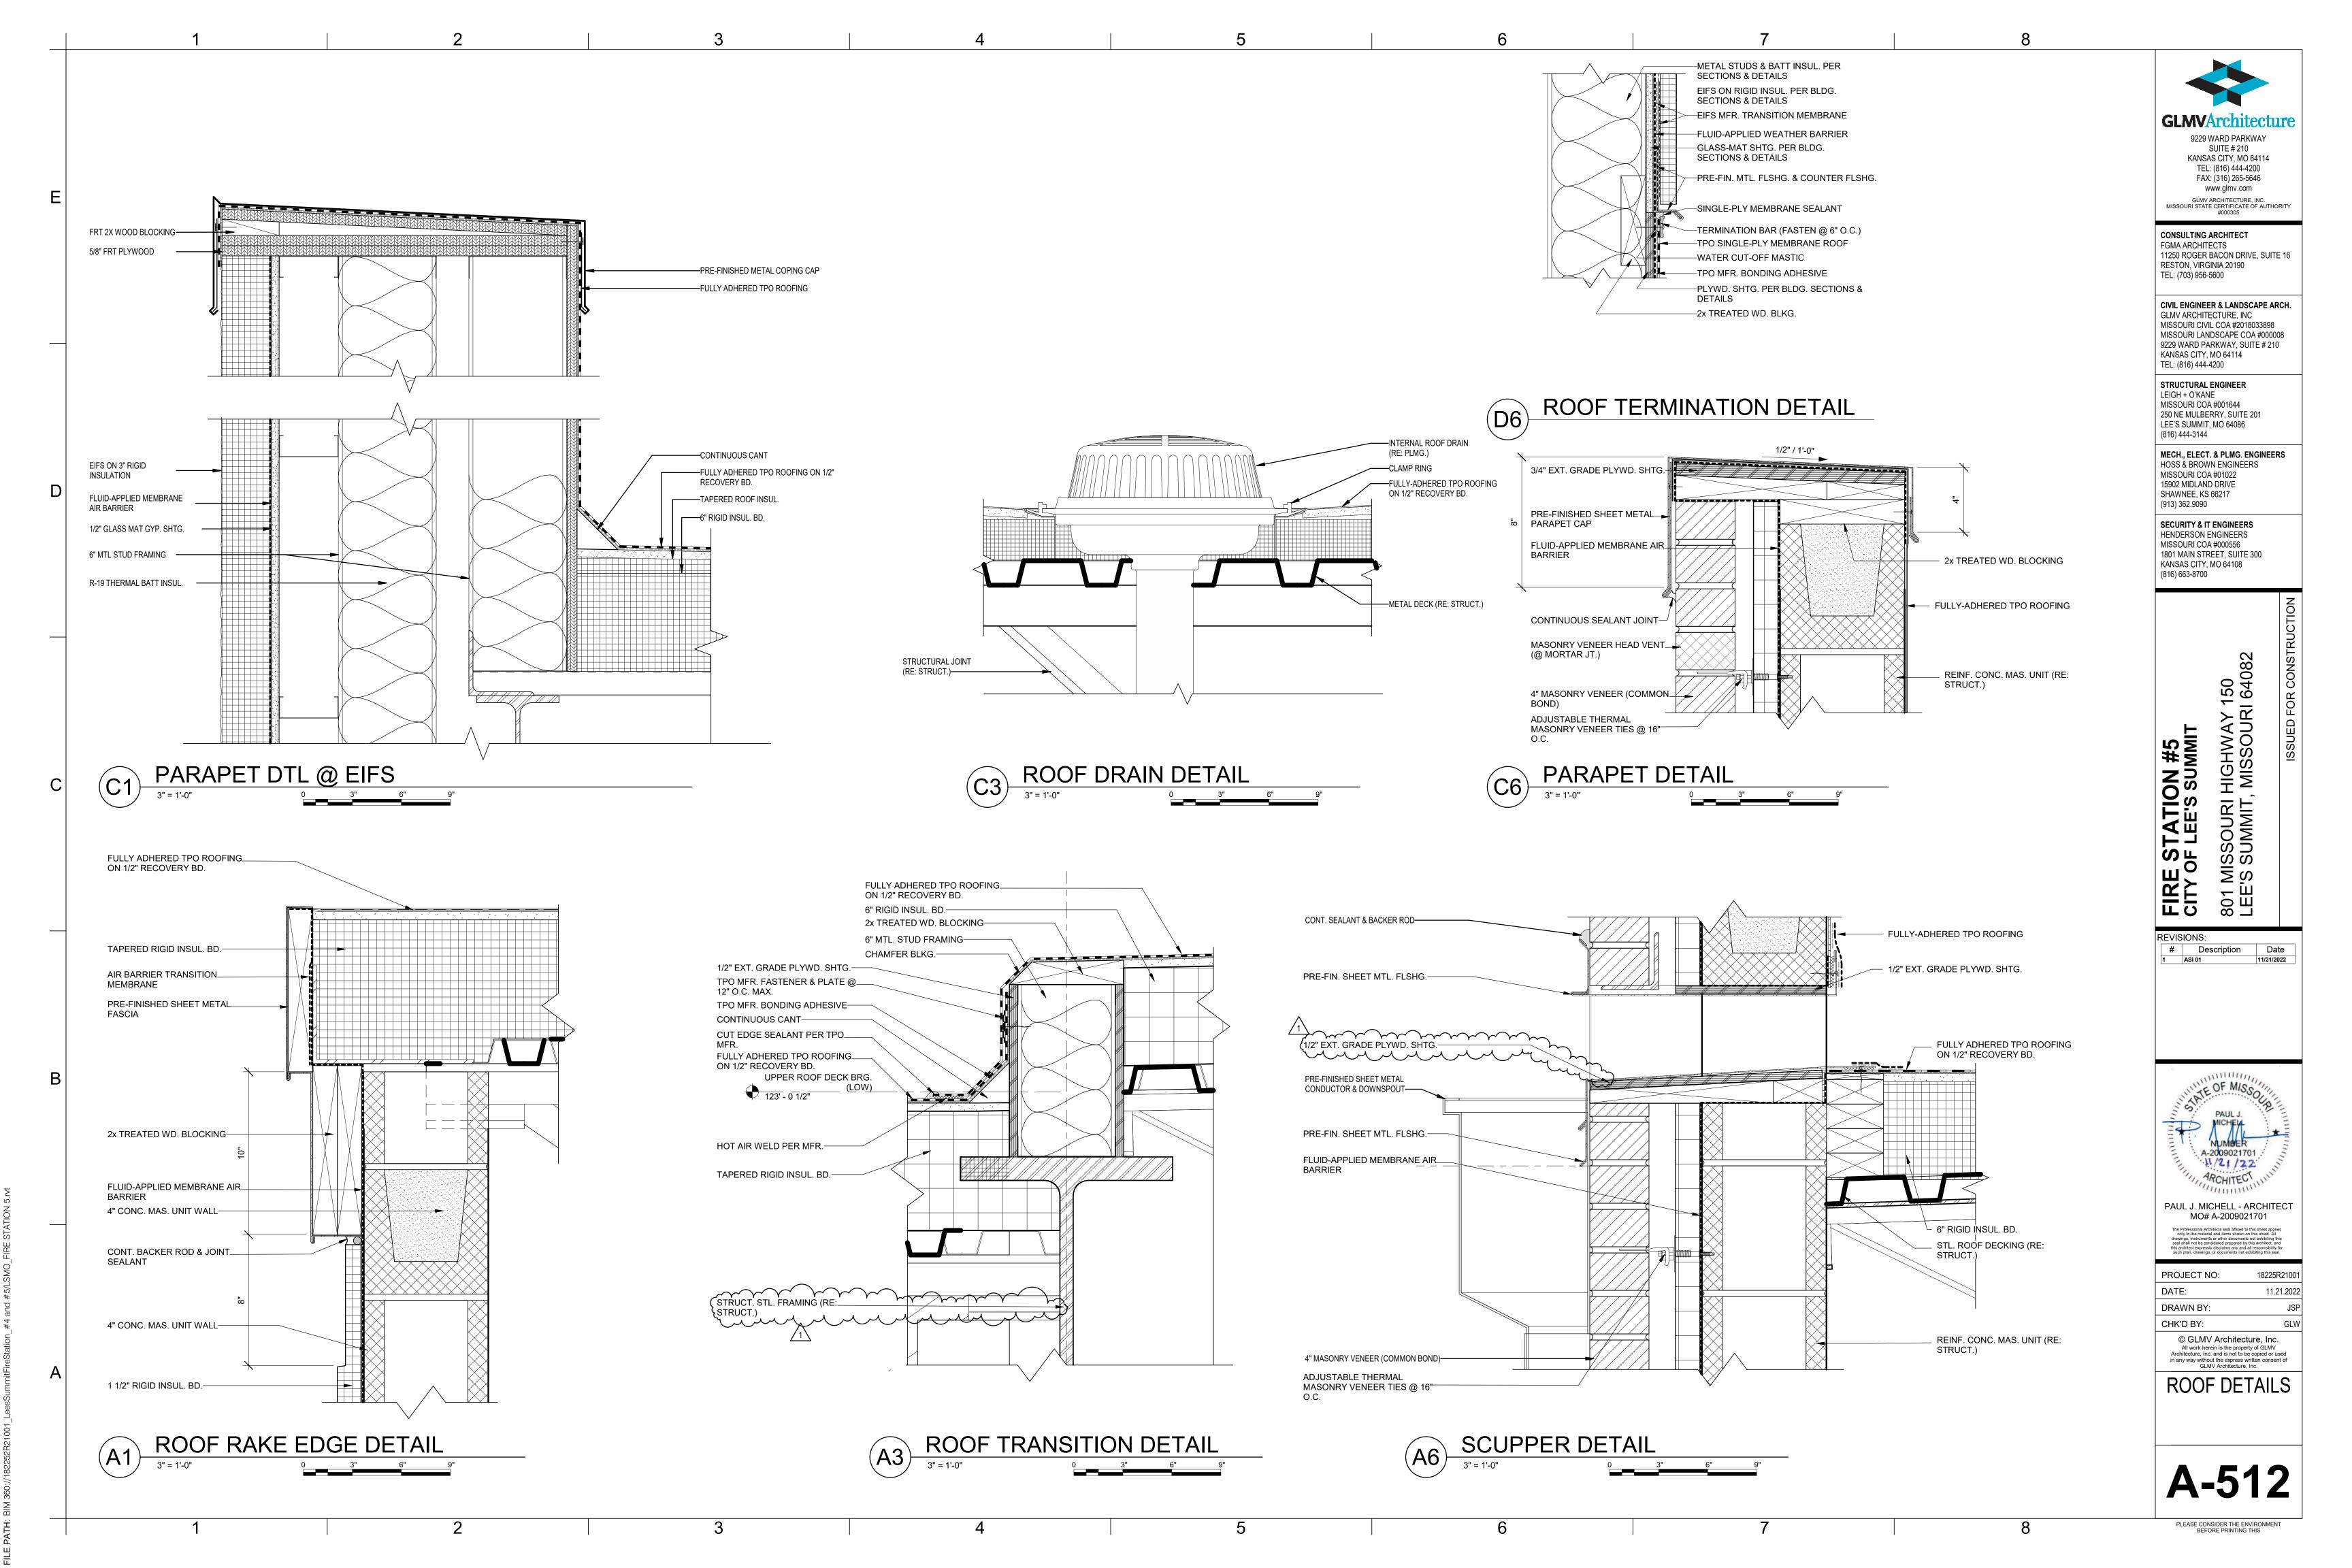

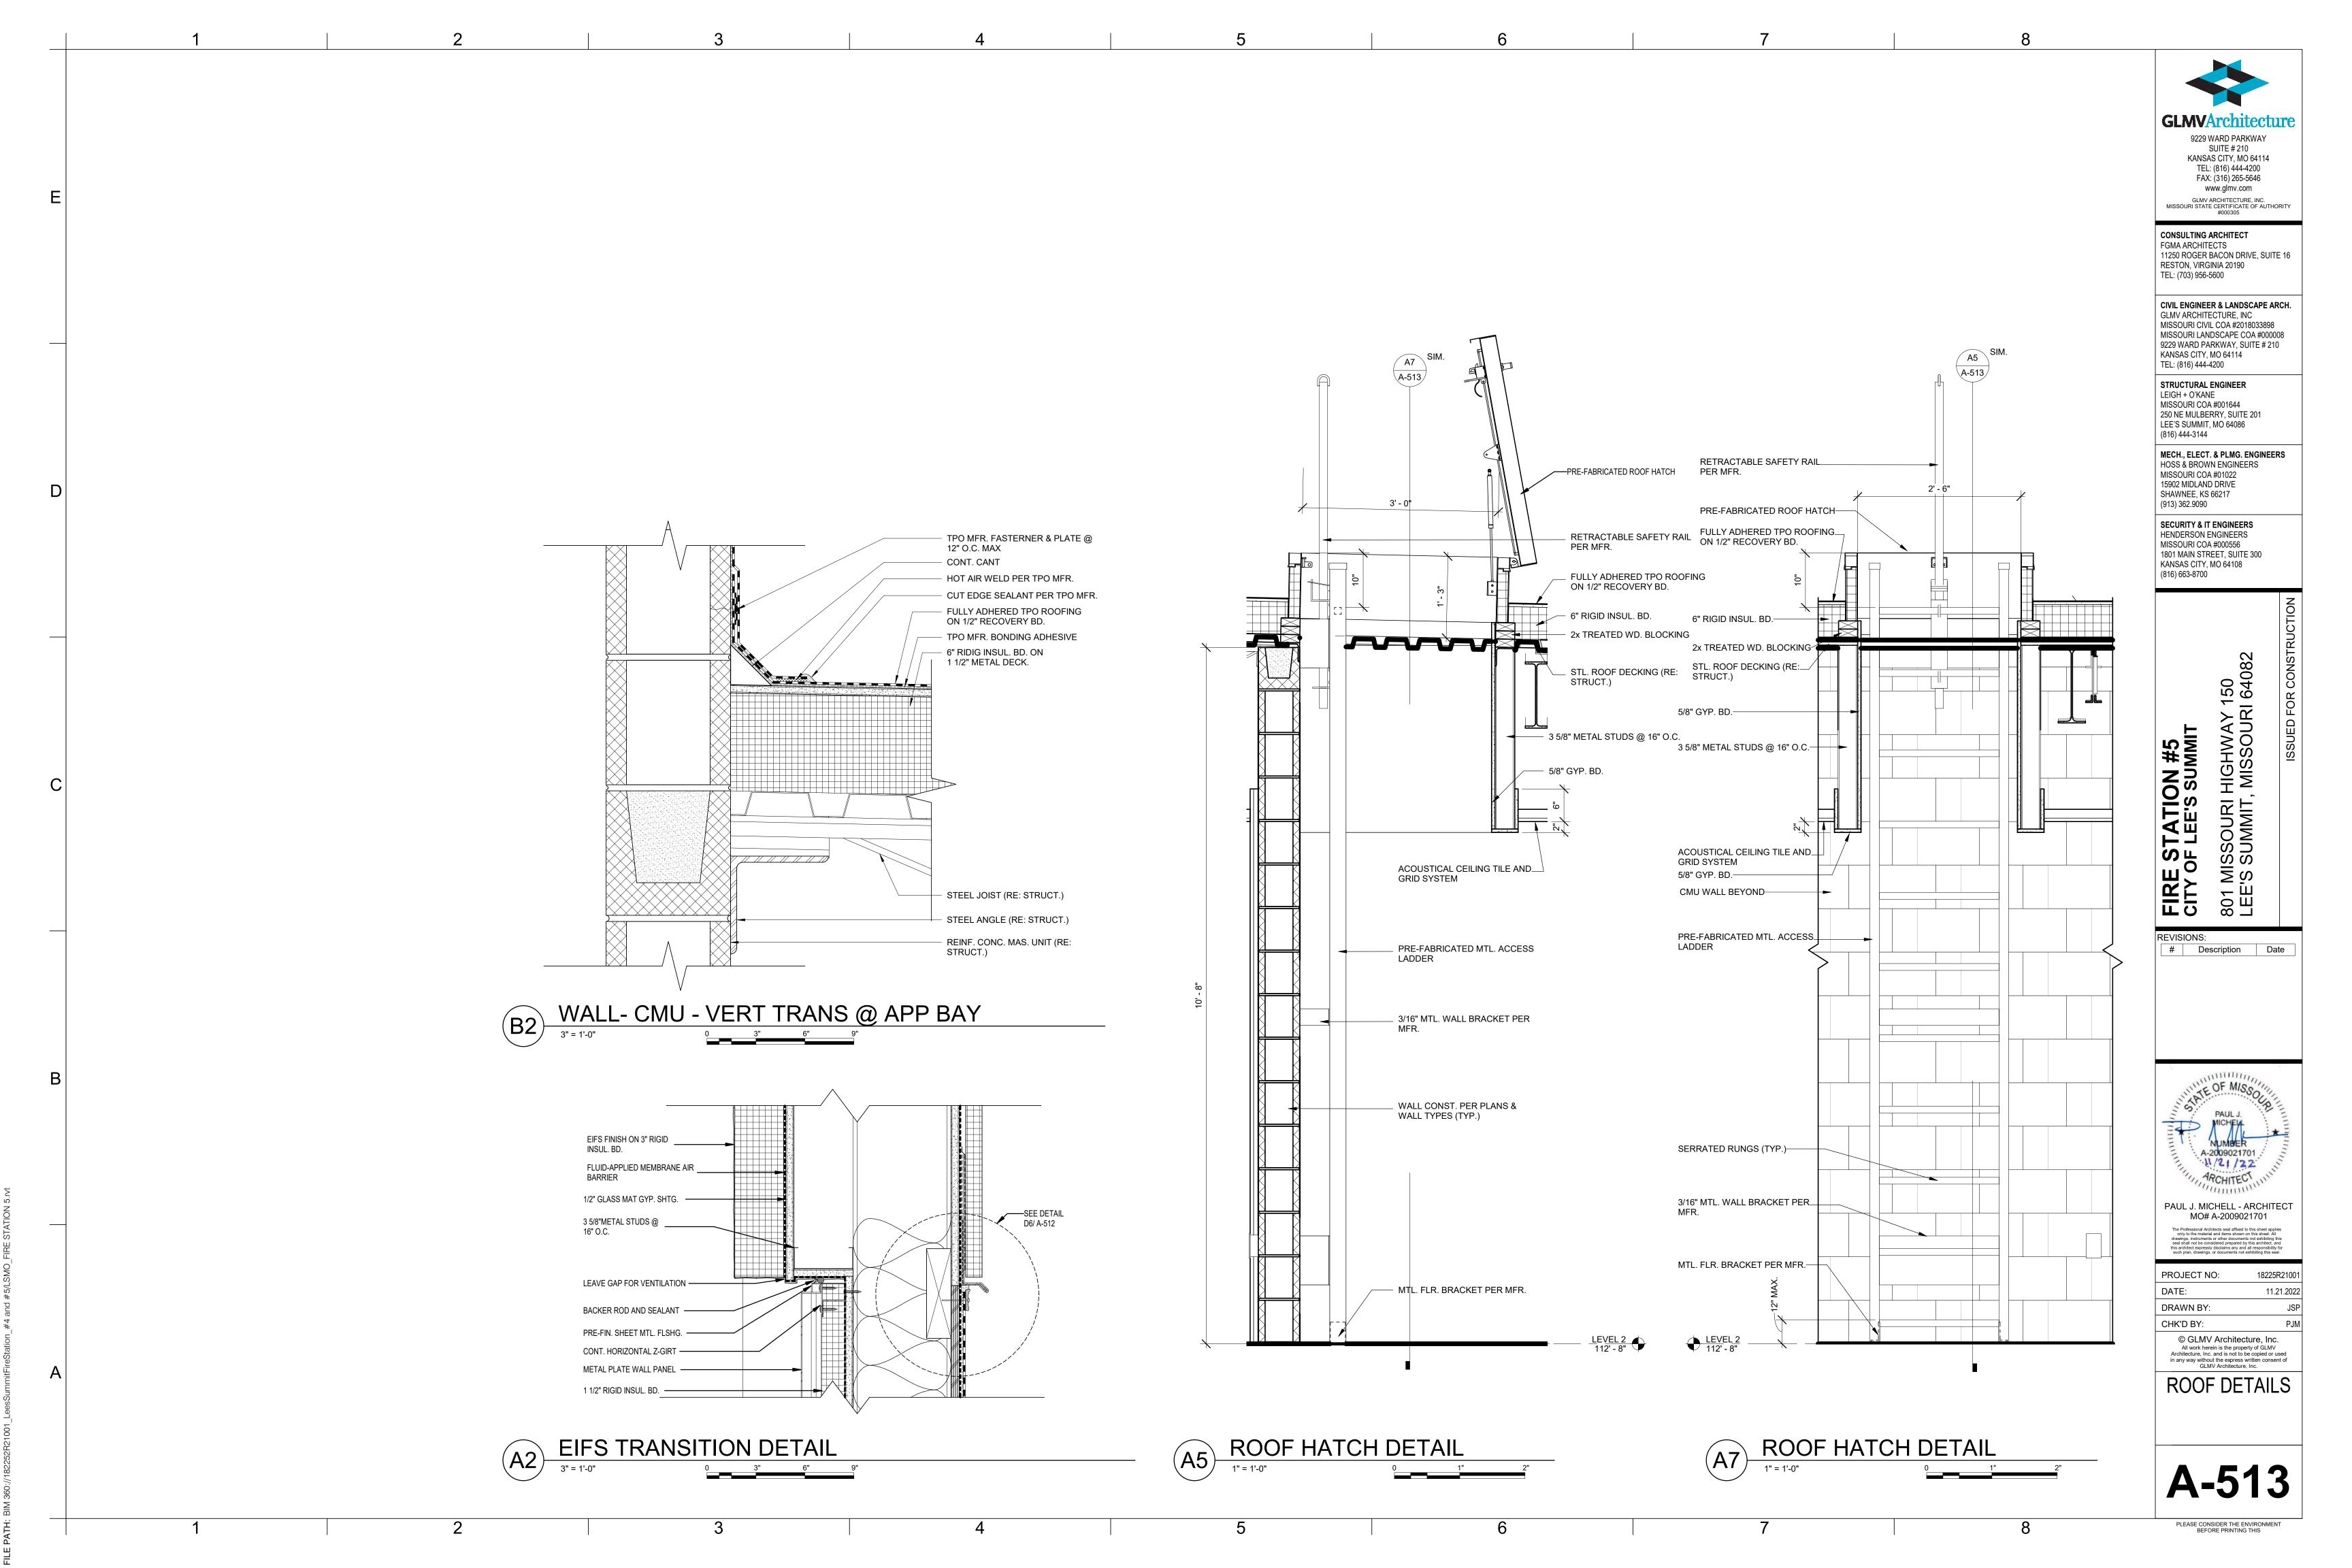

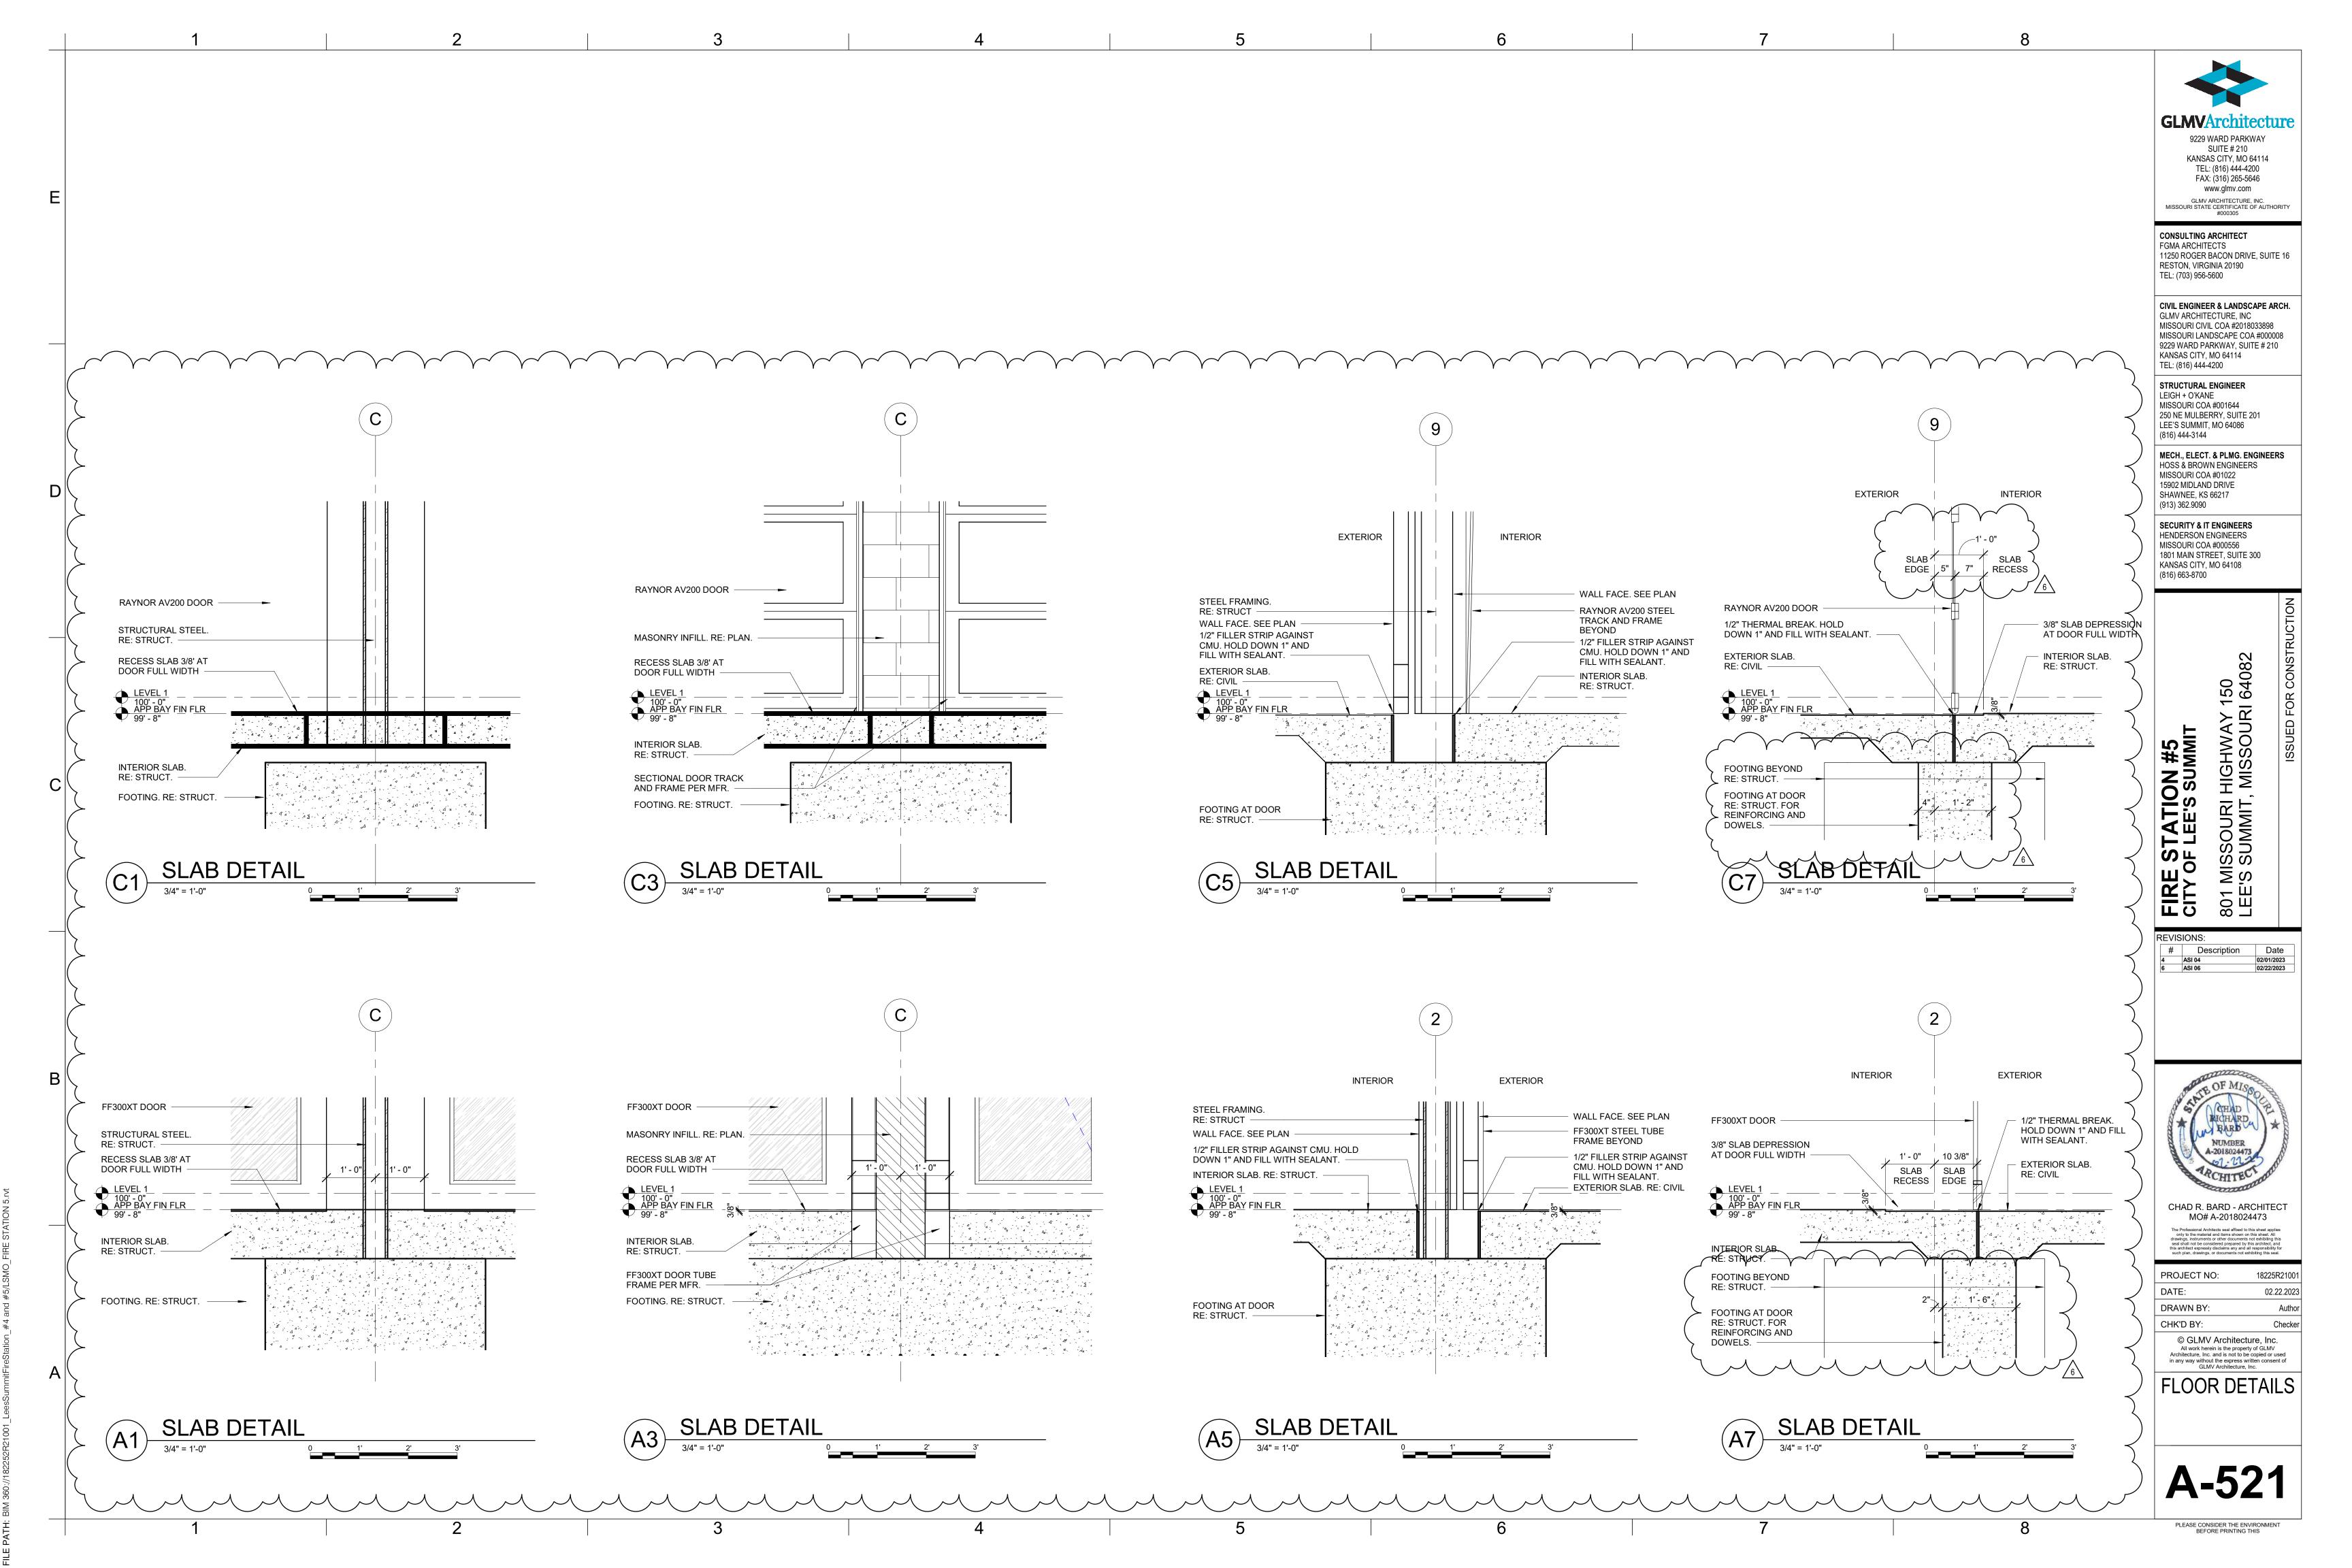

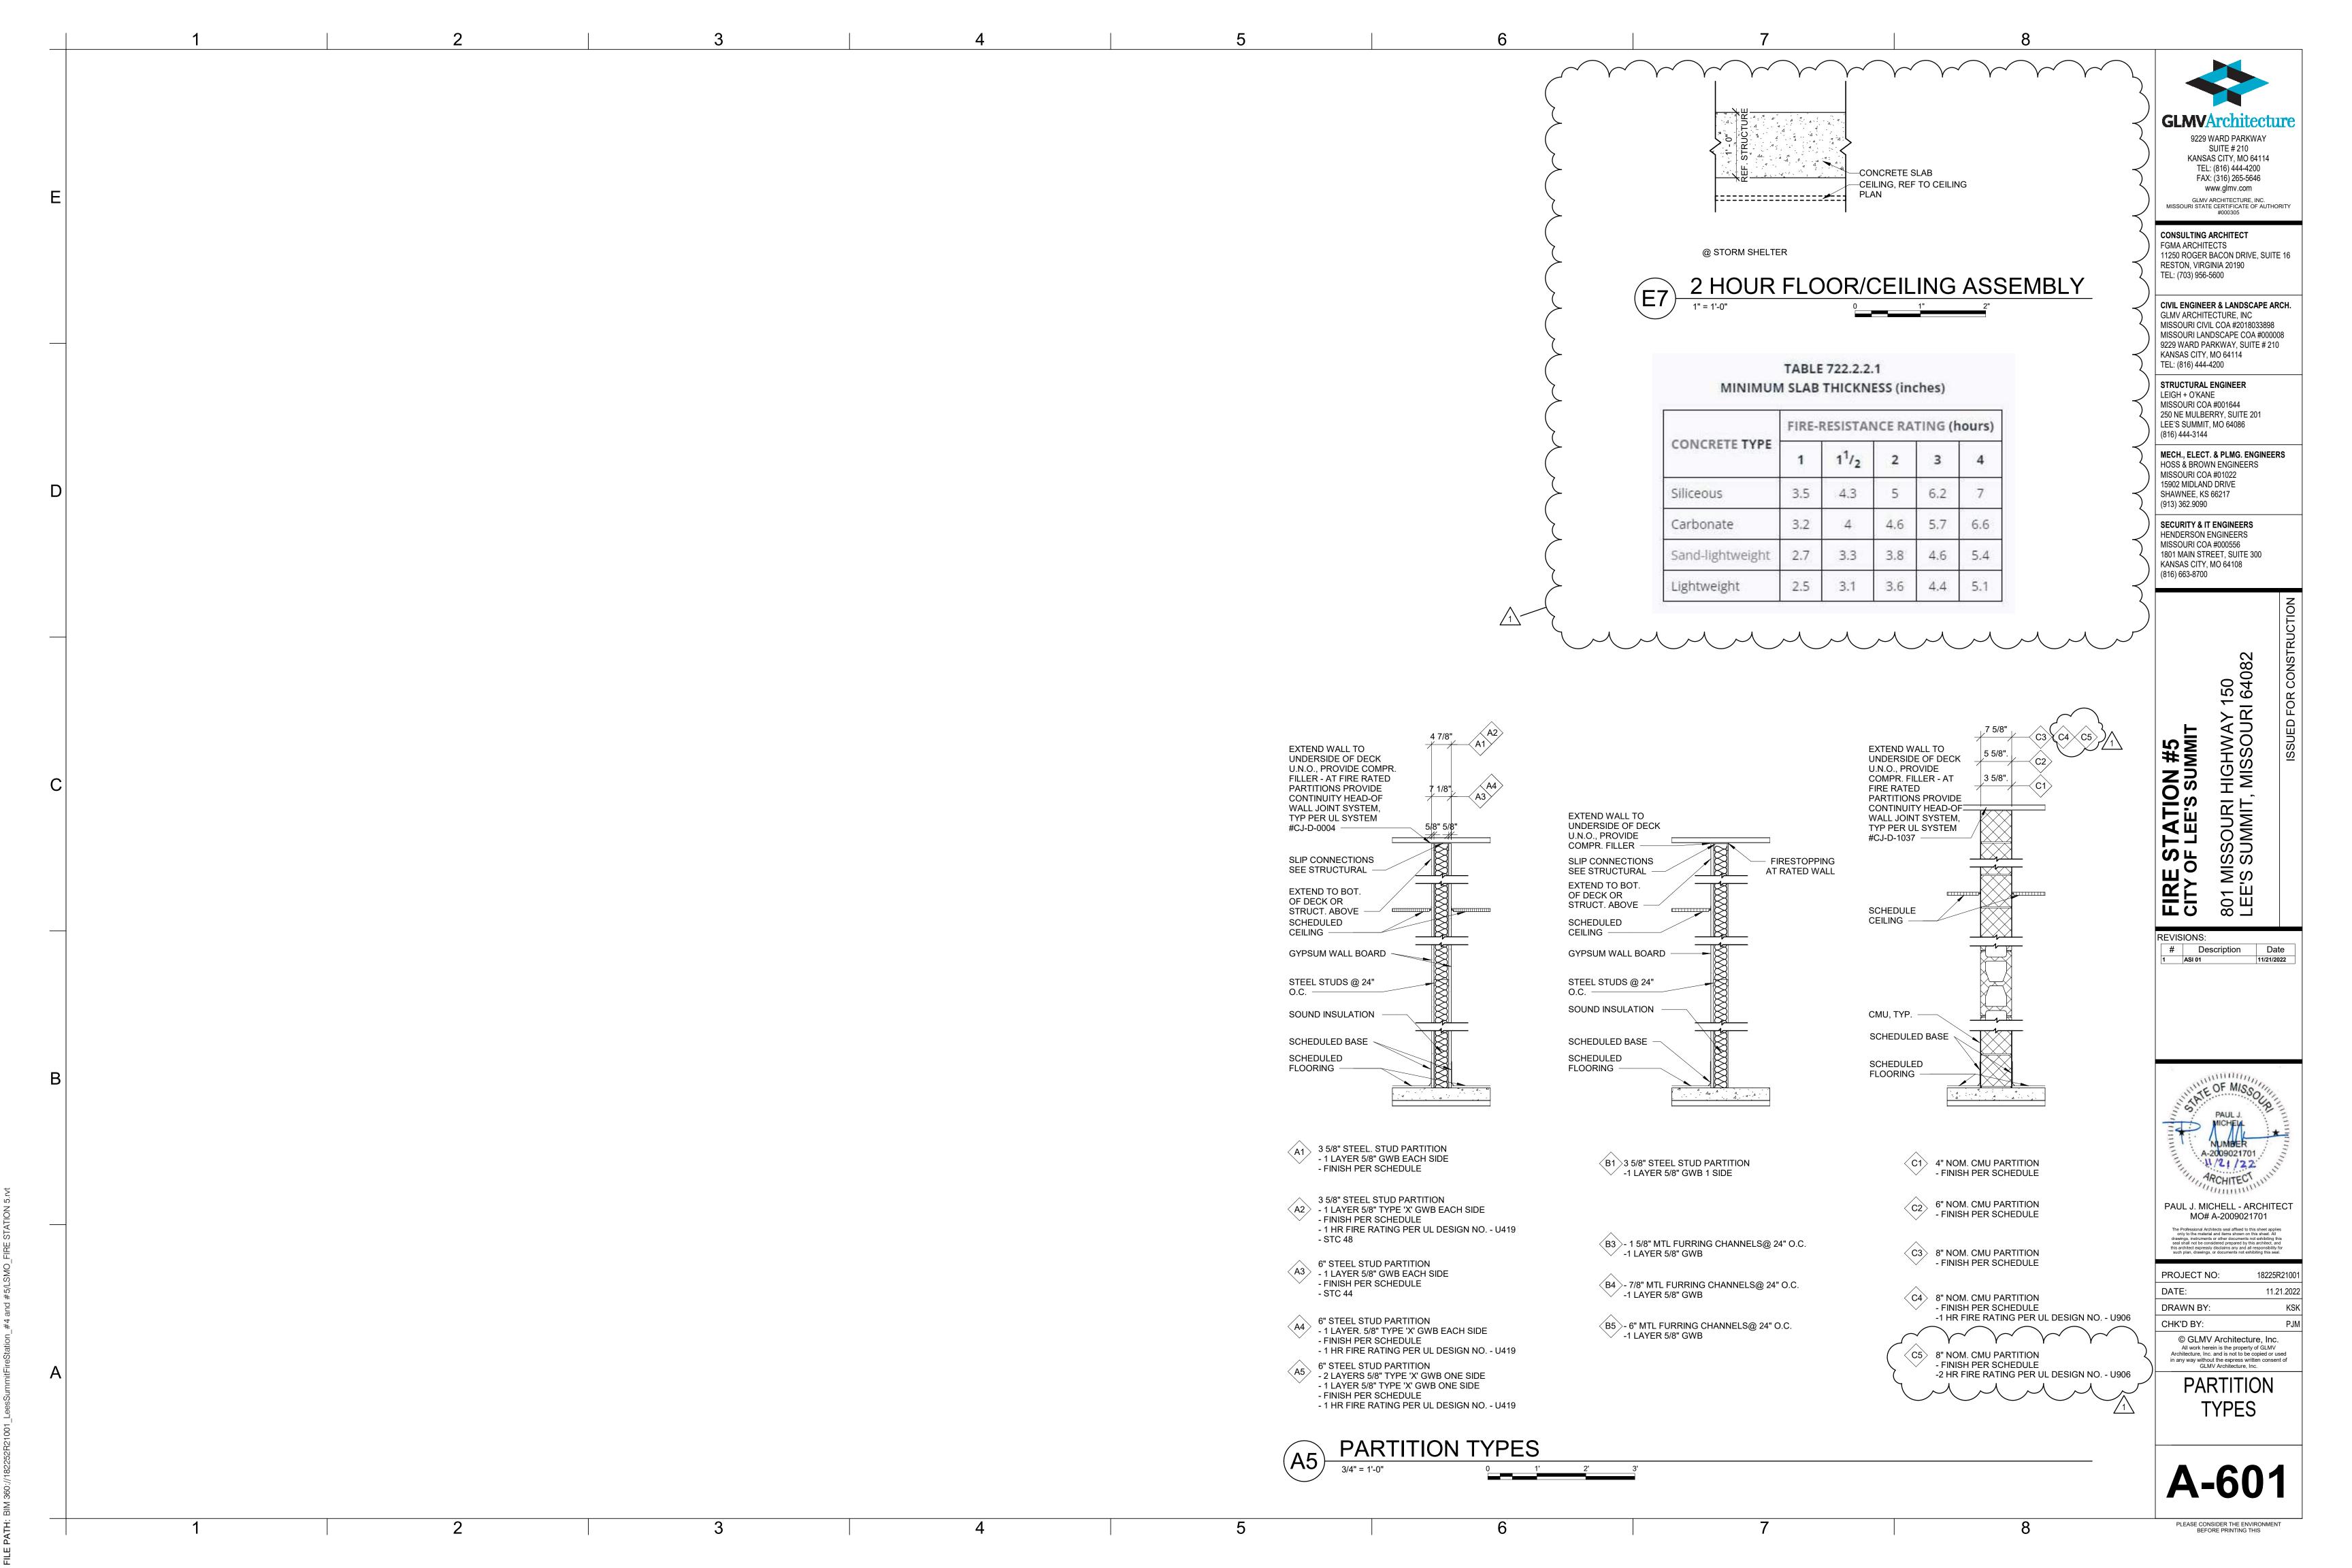

CGC INC - 1/2 in. thick Type C. IP-X2 or IPC-AR: 5/8 in. thick Type AR. C. IP-AR.

1. Floor and Ceiling Runners — (Not Shown) — For use with Item 2 — Channel shaped, fabricated from min 25 MSG corrosion-protected steel, min depth to ccommodate stud size, with min 1-1/4 in. long legs, attached to floor and ceiling FUSION BUILDING PRODUCTS — Viper25TM with fasteners 24 in, OC max.

Item 1 — For use with Item 2B, proprietary channel shaped runners, 3-5/8 in. deep attached to floor and ceiling with fasteners 24 in. OC may CALIFORNIA EXPANDED METAL PRODUCTS CO — Viper25 ™ Track

1A. Framing Members\* — Floor and Ceiling Runner — Not Shown — In lieu of

CRACO MFG INC — SmartTrack25 ™

MARINO/WARE, DIV OF WARE INDUSTRIES INC - Viper25 IM Track

FUSION BUILDING PRODUCTS — Viper25 M Track

IMPERIAL MANUFACTURING GROUP INC — Viper25 ™ Track

18. Framing Members\* — Floor and Ceiling Runner — Not Shown — In lieu of Item 1 — For use with Item 2C, proprietary channel shaped runners, 1-1/4 in. wide by 3-5/8 in. deep fabricated from min 0.018 in. thick galv steel, attached to floor and eiling with fasteners spaced 24 in. OC max. CALIFORNIA EXPANDED METAL PRODUCTS CO — Viper 20 1M Track MBA METAL FRAMING — ProTRAK

RAM SALES L L C — Ram ProTRAK

STEEL STRUCTURAL PRODUCTS L L C — Tri-S ProTRAK

1F. Framing Members\* — Floor and Ceiling Runner — Not Shown — In lieu of to accommodate stud size, with 1- 1/8 in. long legs fabricated from min 0.015 in. (min bare metal thickness) galv steel, attached to floor and ceiling with fasteners spaced 24 in. OC max. SUPER STUD BUILDING PRODUCTS — The Edge

1G. Framing Members\* — Floor and Ceiling Runner — For use with Item 2G, tached to floor and ceiling with fasteners 24 in. OC max. STUDCO BUILDING SYSTEMS — CROCSTUD Track

1H. Floor and Ceiling Runners — (Not Shown) — Channel shaped, fabricated from min 0.02 in, galv steel, min width to accommodate stud size, with min 1 in, long legs, for use with studs specified below and fabricated from min 0.018 in. galv steel or thicker, attached to floor and ceiling with fasteners spaced max 24 in. OC MARINO/WARE, DIV OF WARE INDUSTRIES INC — Viper20™ Track VT100

FUSION BUILDING PRODUCTS — Viper20™ Track VT100

IMPERIAL MANUFACTURING GROUP INC — Viper20™ Track VT100

11. Framing Members\* — Floor and Ceiling Runners — (Not Shown, As an alternate to Item 1) - For use with Items 2H, channel shaped, fabricated from min. 0.015 in. (min bare metal thickness) galvanized steel, attached to floor and ceiling with fasteners 24 in. OC. max. TELLING INDUSTRIES L L C — TRUE-TRACK™

1J. Framing Members\* — Floor and Ceiling Runner — Not Shown — In lieu of Item 1 — For use with Item 2I, proprietary channel shaped runners, 3-5/8 in. deep attached to floor and ceiling with fasteners 24 in. OC max.

MBA METAL FRAMING — ProTRAK

RAM SALES L L C — Ram ProTRAK

STEEL STRUCTURAL PRODUCTS L L C - Tri-S ProTRAK

1F. Framing Members\* — Floor and Ceiling Runner — Not Shown — In lieu of Item 1 — For use with Item 2F, proprietary channel shaped runners, minimum width to accommodate stud size, with 1- 1/8 in. long legs fabricated from min 0.015 in. (min bare metal thickness) galv steel, attached to floor and ceiling with fasteners spaced 24 in. OC max. SUPER STUD BUILDING PRODUCTS — The Edge

1G. Framing Members\* — Floor and Ceiling Runner — For use with Item 2G, proprietary channel shaped runners, minimum width to accommodate stud size attached to floor and ceiling with fasteners 24 in. OC max. STUDCO BUILDING SYSTEMS — CROCSTUD Track

1H. Floor and Ceiling Runners — (Not Shown) — Channel shaped, fabricated from min 0.02 in, galv steel, min width to accommodate stud size, with min 1 in, long legs, for use with studs specified below and fabricated from min 0.018 in. galv steel or thicker, attached to floor and ceiling with fasteners spaced max 24 in. OC MARINO/WARE, DIV OF WARE INDUSTRIES INC — Viper20™ Track VT100

FUSION BUILDING PRODUCTS — Viper20™ Track VT100

IMPERIAL MANUFACTURING GROUP INC — Viper20™ Track VT100

11. Framing Members\* — Floor and Ceiling Runners — (Not Shown, As an alternate to Item 1) - For use with Items 2H, channel shaped, fabricated from min 0.015 in. (min bare metal thickness) galvanized steel, attached to floor and ceiling TELLING INDUSTRIES L L C — TRUE-TRACK™

1J. Framing Members\* — Floor and Ceiling Runner — Not Shown — In lieu of Item 1 — For use with Item 2I, proprietary channel shaped runners, 3-5/8 in. deep attached to floor and ceiling with fasteners 24 in. OC max. edges, applied vertically. Vertical joints centered over studs and staggered min 1 stud cavity on opposite sides of studs. Wallboard secured to studs with 1-1/4 in, long Type S-12 (or No. 6 by 1-1/4 in. long bugle head fine driller) steel screws spaced 8 in. OC at perimeter and 12 in. OC in the field. NEW ENGLAND LEAD BURNING CO INC. DBA NELCO - Nelco

5F. Gypsum Board\* — (As an alternate to Item 5) — For use with Items 1E and 2E and limited to 1 Hour Rating only. Gypsum panels with beyeled, square or tapered edges, applied vertically, and fastened to the steel studs with 1 in. long Type S screws spaced 8 in. OC along vertical and bottom edges and 12 in. OC in the field. Vertical joints centered over studs and staggered one stud cavity on opposite sides UNITED STATES GYPSUM CO - 5/8 in. thick Type SCX, SGX

USG BORAL DRYWALL SFZ LLC - 5/8 in. thick Type SCX, SGX

5G. Gypsum Board\* — (As an alternate to Item 5) — For use with Items 1E and 2E only. Gypsum panels with beveled, square or tapered edges, applied vertically or norizontally, as specified in the table below and fastened to the steel studs as described in Item 6. Vertical joints centered over studs and staggered one stud cavity on opposite sides of studs. Vertical joints in adjacent layers (multilayer systems) staggered one stud cavity. Horizontal joints need not be backed by stee framing. Horizontal edge joints and horizontal butt joints on opposite sides of studs need not be staggered. Horizontal edge joints and horizontal butt joints in adjacen ayers (multilayer systems) staggered a min of 12 in. The thickness and number of layers for the 2 hr, 3 hr and 4 hr ratings are as follows:

Gypsum Board Protection on Each Side of Wall

Rating, Hr	Min Stud Depth, in. Item 2E	No. of Layers & Thickness of Panel	Min Thkns of Insulation (Item 4)
2	1-5/8	2 layers, 1/2 in. thick	Optional
2	1-5/8	2 layers, 5/8 in. thick	Optional
3	1-5/8	3 layers, 1/2 in. thick	Optional
3	1-5/8	3 layers, 5/8 in. thick	Optional
4	1-5/8	4 layers, 5/8 in. thick	Optional
4	1-5/8	4 layers, 1/2 in. thick	Optional

P-X1, IP-X2, IPC-AR, SCX, SHX, or: 3/4 in, thick Types IP-X3 or ULTRACODE 2B. Framing Members\* - Steel Studs — (As an alternate to Item 2, For use with

Items 5C, 5I or 5K) - Proprietary channel shaped studs, 3-5/8 in. deep spaced a max of 24 in, OC. Studs to be cut 3/4 in less than the assembly height and installed with a 1/2 in. gap between the end of the stud and track at the bottom of the wall. CALIFORNIA EXPANDED METAL PRODUCTS CO — Viper25™

CRACO MFG INC — SmartStud25™

MARINO/WARE, DIV OF WARE INDUSTRIES INC — Viper25™

MPERIAL MANUFACTURING GROUP INC — Viper25™

2C. Framing Members\* — Steel Studs — Not Shown — In lieu of Item 2 proprietary channel shaped steel studs, min depth as indicated under Item 5, spaced a max if 24 in. OC, fabricated from min 0.018 in. thick galv steel. Studs cut 3/8 in. to 3/4 in, less in lengths than assembly heights CALIFORNIA EXPANDED METAL PRODUCTS CO — Viper20™

MARINO/WARE, DIV OF WARE INDUSTRIES INC — Viper20™

FUSION BUILDING PRODUCTS — Viper20<sup>TM</sup>

MPERIAL MANUFACTURING GROUP INC — Viper20™

2D. Framing Members\* — Steel Studs — In lieu of Item 2 — Channel shaped studs, min depth as indicated under Item 5, spaced a max of 24 in. OC. Studs to be cut 3/4 in. less than assembly height. ALLSTEEL & GYPSUM PRODUCTS INC — Type SUPREME D24/30EQD and

CONSOLIDATED FABRICATORS CORP, BUILDING PRODUCTS DIV — Type SUPREME D24/30EQD and Type SUPREME D20

QUAIL RUN BUILDING MATERIALS INC — Type SUPREME D24/30EQD and

SCAFCO STEEL STUD MANUFACTURING CO — Type SUPREME D24/30EQD and Type SUPREME D20

STEEL CONSTRUCTION SYSTEMS INC — Type SUPREME D24/30EQD and Type SUPREME D20

UNITED METAL PRODUCTS INC — Type SUPREME D24/30EQD and Type

2E. Framing Members\* — Steel Studs — (Not Shown, As an alternate to Item 2) - For use with Items 5F or 5G or 5I or 5K only, channel shaped studs, min depth as indicated under Item 5F, 5G or 5I, fabricated from min. 0.015 in. (min bare metal thickness) galvanized steel, spaced a max of 24 in. OC. Studs to be cut 3/4 in. less

than assembly height.

CLARKDIETRICH BUILDING SYSTEMS — CD ProSTUD

DMFCWBS L L C - ProSTUD

MBA METAL FRAMING - ProSTUD

RAM SALES L L C - Ram ProSTUD

STEEL STRUCTURAL PRODUCTS L L C — Tri-S ProSTUD

2F. Framing Members\* - Steel Studs - Not Shown - In lieu of Item 2 proprietary channel shaped steel studs, minimum width indicated under Item 5, 1-1/4 deep fabricated from min 0.015 in. (min bare metal thickness) galvanized steel. Studs 3/8 in. to 3/4 in. less in lengths than assembly heights. SUPER STUD BUILDING PRODUCTS — The Edge

2G. Framing Members\* — Steel Studs — Not Shown — In lieu of Item 2 proprietary channel shaped studs, minimum width indicated under Item 5, Studs to be cut 3/8 to 3/4 in less than the assembly height STUDCO BUILDING SYSTEMS - CROCSTUD spaced a max of 24 in. OC. Studs to be cut 3/4 in. less than assembly height. TELLING INDUSTRIES L L C — TRUE-STUD™

21. Framing Members\* — Steel Studs — (As an alternate to Item 2, For use with Items 5C or 5L or 5K) — Proprietary channel shaped studs, 3-5/8 in. deep spaced a max of 24 in. OC. Studs to be cut 3/4 in less than the assembly height and installed with a 1/2 in. gap between the end of the stud and track at the bottom of the wall. For direct attachment of gypsum board only TELLING INDUSTRIES L L C — Viper25™

2J. Framing Members\* — Metal Studs — Not Shown — In lieu of Item 2 proprietary channel shaped steel studs, min depth as indicated under Item 5, spaced a max if 24 in. OC, fabricated from min 0.018 in. thick galv steel. Studs cut 3/8 in. to 3/4 in. less in lengths than assembly height TELLING INDUSTRIES L L C — Viper20™

2K. Framing Members\* — Steel Studs — As an alternate to Item 2 — For use with Item 1, channel shaped studs, fabricated from min 25 MSG corrosion-protect steel, min depth as indicated under Item 5, spaced a max of 24 in. OC. Studs to be cut 3/8 to 3/4 in. less than assembly height. EB METAL INC - NITROSTUD

2L. Framing Members\* — Steel Studs — As an alternate to Item 2 — For use with Item 1, channel shaped studs, fabricated from min 25 MSG corrosion-protected steel, min depth as indicated under Item 5, spaced a max of 24 in. OC. Studs to be cut 3/8 to 3/4 in. less than assembly height.

OLMAR SUPPLY INC — PRIMESTUD

2M. Framing Members\* — Steel Studs — As an alternate to Item 2 — For use with Item 1, channel shaped studs, fabricated from min 25 MSG corrosic steel, min depth as indicated under Item 5, spaced a max of 24 in. OC. Studs to be cut 3/8 to 3/4 in. less than assembly height. NO/WARE, DIV OF WARE INDUSTRIES INC — StudRite TM

2N. Framing Members\*— Steel Studs — As an alternate to Item 2 — proprietary channel shaped steel studs, min depth 3-1/2 in. and as indicated under Item 5, spaced a max of 24 in. OC, fabricated from min 0.018 in. thick galv steel. Studs cut STEEL INVESTMENT GROUP L L C - AlphaSTUD

20. Framing Members\* - Steel Studs - As an alternate to Item 2 - proprietary channel shaped steel studs, min width as indicated under Item 5, galv steel. Studs to be cut 3/8 to 3/4 in. less in lengths than assembly height. Spaced 24 in. OC max. RONDO BUILDING SERVICES PTY LTD — Rondo Lipped Wall Stud

2P. Framing Members\* — Steel Studs — As an alternate to Item 2 — proprietary channel shaped steel studs, min width as indicated under Item 5, min 25 MSG galv steel. Studs to be cut 3/8 to 3/4 in. less in lengths than assembly height. Spaced 24 OEG BUILDING MATERIALS — OEG Stud

2Q. Framing Members\* — Steel Studs — Not Shown — In lieu of Item 2 — For use with Item 10, proprietary channel shaped steel studs, min depth as indicated under Item 5, spaced a max of 24 in. OC, fabricated from min 25 MSG (0.018 in. min. bare metal thickness). Studs cut 3/8 in. to 3/4 in. less in lengths than assembly CALIFORNIA EXPANDED METAL PRODUCTS CO - Viner X

3. Wood Structural Panel Sheathing — (Optional, For use with Item 5 Only) — (Not Shown) — 4 ft wide, 7/16 in. thick oriented strand board (OSB) or 15/32 in. thick structural 1 sheathing (plywood) complying with DOC PS1 or PS2, or APA Standard PRP-108, manufactured with exterior glue, applied horizontally or vertically to the steel studs. Vertical joints centered on studs, and staggered one stud space from wallboard joints. Attached to studs with flat-head self-drilling tapping screws with a min. head diam. of 0.292 in. at maximum 6 in. OC. in the perimeter and 12 in. OC. in the field. When used, gypsum panels attached over OSB or plywood panels and fastener lengths for gypsum panels increased by min. 1/2 in.

4. Batts and Blankets\* — (Required as indicated under Item 5) — Mineral wool batts, friction fitted between studs and runners. Min nom thickness as indicated

under Item 5.

See Batts and Blankets (BKNV or BZJZ) Categories for names of

4A. Batts and Blankets\* — (Optional) — Placed in stud cavities, any glass fiber or mineral wool insulation bearing the UL Classification Marking as to Surface Burning Characteristics and/or Fire Resistance.

See Batts and Blankets (BKNV or BZJZ) Categories for names of

4B. Batts and Blankets\* — For use with Item 5K. Placed in stud cavities, any min. 3-1/2 in. thick glass fiber insulation bearing the UL Classification Marking as to Surface Burning Characteristics and/or Fire Resistance.

4C. Fiber, Sprayed\* — (Optional) and as an alternate to Batts and Blankets (Item 4B) where insulation is required - Spray applied granulated mineral fiber material. The fiber is applied with adhesive at a minimum density of 4.0 pcf to completely fill the wall cavity in accordance with the application instructions supplied with the product. See Fiber, Sprayed (CCAZ)

AMERICAN ROCKWOOL MANUFACTURING, LLC — Type Rockwool Premium

See Batts and Blankets (BKNV or BZJZ) Categories for names of

5. Gypsum Board\* — Gypsum panels with beveled, square or tapered edges. applied vertically or horizontally. Vertical joints centered over studs and staggered one stud cavity on opposite sides of studs. Vertical joints in adjacent layers (multilayer systems) staggered one stud cavity. Horizontal joints need not be backed by steel framing. Horizontal edge joints and horizontal butt joints on opposite sides of studs need not be staggered. Horizontal edge joints and horizontal butt joints in adjacent layers (multilayer systems) staggered a min of 12 in. The thickness and

number of layers for the 1 hr, 2 hr, 3 hr and 4 hr ratings are as follows:

Gypsum Board Protection on Each Side of Wall

Rating, Hr	Min Stud Depth, in. Items 2, 2C, 2D, 2F, 2G, 2O	No. of Layers & Thkns of Panel	Min Thkns of Insulation (Item 4)
1	3-1/2	1 layer, 5/8 in. thick	Optional
1	2-1/2	1 layer, 1/2 in. thick	1-1/2 in.
1	1-5/8	1 layer, 3/4 in. thick	Optional
2	1-5/8	2 layers, 1/2 in. thick	Optional
2	1-5/8	2 layers, 5/8 in. thick	Optional
2	3-1/2	1 layer, 3/4 in. thick	3 in.
3	1-5/8	3 layers, 1/2 in. thick	Optiona
3	1-5/8	2 layers, 3/4 in. thick	Optional
3	1-5/8	3 layers, 5/8 in. thick	Optional
4	1-5/8	4 layers, 5/8 in. thick	Optional
4	1-5/8	4 layers, 1/2 in. thick	Optional
4	2-1/2	2 layers, 3/4 in. thick	2 in.

CGC INC - 1/2 in. thick Type C, IP-X2 or IPC-AR; WRC, 5/8 in. thick Type AR, C, IP-AR, IP-X1, IP-X2, IPC-AR, SCX, SHX, WRX or WRC; 3/4 in. thick Types IP-X3 or

UNITED STATES GYPSUM CO - 1/2 in. thick Type C, IP-X2, IPC-AR or WRC; 5/8 in. thick Type SCX, SGX, SHX, WRX, IP-X1, AR, C, WRC, FRX-G, IP-AR, IP-X2, IPC-AR; 3/4 in. thick Types IP-X3 or ULTRACODE

USG BORAL DRYWALL SFZ LLC — 1/2 in. Type C; 5/8 in. Types C, SCX, SGX,

USG MEXICO S A DE C V — 1/2 in. thick Type C, IP-X2, IPC-AR or WRC; 5/8 in. thick Type AR, C, IP-AR, IP-X1, IP-X2, IPC-AR, SCX, SHX, WRX, WRC or; 3/4 in. thick Types IP-X3 or ULTRACODE

When Item 7B, Steel Framing Members\*, is used, Nonbearing Wall Rating is limited to 1 Hr. Min. stud depth is 3-1/2 in., min. thickness of insulation (Item 4) is 3 in., and two layers of gypsum board panels (1/2 in. or 5/8 in. thick) shall be attached to furring channels as described in Item 6. One layer of gypsum board panels (1/2 in. or 5/8 in. thick) attached to opposite side of stud without furring channels as

5A. Gypsum Board\* — (As an alternate to Item 5) — 5/8 in. thick, 24 to 54 in. wide, applied horizontally as the outer layer to one side of the assembly. Secured as described in Item 6.

UNITED STATES GYPSUM CO — Type FRX-G, SHX.

USG MEXICO S A DE C V — Type SHX.

5B. Gypsum Board\* — (Not Shown) — As an alternate to Item 5 when used as the base layer on one or both sides of wall when 5/8 in or 3/4 in, thick products are specified. For direct attachment only to steel studs Item 2A, (not to be used with Item 3) — Nom 5/8 in. or 3/4 in. may be used as alternate to all 5/8 in. or 3/4 in. shown in Item 5, Wallboard Protection on Each Side of Wall table. Nom 5/8 in. or 3/4 in. thick lead backed gypsum panels with beveled, square or tapered edges, applied vertically. Vertical joints centered over study and staggered min 1 stud cavity on opposite sides of studs. Gypsum board secured to 20 MSG steel studs Item 2A with 1-1/4 in. long Type S-12 steel screws spaced 8 in. OC at perimeter and 12 in. OC in the field. To be used with Lead Batten Strips (see Item 11) or Lead Discs or Tabs RAY-BAR ENGINEERING CORP — Type RB-LBG

5C. Gypsum Board\* — (For Use With Item 2B) — Rating Limited to 1 Hour. 5/8 in. thick, 48 in. wide, Gypsum panels with beveled, square or tapered edges, applied vertically or horizontally. (Vertical Application) - The gypsum board is to be installed on each side of the studs with 1 in, long Type S coated steel screws spaced 8 in, OC starting 4 in. from the edge of the board at the vertical edges and 12 in. OC starting 6 in. from the edge of the board at the center of each board. Gypsum boards are to be secured to the top and bottom track with screws spaced 8 in. OC starting 4 in. from the board edge. Fasteners shall not penetrate through both the stud and the track at the same time. Vertical joints are to be centered over studs and staggered one stud cavity on opposite sides of studs. (Horizontal Application) - The gypsum board is to be installed on each side of the studs with 1 in. long Type S coated steel screws spaced 8 in, OC starting 4 in, from the edge of the board at the vertical edges and 12 in. OC starting 6 in. from the edge of the board at the center of each board. Gypsum boards are to be secured to the top and bottom track with screws spaced 8 in. OC starting 4 in, from the board edge. Fasteners shall not penetrate through both the stud and the track at the same time. All horizontal joints are to be backed as outlined under section VI of Volume 1 in the Fire Resistive Directory.

UNITED STATES GYPSUM CO — Type SCX, SGX.

USG BORAL DRYWALL SFZ LLC — Type SCX

CGC INC - Type SCX.

USG MEXICO S A DE C V — Type SCX

5D. Gypsum Board\* — (As an alternate to Item 5) — 5/8 in. thick, 48 in. wide, applied vertically or horizontally. Secured as described in Item 6. For use with Items CGC INC - Type USGX

UNITED STATES GYPSUM CO - Type USGX USG BORAL DRYWALL SFZ LLC - Type USGX

USG MEXICO S A DE C V — Type USGX

5E. Gypsum Board\* — (Not Shown) — (As an alternate to Item 5 when used as the base layer on one or both sides of wall when 1/2 in. or 5/8 in thick products are specified. For direct attachment only to steel studs Item 2A, not to be used with Item

3). Nominal 5/8 in. thick lead backed gypsum panels with beveled, square or tapered

edges, applied vertically. Vertical joints centered over studs and staggered min 1 stud cavity on opposite sides of studs. Wallboard secured to studs with 1-1/4 in. long pe S-12 (or No. 6 by 1-1/4 in. long bugle head fine driller) steel screws spaced 8 n. OC at perimeter and 12 in. OC in the field.

5F. Gypsum Board\* — (As an alternate to Item 5) — For use with Items 1E and 2E and limited to 1 Hour Rating only, Gypsum panels with beveled, square or tapere edges, applied vertically, and fastened to the steel studs with 1 in. long Type S screws spaced 8 in. OC along vertical and bottom edges and 12 in. OC in the field. Vertical joints centered over studs and staggered one stud cavity on opposite sides of studs. Steel stud depth shall be a minimum 3-5/8 in. UNITED STATES GYPSUM CO — 5/8 in. thick Type SCX, SGX

NEW ENGLAND LEAD BURNING CO INC, DBA NELCO — Nelco

USG BORAL DRYWALL SFZ LLC - 5/8 in. thick Type SCX, SGX

5G. Gypsum Board\* — (As an alternate to Item 5) — For use with Items 1E and 2E only. Gypsum panels with beveled, square or tapered edges, applied vertically or orizontally, as specified in the table below and fastened to the steel studs as described in Item 6. Vertical joints centered over studs and staggered one stud cavity on opposite sides of studs. Vertical joints in adjacent layers (multilayer vstems) staggered one stud cavity. Horizontal joints need not be backed by stee framing. Horizontal edge joints and horizontal butt joints on opposite sides of studs need not be staggered. Horizontal edge joints and horizontal butt joints in adjacent ayers (multilayer systems) staggered a min of 12 in. The thickness and number of layers for the 2 hr, 3 hr and 4 hr ratings are as follows:

Gypsum Board Protection on Each Side of Wall

Rating, Hr	Min Stud Depth, in. Item 2E	No. of Layers & Thickness of Panel	Min Thkns of Insulation (Item 4)
2	1-5/8	2 layers, 1/2 in. thick	Optional
2	1-5/8	2 layers, 5/8 in. thick	Optional
3	1-5/8	3 layers, 1/2 in. thick	Optional
3	1-5/8	3 layers, 5/8 in. thick	Optional
4	1-5/8	4 layers, 5/8 in. thick	Optional
4	1-5/8	4 layers, 1/2 in. thick	Optional

CGC INC - 1/2 in thick Type C IP-X2 or IPC-AR: 5/8 in thick Type AR C IP-AR IP-X1, IP-X2, IPC-AR, SCX, SHX, or; 3/4 in. thick Types IP-X3 or ULTRACODE hick Type SCX, SGX, SHX, IP-X1, AR, C., FRX-G, IP-AR, IP-X2, IPC-AR, ULIX

USG BORAL DRYWALL SFZ LLC — 1/2 in. Type C; 5/8 in. Types C, SCX, SGX,

3/4 in. thick Types IP-X3 or ULTRACODE

USG MEXICO S A DE C V - 1/2 in. thick Type C, IP-X2, IPC-AR or; 5/8 in. thick Type AR, C, IP-AR, IP-X1, IP-X2, IPC-AR, SCX, SHX, or; 3/4 in. thick Types IP-X3

5H. Gypsum Board\* — (Not Shown) — (As an alternate to Item 5 when used as the base layer on one or both sides of wall when 5/8 or 3/4 in thick products are specified. For direct attachment only to steel studs Item 2A, (not to be used with Item ) - Nom 5/8 or 3/4 in. may be used as alternate to all 5/8 or 3/4 in. shown in Item 5, Wallboard Protection on Each Side of Wall table. Nom 5/8 or 3/4 in. thick lead backed gypsum panels with beveled, square or tapered edges, applied vertically. Vertical joints centered over 20 MSG steel studs and staggered min 1 stud cavity on opposite sides of studs. Wallboard secured to studs with 1-1/4 in. long Type S-12 secured to 20 MSG steel studs Item 2B with 1-1/4 in. long Type S-12 steel screws spaced 8 in. OC at perimeter and 12 in. OC in the field. For Joint Compound see em 5. To be used with Lead Batten Strips (see Item 11A) or Lead Discs (see Item

51. Gypsum Board\* — (As an alternate to Item 5) — Nom. 5/8 in. thick gypsum panels with beveled, square or tapered edges installed as described in Item 5. Steel

stud minimum depth shall be as indicated in Item 5.

MAYCO INDUSTRIES INC — Type X-Ray Shielded Gypsum

UNITED STATES GYPSUM CO - Type ULX

USG MEXICO S A DE C V — Type ULX

5.1 Gypsum Board\* — (Not Shown) — (As an alternate to Item 5 when used as the base layer on one or both sides of wall when 1/2 in. or 5/8 in thick products are ecified, For direct attachment only to steel studs Item 2A, not to be used with Item Nom 5/8 in, thick lead backed gypsum panels with beveled, square or tapered edges, applied vertically. Vertical joints centered over studs and staggered min 1 stud cavity on opposite sides of studs. Wallboard secured to studs with 1-1/4 in. long Type S-12 steel screws gypsum panel steel screws spaced 8 in. OC at perimeter and 12 in, OC in the field. Lead batten strips required behind vertical joints of lead backed gypsum wallboard and optional at remaining stud locations. Lead batten strips, min 2 in. wide, max 8 ft long with a max thickness of 0.14 in. placed on the ace of studs and attached to the stud with construction adhesive and two 1 in. long ype S-12 pan head steel screws, one at the top of the strip and one at the bottom of the strip. Lead discs. nominal 3/8 in. diam by max 0.085 in. thick. Compression fitted or adhered over the screw heads. Lead batten strips and discs to have a purity of 99.9% meeting the Federal specification QQ-L-201f, Grade "C" RADIATION PROTECTION PRODUCTS INC — Type RPP - Lead Lined Drywall

5K. Gypsum Board\* — (Not Shown) — (As an alternate to Item 5) — Nom. 5/8 in. thick gypsum panels with beveled, square or tapered edges, applied vertically or horizontally. Vertical joints centered over studs and staggered one stud cavity on opposite sides of studs. Vertical joints in adjacent layers (multilayer systems) taggered one stud cavity. Horizontal joints need not be backed by steel framing. Horizontal edge joints and horizontal butt joints on opposite sides of studs need not e staggered. Horizontal edge joints and horizontal butt joints in adjacent layers (multilayer systems) need not be staggered. The number of layers for the 1 hr, 2 hr, 3 hr and 4 hr ratings are as follows:

Gypsum Board Protection on Each Side of Wall

Rating, Hr	Min Stud Depth, in. Items 2 through 20	No. of Layers & Thkns of Panel	Min Thkns of Insulation (Item 4B)
1	3-5/8	1 layer, 5/8 in. thick	3-1/2 in.
2	1-5/8	2 layers, 5/8 in. thick	Optional
3	1-5/8	3 layers, 5/8 in. thick	Optional
4	1-5/8	4 layers, 5/8 in. thick	Optional

UNITED STATES GYPSUM CO — 5/8 in. thick Type ULIX

6. Fasteners — (Not Shown) — For use with Items 2 and 2F - Type S or S-12 steel screws used to attach panels to studs (Item 2) or furring channels (Item 7). Single layer systems: 1 in. long for 1/2 and 5/8 in. thick panels or 1-1/4 in. long for 3/4 in. thick panels, spaced 8 in. OC when panels are applied horizontally, or 8 in. OC along vertical and bottom edges and 12 in. OC in the field when panels are applied vertically. Two layer systems: First layer- 1 in. long for 1/2 and 5/8 in. thick panels or 1-1/4 in. long for 3/4 in. thick panels, spaced 16 in. OC. Second layer- 1-5/8 in. long for 1/2 in., 5/8 in. thick panels or 2-1/4 in. long for 3/4 in. thick panels, spaced 6 in. OC with screws offset 8 in. from first layer. Three-layer systems: First layer- 1 in. long for 1/2 in., 5/8 in. thick panels, spaced 24 in. OC. Second layer- 1-5/8 in. long for 1/2 in., 5/8 in. thick panels, spaced 24 in. OC. Third layer- 2-1/4 in. long for 1/2 in., 5/8 in. thick panels or 2-5/8 in. long for 5/8 in. thick panels, spaced 12 in. OC. Screws offset min 6 in. from layer below. Four-layer systems: First layer- 1 in. long for 1/2 in., 5/8 in. thick panels, spaced 24 in. OC. Second layer- 1-5/8 in. long for 1/2 in., 5/8 in. thick panels, spaced 24 in. OC. Third layer- 2-1/4 in. long for 1/2 in. thick anels or 2-5/8 in. long for 5/8 in. thick panels, spaced 24 in. OC. Fourth layer- 2-5/8 in. long for 1/2 in. thick panels or 3 in. long for 5/8 in. thick panels, spaced 12 in. OC Screws offset min 6 in. from layer below.

7. Furring Channels — (Optional, Not Shown, for single or double layer systems) Resilient furring channels fabricated from min 25 MSG corrosion-protected stee spaced vertically a max of 24 in. OC. Flange portion attached to each intersecting stud with 1/2 in. long Type S-12 steel screws. Not for use with Item 5A. 7A. Framing Members\* — (Optional on one or both sides, not shown, for single or double layer systems) — As an alternate to Item 7, furring channels and Steel

a. Furring Channels — Formed of No. 25 MSG galv steel. 2-9/16 in. or 2-23/32 in. wide by 7/8 in. deep, spaced max. 24 in. OC perpendicular to studs. Channels secured to studs as described in Item b. Gypsum board attached to furring channels as described in Item 6. Not for use with Item 5A.

Framing Members as described below:

 Steel Framing Members\* — Used to attach furring channel (Item 7Aa) to studs (Item 2). Clips spaced max. 48 in. OC. RSIC-1 and RSIC-1 (2.75) clips secured to studs with No. 8 x 1-1/2 in. ninimum self-drilling, S-12 steel screw through the center gromme RSIC-V and RSIC-V (2.75) clips secured to study with No. 8 x 9/16 n. minimum self-drilling, S-12 steel screw through the center hole Furring channels are friction fitted into clips. RSIC-1 and RSIC-V lips for use with 2-9/16 in. wide furring channels. RSIC-1 (2.75) and RSIC-V (2.75) clips for use with 2-23/32 in. wide furring PAC INTERNATIONAL L L C — Types RSIC-1, RSIC-V, RSIC-1 (2.75), RSIC-V (2.75).

7B. Framing Members\* — (Optional, Not Shown) — As an alternate to Item 7, for single or double layer systems, furring channels and Steel Framing Members on only one side of studs as described below:

Furring Channels — Formed of No. 25 MSG galv steel, spaced 24 in. OC perpendicular to studs. Channels secured to studs as described in Item b. Batts and Blankets placed in stud cavity as described in Item 5. Two layers of gypsum board attached to furring channels as described in Item 5. Not for use with Item 5A. b. Steel Framing Members\* - Used to attach furring channels

(Item 7Ba) to one side of studs (Item 2) only. Clips spaced 48 in.

OC., and secured to studs with two No. 8 x 2-1/2 in. coarse drywall

screws, one through the hole at each end of the clip. Furring KINETICS NOISE CONTROL INC - Type Isomax

7C. Framing Members\* — (Not Shown) — (Optional on one or both sides, not shown, for single or double layer systems) — As an alternate to Item 7, furring channels and Steel Framing Members as described below

a Furring Channels - Formed of No. 25 MSG galv steel. 2-3/8 in. wide by 7/8 in. deep, spaced max. 24 in. OC perpendicular to studs. Channels secured to studs as described in Item b. Gypsum board attached to furring channels as described in Item 6. Not for

b. Steel Framing Members\* — Used to attach furring channels (Item 7Ca) to studs (Item 2). Clips spaced max. 48 in. OC. SENIECLIPS secured to studs with No. 8 x 1-1/2 in. minimum selfdrilling, S-12 steel screw through the center grommet. Furring hannels are friction fitted into clips PLITEQ INC - Type GENIECLIP

7D. Steel Framing Members\* — (Optional on one or both sides, not shown, for single or double layer systems) — Furring channels and Steel Framing Members as

> a. Furring Channels — Formed of No. 25 MSG galv steel. Spaced 24 in. OC perpendicular to studs. Channels secured to studs as and tied together with double strand of No. 18 AWG galvanized steel wire.. Gypsum board attached to furring channels as escribed in Item 6. Not for use with Item 5A.

> Steel Framing Members\* — Used to attach furring channels (Item 7Da) to studs. Clips spaced 48 in. OC., and secured to studs with 2 in. coarse drywall screw with 1 in. diam washer through the enter hole. Furring channels are friction fitted into clips STUDCO BUILDING SYSTEMS — RESILMOUNT Sound Isolation Clips - Type A237 or A237R

7E. Steel Framing Members\* — (Optional on one or both sides, not shown, for single or double layer systems) - Furring channels and Steel Framing Members as

> a. Furring Channels — Formed of No. 25 MSG galv steel. Spaced 24 in. OC perpendicular to studs. Channels secured to studs as described in Item 7Eb. Ends of adjoining channels overlapped 6 in and tied together with double strand of No. 18 AWG galvanized teel wire.. Gypsum board attached to furring channels as

described in Item 6. Not for use with Item 5A and 5E. b. Steel Framing Members\* - Used to attach furring channels Item 7Ea) to studs. Clips spaced 48 in. OC., and secured to studs with No. 8 x 2-1/2 in. coarse drywall screw through the center hole.

7F. Steel Framing Members\* — (Optional on one or both sides, not shown, for single or double layer systems) — Resilient channels and Steel Framing Members

REGUPOL AMERICA — Type SonusClip

a. Resilient Channels — Formed of No. 25 MSG galv steel, spaced 24 in. OC, and perpendicular to studs. Channels secured to studs as described in Item b. Ends of adjoining channels overlapped 6 in. and secured in place with two No. 8 15 x 1/2 in. Philips Modified Truss screws spaced 2-1/2 in. from the center of the overlap. Gypsum board attached to resilient channels as described in Item 5. Not for use with Item 5A and 5E.

b. Steel Framing Members\* — Used to attach resilient channels Item 7Fa) to studs. Clips spaced 48 in. OC., and secured to studs with No. 8 x 2-1/2 in. coarse drywall screw through the center hole. Resilient channels are secured to clips with one No. 10 x 1/2 in. pan-head self-drilling screw. KEENE BUILDING PRODUCTS CO INC — Type RC+ Assurance

7G. Framing Members\* — (Optional on one or both sides, not shown, for single or double layer systems) — As an alternate to Item 7, furring channels and Steel

Framing Members as described below: a. Furring Channels — Formed of No. 25 MSG galv steel. 2-23/32 in, wide by 7/8 in, or 1-1/2 in, deep, spaced max, 24 in, OC perpendicular to studs. Channels secured to studs as described in tem b. Gypsum board attached to furring channels as described in Item 6. Not for use with Item 5A.

b. Steel Framing Members\* — Used to attach furring channels (Item 7Ga) to studs (Item 2). Clips spaced max. 48 in. OC. Clips secured to studs with No. 8 x 1-1/2 in. minimum self-drilling, S-12 teel screw through the center hole. Furring channels are friction fitted into clips CLARKDIETRICH BUILDING SYSTEMS — Type ClarkDietrich

8. Joint Tape and Compound — Vinyl or casein, dry or premixed joint compound applied in two coats to joints and screw heads of outer layers. Paper tape, nom 2 in. ape and joint compound may be omitted when gypsum panels are supplied with a

9. Siding, Brick or Stucco — (Optional, Not Shown) — Aluminum, vinyl or steel

siding, brick veneer or stucco, meeting the requirements of local code agencies,

installed over gypsum panels. Brick veneer attached to studs with corrugated metal

wall ties attached to each stud with steel screws, not more than each sixth course of 10. Caulking and Sealants\* — (Optional, Not Shown) — A bead of acoustical sealant applied around the partition perimeter for sound control

UNITED STATES GYPSUM CO — Type AS

11. Lead Batten Strips — (Not Shown, For Use With Item 5B) — Lead batten strips, min 1-1/2 in. wide, max 10 ft long with a max thickness of 0.125 in. Strips placed on the interior face of studs and attached from the exterior face of the stud with two 1 in. long Type S-12 pan head steel screws, one at the top of the strip and one at the bottom of the strip. Lead batten strips to have a purity of 99.9% meeting the Federal specification QQ-L-201f, Grade "C". Lead batten strips required behind vertical joints of lead backed gypsum wallboard (Item 5B) and optional at remaining stud locations. Required behind vertical joints.

strips, 2 in. wide, max 10 ft long with a max thickness of 0.140 in. Strips placed on the face of studs and attached to the stud with two min. 1 in. long min. Type S-8 pan head steel screws, one at the top of the strip and one at the bottom of the strip or with one min. 1 in. long min. Type S-8 pan head steel screw at the top of the strip ead batten strips to have a purity of 99.5% meeting the Federal specification QQ-L 201f, Grades "B, C or D". Lead batten strips required behind vertical joints of lead backed gypsum wallboard and optional at remaining stud locations 12. Lead Discs or Tabs — (Not Shown, For Use With Item 5B) — Used in lieu of or in addition to the lead batten strips (Item 11) or optional at other locations -  ${\rm Max}\ 3/4$ 

in. diam by max 0.125 in. thick lead discs compression fitted or adhered over steel

screw heads or max 1/2 in. by 1-1/4 in. by max 0.125 in. thick lead tabs placed on

gypsum boards (Item 5B) underneath screw locations prior to the installation of the

11A. Lead Batten Strips — (Not Shown, For Use With Item 5H) — Lead batten

screws. Lead discs or tabs to have a purity of 99.9% meeting the Federal specification QQ-L-201f, Grade "C". 12A. Lead Discs — (Not Shown, for use with Item 5H) — Max 5/16 in. diam by max 0.140 in. thick lead discs compression fitted or adhered over steel screw head ead discs to have a purity of 99.5% meeting the Federal Specification QQ-L-201f,

Grades "B, C or D". 13. Lead Batten Strips — (Not Shown, For Use With Item 5E) — Lead batten strips, 2 in. wide, max 10 ft long with a max thickness of 0.142 in. Strips placed on the face of studs and attached to the stud with two min. 1 in, long min. Type S-8 pan head steel screws, one at the top of the strip and one at the bottom of the strip or with one min. 1 in. long min. Type S-8 pan head steel screw at the top of the strip. Lead batten strips to have a purity of 99.9% meeting the Federal specification QQ-L-201f, Grade "C". Lead batten strips required behind vertical joints of lead backed gypsum wallboard (Item 5E) and optional at remaining stud locations.

14. Lead Tabs — (Not Shown, For Use With Item 5E) — 2 in, wide, 5 in, long with a max thickness of 0.142 in. Tabs friction-fit around front face of stud, the stud folded back flange, and the back face of the stud. Tabs required at each location where a screw (that secures the gypsum boards, Item 5E) will penetrate the steel stud. Lead tabs to have a purity of 99.9% meeting the Federal specification QQ-L-201f, Grade C". Lead tabs may be held in place with standard adhesive tape if necessary.

15. Barrier Mesh — (Optional, Not Shown) - Attached to steel studs on one or both sides of the wall using Barrier Mesh Clips spaced at maximum 12 inches on center ertically, using a flat head type screw penetrating through the steel at least 3/8 of an inch. For Steel Studs less than 0.033 inches in thickness, use self-piercing screws. For Steel Studs equal to or greater than 0.033 inches in thickness, use steel drill screws (self-tapping). Gypsum Board (Item 5) to be installed directly over the Barrier Mesh using prescribed screw patterns with lengths increased by a minimum 1/8 in. Barrier Mesh may be installed with the long dimension of the diamond pattern positioned vertically or horizontally. Barrier Mesh joints may occur as butt joints at the framing members and secured using the Barrier Mesh Clips or occur in between raming members as overlapping joints secured using 18 SWG wire ties spaced a maximum 12 in. on center.

\* Indicates such products shall bear the UL or cUL Certification Mark for jurisdictions employing the UL or cUL Certification (such as Canada), respectively.

CLARKDIETRICH BUILDING SYSTEMS — Barrier Mesh, Barrier Mesh Clips

Design/System/Construction/Assembly Usage Disclaimer

Last Updated on 2019-09-13

 Authorities Having Jurisdiction should be consulted in all cases as to the particular requirements covering the installation and use of UL Certified products, equipment, system, devices, and

· Authorities Having Jurisdiction should be consulted before construction. • Fire resistance assemblies and products are developed by the design submitter and have been investigated by UL for compliance with applicable requirements. The published information cannot always address every construction nuance encountered in the field. When field issues arise, it is recommended the first contact for assistance be the technical service staff provided by the product manufacturer noted for the design. Users of fire resistance assemblies are advised to consult the general Guide Information for each product category and

Only products which bear UL's Mark are considered Certified.

The appearance of a company's name or product in this database does not in itself assure that products so identified have been manufactured under UL's Follow-Up Service. Only those products bearing the UL Mark should be considered to be Certified and covered under UL's Follow-Up Service. Always look for the Mark on the product.

UL permits the reproduction of the material contained in the Online Certification Directory subject to the following conditions: 1. The Guide Information, Assemblies, Constructions, Designs, Systems, and/or Certifications (files) must be presented in their entirety and in a non-misleading manner, without any manipulation of the data (or drawings). 2. The statement "Reprinted from the Online Certifications Directory with permission from UL" must appear adjacent to the extracted material. In addition, the reprinted material must include a copyright notice in the following format: "© 2019 UL

UL and the UL logo are trademarks of UL LLC @ 2019 All Rights Reserved.

9229 WARD PARKWAY SUITE # 210 KANSAS CITY, MO 64114 TEL: (816) 444-4200

FAX: (316) 265-5646

www.glmv.com

GLMV ARCHITECTURE. INC

MISSOURI STATE CERTIFICATE OF AUTHORITY #000305 CONSULTING ARCHITECT **FGMA ARCHITECTS** 11250 ROGER BACON DRIVE, SUITE 16 RESTON, VIRGINIA 20190

TEL: (703) 956-5600

CIVIL ENGINEER & LANDSCAPE ARCH. GLMV ARCHITECTURE, INC MISSOURI CIVIL COA #2018033898 MISSOURI LANDSCAPE COA #000008 9229 WARD PARKWAY, SUITE # 210 KANSAS CITY, MO 64114 TEL: (816) 444-4200


STRUCTURAL ENGINEER LEIGH + O'KANE MISSOURI COA #001644 250 NE MULBERRY, SUITE 201 LEE'S SUMMIT, MO 64086 (816) 444-3144

MECH., ELECT. & PLMG. ENGINEERS HOSS & BROWN ENGINEERS MISSOURI COA #01022 15902 MIDLAND DRIVE SHAWNEE, KS 66217 (913) 362.9090

**SECURITY & IT ENGINEERS** HENDERSON ENGINEERS MISSOURI COA #000556 1801 MAIN STREET, SUITE 300 KANSAS CITY, MO 64108 (816) 663-8700

ES. SS 屋屋 ОШ  $\infty$   $\square$ 

REVISIONS Description ASI 01

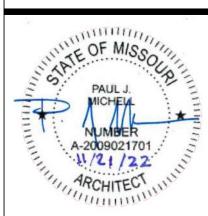

MO# A-2009021701 PROJECT NO: 18225R21001


PAUL J. MICHELL - ARCHITECT

DATE: 11.21.2022 DRAWN BY: CHK'D BY: © GLMV Architecture, Inc. All work herein is the property of GLMV

**UL DETAILS** 

Architecture, Inc. and is not to be copied or used

in any way without the express written consent of

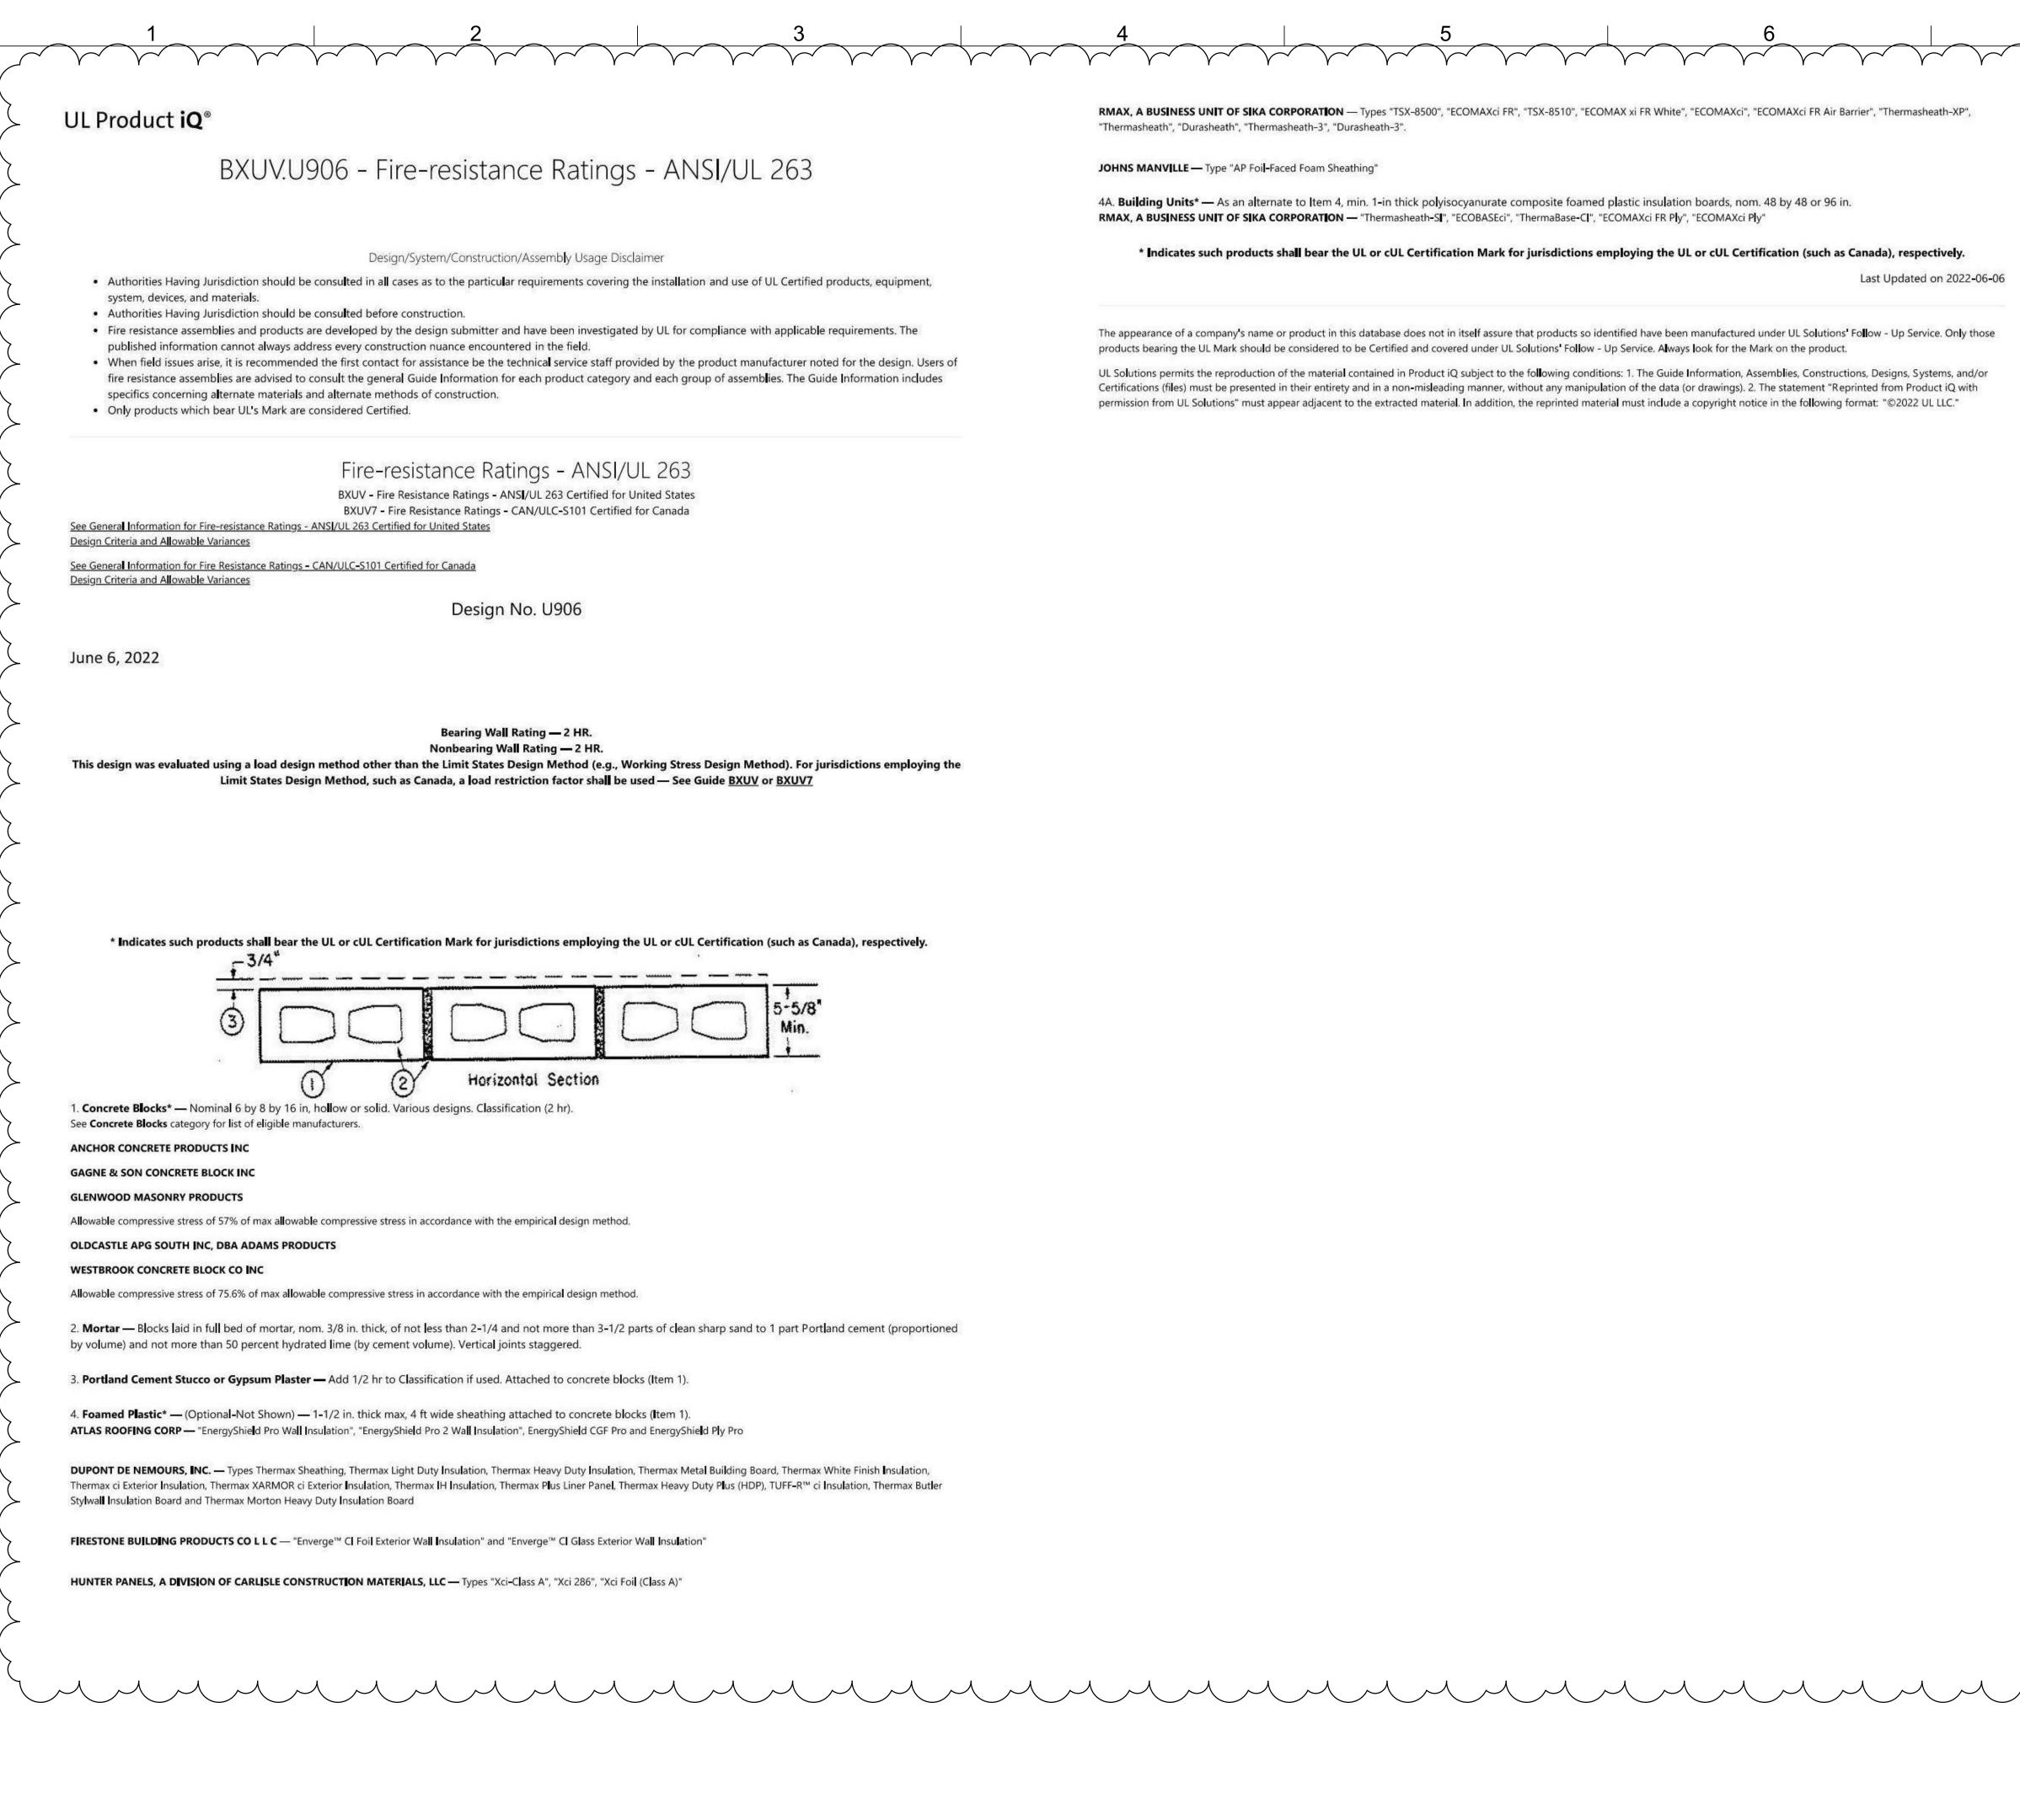

RMAX, A BUSINESS UNIT OF SIKA CORPORATION — Types "TSX-8500", "ECOMAXci FR", "TSX-8510", "ECOMAX xi FR White", "ECOMAXci", "ECOMAXci FR Air Barrier", "Thermasheath-XP", "Thermasheath", "Durasheath", "Thermasheath-3", "Durasheath-3".

### JOHNS MANVILLE - Type "AP Foil-Faced Foam Sheathing"

4A. Building Units\* — As an alternate to Item 4, min. 1-in thick polyisocyanurate composite foamed plastic insulation boards, nom. 48 by 48 or 96 in. RMAX, A BUSINESS UNIT OF SIKA CORPORATION — "Thermasheath-SI", "ECOBASEci", "ThermaBase-CI", "ECOMAXci FR Ply", "ECOMAXci Ply"

### \* Indicates such products shall bear the UL or cUL Certification Mark for jurisdictions employing the UL or cUL Certification (such as Canada), respectively.

Last Updated on 2022-06-06

The appearance of a company's name or product in this database does not in itself assure that products so identified have been manufactured under UL Solutions' Follow - Up Service. Only those products bearing the UL Mark should be considered to be Certified and covered under UL Solutions' Follow - Up Service. Always look for the Mark on the product.

UL Solutions permits the reproduction of the material contained in Product iQ subject to the following conditions: 1. The Guide Information, Assemblies, Constructions, Designs, Systems, and/or Certifications (files) must be presented in their entirety and in a non-misleading manner, without any manipulation of the data (or drawings). 2. The statement "Reprinted from Product iQ with permission from UL Solutions" must appear adjacent to the extracted material. In addition, the reprinted material must include a copyright notice in the following format: "©2022 UL LLC."

9229 WARD PARKWAY SUITE # 210

FAX: (316) 265-5646 www.glmv.com GLMV ARCHITECTURE, INC. MISSOURI STATE CERTIFICATE OF AUTHORITY #000305

KANSAS CITY, MO 64114 TEL: (816) 444-4200

**CONSULTING ARCHITECT** FGMA ARCHITECTS 11250 ROGER BACON DRIVE, SUITE 16 RESTON, VIRGINIA 20190

TEL: (703) 956-5600

TEL: (816) 444-4200

CIVIL ENGINEER & LANDSCAPE ARCH. GLMV ARCHITECTURE, INC MISSOURI CIVIL COA #2018033898 MISSOURI LANDSCAPE COA #000008 9229 WARD PARKWAY, SUITE # 210 KANSAS CITY, MO 64114

STRUCTURAL ENGINEER LEIGH + O'KANE MISSOURI COA #001644 250 NE MULBERRY, SUITE 201 LEE'S SUMMIT, MO 64086 (816) 444-3144

MECH., ELECT. & PLMG. ENGINEERS HOSS & BROWN ENGINEERS MISSOURI COA #01022 15902 MIDLAND DRIVE SHAWNEE, KS 66217 (913) 362.9090

SECURITY & IT ENGINEERS HENDERSON ENGINEERS MISSOURI COA #000556 1801 MAIN STREET, SUITE 300 KANSAS CITY, MO 64108


FIRE STAT 80 LE




PAUL J. MICHELL - ARCHITECT MO# A-2009021701

PROJECT NO:	18225R21001
DATE:	11.21.2022
DRAWN BY:	Author
CHK'D BY:	Checker
© GLMV Arch All work herein is the Architecture, Inc. and is n in any way without the exp GLMV Archite	property of GLMV ot to be copied or used press written consent of

**UL DETAILS** 

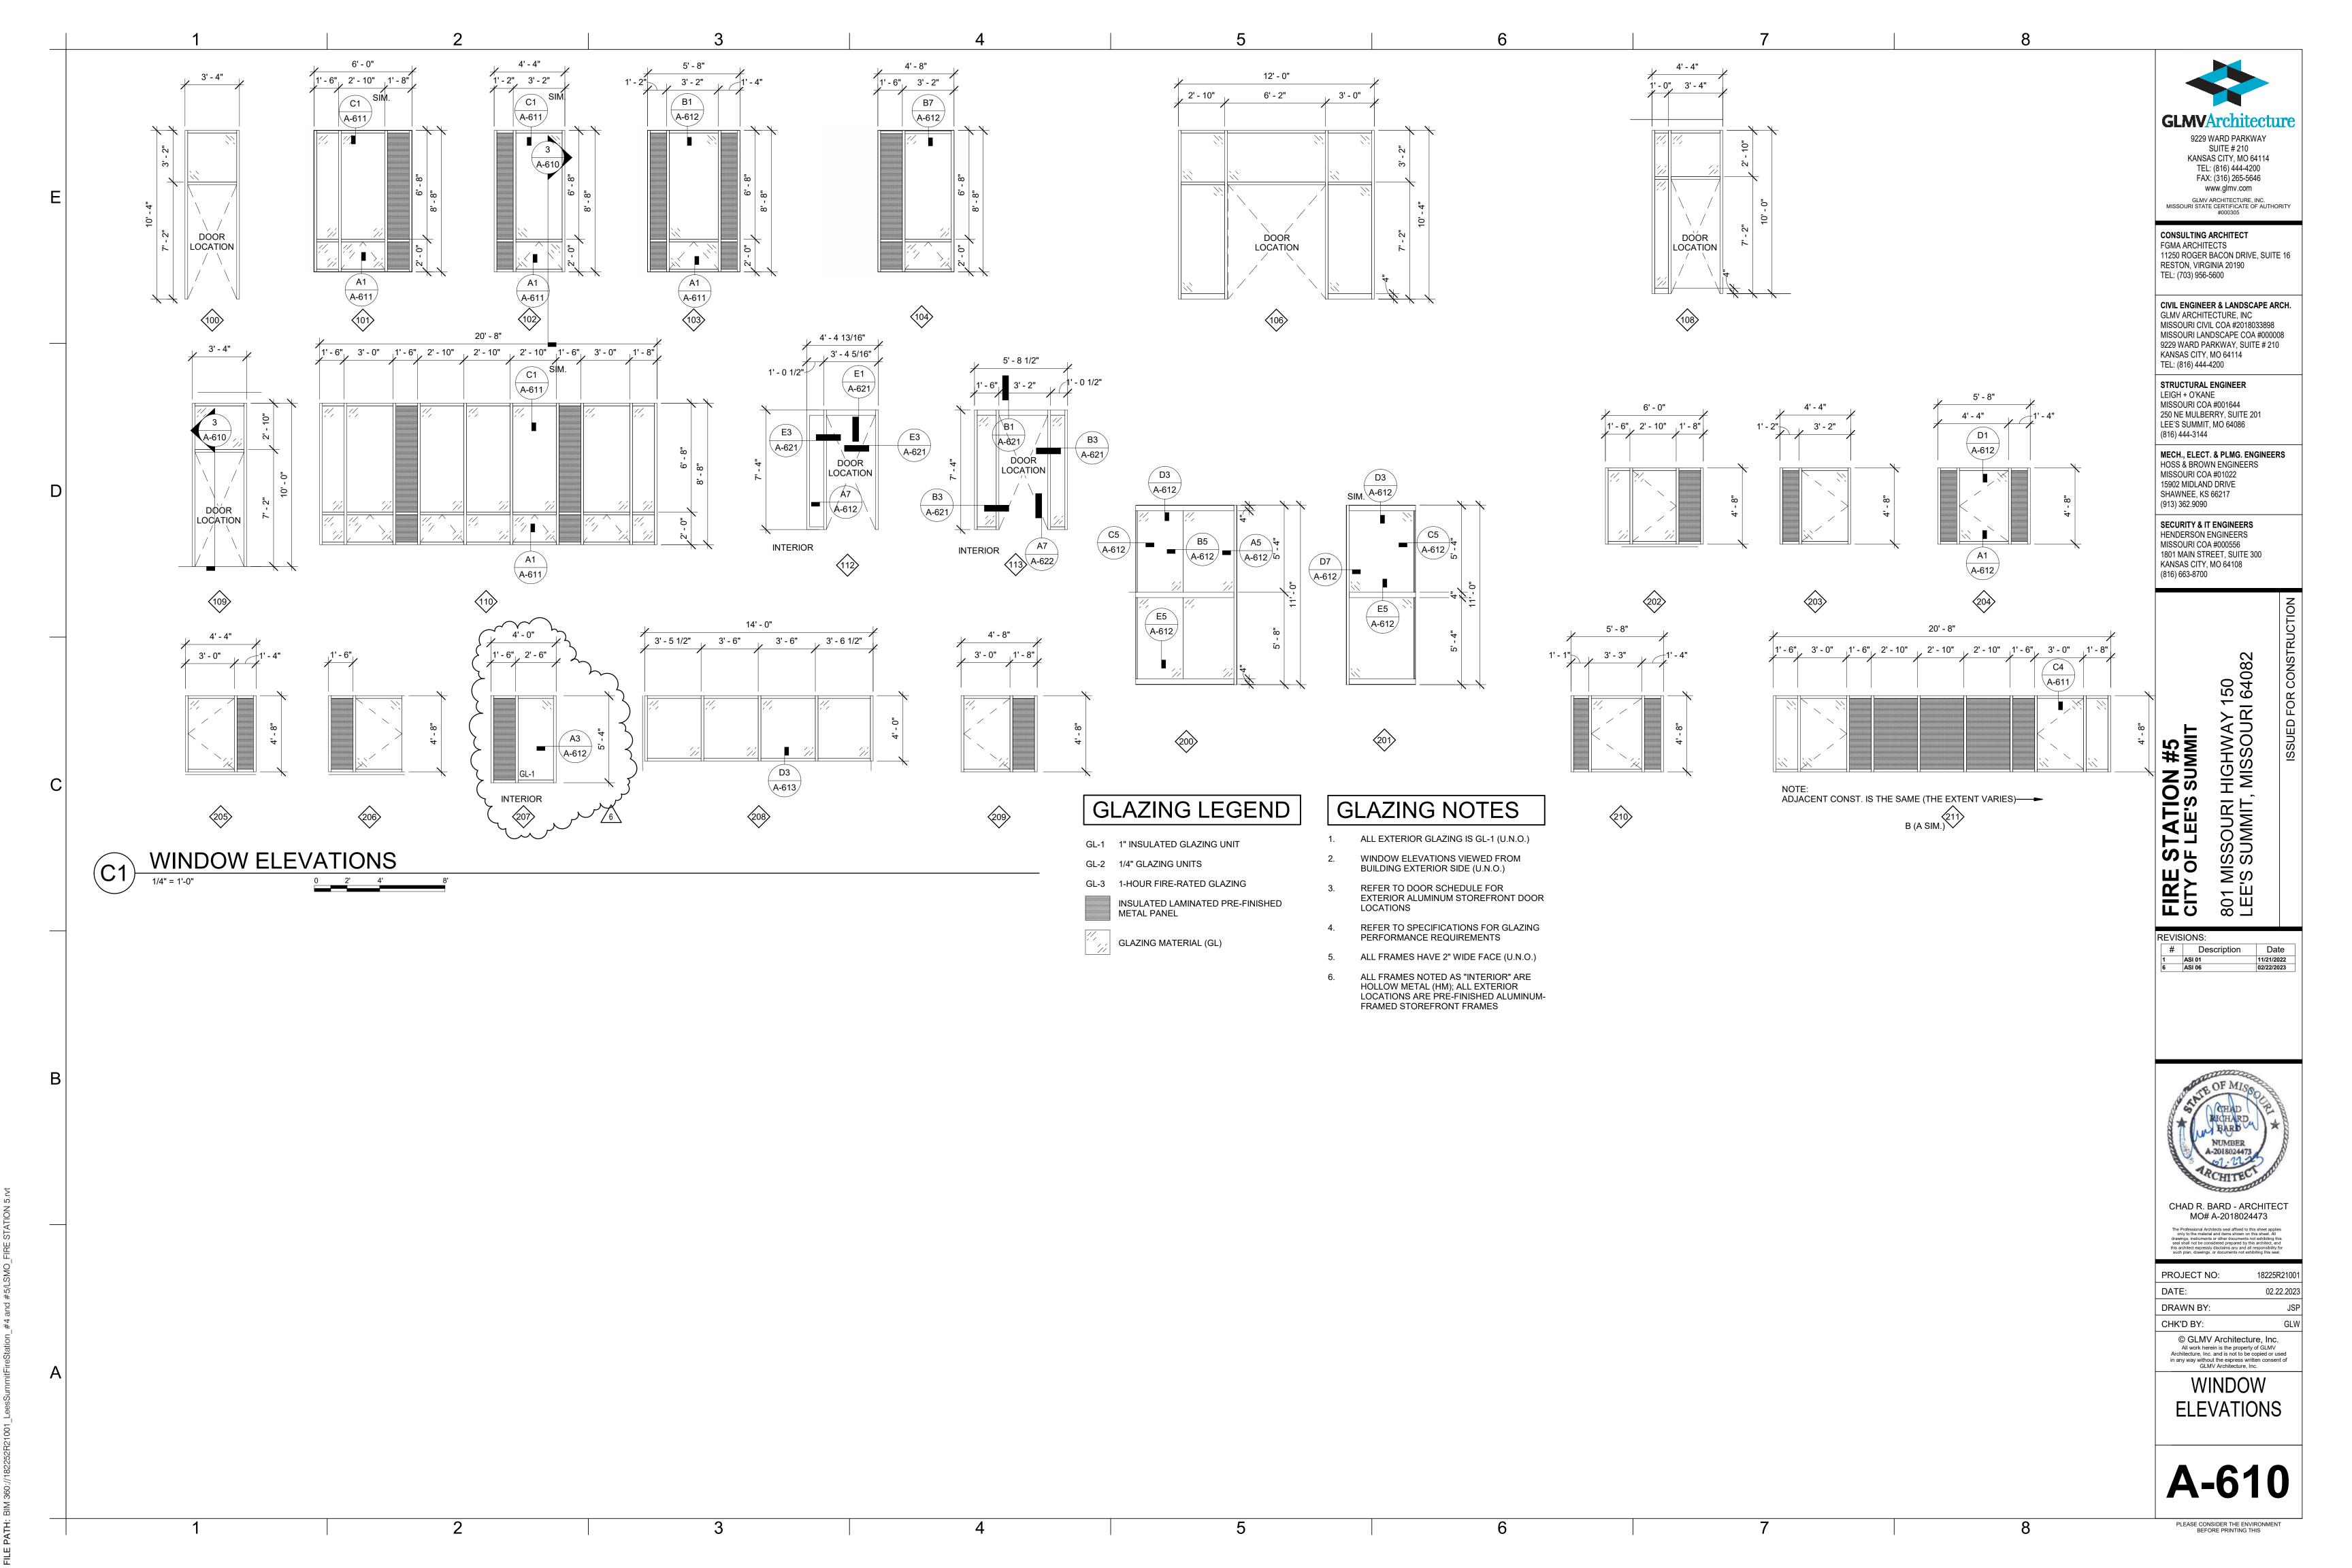

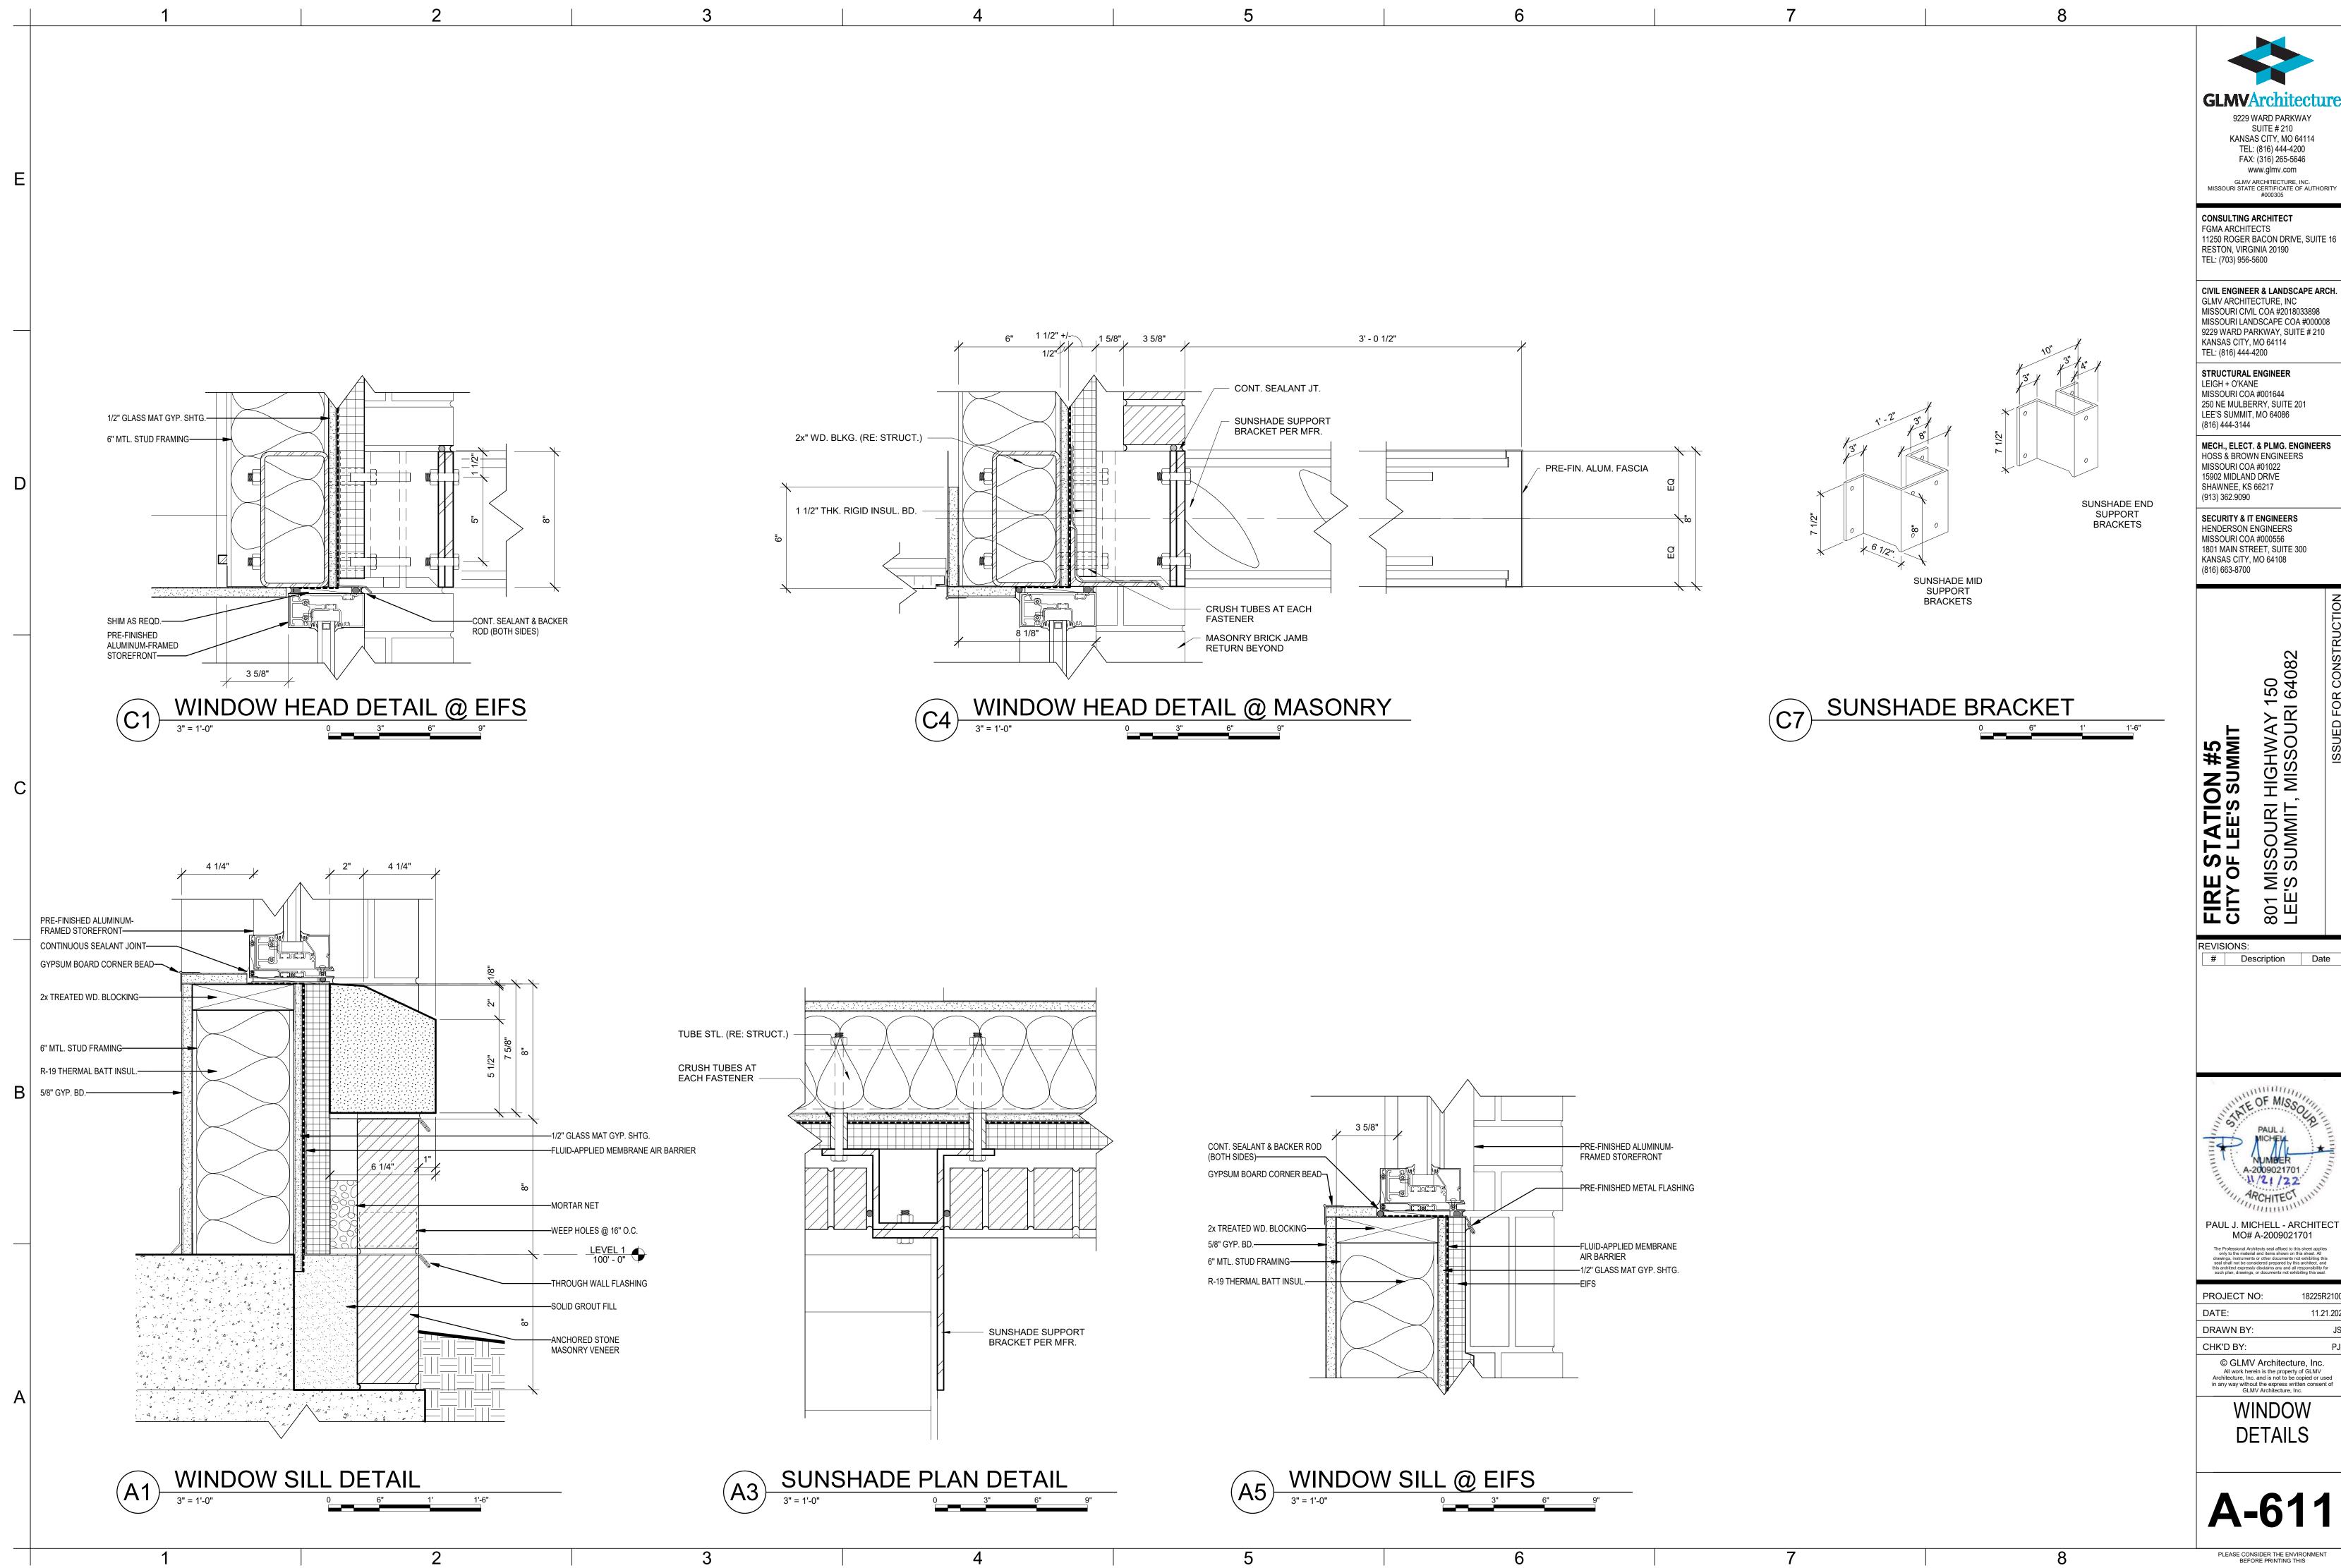

KANSAS CITY, MO 64114 TEL: (816) 444-4200 FAX: (316) 265-5646


MISSOURI CIVIL COA #2018033898 MISSOURI LANDSCAPE COA #000008 9229 WARD PARKWAY, SUITE # 210


MECH., ELECT. & PLMG. ENGINEERS


# Description Date


PAUL J. MICHELL - ARCHITECT MO# A-2009021701


PROJECT NO:	18225R21001
DATE:	11.21.2022
DRAWN BY:	JSP
CHK'D BY:	РЈМ
© GLMV Archi All work herein is the p	property of GLMV

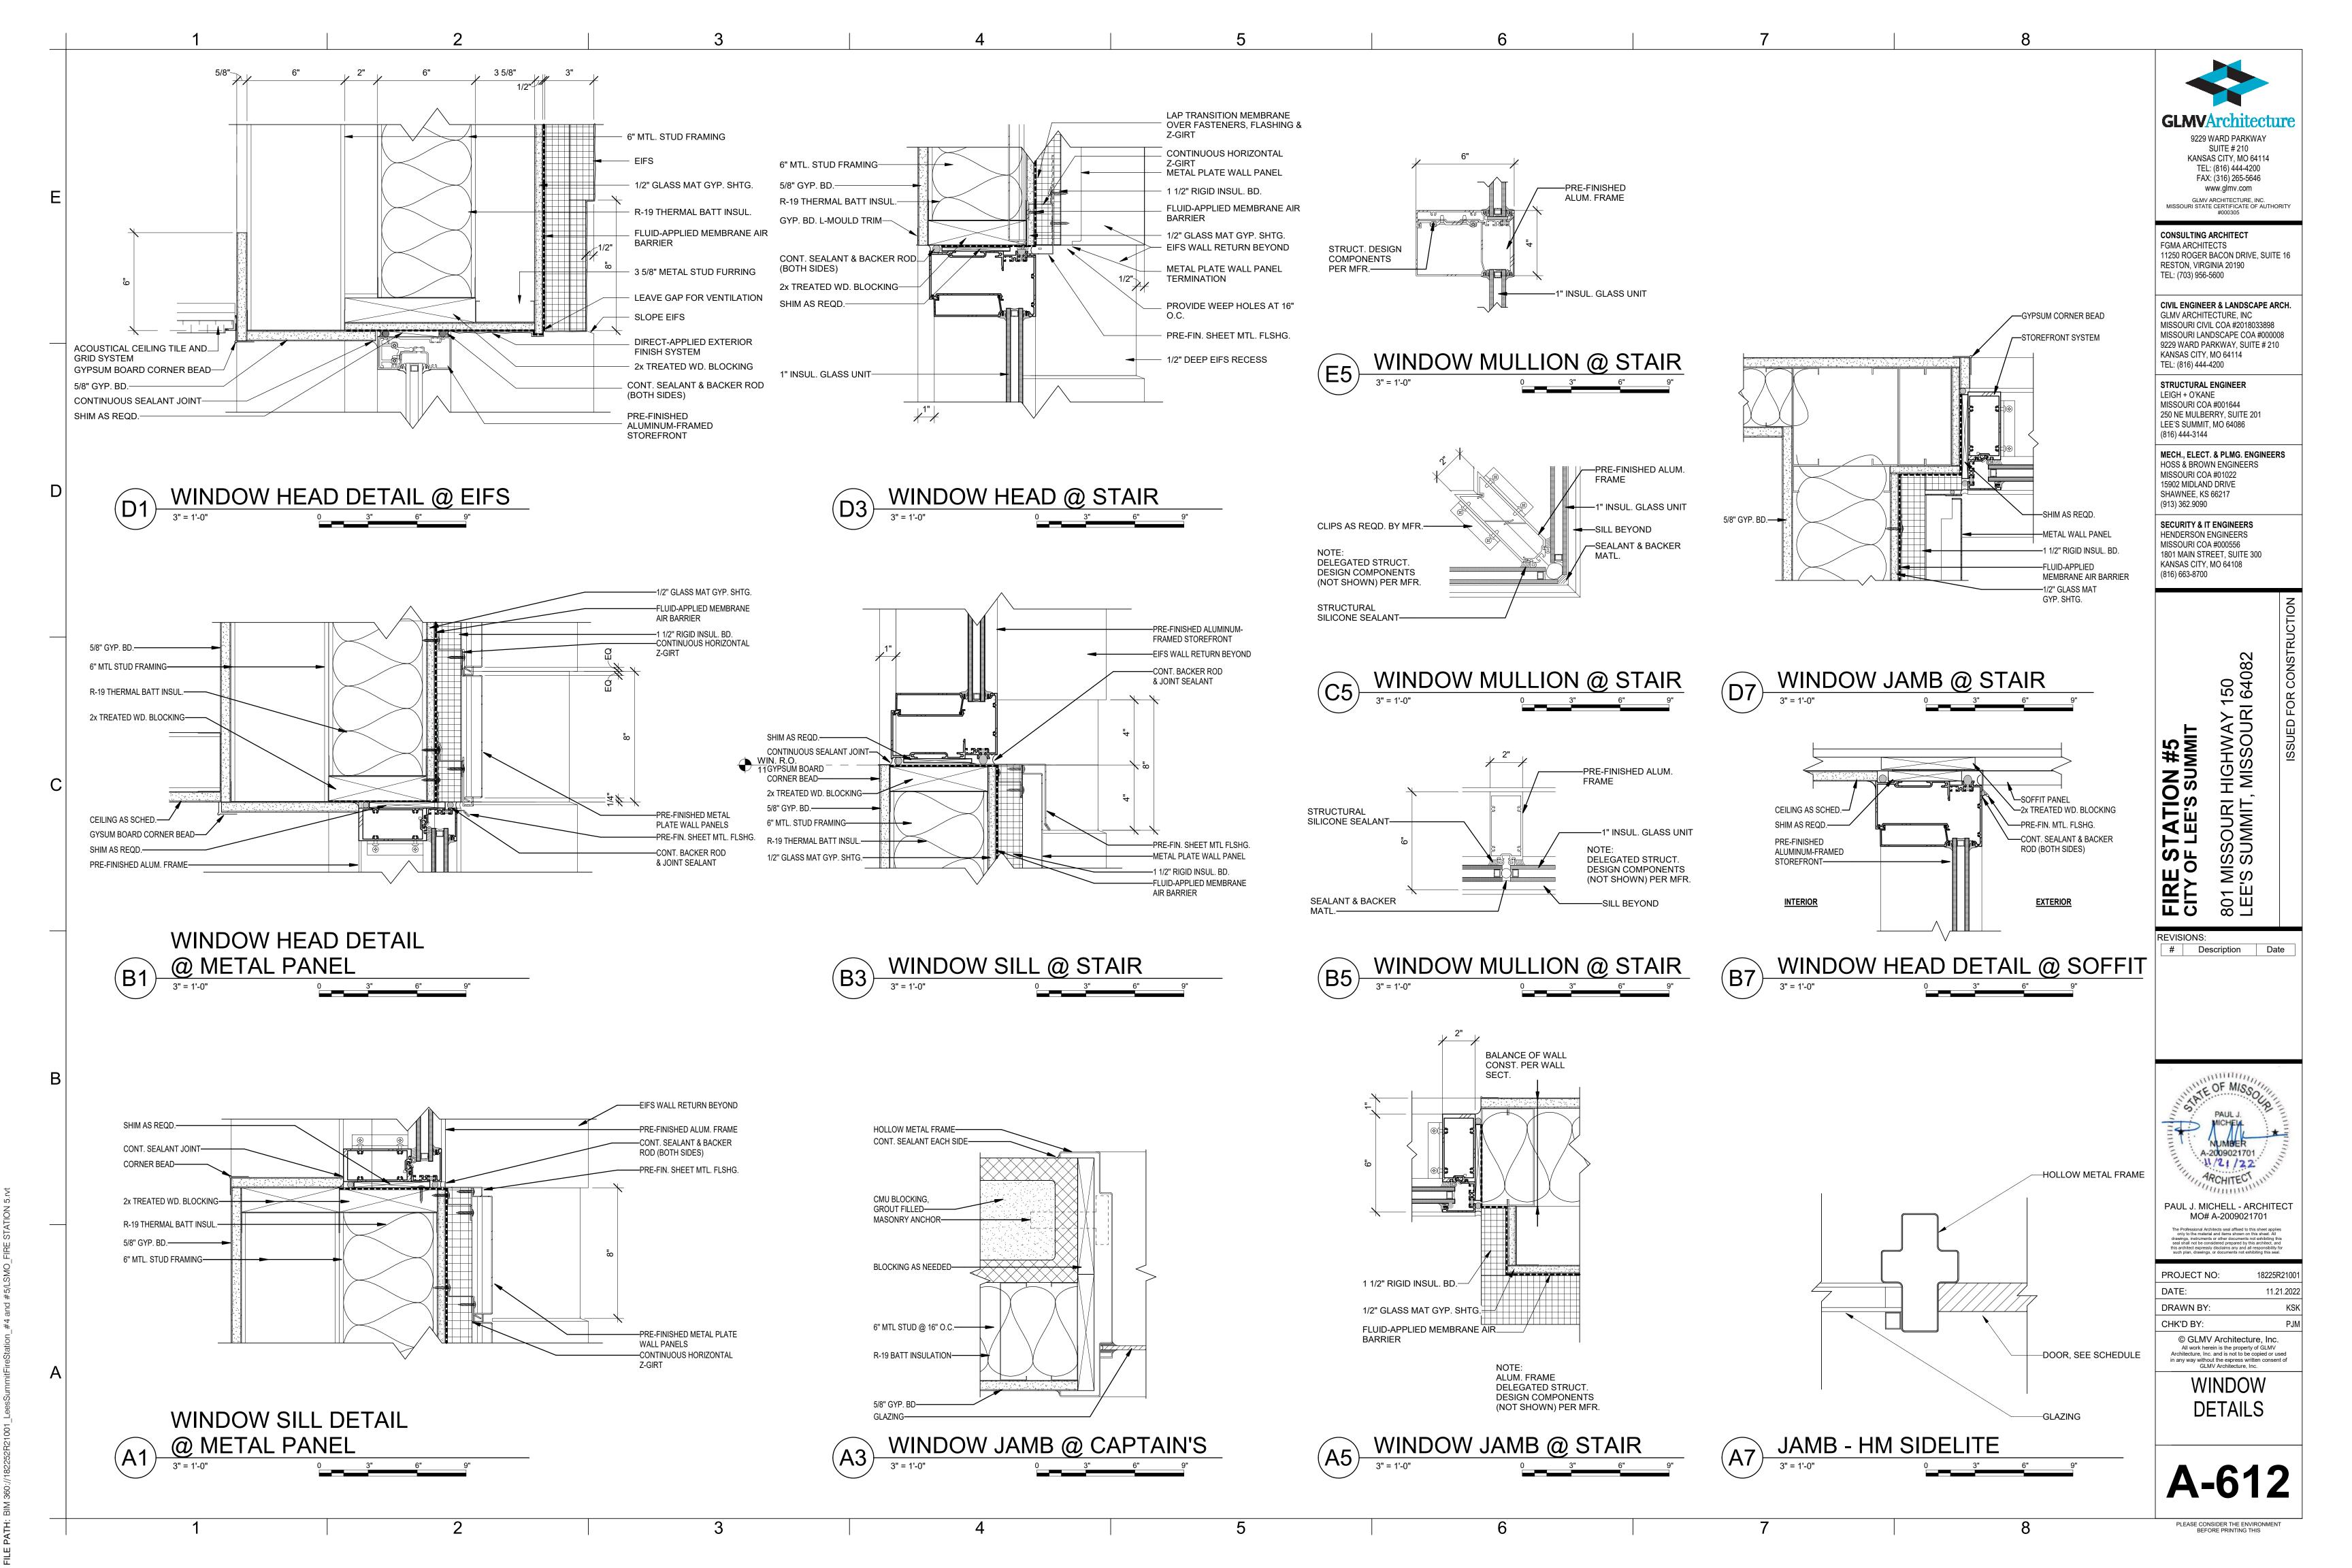


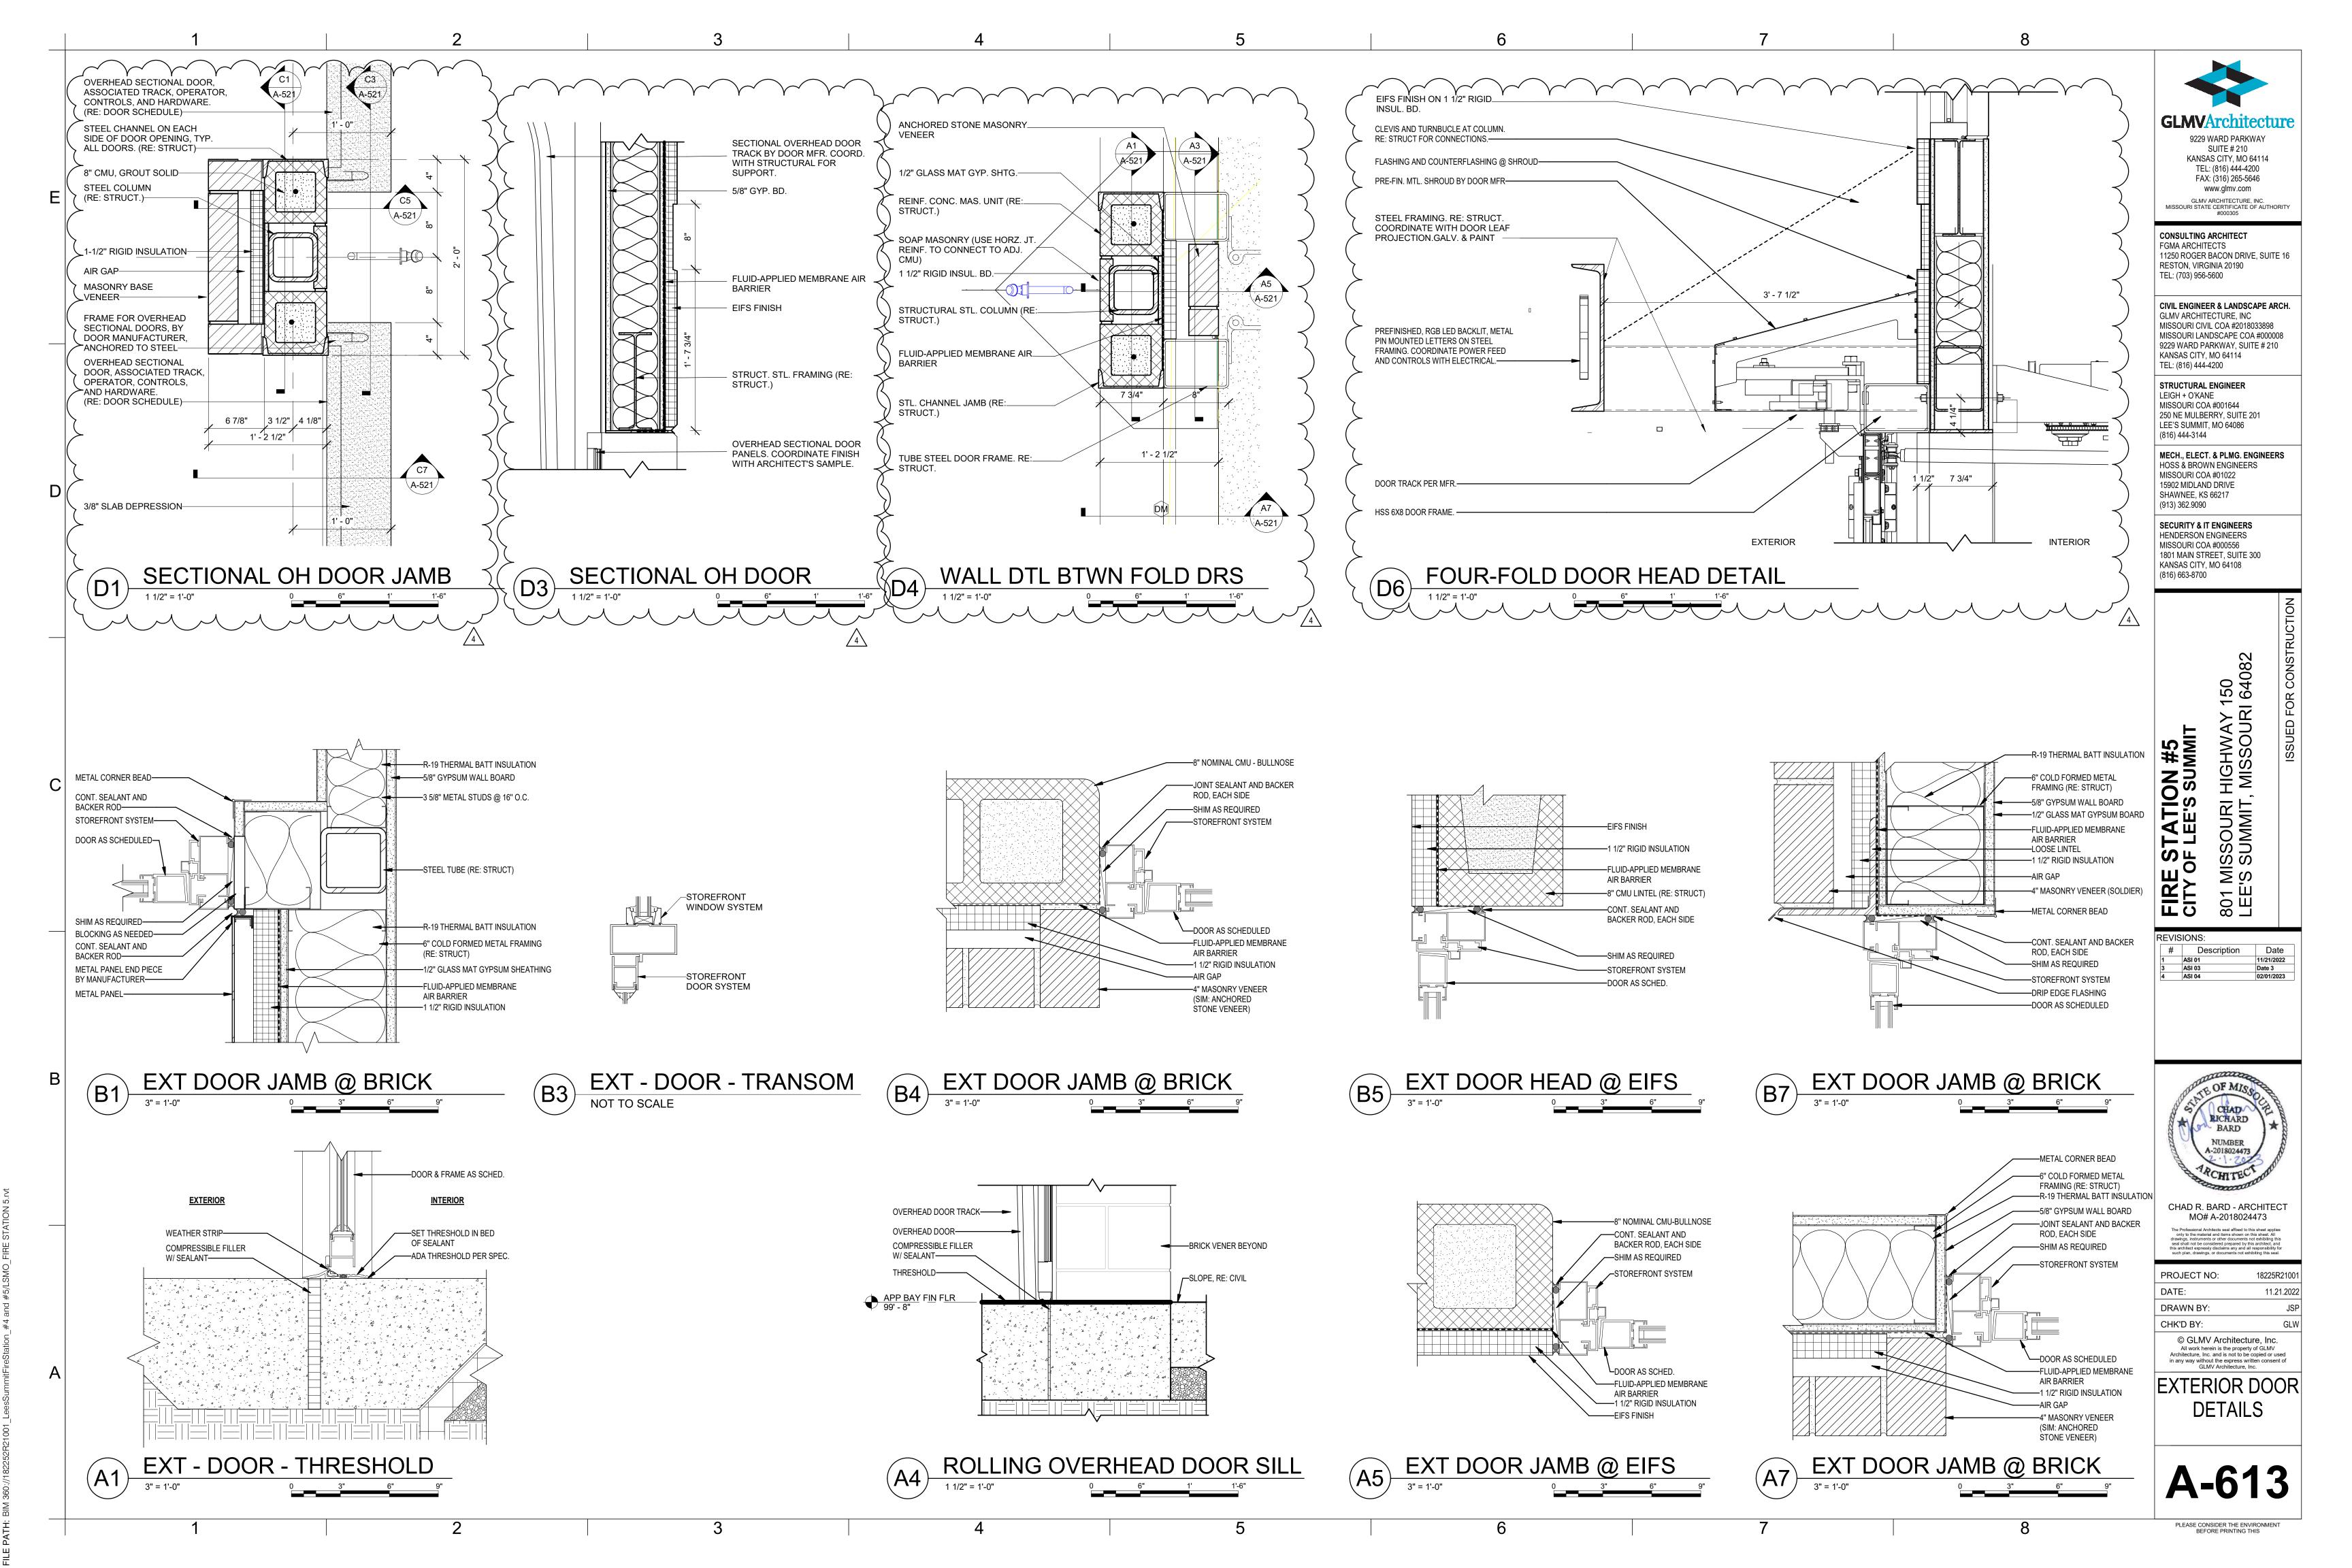


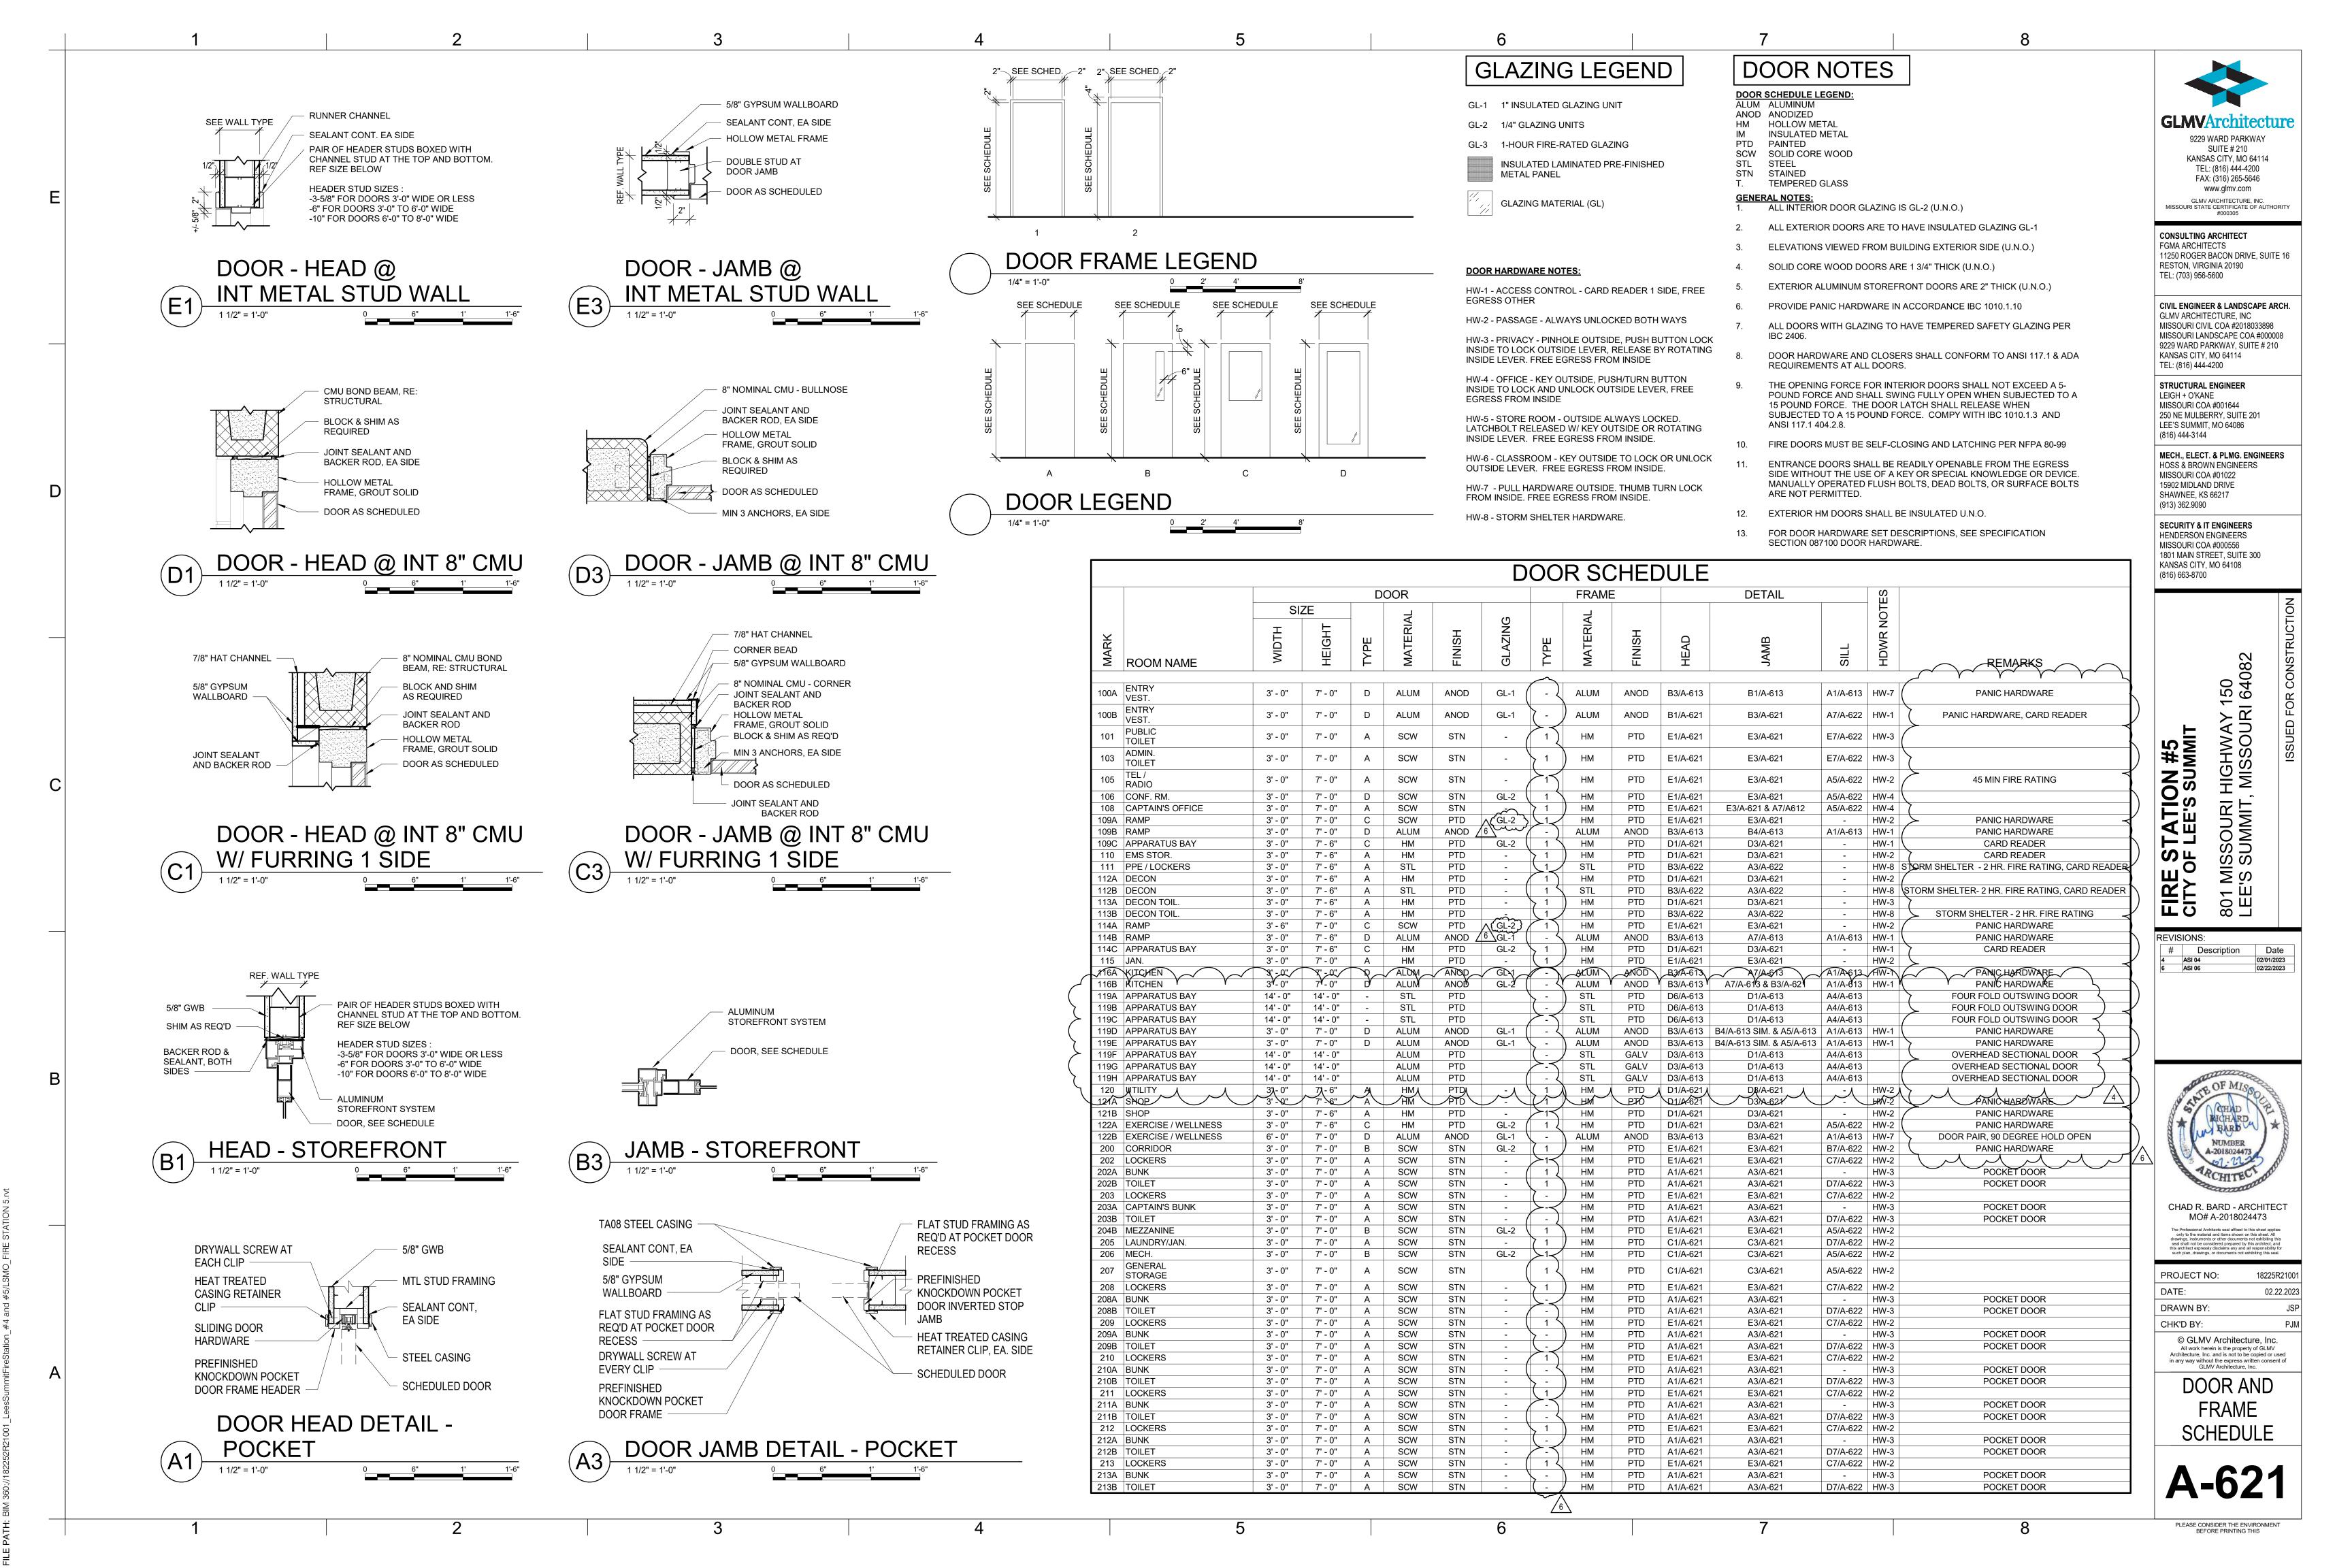


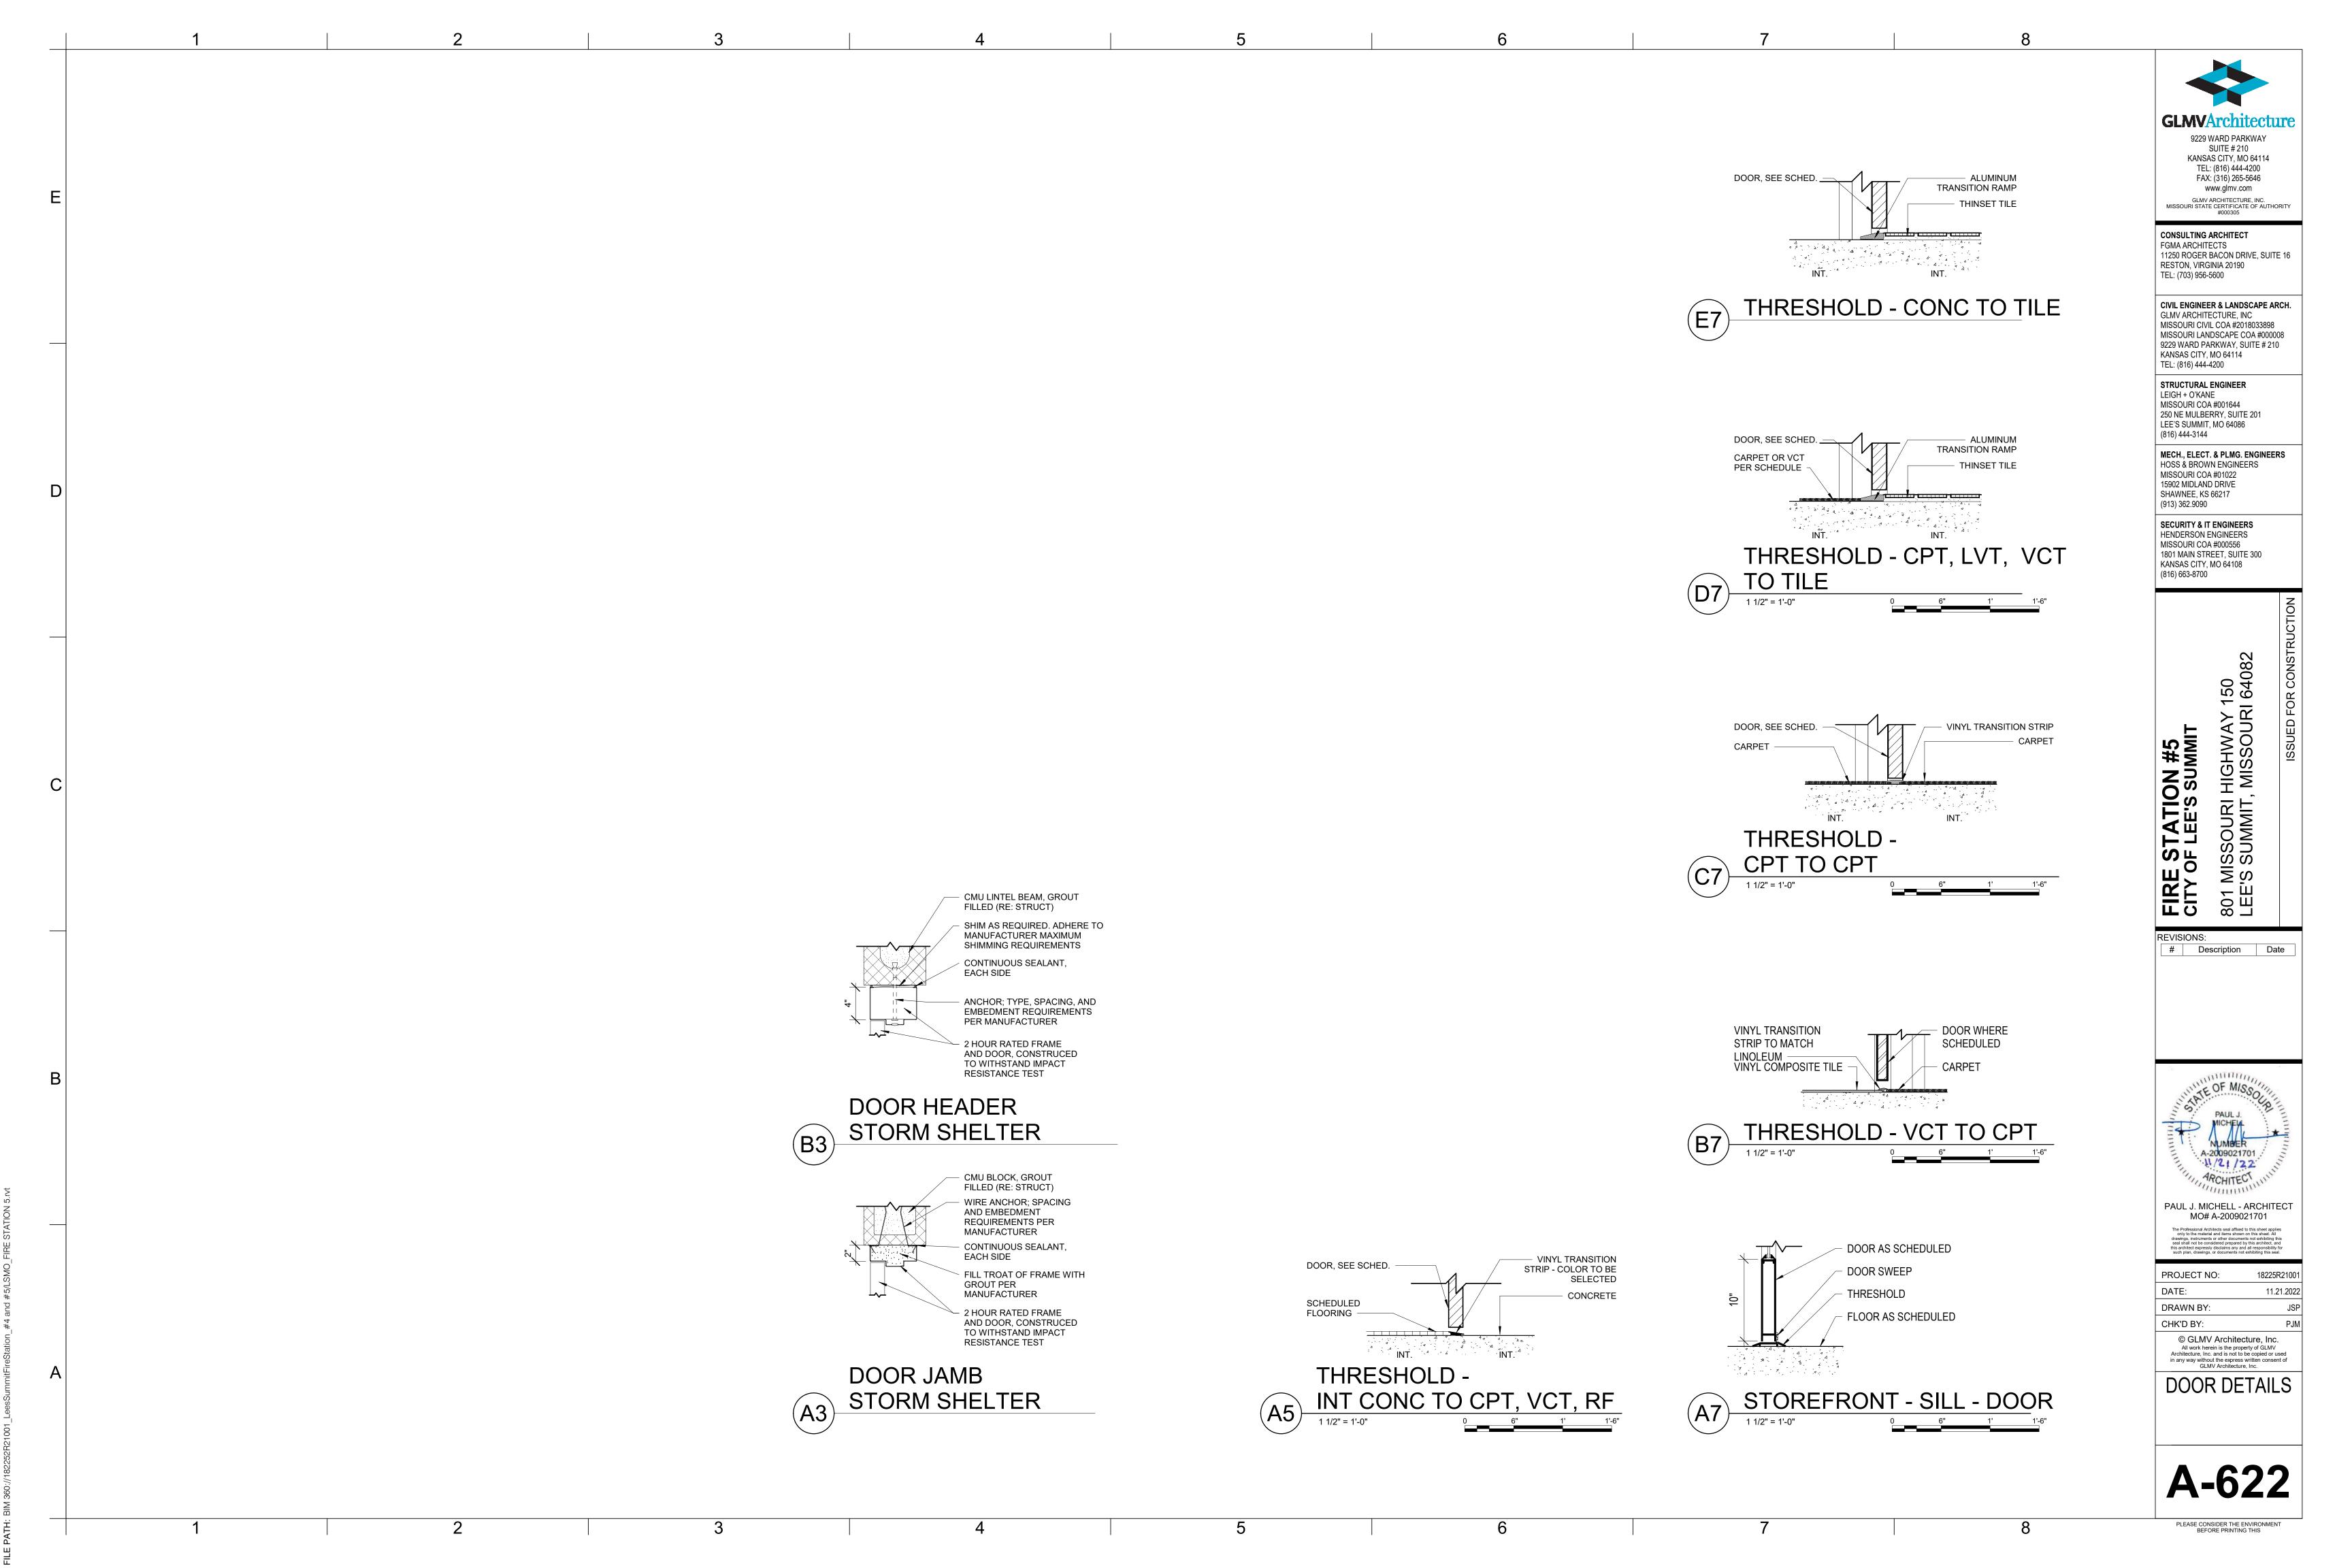


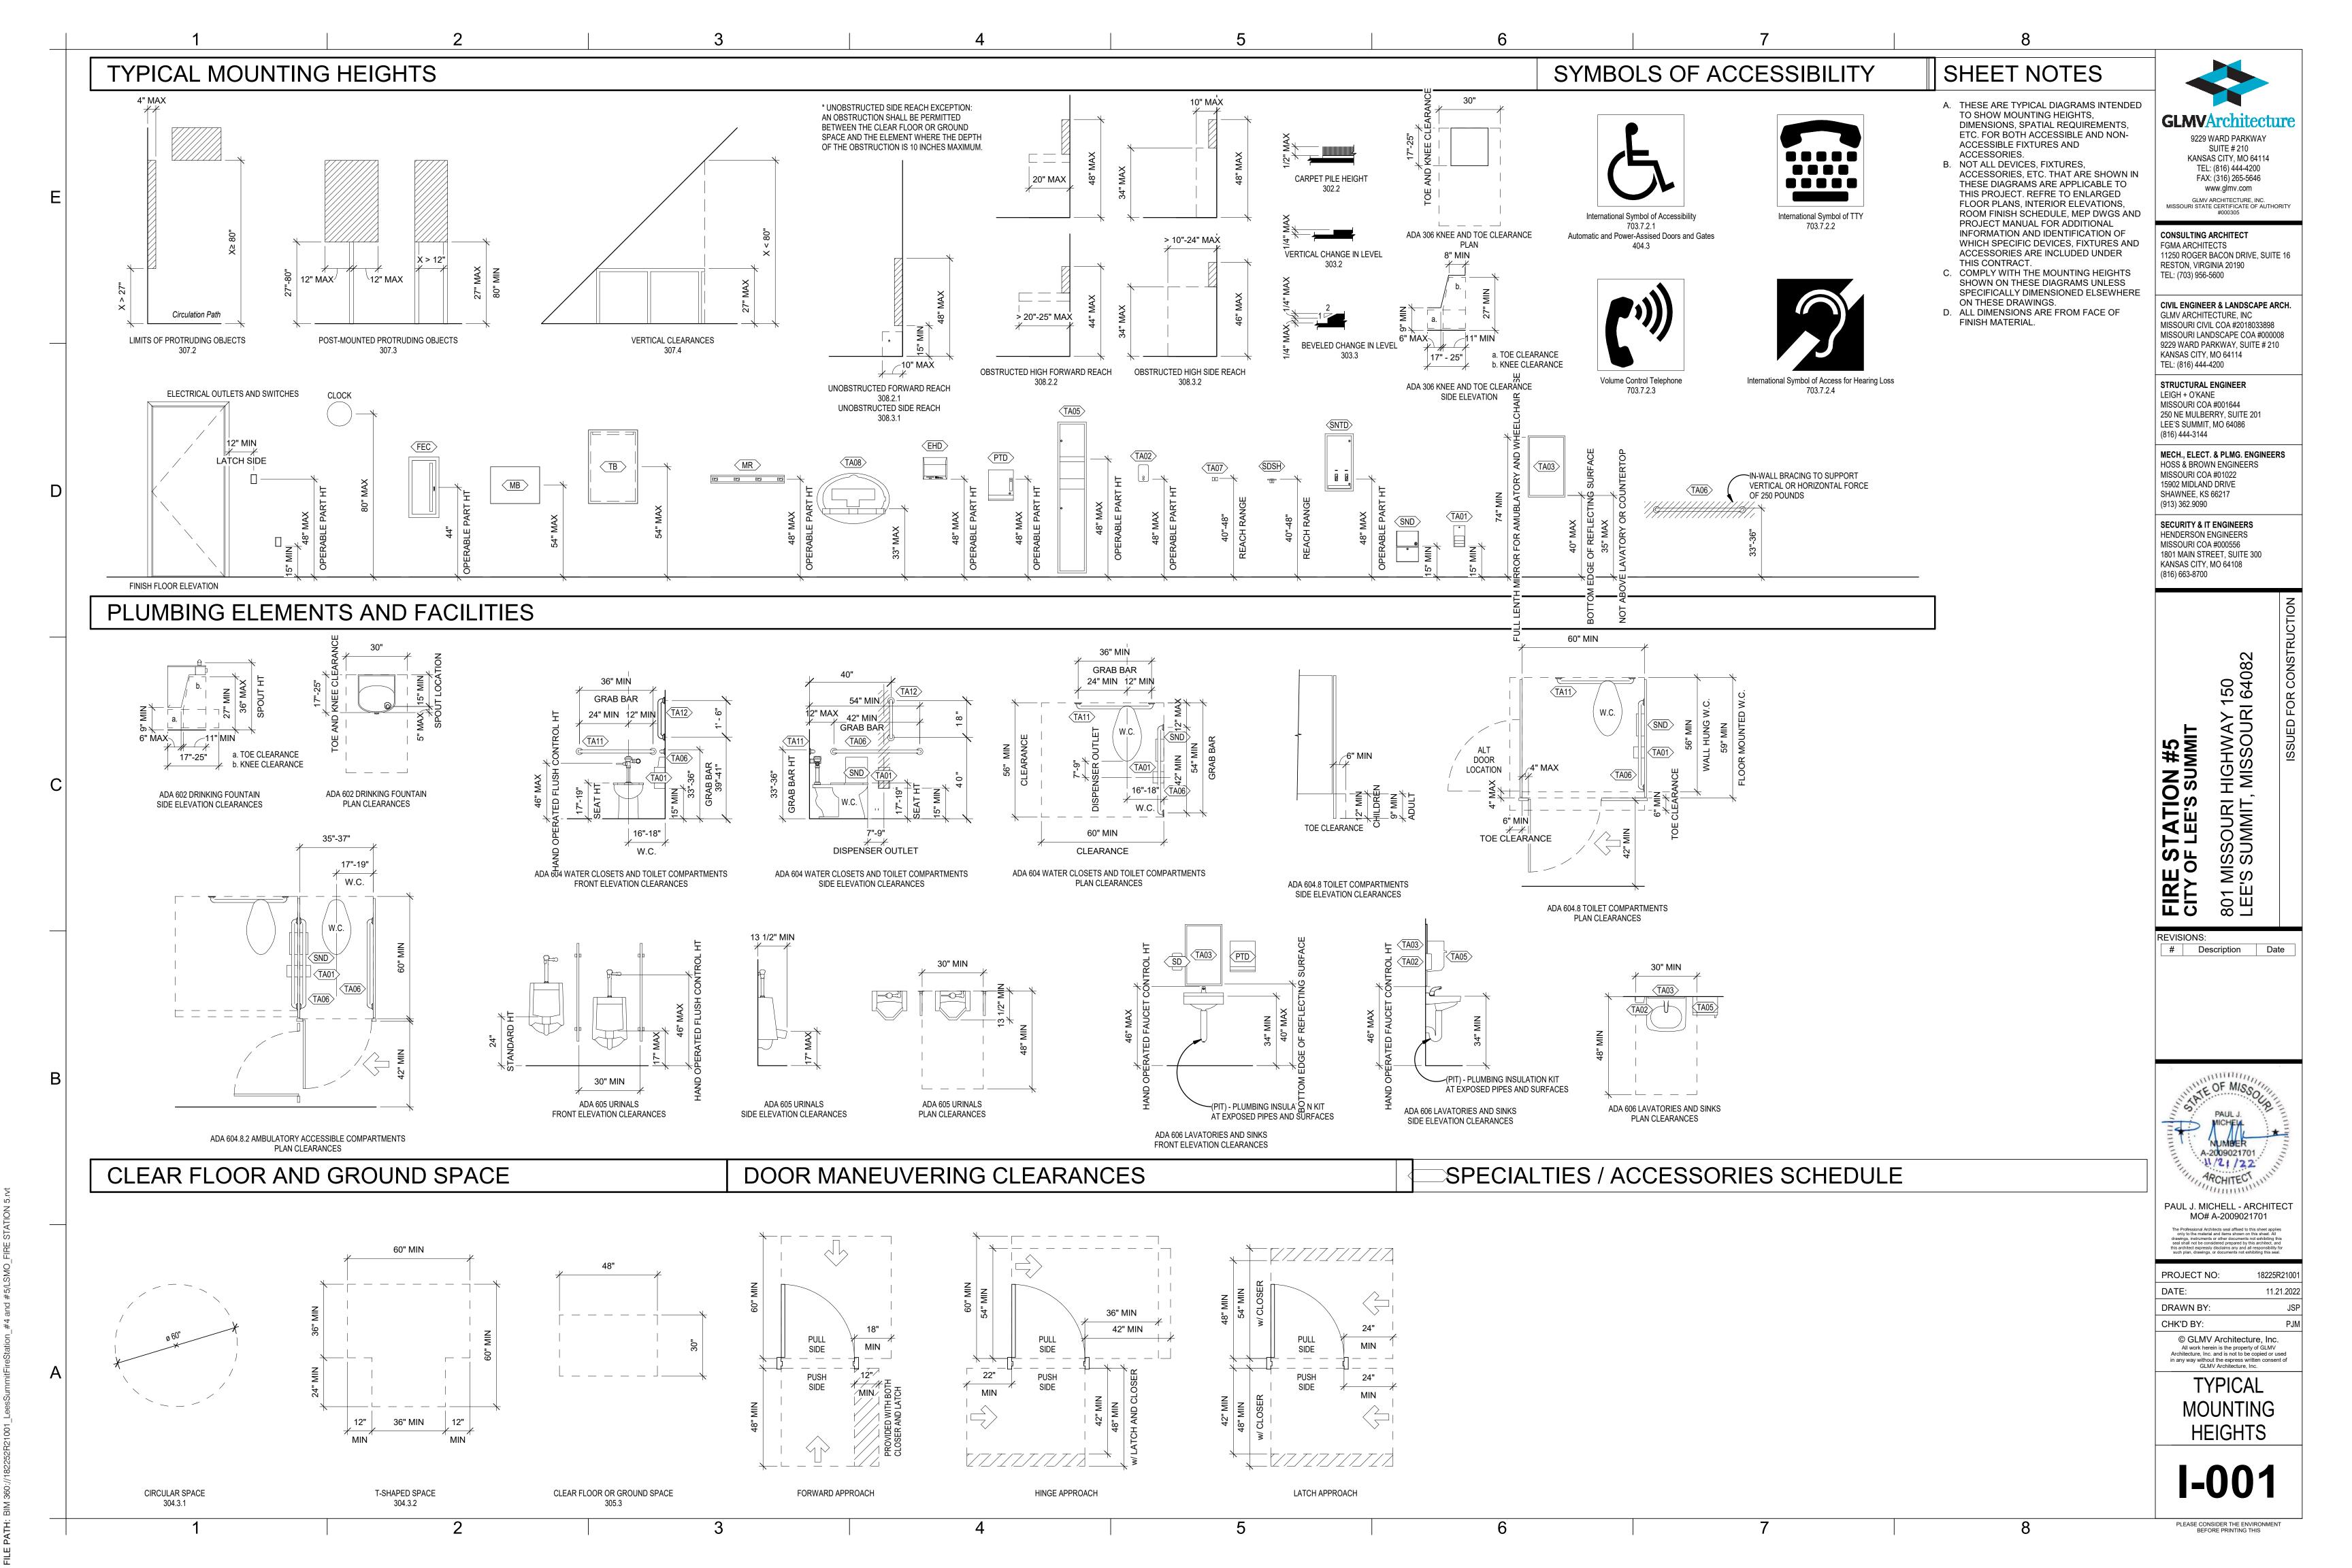

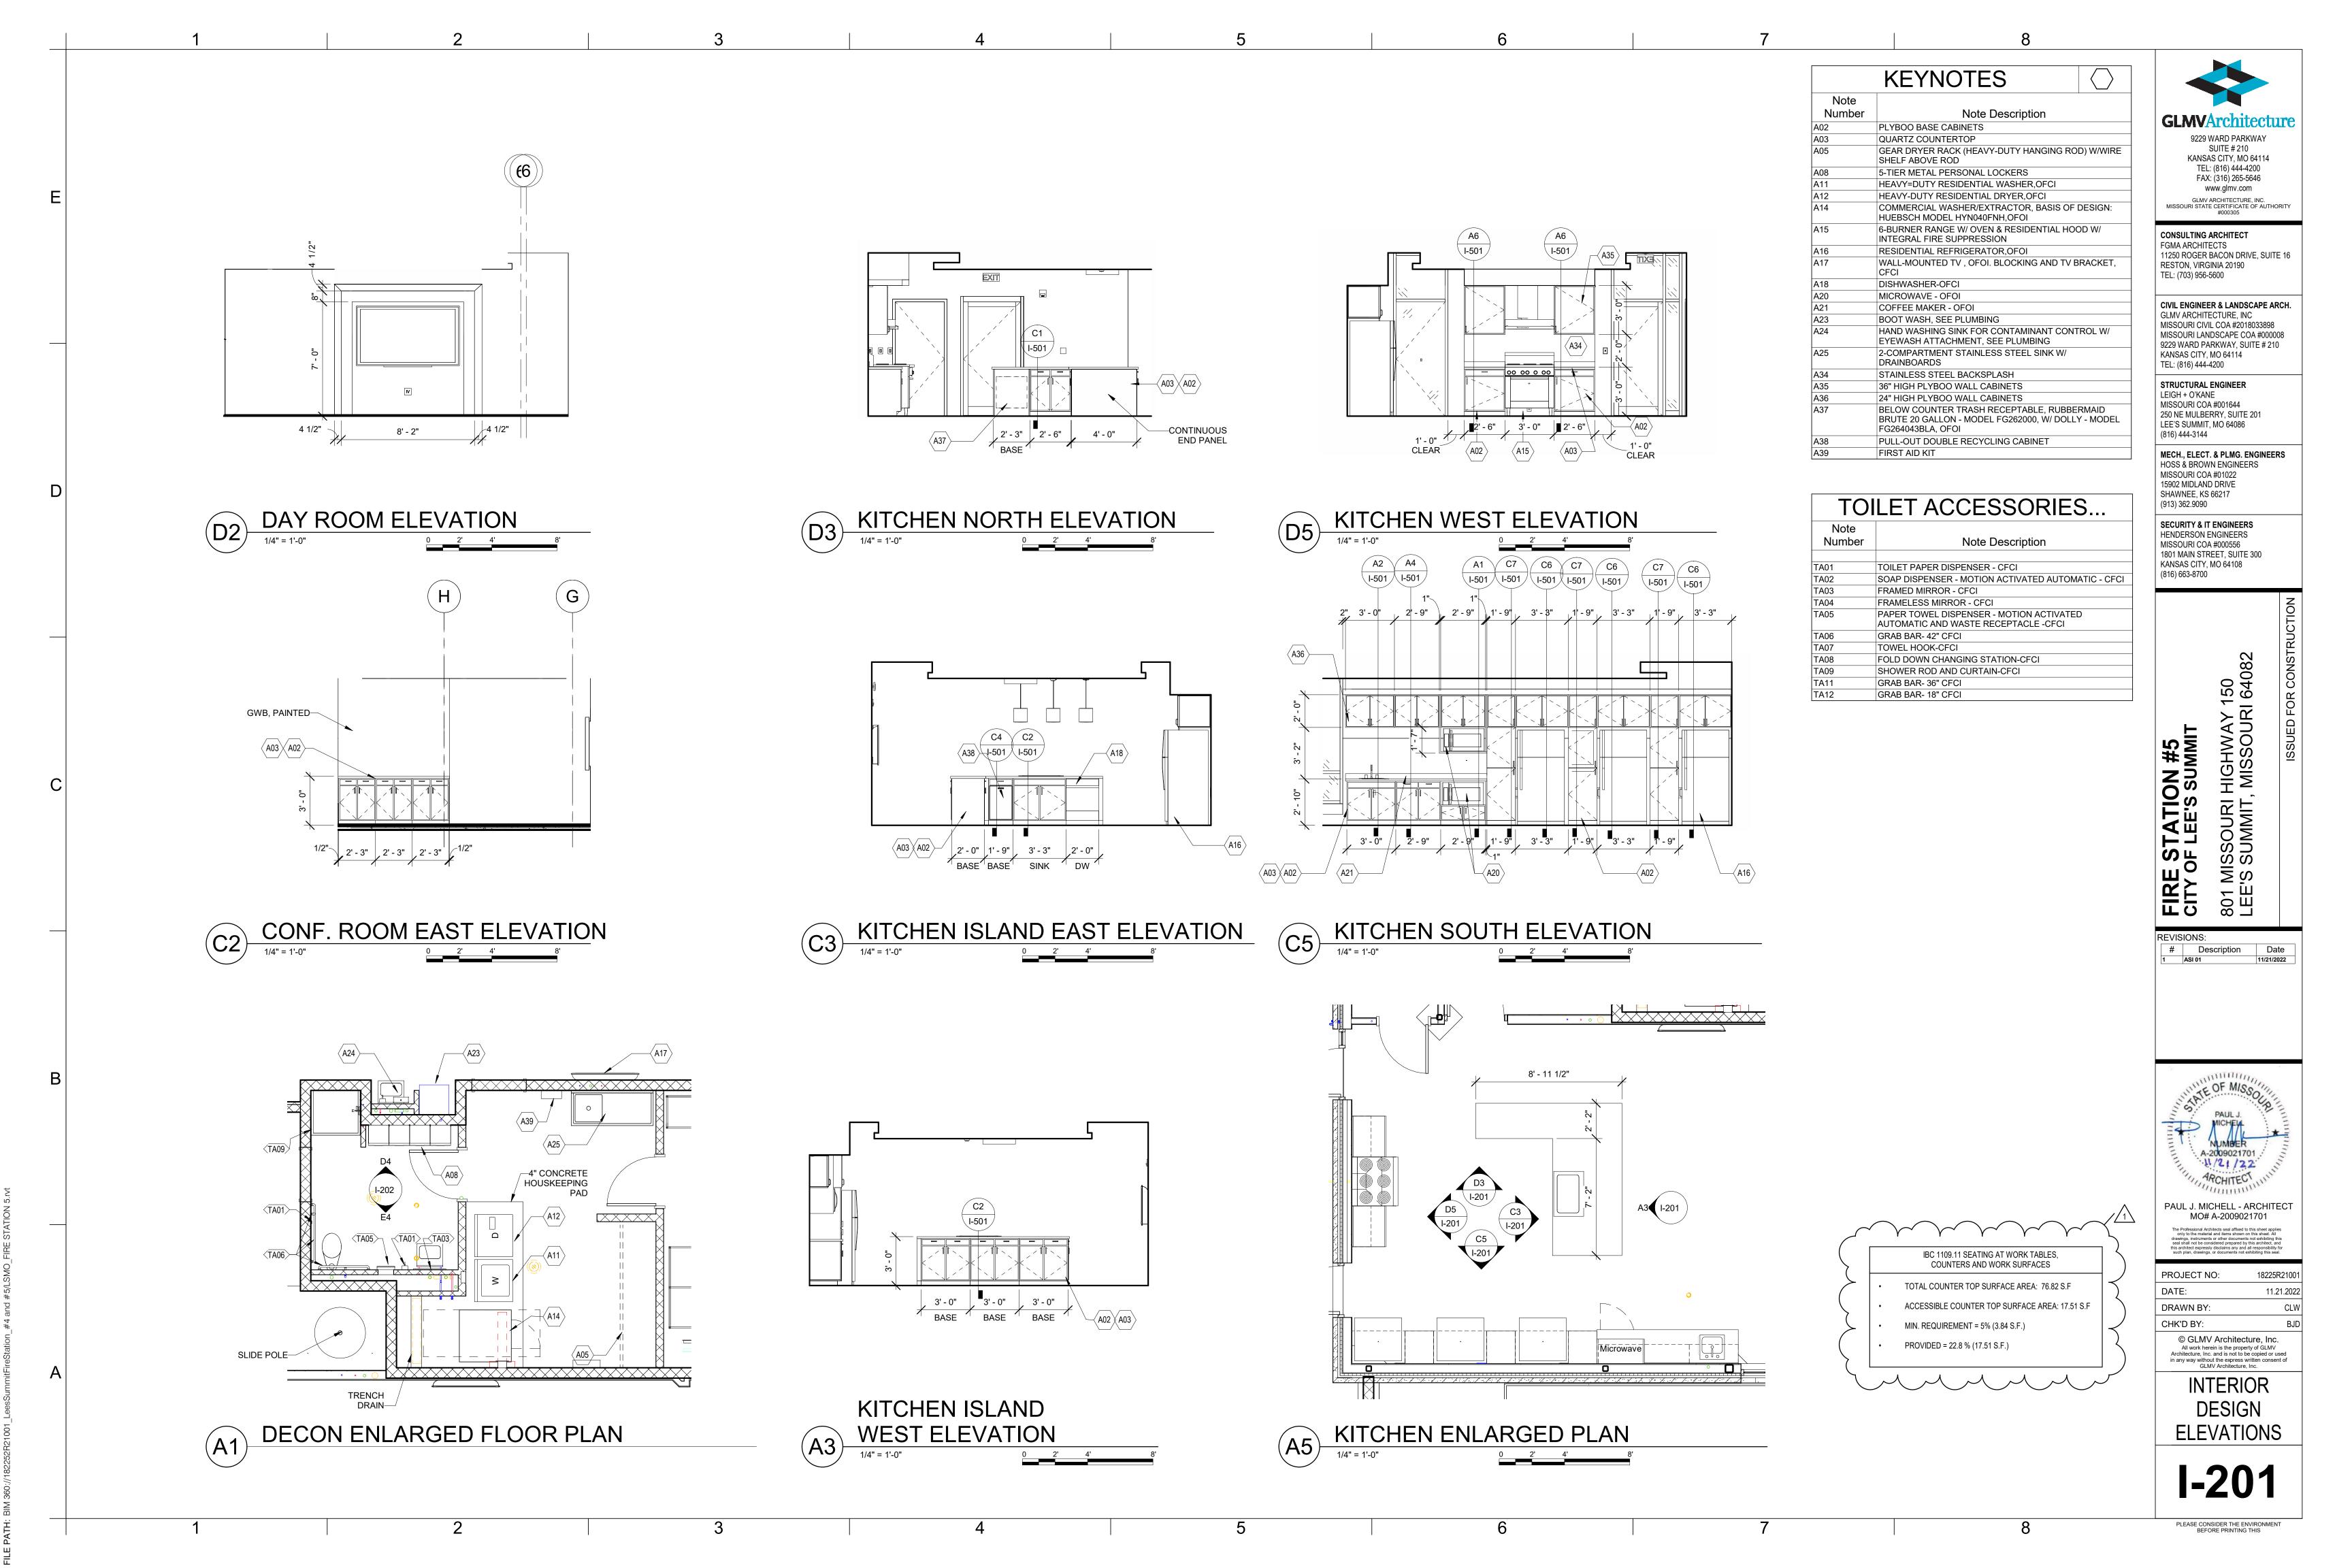

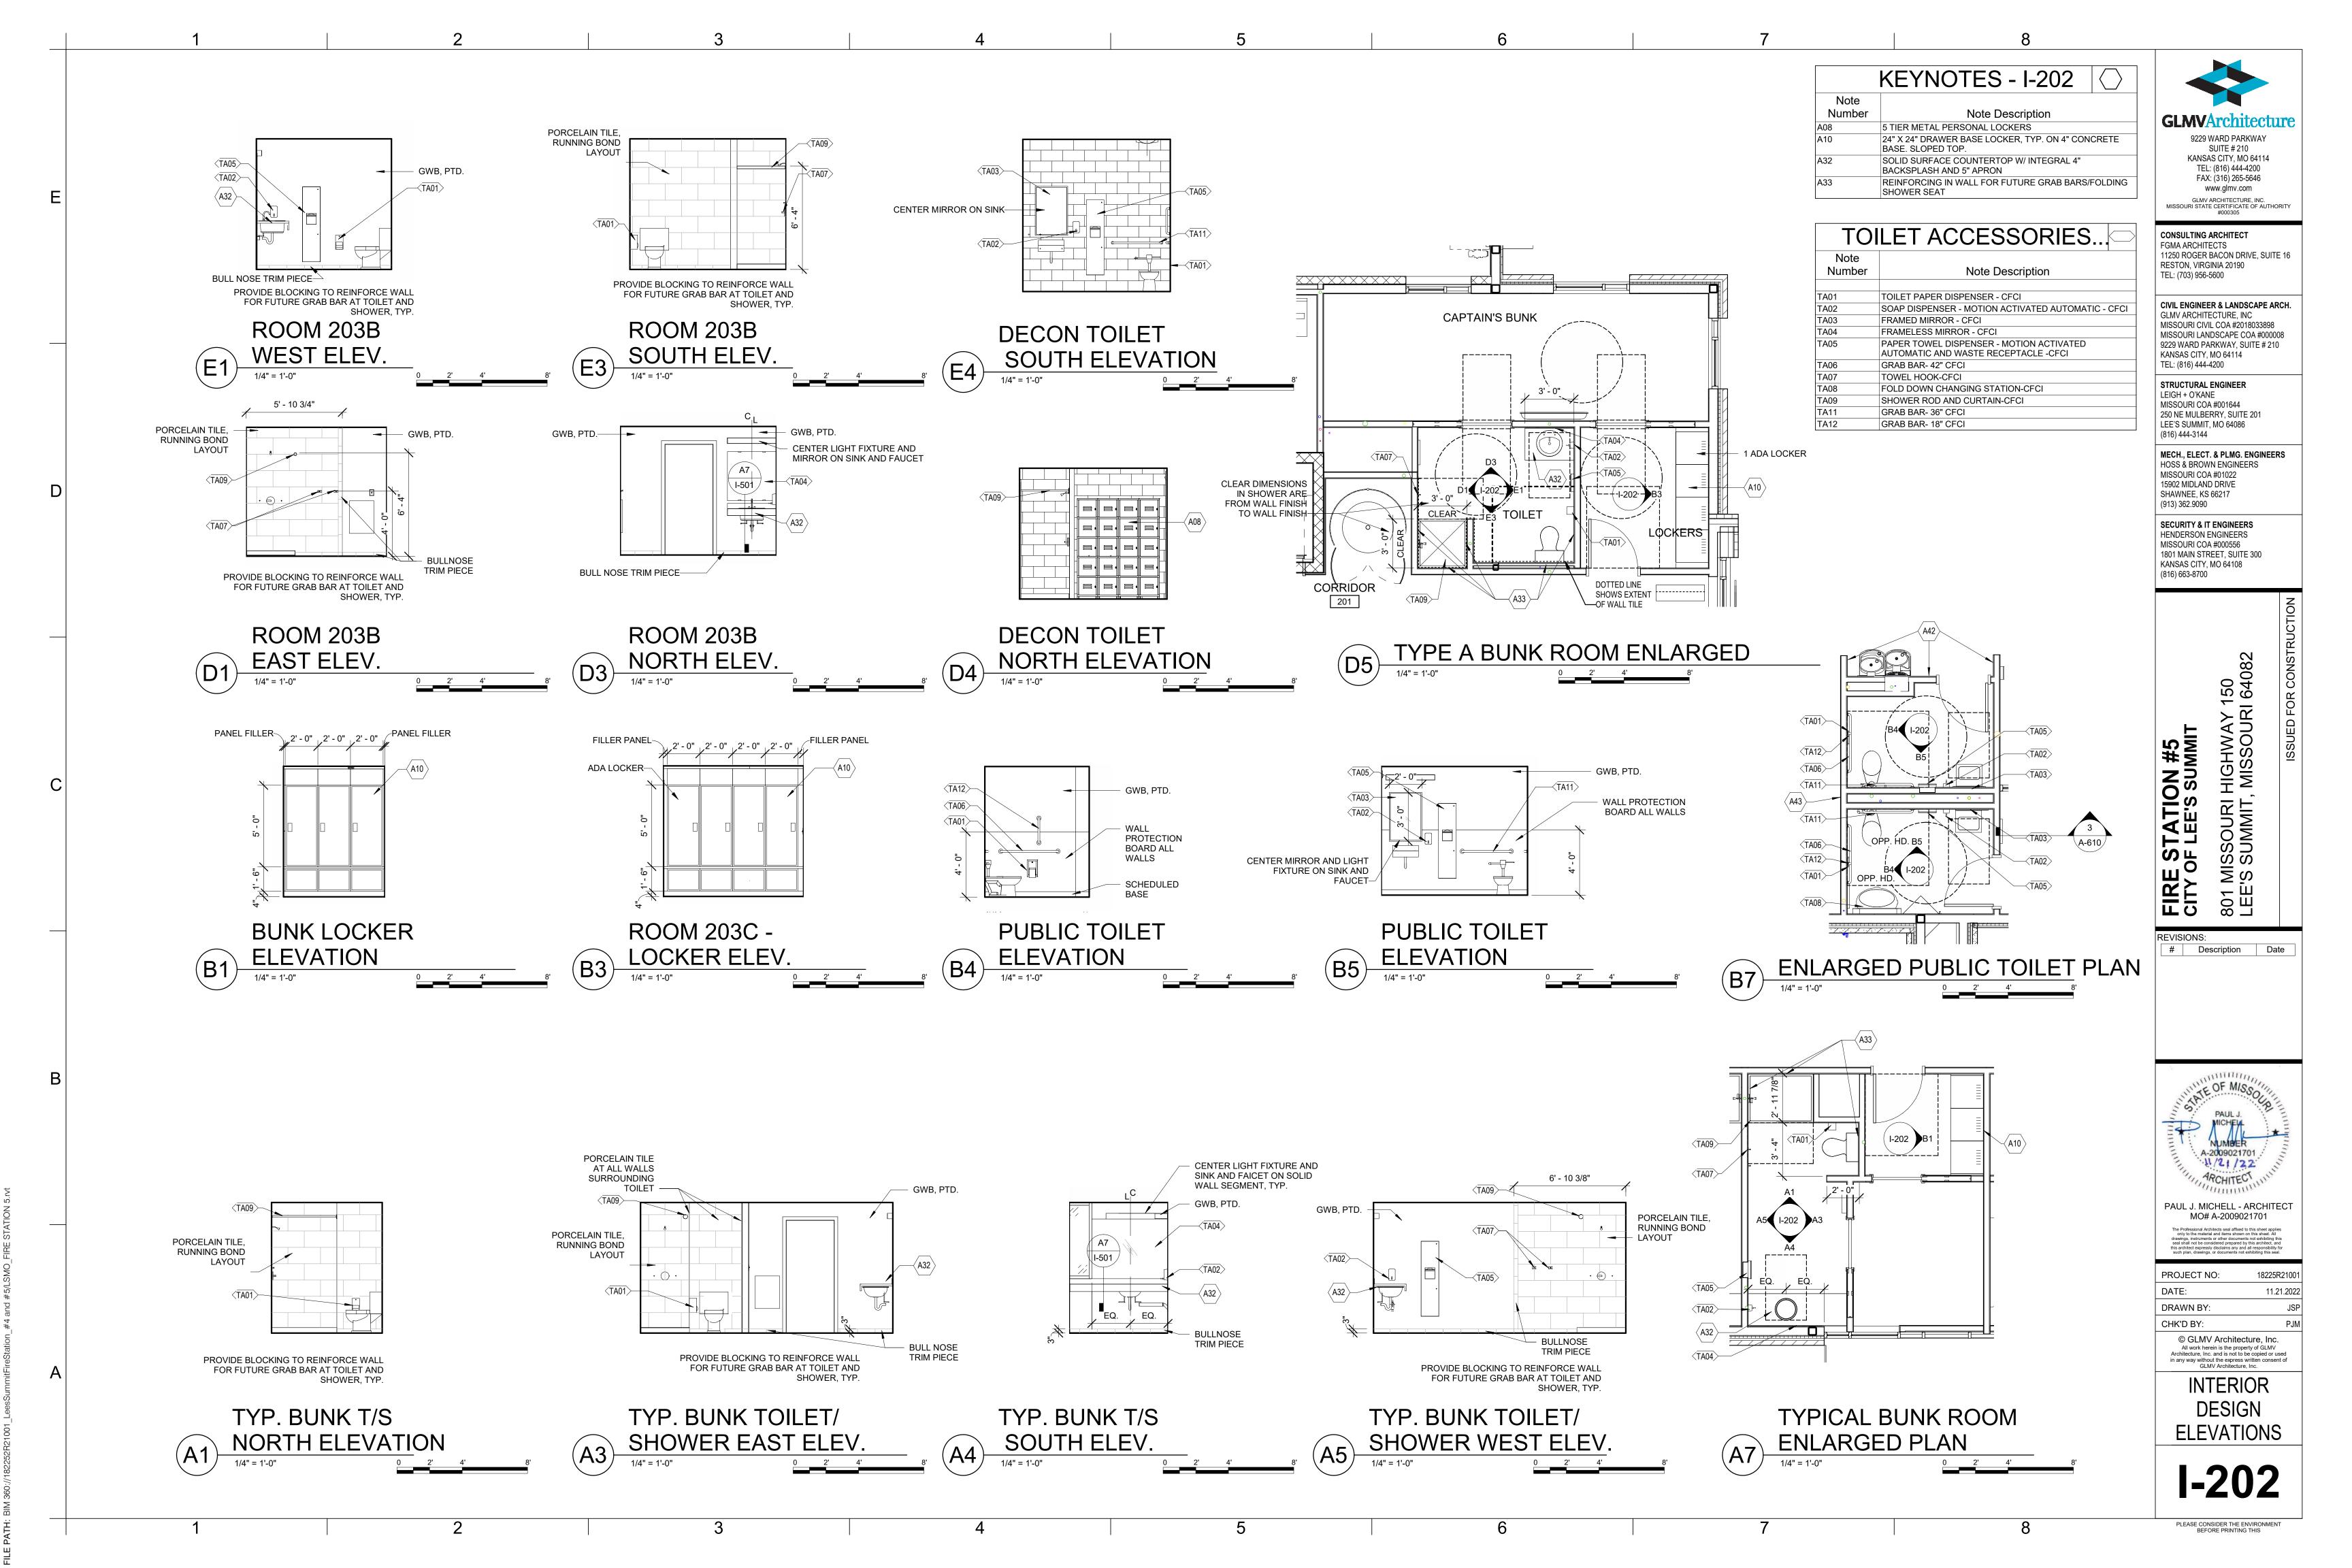

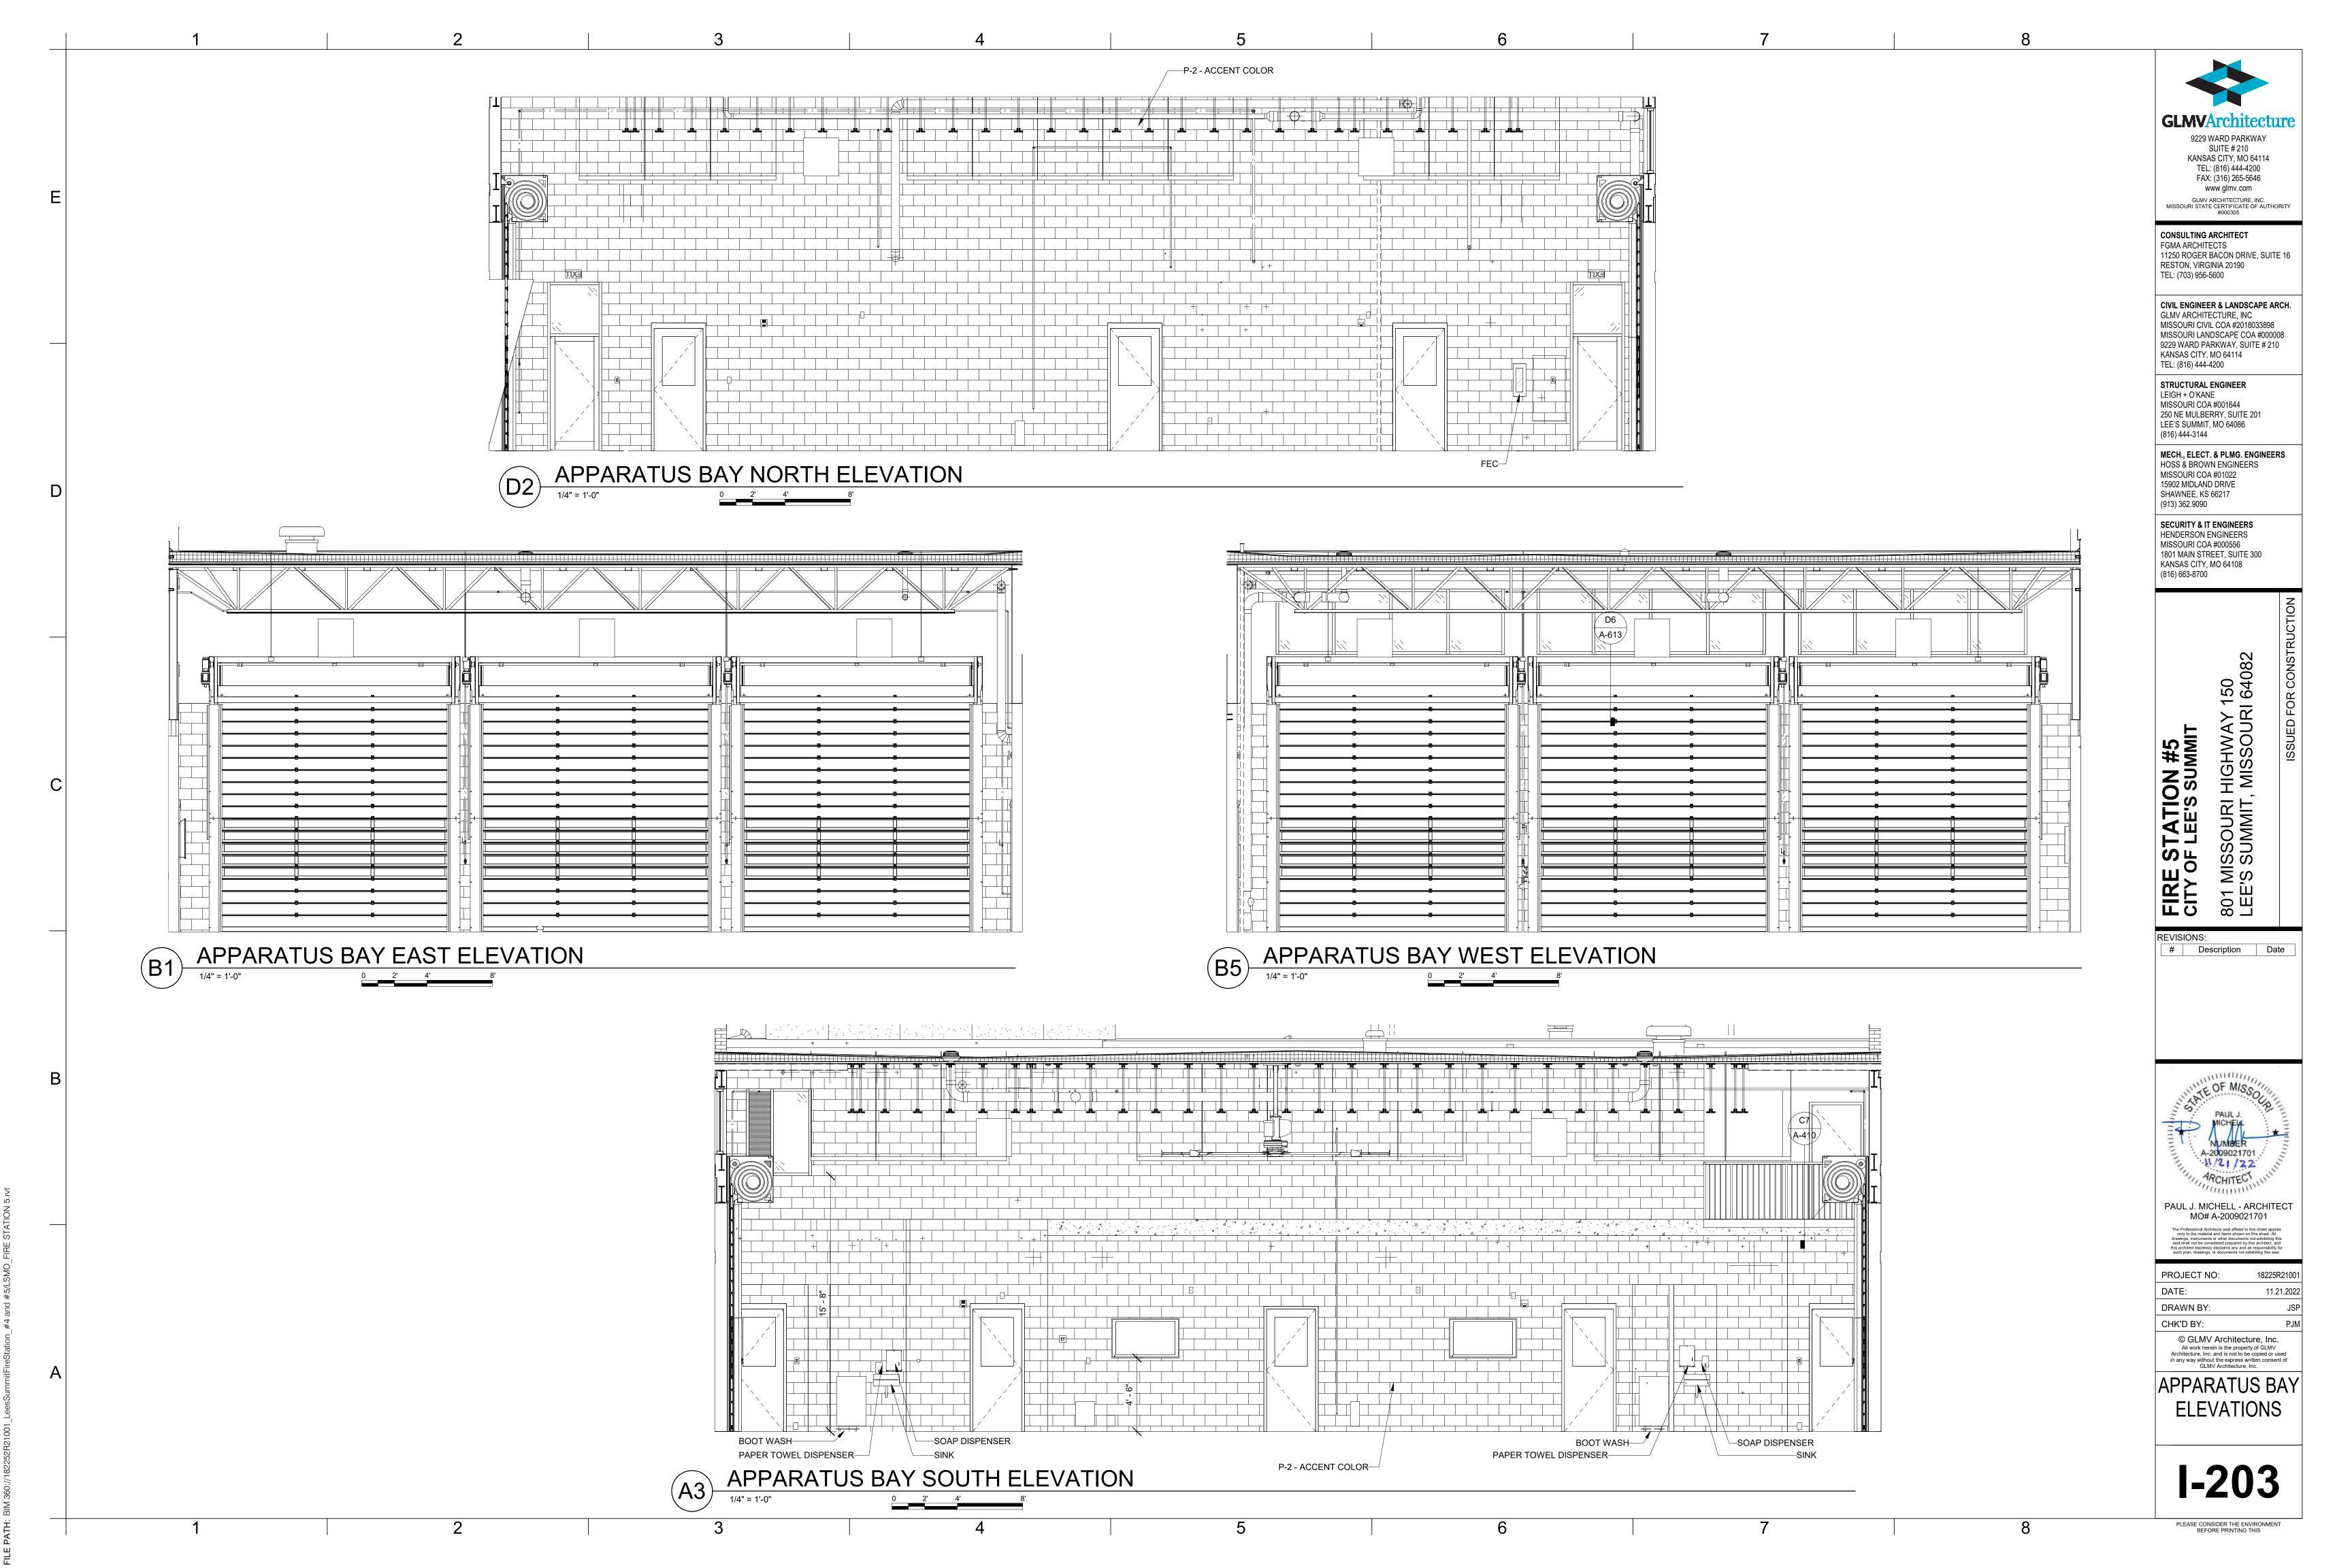

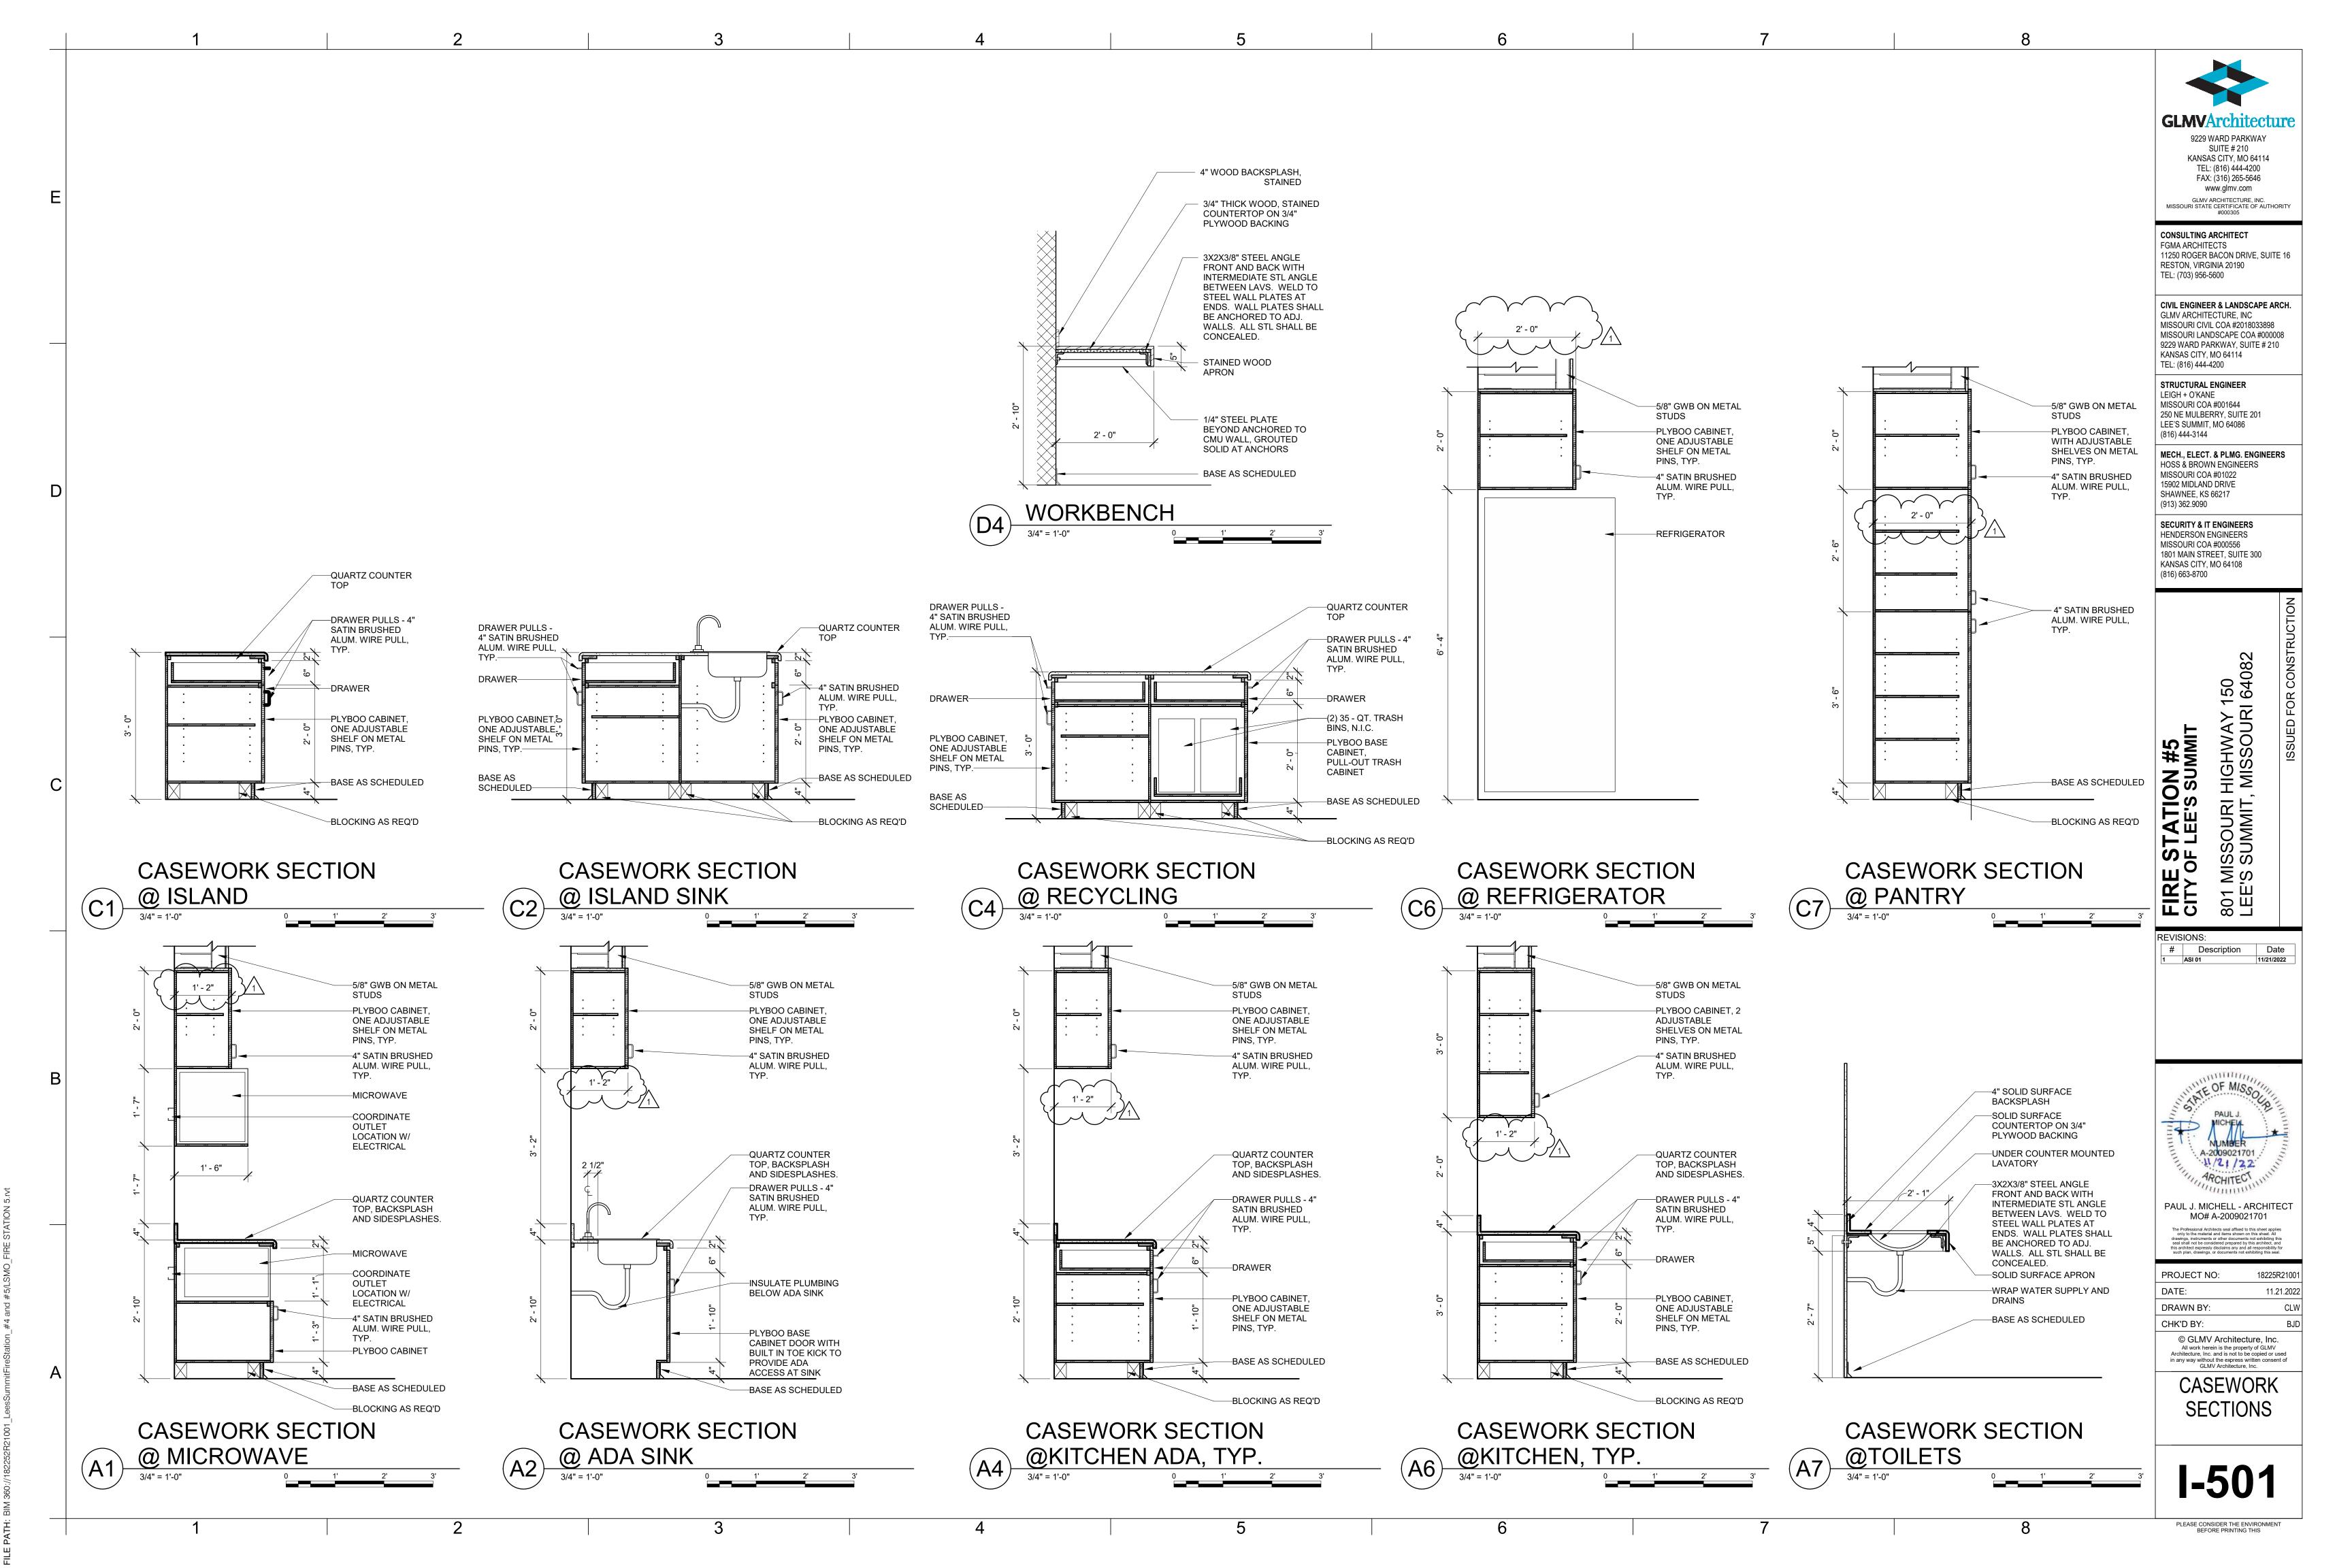

	1	2		3			4			5				6			7	7	8
							OM NO.	NAME	FLOOR	BASE TYPE/ FINISH	NORTH MAT. / FIN.	EAST MAT. / FIN.	SOUTH MAT. / FIN.	WEST MAT. / FIN.	CEILING	IR WET	REMARK	is .	ROOM FINISH C
						100	E V F	ENTRY /EST. PUBLIC	POLISHED CONC POLISHED CONC	RB ∤RB	GWB/PTD	GWB/PTD	GWB/PTD	GWB/PTD	GWB/PTD	PRO	TECTION BOARD ON	N WET WALL	GENERAL NOTES:  1. ALL FLOOR FINISHES TO EXTEND UND
						103	Δ	ADMIN.	POLISHED CONC	RB	GWB/PTD	GWB/PTD	GWB/PTD	GWB/PTD	ACT		TECTION BOARD ON		FURNITURE  2. ALL EXPOSED STRUCTURE IS TO BE P  3. PROVIDE WINDOW TREATMENTS AT A WINDOWS AND/OR STOREFRONT GLAZI
E						105	F	RADIO CONF. RM.	CPT	RB RB	GWB/PTD	GWB/PTD	GWB/PTD	GWB/PTD	EXP/PTD ACT				SECTIONS 4. ALL WALL/CEILING/EXPOSED STRUCT COLORS TO BE P-1 U.N.O. REFER TO FIN
						107 108 109	C	ELEV CAPTAIN'S OFFICE RAMP	CPT SC	RB RB	GWB/PTD CMU/PTD	GWB/PTD CMU/PTD	GWB/PTD GWB/PTD	GWB/PTD CMU/PTD	ACT EXP/PTD				EXTENT OF ACCENT WALL COLORS 5. ALL TILED WALLS TO USE GLASS MAT 6. ALL ROOMS MARKED "WET" ARE TO R
						110 111 112	F	EMS STOR. PPE / LOCKERS DECON	SC SC SC	RB RB RB	CMU/PTD CMU/PTD CMU/ EPOXY	CMU/PTD CMU/PTD	GWB/PTD CMU/PTD CMU/ FPOXY	CMU/PTD CMU/PTD CMU/ EPOXY	EXP/PTD EXP/PTD EXP/PTD				RESISTANT GWB 7. ALL ROOMS MARKED "IR" ARE TO REC RESISTANT TYPE 'X' GWB
						113		DECON TOIL.	SC	RB	PTD  CMU/ EPOXY PTD	PTD	PTD	PTD  CMU/ EPOXY PTD					
						114 115 116	J	RAMP JAN. KITCHEN	SC POLISHED CONC	RB RB	CMU/PTD  GWB/PTD	GWB/PTD GWB/PTD	GWB/PTD	CMU/PTD GWB/PTD	EXP/PTD  ACT DECORATIVE				FINISH SCHEDULE LEGEND:
						117 118		DINING DAY ROOM APPARATUS BAY	POLISHED CONC CPT SC		GWB/PTD GWB/PTD CMU/PTD	GWB/PTD GWB/PTD CMU/PTD	GWB/PTD GWB/PTD CMU/PTD	GWB/PTD GWB/PTD CMU/PTD	ACT DECORATIVE ACT DECORATIVE EXP/PTD				ACT ACOUSTICAL CEILING TILE CPT CARPET TILE CMU CONCRETE MASONRY UNIT
						120 121	U	JTILITY SHOP	SC SC	-	CMU/PTD CMU/PTD	CMU/PTD CMU/PTD	CMU/PTD CMU/PTD	CMU/PTD CMU/PTD	EXP/PTD EXP/PTD				EXP EXPOSED STRUCTURE GWB GYPSUM WALL BOARD HPC HIGH PERFORMANCE COATING
						200 201	S	EXERCISE / WELLNESS STAIR CORRIDOR	RT CPT	RB RB	CMU/PTD GWB/PTD GWB/PTD	CMU/PTD GWB/PTD GWB/PTD	CMU/PTD GWB/PTD GWB/PTD	CMU/PTD GWB/PTD GWB/PTD	ACT ACT ACT	COR	RRIDOR WALLS TO RE	ECEIVE CORNER	IR IMPACT RESISTANT PC POLISHED CONCRETE PT PORCELAIN TILE
						202 202A	В	LOCKERS	CPT CPT	RB RB	GWB/PTD GWB/PTD	GWB/PTD GWB/PTD	GWB/PTD GWB/PTD	GWB/PTD GWB/PTD	ACT ACT	GUA	IRDS		PTD PAINTED RAF RESILIENT ATHLETIC FLOOR RF RUBBER FLOORING RT RUBBER TREAD
D						202B 203 203A	L	COILET  LOCKERS  CAPTAIN'S BUNK	PT CPT CPT	PT RB RB	PT GWB/PTD GWB/PTD	GWB/PTD/PT GWB/PTD GWB/PTD	GWB/PTD GWB/PTD	GWB/PTD/PT GWB/PTD GWB/PTD	GWB/PTD ACT ACT				RB RUBBER BASE SC SEALED CONCRETE
						203B 204 205	N	TOILET MEZZANINE LAUNDRY/JAN.	PT PT	PT PT	GWB/PTD	GWB/PTD/PT GWB/PTD	PT CMU/PTD	GWB/PTD CMU/GWB/PT	GWB/PTD  D ACT				
						206 207	N G	MECH. GENERAL STORAGE	SC SC	- RB	CMU/PTD GWB/PTD	GWB/PTD GWB/PTD	CMU/PTD CMU/PTD	GWB/PTD GWB/PTD	-				
						208 208A 208B	L	OCKERS BUNK FOILET	CPT CPT PT	RB RB	GWB/PTD GWB/PTD GWB/PTD	GWB/PTD GWB/PTD/PT	GWB/PTD GWB/PTD	GWB/PTD GWB/PTD GWB/PTD/PT	ACT ACT				
						209 209A	L B	OCKERS BUNK	CPT CPT PT	RB RB	GWB/PTD GWB/PTD	GWB/PTD GWB/PTD	GWB/PTD GWB/PTD	GWB/PTD GWB/PTD	ACT ACT				
						209B 210 210A	L B	FOILET LOCKERS BUNK	CPT CPT	PT RB RB	PT GWB/PTD GWB/PTD	GWB/PTD/PT GWB/PTD GWB/PTD	GWB/PTD GWB/PTD	GWB/PTD GWB/PTD	ACT ACT				
						210B 211 211A	L	FOILET LOCKERS BUNK	PT CPT CPT	PT RB RB	PT GWB/PTD GWB/PTD	GWB/PTD/PT GWB/PTD GWB/PTD	GWB/PTD GWB/PTD GWB/PTD	GWB/PTD/PT GWB/PTD GWB/PTD	ACT ACT				
						211B 212 212A	L	TOILET LOCKERS BUNK	PT CPT CPT	PT RB RB	PT GWB/PTD GWB/PTD	GWB/PTD/PT GWB/PTD GWB/PTD	GWB/PTD GWB/PTD	GWB/PTD/PT GWB/PTD GWB/PTD	GWB/PTD ACT ACT				
						212B 213 213A	L	TOILET LOCKERS BUNK	PT CPT CPT	PT RB RB	PT GWB/PTD GWB/PTD	GWB/PTD/PT GWB/PTD GWB/PTD	GWB/PTD GWB/PTD GWB/PTD	GWB/PTD/PT GWB/PTD GWB/PTD	GWB/PTD ACT ACT				
С						213B		FOILET	PT	PT	PT	GWB/PTD/PT		GWB/PTD/PT					
В																			
A																			
					ı														

5

2

# SH CODE

XTEND UNDER MOVEABLE

E IS TO BE PAINTED U.N.O. IMENTS AT ALL EXTERIOR RONT GLAZING SYSTEM

SED STRUCTURE PAINT EFER TO FINISH PLANS FOR GLASS MAT BOARD T" ARE TO RECEIVE WATER ARE TO RECEIVE 5/8" IMPACT

9229 WARD PARKWAY

SUITE # 210 KANSAS CITY, MO 64114 TEL: (816) 444-4200 FAX: (316) 265-5646 www.glmv.com GLMV ARCHITECTURE, INC. MISSOURI STATE CERTIFICATE OF AUTHORITY #000305

# CONSULTING ARCHITECT FGMA ARCHITECTS 11250 ROGER BACON DRIVE, SUITE 16 RESTON, VIRGINIA 20190 TEL: (703) 956-5600

CIVIL ENGINEER & LANDSCAPE ARCH.
GLMV ARCHITECTURE, INC
MISSOURI CIVIL COA #2018033898
MISSOURI LANDSCAPE COA #0000008

9229 WARD PARKWAY, SUITE # 210 KANSAS CITY, MO 64114 TEL: (816) 444-4200 STRUCTURAL ENGINEER LEIGH + O'KANE MISSOURI COA #001644

250 NE MULBERRY, SUITE 201 LEE'S SUMMIT, MO 64086 (816) 444-3144

MECH., ELECT. & PLMG. ENGINEERS
HOSS & BROWN ENGINEERS
MISSOURI COA #01022
15902 MIDLAND DRIVE SHAWNEE, KS 66217 (913) 362.9090


SECURITY & IT ENGINEERS
HENDERSON ENGINEERS
MISSOURI COA #000556 1801 MAIN STREET, SUITE 300 KANSAS CITY, MO 64108 (816) 663-8700

RI HIGHWAY 150 IIT, MISSOURI 64082

FIRE STATION #5
CITY OF LEE'S SUMMIT 801 MISSOUF LEE'S SUMMI

REVISIONS:

# Description Date
6 ASI 06 02/22/2023

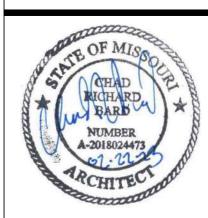


CHAD R. BARD - ARCHITECT MO# A-2018024473


PROJECT NO:	18225R21001
DATE:	02.22.2023
DRAWN BY:	KSk
CHK'D BY:	PJM
© GLMV Archit All work herein is the p Architecture, Inc. and is not in any way without the expre GLMV Architecture.	roperty of GLMV t to be copied or used ess written consent of


FINISH SCHEDULE


**I-601** 

8

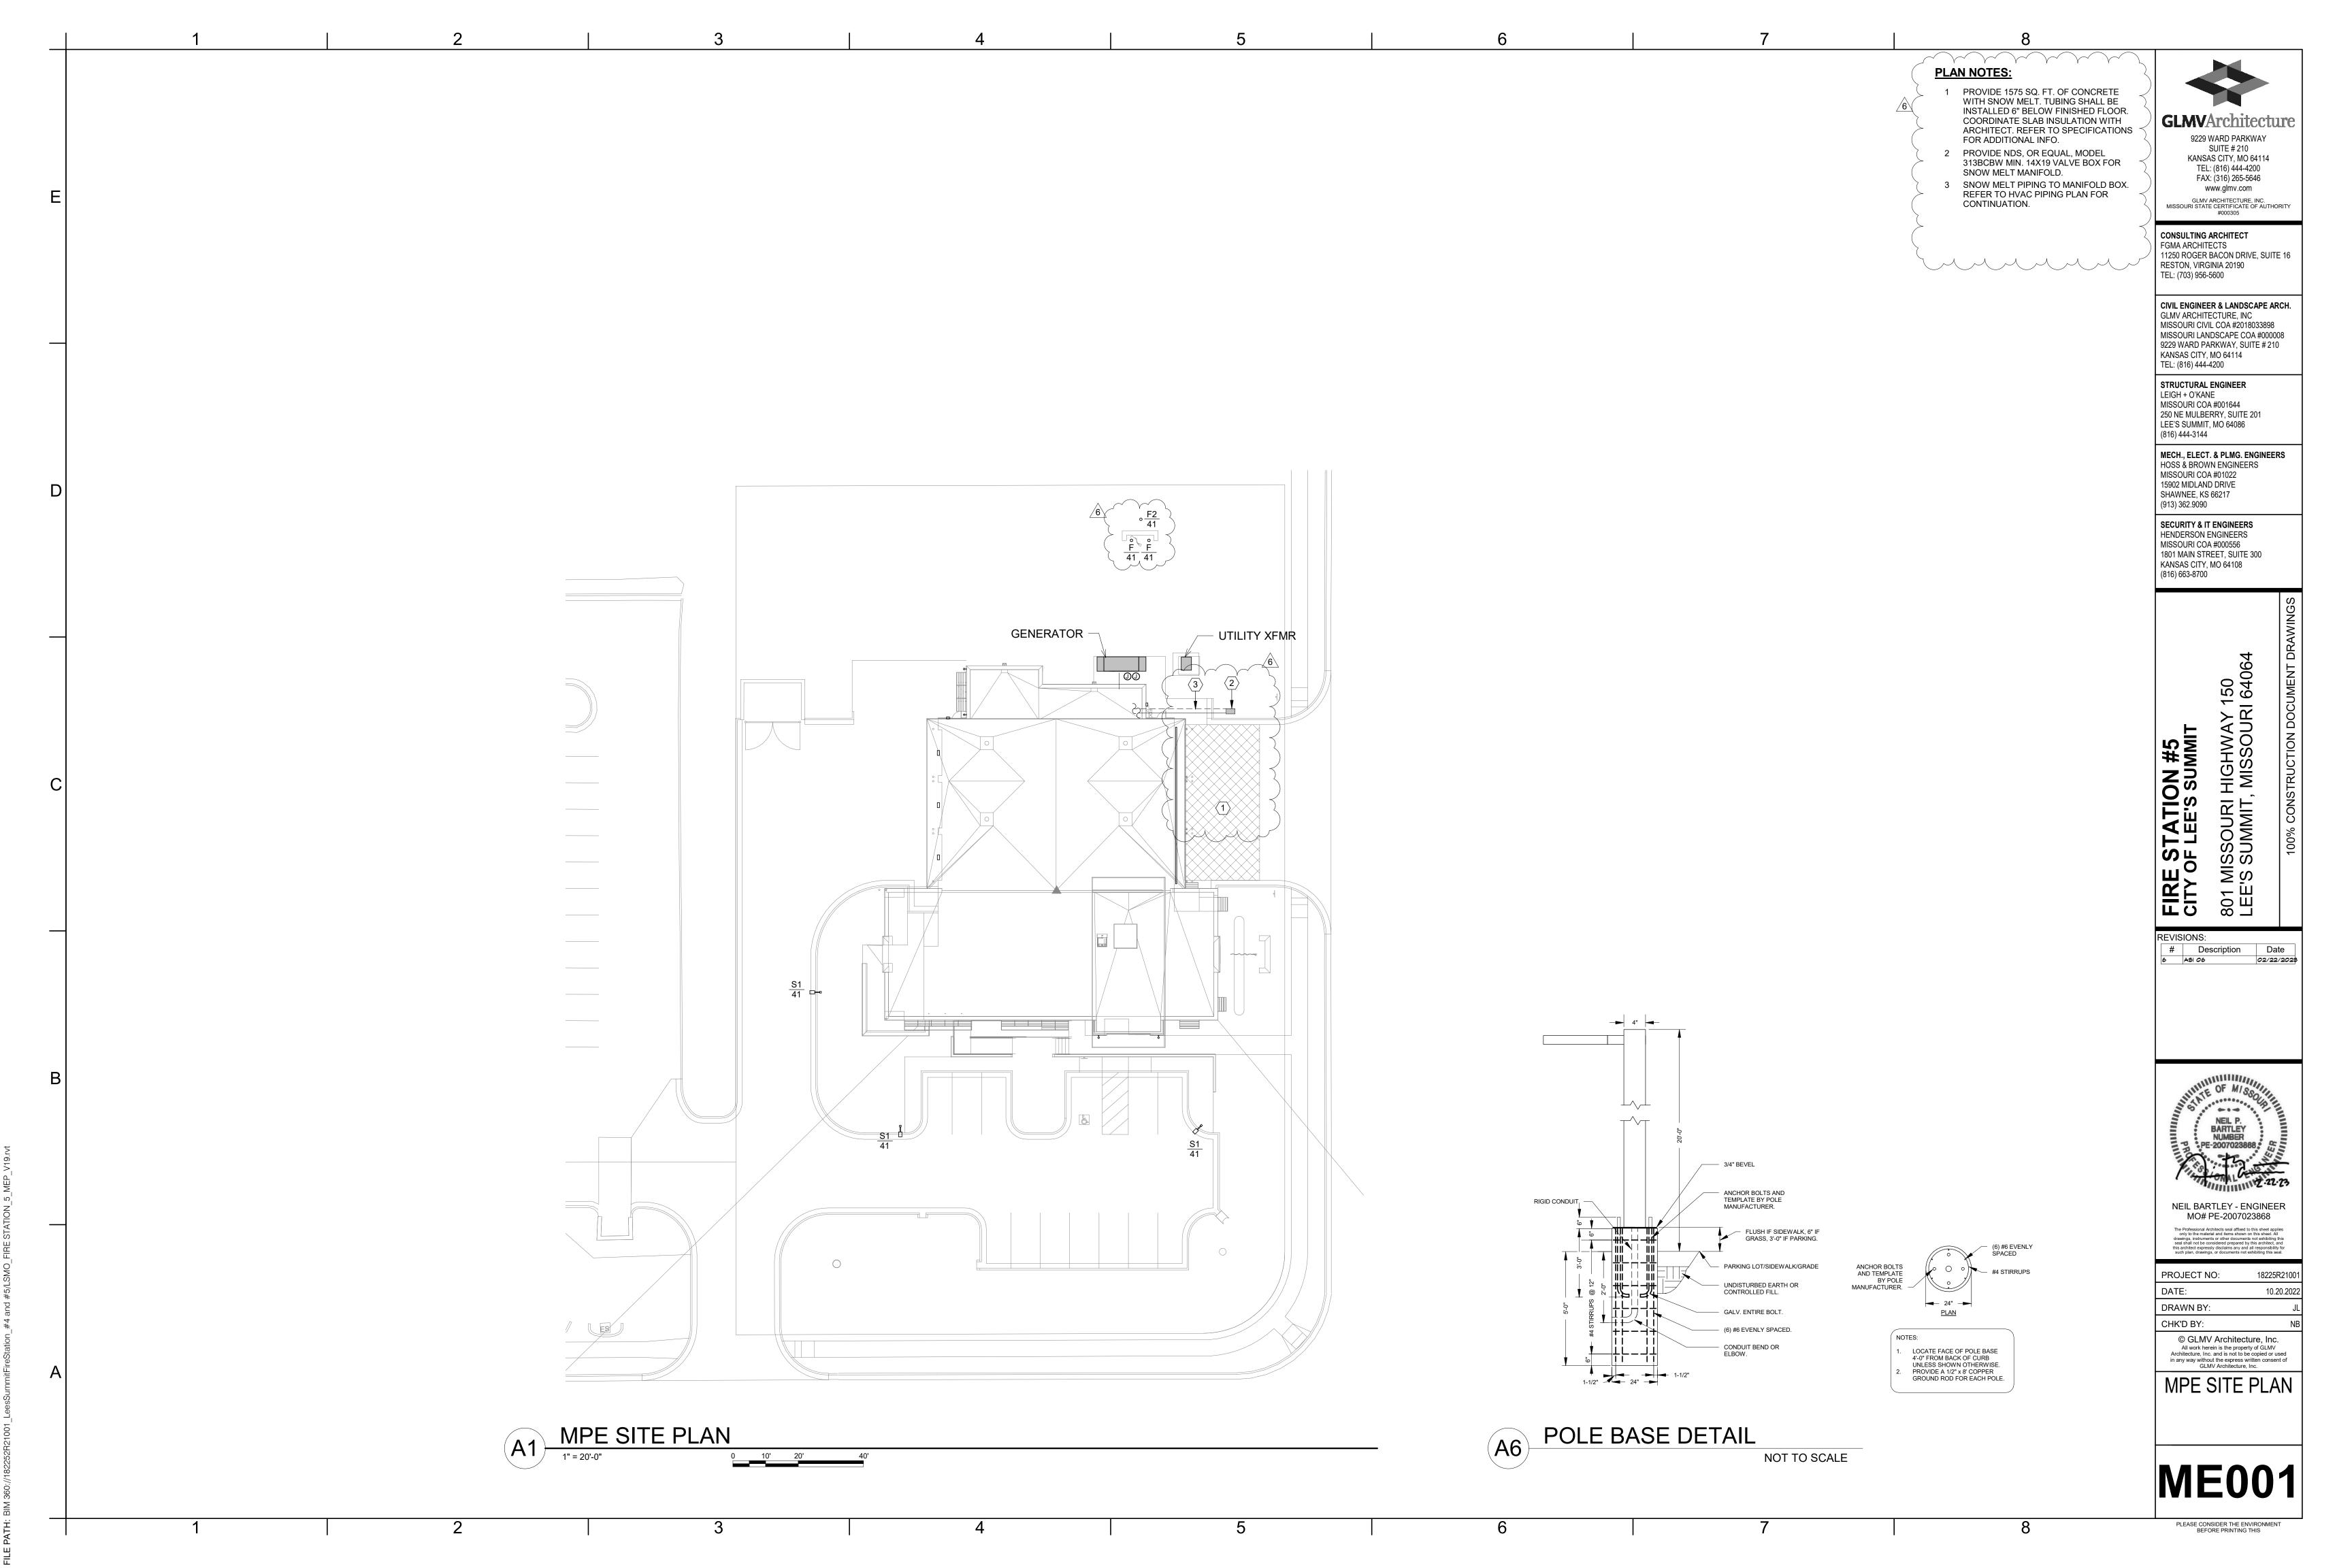

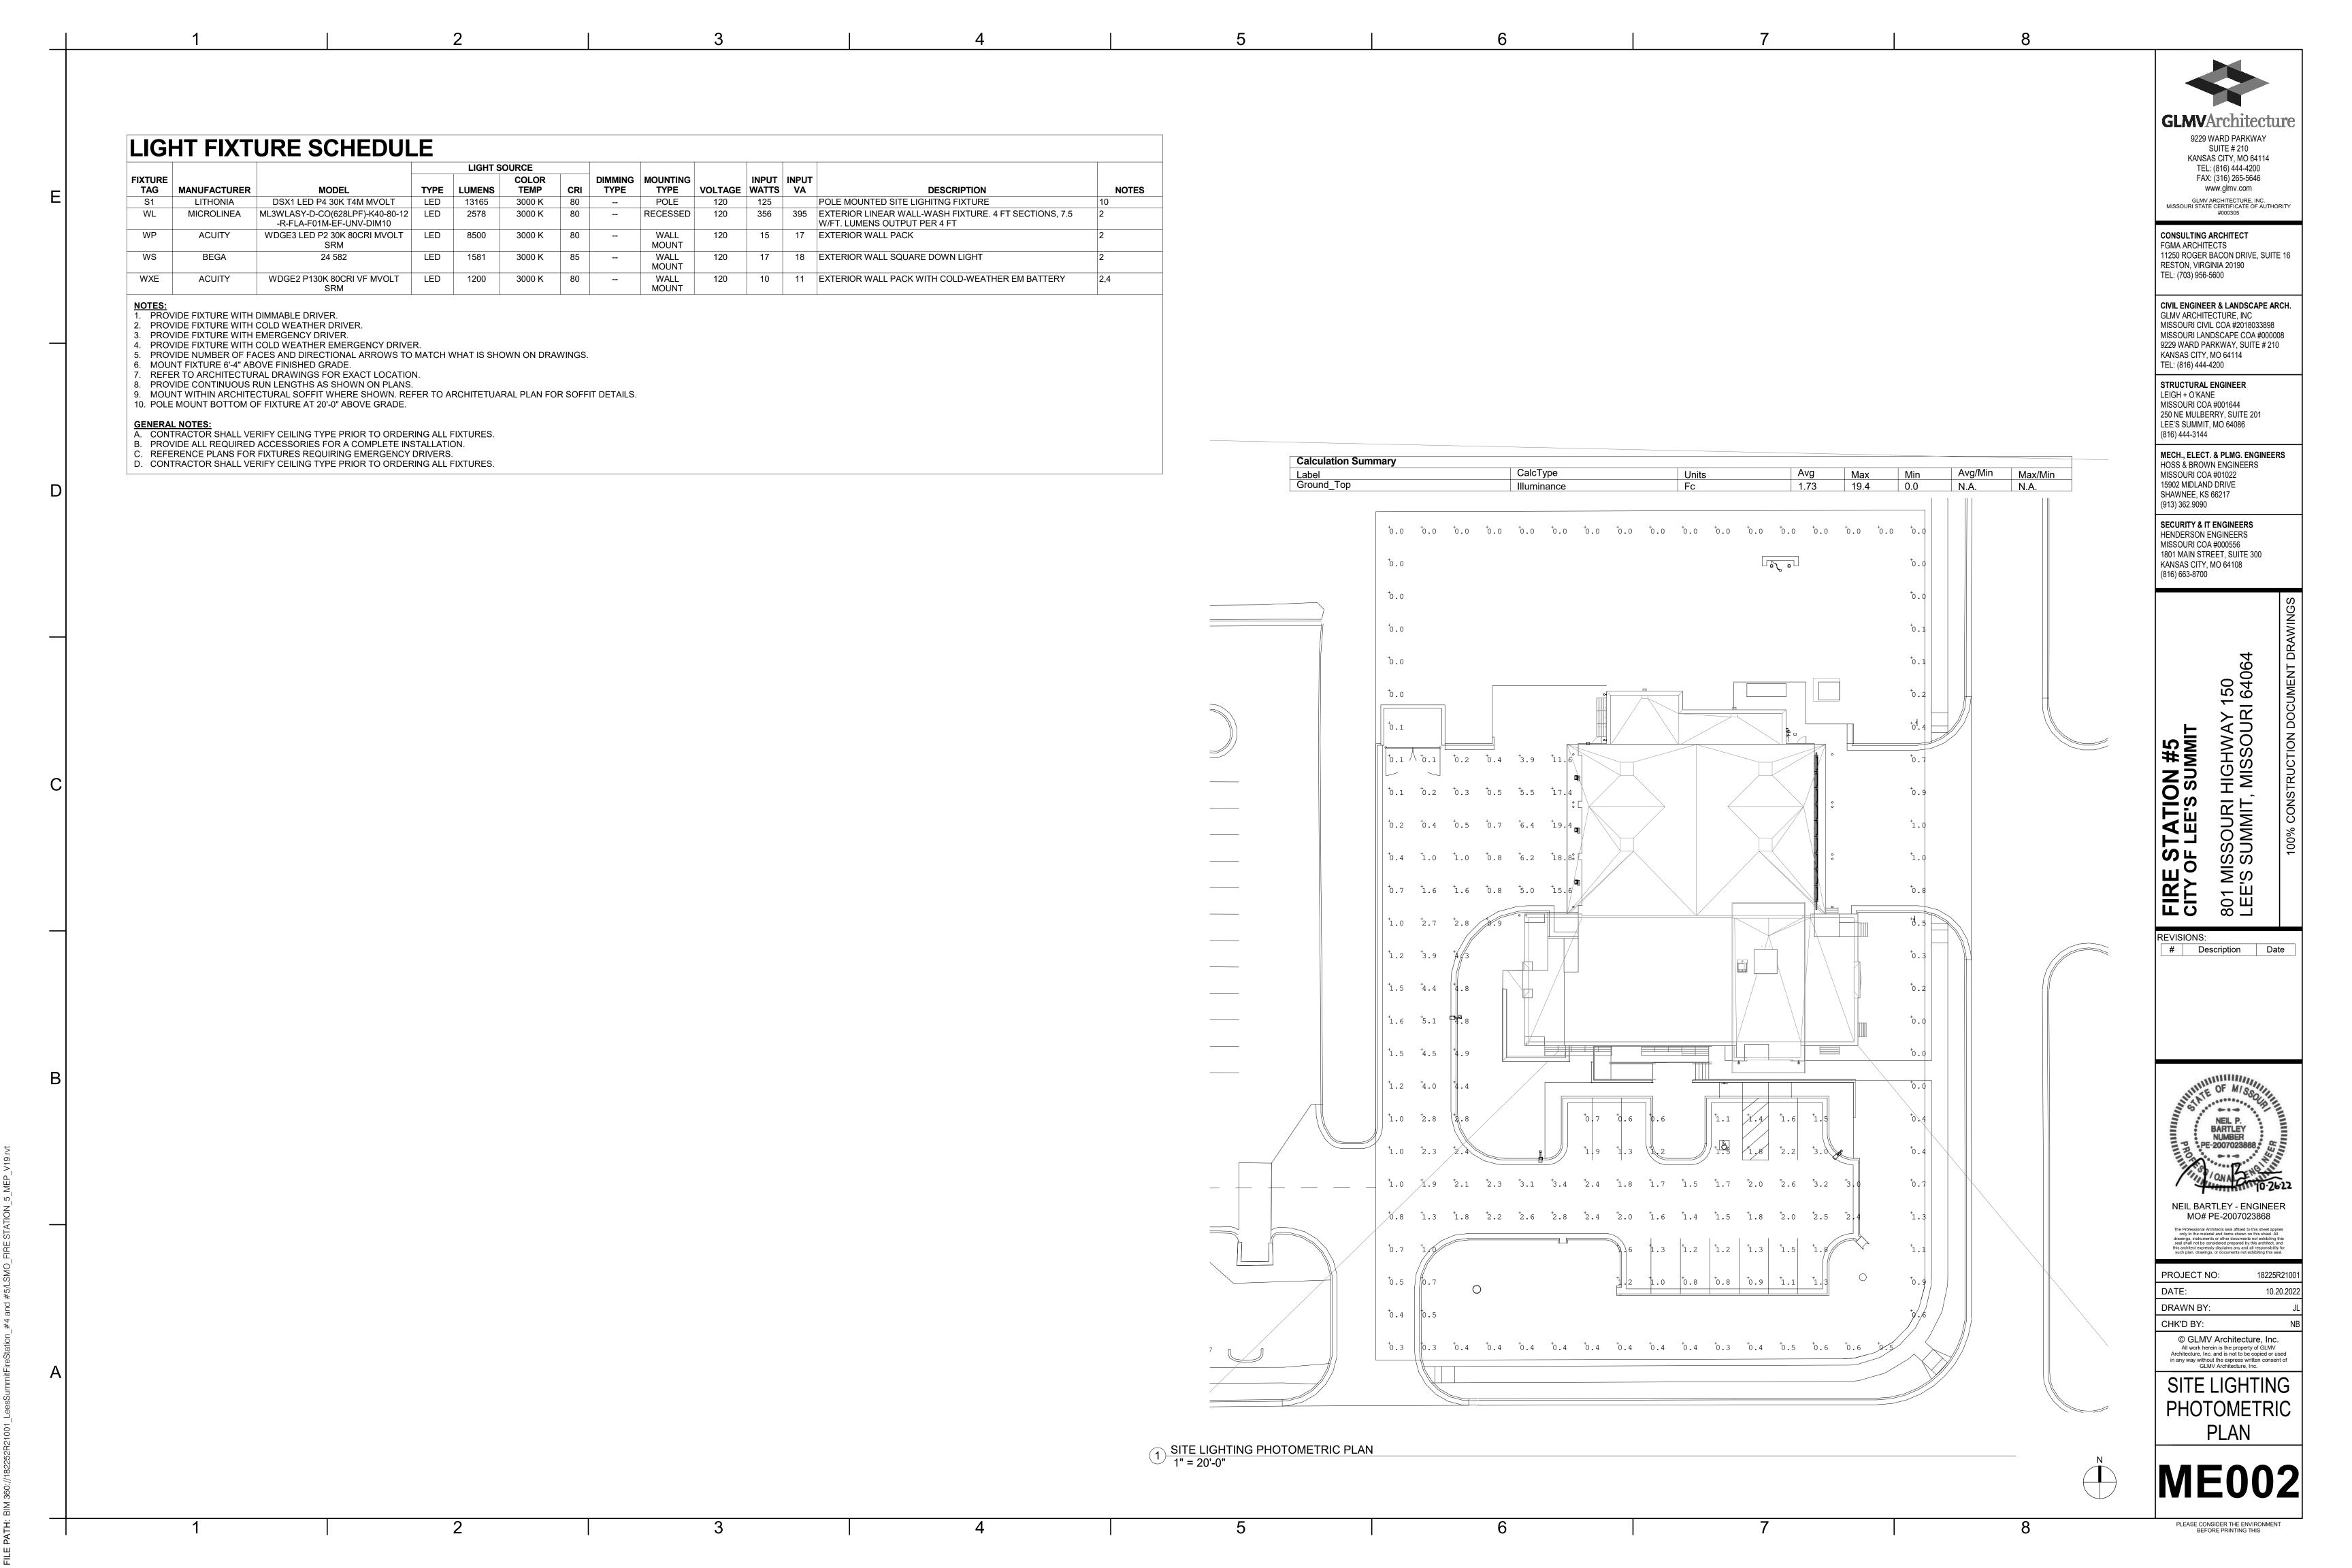

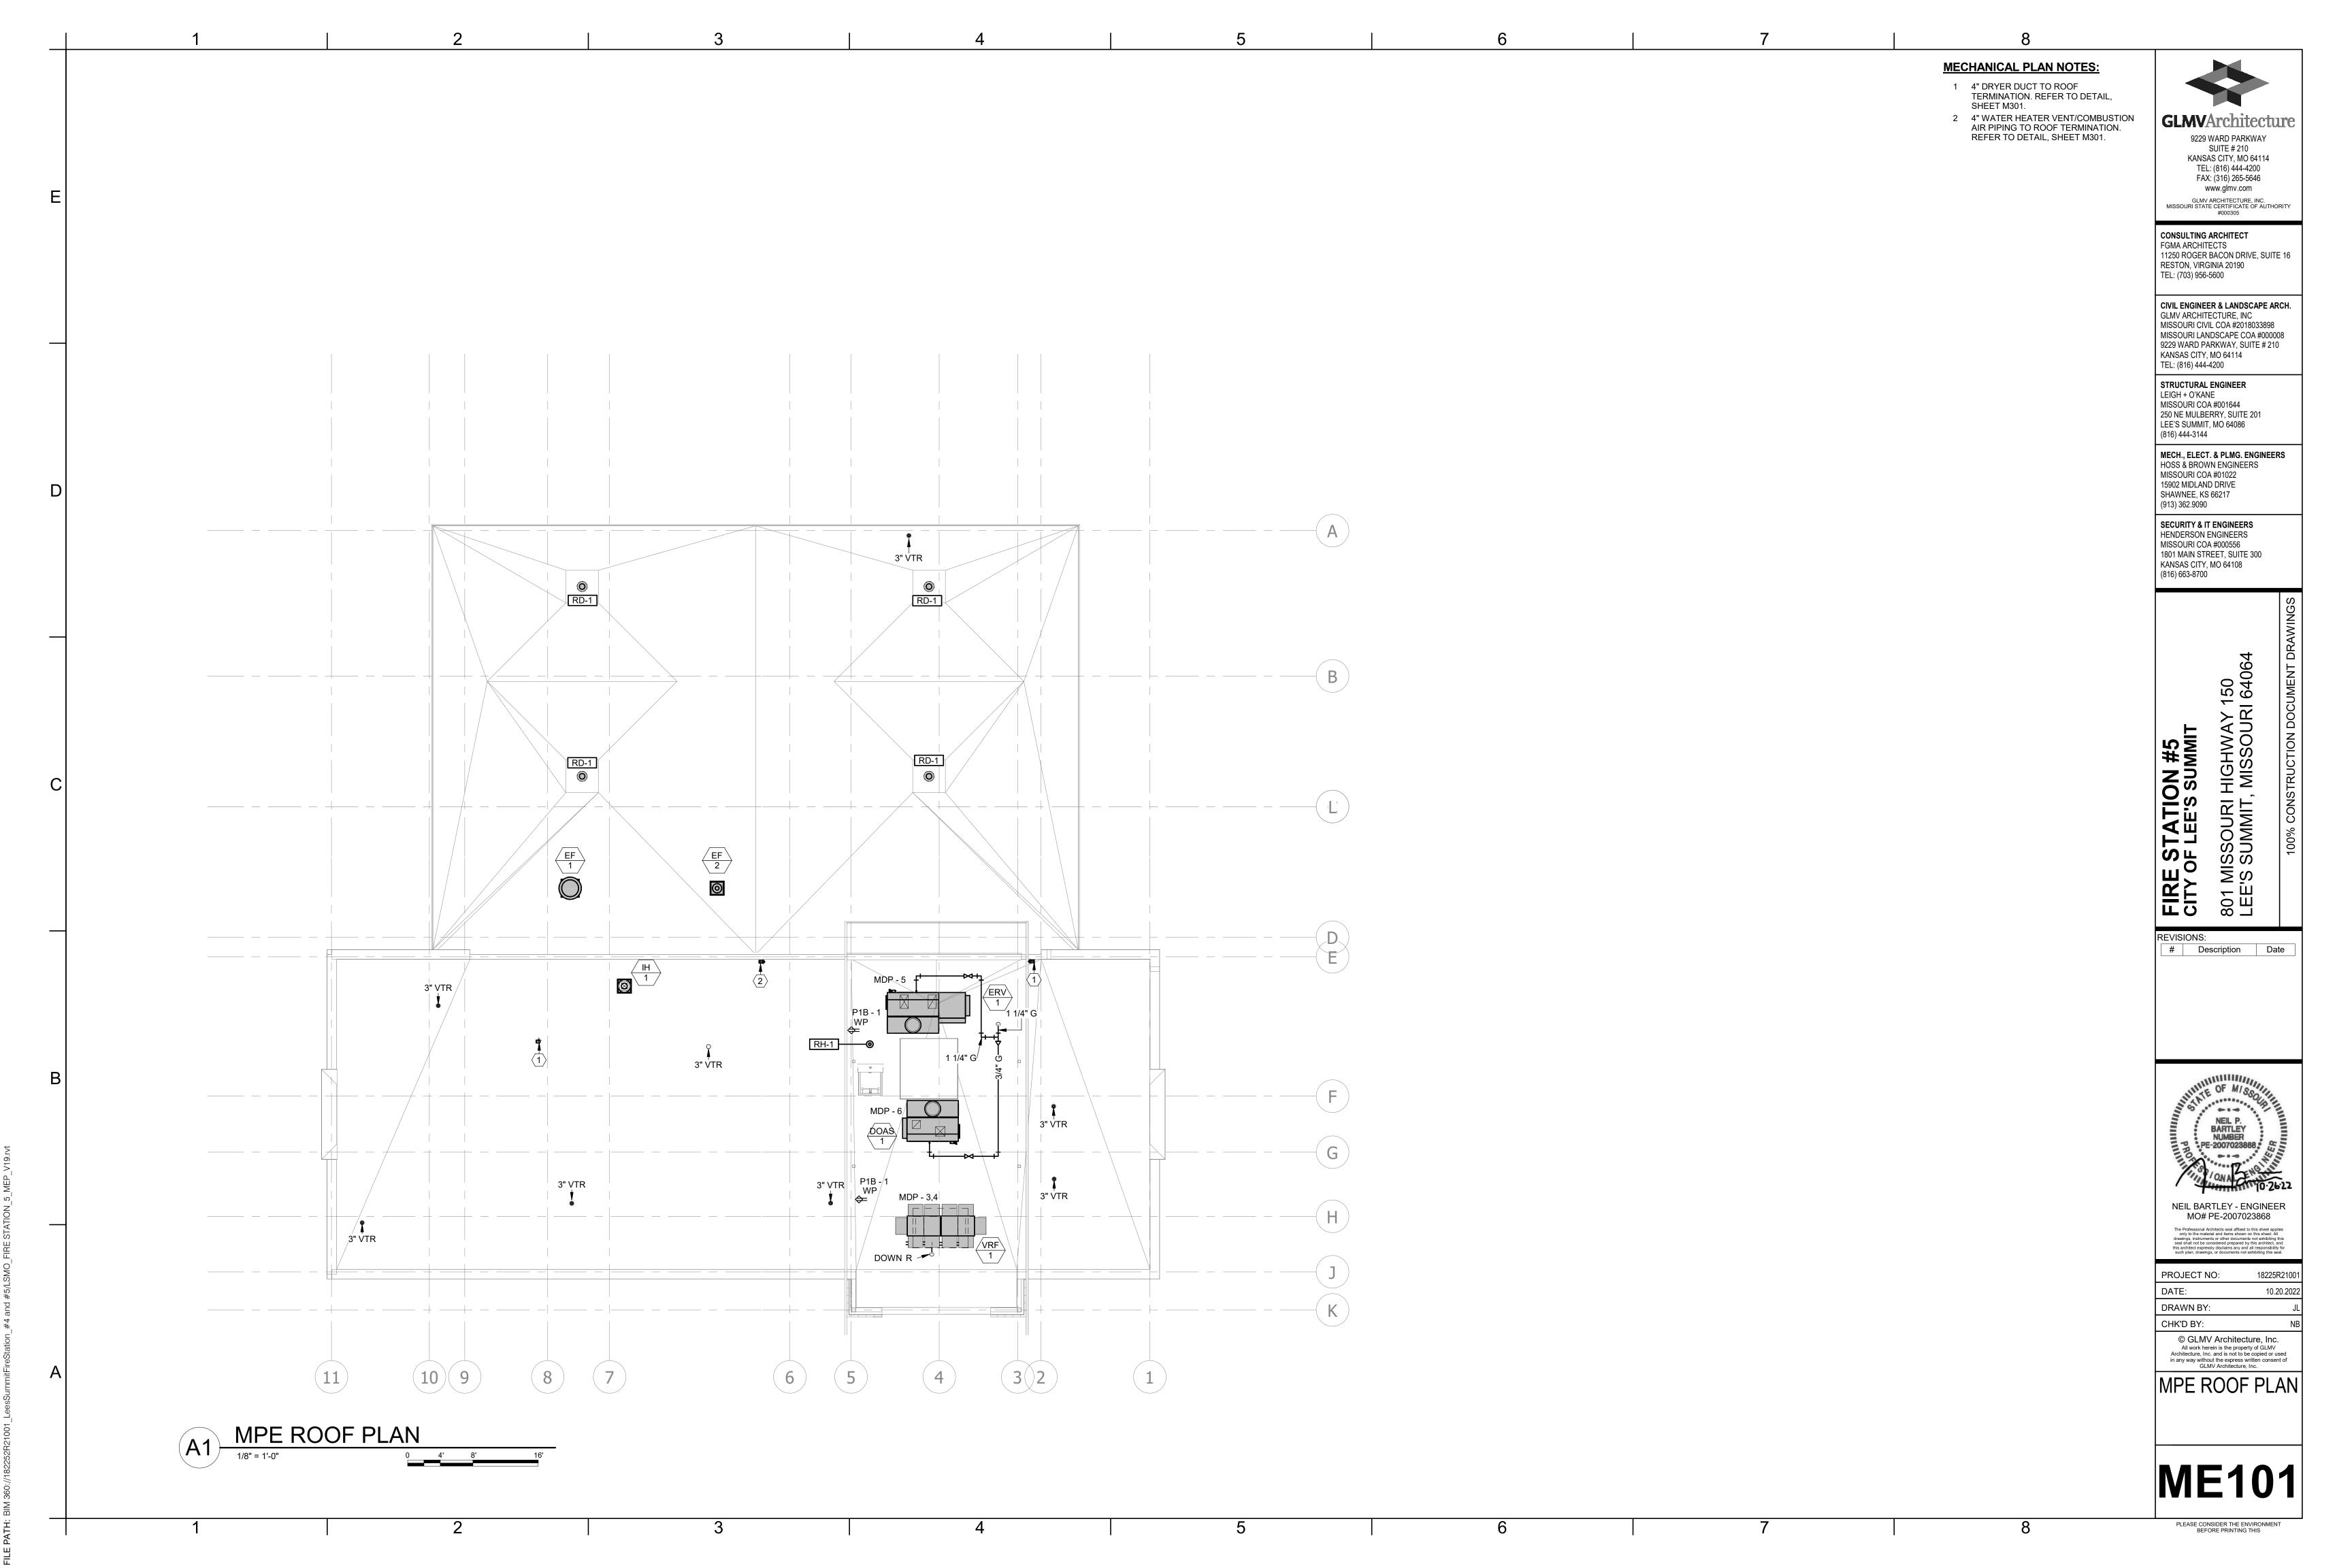

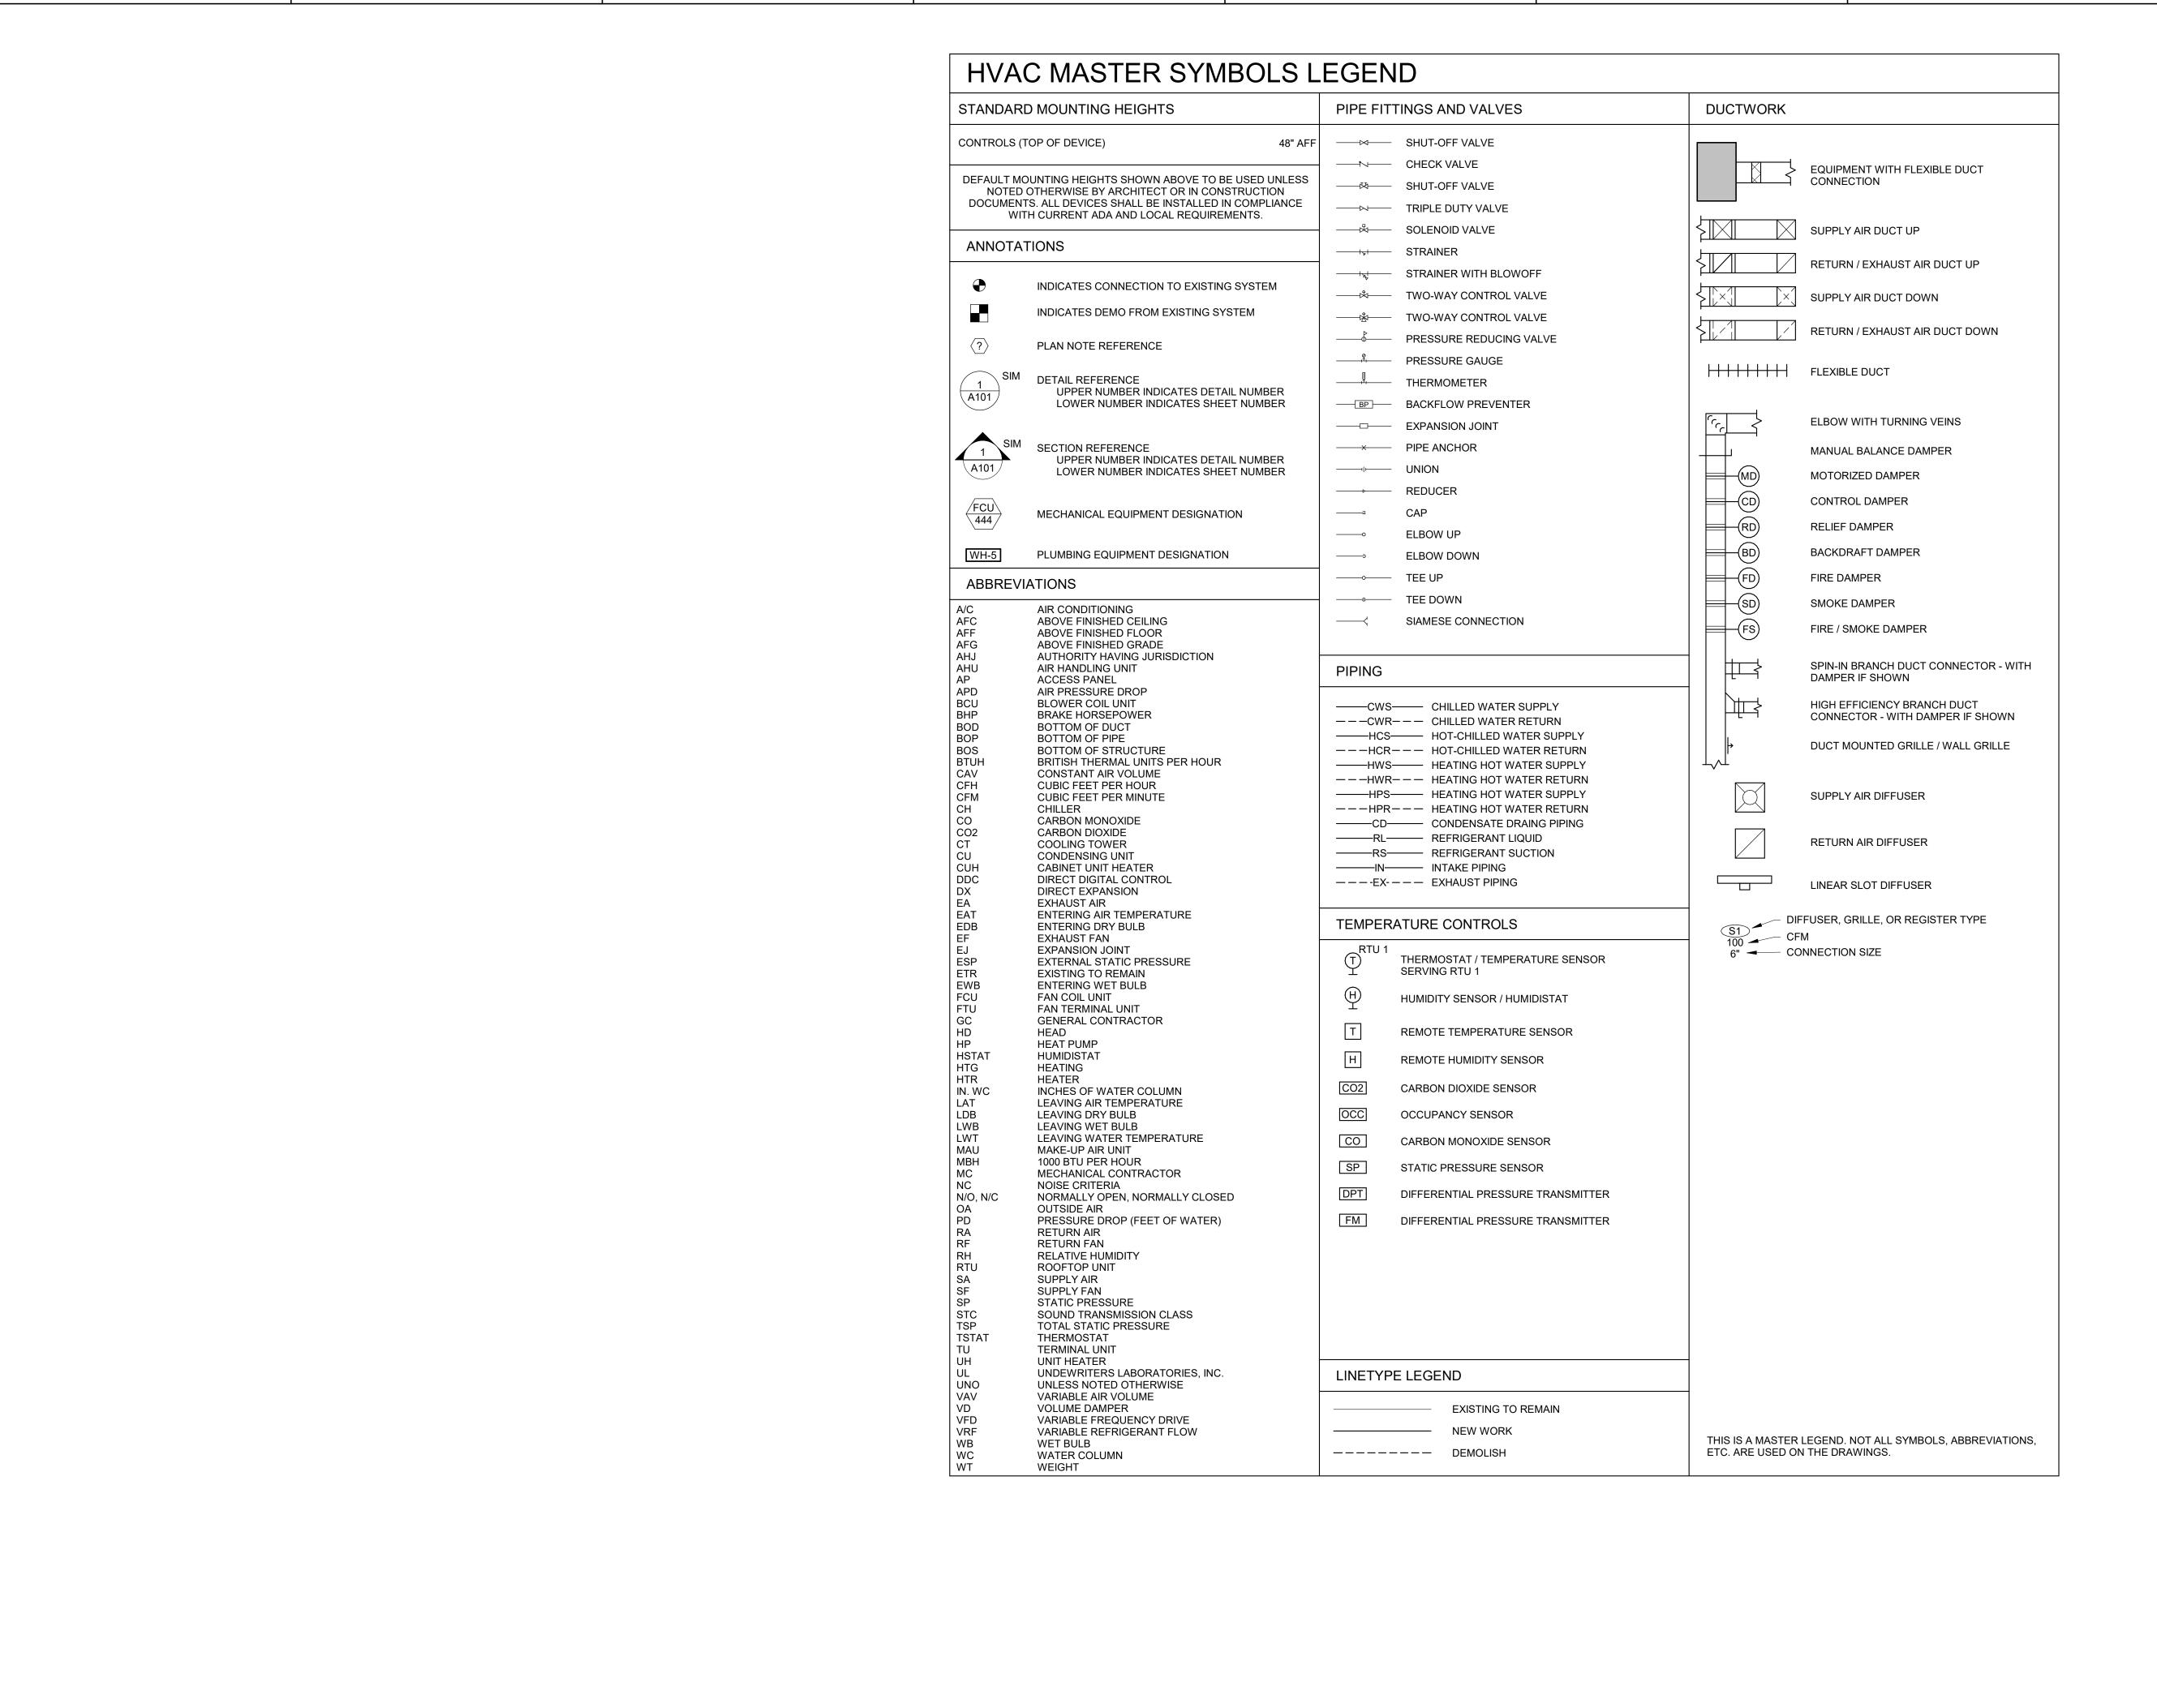

### **HVAC GENERAL NOTES**

- A. THESE DRAWINGS ARE DIAGRAMMATIC AND INDICATE THE GENERAL EXTENT OF THE WORK. PROVIDE SHEET METAL SYSTEMS COMPLETE AND PER APPLICABLE CODES INCLUDING ALL NECESSARY OFFSETS, FITTINGS AND SPECIAL RADIUS OR MITERED ELBOWS WHICH ARE REQUIRED DUE TO SPACE CONSTRAINTS OR OTHER CONDITIONS.
- B. COORDINATE THE INSTALLATION OF THE DUCTWORK AND EQUIPMENT WITH THE WORK OF ALL OTHER TRADES. VERIFY ALL CLEARANCES PRIOR TO THE FABRICATION OF
- ANY SYSTEM COMPONENTS. C. DUCTWORK SHALL NOT BE LOCATED OVER ELECTRICAL EQUIPMENT OR PANELS. PROVIDE THE CODE REQUIRED WORKING CLEARANCE
- AROUND ALL ELECTRICAL EQUIPMENT AND PANELS. D. PROVIDE ALL MISCELLANEOUS SUPPORTING
- STEEL, ETC. FOR THE PROPER INSTALLATION OF ALL MECHANICAL SYSTEMS. E. COORDINATE FLOOR, WALL, ROOF PENETRATIONS, LOUVER SIZES, PAD LOCATIONS,
- ETC. WITH THE ARCHITECTURAL TRADES. F. REFER TO ARCHITECTURAL REFLECTED CEILING PLANS AND WALL ELEVATIONS FOR EXACT LOCATION OF GRILLES, REGISTERS, AND DIFFUSERS.
- G. BRANCH DUCTWORK TO DIFFUSERS, REGISTERS OR GRILLES SHALL BE NECK SIZE UNLESS NOTED OTHERWISE.
- H. ALL RUNOUTS TO SUPPLY DIFFUSERS SHALL BE PROVIDED WITH BALANCING DAMPERS. PROVIDE CONCEALED DAMPER OPERATORS WHERE LOCATED ABOVE HARD CEILINGS. I. ALL DUCTWORK DIMENSIONS INDICATE THE INSIDE CLEAR DIMENSION.
- J. PROVIDE ACCESS DOORS IN HARD CEILING AREAS FOR ACCESS TO BALANCING DAMPERS, ETC. REFER TO ARCHITECTURAL DRAWINGS FOR CEILING TYPES. COORDINATE WITH THE ARCHITECTURAL TRADES.
- K. COORDINATE THE INSTALLATION OF PIPING AND EQUIPMENT WITH THE WORK OF ALL OTHER TRADES.
- L. THE CONTRACTOR SHALL NOT LOCATE PIPING BELOW EQUIPMENT. M. THE CONTRACTOR SHALL ARRANGE BRANCH PIPING TO VRF UNIT COILS SO THAT IT DOES NOT INTERFERE WITH ACCESS TO THE UNIT OR
- CONTROLS. N. PROVIDE SUPPLEMENTARY STEEL AS REQUIRED FOR SUPPORTS, ANCHORS, AND GUIDES. SUBMIT PROPOSED METHODS OF ANCHORING AND GUIDING TO THE STRUCTURAL ENGINEER FOR APPROVAL.
- O. PIPING SHALL NOT BE LOCATED OVER ELECTRICAL EQUIPMENT OR PANELS. PROVIDE THE CODE REQUIRED WORKING CLEARANCE AROUND ALL ELECTRICAL EQUIPMENT AND PANELS.
- P. ALL REFRIGERANT PIPING BETWEEN SPLIT SYSTEMS SHALL BE CONCEALED WHERE POSSIBLE. ALL EXPOSED PIPING SHALL BE ROUTED AT RIGHT ANGLES WITH RESPECT TO THE STRUCTURE, AND PAINTED TO MATCH WALL/ CEILING FINISHES WHERE EXPOSED. COORDINATE WITH GENERAL CONTRACTOR ANY LOCATIONS WHERE PIPING SHALL BE CONCEALED BEHIND FALSE CAVITIES OR FUR-
- Q. ALL TEMPERATURE CONTROLS DEVICES AND WIRING REQUIRED FOR THE INSTALLATION OF THE LOW VOLTAGE PORTION OF THE TEMPERATURE CONTROL SYSTEM SHALL BE FURNISHED AND INSTALLED BY THE TEMPERATURE CONTROL CONTRACTOR. THE ELECTRICAL CONTRACTOR SHALL FURNISH AND INSTALL THE NECESSARY CONDUIT AND BOXES REQUIRED FOR THE TEMPERATURE CONTROL SYSTEM UNDER THE SUPERVISION OF THE TEMPERATURE CONTROL CONTRACTOR.



9229 WARD PARKWAY SUITE # 210 KANSAS CITY, MO 64114

www.glmv.com GLMV ARCHITECTURE, INC. MISSOURI STATE CERTIFICATE OF AUTHORITY #000305

TEL: (816) 444-4200

FAX: (316) 265-5646

CONSULTING ARCHITECT FGMA ARCHITECTS 11250 ROGER BACON DRIVE, SUITE 16 RESTON, VIRGINIA 20190

TEL: (703) 956-5600

**CIVIL ENGINEER & LANDSCAPE ARCH.** GLMV ARCHITECTURE, INC MISSOURI CIVIL COA #2018033898 MISSOURI LANDSCAPE COA #000008

9229 WARD PARKWAY, SUITE # 210 KANSAS CITY, MO 64114 TEL: (816) 444-4200

STRUCTURAL ENGINEER LEIGH + O'KANE MISSOURI COA #001644 250 NE MULBERRY, SUITE 201 LEE'S SUMMIT. MO 64086 (816) 444-3144

MECH., ELECT. & PLMG. ENGINEERS HOSS & BROWN ENGINEERS MISSOURI COA #01022 15902 MIDLAND DRIVE SHAWNEE, KS 66217

SECURITY & IT ENGINEERS HENDERSON ENGINEERS MISSOURI COA #000556 1801 MAIN STREET, SUITE 300 KANSAS CITY, MO 64108

(913) 362.9090

(816) 663-8700

**REVISIONS:** # Description Date

ОШ





**NEIL BARTLEY - ENGINEER** MO# PE-2007023868


PROJECT NO: 18225R21001 DATE: 10.20.2022 DRAWN BY: CHK'D BY: © GLMV Architecture, Inc. All work herein is the property of GLMV Architecture, Inc. and is not to be copied or used


**HVAC SYMBOLS LEGEND** 


in any way without the express written consent of GLMV Architecture, Inc.

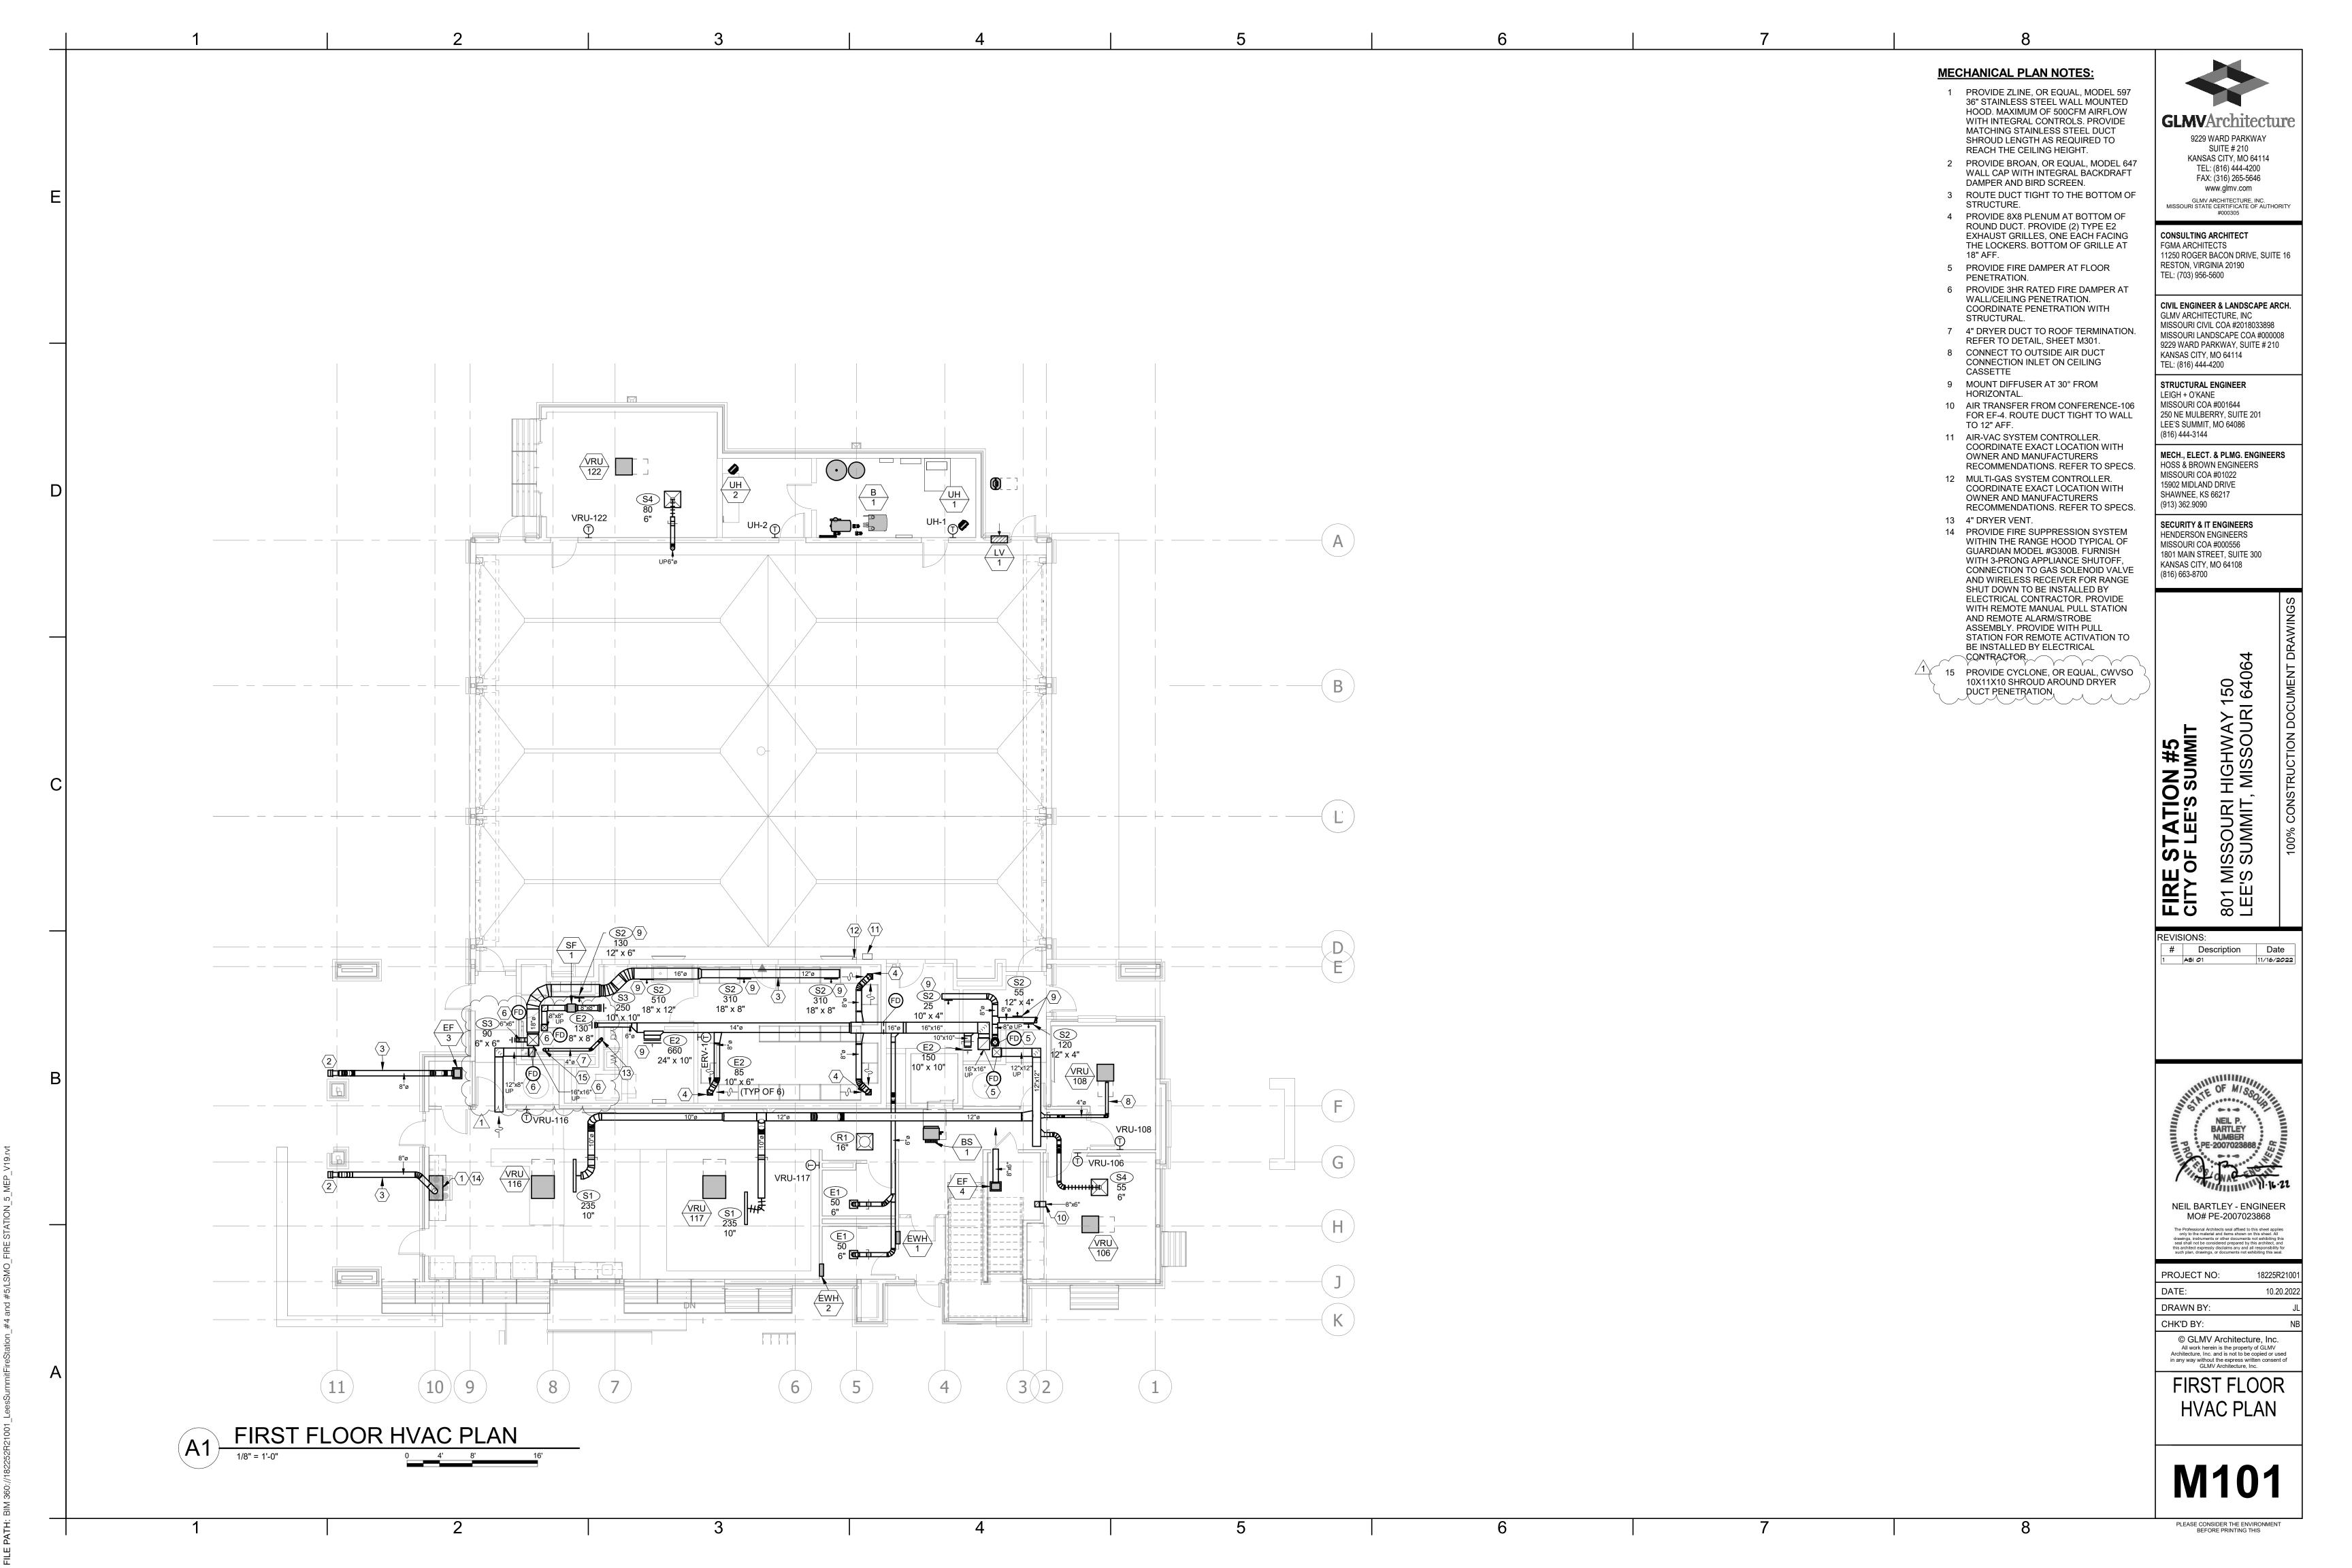


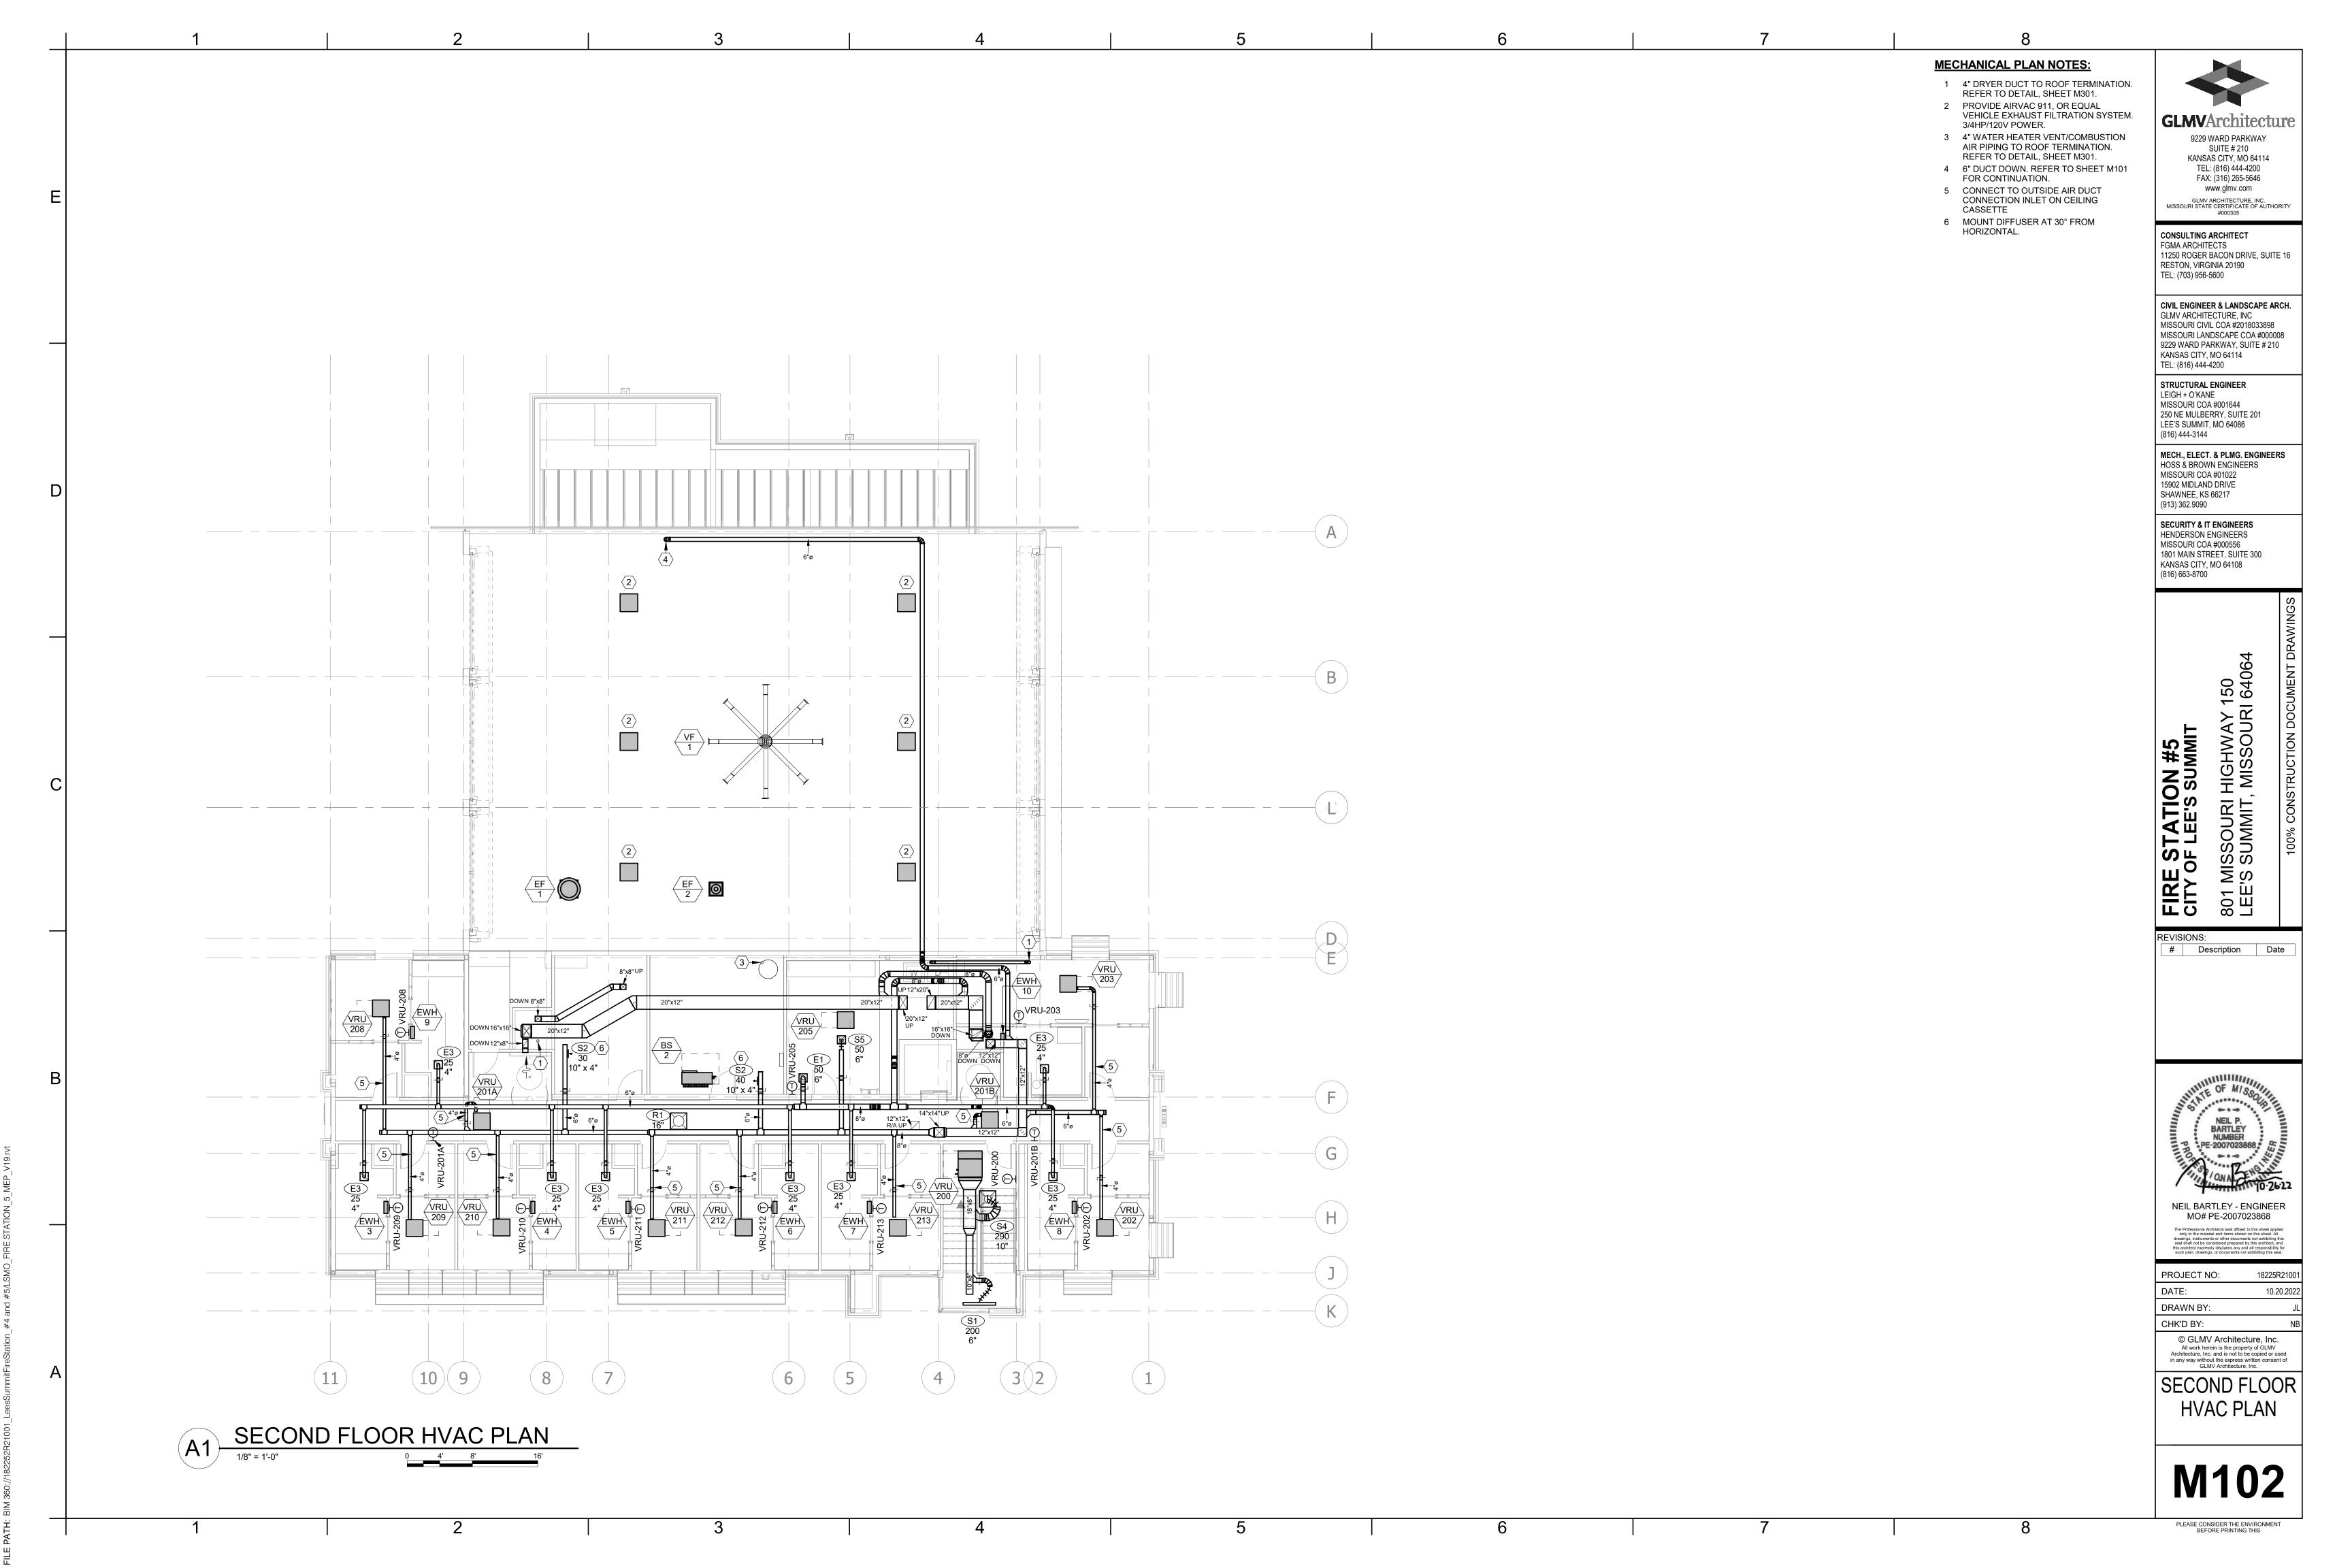

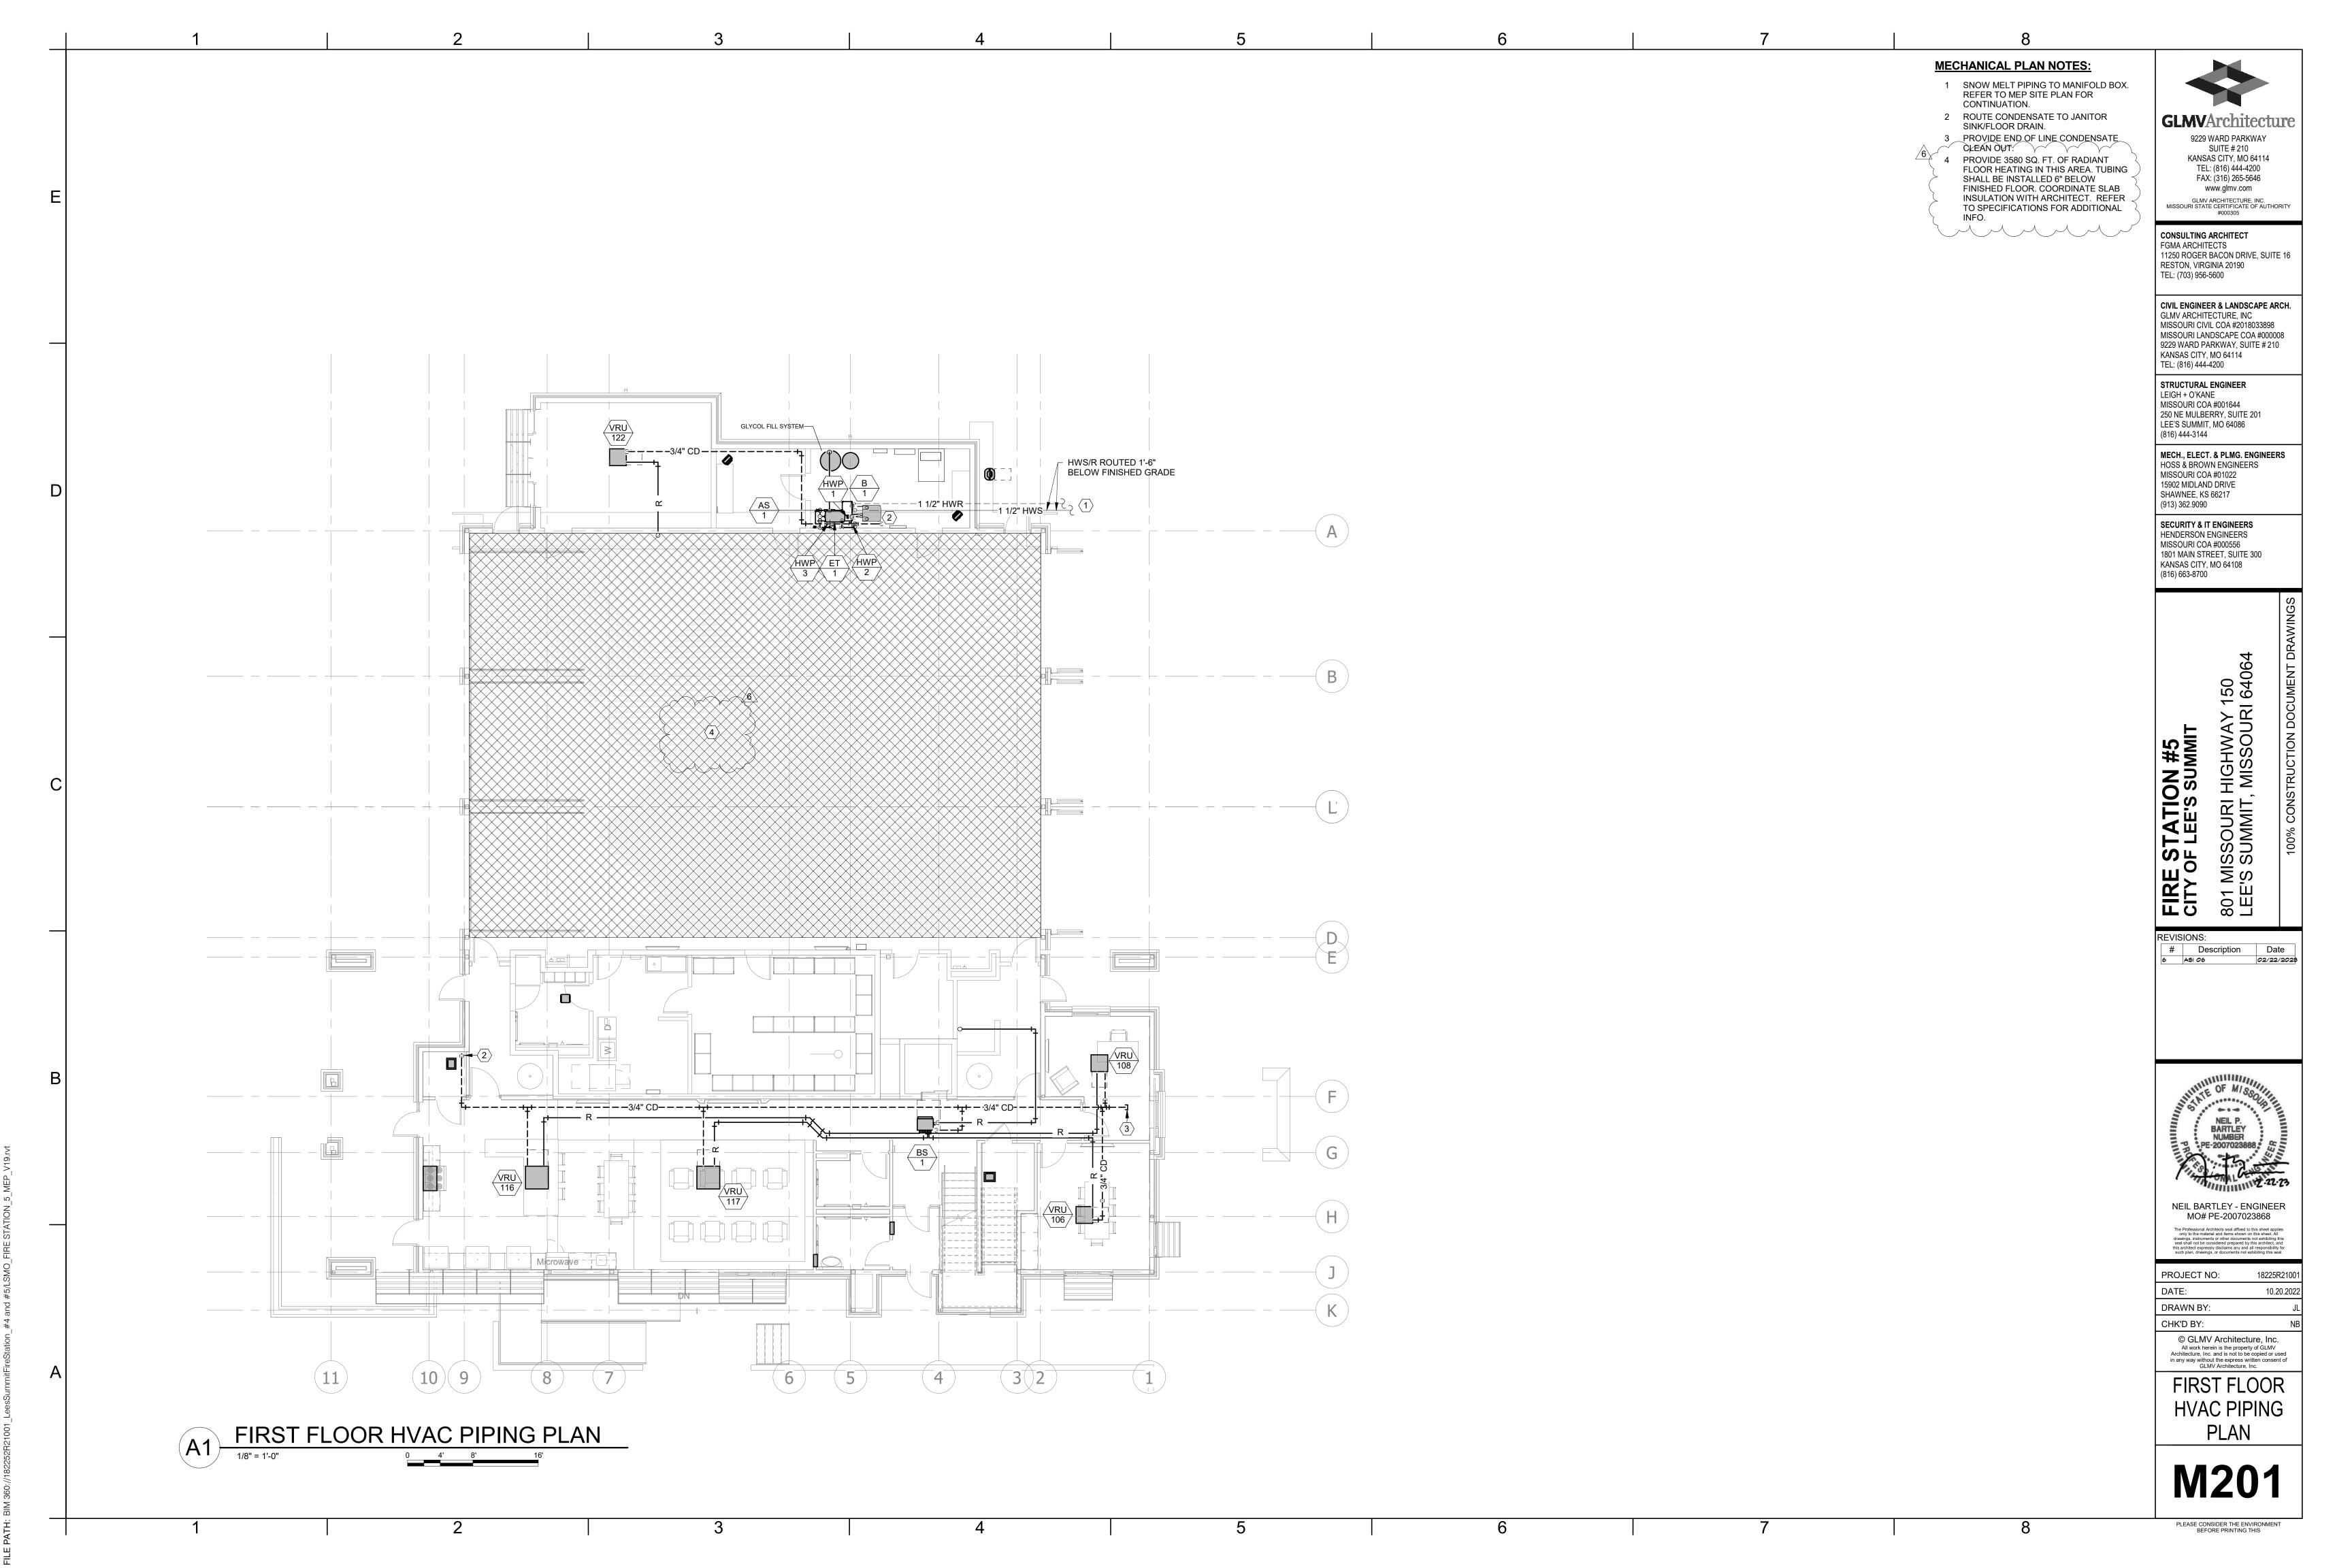

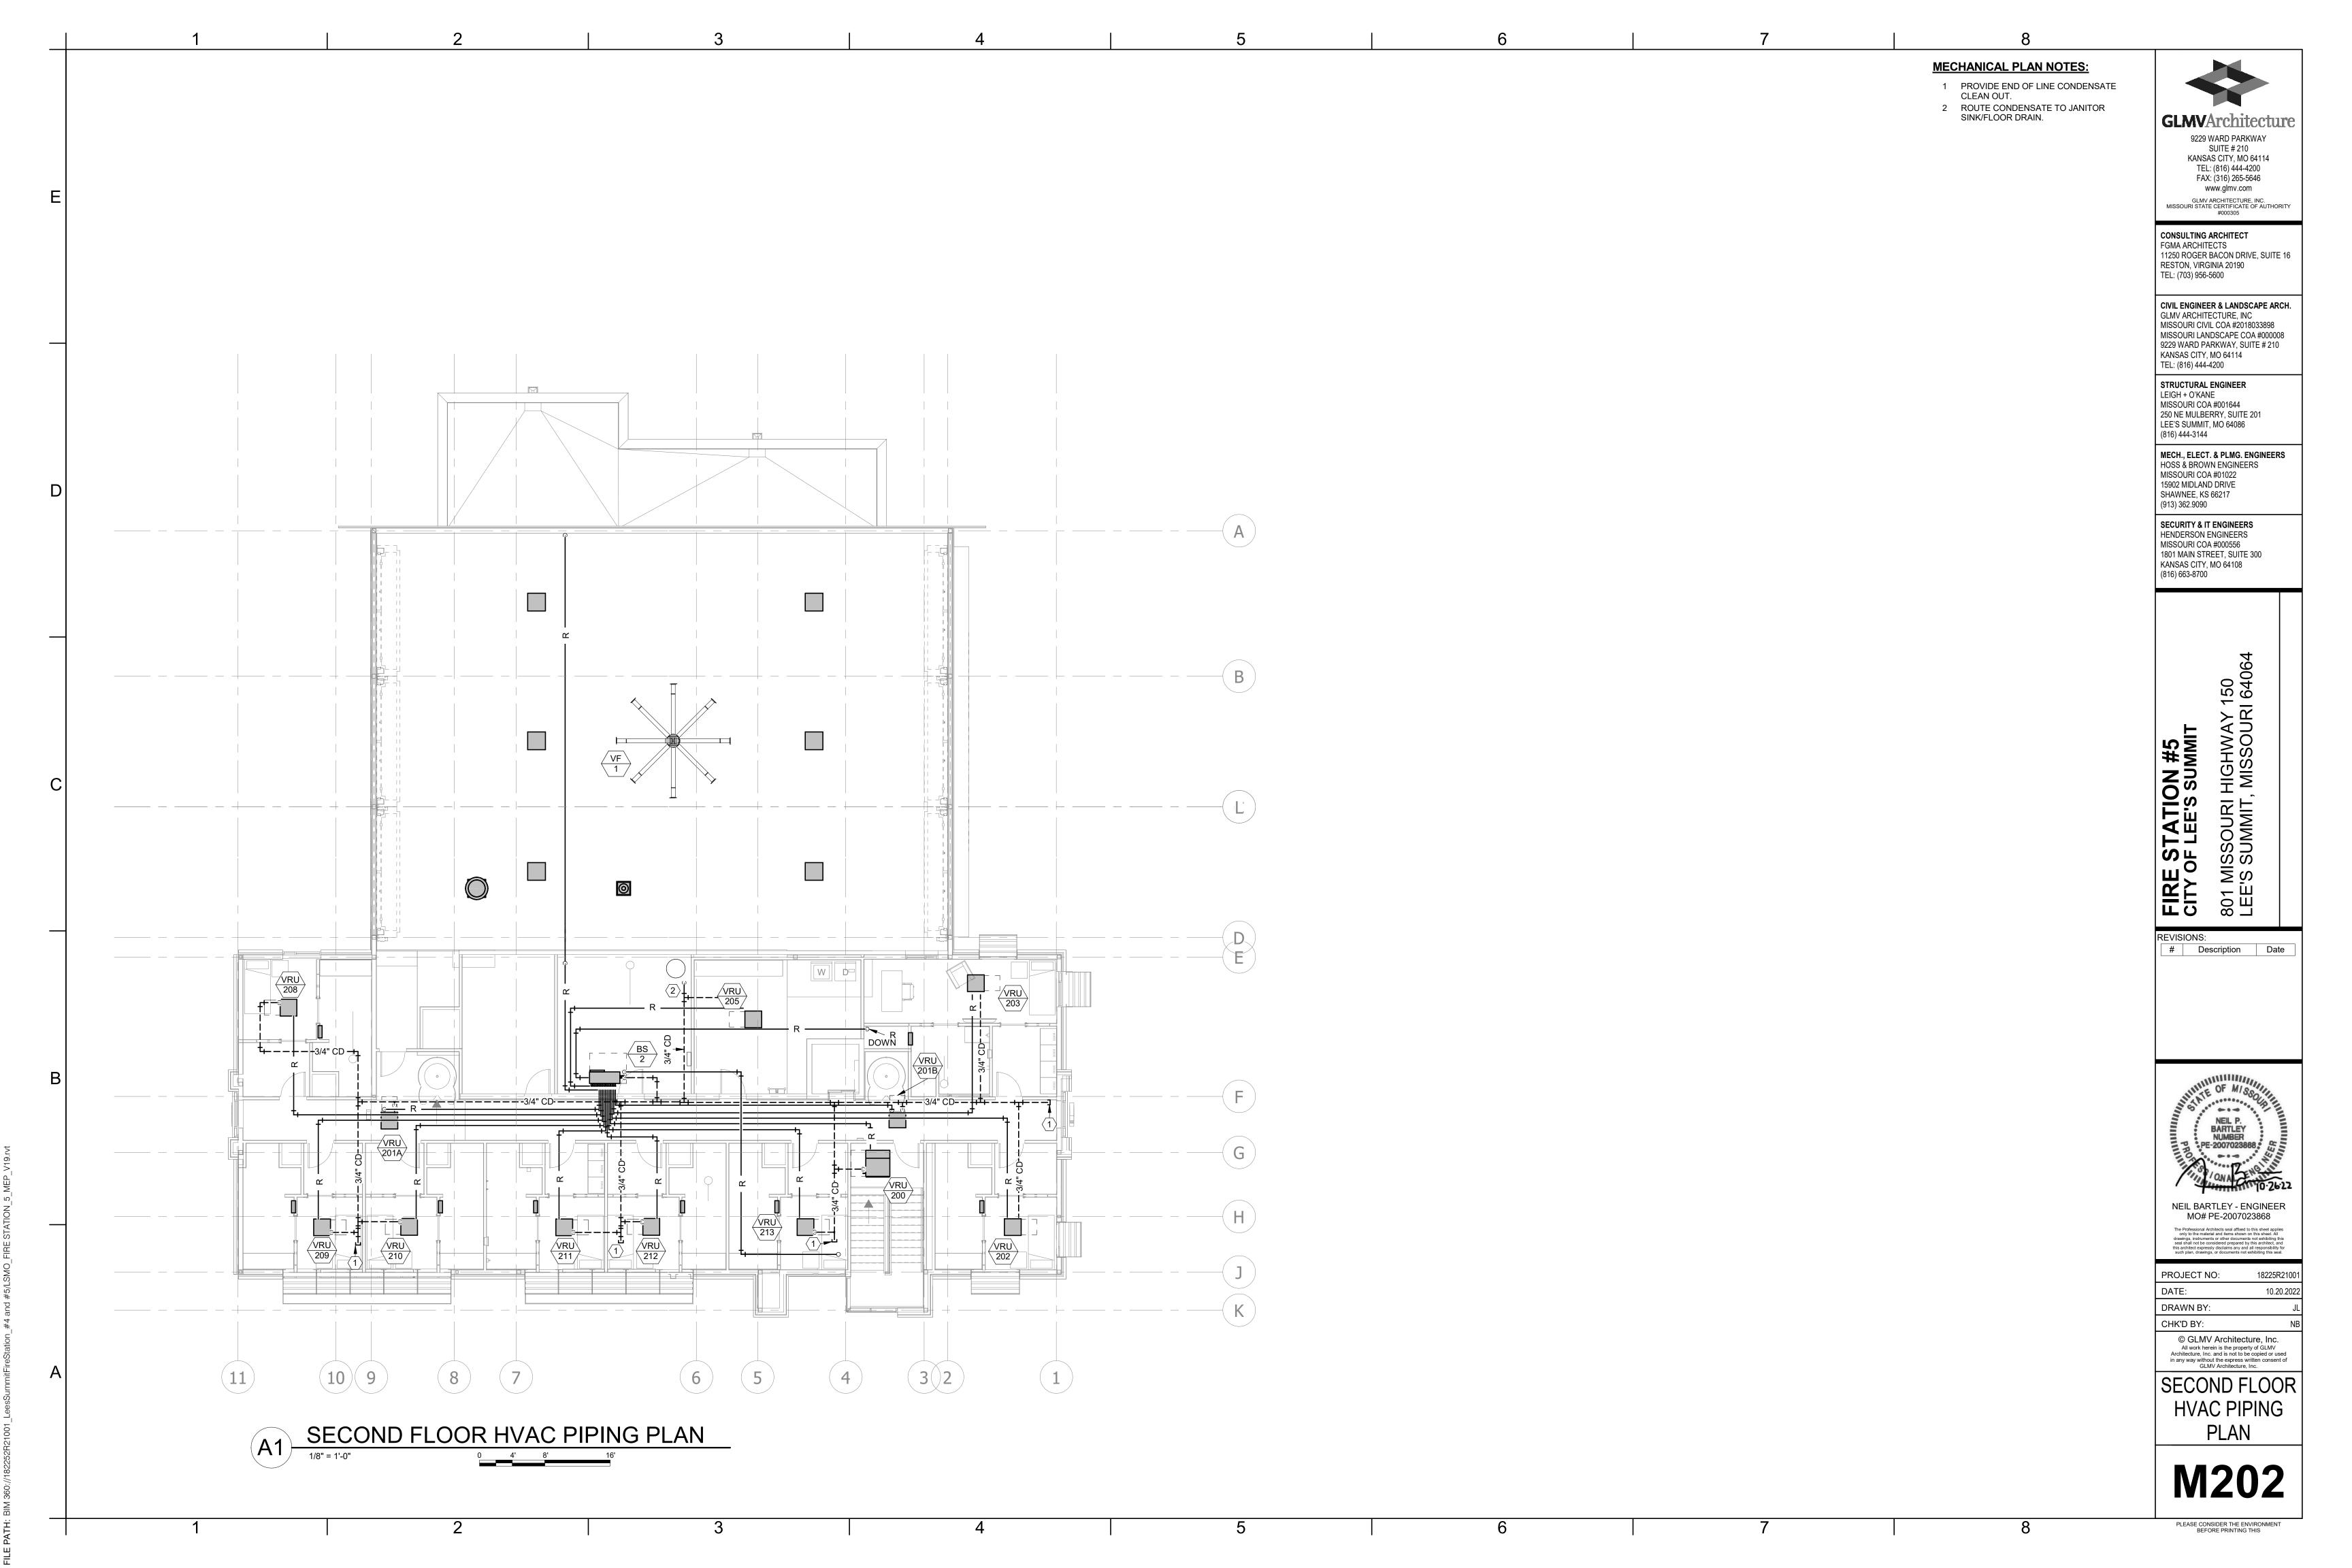

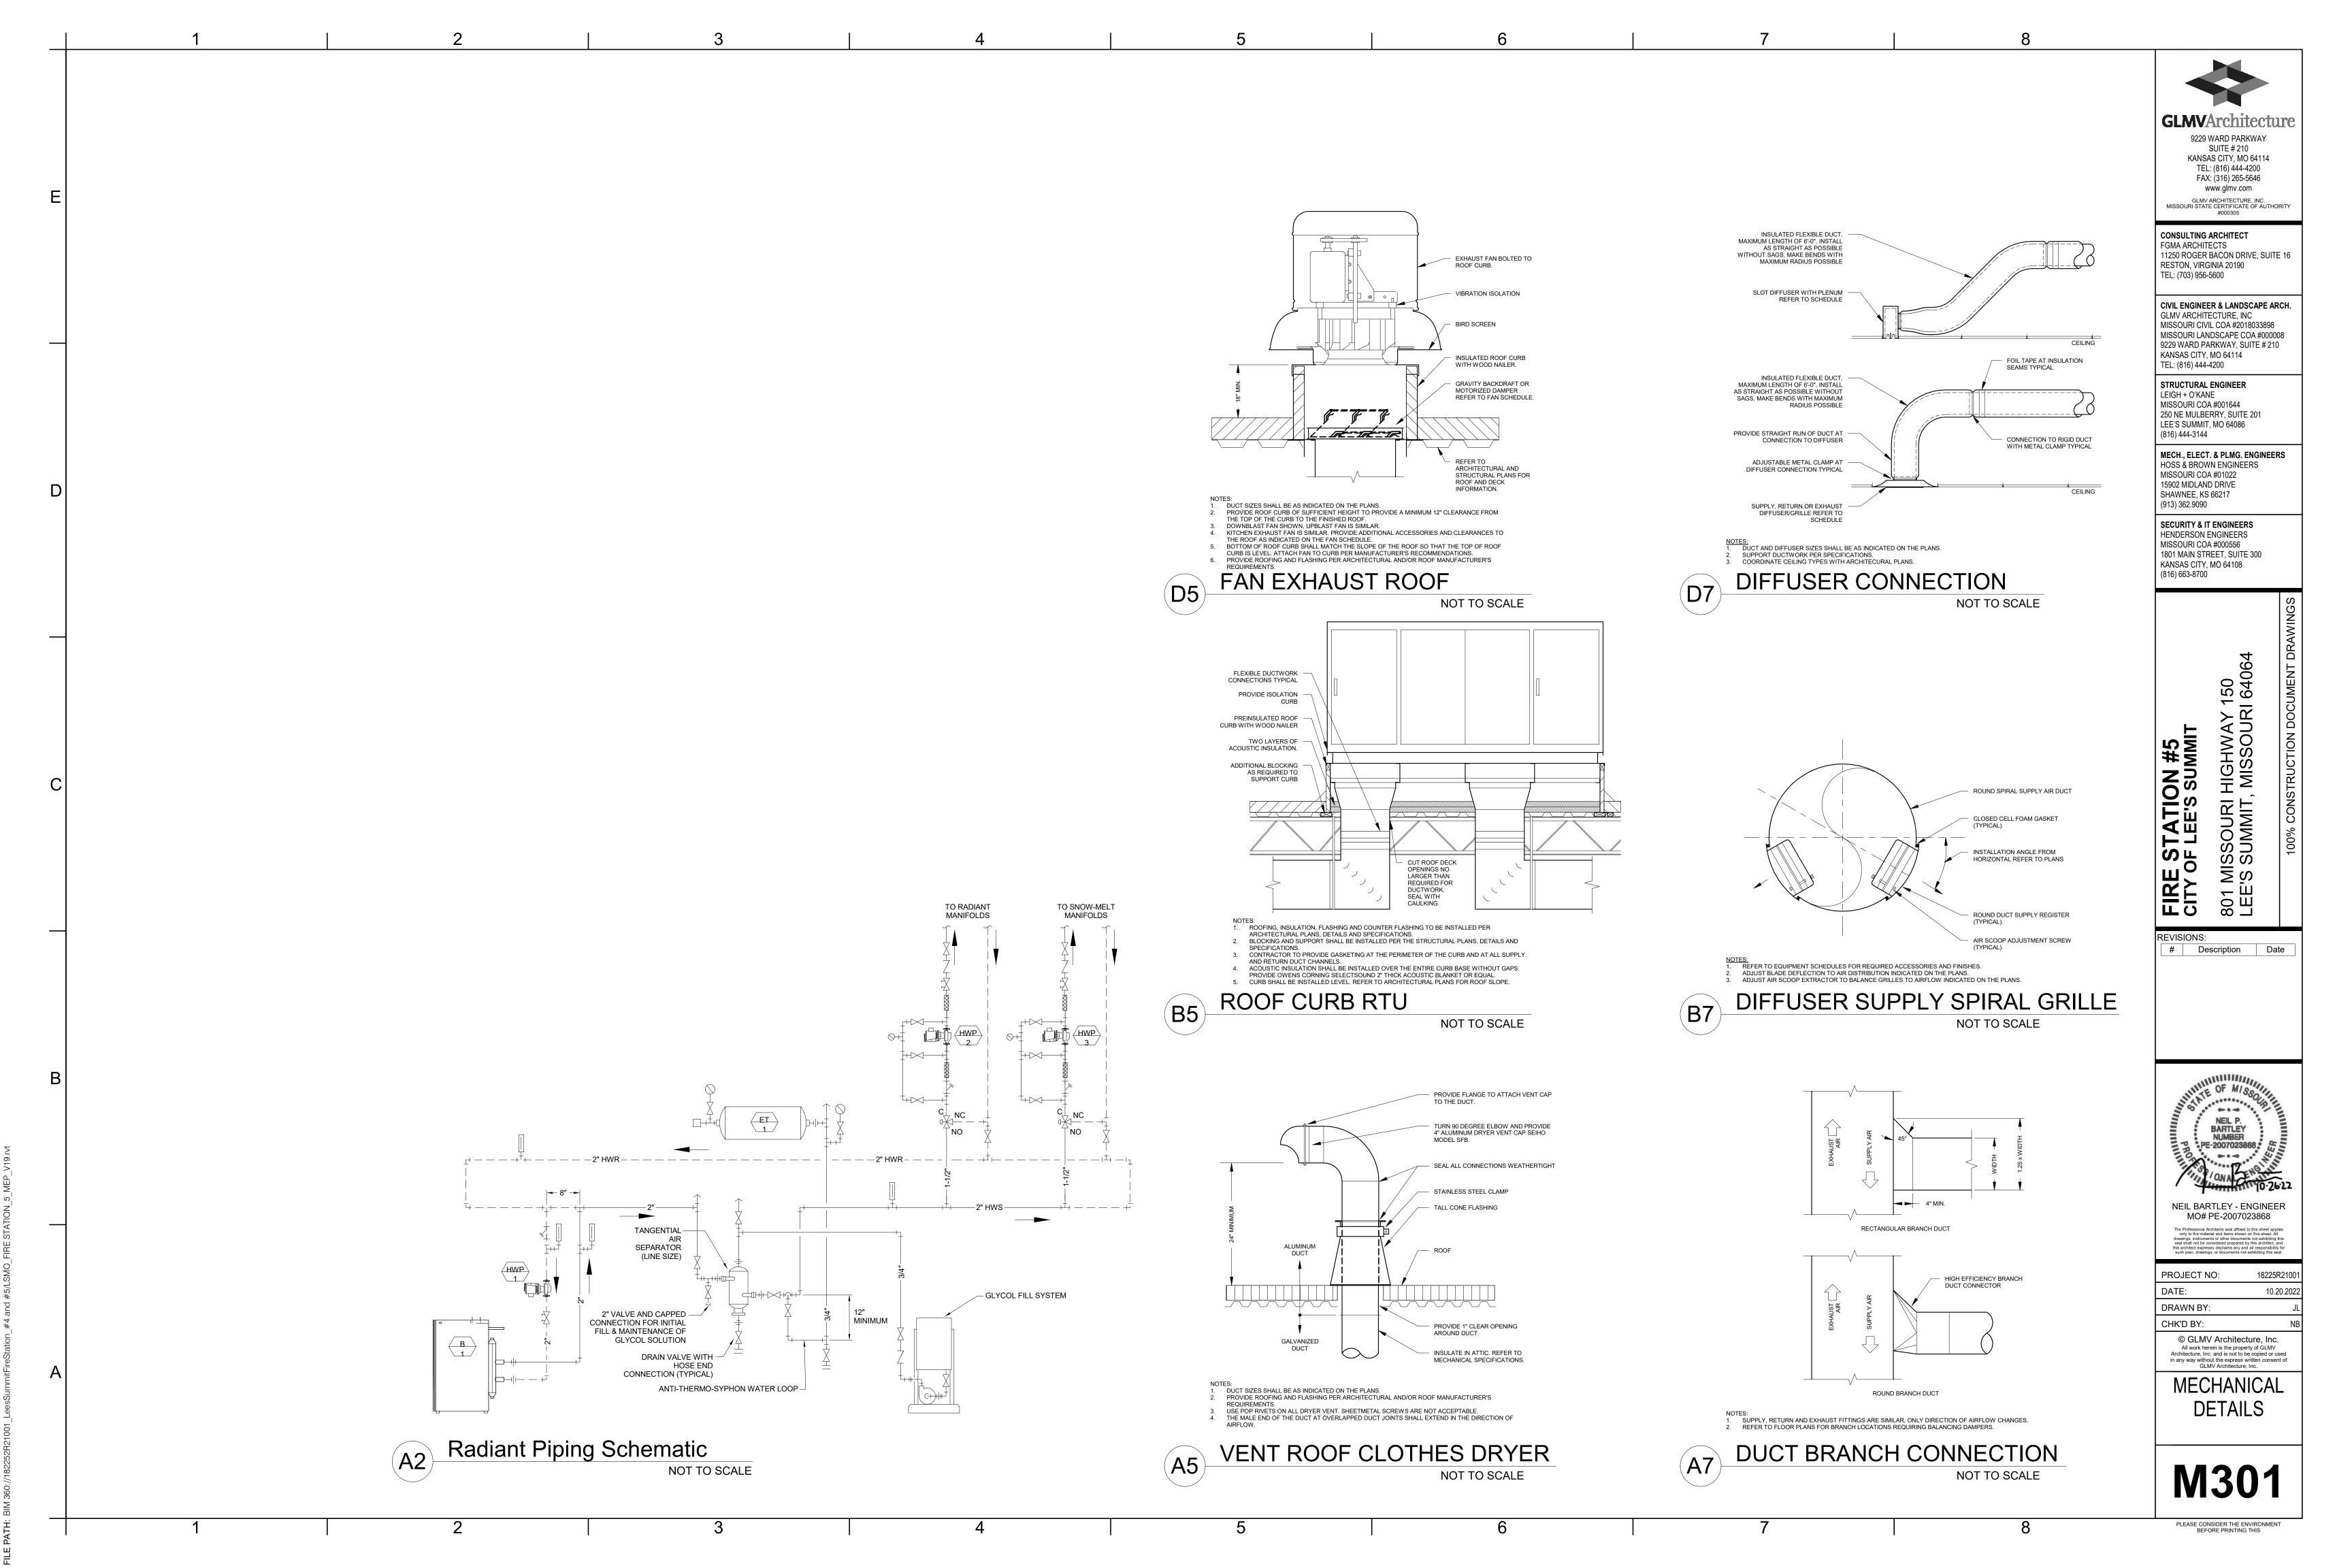

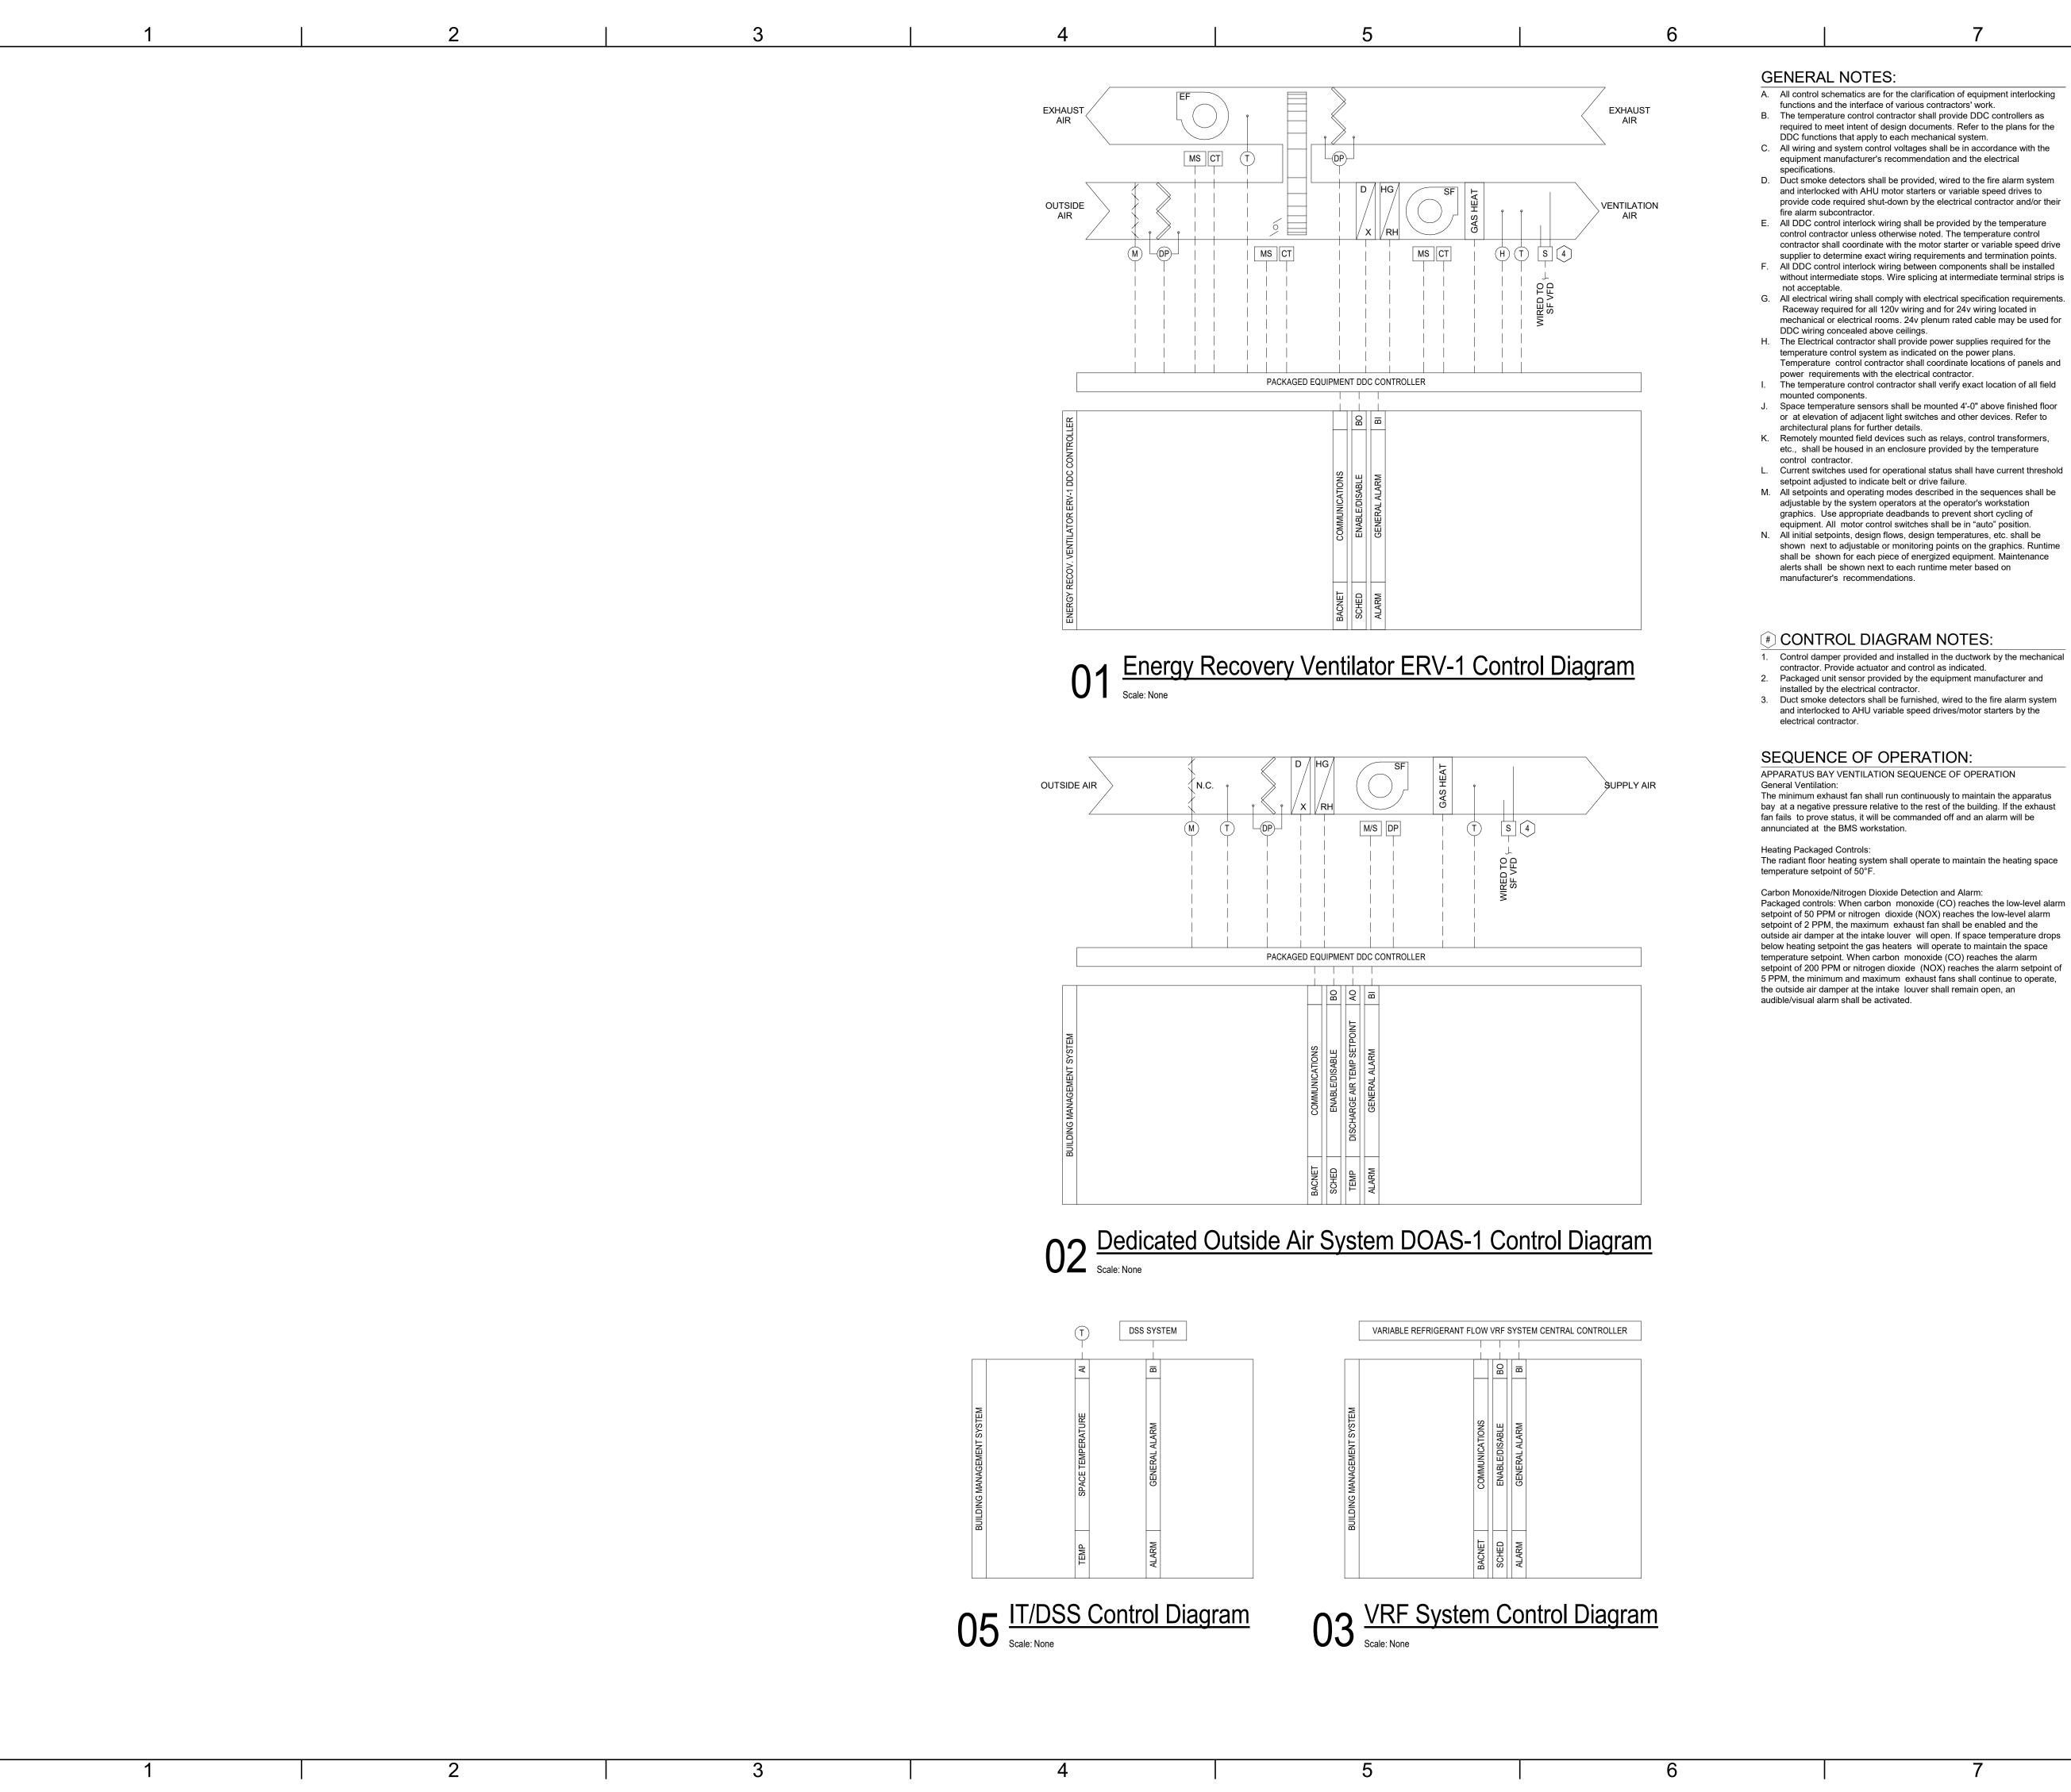

- A. All control schematics are for the clarification of equipment interlocking
- B. The temperature control contractor shall provide DDC controllers as required to meet intent of design documents. Refer to the plans for the
- C. All wiring and system control voltages shall be in accordance with the equipment manufacturer's recommendation and the electrical
- and interlocked with AHU motor starters or variable speed drives to provide code required shut-down by the electrical contractor and/or their
- control contractor unless otherwise noted. The temperature control contractor shall coordinate with the motor starter or variable speed drive supplier to determine exact wiring requirements and termination points. F. All DDC control interlock wiring between components shall be installed
- without intermediate stops. Wire splicing at intermediate terminal strips is G. All electrical wiring shall comply with electrical specification requirements. Raceway required for all 120v wiring and for 24v wiring located in
- mechanical or electrical rooms. 24v plenum rated cable may be used for
- temperature control system as indicated on the power plans. Temperature control contractor shall coordinate locations of panels and
- J. Space temperature sensors shall be mounted 4'-0" above finished floor or at elevation of adjacent light switches and other devices. Refer to
- K. Remotely mounted field devices such as relays, control transformers, etc., shall be housed in an enclosure provided by the temperature
- L. Current switches used for operational status shall have current threshold
- M. All setpoints and operating modes described in the sequences shall be adjustable by the system operators at the operator's workstation graphics. Use appropriate deadbands to prevent short cycling of
- N. All initial setpoints, design flows, design temperatures, etc. shall be shown next to adjustable or monitoring points on the graphics. Runtime shall be shown for each piece of energized equipment. Maintenance alerts shall be shown next to each runtime meter based on

- contractor. Provide actuator and control as indicated.
- Packaged unit sensor provided by the equipment manufacturer and
- Duct smoke detectors shall be furnished, wired to the fire alarm system and interlocked to AHU variable speed drives/motor starters by the

APPARATUS BAY VENTILATION SEQUENCE OF OPERATION

The minimum exhaust fan shall run continuously to maintain the apparatus bay at a negative pressure relative to the rest of the building. If the exhaust fan fails to prove status, it will be commanded off and an alarm will be

The radiant floor heating system shall operate to maintain the heating space

Packaged controls: When carbon monoxide (CO) reaches the low-level alarm setpoint of 50 PPM or nitrogen dioxide (NOX) reaches the low-level alarm setpoint of 2 PPM, the maximum exhaust fan shall be enabled and the outside air damper at the intake louver will open. If space temperature drops below heating setpoint the gas heaters will operate to maintain the space temperature setpoint. When carbon monoxide (CO) reaches the alarm setpoint of 200 PPM or nitrogen dioxide (NOX) reaches the alarm setpoint of 5 PPM, the minimum and maximum exhaust fans shall continue to operate, the outside air damper at the intake louver shall remain open, an

### SEQUENCE OF OPERATION:

VARIABLE REFRIGERANT FLOW VRF SYSTEM SEQUENCE OF OPERATION

Packaged Controls: The manufacturer's central controller shall be provided with required sensors and programming for the system. The controller shall be factory programmed, mounted, wired and tested. The controller shall have an LCD readout for changing setpoints and monitoring operation. The controls shall be provided with a BACnet communications interface allowing the capability of BMS

monitoring and control of the system. The system shall be enabled 24/7/365. The system shall only be disabled for maintenance/service. Individual indoor cassettes shall operate continuously to maintain the space temperature setpoint. The occupants shall be able to adjust the space temperature setpoint within system limits. Space temperature setpoints and system limits shall be coordinated with the owner and modifiable for each

CONSULTING ARCHITECT FGMA ARCHITECTS ENERGY RECOVERY VENTILATOR ERV-1 SEQUENCE OF OPERATION 11250 ROGER BACON DRIVE, SUITE 16 Packaged Controls:

9229 WARD PARKWAY

SUITE # 210

KANSAS CITY, MO 64114

TEL: (816) 444-4200

FAX: (316) 265-5646

www.glmv.com

GLMV ARCHITECTURE, INC. MISSOURI STATE CERTIFICATE OF AUTHORITY #000305

CIVIL ENGINEER & LANDSCAPE ARCH.

RESTON, VIRGINIA 20190

GLMV ARCHITECTURE, INC

KANSAS CITY, MO 64114

STRUCTURAL ENGINEER

MISSOURI COA #001644

LEE'S SUMMIT, MO 64086

250 NE MULBERRY, SUITE 201

HOSS & BROWN ENGINEERS

SECURITY & IT ENGINEERS

1801 MAIN STREET, SUITE 300

HENDERSON ENGINEERS

MISSOURI COA #000556

KANSAS CITY, MO 64108

MISSOURI COA #01022

15902 MIDLAND DRIVE

SHAWNEE, KS 66217

(913) 362.9090

(816) 663-8700

ON #5 S SUMMIT

TATI( LEE'S

FIRE ST

**REVISIONS:** 

6 ASI 06

S

-  $\square$ 

ОШ

02/22/2028

Description

MECH., ELECT. & PLMG, ENGINEERS

TEL: (816) 444-4200

LEIGH + O'KANE

(816) 444-3144

MISSOURI CIVIL COA #2018033898


MISSOURI LANDSCAPE COA #000008

9229 WARD PARKWAY, SUITE # 210

TEL: (703) 956-5600

The manufacturer's controller shall be provided with required sensors and programming for the unit. The controller shall be factory programmed, mounted, wired and tested. The controller shall have an LCD readout for changing setpoints and monitoring operation. The controls shall be provided with a BACnet communications interface allowing the capability of BMS monitoring and control of the unit. Unit Startup:

- The unit shall be enabled 24/7/365, the following shall occur: Outdoor air damper opens
- Supply and Exhaust fans start
- Tempering and energy wheel function as described below
- When the unit is disabled for maintenance, the following shall occur: Supply and Exhaust fans stop
- Outdoor air damper closes Tempering and energy wheel function are disabled
- Supply and Exhaust Fan Operation: The supply and exhaust fans are provided with factory mounted variable
- frequency drives. The supply and exhaust fans shall operate at a constant speed setpoints (adjustable) during operation. Outdoor Air Damper Operation:
- The outdoor air damper is provided with a two-position actuator. When the unit is enabled, the damper will open. When the unit is disabled, the damper will close.
- Cooling Operation: The unit DX cooling is modulated to maintain the space temperature setpoint. **Dehumidification Operation:** During dehumidification cooling is modulated to maintain the cooling coil
- setpoint (55F adjustable), the hot gas reheat is modulated to maintain the space temperature setpoint. Hot gas reheat is modulated to maintain the space temperature setpoint. **Heating Operation:**
- The unit gas heat is modulated to maintain the space temperature setpoint. Freeze Protection: If supply air temperature drops below setpoint (35F adjustable) for 5 minutes
- (adjustable), the unit will be disabled and activate the alarm output. Energy Wheel Frost Control Operation: Frost control is enabled when frost is present on the wheel based on the outside air temperature and pressure drop across the wheel. Frost control is enabled when outdoor air temperature is below setpoint (5F adjustable) and
- the differential pressure across the wheel is above setpoint (1.5 IN WG During frost control the supply fan is cycled (30 minutes on/5 minutes off, adjustable) to allow the warm exhaust air to defrost the wheel. Once either pressure drop is below setpoint or outdoor air temperature is above setpoint the unit will resume normal operation.
- The controller will display alarms on the LCD.
- Dirty Wheel: if pressure drop across the wheel increases and an alarm shall be generated.
- Supply and Exhaust Fan Status: if fan status is abnormal and an alarm shall be generated.
- DX System: if high/low refrigerant pressure is detected the compressors will shut down and an alarm shall be generated.
- Temperature Sensor: if a temp sensor fails an alarm shall be generated. DEDICATED OUTSIDE AIR SYSTEM DOAS-1 SEQUENCE OF OPERATION Packaged Controls:
- The manufacturer's controller shall be provided with required sensors and programming for the unit. The controller shall be factory programmed, mounted, wired and tested. The controller shall have an LCD readout for changing setpoints and monitoring operation. The controls shall be provided with a BACnet communications interface allowing the capability of BMS monitoring and control of the unit.
- Unit Startup: The unit shall be enabled 24/7/365, the following shall occur:
- Outdoor air damper opens Supply fan starts
- Tempering functions as described below
- Unit Stop: When the unit is disabled for maintenance, the following shall occur: Supply fan stops Outdoor air damper closes
- Tempering function are disabled Supply Fan Operation: The supply fan is provided with an ECM motor for fan speed control. The supply fan shall operate at a constant speed setpoint (adjustable) during
- Outdoor Air Damper Operation: The outdoor air damper is provided with a modulating actuator. When the unit is enabled, the damper will open to its setpoint. When the unit is disabled, the
- Cooling Operation: The unit DX cooling is modulated to maintain the discharge air temperature setpoint (70F adjustable). **Dehumidification Operation:**
- During dehumidification (supply air dewpoint) DX cooling is modulated to maintain the cooling coil setpoint (55F adjustable). the hot gas reheat is modulated to maintain the discharge air temperature setpoint. Heating Operation: The unit gas heat is modulated to maintain the space temperature setpoint.
- Freeze Protection: If supply air temperature drops below setpoint (35F adjustable) for 5 minutes (adjustable), the unit will be disabled and activate the alarm output.
- The controller will display alarms on the LCD. - Dirty Filter: if pressure drop across the filter increases and an alarm
- shall be generated. Supply Fan Status: if fan status is abnormal and an alarm shall be
- DX System: if high/low refrigerant pressure is detected the
- compressors will shut down and an alarm shall be generated.
- Temperature Sensor: if a temp sensor fails an alarm shall be generated.

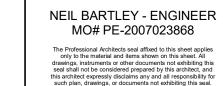

PROJECT NO:

DATE:

BARTLEY NUMBER

DRAWN BY: CHK'D BY: © GLMV Architecture, Inc. Architecture, Inc. and is not to be copied or used

18225R21001

10.20.2022

**TEMPERATURE CONTROLS** 

### ROOFTOP UNIT SCHEDULE

	SUPPLY FAN RETURN FAN					DX COOLING HOT GAS REHEAT				REHEAT	GAS HEAT E			LECTRICAL DA	ТА																		
			MIN															E	NTERING A	R TEMP	LEAVING	AIR TEMP		SENSIBLE	LEAVING A	AIR TEMP							
EQUIPMENT			O/A																				CAPACIT	CAPACITY			INPUT	OUTPUT			MOCP	WEIGHT	
MARK	MANUFACTURER	MODEL	CFM	CFM	TYPE	DRIVE	ESP	TSP	BHP I	IP F	PM CF	M TYPE	DRIVE	ESP	TSP	BHP F	IP RP	M	DB	WB	DB	WB	(BTU/H)	(BTU/H)	DB	WB	(Mbh)	(Mbh)	VOLTS	PHASE MCA	(A)	(LBS)	NOTES
DOAS 1	RUPP AIR	CASRTU1-I.75-13-6T	1025	1025	13P-1	DIRECT	1.00	1.25	0.230	1 1	100 0	-	-	0.00	0.00	0.00	0 0	)	87	79	57	57	83.9	33.6	70	62	104.3	84.5	208	1 30.7	35	1183	1,2,3,4,5,6
ERV 1	RUPP AIR	RARTU1-I.200-15-5T	1540	1540	15P-1	DIRECT	2.00	2.50	1.140	2 1	400 192	5 15P-1	DIRECT	1.00	1.50	1.14	2 0	)	80	66	53	53	59.9	43.9	75	61	196.2	156.9	208	3 38.1	40	1649	1,2,3,4,5

- 1. ESP DOES NOT INCLUDE DIRTY FILTER PRESSURE DROP. ADD 0.5" TO INTERNAL PRESSURE DROP FOR DIRTY FILTERS.
- 2. PROVIDE UNIT WITH FACTORY MOUNTED AND WIRED DISCONNECT FOR SINGLE-POINT ELECTRICAL CONNECTION. 3. PROVIDE UNIT WITH FACTORY MOUNTED AND WIRED VFD.
- 4. PROVIDE INSULATED ROOF CURB, HEIGHT AS REQUIRED TO PROVIDE 18" CLEARANCE ABOVE FINISHED ROOF. REFER TO ARCHITECTURAL DRAWINGS FOR ROOF SLOPE.
- 5. PROVIDE BURNER WITH MODULATING GAS HEAT. 6. PROVIDE UNIT WITH BAROMETRIC RELIEF DAMPER

- A. PROVIDE MINIMUM EFFICIENCY OF MERV 6 FILTERS DURING CONSTRUCTION AND CHANGE MONTHLY AFTER UNIT START-UP. FINAL FILTER CHANGE AT OWNER OCCUPANCY SHALL BE MERV 8.
- B. ELECTRICAL CONTRACTOR SHALL PROVIDE SMOKE DETECTORS IN THE MAIN RETURN DUCT AND INTERLOCK WITH UNIT PER CODE.
- C. FUEL SOURCE FOR GAS HEATER IS NATURAL GAS. D. PROVIDE A CONDENSATE DRAIN WITH A TRAP DEPTH 2" DEEPER THAN THE EXPECTED STATIC PRESSURE AT THE DRAIN LOCATION IN THE UNIT AND EXTEND TO NEAREST ROOF DRAIN.
- E. COOLING CAPACITY SHALL BE BASED ON 105 F AMBIENT TEMPERATURE.

### GRILLE, REGISTER, AND DIFFUSER SCHEDULE

EQUIPMENT MARK	MANUFACTURER	MODEL	FACE SIZE	SERVICE	MAX NC	MAX PRESSURE DROP (IN WG)	DAMPER	NOTES
E1	TITUS	355FL	12x12	EXHAUST	30	0.10	NO	
E2	TITUS	355RL	SEE PLAN	EXHAUST	30	0.10	YES	
E3	TITUS	355FL	12x12	EXHAUST	30	0.10	YES	
R1	TITUS	OMNI	24x24	RETURN	30	0.10	NO	
S1	TITUS	ML-39	48"x4"	SUPPLY	30	0.10	NO	1,2
S2	TITUS	S300FL	SEE PLAN	SUPPLY	30	0.10	YES	
S3	TITUS	300RL	SEE PLAN	SUPPLY	30	0.10	NO	
S4	TITUS	OMNI	24x24	SUPPLY	30	0.10	NO	
S5	TITUS	OMNI	12x12	SUPPLY	30	0.10	NO	

- I. PROVIDE 2 1" SLOTS AND MANUFACTURER'S 48" INSULATED PLENUM WITH 10" INLET. CONTRACTOR SHALL CONSTURCT A PLENUM EXTENSION AS REQUIRED FOR THE PLENUM TO CLEAR THE CEILING STRUCTURE. EACH DIFFUSER GROUPING SHALL CONSIST OF (2) 48"
- ACTIVE FACE GRILLES, AND (1) 48" BLANK SECTION. PERFORMANCE DATA ON PLAN IS LISTED PER 48" SECTION. PROVIDE DIFFUSER WITH BOARDER TYPE 15, FLUSH CONCEALED BOARDER. COLOR SHALL BE SELECTED BY ARCHITECT

- GENERAL NOTES (APPLY TO ALL ABOVE):

  A. PROVIDE MOUNTING FRAME TO MATCH CEILING TYPE. VERIFY WITH ARCHITECT'S PLANS PRIOR TO ORDERING.
- B. REFER TO DIFFUSER TAGS ON PLANS FOR NECK SIZE AND AIRFLOW.
- C. UNLESS NOTED OTHERWISE, COLOR SHALL BE STANDARD WHITE. D. FOUR-WAY THROW PATTERN FOR SQUARE DIFFUSERS UNLESS NOTED OTHERWISE.
- E. MAXIMUM NC OF 30 FOR ALL GRILLES, REGISTERS, AND DIFFUSERS.

### F. MAXIMUM PRESSURE DROP OF 0.1 IN-WG FOR ALL GRILLES, REGISTERS, AND DIFFUSERS.

# **FAN SCHEDULE**

EQUIPMENT MARK	MANUFACTURER	MODEL	CFM	STATIC PRESSURE (IN WG)	DRIVE	ВНР	HP	VOLTS	PHASE	NOTES
EF 1	LOREN COOK	ACED	2700	0.20	DIRECT	0.47	0.75	120	1	2,3,4,5
EF 2	LOREN COOK	ACED	200	0.20	DIRECT	0.00	0.05	120	1	2,3,4,5
EF 3	LOREN COOK	GC-422	50	0.10	DIRECT	0.03	0.03	120	1	2,3,6
EF 4	LOREN COOK	GC-422	275	0.20	DIRECT	0.00	0.00	120	1	2,3,6
SF 1	LOREN COOK	SQN-D	250	0.00	DIRECT	0.00	0.00	120	1	2,3
VF 1	SKY BLADE	FNTM-1443	0	0.00	DIRECT	1.50	1.35	208	3	1,2

- 1. PROVIDE 14FT. DIA. 6-BLADE HVLS FAN AND MANUFACTUERERS SINGLE YOKE CONTROLLER. 2. PROVIDE ALL REQUIRED ACCESSORIES FOR A COMPLETE INSTALLATION.
- PROVIDE WITH FACTORY INSTALLED AND WIRED DISCONNECT AND SPEED CONTROLLER.
- 4. PROVIDE TALL ROOF CURB, HEIGHT AS REQUIRED TO PROVIDE 18" CLEARANCE ABOVE FINISHED FLOOR. PROVIDE WITH BACKDRAFT DAMPER, AND INTEGRAL BIRD SCREEN.
- 6. PROVIDE WITH MANUFACTURER'S ALUMINUM GRILLE.

### VRF INDOOR UNIT SCHEDULE

						COOLING	COOLING		El	LECTRIC	Ά		
EQUIPMENT				DOAS	SUPPLY	TOTAL	SENSIBLE	HEATING				MOCP	
MARK	MANUFACTURER	MODEL	UNIT TYPE	AIR CFM	AIR CFM	BTUH	BTUH	BTUH	VOLTS	PHASE	MCA	(A)	NOTES
VRU 106	TRANE	TPLFYP015FM140A	24x24 Cassette	0	390	14747.0	9037.0	11548.0	208	1	0.4	15	
VRU 108	TRANE	TPLFYP008FM140A	24x24 Cassette	20	315	7865.0	5509.0	6114.0	208	1	0.3	15	2
VRU 116	TRANE	TPLFYP024EM140A	36x36 Cassette	0	810	24000.0	17100.0	27000.0	208	1	0.4	15	
VRU 117	TRANE	TPLFYP024EM140A	36x36 Cassette	0	810	24000.0	17100.0	27000.0	208	1	0.4	15	
VRU 122	TRANE	TPLFYP018FM140A	24x24 Cassette	0	460	17696.0	10869.0	13586.0	208	1	0.5	15	
VRU 200	TRANE	TPEFYP015MA144A	CONCEALED	0	494	14747.0	10108.0	11548.0	208	1	2.9	15	1
VRU 201A	TRANE	TPEFYP005FM140A	24x24 Cassette	25	280	4916.0	3819.0	3804.0	208	1	0.2	15	2
VRU 201B	TRANE	TPEFYP005FM140A	24x24 Cassette	25	280	4916.0	3819.0	3804.0	208	1	0.2	15	2
VRU 202	TRANE	TPLFYP008FM140A	24x24 Cassette	25	315	7865.0	5509.0	6114.0	208	1	0.3	15	2
VRU 203	TRANE	TPLFYP008FM140A	24x24 Cassette	25	315	7865.0	5509.0	6114.0	208	1	0.3	15	2
VRU 205	TRANE	TPEFYP005FM140A	24x24 Cassette	0	280	4916.0	3819.0	3804.0	208	1	0.2	15	
VRU 208	TRANE	TPLFYP012FM140A	24x24 Cassette	25	335	11797.0	7347.0	9171.0	208	1	0.3	15	2
VRU 209	TRANE	TPLFYP012FM140A	24x24 Cassette	25	335	11797.0	7347.0	9171.0	208	1	0.3	15	2
VRU 210	TRANE	TPEFYP005FM140A	24x24 Cassette	25	280	4916.0	3819.0	3804.0	208	1	0.2	15	2
VRU 211	TRANE	TPEFYP005FM140A	24x24 Cassette	25	280	4916.0	3819.0	3804.0	208	1	0.2	15	2
VRU 212	TRANE	TPEFYP005FM140A	24x24 Cassette	25	280	4916.0	3819.0	3804.0	208	1	0.2	15	2
VRU 213	TRANE	TPEFYP005FM140A	24x24 Cassette	25	280	4916.0	3819.0	3804.0	208	1	0.2	15	2

### NOTES: 1. PROVIDE UNIT WITH FBM2-2-A FILTER BOX.

2. CONNECT DOAS SUPPLY AIR TO EQUIPMENT OUTSIDE AIR DUCT CONNECTION. PROVIDE REDUCER AT CONNECTION AS REQUIRED.

- A. INDOOR UNIT CAPACITIES BASED ON INDOOR SPACE CONDITIONS: SUMMER = 75F/55%RH, WINTER = 70F
- B. MANUFACTURER TO SIZE REFRIGERANT PIPING AND CALCULATE REFRIGERANT VOLUME REQUIRED. PROVIDE DIAGRAMS WITH SUBMITTALS. C. PROVIDE MANUFACTURER'S BASIC THERMOSTATS AND CENTRAL CONTROLLER. PROVIDE WITH WEB-INTERFACE CAPABILITY.
- D. PROVIDE MANUFACTURER'S INTEGRAL CONDENSATE PUMP. E. PROVIDE 3/4" CONDENSATE LINE UNLESS OTHERWISE NOTED

### VRF OUTDOOR UNIT SCHEDULE

							E	LECTRICAL DATA				
			CORRECTED	CORRECTED	FIELD			UNI	T #1	UNI	T #2	
<b>EQUIPMENT</b>			COOLING	HEATING	REFRIGERANT				MOCP		MOCP	
MARK	MANUFACTURER	MODEL	BTUH	BTUH	CHARGE (lbs)	VOLTS	PHASE	MCA	(A)	MCA	(A)	NOTES
VRF 1	TRANE	TURYH1443BN40AN	143867.0	135184.0	33.1	208	3	38.0 A	60 A	38.0 A	60 A	1

# NOTES: 1. PROVIDE FACTORY INSTALLED PHASE MONITOR.

- GENERAL NOTES:

  A. OUTDOOR UNIT CAPACITIES BASED ON AMBIENT TEMPERATURES: SUMMER = 105F, WINTER -10F B. MANUFACTURER TO SIZE REFRIGERANT PIPING AND CALCULATE REFRIGERANT VOLUME REQUIRED. PROVIDE DIAGRAMS WITH SUBMITTALS.
- PROVIDE MANUFACTURER'S BASIC THERMOSTATS AND CENTRAL CONTROLLER. PROVIDE OUTDOOR UNIT WITH MANUFACTURER'S LOW AMBIENT KIT.
- MOUNT UNITS ON STRUCTURAL STEEL BASE AT LEAST 24" ABOVE ROOF QUICKSLING VRF SUPERSTAND OR EQUIVALENT
- PROVIDE TOP HOOD ACCESSORY, AND HAIL GUARDS.

### **PUMP SCHEDULE**

EQUIPMENT MARK	MANUFACTURER	MODEL	GPM	HEAD	ВНР	HP	VOLTS	PHASE	NOTES
HWP 1	TACO	VR15L	37	15	0.36	0.40	120	1	1
HWP 2	TACO	0034e	14	15	0.00	0.00	120	1	1
HWP 3	TACO	0034e	23	19	0.00	0.00	120	1	1

1. PUMP SHALL HAVE INTEGRAL VFD/ECM MOTOR AND SMART CONTROL. PUMPS SHALL BE SET FOR CONSTANT

GENERAL NOTES (APPLY TO ALL ABOVE):

A. FLUID IS 30% PROPYLENE GLYCOL. B. ALL PUMPS SHALL BE NON-OVERLOADING.

# **HOOD & LOUVER SCHEDULE**

EQUIPMENT				SIZE		AIRFLOW	MIN. FREE	MAX. PD	
MARK	MANUFACTURER	MODEL	SERVICE	W	Н	CFM	AREA (S.F.)	INCHES WC	NOTES
IH 1	GREENHECK	GRSI-8	INTAKE	10 1/2"	10 1/2"	250	0.35	0.08	
LV 1	RUSKIN	ELC-6375DAX	INTAKE	24"	48"	2700	4.09	0.15	1

NOTES:

1. PROVIDE COMBINATION LOUVER/DAMPER. DAMPER SHALL BE CONTROLLED WITH EF-1 FAN OPERATION.

GENERAL NOTES (APPLY TO ALL ABOVE):

A. PROVIDE MOUNTING FRAME TO MATCH CONSTRUCTION.

B. COLOR TO BE SELECTED BY CONTRACTOR FROM MANUFACTURER'S STANDARD COLORS. C. PROVIDE ALL FASTENERS, HANGERS, AND ASSOCIATED DEVICES REQUIRED FOR COMPLETE INSTALLATION.

## **ELECTRIC UNIT HEATER SCHEDULE**

						LECIRIO	AL DAI	A	
EQUIPMENT			SUPPLY	ELEMENT				MOCP	
MARK	MANUFACTURER	MODEL	CFM	KW	VOLTS	PHASE	FLA	(A)	NOTES
EWH 1	QMARK	AWH3150F	100	1.5	120	1	15.6	20	1,2
EWH 2	QMARK	AWH3150F	100	1.5	120	1	15.6	20	1,2
EWH 3	QMARK	AWH3150F	100	1.5	120	1	15.6	20	1,2
EWH 4	QMARK	AWH3150F	100	1.5	120	1	15.6	20	1,2
EWH 5	QMARK	AWH3150F	100	1.5	120	1	15.6	20	1,2
EWH 6	QMARK	AWH3150F	100	1.5	120	1	15.6	20	1,2
EWH 7	QMARK	AWH3150F	100	1.5	120	1	15.6	20	1,2
EWH 8	QMARK	AWH3150F	100	1.5	120	1	15.6	20	1,2
EWH 9	QMARK	AWH3150F	100	1.5	120	1	15.6	20	1,2
EWH 10	QMARK	AWH3150F	100	1.5	120	1	15.6	20	1,2
UH 1	QMARK	MUH0381-PRO	350	3.0	208	1	14.5	20	1,3,4
UH 2	QMARK	MUH0381-PRO	350	3.0	208	1	14.5	20	1,3,4

NOTES:

1. PROVIDE UNIT WITH FACTORY MOUNTED AND WIRED DISCONNECT FOR A SINGLE-POINT ELECTRICAL

- 2. PROVIDE A UNIT-MOUNTED, FACTORY WIRED THERMOSTAT.
- 3. PROVIDE MANUFACTURER'S STANDARD 24V WALL-MOUNTED THERMOSTAT. 4. PROVIDE WITH MANUFACTURER'S STANDARD LOUVER AND CEILING MOUNTING BRACKET.

GENERAL NOTES:

A. ELECTRIC HEAT KW SHOWN IS ACTUAL OUTPUT AT THE VOLTAGE SHOWN. B. CABINET COLOR TO BE SELECTED BY ARCHITECT FROM MANUFACTURER'S STANDARD COLOR.

### **BOILER SCHEDULE**

			GAS LOAD (BTU/H)			WATER TEMP	ERATURE (°F)	E	LECTRIC	AL DATA	4
EQUIPMENT MARK	MANUFACTURER	MODEL	INPUT	ОИТРИТ	FLOW (GPM)	ENTERING	LEAVING	VOLTS	PHASE	MCA	MOCP (A)
1415-21 21 2	MANOI ACIONEN	MODEL	1141 01	0011 01	(01 111)	LITTLITIES	LLAVIIIO	VOLIG	I IIAOL	INIOA	(~)
B 1	AERCO	AM 399-500	500.0	495.0	33.0	80	110	120	1	2.25	15

A. PROVIDE WITH CONDENSATE NEUTRALIZATION KIT. B. PROVIDE LOW WATER CUTOFF WITH MANUAL RESET.

- C. PROVIDE ASME RELIEF VALVE.
- D. FUEL SOURCE IS NATURAL GAS E. OUTPUT SHALL BE BASED ON 40% PROPYLENE GLYCOL

# VRF BRANCH SELECTOR BOX SCHEDULE

	ELE	CTR	ICAL	. DAT	Ά	

EQUIPMENT MARK	MANUFACTURER	MODEL	VOLTS	PHASE	MCA	MOCP (A)
BS 1	TRANE	TCMBM1012JA1	208	1	0.7	15
BS 2	TRANE	TCMBM1012JA11N4	208	1	1.6	15

A. MANUFACTURER TO SIZE REFRIGERANT PIPING AND CALCULATE REFRIGERANT VOLUME

REQUIRED. PROVIDE DIAGRAMS WITH SUBMITTALS.

B. PROVIDE MANUFACTURER'S INTEGRAL CONDENSATE PUMP. C. PROVIDE 3/4" CONDENSATE LINE UNLESS OTHERWISE NOTED.

# BARTLEY NUMBER \*PE-2007023868 -1-

80 LE

9229 WARD PARKWAY SUITE # 210 KANSAS CITY, MO 64114 TEL: (816) 444-4200 FAX: (316) 265-5646 www.glmv.com

**CONSULTING ARCHITECT** 

RESTON, VIRGINIA 20190

GLMV ARCHITECTURE, INC MISSOURI CIVIL COA #2018033898 MISSOURI LANDSCAPE COA #000008 9229 WARD PARKWAY, SUITE # 210

KANSAS CITY, MO 64114 TEL: (816) 444-4200

STRUCTURAL ENGINEER

MISSOURI COA #001644 250 NE MULBERRY, SUITE 201 LEE'S SUMMIT, MO 64086

SECURITY & IT ENGINEERS HENDERSON ENGINEERS

1801 MAIN STREET, SUITE 300

MISSOURI COA #000556

KANSAS CITY, MO 64108

(816) 663-8700

FIRE STAT

REVISIONS:

# Description

(816) 444-3144

11250 ROGER BACON DRIVE, SUITE 16

CIVIL ENGINEER & LANDSCAPE ARCH.

MECH., ELECT. & PLMG. ENGINEERS HOSS & BROWN ENGINEERS MISSOURI COA #01022 15902 MIDLAND DRIVE SHAWNEE, KS 66217 (913) 362.9090

FGMA ARCHITECTS

TEL: (703) 956-5600

MO# PE-2007023868

PRO IECT NO:

TROSECTIVO.	10223112 100 1
DATE:	10.20.2022
DRAWN BY:	JL
CHK'D BY:	NB

Architecture, Inc. and is not to be copied or used **MECHANICAL** 

**SCHEDULES** 

	PE INSULA DESCRIPTION	- <del></del>					
	FIBER GLASS RIGID I	MOLDED INSULA	TION - JOHNS-MAN	VILLE MICRO-LOK, A	SJ JACKET, K-VALU	JE = 0.23, MAX SERV	CE TEMP =
	VAPOR TRANSMISSI			•	<u> </u>		
	ARMACELL AP/ARMA		•	,	•		
	VAPOR PERMEABILIT PVC JACKETS, HIGH-			<u> </u>			END JOIN
	COMPLIES WITH AST		,	., 00 11112 1111011, 1	0 V (		2112 0011
	ALUMINUM JACKETS	•	MBOSSED FINISH, L	ONGITUDINAL SLIP	JOINTS AND 2" LAP	PS	
	COMPLIES WITH AST SULATED PIPE SUPF		-MOLDED PIPE SUE	PPORTS VAPOR BAI	RRIFR AND GALVAN	JIZED STEEL SHIELD	FOR
	> 1 1/2" PIPES MINIM	•		•			•
INSULATED PIPE S	SUPPORTS						
	PIPE SIZE		INSERT LENGTH	SHIELD LENGTH	SHIELD GAUGE	INSULATION	
	1 1/2" TO 5"		6"	4"	20	TYPE 5	4
	6" TO 8" 10" TO 12"		9" 9"	6" 6"	16 14	TYPE 5 TYPE 5	4
	14" AND LARGER		12"	10"	12	TYPE 5	4
INSULATION THICK	(NESS FOR PIPES LO	CATED WITHIN	THE BUILDING THE	RMAL ENVELOPE			
PIPING	CONTINUOUS		PIPE	SIZE			
SYSTEM	VAPOR BARRIER	< 1 1/2"	1 1/2" - 4"	5" - 6"	>= 8"	INSULATION	
HWS & HWR	NO	1 1/2"	2"	2"	2"	TYPE 1	1
COOL COIL	YES	1/2"	1/2"	1/2"	1/2"	TYPE 2	2
REFRIG SUCTION	YES OR DIDES LO	3/4"	3/4"	3/4"	3/4"	TYPE 2	2
	(NESS FOR PIPES LC	JCATED OUTSIDE					
PIPING	CONTINUOUS	. 4.4/00		SIZE		1110111 471011	
SYSTEM HWS & HWR	VAPOR BARRIER NO	<= 1 1/2"	<b>2" - 4"</b> 2"	<b>5" - 6"</b>	>= <b>8"</b> 2"	INSULATION TYPE 1,4	 1
COOL COIL	YES	1/2"	1/2"	1/2"	1/2"	TYPE 1,4	2
REFRIG SUCTION	YES	3/4"	3/4"	3/4"	3/4"	TYPE 2,4	2
NOTES:		C TEES ELANO	•	,			ROPRIAT
1. A	ALL FITTINGS, VALVE	, ,		//ATCH PV/C:.JACKET	S. (FOR FIBER GLAS	SS INSULATION)	
1. <i>I</i>	NSULATED FITTING	COVERS. FITTING			SULATED AND COVE	,	RUPRIAI
1. A 1 2. A	,	COVERS. FITTING ES, TEES, FLANG	ES, CONNECTIONS	, ETC. SHALL BE INS		RED WITH THE APP	
1.	NSULATED FITTING ALL FITTINGS, VALVE	COVERS. FITTING ES, TEES, FLANG ED INSULATION I	ES, CONNECTIONS FITTINGS. PROVIDE	, ETC. SHALL BE INS ARMAFIX PRE-INSU	JLATED PIPE HANGI	ERED WITH THE APP ER FITTINGS AT ALL	HANGEI
1. A 1 2. A 5 3. S	NSULATED FITTING ALL FITTINGS, VALVE FACTORY-FABRICAT	COVERS. FITTING ES, TEES, FLANG ED INSULATION I SEAMS, ENG JO	ES, CONNECTIONS FITTINGS. PROVIDE INTS AND PROTRU	, ETC. SHALL BE INS ARMAFIX PRE-INSU SIONS WITH VAPOR	JLATED PIPE HANGI R-BARRIER MASTIC /	ERED WITH THE APP ER FITTINGS AT ALL	HANGE
1.	NSULATED FITTING ALL FITTINGS, VALVE FACTORY-FABRICAT SEAL LONGITUDINAL PIPE INSERT THICKN	COVERS. FITTING ES, TEES, FLANG ED INSULATION I SEAMS, ENG JO IESS SHALL BE E	ES, CONNECTIONS FITTINGS. PROVIDE INTS AND PROTRU	, ETC. SHALL BE INS ARMAFIX PRE-INSU SIONS WITH VAPOR	JLATED PIPE HANGI R-BARRIER MASTIC /	ERED WITH THE APP ER FITTINGS AT ALL	HANGER
1. A 2. A 5 3. S 4. F	NSULATED FITTING ALL FITTINGS, VALVE FACTORY-FABRICAT SEAL LONGITUDINAL PIPE INSERT THICKN  (APPLY ALL TO ABO	COVERS. FITTINGES, TEES, FLANGED INSULATION INSULATION INSULATION INSERTION INSULATION I	ES, CONNECTIONS FITTINGS. PROVIDE INTS AND PROTRU QUAL TO THE ADJO	, ETC. SHALL BE INS ARMAFIX PRE-INSU SIONS WITH VAPOR DINING INSULATION	JLATED PIPE HANGI R-BARRIER MASTIC / THICKNESS	ERED WITH THE APP ER FITTINGS AT ALL AND JOINT SEALANT	HANGEF
1.	NSULATED FITTING ALL FITTINGS, VALVE FACTORY-FABRICAT SEAL LONGITUDINAL PIPE INSERT THICKN	COVERS. FITTINGES, TEES, FLANGED INSULATION	ES, CONNECTIONS, FITTINGS. PROVIDE INTS AND PROTRU QUAL TO THE ADJO	, ETC. SHALL BE INS ARMAFIX PRE-INSUSIONS WITH VAPOR DINING INSULATION	JLATED PIPE HANGI R-BARRIER MASTIC A THICKNESS DHNS-MANVILLE WH	ERED WITH THE APP ER FITTINGS AT ALL AND JOINT SEALANT IICH SHALL REPRES	HANGEF ENT THE
1. A  1. A  2. A  5. A  4. F  GENERAL NOTES:  A. T	NSULATED FITTING ALL FITTINGS, VALVE FACTORY-FABRICAT SEAL LONGITUDINAL PIPE INSERT THICKN  (APPLY ALL TO ABOTHE BASIS FOR FIBE	COVERS. FITTINGES, TEES, FLANGED INSULATION IS SEAMS, ENG JOSESS SHALL BE ENG FOR THE INCOMPTENT OF TH	ES, CONNECTIONS FITTINGS. PROVIDE INTS AND PROTRU QUAL TO THE ADJO SULATION AND FIT	, ETC. SHALL BE INS ARMAFIX PRE-INSUSIONS WITH VAPOR DINING INSULATION TING COVERS IS JO D BY OWENS-CORNI	JLATED PIPE HANGI R-BARRIER MASTIC A THICKNESS PHNS-MANVILLE WH ING AND KNAUF SHA	ERED WITH THE APPER FITTINGS AT ALL AND JOINT SEALANT  IICH SHALL REPRES ALL BE PERMITTED	HANGER  ENT THE I
1.	NSULATED FITTING ALL FITTINGS, VALVE FACTORY-FABRICAT SEAL LONGITUDINAL PIPE INSERT THICKN  (APPLY ALL TO ABO THE BASIS FOR FIBE LEVEL OF CONSTRUCTHE BASIS FOR FLEX PRODUCTS MANUFA	COVERS. FITTINGES, TEES, FLANGED INSULATION INSULATION INSULATION INSULATION IN SEAMS, ENG JOURNESS SHALL BE ENDED IN CTION. PRODUCTION. PRODUCTURED BY AER	ES, CONNECTIONS, FITTINGS. PROVIDE INTS AND PROTRUM QUAL TO THE ADJUMENTATION AND FIT IS MANUFACTURED RIC INSULATION IS OFLEX SHALL BE P	ETC. SHALL BE INSTANTION  ARMAFIX PRE-INSUSIONS WITH VAPOR  DINING INSULATION  TING COVERS IS JOURNAL BY OWENS-CORNI  ARMACELL WHICH  ERMITTED TO BID.	JLATED PIPE HANGI R-BARRIER MASTIC A THICKNESS PHNS-MANVILLE WH ING AND KNAUF SHA SHALL REPRESENT	ERED WITH THE APPER FITTINGS AT ALL AND JOINT SEALANT  IICH SHALL REPRES ALL BE PERMITTED THE MINIMUM LEVI	HANGER  ENT THE I
1.	INSULATED FITTING ALL FITTINGS, VALVE FACTORY-FABRICAT SEAL LONGITUDINAL PIPE INSERT THICKN  (APPLY ALL TO ABOUTHE BASIS FOR FIBE LEVEL OF CONSTRUCTED SEASIS FOR FLEX	COVERS. FITTINGES, TEES, FLANGED INSULATION IS SEAMS, ENG JOUTESS SHALL BE ENGLY BE INCTION. PRODUCTION. PRODUCTION. PRODUCTIONED BY AER SULATION PER MEDITAL STORES.	ES, CONNECTIONS, FITTINGS. PROVIDE INTS AND PROTRUM QUAL TO THE ADJUMENTATION AND FIT IS MANUFACTURED RIC INSULATION IS OFLEX SHALL BE PIANUFACTURER'S F	ETC. SHALL BE INSTALL BETTER BET	JLATED PIPE HANGI R-BARRIER MASTIC A THICKNESS PHNS-MANVILLE WH ING AND KNAUF SHA SHALL REPRESENT	ERED WITH THE APPER FITTINGS AT ALL AND JOINT SEALANT  IICH SHALL REPRES ALL BE PERMITTED THE MINIMUM LEVI	HANGER  ENT THE I

# **DUCT INSULATION SCHEDULE**

	OSEATION COTTEDUE
INSULATION	DESCRIPTION
TYPE 1	WRAP INSULATION - CERTAINTEED SOFTTOUCH, TYPE 150, FSK FACED, 1 1/2" THICK, 1.5 PCF, K-VALUE = 0.24, R-VALUE = 6.2, VAPOR TRANSMISSION = 0.02 PERMS MAX. COMPLIES WITH ASTM C553 TYPE II, ASTM C1290 AND ASTM C1338 FUNGI RESISTANCE
TYPE 2	WRAP INSULATION - CERTAINTEED SOFTTOUCH, TYPE 75, FSK FACED, 3" THICK, 0.75 PCF, K-VALUE = 0.31, R-VALUE = 9.6, VAPOR TRANSMISSION = 0.02 PERMS MAX. COMPLIES WITH ASTM C553 TYPE II, ASTM C1290 AND ASTM C1338 FUNGI RESISTANCE
TYPE 3	ROUND DUCT LINER - CERTAINTEED ULTRAROUND DUCT LINER, 1" THICK, K-VALUE = 0.23, R-VALUE = 4.3, NRC = 0.75. COMPLIES WITH ASTM C1071 TYPE I, ASTM G22 BACTERIA RESISTANCE AND ASTM C1338 FUNGI RESISTANCE.
TYPE 4	DUCT LINER - CERTAINTEED TOUGHGARD R DUCT LINER, TYPE 200, 1/2" THICK, 2.0 PCF, K-VALUE = 0.24, R-VALUE = 2.1, NRC = 0.45. COMPLIES WITH ASTM C1071 TYPE I, ASTM G22 BACTERIA RESISTANCE AND ASTM C1338 FUNGI RESISTANCE.

DUCT WITHIN THE BUILDING THERMAL ENVELOPE										
DUCT TYPE - CONCEALED	INSULATION	NOTES	DUCT TYPE - EXPOSED	INSULATION	NOTES					
ROUND LOW PRESSURE SUPPLY AIR	TYPE 1	-	ROUND LOW PRESSURE SUPPLY AIR	TYPE 3	-					
ROUND LOW PRESSURE RETURN AIR	NONE	-	ROUND LOW PRESSURE RETURN AIR	NONE	-					
ROUND OUTDOOR AIR	TYPE 2	-	ROUND OUTDOOR AIR	TYPE 2	-					
ROUND VENTILATION AIR	NONE	-	ROUND VENTILATION AIR	NONE	-					
ROUND MIXED AIR	TYPE 1	-	ROUND MIXED AIR	TYPE 1	-					
ROUND LOW PRESSURE EXHAUST AIR	NONE	-	ROUND LOW PRESSURE EXHAUST AIR	NONE	-					
ROUND LOW PRESSURE RELIEF AIR	TYPE 2	-	ROUND LOW PRESSURE RELIEF AIR	TYPE 2	-					
RECTANGULAR LOW PRESSURE SUPPLY AIR	TYPE 1	-	RECTANGULAR LOW PRESSURE SUPPLY AIR	TYPE 1	-					
RECTANGULAR LOW PRESSURE RETURN AIR	NONE	-	RECTANGULAR LOW PRESSURE RETURN AIR	NONE	-					
RECTANGULAR OUTDOOR AIR	TYPE 2	-	RECTANGULAR OUTDOOR AIR	TYPE 2	-					
RECTANGULAR VENTILATION AIR	NONE	-	RECTANGULAR VENTILATION AIR	NONE	-					
RECTANGULAR MIXED AIR	TYPE 1	-	RECTANGULAR MIXED AIR	TYPE 1	-					
RECTANGULAR LOW PRESSURE EXHAUST AIR	NONE	-	RECTANGULAR LOW PRESSURE EXHAUST AIR	NONE	-					
RECTANGULAR LOW PRESSURE RELIEF AIR	TYPE 2	-	RECTANGULAR LOW PRESSURE RELIEF AIR	TYPE 2	-					

DUCT TYPE - CONCEALED	INSULATION	NOTES	DUCT TYPE - EXPOSED	INSULATION	NOTES
ROUND LOW PRESSURE SUPPLY AIR	TYPE 2	-	ROUND LOW PRESSURE SUPPLY AIR	TYPE 2	-
ROUND LOW PRESSURE RETURN AIR	TYPE 2	-	ROUND LOW PRESSURE RETURN AIR	TYPE 2	-
ROUND OUTDOOR AIR	TYPE 1	-	ROUND OUTDOOR AIR	TYPE 1	-
ROUND VENTILATION AIR	TYPE 2	-	ROUND VENTILATION AIR	NONE	-
ROUND MIXED AIR	TYPE 2	-	ROUND MIXED AIR	TYPE 2	-
ROUND LOW PRESSURE EXHAUST AIR	TYPE 1	-	ROUND LOW PRESSURE EXHAUST AIR	TYPE 1	-
ROUND LOW PRESSURE RELIEF AIR	NONE	-	ROUND LOW PRESSURE RELIEF AIR	NONE	-
RECTANGULAR LOW PRESSURE SUPPLY AIR	TYPE 2	-	RECTANGULAR LOW PRESSURE SUPPLY AIR	TYPE 2	-
RECTANGULAR LOW PRESSURE RETURN AIR	TYPE 2	-	RECTANGULAR LOW PRESSURE RETURN AIR	TYPE 2	-
RECTANGULAR OUTDOOR AIR	TYPE 1	-	RECTANGULAR OUTDOOR AIR	TYPE 2	-
RECTANGULAR VENTILATION AIR	TYPE 2	-	RECTANGULAR VENTILATION AIR	NONE	-
RECTANGULAR MIXED AIR	TYPE 2	-	RECTANGULAR MIXED AIR	TYPE 2	-
RECTANGULAR LOW PRESSURE EXHAUST AIR	TYPE 1	-	RECTANGULAR LOW PRESSURE EXHAUST AIR	TYPE 1	-
RECTANGULAR LOW PRESSURE RELIEF AIR	NONE	-	RECTANGULAR LOW PRESSURE RELIEF AIR	NONE	-

ACOUSTICALLY LINED DUCTS					
DUCT TYPE	INSULATION	NOTES	DUCT TYPE	INSULATION	NOTES
RECTANGULAR SUPPLY AIR AT CENTRAL UNIT	TYPE 4	1	RECTANGULAR EXHAUST AIR	TYPE 4	4
RECTANGULAR SUPPLY AIR AT FAN TERMINAL UNIT	TYPE 4	2	RECTANGULAR RETURN AIR BOOTS	TYPE 4	-
RECTANGULAR RETURN AIR AT CENTRAL UNIT	TYPE 4	3	RECTANGULAR RETURN AIR TRANSFERS	TYPE 4	-

- 1. THE VERTICAL DUCTWORK FROM THE UNIT DISCHARGE TO HORIZONTAL AND THE FIRST 10 FEET OF HORIZONTAL DUCTWORK IN ALL DIRECTIONS (TYPICAL FOR CENTRAL AHU, RTU, MAU, DOAU, ETC.)
- 2. THE FIRST 10 FEET OF DUCTWORK FROM THE FAN TERMINAL OUTLET.
- 3. THE VERTICAL DUCTWORK FROM THE UNIT INLET TO HORIZONTAL AND THE FIRST 10 FEET OF HORIZONTAL DUCTWORK IN ALL DIRECTIONS (TYPICAL FOR CENTRAL AHU, RTU, MAU, DOAU, ETC.)
- 4. THE FIRST 10 FEET OF DUCTWORK FROM THE EXHAUST FAN INLET.

### GENERAL NOTES (APPLY ALL TO ABOVE):

- A. THE BASIS FOR THE DUCT INSULATION IN THIS SCHEDULE IS CERTAIN-TEED WHICH SHALL REPRESENT THE MINIMUM LEVEL OF CONSTRUCTION. PRODUCTS MANUFACTURED BY OWENS-CORNING, JOHNS-MANSVILLE, KNAUF, 3M, FIREMASTER AND AEROFLEX SHALL BE PERMITTED TO BID.
- B. REFER TO FLOOR PLANS AS ADDITIONAL INSULATION REQUIREMENTS MAY BE INDICATED THERE.
- C. THE REQUIREMENT FOR ACOUSTICAL INSULATION IS IN ADDITION TO THE THERMAL INSULATION REQUIREMENT. PROVIDE EXTERNAL THERMAL INSULATION AND INTERNAL ACOUSTICAL LINER AS INDICATED.
- D. INSTALL ALL DUCT INSULATION PER MANUFACTURER'S PUBLISHED INSTALLATION INSTRUCTIONS.

**DEFINITIONS:** SUPPLY AIR: CONDITIONED AIR FROM AN AIR HANDLING SYSTEM TO AN OCCUPIED SPACE RETURN AIR: AIR FROM AN OCCUPIED SPACE BACK TO AN AIR HANDLING SYSTEM VENITLATION AIR: CONDITIONED AIR FROM THE DISCHARGE OF THE DOAS TO THE OCCUPIED SPACE RELIEF AIR: AIR DOWNSTREAM OF THE DOAS/ERW ENERGY RECOVERY SYSTEM TO OUTSIDE THE BUILDING OUTSIDE AIR: UNCONDITIONED AIR FROM OUTSIDE THE BUILDING TO AN AIR HANDLING SYSTEM

EXHAUST AIR: AIR THAT IS REMOVED FROM A BUILDING SPACE AND CONVEYED TO OUTSIDE THE BUILDING

LOW PRESSURE: LESS THAN 2" STATIC PRESSURE

CONCEALED LOCATION: DUCT IS LOCATED ABOVE A CEILING, WITHIN CHASE OR SHAFT, ETC. EXPOSED LOCATION: DUCT IS NOT CONCEALED WITH THE BUILDING CONSTRUCTION (FINISHED SPACES, OR UNFINSHED SUCH AS MECHANICAL ROOMS)

9229 WARD PARKWAY SUITE # 210 KANSAS CITY, MO 64114 TEL: (816) 444-4200 FAX: (316) 265-5646

GLMV ARCHITECTURE, INC. MISSOURI STATE CERTIFICATE OF AUTHORITY #000305 CONSULTING ARCHITECT

FGMA ARCHITECTS

www.glmv.com

11250 ROGER BACON DRIVE, SUITE 16 RESTON, VIRGINIA 20190 TEL: (703) 956-5600 CIVIL ENGINEER & LANDSCAPE ARCH.

GLMV ARCHITECTURE, INC MISSOURI CIVIL COA #2018033898 MISSOURI LANDSCAPE COA #000008 9229 WARD PARKWAY, SUITE # 210 KANSAS CITY, MO 64114 TEL: (816) 444-4200


STRUCTURAL ENGINEER LEIGH + O'KANE MISSOURI COA #001644 250 NE MULBERRY, SUITE 201 LEE'S SUMMIT, MO 64086 (816) 444-3144

MECH., ELECT. & PLMG. ENGINEERS HOSS & BROWN ENGINEERS MISSOURI COA #01022 15902 MIDLAND DRIVE SHAWNEE, KS 66217 (913) 362.9090

SECURITY & IT ENGINEERS HENDERSON ENGINEERS MISSOURI COA #000556 1801 MAIN STREET, SUITE 300 KANSAS CITY, MO 64108 (816) 663-8700

FIRE STATION #5
CITY OF LEE'S SUMMIT

80 LE REVISIONS: # Description Date

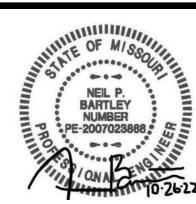



NEIL BARTLEY - ENGINEER MO# PE-2007023868


PROJECT NO:	18225R21001
DATE:	10.20.2022
DRAWN BY:	JL
CHK'D BY:	NB
© GLMV Archit All work herein is the p	,

Architecture, Inc. and is not to be copied or used in any way without the express written consent of GLMV Architecture, Inc. **MECHANICAL** 

PLEASE CONSIDER THE ENVIRONMENT BEFORE PRINTING THIS

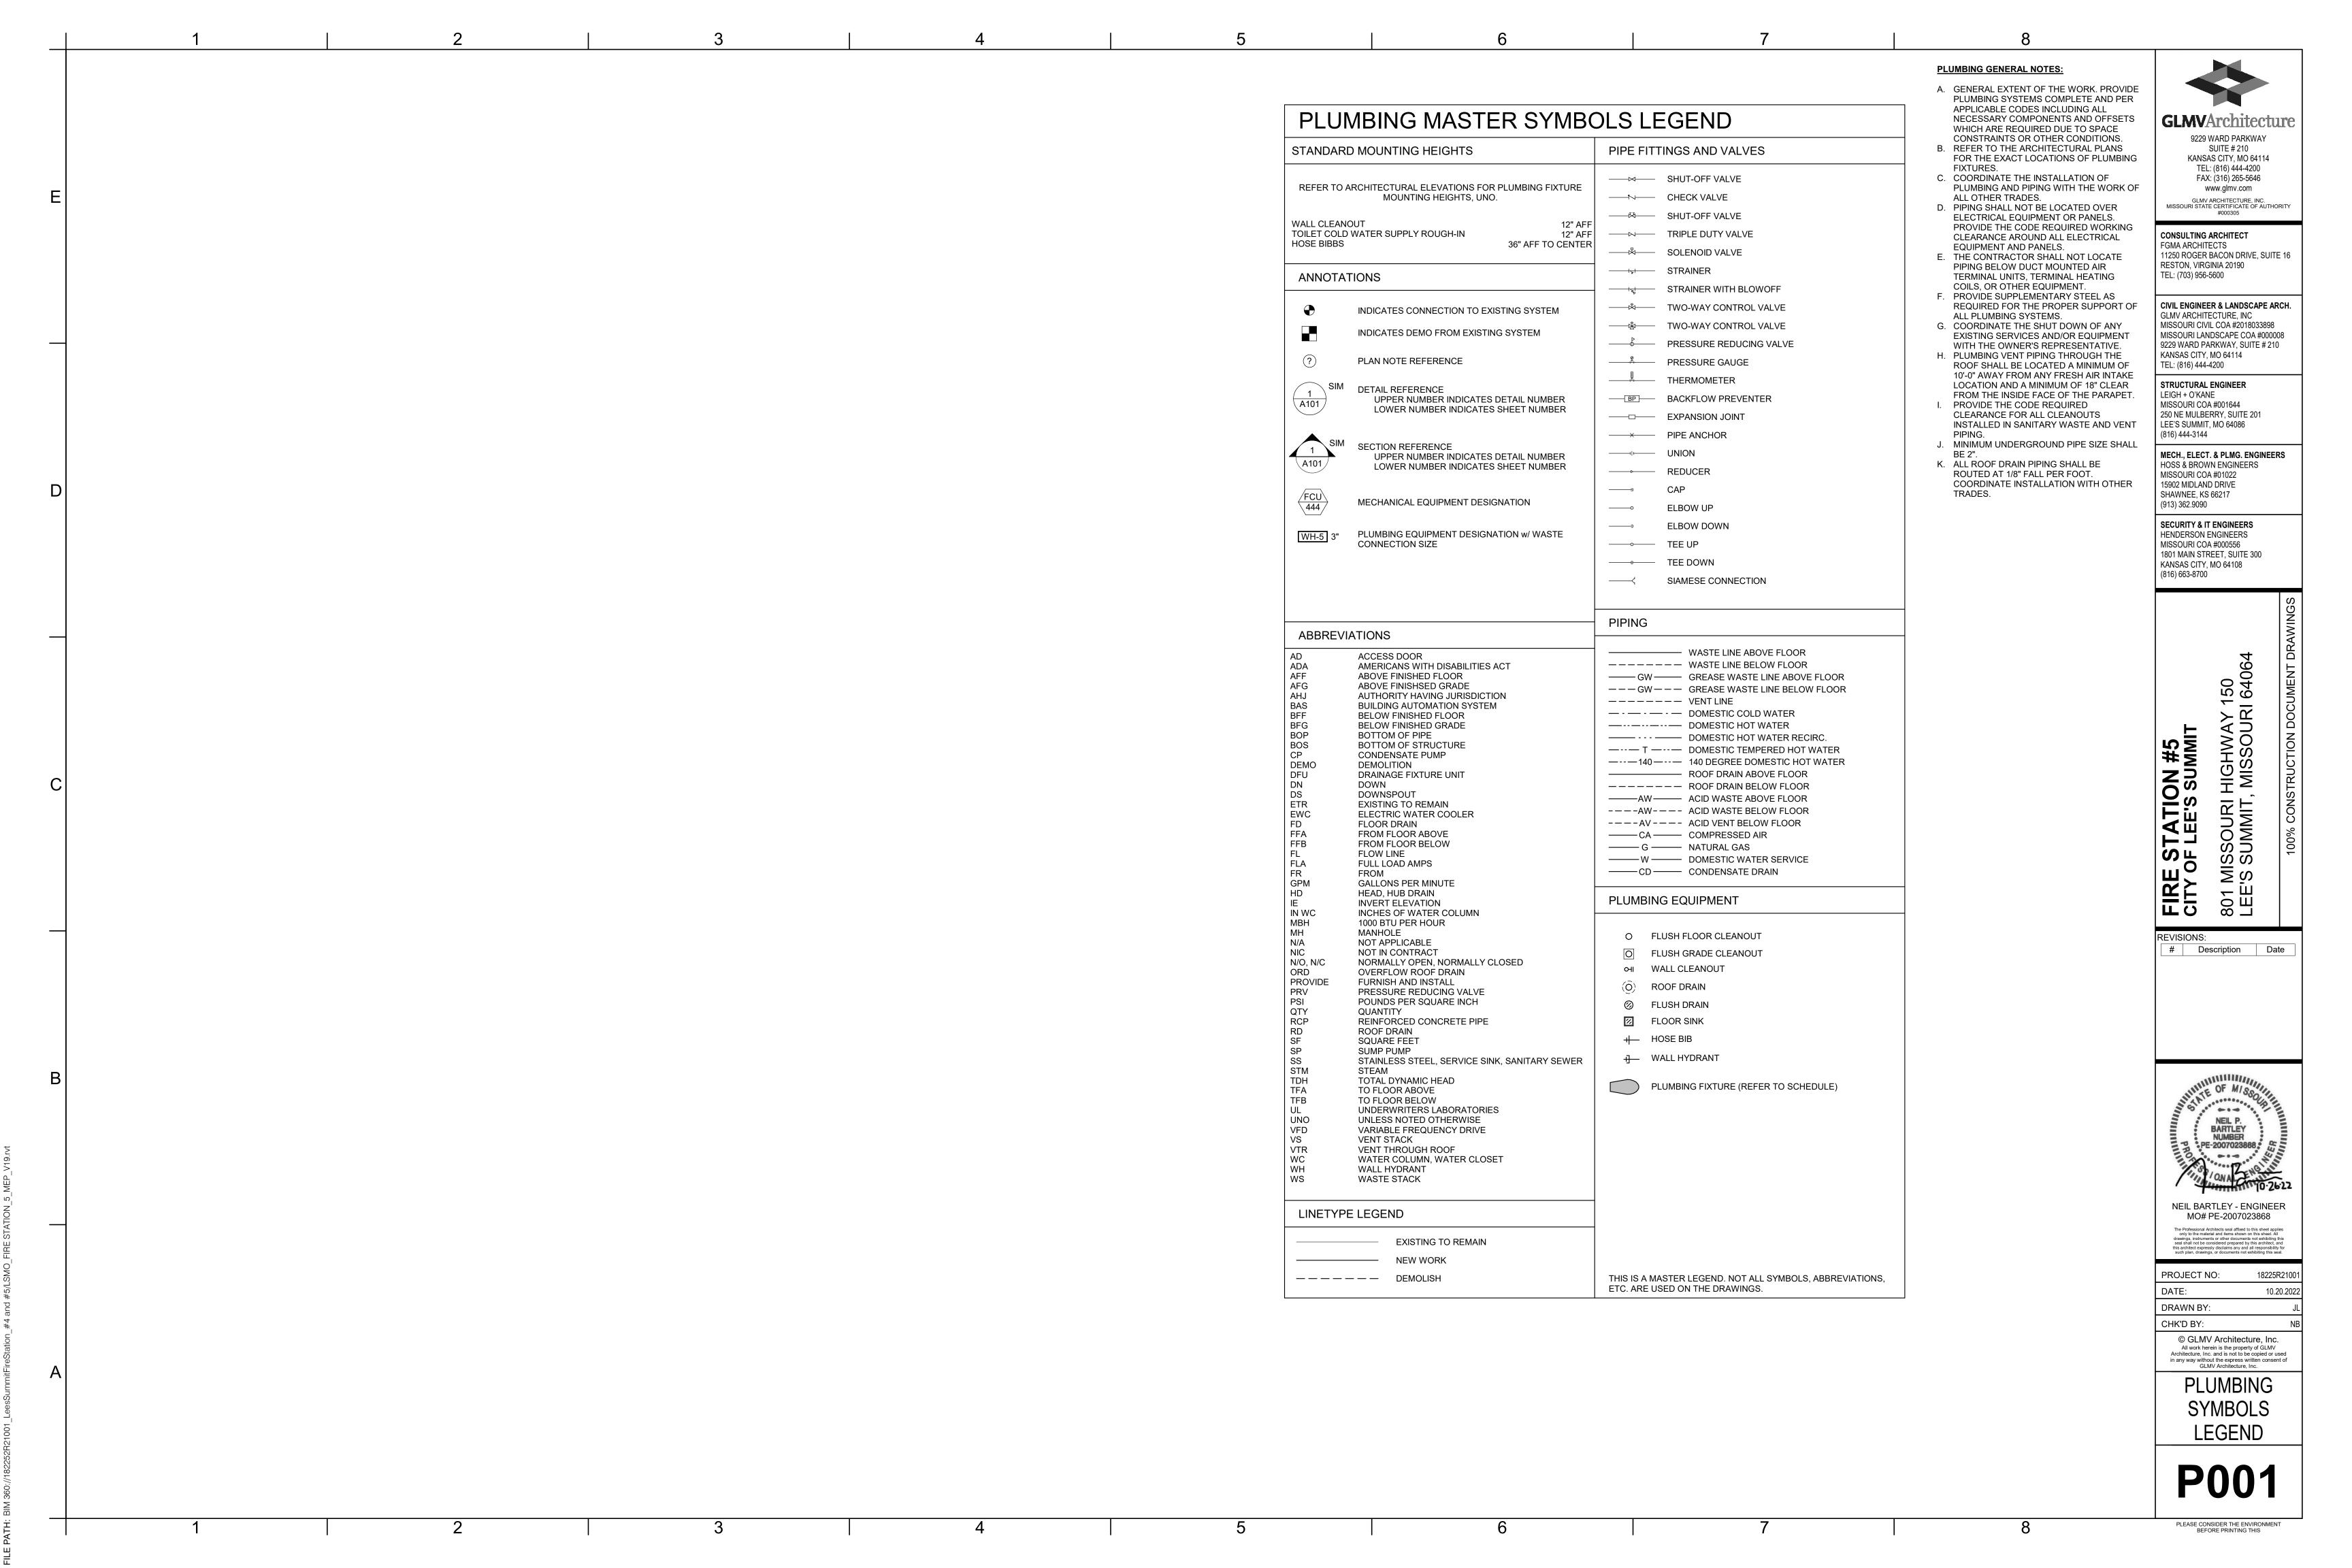

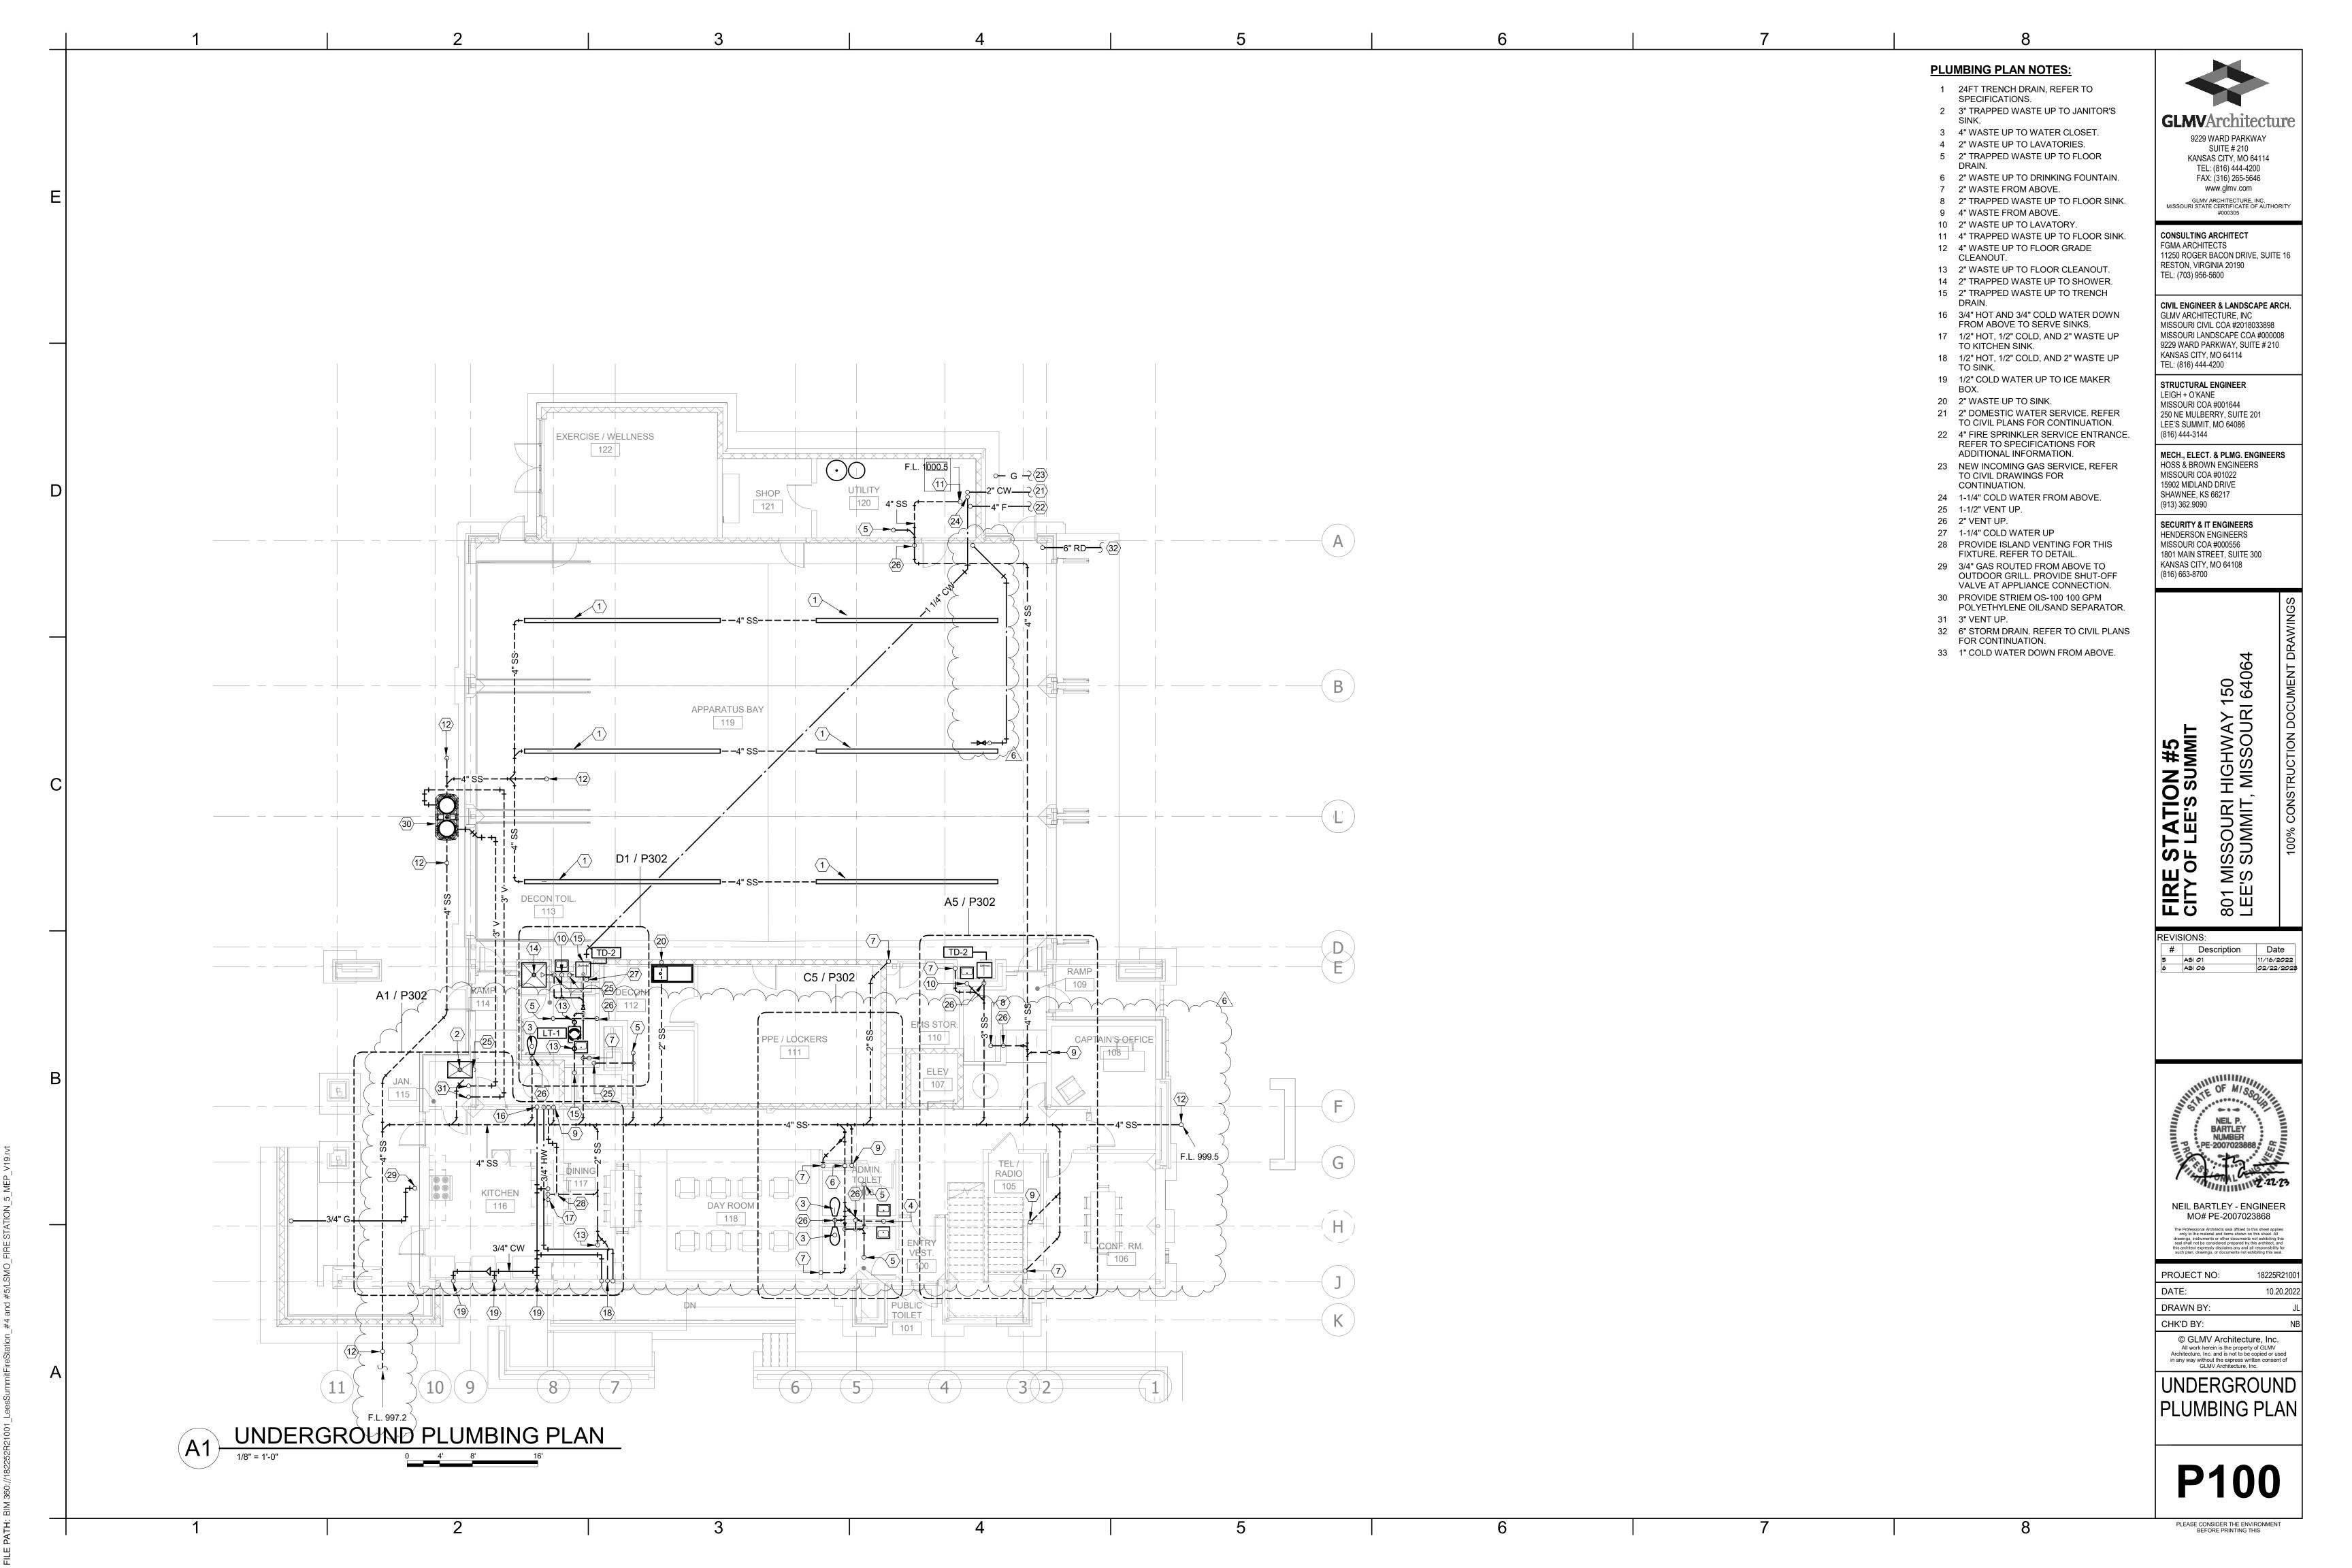

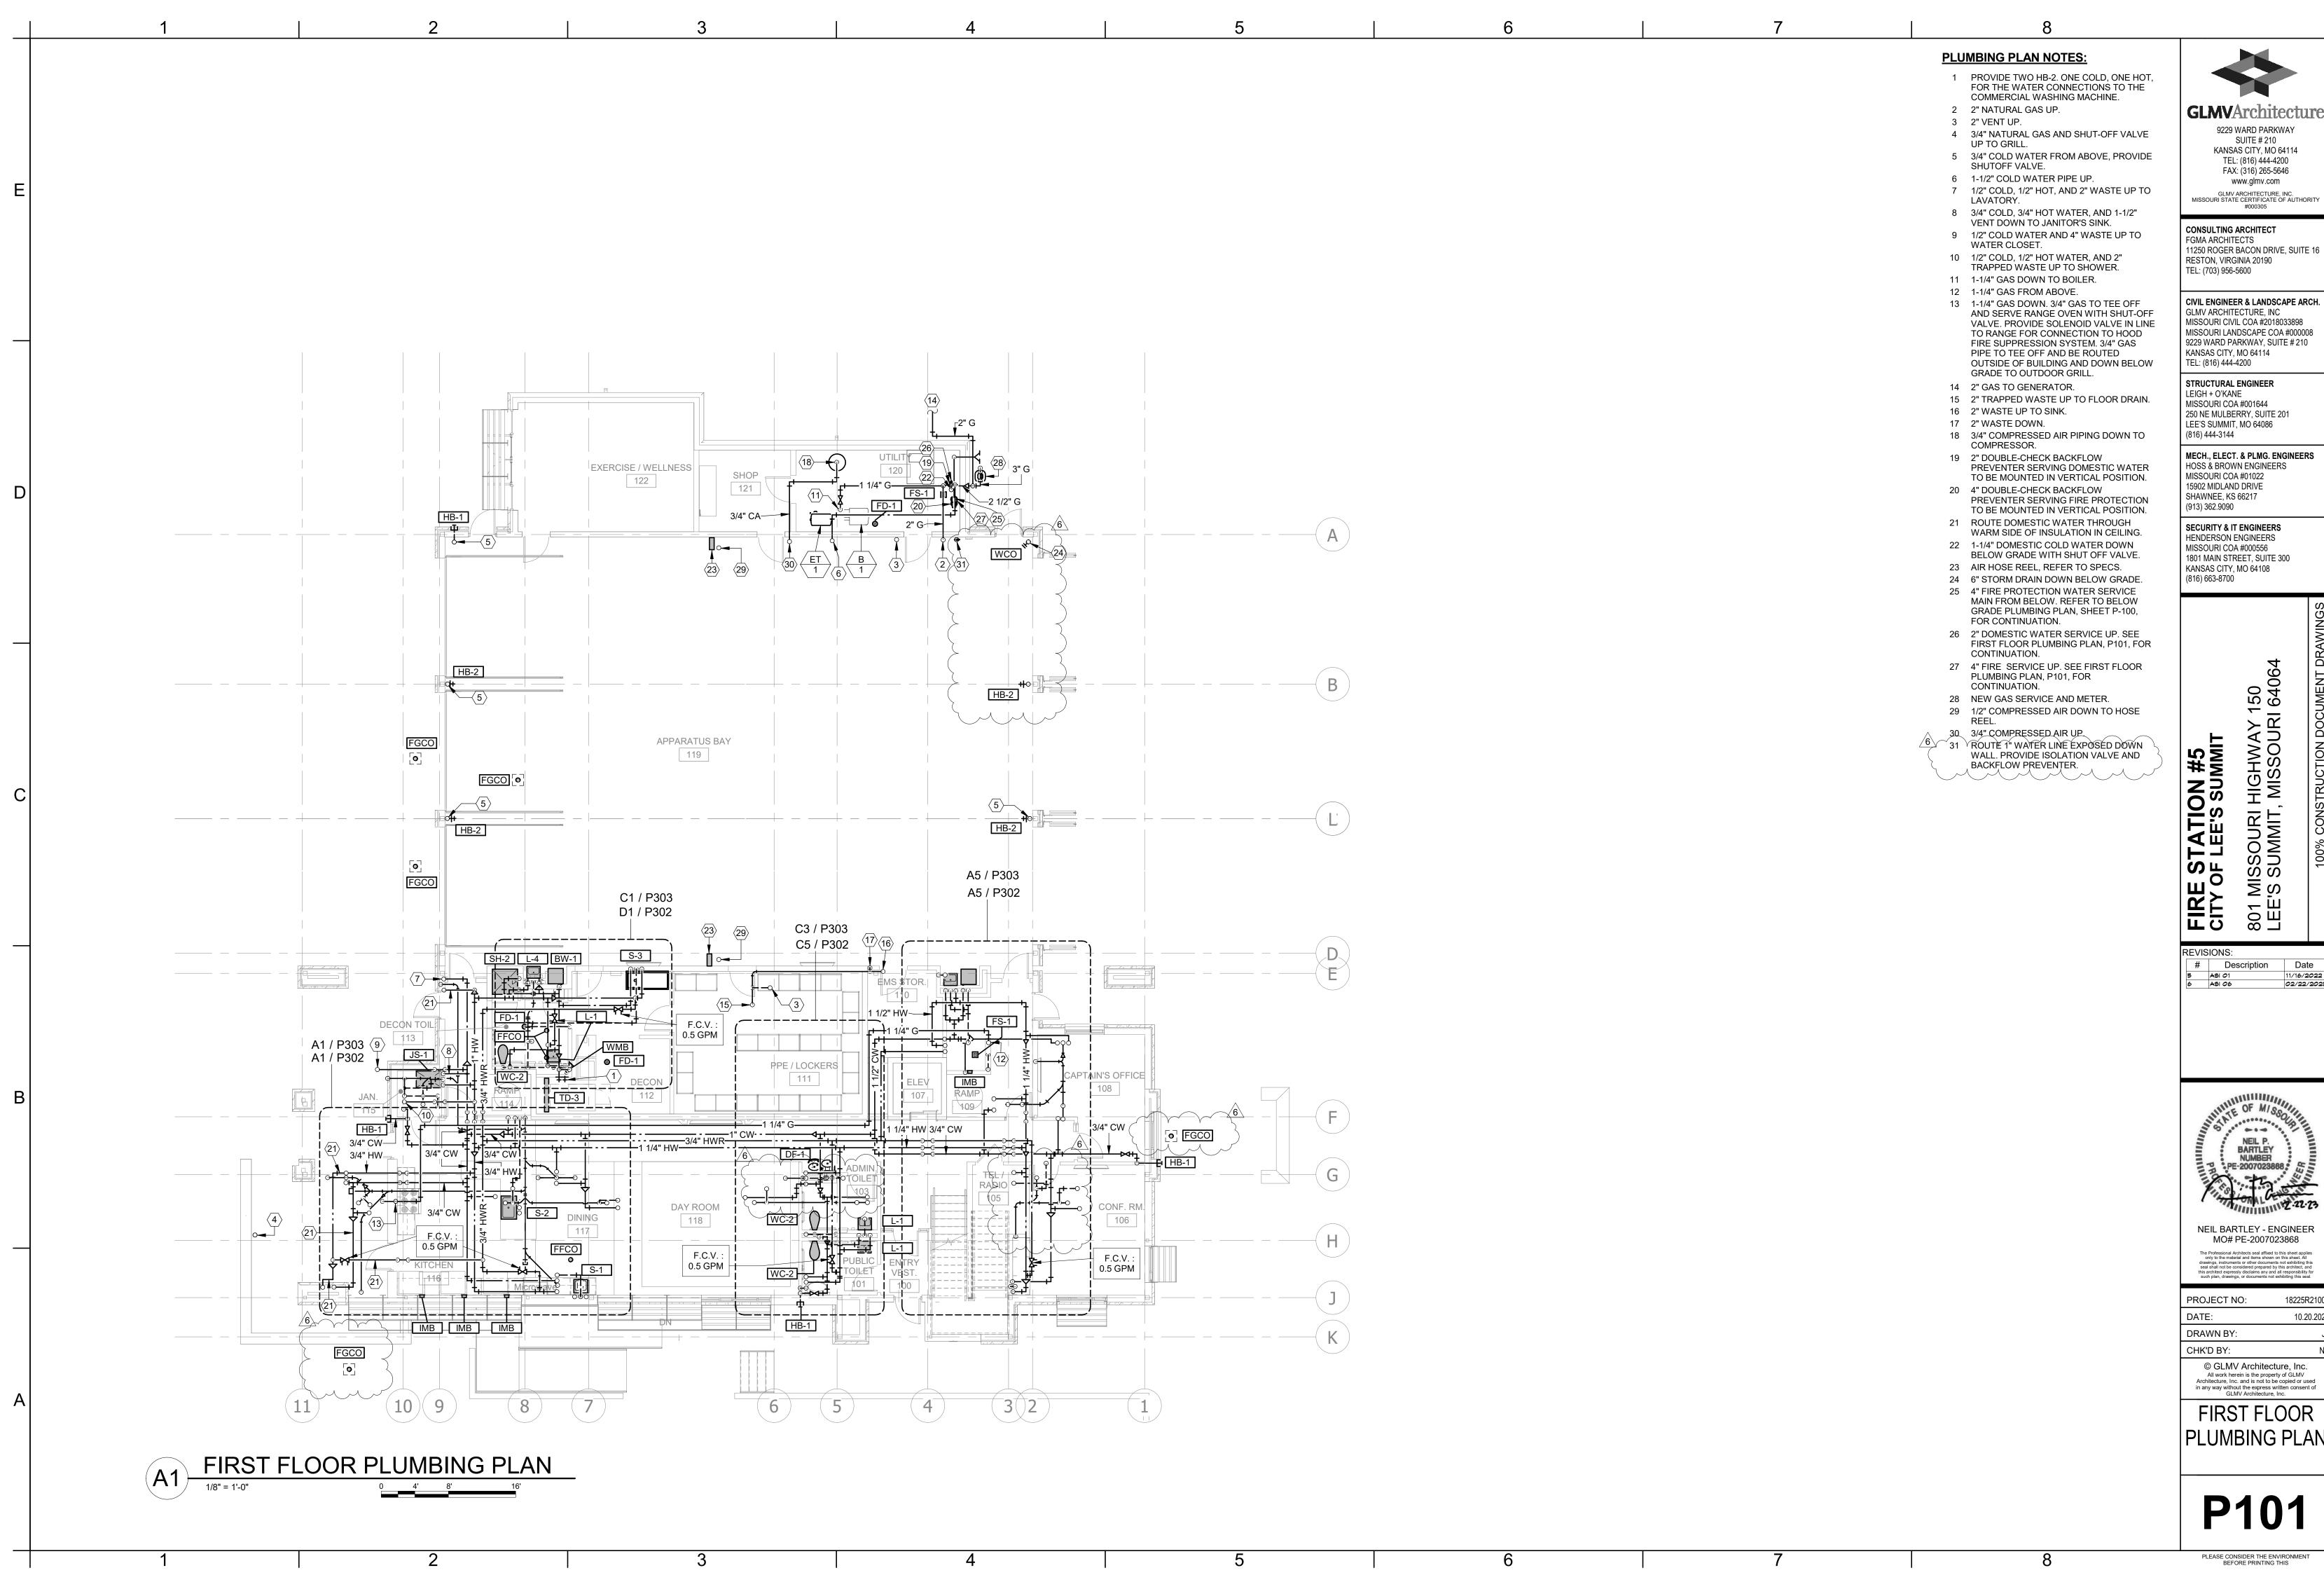

**GLMV**Architecture

SUITE # 210 KANSAS CITY, MO 64114 TEL: (816) 444-4200

FAX: (316) 265-5646 www.glmv.com

11250 ROGER BACON DRIVE, SUITE 16 RESTON, VIRGINIA 20190

CIVIL ENGINEER & LANDSCAPE ARCH. GLMV ARCHITECTURE, INC MISSOURI CIVIL COA #2018033898

MISSOURI LANDSCAPE COA #000008 9229 WARD PARKWAY, SUITE # 210 KANSAS CITY, MO 64114

STRUCTURAL ENGINEER MISSOURI COA #001644

250 NE MULBERRY, SUITE 201 LEE'S SUMMIT, MO 64086 MECH., ELECT. & PLMG. ENGINEERS

HOSS & BROWN ENGINEERS

SECURITY & IT ENGINEERS HENDERSON ENGINEERS MISSOURI COA #000556 1801 MAIN STREET, SUITE 300 KANSAS CITY, MO 64108

801 MISSOUF LEE'S SUMMI

Date 11/16/2022 02/22/2028





**NEIL BARTLEY - ENGINEER** MO# PE-2007023868


10.20.2022 © GLMV Architecture, Inc.


All work herein is the property of GLMV
Architecture, Inc. and is not to be copied or used
in any way without the express written consent of
GLMV Architecture, Inc.

FIRST FLOOR PLUMBING PLAN

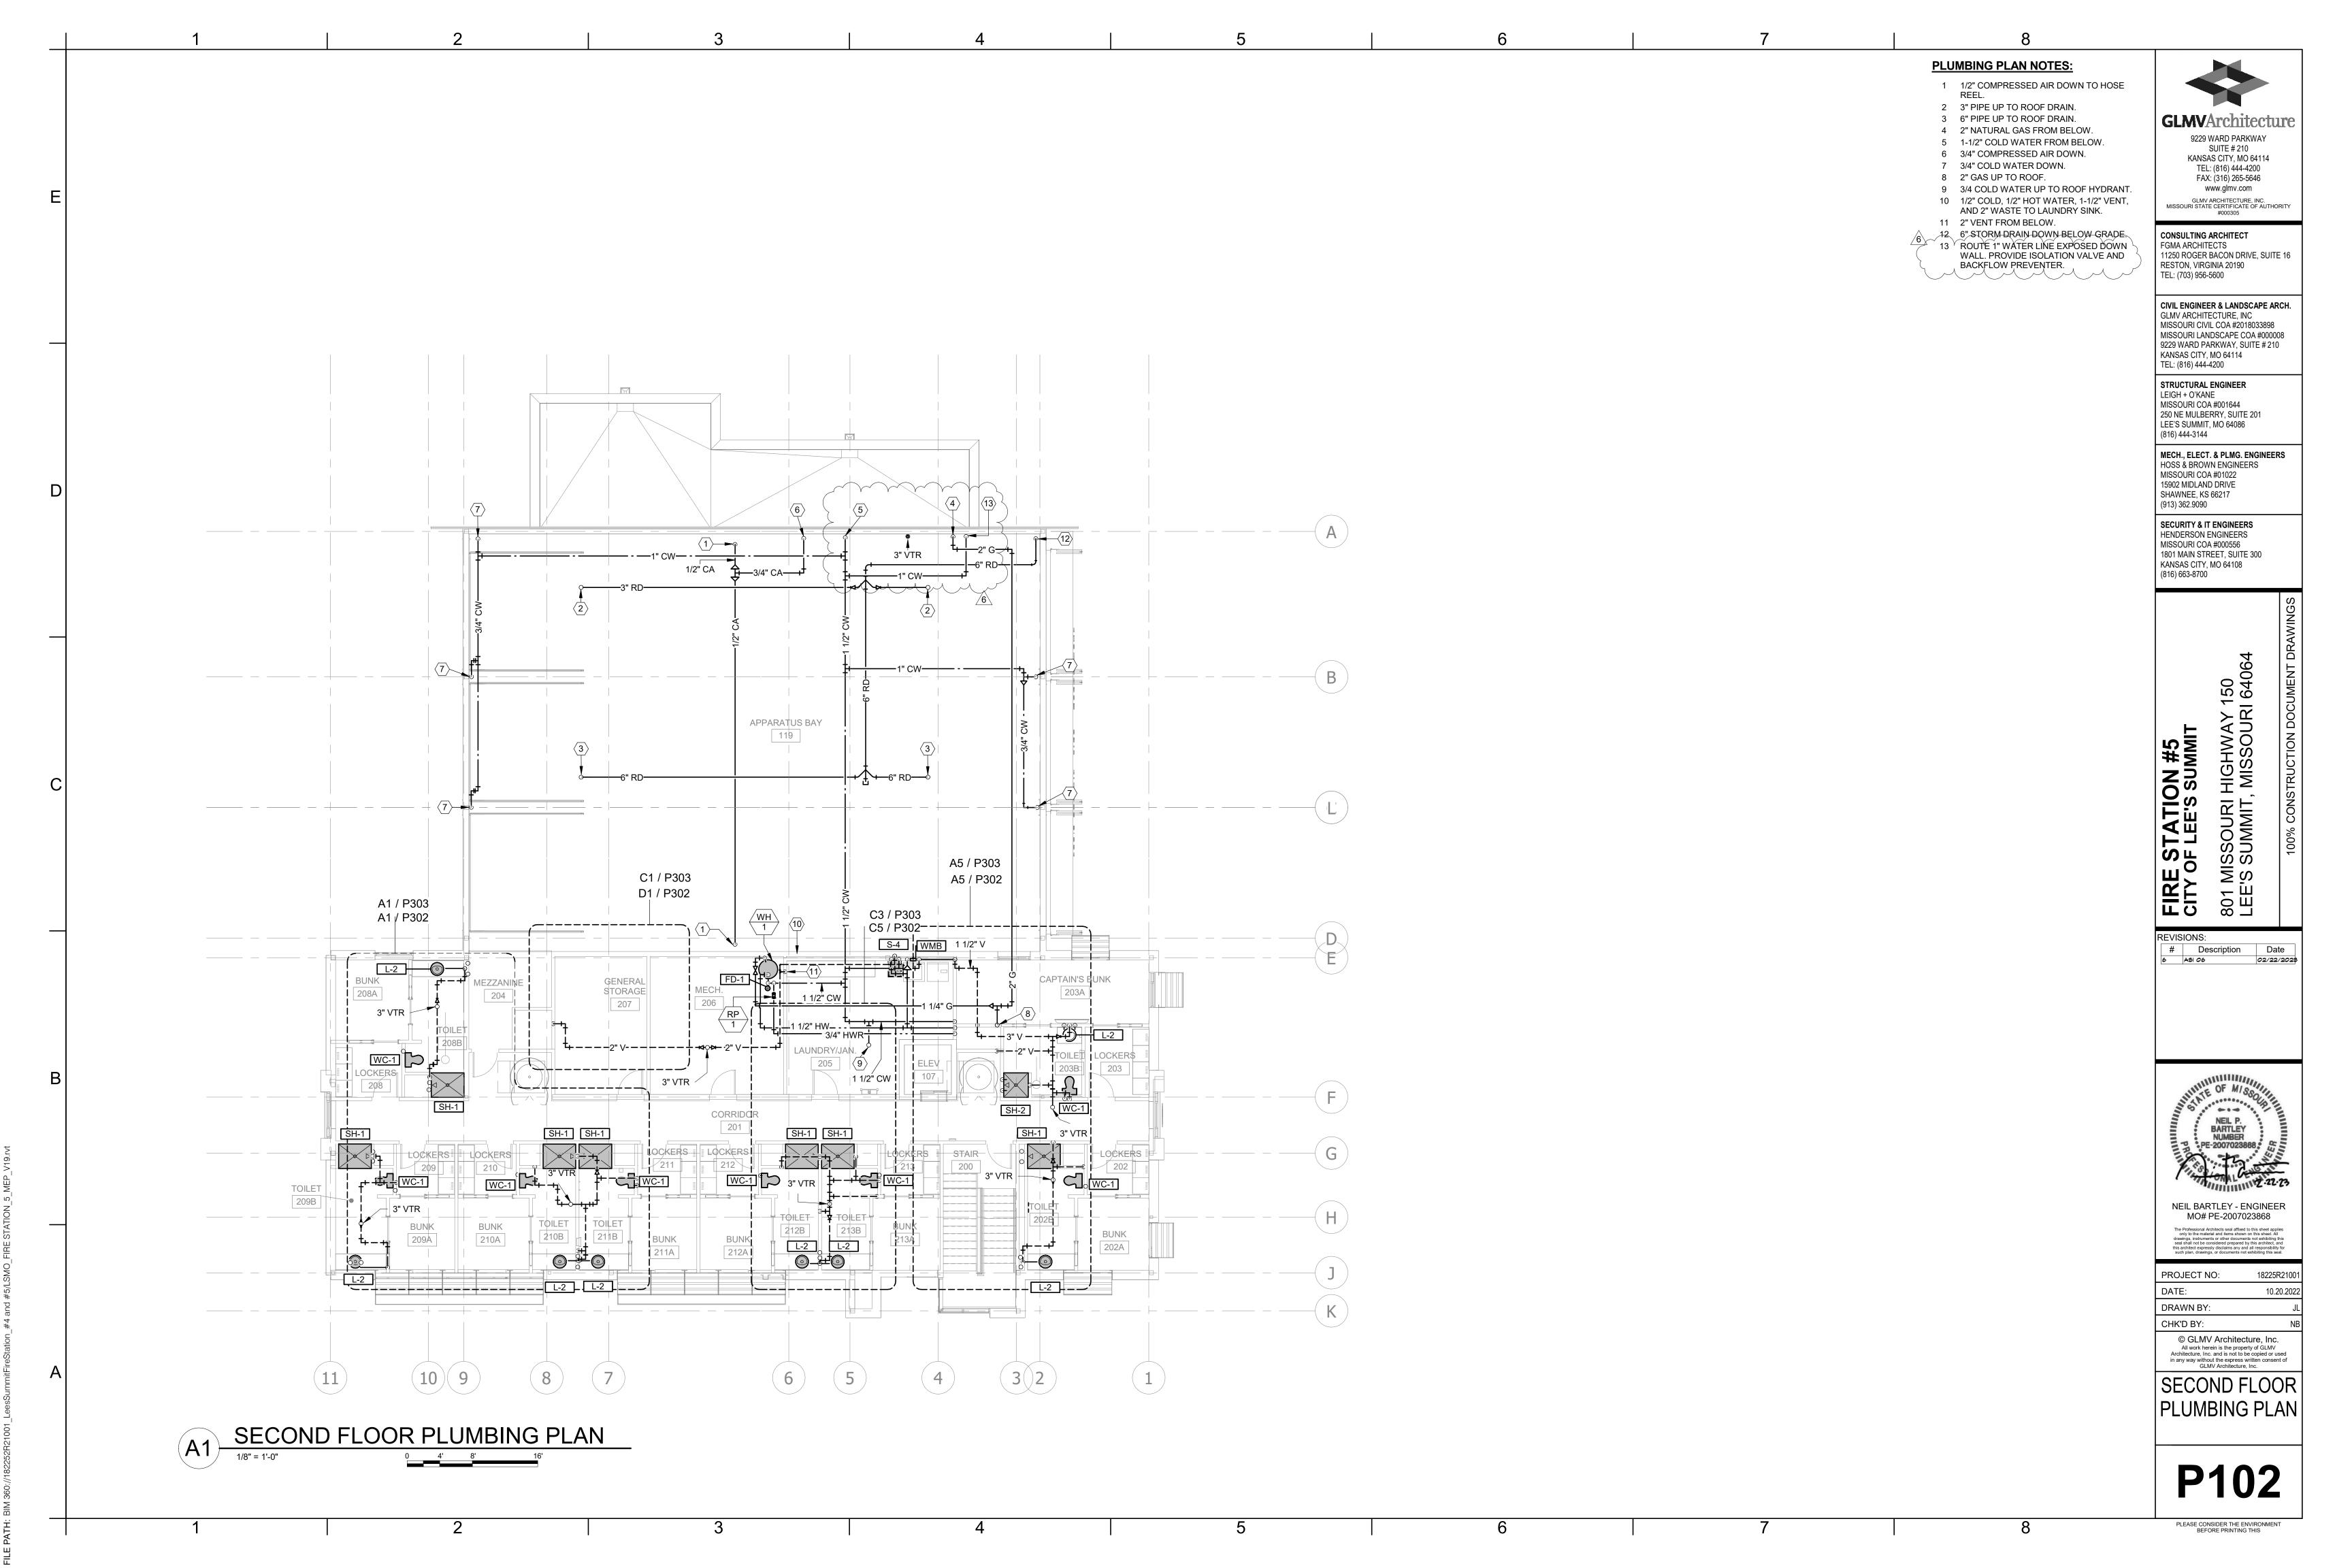

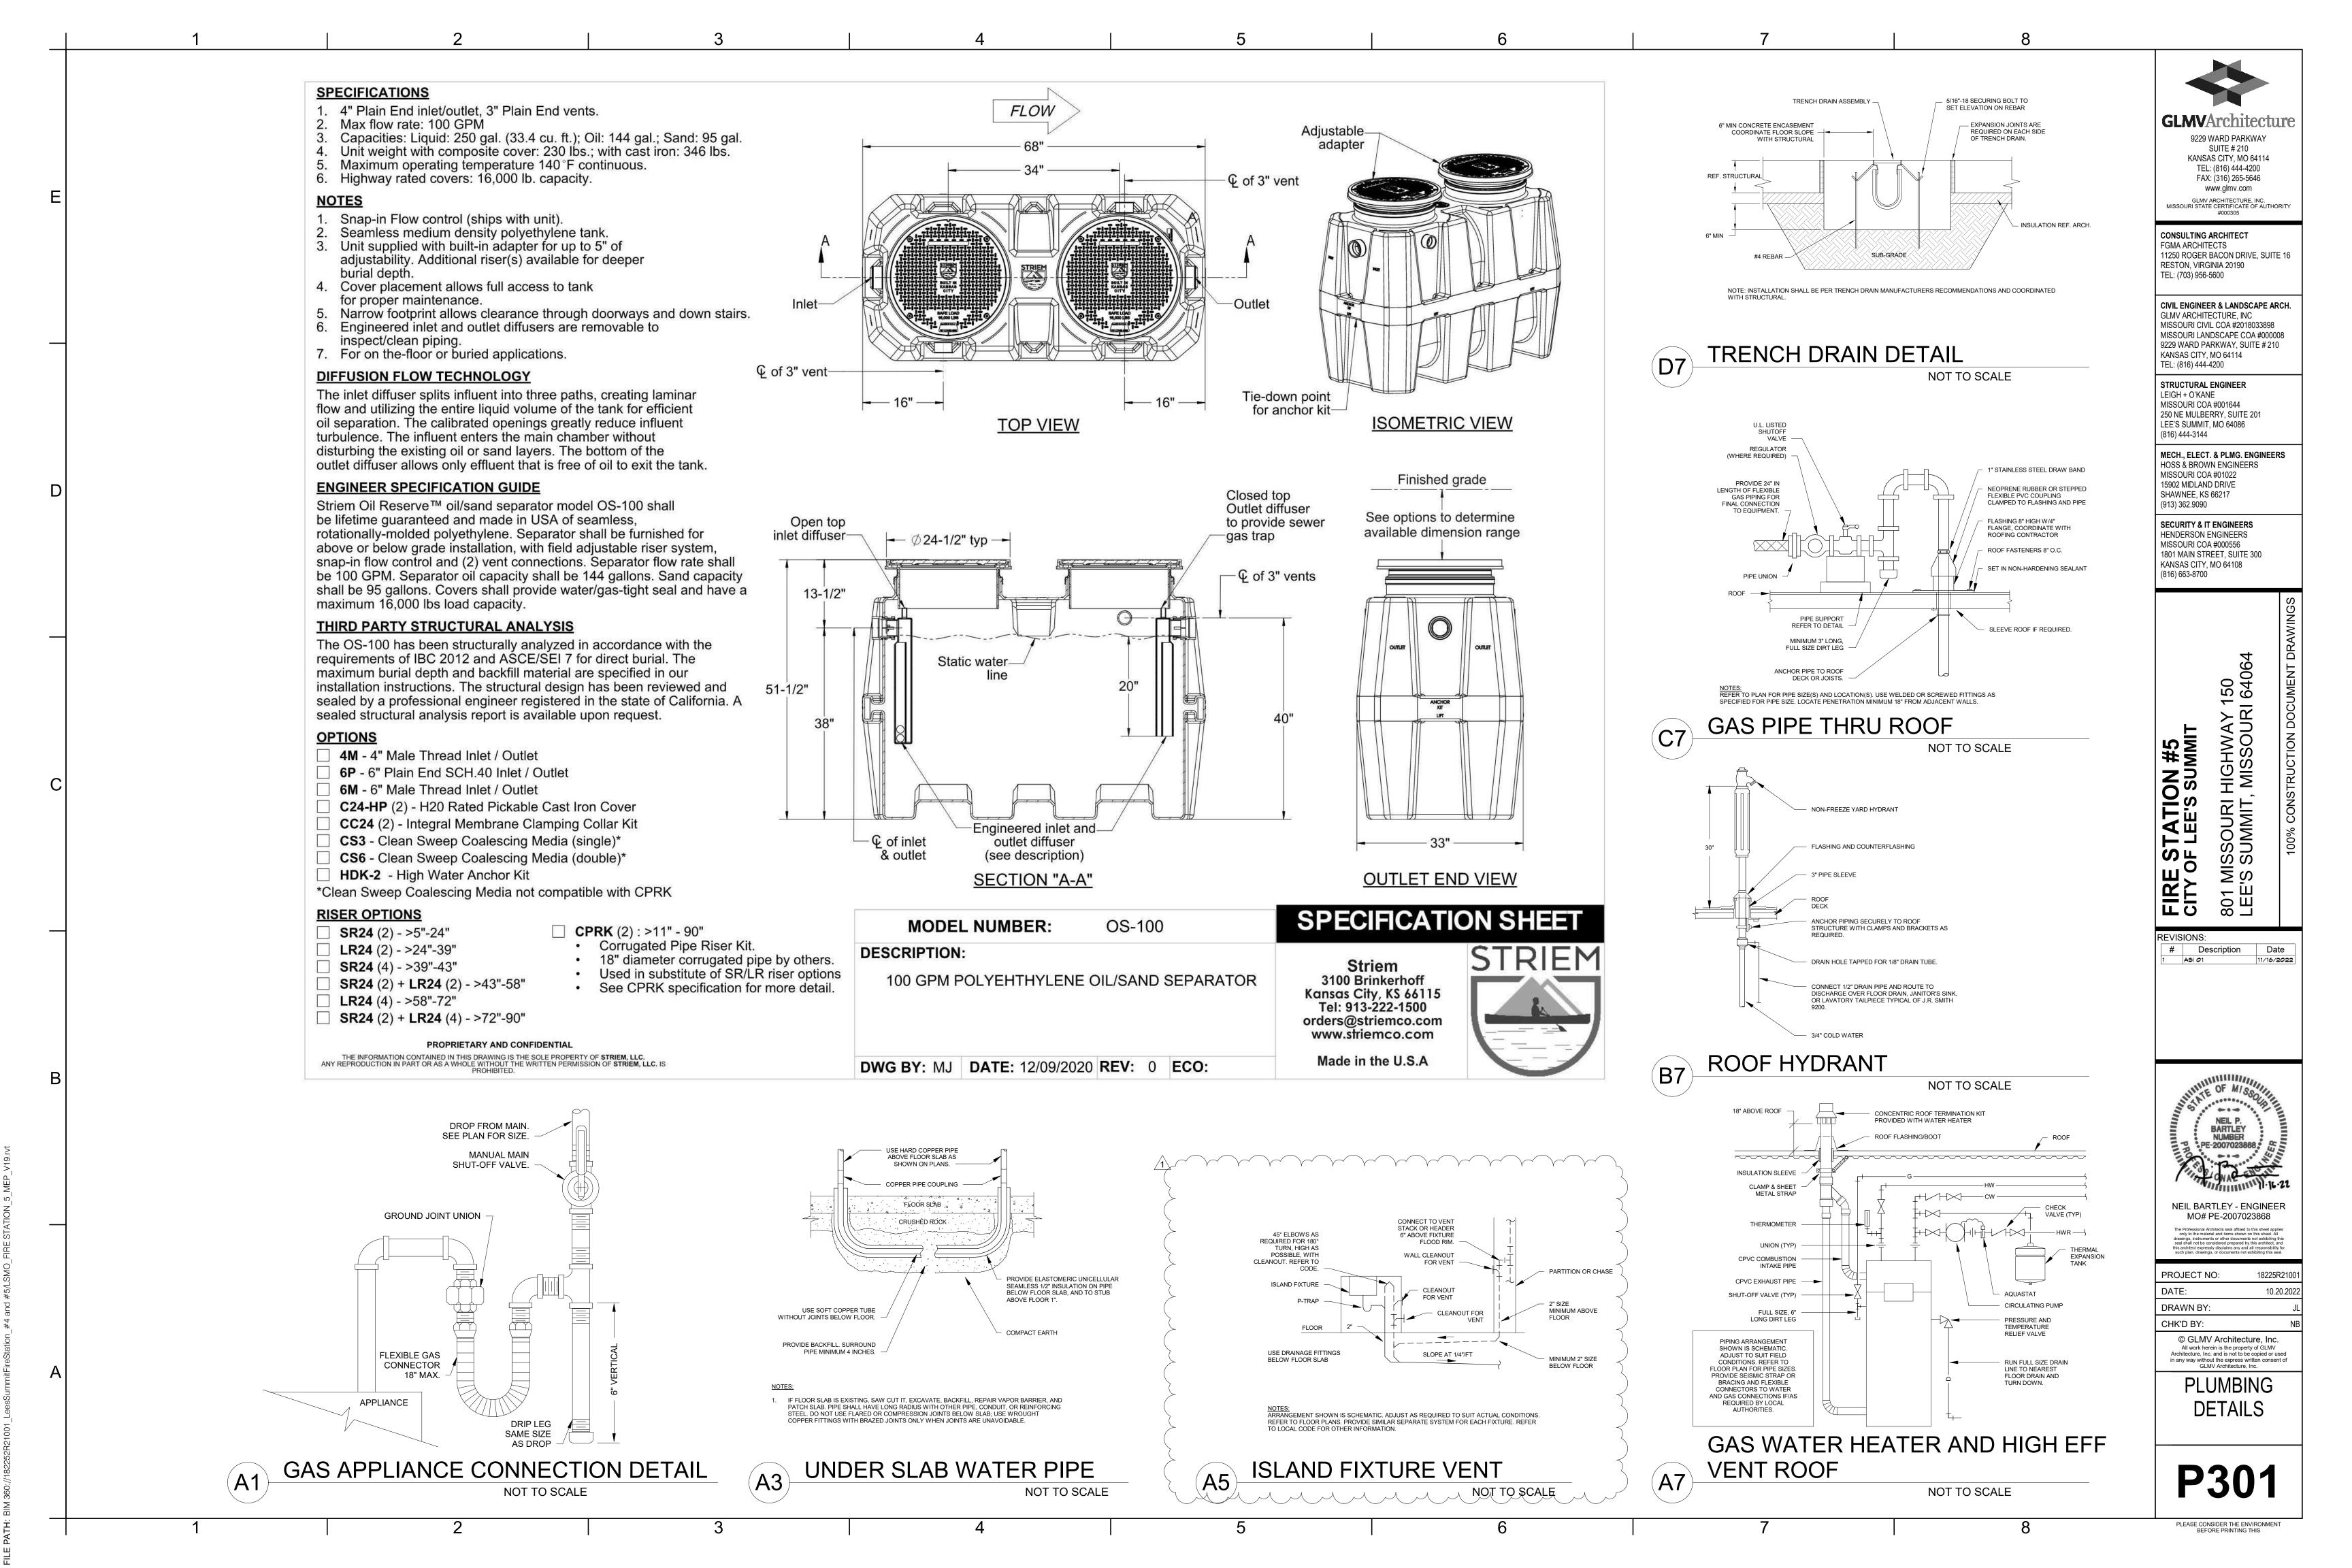

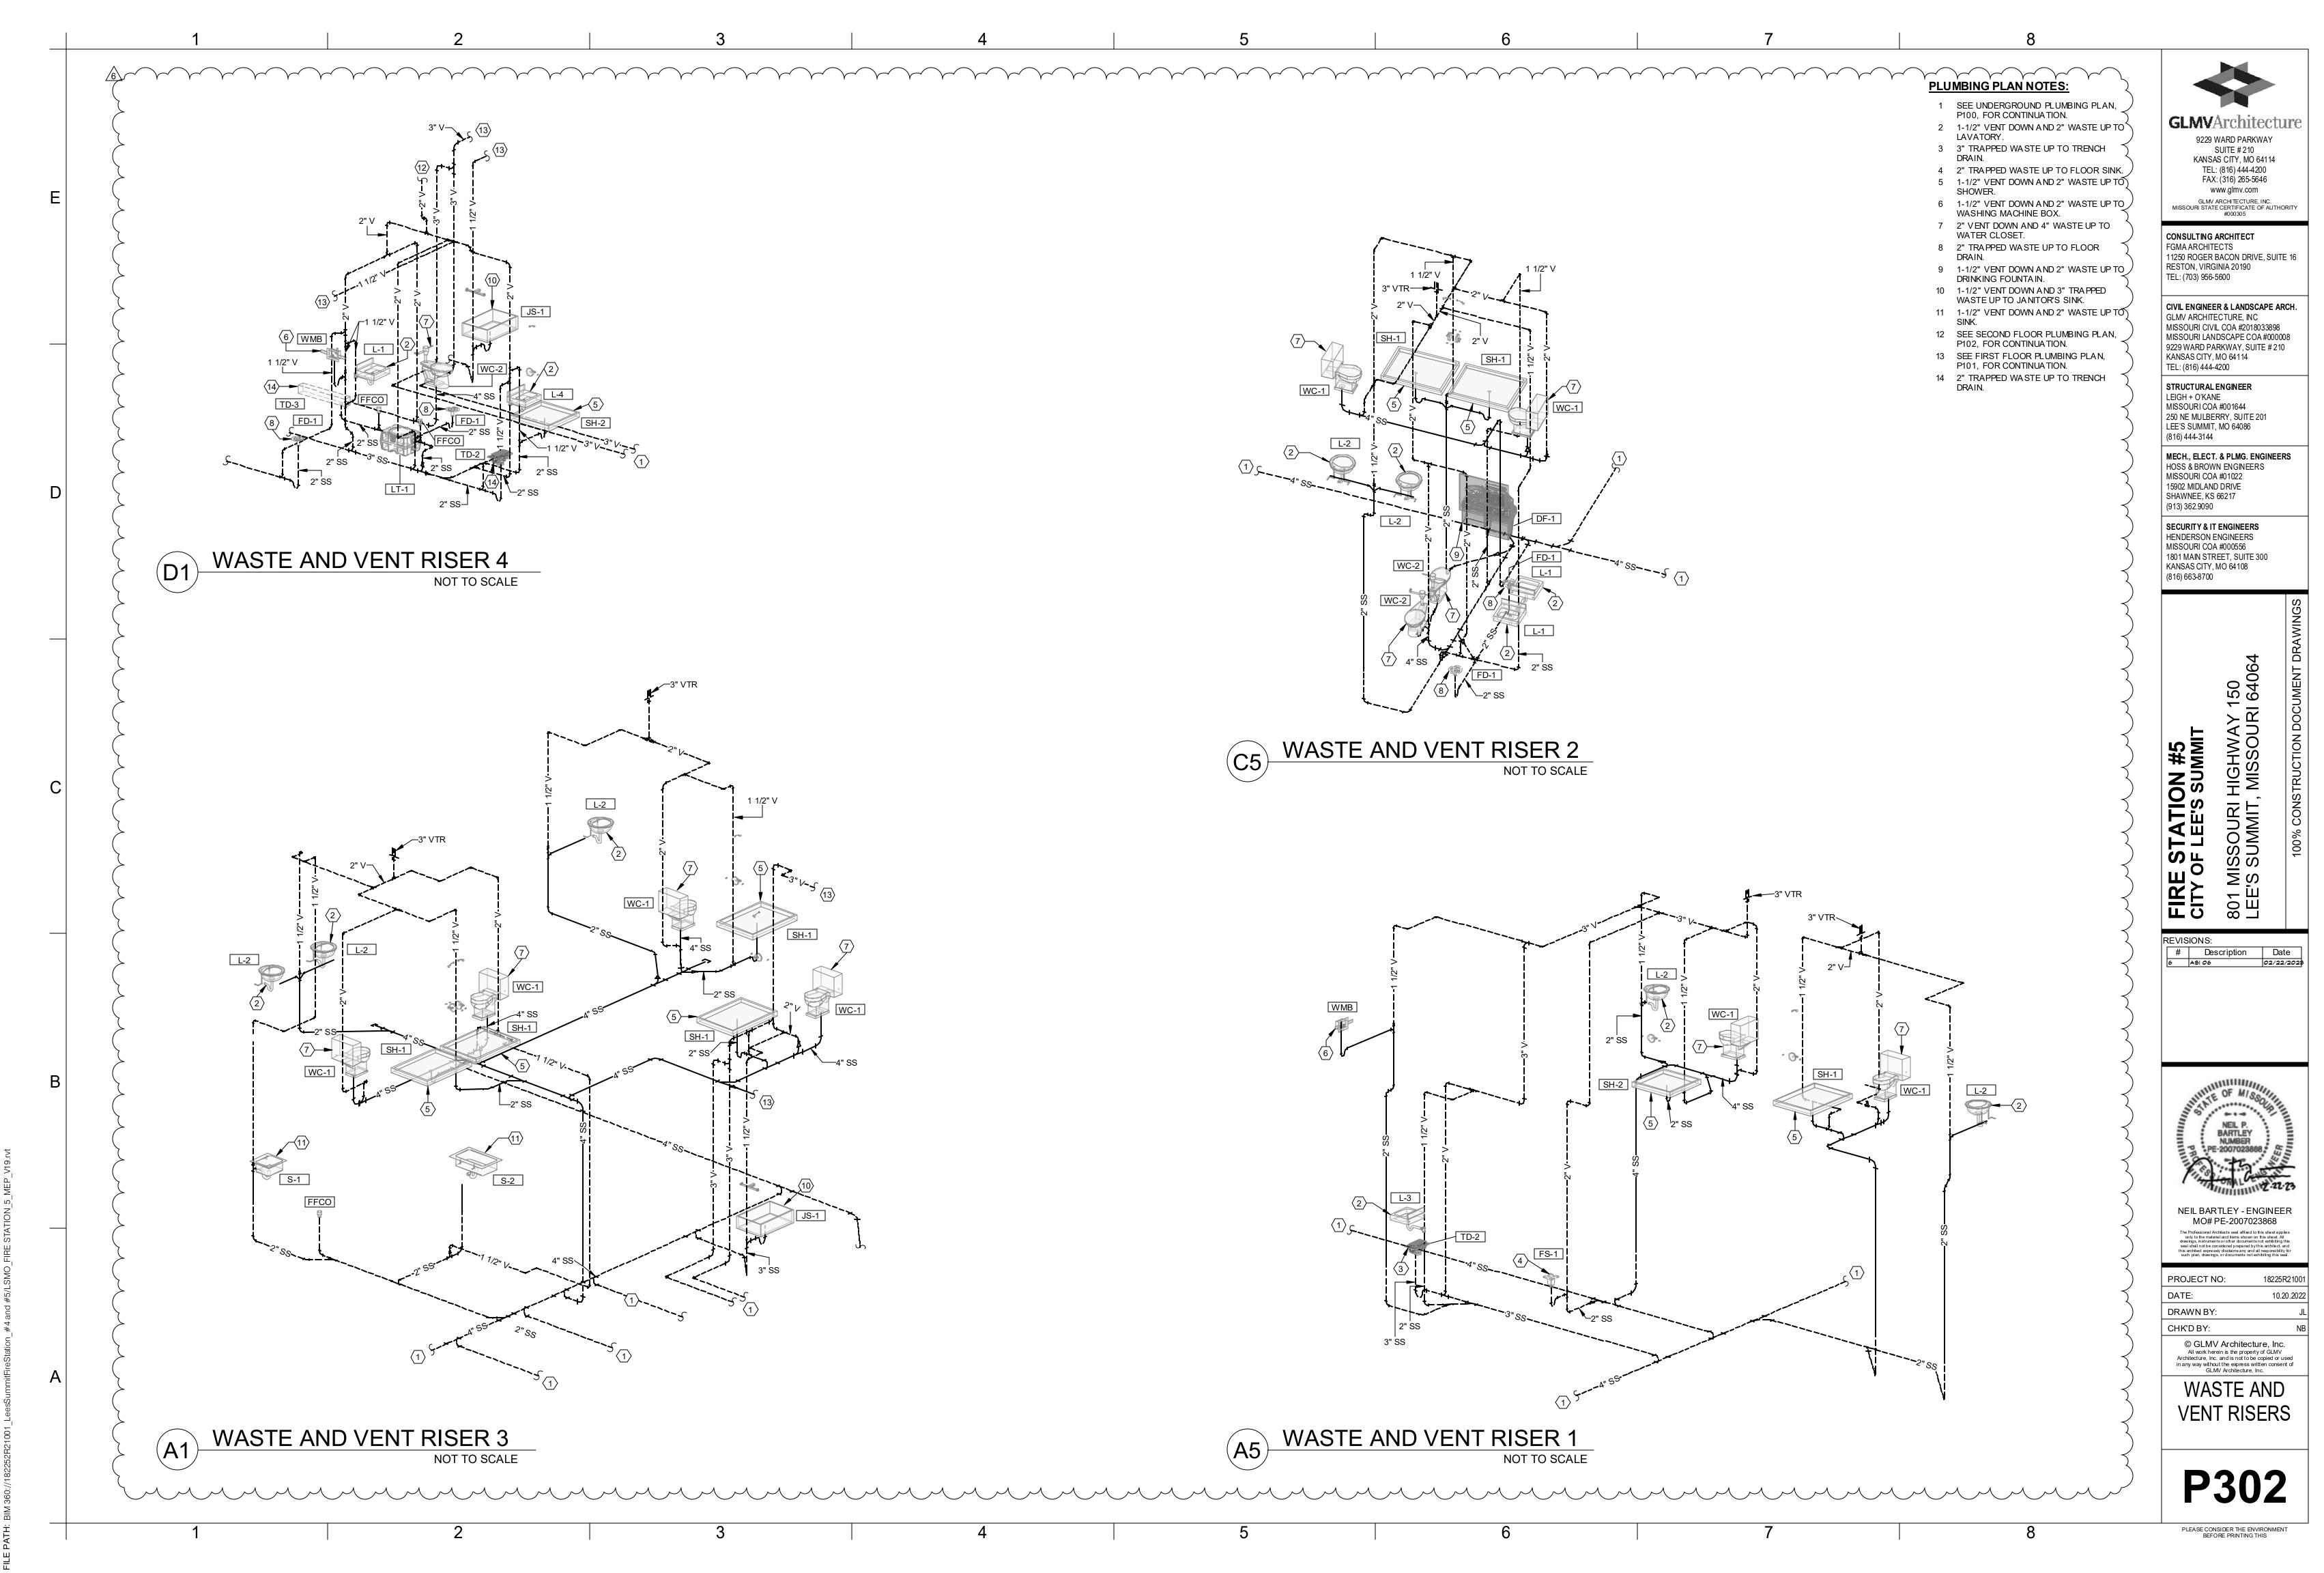

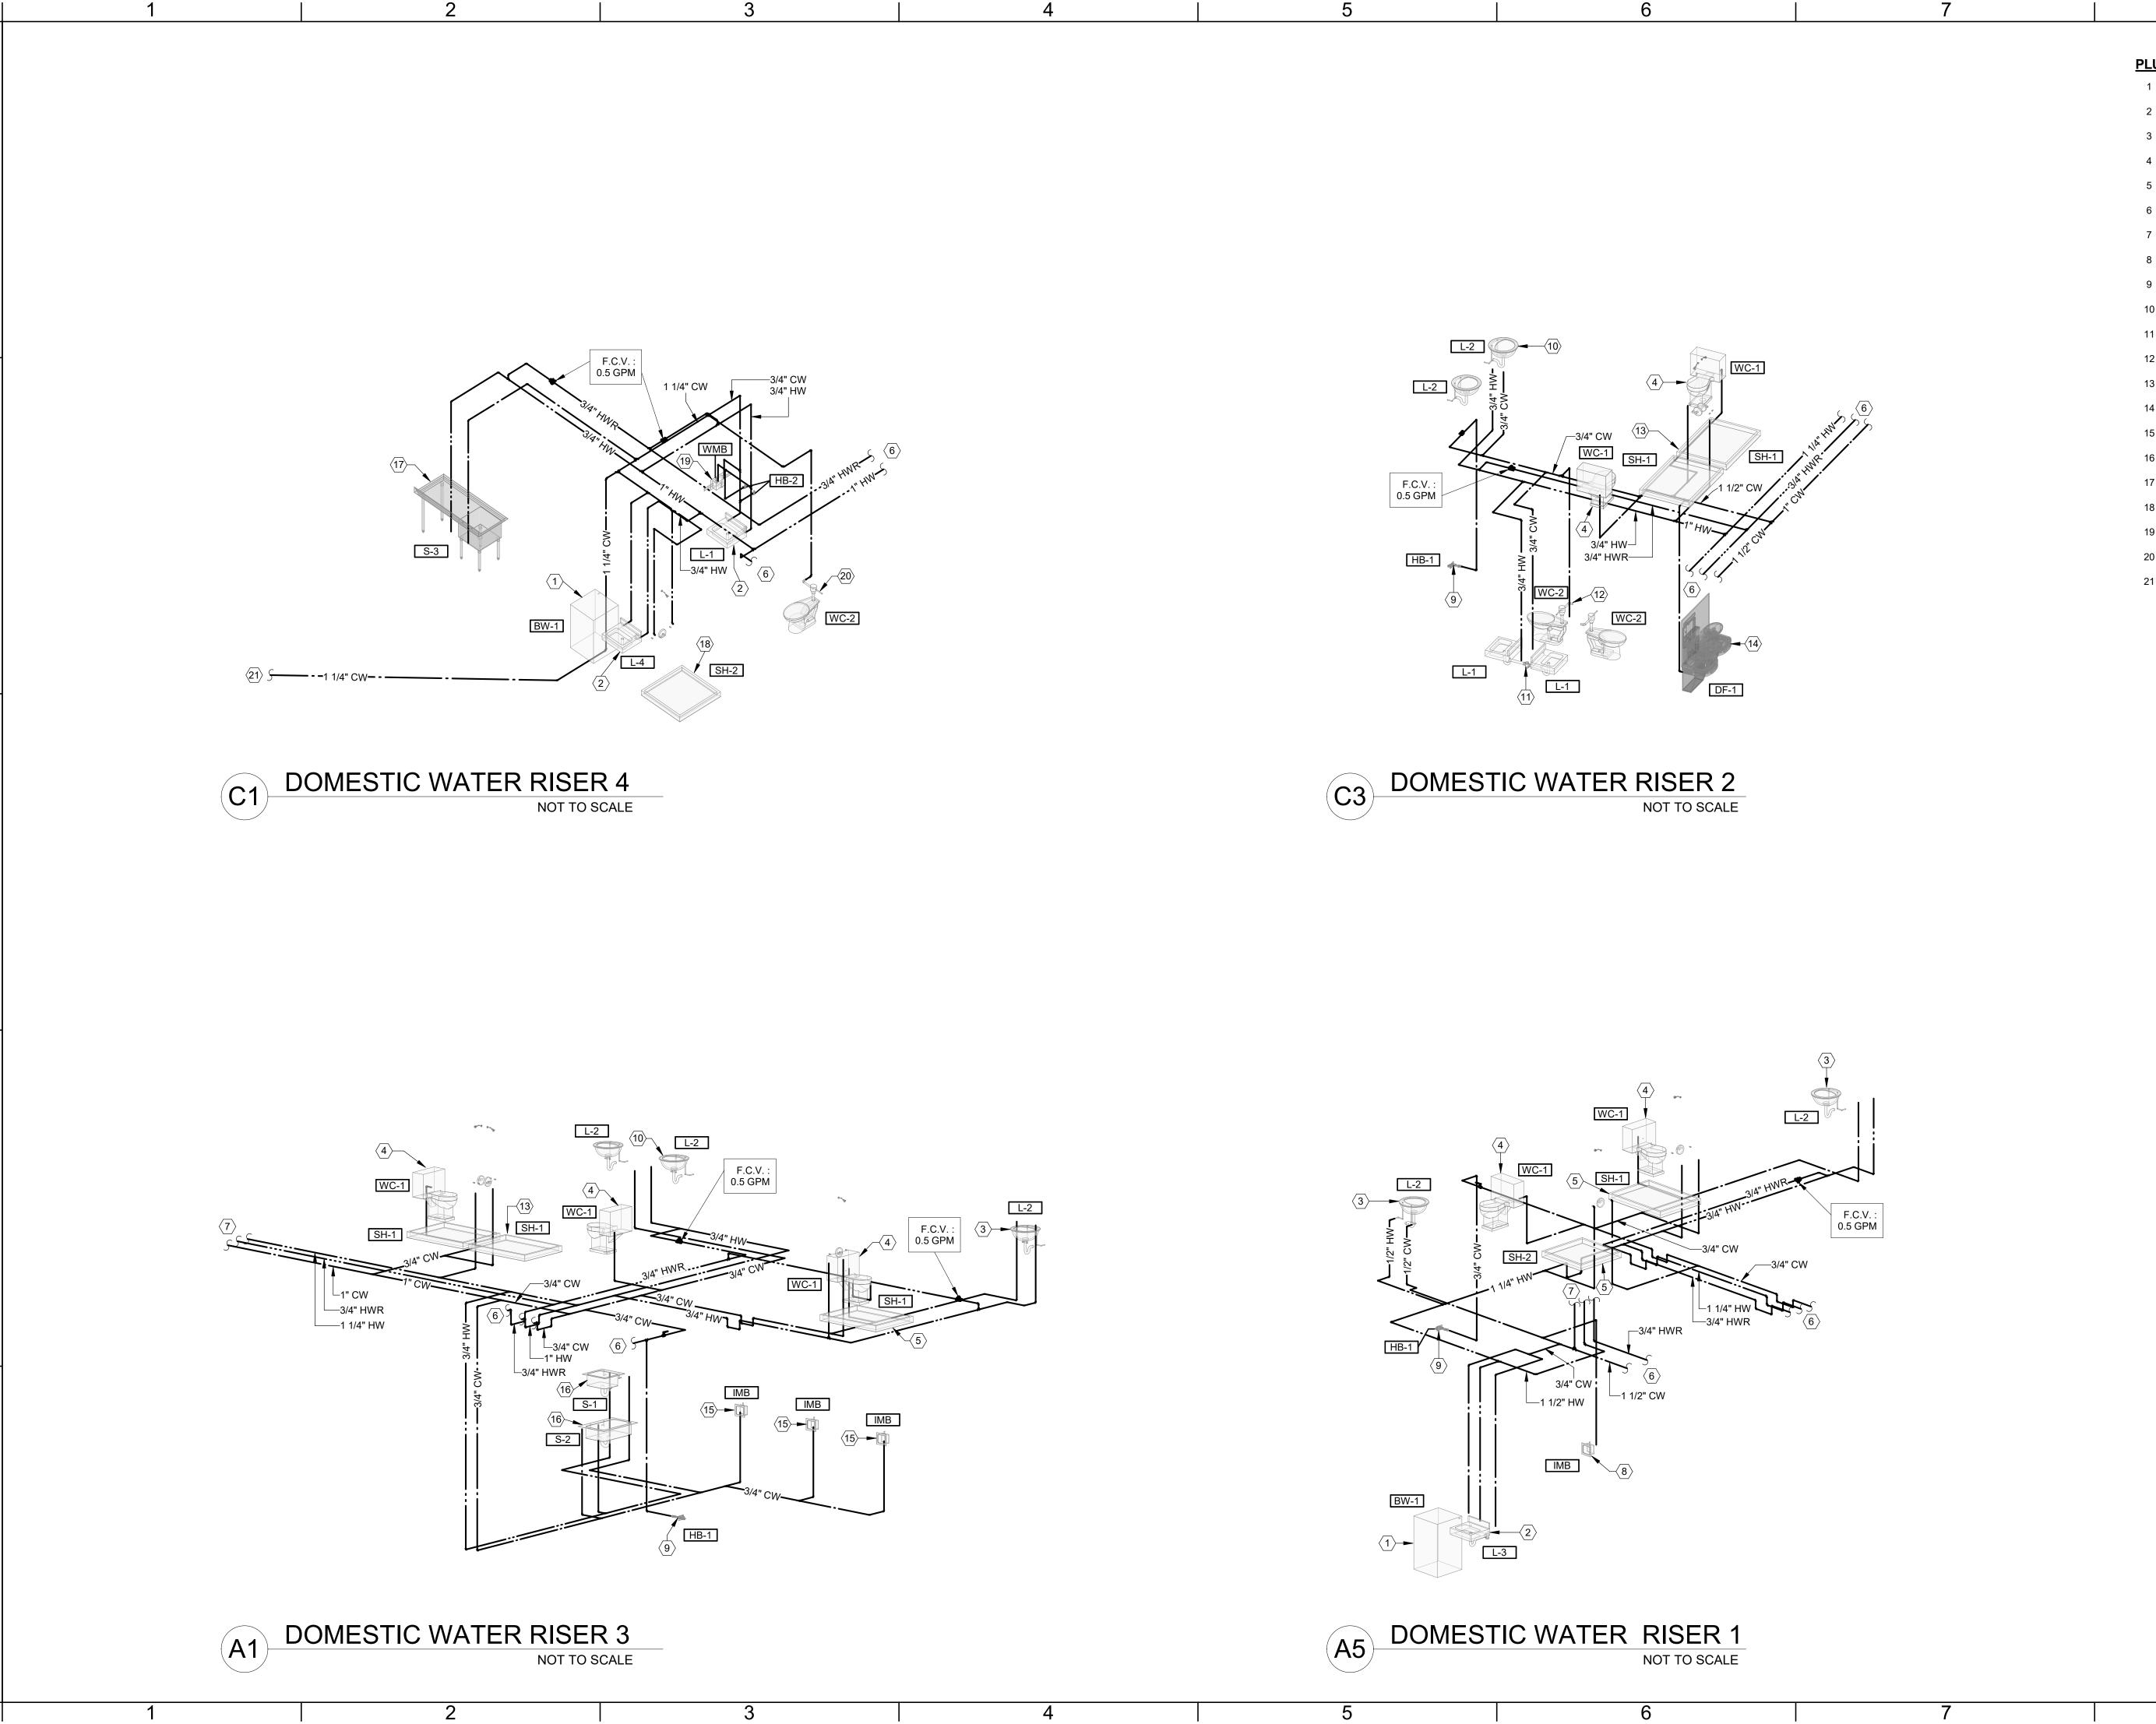

LAVATORY.

- WASH STATION.
- 2 1/2" COLD AND 1/2" HOT WATER DOWN
- 3 1/2" COLD AND 1/2" HOT WATER UP TO
- 4 1/2" COLD WATER UP TO WATER CLOSET.
- 5 1/2" COLD AND 1/2" HOT WATER UP TO
- 6 SEE FIRST FLOOR PLUMBING PLAN,
- 7 SEE SECOND FLOOR PLUMBING PLAN,
- 8 1/2" COLD WATER DOWN TO ICE

- LAVATORIES.
- TO LAVATORIES.
- 12 1-1/4" COLD WATER DOWN TO WATER
- CLOSETS.
- 14 1/2" COLD WATER DOWN TO DRINKING
- 15 1/2" COLD WATER UP TO ICE MAKER
- 16 1/2" COLD AND 1/2" WATER HOT UP TO
- 17 1/2" COLD AND 1/2" HOT WATER DOWN
- TO SHOWER.
- TO WASHING MACHINE BOX.
- 20 1-1/4" COLD WATER DOWN TO WATER CLOSET.
  - P100, FOR CONTINUATION.

### **PLUMBING PLAN NOTES:**

- 1 1/2" COLD WATER DOWN TO BOOT
- TO LAVATORY.
  - SUITE # 210 KANSAS CITY, MO 64114

  - SHOWER.
- P101, FOR CONTINUATION.
- P102, FOR CONTINUATION.
- MAKER BOX.
- 9 3/4" COLD WATER DOWN TO HOSE
- 10 3/4" COLD AND 3/4" HOT WATER UP TO
- 11 3/4" COLD AND 3/4" HOT WATER DOWN

- 13 3/4" COLD AND 3/4" HOT WATER UP TO SHOWERS.
- FOUNTAIN.
- BOX.
- SINK.
- TO SINK. 18 1/2" COLD AND 1/2" HOT WATER DOWN
- 19 1/2" COLD AND 1/2" HOT WATER DOWN
- 21 SEE UNDERGROUND PLUMBING PLAN,

**GLMV**Architecture

TEL: (816) 444-4200 FAX: (316) 265-5646 www.glmv.com

9229 WARD PARKWAY

GLMV ARCHITECTURE, INC. MISSOURI STATE CERTIFICATE OF AUTHORITY #000305 CONSULTING ARCHITECT

FGMA ARCHITECTS 11250 ROGER BACON DRIVE, SUITE 16 RESTON, VIRGINIA 20190 TEL: (703) 956-5600

CIVIL ENGINEER & LANDSCAPE ARCH.

GLMV ARCHITECTURE, INC MISSOURI CIVIL COA #2018033898 MISSOURI LANDSCAPE COA #000008 9229 WARD PARKWAY, SUITE # 210

KANSAS CITY, MO 64114 TEL: (816) 444-4200 STRUCTURAL ENGINEER LEIGH + O'KANE MISSOURI COA #001644

250 NE MULBERRY, SUITE 201 LEE'S SUMMIT, MO 64086 (816) 444-3144 MECH., ELECT. & PLMG. ENGINEERS

HOSS & BROWN ENGINEERS MISSOURI COA #01022 15902 MIDLAND DRIVE SHAWNEE, KS 66217 (913) 362.9090

SECURITY & IT ENGINEERS HENDERSON ENGINEERS MISSOURI COA #000556 1801 MAIN STREET, SUITE 300 KANSAS CITY, MO 64108 (816) 663-8700

I HIGHWAY 150 <sup>-</sup>, MISSOURI 64064

FIRE STATION #5
CITY OF LEE'S SUMMIT 801 MISSOUF LEE'S SUMMI

REVISIONS:
# Description



NEIL BARTLEY - ENGINEER MO# PE-2007023868

DRAWN BY: CHK'D BY:

© GLMV Architecture, Inc.
All work herein is the property of GLMV
Architecture, Inc. and is not to be copied or used
in any way without the express written consent of
GLMV Architecture, Inc.

DOMESTIC WATER RISERS

P303

			-		CONNECTIONS				
MARK	DESCRIPTION	MANUFACTURER	MODEL	TRIM	CW	HW	W	V	NOTES
	WASHING MACHINE			GALVANIZED	T				
WMB	CONNECTION BOX	GUY GRAY	B200	STEEL BOX	1/2"	1/2"	2"	1-1/2"	
IMB	ICE MAKER CONNECTION BOX	GUY GRAY	BIM875	GALVANIZED STEEL BOX	1/2"				
MV-1	POINT-OF-USE THERMOSTATIC MIXING VALVE	SYMMONS LEONARD POWERS	270-LF	0.25 GPM MIN. FLOW ASSE 1017 CERTIFIED LOW FLOW	SEE				15
EW-1	FAUCET WITH INTEGRAL EMERGENCY EYE WASH	BRADLEY	S19-505M	FAUCET WITH SWING ACTIVATED EYE-WASH PROVIDE S19-2000 TMV	1/2"	1/2"			
ET-1	EXPANSION TANK	AMTROL TACO	THERM-X-TROL ST-12 PAX	DOMESTIC WATER SERVICE		3/4"			
RP-1	HIGH EFFICIENCY RECIRCULATION PUMP	TACO	006e3	1/40 HP, 120V AQUASTAT WITH 7-DAY DIGITAL TIMER 3.0 GPM, 8' HEAD					15
					I				
GD-1	GARBAGE DISPOSAL	INSINKERATOR	BADGER 5	1/2 HP, 120V					
HB-1	NON-FREEZE WALL HYDRANT	WOODFORD WADE SMITH	MODEL 65 8600 5609QT	VACUUM BREAKER LOOSE CONTROL KEY WALL CLAMP	1/2"				10
HB-2	ROUGH BRASS HOSE BIBB	WOODFORD CHICAGO	MODEL 24 998	VACUUM BREAKER DRAIN PLUG	1/2"				
RD-1	CAST IRON ROOF DRAIN WITH CAST IRON DOME	WADE ZURN SMITH	W-3000 ZC-100 1010-CID	ROOF DRAIN WITH FLANGE, FLASHING RING, GRAVEL STOP AND CAST IRON DOME					
RH-1	FREEZELESS ROOF HYDRANT NO DRAIN	WOODFORD FREEZE FLOW	2131R		3/4"				

- FAUCET HOLES TO MATCH FAUCET SPECIFIED.
- MOUNT WITH HANDICAPPED RECEPTOR RIM 34" ABOVE FLOOR.
- FIXTURE ASSEMBLY MUST BE APPROVED BY AND INSTALLED PER ADA.
- PROVIDE TRAP GUARDS FOR ALL FLOOR DRAINS OUTSIDE OF FOOD SERVICE AREA.
- PROVIDE FIRE RATED BOX WHERE INSTALLATION IS WITHIN FIRE RATED WALLS, AND STANDARD BOX FOR ALL OTHER WALL TYPES.
- TOLIET FLUSH HANDLES SHALL BE MOUNTED ON THE OPEN SIDE OF THE WATER CLOSET OPPOSITE THE GRAB BALL WALL. PROVIDE BLOCKING FOR FUTURE GRAB BAR INSTALLATION.
- COORDINATE SPUD SIZE WITH FLUSH VALVE SUPPLIED. PROVIDE OPERATING ROD ASSEMBLY PER MANUFACTURER'S RECOMMENDATIONS BASED ON WALL THICKNESS.
- PIPE FOR SHOWER HEAD SHALL BE LOCATED AT 6'-8" A.F.F., ABOVE SURROUND
- COORDINATE SPUD SIZE WITH FLUSH VALVE SUPPLIED. 13. EQUIVALENT CARRIER BY WADE.
- PLUG THE DRAIN FITTING AT THE BOX.
- 15. PIPE SIZE AS SHOWN ON DRAWING.
- 16. PROVIDE LOAD CLASS C, 9870-462-DGC DUCTILE IRON SLOTTED GRATE. PROVIDE ALL REQUIRED ACCESSORIES FOR A COMPLETE INSTALLATION.

### **GENERAL NOTES:**

A. PROVIDE INSULATION KIT ON ALL ADA FIXTURES WITH EXPOSED TRAP AND SUPPLIES.

TOTAL CON	NNECTED GAS LOAD
EQUIPMENT MARK	GAS LOAD (MBH)
B 1	500.0
DOAS 1	104.3
ED\/ 1	106.2

	GAS LOAD	INSULATION	DESCRIPTION
EQUIPMENT MARK	(MBH)	TYPE 1	FIBER GLASS RIGID MOLDED INSULATION - JOHNS-MANVILLE MICRO-LOK, ASJ
B 1	500.0		VAPOR TRANSMISSION = 0.02 PERMS MAX, COMPLIES WITH ASTM C 547, CLAS
DOAS 1	104.3	TYPE 2	PVC JACKETS, HIGH-IMPACT-RESISTANT, UV-RESISTANT, 30 MILS THICK, 1" O\
ERV 1	196.2		COMPLIES WITH ASTM D 1784 AND CLASS 16354-C
GENERATOR	2115.0	TYPE 3	ALUMINUM JACKETS, 0.016" THICK, EMBOSSED FINISH, LONGITUDINAL SLIP JC
GRILL	56.0		COMPLIES WITH ASTM B 209
RANGE OVEN	78.0	TYPE 4	ISULATED PIPE SUPPORTS, 360° PRE-MOLDED PIPE SUPPORTS, VAPOR BARR
WH 1	199.9		> 1 1/2" PIPES MINIMUM COMPRESSIVE STRENGTH: 100 PSIG FOR PIPE SIZE <
TAL GAS LOAD: 7	3249.4	TYPE 5	LAVATORY PIPING COVERS - HANDICAPPED LAVATORY P-TRAPS AND HOT/ CO
			TRUEBRO LAV GUARD 2, FULLY MOLDED VINYL INSULATION SYSTEM. VINYL T
			ASTM D-635, ASTM G21, ASTM G22, COLOR SHALL BE CHINA WHITE AND PAINT

PIPE INSU	ILATION						
INSULATION	DESCRIPTION						
TYPE 1	FIBER GLASS RIGIT	D MOLDED INSULA	ΓΙΟΝ - JOHNS-MAN\	/ILLE MICRO-LOK, A	SJ JACKET, K-VALU	E = 0.23, MAX SERV	ICE TEMP = 850°F
	VAPOR TRANSMISS	SION = 0.02 PERMS	MAX, COMPLIES W	'ITH ASTM C 547, CL	LASS 3, AND ASTM (	C1136 TYPE 1	
TYPE 2	PVC JACKETS, HIG	H-IMPACT-RESISTA	NT, UV-RESISTANT	T, 30 MILS THICK, 1"	OVERLAP AT LONG	ITDINAL SEAMS AN	D END JOINTS
	COMPLIES WITH AS	STM D 1784 AND CL	ASS 16354-C				
TYPE 3	ALUMINUM JACKET	TS, 0.016" THICK, E	MBOSSED FINISH, L	ONGITUDINAL SLIP	JOINTS AND 2" LAP	S	
	COMPLIES WITH AS	STM B 209					
TYPE 4	ISULATED PIPE SU	PPORTS, 360° PRE-	-MOLDED PIPE SUP	PORTS, VAPOR BAI	RRIER AND GALVAN	IIZED STEEL SHIELD	), FOR
	> 1 1/2" PIPES MIN	IMUM COMPRESSIN	/E STRENGTH: 100	PSIG FOR PIPE SIZI	E <6", 450 PSIG FOR	PIPE SIZE 6" AND L	.ARGER
TYPE 5	LAVATORY PIPING	COVERS - HANDIC	APPED LAVATORY	P-TRAPS AND HOT/	COLD WATER LINE	S SHALL BE INSULA	TED WITH
	TRUEBRO LAV GUA	ARD 2, FULLY MOLE	DED VINYL INSULAT	ION SYSTEM. VINYL	THICKNESS = 0.12	5", ADA COMPLIANT	, MEETING
	ASTM D-635, ASTM	G21, ASTM G22, C0	OLOR SHALL BE CH	INA WHITE AND PAI	INTABLE WITH LATE	X PAINT.	
<b>NSULATED PIPE</b>	SUPPORTS						
	PIPE SIZE		INSERT LENGTH	SHIELD LENGTH	SHIELD GAUGE	INSULATION	NOTES
	1 1/2" TO 5"		6"	4"	20	TYPE 4	4
	6" TO 8"		9"	6"	16	TYPE 4	4
<b>INSULATION THI</b>	CKNESS FOR PIPES	LOCATED WITHIN T	HE BUILDING THEF	MAL ENVELOPE			
PIPING	CONTINUOUS		PIPE SIZE				
SYSTEM	VAPOR BARRIER	<= 1 1/2"	2" - 4"	5" - 6"	>= 8"	INSULATION	NOTES
CW	YES	1"	1"	1"	1"	TYPE 1	

NOTES:

HWC

ROOF DRAIN

ALL FITTINGS, VALVES, TEES, FLANGES, CONNECTIONS, ETC. SHALL BE INSULATED AND COVERED WITH THE APPROPRIATE PVC INSULATED FITTING COVERS. FITTING COVERS SHALL MATCH PVC JACKETS. (FOR FIBER GLASS INSULATION) SEAL LONGITUDINAL SEAMS, ENG JOINTS AND PROTRUSIONS WITH VAPOR-BARRIER MASTIC AND JOINT SEALANT.

PIPE INSERT THICKNESS SHALL BE EQUAL TO THE ADJOINING INSULATION THICKNESS.

### GENERAL NOTES: (APPLY ALL TO ABOVE)

YES

- THE BASIS FOR FIBER GLASS PIPE INSULATION AND FITTING COVERS IS JOHNS-MANVILLE WHICH SHALL REPRESENT THE MINIMUM LEVEL OF CONSTRUCTION. PRODUCTS MANUFACTURED BY OWENS-CORNING AND KNAUF SHALL BE PERMITTED TO BID.
- INSTALL ALL PIPE INSULATION PER MANUFACTURER'S PUBLISHED INSTALLATION INSTRUCTIONS. INSTALL INSULATION CONTINUOUSLY THROUGH PENETRATIONS
- PROVIDE LAVATORY PIPING COVERS AT ALL ADA ACCESSIBLE SINKS AND LAVATORIES

					3" THRESHOL	D, SHOWER VA	LVE: SV-1				
T	SINGLE LEVER					1.75 GPM				I	
SV-1	PRESSURE BALANCE		DELTA	T13H133	CH	ROME FINISH		1/2"	1/2"		 11
O V - 1	SHOWER FAUCET		DELIA	11011100		IOWER VALVE		1/2	1/2		''
	GHOWERTAGGET				Off	OVIEW VILVE					
	7" ROUND		WADE	1100STD	NICKEL	BRONZE STRAI	NER				
FD-1	FLOOR DRAIN		ZURN	Z-415		EP SEAL TRAP					
			SMITH	2005							
	8" SQUARE		WADE	9110	6-1/4" DEE	EP BODY, ENAM	IELED				
FS-1	FLOOR SINK		ZURN	Z-1910	INTERIOR	, SEDIMENT BU	CKET,				
			SMITH	3100	NICKEL BRO	ONZE RIM AND	GRATE				
					6" WIDE POL'	YPROPYLENE C	CHANNEL				
TD-1	TRENCH DRAIN		SMITH	9940-DCG-3	w/COATED STE	EL FRAME RAD	IUSED BTM			4"	 16
					9870-462-DGC I	DUCTILE IRON S	SLOTTED				
					6" WIDE, 1	12" LONG, CAST	IRON				
TD-2	MINI-TRENCH DRAIN		ZURN	Z-664		TTOM OUTLET, I					
						R, SLOTTED GF					
						YLENE BODY A					
TD-3	LAUNDRY TRENCH DRAIN	H-M	COPMANY	DRAIN TROUGH		REENS AND ST				2"	
						12" DEEP, SIDE					
	SMALL BASKET-STYLE				35 GPM	I, POLYETHYLE	NE				
LT-1	SMALL BASKET-STYLE SOLIDS INTERCEPTOR		STRIEM	AA-S		I, POLYETHYLE	NE			2"	
LT-1	SOLIDS INTERCEPTOR		HEATER SO		35 GPM	I, POLYETHYLE	NE	<del>-</del>		2"	 VOLT/
LT-1	SOLIDS INTERCEPTOR	VATER		CHEDULE	35 GPM 1/8" DIAMETER	I, POLYETHYLE SCREEN PERF	NE			OVERY	VOLT/ PHASE
LT-1	SOLIDS INTERCEPTOR	VATER QUIPMENT	HEATER S	CHEDULE	35 GPM 1/8" DIAMETER	I, POLYÉTHYLE SCREEN PERF	NE ORATIONS,		(G		
LT-1	SOLIDS INTERCEPTOR  V E	VATER QUIPMENT MARK WH-1	HEATER SOME MANUFACTURES A.O. SMITH	CHEDULE  R MODEL  BTH-199	35 GPM 1/8" DIAMETER CAPACITY (GAL)	INPUT (BTUH/H)	NE ORATIONS, EFFICIEN		(G	OVERY PH)	PHASE
LT-1	SOLIDS INTERCEPTOR  V E	VATER QUIPMENT MARK WH-1 ENERAL NO	MANUFACTURES A.O. SMITH OTES (APPLIES TO	CHEDULE  R MODEL  BTH-199  ALL ABOVE):	35 GPM 1/8" DIAMETER CAPACITY (GAL) 100	INPUT (BTUH/H) 199.0	NE ORATIONS, EFFICIEN		(G	OVERY PH)	PHASE
LT-1	SOLIDS INTERCEPTOR  V E	VATER QUIPMENT MARK WH-1 ENERAL NO	MANUFACTURE  A.O. SMITH  OTES (APPLIES TO  PROVIDE ASME F	R MODEL BTH-199 ALL ABOVE): PRESSURE AND TEN	35 GPN 1/8" DIAMETER  CAPACITY (GAL) 100  MPERATURE RELII	INPUT (BTUH/H) 199.0  EF VALVE.	NE ORATIONS, EFFICIEN		(G	OVERY PH)	PHASE
LT-1	SOLIDS INTERCEPTOR  V E	VATER QUIPMENT MARK WH-1 ENERAL NO A. B.	MANUFACTURE  A.O. SMITH  OTES (APPLIES TO  PROVIDE ASME FOR PROVIDE DIELECTION OF THE PROVIDE DI	R MODEL BTH-199 ALL ABOVE): PRESSURE AND TENTERIC CONNECTION:	35 GPM 1/8" DIAMETER  CAPACITY (GAL) 100  MPERATURE RELII S AT WATER HEA	INPUT (BTUH/H) 199.0  EF VALVE. TER.	NE ORATIONS, EFFICIEN 0.96		(G	OVERY PH)	PHASE
LT-1	SOLIDS INTERCEPTOR  V E	VATER QUIPMENT MARK WH-1 ENERAL NO	MANUFACTURE  A.O. SMITH  OTES (APPLIES TO  PROVIDE ASME F  PROVIDE DIELEC  ALL WATER HEAT	R MODEL BTH-199 ALL ABOVE): PRESSURE AND TEN	CAPACITY (GAL) 100  MPERATURE RELIIS AT WATER HEAL ARGER SHALL HA	INPUT (BTUH/H) 199.0  EF VALVE. TER. AVE ASME RATI	NE ORATIONS,  EFFICIEN 0.96		(G	OVERY PH)	PHASE
LT-1	SOLIDS INTERCEPTOR  V E	VATER QUIPMENT MARK WH-1 ENERAL NO A. B. C.	MANUFACTURE  A.O. SMITH  TES (APPLIES TO  PROVIDE ASME F  PROVIDE DIELECT  ALL WATER HEAT  RESTROOM RECO	CHEDULE  R MODEL BTH-199 ALL ABOVE): PRESSURE AND TENTRIC CONNECTION: TERS 200 MBH OR L	35 GPM 1/8" DIAMETER  CAPACITY (GAL) 100  MPERATURE RELII S AT WATER HEA ARGER SHALL HA 00 DEGREE TEMPI	INPUT (BTUH/H) 199.0  EF VALVE. TER. AVE ASME RATILE	EFFICIEN 0.96	ICY	( <b>G</b>	OVERY PH) 61.0	PHASE 120/1

<b>EQUIPMENT</b>			CAPACITY	INPUT		RECOVERY	VOLT/
MARK	MANUFACTURER	MODEL	(GAL)	(BTUH/H)	<b>EFFICIENCY</b>	(GPH)	PHASE
WH-1	A.O. SMITH	BTH-199	100	199.0	0.96	261.0	120/1
SENERAL NO	TES (APPLIES TO AL	L ABOVE):					
A.	PROVIDE ASME PRE	SSURE AND TEM	PERATURE RELI	EF VALVE.			
B.	PROVIDE DIELECTR	IC CONNECTIONS	AT WATER HEA	TER.			
C.	ALL WATER HEATER	RS 200 MBH OR LA	RGER SHALL HA	VE ASME RATI	NG.		
D	RESTROOM RECOV	FRY BASED ON 90	DEGREE TEMPI	FRATURE RISE			

**GLMV**Architecture 9229 WARD PARKWAY SUITE # 210 KANSAS CITY, MO 64114

CONNECTIONS

CW HW W V NOTES

| 1/2" | -- | 4" | 2" | 1, 4, 7

1-1/4" -- | 4" | 2" | 4, 9

-- 2" 1-1/2"

-- 2" 1-1/2" 2

-- 2" 1-1/2"

-- | -- | 2" |1-1/2"|

-- | -- | 3" |1-1/2"|

1/2" | 1/2" | -- | -- |

1/2" | 1/2" |

3/4" 3/4"

3/4" 3/4"

1/2" | 1/2" |

1/2" -- 2" 1-1/2" 3, 4

-- | -- | 2" |1-1/2"

-- 2" 1-1/2" 8

1/2" | 1/2" | --

-- 2" |1-1/2" | 2

-- 2" 1-1/2" 1, 2, 4

-- 2" -- 1, 2, 4

TEL: (816) 444-4200 FAX: (316) 265-5646 www.glmv.com GLMV ARCHITECTURE, INC. MISSOURI STATE CERTIFICATE OF AUTHORITY #000305

FGMA ARCHITECTS 11250 ROGER BACON DRIVE, SUITE 16 RESTON, VIRGINIA 20190 TEL: (703) 956-5600

CONSULTING ARCHITECT

CIVIL ENGINEER & LANDSCAPE ARCH. GLMV ARCHITECTURE, INC MISSOURI CIVIL COA #2018033898 MISSOURI LANDSCAPE COA #000008 9229 WARD PARKWAY, SUITE # 210 KANSAS CITY, MO 64114 TEL: (816) 444-4200

STRUCTURAL ENGINEER LEIGH + O'KANE MISSOURI COA #001644 250 NE MULBERRY, SUITE 201 LEE'S SUMMIT, MO 64086 (816) 444-3144

MECH., ELECT. & PLMG. ENGINEERS HOSS & BROWN ENGINEERS MISSOURI COA #01022 15902 MIDLAND DRIVE SHAWNEE, KS 66217 (913) 362.9090

**SECURITY & IT ENGINEERS** HENDERSON ENGINEERS MISSOURI COA #000556 1801 MAIN STREET, SUITE 300 KANSAS CITY, MO 64108 (816) 663-8700

> NO S SUI FIRE STAT SS  $\leftarrow$   $\square$

**REVISIONS:** # Description Date

80 LE



**NEIL BARTLEY - ENGINEER** MO# PE-2007023868

PROJECT NO: 18225R21001 DATE: 10.20.2022 DRAWN BY: CHK'D BY: © GLMV Architecture, Inc. All work herein is the property of GLMV Architecture, Inc. and is not to be copied or used

in any way without the express written consent of GLMV Architecture, Inc. **PLUMBING SCHEDULES** 

TYPE 1

TYPE 1

PLUMBING FIXTURE SCHEDULE

DESCRIPTION

ADA FLOOR MOUNTED

FLUSH TANK

WATER CLOSET-1.28 GPF

ADA FLOOR MOUNTED

FLUSH VALVE

WATER CLOSET

**BATTERY POWERED** SENSOR WATER CLOSET

FLUSH VALVE

WALL HUNG LAVATORY

SOLID SURFACE SINK

FURNISHED WITH

COUNTERTOP

WALL HUNG LAVATORY

WALL HUNG LAVATORY

ADA SINGLE BOWL

18 GAUGE

**SELF RIM SINK** 

ADA SINGLE BOWL

TOP MOUNT

KITCHEN SINK

SINGLE BOWL

SINK WITH TWO DRAINBOARDS

FLOOR MOUNTED

TUB TYPE

SERVICE SINK

MOLDED STONE

JANITOR'S SINK

**BOOT WASH** 

ADA SINGLE LEVER

LAVATORY FAUCET

HANDS FREE

LAVATORY

FAUCET

ADA SINGLE LEVER

KITCHEN FAUCET

**ADA TWO-HANDLE** 

WALL-MOUNT SINK

FAUCET

JANITOR'S SINK

FAUCET

TUB TYPE

SINK FAUCET

HANDS FREE

LAVATORY

FAUCET

ADA WALL HUNG

WITH BOTTLE FILLING STATION

SHOWER BASE

36"x36"

SHOWER BASE

DF-1 BI-LEVEL DRINKING FOUNTAIN

MANUFACTURER

KOHLER

TOTO

KOHLER

TOTO

SLOAN

ZURN

TOTO

KOHLER

TOTO

**FURNISHED BY** 

OTHERS

KOHLER

TOTO

AMERICAN STANDARD

KOHLER

TOTO

ELKAY

ELKAY

MANUFACTURING

FIAT

FIAT

RHINO

DELTA

ZURN

TOTO

DELTA

MOEN

DELTA

ZURN

T&S

AMERICAN STANDARD

FIAT

DELTA

TOTO

ELKAY

AQUATIC

AQUATIC

AMERICAN STANDAR

AMERICAN STANDARD RELIANT 7385007

AMERICAN STANDARD

AMERICAN STANDARD CADET III 3717C.001

AMERICAN STANDARD LUCERNE 0355.012

AMERICAN STANDARD LUCERNE 0355.012

MODEL

K-5310-0

CST454CEFG

MADERA 3043.001

K-96057-0

CT705ELN

G2 811-1.6

ZER6000AV-TM-WS1

TET1GA

KINGSTON K-2005

LT307

KINGSTON K-2005

LT307

LUCERNE 0355.012

KINGSTON K-2005

LT307

LRAD202265PD

LUSTERSTONE

LRADQ312265PD

LUSTERSTONE

NSFB-260-24RL-12/12

FL-1

MSB-3624

AGRIWASH

501/520/523-WFHDF

SIERRA Z-7440-VP

TEL105-D10E

2021.634

400-WFELHHDF

BANBURY 87017

28T6443

Z-841H1

B-0290

8344.112

830-AA

28T9-AC

A-1

TEL105-D10E

**EXSTLDDWSVRLK** 

SB4836

SB3636

TRIM

CHURCH 9500C OPEN FRONT SEAT

TOTO SC534 OPEN FRONT SEAT

FLUSH VALVE: FV-1

CHURCH 9500C OPEN FRONT SEAT

TOTO SC534 OPEN FRONT SEAT

1.6 GALLONS PER FLUSH

FAUCET: F-7

20X18 BASIN, CONCEALED

ARM CARRIER, MIXING VALVE MV-1

FAUCET: F-1

FAUCET: F-3

20X18 BASIN, CONCEALED

ARM CARRIER, MIXING VALVE MV-1

FAUCET: EW-1

20X18 BASIN, CONCEALED

ARM CARRIER

FAUCET F-3

INTEGRAL DRAIN WITH STOP

FAUCET: F-3

GARBAGE DISPOSAL: GD-1

33X22X5-1/2" SINGLE BOWL

FAUCET: F-4

FAUCET F-6

INTEGRAL DRAIN WITH STOP

FAUCET: F-5;

S/S BUMPERGUARDS,

S/S WALL GUARDS FAUCET: HB-2

DRAIN: TD-2

2.5 GPM, VANDAL RESISTANT

POP-UP DRAIN, 4" CENTERS

THERMOSTATIC MIXING VALVE

0.5 GPM, SELF-GENERATING

VALVE, GRID STRAINER, COVER PLATE

HAND SPRAY

CUP STRAINER DRAIN

2.5 GPM. 8" CENTERS

SWING SPOUT

MOUNT ON BACKSPLASH

VACUUM BREAKER, WALL BRACE,

PAIL HOOK, 30" HOSE WITH WALL

GRIP, MOP HANGER

DECK FAUCET

4" CENTERS

0.5 GPM, SELF-GENERATING

BATTERY, THERMOSTATIC

MIXING VALVE, GRID STRAINER

WHITE CERAMIC BASE

CENTER DRAIN 3" THRESHOLD, SHOWER VALVE: SV-1

WHITE CERAMIC BASE

CENTER DRAIN

BATTERY, THERMOSTATIC MIXING 1/2" 1/2"

INTEGRAL SUMP, SS WATER LINES

MARK

WC-1

WC-2

FV-1

L-2

L-3

L-4

S-1

S-2

S-3

S-4

JS-1

BW-1

F-1

F-2

F-3


F-4

F-6

F-7

SH-1

SH-2

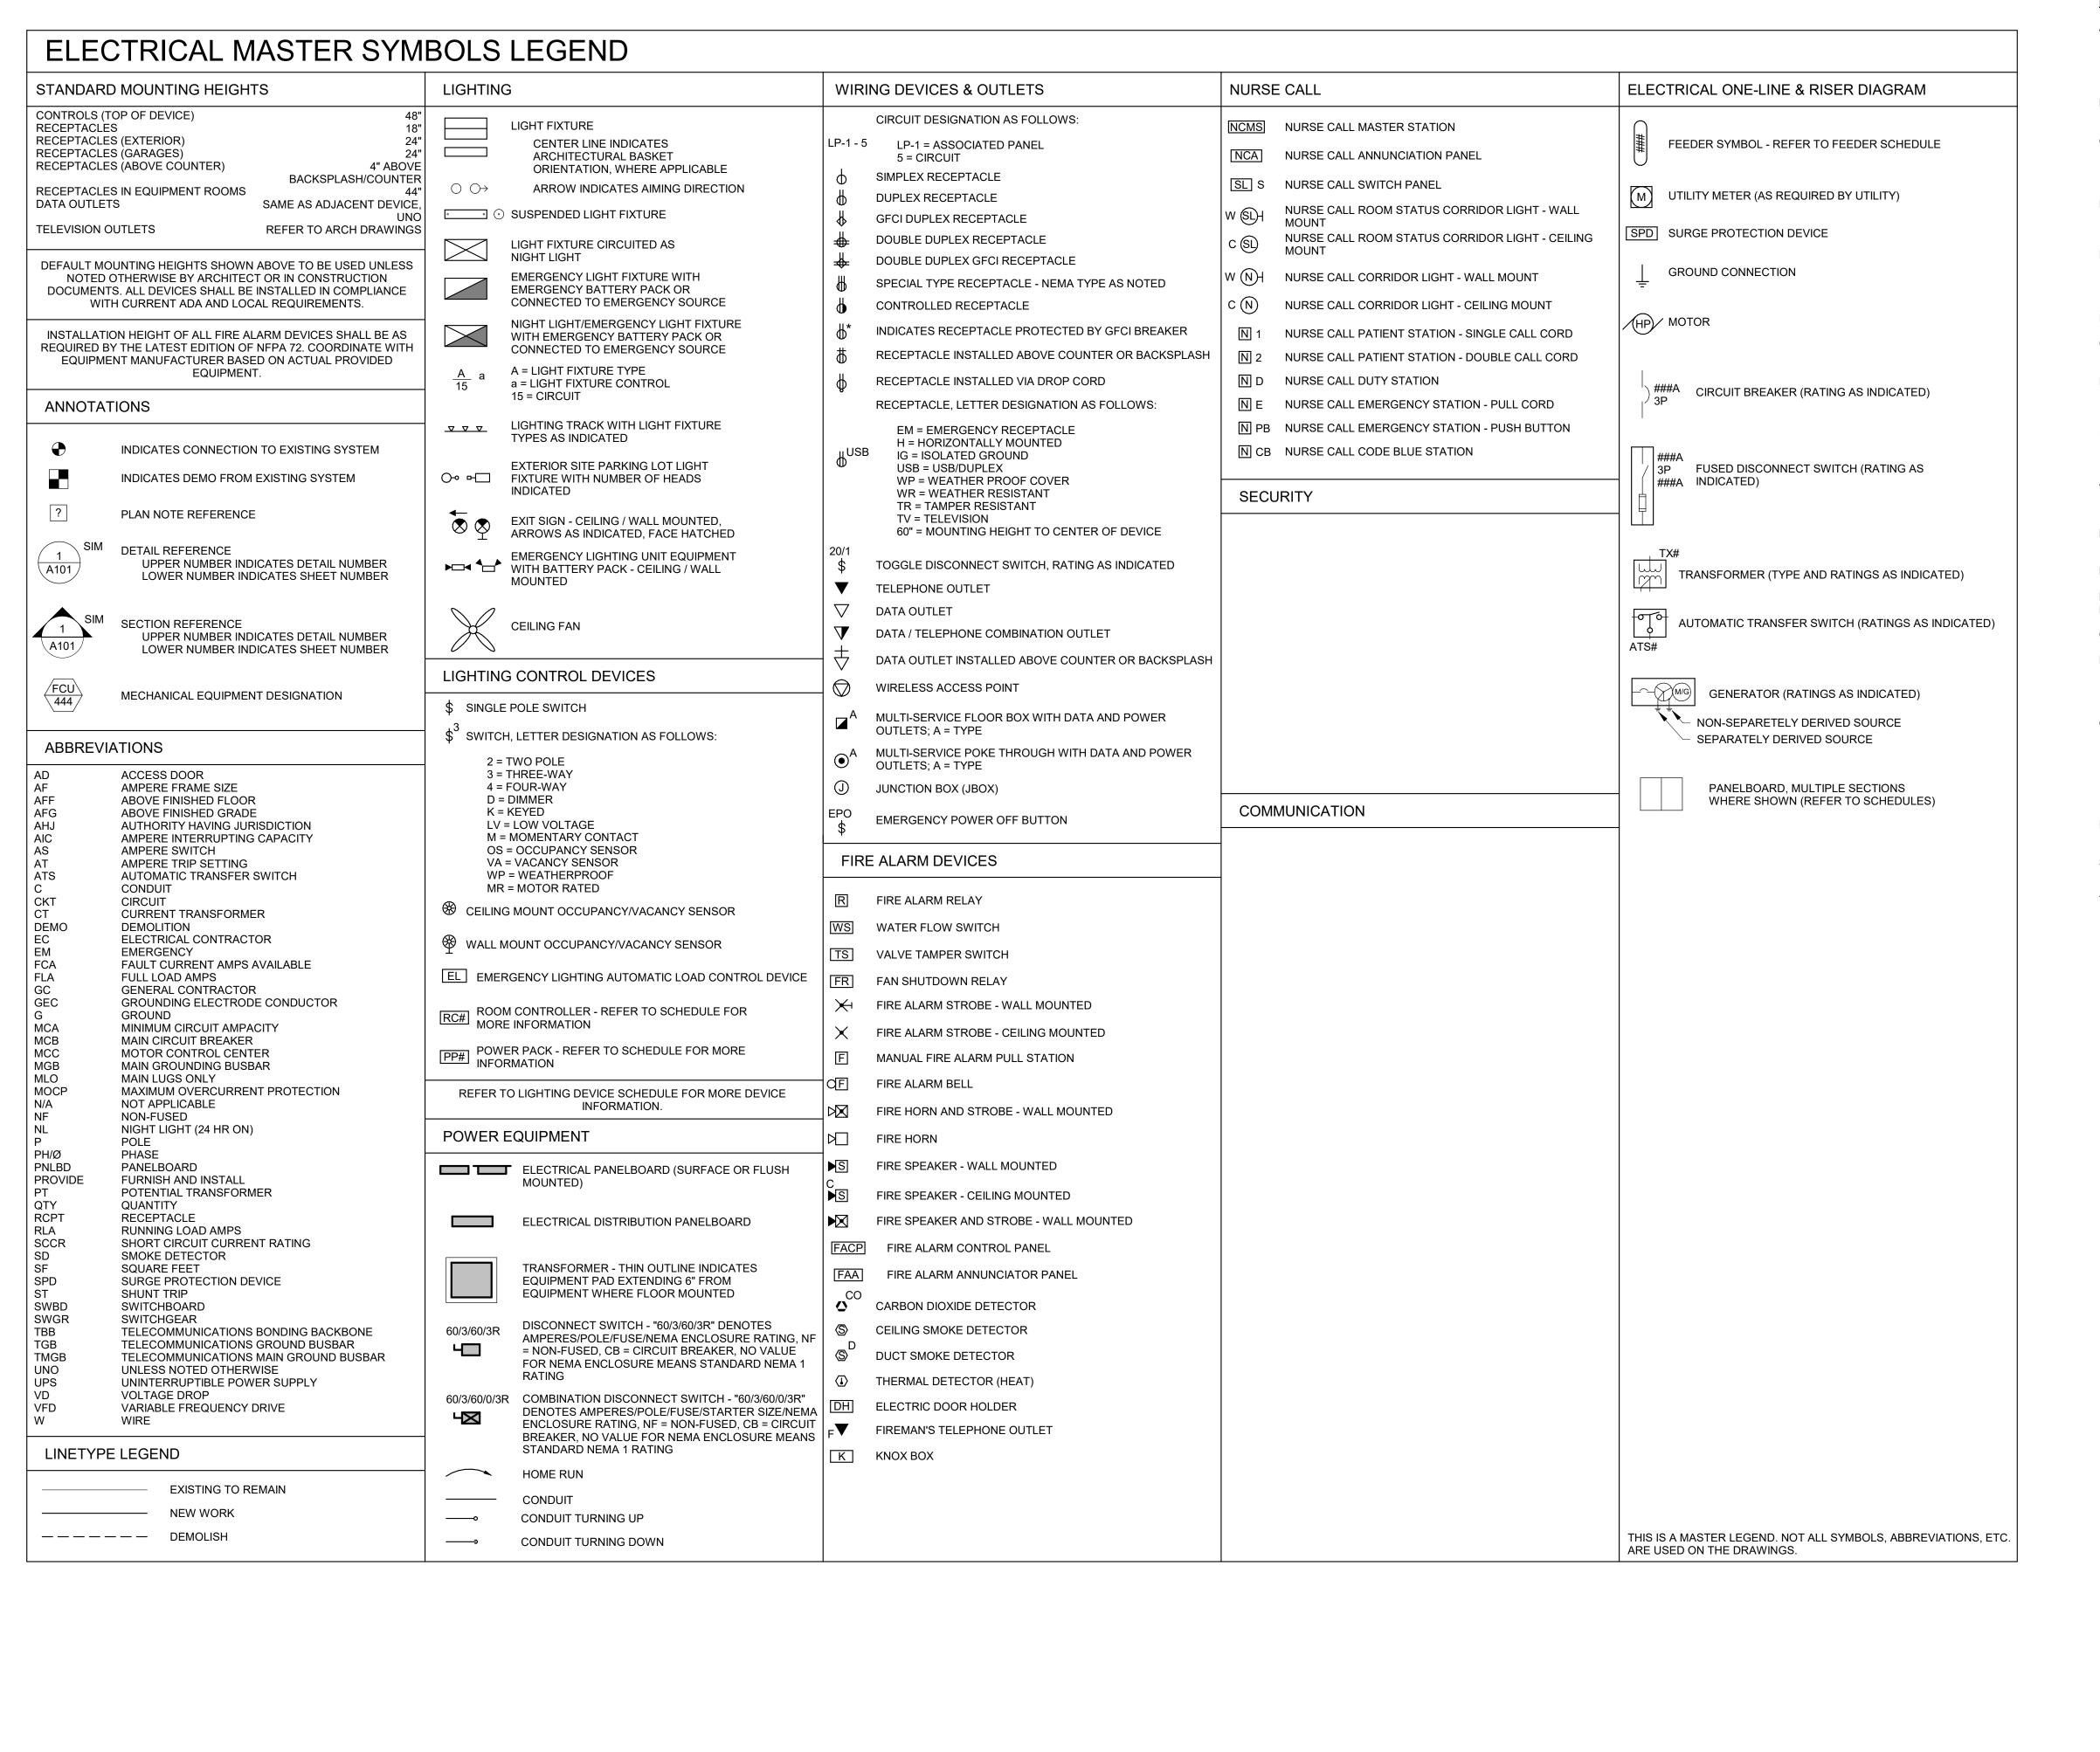

- SYSTEM.
- B. ELECTRICAL CONTRACTOR SHALL DE-RATE CONDUCTORS AS REQUIRED BY THE N.E.C. WHEN
- C. VERIFY REQUIREMENTS OF ALL MECHANICAL EQUIPMENT WITH CONTRACTOR PROVIDED BETWEEN THE SUBMITTALS AND ELECTRICAL
  - THROUGH FIRE RATED WALLS AND FLOORS.
- E. CONTRACTOR SHALL OFFSET OUTLET BOXES ON OPPOSITE SIDES OF A COMMON WALL TO PREVENT
- SHALL BE PROVIDED AS PLENUM RATED CABLES. PULL-STRINGS UP TO ACCESSIBLE LOCATION IN
- IN DIRECT CONTACT WITH THE EARTH, OR MASONRY THAT IS IN DIRECT CONTACT WITH THE EARTH SHALL BE WET LOCATION LISTED. J. FURNITURE LAYOUTS ARE FOR REFERENCE ONLY. COORDINATE THE FINAL LOCATION OF ELECTRICAL
- DEVICES AND OUTLETS WITH ARCHITECT, OWNER AND FINAL FURNITURE PLANS PRIOR TO INSTALLATION. K. PROVIDE LOCKING CLIPS ON ALL CIRCUIT BREAKERS
- ALARM CONTROL PANELS.
- OPEN J-BOXES LOCATED IN EXISTING WALL. M. MAINTAIN ALL EXISTING CIRCUIT CONTINUITIES.
- THERMOSTATS AS INDICATED. O. REFER TO TELECOMMUNICATION DRAWINGS FOR DATA
- P. PROVIDE DUCT SMOKE DETECTORS IN RETURN AIR PATHS FOR AIR HANDLING EQUIPMENT 2,000 CFM AND LARGER AND WHERE SHOWN ON PLANS. INTERLOCK WITH AIR HANDLING EQUIPMENT TO SHUT DOWN UNIT UPON SMOKE DETECTION.
- ALARM SUBCONTRACTORS TO PROVIDE A FULLY SYSTEM DESIGN AND INSTALLATION.
- R. GROUND FAULT INTERRUPTER RECEPTACLES SHALL BE PROVIDED IN ALL LOCATIONS AS REQUIRED IN SECTION 210.8 OF THE 2017 NEC.
- S. ARC FAULT INTERRUPTER PROTECTION SHALL BE PROVIDED IN ALL LOCATIONS AS REQUIRED IN SECTION 210.12 OF THE 2017 NEC.

**ELECTRICAL GENERAL NOTES:** 

- A. THESE DRAWINGS ARE DIAGRAMMATIC IN NATURE AND INDICATE THE GENERAL EXTENT OF THE WORK. THE ELECTRICAL CONTRACTOR SHALL PROVIDE ALL PULL BOXES, JUNCTION BOXES AND INCIDENTAL MATERIALS AND LABOR FOR A COMPLETE AND FULLY FUNCTIONAL
- GROUPED IN COMMON RACEWAYS.
- SUBMITTALS. NOTIFY ENGINEER OF ANY CONFLICTS DRAWINGS.
  - D. PROVIDE FIRESTOPPING ON CONDUITS PASSING COORDINATE LOCATION AND RATINGS OF WALLS WITH ARCHITECTURAL DRAWINGS.
  - SOUND TRANSMISSION BETWEEN ADJOINING ROOMS BOXES SHALL BE A MINIMUM OF 12" APART, AND MUST
  - BE INSTALLED IN SEPARATE STUD CAVITIES. F. ALL LOW VOLTAGE WIRES NOT ROUTED IN CONDUIT G. PROVIDE JUNCTION BOXES AND 3/4" CONDUIT WITH
- PLENUM AT ALL VOICE AND DATA OUTLET LOCATIONS. H. WHERE BOXES ARE INSTALLED IN CONCRETE BLOCK WALLS, THE BOX MOUNTING HEIGHT SHALL BE AT THE BLOCK JOINT AND THE DEVICES SHALL BE PROVIDED WITH A JUMBO COVERPLATE. I. ALL WIRES RUN BELOW GRADE, IN CONCRETE THAT IS
- SERVING TELECOMMUNICATION EQUIPMENT AND FIRE
- L. PROVIDE BLANK COVER PLATES FOR ALL EXISTING
- N. PROVIDE ROUGH-IN BOXES AND CONDUIT FOR
- REQUIREMENTS.
- Q. THE FIRE ALARM SCOPE OF WORK IS A DELEGATED DESIGN AND DEFERRED SUBMITTAL REQUIRING FIRE ALARM SUBCONTRACTOR STAMPED ENGINEERING AND SUBMISSION TO THE AHJ FOR REVIEW/APPROVAL. IT IS THE RESPONSIBILITY OF THE ELECTRICAL AND FIRE COORDINATED, COMPLETE, AND CODE COMPLIANT

- T. TAMPER RESISTANT RECEPTACLES SHALL BE PROVIDED AT ALL LOCATIONS AS REQUIRED BY SECTION 406.12 (DWELLING UNITS) OF THE 2017 NEC.

**GLMV**Architecture 9229 WARD PARKWAY

SUITE # 210

KANSAS CITY, MO 64114 TEL: (816) 444-4200 FAX: (316) 265-5646 www.glmv.com GLMV ARCHITECTURE, INC. MISSOURI STATE CERTIFICATE OF AUTHORITY #000305

CONSULTING ARCHITECT FGMA ARCHITECTS 11250 ROGER BACON DRIVE, SUITE 16 RESTON, VIRGINIA 20190 TEL: (703) 956-5600

CIVIL ENGINEER & LANDSCAPE ARCH. GLMV ARCHITECTURE, INC MISSOURI CIVIL COA #2018033898 9229 WARD PARKWAY, SUITE # 210

MISSOURI LANDSCAPE COA #000008 KANSAS CITY. MO 64114 TEL: (816) 444-4200 STRUCTURAL ENGINEER


LEIGH + O'KANE MISSOURI COA #001644 250 NE MULBERRY, SUITE 201 LEE'S SUMMIT, MO 64086 (816) 444-3144

MECH., ELECT. & PLMG. ENGINEERS HOSS & BROWN ENGINEERS MISSOURI COA #01022 15902 MIDLAND DRIVE SHAWNEE, KS 66217 (913) 362.9090

SECURITY & IT ENGINEERS HENDERSON ENGINEERS MISSOURI COA #000556 1801 MAIN STREET, SUITE 300 KANSAS CITY, MO 64108 (816) 663-8700

NO SU SS ОШ

**REVISIONS**: # Description

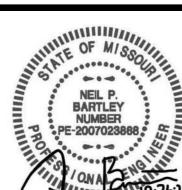



**NEIL BARTLEY - ENGINEER** MO# PE-2007023868


PROJECT NO: 18225R21001 DATE: 10.20.2022 DRAWN BY: CHK'D BY: © GLMV Architecture, Inc. Architecture, Inc. and is not to be copied or used


**ELECTRICAL SYMBOLS** LEGEND


in any way without the express written consent of GLMV Architecture, Inc.

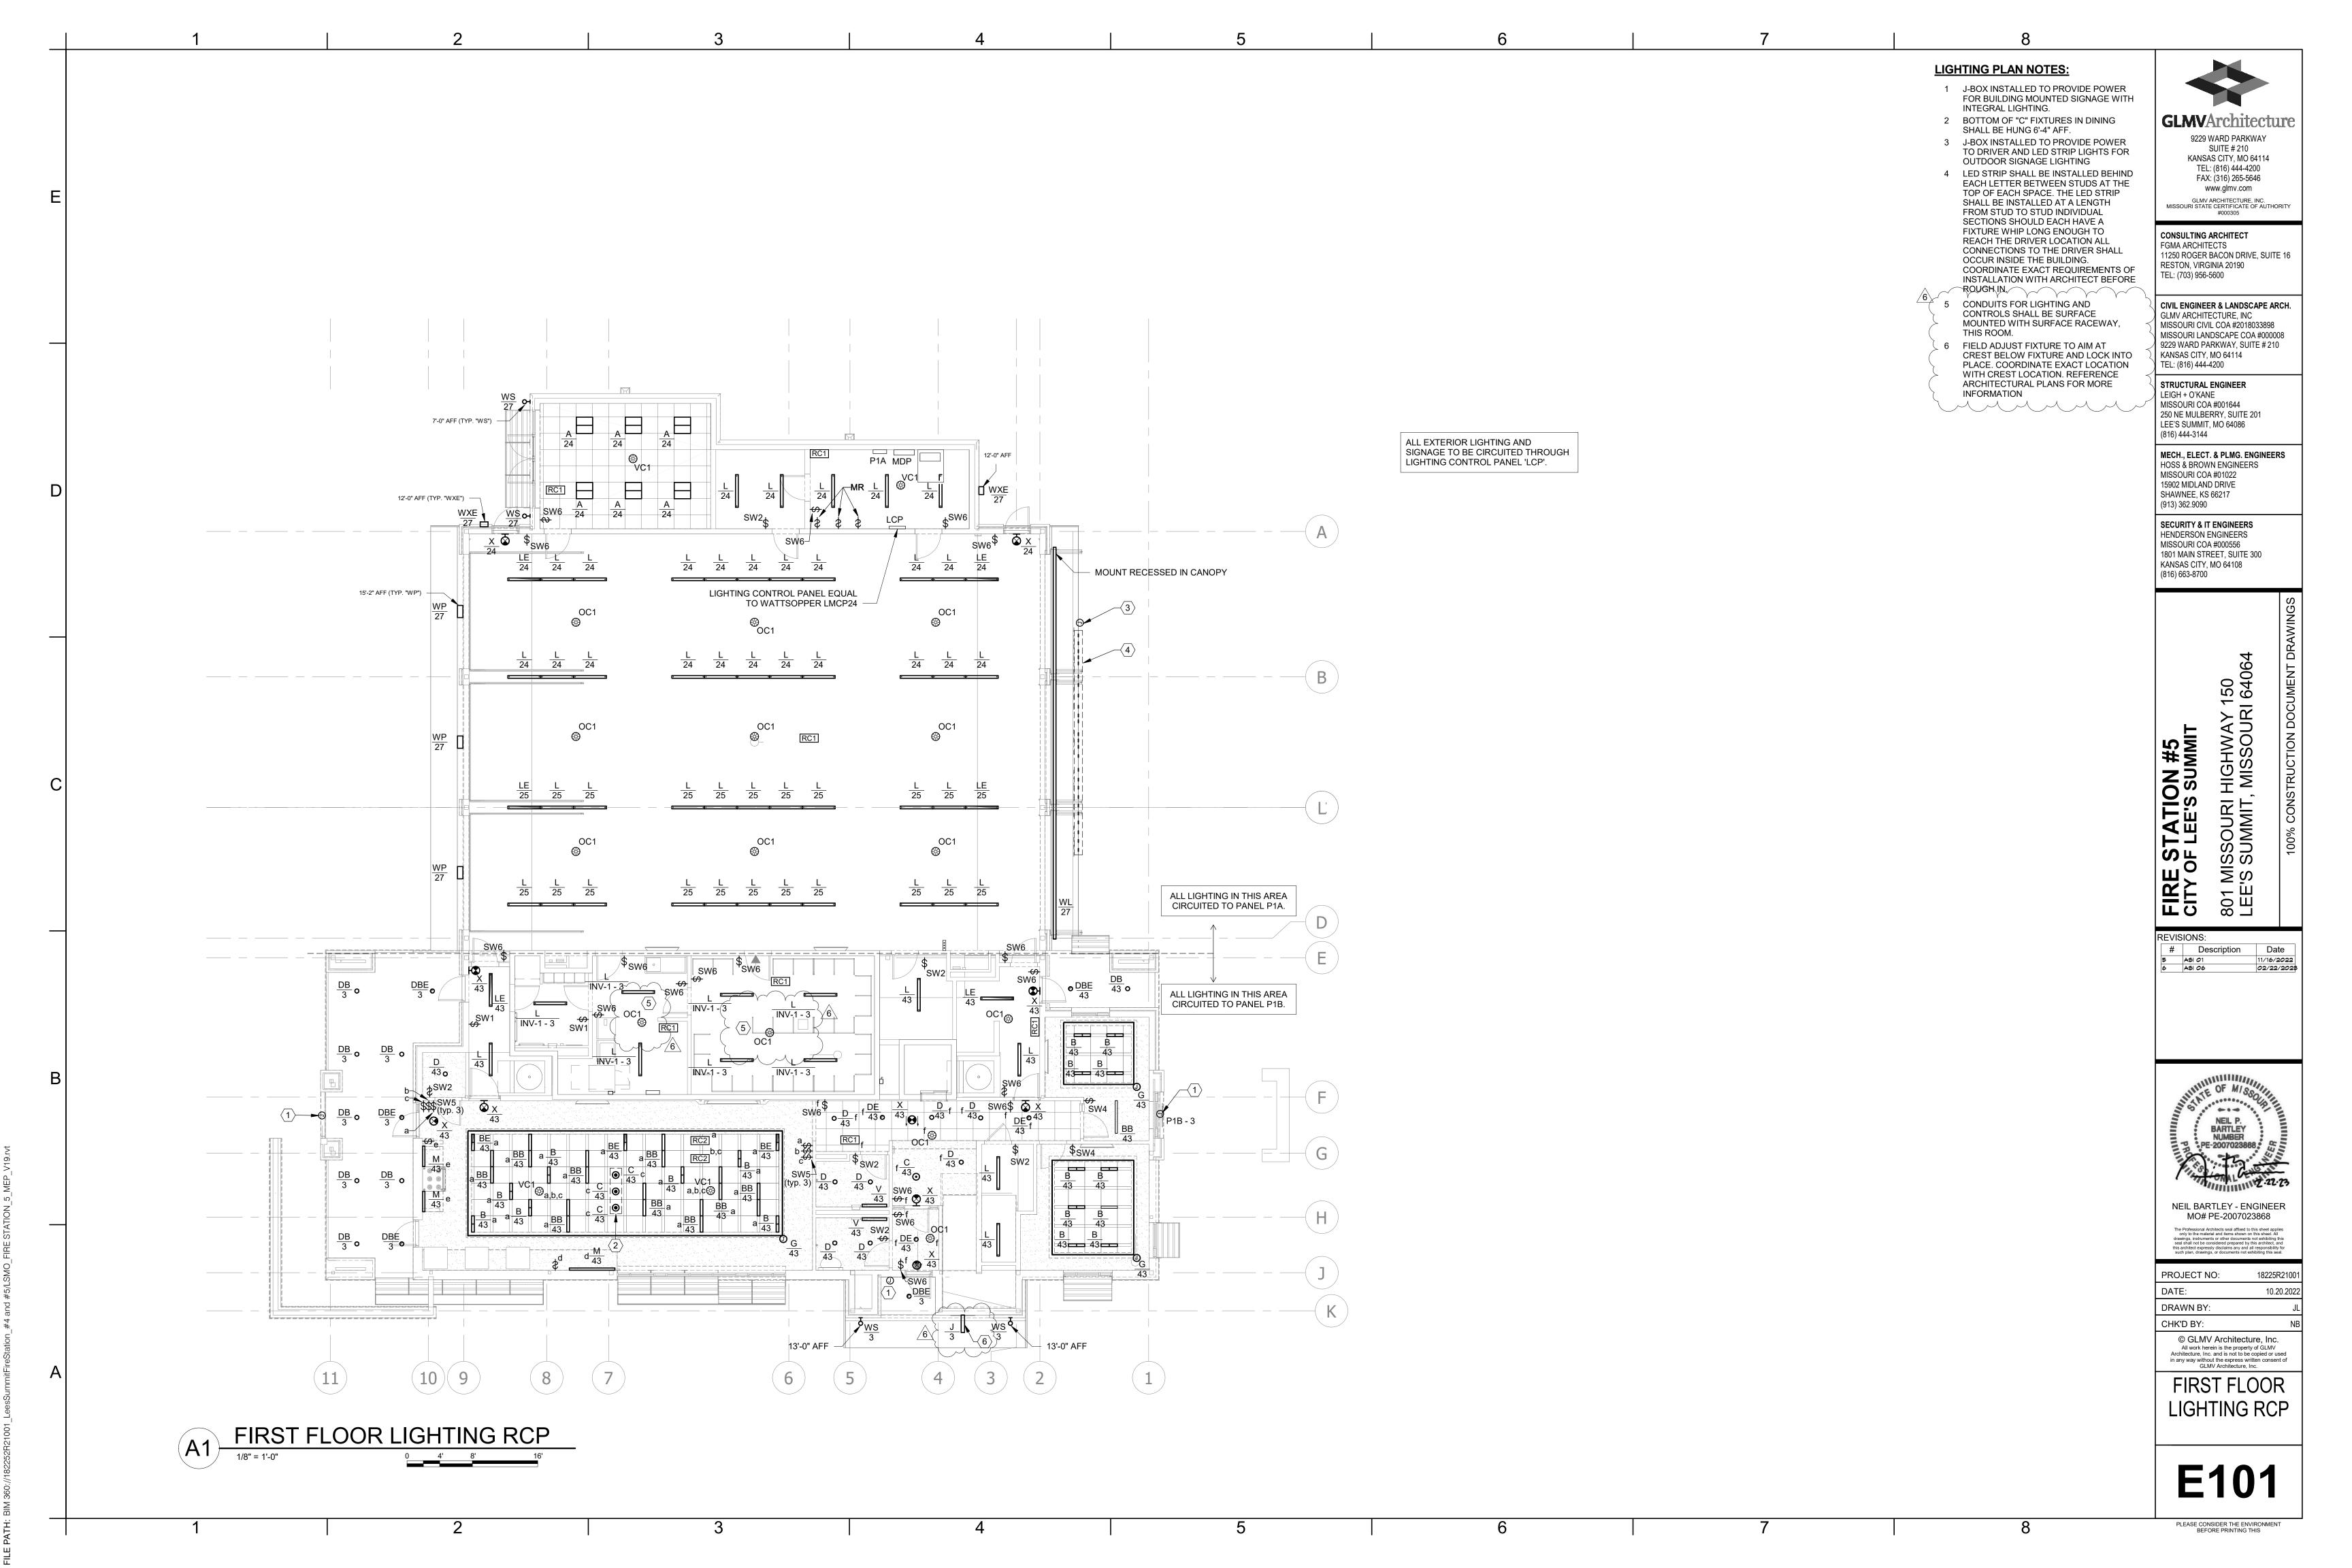


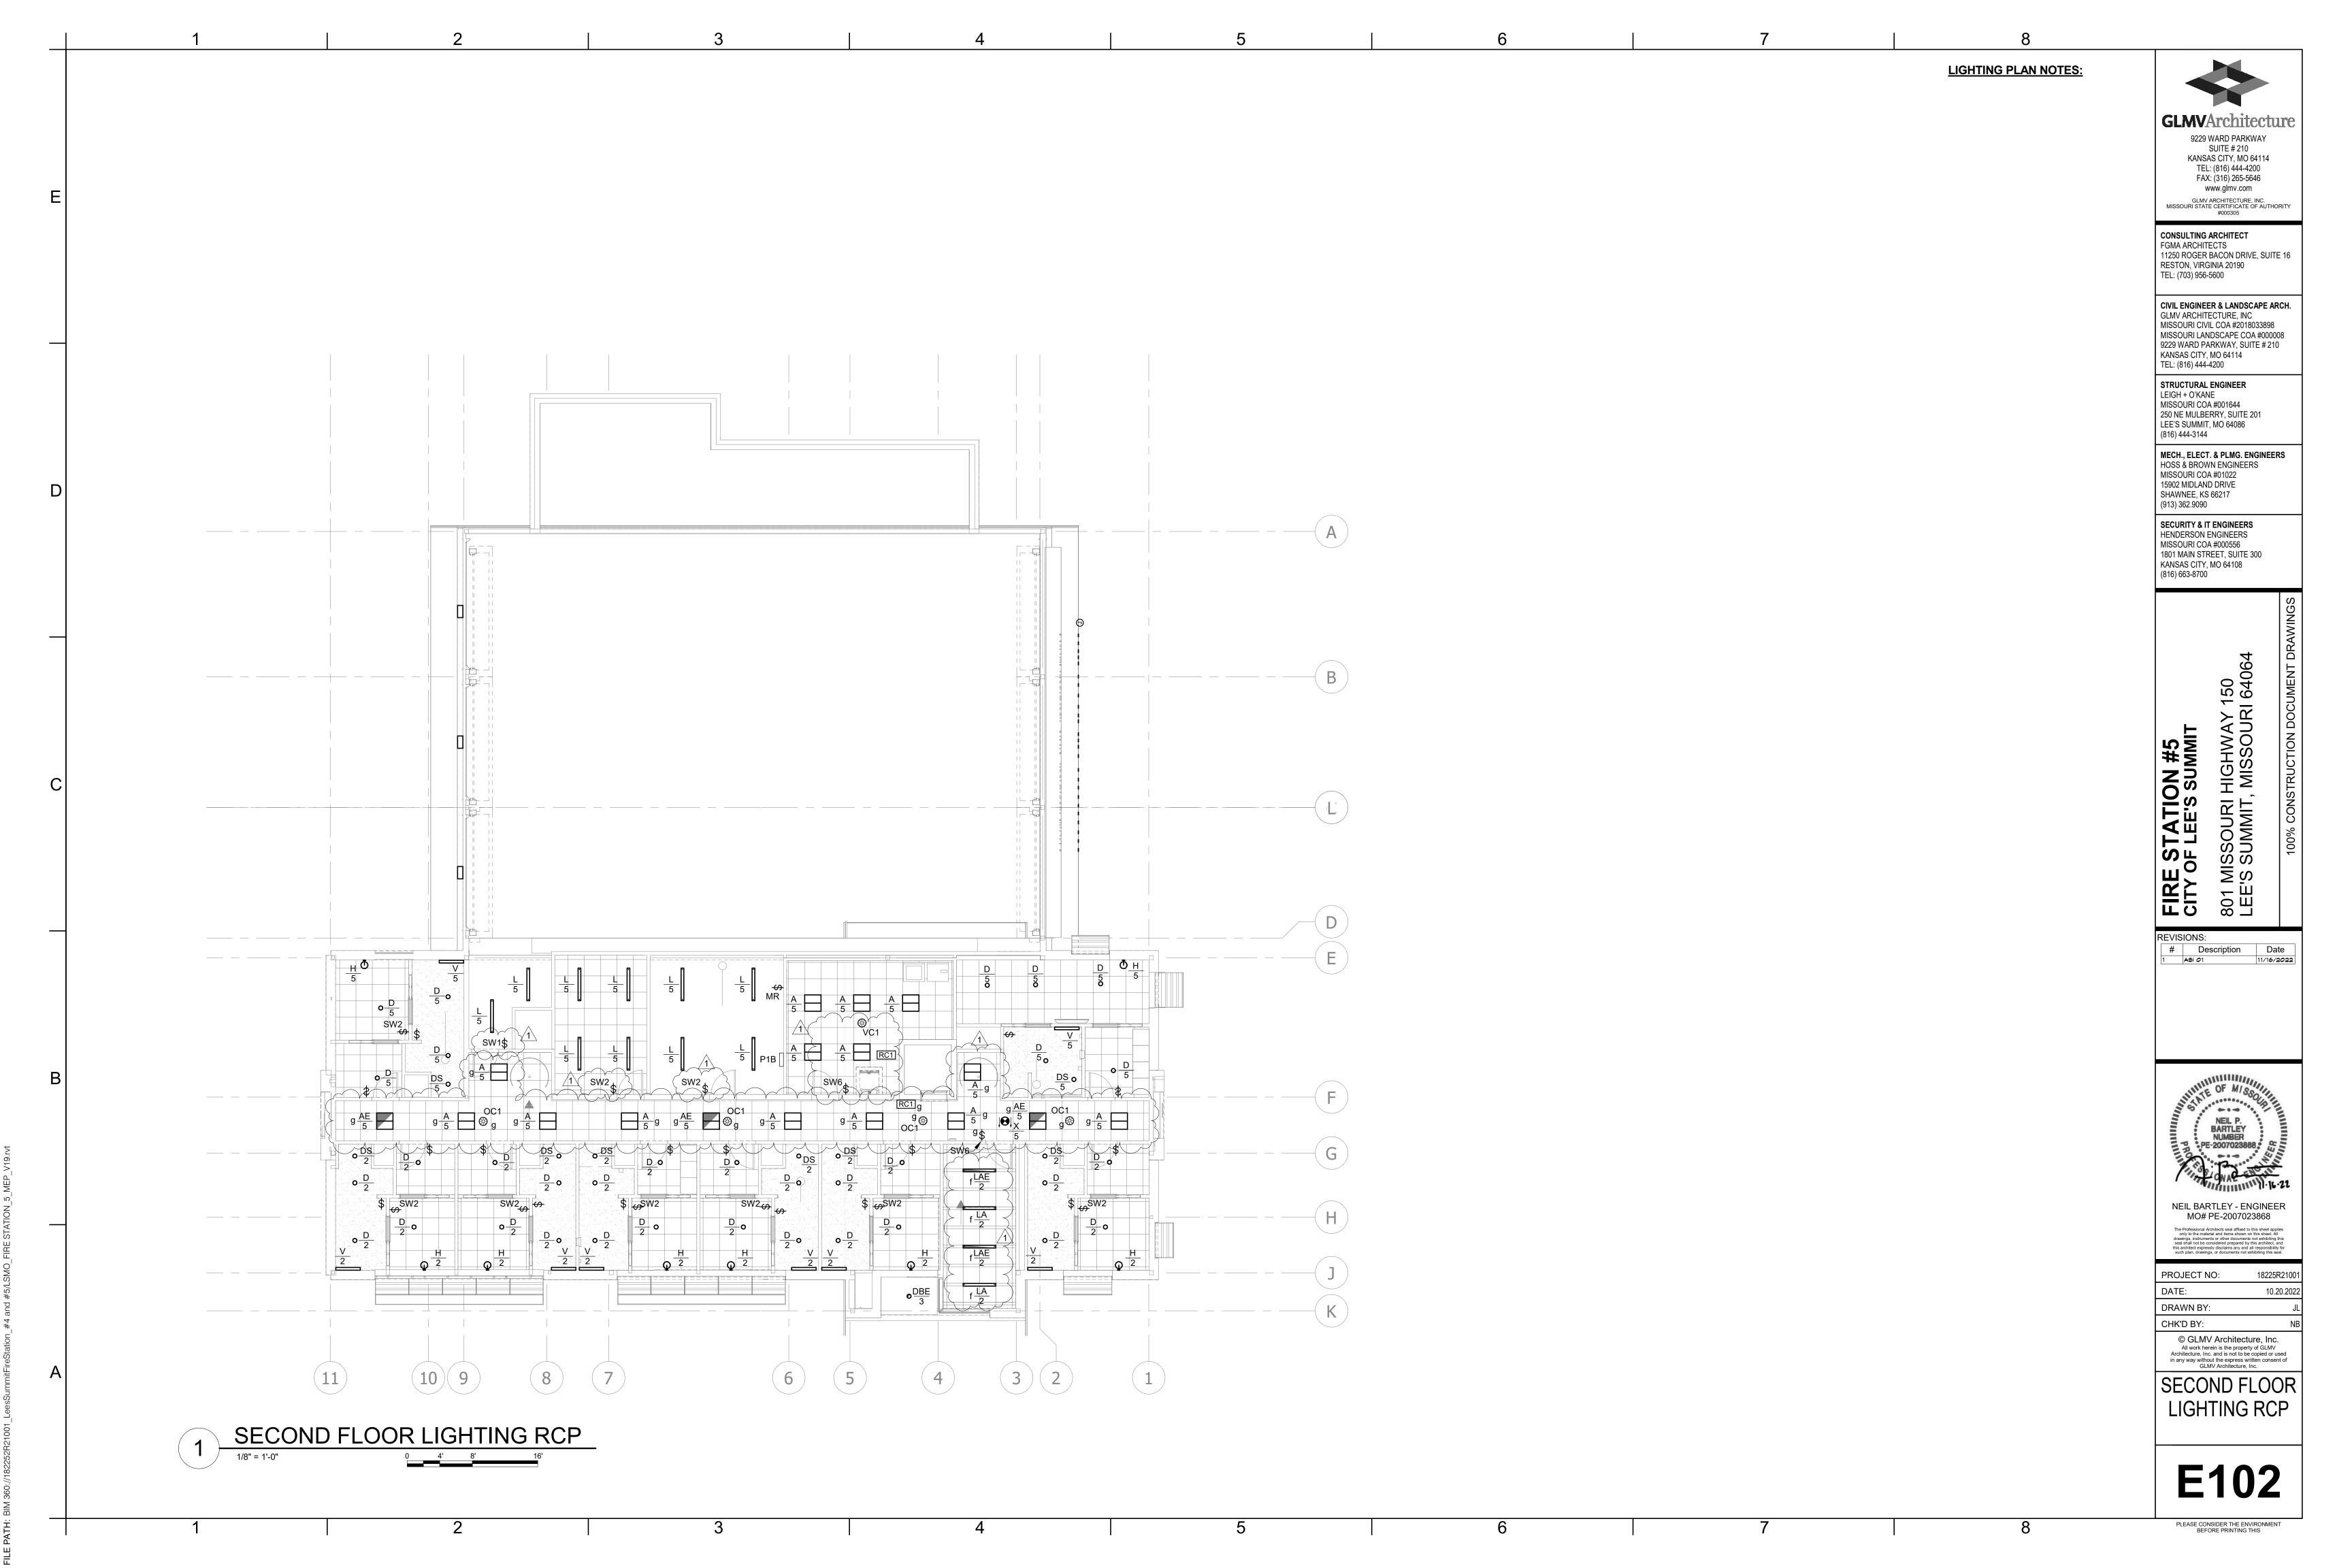


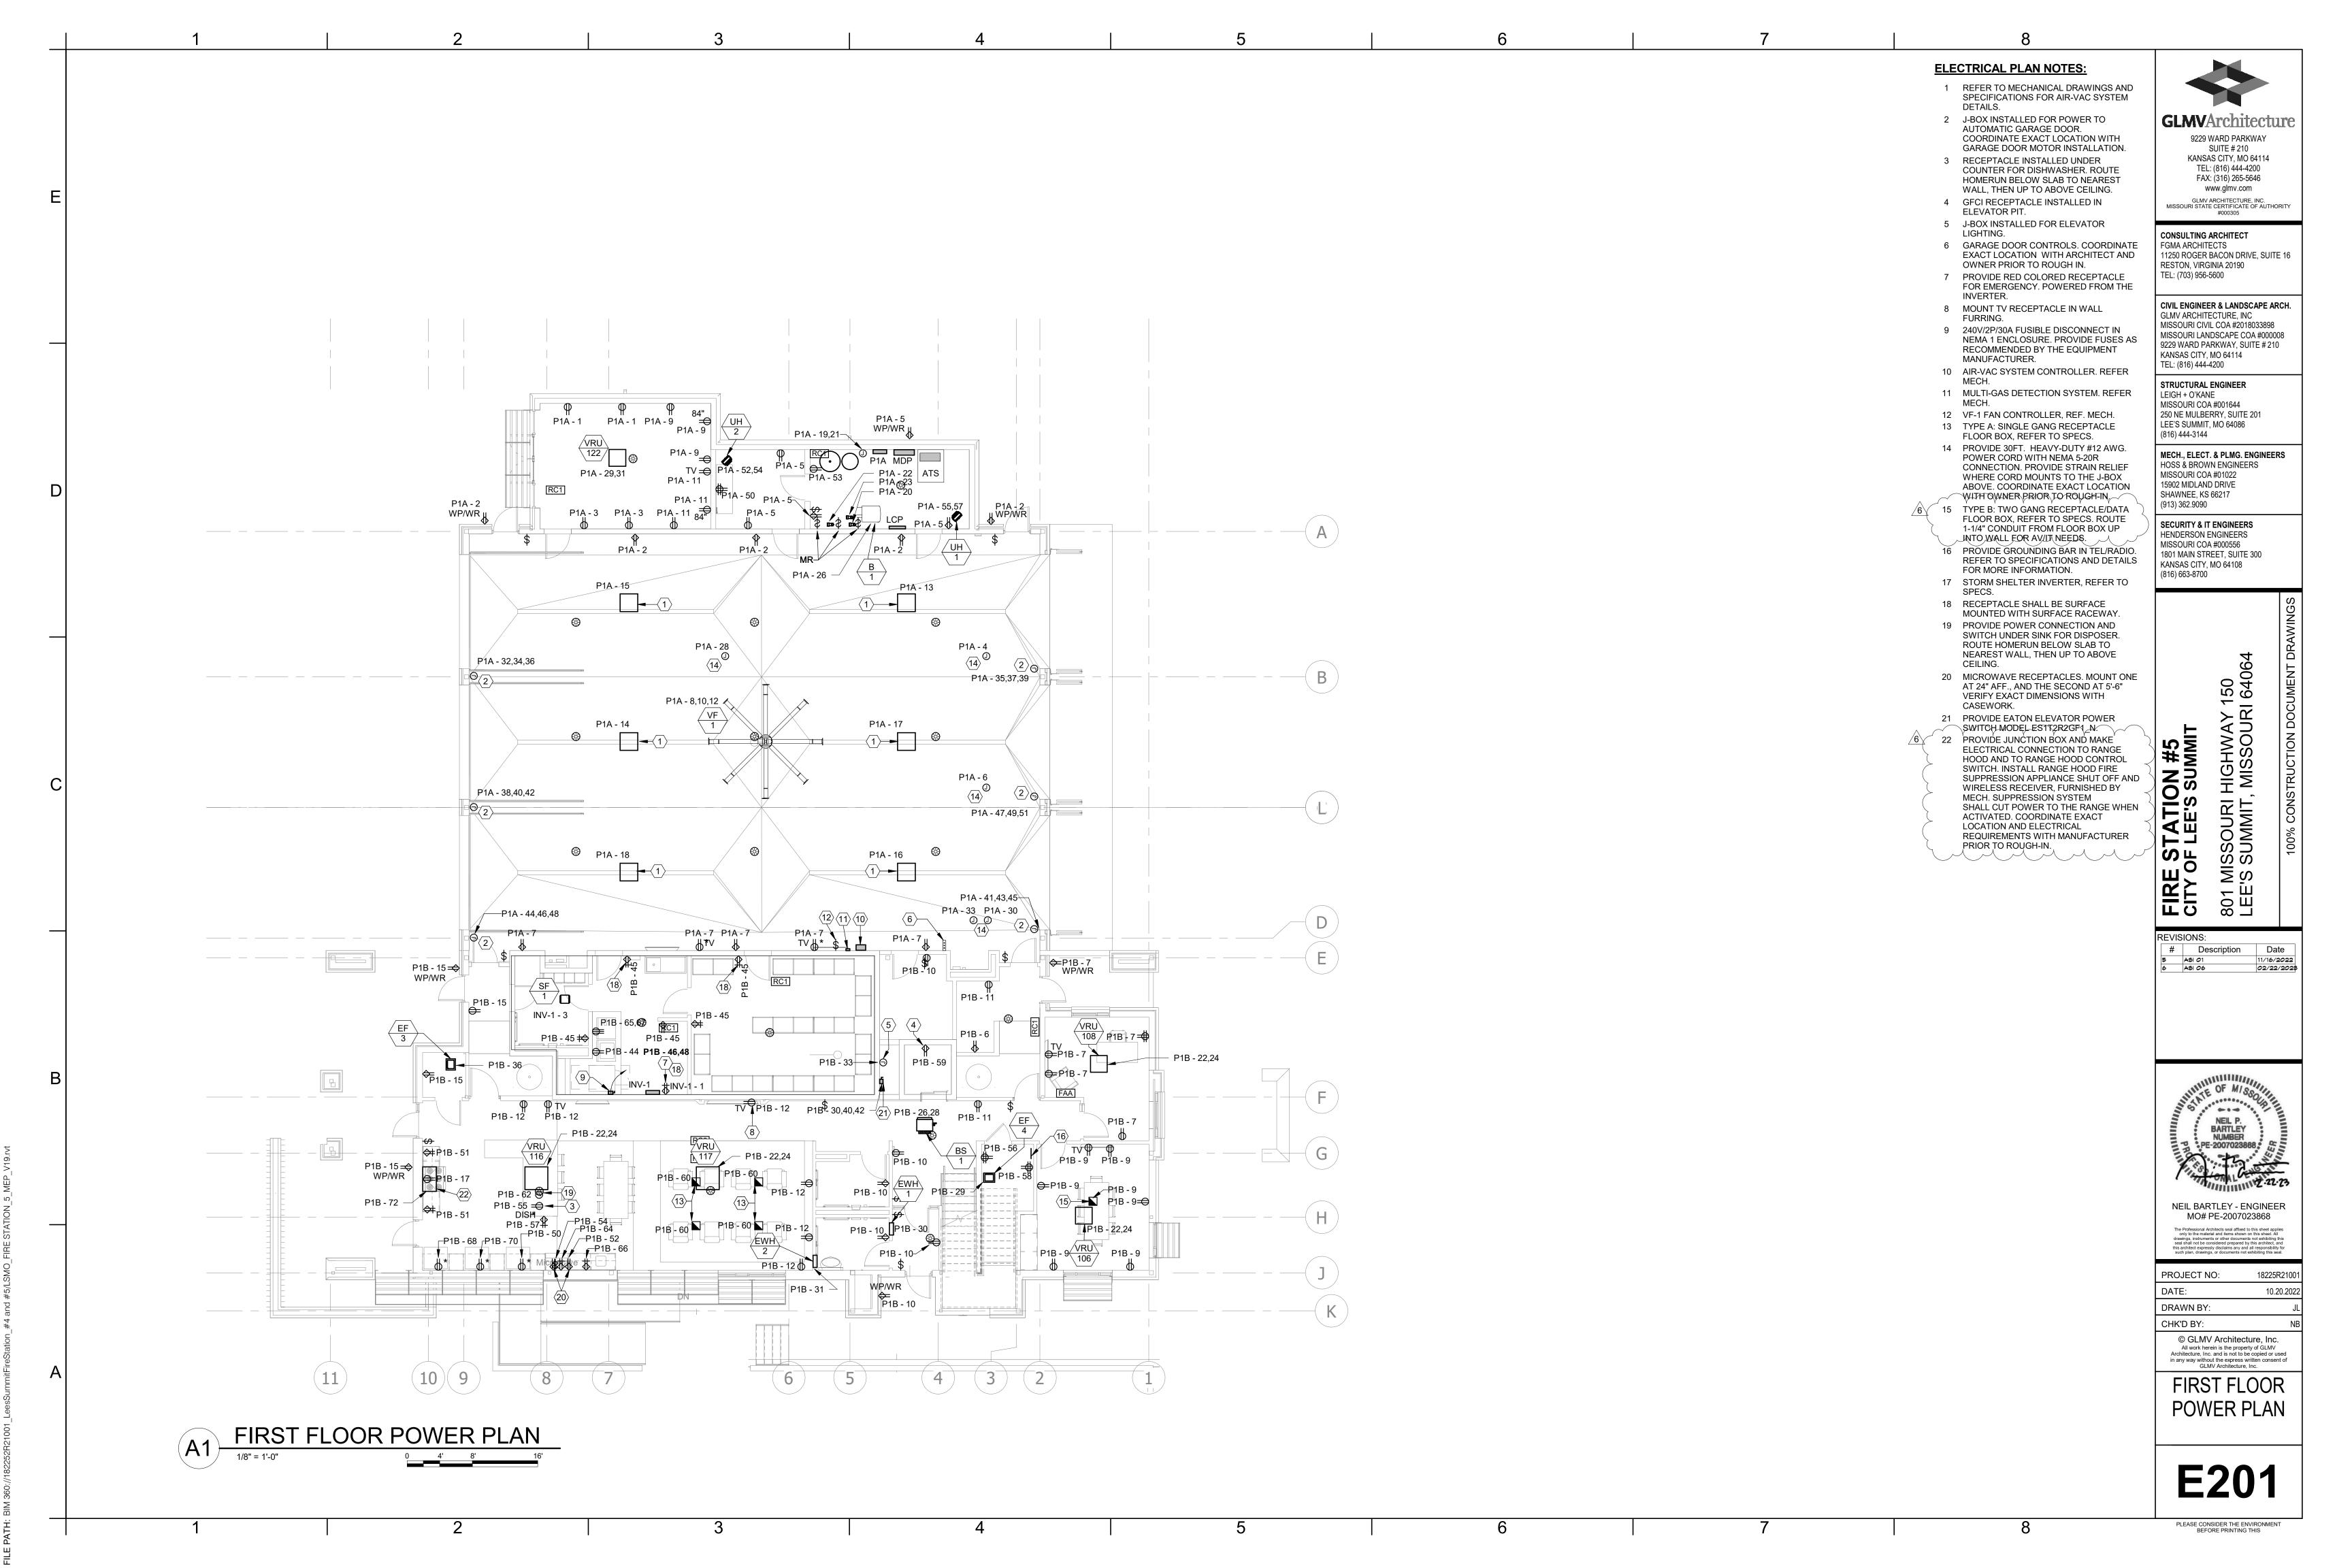

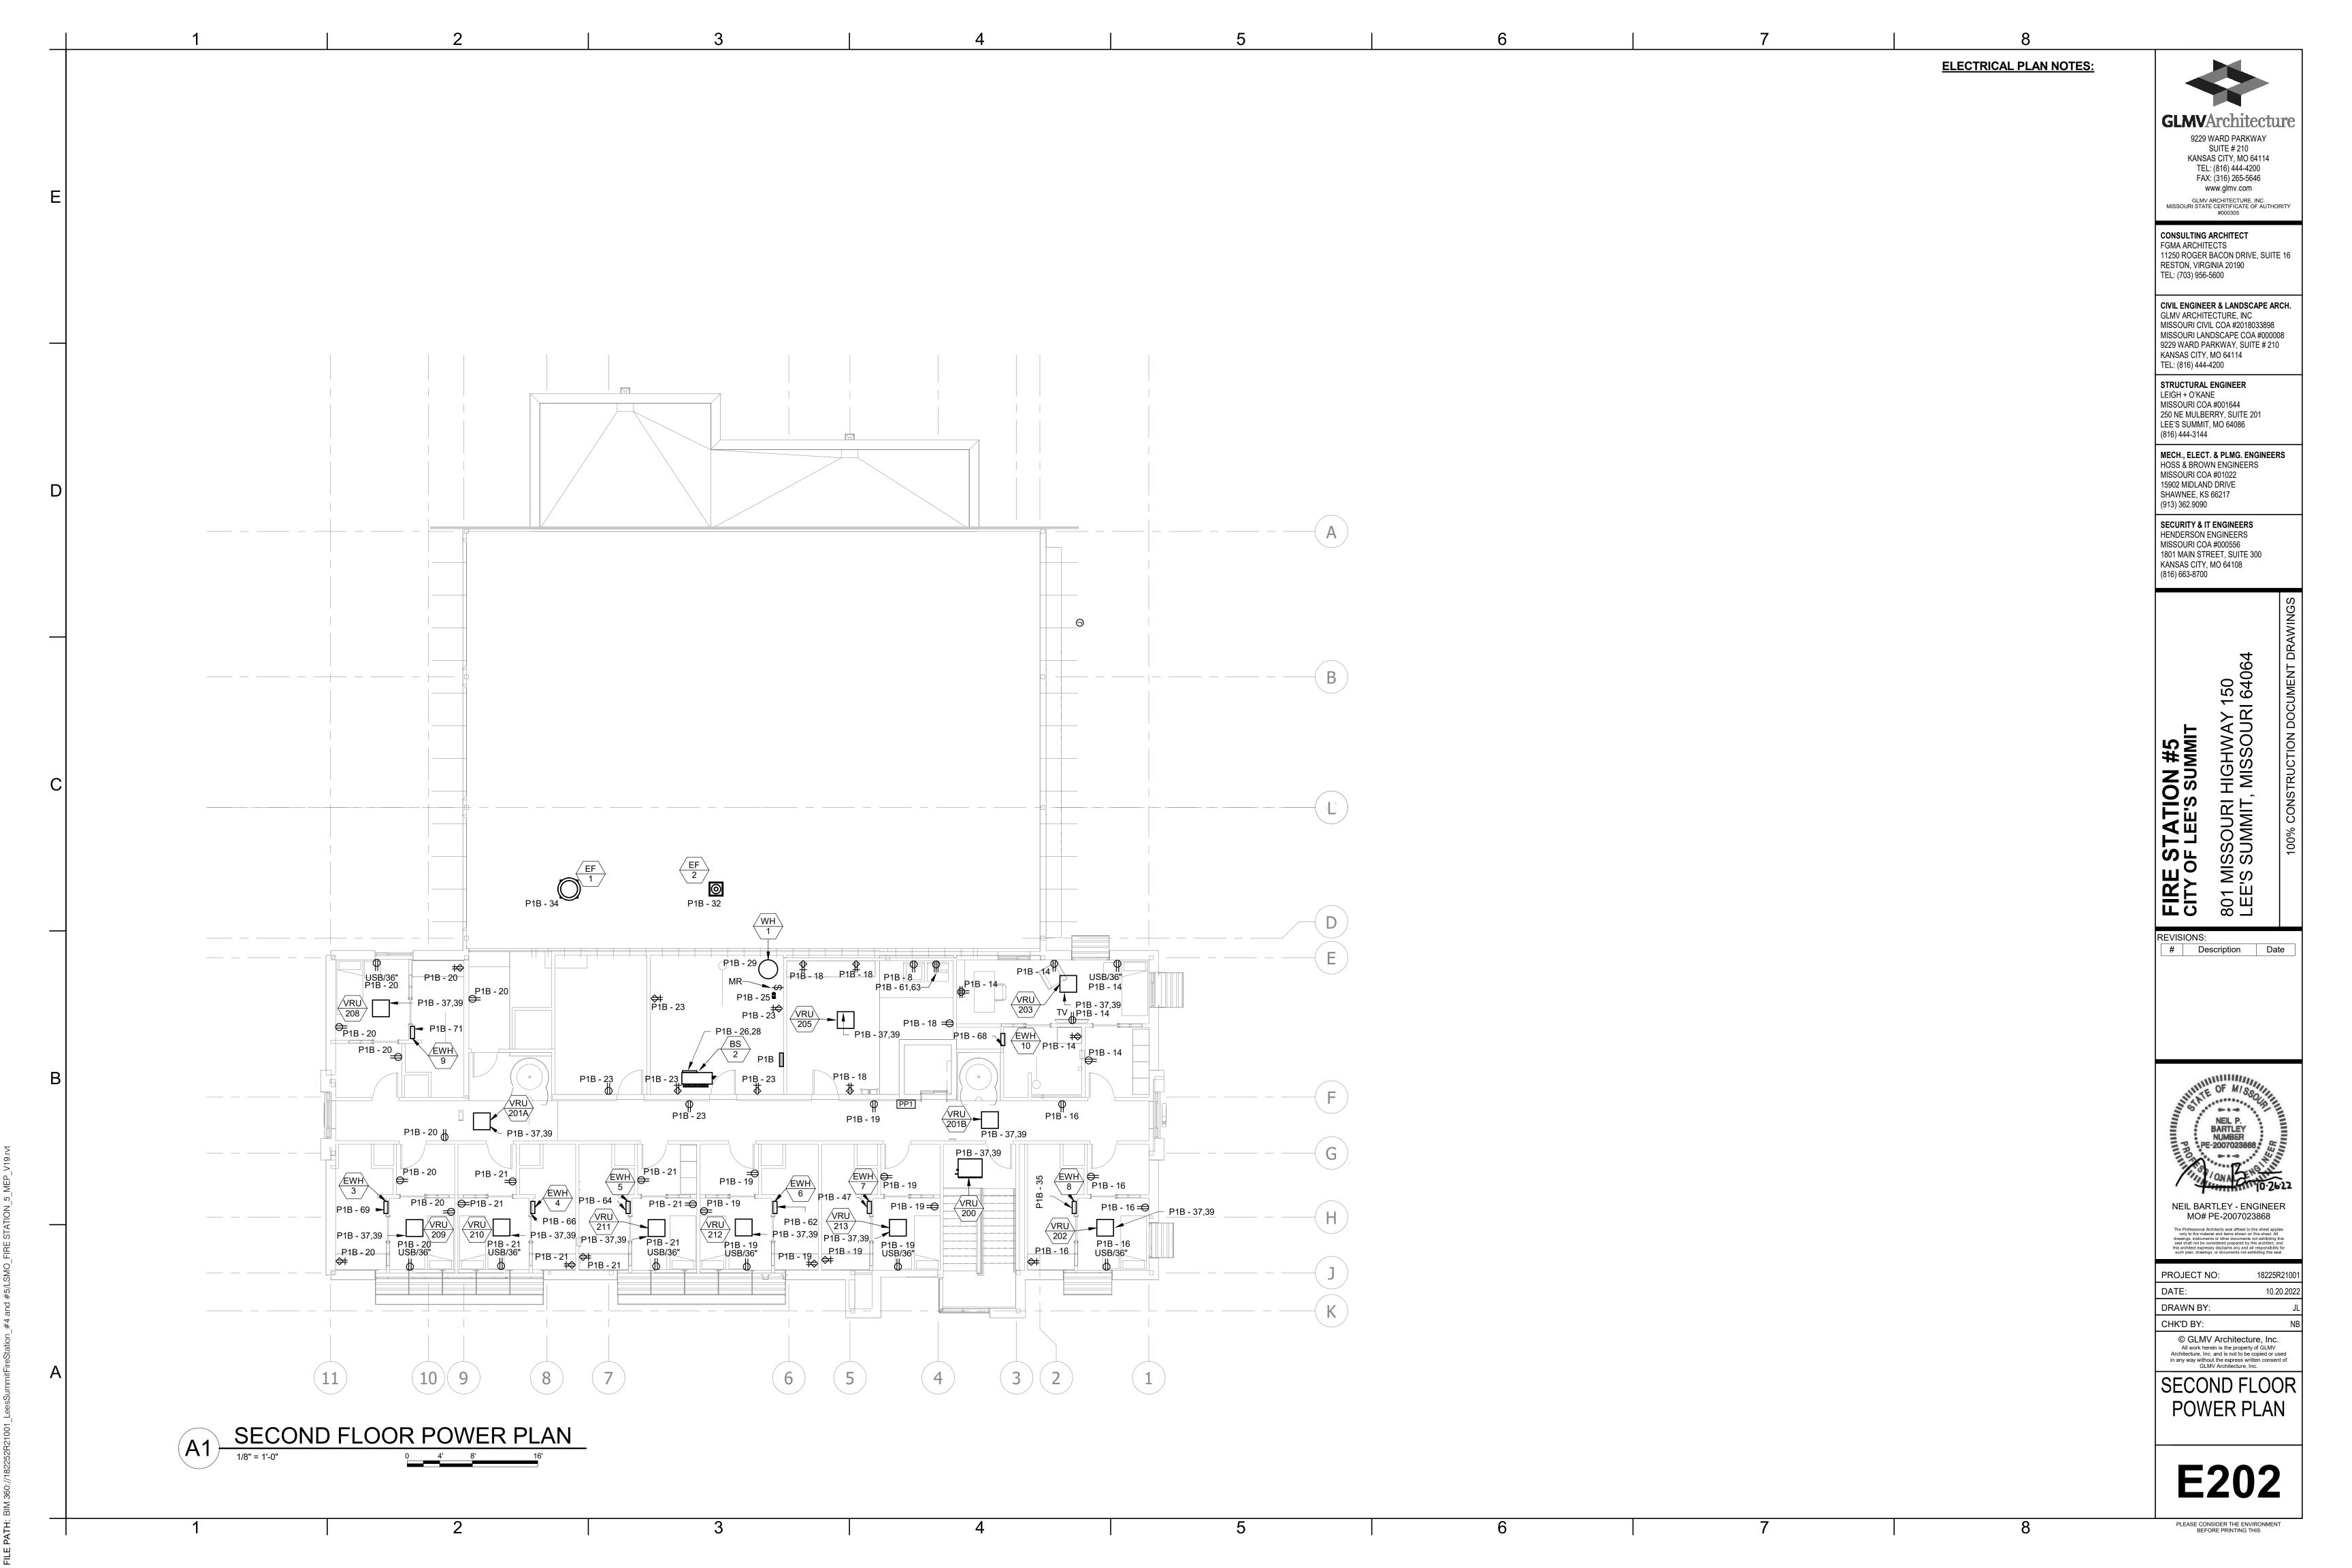


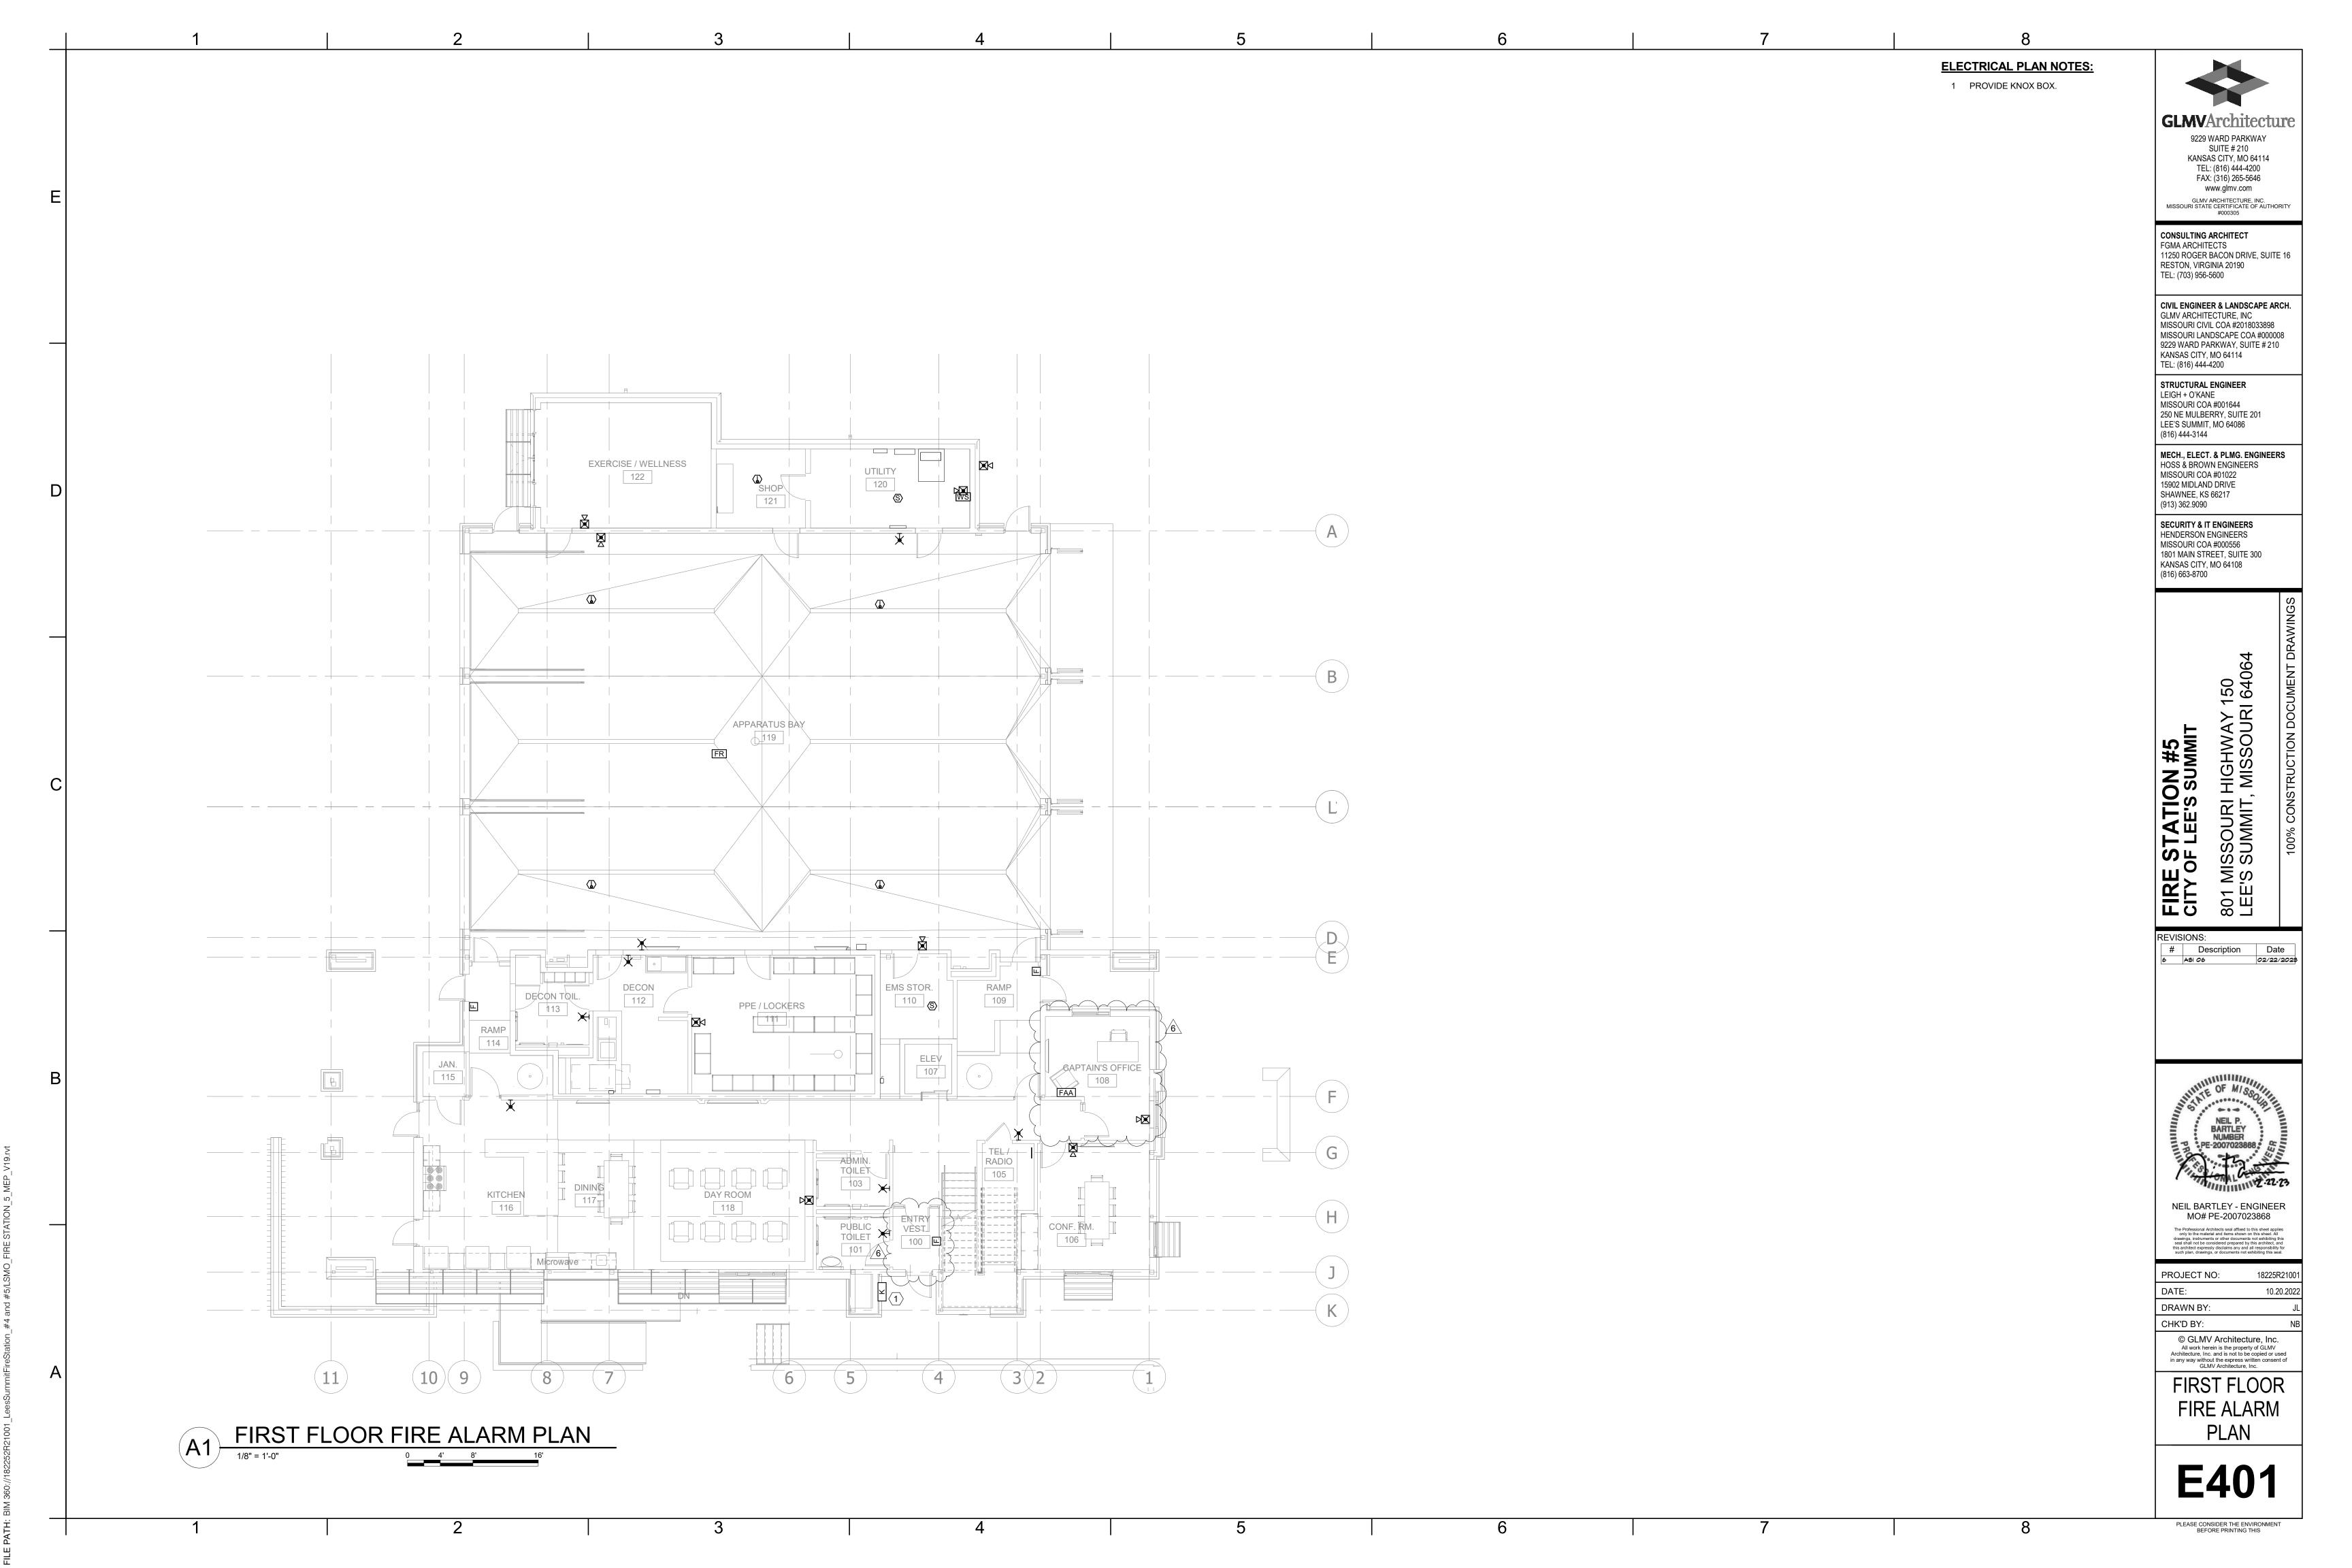

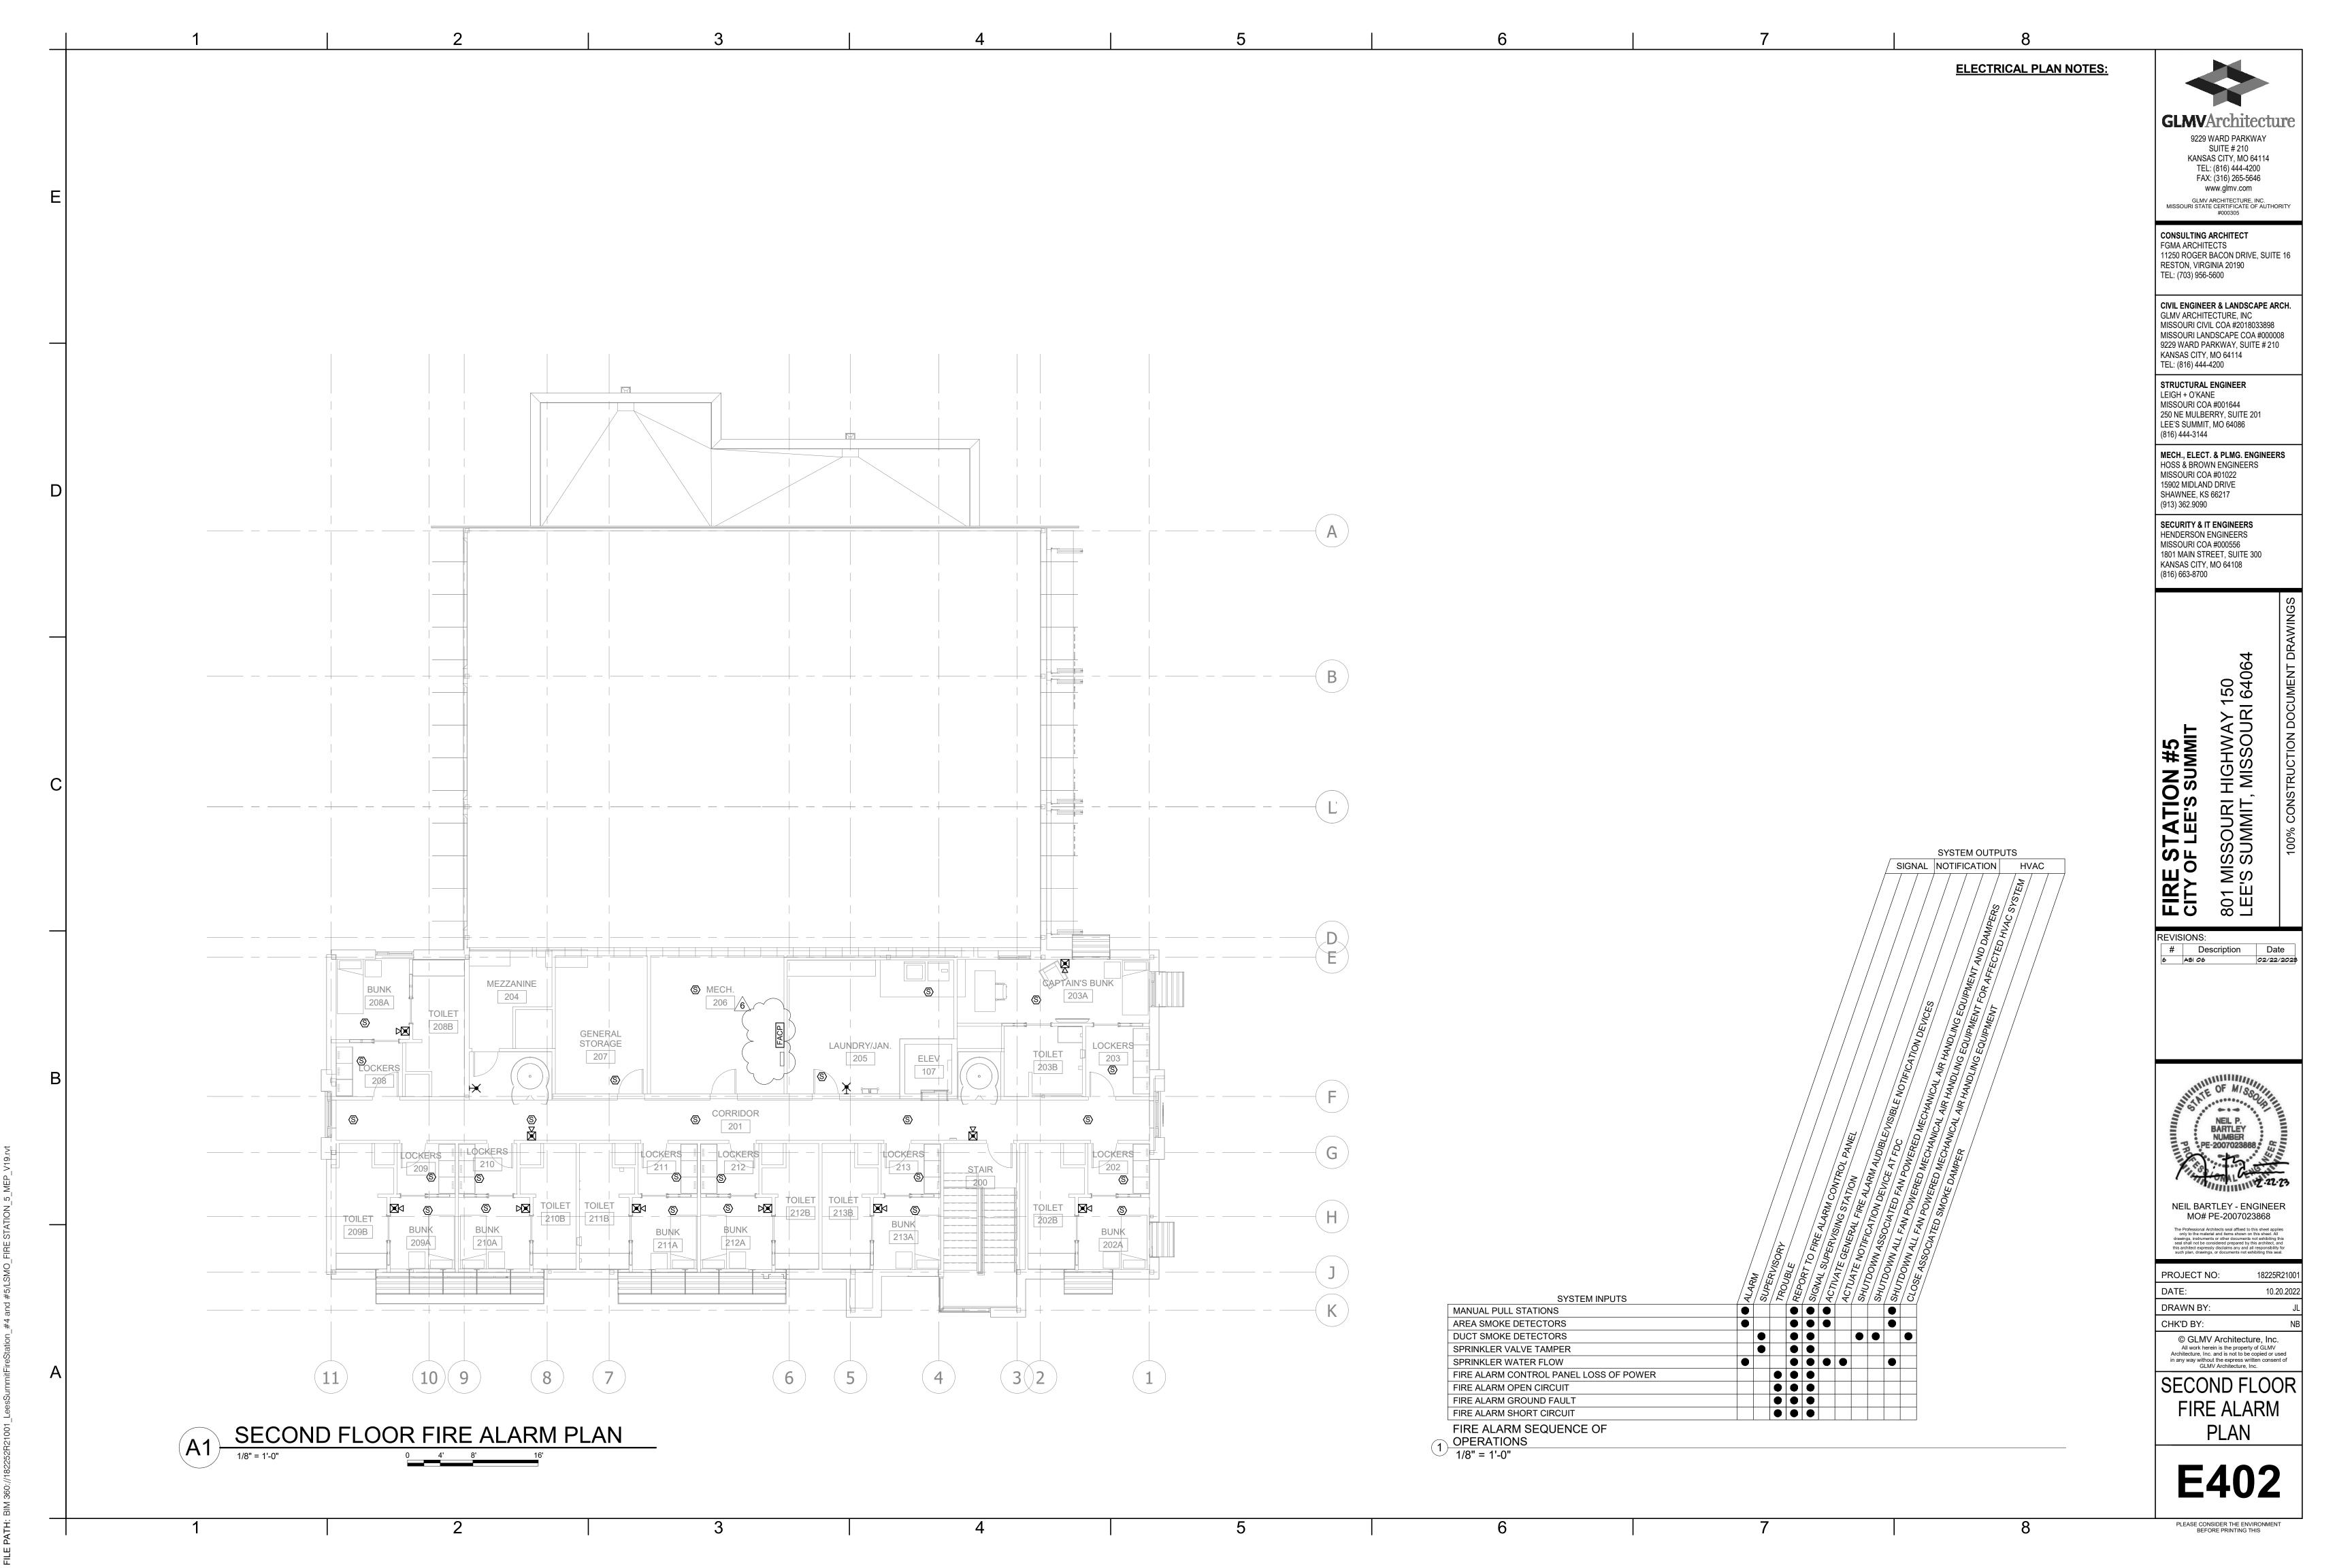

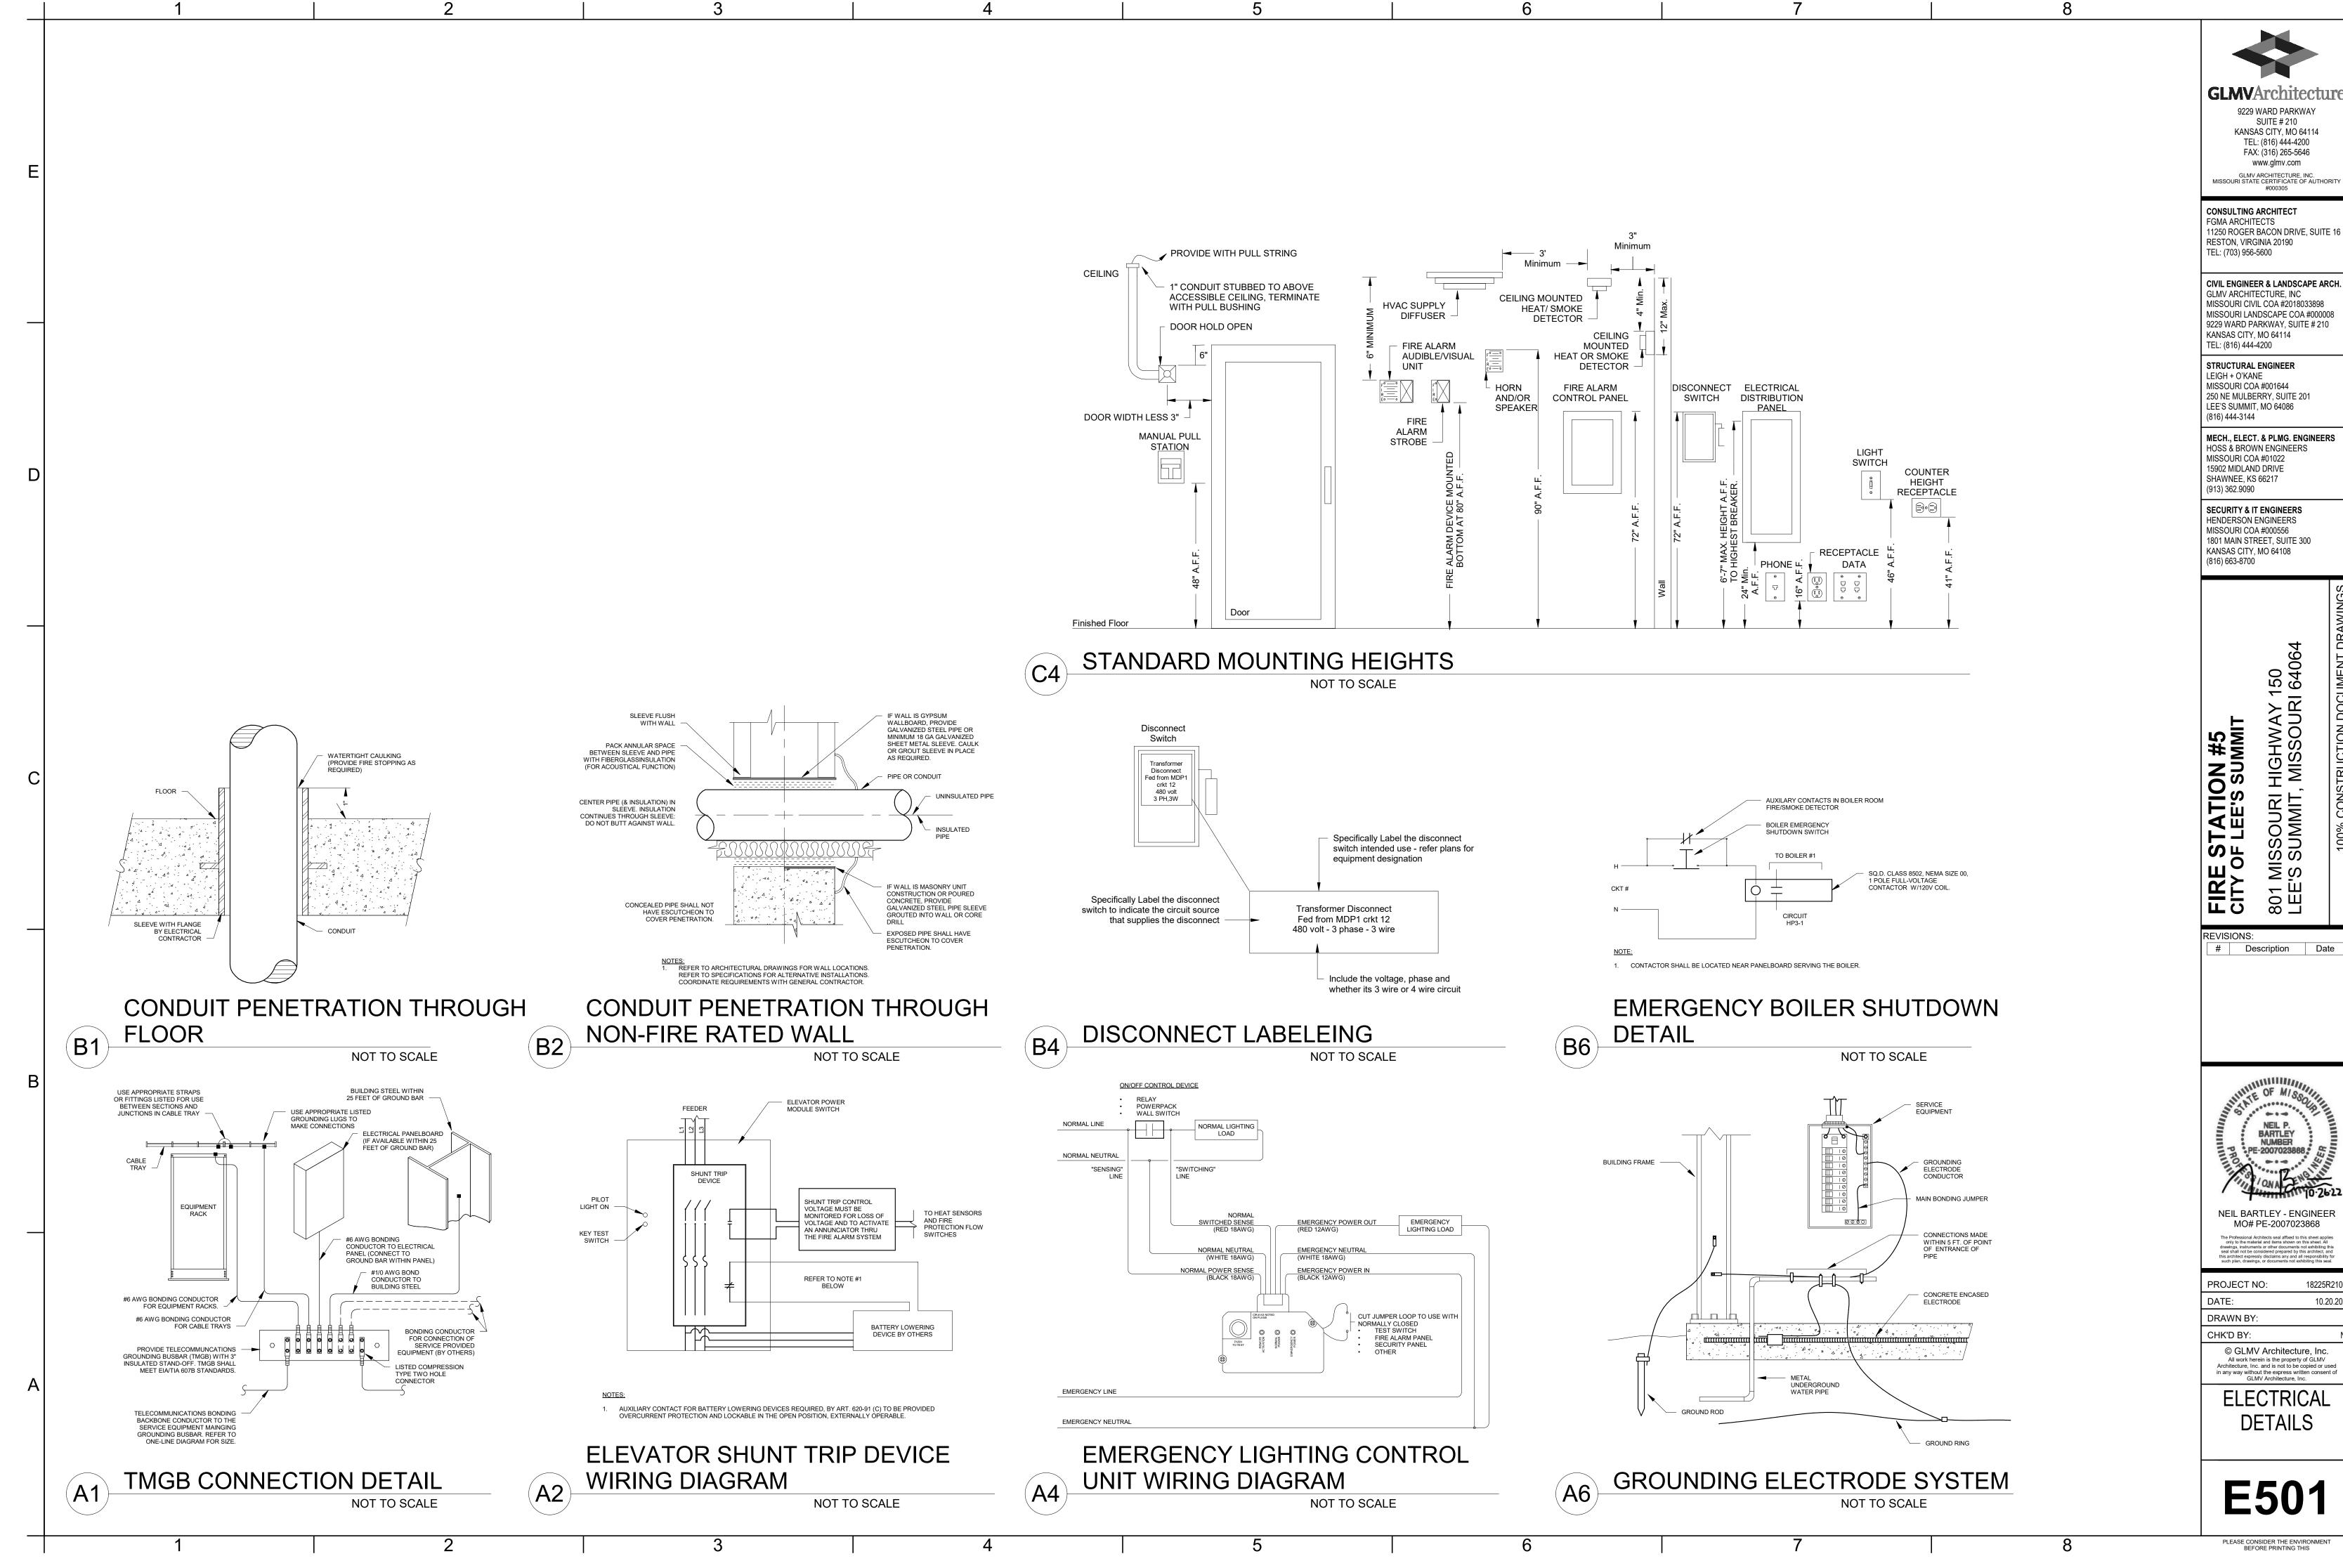

18225R21001 10.20.2022

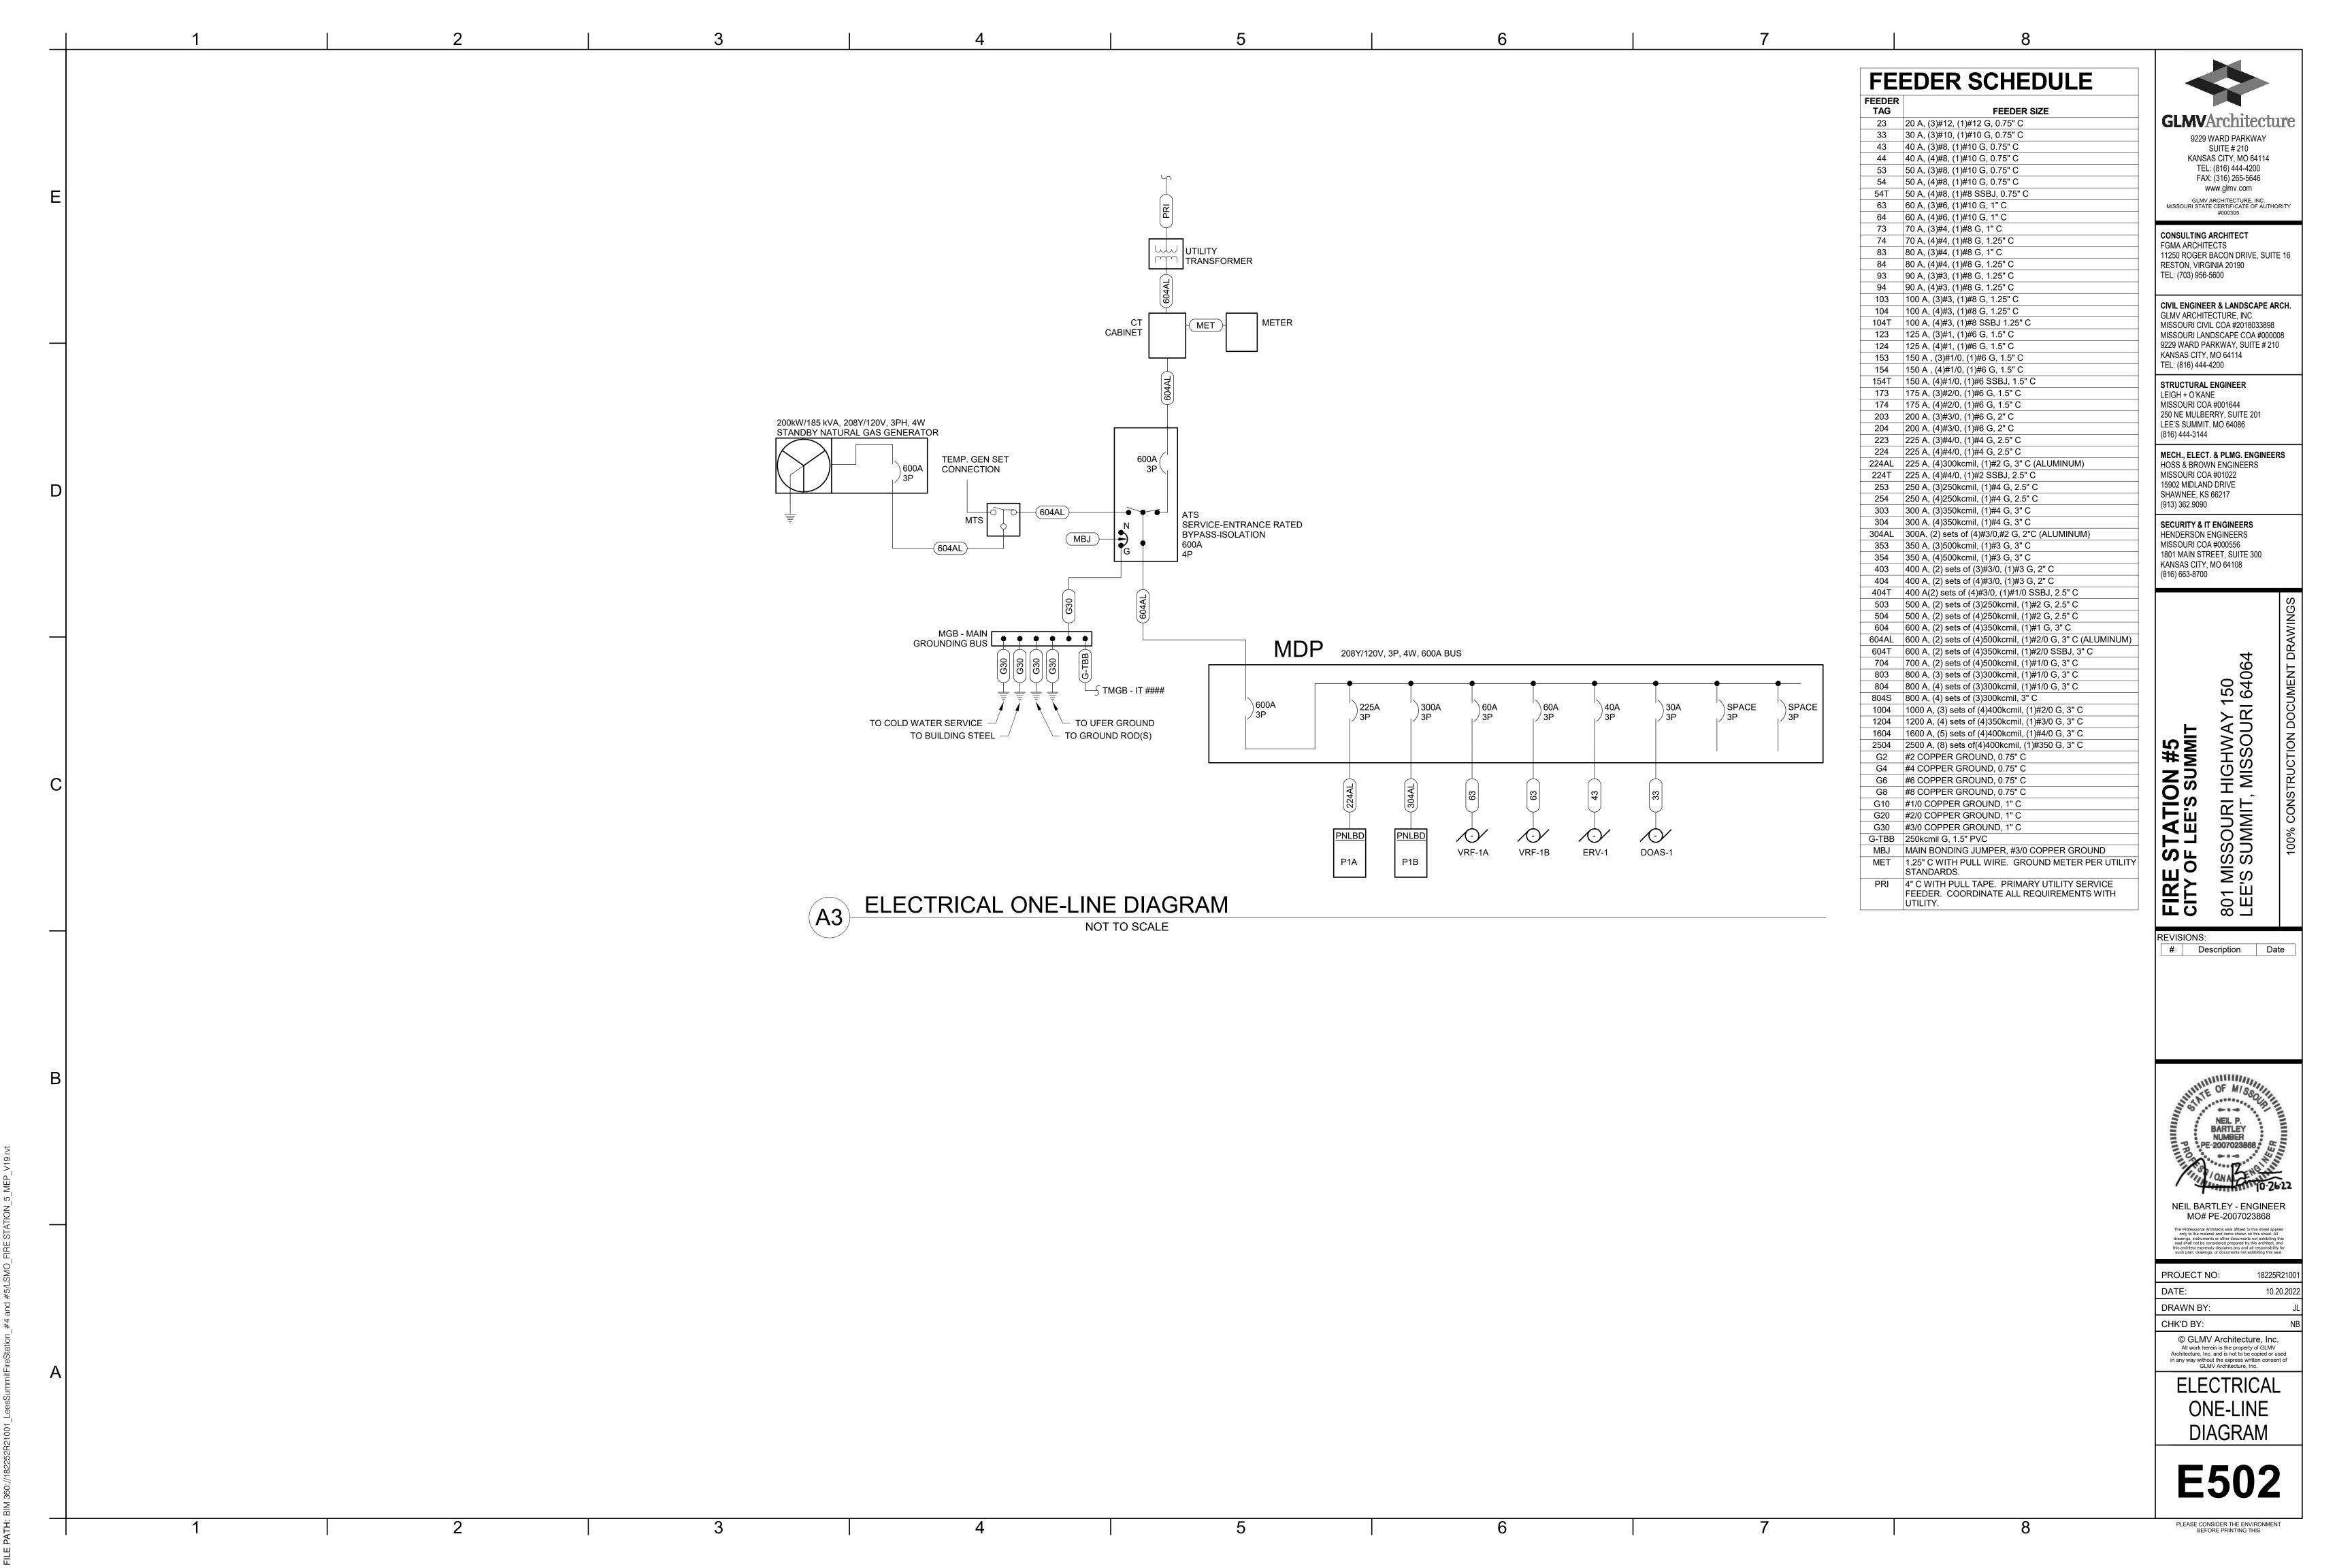

+	1   2	3		4			5			6				7			8
		PANELBOARD SCHE	EDULE LEGEND	LIG	HT FIXT	URE SCH	EDULE										
		OL REFER TO ONE-LII AF ARC FAULT CIRCU GF GROUND FAULT C GFEP GROUND FAULT E FA PROVIDE RED HAN	INE DIAGRAM UIT BREAKER	FIXTURE TAG	MANUFACTURER HE WILLIAMS	R MODEL AT1-22-L40/830-D-E	EQUIVALENT MANUFACTURE	LED	LUMENS 3000	COLOR TEMP 3000 K	CRI TYP 80 0-10	YE TYPE  OV RECESSED		INPUT S VA 41 2X2 RECESSED			NOTES
•		SECURING BREAK	CKABLE-OFF DEVICE CAPABLE OF KER HANDLE IN THE OFF POSITION. TRIP DEVICE FOR BREAKER	B BB BE	HE WILLIAMS HE WILLIAMS HE WILLIAMS HE WILLIAMS	AT1-22-L40/830-D-EM/10  LRX4F-2-L8/830-DMA  LRX4F-4-L8/830-DMA  LRX4F-2-L8/830-EM/10W-	-DIM-UNV -DIM-UNV	LED LED LED	3000 1600 3200 1600	3000 K 3000 K 3000 K 3000 K	80 0-10 80 0-10 80 0-10 80 0-10	V RECESSED V RECESSED	120 37 120 13 120 27 120 13	BATTERY  15 2' RECESSED S  30 4' RECESSED S  15 2' RECESSED S			1 1
				C D DB DBE	HE WILLIAMS HE WILLIAMS HE WILLIAMS HE WILLIAMS	6CR-TL-L10/830-DIM 4DR-TL-L10/830-DIM-L 6DR-TL-L10/830-ATH-DIM 6DR-TL-L10/830-EM/10W-OW-OF	NV-OW-OF I-UNV-OW-OF	LED LED LED	1000 1000 1000 1000	3000 K 3000 K 3000 K 3000 K	80 0-10 80 0-10 80 0-10 80 0-10	RECESSED RECESSED	120 9 120 9 120 9 120 9	10 6" RECESSED D		RATED WITH INTE	1,6,7 1 1,2 ERGRAL 1,2,4
				DE DS	HE WILLIAMS  HE WILLIAMS	4DR-TL-L10/830-EM/10W- OF 4DR-TL-L10/830-DIM-UNV D	-SW-OF-WH-A	LED	1000	3000 K	80 0-10 80 0-10	V RECESSED	120 9 120 9	10 4" RECESSED DE BATTERY 10 4" RECESSED DE	OOWNLIGHT WITH INTER	RATED	
				6 F2 G	BEGA HYDREL ACCLAIM LIGHTING ARTEMIDE	M9410C-A-LED-P1-40K-M LCSR-12B-LSF-LD	VOLT-WWD-FY	LED LED	3211 1262 232	3000 K 3000 K 3000 K	95 0-10		120 34 120 11 120 3	12 CAST-IN PLACE  3 LED TAPELIGHT FOOT. WATTAGE	EIN-GRADE FLAGPOLE I EIN-GRADE L'IQUID TIGH FWITH 45 DEG CHANNE SE PER LINEAR FOOT FLEXABLE DESK LIGHT	HT WALL WASH FI	
				6 J	HE WILLIAMS			LED LED	72 131 3800	3000 K	80 80 0-10 80 0-10	THUOM /	120 4	4 WALL MOUNTE			1,10
				LA LAE	FOCAL POINT FOCAL POINT HE WILLIAMS	FSM4LS-BW-625F-30K-10 4 FSM4LS-BW-625F-30K-10 4-1EM 75L-4-L38/830-EM/10W-D	C-UNV-LD1-C2	LED LED	2500 2500 3800	3000 K	80 0-10 80 0-10 80 0-10	D SUSPENDE D			LINEAR LINEAR WITH INTERGR PENDED STRIP FIXTUR		
				M S1 V	TASK LIGHTING  LITHONIA  HUBBELL	NV	M MVOLT	LED  LED  LED	200 13165 900	3000 K 3000 K 3000 K	80 0-10 80	D D POLE	120 2 120 125 120 6	2 UNDERCABINE PER FOOT. POLE MOUNTE	ATTERY T LINEAR FIXTURE. LUM D SITE LIGHITNG FIXTU	MENS PER FOOT,	
				WL	MICROLINEA ACUITY	ML3WLASY-D-CO(628LPI -FLA-F01M-EF-UNV WDGE3 LED P2 30K 80CF	F)-K40-80-12-R /-DIM10	LED		3000 K	80	MOUNT RECESSED WALL MOUNT	120 356	395 EXTERIOR LINE	AR WALL-WASH FIXTU OUTPUT PER 4 FT	JRE. 4 FT SECTION	S, 7.5 2 2
				WS WXE X NOTES:	ACUITY H.E. WILLIAMS	24 582  WDGE2 P130K 80CRI VF  EXIT-R-EM-WHT		LED LED	1581	3000 K 3000 K		WALL MOUNT WALL MOUNT UNIVERSAL		18 EXTERIOR WAL	L SQUARE DOWN LIGH		2 2,4 3,5
•				2. PRO 3. PRO 4. PRO 5. PRO 6. MOU 7. REFE 8. PRO 9. MOU 10. MOU 11. MOU 11. MOU 6. CON B. PRO C. REFE	VIDE FIXTURE WITH VIDE FIXTURE WITH VIDE FIXTURE WITH VIDE NUMBER OF FINT FIXTURE 6'-4" A SER TO ARCHITECTURE 8'-0" A SINT FIXTURE 8'-0" A SINT FIXTURE CENTIFICATION OF SHALL VIDE ALL REQUIRE FRENCE PLANS FO	BOVE FINISHED GRADE. JRAL DRAWINGS FOR EXA RUN LENGTHS AS SHOWI ECTURAL SOFFIT WHERE BOVE PINISHED GRADE. ERED ON THE WALL 3'-0" F  ERIFY CEILING TYPE PRIOD ACCESSORIES FOR A COR	ENCY DRIVER. ARROWS TO MATCH WHAT IS S CT LOCATION. N ON PLANS. SHOWN-REFER TO ARCHITETURE ROM THE FACE. R TO ORDERING ALL FIXTURES DMPLETE INSTALLATION.	JARAL PLAN		DETAILS.							
							IGHTING DE	VICE	SCH	EDUI	LE			271222			
						Т	MANUFACTURER  W6 WATTSTOPPER	MODEL			<b>DESCRIPTION</b> F WALL SWITC		DIMMING (	SENSOR ON MODE   SENSOR TYPE		MOUNTING TYPE	VOLTAGE NOTES
						AUX F	C1 WATTSTOPPER C2 WATTSTOPPER LING-MOUNTED OCCUPANCY S	LMRC-10 LMRC-11	X 2 ZONE C	EILING PLEN	UM ROOM CON	,	 0-10V		0 A 10 A	PLENUM	120 120
						V	C1 WATTSTOPPER  C1 WATTSTOPPER  CUPANCY SENSOR SWITCH	DT-300	OCCUPA	NCY MODE TAGE CEILIN		OUAL TECH SENSOR				CEILING	24 24
						S	W1 WATTSTOPPER W2 WATTSTOPPER W4 WATTSTOPPER		SENSOR LINE VOL SENSOR LINE VOL	IN OCCUPAN TAGE SWITC IN VACANCY TAGE SWITC	CY MODE H WITH INTERO MODE H WITH INTERO	GRAL DUAL TECH GRAL DUAL TECH GRAL DUAL TECH			0 A 0 A	WALL	120 120 120
						S	LL SWITCHES W5 WATTSTOPPER ENERAL CONTROL NOTES:	LMSW-10	05 LOW VOL		SWITCH WITH I	IMMING CAPABILIT	0-10V			WALL	24
						A. B.	AUTO ON (OCCUPANCY MODE DETECTION, IT THEN REVERT MANUAL ON (VACANCY MODE DELAY.	ΓŚ ΤΟ AUTO :	ON MODE.					·			
						A. B. C. D. E.	PROVIDE ALL REQUIRED WIRI DUAL TECHNOLOGY SENSOR RETRIGGER WHEN OPTION IS PROVIDE TWO DIGITAL WIREL COORDINATE FINISHES WITH ALL SENSORS IN CORRIDORS	RS OCCUPAN S AVAILABLE LESS CONFI I ARCHITECT	ICY LOGIC SHA SURATION TO SOWNER PRICE	ALL BE SELE OOLS, WATTS OR TO ORDEF	CTED FOR DET TOPPER MODE RING ALL CONT	TECTION BY EITHE EL LMCT-100. TROL DEVICES.				ND MAINTAINED C	CCUPANCY AND
						1.	THIS SWITCH SHALL BE PROG PADDLE: ALL ON/OFF 50% BUTTON 1: ALL 100% BUTTON 2: ALL 75% BUTTON 3: ALL 50% BUTTON 4: ALL 25% THIS SWITCH SHALL BE PROG	6 BY DEFUAL	.T. ALL DIM UP	P/DOWN.							
						3.	<ul> <li>PADDLE: ALL ON/OFF 50%</li> <li>BUTTON 1: ALL DIM UP</li> <li>BUTTON 2: ALL DIM DOWN</li> <li>THIS SWITCH SHALL BE PROG</li> <li>BUTTON 1: ALL ON</li> <li>BUTTON 2: ALL OFF</li> </ul>	% BY DEFAUL N	.Т								

BUTTON 1: ALL ON
 BUTTON 2: ALL OFF
 THIS SWITCH SHALL BE PROGRAMED WITH THE FOLLOWING SCENES. COORDINATE FINALE SCHENE WITH OWNER PRIOR TO COMMISSIONING:
 BUTTON 1: ALL ON/OFF

GLMVArchitecture

9229 WARD PARKWAY SUITE # 210 KANSAS CITY, MO 64114 TEL: (816) 444-4200 FAX: (316) 265-5646 www.glmv.com

GLMV ARCHITECTURE, INC.
MISSOURI STATE CERTIFICATE OF AUTHORITY
#000305

CONSULTING ARCHITECT
FGMA ARCHITECTS
11250 ROGER BACON DRIVE, SUITE 16
RESTON, VIRGINIA 20190
TEL: (703) 956-5600

CIVIL ENGINEER & LANDSCAPE ARCH.
GLMV ARCHITECTURE, INC
MISSOURI CIVIL COA #2018033898
MISSOURI LANDSCAPE COA #000008
9229 WARD PARKWAY, SUITE # 210
KANSAS CITY, MO 64114
TEL: (816) 444-4200

STRUCTURAL ENGINEER
LEIGH + O'KANE
MISSOURI COA #001644
250 NE MULBERRY, SUITE 201
LEE'S SUMMIT, MO 64086
(816) 444-3144

MECH., ELECT. & PLMG. ENGINEERS
HOSS & BROWN ENGINEERS
MISSOURI COA #01022
15902 MIDLAND DRIVE
SHAWNEE, KS 66217
(913) 362.9090

SECURITY & IT ENGINEERS
HENDERSON ENGINEERS
MISSOURI COA #000556
1801 MAIN STREET, SUITE 300
KANSAS CITY, MO 64108
(816) 663-8700

150 I 64064

FIRE STATION #5
CITY OF LEE'S SUMMIT
801 MISSOURI HIGHWAY 150
LEE'S SUMMIT, MISSOURI 64064

REVISIONS:

# Description Date
5 ASI 01 11/16/2022
6 ASI 06 02/22/2023

NEIL P.
BARTLEY
NUMBER
PE-2007023868

NEIL BARTLEY - ENGINEER
MO# PE-2007023868

The Professional Architects seal affixed to this sheet applies
only to the material and items shown on this sheet. All
drawings, instruments or other documents not exhibiting this
seal shall not be considered prepared by this architect, and

PROJECT NO: 18225R21001

DATE: 10.20.2022

DRAWN BY: JL


CHK'D BY: NB

© GLMV Architecture, Inc.

© GLMV Architecture, Inc.
All work herein is the property of GLMV
Architecture, Inc. and is not to be copied or used in any way without the express written consent of GLMV Architecture, Inc.

ELECTRICAL SCHEDULES

E600

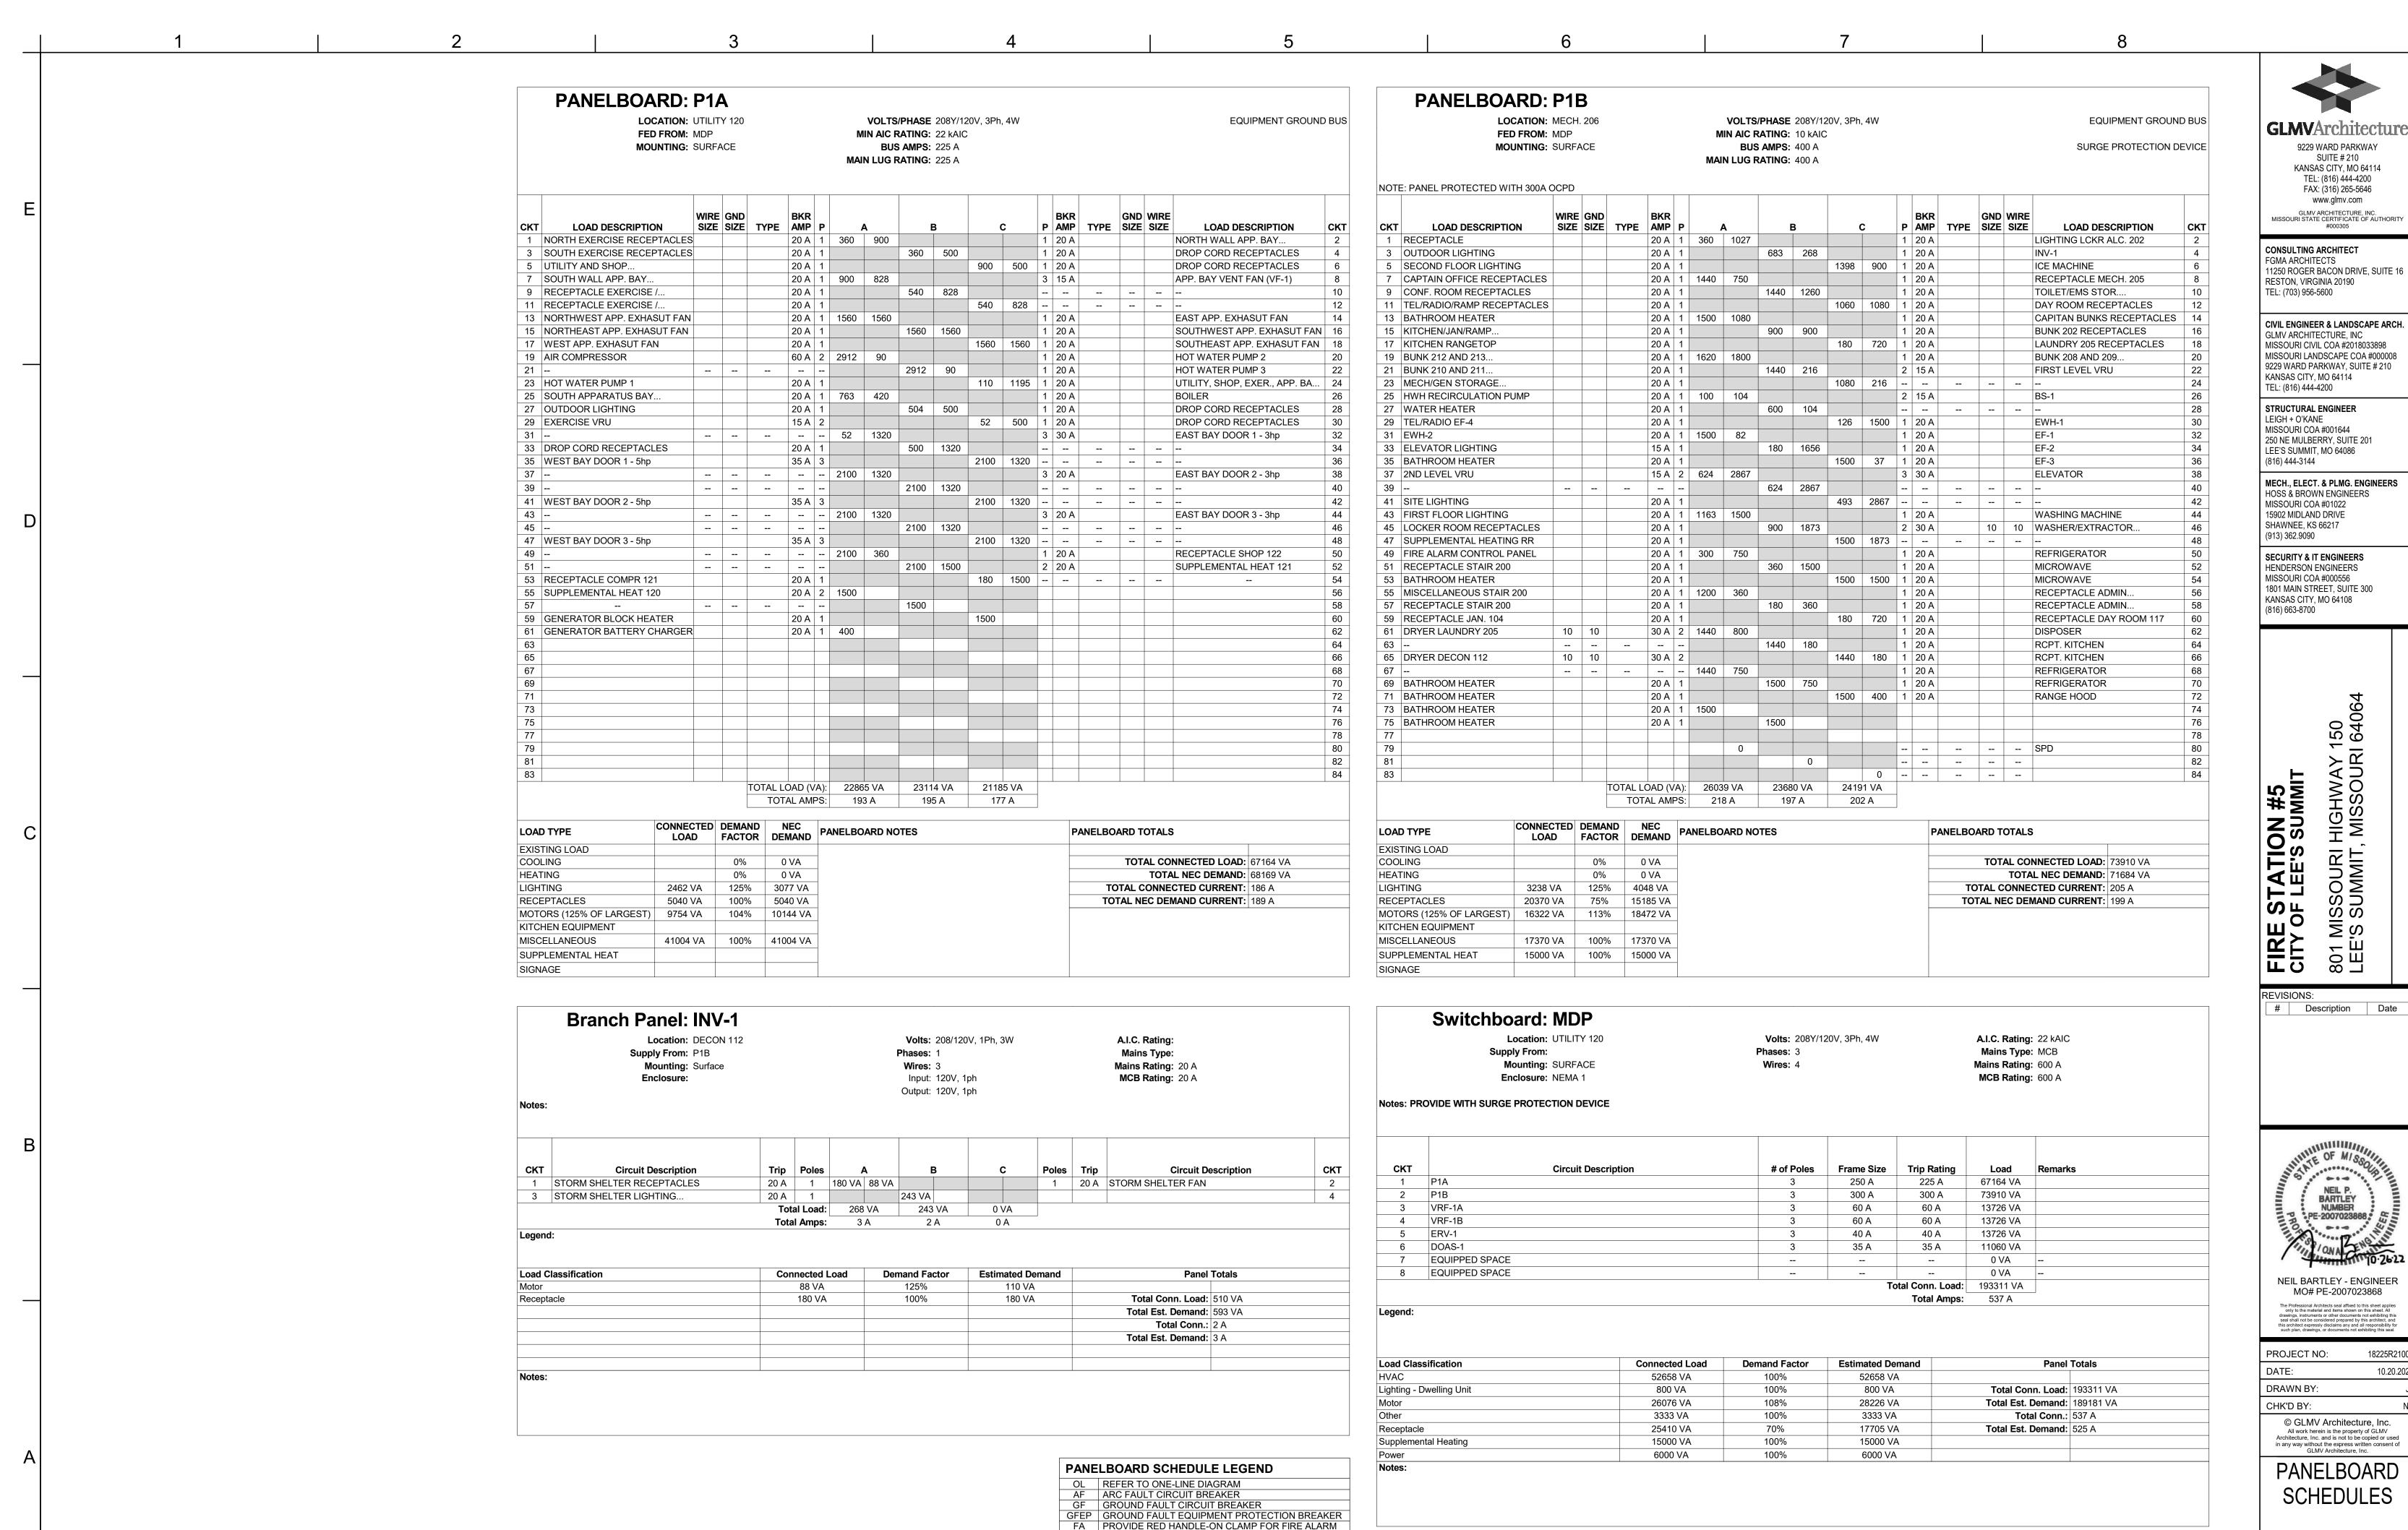

HLO PROVIDE PAD LOCKABLE-OFF DEVICE CAPABLE OF


ST PROVIDE SHUNT TRIP DEVICE FOR BREAKER

2

SECURING BREAKER HANDLE IN THE OFF POSITION.

18225R21001

10.20.2022

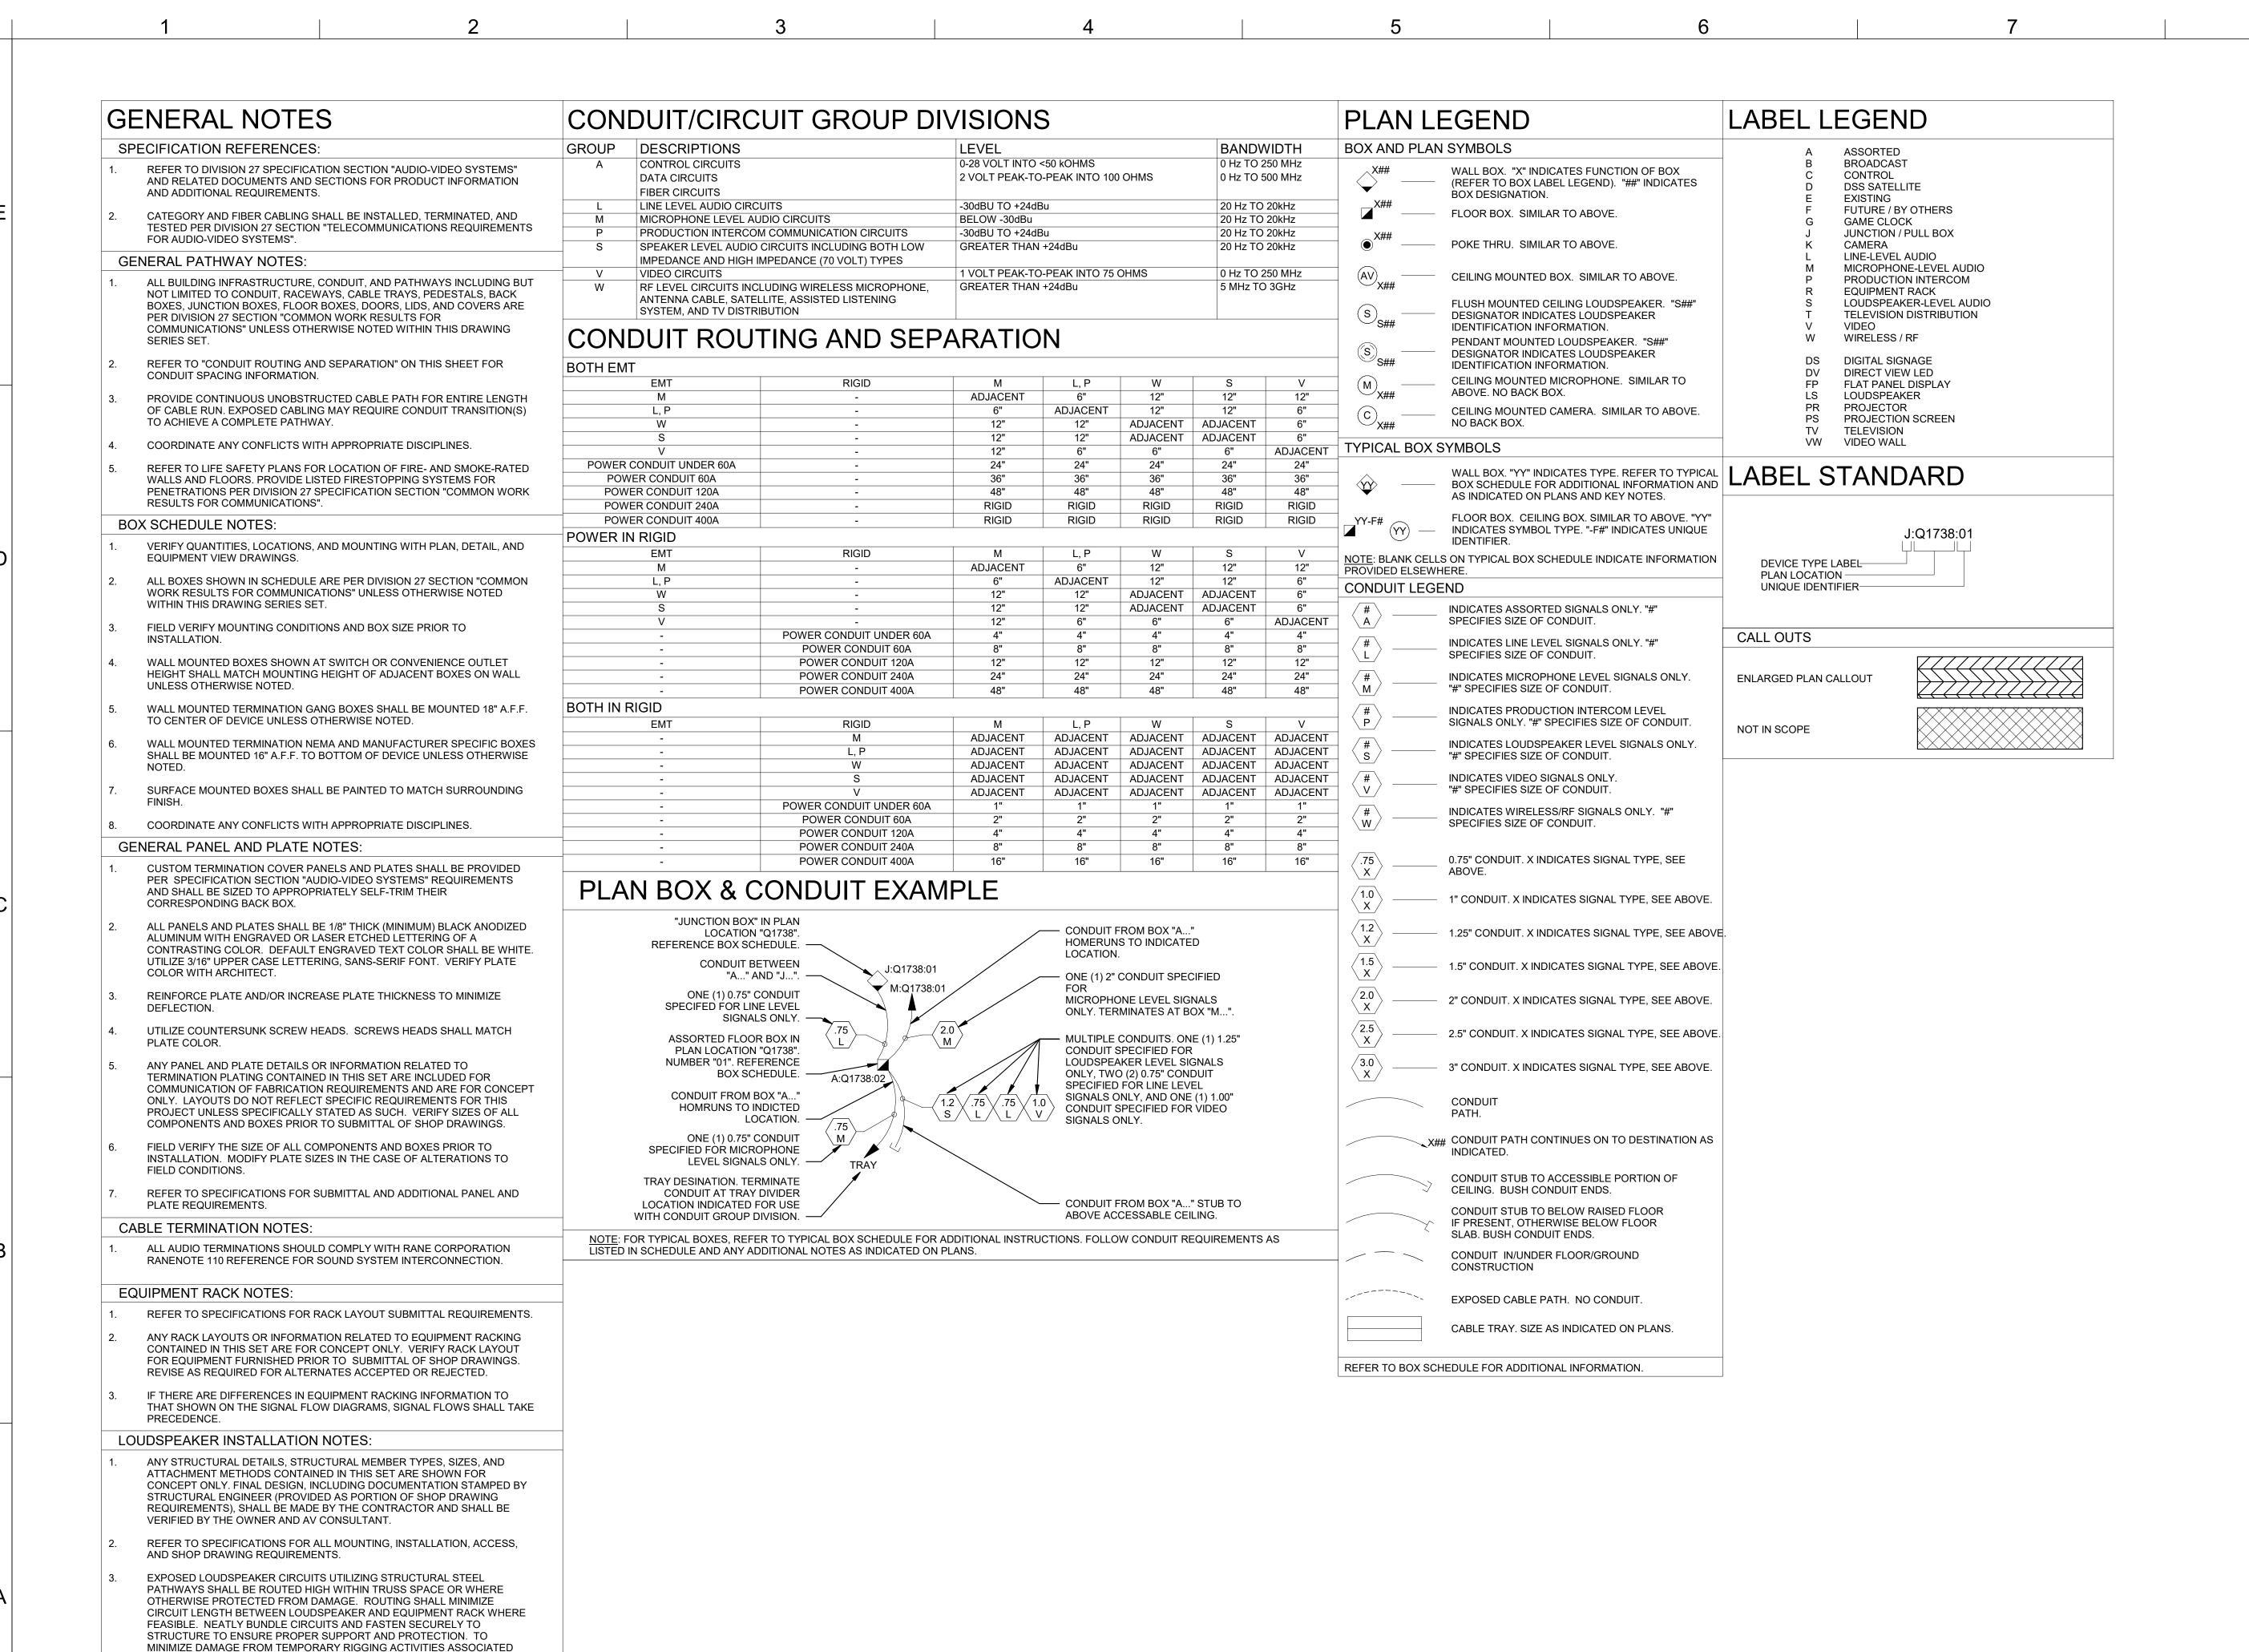

WITH SPECIAL EVENT SUPPORT, AVOID ROUTING CIRCUITS IN AREAS PRONE

CONFLICT WITH OTHER BUILDING ELEMENTS SUCH AS LIGHTING FIXTURES & BALLASTS, DUCTS, RIGGING, AND SHARP EDGES. CABLE COLOR SHALL

TO THIS USE, I.E. BOTTOM CHORDS OF TRUSSES. AVOID CONTACT OR

MATCH SURROUNDING ELEMENTS.

9229 WARD PARKWAY SUITE # 210 KANSAS CITY, MO 64114 TEL: (816) 444-4200

WWW.glmv.com

GLMV ARCHITECTURE, INC.
MISSOURI STATE CERTIFICATE OF AUTHORITY
#000305

FAX: (316) 265-5646

CONSULTING ARCHITECT
LEMAY ERICKSON WILLCOX
ARCHITECTS
11250 ROGER BACON DRIVE, SUITE 16
RESTON, VIRGINIA 20190
TEL: (703) 956-5600

CIVIL ENGINEER & LANDSCAPE ARCH.
GLMV ARCHITECTURE, INC
MISSOURI CIVIL COA #2018033898
MISSOURI LANDSCAPE COA #000008
9229 WARD PARKWAY, SUITE # 210
KANSAS CITY, MO 64114
TEL: (816) 444-4200

STRUCTURAL ENGINEER
LEIGH + O'KANE
MISSOURI COA #001644
250 NE MULBERRY, SUITE 201
LEE'S SUMMIT, MO 64086
(816) 444-3144

MECH., ELECT. & PLMG. ENGINEERS HOSS & BROWN ENGINEERS MISSOURI COA #01022 15902 MIDLAND DRIVE SHAWNEE, KS 66217 (913) 362.9090

SECURITY & IT ENGINEERS
HENDERSON ENGINEERS
MISSOURI COA #000556
1801 MAIN STREET, SUITE 300
KANSAS CITY, MO 64108
(816) 663-8700


STATION #5

DF LEE'S SUMMIT

JORTHEAST LAKEWOOD WA
SUMMIT, MISSOURI 64064

REVISIONS:
# Description Date

ОШ

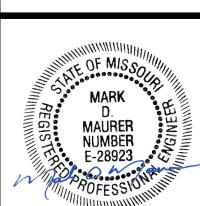

10/26/2022

PROJECT NO:	2150001291						
DATE:	10.26.2022						
DRAWN BY:	J.ROSE						
CHK'D BY:	M.MAURER						
© GLMV Architecture, Inc.  All work herein is the property of GLMV  Architecture, Inc. and is not to be copied or used in any way without the express written consent of							

AUDIO-VIDEO

GENERAL NOTE:

HENDERSON

8345 LENEXA DRIVE, SUITE 300 LENEXA, KS 66214


TEL 913.742.5000 FAX 913.742.5001

WWW.HENDERSONENGINEERS.COM

MO. CORPORATE NO: E-556D EXPIRES 12/31/2022

ENGINEERS

**TA000** 

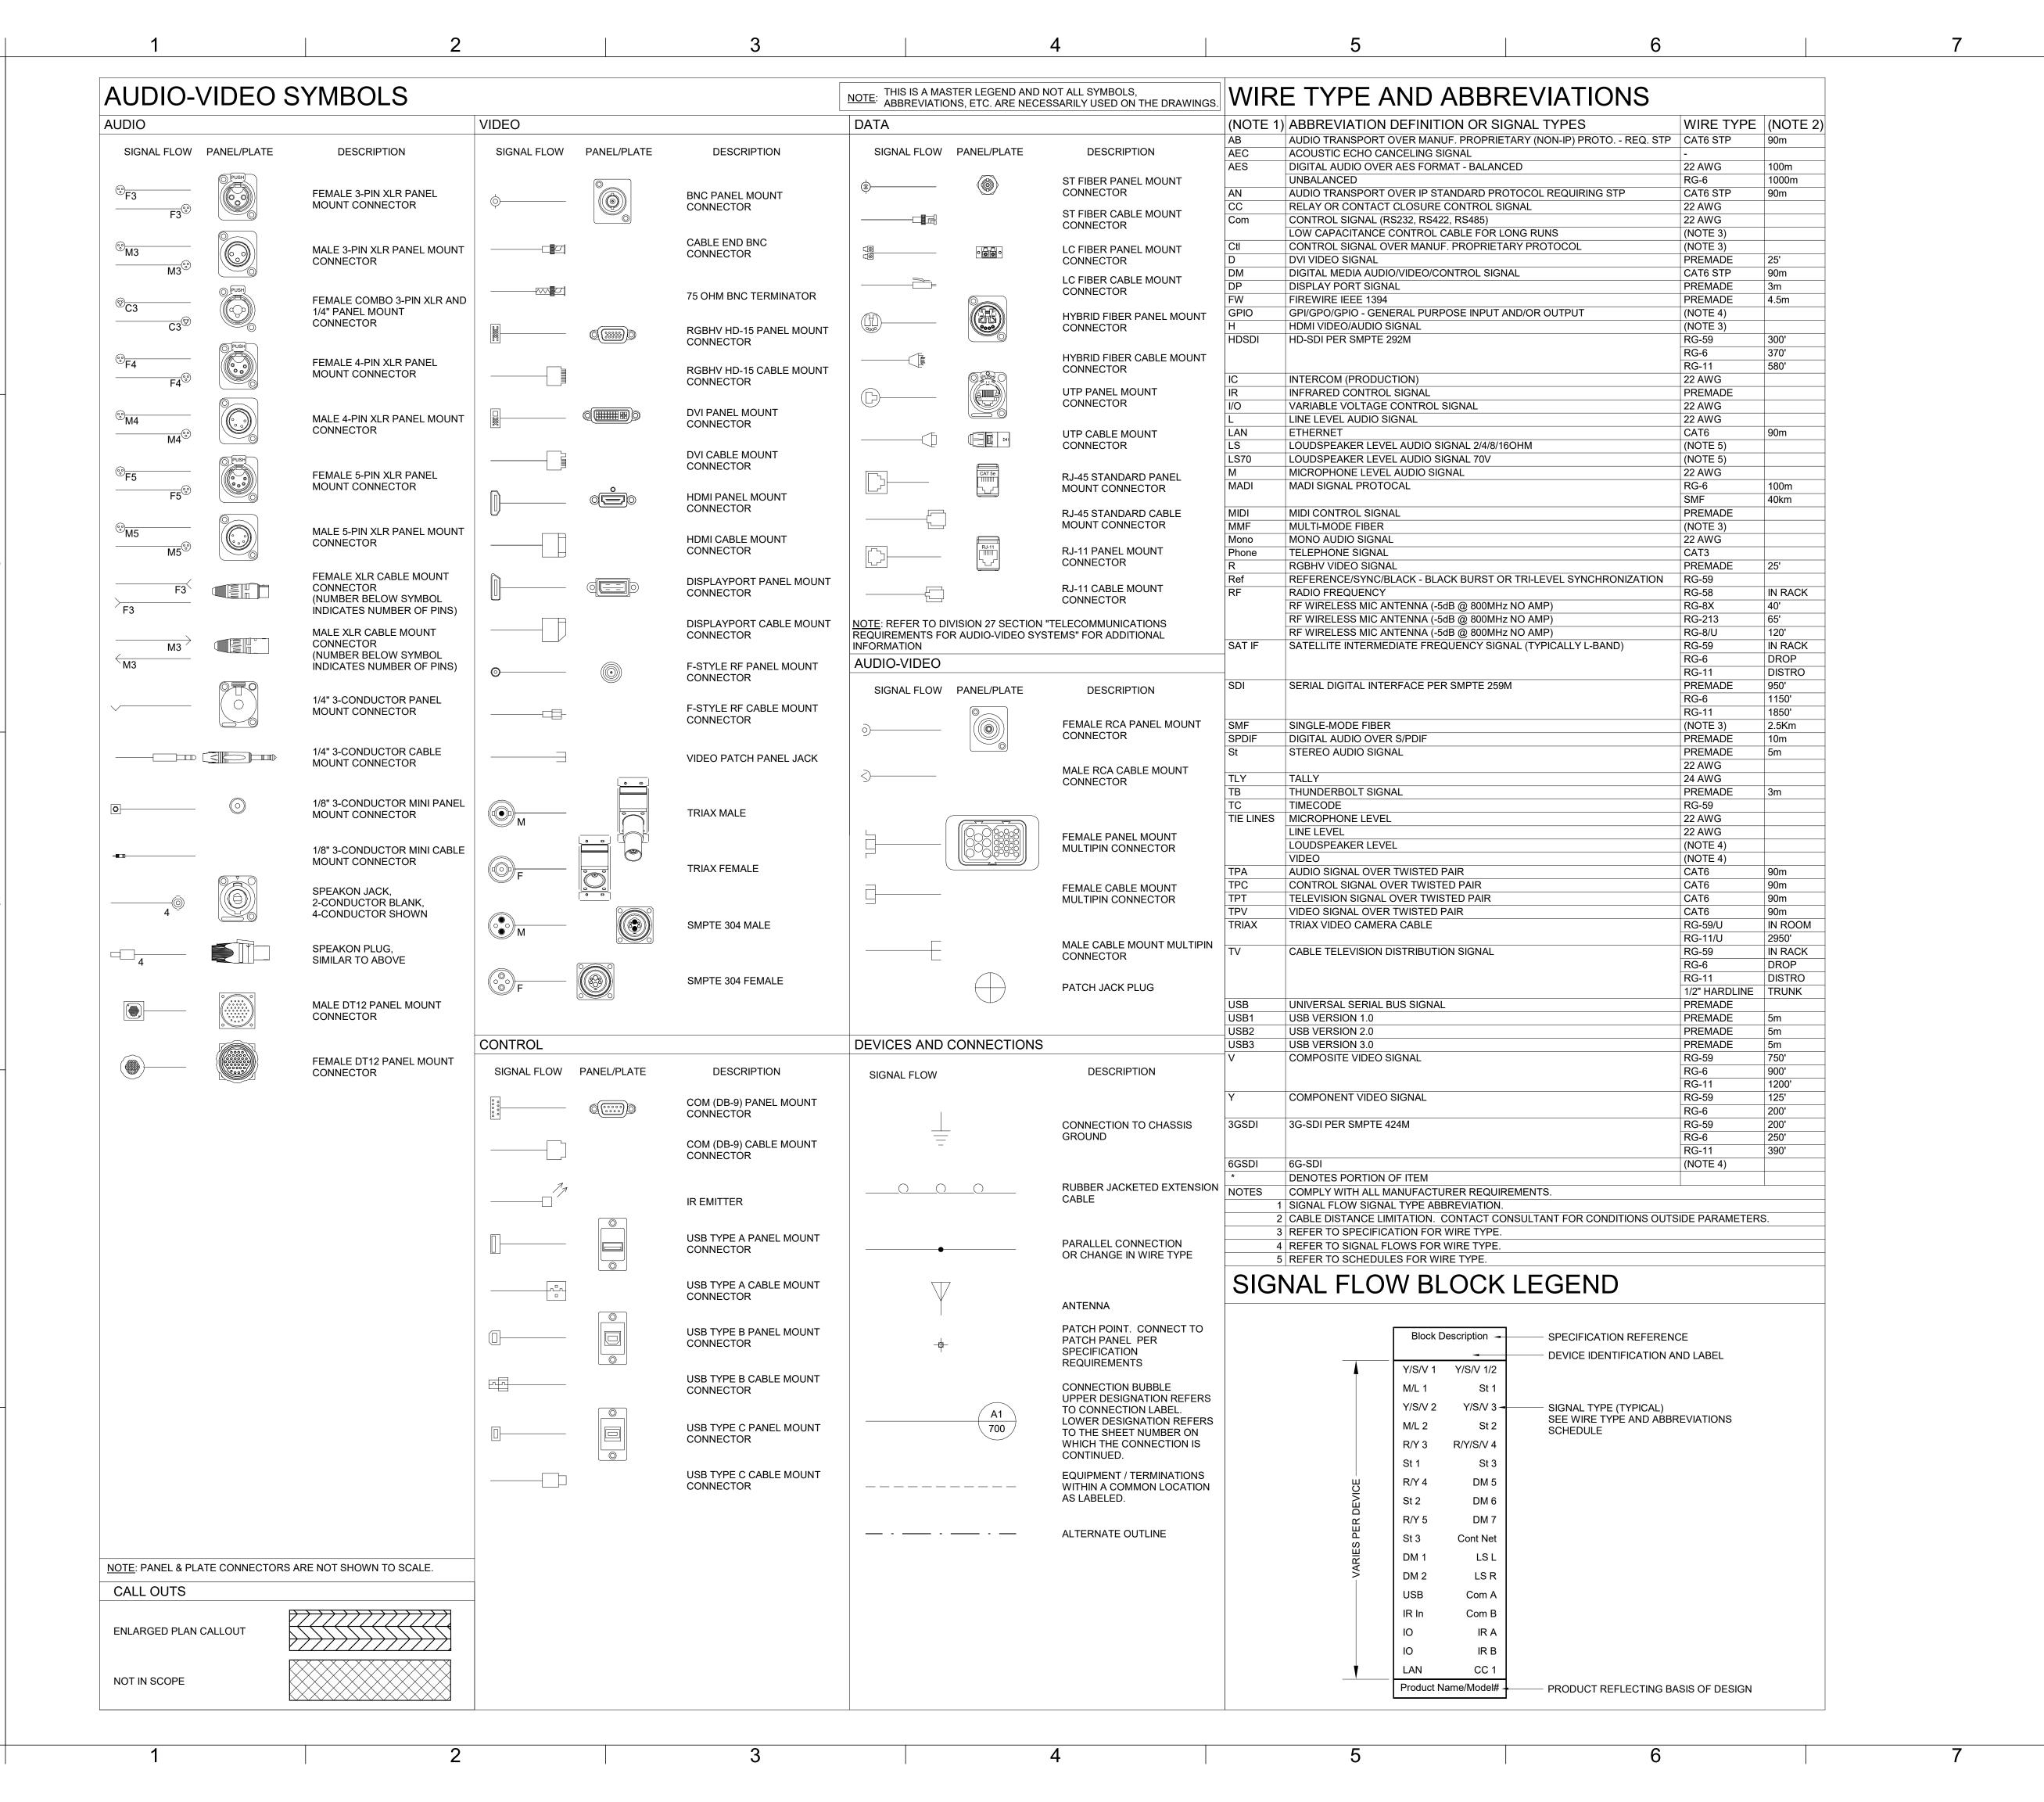



SUITE # 210

KANSAS CITY, MO 64114

TEL: (816) 444-4200

FAX: (316) 265-5646

www.glmv.com

GLMV ARCHITECTURE, INC.
MISSOURI STATE CERTIFICATE OF AUTHORITY
#000305

CONSULTING ARCHITECT
LEMAY ERICKSON WILLCOX
ARCHITECTS
11250 ROGER BACON DRIVE, SUITE 16
RESTON, VIRGINIA 20190
TEL: (703) 956-5600

CIVIL ENGINEER & LANDSCAPE ARCH.
GLMV ARCHITECTURE, INC
MISSOURI CIVIL COA #2018033898
MISSOURI LANDSCAPE COA #000008
9229 WARD PARKWAY, SUITE # 210
KANSAS CITY, MO 64114

STRUCTURAL ENGINEER
LEIGH + O'KANE
MISSOURI COA #001644
250 NE MULBERRY, SUITE 201
LEE'S SUMMIT, MO 64086
(816) 444-3144


TEL: (816) 444-4200

MECH., ELECT. & PLMG. ENGINEERS
HOSS & BROWN ENGINEERS
MISSOURI COA #01022
15902 MIDLAND DRIVE
SHAWNEE, KS 66217
(913) 362.9090

SECURITY & IT ENGINEERS
HENDERSON ENGINEERS
MISSOURI COA #000556
1801 MAIN STREET, SUITE 300
KANSAS CITY, MO 64108
(816) 663-8700

FIRE STATION #5
CITY OF LEE'S SUMMIT
5031 NORTHEAST LAKEWOOD WAY
LEE'S SUMMIT, MISSOURI 64064

REVISIONS:
# Description Date

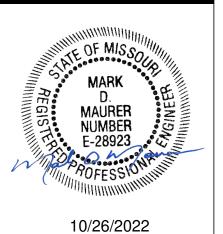

AUDI	O-VIDEO
All work herei Architecture, Inc. in any way without	Architecture, Inc. n is the property of GLMV and is not to be copied or used the express written consent of / Architecture, Inc.
CHK'D BY:	M.MAURER
DRAWN BY:	J.ROSE
DATE:	10.26.2022

GENERAL SYMBOLS

HENDERSON ENGINEERS


8345 LENEXA DRIVE, SUITE 300

LENEXA, KS 66214
TEL 913.742.5000 FAX 913.742.5001

WWW.HENDERSONENGINEERS.COM

2150001291 MO. CORPORATE NO: E-556D EXPIRES 12/31/2022 PROJECT NO:

**TA001** 

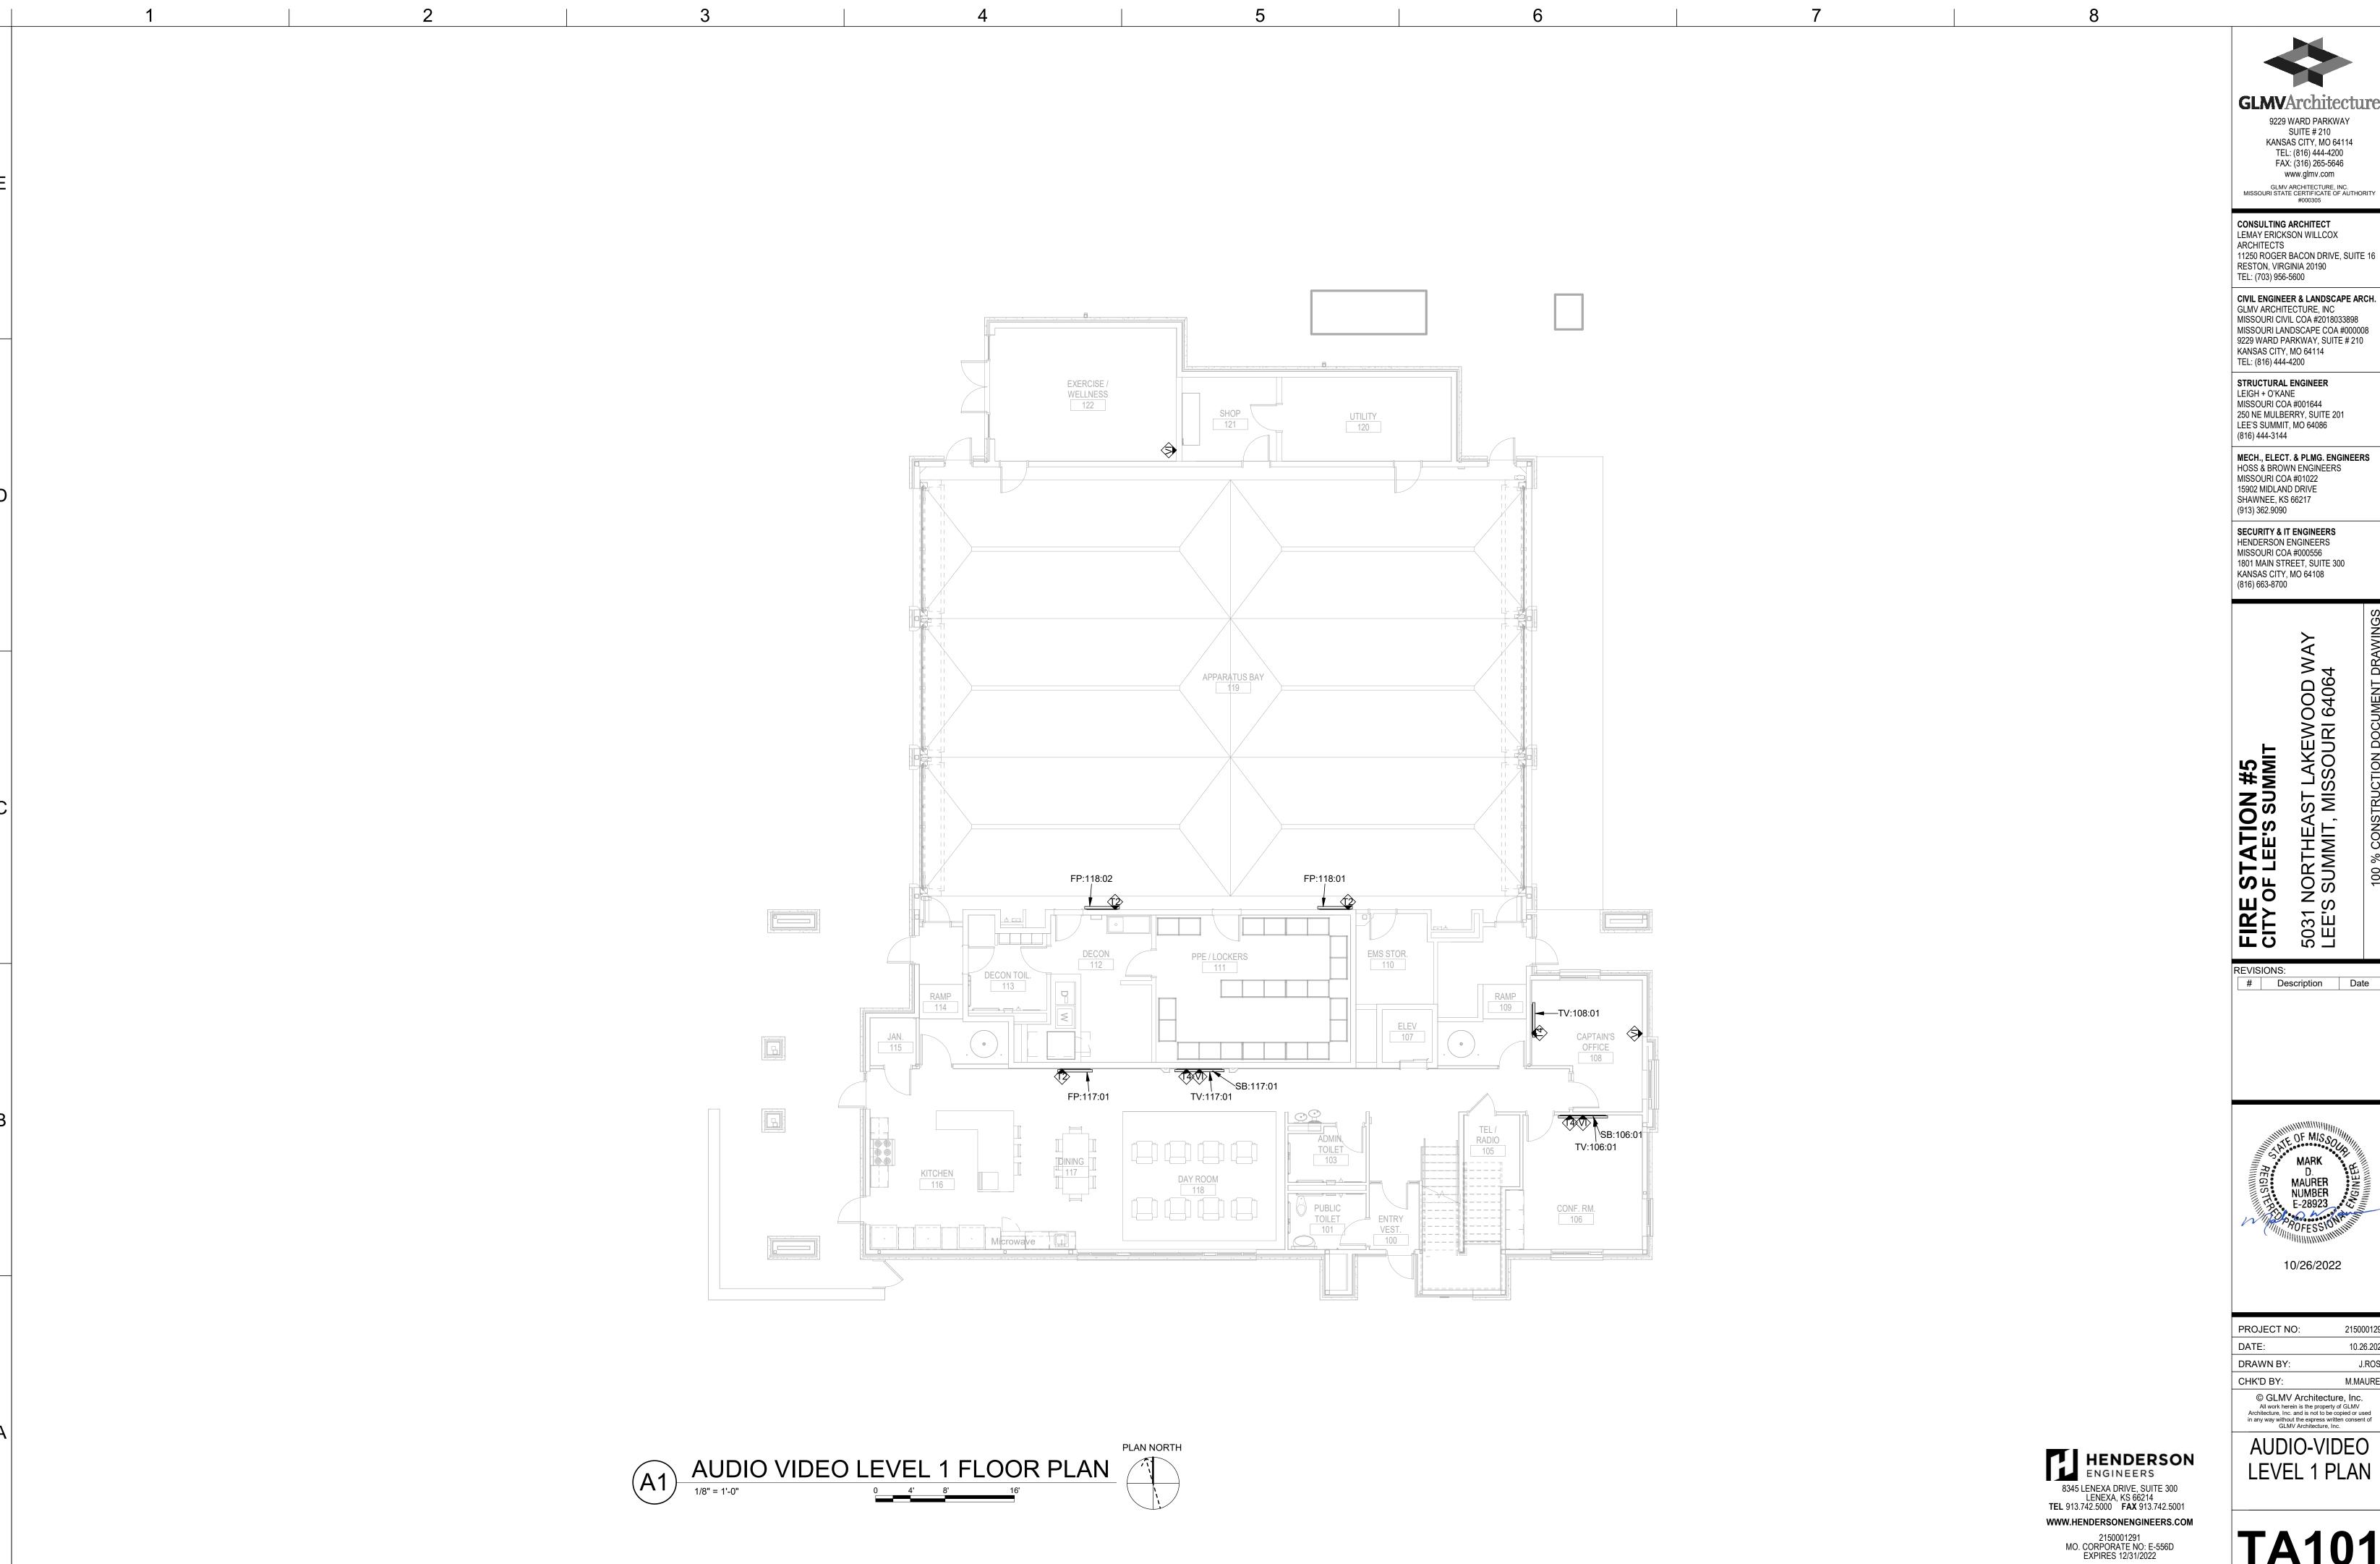

2



SUITE # 210 KANSAS CITY, MO 64114 TEL: (816) 444-4200 FAX: (316) 265-5646 www.glmv.com

CONSULTING ARCHITECT LEMAY ERICKSON WILLCOX 11250 ROGER BACON DRIVE, SUITE 16 RESTON, VIRGINIA 20190

CIVIL ENGINEER & LANDSCAPE ARCH.
GLMV ARCHITECTURE, INC
MISSOURI CIVIL COA #2018033898
MISSOURI LANDSCAPE COA #000008 9229 WARD PARKWAY, SUITE # 210


STRUCTURAL ENGINEER LEIGH + O'KANE MISSOURI COA #001644 250 NE MULBERRY, SUITE 201 LEE'S SUMMIT, MO 64086 (816) 444-3144

MECH., ELECT. & PLMG. ENGINEERS HOSS & BROWN ENGINEERS MISSOURI COA #01022 15902 MIDLAND DRIVE SHAWNEE, KS 66217

SECURITY & IT ENGINEERS HENDERSON ENGINEERS MISSOURI COA #000556 1801 MAIN STREET, SUITE 300 KANSAS CITY, MO 64108 (816) 663-8700


5031 NORTHI LEE'S SUMMI

REVISIONS:
# Description Date

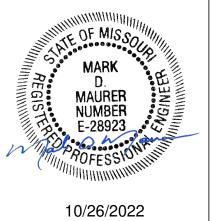

	PROJECT NO:	21500012				
	DATE:	10.26.20				
	DRAWN BY:	J.RO				
	CHK'D BY:	M.MAURI				
	© GLMV Architecture, Inc.  All work herein is the property of GLMV  Architecture, Inc. and is not to be copied or used in any way without the express written consent of GLMV Architecture, Inc.					
ĺ	AUDIO-V					
	LEVEL 1	PLAN				

**TA101** 

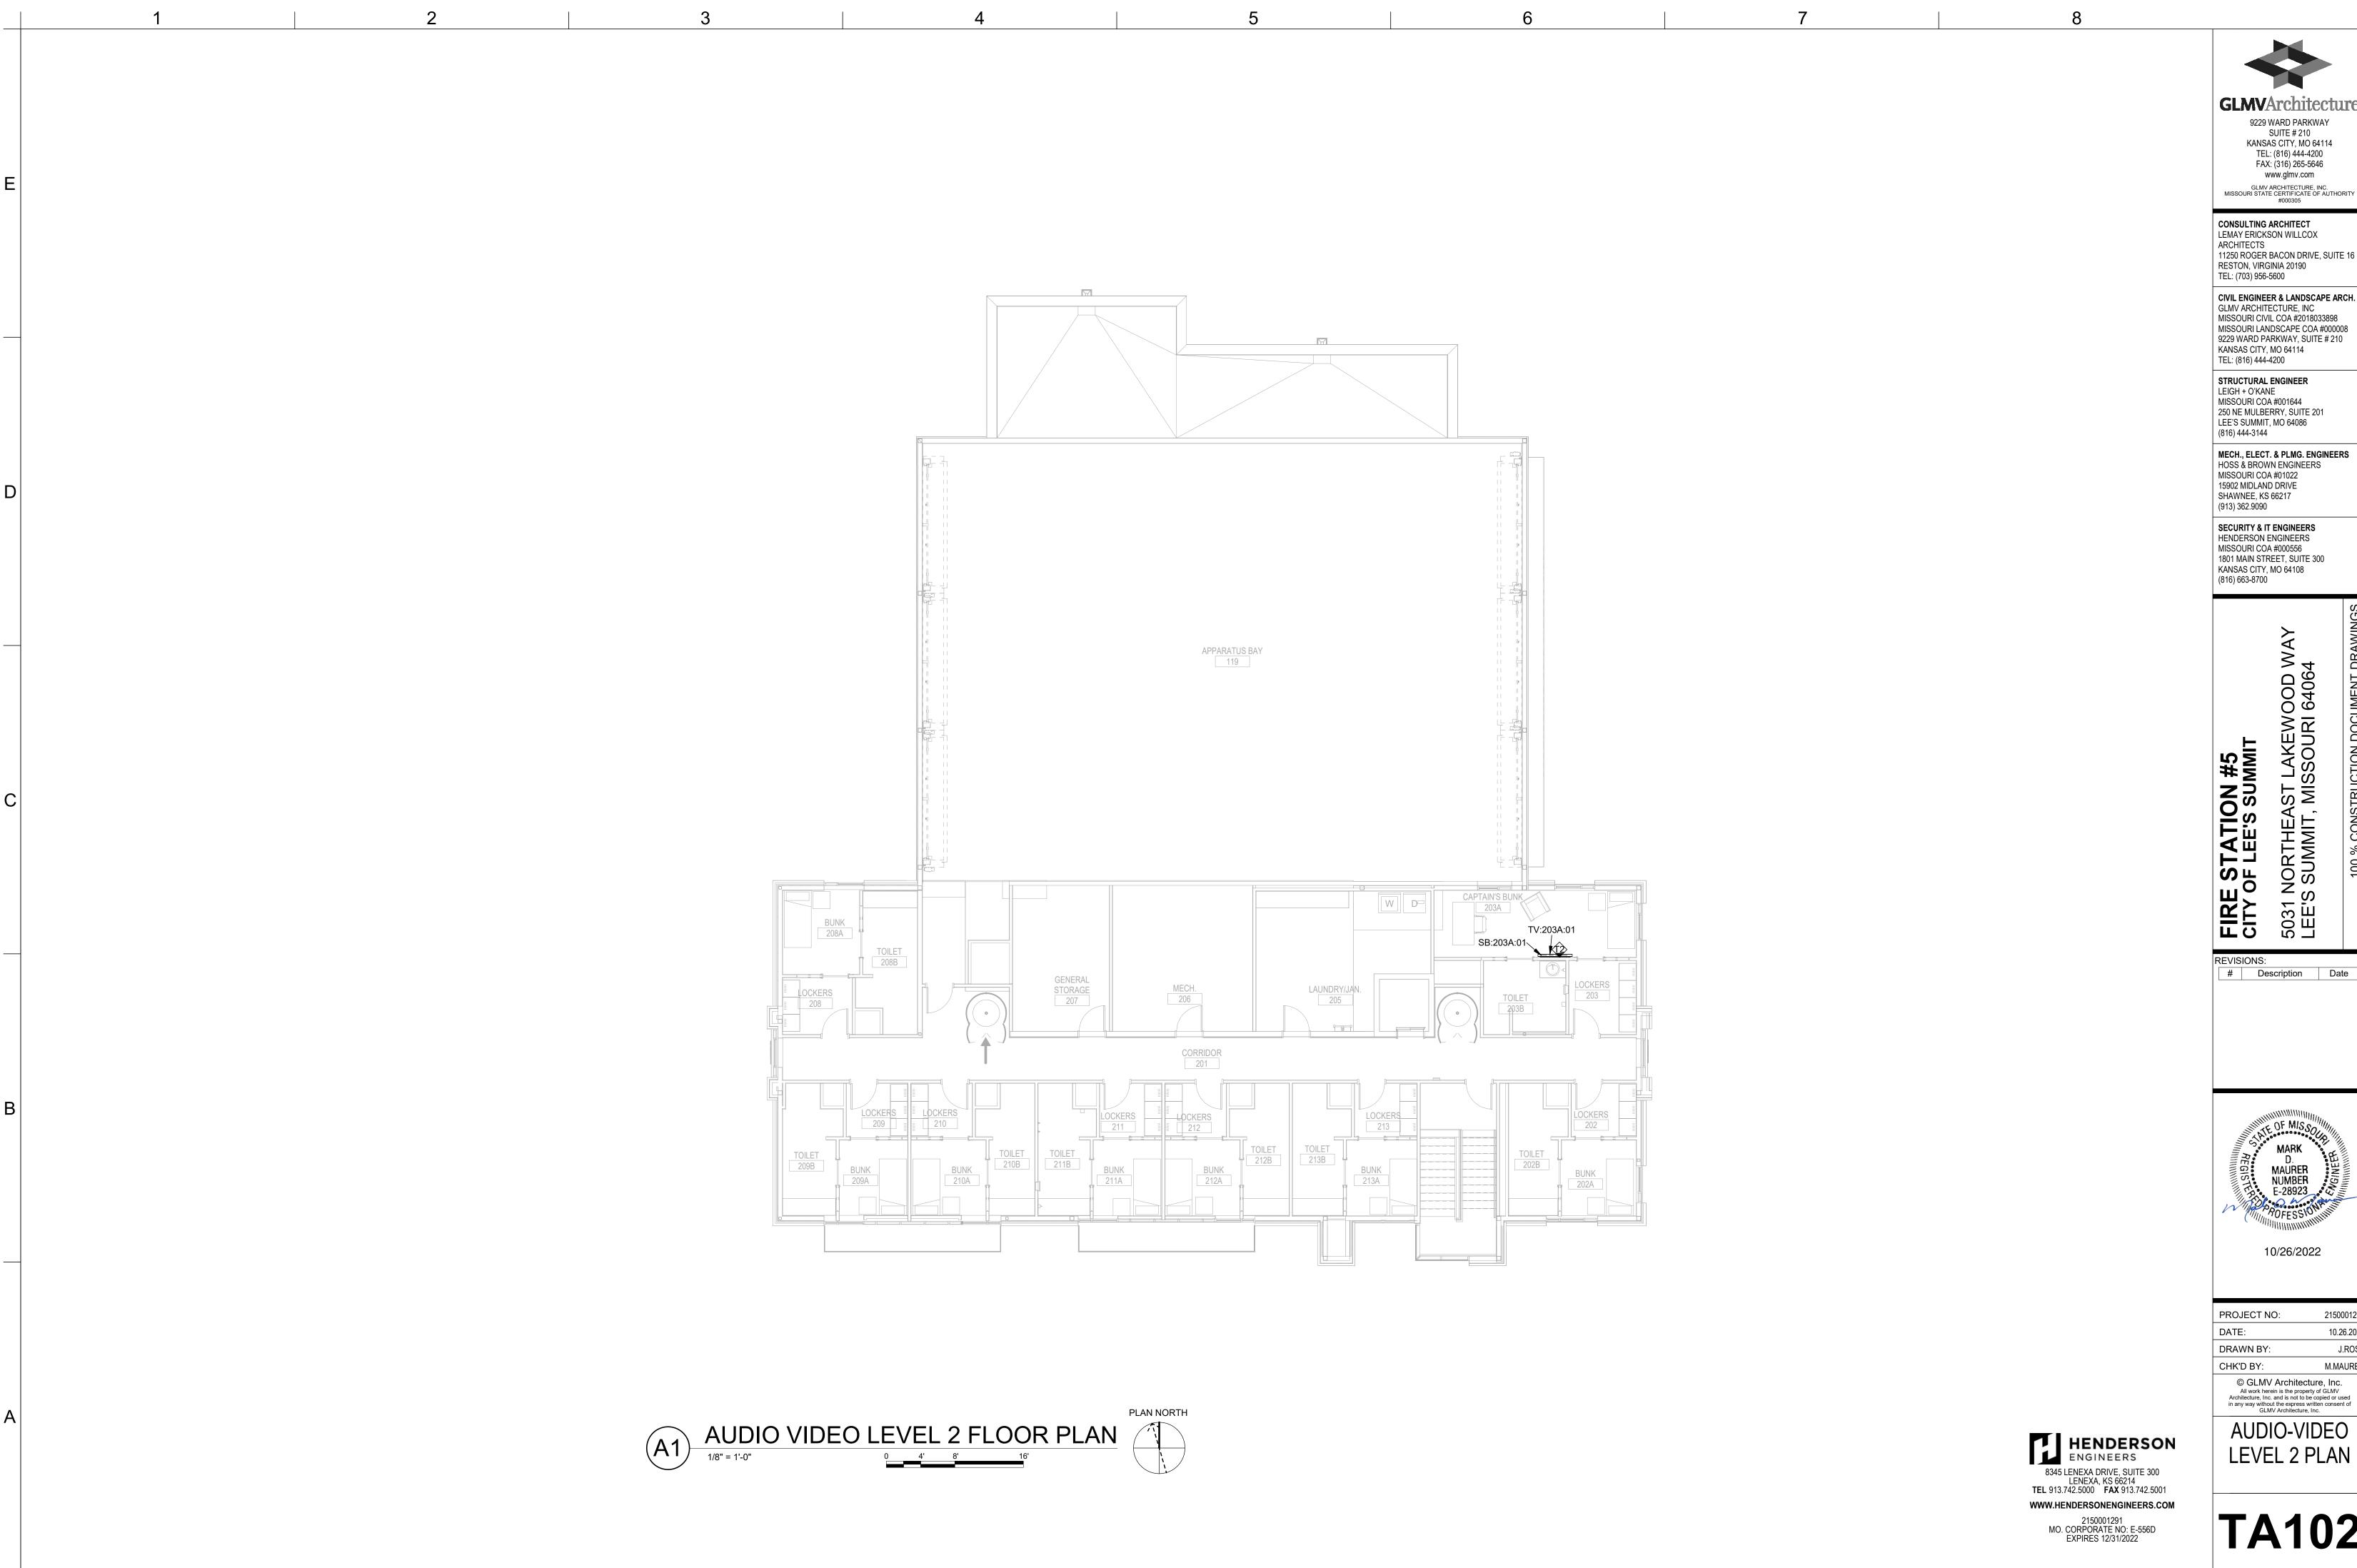

SUITE # 210 KANSAS CITY, MO 64114 TEL: (816) 444-4200 FAX: (316) 265-5646 www.glmv.com GLMV ARCHITECTURE, INC. MISSOURI STATE CERTIFICATE OF AUTHORITY #000305

CONSULTING ARCHITECT LEMAY ERICKSON WILLCOX ARCHITECTS 11250 ROGER BACON DRIVE, SUITE 16 RESTON, VIRGINIA 20190

TEL: (703) 956-5600 CIVIL ENGINEER & LANDSCAPE ARCH.
GLMV ARCHITECTURE, INC
MISSOURI CIVIL COA #2018033898
MISSOURI LANDSCAPE COA #000008

TEL: (816) 444-4200 STRUCTURAL ENGINEER LEIGH + O'KANE MISSOURI COA #001644 250 NE MULBERRY, SUITE 201

MECH., ELECT. & PLMG. ENGINEERS HOSS & BROWN ENGINEERS MISSOURI COA #01022 15902 MIDLAND DRIVE SHAWNEE, KS 66217

SECURITY & IT ENGINEERS HENDERSON ENGINEERS MISSOURI COA #000556 1801 MAIN STREET, SUITE 300 KANSAS CITY, MO 64108 (816) 663-8700

5031 NORTHI LEE'S SUMMI


# Description Date

MAURER NUMBER E-28923

10/26/2022

5	AUDIO-\	
	© GLMV Archite All work herein is the pr Architecture, Inc. and is not in any way without the expre	operty of GLMV to be copied or used
	CHK'D BY:	M.MAURE
	DRAWN BY:	J.ROS
	DATE:	10.26.20
	PROJECT NO:	21500012

**TA102** 

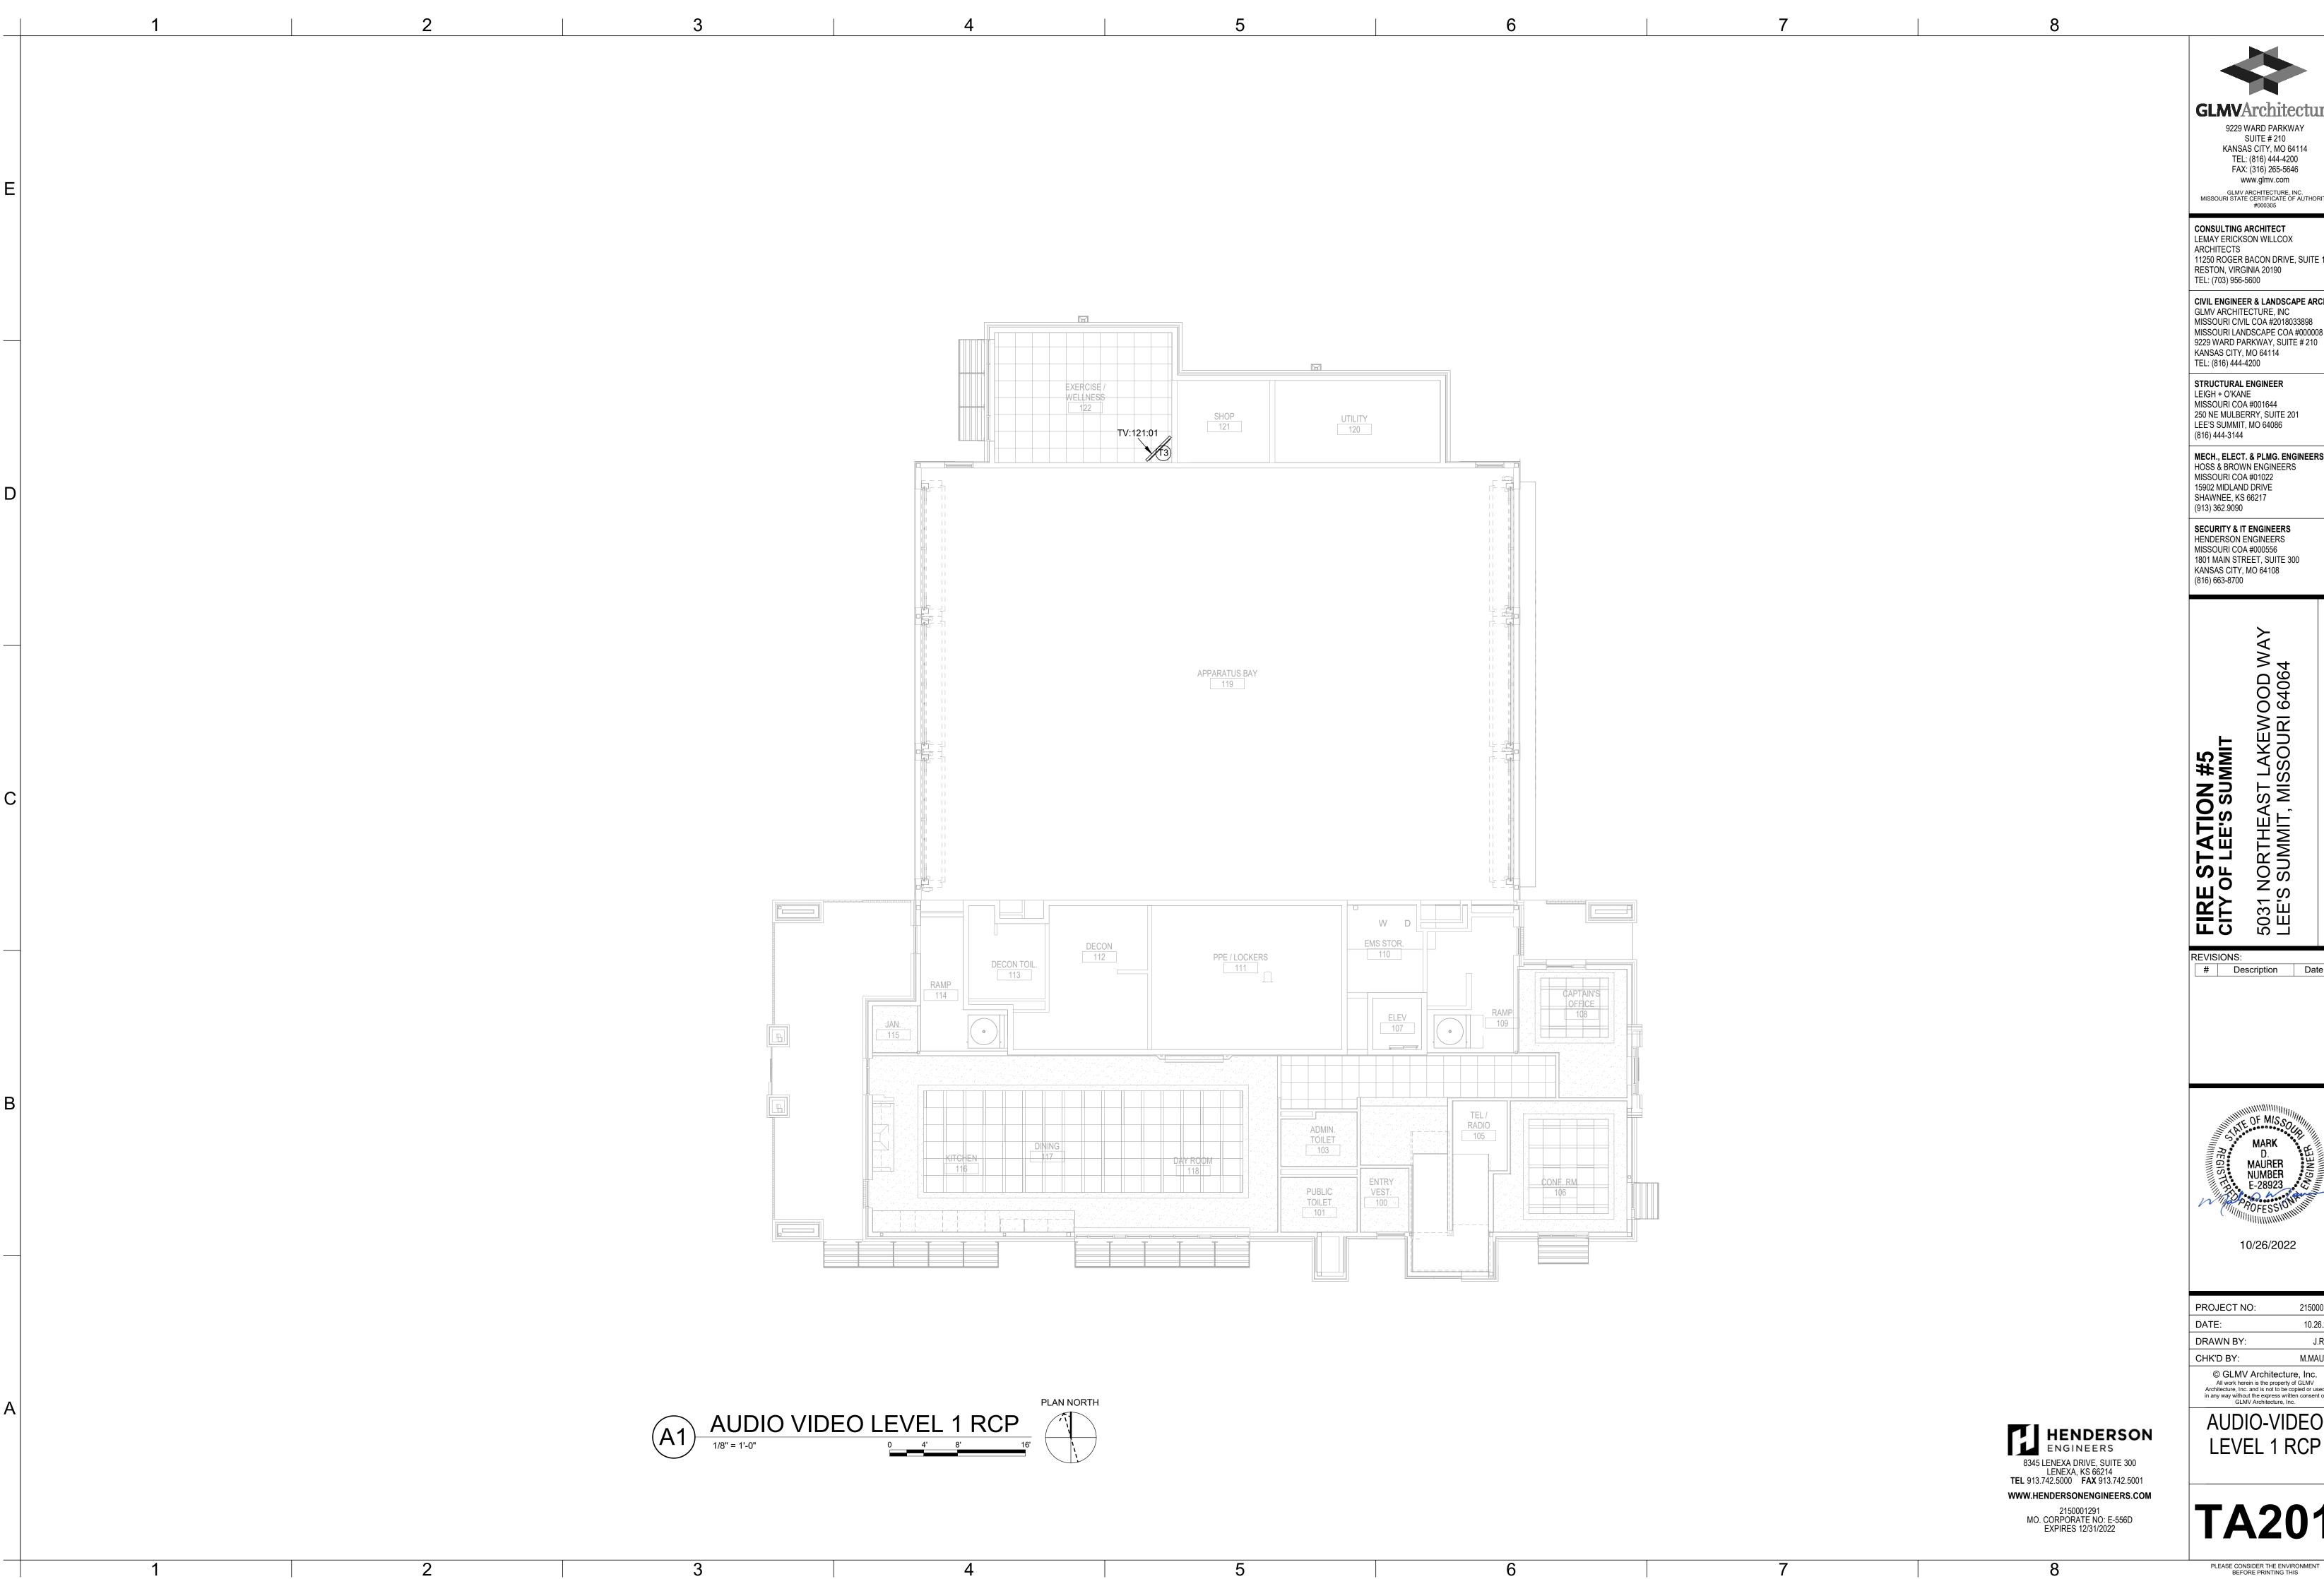

9229 WARD PARKWAY SUITE # 210 KANSAS CITY, MO 64114 TEL: (816) 444-4200 FAX: (316) 265-5646 www.glmv.com GLMV ARCHITECTURE, INC. MISSOURI STATE CERTIFICATE OF AUTHORITY #000305

CONSULTING ARCHITECT LEMAY ERICKSON WILLCOX

11250 ROGER BACON DRIVE, SUITE 16 RESTON, VIRGINIA 20190 TEL: (703) 956-5600

CIVIL ENGINEER & LANDSCAPE ARCH.
GLMV ARCHITECTURE, INC
MISSOURI CIVIL COA #2018033898
MISSOURI LANDSCAPE COA #0000008 9229 WARD PARKWAY, SUITE # 210 KANSAS CITY, MO 64114


STRUCTURAL ENGINEER LEIGH + O'KANE MISSOURI COA #001644 250 NE MULBERRY, SUITE 201 LEE'S SUMMIT, MO 64086 (816) 444-3144

MECH., ELECT. & PLMG. ENGINEERS
HOSS & BROWN ENGINEERS
MISSOURI COA #01022
15902 MIDLAND DRIVE SHAWNEE, KS 66217

SECURITY & IT ENGINEERS
HENDERSON ENGINEERS
MISSOURI COA #000556 1801 MAIN STREET, SUITE 300 KANSAS CITY, MO 64108 (816) 663-8700

5031 NORTHI LEE'S SUMMI

REVISIONS:
# Description Date

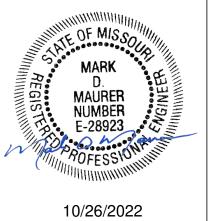

	DDO IEOT NO	04500040
	PROJECT NO:	21500012
	DATE:	10.26.20
	DRAWN BY:	J.ROS
	CHK'D BY:	M.MAURE
	© GLMV Archite  All work herein is the pro Architecture, Inc. and is not to in any way without the expres GLMV Architectu	perty of GLMV o be copied or used s written consent of
Ì	AUDIO-V	
•	│	D C D

BLANK NONE


FLUSH


	AUDIO-VIDEO FLAT PANEL DISPLAY SCHEDULE									
	DIS	SPLAY PROPERTIES	<i>,</i>	UDIO-VIDEO FLAT F	MOUNTING REQUIREMENT	PONSIBILITY				
	Die d			INSTALL HEIGHT AFF. (CENTER OF			BIOI LATITUDE	ONOIBIETT		
ID	SPEC NAME	B.O.D. MANUF.	B.O.D. MODEL	DISPLAY)	TYPE	FURNISHED BY	INSTALLED BY	PROVIDED BY	NOTES	
FP:117:01	LCD COMM DISPLAY - 2160/55	ONWER FURNISHED	ONWER FURNISHED	60"	WALL - ARTICULATING ADA	CONTRACTOR	CONTRACTOR	OWNER		
FP:118:01	LCD COMM DISPLAY - 2160/55	ONWER FURNISHED	ONWER FURNISHED	60"	WALL - ARTICULATING	CONTRACTOR	CONTRACTOR	OWNER		
FP:118:02	LCD COMM DISPLAY - 2160/55	ONWER FURNISHED	ONWER FURNISHED	60"	WALL - ARTICULATING	CONTRACTOR	CONTRACTOR	OWNER		
TV:106:01	LCD COMM DISPLAY - 2160/75	ONWER FURNISHED	ONWER FURNISHED	60"	WALL - ARTICULATING	CONTRACTOR	CONTRACTOR	OWNER		
TV:108:01	LCD COMM DISPLAY - 2160/55	ONWER FURNISHED	ONWER FURNISHED	60"	WALL - ARTICULATING	CONTRACTOR	CONTRACTOR	OWNER		
TV:117:01	LCD COMM DISPLAY - 2160/75	ONWER FURNISHED	ONWER FURNISHED	60"	WALL - ARTICULATING ADA	CONTRACTOR	CONTRACTOR	OWNER		
TV:121:01	LCD COMM DISPLAY - 2160/55	ONWER FURNISHED	ONWER FURNISHED	102"	CEILING - POLE	CONTRACTOR	CONTRACTOR	OWNER		
TV:203A:01	LCD COMM DISPLAY - 2160/55	ONWER FURNISHED	ONWER FURNISHED	60"	WALL - ARTICULATING	CONTRACTOR	CONTRACTOR	OWNER		

	AUDIO-VIDEO LOUDSPEAKER SCHEDULE													
	LOUDSPEAKER PROPERTIES					LOUDSPEAKER MOUNTING ORIENTATION			N	ENCLOSU	IRE/HORN			
					IMPEDANCE	70V TAP	MOUNTING					ROLL	ROTATE	
ID		SPEC NAME	B.O.D. MANUF.	B.O.D. MODEL	(OHM)	(WATTS)	CONDITION	HEIGHT	YAW	PITCH	ROLL	ENCL. 90	HORN 90	NOTES

2-GANG/1-GANG | RACO | 260 W/ 843 | 18"

SB:106:01	SB 8 4x2 - SP	JBL	PSB-1	8	-	SURFACE	38"	0.00°	0.00°	0.00°	No	No	
SB:117:01	SB 8 4x2 - SP	JBL	PSB-1	8	-	SURFACE	38"	0.00°	0.00°	0.00°	No	No	
SB:203A:01	SB 8 4x2 - SP	JBL	PSB-1	8	-	SURFACE	44"	0.00°	0.00°	0.00°	No	No	

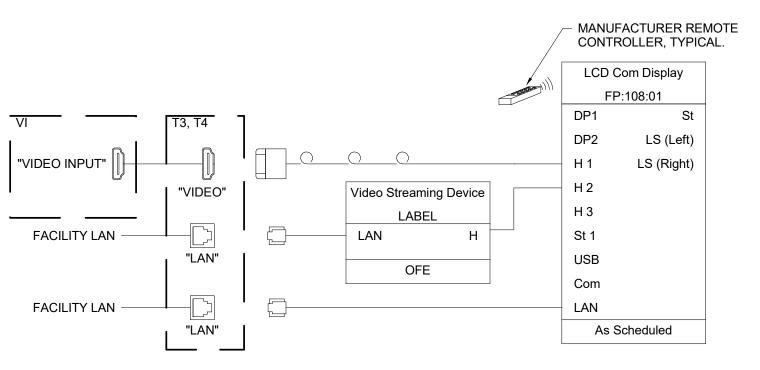

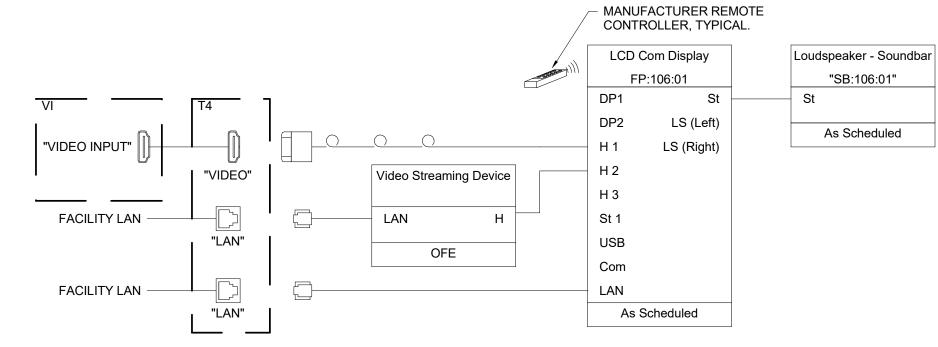

1.25" C ABOVE ACESSIBLE CEILING OR AS HIGH AS POSSIBLE TO CEILING DECK IN ROOM

CAPTAIN'S OFFICE 108 DISPLAY WITH LOCAL HDMI, FP:108:01 SHOWN

NOT TO SCALE 1. SYSTEM/ROOM SHOWN IS TYPICAL OF MULTIPLE SYSTEMS/ROOMS. IN ADDITION TO THE SYSTEM/ROOM SHOWN PROVIDE ONE SYSTEM THIS TYPE FOR THE FOLLOWING ROOMS:

1.1 EXERCISE / WELLNESS 122 (FP:122:01)

1.1 APPARATUS BAY 118 (FP:118:02)

1.2 DINNING 117 (FP:117:01)

VI ASSORTED CONNECTION WALL BOX

MANUFACTURER REMOTE CONTROLLER, TYPICAL. LCD Com Display FP:118:01 Video Streaming Device LS (Right) OFE USB "LAN" Com

SINGLE DISPLAY WITH LOCAL HDMI, TYPICAL TRAINING/SMALL CONFERENCE ROOM 106 SHOWN

1. SYSTEM/ROOM SHOWN IS TYPICAL OF MULTIPLE SYSTEMS/ROOMS. IN ADDITION TO THE SYSTEM/ROOM SHOWN PROVIDE ONE SYSTEM THIS TYPE FOR THE FOLLOWING ROOMS:

> MANUFACTURER REMOTE CONTROLLER, TYPICAL. LCD Com Display Loudspeaker - Soundbar FP:203A:01 "SB:203A:01" DP1 Video Streaming Device DP2 LS (Left) As Scheduled LS (Right) OFE FACILITY LAN -USB "LAN" Com LAN As Scheduled

APPARATUS BAY 118 DISPLAY, TYPICAL FP:118:01 SHOWN NOT TO SCALE

> 1. SYSTEM/ROOM SHOWN IS TYPICAL OF MULTIPLE SYSTEMS/ROOMS. IN ADDITION TO THE SYSTEM/ROOM SHOWN PROVIDE ONE SYSTEM THIS TYPE FOR THE FOLLOWING ROOMS:



HENDERSON ENGINEERS 8345 LENEXA DRIVE, SUITE 300 LENEXA, KS 66214 TEL 913.742.5000 FAX 913.742.5001 WWW.HENDERSONENGINEERS.COM 2150001291 MO. CORPORATE NO: E-556D EXPIRES 12/31/2022

9229 WARD PARKWAY SUITE # 210 KANSAS CITY, MO 64114 TEL: (816) 444-4200 FAX: (316) 265-5646

> www.glmv.com GLMV ARCHITECTURE, INC. MISSOURI STATE CERTIFICATE OF AUTHORITY #000305 CONSULTING ARCHITECT

LEMAY ERICKSON WILLCOX ARCHITECTS 11250 ROGER BACON DRIVE, SUITE 16 RESTON, VIRGINIA 20190 TEL: (703) 956-5600

CIVIL ENGINEER & LANDSCAPE ARCH. GLMV ARCHITECTURE, INC MISSOURI CIVIL COA #2018033898 MISSOURI LANDSCAPE COA #000008 9229 WARD PARKWAY, SUITE # 210 KANSAS CITY, MO 64114 TEL: (816) 444-4200


STRUCTURAL ENGINEER LEIGH + O'KANE MISSOURI COA #001644 250 NE MULBERRY, SUITE 201 LEE'S SUMMIT, MO 64086 (816) 444-3144

MECH., ELECT. & PLMG. ENGINEERS HOSS & BROWN ENGINEERS MISSOURI COA #01022 15902 MIDLAND DRIVE SHAWNEE, KS 66217 (913) 362.9090

> SECURITY & IT ENGINEERS HENDERSON ENGINEERS MISSOURI COA #000556 1801 MAIN STREET, SUITE 300 KANSAS CITY, MO 64108 (816) 663-8700

FIRE STATIC CITY OF LEE'S 5031 NORTHI LEE'S SUMMI

REVISIONS: # Description

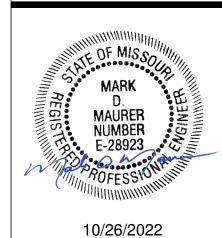


AUDIO-W	
© GLMV Archite  All work herein is the properties of the propertie	perty of GLMV be copied or used s written consent of
CHK'D BY:	M.MAURER
DRAWN BY:	J.ROSE
DATE:	10.26.2022
PROJECT NO:	2150001291

**SCHEDULES &** SIGNAL FLOWS

LAN

As Scheduled

1.1 DAY ROOM 117

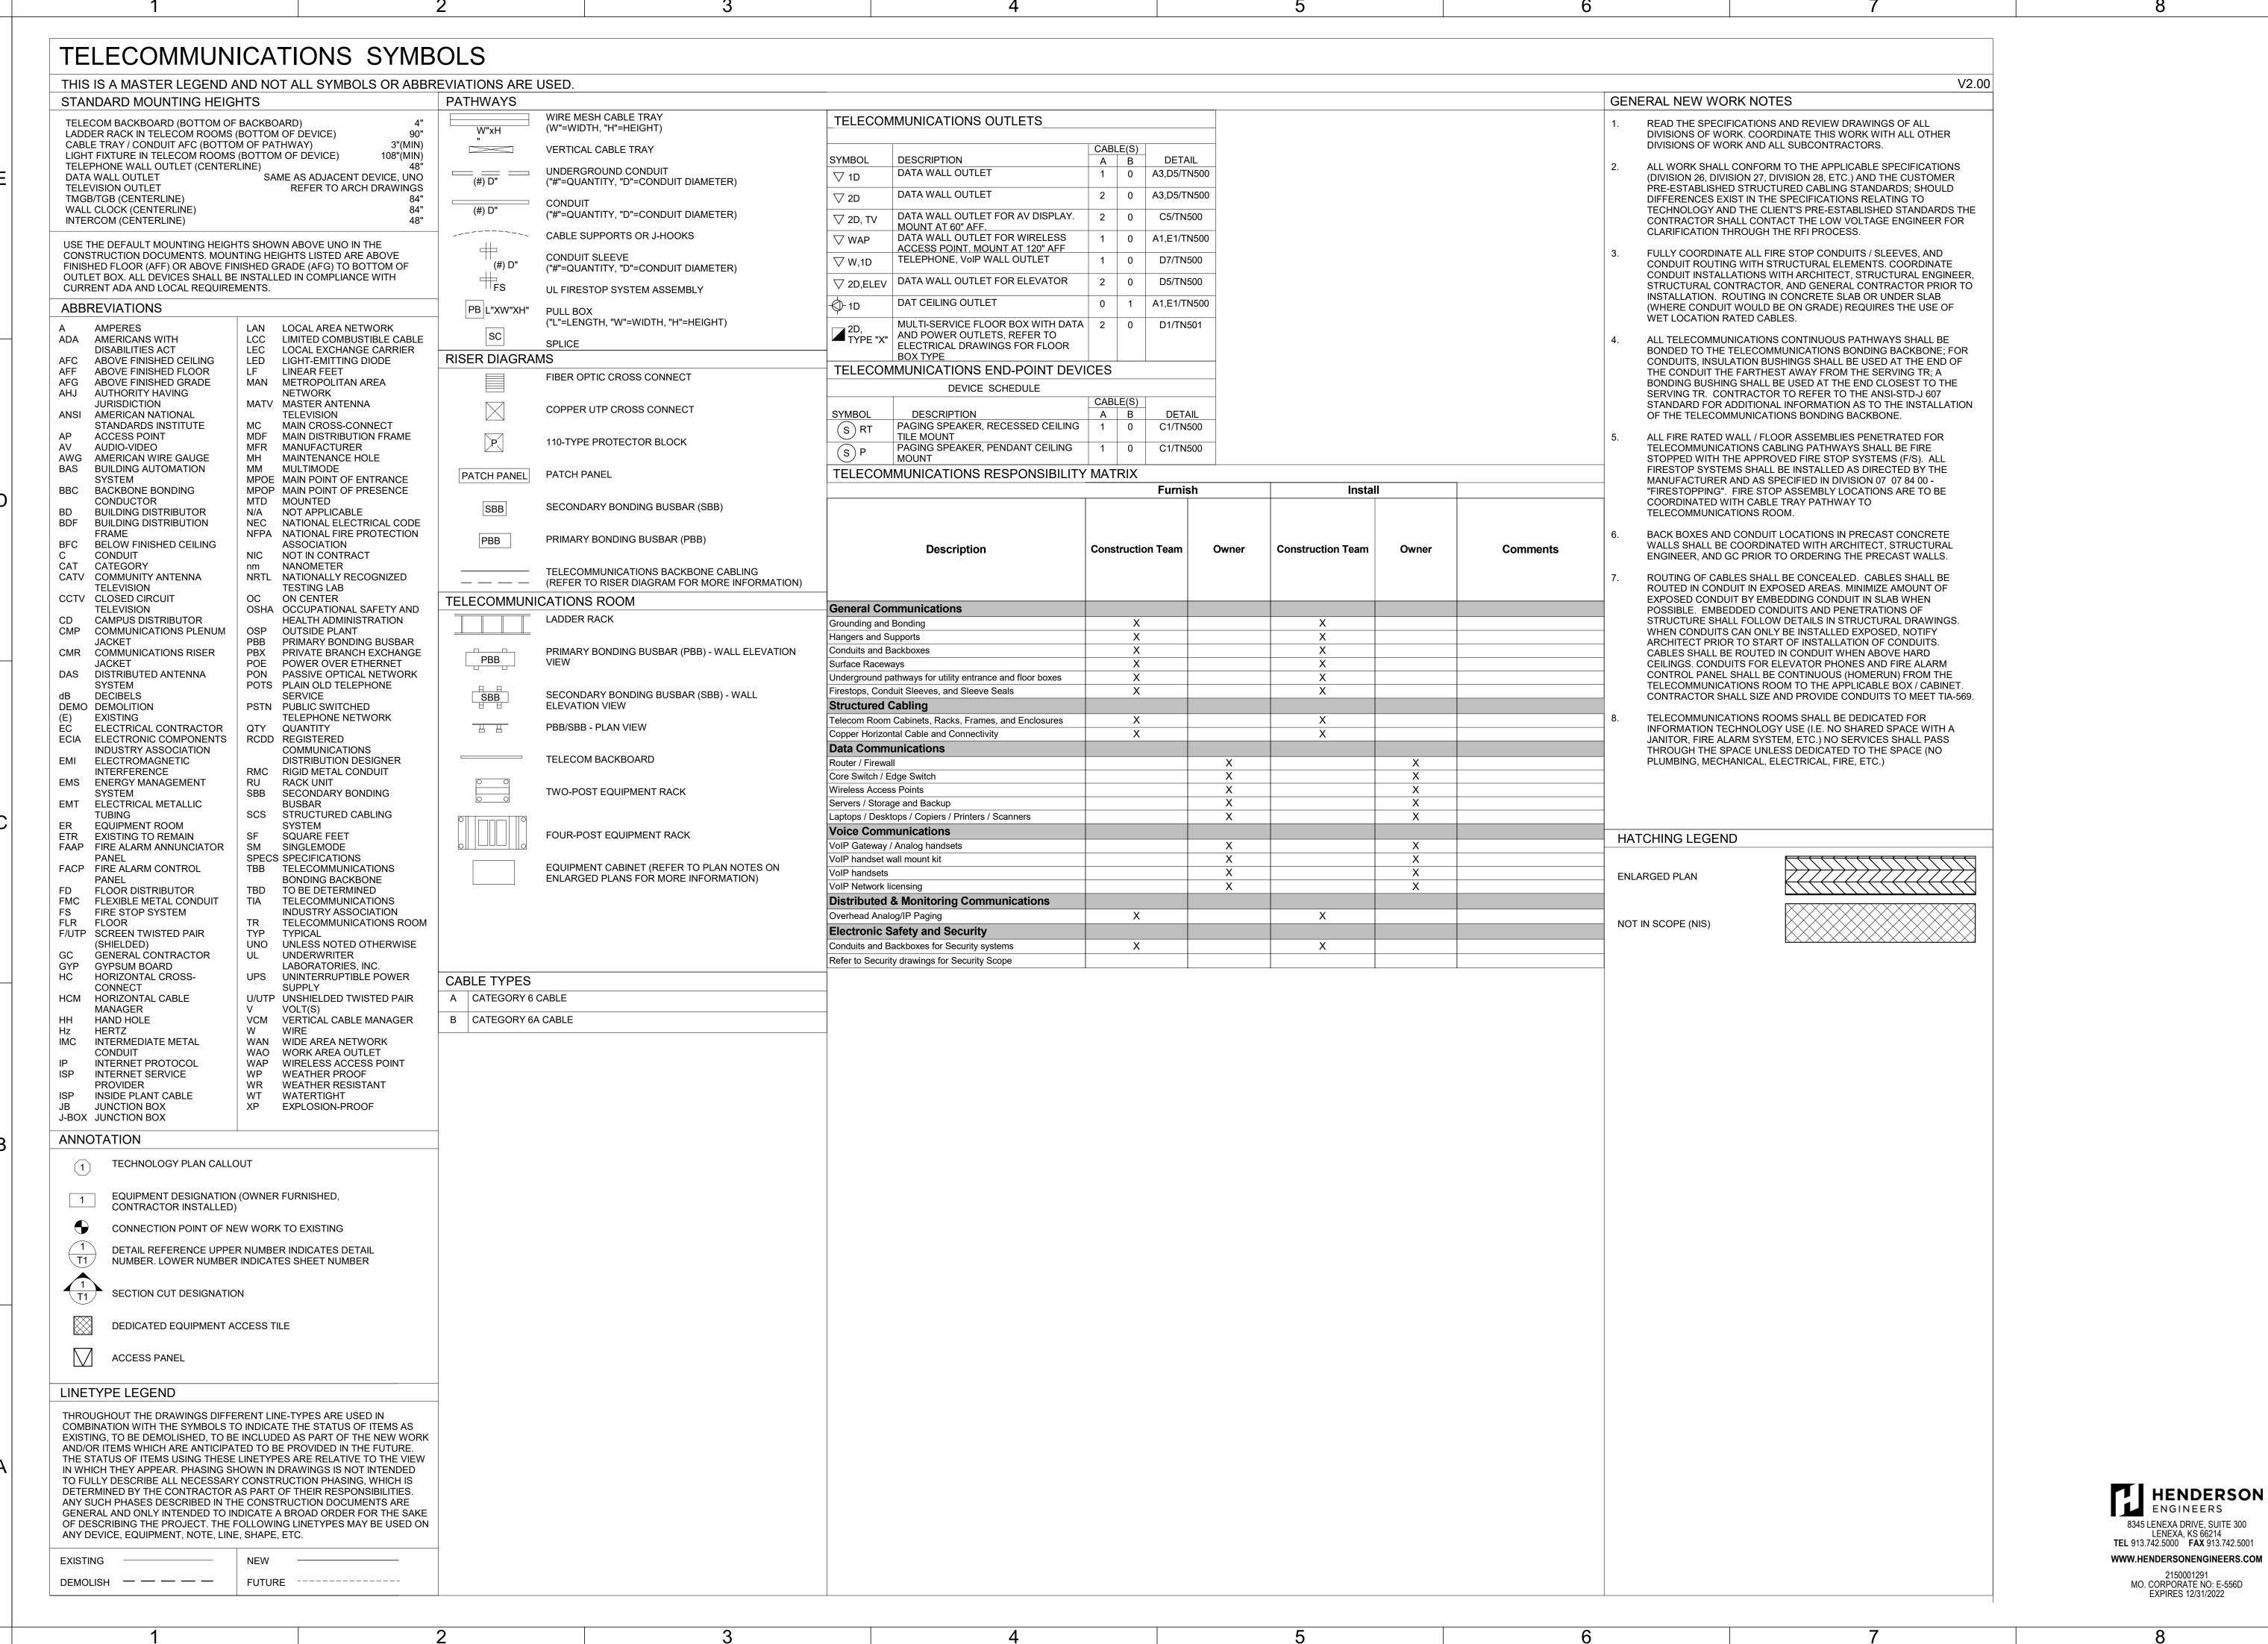



TEL: (816) 444-4200 FAX: (316) 265-5646 www.glmv.com GLMV ARCHITECTURE, INC. MISSOURI STATE CERTIFICATE OF AUTHORITY #000305

SUITE # 210

KANSAS CITY, MO 64114

CONSULTING ARCHITECT LEMAY ERICKSON WILLCOX ARCHITECTS 11250 ROGER BACON DRIVE, SUITE 16 RESTON, VIRGINIA 20190 TEL: (703) 956-5600

CIVIL ENGINEER & LANDSCAPE ARCH. GLMV ARCHITECTURE, INC MISSOURI CIVIL COA #2018033898 MISSOURI LANDSCAPE COA #000008 9229 WARD PARKWAY, SUITE # 210 KANSAS CITY, MO 64114 TEL: (816) 444-4200

STRUCTURAL ENGINEER LEIGH + O'KANE MISSOURI COA #001644 250 NE MULBERRY, SUITE 201 LEE'S SUMMIT, MO 64086 (816) 444-3144


MECH., ELECT, & PLMG, ENGINEERS HOSS & BROWN ENGINEERS MISSOURI COA #01022 15902 MIDLAND DRIVE SHAWNEE, KS 66217 (913) 362.9090

**SECURITY & IT ENGINEERS** HENDERSON ENGINEERS MISSOURI COA #000556 1801 MAIN STREET, SUITE 300 KANSAS CITY, MO 64108 (816) 663-8700

ES.

REVISIONS # Description

50; LE

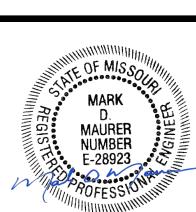

10/26/2022

PROJECT NO:	2150001291						
DATE:	10.26.2022						
DRAWN BY:	J.CORONADO						
CHK'D BY:	M.MAURER						
© GLMV Architecture, Inc.  All work herein is the property of GLMV  Architecture. Inc. and is not to be copied or used							

in any way without the express written consent of GLMV Architecture, Inc.

GENERAL NOTES


PLEASE CONSIDER THE ENVIRONMENT BEFORE PRINTING THIS

EXPIRES 12/31/2022

8345 LENEXA DRIVE, SUITE 300

LENEXA, KS 66214

MO. CORPORATE NO: E-556D

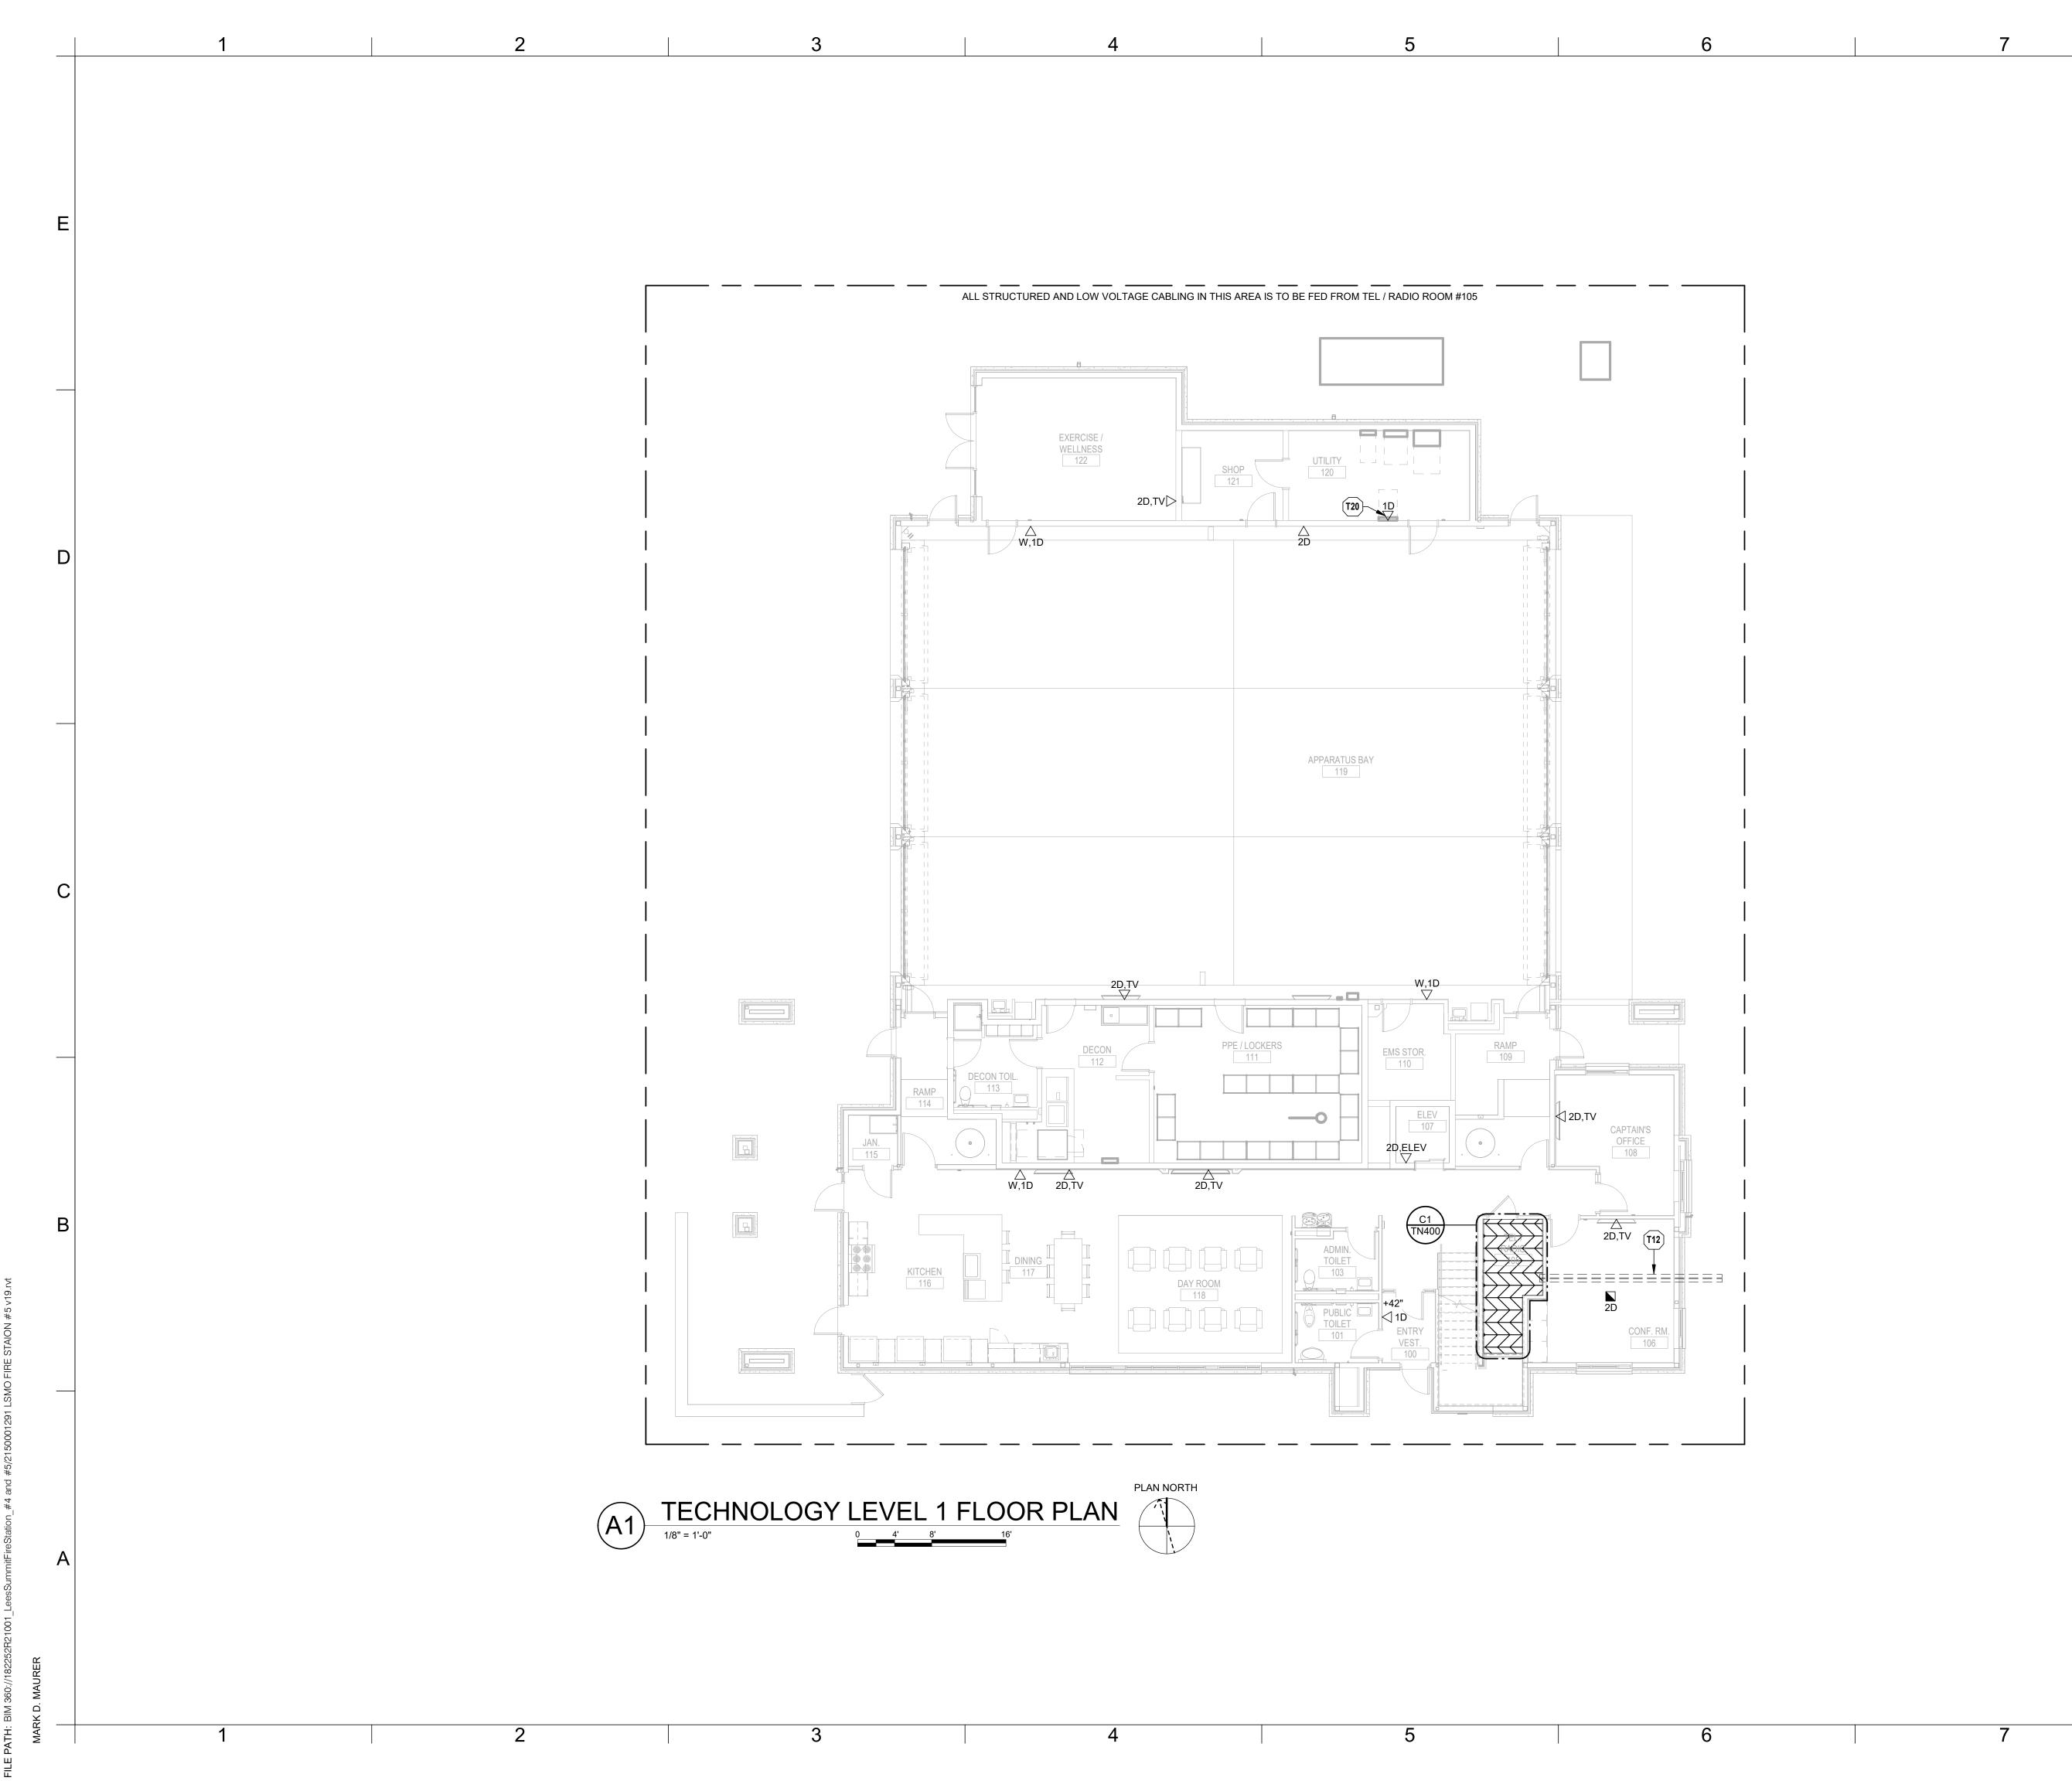

<u>TECHNOLOGY PLAN NOTES:</u>

T12 PROVIDE (2) 4" SERVICE ENTRANCE CONDUITS FROM ENTRANCE FACILITY TO 5'-0" OUTSIDE OF BUILDING. PROVIDE PULL STRING. REFER TO CIVIL SITE PLANS AND DIVISION 27 SPECIFICATIONS FOR ADDITIONAL INFORMATION.

T20 PROVIDE DATA OUTLET FOR LIGHTING CONTROL PANEL. REFER TO ELECTRICAL SHEETS FOR FURTHER INFORMATION. COORDINATE WITH ELECTRICAL CONTRACTOR ON EXACT HEIGHT AND LOCATION PRIOR TO INSTALLATION.

9229 WARD PARKWAY SUITE # 210

> FAX: (316) 265-5646 www.glmv.com GLMV ARCHITECTURE, INC. MISSOURI STATE CERTIFICATE OF AUTHORITY #000305

KANSAS CITY, MO 64114 TEL: (816) 444-4200

CONSULTING ARCHITECT

LEMAY ERICKSON WILLCOX ARCHITECTS 11250 ROGER BACON DRIVE, SUITE 16 RESTON, VIRGINIA 20190 TEL: (703) 956-5600

CIVIL ENGINEER & LANDSCAPE ARCH.
GLMV ARCHITECTURE, INC MISSOURI CIVIL COA #2018033898 MISSOURI LANDSCAPE COA #000008 9229 WARD PARKWAY, SUITE # 210

KANSAS CITY, MO 64114 TEL: (816) 444-4200 STRUCTURAL ENGINEER LEIGH + O'KANE MISSOURI COA #001644 250 NE MULBERRY, SUITE 201


LEE'S SUMMIT, MO 64086

(816) 444-3144 MECH., ELECT. & PLMG. ENGINEERS HOSS & BROWN ENGINEERS MISSOURI COA #01022 15902 MIDLAND DRIVE SHAWNEE, KS 66217 (913) 362.9090

SECURITY & IT ENGINEERS HENDERSON ENGINEERS MISSOURI COA #000556 1801 MAIN STREET, SUITE 300 KANSAS CITY, MO 64108 (816) 663-8700

FIRE STATION #5 CITY OF LEE'S SUMMIT 5031 NORTHI LEE'S SUMMI

REVISIONS:
# Description Date

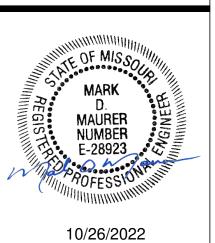

PROJECT NO:	2150001291				
DATE:	10.26.2022				
DRAWN BY:	J.CORONADO				
CHK'D BY:	M.MAURER				
© GLMV Archi All work herein is the Architecture, Inc. and is no in any way without the exp	property of GLMV ot to be copied or used ress written consent of				

TECHNOLOGY LEVEL 1 PLAN


HENDERSON ENGINEERS

8345 LENEXA DRIVE, SUITE 300 LENEXA, KS 66214 TEL 913.742.5000 FAX 913.742.5001

WWW.HENDERSONENGINEERS.COM

2150001291 MO. CORPORATE NO: E-556D EXPIRES 12/31/2022

**TN101** 

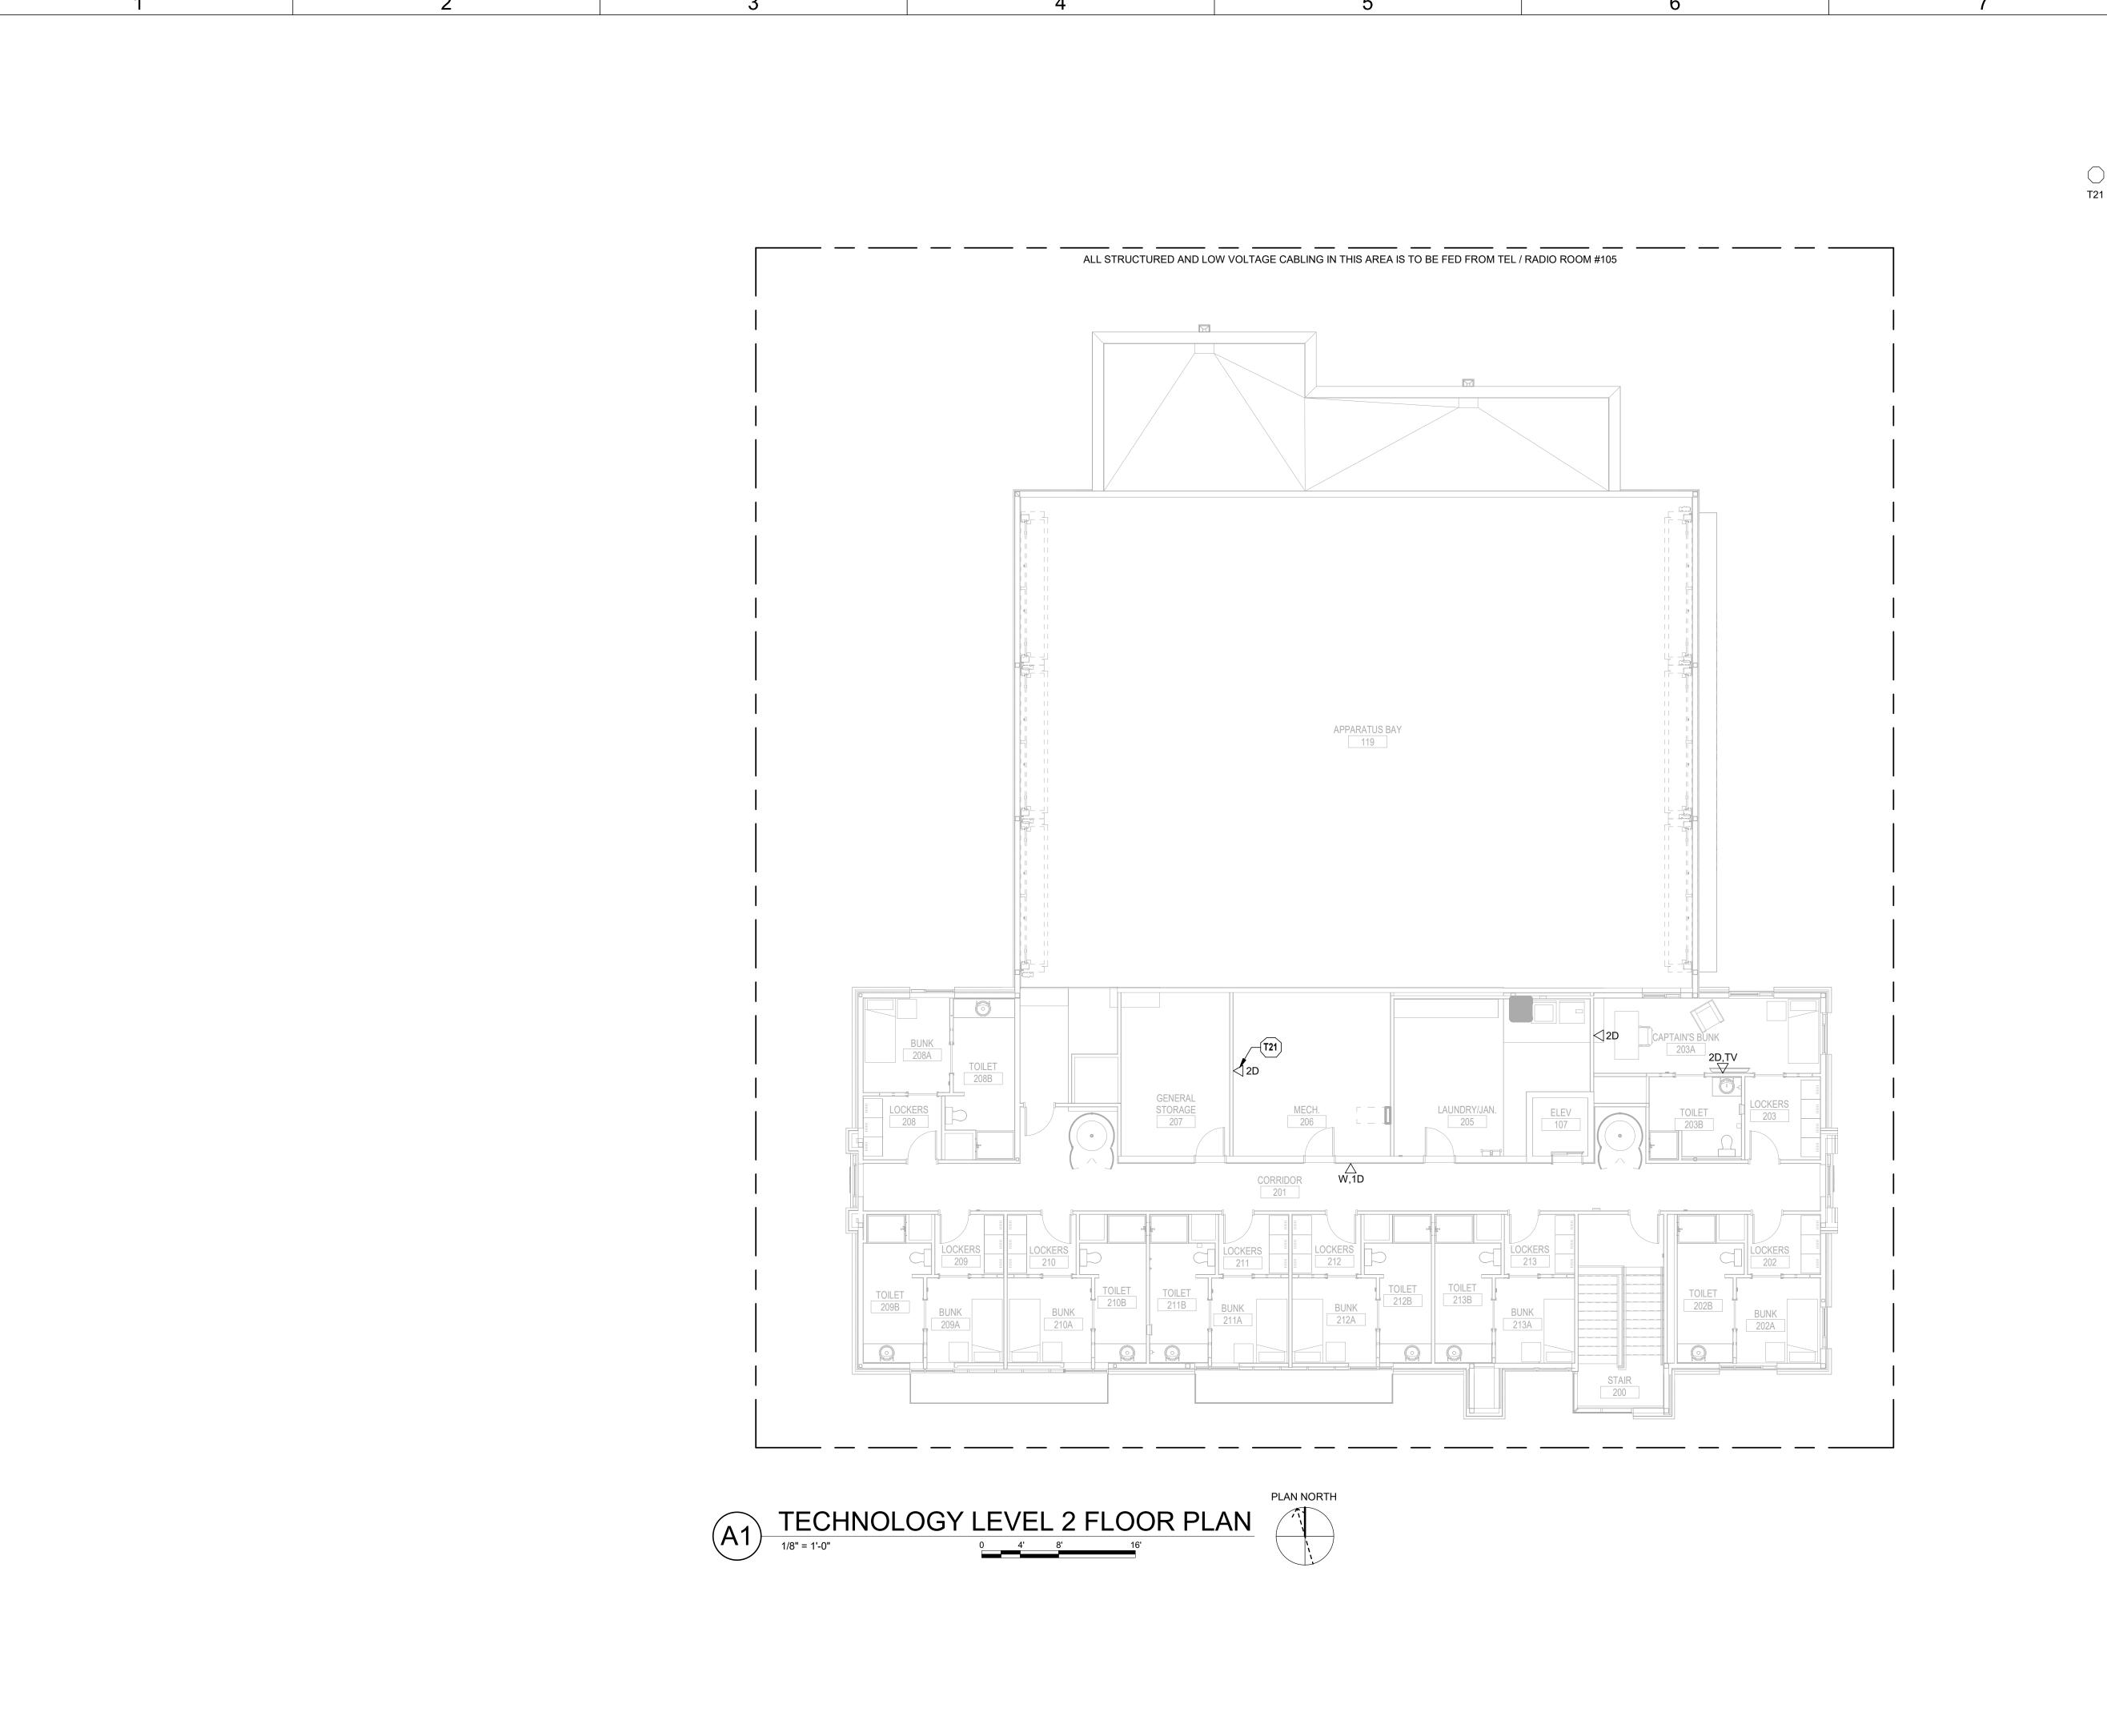

## TECHNOLOGY PLAN NOTES:

T21 PROVIDE DATA OUTLET FOR BMS CONTROL PANEL. REFER TO MECHANICAL SHEETS FOR FURTHER INFORMATION. COORDINATE WITH MECHANICAL CONTRACTOR ON EXACT HEIGHT AND LOCATION PRIOR TO INSTALLATION.

9229 WARD PARKWAY

SUITE # 210 KANSAS CITY, MO 64114 TEL: (816) 444-4200 FAX: (316) 265-5646

www.glmv.com GLMV ARCHITECTURE, INC. MISSOURI STATE CERTIFICATE OF AUTHORITY #000305

CONSULTING ARCHITECT LEMAY ERICKSON WILLCOX ARCHITECTS

11250 ROGER BACON DRIVE, SUITE 16 RESTON, VIRGINIA 20190 TEL: (703) 956-5600 CIVIL ENGINEER & LANDSCAPE ARCH.
GLMV ARCHITECTURE, INC
MISSOURI CIVIL COA #2018033898

MISSOURI LANDSCAPE COA #000008 9229 WARD PARKWAY, SUITE # 210 KANSAS CITY, MO 64114 TEL: (816) 444-4200


STRUCTURAL ENGINEER LEIGH + O'KANE MISSOURI COA #001644 250 NE MULBERRY, SUITE 201 LEE'S SUMMIT, MO 64086 (816) 444-3144

MECH., ELECT. & PLMG. ENGINEERS HOSS & BROWN ENGINEERS MISSOURI COA #01022 15902 MIDLAND DRIVE SHAWNEE, KS 66217 (913) 362.9090

SECURITY & IT ENGINEERS HENDERSON ENGINEERS MISSOURI COA #000556 1801 MAIN STREET, SUITE 300 KANSAS CITY, MO 64108 (816) 663-8700

5031 NORTHI LEE'S SUMMI

FIRE STATION #5 CITY OF LEE'S SUMMIT REVISIONS: # Description Date

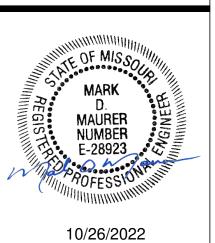

PROJECT NO:	2150001291		
DATE:	10.26.2022		
DRAWN BY:	J.CORONADO		
CHK'D BY:	M.MAURER		
© GLMV Architecture, Inc.  All work herein is the property of GLMV  Architecture, Inc. and is not to be copied or used in any way without the express written consent of GLMV Architecture, Inc.			
TEOLINIC	21.001/		


TECHNOLOGY LEVEL 2 PLAN


**TN102** 

HENDERSON ENGINEERS 8345 LENEXA DRIVE, SUITE 300 LENEXA, KS 66214 TEL 913.742.5000 FAX 913.742.5001

WWW.HENDERSONENGINEERS.COM

2150001291 MO. CORPORATE NO: E-556D EXPIRES 12/31/2022

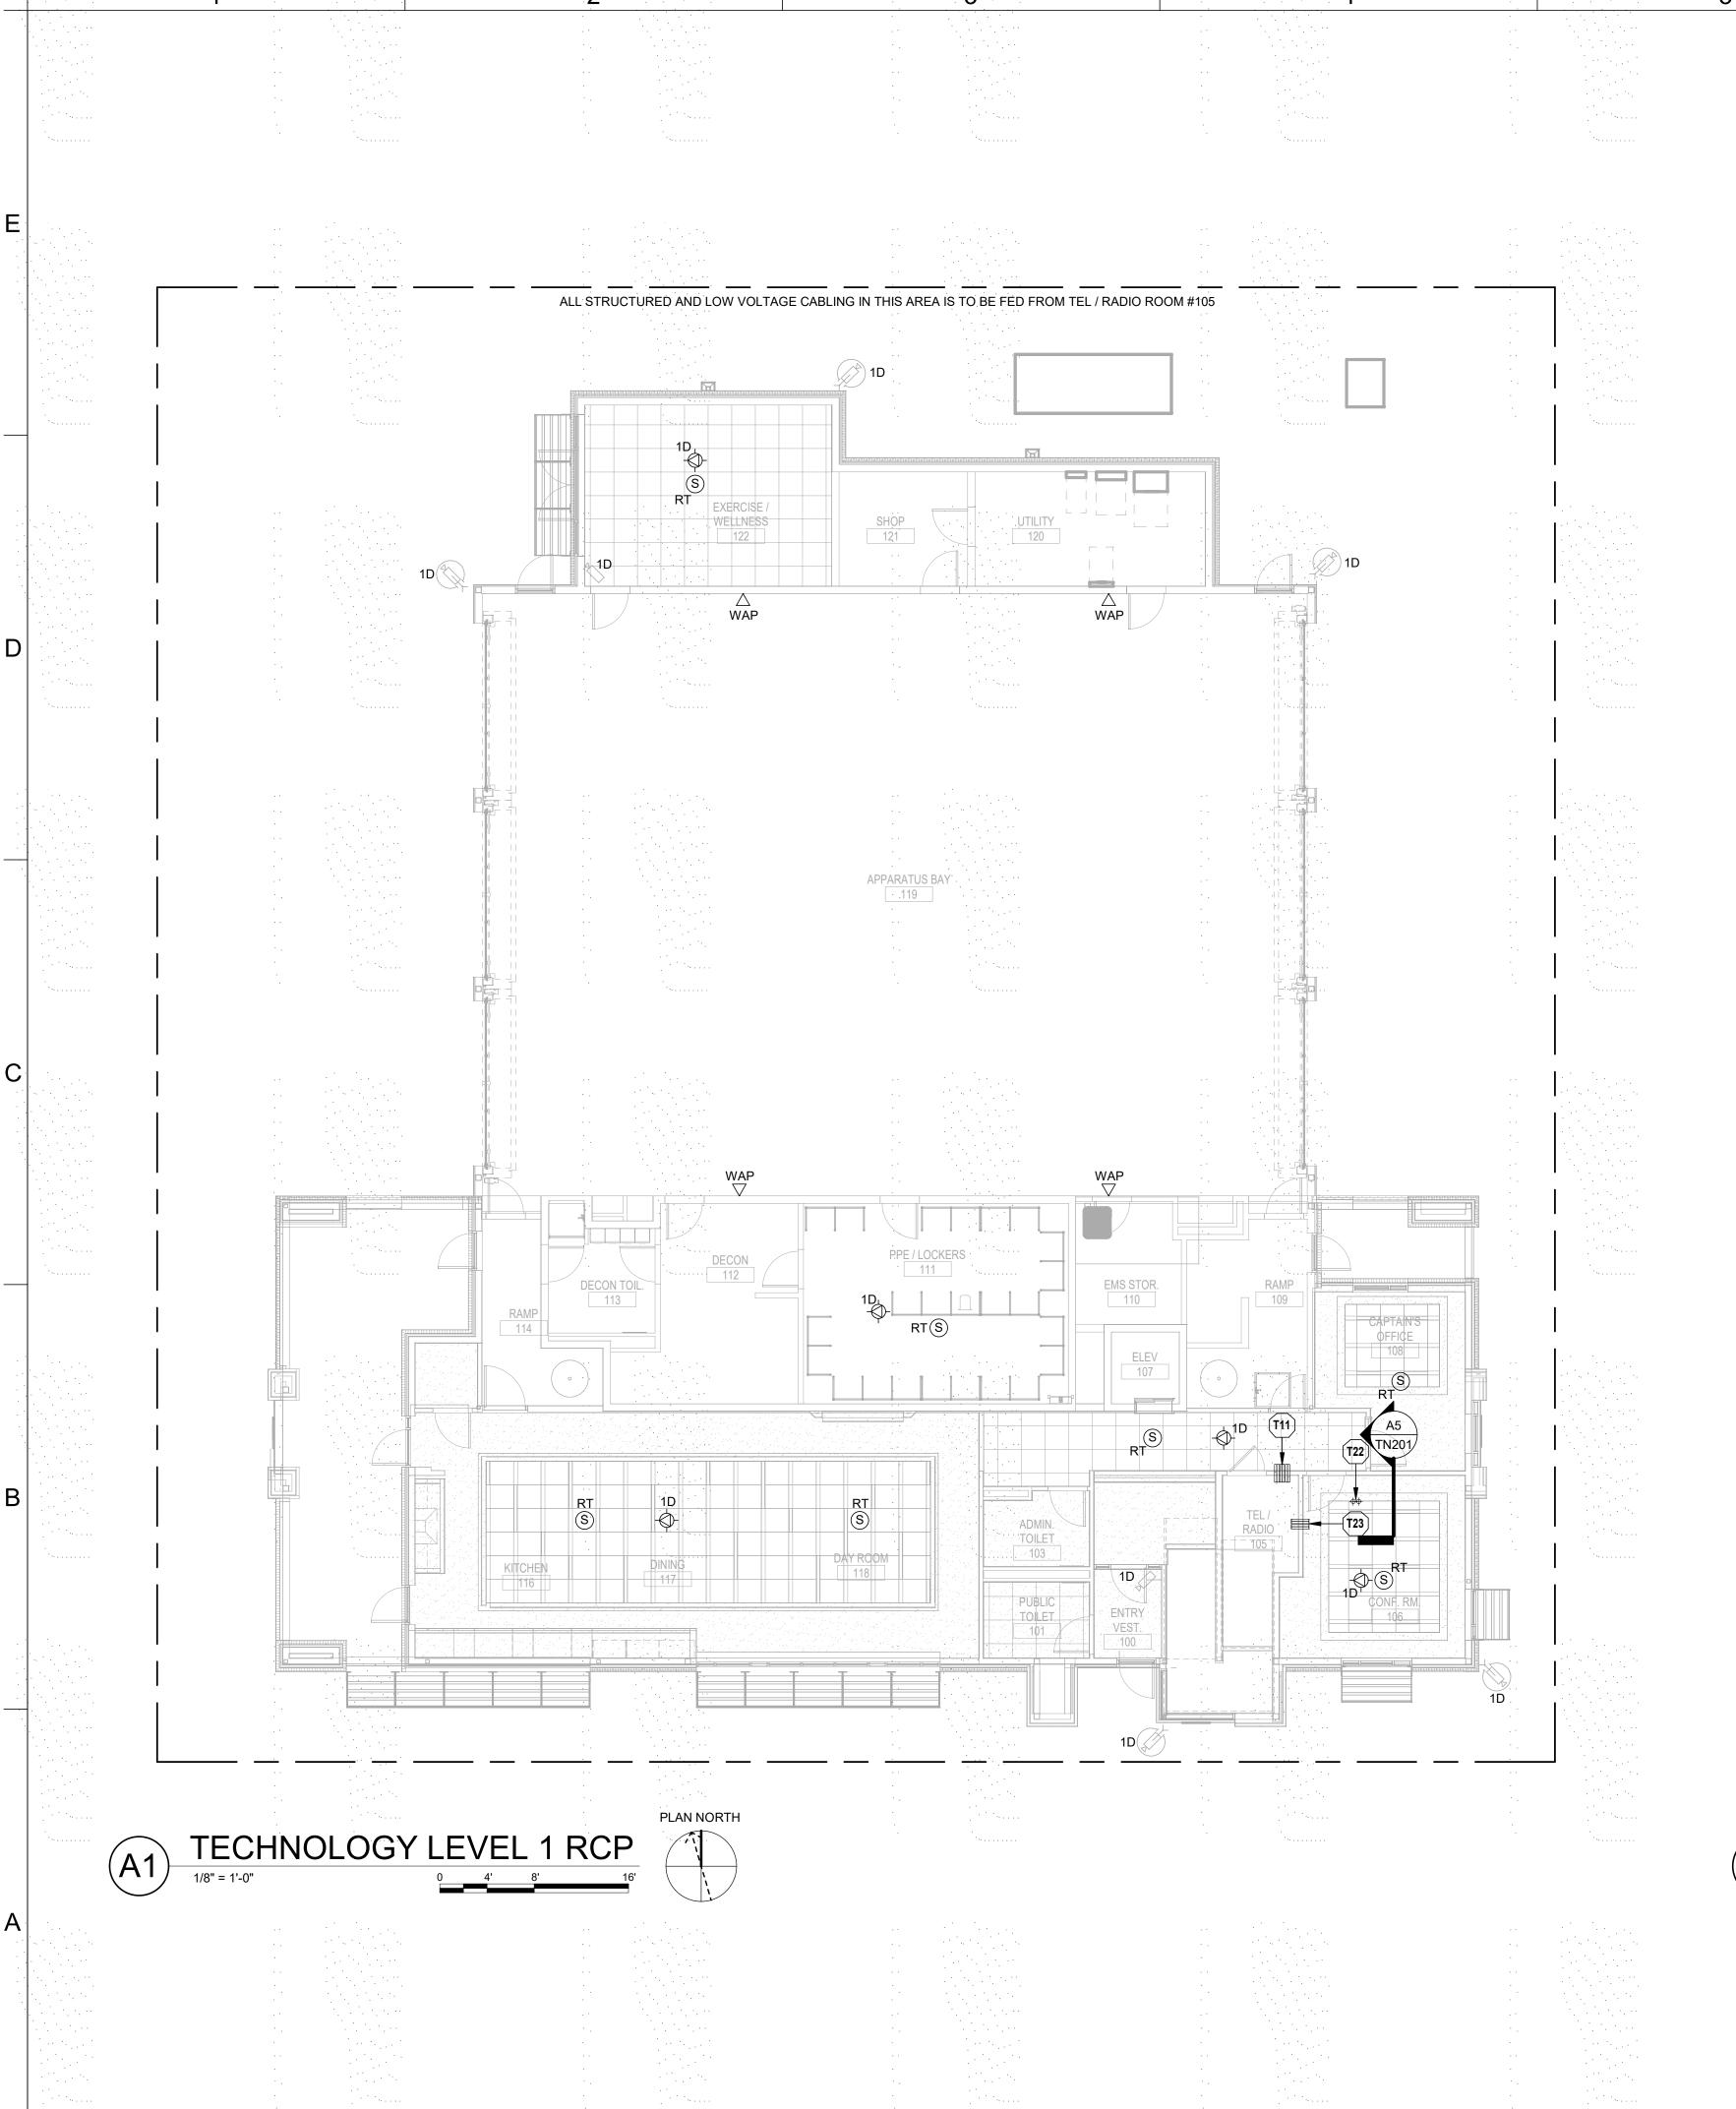

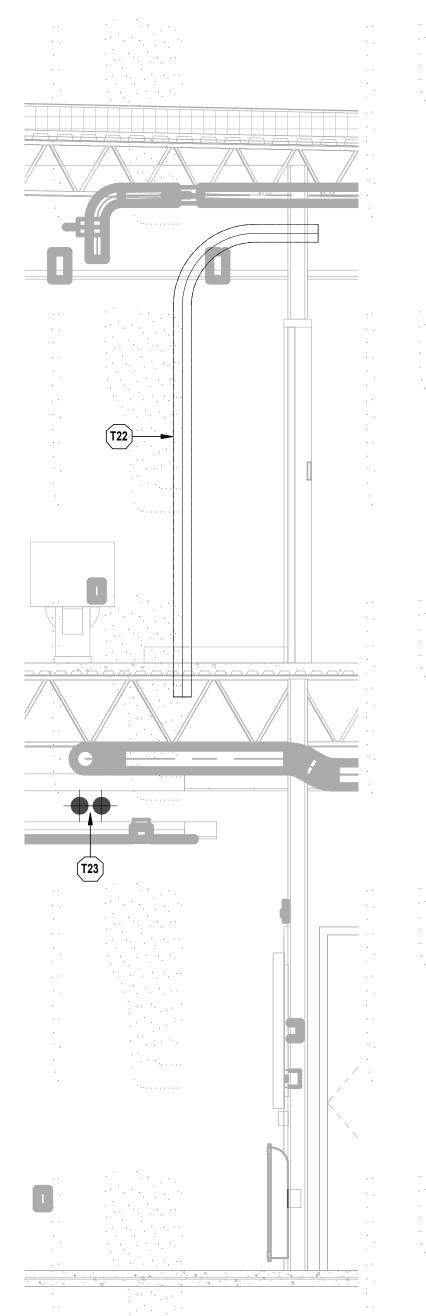







HENDERSON ENGINEERS 8345 LENEXA DRIVE, SUITE 300 LENEXA, KS 66214 TEL 913.742.5000 FAX 913.742.5001 WWW.HENDERSONENGINEERS.COM 2150001291 MO. CORPORATE NO: E-556D EXPIRES 12/31/2022

9229 WARD PARKWAY

8

( ) <u>TECHNOLOGY PLAN NOTES:</u>

FLOOR HORIZONTAL CABLING.

CABLING.

ROOM #105.

T11 PROVIDE (3) 4" FIRE-RATED CONDUITS FOR HORIZONTAL

T22 PROVIDE (2) 4" FIRE-RATED CONDUITS FOR 2ND FLOOR HORIZONTAL CABLING ORIGINATING FROM TEL / RADIO

T23 PROVIDE (2) 4" FIRE-RATED CONDUIT SLEEVES FOR 2ND

SUITE # 210 KANSAS CITY, MO 64114 TEL: (816) 444-4200 FAX: (316) 265-5646 www.glmv.com

GLMV ARCHITECTURE, INC. MISSOURI STATE CERTIFICATE OF AUTHORITY #000305 CONSULTING ARCHITECT LEMAY ERICKSON WILLCOX ARCHITECTS 11250 ROGER BACON DRIVE, SUITE 16

RESTON, VIRGINIA 20190 TEL: (703) 956-5600 CIVIL ENGINEER & LANDSCAPE ARCH. GLMV ARCHITECTURE, INC MISSOURI CIVIL COA #2018033898

MISSOURI LANDSCAPE COA #000008 9229 WARD PARKWAY, SUITE # 210 KANSAS CITY, MO 64114 TEL: (816) 444-4200 STRUCTURAL ENGINEER LEIGH + O'KANE MISSOURI COA #001644

250 NE MULBERRY, SUITE 201 LEE'S SUMMIT, MO 64086


(816) 444-3144 MECH., ELECT. & PLMG. ENGINEERS HOSS & BROWN ENGINEERS MISSOURI COA #01022 15902 MIDLAND DRIVE SHAWNEE, KS 66217

(913) 362.9090 SECURITY & IT ENGINEERS HENDERSON ENGINEERS MISSOURI COA #000556 1801 MAIN STREET, SUITE 300

KANSAS CITY, MO 64108 (816) 663-8700

FIRE STATION #5 CITY OF LEE'S SUMMIT 5031 NORTHI LEE'S SUMMI


REVISIONS: # Description Date

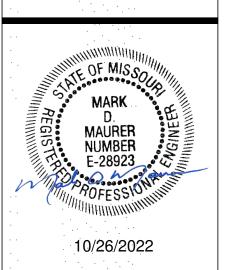

PROJECT NO: 2150001291 10.26.2022 DRAWN BY: J.CORONADO CHK'D BY: M.MAURER © GLMV Architecture, Inc.
All work herein is the property of GLMV
Architecture, Inc. and is not to be copied or used
in any way without the express written consent of
GLMV Architecture, Inc.

**TECHNOLOGY** LEVEL 1 RCP

**TN201** 

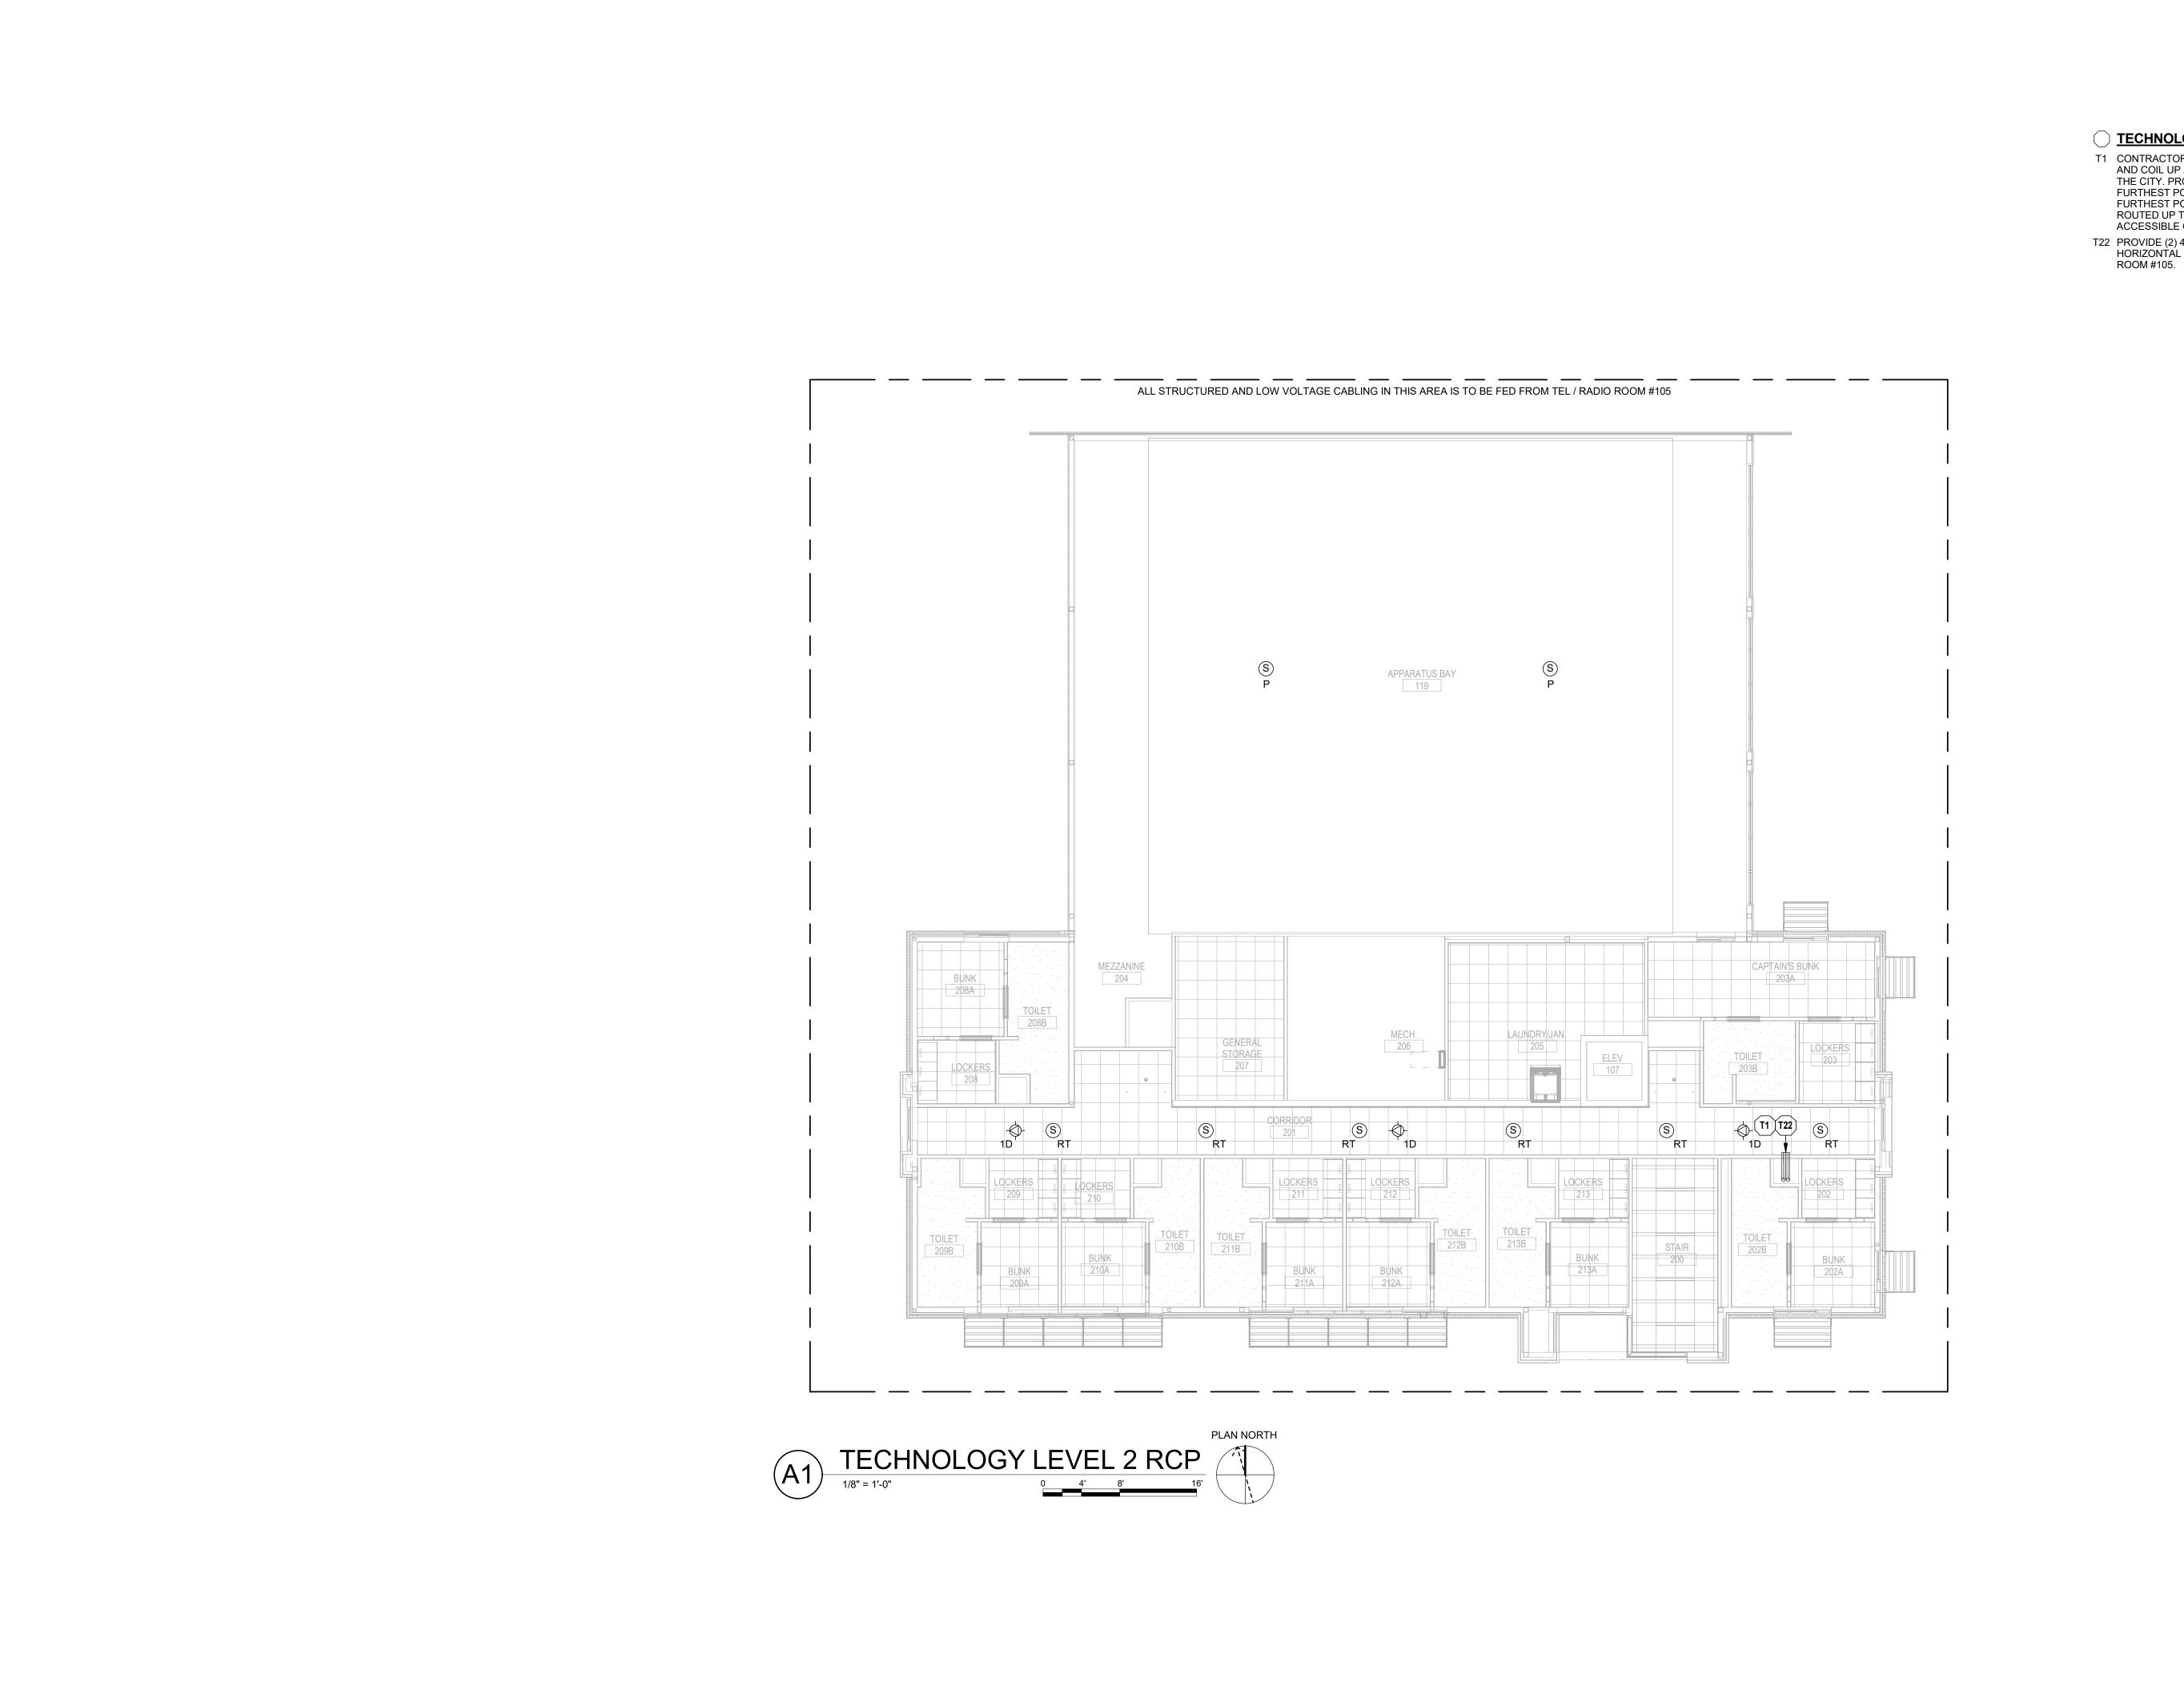



T22 PROVIDE (2) 4" FIRE-RATED CONDUITS FOR 2ND FLOOR



T1 CONTRACTOR TO PROVIDE AN ADDITIONAL 30 DATA CABLES AND COIL UP ABOVE CEILING FOR FUTURE TERMINATION BY THE CITY. PROVIDE ENOUGH SLACK TO REACH THE FURTHEST POINT WITHIN EACH ROOM SPECIFICALLY FURTHEST POINT OF APPARATUS BAY. CABLES ARE TO BE ROUTED UP THE CHASE NEXT TO THE STAIRWELL INTO ACCESSIBLE CEILING.

HORIZONTAL CABLING ORIGINATING FROM TEL / RADIO



FAX: (316) 265-5646 www.glmv.com GLMV ARCHITECTURE, INC. MISSOURI STATE CERTIFICATE OF AUTHORITY #000305

SUITE # 210 KANSAS CITY, MO 64114 TEL: (816) 444-4200

CONSULTING ARCHITECT LEMAY ERICKSON WILLCOX ARCHITECTS

11250 ROGER BACON DRIVE, SUITE 16 RESTON, VIRGINIA 20190 TEL: (703) 956-5600

CIVIL ENGINEER & LANDSCAPE ARCH.
GLMV ARCHITECTURE, INC MISSOURI CIVIL COA #2018033898 MISSOURI LANDSCAPE COA #000008 9229 WARD PARKWAY, SUITE # 210 KANSAS CITY, MO 64114 TEL: (816) 444-4200

STRUCTURAL ENGINEER LEIGH + O'KANE MISSOURI COA #001644 250 NE MULBERRY, SUITE 201 LEE'S SUMMIT, MO 64086 (816) 444-3144


MECH., ELECT. & PLMG. ENGINEERS HOSS & BROWN ENGINEERS MISSOURI COA #01022 15902 MIDLAND DRIVE SHAWNEE, KS 66217 (913) 362.9090

SECURITY & IT ENGINEERS HENDERSON ENGINEERS MISSOURI COA #000556 1801 MAIN STREET, SUITE 300 KANSAS CITY, MO 64108 (816) 663-8700

5031 NORTHI LEE'S SUMMI

REVISIONS: # Description Date

FIRE STATION #5 CITY OF LEE'S SUMMIT

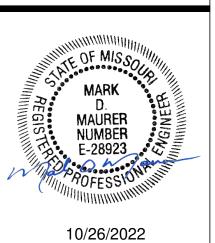


PROJECT NO:	2150001291		
DATE:	10.26.2022		
DRAWN BY:	J.CORONADO		
CHK'D BY:	M.MAURER		
© GLMV Architecture, Inc.  All work herein is the property of GLMV  Architecture, Inc. and is not to be copied or used in any way without the express written consent of GLMV Architecture, Inc.			

TECHNOLOGY HENDERSON ENGINEERS LEVEL 2 RCP 8345 LENEXA DRIVE, SUITE 300 LENEXA, KS 66214 TEL 913.742.5000 FAX 913.742.5001

WWW.HENDERSONENGINEERS.COM

2150001291 MO. CORPORATE NO: E-556D EXPIRES 12/31/2022

**TN202** 

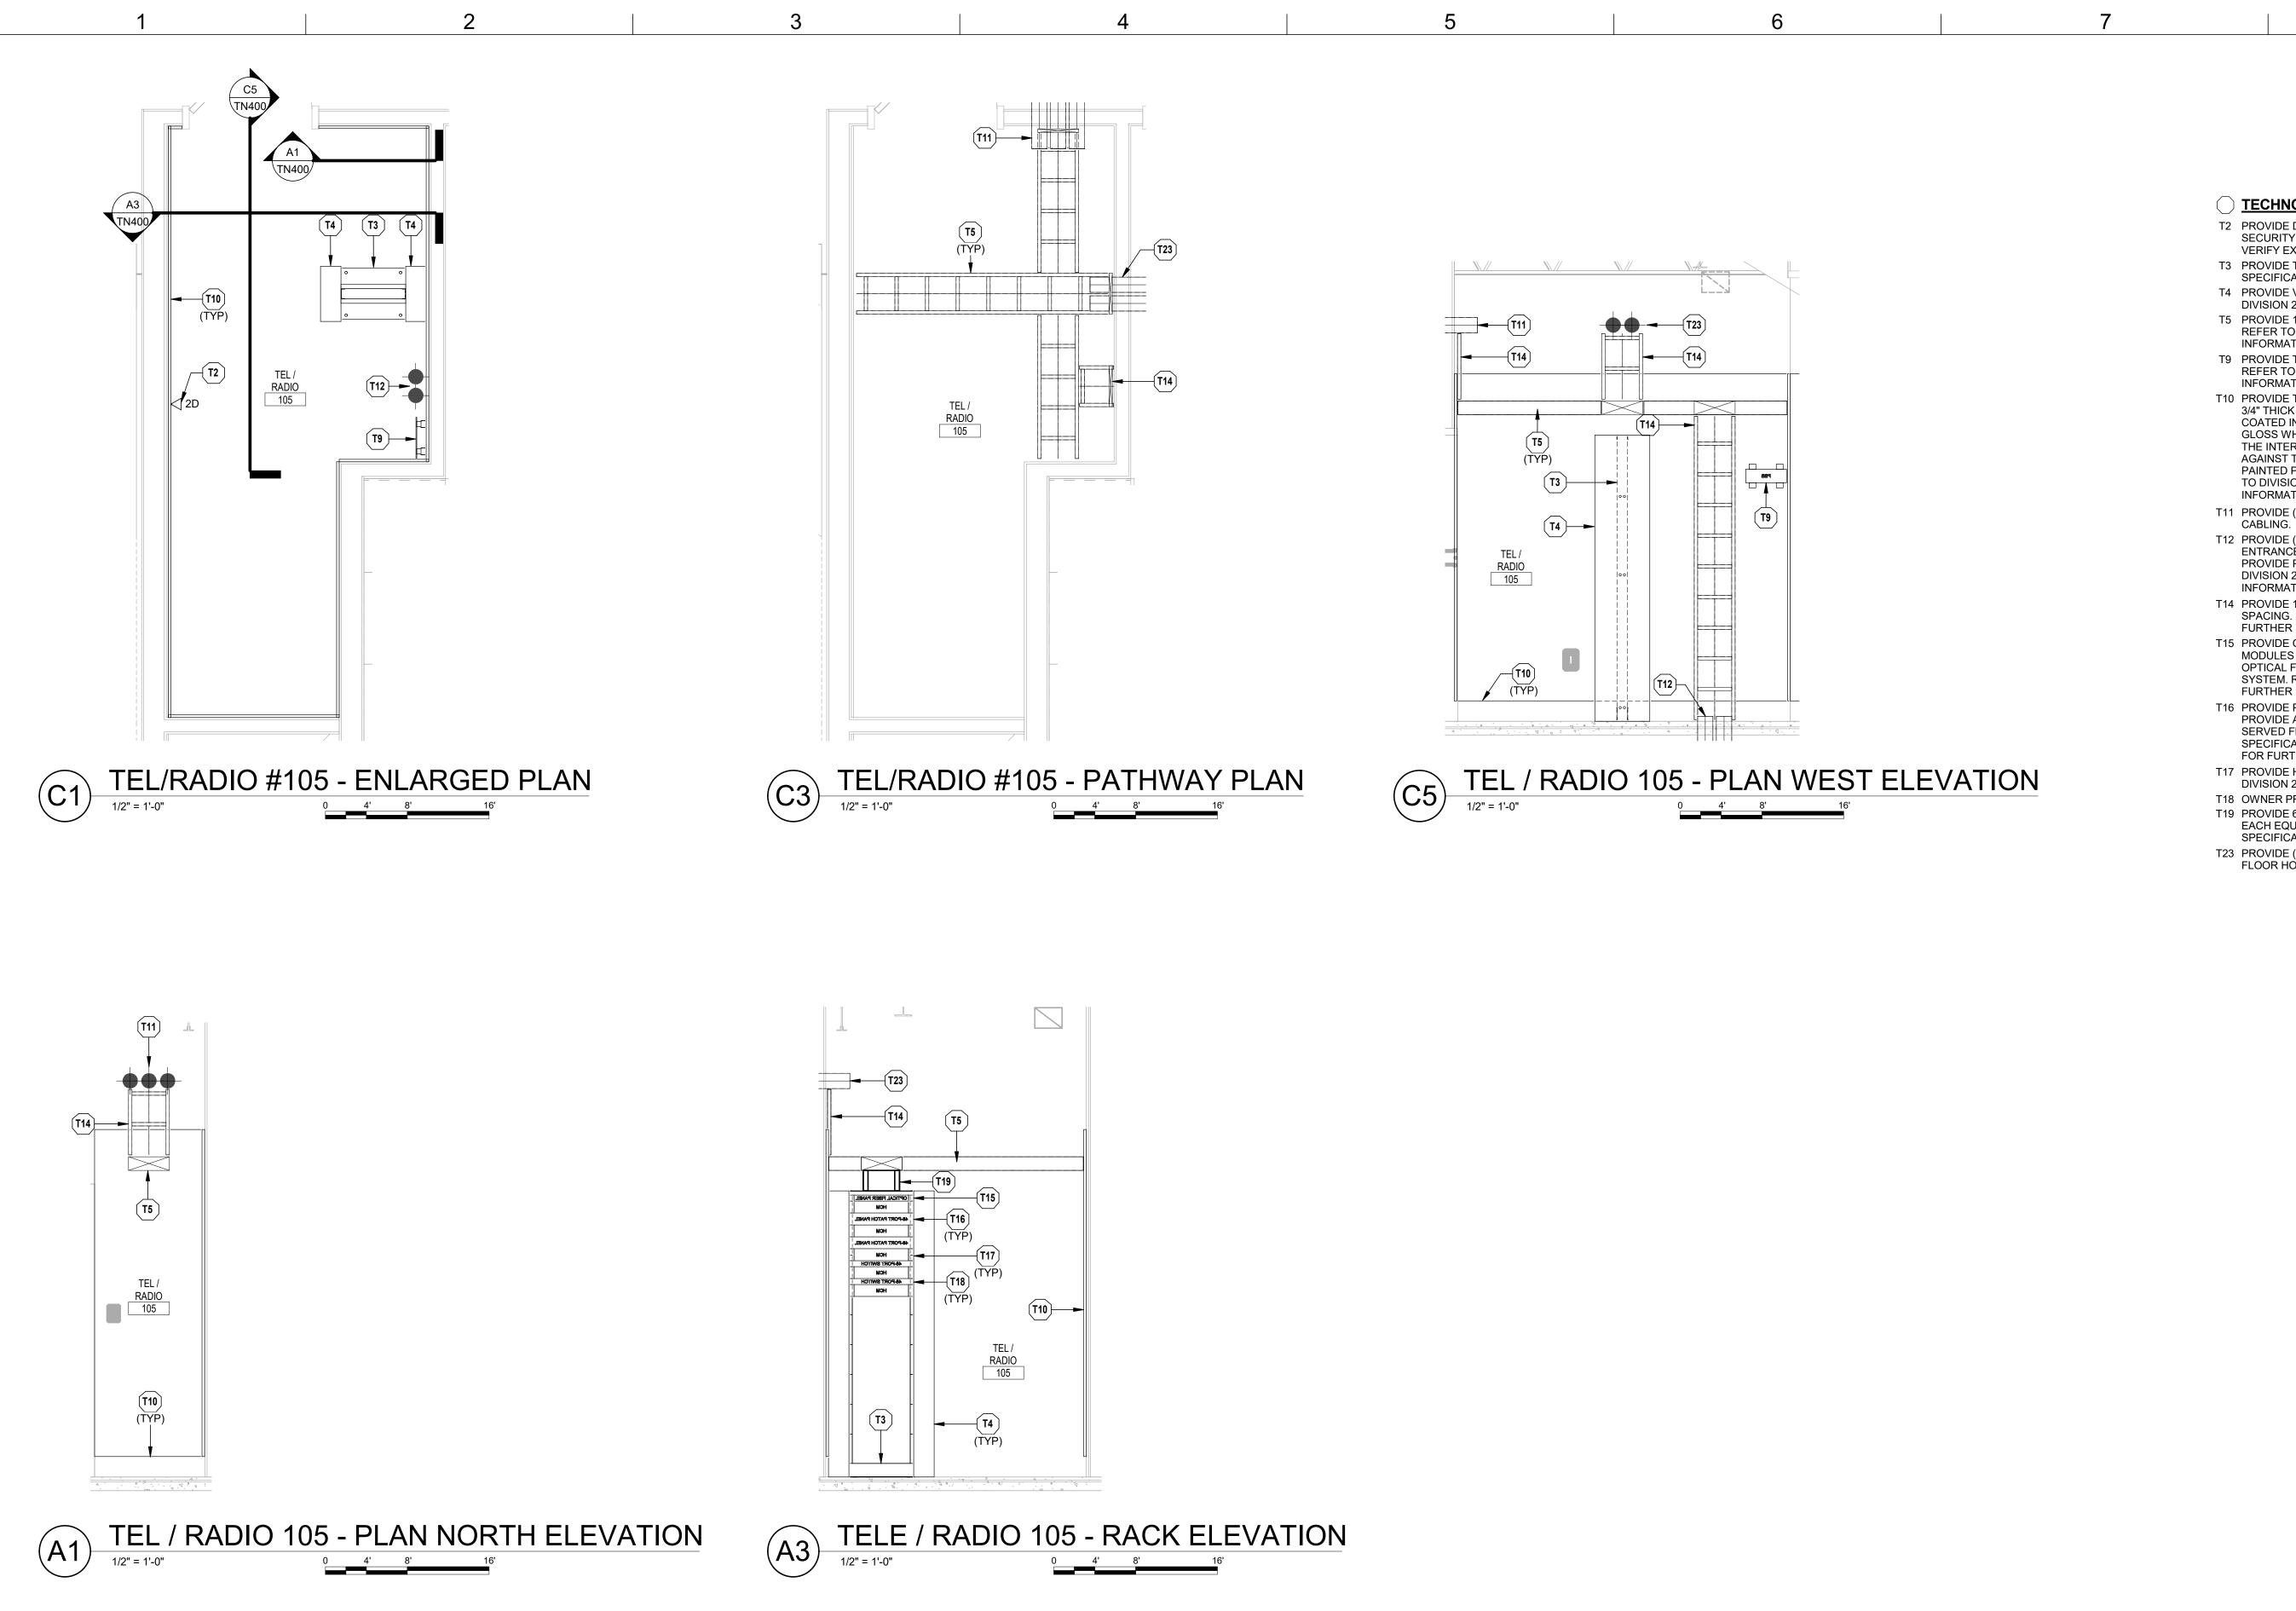

T2 PROVIDE DATA OUTLET FOR SECURITY SYSTEM. REFER TO SECURITY SHEETS FOR ADDITIONAL INFORMATION. FIELD VERIFY EXACT LOCATION WITH SECURITY PROVIDER.

T3 PROVIDE TWO-POST FLOOR RACK. REFER TO DIVISION 27 SPECIFICATIONS FOR FURTHER INFORMATION.

T4 PROVIDE VERTICAL CABLE MANAGEMENT. REFER TO

T5 PROVIDE 12" WIDE LADDER RACK WITH 9" RUNG SPACING. REFER TO DIVISION 27 SPECIFICATIONS FOR FURTHER

T9 PROVIDE TELECOMMUNICATIONS PRIMARY BUS BAR (PBB). REFER TO DIVISION 27 SPECIFICATIONS FOR FURTHER

T10 PROVIDE TELECOMMUNICATIONS BACKBOARD. GRADE A/C COATED IN UL 723 CLASSIFIED FIRE RETARDANT LOW THE INTERIOR OF THE ROOM AND THE C SIDE PLACED TO DIVISION 27 SPECIFICATIONS FOR FURTHER

T11 PROVIDE (3) 4" FIRE-RATED CONDUITS FOR HORIZONTAL

T12 PROVIDE (2) 4" SERVICE ENTRANCE CONDUITS FROM DIVISION 27 SPECIFICATIONS FOR ADDITIONAL

T15 PROVIDE OPTICAL FIBER ENCLOSURE, PANELS AND MODULES TO PROVIDE COMPLETE TERMINATION OF OPTICAL FIBER CABLES FOR A FULLY-FUNCTIONING SYSTEM. REFER TO DIVISION 27 SPECIFICATIONS FOR

T16 PROVIDE PATCH PANEL FOR HORIZONTAL CABLING. PROVIDE APPROPRIATE QUANTITY TO SUPPORT DEVICES SERVED FROM COMM ROOM PLUS SPARES AS NOTED IN SPECIFICATIONS. REFER TO DIVISION 27 SPECIFICATIONS

T19 PROVIDE 6" RUNWAY EXTENSION KIT AND A 3" TOP PLATE AT EACH EQUIPMENT RACK. REFER TO DIVISION 27

T23 PROVIDE (2) 4" FIRE-RATED CONDUIT SLEEVES FOR 2ND FLOOR HORIZONTAL CABLING.

TECHNOLOGY PLAN NOTES:

DIVISION 27 SPECIFICATIONS FOR FURTHER INFORMATION.

T14 PROVIDE 12" WIDE VERTICAL LADDER RACK WITH 9" RUNG SPACING. REFER TO DIVISION 27 SPECIFICATIONS FOR FURTHER INFORMATION.

FURTHER INFORMATION.

DIVISION 27 SPECIFICATIONS FOR FURTHER INFORMATION. T18 OWNER PROVIDED NETWORK SWITCH.

SPECIFICATIONS FOR FURTHER INFORMATION.

INFORMATION.

INFORMATION.

3/4" THICK FIRE RATED PLYWOOD BACKBOARDS DOUBLE GLOSS WHITE PAINT. THE "A" SIDE SHALL BE EXPOSED TO AGAINST THE BUILDING STRUCTURE. PLYWOOD SHALL BE PAINTED PRIOR TO INSTALLATION OF EQUIPMENT. REFER INFORMATION.

ENTRANCE FACILITY TO 5'-0" OUTSIDE OF BUILDING. PROVIDE PULL STRING. REFER TO CIVIL SITE PLANS AND INFORMATION.

FOR FURTHER INFORMATION.

T17 PROVIDE HORIZONTAL CABLE MANAGEMENT. REFER TO

ARCHITECTS 11250 ROGER BACON DRIVE, SUITE 16 RESTON, VIRGINIA 20190 TEL: (703) 956-5600

CIVIL ENGINEER & LANDSCAPE ARCH. GLMV ARCHITECTURE, INC MISSOURI CIVIL COA #2018033898 MISSOURI LANDSCAPE COA #000008

CONSULTING ARCHITECT

LEMAY ERICKSON WILLCOX

9229 WARD PARKWAY, SUITE # 210 KANSAS CITY, MO 64114 TEL: (816) 444-4200

9229 WARD PARKWAY SUITE # 210 KANSAS CITY, MO 64114 TEL: (816) 444-4200 FAX: (316) 265-5646

www.glmv.com GLMV ARCHITECTURE, INC. MISSOURI STATE CERTIFICATE OF AUTHORITY #000305


STRUCTURAL ENGINEER LEIGH + O'KANE MISSOURI COA #001644 250 NE MULBERRY, SUITE 201 LEE'S SUMMIT, MO 64086 (816) 444-3144

MECH., ELECT, & PLMG, ENGINEERS HOSS & BROWN ENGINEERS MISSOURI COA #01022 15902 MIDLAND DRIVE SHAWNEE, KS 66217 (913) 362.9090

SECURITY & IT ENGINEERS HENDERSON ENGINEERS MISSOURI COA #000556 1801 MAIN STREET, SUITE 300 KANSAS CITY, MO 64108 (816) 663-8700

FIRE STATIC CITY OF LEE'S 5031 NORTHI LEE'S SUMMI

REVISIONS: # Description Date

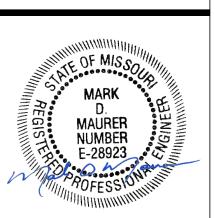

10/26/2022

PROJECT NO:	2150001291				
DATE:	10.26.2022				
DRAWN BY:	J.CORONADO				
CHK'D BY:	M.MAURER				
© GLMV Architecture, Inc. All work herein is the property of GLMV					

Architecture, Inc. and is not to be copied or used in any way without the express written consent of GLMV Architecture, Inc. **ENLARGED** 


**PLANS** 


HENDERSON ENGINEERS

8345 LENEXA DRIVE, SUITE 300 LENEXA, KS 66214 TEL 913.742.5000 FAX 913.742.5001

WWW.HENDERSONENGINEERS.COM

2150001291 MO. CORPORATE NO: E-556D EXPIRES 12/31/2022

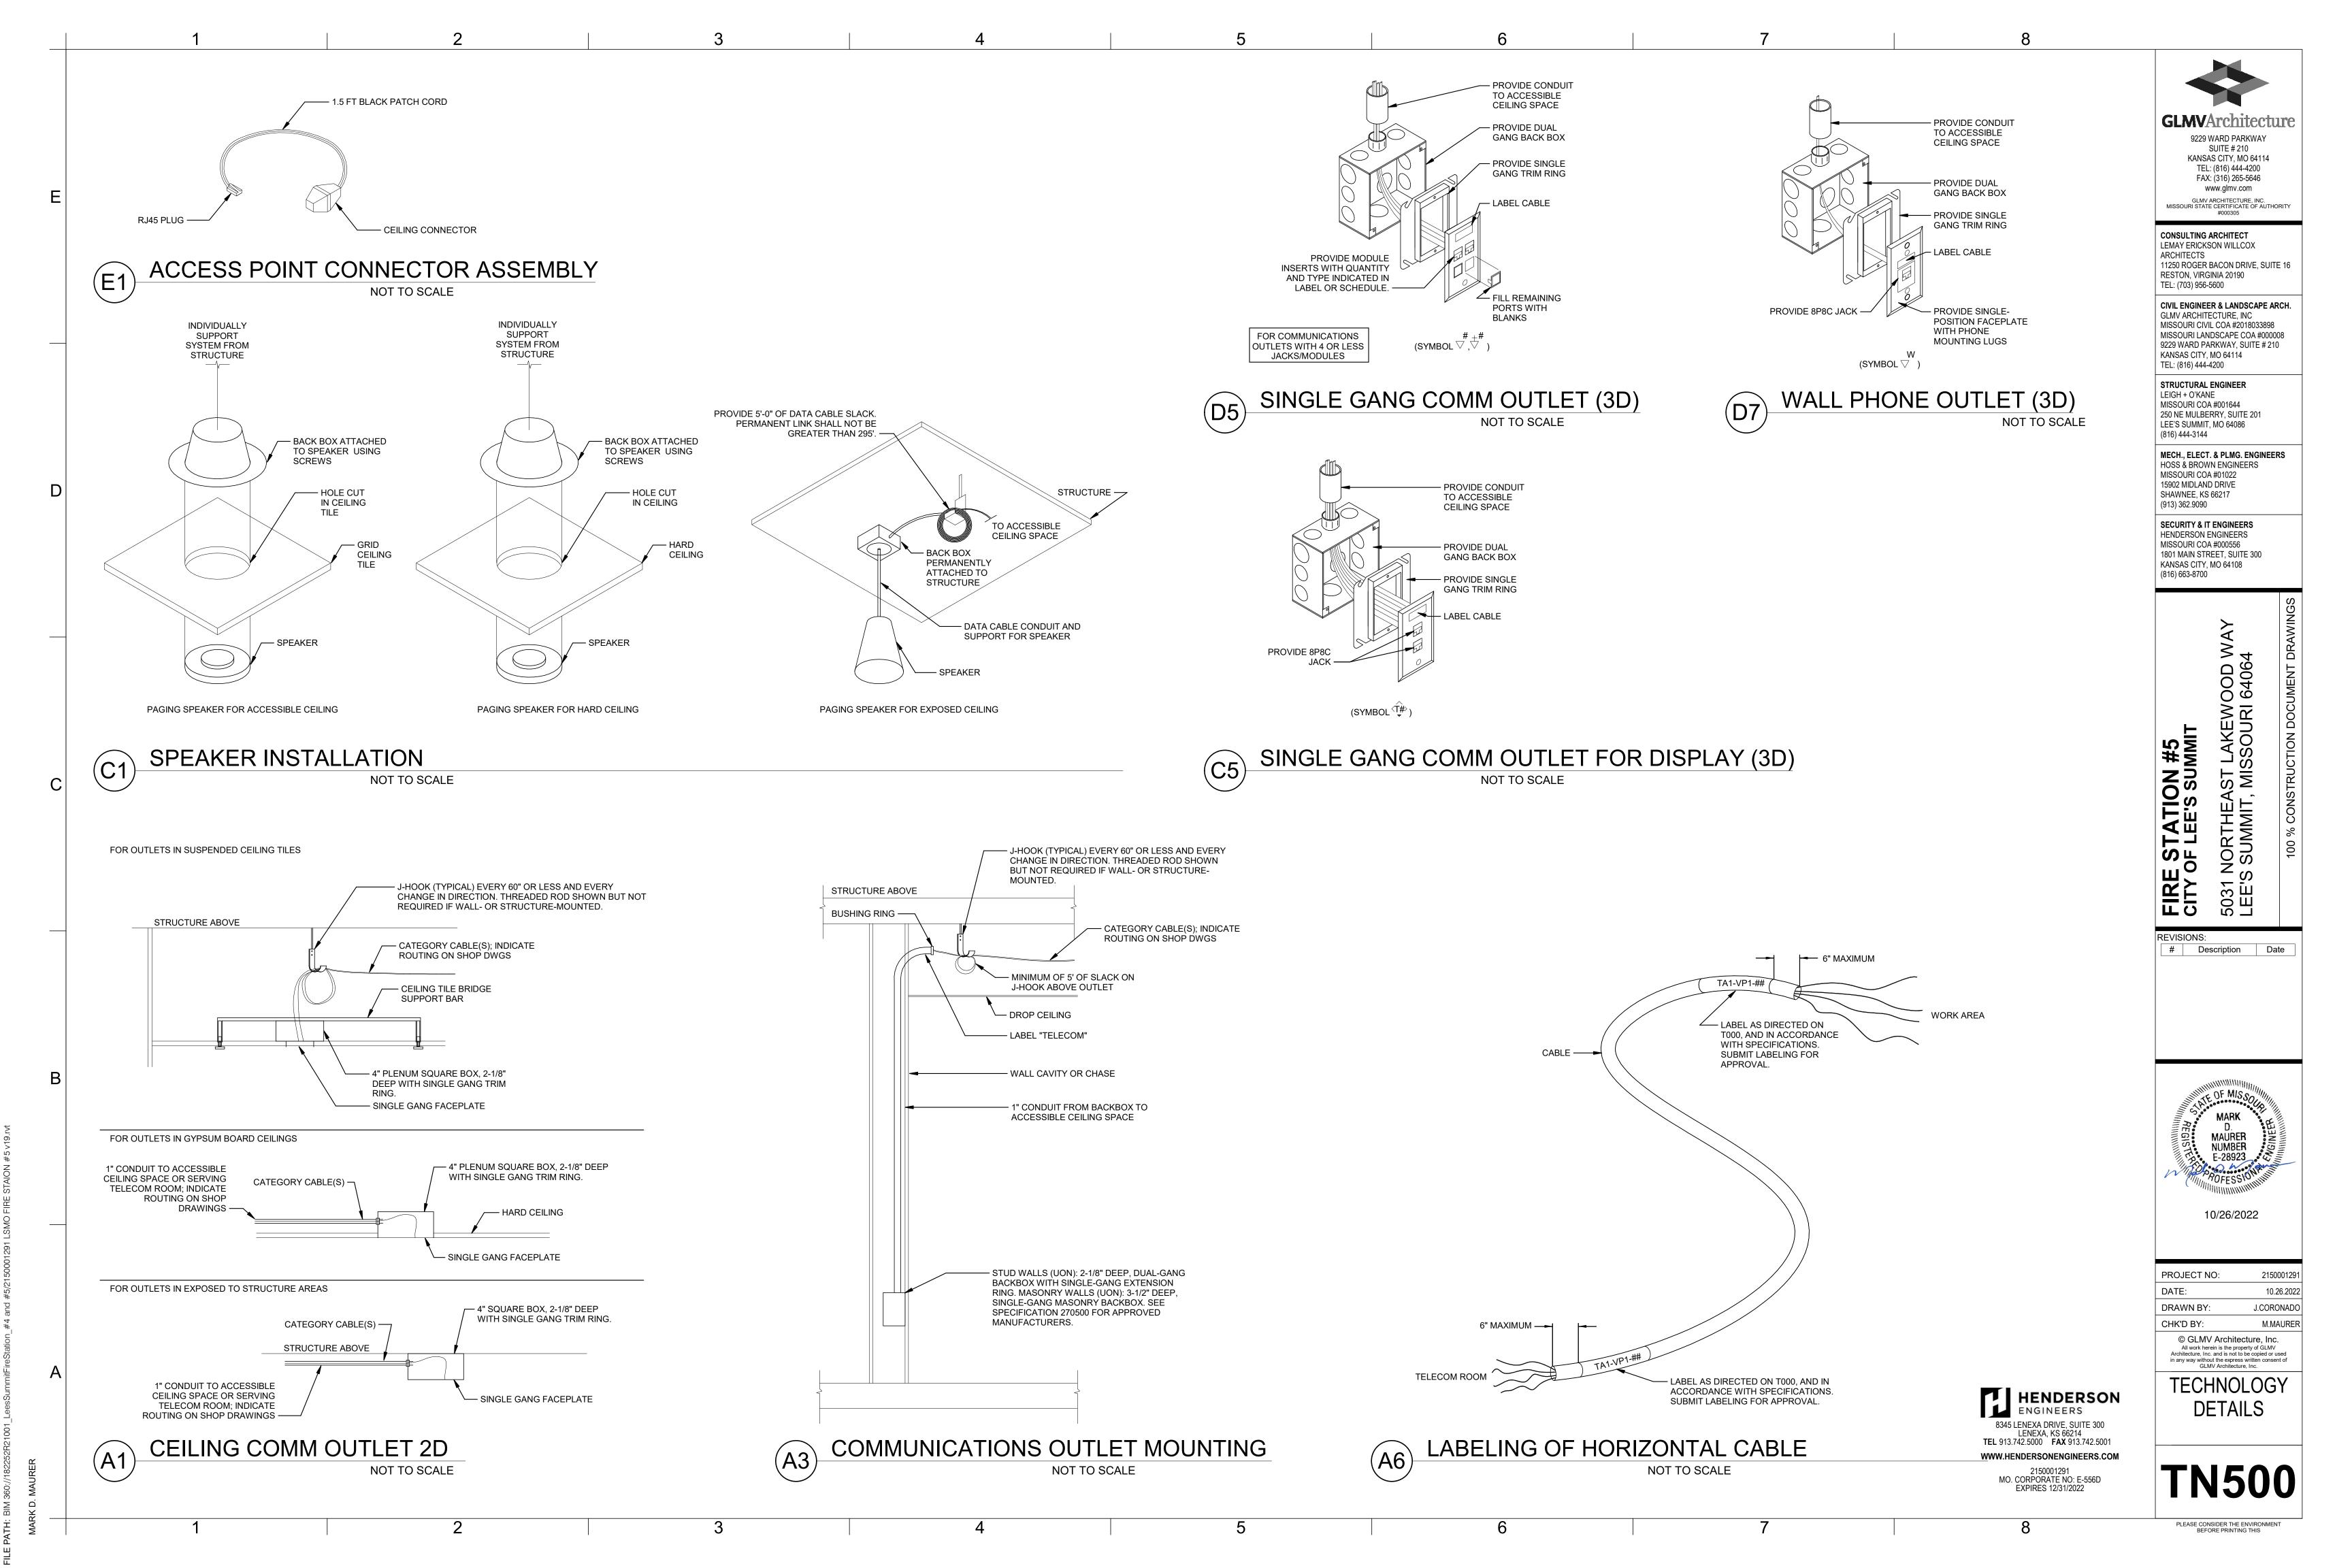

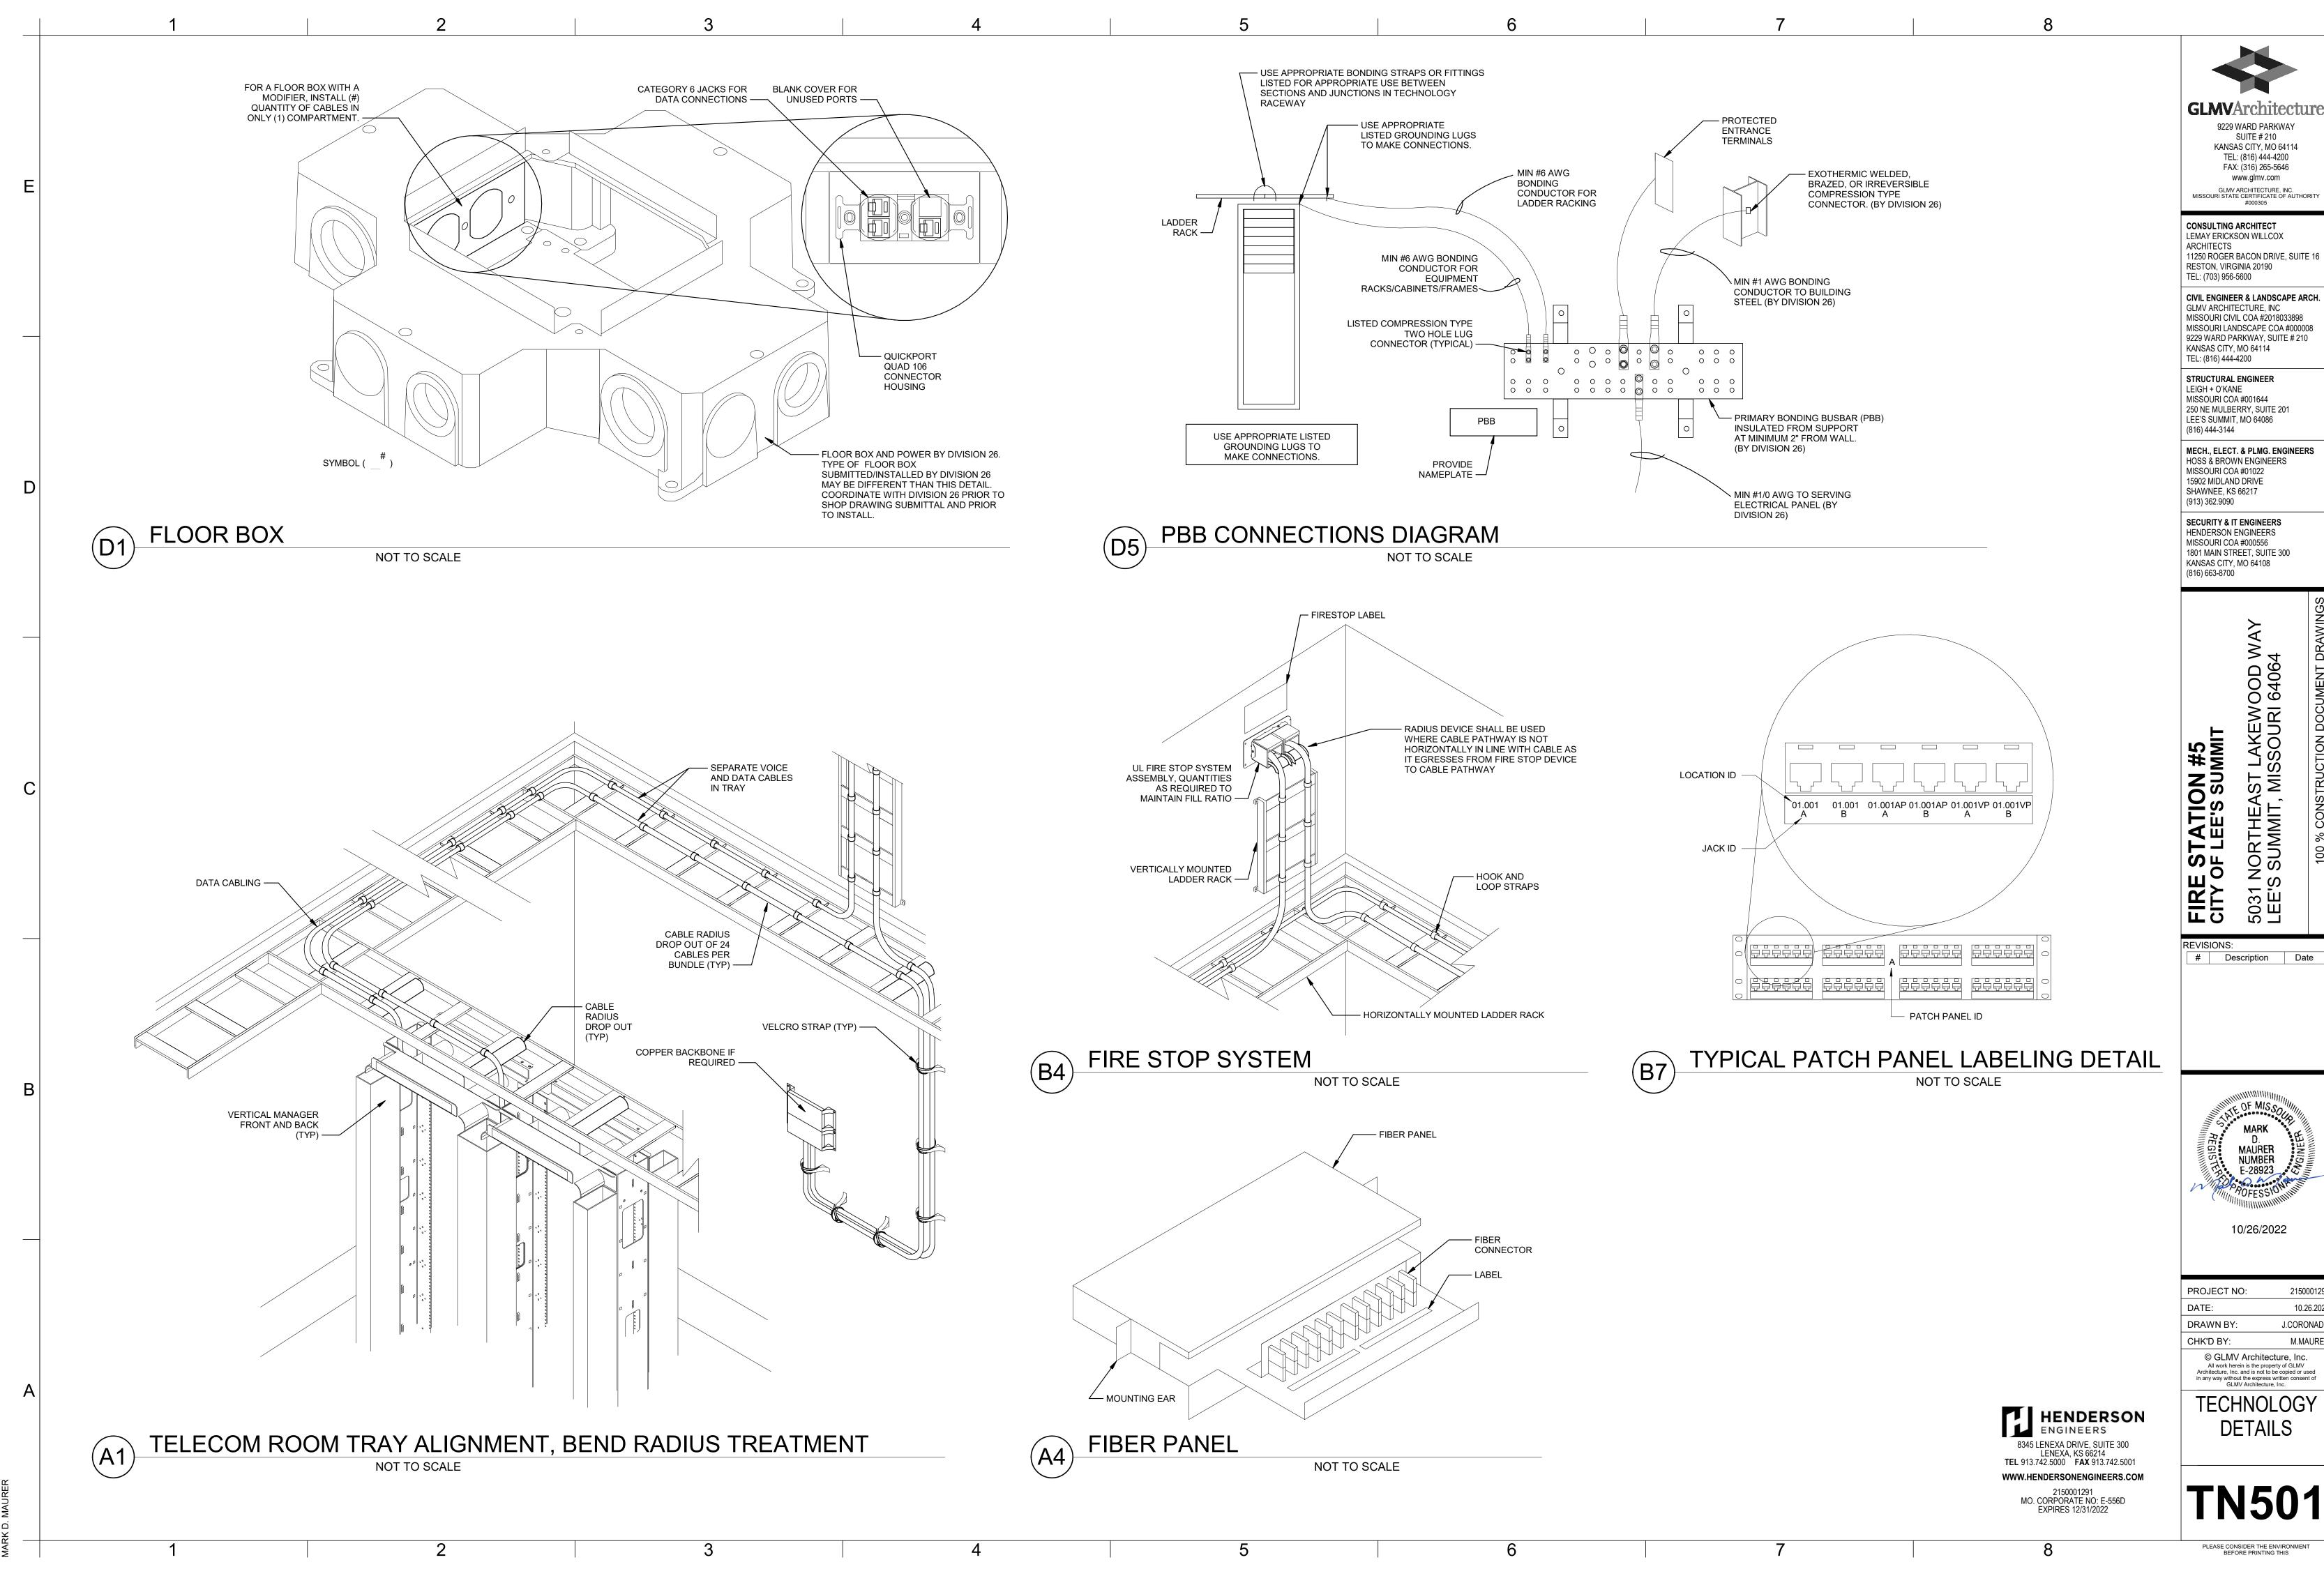

KANSAS CITY, MO 64114

11250 ROGER BACON DRIVE, SUITE 16

CIVIL ENGINEER & LANDSCAPE ARCH. MISSOURI CIVIL COA #2018033898 MISSOURI LANDSCAPE COA #000008 9229 WARD PARKWAY, SUITE # 210

MECH., ELECT. & PLMG. ENGINEERS

PROJECT NO:	2150001291
DATE:	10.26.2022
DRAWN BY:	J.CORONADO
CHK'D BY:	M.MAURER
© GLMV Arch All work herein is the Architecture, Inc. and is n in any way without the exp GLMV Archite	property of GLMV ot to be copied or used ress written consent of

**TN501** 

	ND NOT ALL SYMBOLS OR ABBR									V2
ANDARD MOUNTING HEIGITERCOM (OPERABLE PART)	HTS 48"	SECURITY SYMBOLS	CAMERA TYPE S	SCHEDULE		IMAGER SIZE				
RD READER (CENTER OR TOP WH RTS EXIST)	ERE OPERABLE 48"	AREA OF REFUGE CALL BOX  CR PROXIMITY CARD READER	TYPE FACTOR	DESCRIPTION	LOCATIONS	RESOLUTION	POWER	MODELS	COLOR	COMMENTS  DEVICES FOR REFERENCE ONLY. CONTRACTOR TO PROVIDE BACK
IERGENCY LOCK RELEASE IERGENCY PHONE (OPERABLE PAI FAULT MOUNTING HEIGHTS SHOW	•	CW CLIENT WORKSTATION WHERE X = NUMBER OF MONITORS (AC) ACCESS CONTROL	01	VANDAL DOME CAMERA	INDOOR/ OUTDOOR	5MP	POE	AVIGILON H5A	WHITE	BOX, CABLING, AND ALL PATHWAY. DEVICES, MOUNTING HARDWARE, AND CONFIGURATION BY ADS.
OVIDED. MOUNTING HEIGHTS LIST ABOVE FINISHED GRADE (AFG). A	ED ARE ABOVE FINISHED FLOOR (AFF) LL DEVICES SHALL BE INSTALLED IN	(SM) SECURITY MANAGEMENT (TS) TOUCHSCREEN CONTROL		360 DEGREE MULTISENSOR	OUTDOOR	MULTI-	НРОЕ	AVIGILON 360°	WHITE	DEVICES FOR REFERENCE ONLY. CONTRACTOR TO PROVIDE BACK BOX, CABLING, AND ALL PATHWAY. DEVICES, MOUNTING
MPLIANCE WITH CURRENT ADÁ AN BREVIATIONS	ID LOCAL REQUIREMENTS.	(VS) VIDEO SURVEILLANCE  DA DOOR ANNUCATOR	CARD READER	CAMERA TYPE SCHEDULE		SENSOR				HARDWARE, AND CONFIGURATION BY ADS.
AMPS ACCESS CONTROL PANEL	KVM KEYBOARD VIDEO MOUSE SWITCH	(DB) DOOR BELL	FORM TYPE FACTOR	TECHNOLOGY	LOCATIONS	READ RANGE	POWER	MODELS	COLOR	COMMENTS
AMERICANS WITH DISABILITIES ACT	LAN LOCAL AREA NETWORK LED LIGHT-EMITTING DIODE LF LINEAR FEET	(CH) CHIME	THE TACTOR		INDOOR/	TOTOL				DEVICES FOR REFERENCE ONLY. CONTRACTOR TO PROVIDE BACK BOX, CABLING, AND ALL PATHWAY. DEVICES, MOUNTING
ABOVE FINISHED CEILING ABOVE FINISHED FLOOR ABOVE FINISHED GRADE	MBS MAINTENANCE BYPASS SWITCH	DM DOOR POSITION SWITCH ONLY SEE ARCHITECTURAL DOOR HARDWARE SCHEDULE	01	RFID	OUTDOOR/		PANEL	HID SIGNO 40	BLACK	HARDWARE, AND CONFIGURATION BY ADS.
AUTHORITY HAVING JURISDICTION AMERICAN NATIONAL	MDF MAIN DISTRIBUTION FRAME MFR MANUFACTURER MH MAINTENANCE HOLE	DL DOOR POSITION SWITCH AND LATCHBOLT MONITOR SEE ARCHITECTURAL DOOR HARDWARE SCHEDULE	02	RFID	INDOOR/ OUTDOOR		PANEL	HID SIGNO 20	BLACK	DEVICES FOR REFERENCE ONLY. CONTRACTOR TO PROVIDE BACK BOX, CABLING, AND ALL PATHWAY. DEVICES, MOUNTING HARDWARE, AND CONFIGURATION BY ADS.
STANDARDS INSTITUTE AUDIO-VIDEO	MM MULTIMODE MPOE MAIN POINT OF ENTRANCE	ELECTRIFIED LOCKING DEVICE, REQUEST TO EXIT, DOOR POSITION SWITCH, AND LATCH BOLT MONITOR	INTERCOM TYP	E SCHEDULE	33123311					
AMERICAN WIRE GAUGE BUILDING AUTOMATION SYSTEM	MPOP MAIN POINT OF PRESENCE MTD MOUNTED N/A NOT APPLICABLE	SEE ARCHITECTURAL DOOR HARDWARE SCHEDULE	TYPE FACTOR	DESCRIPTION	LOCATIONS	SPEAKER	POWER	MODELS	COLOR	COMMENTS
BUILDING DISTRIBUTOR BUILDING DISTRIBUTION FRAME	NEC NATIONAL ELECTRICAL CODE NFPA NATIONAL FIRE PROTECTION ASSOCATION	SEE ARCHITECTURAL DOOR HARDWARE SCHEDULE		IP ADDRESSABLE VIDEO DOOR	INDOOR/	HANDS-FREE	POE		BLACK	DEVICES FOR REFERENCE ONLY. CONTRACTOR TO PROVIDE BACK BOX, CABLING, AND ALL PATHWAY. DEVICES, MOUNTING
BELOW FINISHED CEILING BIOMETRIC READER	NIC NOT IN CONTRACT nm NANOMETER	(EP) EMERGENCY PHONE (GB) GLASS BREAK DETECTOR		STATION	OUTDOOR					HARDWARE, AND CONFIGURATION BY ADS.
CONDUIT CATEGORY CENTRAL CONTROL	NRTL NATIONALLY RECOGNIZED TESTING LAB NVR NETWORK VIDEO	IC INTERCOM								
CLOSED CIRCUIT TELEVISION	RECORDER OC ON CENTER	(CR) WITH CARD READER (DS) DOOR STATION (RS) RECEIVING (MASTER) STATION								
CAMPUS DISTRIBUTOR COMMUNICATIONS PLENUM JACKET	OSHA OCCUPATIONAL SAFETY AND HEALTH ADMINISTRATION OSP OUTSIDE PLANT	(VS) VIDEO STATION								
COMMUNICATIONS RISER JACKET	POE POWER OVER ETHERNET PON PASSIVE OPTICAL NETWORK	(IP) INMATE PHONE   (KP) KEYPAD								
REMOTE DEVICE DISTRIBUTED ANTENNA SYSTEM	QTY QUANTITY (R) RELOCATED EXISTING DEVICE (RE) REMOVE EXISTING DEVICE	(ID) INTRUSION DETECTION SYSTEM (AC) ACCESS CONTROL								
DECIBELS DOOR CONTROL SYSTEM	AND INSTALL AT ANOTHER LOCATION, SEE (R)	(LC) LIGHTING CONTROL RELAYS								
DEMOLITION DIGITAL SIGNAL PROCESSOR	RMC RIGID METAL CONDUIT RMS REMOTE MONITORING STATION	MD MOTION DETECTOR								
DIGITAL VIDEO RECORDER EXISTING DEVICE	RU RACK UNIT SCS STRUCTURED CABLING	PANIC ALARM THREE-COLOR INDICATOR LIGHT  PB PANIC/DURESS BUTTON								
ELECTRICAL CONTRACTOR ELECTRONIC OMPONENTS INDUSTRY ASSOCIATION	SYSTEM SF SQUARE FEET SM SINGLEMODE	RE REQUEST-TO-EXIT PUSH PAD								
ELECTROMAGNETIC INTERFERENCE	SP SCRAMBLE PAD TBD TO BE DETERMINED	REMOTE UNLOCK/OPEN BUTTON								
ENERGY MANAGEMENT SYSTEM ELECTRICAL METALLIC	TIA TELECOMMUNICATIONS INDUSTRY ASSOCIATION TGB TELECOMMUNICATIONS	ML MICROPHONE STATUS LIGHT, WALL MOUNT								
TUBING EQUIPMENT ROOM	GROUND BUS BAR TMGB TELECOMMUNICATIONS	MP MICROPHONE  MICROPHONE MUTE II LUMINATED SWITCH								
EXISTING TO REMAIN DOOR FRAME MOUNTED	MAIN GROUND BUS BAR TR TELECOMMUNICATIONS	MICROPHONE MUTE ILLUMINATED SWITCH  S SPEAKER (DOOR BELL)								
DEVICE FIRE ALARM ANNUNCIATOR PANEL	TR TELECOMMUNICATIONS ROOM TYP TYPICAL	SP PAGING SPEAKER								
FIRE ALARM CONTROL PANEL	UNO UNLESS NOTED OTHERWISE UL UNDERWRITER	VAULT MONITOR								
FLOOR DISTRIBUTOR FLEXIBLE METAL CONDUIT FIBER OPTIC RACK	LABORATORIES, INC. UPS UNINTERRUPTIBLE POWER SUPPLY	WC WATER CONTROL VALVE VALVE BY DIVISION 22, CONTROL BY DIVISION 28								
FIRE STOP SYSTEM FLOOR	UPSDP UNINTERRUPTIBLE POWER SUPPLY DISTRIBUTION	WT WATCH TOUR								
GENERAL CONTRACTOR GUARD TOUR GYPSUM BOARD	PANEL V VOLT(S) VCM VERTICAL CABLE MANAGER									
HAND HOLE HERTZ	VMS VIDEO MANAGEMENT SYSTEM									
INTERMEDIATE METAL CONDUIT INTERCOM CONTROL	WAO WORK AREA OUTLET WP WEATHER PROOF WR WEATHER RESISTANT	SECURITY CAMERAS								
SYSTEM INTERNET PROTOCOL	WT WATERTIGHT XP EXPLOSION-PROOF	FIXED CAMERA ( TWO IMAGER CAMERA								
INSIDE PLANT CABLE JUNCTION BOX ELECTRICALLY OPERATED		PTZ CAMERA  FOUR IMAGER CAMERA  360 CAMERA								
BY KEY KEY PAD										
IDICATES MODIFIER FOR SPECIAL	OPERATION IN LABELING SCHEME	180 CAMERA  MOUNTING TYPE SYMBOLS (APPLIES TO ANY SECURITY								
OTATION		DEVICE SYMBOL)								
SECURITY PLAN CALLOUT		☐ CEILING MOUNT  H☐ WALL MOUNT								
CONNECTION POINT OF NE	W WORK TO EXISTING	POLE / BOLLARD MOUNT								
DETAIL REFERENCE UPPE	R NUMBER INDICATES DETAIL	≻□□□ CORNER MOUNT								
NUMBER. LOWER NUMBER		PENDANT MOUNT								
section cut designatio	N	WALL MOUNT PENDANT ARM								
DEDICATED EQUIPMENT AG	CCESS TILE	LABELING SCHEME SECURITY DEVICES (TYPICAL)								
ACCESS PANEL		A: DEVICE SYMBOL								
TYPE LEGEND		XX: MODIFIER FOR SPECIAL OPERATION IF APPLICABLE								
BINATION WITH THE SYMBOLS T	RENT LINE-TYPES ARE USED IN O INDICATE THE STATUS OF ITEMS AS	YY: DEVICE TYPE								
ΓING, TO BE DEMOLISHED, TO Β Κ AND/OR ITEMS WHICH ARE AN	INCLUDED AS PART OF THE NEW TICIPATED TO BE PROVIDED IN THE	SEE MATCHING SCHEDULES ON THIS SHEET (IF APPLICABLE	<u>=</u> )							
VIEW IN WHICH THEY APPEAR. F	IG THESE LINETYPES ARE RELATIVE TO HASING SHOWN IN DRAWINGS IS NOT IECESSARY CONSTRUCTION PHASING,	SECURITY CAMERAS (TYPICAL)	0411 0175			٦				
CH IS DETERMINED BY THE CON' PONSIBILITIES. ANY SUCH PHASI	RACTOR AS PART OF THEIR S DESCRIBED IN THE CONSTRUCTION	C-XX XX: CAMERA NUMBER	CALL OUTS	K \ \ \ \ \ \ \ \ \ \ \ \ \ \ \ \ \ \ \	\\\\\\\\\\\\\\\\\\\\\\\\\\\\\\\\\\\\\\	-				
ER FOR THE SAKE OF DESCRIBI	LY INTENDED TO INDICATE A BROAD IG THE PROJECT. THE FOLLOWING VICE, EQUIPMENT, NOTE, LINE, SHAPE,	AA: CAMERA TYPE (SEE CAMERA ## AFF SCHEDULE ON THIS PAGE)	ENLARGED PLAN C	ALLOUT						
		FOR WALL MOUNTED CAMERAS, HEIGHT ABOVE FINISHED FLOOR			<del>&gt;&gt;&gt;&gt;</del>					
TING ————————————————————————————————————	NEW ————————————————————————————————————		NOT IN SCOPE							



FAX: (316) 265-5646 www.glmv.com GLMV ARCHITECTURE, INC. MISSOURI STATE CERTIFICATE OF AUTHORITY #000305

CONSULTING ARCHITECT
LEMAY ERICKSON WILLCOX
ARCHITECTS
11250 ROGER BACON DRIVE, SUITE 16
RESTON, VIRGINIA 20190
TEL: (703) 956-5600

CIVIL ENGINEER & LANDSCAPE ARCH.
GLMV ARCHITECTURE, INC
MISSOURI CIVIL COA #2018033898
MISSOURI LANDSCAPE COA #000008
9229 WARD PARKWAY, SUITE # 210
KANSAS CITY, MO 64114
TEL: (816) 444-4200

STRUCTURAL ENGINEER
LEIGH + O'KANE
MISSOURI COA #001644
250 NE MULBERRY, SUITE 201
LEE'S SUMMIT, MO 64086
(816) 444-3144

MECH., ELECT. & PLMG. ENGINEERS
HOSS & BROWN ENGINEERS
MISSOURI COA #01022
15902 MIDLAND DRIVE SHAWNEE, KS 66217 (913) 362.9090

SECURITY & IT ENGINEERS HENDERSON ENGINEERS MISSOURI COA #000556 1801 MAIN STREET, SUITE 300 KANSAS CITY, MO 64108 (816) 663-8700

5031 NORTHEAST LAKEWOOD WAY LEE'S SUMMIT, MISSOURI 64064 FIRE STATION #5 CITY OF LEE'S SUMMIT

REVISIONS:
# Description Date




PROJECT NO:	2150001291
DATE:	10.26.2022
DRAWN BY:	R.GAMMON
CHK'D BY:	M.MAURER
© GLMV Archited All work herein is the prop Architecture, Inc. and is not to	perty of GLMV be copied or used


SECURITY GENERAL NOTES

HENDERSON ENGINEERS 8345 LENEXA DRIVE, SUITE 300 LENEXA, KS 66214 TEL 913.742.5000 FAX 913.742.5001

WWW.HENDERSONENGINEERS.COM

2150001291 MO. CORPORATE NO: E-556D EXPIRES 12/31/2022

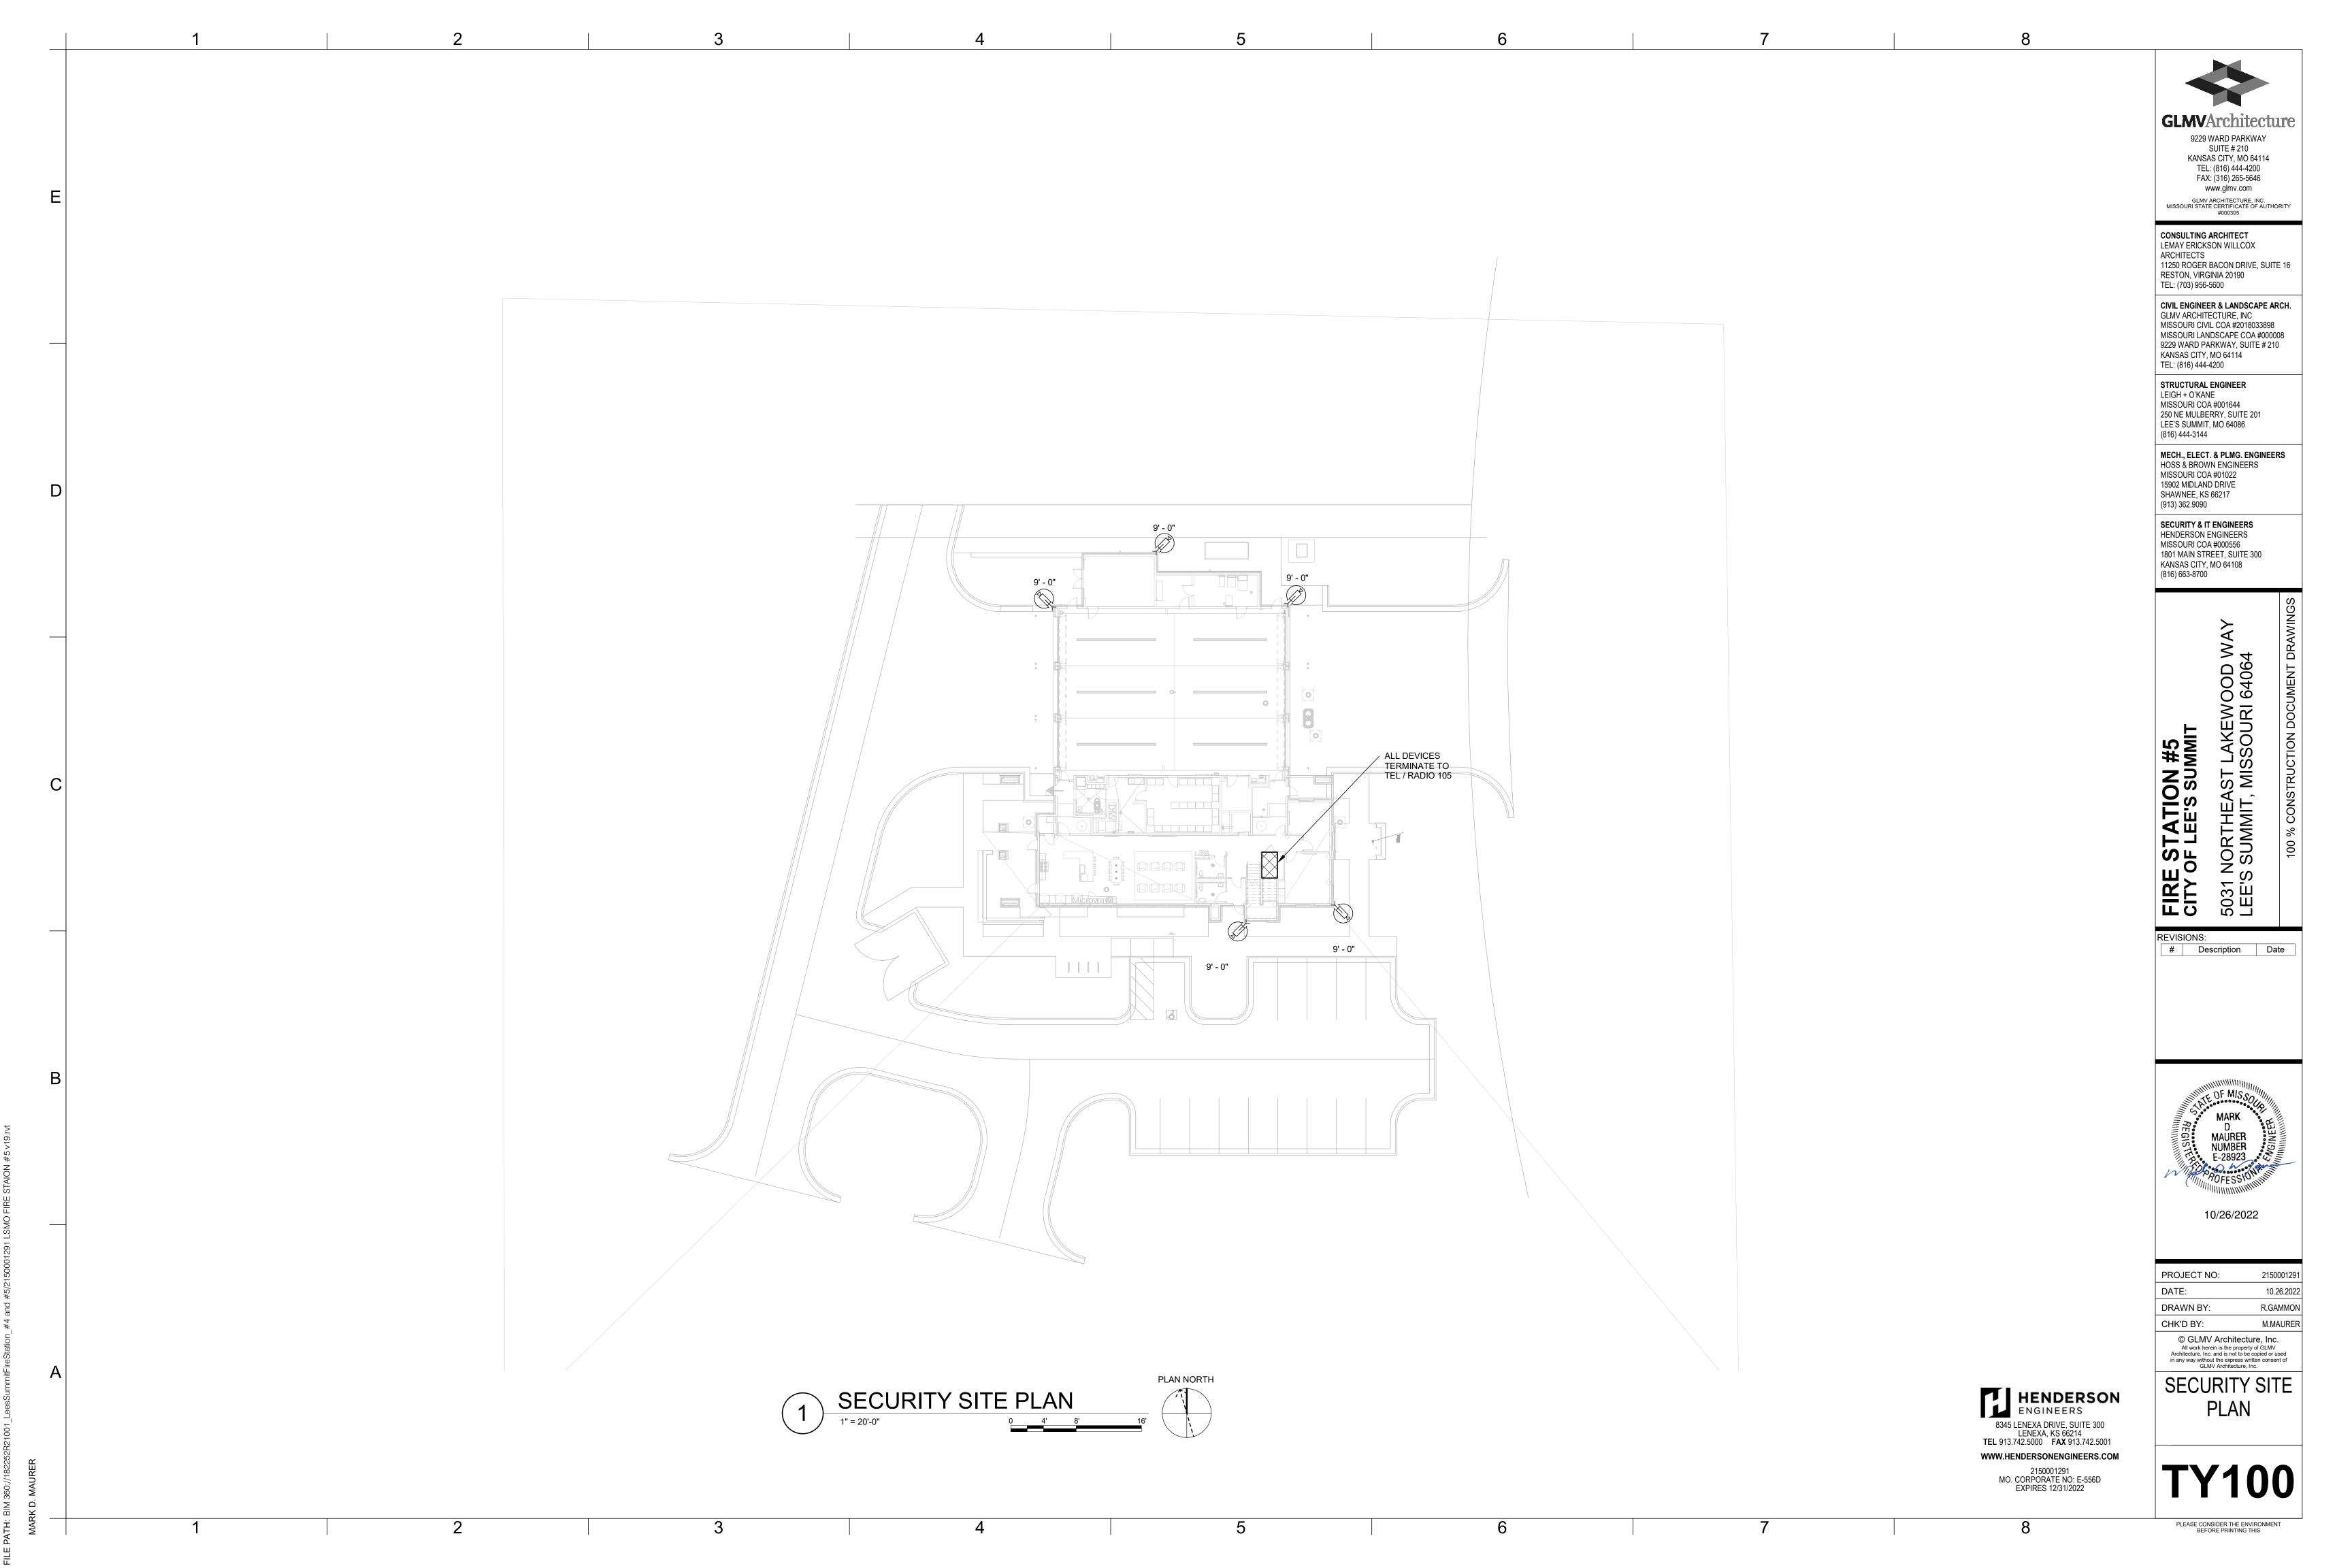

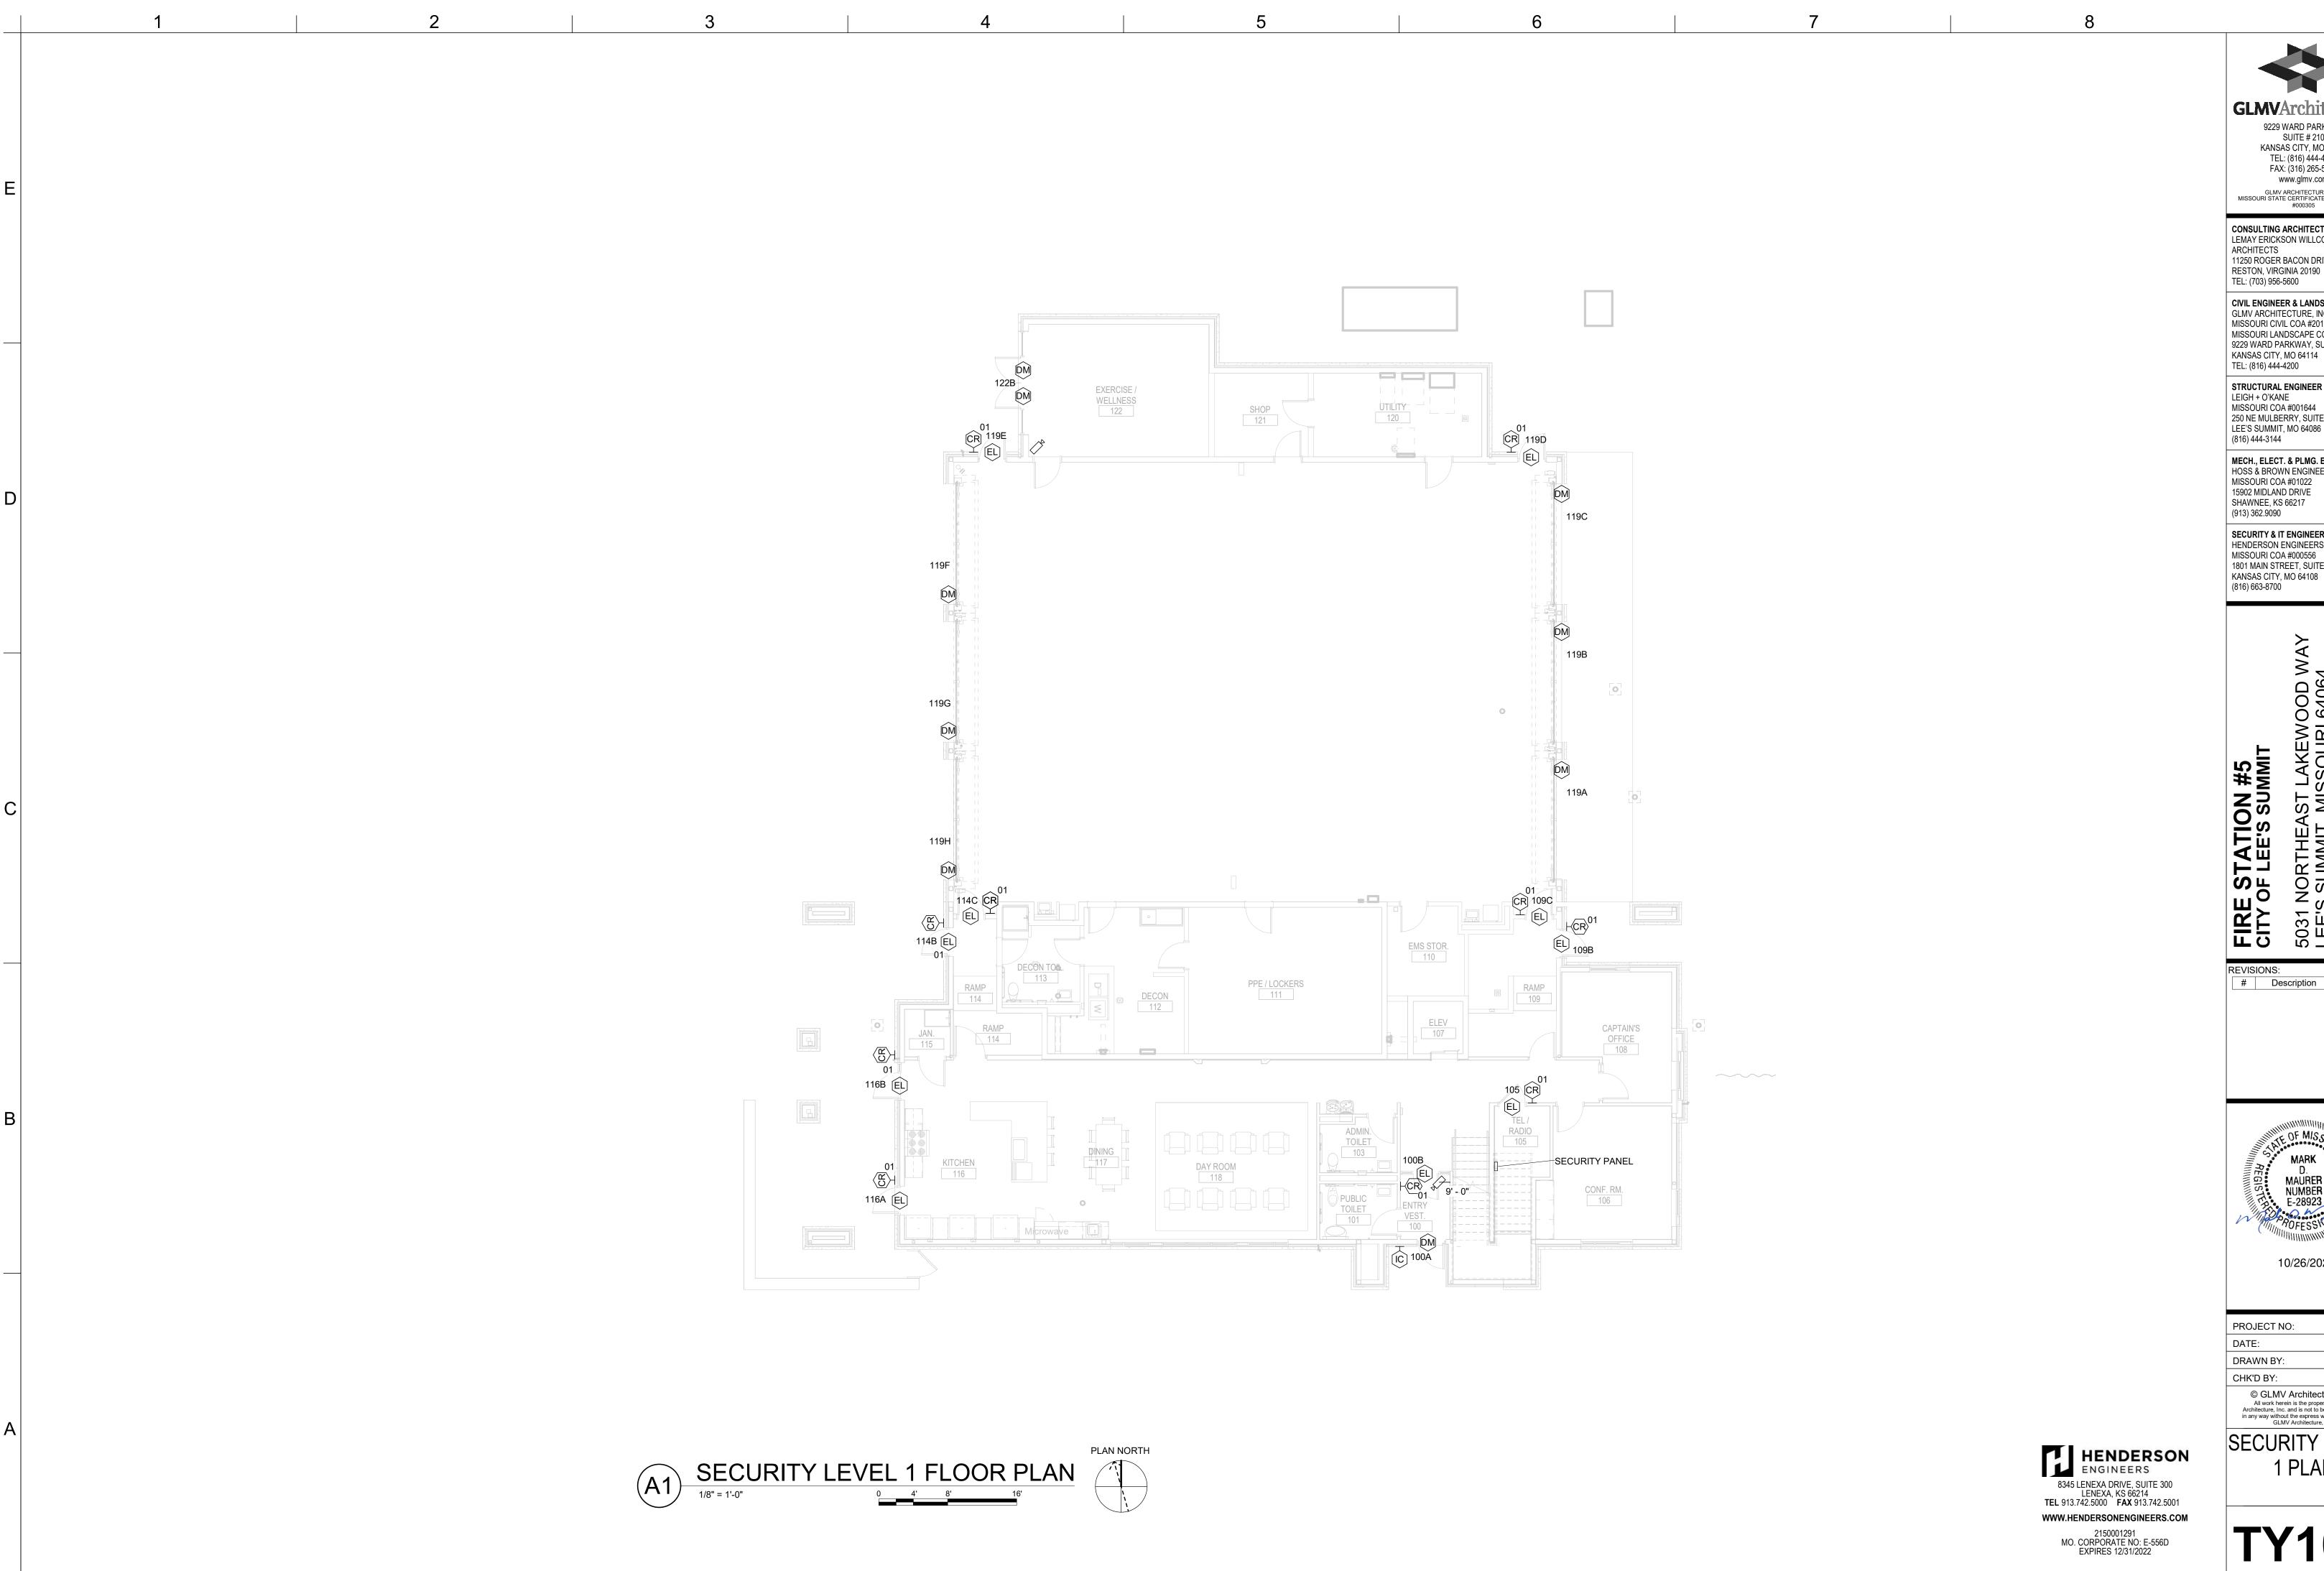

2

9229 WARD PARKWAY SUITE # 210 KANSAS CITY, MO 64114 TEL: (816) 444-4200 FAX: (316) 265-5646 www.glmv.com GLMV ARCHITECTURE, INC. MISSOURI STATE CERTIFICATE OF AUTHORITY #000305

CONSULTING ARCHITECT LEMAY ERICKSON WILLCOX 11250 ROGER BACON DRIVE, SUITE 16 RESTON, VIRGINIA 20190

CIVIL ENGINEER & LANDSCAPE ARCH.
GLMV ARCHITECTURE, INC
MISSOURI CIVIL COA #2018033898
MISSOURI LANDSCAPE COA #000008 9229 WARD PARKWAY, SUITE # 210


STRUCTURAL ENGINEER LEIGH + O'KANE MISSOURI COA #001644 250 NE MULBERRY, SUITE 201 LEE'S SUMMIT, MO 64086 (816) 444-3144

MECH., ELECT. & PLMG. ENGINEERS
HOSS & BROWN ENGINEERS
MISSOURI COA #01022
15902 MIDLAND DRIVE SHAWNEE, KS 66217

SECURITY & IT ENGINEERS HENDERSON ENGINEERS MISSOURI COA #000556 1801 MAIN STREET, SUITE 300 KANSAS CITY, MO 64108 (816) 663-8700


5031 NORTHI LEE'S SUMMI

REVISIONS:
# Description Date

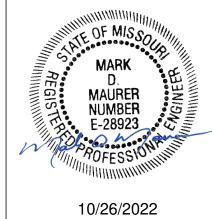

PROJECT NO:	215000129	
DATE:	10.26.202	
DRAWN BY:	R.GAMMO	
CHK'D BY:	M.MAURE	
© GLMV Architecture, Inc.  All work herein is the property of GLMV  Architecture, Inc. and is not to be copied or used in any way without the express written consent of GLMV Architecture, Inc.		

SECURITY LEVEL 1 PLAN

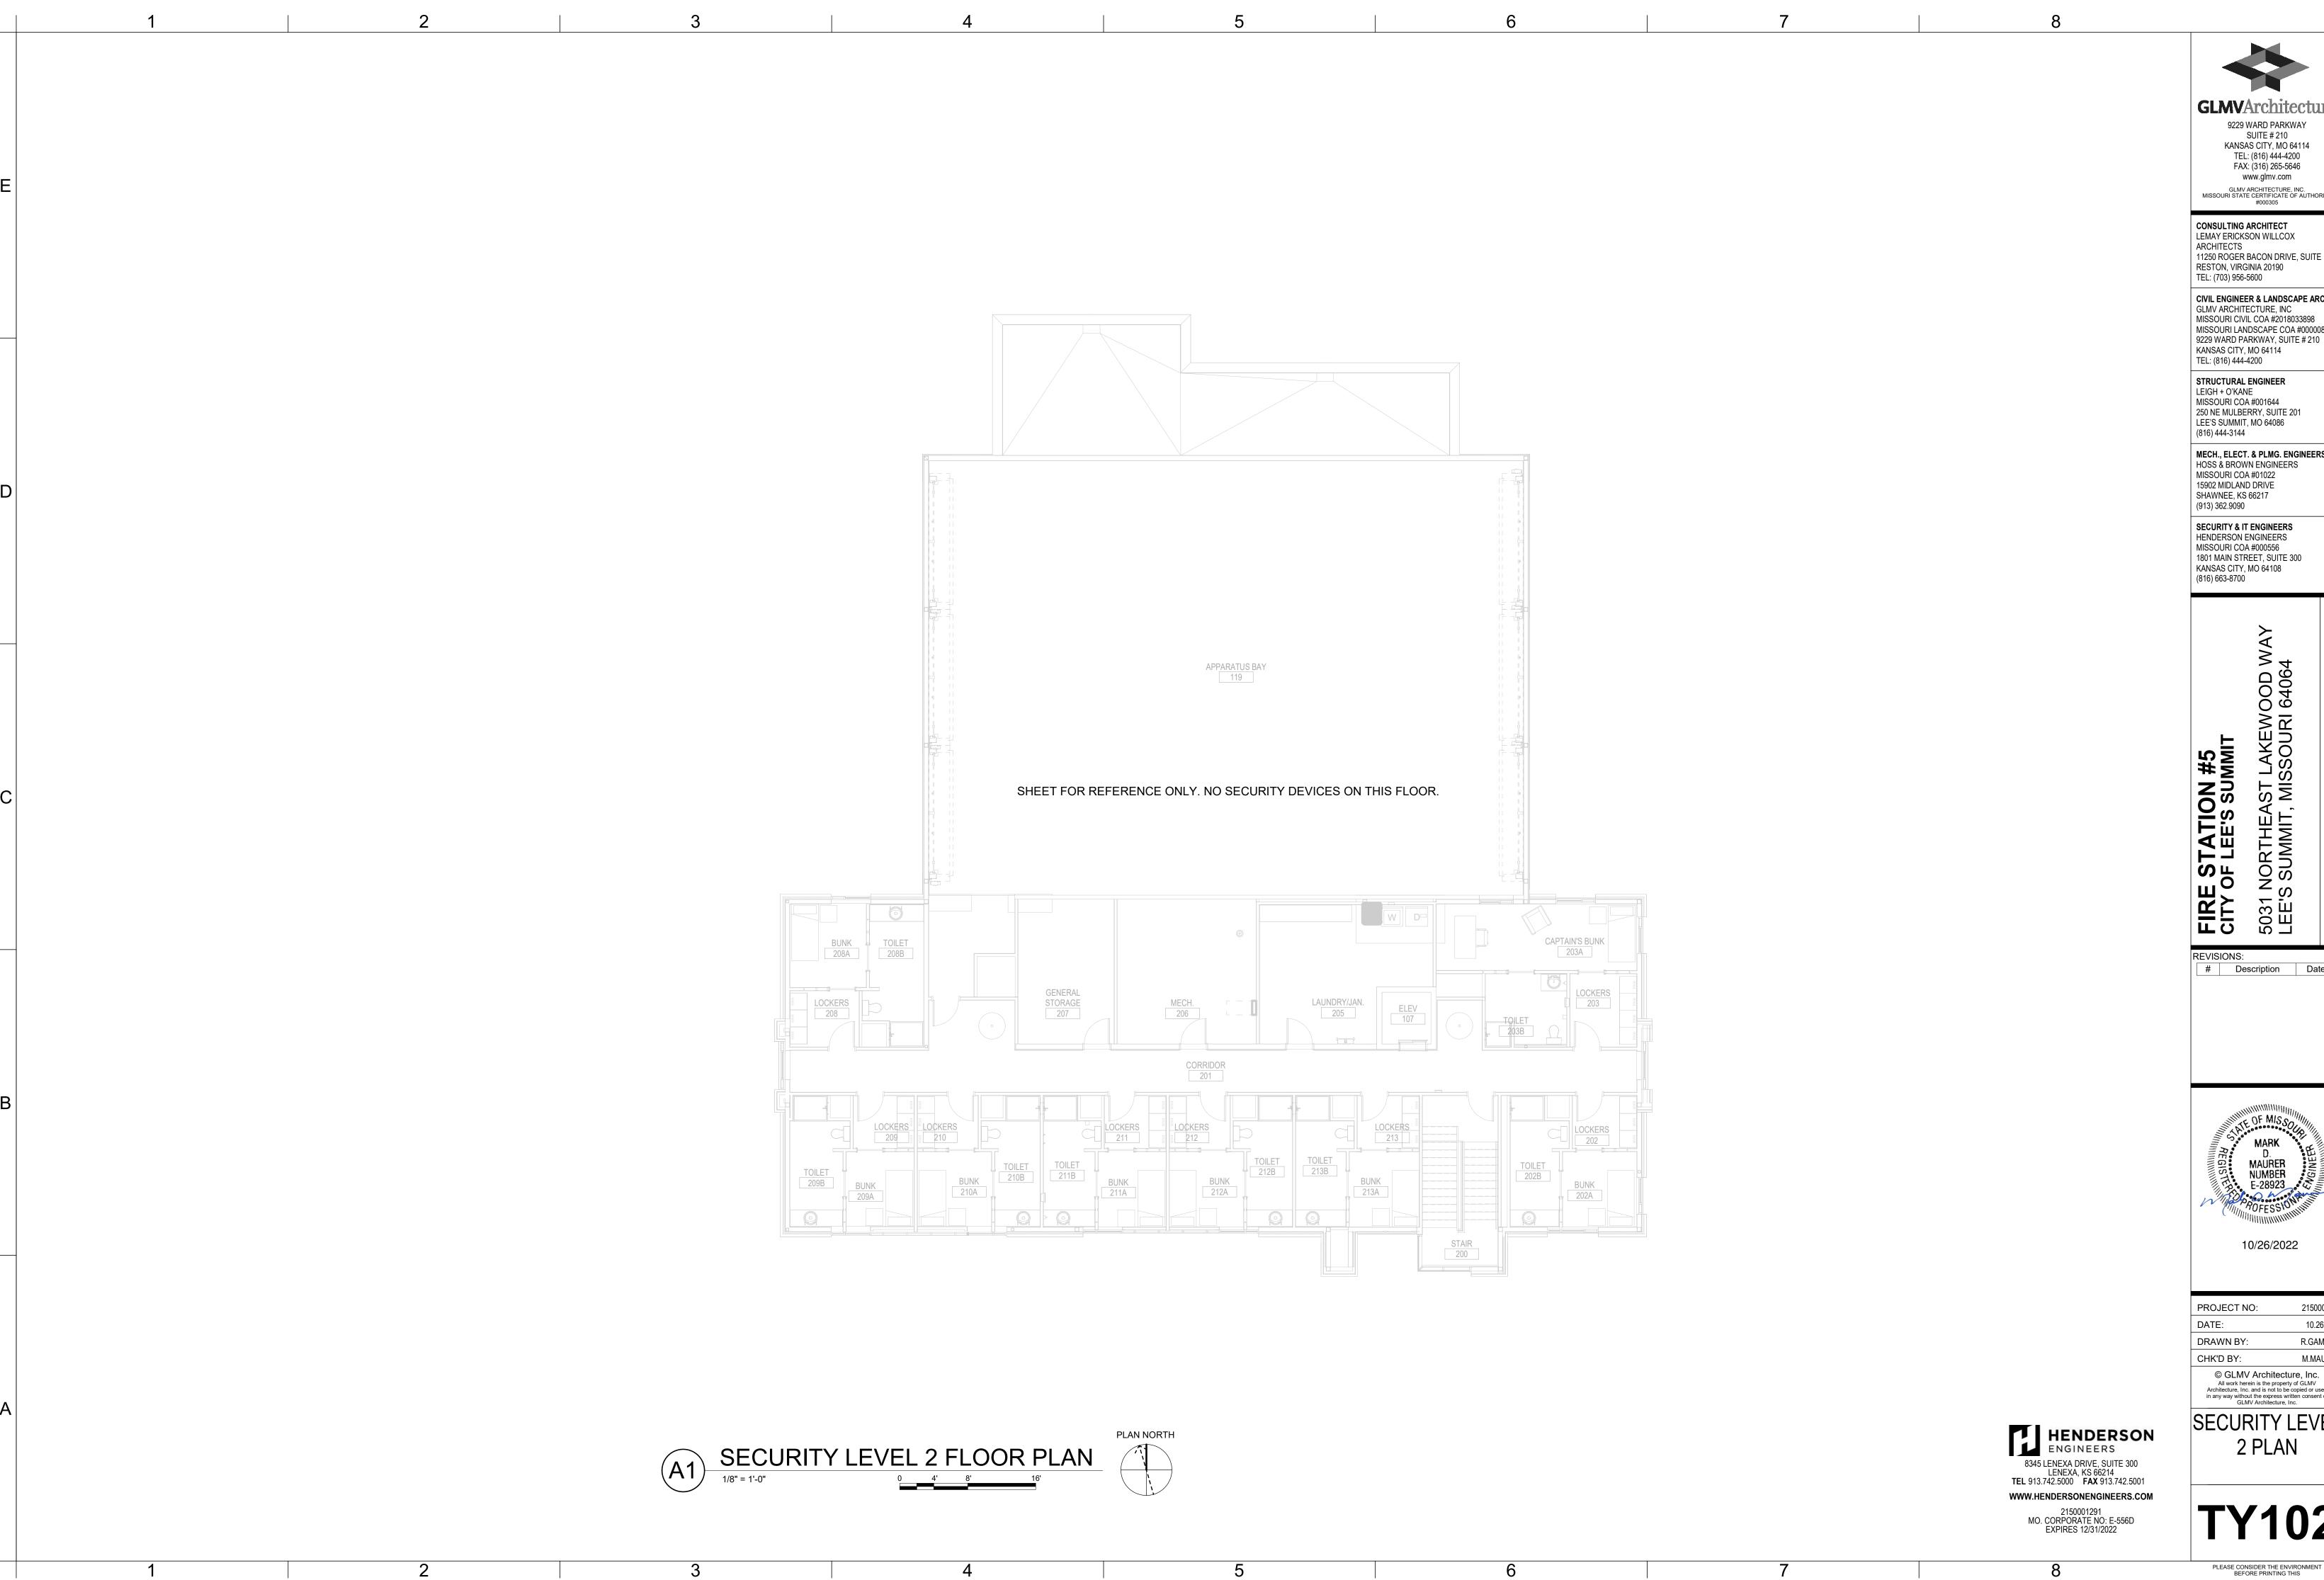

SUITE # 210 KANSAS CITY, MO 64114 TEL: (816) 444-4200 FAX: (316) 265-5646 www.glmv.com GLMV ARCHITECTURE, INC. MISSOURI STATE CERTIFICATE OF AUTHORITY #000305

CONSULTING ARCHITECT LEMAY ERICKSON WILLCOX ARCHITECTS 11250 ROGER BACON DRIVE, SUITE 16 RESTON, VIRGINIA 20190

CIVIL ENGINEER & LANDSCAPE ARCH.
GLMV ARCHITECTURE, INC
MISSOURI CIVIL COA #2018033898 MISSOURI LANDSCAPE COA #000008 9229 WARD PARKWAY, SUITE # 210


STRUCTURAL ENGINEER LEIGH + O'KANE MISSOURI COA #001644 250 NE MULBERRY, SUITE 201 LEE'S SUMMIT, MO 64086

MECH., ELECT. & PLMG. ENGINEERS HOSS & BROWN ENGINEERS MISSOURI COA #01022 15902 MIDLAND DRIVE SHAWNEE, KS 66217

SECURITY & IT ENGINEERS
HENDERSON ENGINEERS
MISSOURI COA #000556 1801 MAIN STREET, SUITE 300 KANSAS CITY, MO 64108 (816) 663-8700

5031 NORTHI LEE'S SUMMI

# Description Date

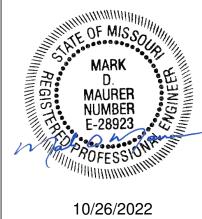

PROJECT NO:	215000129
DATE:	10.26.202
DRAWN BY:	R.GAMMO
CHK'D BY:	M.MAURE
© GLMV Archite  All work herein is the prop Architecture, Inc. and is not to in any way without the express GLMV Architecture	perty of GLMV be copied or used s written consent of

SECURITY LEVEL 2 PLAN

