

1501 E US HWY 40, LEE'S SUMMIT, MO 64015

PERMIT REVISIONS: 03-28-2023

### DRAWING INDEX

### **ARCHITECTURAL**


G001 COVER SHEET A101.0 SITE PLAN

A101.3 FLOOR + FURNITURE PLAN - COVERED BAYS

A201.2 RCP - COVERED BAYS

### ELECTRICAL

E101 ELECTRICAL SITE PLAN
E601 ELECTRICAL ONE-LINE DIAGRAM AND SCHEDULES
E602 PANEL SCHEDULES

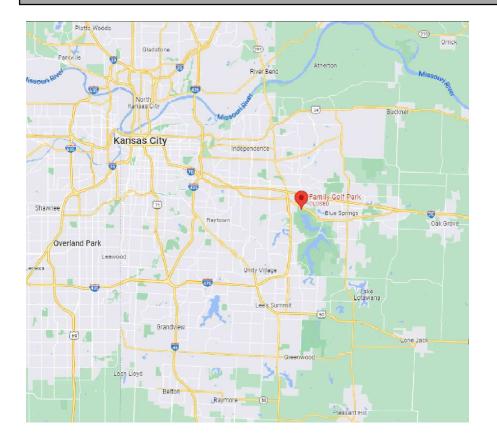


#### PROJECT CONTACTS

BLUE JEANS GOLF 3333 LEE PARKWAY SUITE 460 **DALLAS, TX 75219** ATTN: DEVIN CHARHON

ARCHITECT: HARRISON FRENCH & ASSOC., LTD 1705 S WALTON BLVD, SUITE 3 BENTONVILLE, AR 72712 ATTN: KARL GUIDER PH: 479-273-7780, EXT. 125 CELL: 773-679-0600



**DISCLAIMER:** EXISTING CONDITIONS SHOWN ARE BASED ON DRAWING AND/OR INFORMATION PROVIDED BY THE OWNER'S REPRESENTATIVE. THE ARCHITECT AND ENGINEERS HAVE NOT FIELD VERIFIED THIS INFORMATION AND ASSUME NO RESPONSIBILITY FOR THE ACCURACY AND COMPLETENESS OF THIS INFORMATION. THE GENERAL CONTRACTOR SHALL NOTIFY BOTH THE ARCHITECT AND THE OWNER'S REPRESENTATIVE IMMEDIATELY IF THE EXISTING CONDITIONS ARE NOT AS SHOWN WITHIN THE CONSTRUCTION DOCUMENTS.

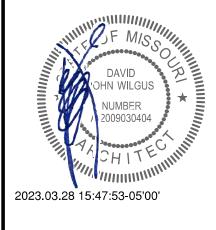

DAVID JOHN W ILGUS, ARCHITECT A-2009030404


HARRISON FRENCH &

ASSOCIATES, LTD

A-2005011993-F

**COVER SHEET** 

G001

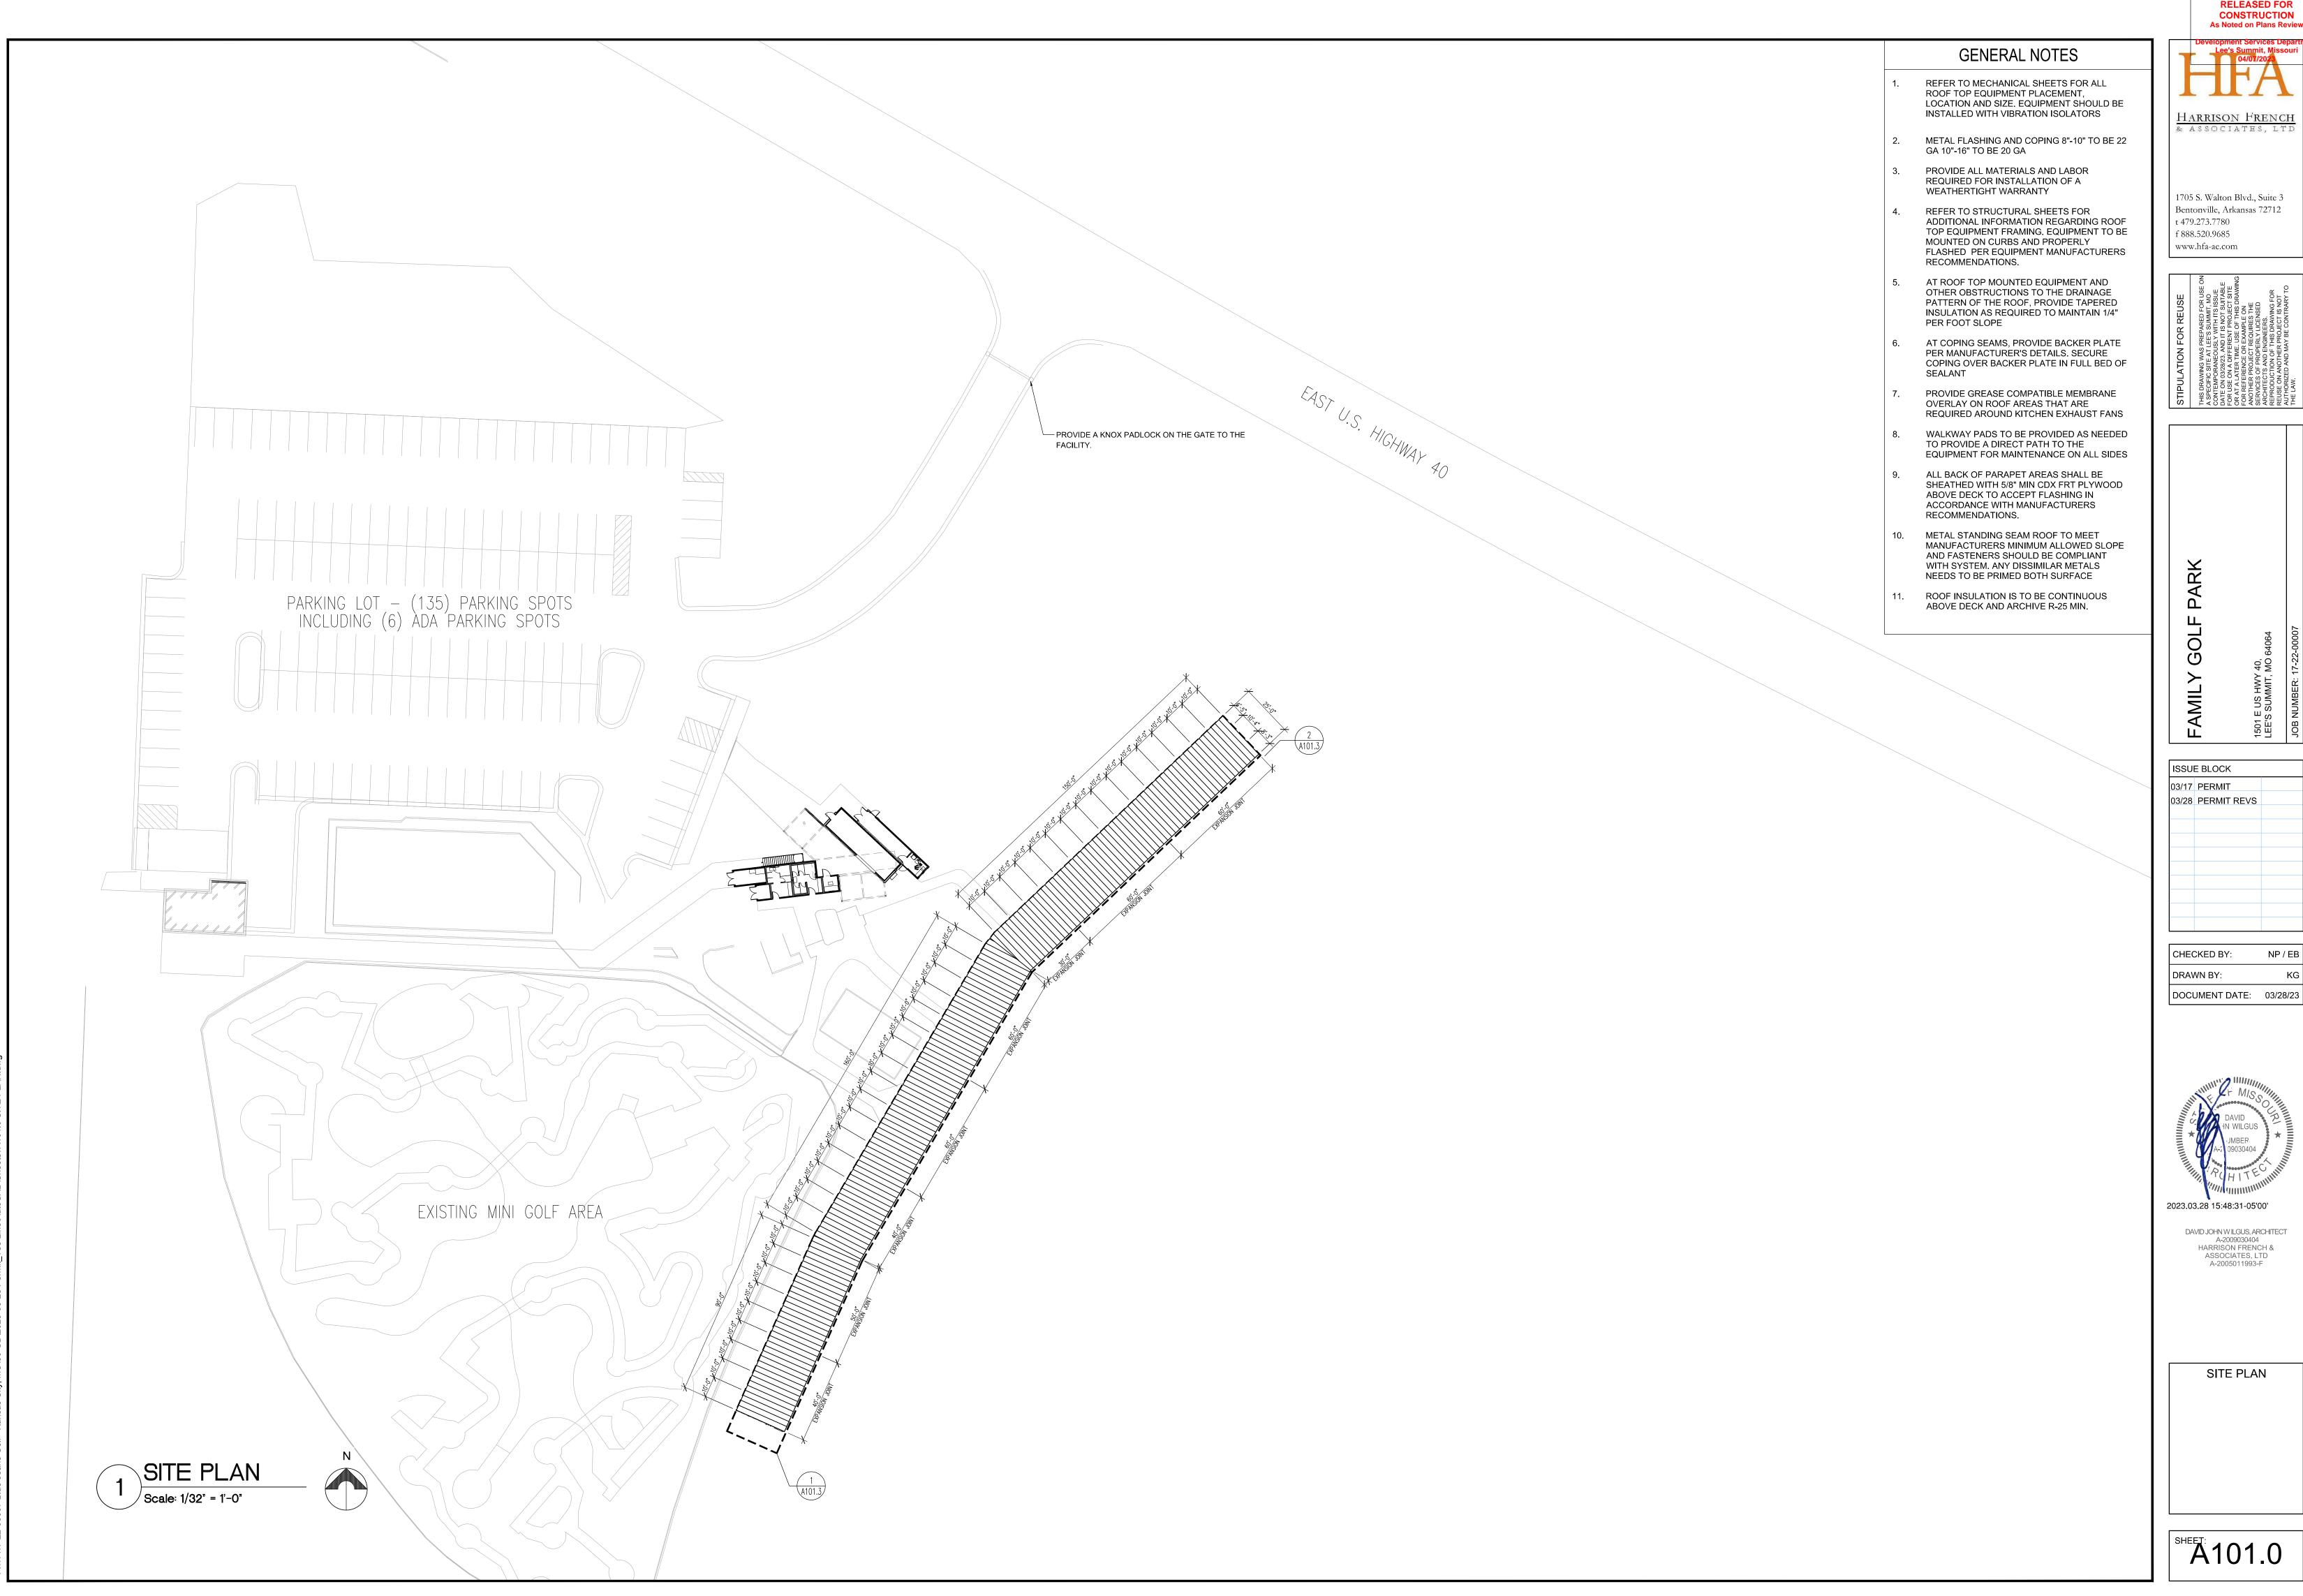

CONSTRUCTION
As Noted on Plans Review

HARRISON FRENCH & ASSOCIATES, LTD


1705 S. Walton Blvd., Suite 3 Bentonville, Arkansas 72712 t 479.273.7780 f 888.520.9685 www.hfa-ae.com

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DAVID JOHN WILGUS, ARCHITECT A-2009030404 HARRISON FRENCH & ASSOCIATES, LTD A-2005011993-F

SITE PLAN

A101.0

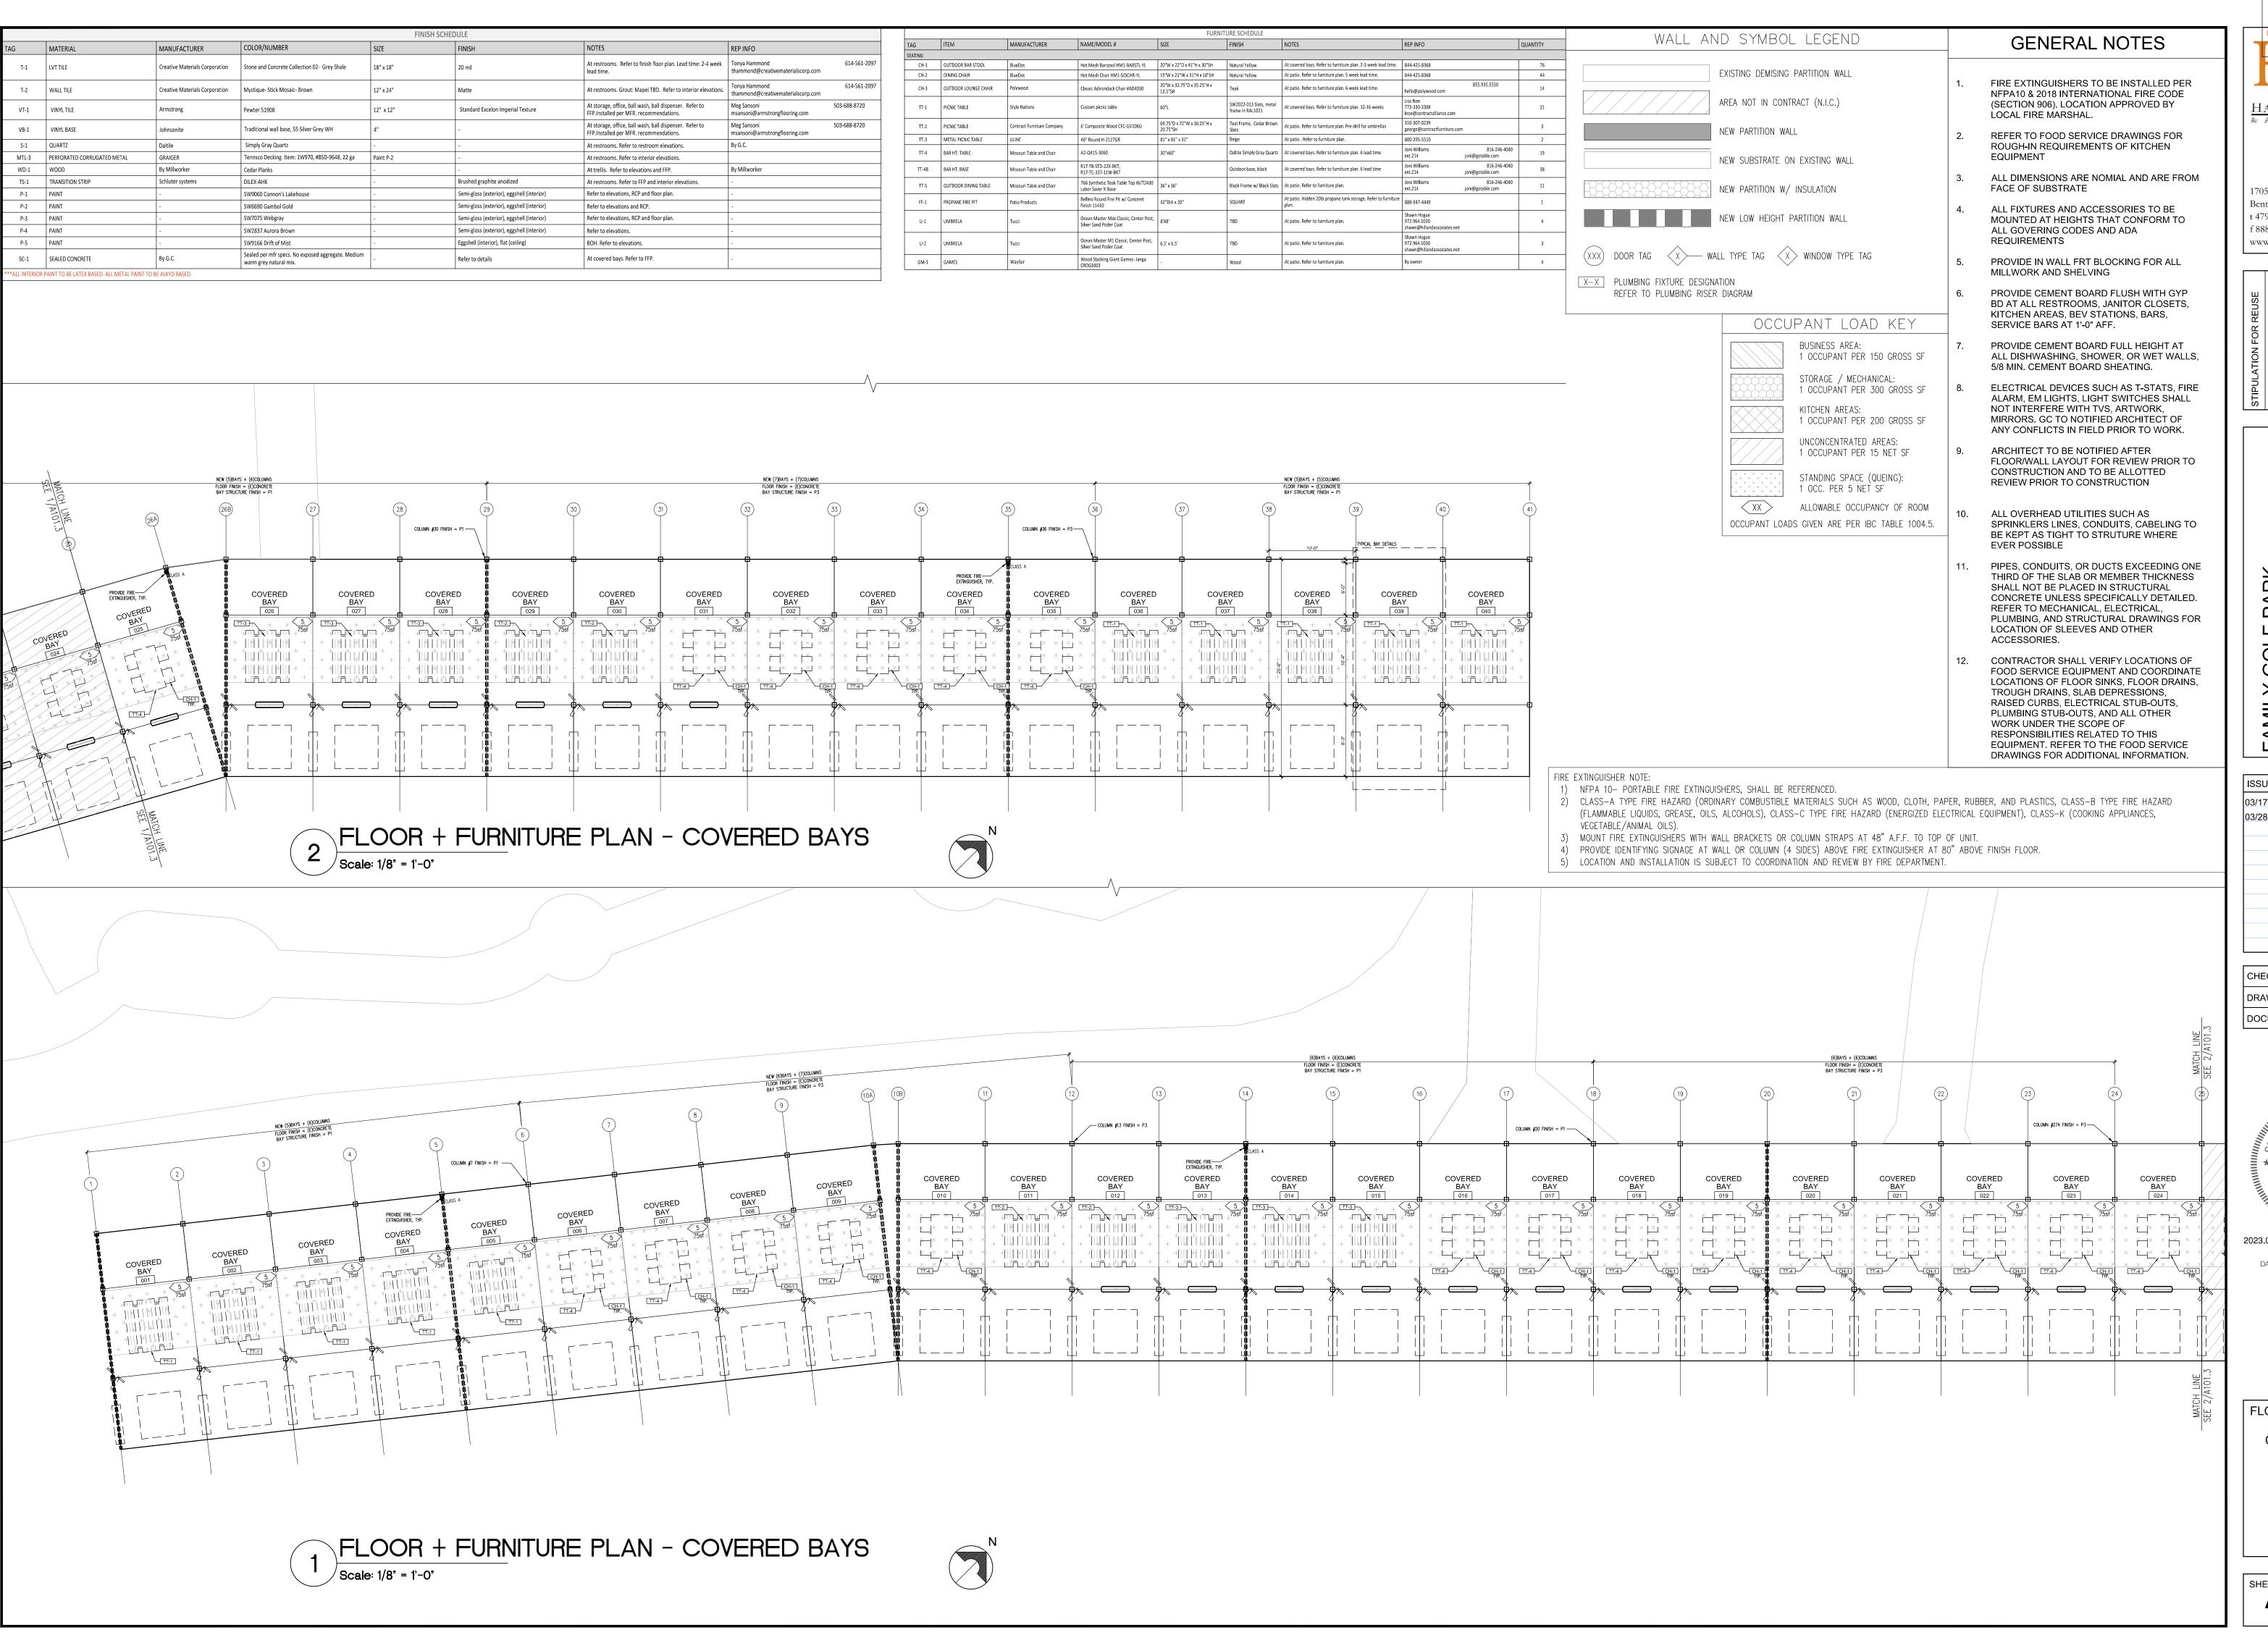

CONSTRUCTION As Noted on Plans Review

HARRISON FRENCH & ASSOCIATES, LT

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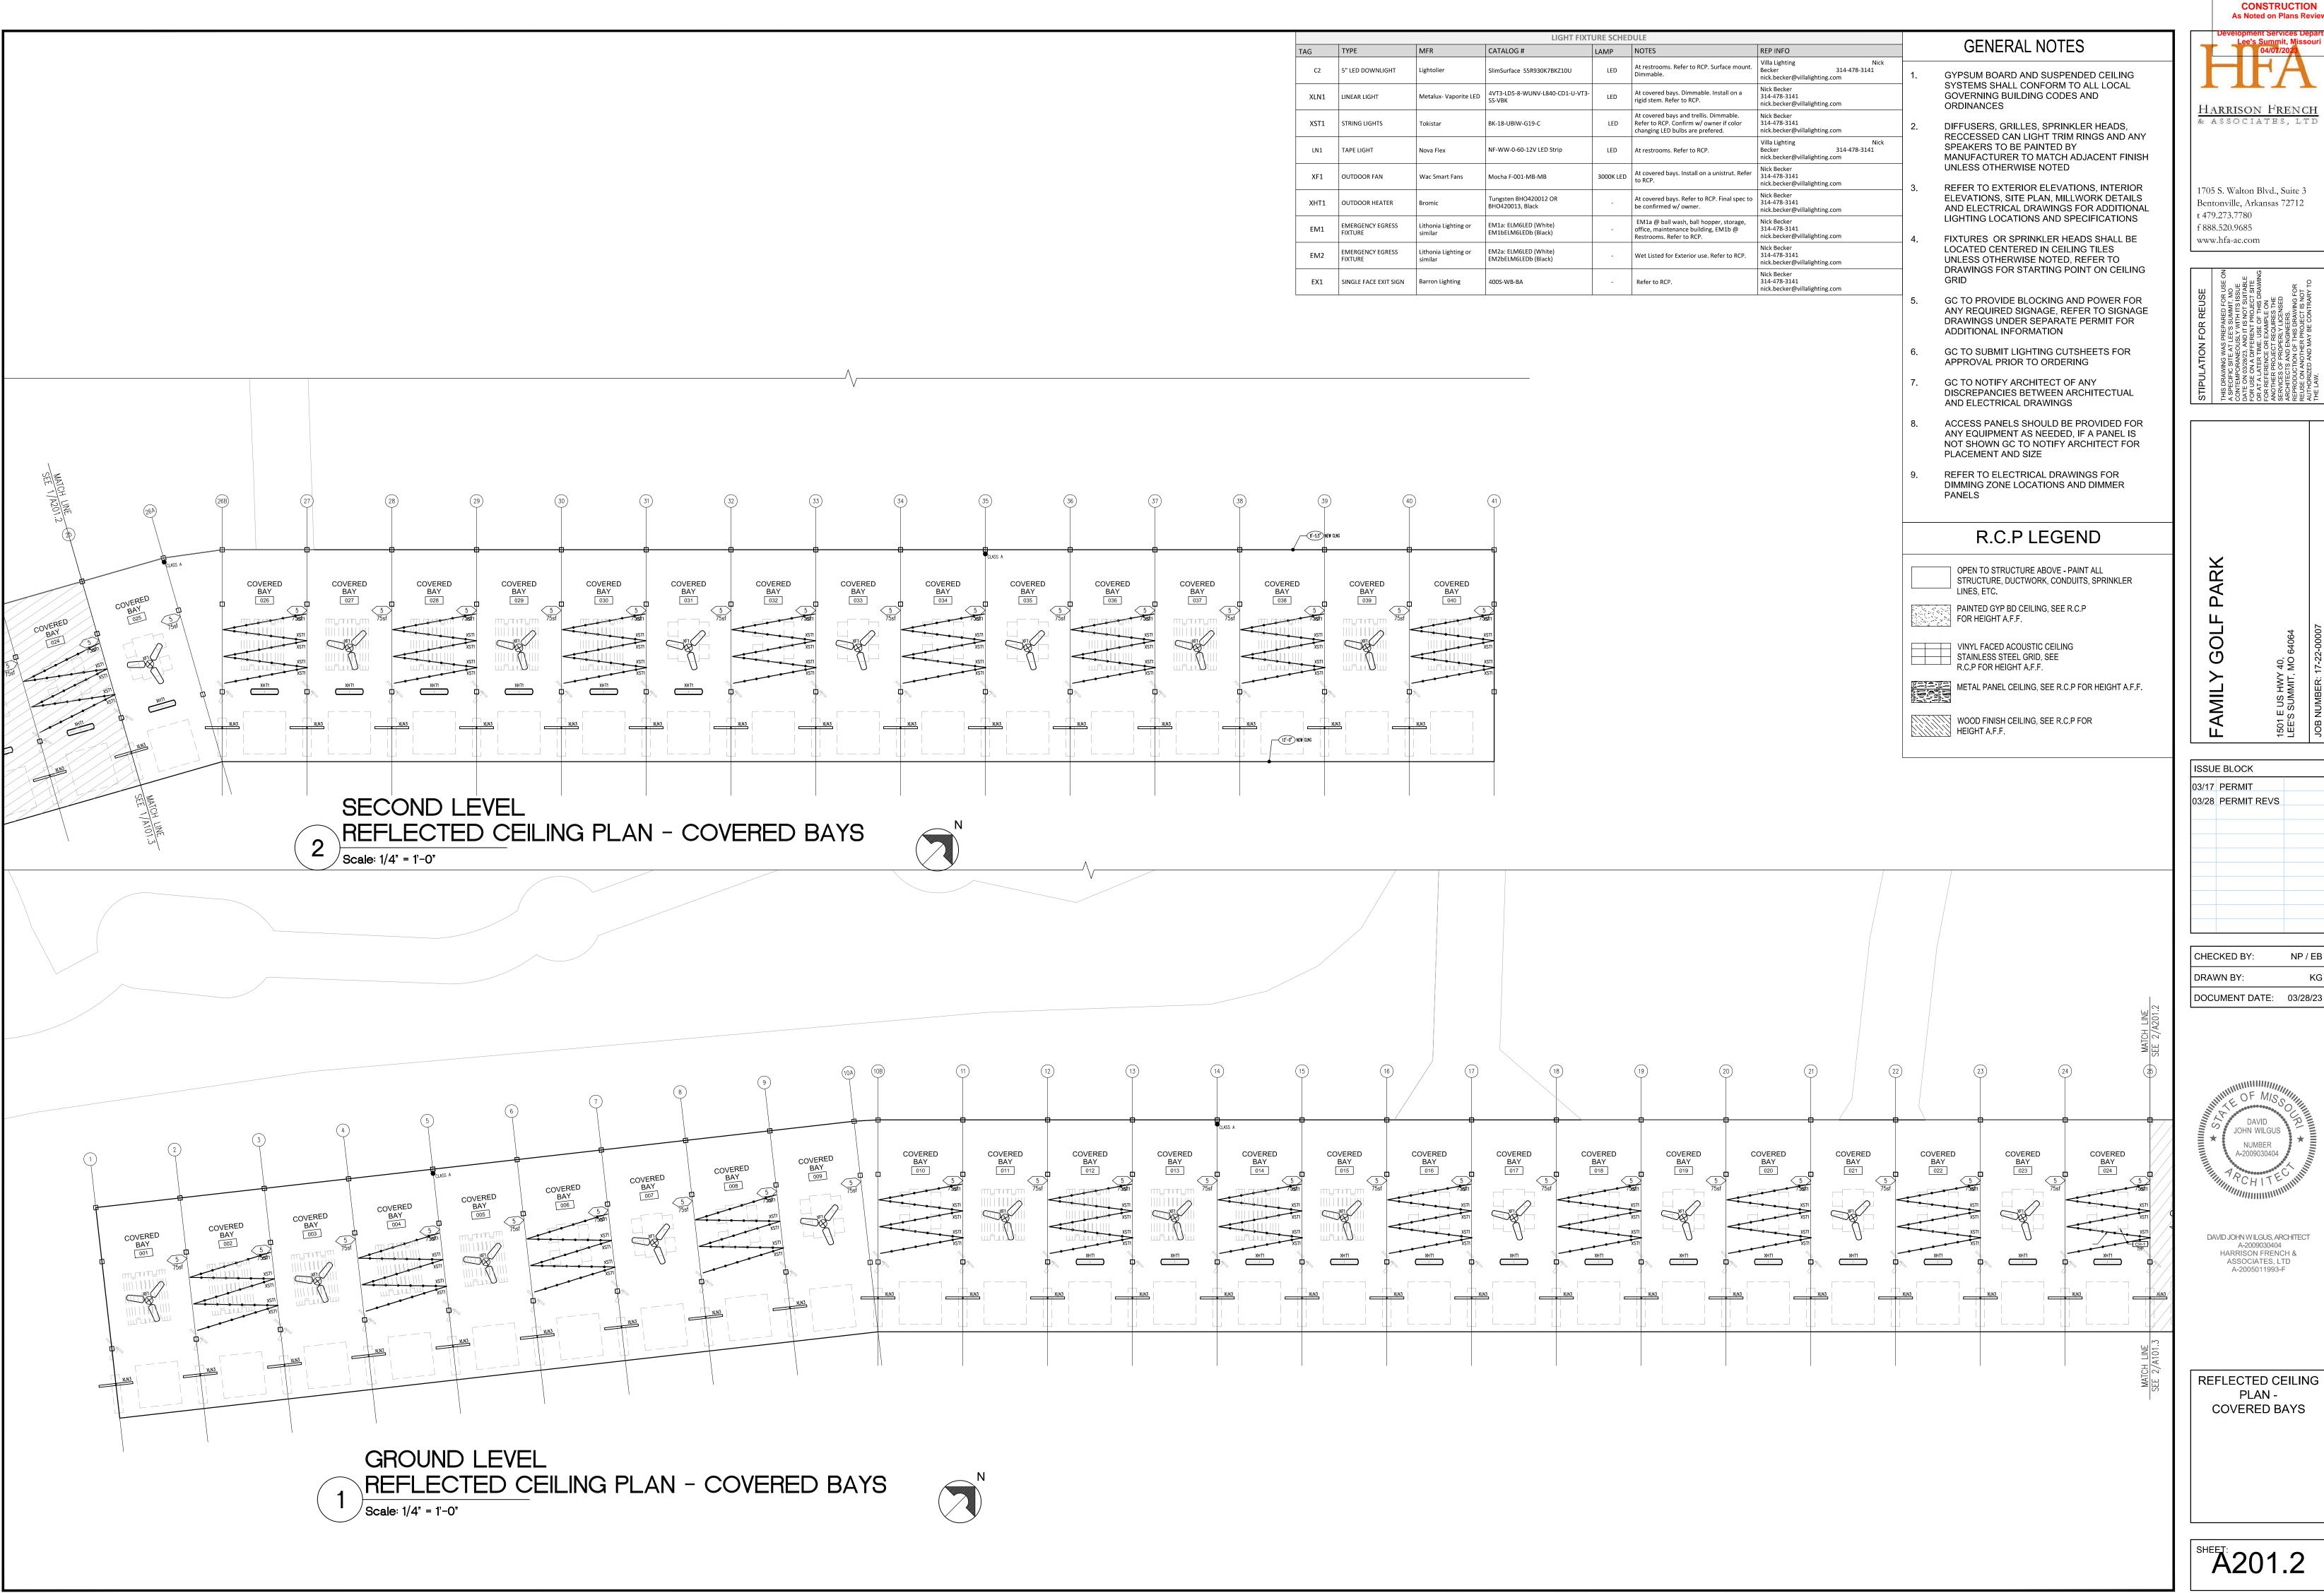
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ASSOCIATES, LTD

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FLOOR + FURNITURE PLAN -**COVERED BAYS** 

A101.3



As Noted on Plans Review

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HARRISON FRENCH

03/17 PERMIT 03/28 PERMIT REVS

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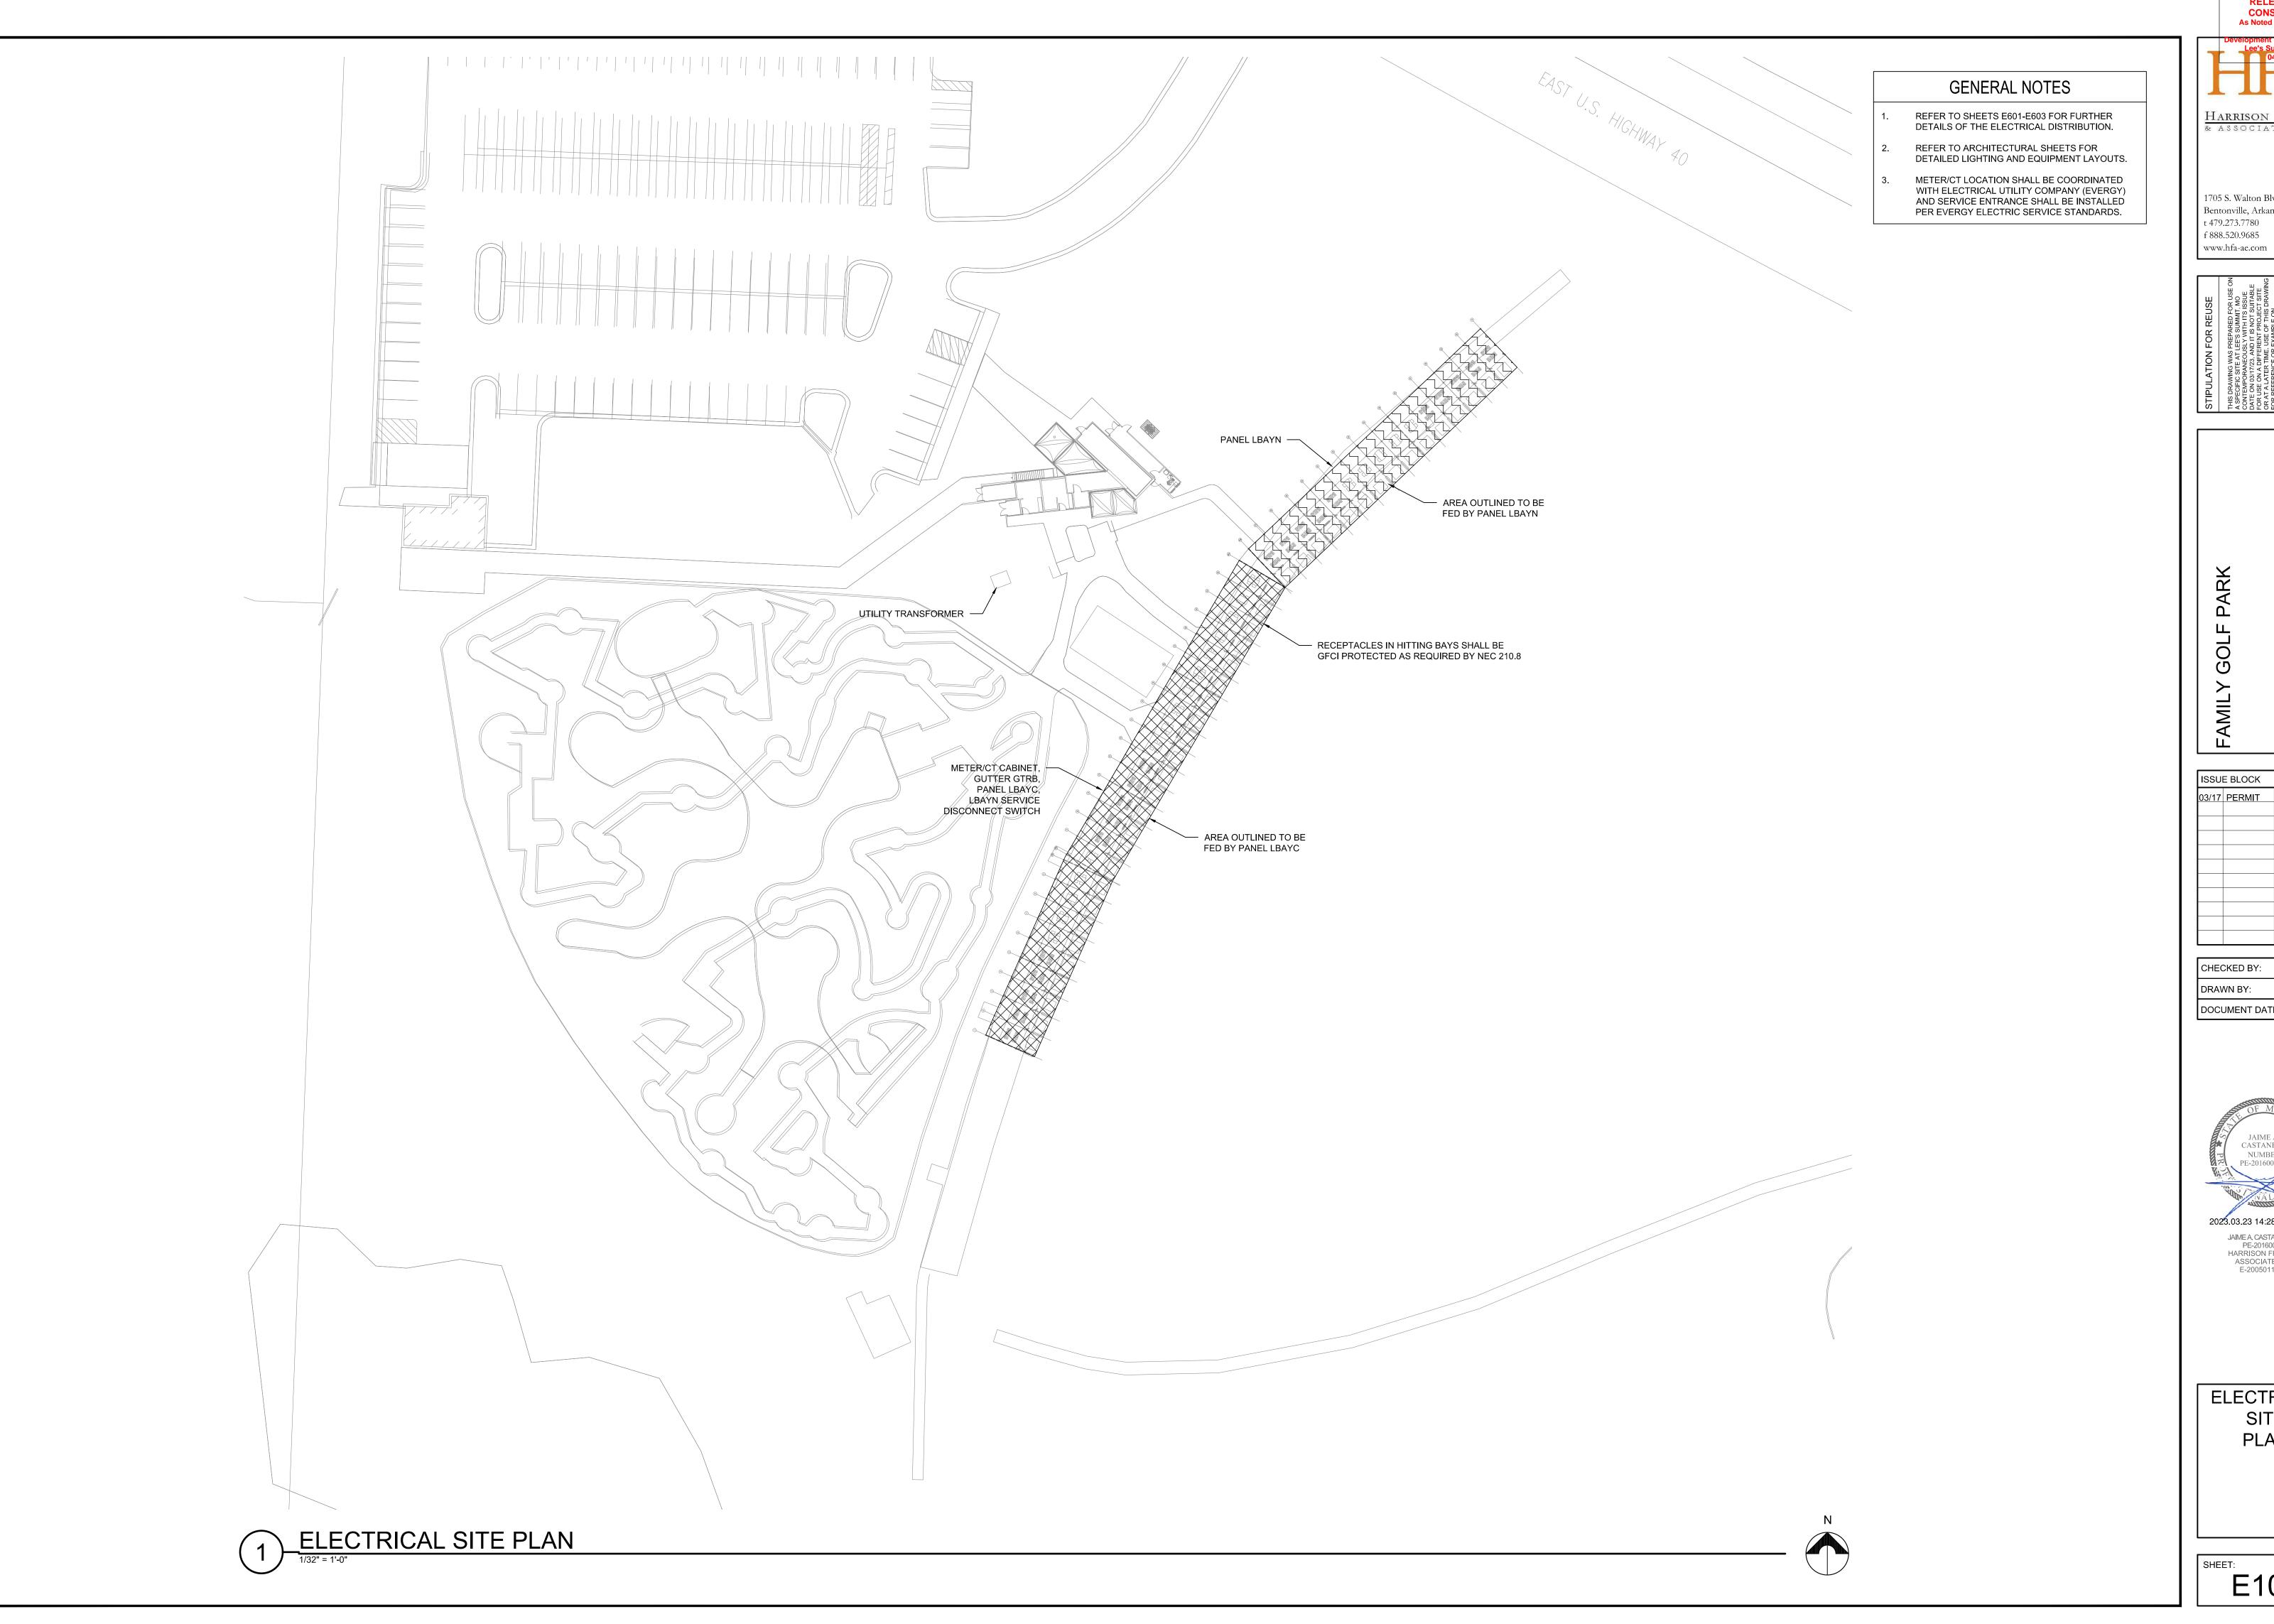
DOCUMENT DATE: 03/28/23



DAVID JOHN W ILGUS, ARCHITECT A-2009030404 HARRISON FRENCH & ASSOCIATES, LTD A-2005011993-F

REFLECTED CEILING PLAN -**COVERED BAYS** 


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CONSTRUCTION
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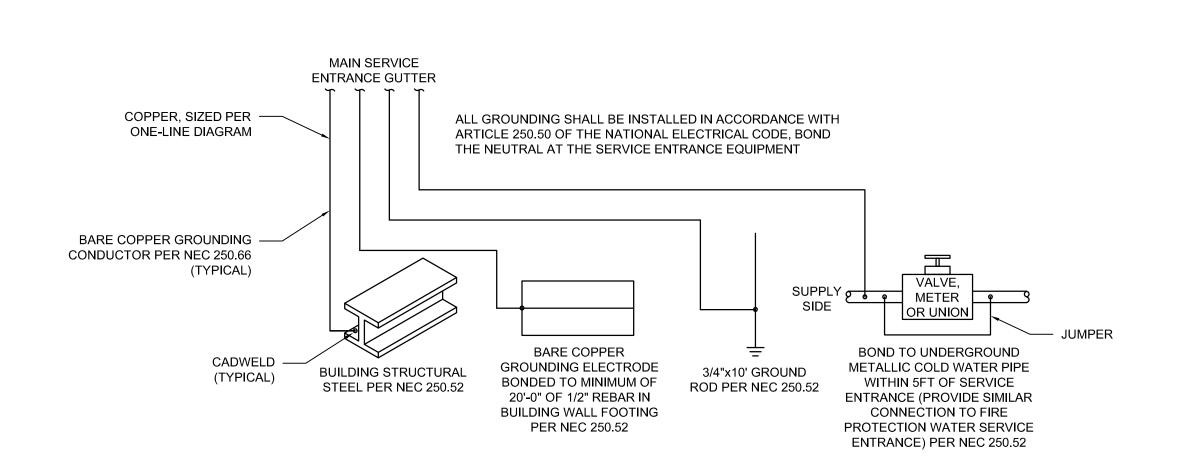
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DOCUMENT DATE: 03/17/23



ELECTRICAL SITE PLAN

E101

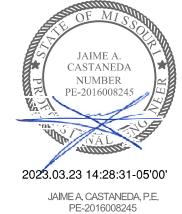

ONE-LINE DIAGRAM

# GROUNDING ELECTRODE SYSTEM DETAIL 1

### SERVICES TABLE 1

SERVICE SIZE	MAX CIRCUIT AMPS	3PH 4W COPPER CONDUCTORS <sup>2,3</sup>	3PH 4W ALUMINUM CONDUCTORS <sup>2,3</sup>
600A4W	600	(2) SETS OF 3"C, (4) 350kcmil	(2) SETS OF 3"C, (4) 500kcmil
1			

<sup>1</sup>Used for Electrical Service Entrance conductors only. Reference electric utility info for max number and size of conduits and conductors.

<sup>2</sup> Conduit sized per NEC for Schedule 80 PVC. Calculations required for any other conduit types.

<sup>3</sup>Assumes THHN/THWN Copper wire and XHHW-2 Aluminum wire. Calculations required for any other wire type.

<sup>4</sup>The next higher standard overcurrent device is used as allowed by NEC 240.4(B). The actual load cannot exceed the Max Circuit Amps.

# THREE PHASE FEEDER AND BRANCH CIRCUIT TABLE 1

# OCP SIZE MAX AMPS SPH 4WG ALUMINUM 3"C 3-1/2"C

00A4WGV	200 <sup>3</sup>	3"C, (4) 250kcmil, (1) #4 G	3-1/2"C, (4) 400kcmil, (1) #1 G				
ll wire and conduit sizes based on THHN/THWN and							

<sup>1</sup>All wire and conduit sizes based on THHN/THWN and PVC. Calculations required for other types.

<sup>2</sup>The next higher standard overcurrent device is used as allowed by NEC 240.4(B). The actual load cannot exceed the Max Circuit Amps. Normally used for branch circuits.

### THREE PHASE FEEDER AND

LBAYC

208/120V/3

NEW

CT

[CABINET]

INCOMING PRIMARY

TRANSFORMER

, UTILITY

600A4W

### BRANCH CIRCUIT TABLE 1

PANEL LBAYN 208/120V/3

- 200/3 FUSED

SERVICE RATED

REFER TO GROUNDING ELECTRODE SYSTEM DETAIL 1 THIS SHEET

NEMA 3R

GUTTER GTRB 208Y/120V, 600A NEMA 3R = #2/0 GEC

OCP SIZE	MAX AMPS	3PH 4WG COPPER	3PH 4WG ALUMINUM
200A4WEG <sup>4</sup>	200	2-1/2"C, (4) #3/0, (1) #4 G	3"C, (4) 250kcmil, (1) #2 G
400A4WEG <sup>4</sup>	380 <sup>2</sup>	3-1/2"C, (4) 500kcmil, (1) #1/0 G	5"C, (4) 750kcmil, (1) #3/0 G

<sup>1</sup>All wire and conduit sizes based on THHN/THWN and PVC. Calculations required for other types.

<sup>2</sup>The next higher standard overcurrent device is used as allowed by NEC 240.4(B). The actual load cannot exceed the Max Circuit Amps. Normally used for branch circuits.

<sup>3</sup>Feeder upsized due to voltage drop.

<sup>4</sup>Feeder shall be provided with grounding electrode conductor per NEC 256.64(D).

CONSTRUCTION
As Noted on Plans Review

Davelopment Services Departs
Lee's Summit, Missouri
04/07/2023

HARRISON FRENCH
& ASSOCIATES, LTD

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STIPULATION FOR REUSE


THIS DRAWING WAS PREPARED FOR USE ON A SPECIFIC SITE AT LEE'S SUMMIT, MO CONTEMPORANEOUSLY WITH ITS ISSUE DATE ON 0317123, AND IT IS NOT SUITABLE FOR USE ON A DIFFERENT PROJECT SITE OR AT A LATER TIME. USE OF THIS DRAWING FOR REFERENCE OR EXAMPLE ON ANOTHER PROJECT REQUIRES THE SERVICES OF PROPERLY LICENSED ARCHITECTS AND ENGINEERS.

REPRODUCTION OF THIS DRAWING FOR REUSE ON ANOTHER PROJECT IS NOT THE LAW.

TAIVIILY GOLF PAKK
1501 E US HWY 40,
LEE'S SUMMIT, MO 64064
LOB NUMBER: 17-22-00007

ISSUE	BLOCK	
03/17	PERMIT	
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CHECKED BY:	JAC
DRAWN BY:	ТММ
DOCUMENT DATE:	03/17/23

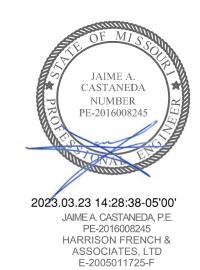

ELECTRICAL
ONE-LINE
DIAGRAM
AND
SCHEDULES

E601

3 2023-1:18nm - User tim mccahe

<sup>&</sup>lt;sup>3</sup>Feeder upsized due to voltage drop.

GTRB NEW 208Y/120V, 3PH, 4W LOAD SUMMARY 600A M.L.O. SERVES: MAIN HITTING BAY SERVICE 22,000 AIC SURFACE MOUNT LOCATION: HITTING BAYS CENTRAL FED FROM: UTILITY TRANSFORMER GROUND BAR SERVICE ENTRANCE RATED NEMA 3R ENCLOSURE WIRE BRKR PL PHASE A PHASE B PHASE C PL BRKR WIRE LOAD SERVED CK LOAD SERVED 1 PANEL LBAYC - - - PANEL LBAYN 40.1 16.1 |--| - | - | 0.00 | 0.00 | 0.00 0.00 0.00 | 0.00 | - | - | --TOTAL CONNECTED 58.1 56.2 49.6 TOTAL CONNECTED 483.8 413.2 TOTAL LOAD 163.8 AMPS 454.7 PER NEC ARTICLE 220 FEEDER LOAD 171.7 AMPS 476.5 100% 0.00 100% 0.00 125% 19.5 125% 24.4 KVA LIGHTING 13.5 16.9 KVA MOTORS 0.00 0.00 KVA RECEPTACLES\* 10.8 10.4 KITCHEN 0.00 KVA REFRIGERATION 0.00 0.00 KVA HVAC - COOLING\*\* 0.00 0.00 KVA HVAC - HEAT\*\* 120.0 100% 120.0 LARGEST MOTOR 0.00 25% 0.00 KVA |171.7 |KVA \*FIRST 10kVA AT 100% AND REMAINING AT 50% \*\*LARGEST OF COOLING OR HEATING

LBAYC NEW 208Y/120V, 3PH, 4W **PANELBOARD** 400A M.C.B. SERVES: HITTING BAYS CENTRAL 22,000 AIC SERVES: HITTING BAYS NORTH LOCATION: HITTING BAYS CENTRAL SURFACE MOUNT FED FROM: GUTTER GTRB NEMA 3R ENCLOSURE WIRE BRKR PL PHASE A PHASE B PHASE C PL BRKR WIRE LOAD SERVED CK LOAD SERVED 8 40 2 3.00 3.00 2 40 8 INFRARED HEATER 1 INFRARED HEATER 8 - -3.00 | 3.00 | 8 40 2 3.00 3.00 2 40 8 INFRARED HEATER 5 INFRARED HEATER 
 8
 3.00
 3.00

 8
 40
 2
 3

 8
 2 40 8 INFRARED HEATER
3.00 3.00 - - 8 2 40 8 INFRARED HEATER
0 - - 8 -9 INFRARED HEATER 8 40 2 3.00 3.00 8 - - 3.00 3.00 8 - - 3.00 3.00 3 INFRARED HEATER 3.00 3.00 2 40 8 INFRARED HEATER 17 INFRARED HEATER 2 40 8 INFRARED HEATER 3.00 3.00 21 INFRARED HEATER 3.00 3.00 - - 8 -8 40 2 3.00 3.00 25 INFRARED HEATER 2 40 8 INFRARED HEATER | 3.00 | 3.00 | 29 HITTING BAY L/R/FAN 1.01 | 1.01 | 1 | 20 | 12 | HITTING BAY L/R/FAN 31 HITTING BAY L/R/FAN | 12 | 20 | 1 | 1.01 | 1.01 | 1 20 12 HITTING BAY L/R/FAN 33 HITTING BAY L/R/FAN | 1.01 | 1.01 | 1 20 12 HITTING BAY L/R/FAN | 12 | 20 | 1 | | 1.01 | 1.01 | 1 | 20 | 12 | HITTING BAY L/R/FAN 35 HITTING BAY L/R/FAN | 12 | 20 | 1| 37 HITTING BAY L/R/FAN | 1 | 20 | 12 | HITTING BAY L/R/FAN | 12 | 20 | 1 | 1.01 | 1.01 | 39 HITTING BAY L/R/FAN | 1.01 | 1.01 | | 1 | 20 | 12 | HITTING BAY L/R/FAN | 12 | 20 | 1| 0.51 1.20 1 20 12 LED FLOODLIGHTS 41 HITTING BAY L/R/FAN 43 TOP TRACER MONITORS 1 20 12 LED FLOODLIGHTS | 12 | 20 | 1 | 0.48 | 1.20 | 1 20 12 LED FLOODLIGHTS 45 TOP TRACER MONITORS 0.48 | 0.60 | 12 | 20 | 1 | 47 TOP TRACER MONITORS 0.48 0.32 1 20 12 TOP TRACER CAMERAS | 12 | 20 | 1| 1 20 12 TOP TRACER SERVERS 49 TOP TRACER MONITORS | 12 | 20 | 1 | 0.48 | 0.28 | 51 TOP TRACER MONITORS | 12 | 20 | 1 | 53 TOP TRACER MONITORS SPARE 0.36 0.00 1 20 12 20 1 0.24 0.00 55 TOP TRACER MONITORS SPARE 57 SPARE SPARE SPARE 59 SPARE 0.00 0.00 1 20 70 3 5.60 0.00 61 FUTURE PANEL LBAYS (1) SPACE 4.52 0.00 SPACE SPACE 4.18 0.00 TOTAL CONNECTED 42.3 35.1 TOTAL CONNECTED 352.6 292.4 TOTAL LOAD 117.5 326.2 PER NEC ARTICLE 220 FEEDER LOAD 123.9 343.8 AMPS 0.00 125% 18.7 125% 15.0 KVA 13.0 LIGHTING 10.4 0.00 MOTORS 0.00 RECEPTACLES\* 8.10 8.10 KITCHEN 0.00 100% 0.00 KVA REFRIGERATION 0.00 0.00 HVAC - COOLING\*\* 0.00 0.00 KVA HVAC - HEAT\*\* 84.0 100% 84.0 LARGEST MOTOR 0.00 0.00 25% KVA 123.9 KVA

\*FIRST 10kVA AT 100% AND REMAINING AT 50%

\*\*LARGEST OF COOLING OR HEATING

#### LBAYN NEW PANELBOARD

208Y/120V, 3PH, 4W 200A M.L.O. 10,000 AIC SURFACE MOUNT NEMA 3R ENCLOSURE

LOCATION: HITTING BAYS NORTH FED FROM: GUTTER GTRB UPSTREAM OVERCURRENT DEVICE: 200A

WIRE BRKRIPL PHASE A PHASE B PHASE C PUBRKRIWIRE LOAD SERVED

СК	LOAD SERVED	WIRE	BRKR	PL	PHAS	SE A	PHASE B	PHAS	SE C	PL	BRKR	WIRE	LOAD SERVED	ск
1	INFRARED HEATER	8	40	2	3.00	3.00				2	40	8	INFRARED HEATER	2
3	_	8	_	-			3.00 3.00			_	_	8	_	4
5	INFRARED HEATER	8	40	2		,		3.00	3.00	2	40	8	INFRARED HEATER	6
7	_	8	_	_	3.00	3.00		_		_	_	8	_	8
9	INFRARED HEATER	∞	40	2			3.00 3.00			2	40	8	INFRARED HEATER	10
11	_	80	_	_				3.00	3.00	_	_	8	_	12
13	HITTING BAY L/R/FAN	12	20	1	1.01	1.01		_		1	20	12	HITTING BAY L/R/FAN	14
15	HITTING BAY L/R/FAN	12	20	1			1.01 1.01			1	20	12	HITTING BAY L/R/FAN	16
17	HITTING BAY L/R/FAN	12	20	1		,		1.01	1.01	1	20	12	HITTING BAY L/R/FAN	18
19	HITTING BAY L/R/FAN	12	20	1	1.01	0.51				1	20	12	HITTING BAY L/R/FAN	20
21	TOP TRACER MONITORS	12	20	1			0.48 1.20			1	20	12	LED FLOODLIGHTS	22
23	TOP TRACER MONITORS	12	20	1			·	0.48	0.00	1	20		SPARE	24
25	TOP TRACER MONITORS	12	20	1	0.48	0.00				1	20		SPARE	26
27	TOP TRACER MONITORS	12	20	1			0.36 0.00			1	20		SPARE	28
29	SPARE		20	1				0.00	0.00	1	20		SPARE	30
31	SPARE		20	1	0.00	0.00				1	20		SPARE	32
33	SPARE		20	1			0.00 0.00			1	20		SPARE	34
35	SPARE		20	1		,		0.00	0.00	1	20		SPARE	36
37	SPACE				0.00	0.00							SPACE	38
39	SPACE						0.00 0.00						SPACE	40
41	SPACE					,		0.00	0.00				SPACE	42
	TOTAL	CON	NECT	ED	16.0		16.1	14.5		K١	/A			
TOTAL CONN			NECT	ΈD	133.5		133.8	120.8		] A N	1PS			

TOTAL LOAD	46.6	KVA	129.3	AMPS
PER NEC ARTICLE 220 FEEDER LOAD	48.5	KVA	134.7	AMPS
100%	0.00	100%	0.00	KVA
125%	4.80	125%	6.00	KVA
LIGHTING	3.08	125%	3.84	KVA
MOTORS	0.00	100%	0.00	KVA
RECEPTACLES*	2.70	*	2.70	KVA
KITCHEN	0.00	100%	0.00	KVA
REFRIGERATION	0.00	100%	0.00	KVA
HVAC — COOLING**	0.00	0%	0.00	KVA
HVAC — HEAT**	36.0	100%	36.0	KVA
LARGEST MOTOR	0.00	25%	0.00	KVA
			48.5	KVA

\*FIRST 10kVA AT 100% AND REMAINING AT 50% \*\*LARGEST OF COOLING OR HEATING

### PANELBOARD NOTES ()

- (1) INSTALL LOCKING DEVICE FURNISHED WITH PANELBOARD (LOCK-OFF FOR MAINTENANCE).
- (2) GFCI BREAKER FOR PERSONNEL PROTECTION (5 mA).

(3) REFER TO ONE-LINE DIAGRAM FOR WIRE SIZES.

CONSTRUCTION
As Noted on Plans Review HARRISON FRENCH

RELEASED FOR

1705 S. Walton Blvd., Suite 3 Bentonville, Arkansas 72712 t 479.273.7780 f 888.520.9685 www.hfa-ae.com

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> CHECKED BY: DRAWN BY: DOCUMENT DATE: 03/17/23




**PANEL SCHEDULES** 

E602

RELEASED FOR

### DRAWINGS FOR FAMILY GOLF PARK 1501 E. US HWY 40 BLUE SPRINGS M.O. 64015

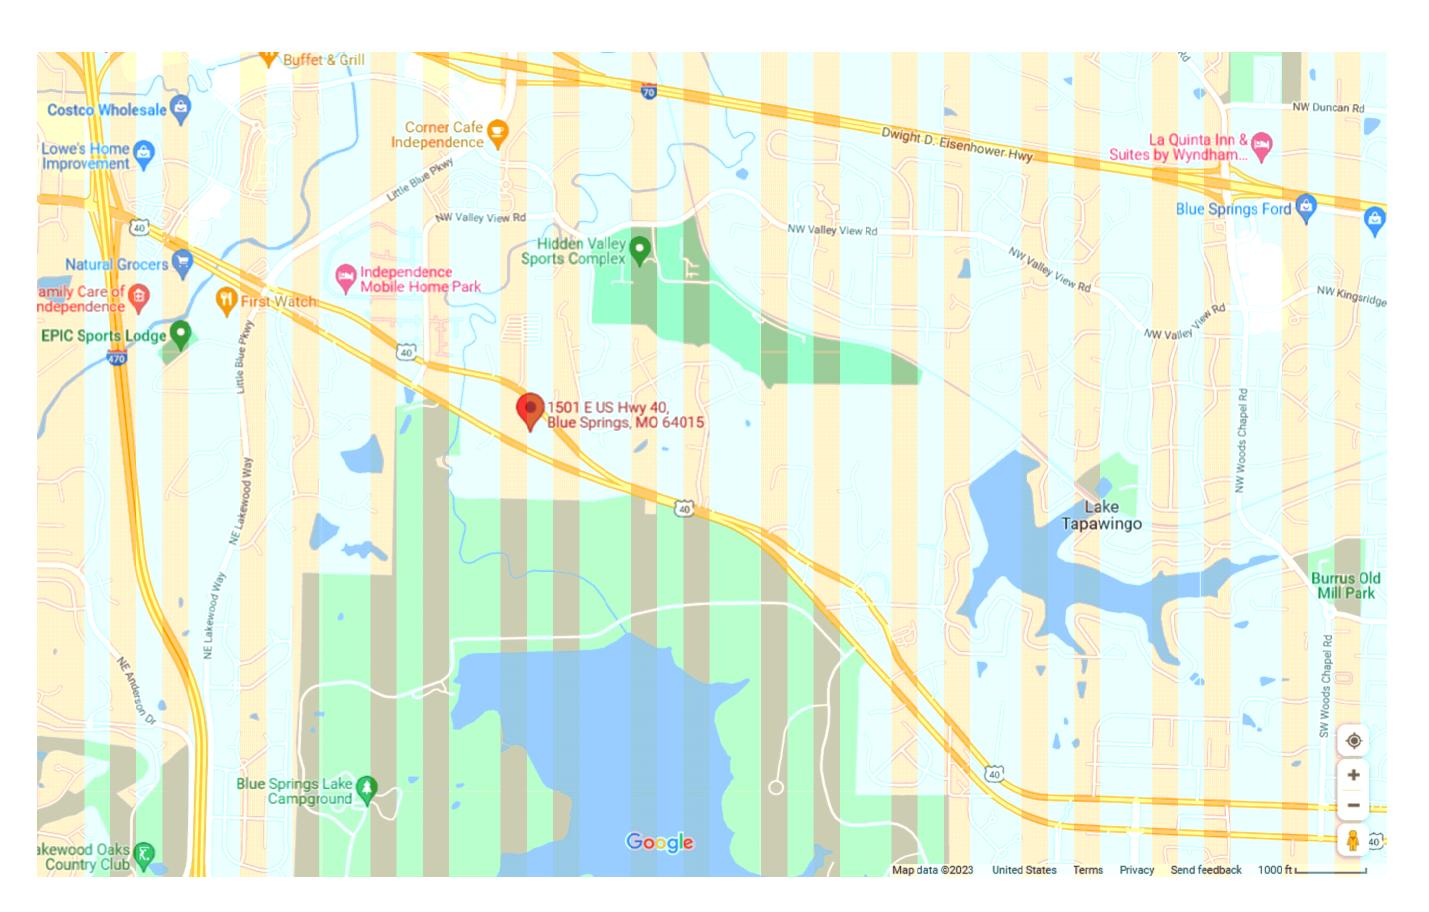

SITE LOCATION

#### GENERAL NOTES:

FLORIDA PRODUCT APPROVAL PRODUCT: ROOFING SUB CAT: METAL ROOFING MANUFACURER: METALS USA BUILDING PRODUCTS FL #: FL2291-R6

#### GENERAL

- I.) ALL BUILDING CONSTRUCTION MATERIALS AND INSTALLATION MUST BE IN ACCORDANCE WITH:
- BUILDING CODE 2018 IF MISSOURI
- IBC 2018 - ASCE 7-16
- 2.) ACCESSIBILITY TO BUILDING IS FIELD AND SUBJECT TO LOCAL BUILDING CODE OFFICIAL APPROVAL ALL SITE CIRCULATION (WALKWAYS, RAMPS, ETC) SITE PREPARATION UTILITIES SURVEY, ETC. NOT INCLUDED HEREIN AND IS TO BE PERFORMED BY OTHERS.
- 3.) WALK, RAMPS, STEPS OR PLATFORMS SHALL NOT BE CONSTRUCTED ADJACENT TO CANOPY AWNINGS, CASEMENTS OR PROJECTING WINDOWS IN SUCH A MANNER AS TO CREATE A HAZARD.
- 4.) ALL MATERIAL SUBSTITUTIONS SHALL BE THIRD PARTY TESTED FBC APPROVED PRODUCTS WITH VALID FL PRODUCT APPROVAL NUMBER. SUBSTITUTED PRODUCTS SHALL MEET OR EXCEED THE SPECIFICATIONS OF THE SPECIFIED PRODUCT AND BE APPROVED BY THE ENGINEER OR ARCHITECT AND OWNER.
- 5.) ALL ELECTRICAL WORK TO BE PROVIDED BY OTHERS. ALL WORK SHALL COMPLY WITH THE LATEST EDITION OF THE N.E.C., AND SHALL COMPLY WITH THE APPLICABLE REGULATIONS OF LOCAL AND STATES CODES. ELECTRICAL CONTRACTOR IS TO OBTAIN AND PAY FOR REQUIRED PERMITS AND FEES FOR ELECTRICAL WORK ON SITE. ELECTRICAL CONTRACTOR IS RESPONSIBLE FOR ALL CUTTING AND PATCHING OF FITTING. ALL WIRING SHALL BE OF THE HIGHEST QUALITY.
- 6.) TO THE BEST OF THE ENGINEER'S KNOWLEDGE THESE DOCUMENTS ARE COMPLETE AND IN COMPLIANCE WITH THE CRITERIA SET FORTH IN THE INTERNATIONAL BUILDING CODE 2015 AND ASCE 7-10. THERE ARE NO KNOWN ASBESTOS CONTAINING MATERIALS IN THIS PROJECT.

ULTIMATE DESIGN WIND SPEED (Vult): 109 MPH 3 - SECOND GUST WIND SPEED (Vasd): 90 MPH RISK CATEGORY: 2 WIND EXPOSURE CATEGORY: C LIVE LOAD: 20 PSF GROUND SNOW LOAD: 20 PSF, Ct = 1.2

FREE STANDING CANOPY AWAY FROM OTHER STRUCTURES WITH NO POSSIBILITY FOR A SNOW DRIFT SURCNARGE.

MATERIAL: 6"X6" X 0.125" COLUMNS (6005A - T61 ALLOY) 2"X6" X 0.125" HOLLOW TUBE (6005A - T61 ALLOY) 1.75" X 5.75" X 0.125" INTERNAL CHANNEL (3003 - H14 ALLOY)  $\frac{1}{4}$ " DIAMETER TREXX-T3 I" SCREWS #12 X 1" TEX SCREWS WITH NEOPRENE WASHERS A325 1 DIAMETER CORROSIVE RESISTIVE THRU BOLTS OR EQUIVALENT REFER PAGES 6-9 FOR DETAILS AND CONNECTION

INDEX: SHEET# DESRIPTION COVER POST LAYOUT PLAN VIEW SIDE ELEVATION FRONT ELEVATION CONNECTION DETAILS CONNECTION DETAILS ANCHOR DETAILS ANCHOR COLLAR DETAILS


COMPONENTS.





Digitally signed by Lyudmila Gurtovaya Date: 2023.01.11 14:42:49 -06'00'

COVER THE TEES 713 KENNEDY PT VIEDO FL, 3276

INFO@LG-ENG.COM

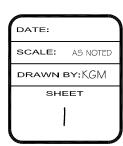

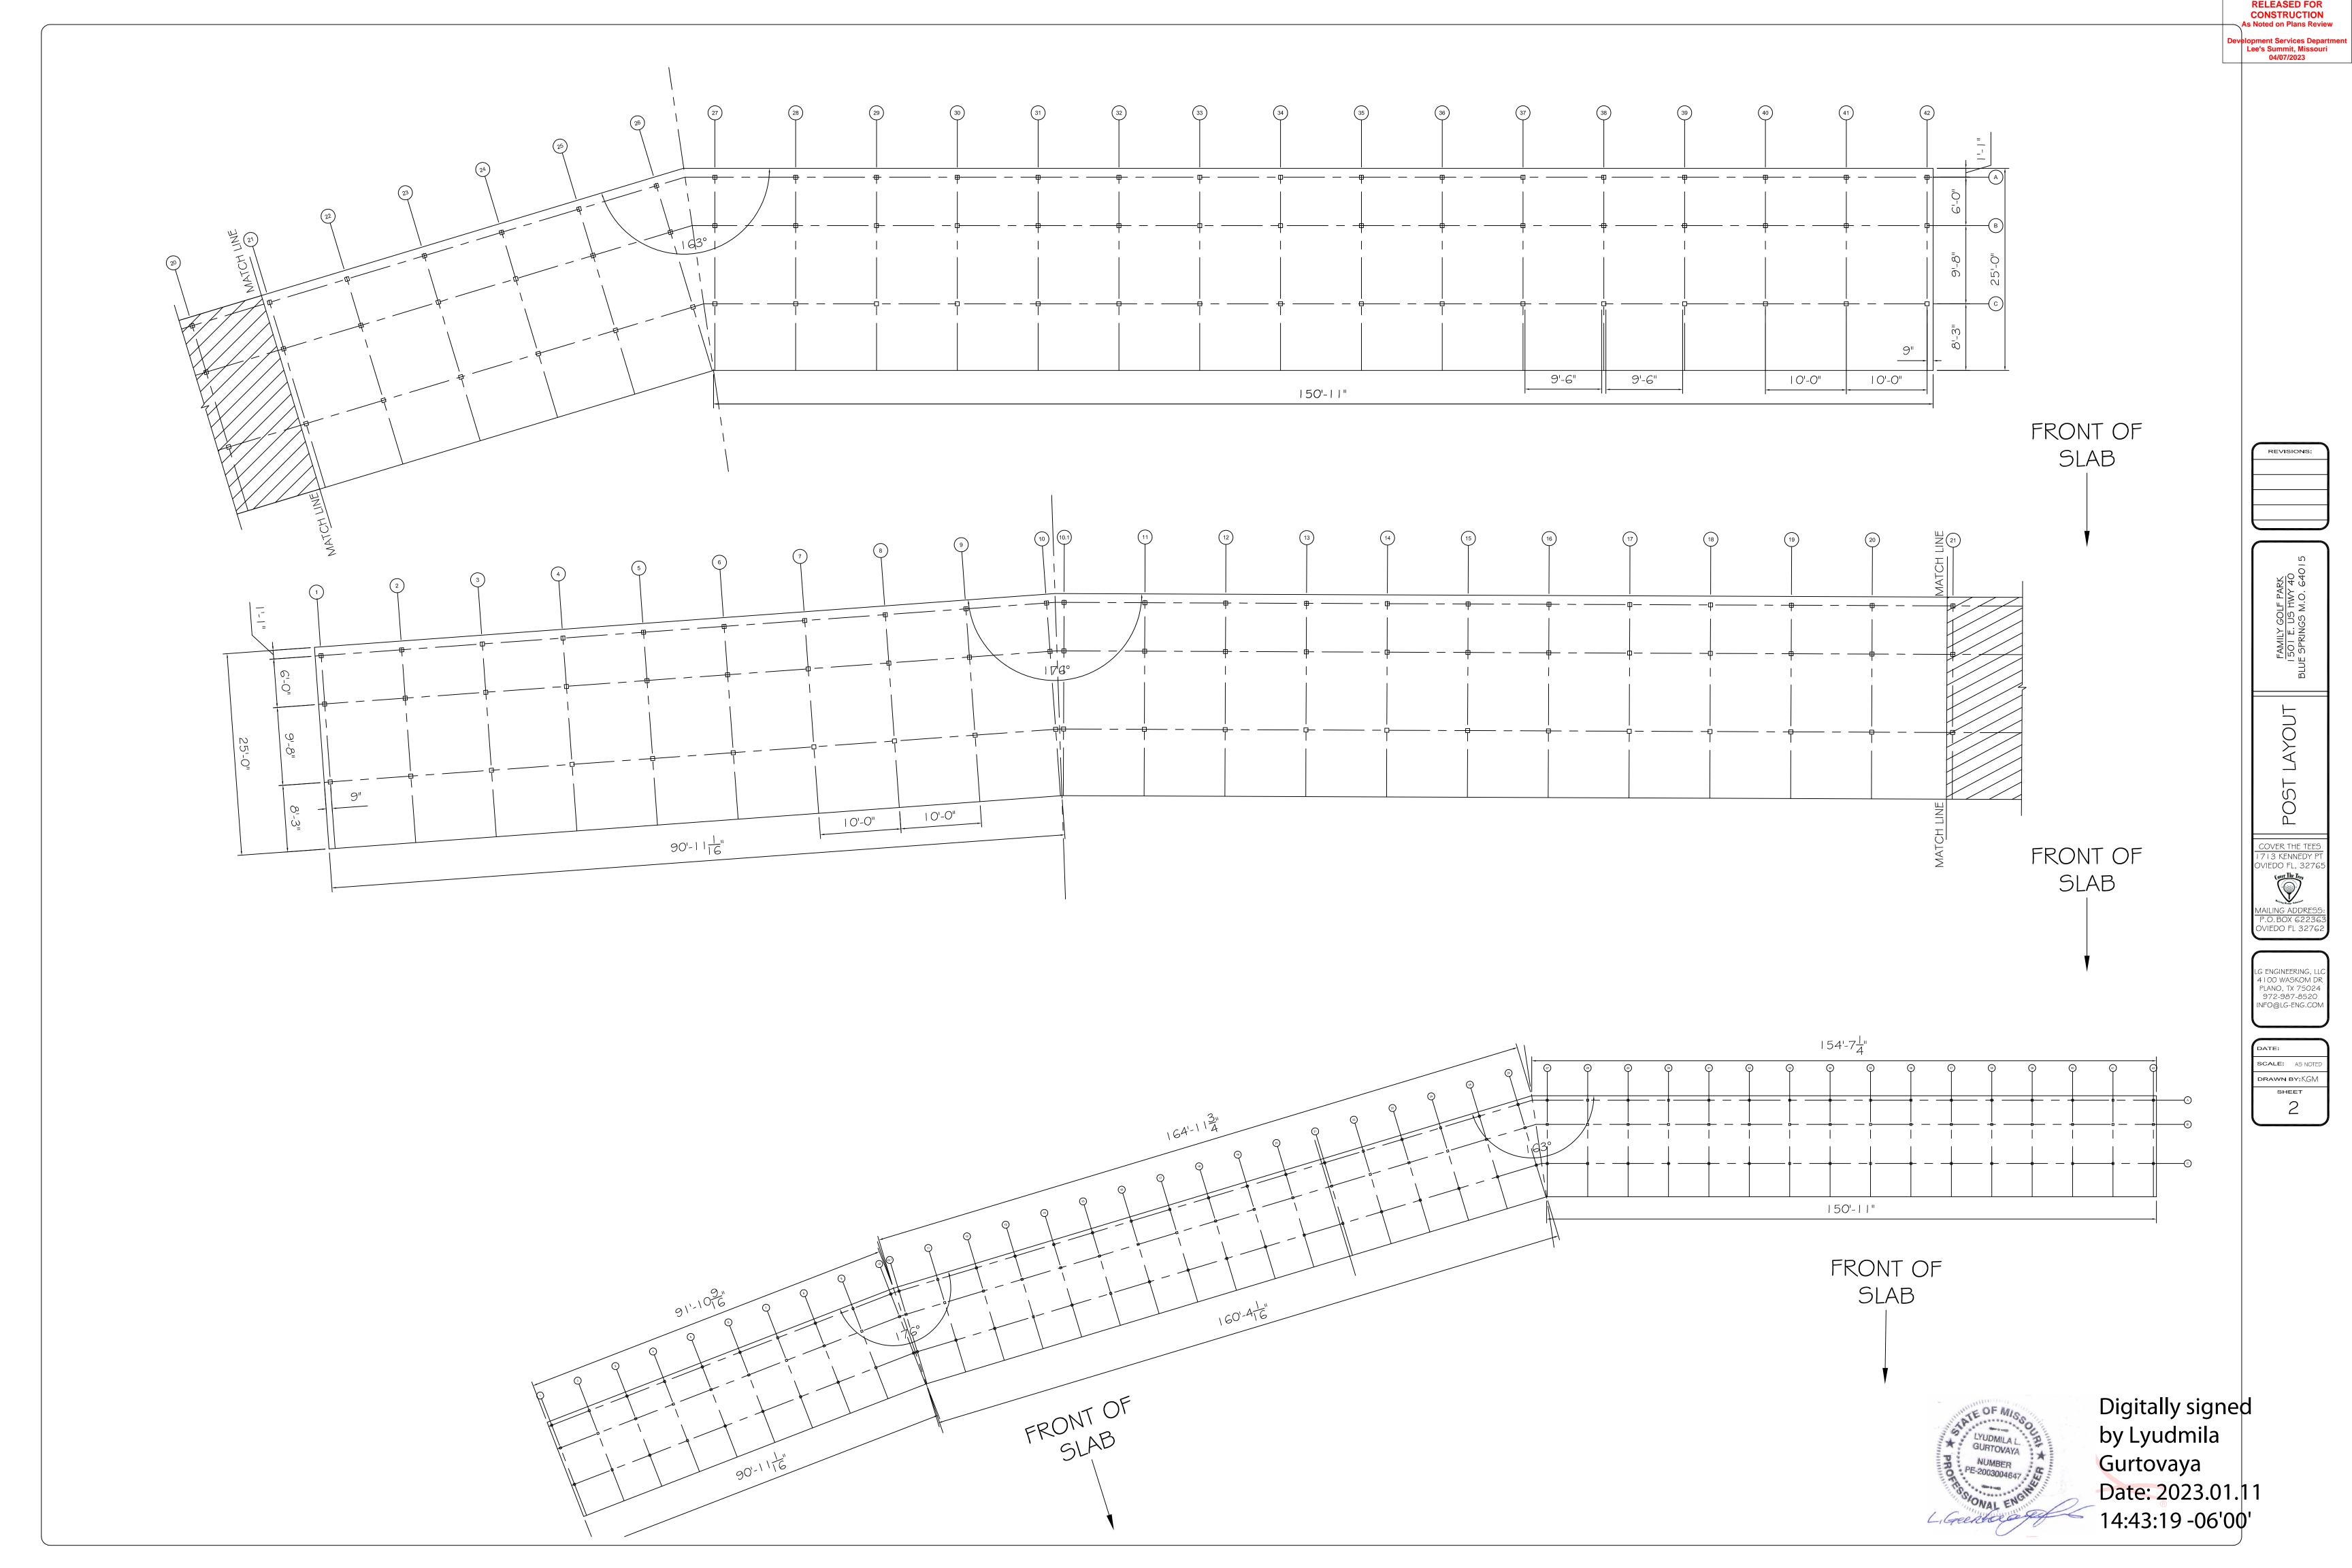

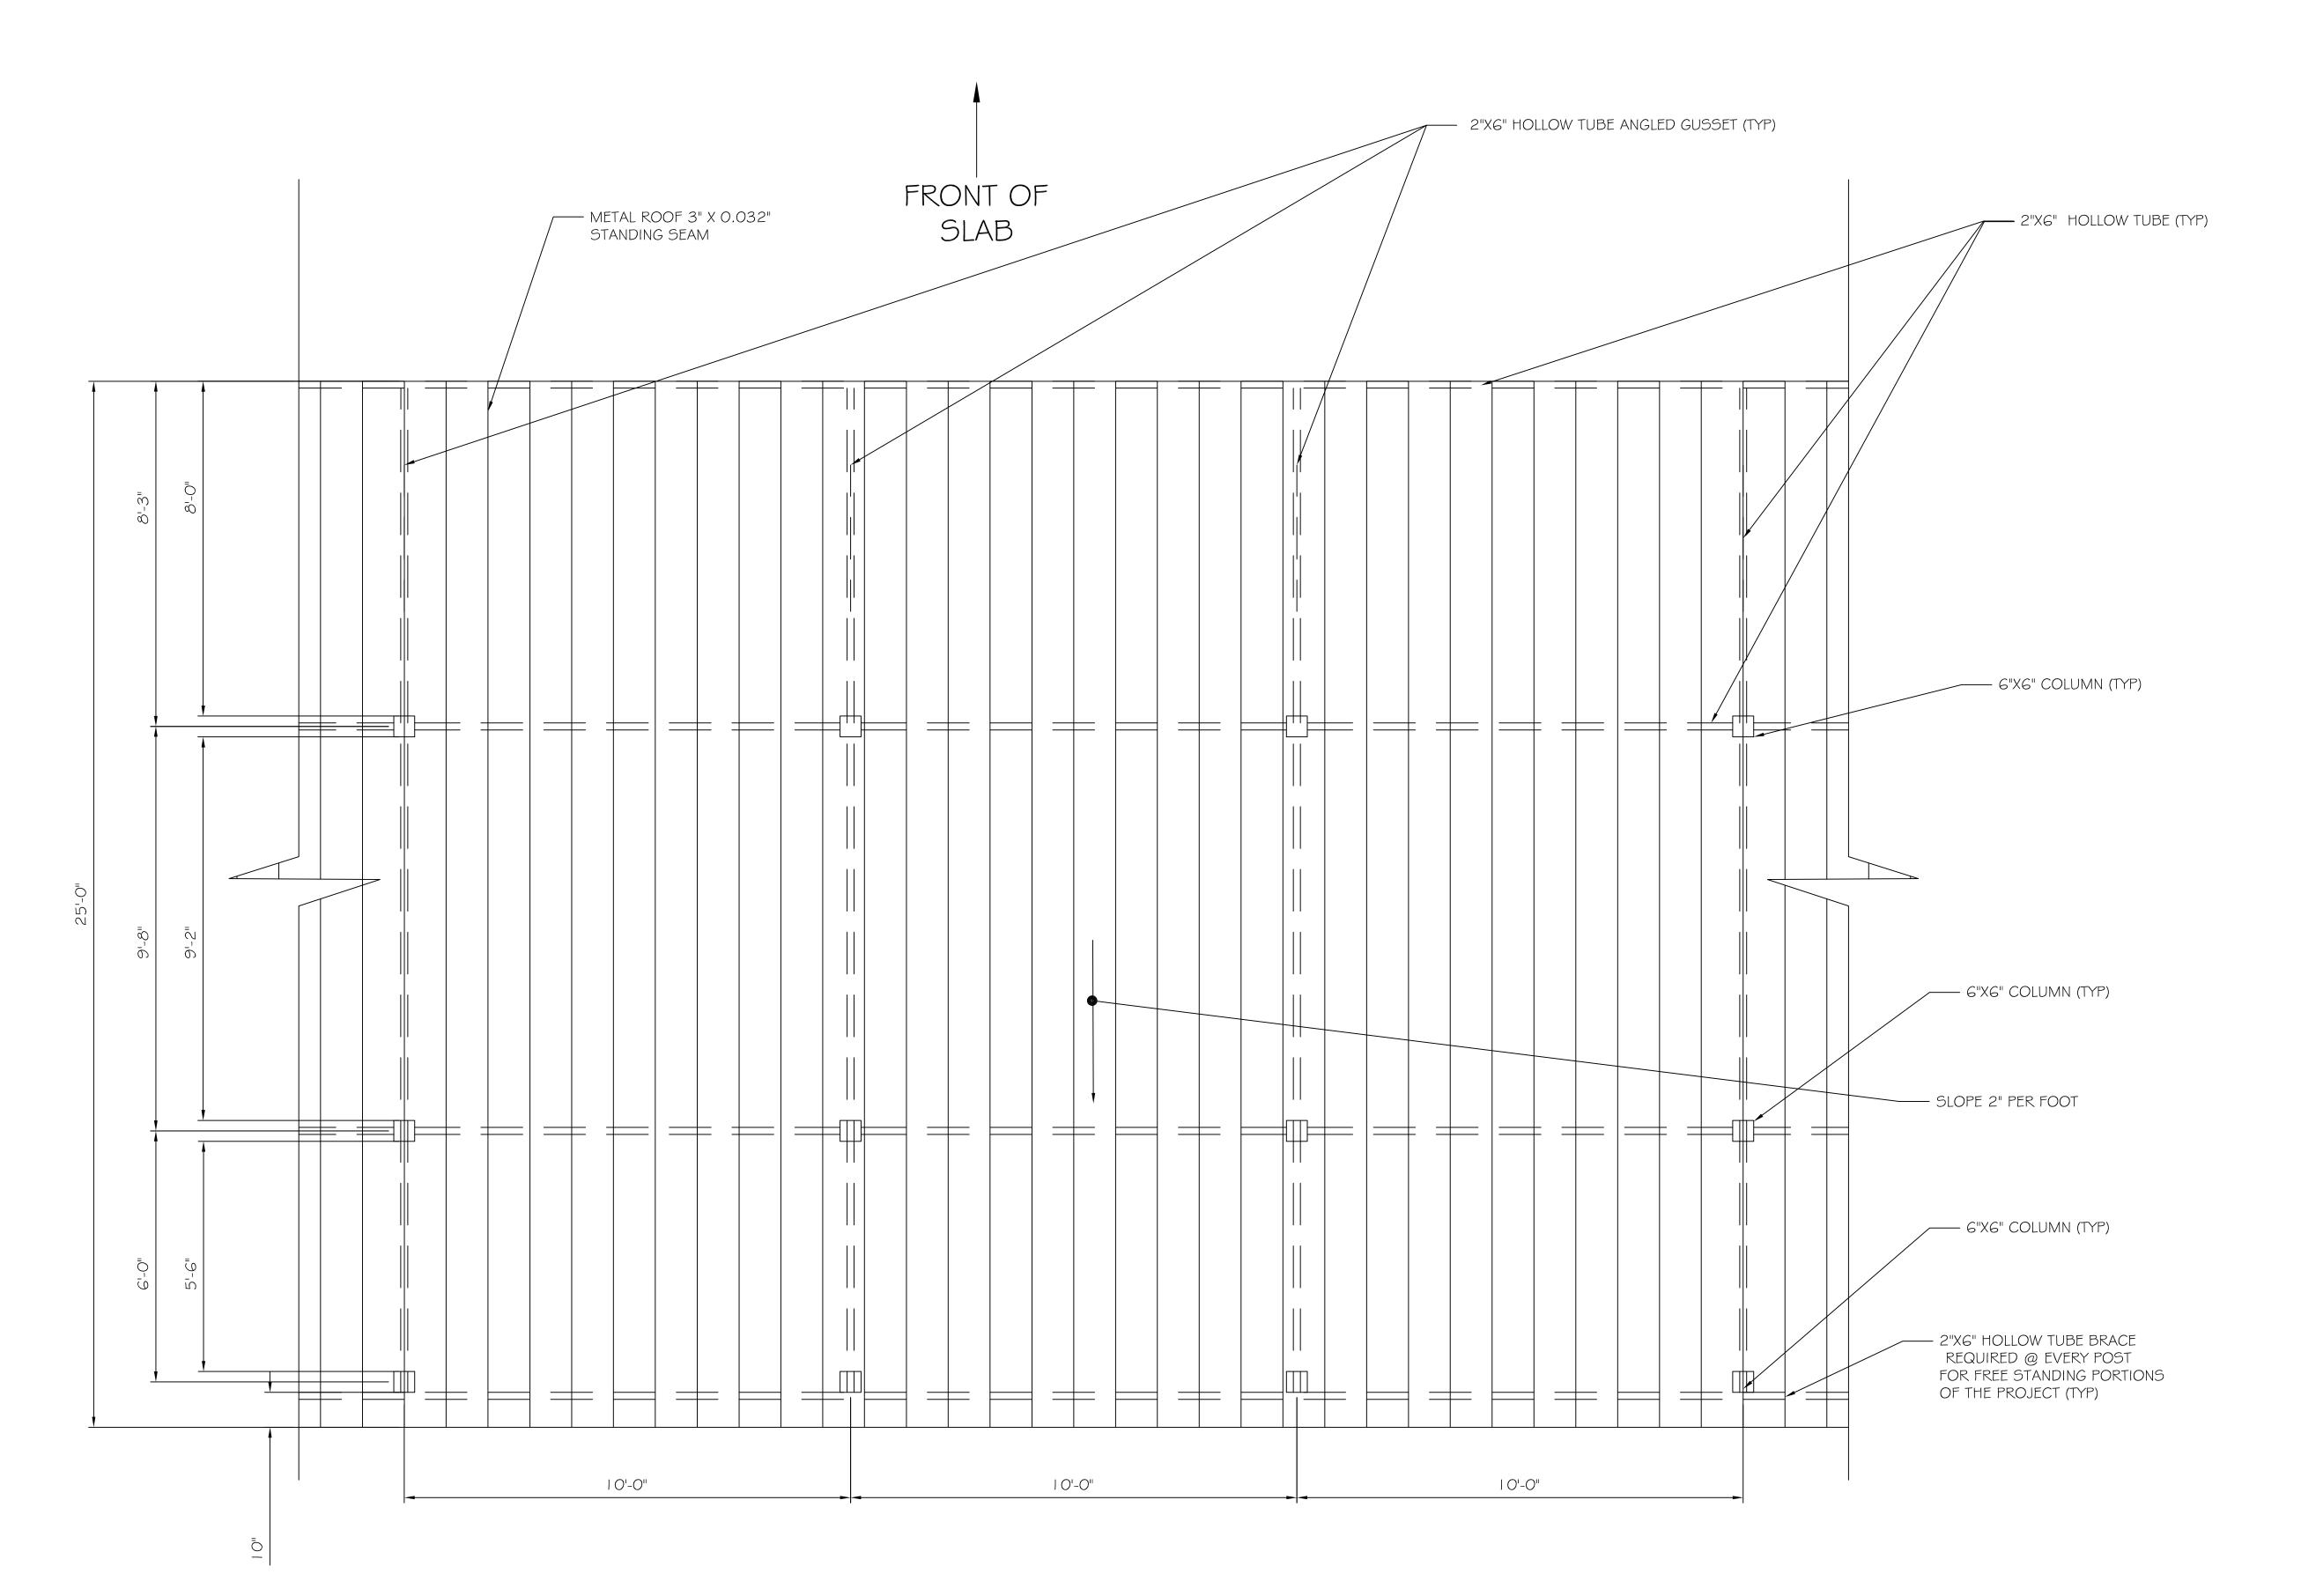


REVISIONS:

FAMILY GOLF PARK 1501 E. US HWY 40 3LUE SPRINGS M.O. 64015

PLAN VIEW






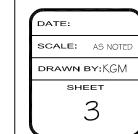



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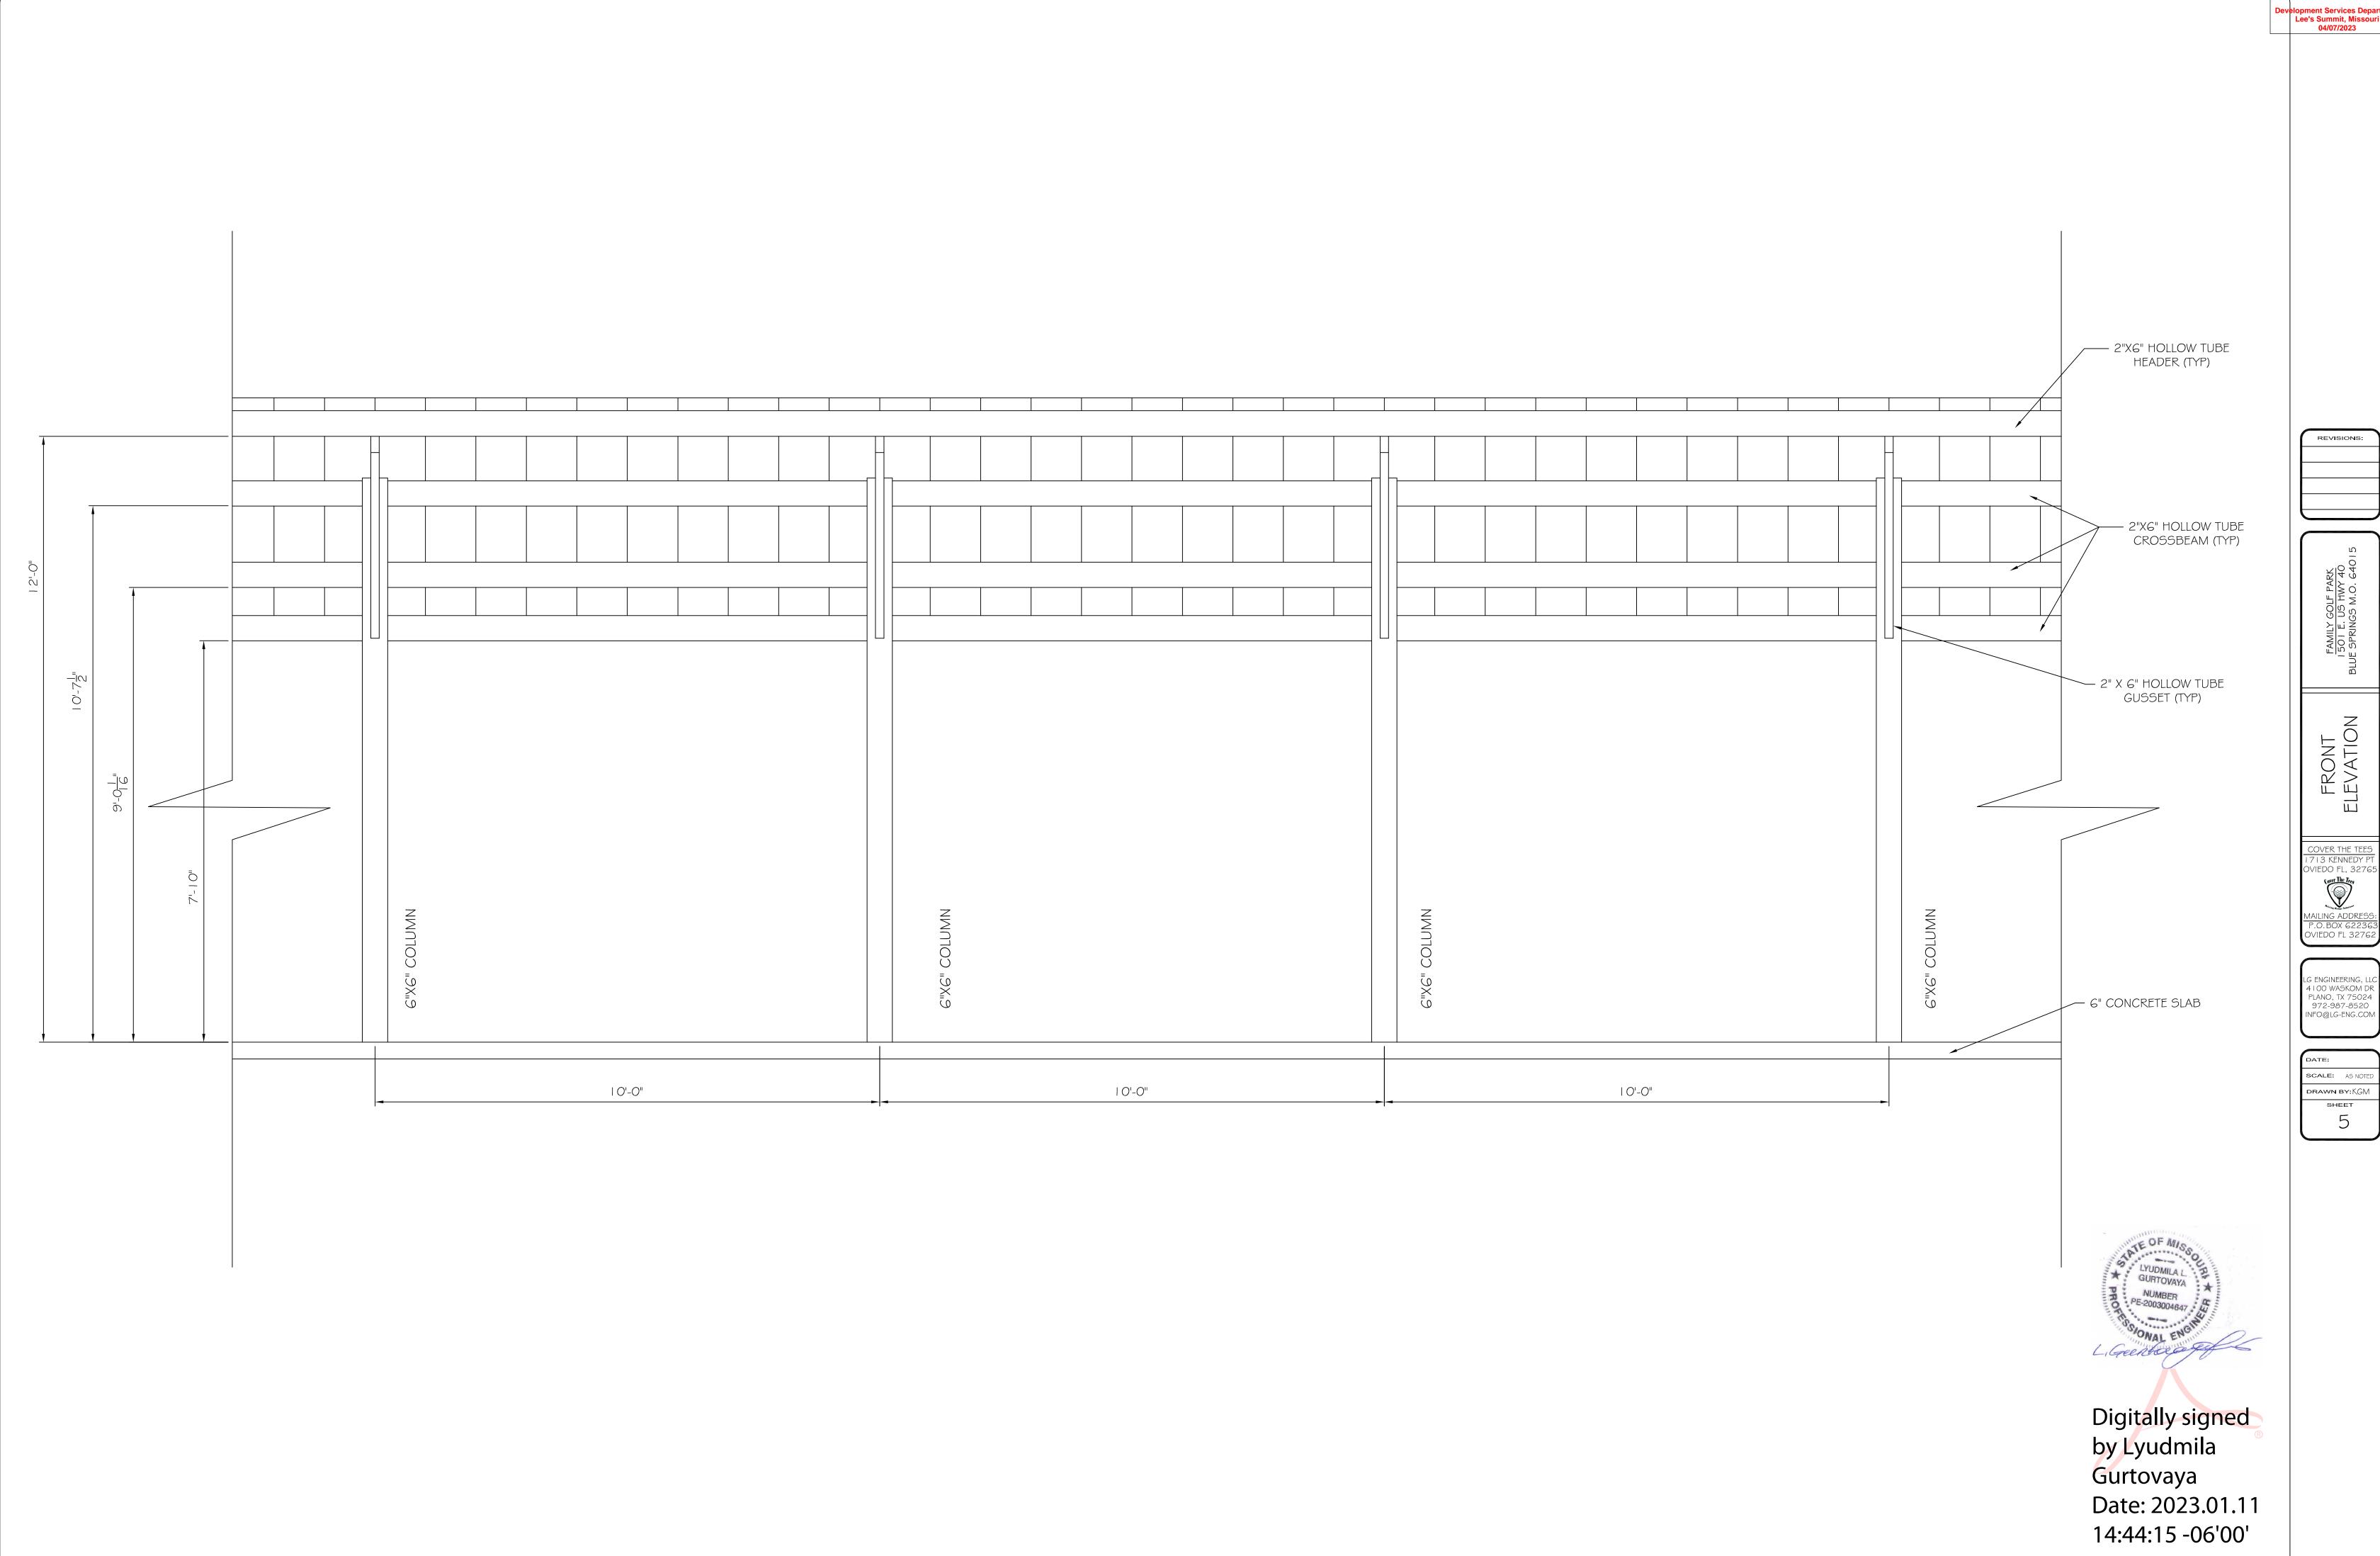

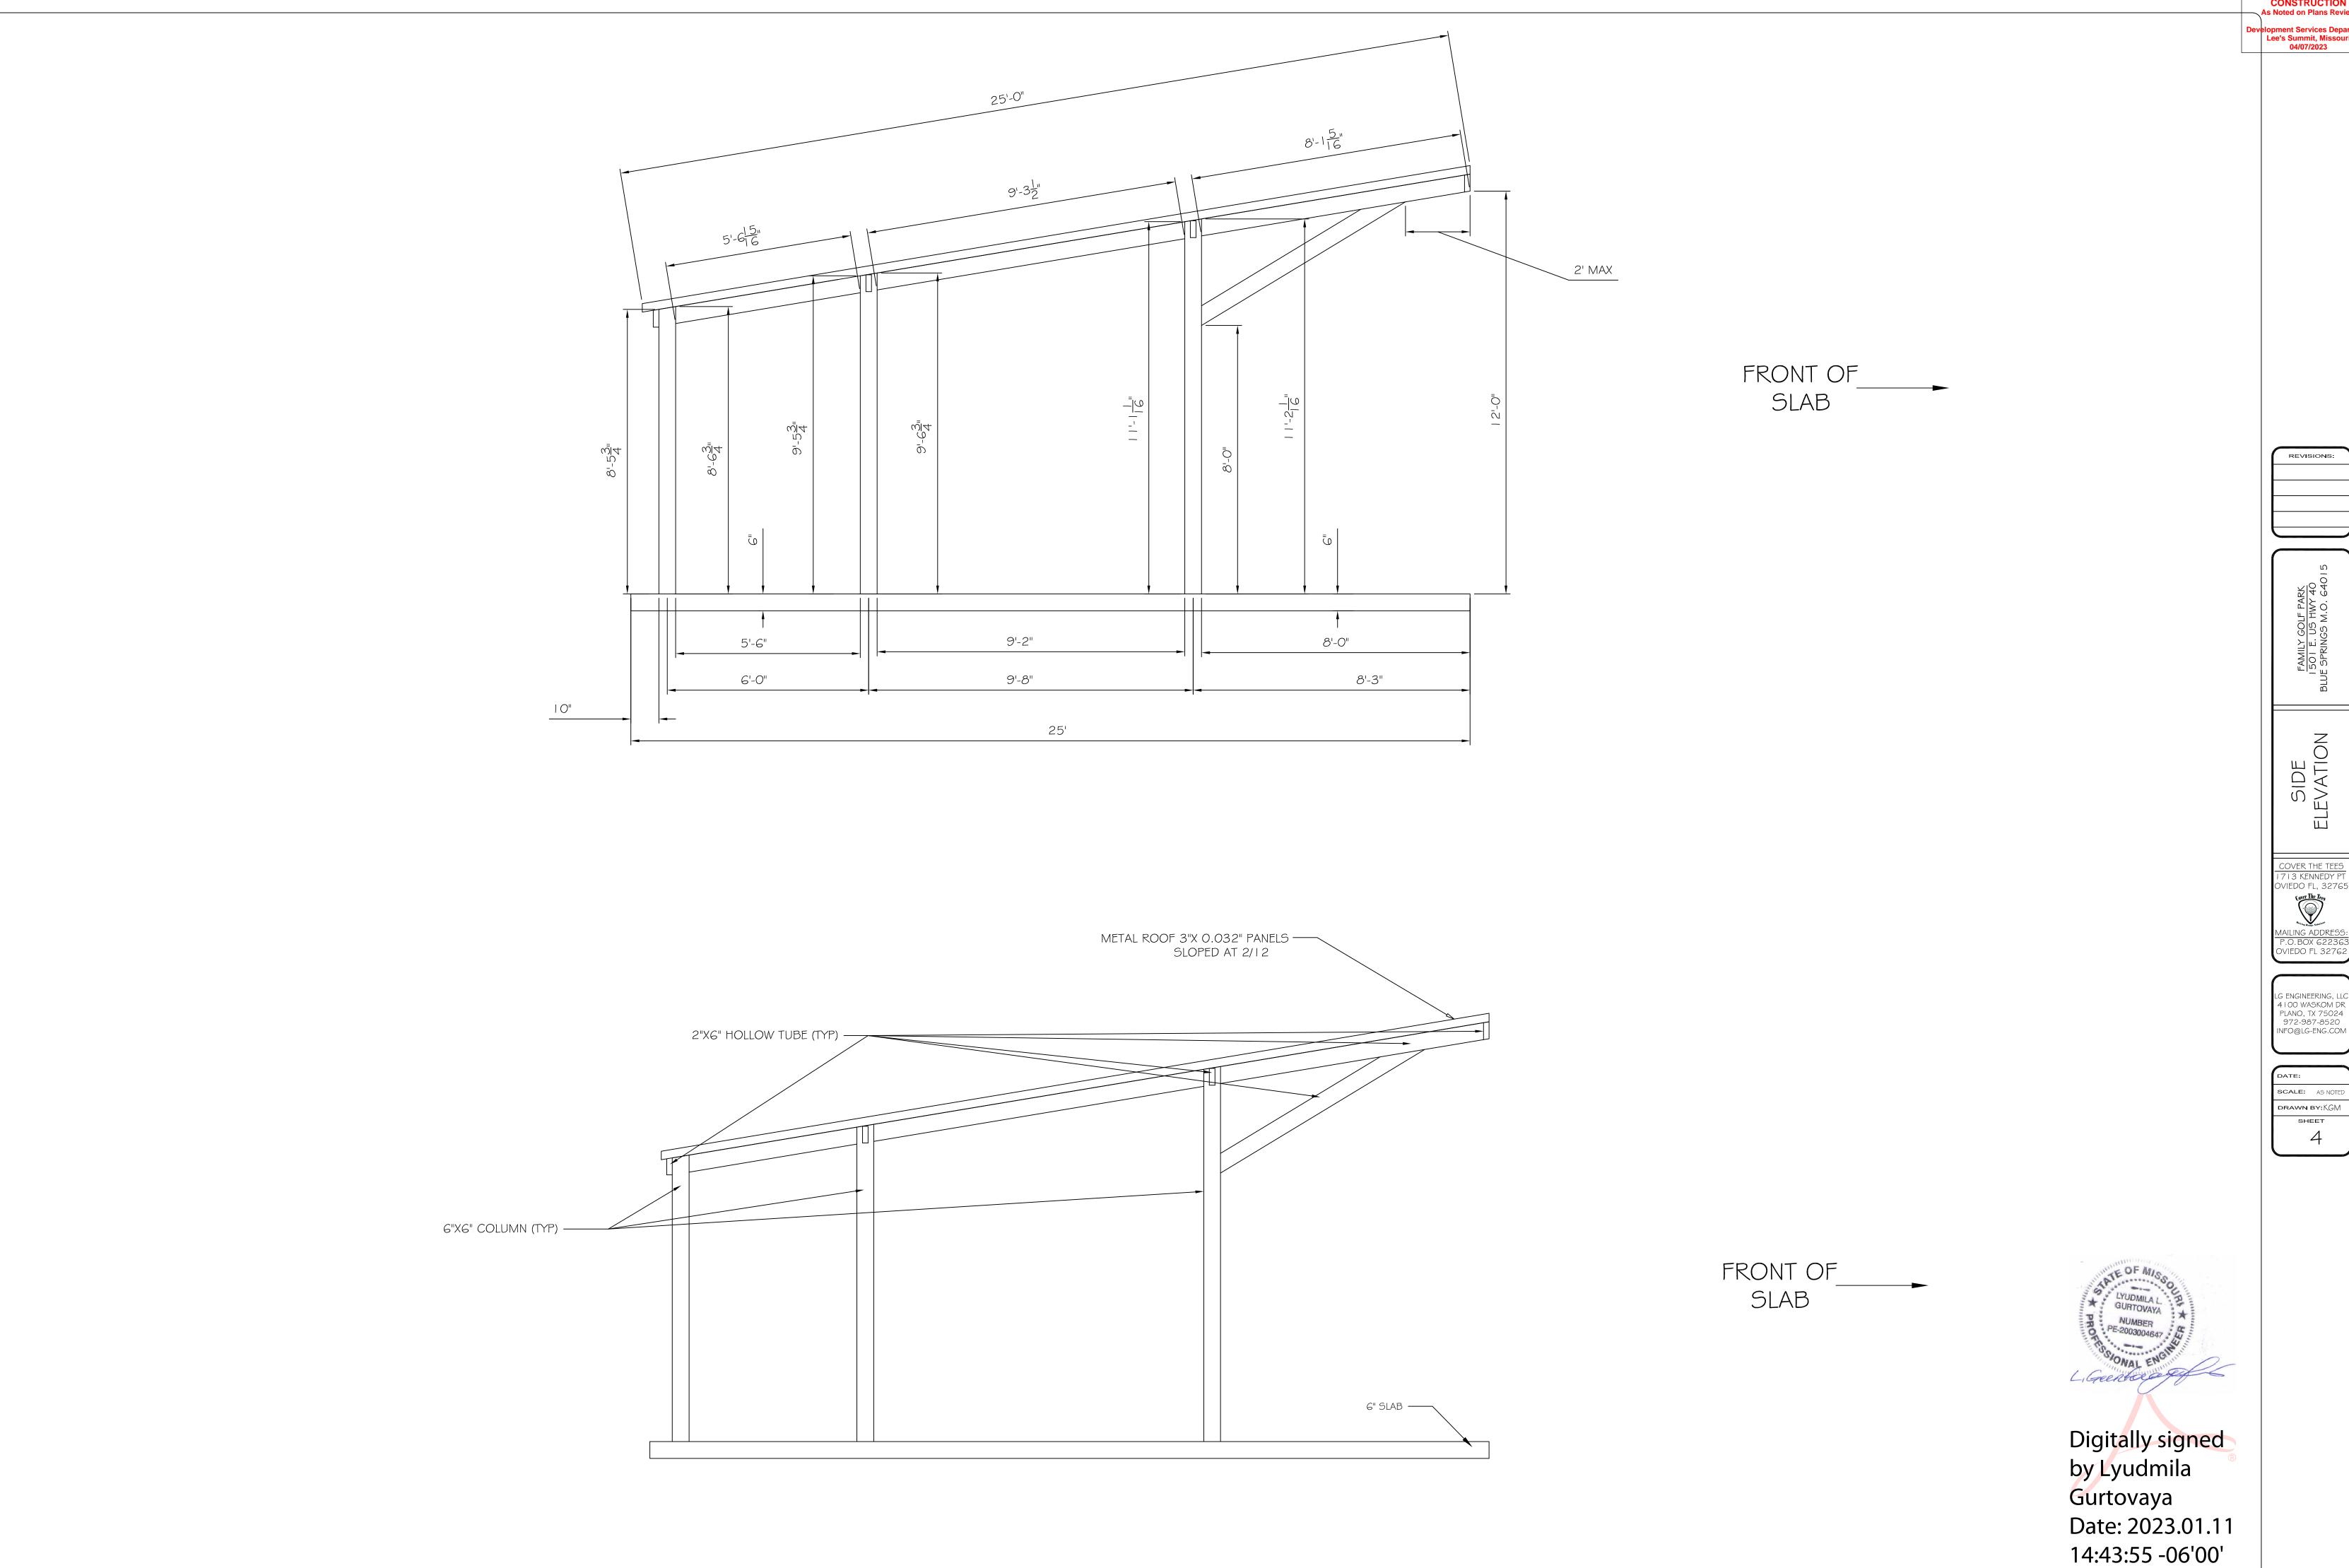
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SIDE ELEVATION








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LG ENGINEERING, LLC 4 I OO WASKOM DR PLANO, TX 75024 972-987-8520 INFO@LG-ENG.COM

SCALE: AS NOTED DRAWN BY:KGM
SHEET
5

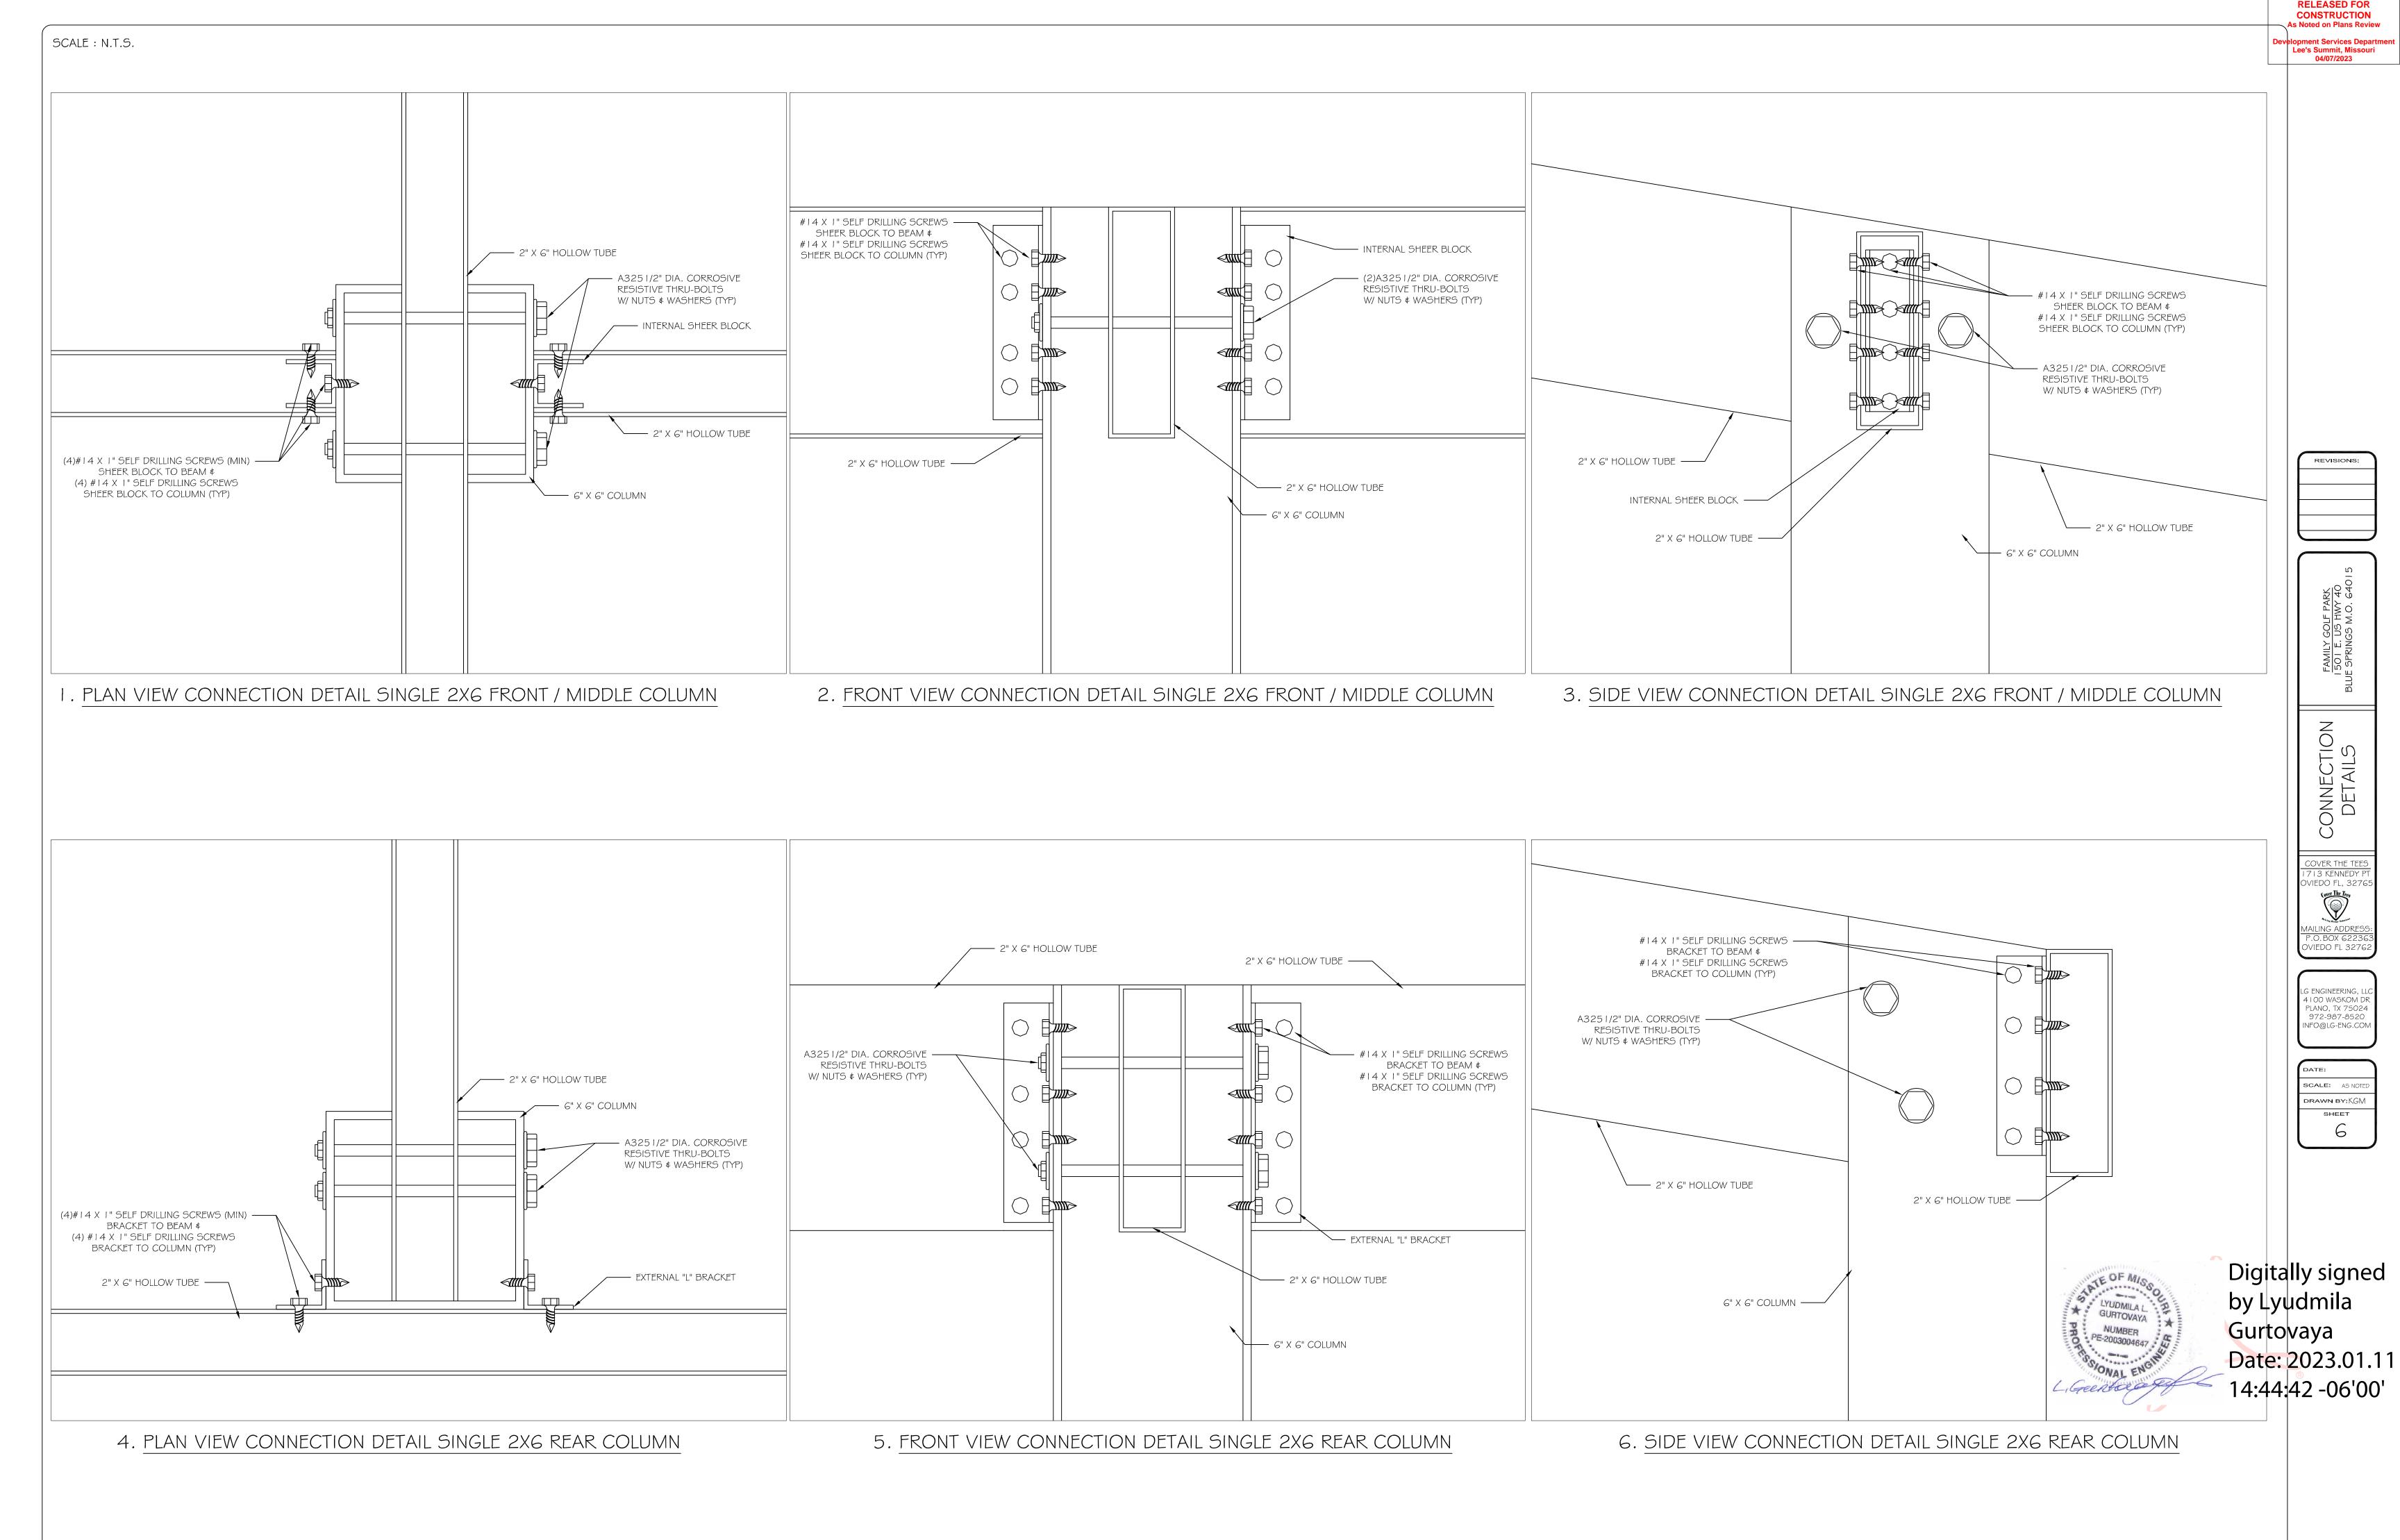

SCALE : N.T.S.

COVER THE TEES

17 13 KENNEDY PT

OVIEDO FL, 32765


WAILING ADDRESS:
P.O. BOX 622363

OVIEDO FL 32762


LG ENGINEERING, LLC 4100 WASKOM DR PLANO, TX 75024 972-987-8520 INFO@LG-ENG.COM

SCALE: AS NOTED


DRAWN BY: KGM

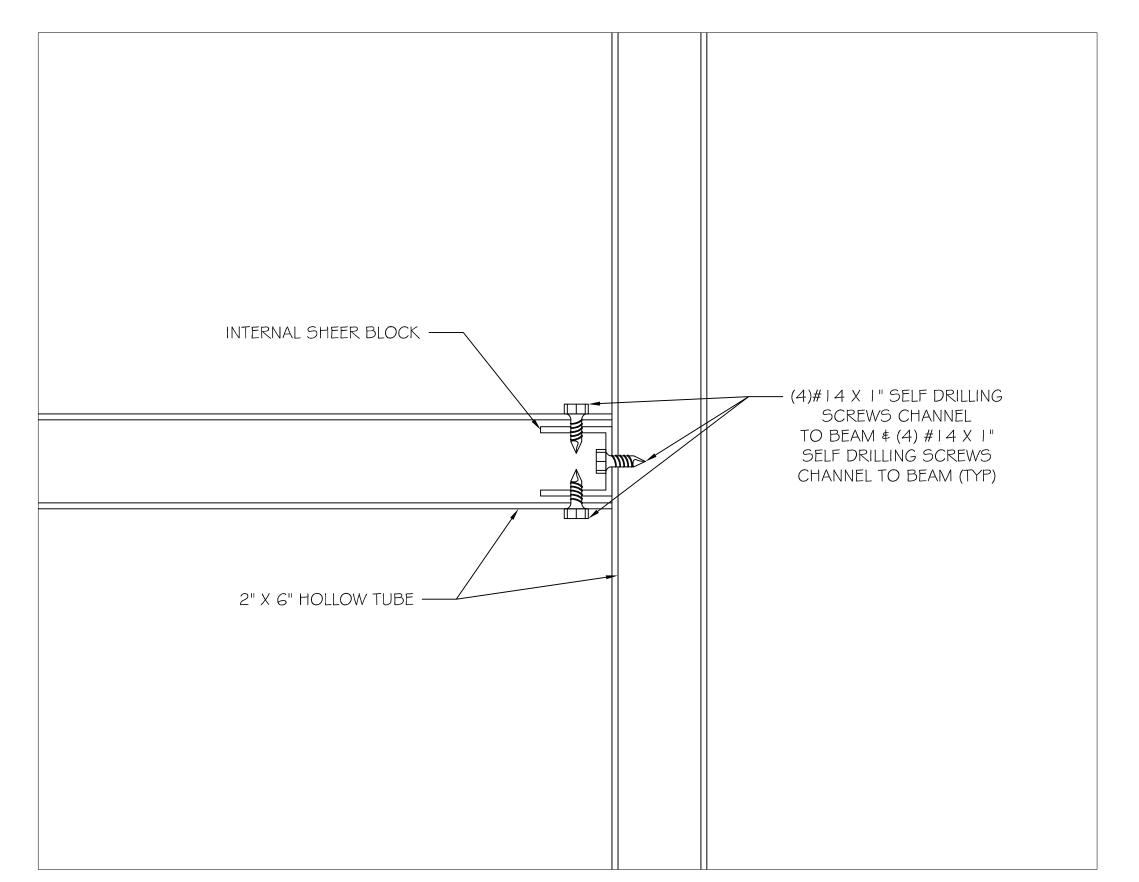

7. PLAN VIEW CONNECTION DETAIL SINGLE 2X6 BEAM TO BEAM

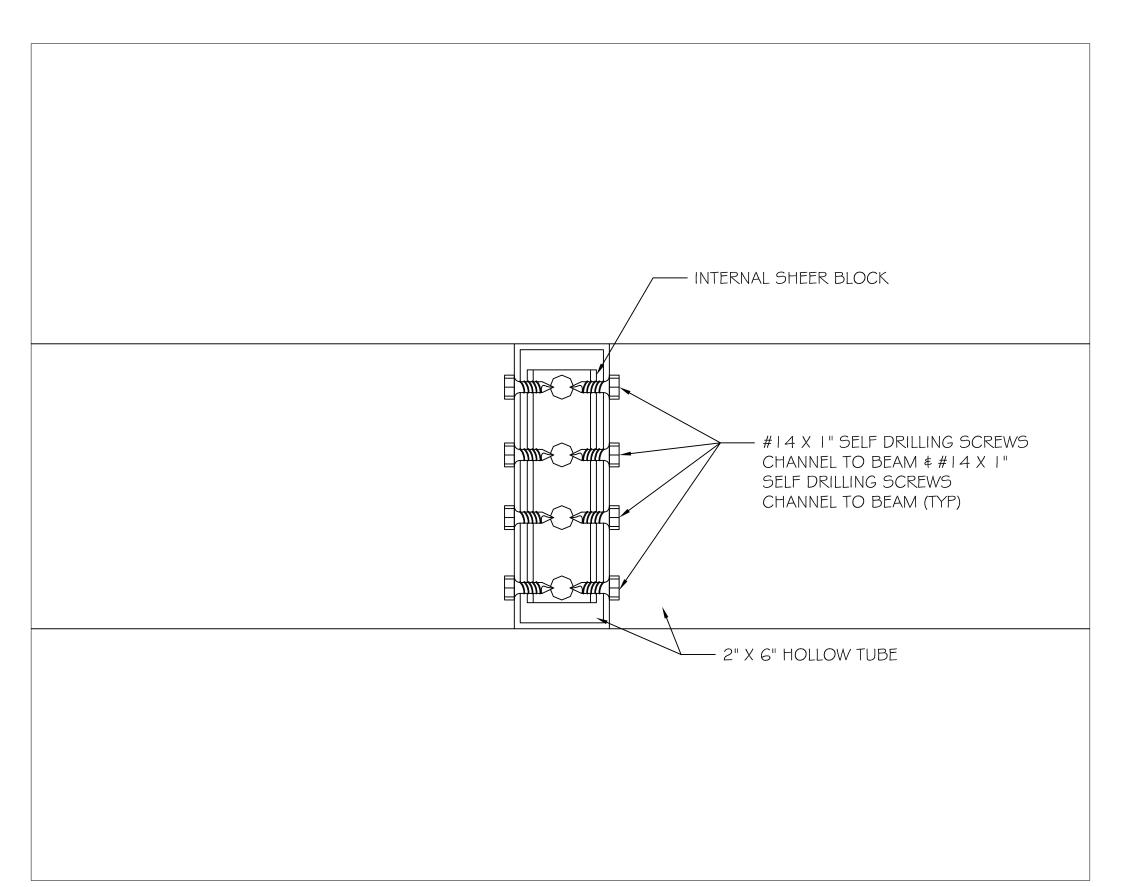


8. FRONT VIEW CONNECTION DETAIL SINGLE 2X6 BEAM TO BEAM

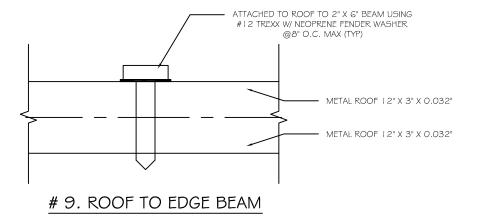



Digitally signed by Lyudmila Gurtovaya Date: 2023.01.11 14:45:04 -06'00'

SCALE : N.T.S.

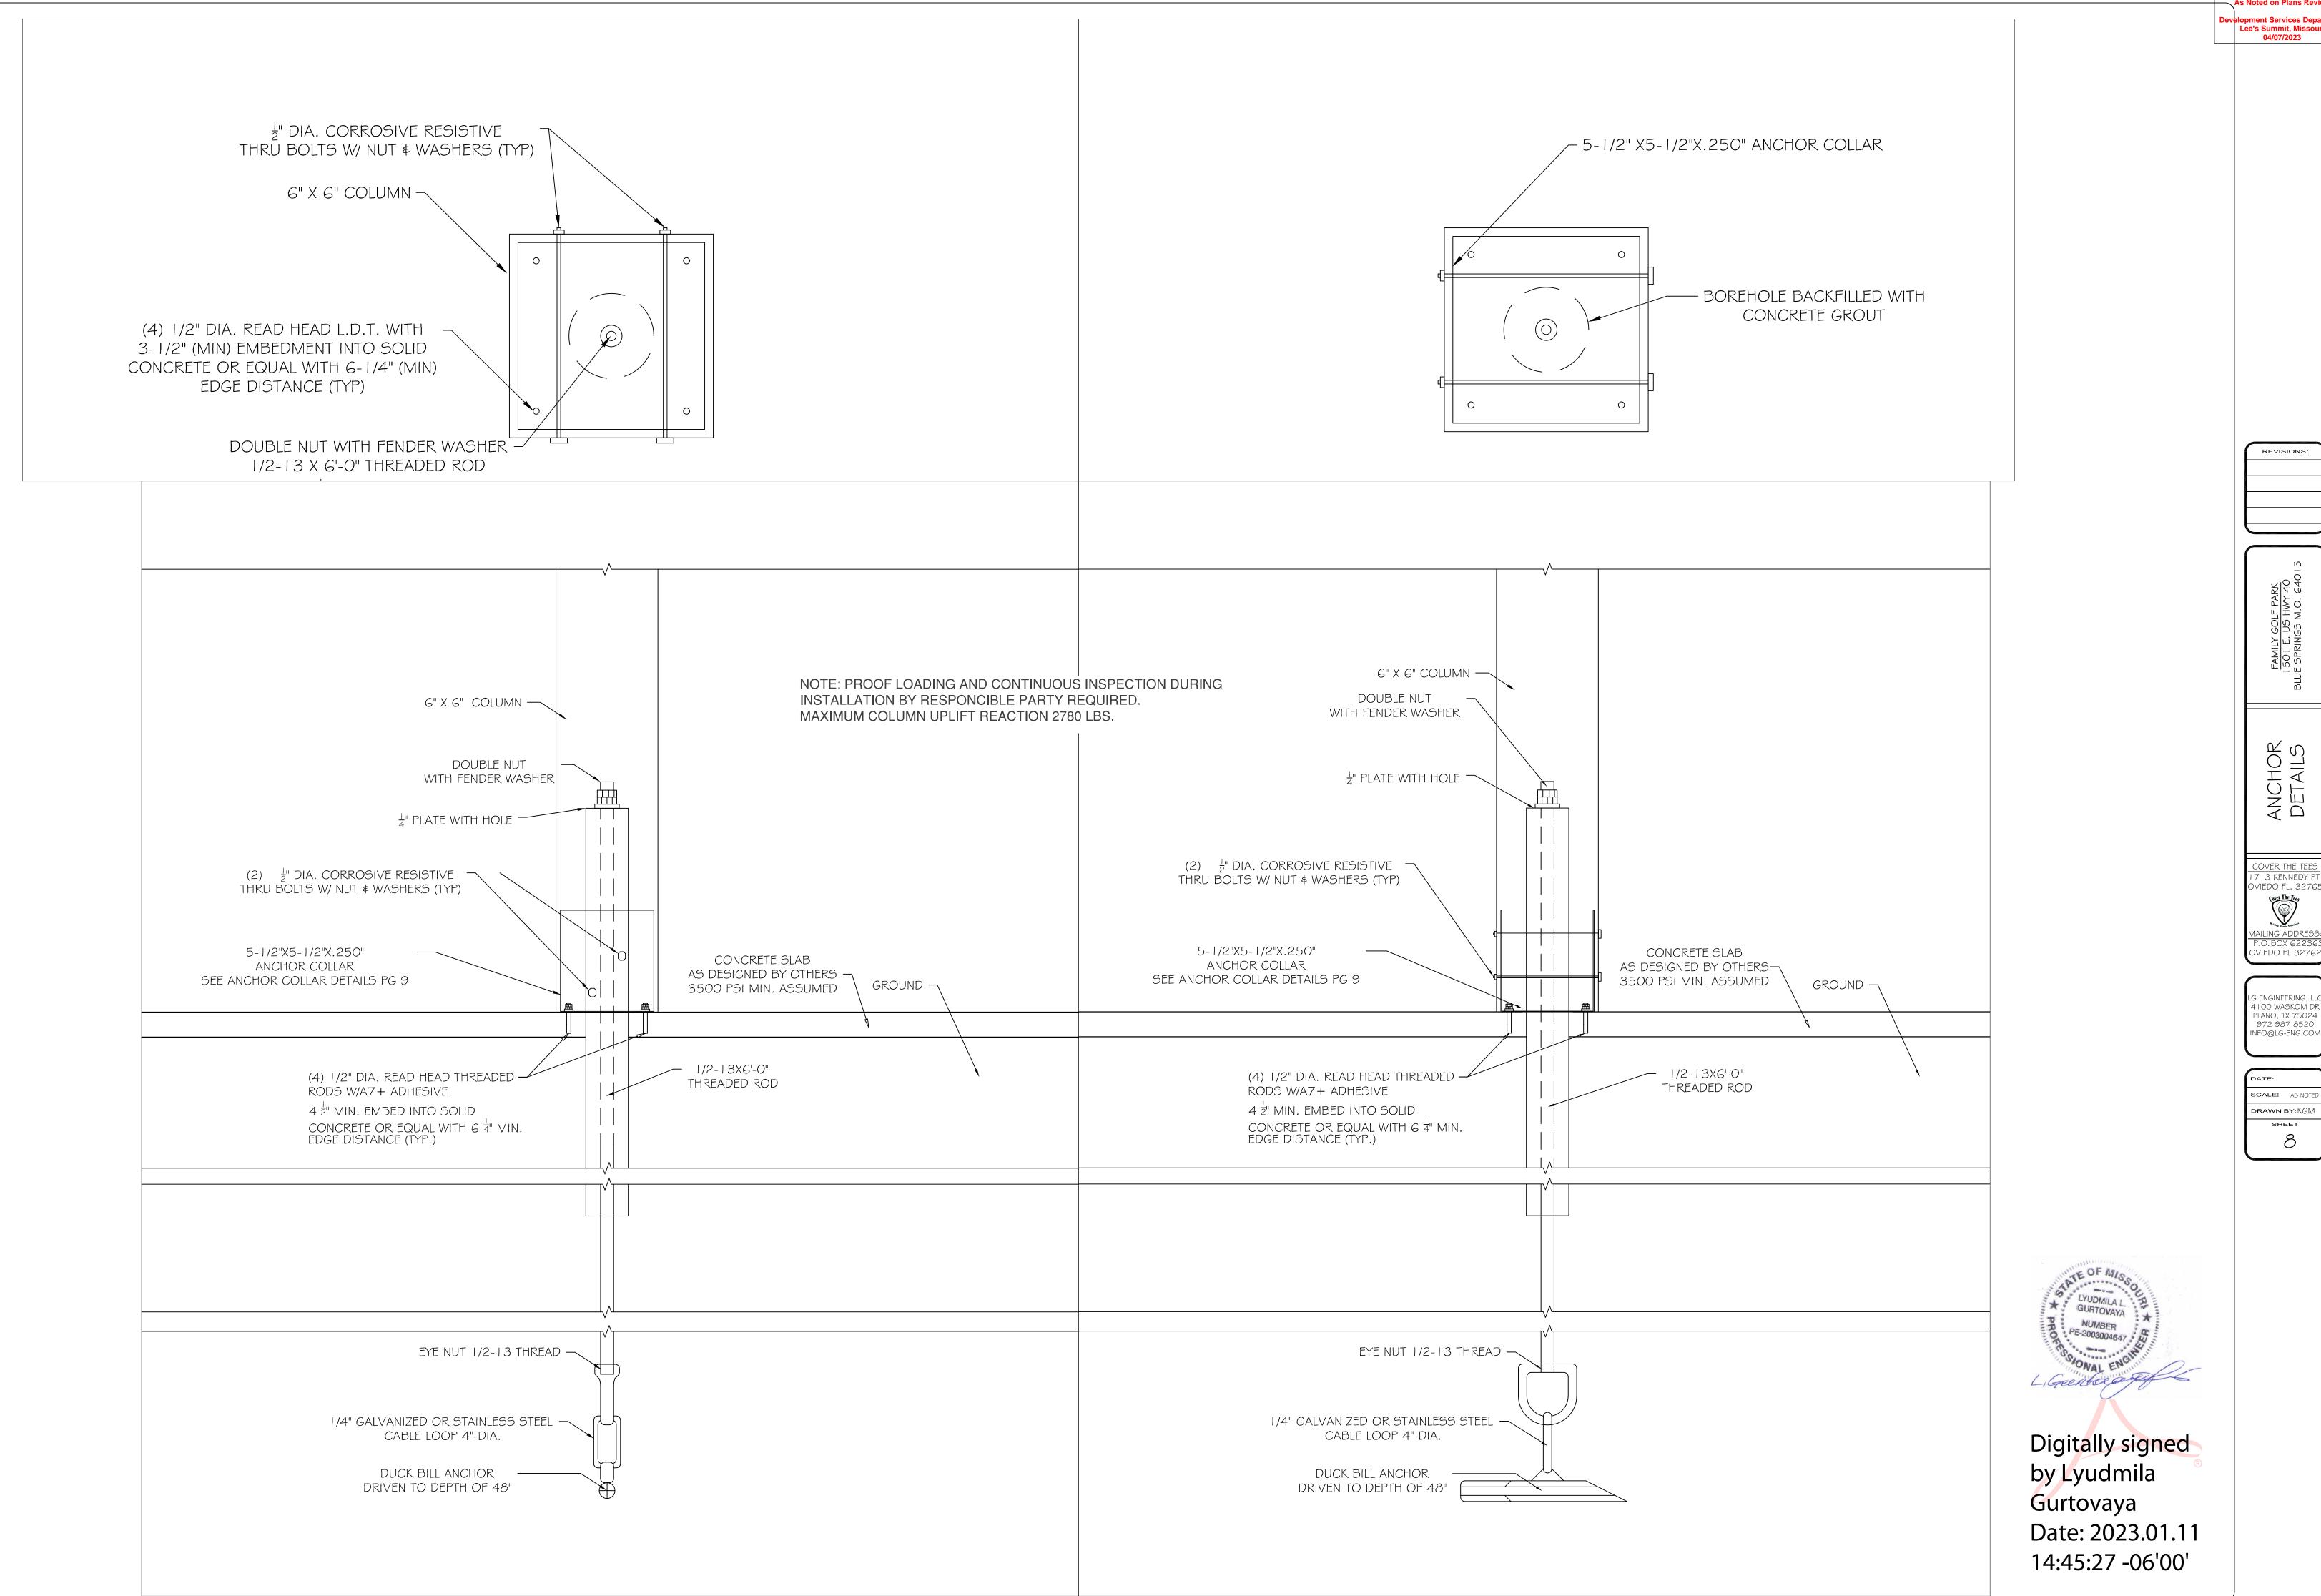



CONSTRUCTION
As Noted on Plans Review

RELEASED FOR


MAILING ADDRESS:
P.O. BOX 622363
OVIEDO FL 32762


LG ENGINEERING, LLC 4100 WASKOM DR PLANO, TX 75024 972-987-8520 INFO@LG-ENG.COM

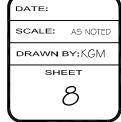

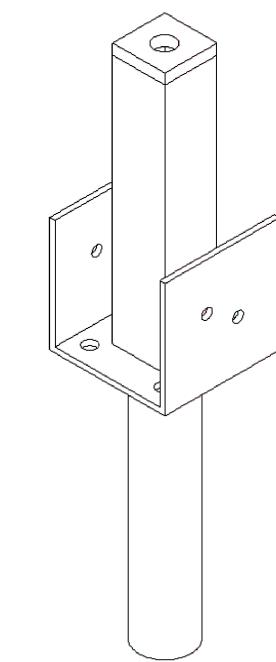


5-1/2"X5-1/2"X6"T ANCHOR COLLAR ISOMETRIC VIEW

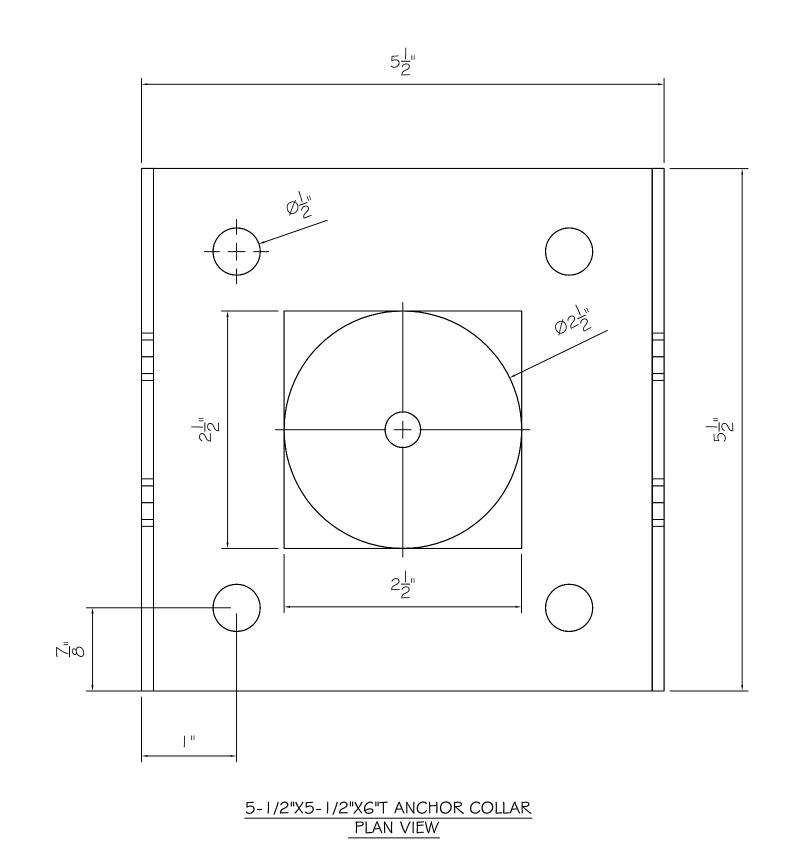


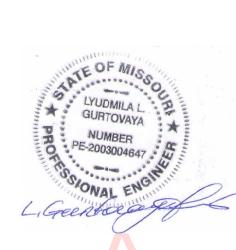

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5-1/2"X5-1/2"X6"T ANCHOR COLLAR FRONT VIEW

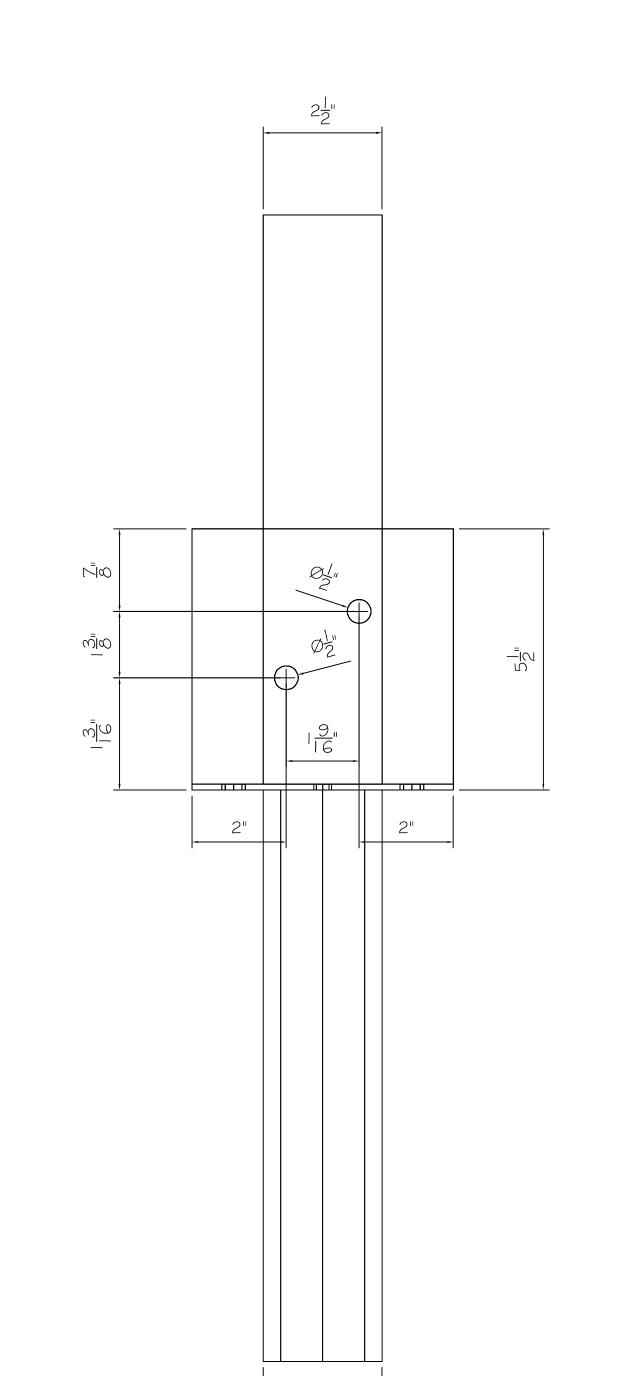

5-1/2"X5-1/2"X6"T ANCHOR COLLAR SIDE VIEW

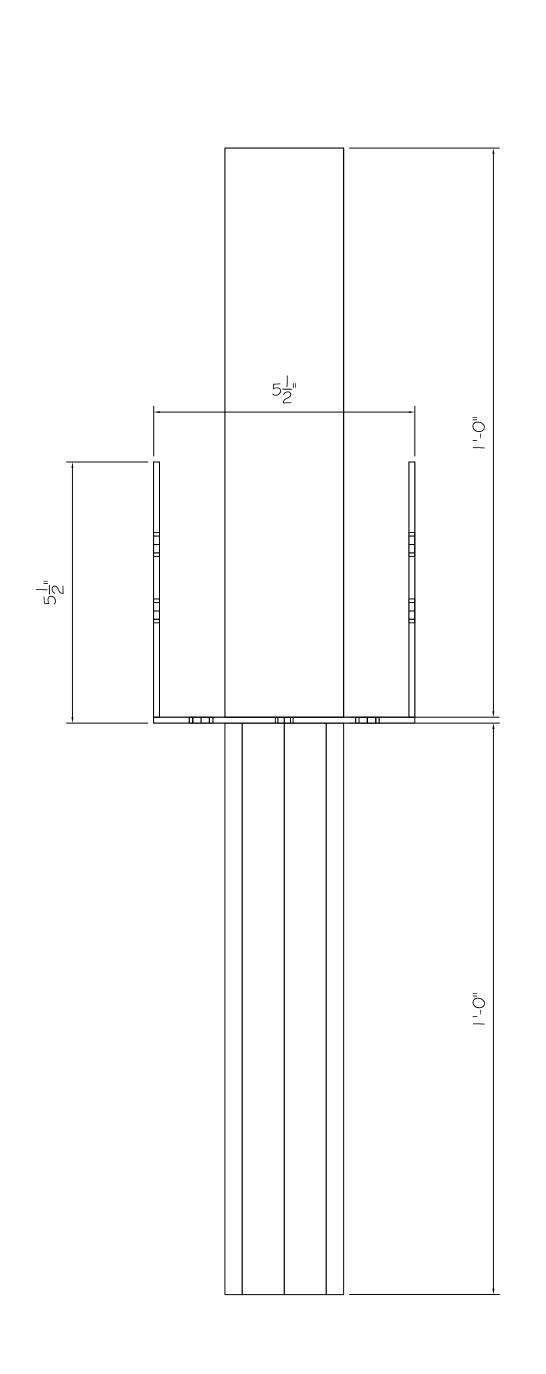FAMILY GOLF PARK 1501 E. US HWY 40 BLUE SPRINGS M.O. 64015

> ANCHUR COLLAR DETAILS

COVER THE TEES

17 1 3 KENNEDY PT

OVIEDO FL, 32765

OVIEDO FL 32765

MAILING ADDRESS:
P.O. BOX 622363

OVIEDO FL 32762



SCALE: AS NOTED

DRAWN BY:KGM