

C:\Users\Jesse\Documents\Paragon Star\_Bldg2\Log\_121-Central\_CA\_fredrikz@finklewilliams.com.rvt

RENDERING FOR CONCEPTUAL REFERENCE ONLY; IMAGE MAY NOT REFLECT LATEST DESIGN. REFERENCE ELEVATIONS AND SCHEDULES FOR FINISHES.



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FS102.2 FIRE SPRINKLER 2ND FLOOR PLAN EAST  
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PROJECT TEAM

**ARCHITECT**  
FINKLE + WILLIAMS ARCHITECTURE  
8787 Renner Blvd, Suite 100  
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**CIVIL**  
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**LANDSCAPE**  
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2100 Central St, Suite 01C  
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**FOUNDATIONS**  
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**CONTRACTOR**  
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Kansas City, Missouri 64108  
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Lenexa, Kansas 66214  
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**PLUMBING**  
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**ELECTRICAL**  
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PH. 913-742-5000

**FIRE PROTECTION**  
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Lenexa, Kansas 66214  
PH. 913-742-5000



FINKLE + WILLIAMS  
ARCHITECTURE

PROJECT ADDRESS  
3201 NW PARAGON  
PKWY  
LEES SUMMIT, MO


PARAGON STAR BLDG 2 / LOT 9

PROJECT NUMBER 19050.01a  
RELEASE DATE 11.29.22  
ISSUED FOR CONSTRUCTION  
CURRENT REVISION (4) 01.20.23 ASI-01





## REGISTRATION

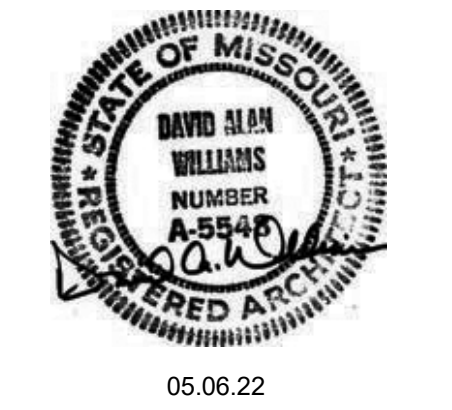

## PROJECT TEAM

ARCHITECT	FINKLE+WILLIAMS ARCHITECTURE
CONTRACTOR	GBA
LANDSCAPE	LAND 3
FOUNDATIONS	BSE STRUCTURAL ENGINEERS
STRUCTURAL	BSE STRUCTURAL ENGINEERS
PLUMBING	HENDERSON ENGINEERS
Mechanical	HENDERSON ENGINEERS
ELECTRICAL	HENDERSON ENGINEERS
EROSION PROTECTION	HENDERSON ENGINEERS
CONTRACTOR	FOGEL-ANDERSON

INKLE + WILLIAMS  
ARCHITECTURE


3787 RENNER BLVD., SUITE 100  
LENEXA, KANSAS 66219  
913.498.1550  
www.finklewilliams.com

## SHEET TITLE

## ARCHITECTURAL SITE PLAN


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## A0.03

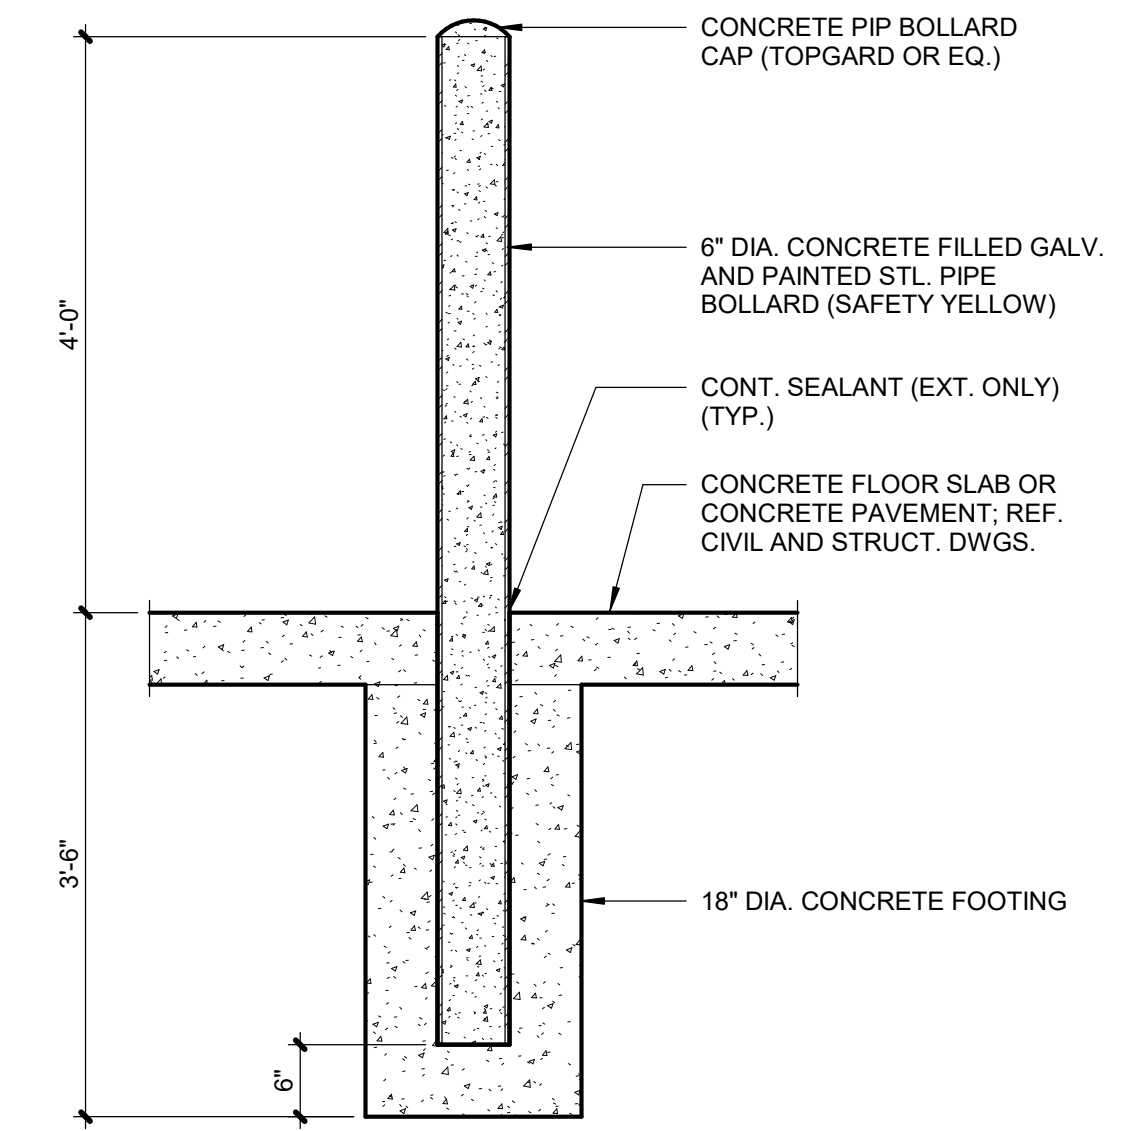


2	BOLLARD DETAIL
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<b>A0.03</b>	SCALE : 3/4" = 1'-0"
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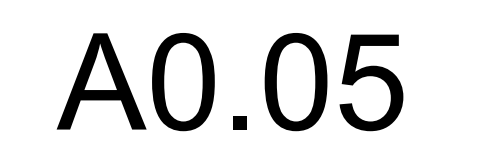


1	ARCHITECTURAL SITE PLAN
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<b>A0.03</b>	SCALE : 1/16" = 1'-0"
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1. PROVIDE TERMITE CONTROL UNDER NEW FLOOR SLABS.
2. ALL STRUCTURAL STEEL TO BE FACTORY PRIMED GRAY.
3. ALL CMU CORNERS ARE TO BE CONSTRUCTED OF BULLNOSE BLOCK.
4. ALL SWITCHES, RECEPTACLES, PHONE/DATA, AND CONTROLS ARE TO BE GRAY COLOR WITH STAINLESS STEEL COVER PLATES.

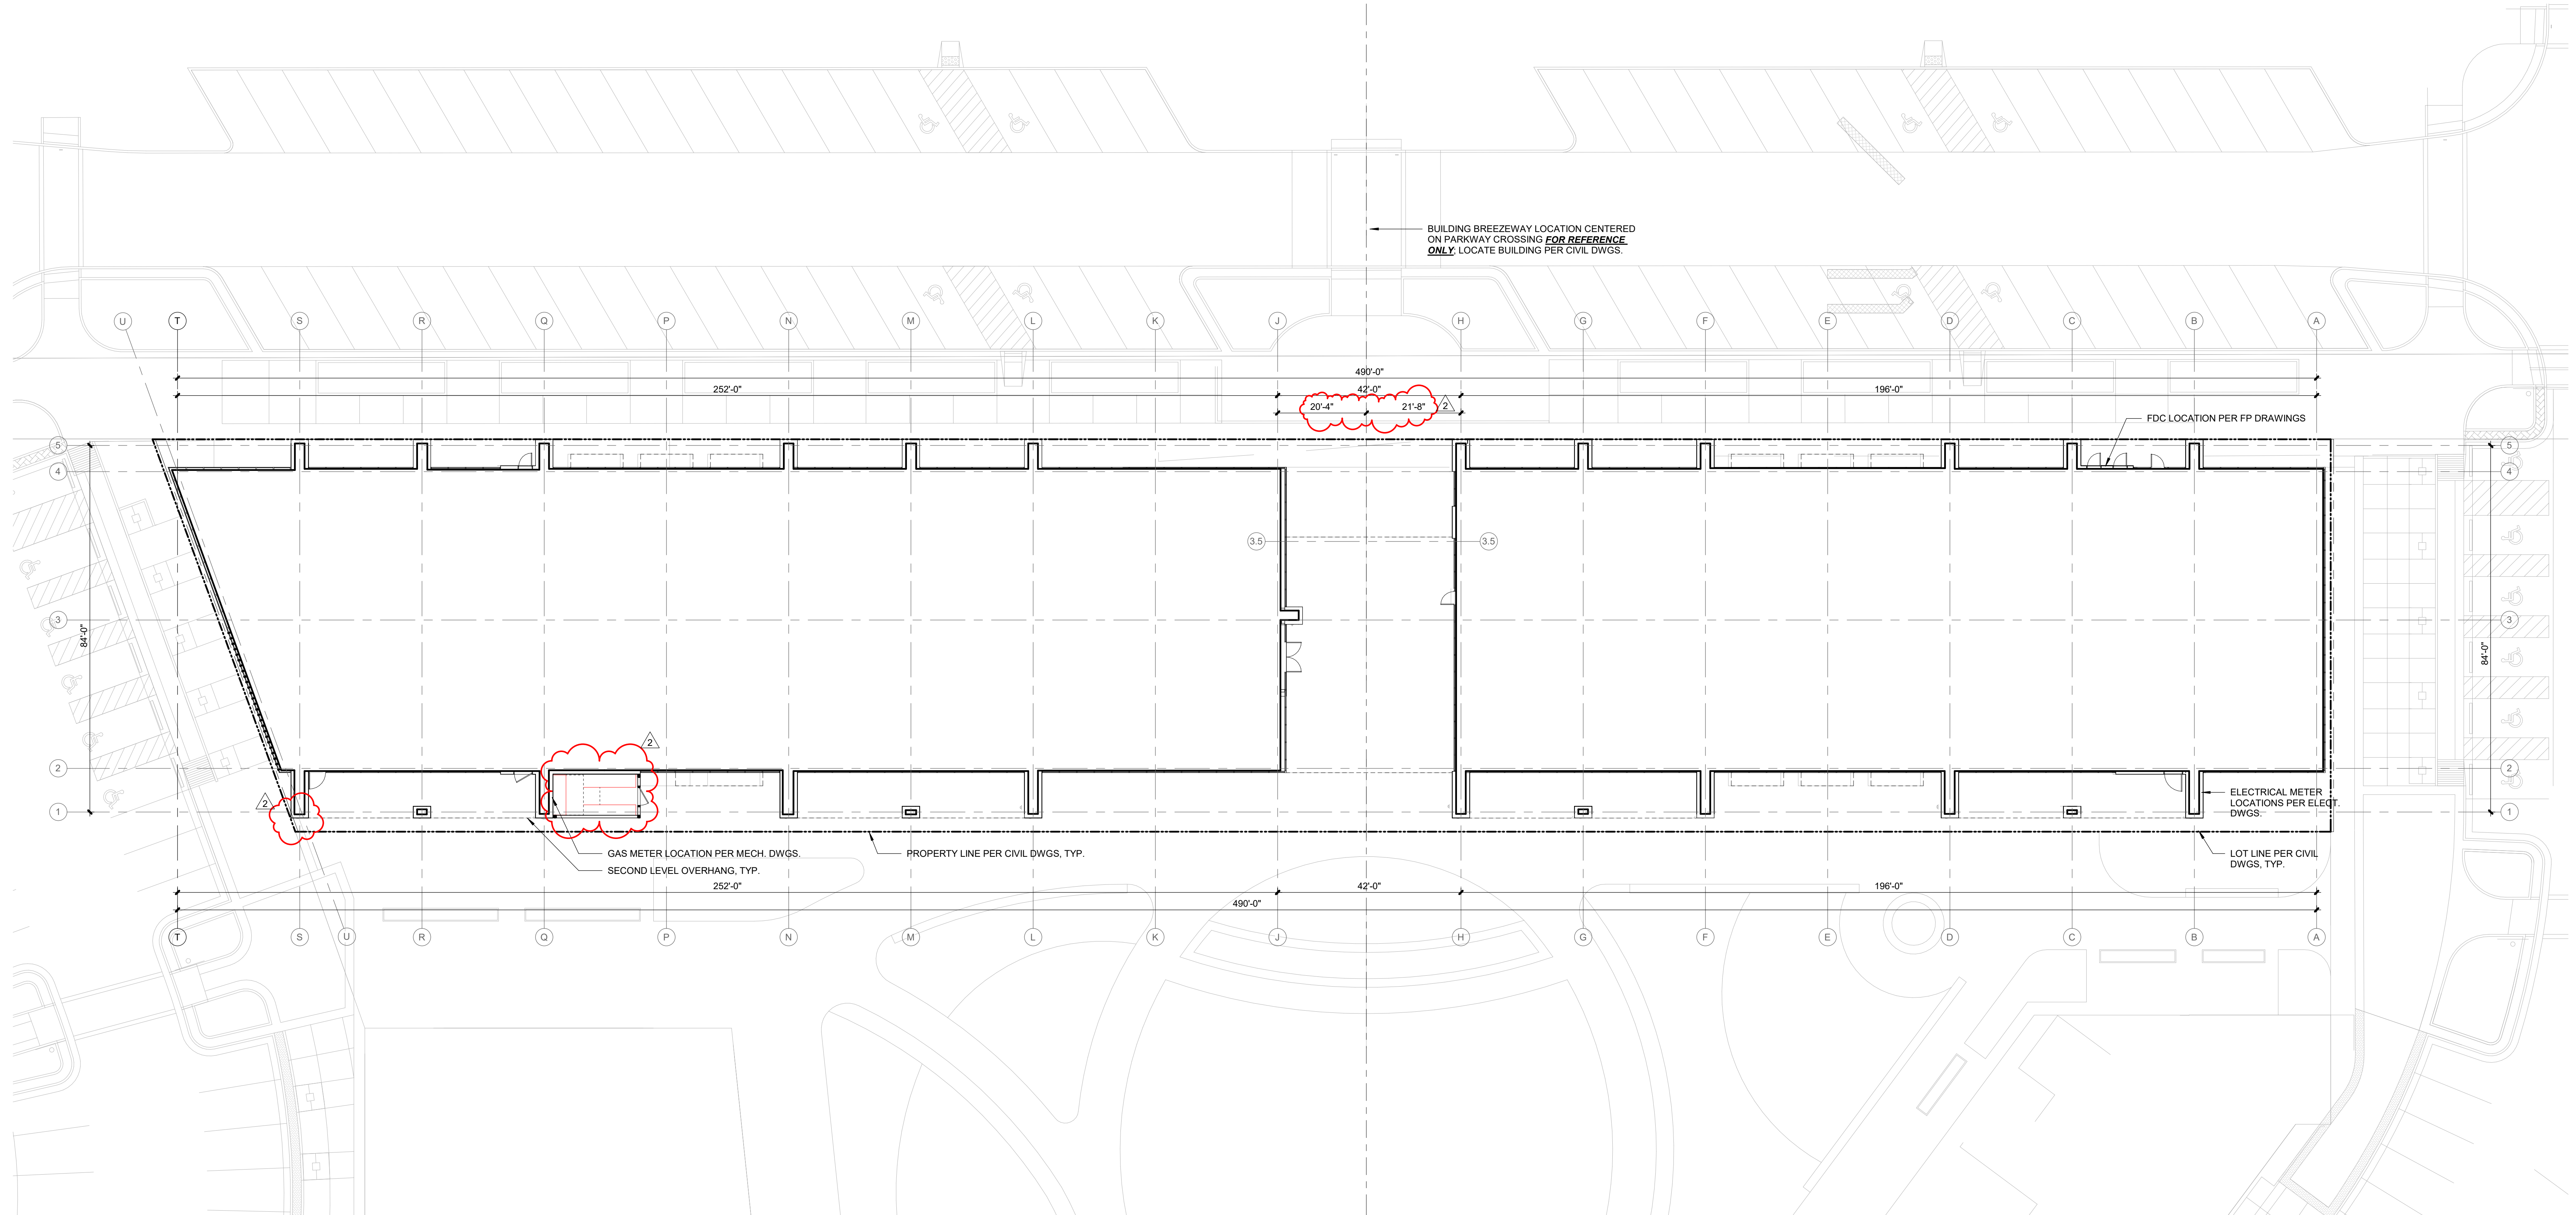

3201 NW PARAGON PKWY  
LEE'S SUMMIT, MO

Project No.: 19050.01a  
Date: 11.29.22  
Used For: CONSTRUCTION

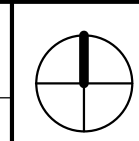REVISIONS	
Date	Description
9.27.22	ADDENDUM 2
11.29.22	ADDENDUM 3
01.20.23	ASI-01

REGISTRATION



05.06.22

## PROJECT TEAM

ARCHITECT FINKLE+WILLIAMS  
ARCHITECTURE

IL GBA

LANDSCAPE LAND 3

FOUNDATIONS      BSE STRUCT

STRUCTURAL BSE STRUCTURAL  
ENGINEERS

JUMBLING HENDERSON  
ENGINEERS

MECHANICAL      HENDERSON  
ENGINEERS

ELECTRICAL HENDERSON  
ENGINEERS

E PROTECTION HENDERSON  
ENGINEERS

INKLE + WILLIAMS  
ARCHITECTURE


787 RENNER BLVD., SUITE 100  
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913.498.1550  
www.finklewilliams.com

SHEET TITLE

## OVERALL FLOOR PLANS



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## A1.01

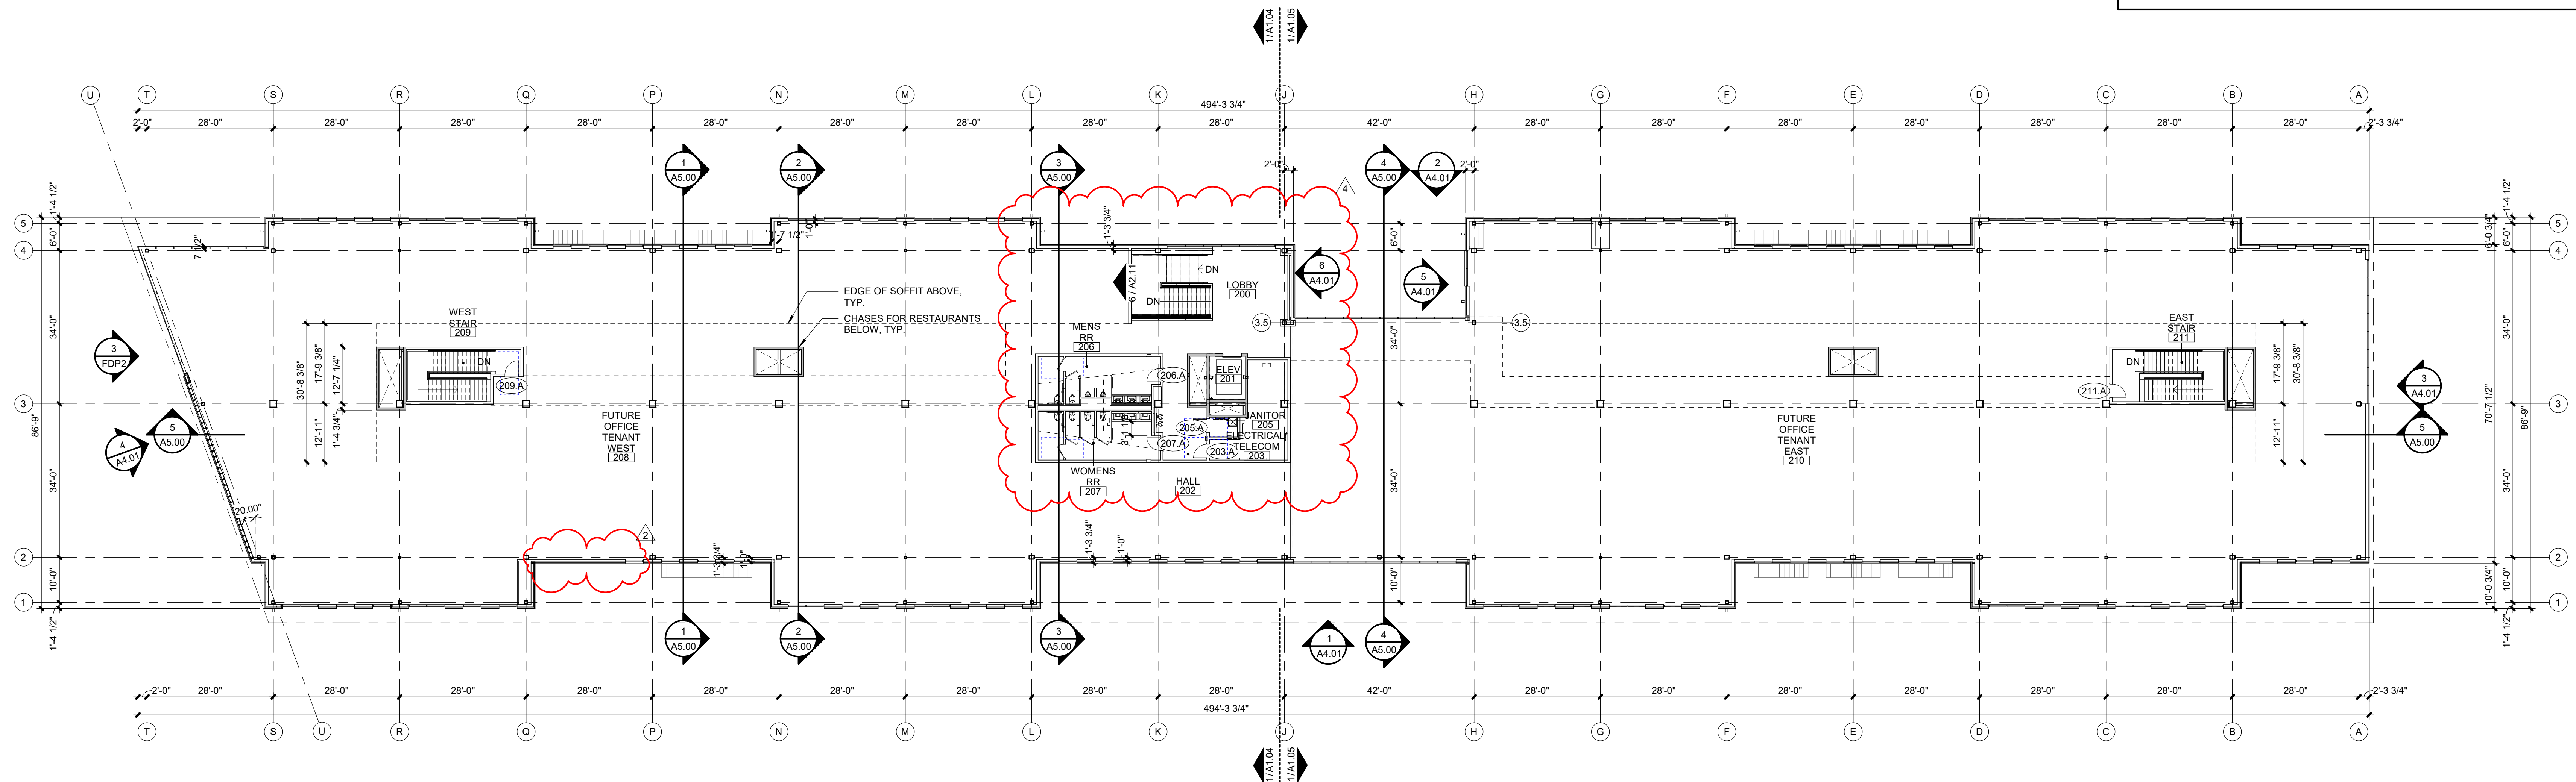


2	OVERALL SECOND FLOOR PLAN
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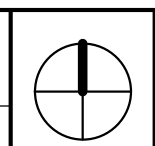
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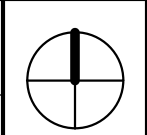
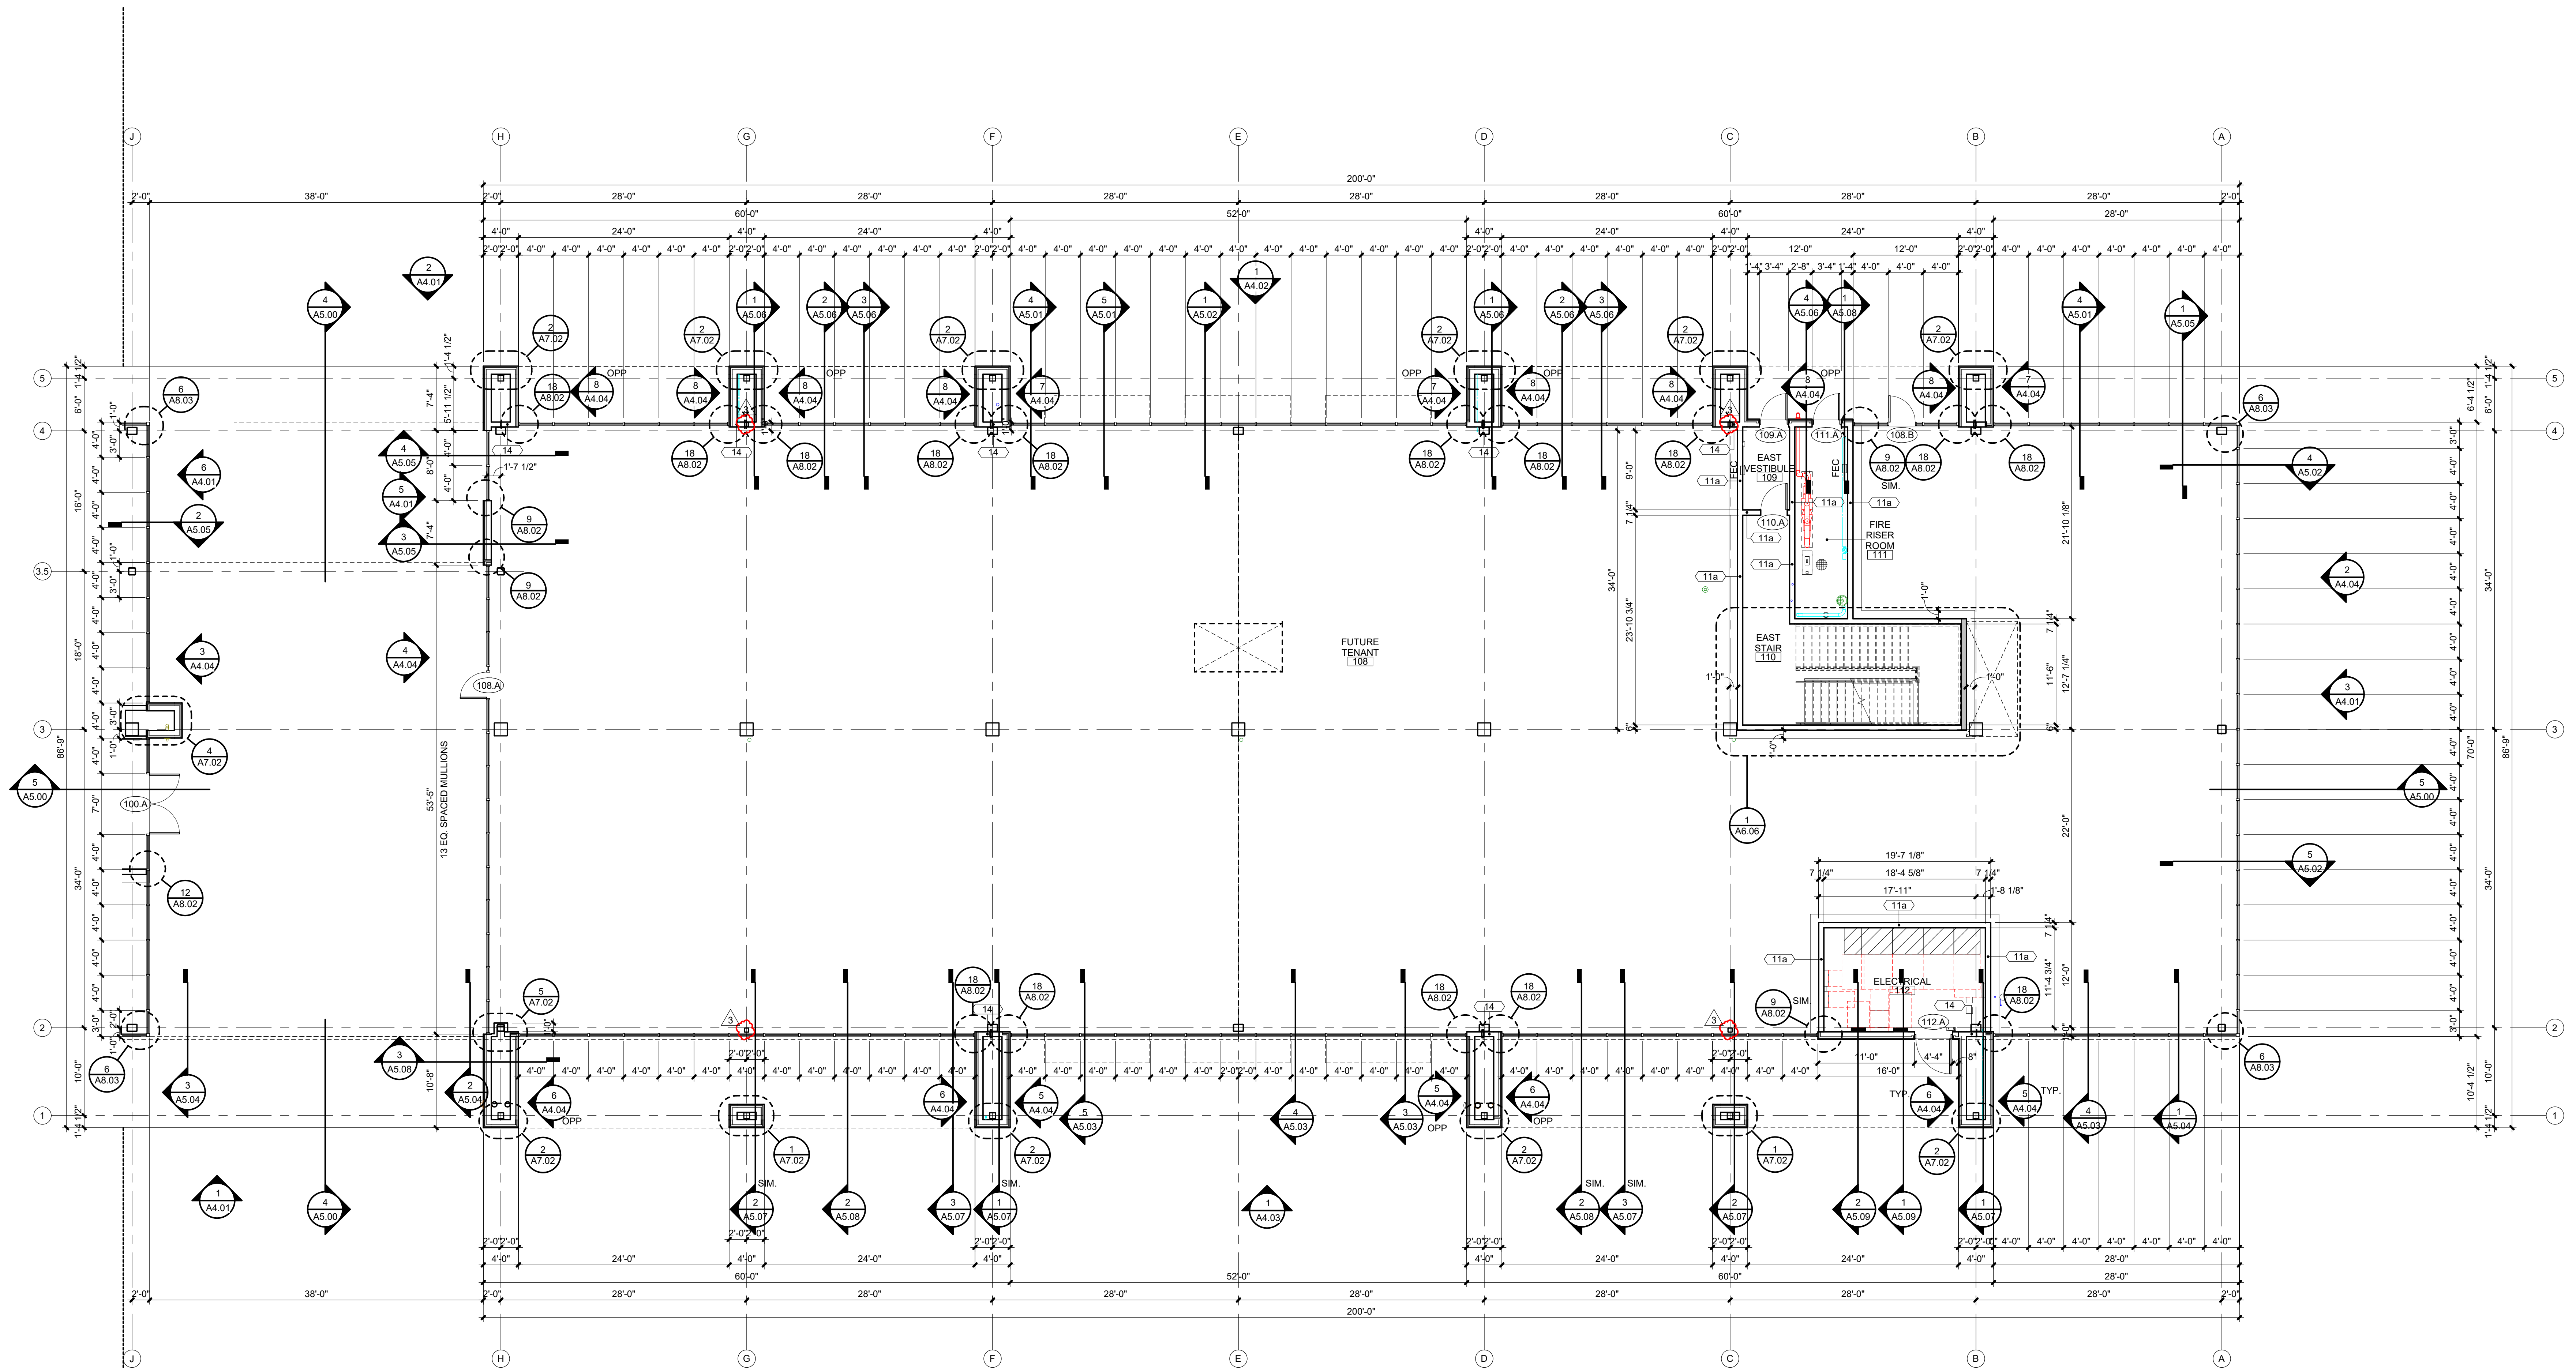


1	OVERALL FIRST FLOOR PLAN
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<b>A1.01</b>	SCALE : 1/16" = 1'-0"
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HIGHEST OPERABLE PART

47" (1219 mm) UNO.

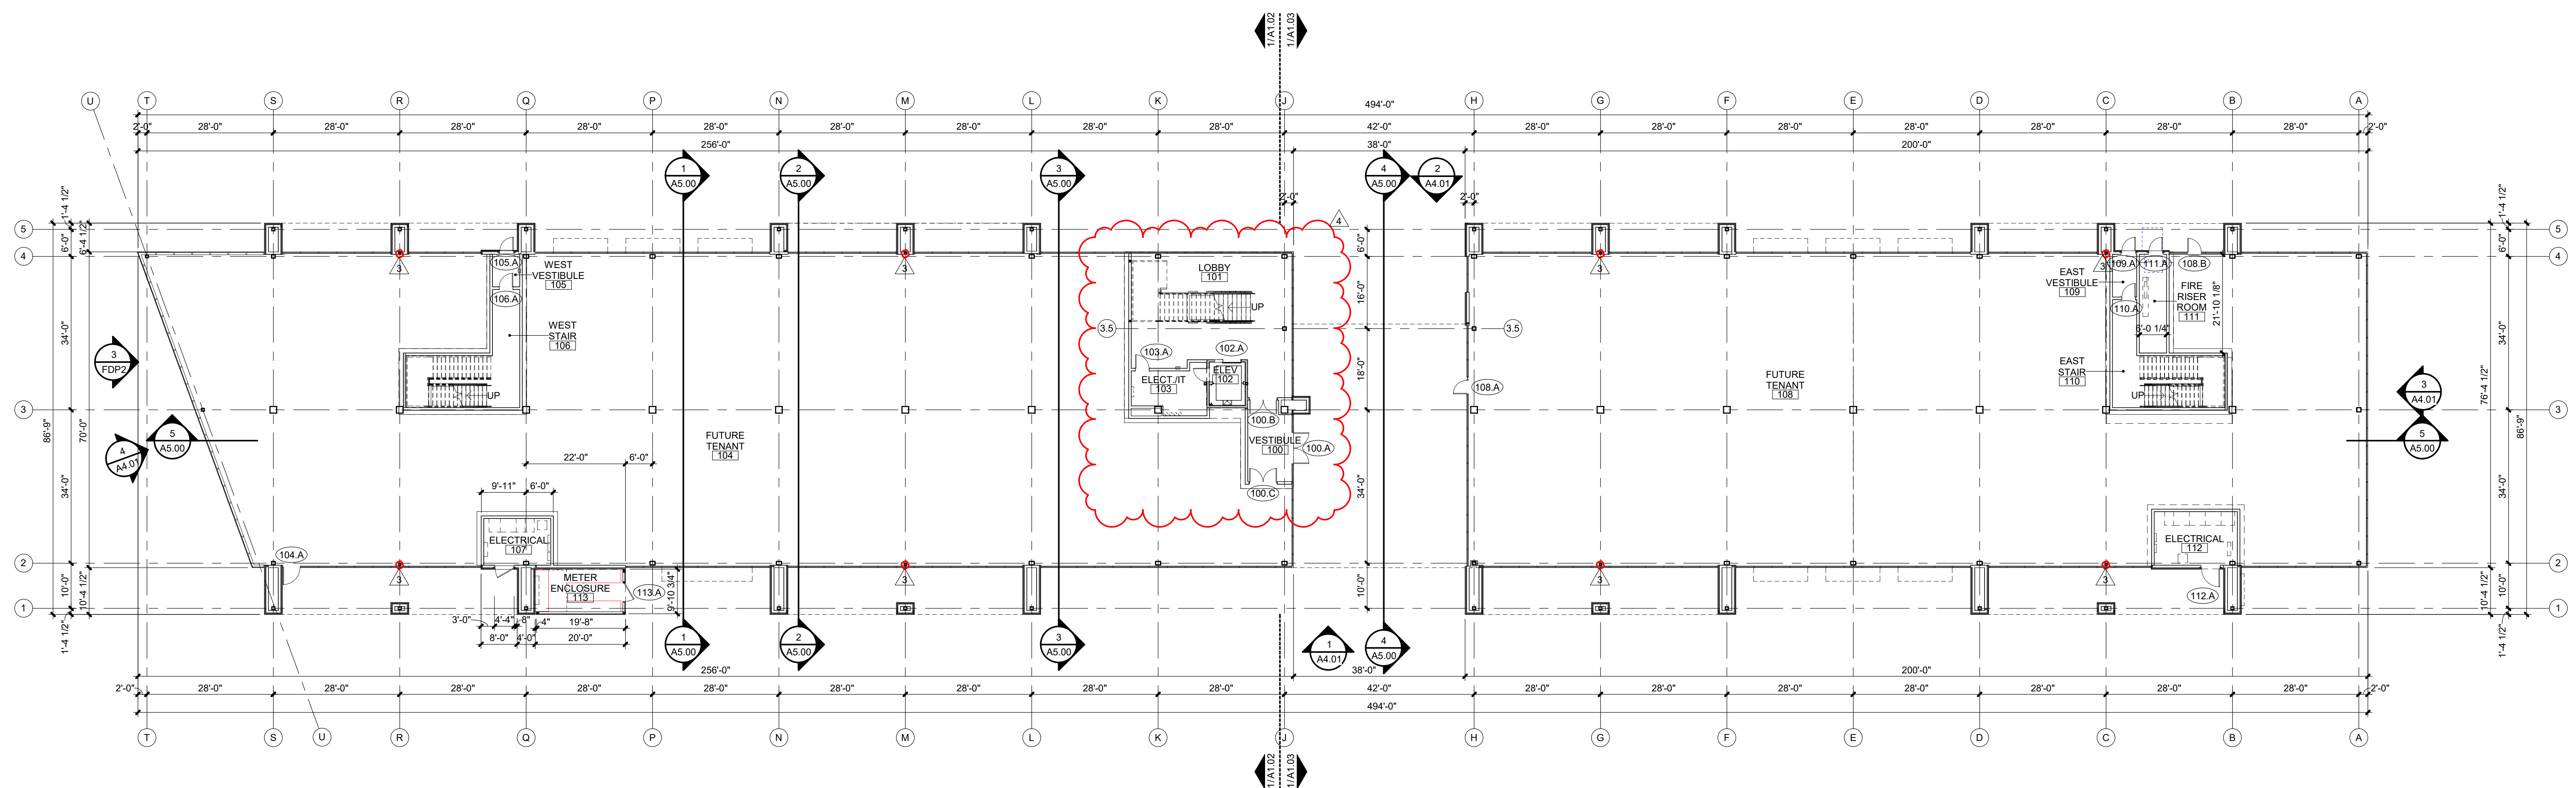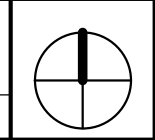TOWEL DISPENSER (MANUAL)

HIGHEST OPERABLE PART

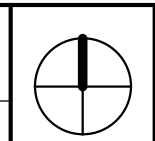47" (1219 mm) UNO.

TOWEL DISPENSER (AUTOMATIC)

HIGHEST OPERABLE PART

47" (1219 mm) UNO.

HAND DRYER

HIGHEST OPERABLE PART





47" (1219 mm) UNO.

TOWEL DISPENSER/ WASTE RECEPTACLE

HIGHEST OPERABLE PART

47" (1219 mm) UNO.

SANITARY NAPKIN DISPENSER

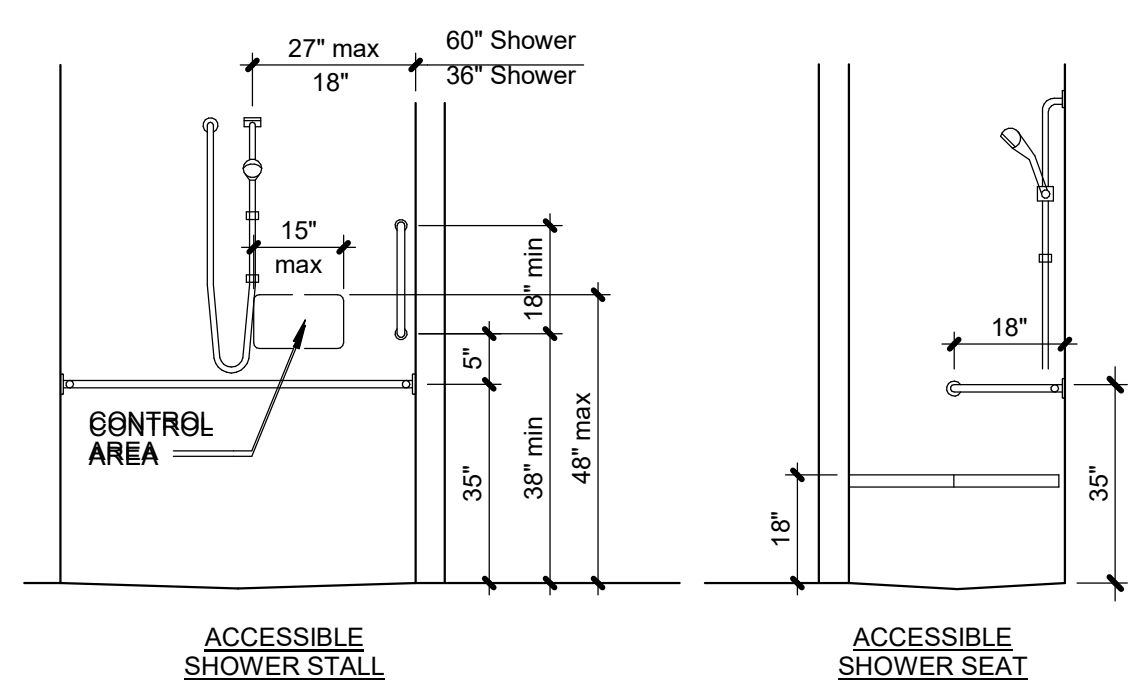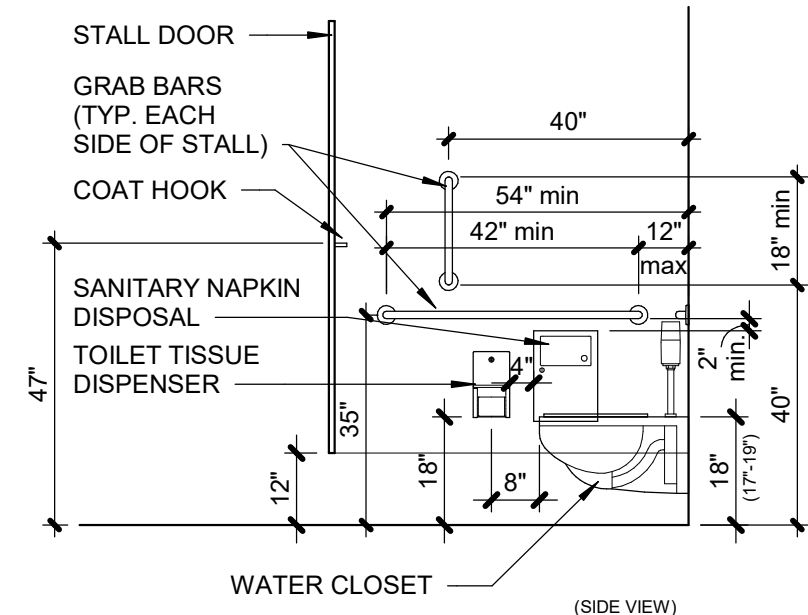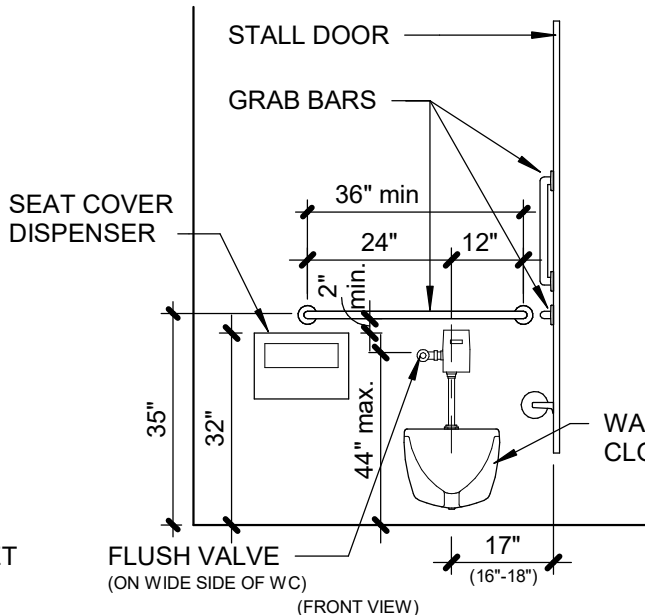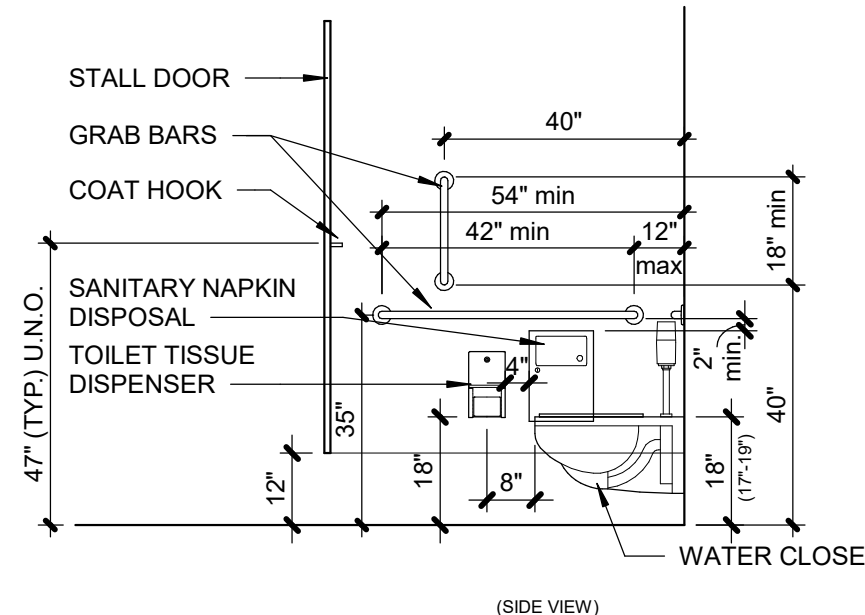

WHEELCHAIR ACCESSIBLE TOILET COMPARTMENT

AMBULATORY ACCESSIBLE TOILET COMPARTMENT

ALL ACCESSORIES SHALL BE STAINLESS STEEL, UNLESS NOTED OTHERWISE.  
ALL ACCESSORIES SHALL BE DESIGNED TO MEET ADA STANDARDS.

- ① COMBINATION PAPER TOWEL DISPENSER/WASTE RECEPTACLE, RECESSED, MATTE BLACK FINISH (BOBRICK B-3803-MBKLC)
- ② UNDERMOUNT SINK KIT WITH WASHBAR (BRADLEY WB1-1B-ER1)
- ③ FRAMED MIRROR (24"W X 82"H). FRAME TO BE 2" WIDE, COLOR BLACK
- ④ FRAMELESS MIRROR WITH POLISHED EDGES (24"W X 58"H)
- ⑤ MULTI-ROLL TOILET TISSUE DISPENSER W/NO KEVED LOCK (BOBRICK B-2888)
- ⑥ GRAB BARS AS SHOWN ON PLANS AND ELEVATIONS (BOBRICK B-6806 SERIES)
- ⑦ GRAB BAR (BOBRICK B6806 X 42)  
LOCATE AS SHOWN IN ACCESSORY MOUNTING HEIGHTS
- ⑧ GRAB BAR (BOBRICK B6806 X 36)  
LOCATE AS SHOWN IN ACCESSORY MOUNTING HEIGHTS
- ⑨ GRAB BAR (BOBRICK B6806 X 18)  
LOCATE AS SHOWN IN ACCESSORY MOUNTING HEIGHTS
- ⑩ SANITARY NAPKIN DISPOSAL, RECESSED (BOBRICK B-353)
- ⑪ H/I / LO ADA ACCESSIBLE DRINKING FOUNTAIN W/ BOTTLE FILL AND FILTER (ELKAY LZWS-LRFBM28K)
- ⑫ RUBBER TIPPED DOOR BUMPER (BOBRICK B-687)
- ⑬ COAT AND HAT HOOK (BOBRICK B-6827)
- ⑭ A.D.A. RESTROOM SIGNAGE, SEE SHEET A0.01
- ⑮ TOILET SEAT COVER DISPENSER (BOBRICK B-221)
- ⑯ BRADLEY - WASHBAR WITH UNDERMOUNT SINK ACCESS PANEL (PWB - SWING DOWN MOUNT BLACK POWDER COATED STAINLESS STEEL). REF. MEP DRAWINGS FOR WASHBAR AND SINK SPECIFICATIONS

PARAGON STAR  
BLDG 2 / LOT 9

3201 NW PARAGON PKWY  
LEE'S SUMMIT, MO

Project No.:	19050.01a
Date:	11.29.22
Issued For:	CONSTRUCTION

[illegible]

## REGISTRATION



05.06.22

## PROJECT TEAM

ARCHITECT	FINKLE+WILLIAMS ARCHITECTURE
CIVIL	GBA
LANDSCAPE	LAND 3
FOUNDATIONS	BSE STRUCTURAL ENGINEERS
STRUCTURAL	BSE STRUCTURAL ENGINEERS
PLUMBING	HENDERSON ENGINEERS
MECHANICAL	HENDERSON ENGINEERS
ELECTRICAL	HENDERSON ENGINEERS
FIRE PROTECTION	HENDERSON ENGINEERS
CONTRACTOR	FOGEL-ANDERSON

FINKLE + WILLIAMS  
ARCHITECTURE



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## SHEET TITLE


## ENLARGED TOILET PLANS AND DETAILS

## SHEET NUMBER


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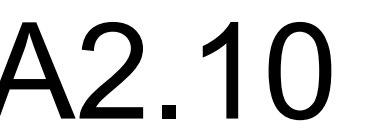



2	ENLARGED TOILET ACCESSORIES
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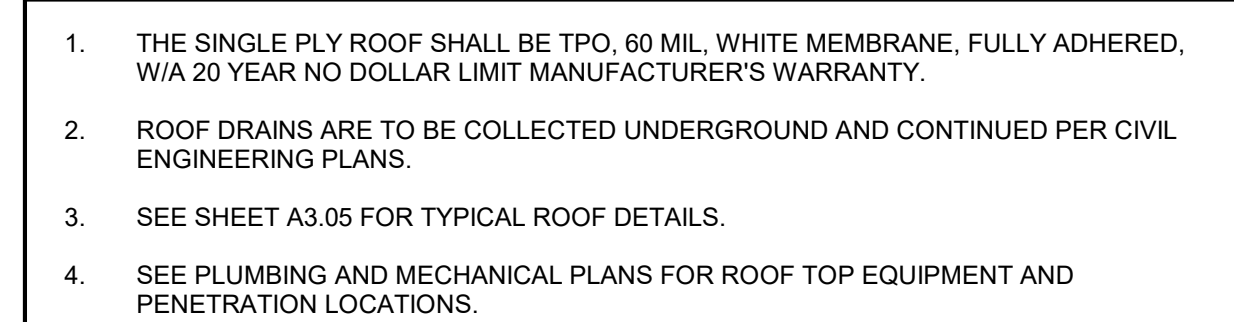
1	ENLARGED RESTROOM PLANS
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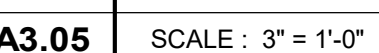
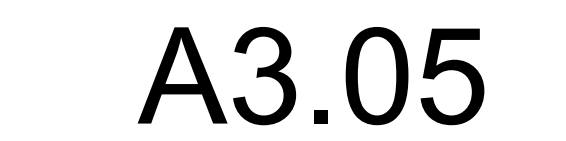






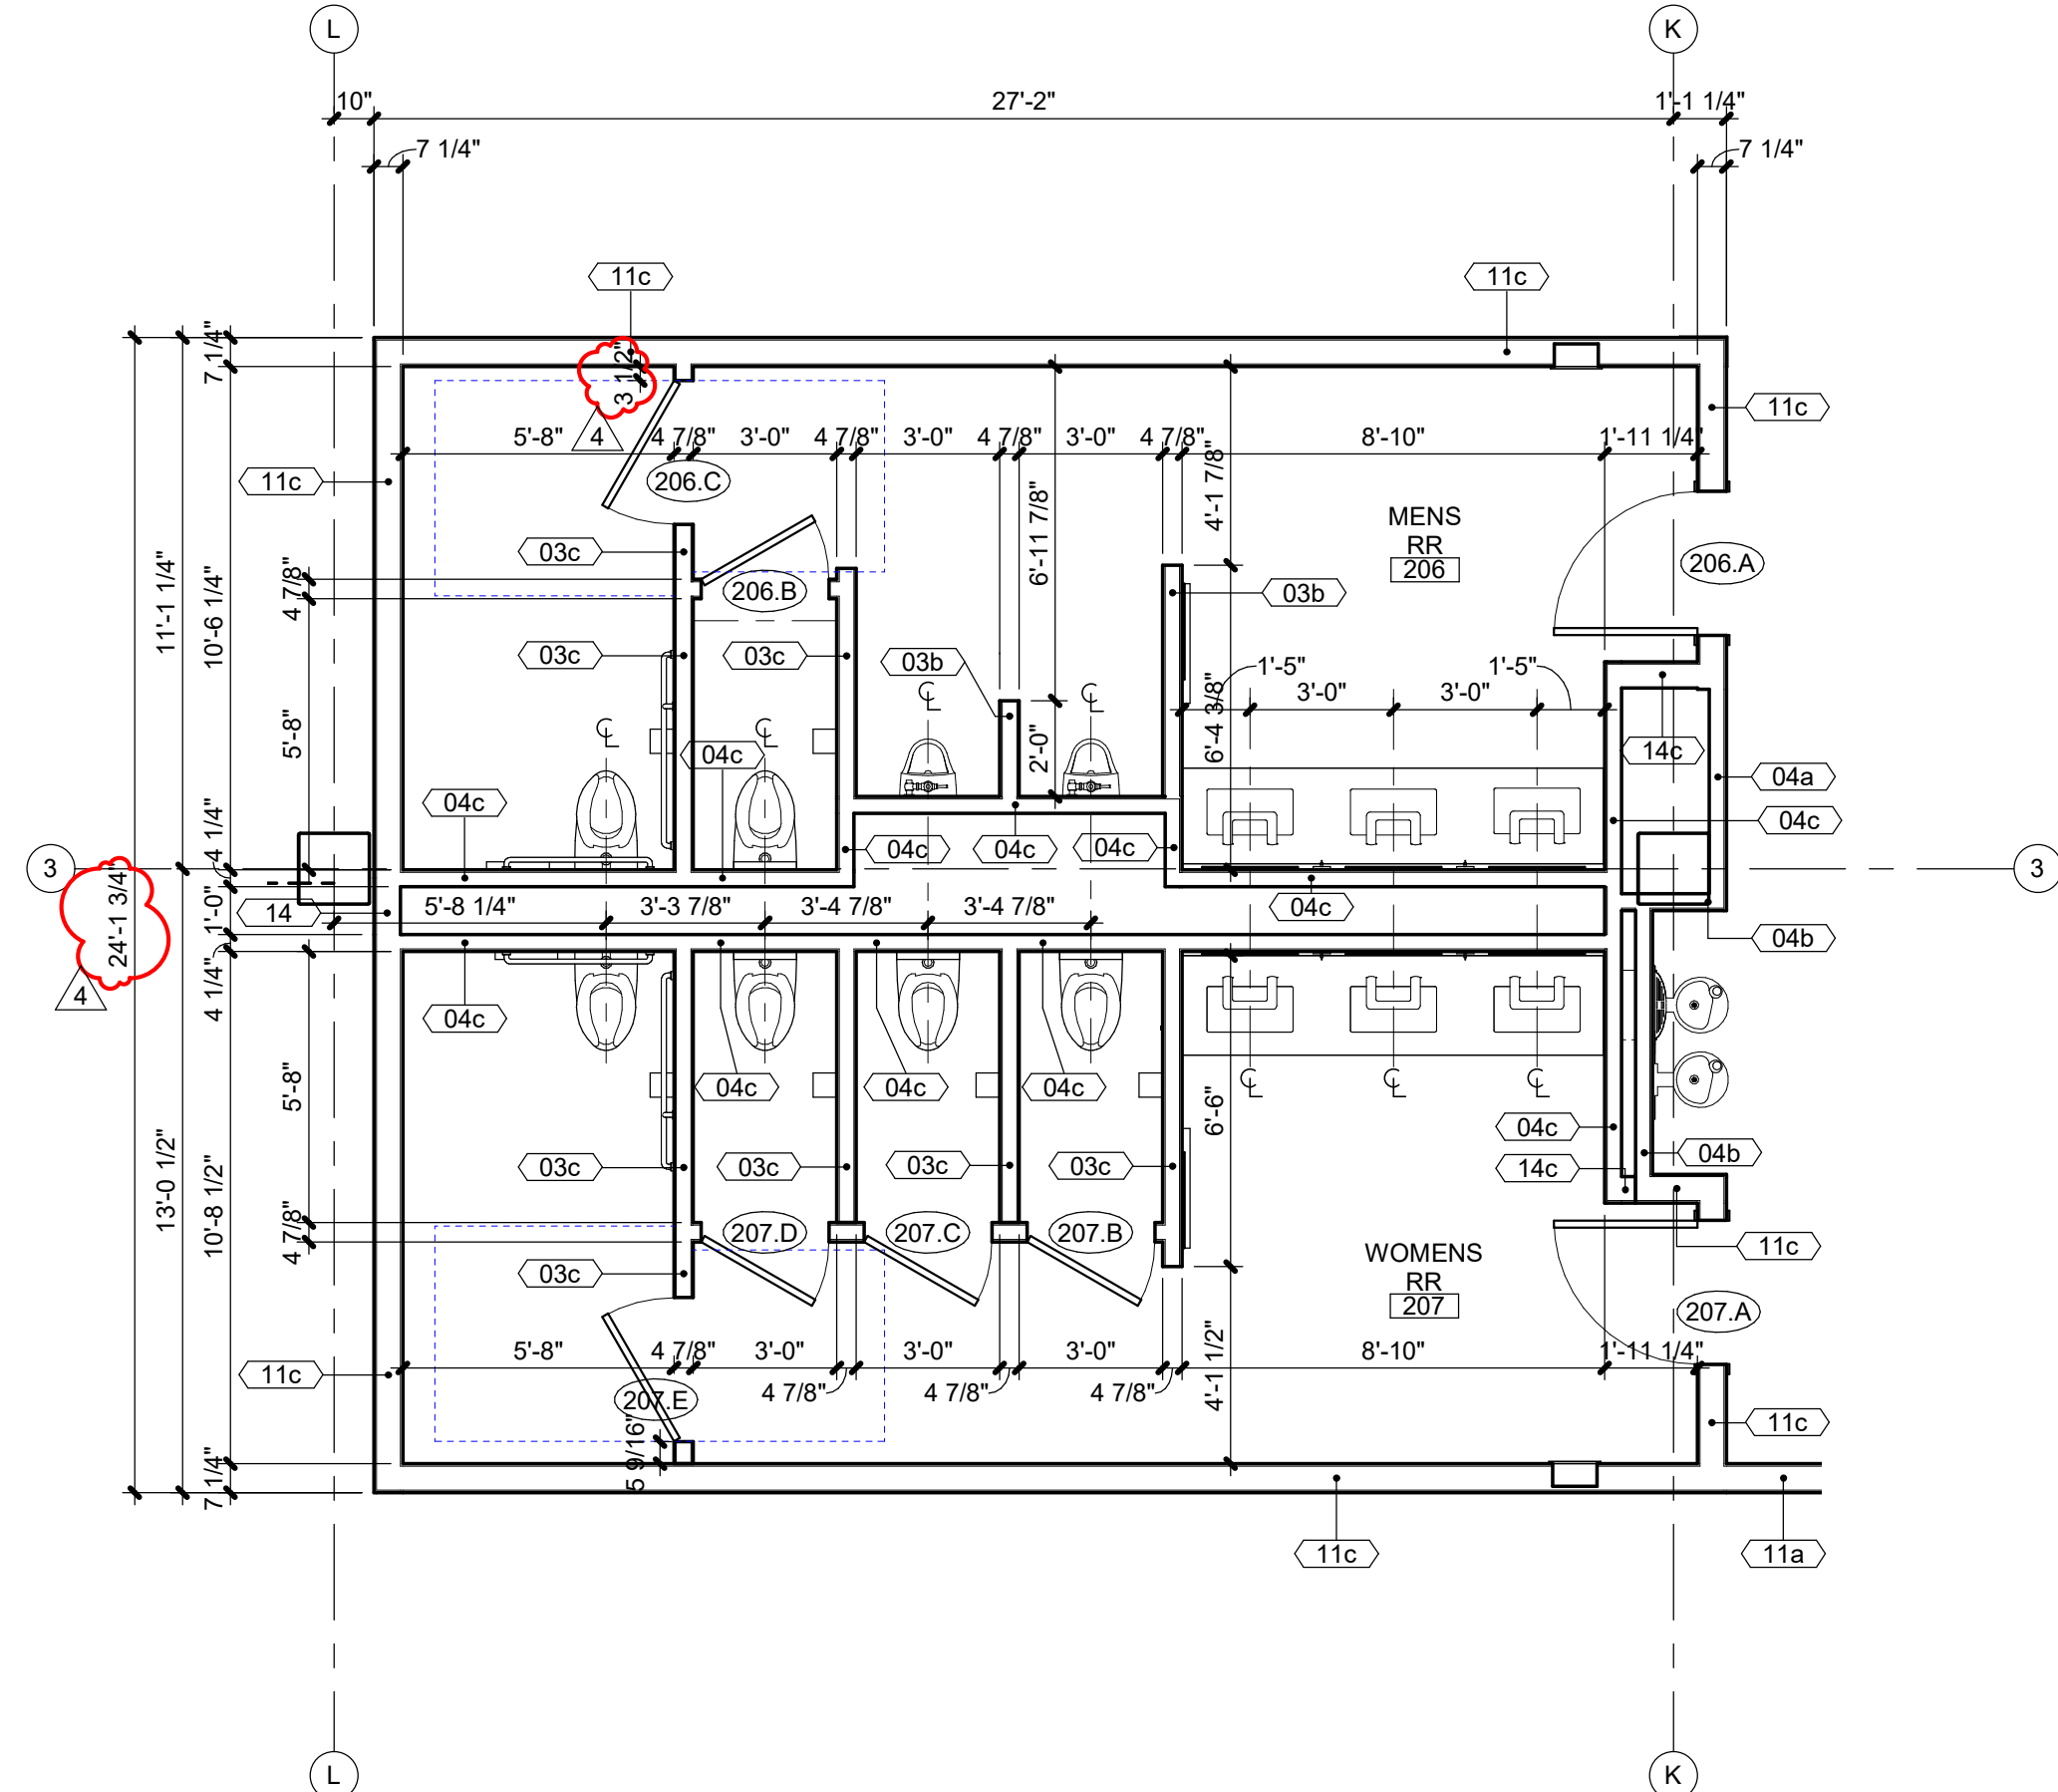
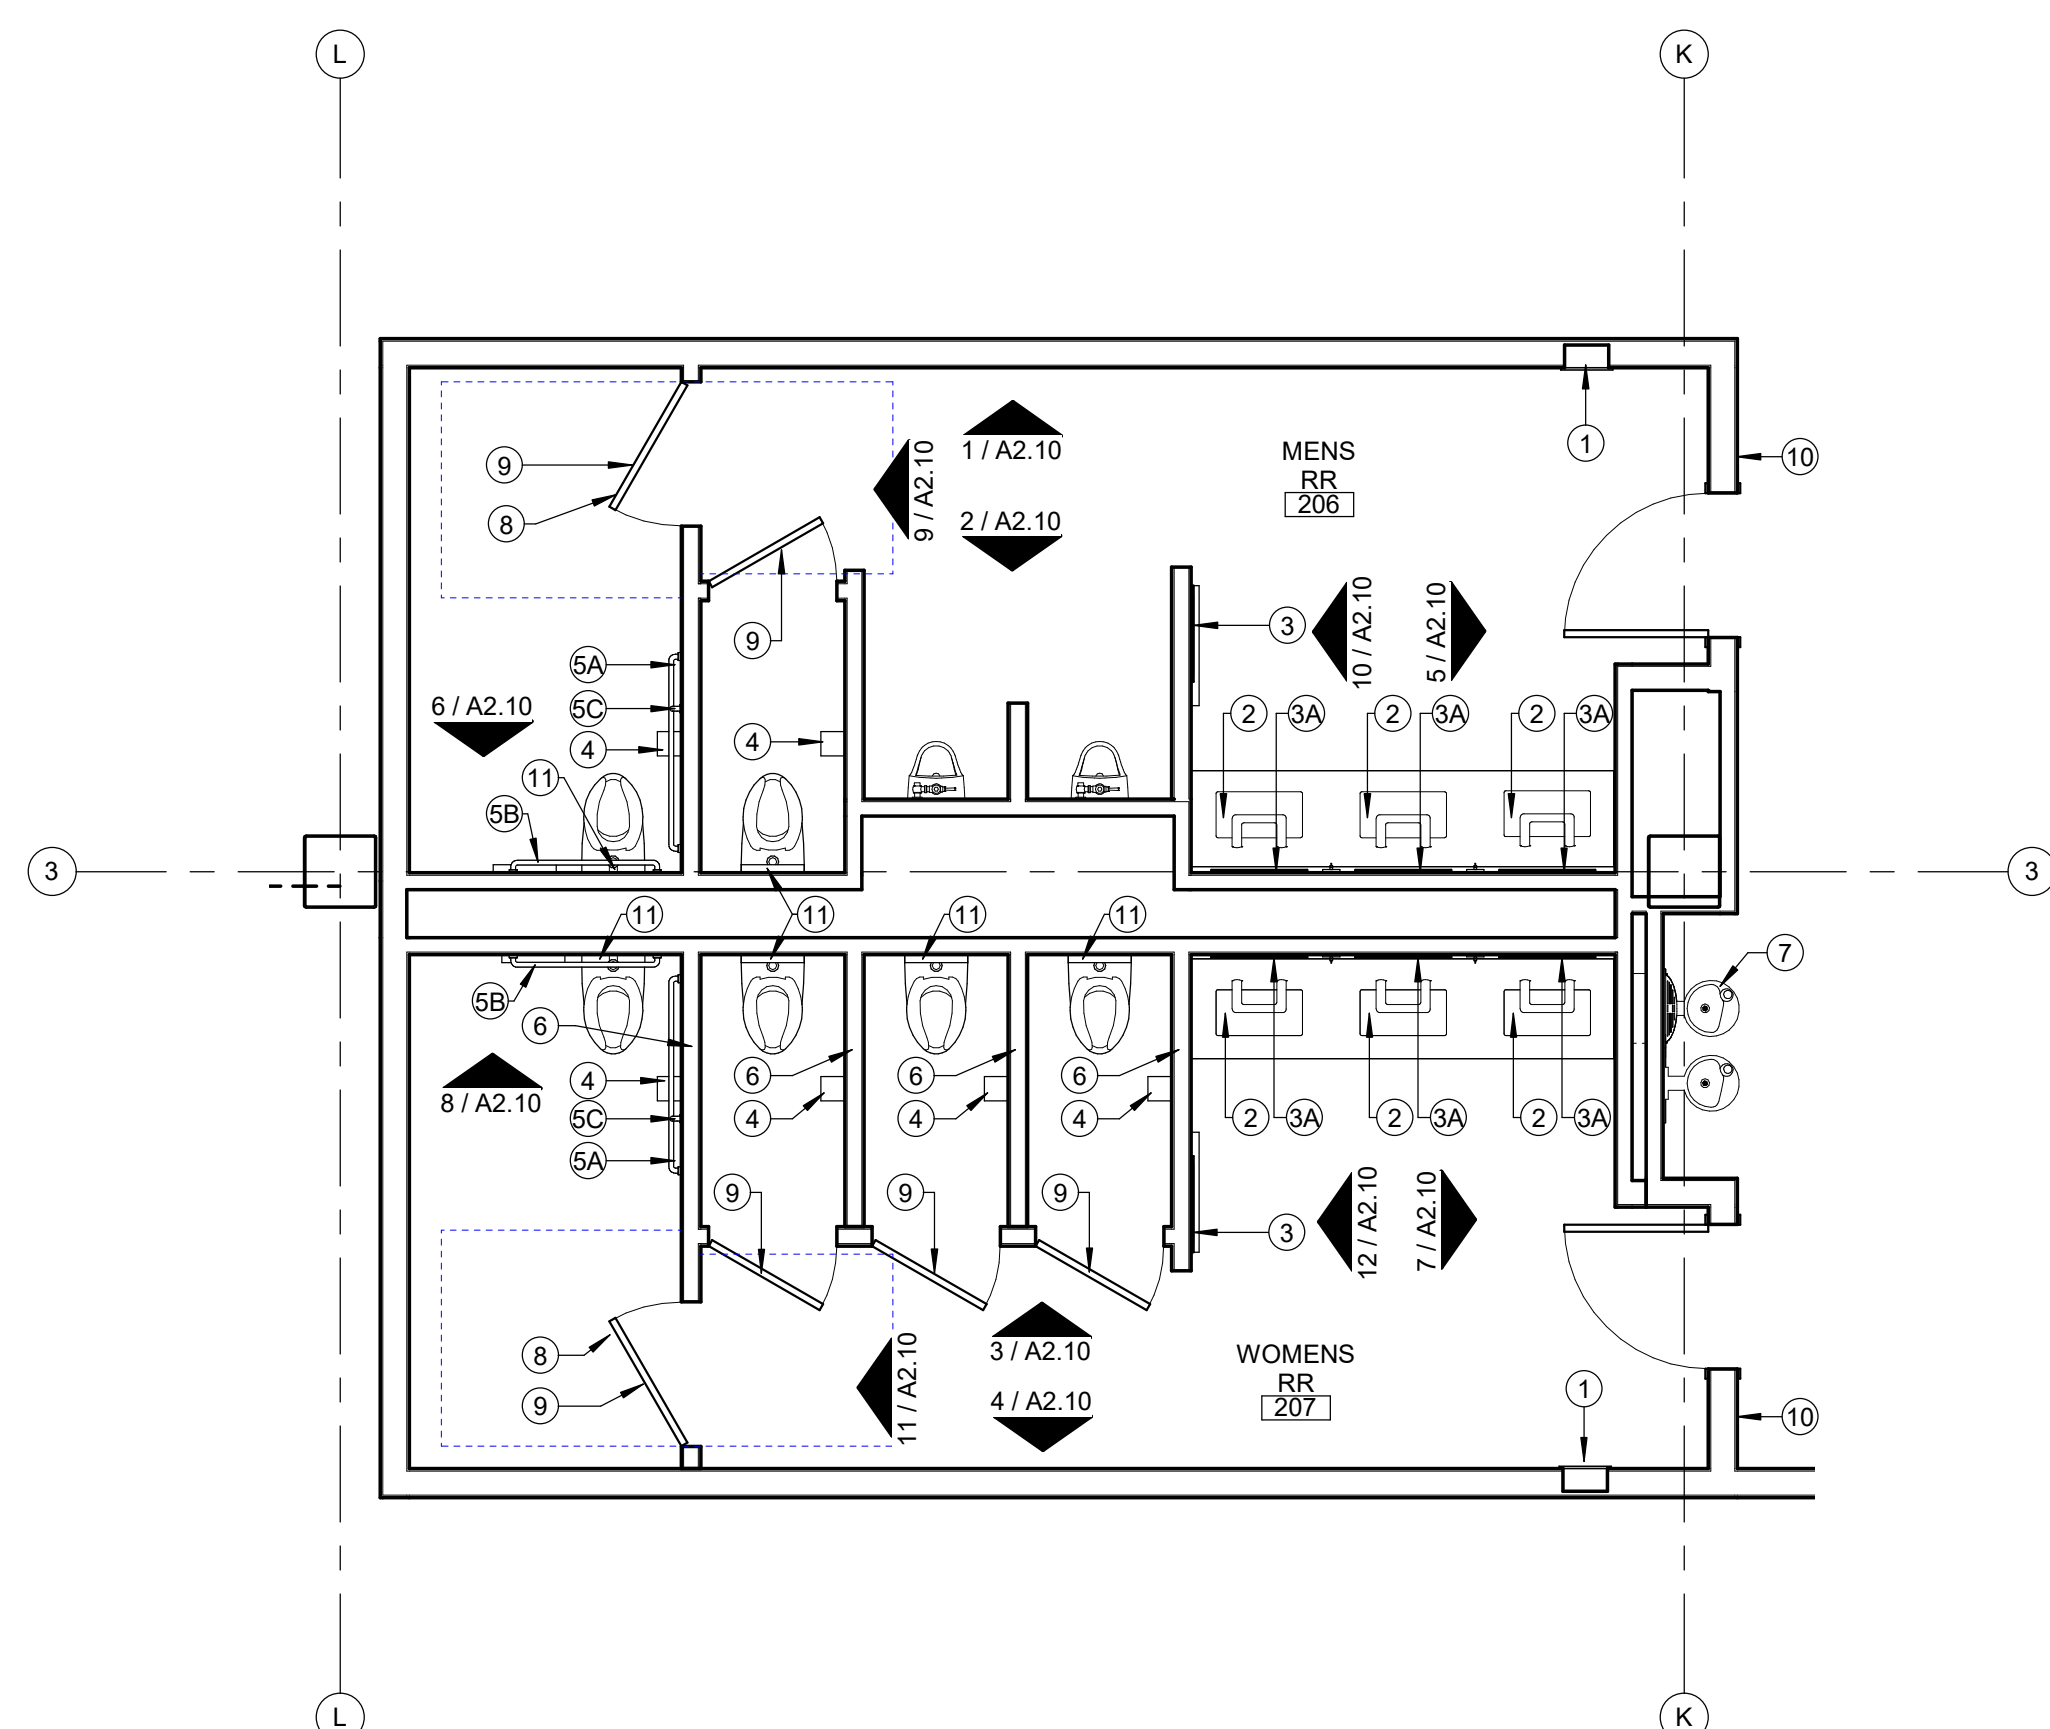
<b>A2.11</b>	SCALE : 1/2" = 1'-0"
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## EXTERIOR MATERIAL LEGEND

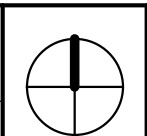- |       |   |
|-------|---|
| MP-1  | WESTERN STATES 'WESTERN SNAP LOCK' STANDING SEAM MTL. PANEL, 18" P/NEL WIDTH, COLOR: MATTE MIDNIGHT BLACK   |
| MP-2  | KYNAR COATED 22 GA BREAK METAL COPING TO MATCH MP-1; BASIS OF DESIGN: WESTERN STATES 'MATTE MIDNIGHT BLACK' OR APPROVED EQ.   |
| MP-3  | WESTERN STATES 'T-GROOVE FLUSH' MTL. PANEL, 12" MATTE MIDNIGHT BLACK  |
| MP-4  | KYNAR COATED 22 GA BREAK METAL COPING TO MATCH MP-3; BASIS OF DESIGN: WESTERN STATES 'MATTE MIDNIGHT BLACK' OR APPROVED EQ.   |
| MP-5  | KYNAR COATED 24 GA BREAK METAL COPING TO MATCH ST-1; BASIS OF DESIGN: WESTERN STATES' COOL TECH 'POLAR WHITE' OR APPROVED EQ.   |
| GL-1  | 2" X 4 1/2" WINDOW WALL, BLACK ANODIZED ALUMINUM FINISH W/ 1" INSULATED LOW-E GLAZING UNIT  |
| GL-2  | 2 1/4" X 7 1/2" CURTAINWALL SYSTEM, BLACK ANODIZED ALUM FINISH W/ 1" INSULATED LOW-E GLAZING UNIT   |
| GL-3  | IGU AT SECOND LEVEL STRUCTURE TO BE SPANDREL GLASS: PPG SALSARBAN 70XL SOLAR CONTROL LOW-E GLAZING UNIT W/ 'SUBDUED GRAY' OPAICIFIER ON 4TH SURFACE, OR APPROVED EQUAL  |
| WD-1  | DELTA MILLWORKS ACCOYA 6" T&G WOOD SOFFIT, UNFINISHED; CONTRACTOR TO STAIN IN-FIELD TO MATCH ARCHITECTS SAMPLE  |
| ST-1  | BORAL CULTURED STONE, HEWVN STONE, COLOR: ARCTIC, PATTERN: HSP35809**   |
| ST-2  | ELDORADO CULTURED STONE MARQUEE24, COLOR: DOVETAIL*   |
| ST-3  | ELDORADO SPLIT EDGE 'WHITE CLOUD' SILL PIECE AT ALL WINDOW WALL OPENINGS IN ST-1 OR ST-2 WALLS<br>**PROVIDE CONTRACT JOINT AT SECOND LEVEL ON ALL ST-1 AND ST-2 LOCATIONS PER ELEVATIONS AND MFR RECOMMENDATIONS;<br>STONE TO BE NO GROUT, DRY-STACK AESTHETIC. |
| MB-1  | GROUND FACE 10w8h81L MASONRY BLOCK PER STRUCTURAL DWGS, BASIS OF DESIGN: TRENDSTONE PLUS GROUND AND POLISHED, COLOR: MIDWEST STATE  |
| AWN-1 | SHOP-BUILT POWDER-COATED ALUM. W/ SURFACE MOUNTED STANDING SEAM METAL TO MATCH MP-1; COORD. W/ ARCHITECT AND STRUCTURAL ENG.  |
| FP-1  | LOCATION FOR FDC AND KNOX BOX PER FIRE PROTECTION DRAWINGS; CENTER FIXTURES IN WALL UNO   |
| PD-1  | ROOF OVERFLOW DRAIN DOWNSPOUT COVER PER PLUMBING DRAWINGS; CENTER ON WALL SPACE UNO   |
| WL-1  | EXTERIOR DECORATIVE WALL LIGHT; AT 9'-0" AFF; CENTER ON WALL SPACE PER ELEVATIONS UNO   |
| WL-2  | EXTERIOR WALL-MOUNTED UP-LIGHT; ALIGN W/ SOFFIT AT 12'-0" AFF; CENTER ON WALL SPACE PER ELEVATIONS UNO  |
| WL-3  | PROVIDE J-BOX FOR FUTURE WALL LIGHT PER TENANT AT 9'-0" AFF; CENTER ON WALL SPACE PER ELEVATIONS UNO  |

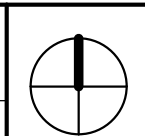

PARAGON STAR  
BLDG 2 / LOT 9

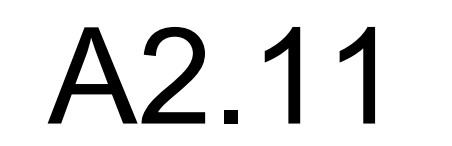3201 NW PARAGON PKWY  
LEE'S SUMMIT, MO

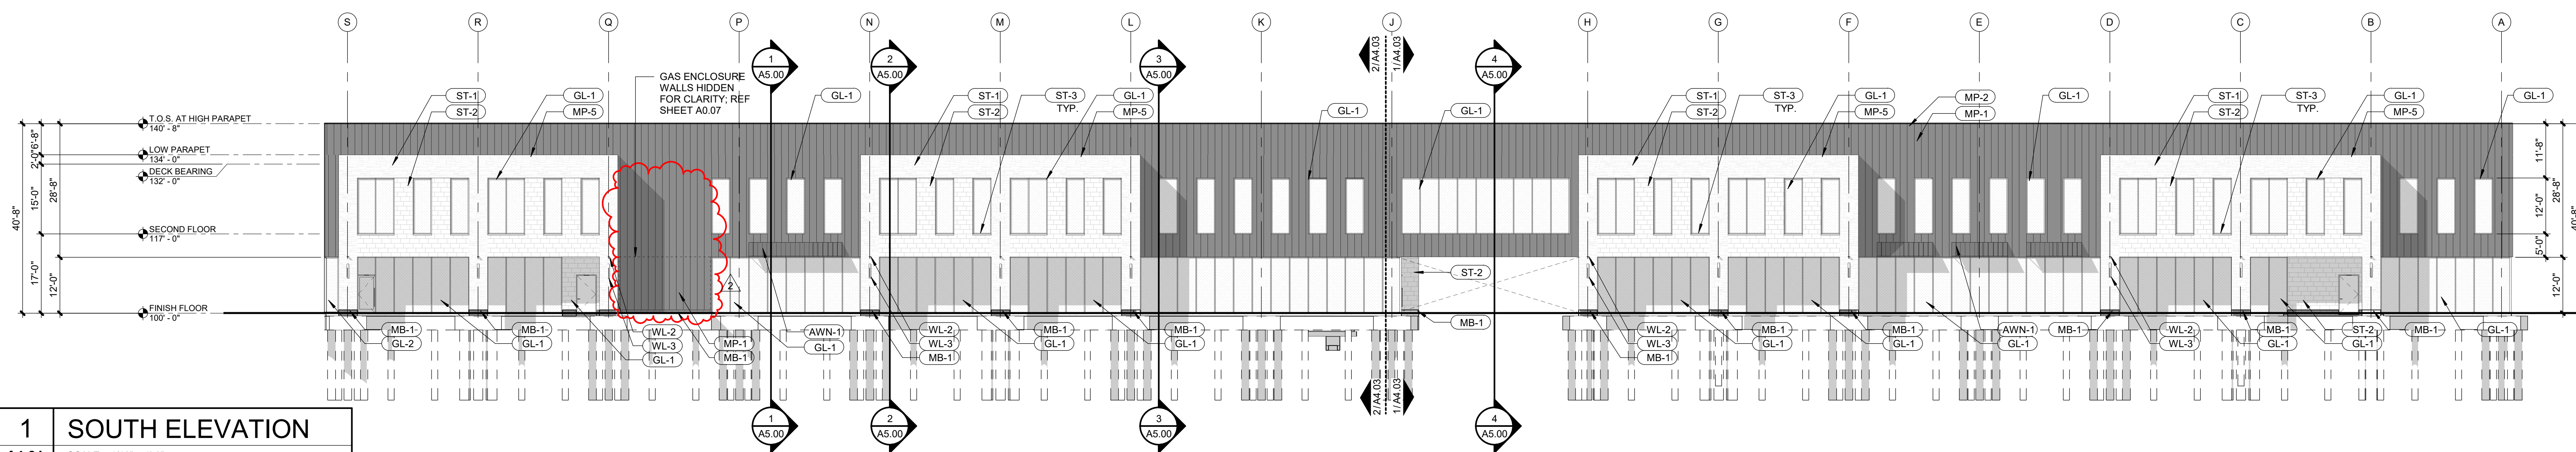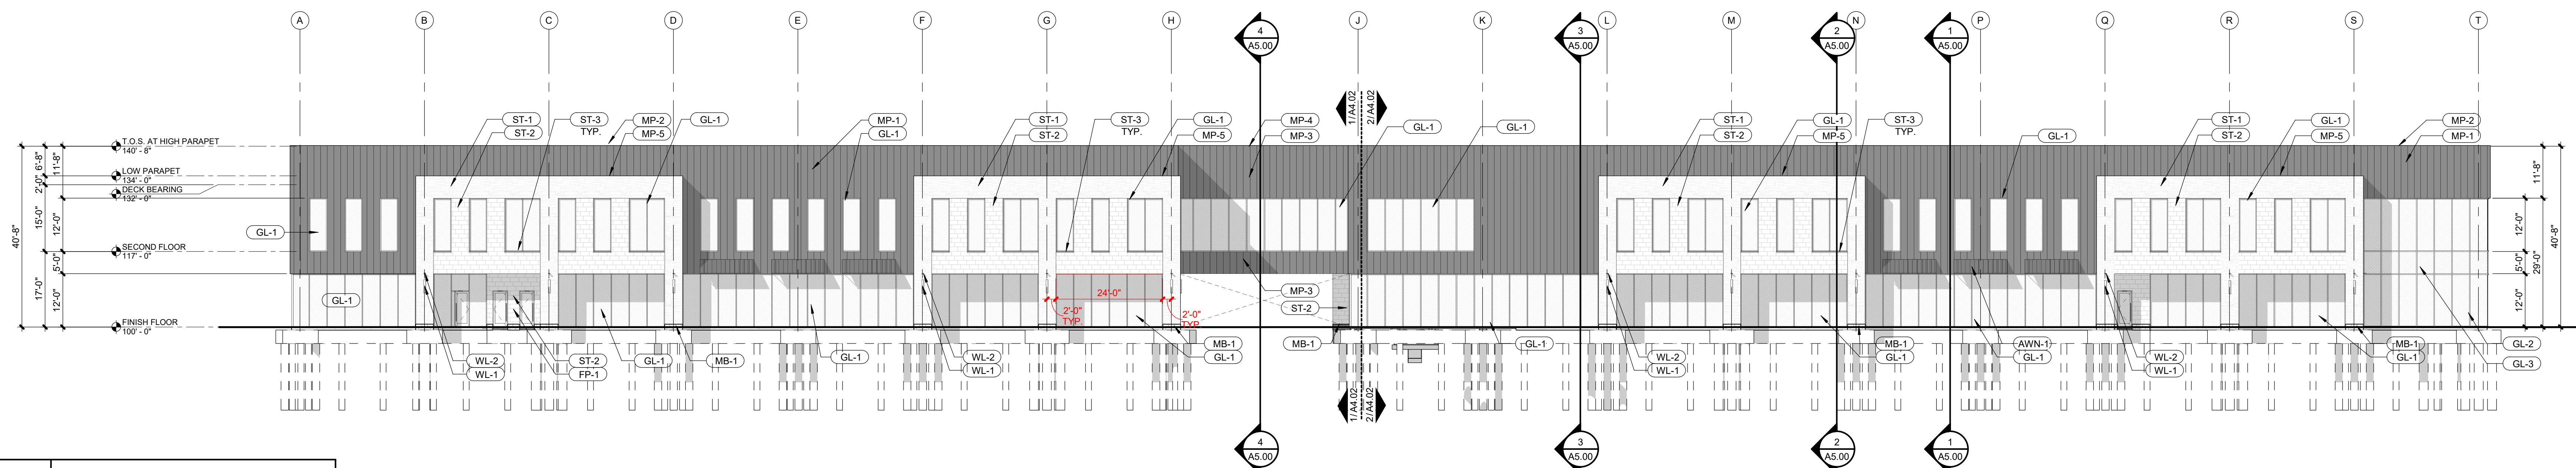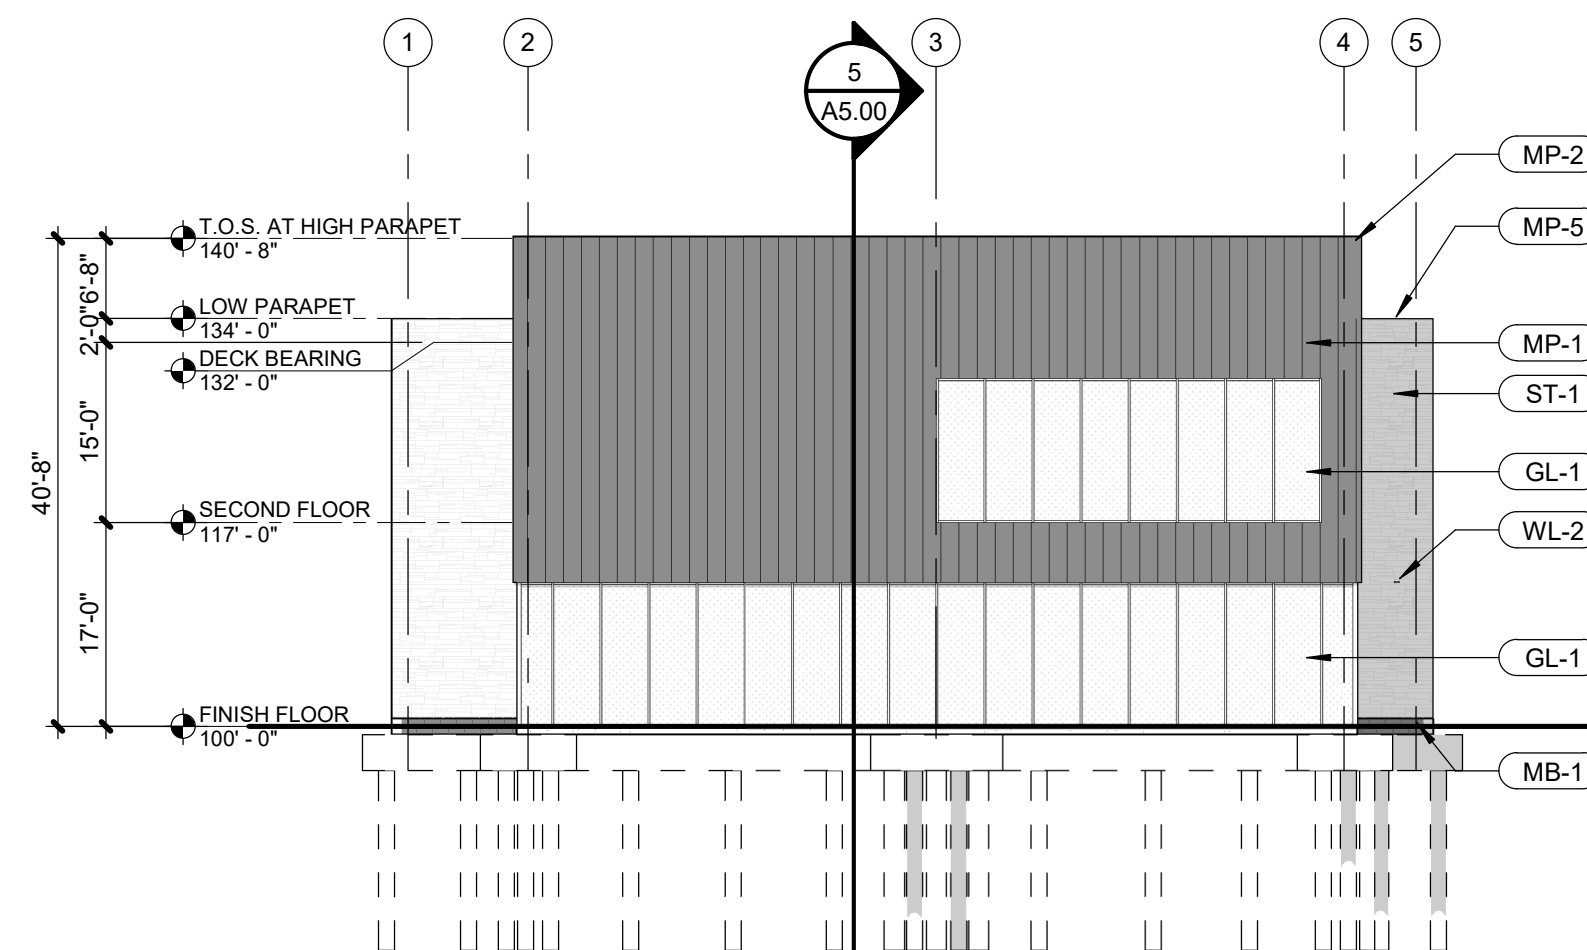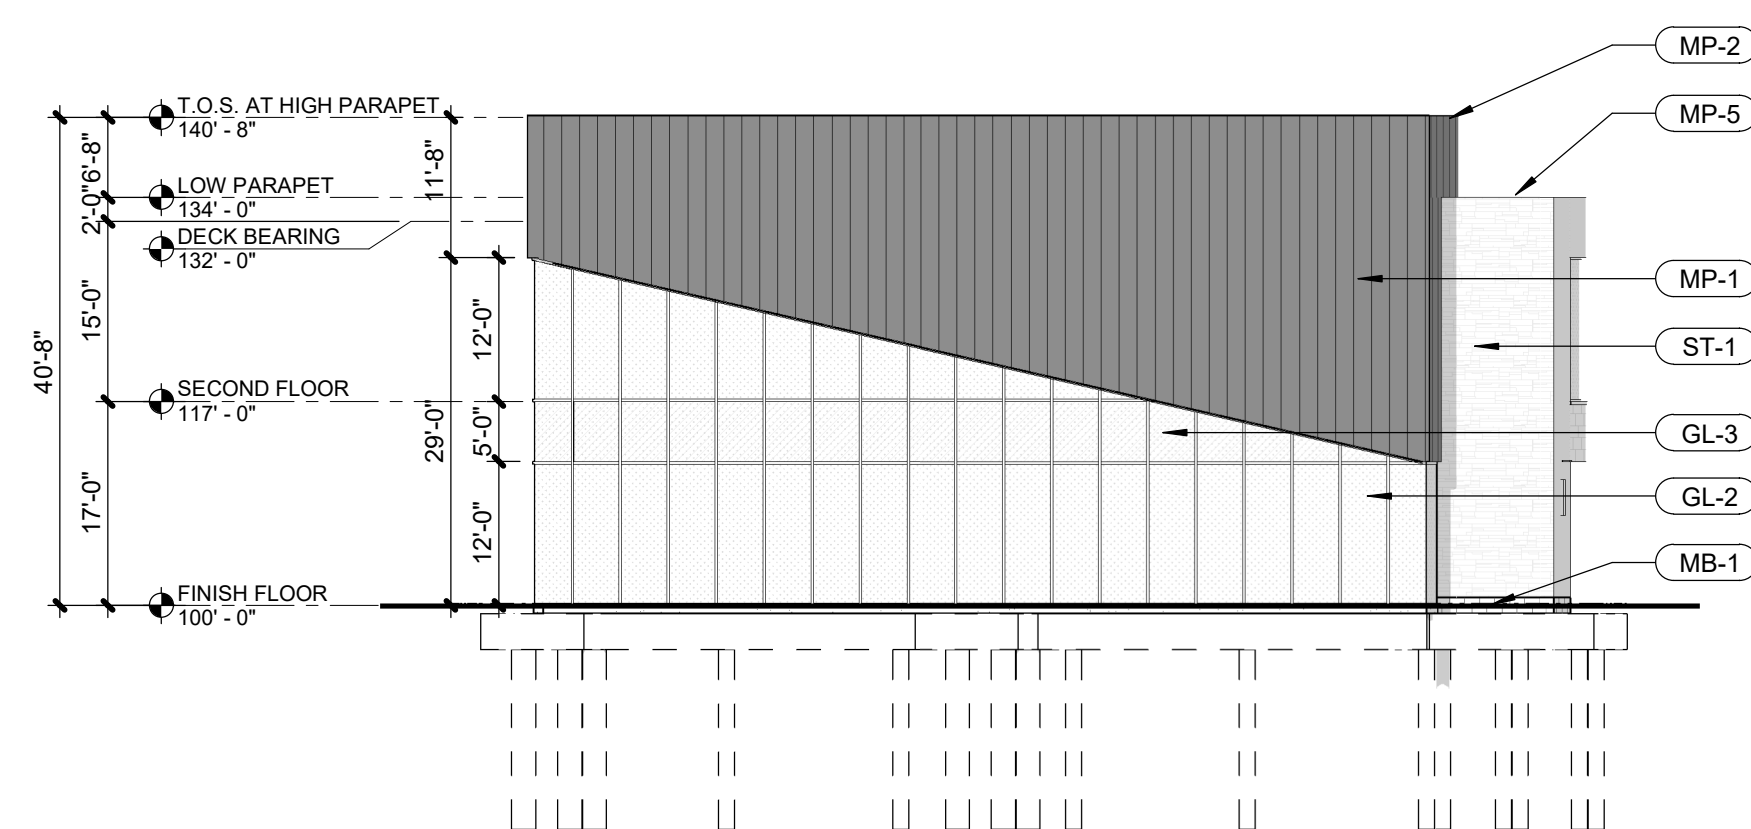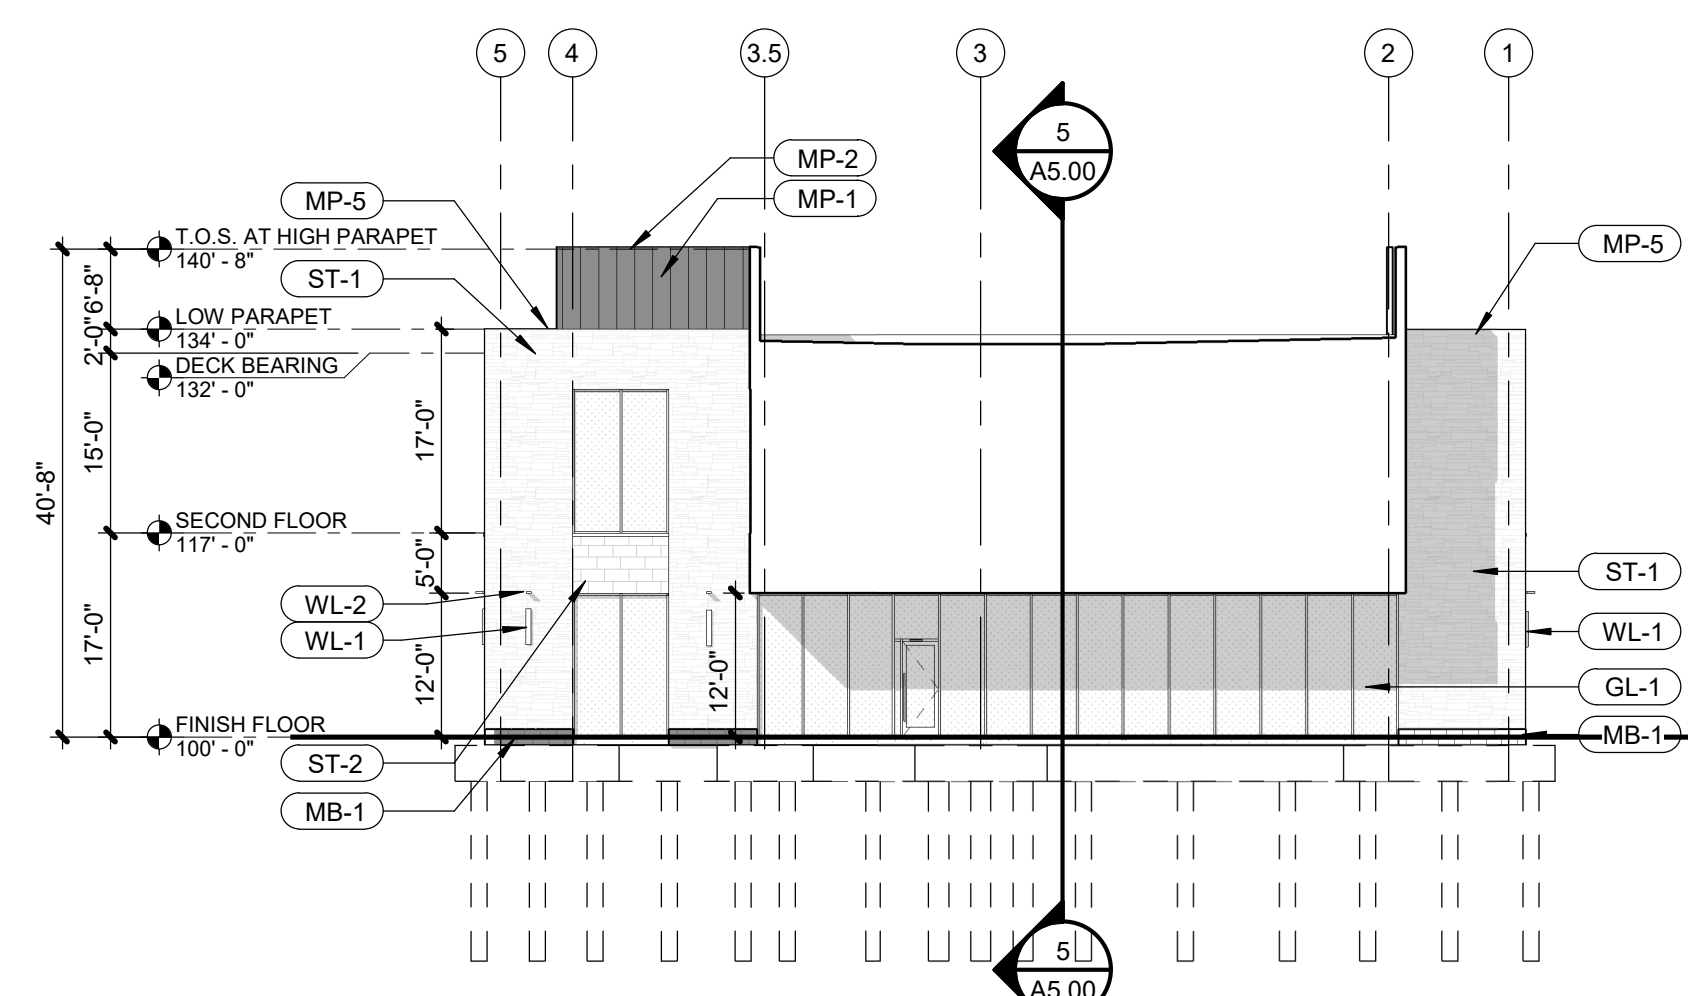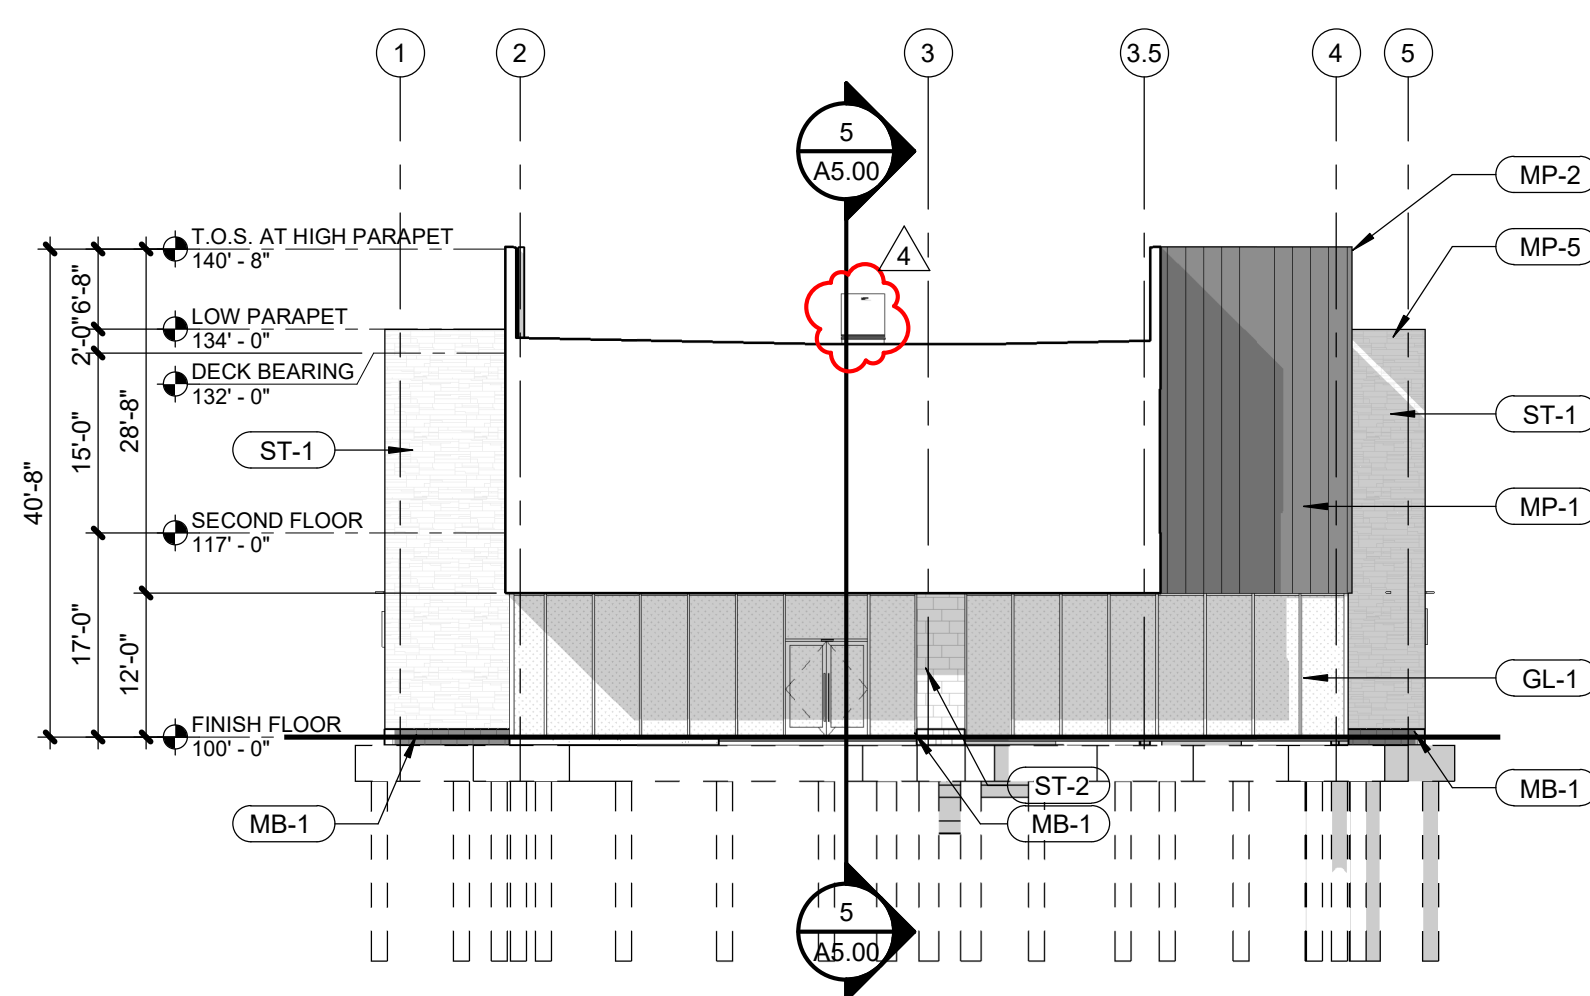Project No.:	19050.01a
Date:	11.29.22
Issued For:	CONSTRUCTION

REVISIONS		
No.	Date	Description
	9.27.22	ADDENDUM 2
	01.20.23	ASI-01



05.06.22

## PROJECT TEAM

ARCHITECT FINKLE+WILLIAMS  
ARCHITECTURE

CIVIL

LANDSCAPE LAND 3

FOUNDATIONS	BSE STRUCTURAL ENGINEERS
STRUCTURAL	BSE STRUCTURAL ENGINEERS

LUMBING      HENDERSON  
ENGINEERS

MECHANICAL HENDERSON  
ENGINEERSELECTRICAL HENDERSON  
ENGINEERS

FIRE PROTECTION HENDERSON

CONTRACTOR      FOGEL-ANDERSON

---

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## SHEET TITLE

## EXTERIOR ELEVATIONS

SHEET NUMBER

## A4.01



3201 NW PARAGON PKWY  
LEE'S SUMMIT, MO

3201 NW PARAGON PKWY  
LEE'S SUMMIT, MO

Project No.: 19050.01a


Date: 11.29.22

Used For: CONSTRUCTION

## REVISIONS

[illegible]

REGISTRATION

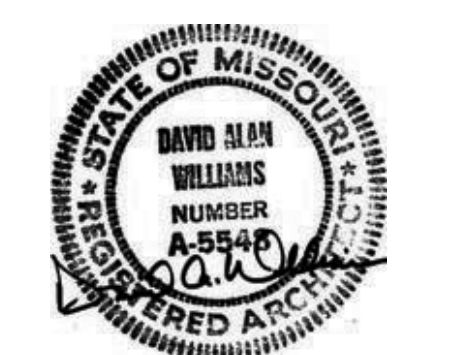

15.06.22

## SUBJECT TEAM

ARCHITECT FINKLE+WILLIAMS  
ARCHITECTURE

/IL GBA

LANDSCAPE LAND 3

FOUNDATIONS      BSE STRUCTURAL

STRUCTURAL      BSE STRUCTURAL

LUMBING      HENDERSON

MECHANICAL HENDERSON

ELECTRICAL HENDERSON

DE PROTECTION, HENDERSON

CONTRACTOR EOGEL-ANDERSON

INKLE + WILLIAMS  
ARCHITECTURE

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SHEET TITLE

ENLARGED  
ELEVATIONS -  
NORTH

ET NUMBER

## A4.02


MP-1	WESTERN STATES' WESTERN SNAP LOCK! STANDING SEAM MTL PANEL, 18" PANEL WIDTH, COLOR: MATTE MIDNIGHT BLACK
MP-2	KYNAR COATED 22 GA BREAK METAL COPING TO MATCH MTL PANEL, BASIS OF DESIGN: WESTERN STATES' MATTE MIDNIGHT BLACK OR APPROVED EQ.
MP-3	WESTERN STATES T-GROOVE FLUSH MTL PANEL, 12" MATTE MIDNIGHT BLACK
MP-4	KYNAR COATED 22 GA BREAK METAL COPING TO MATCH MP-1, BASIS OF DESIGN: WESTERN STATES' MATTE MIDNIGHT BLACK OR APPROVED EQ.
MP-5	KYNAR COATED 24 GA BREAK METAL COPING TO MATCH ST-1, BASIS OF DESIGN: WESTERN STATES' COOL TECH POLAR WHITE OR APPROVED EQ.
GL-1	2" x 4 1/2" WINDOW WALL, BLACK ANODIZED ALUMINUM FINISH W/ 1" INSULATED LOW-E GLAZING UNIT
GL-2	2 1/4" x 1/2" CURTAINWALL SYSTEM, BLACK ANODIZED ALUMINUM FINISH W/ 1" INSULATED LOW-E GLAZING UNIT
GL-3	GL-1 AT SECOND LEVEL STRUCTURE TO BE SPANDIX GLASS, GPX SOLARBAN 70XL SOLAR CONTROL LOW-E GLAZING UNIT W/ SUBDUED GRAY OPAQUEIFIER ON 4TH SURFACE, OR APPROVED EQ.
WD-1	DELTA MILLWORKS ACCOYA 6" T&G WOOD SOFFIT, UNFINISHED, CONTRACTOR TO STAIN IN-FIELD TO MATCH ARCHITECT'S SAMPLE
ST-1	BORAL CULTURED STONE; HEWEN STONE; COLOR: ARCTIC; PATTERN: HSP35808"
ST-2	ELDORADO SPLITEDG STONE MARQUEE24, COLOR: DOVETAIL"
ST-3	ELDORADO SPLITEDG WHITE CLOUD SPLIT, SILEX AT ALL WINDOW WALL OPENINGS IN ST-1 OR ST-2 WALLS
	*PROVIDE CONTRAST JOINT AT SECOND LEVEL ON ALL ST-1 AND ST-2 LOCATIONS PER ELEVATIONS AND MFR RECOMMENDATIONS; STONE TO BE NO GROUT, DRY-STACK AESTHETIC.

MB-1 GROUND FACE 10Wx8Hx16L MASONRY BLOCK PER STRUCTURAL DWGS. BASIS OF DESIGN: TRENDSTONE PLUS GROUND AND POLISHED, COLOR: MIDWEST SLATE

AWN-1 SHOP-BUILT POWDER-COATED ALUM. W/ SURFACE MOUNTED STANDING SEAM METAL TO MATCH MP-1; COORD. W/ ARCHITECT AND STRUCTURAL ENG.


FP-1	LOCATION FOR FDC AND KNOX BOX PER FIRE PROTECTION DRAWINGS; CENTER FIXTURES IN WALL UNO
PD-1	ROOF OVERFLOW DRAIN DOWNSPOUT COVER PER PLUMBING DRAWINGS; CENTER ON WALL SPACE UNO

WL-1	EXTERIOR DECORATIVE WALL LIGHT; AT 9'-0" AFF; CENTER ON WALL SPACE PER ELEVATIONS UNO
WL-2	EXTERIOR WALL-MOUNTED UP-LIGHT; ALIGN W/ SOFFIT AT 12'-0" AFF; CENTER ON WALL SPACE PER ELEVATIONS UNO
WL-3	PROVIDE J-BOX FOR FUTURE WALL LIGHT PER TENANT AT 9'-0" AFF; CENTER ON WALL SPACE PER ELEVATIONS UNO

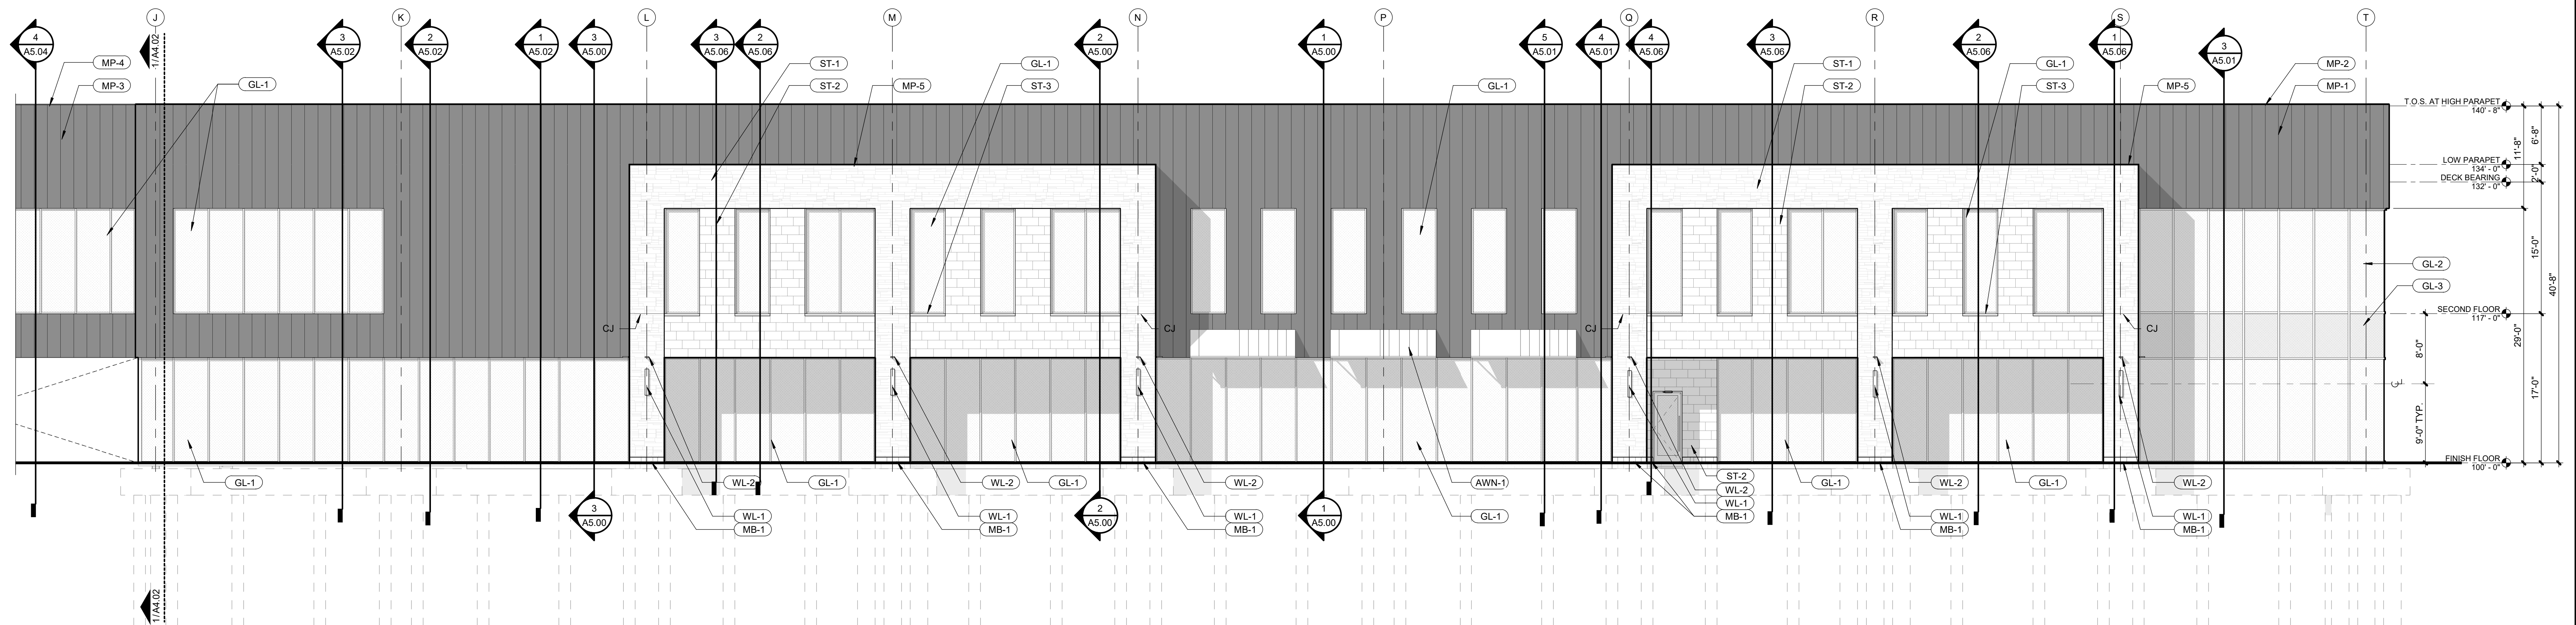


2	NORTH ELEVATION - WEST
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<b>A4.02</b>	SCALE : 1/8" = 1'-0"
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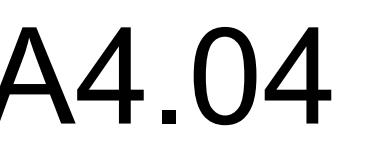


1	NORTH ELEVATION - EAST
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<b>A4.02</b>	SCALE : 1/8" = 1'-0"
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<b>A4.03</b>	SCALE : 1/8" = 1'-0"
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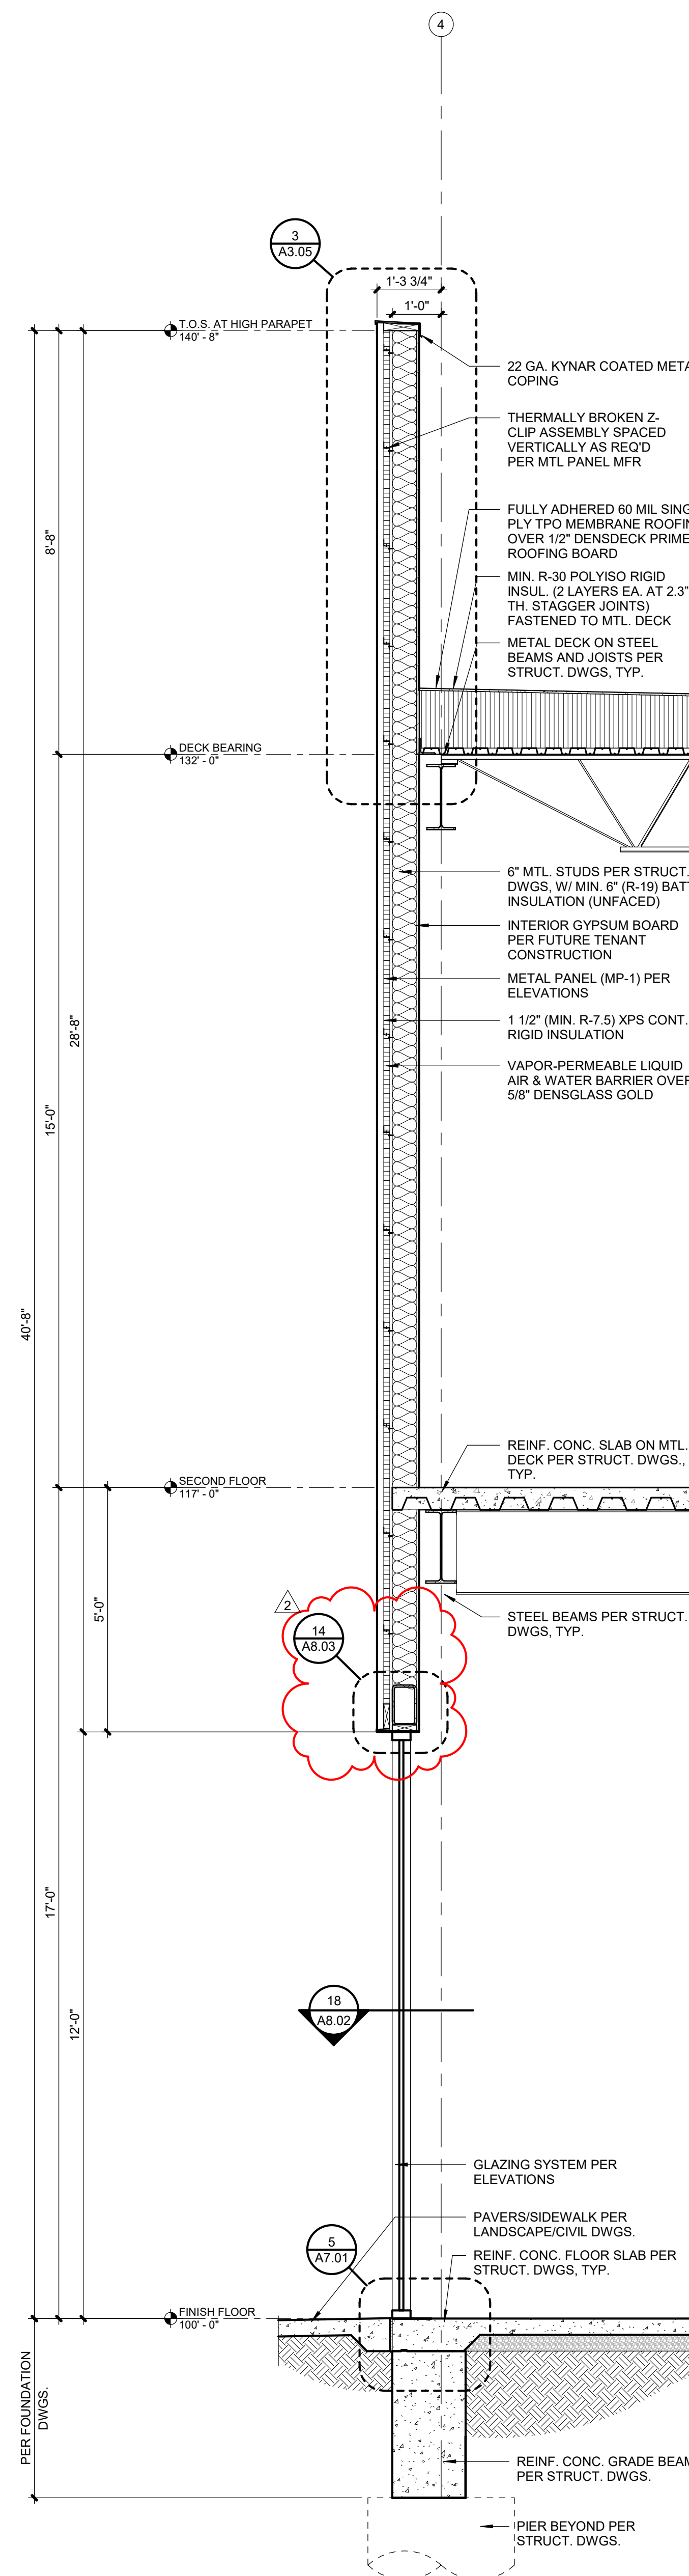
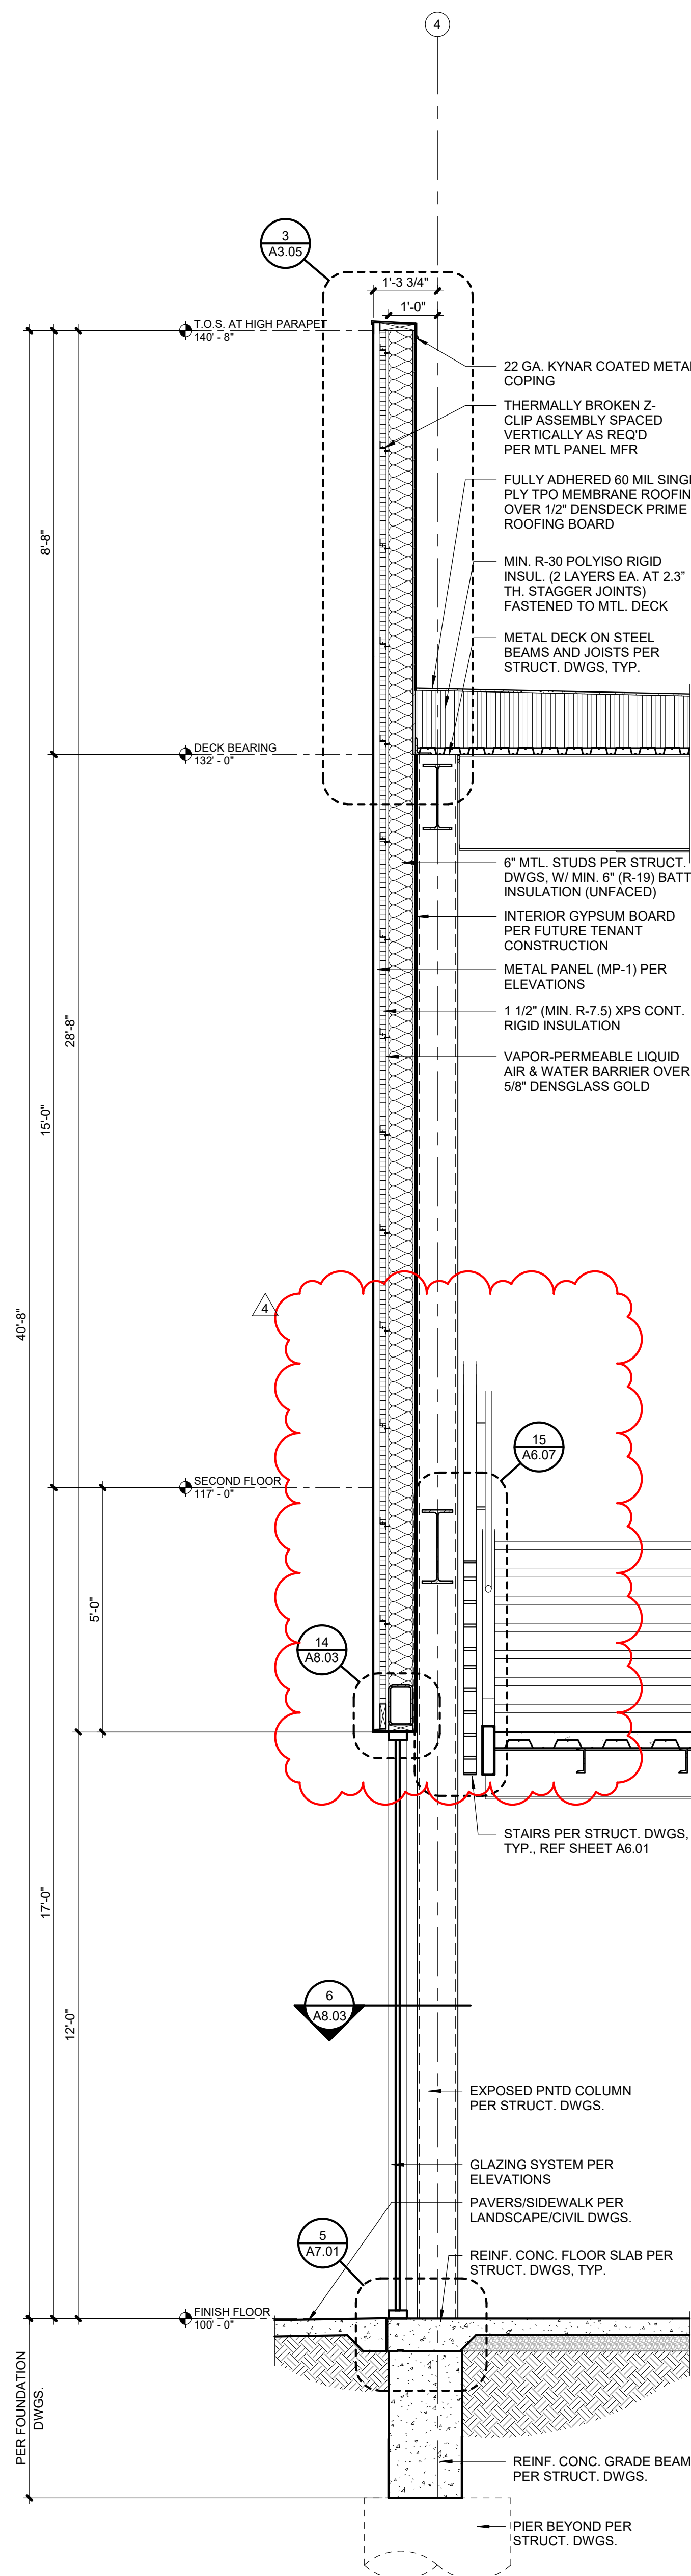
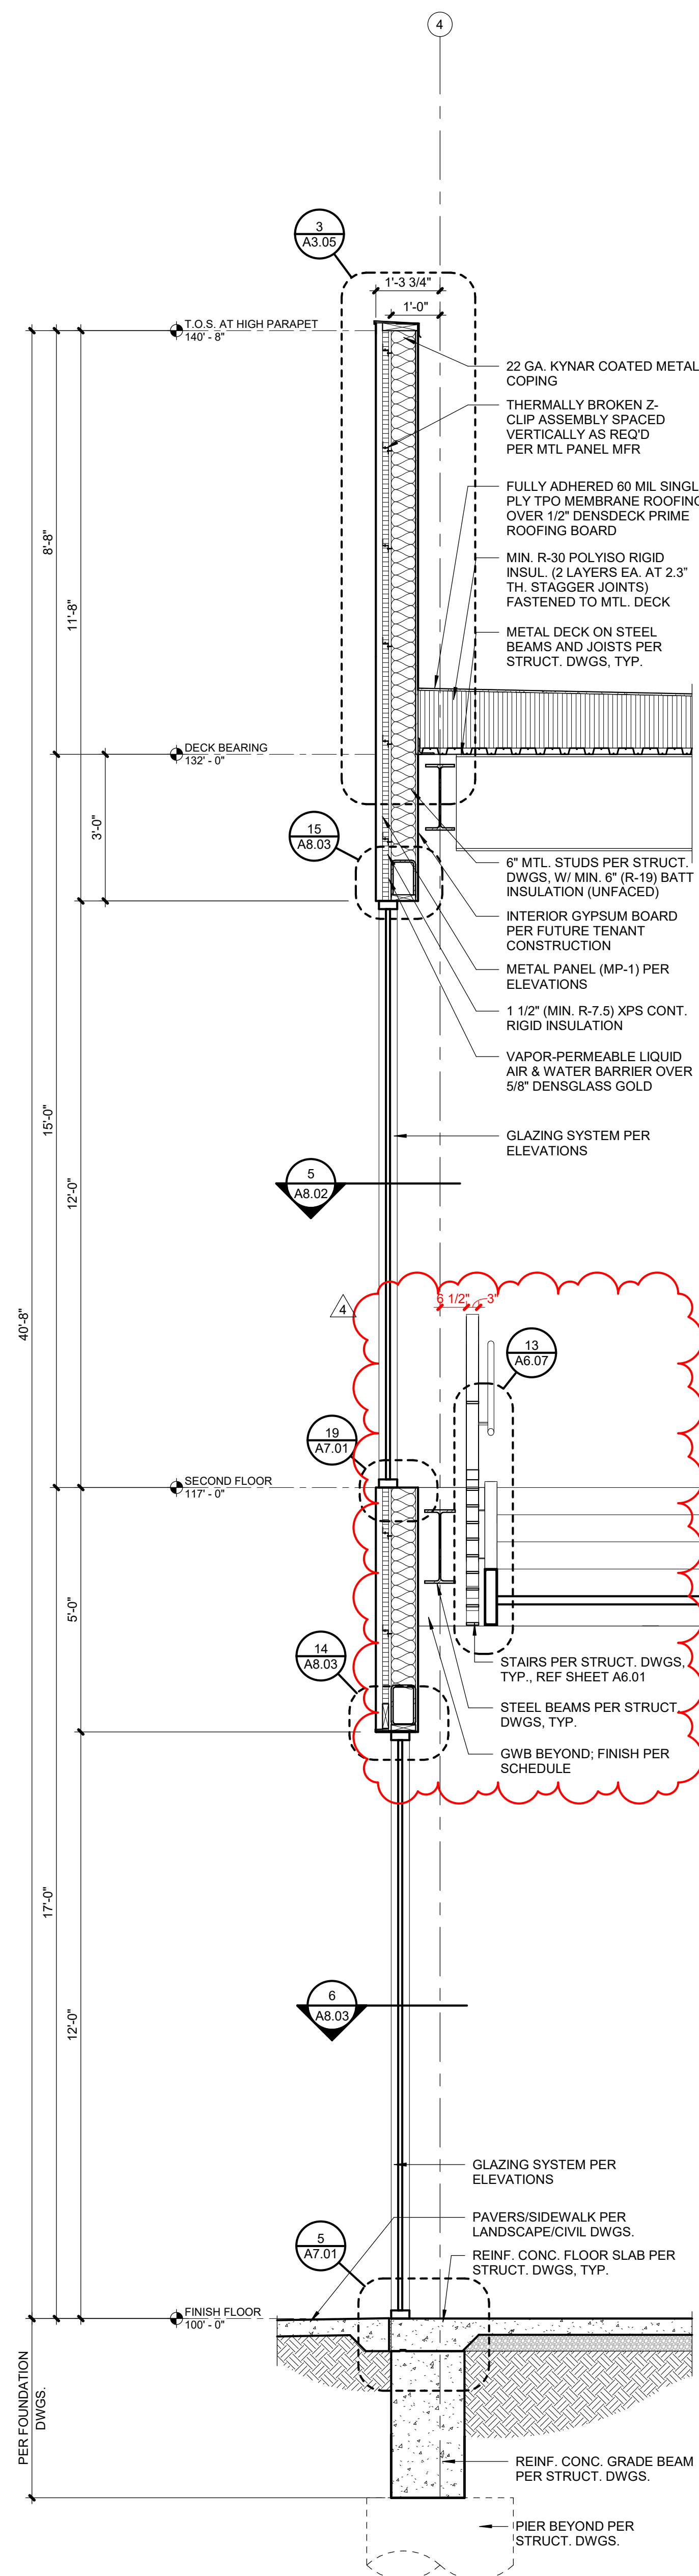
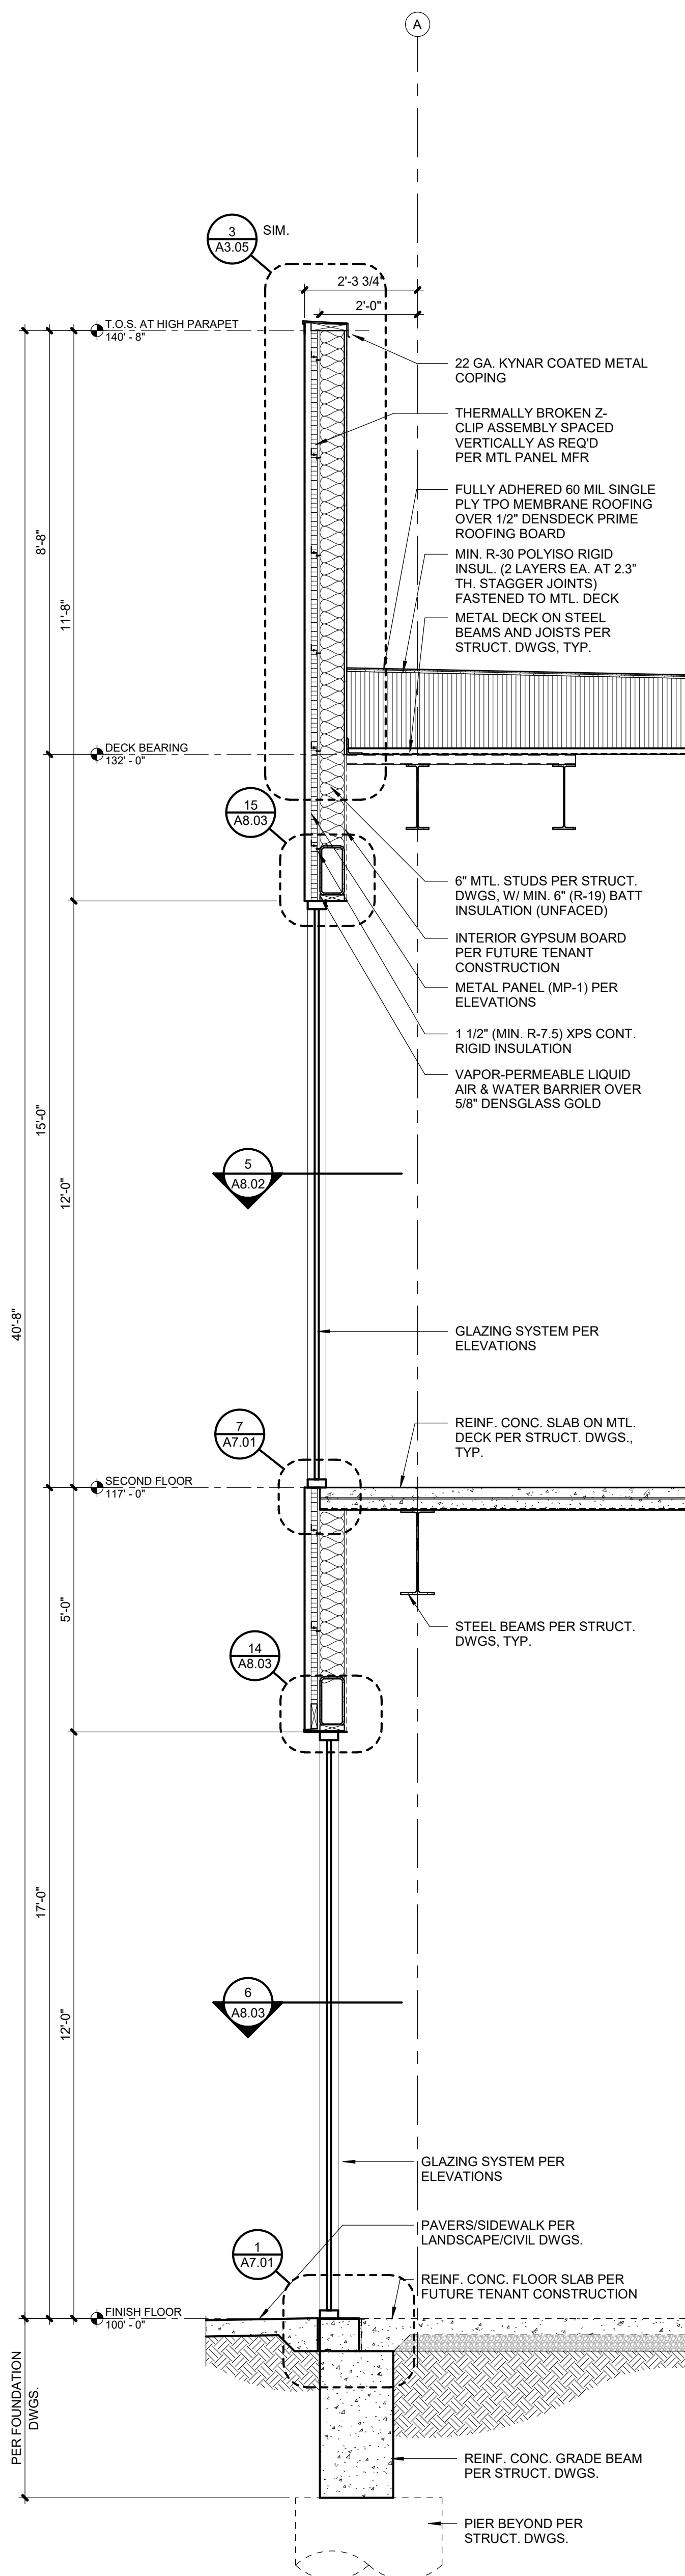
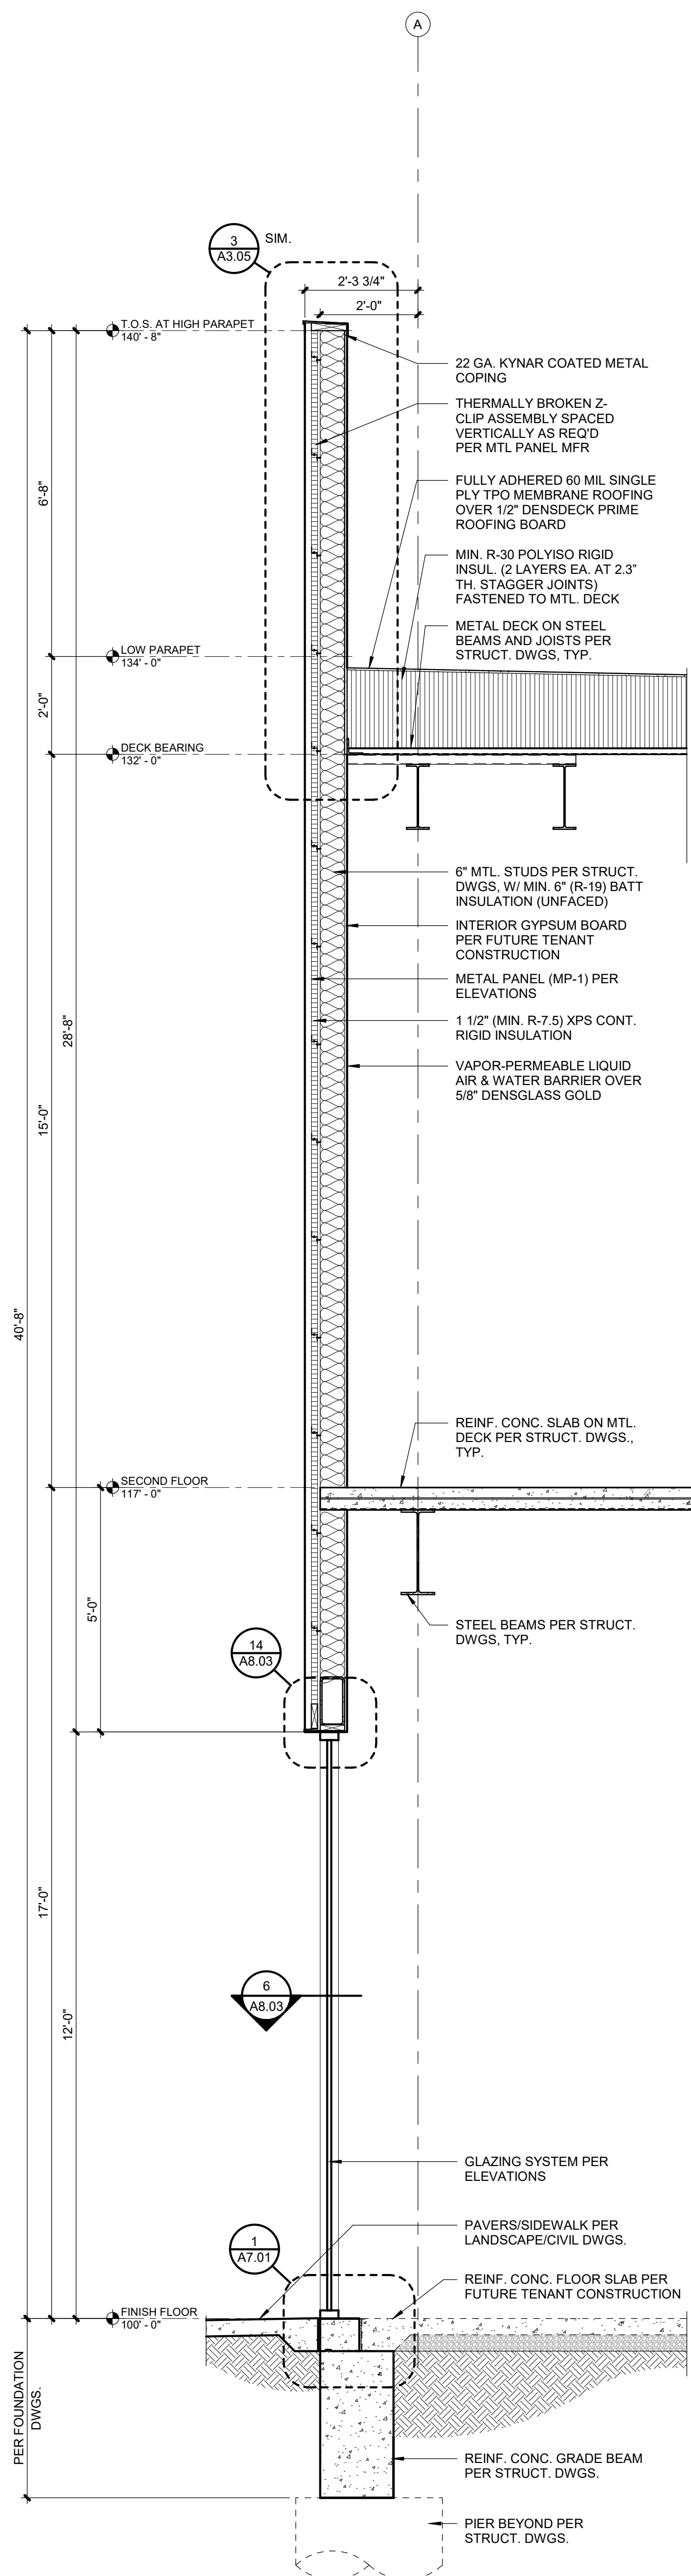
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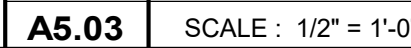


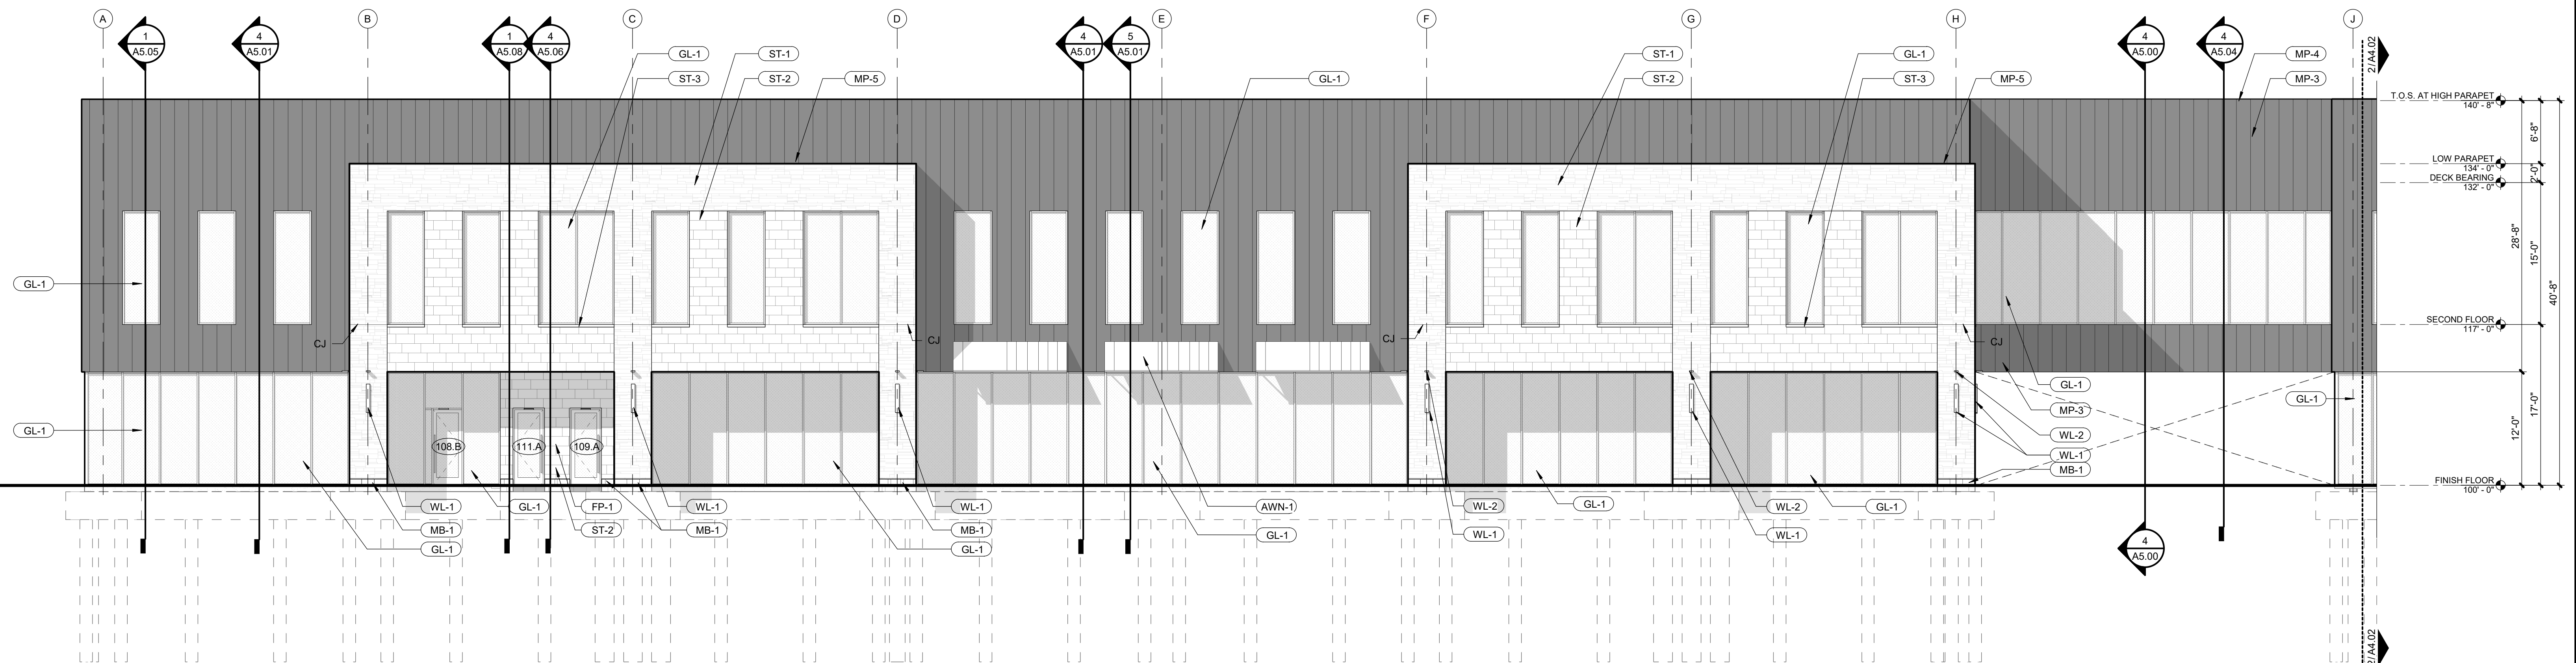ARCHITECT	FINKLE+WILLIAMS ARCHITECTURE
CIVIL	GBA
LANDSCAPE	LAND 3
FOUNDATIONS	BSE STRUCTURAL ENGINEERS
STRUCTURAL	BSE STRUCTURAL ENGINEERS
PLUMBING	HENDERSON ENGINEERS
MECHANICAL	HENDERSON ENGINEERS
ELECTRICAL	HENDERSON ENGINEERS
FIRE PROTECTION	HENDERSON ENGINEERS
CONTRACTOR	FOGEL-ANDERSON



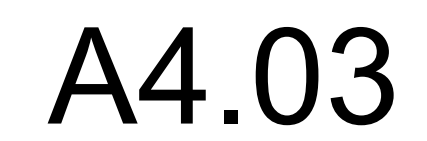

**NOT USED**



3201 NW PARAGON PKWY  
LEE'S SUMMIT, MO

Project No.:	19050.01a
Date:	09.27.22
Issued For:	CONSTRUCTION

[illegible]

REGISTRATION



5.06.22

## PROJECT TEAM

ARCHITECT	FINKLE+WILLIAMS ARCHITECTURE
CIVIL	GBA
LANDSCAPE	LAND 3
FOUNDATIONS	BSE STRUCTURAL ENGINEERS
STRUCTURAL	BSE STRUCTURAL ENGINEERS
PLUMBING	HENDERSON ENGINEERS
MECHANICAL	HENDERSON ENGINEERS
ELECTRICAL	HENDERSON ENGINEERS
FIRE PROTECTION	HENDERSON ENGINEERS
CONTRACTOR	FOGEL-ANDERSON

INKLE + WILLIAMS  
ARCHITECTURE


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ET TITLE


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T NUMBER


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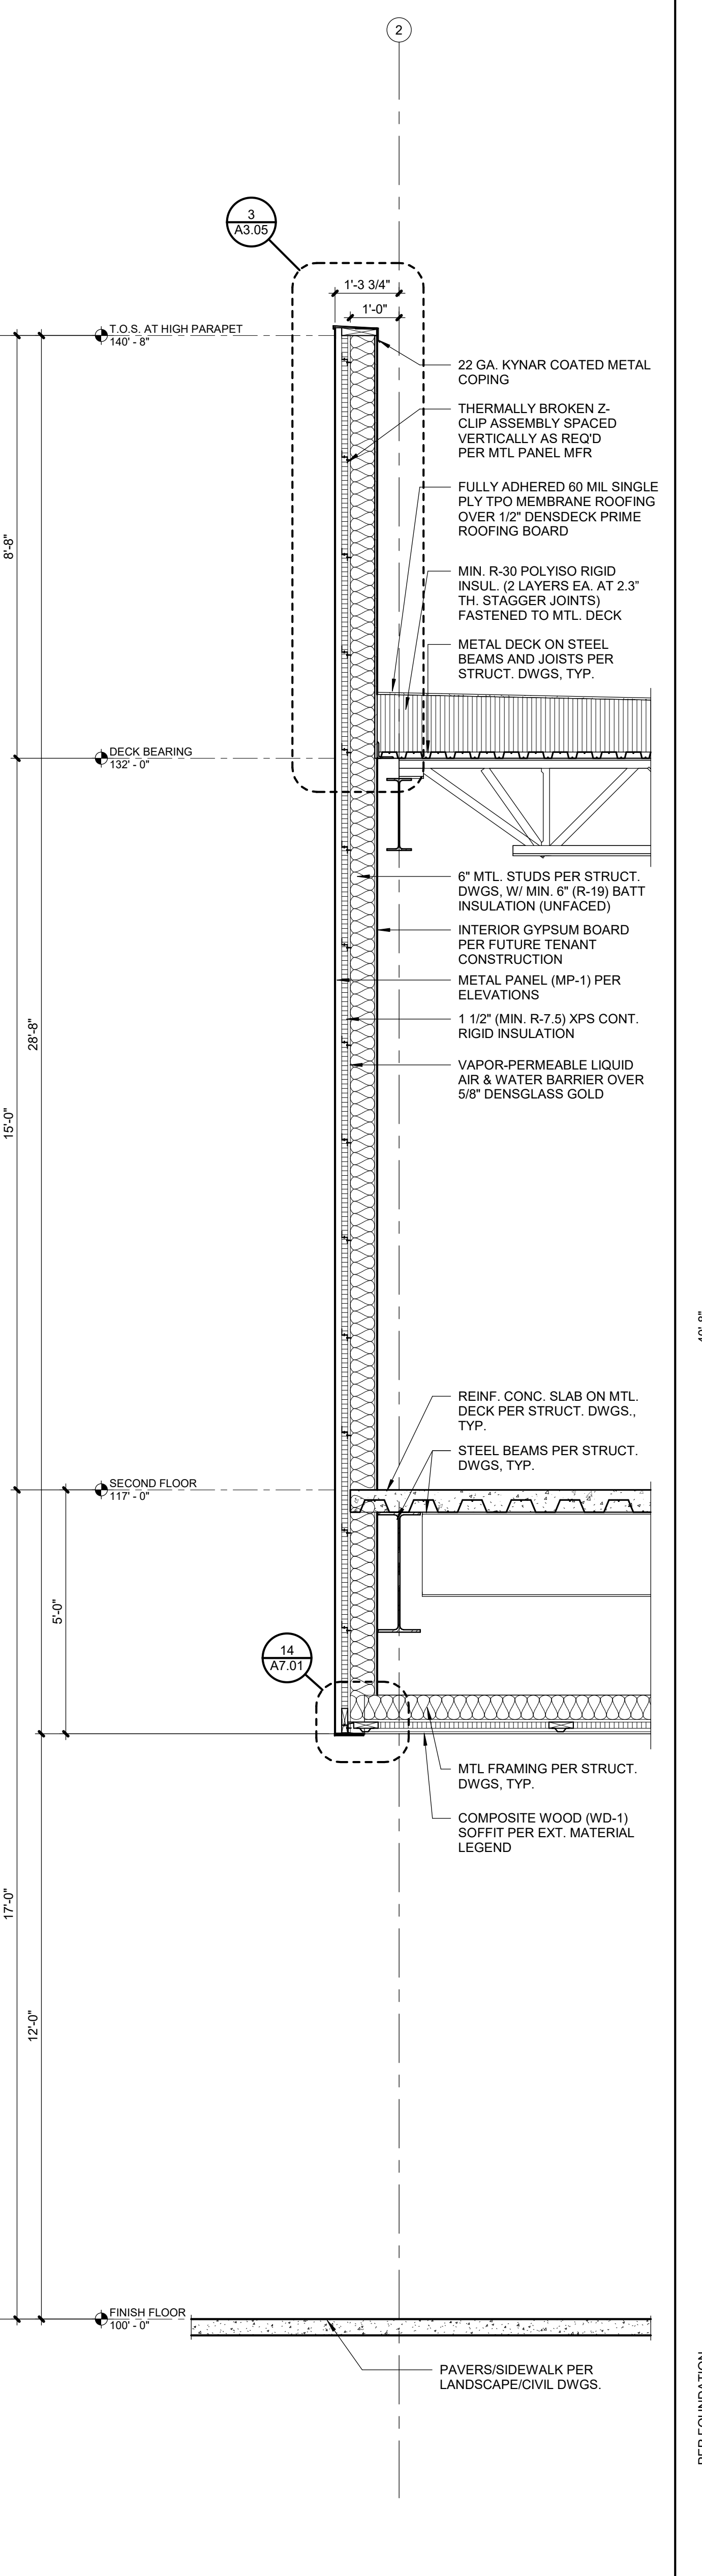
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A5.04	SCALE : 1/2" = 1'-0"




4	WALL SECTION
A5.04	SCALE : 1/2" = 1'-0"

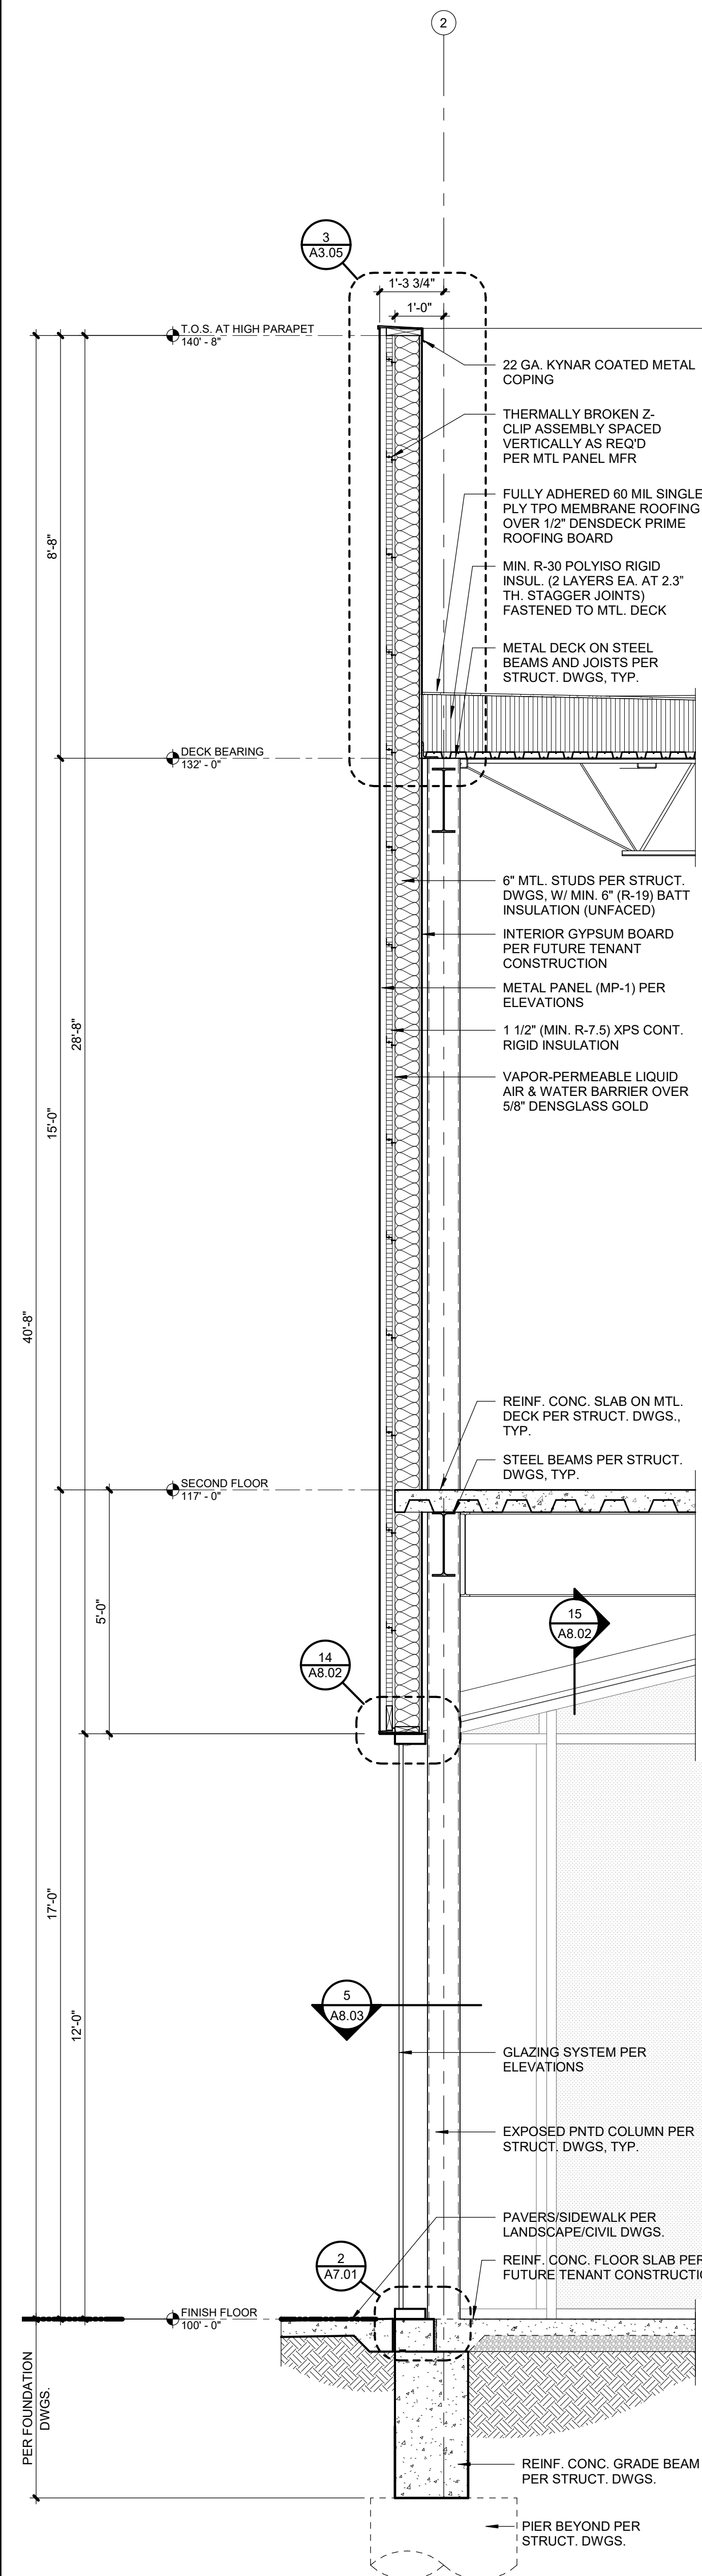

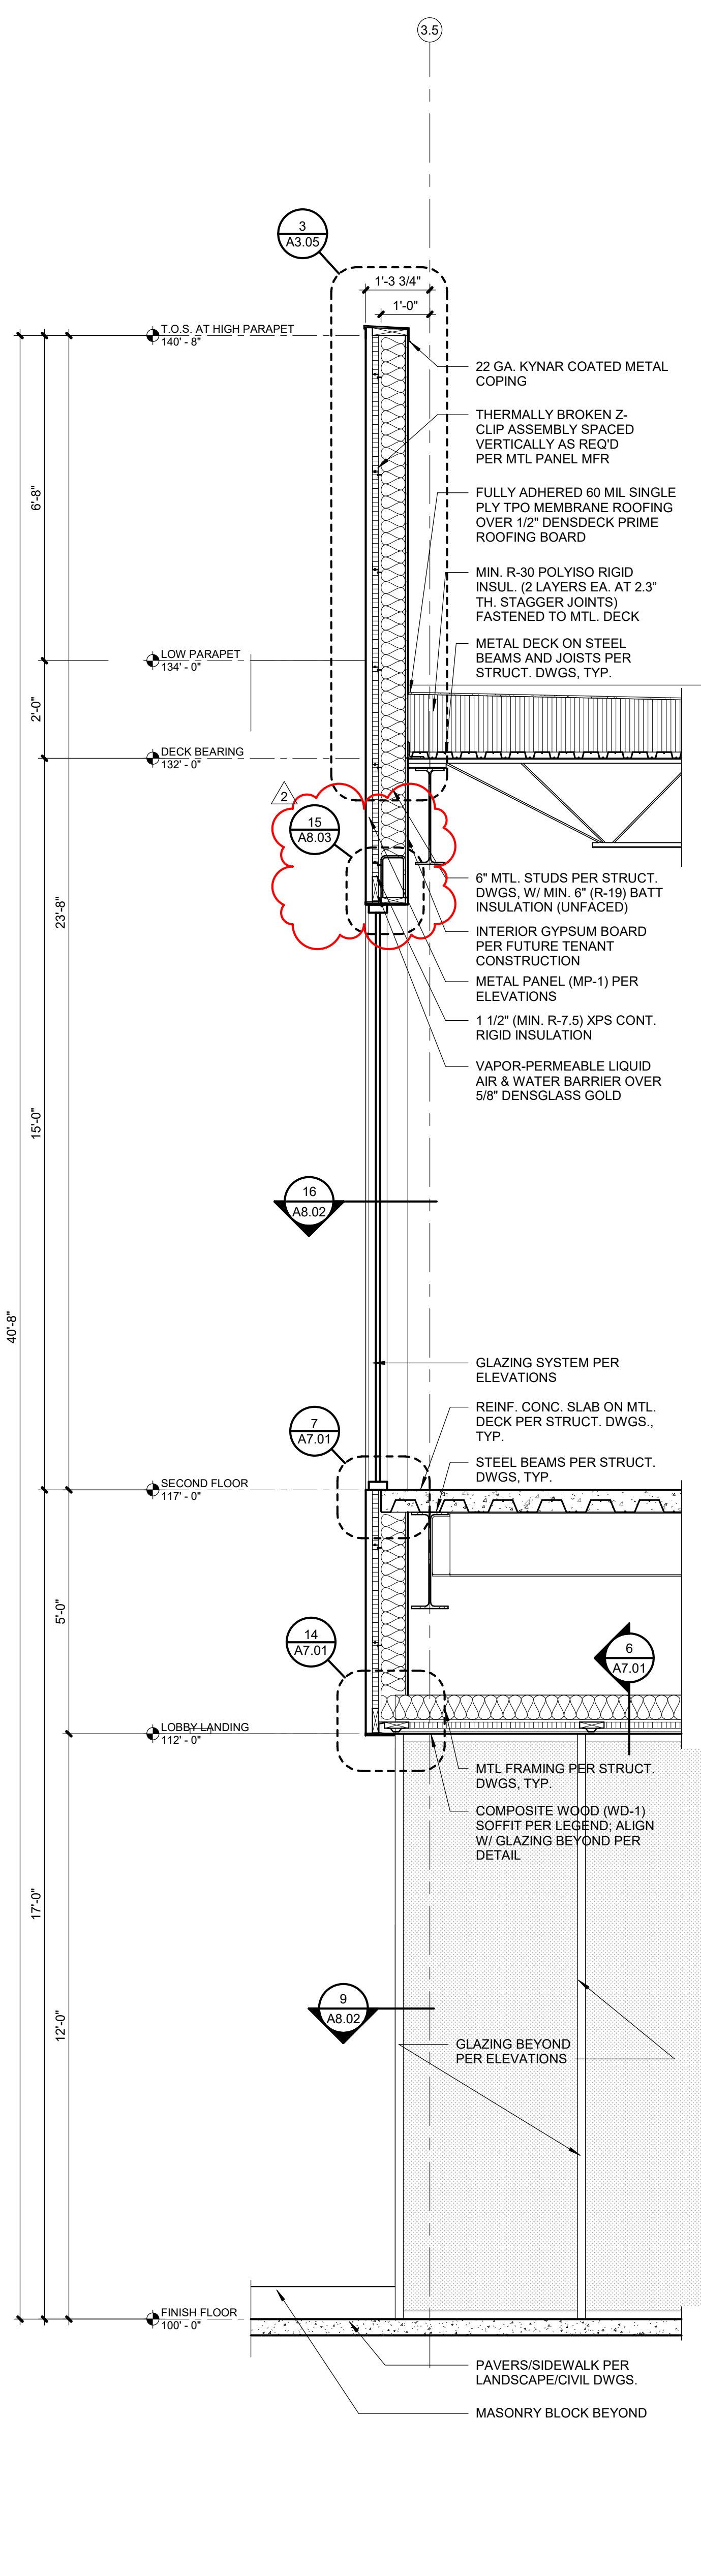3	WALL SECTION
5.04	SCALE : 1/2" = 1'-0"

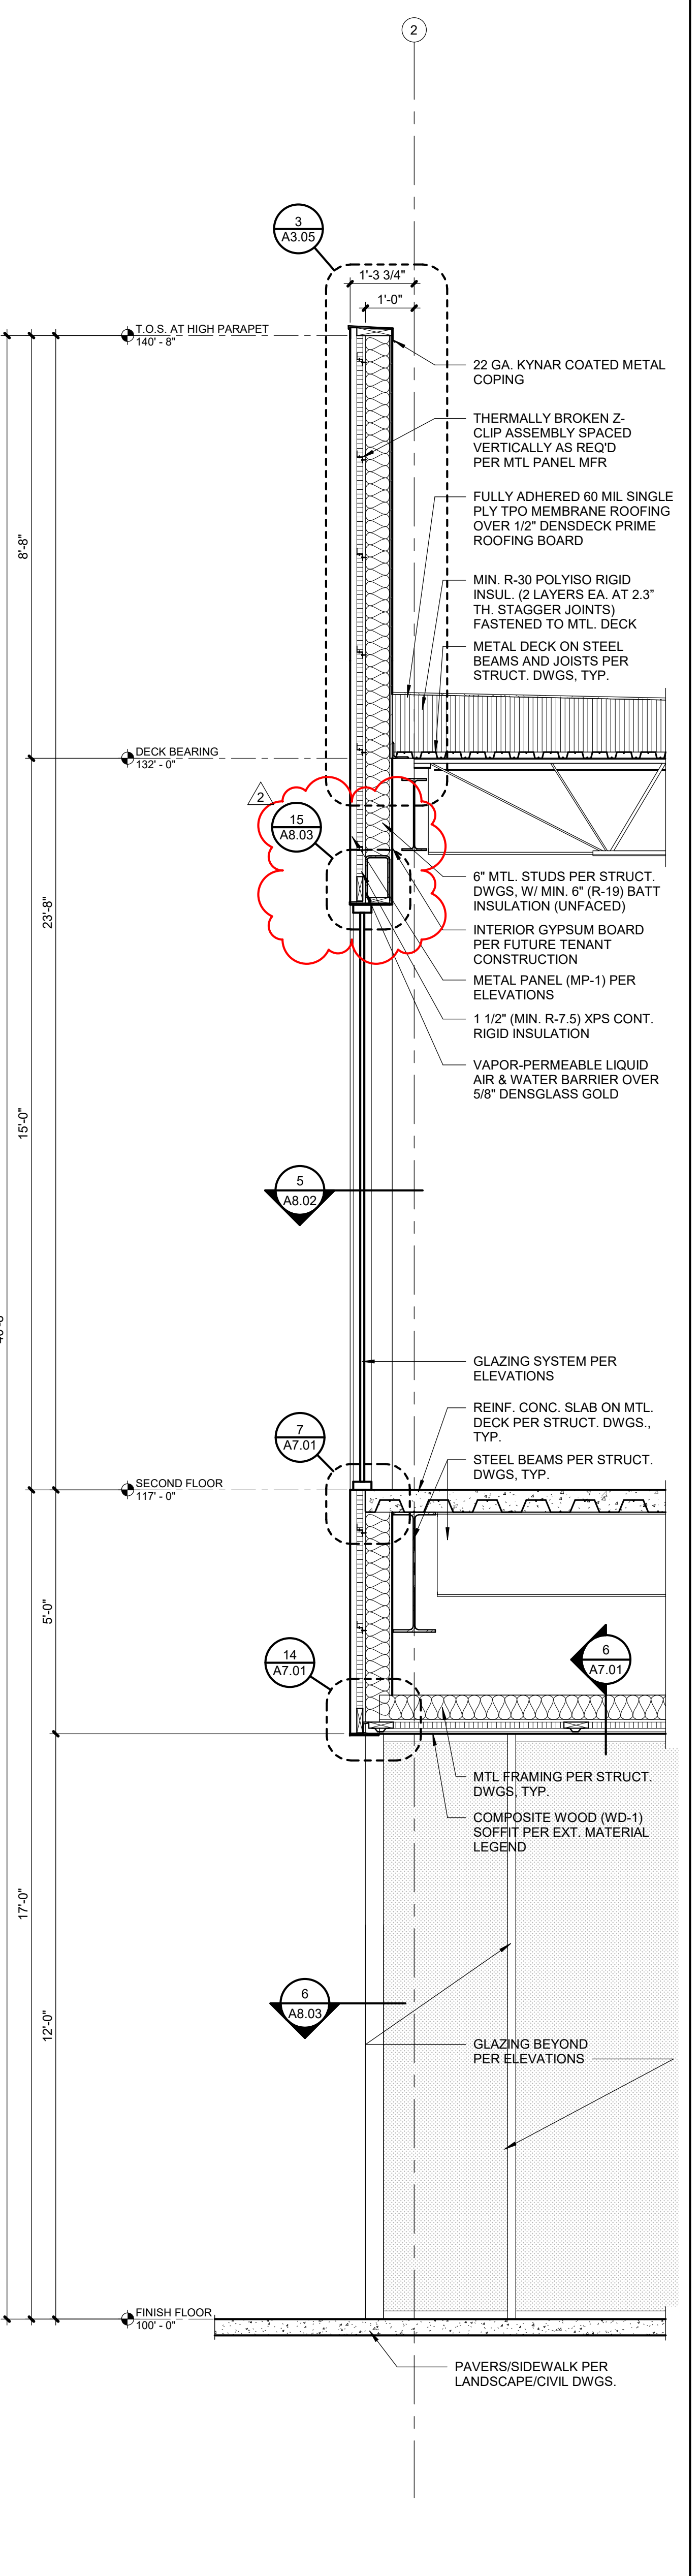



	WALL SECTION
4	SCALE : 1/2" = 1'-0"

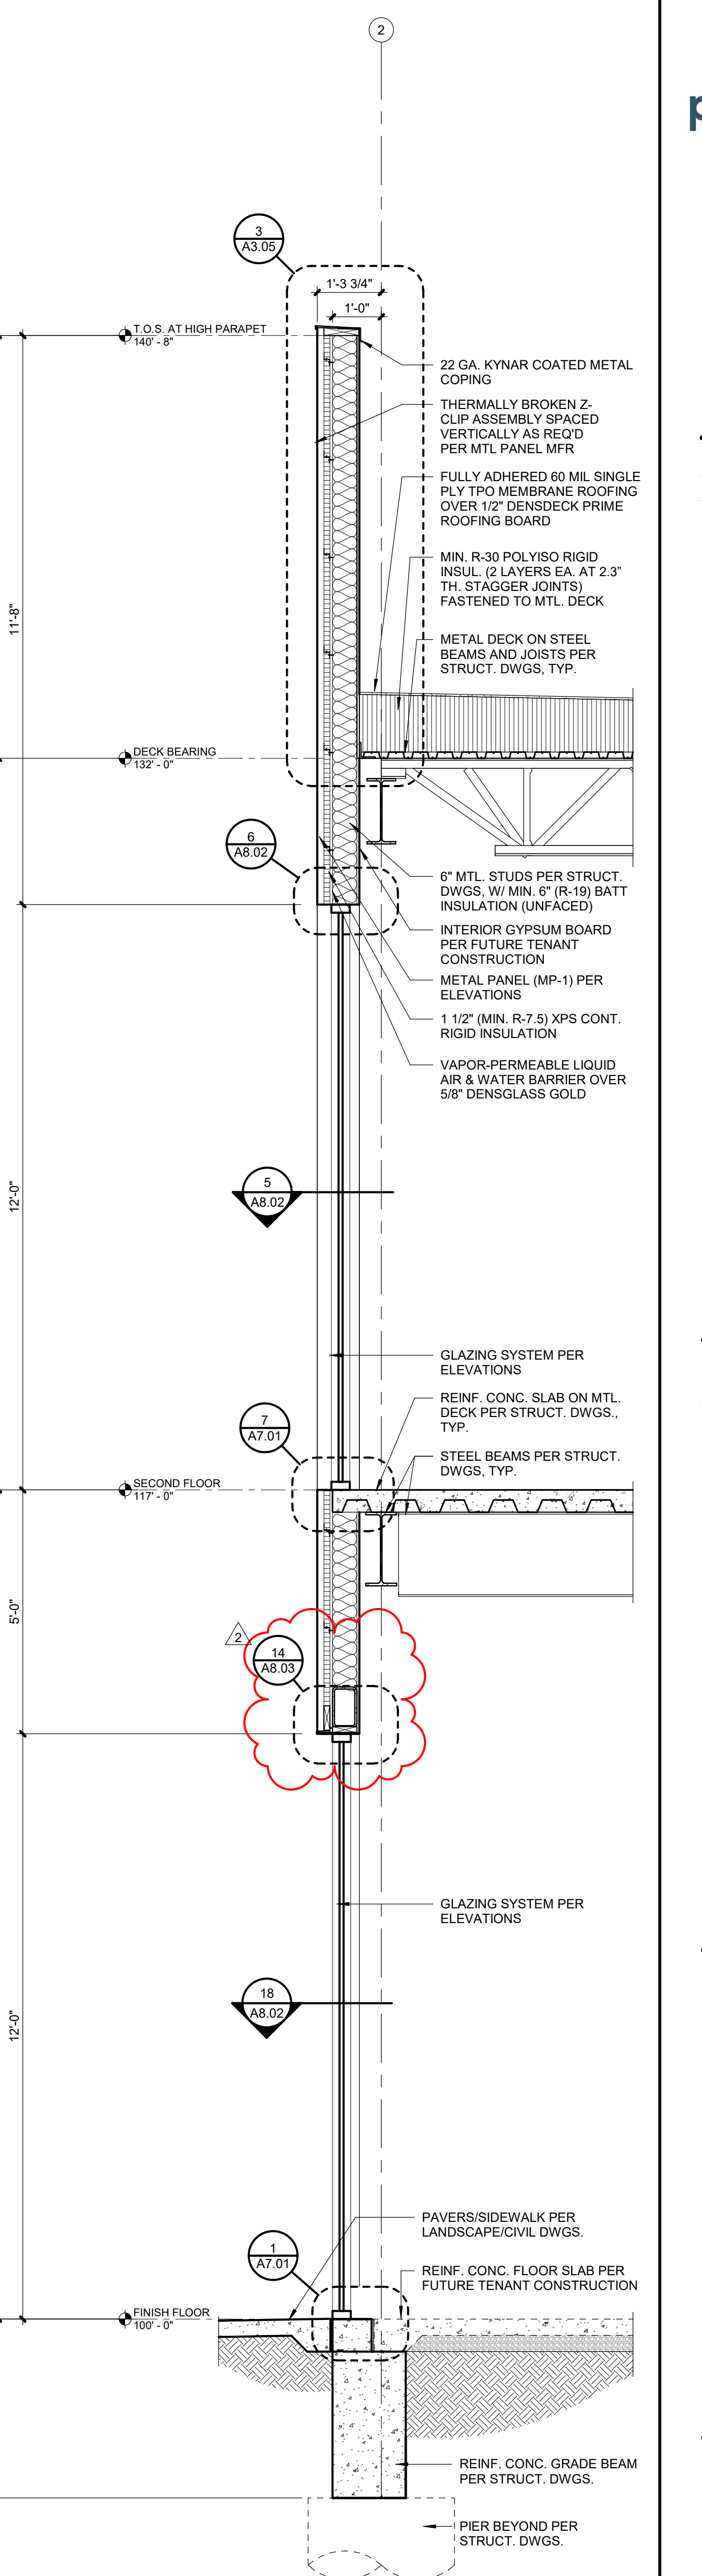


WALL SECTION
SCALE : 1/2" = 1'-0"



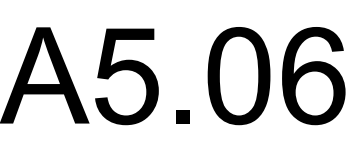

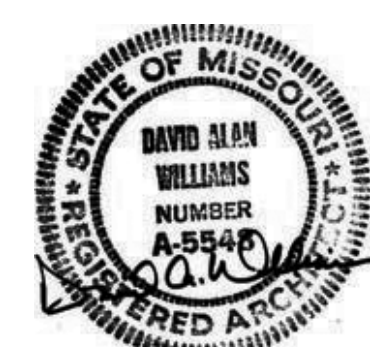


ARCHITECT	FINKLE+WILLIAMS ARCHITECTURE
CIVIL	GBA
LANDSCAPE	LAND 3
FOUNDATIONS	BSE STRUCTURAL ENGINEERS
STRUCTURAL	BSE STRUCTURAL ENGINEERS
PLUMBING	HENDERSON ENGINEERS
MECHANICAL	HENDERSON ENGINEERS
ELECTRICAL	HENDERSON ENGINEERS
FIRE PROTECTION	HENDERSON ENGINEERS
CONTRACTOR	FOGEL-ANDERSON

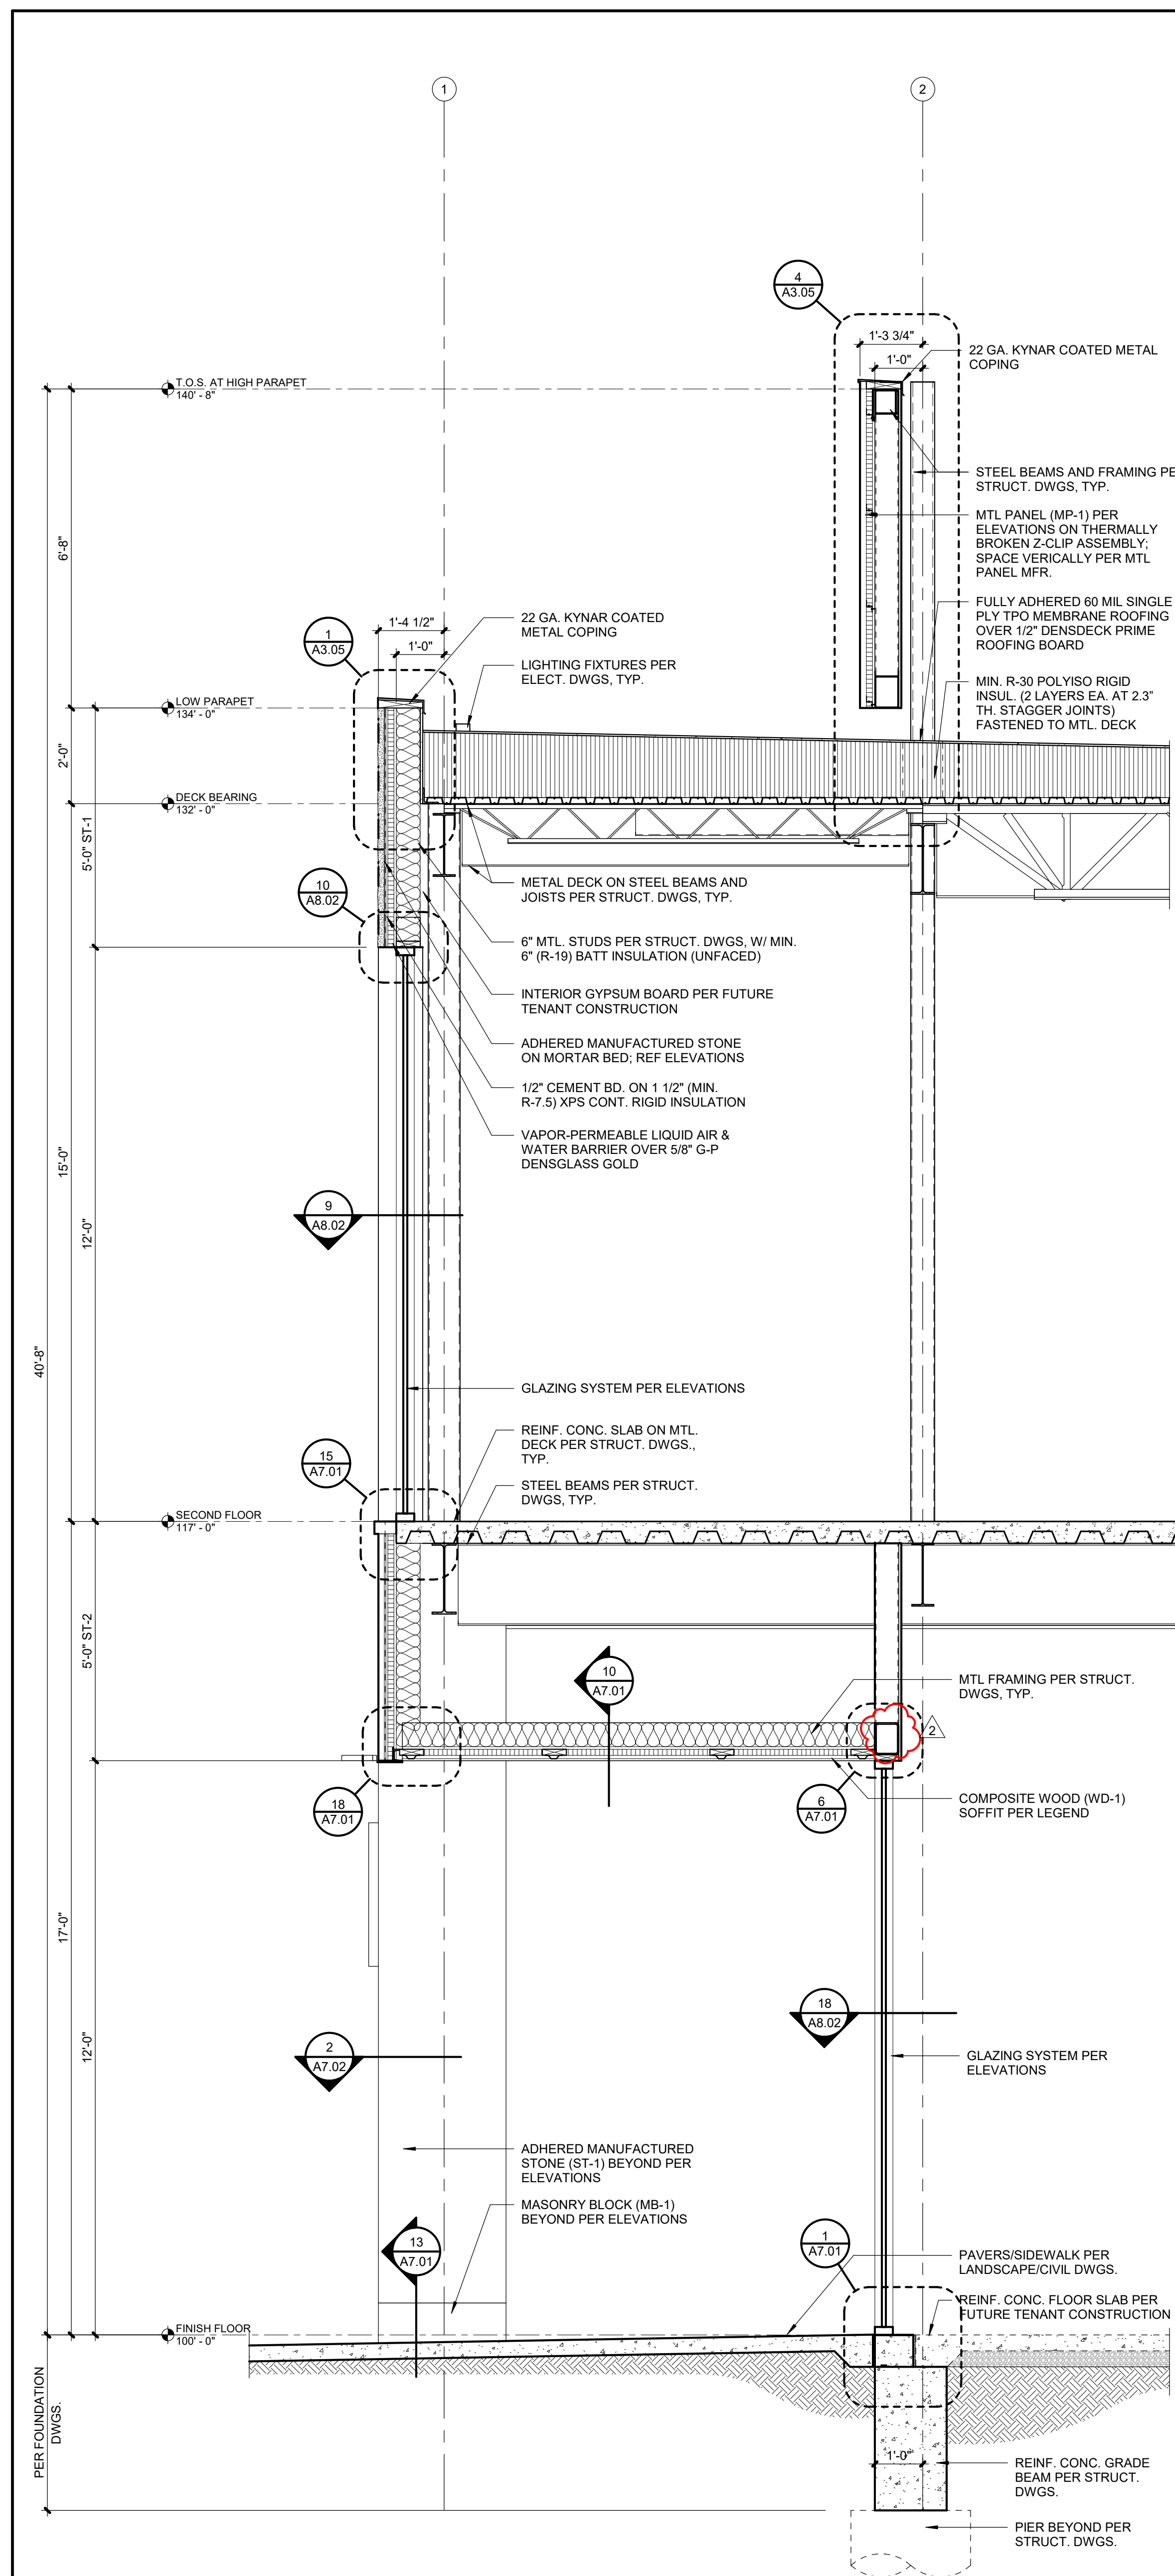


3 WALL SECTION

A5.07 SCALE: 1/2" = 1'-0"

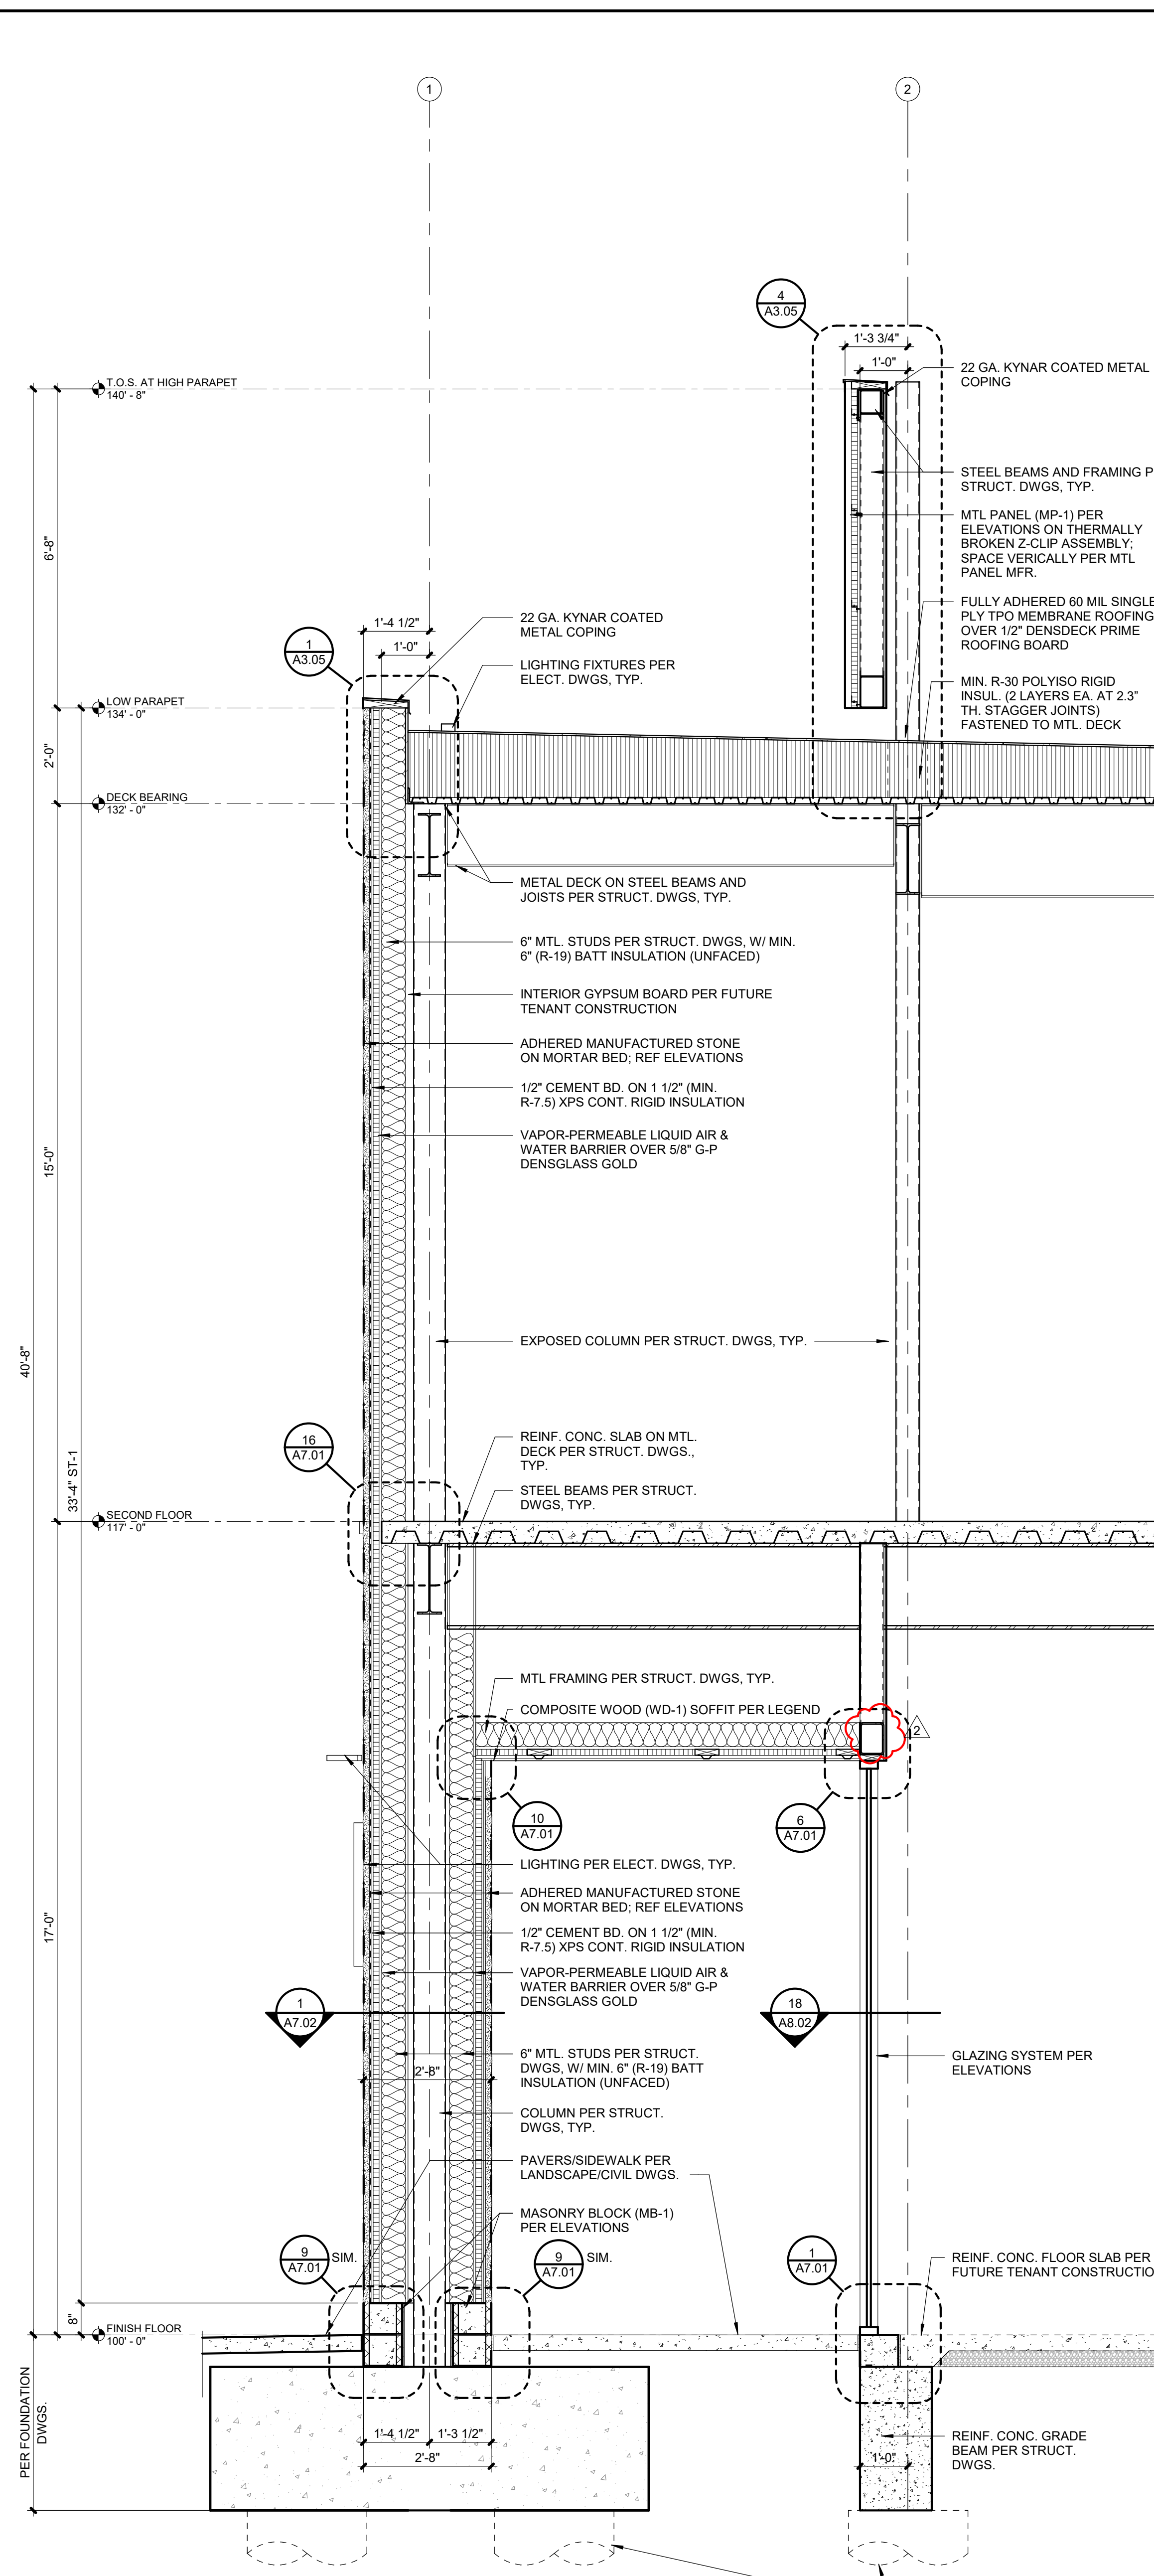

2 WALL SECTION


A5.07 SCALE: 1/2" = 1'-0"

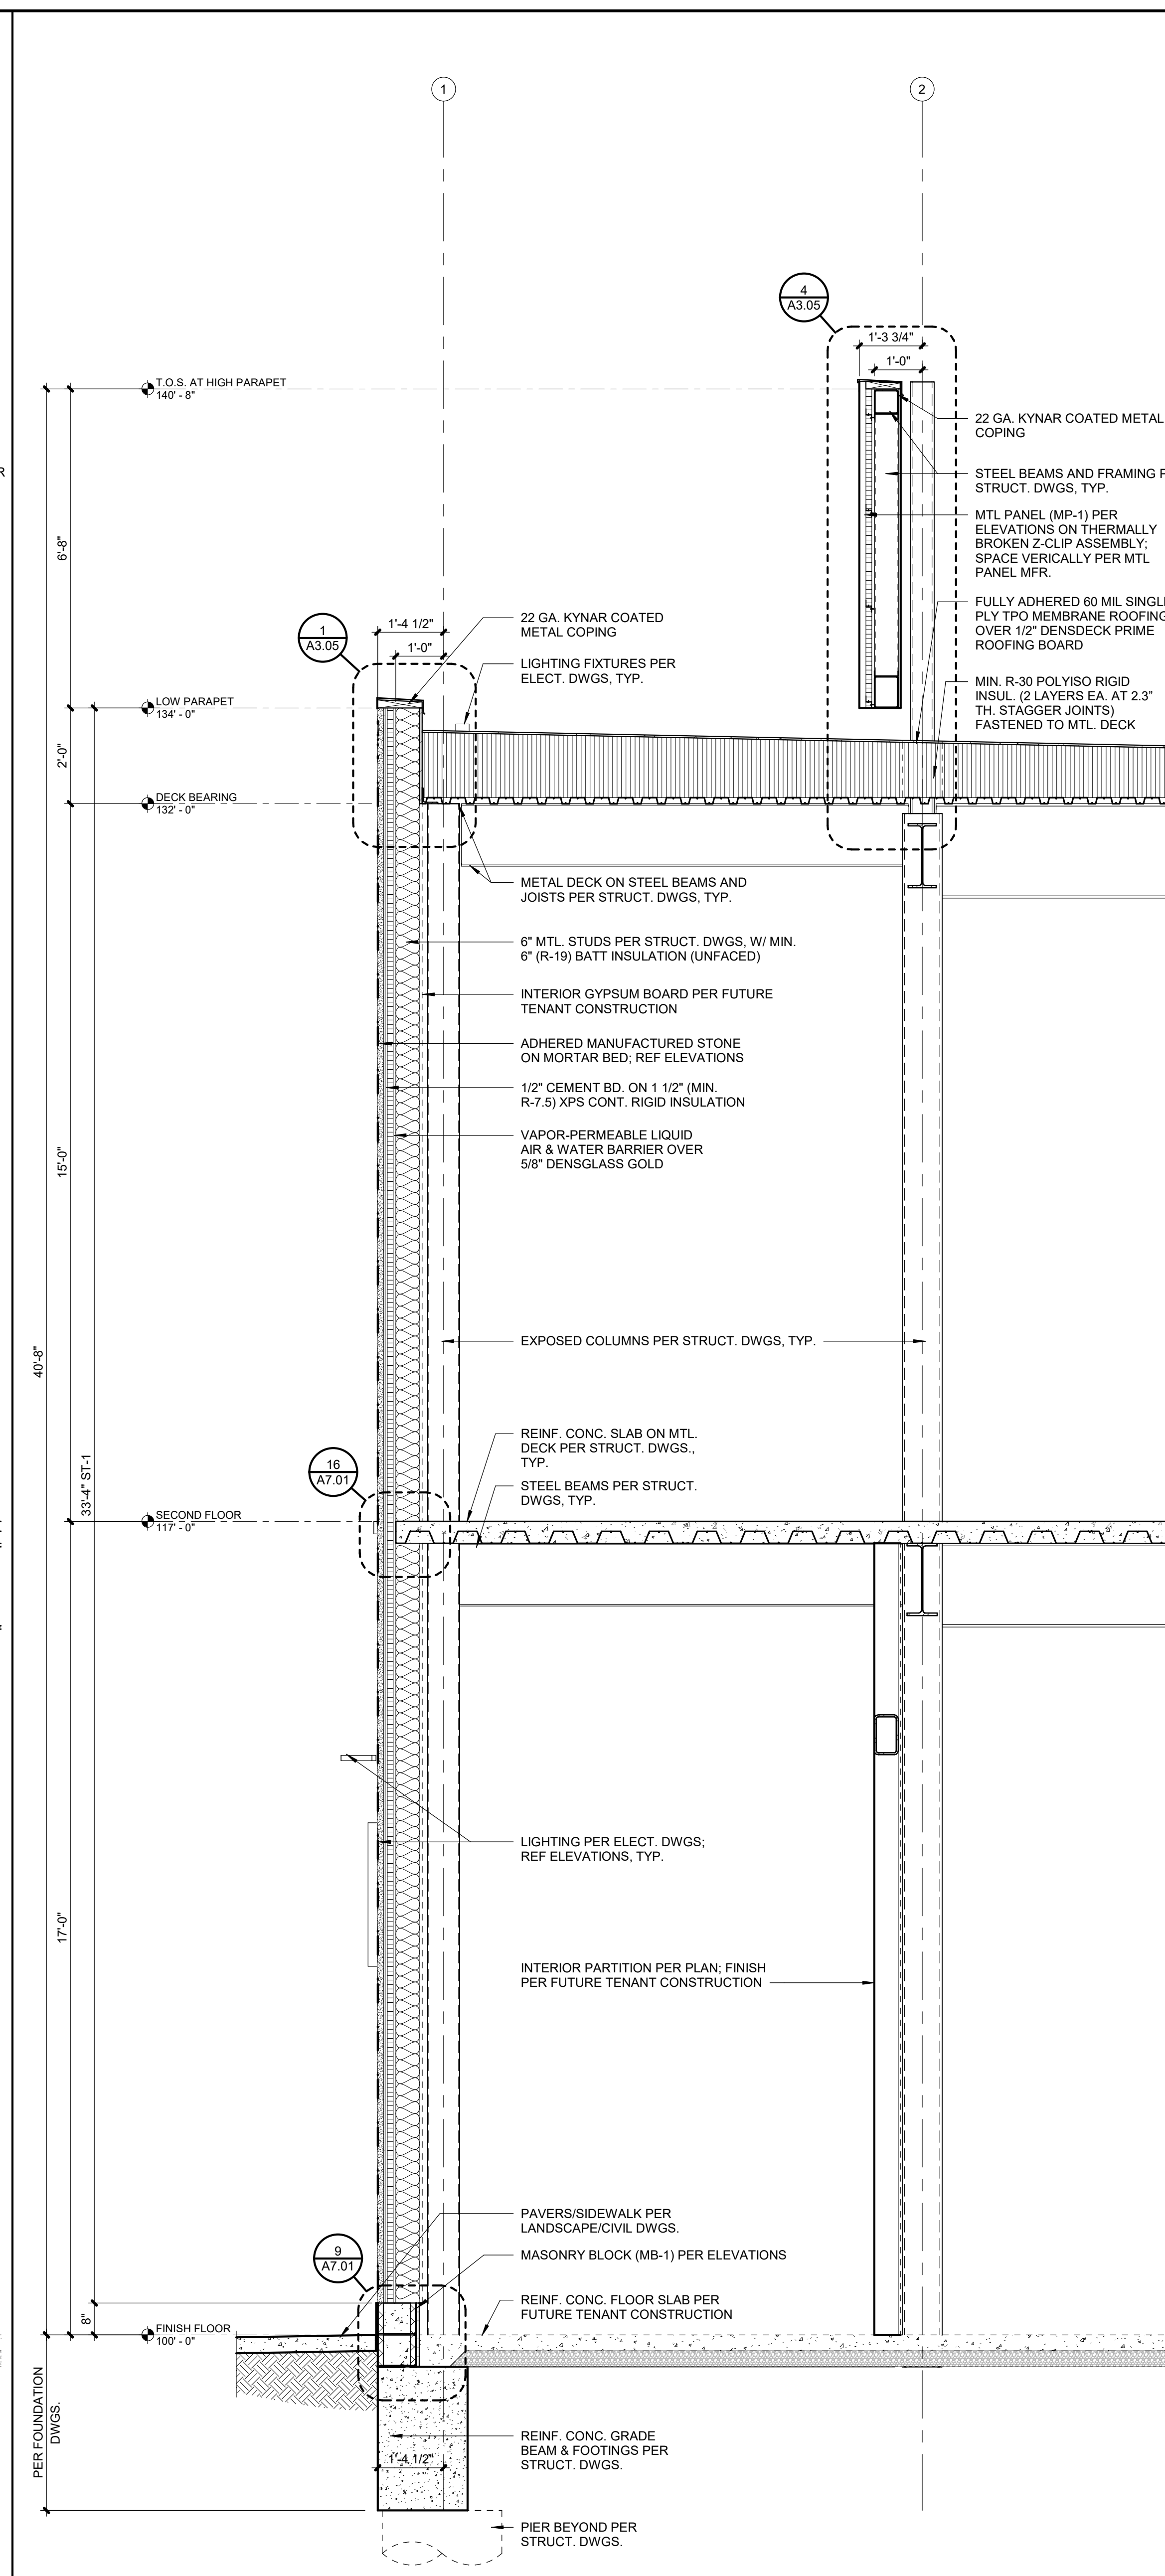


1 WALL SECTION

A5.07 SCALE: 1/2" = 1'-0"

C:\Users\jessica\Documents\Paragon Star\_Bldg2\Lot9\_R21-Central\_JessicaWilliams.com.rvt

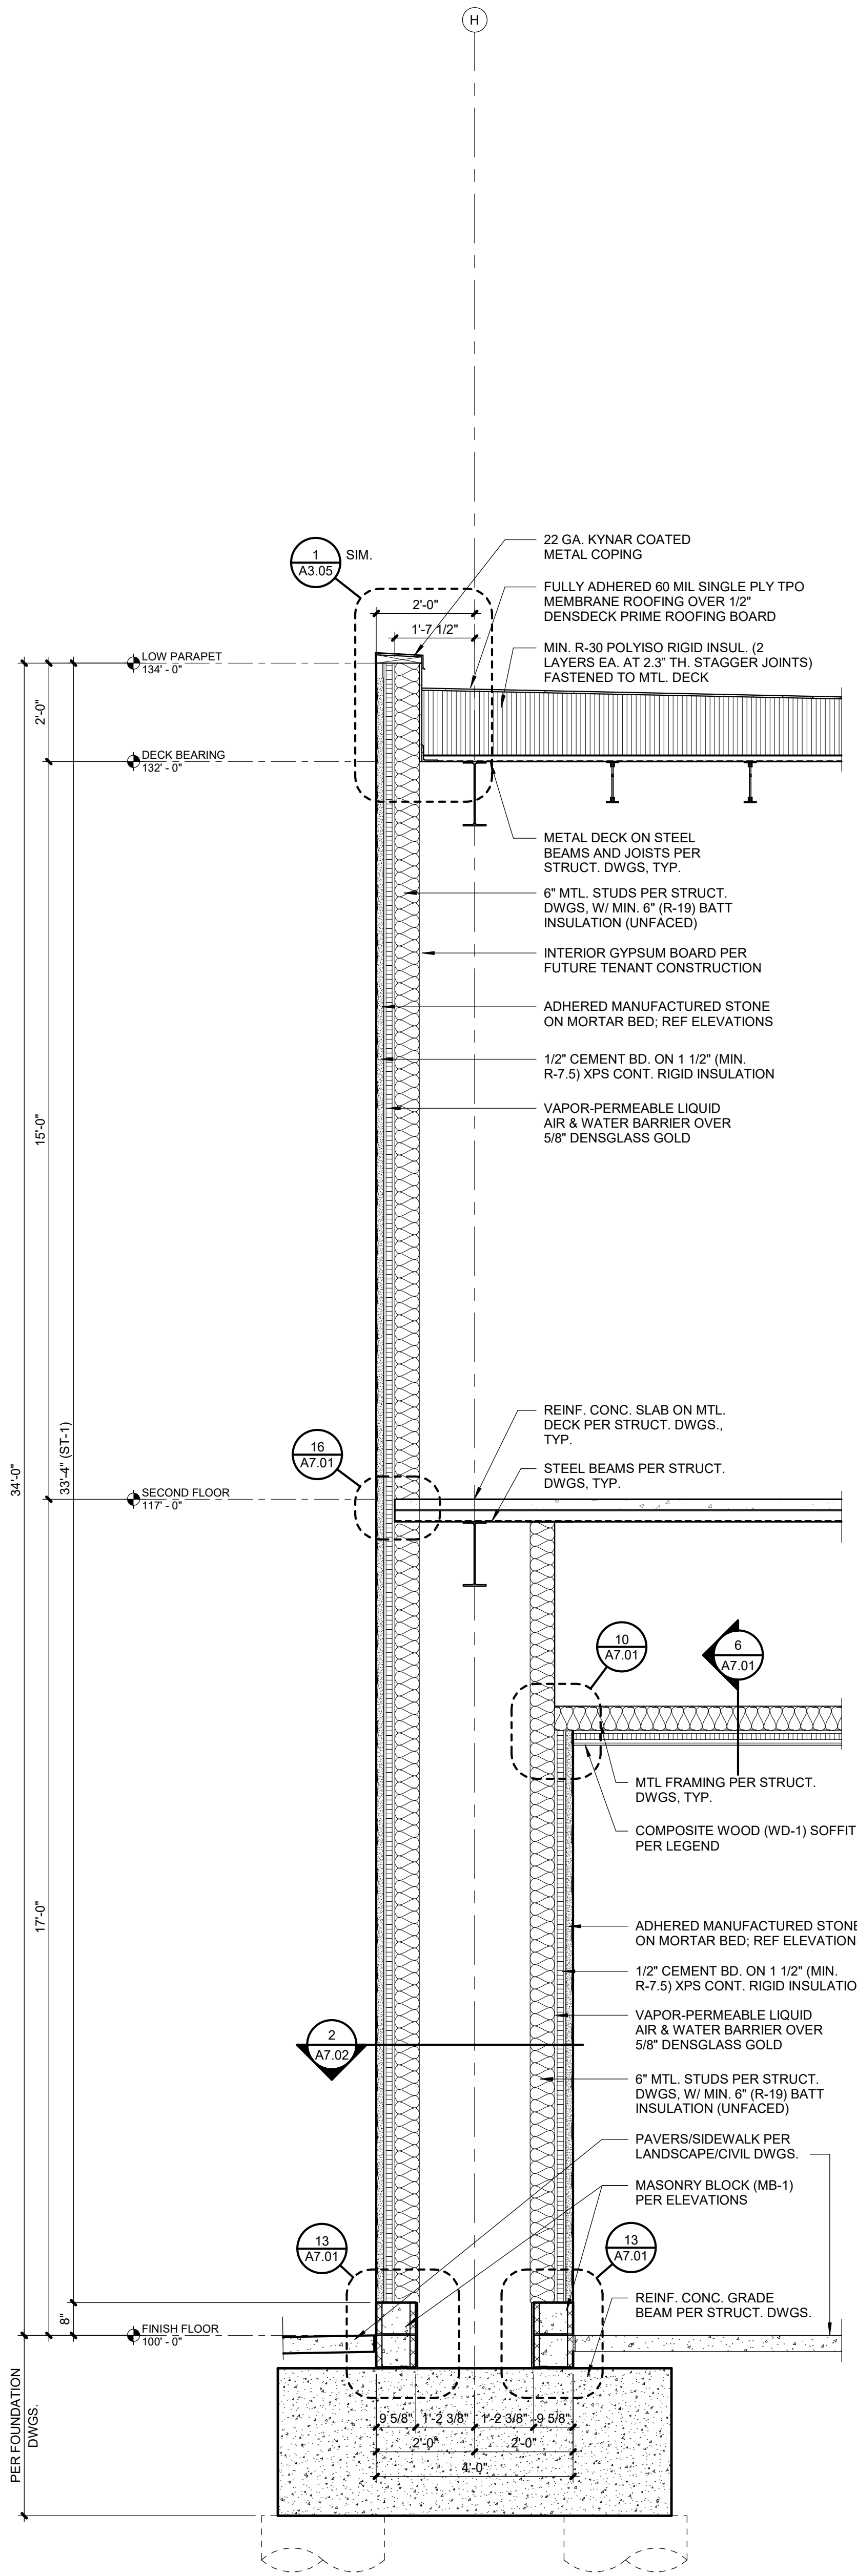


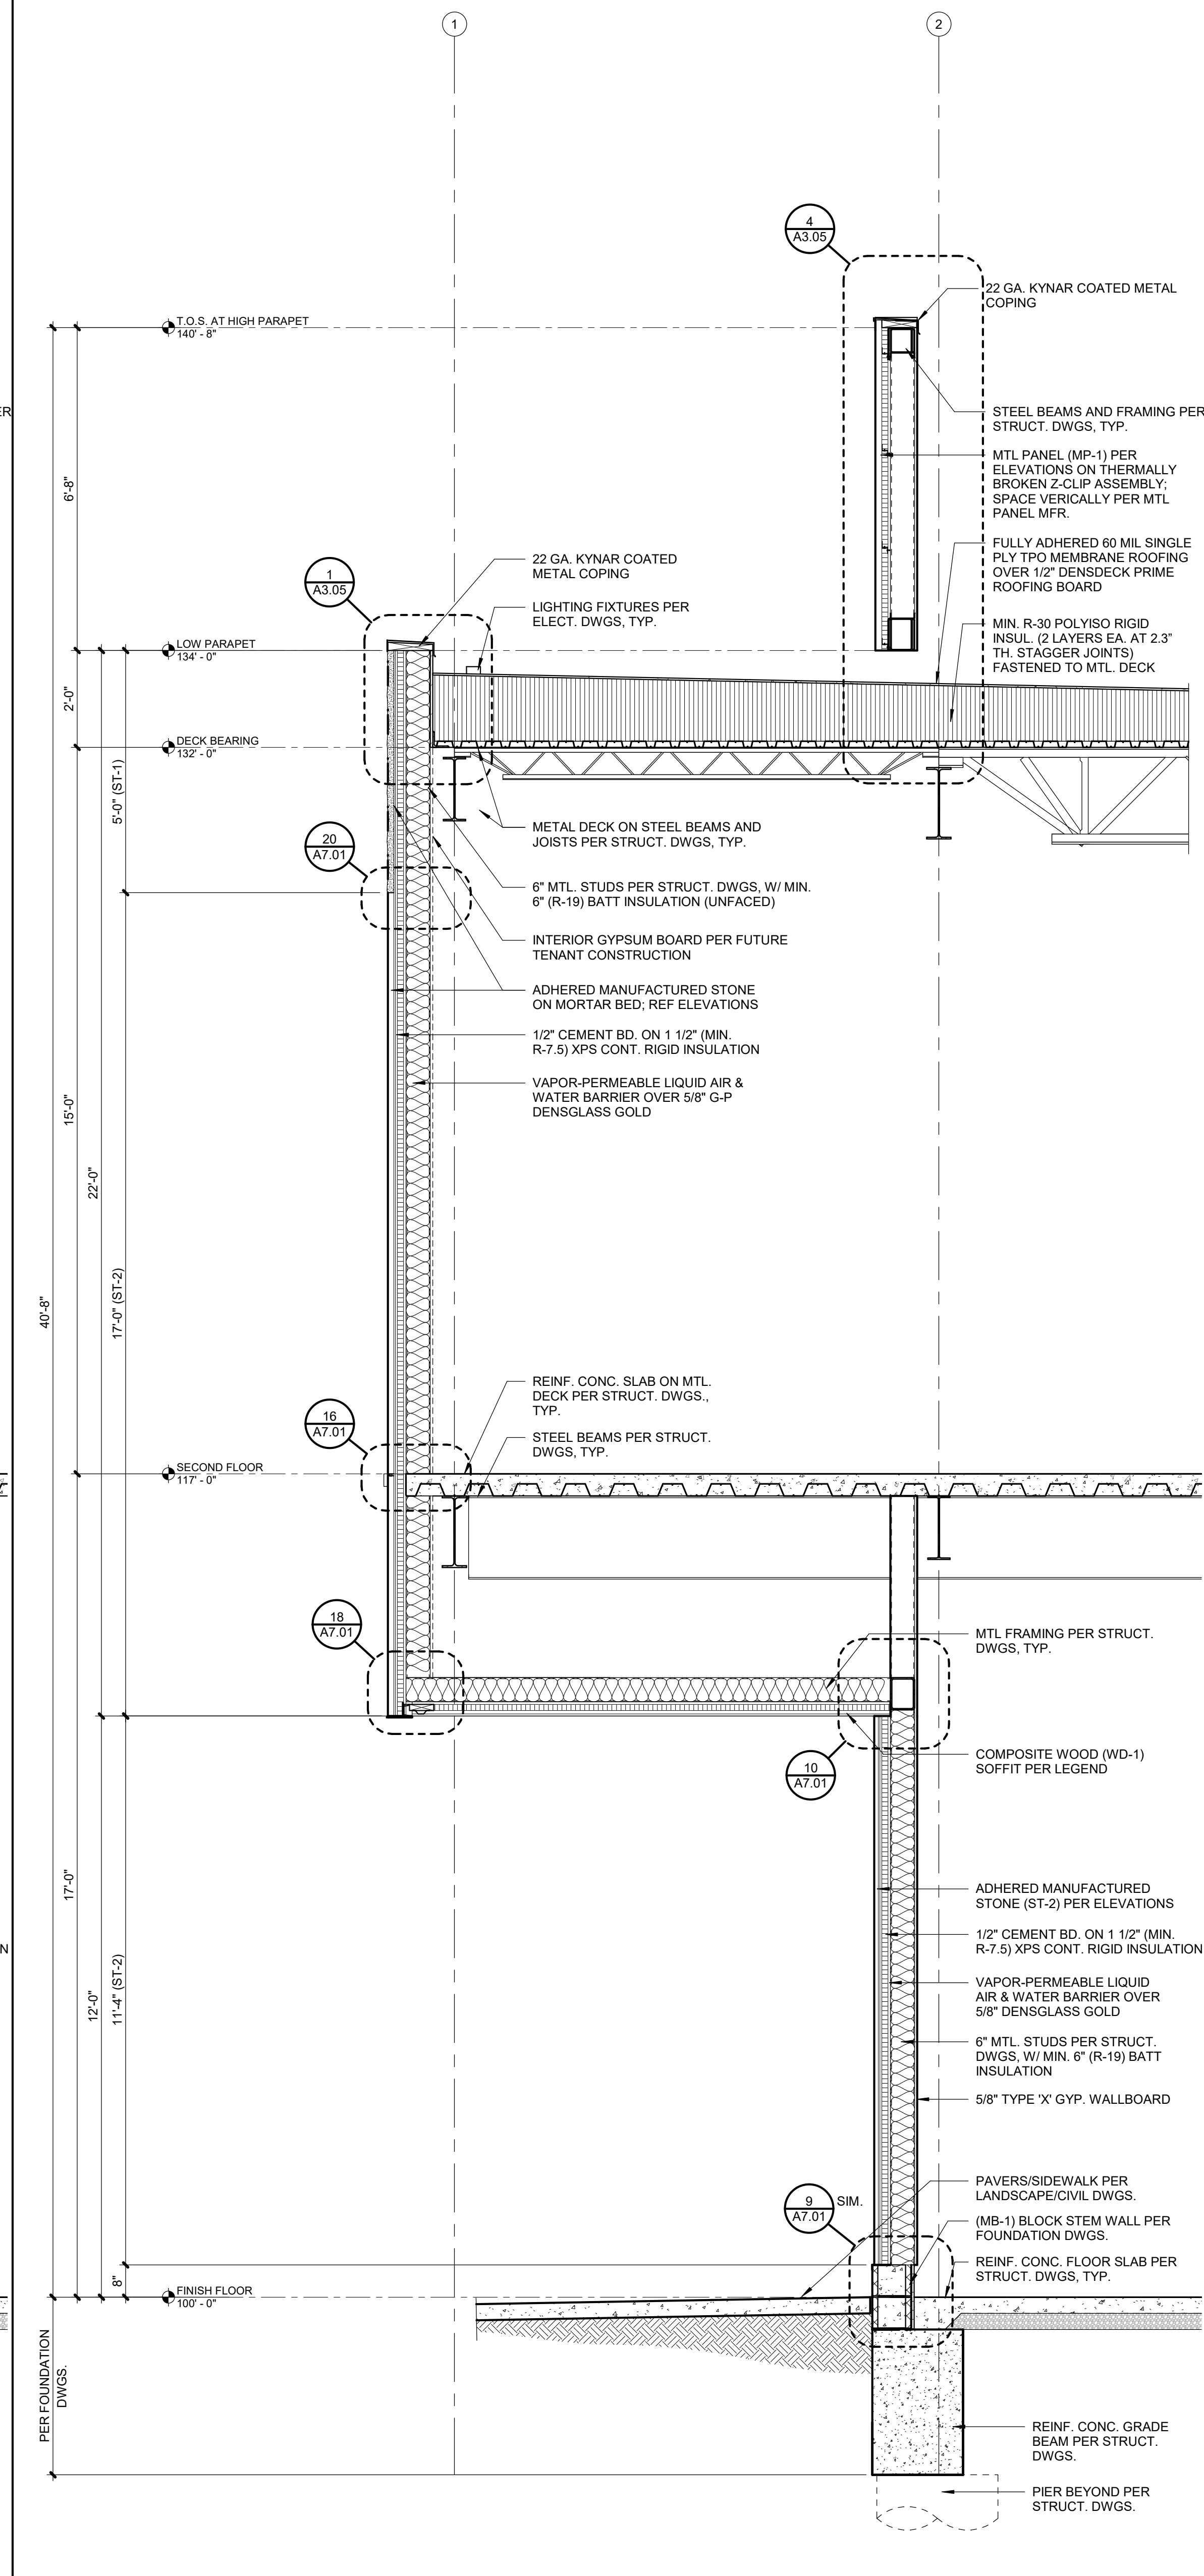

1	WALL SECTION
A5.09	SCALE : 1/2" = 1'-0"

REVISIONS		
No.	Date	Description
2	3.27.22	ADDENDUM 2
4	01.20.23	ASH-01
5	02.01.23	ASH-02

REGISTRATION

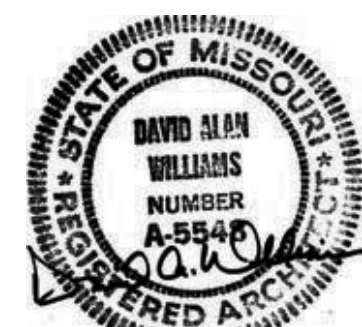

05.06.22

PROJECT TEAM

ARCHITECT	FINKLE+WILLIAMS ARCHITECTURE
CIVIL	GBA
LANDSCAPE	LAND 3
FOUNDATIONS	BSE STRUCTURAL ENGINEERS
STRUCTURAL	BSE STRUCTURAL ENGINEERS
PLUMBING	HENDERSON ENGINEERS
MECHANICAL	HENDERSON ENGINEERS
ELECTRICAL	HENDERSON ENGINEERS
FIRE PROTECTION	HENDERSON ENGINEERS
CONTRACTOR	FOGEL-ANDERSON



FINKLE + WILLIAMS  
ARCHITECTURE


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LENEXA, KANSAS 66219  
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SHEET TITLE

VERTICAL  
CIRCULATION


SHEET NUMBER

A6.01

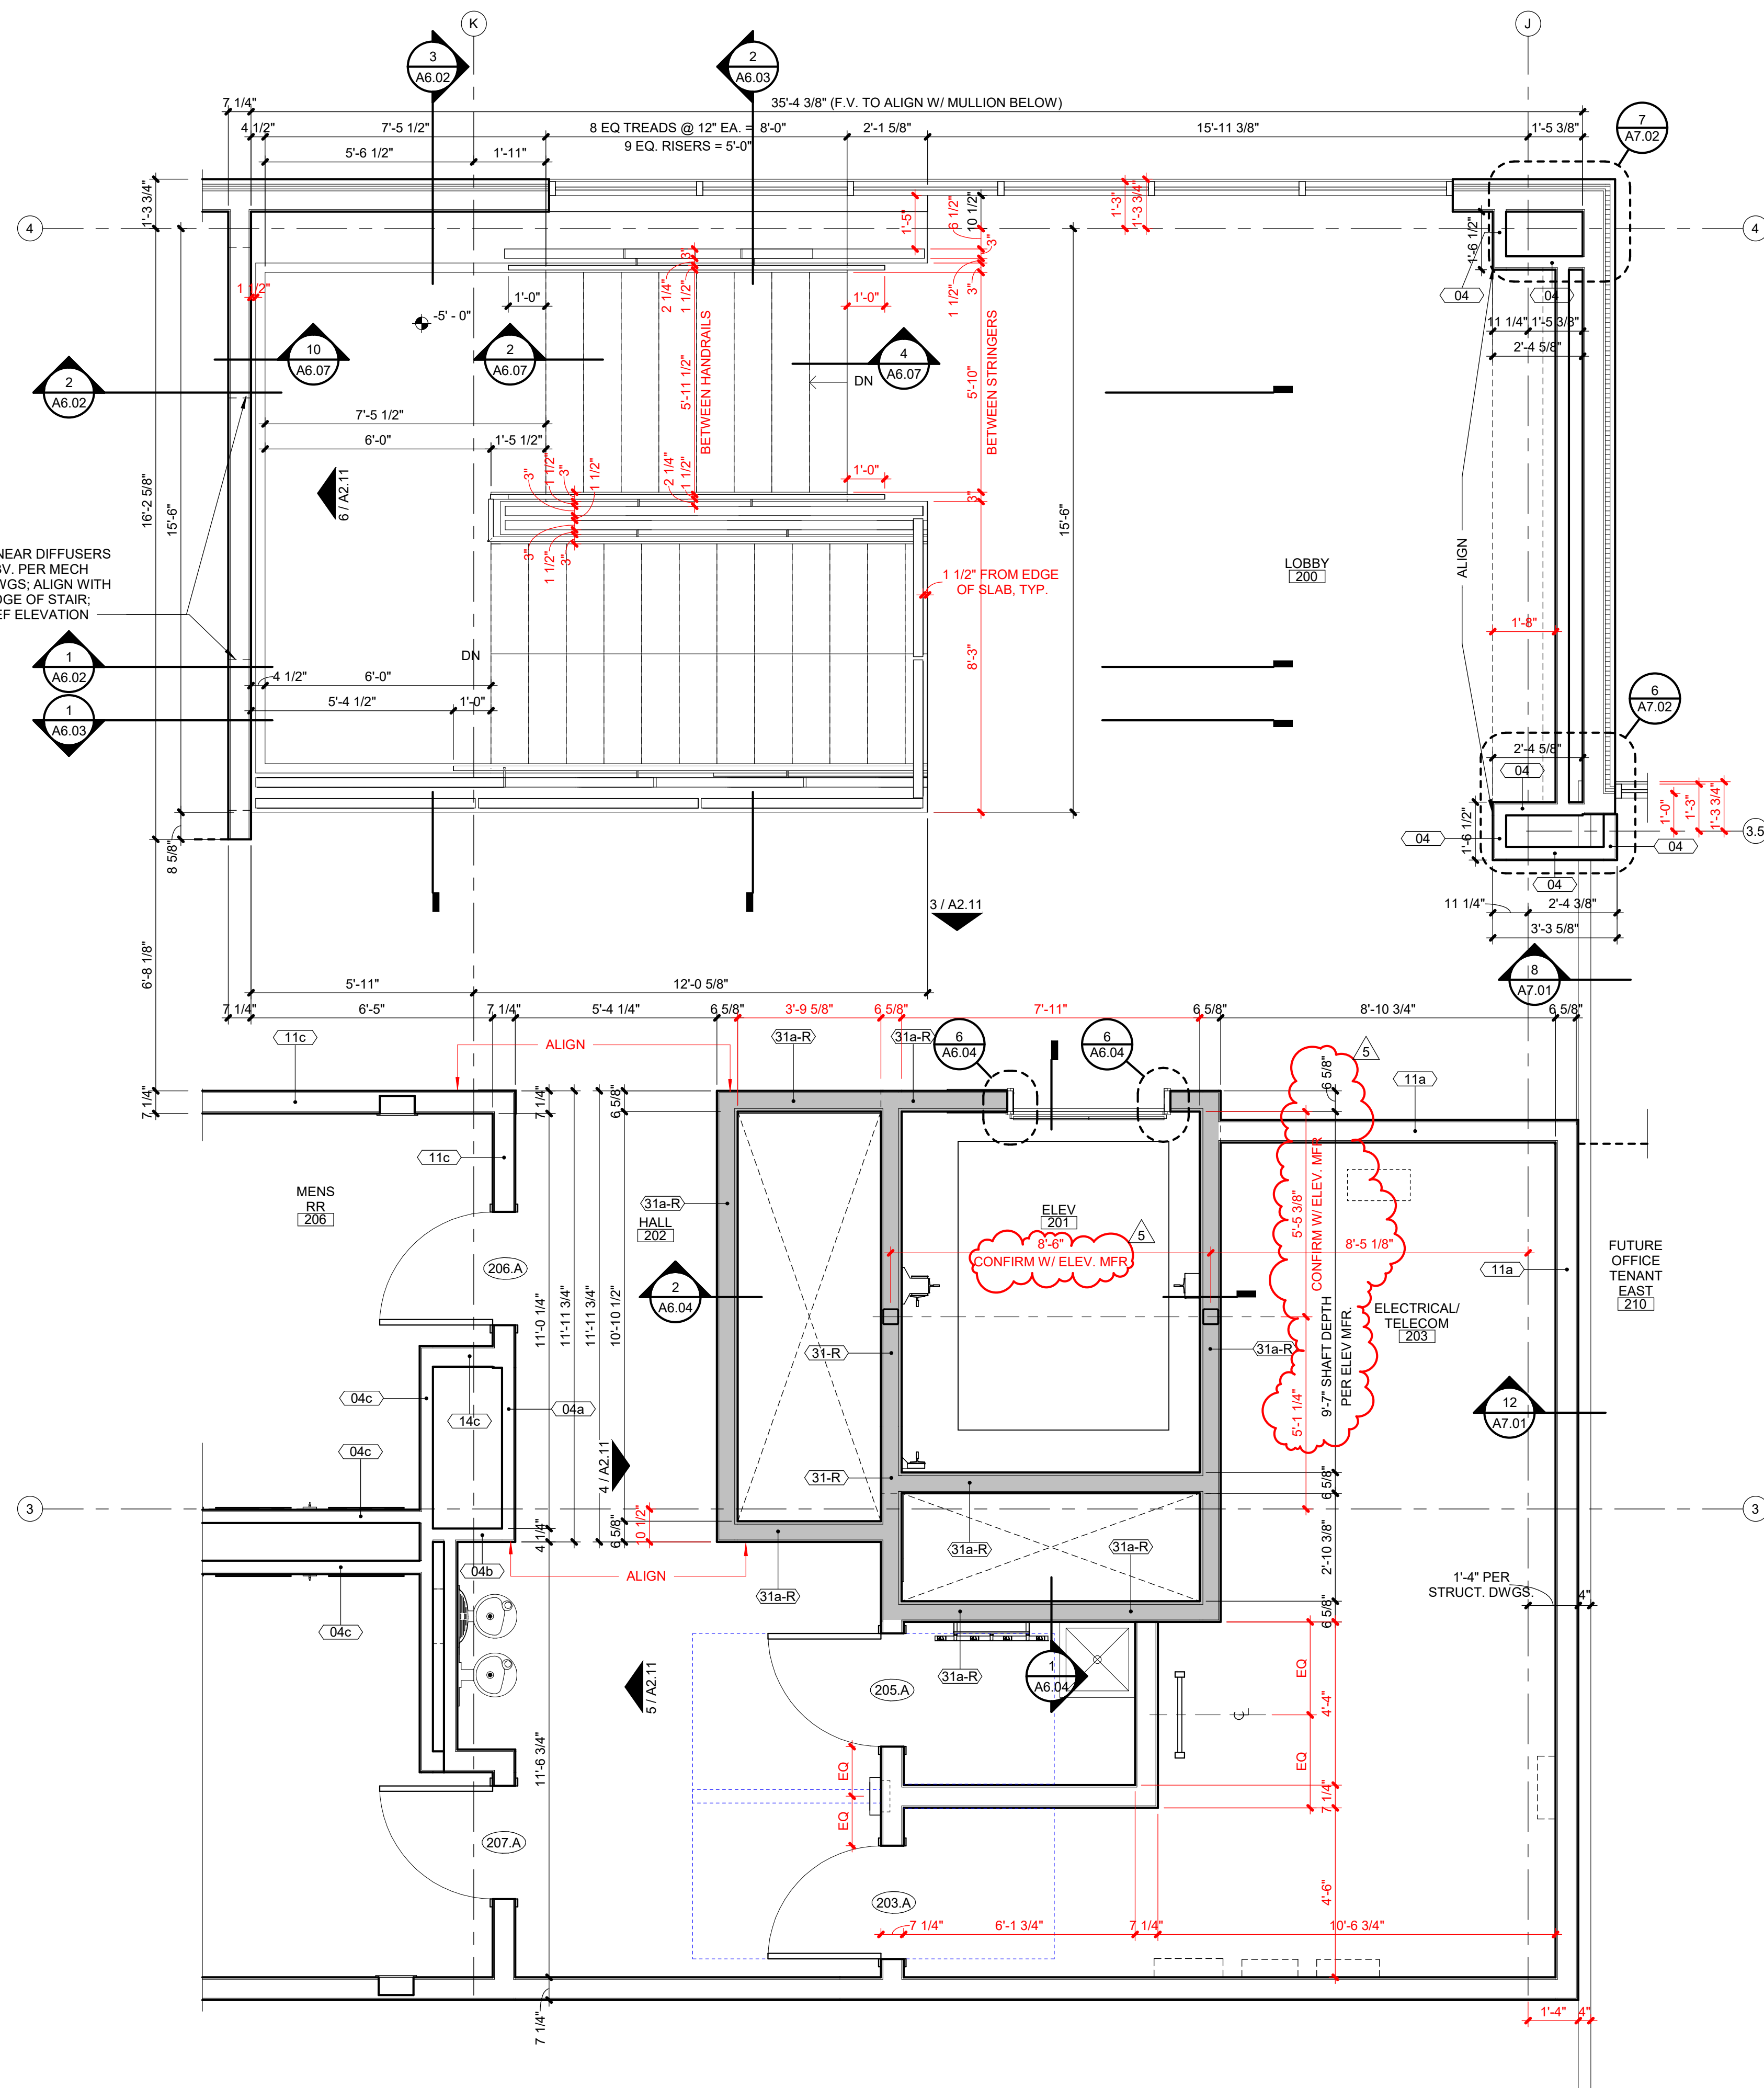


2 ENLARGED STAIR PLAN - SECOND LEVEL

A6.01 SCALE: 3/8\"/>

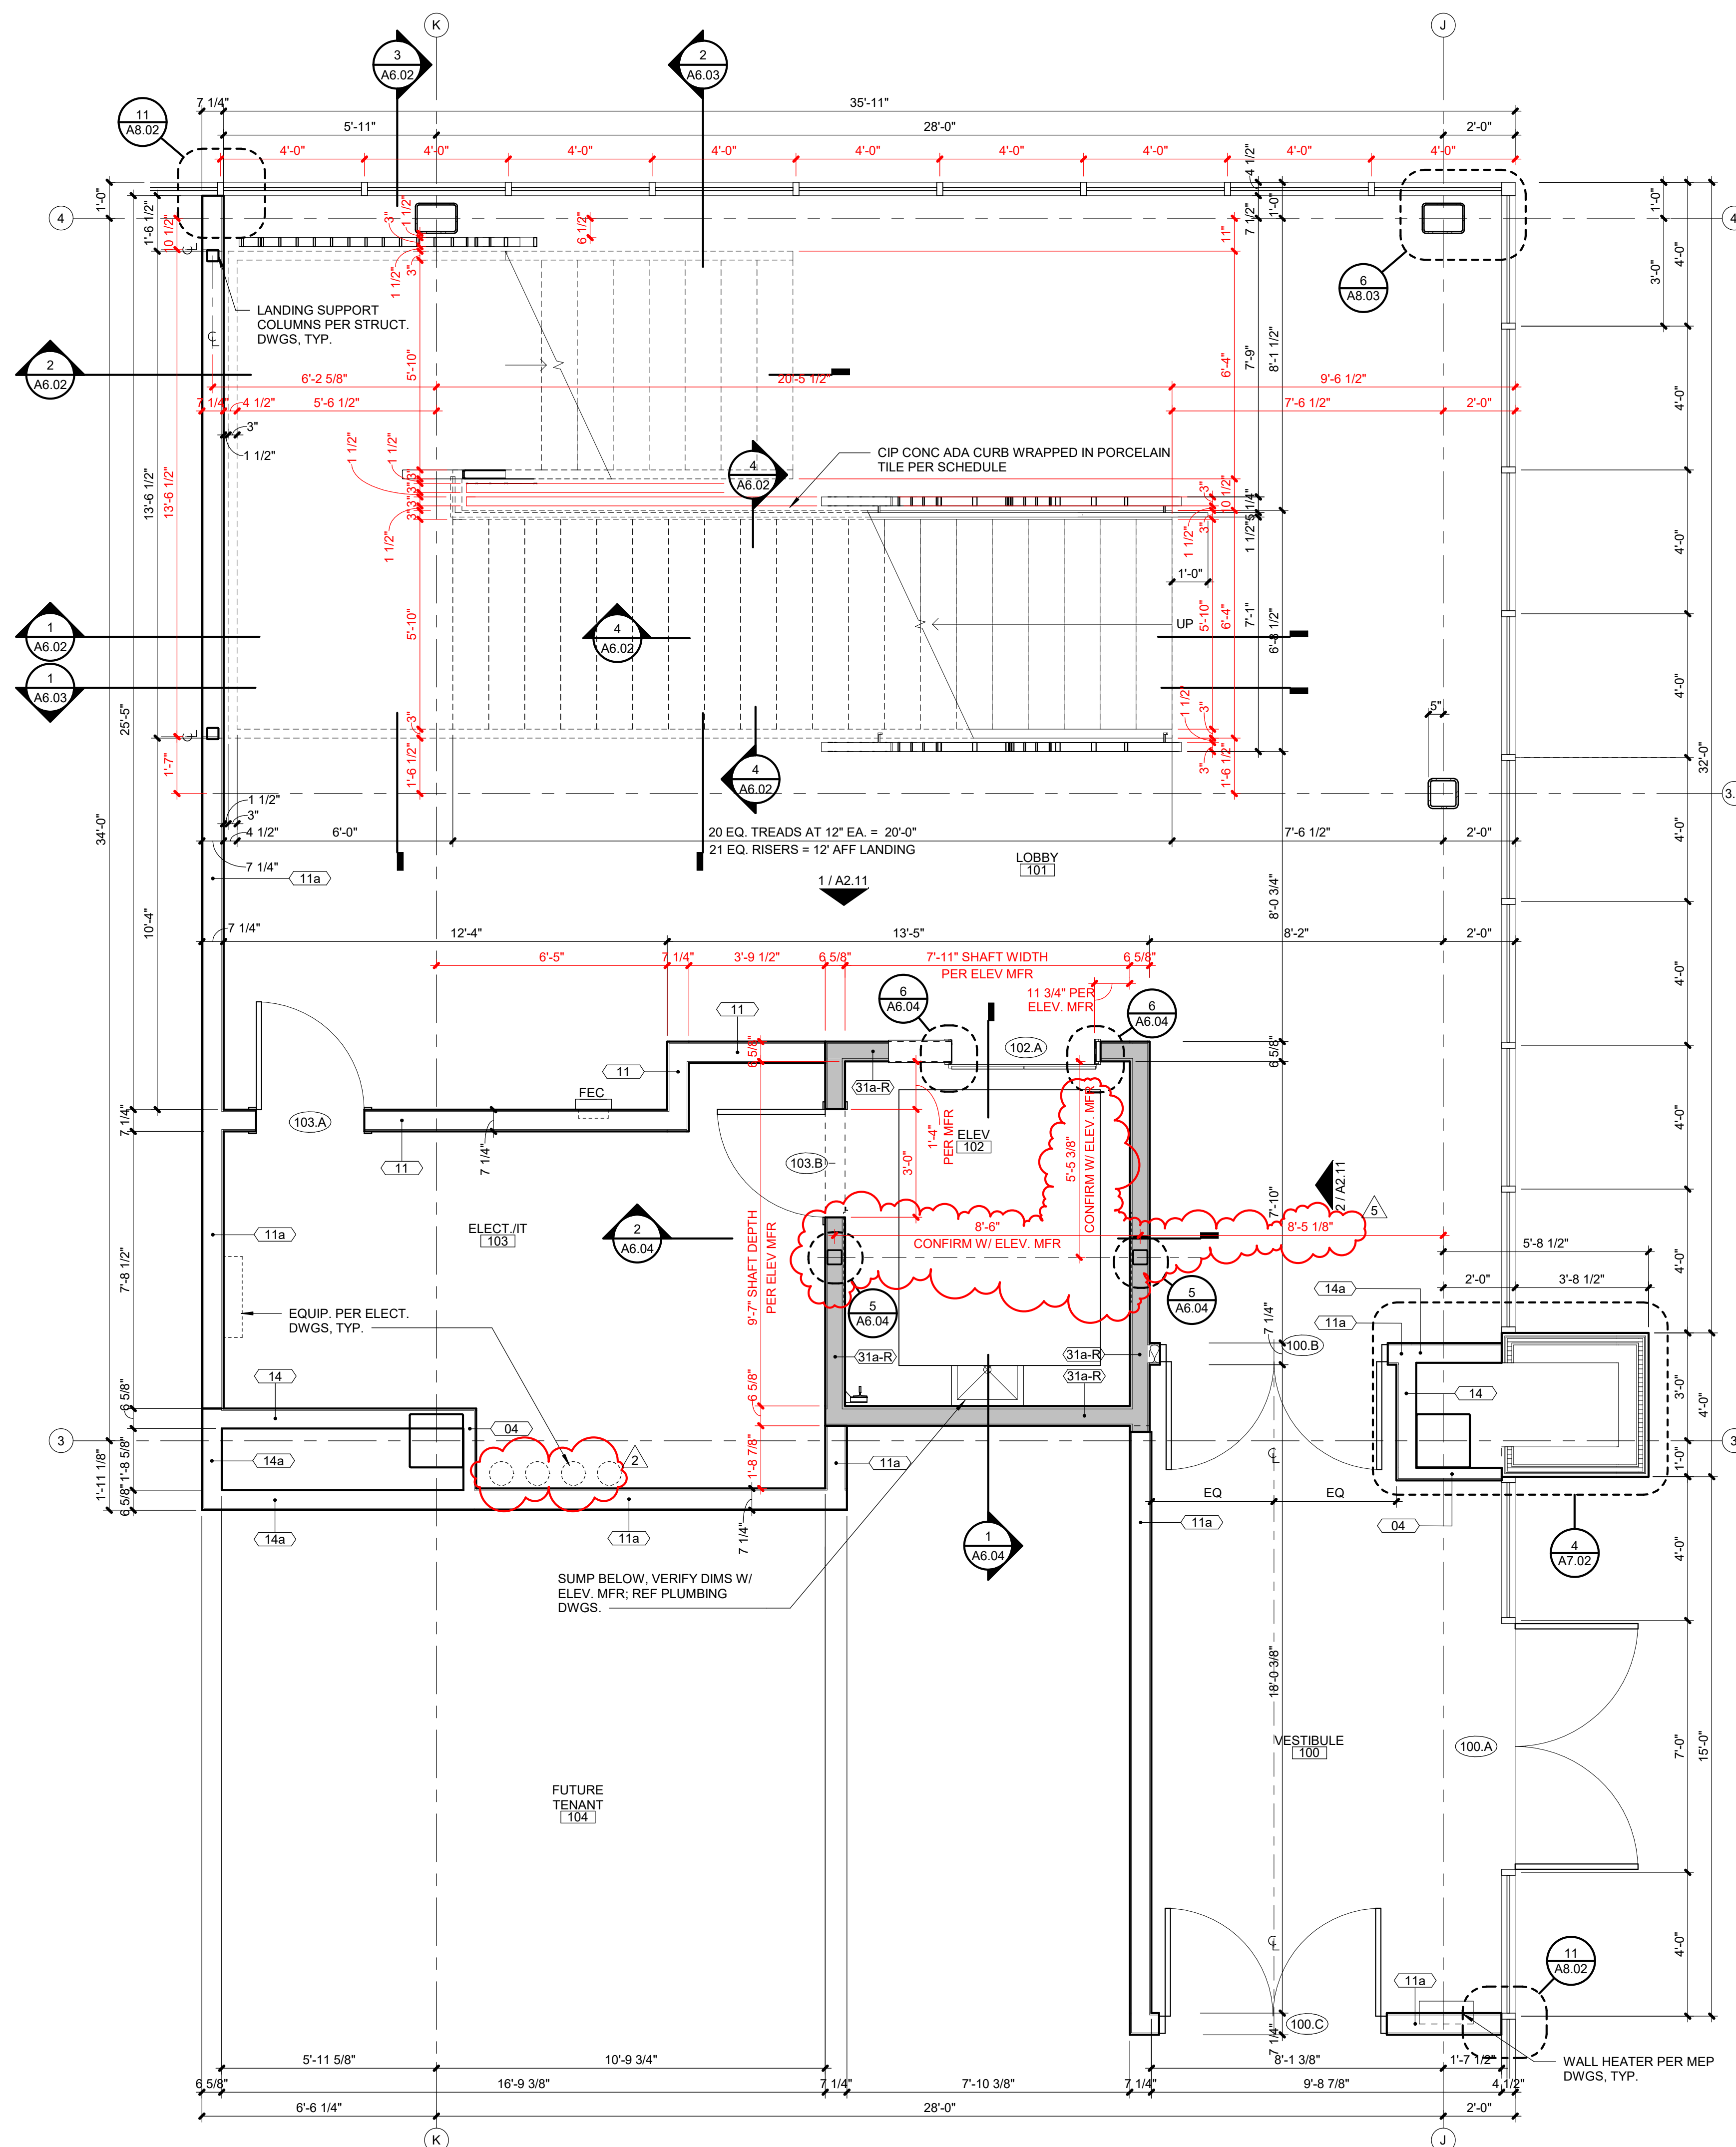


1 ENLARGED STAIR PLAN - FIRST LEVEL

A6.01 SCALE: 3/8\"/>

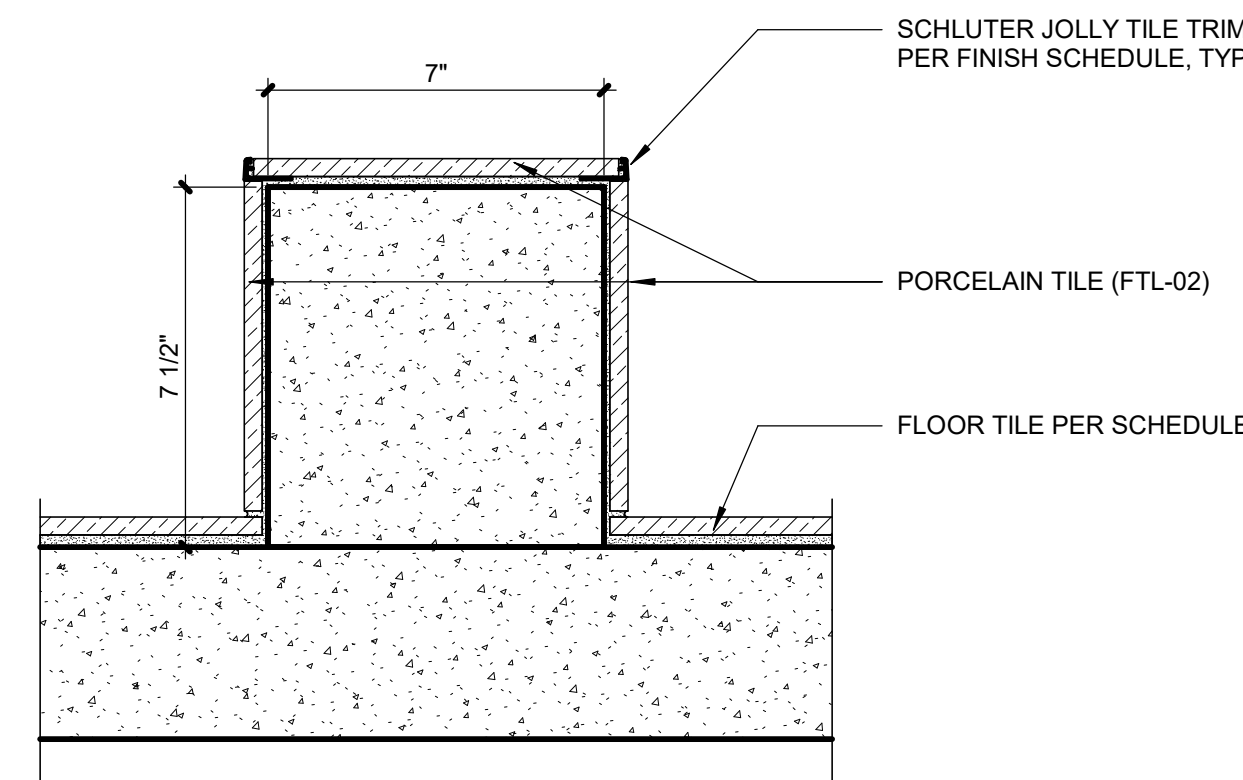


4 CURB DETAIL

A6.02 SCALE: 3" = 1'-0"

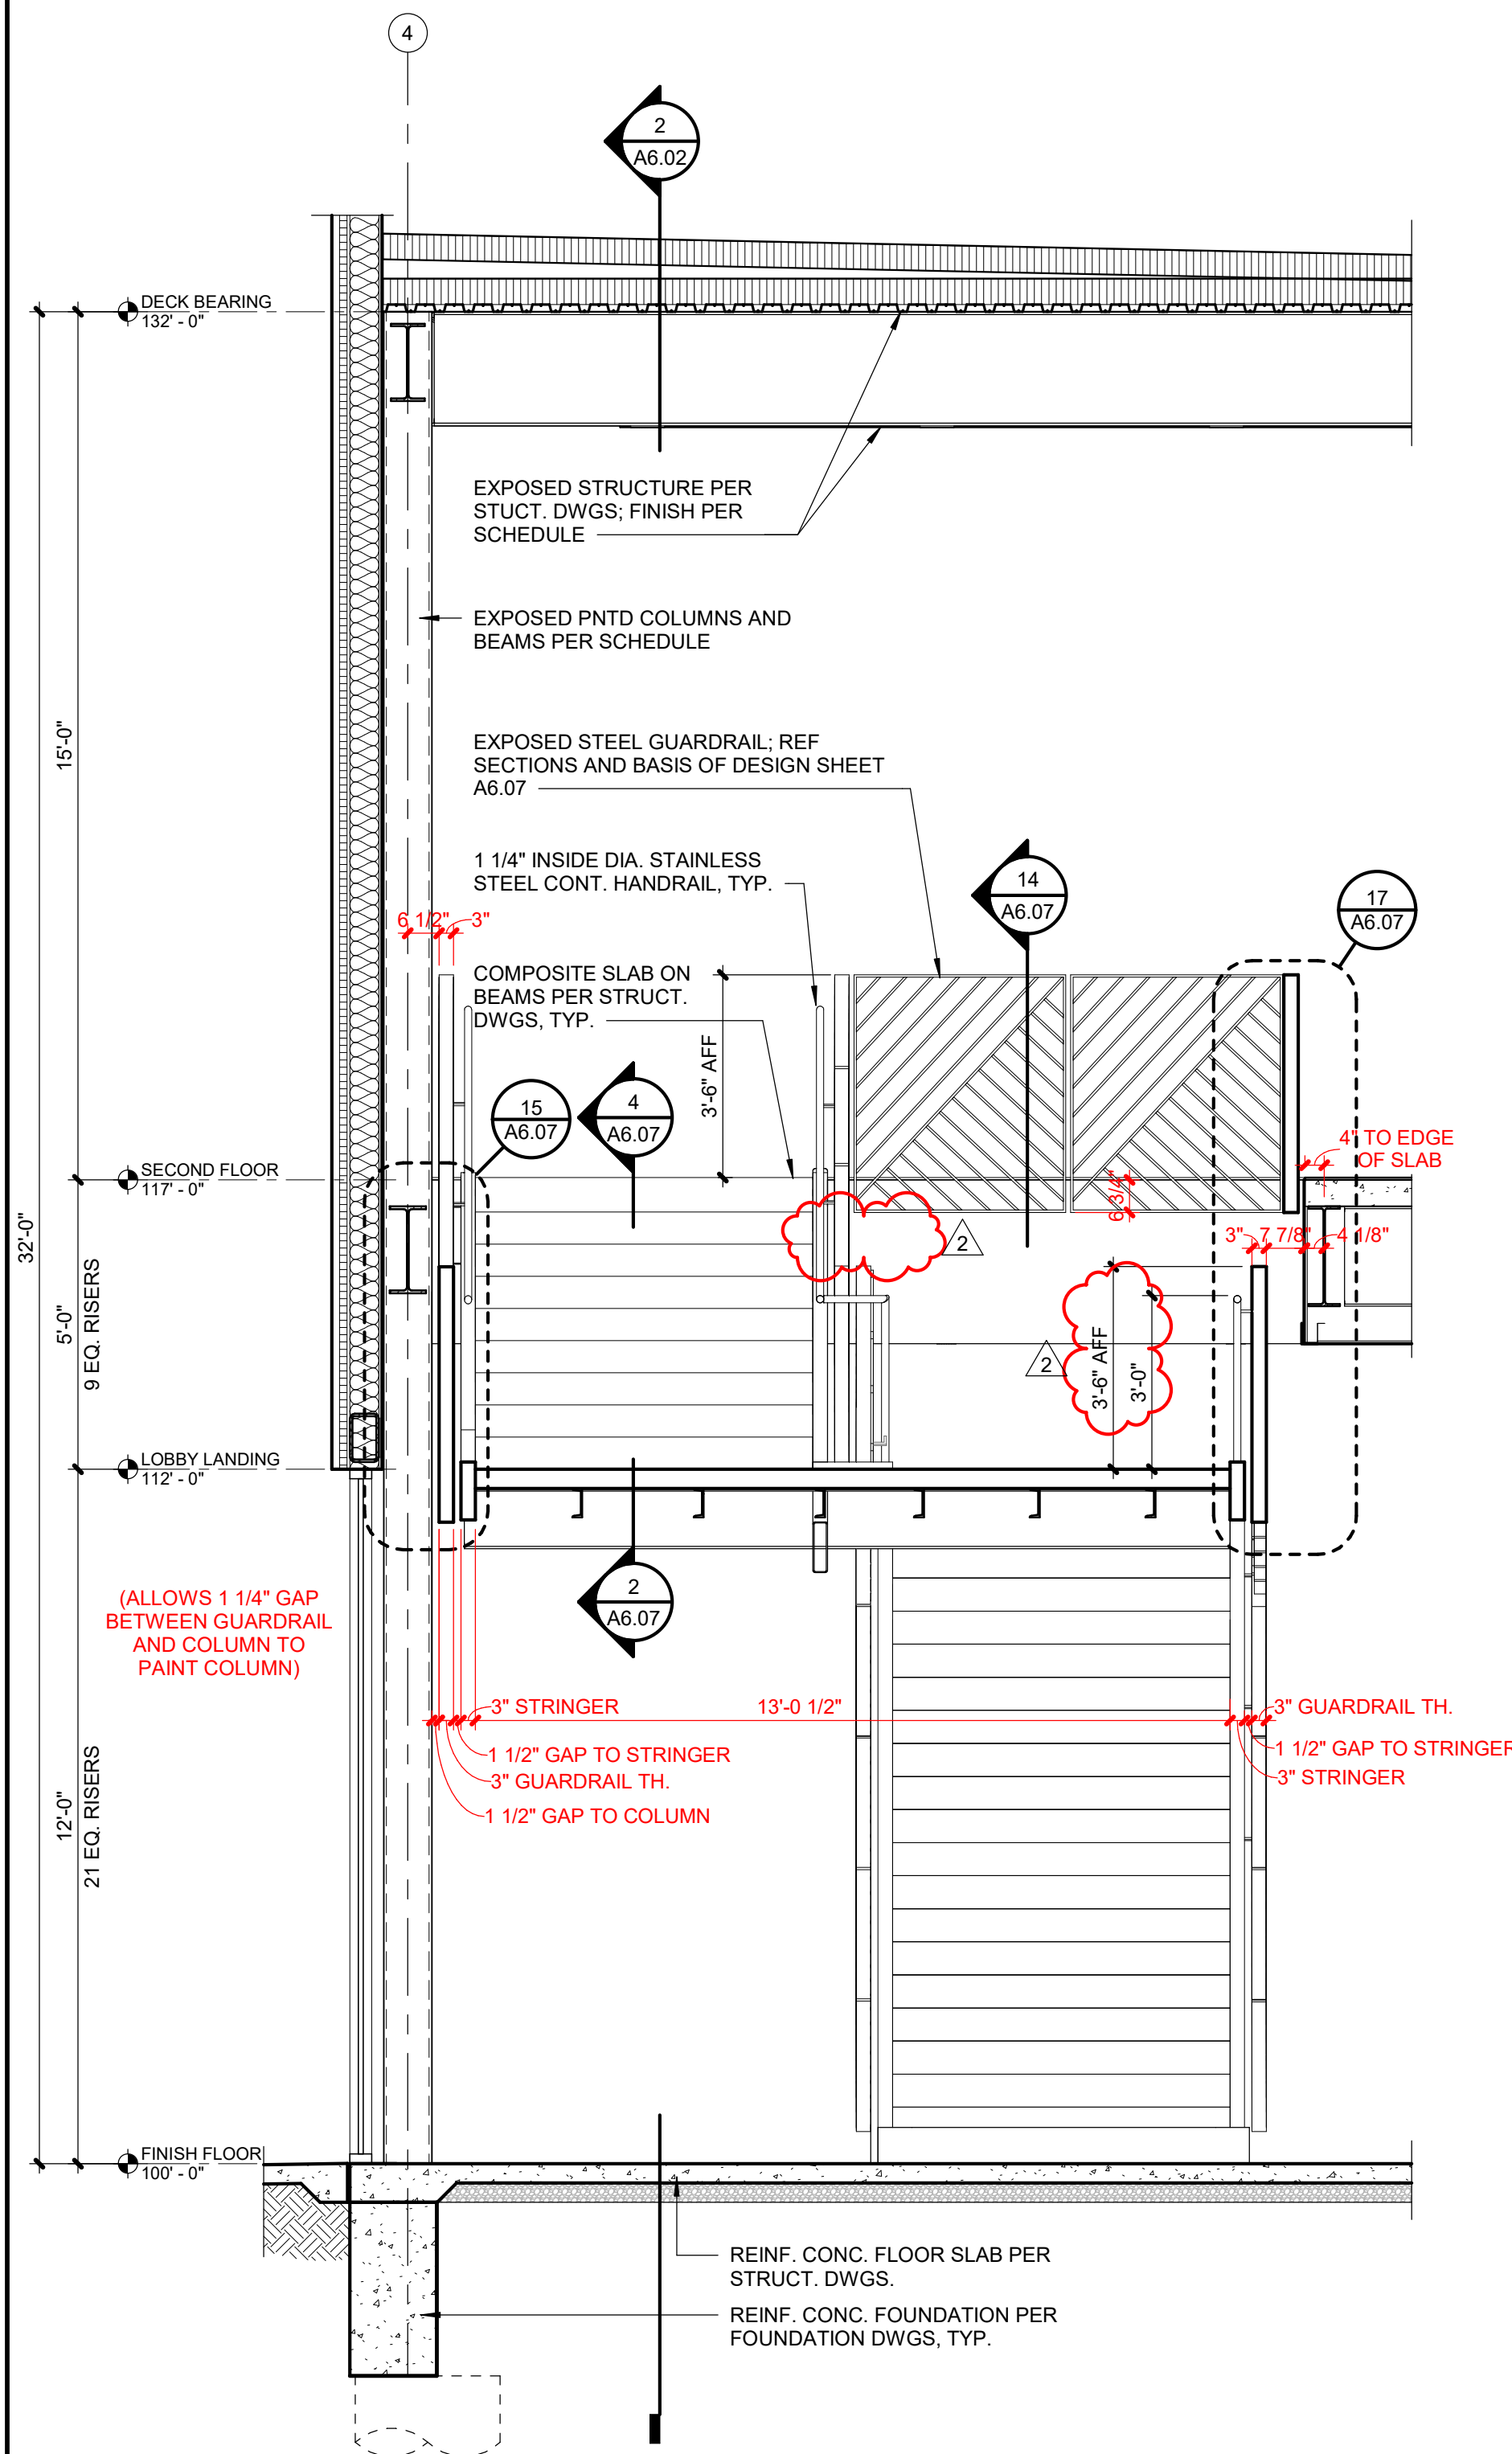


3 STAIR SECTION

A6.02 SCALE: 3/8" = 1'-0"

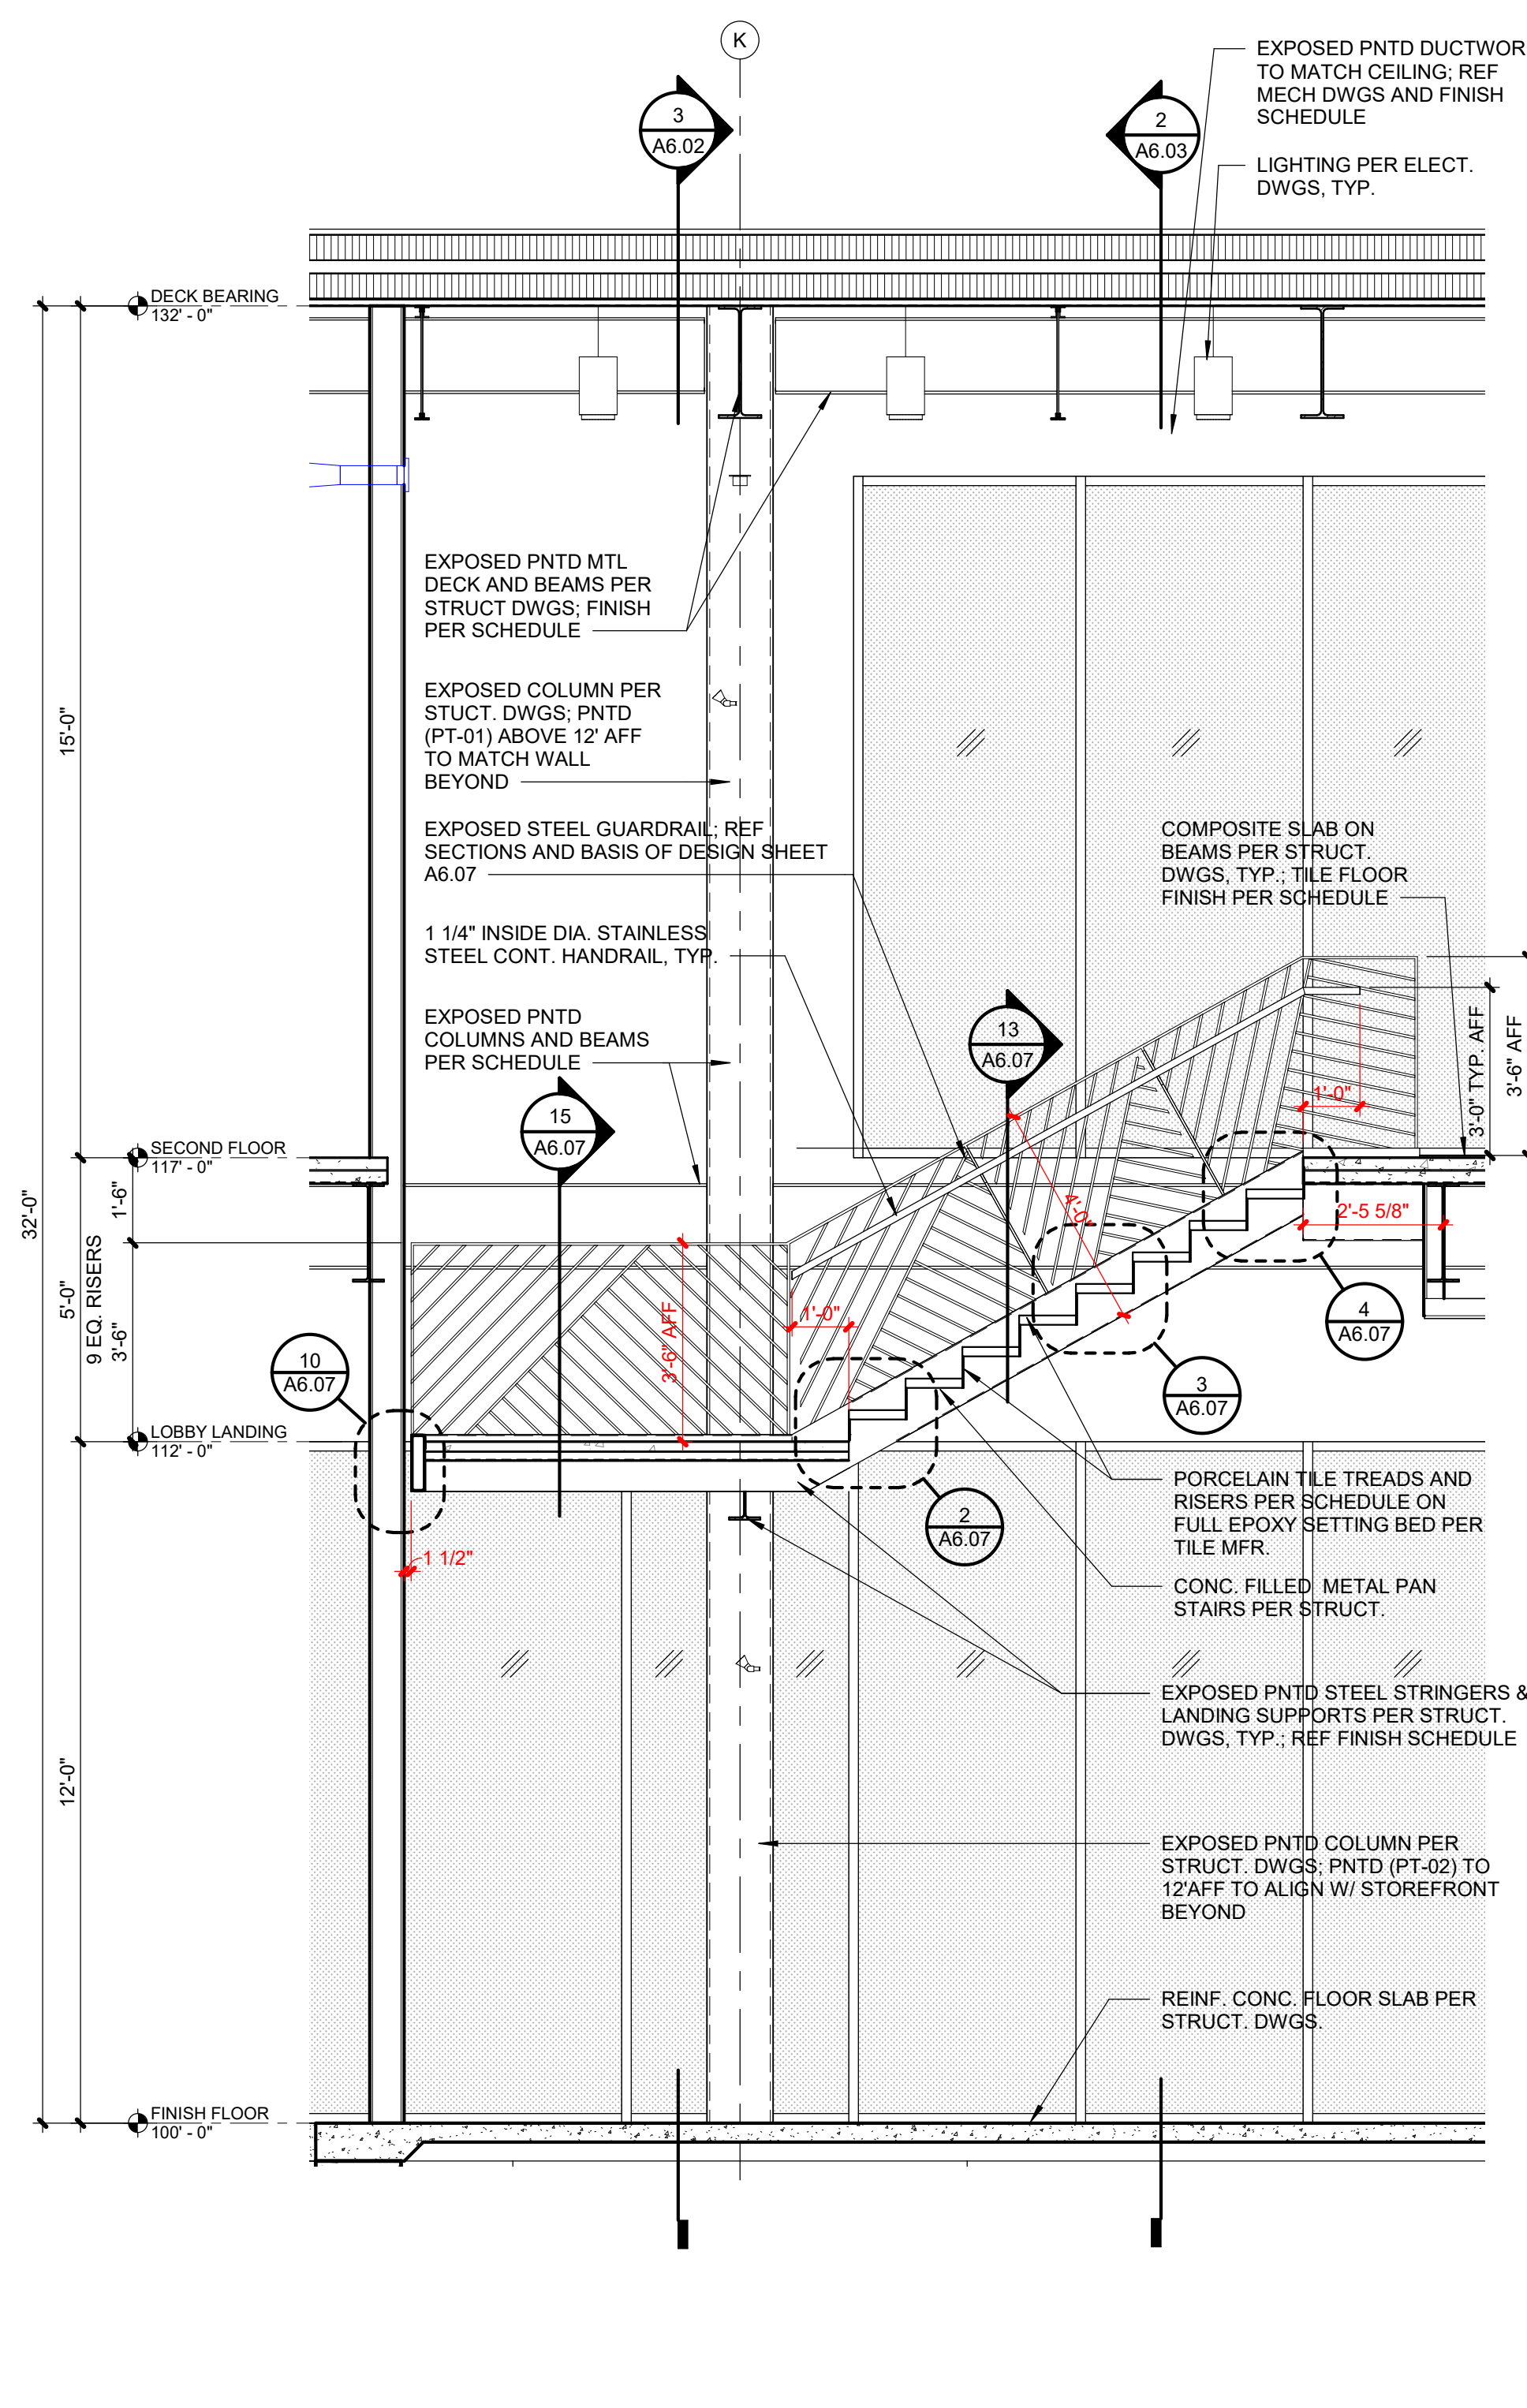

2 STAIR SECTION

A6.02 SCALE: 3/8" = 1'-0"


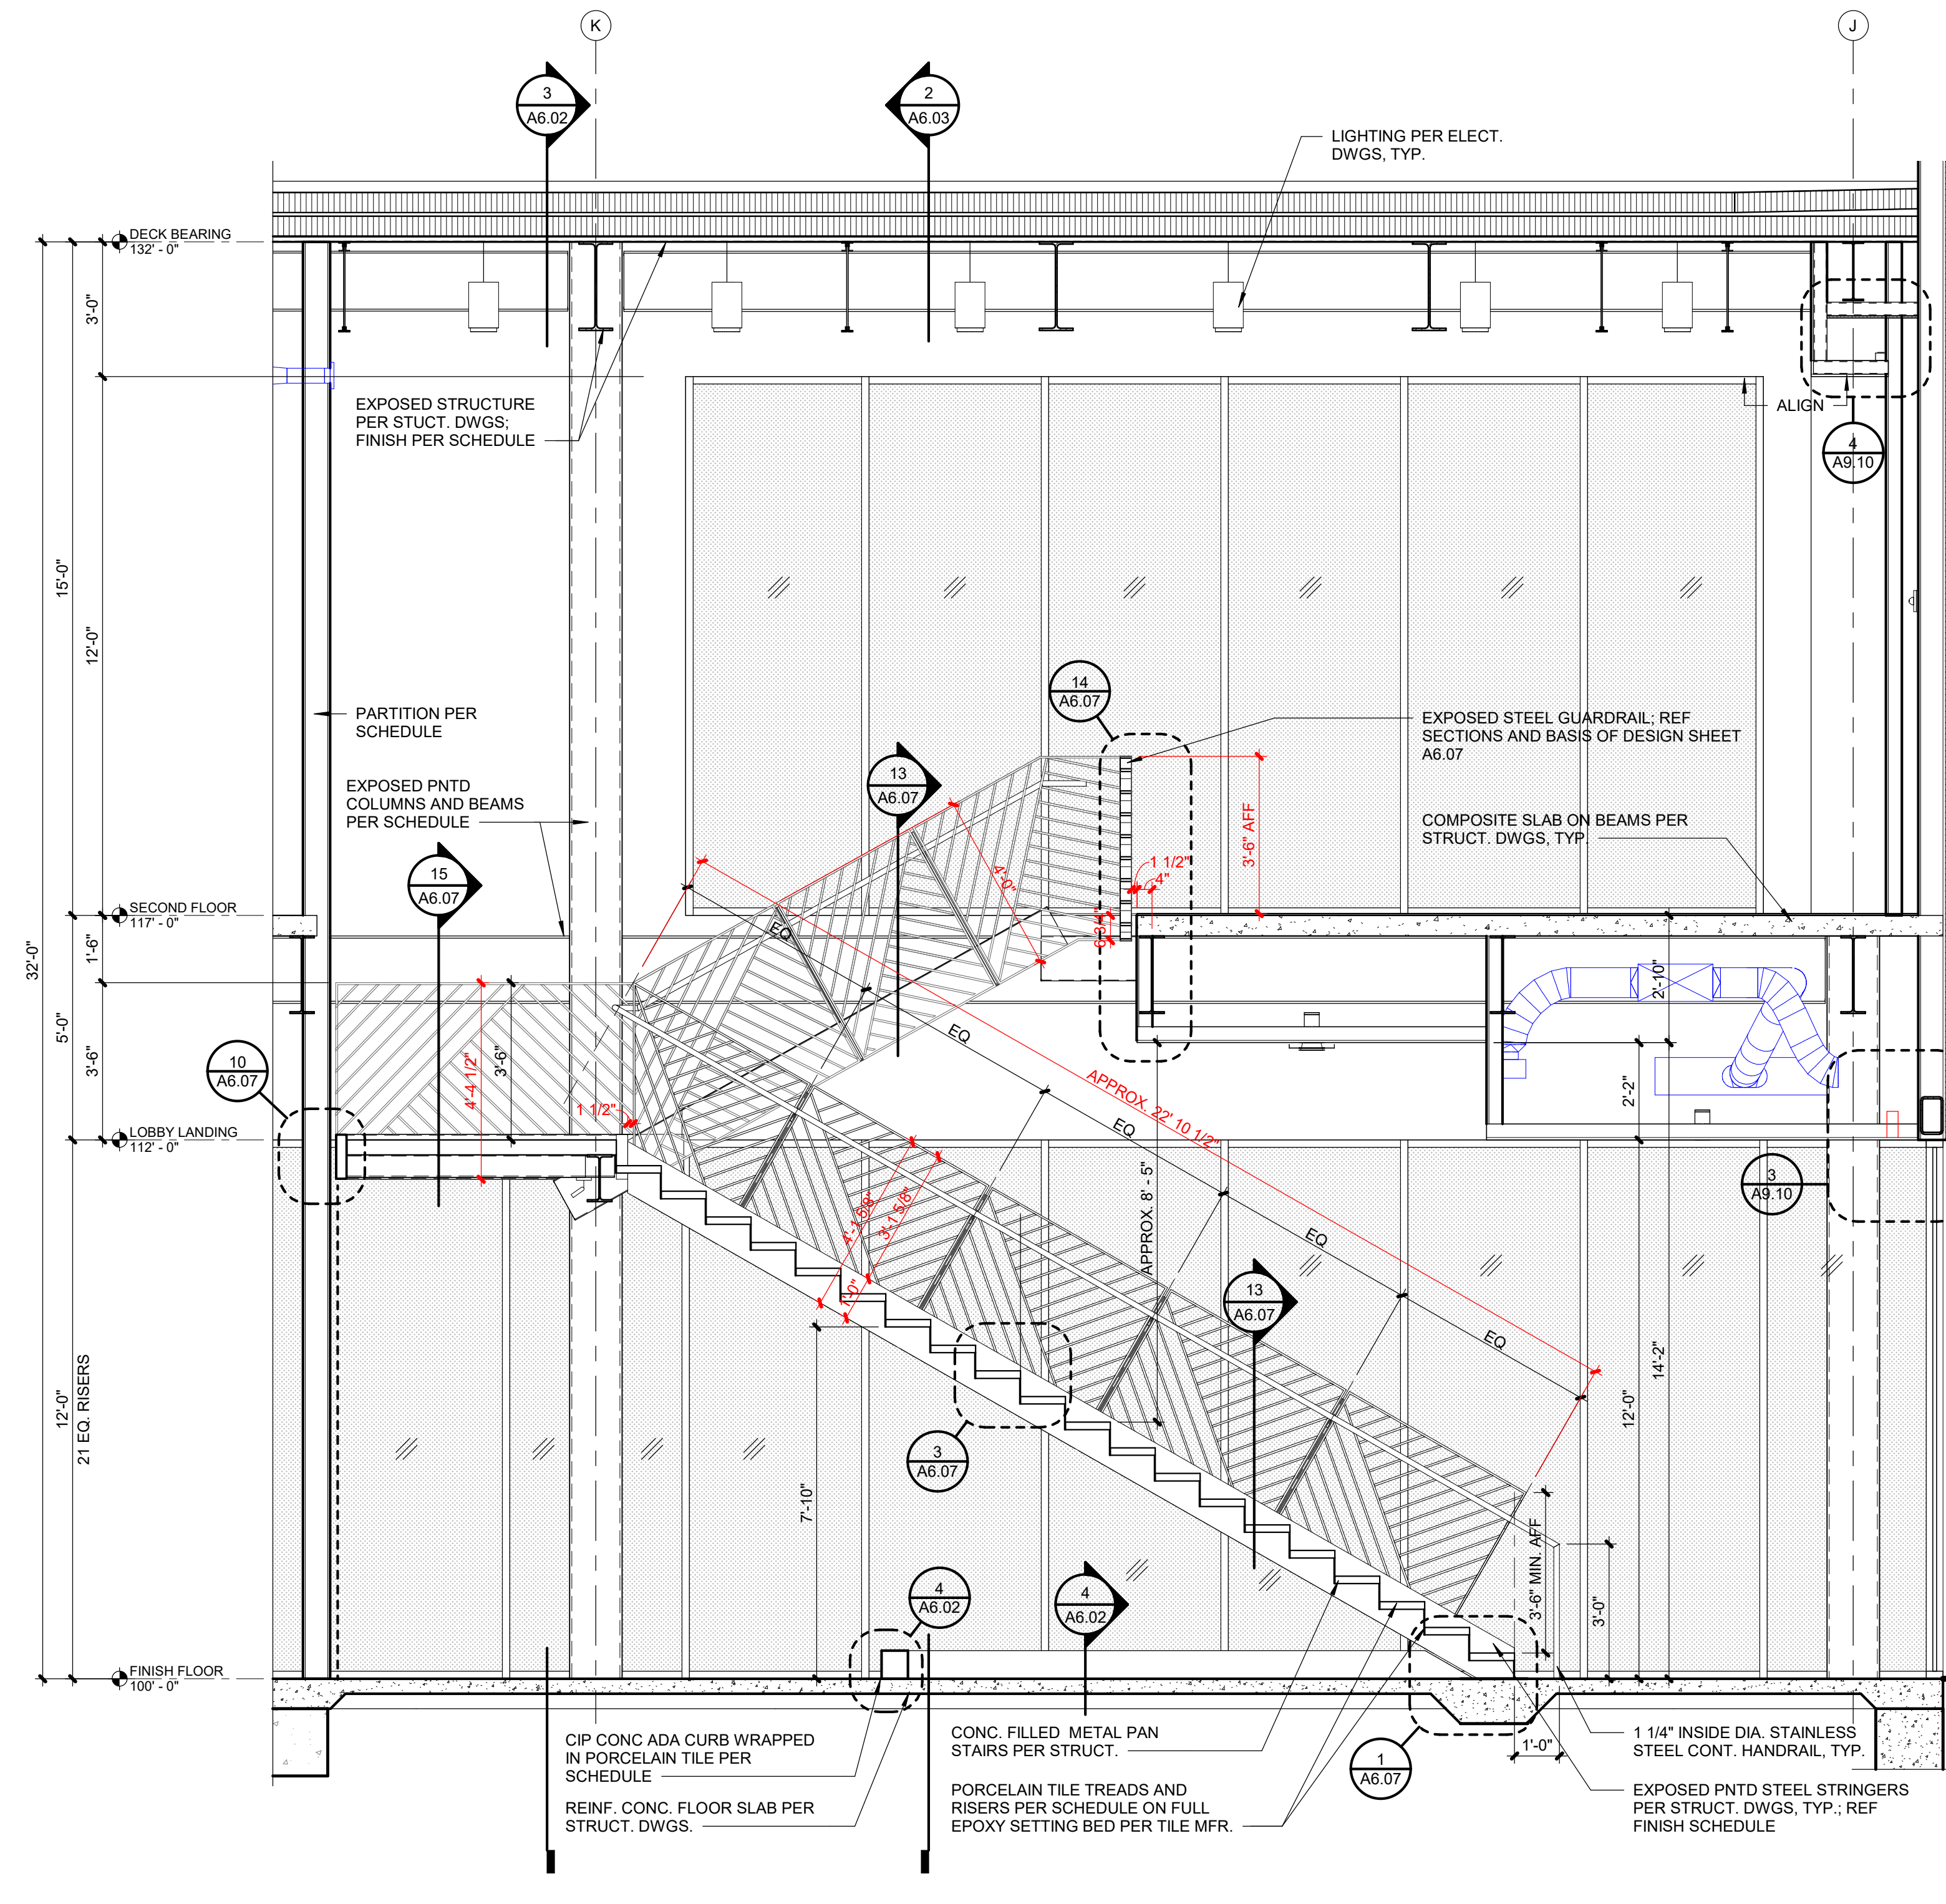


1 STAIR SECTION

A6.02 SCALE: 3/8" = 1'-0"



**\*THESE IMAGES ARE INTENDED FOR REFERENCE ONLY; MAY NOT ACCURATELY REFLECT CURRENT DESIGN. DISCUSS ANY DISCREPANCIES WITH ARCHITECT AND OWNER PRIOR TO FABRICATION**

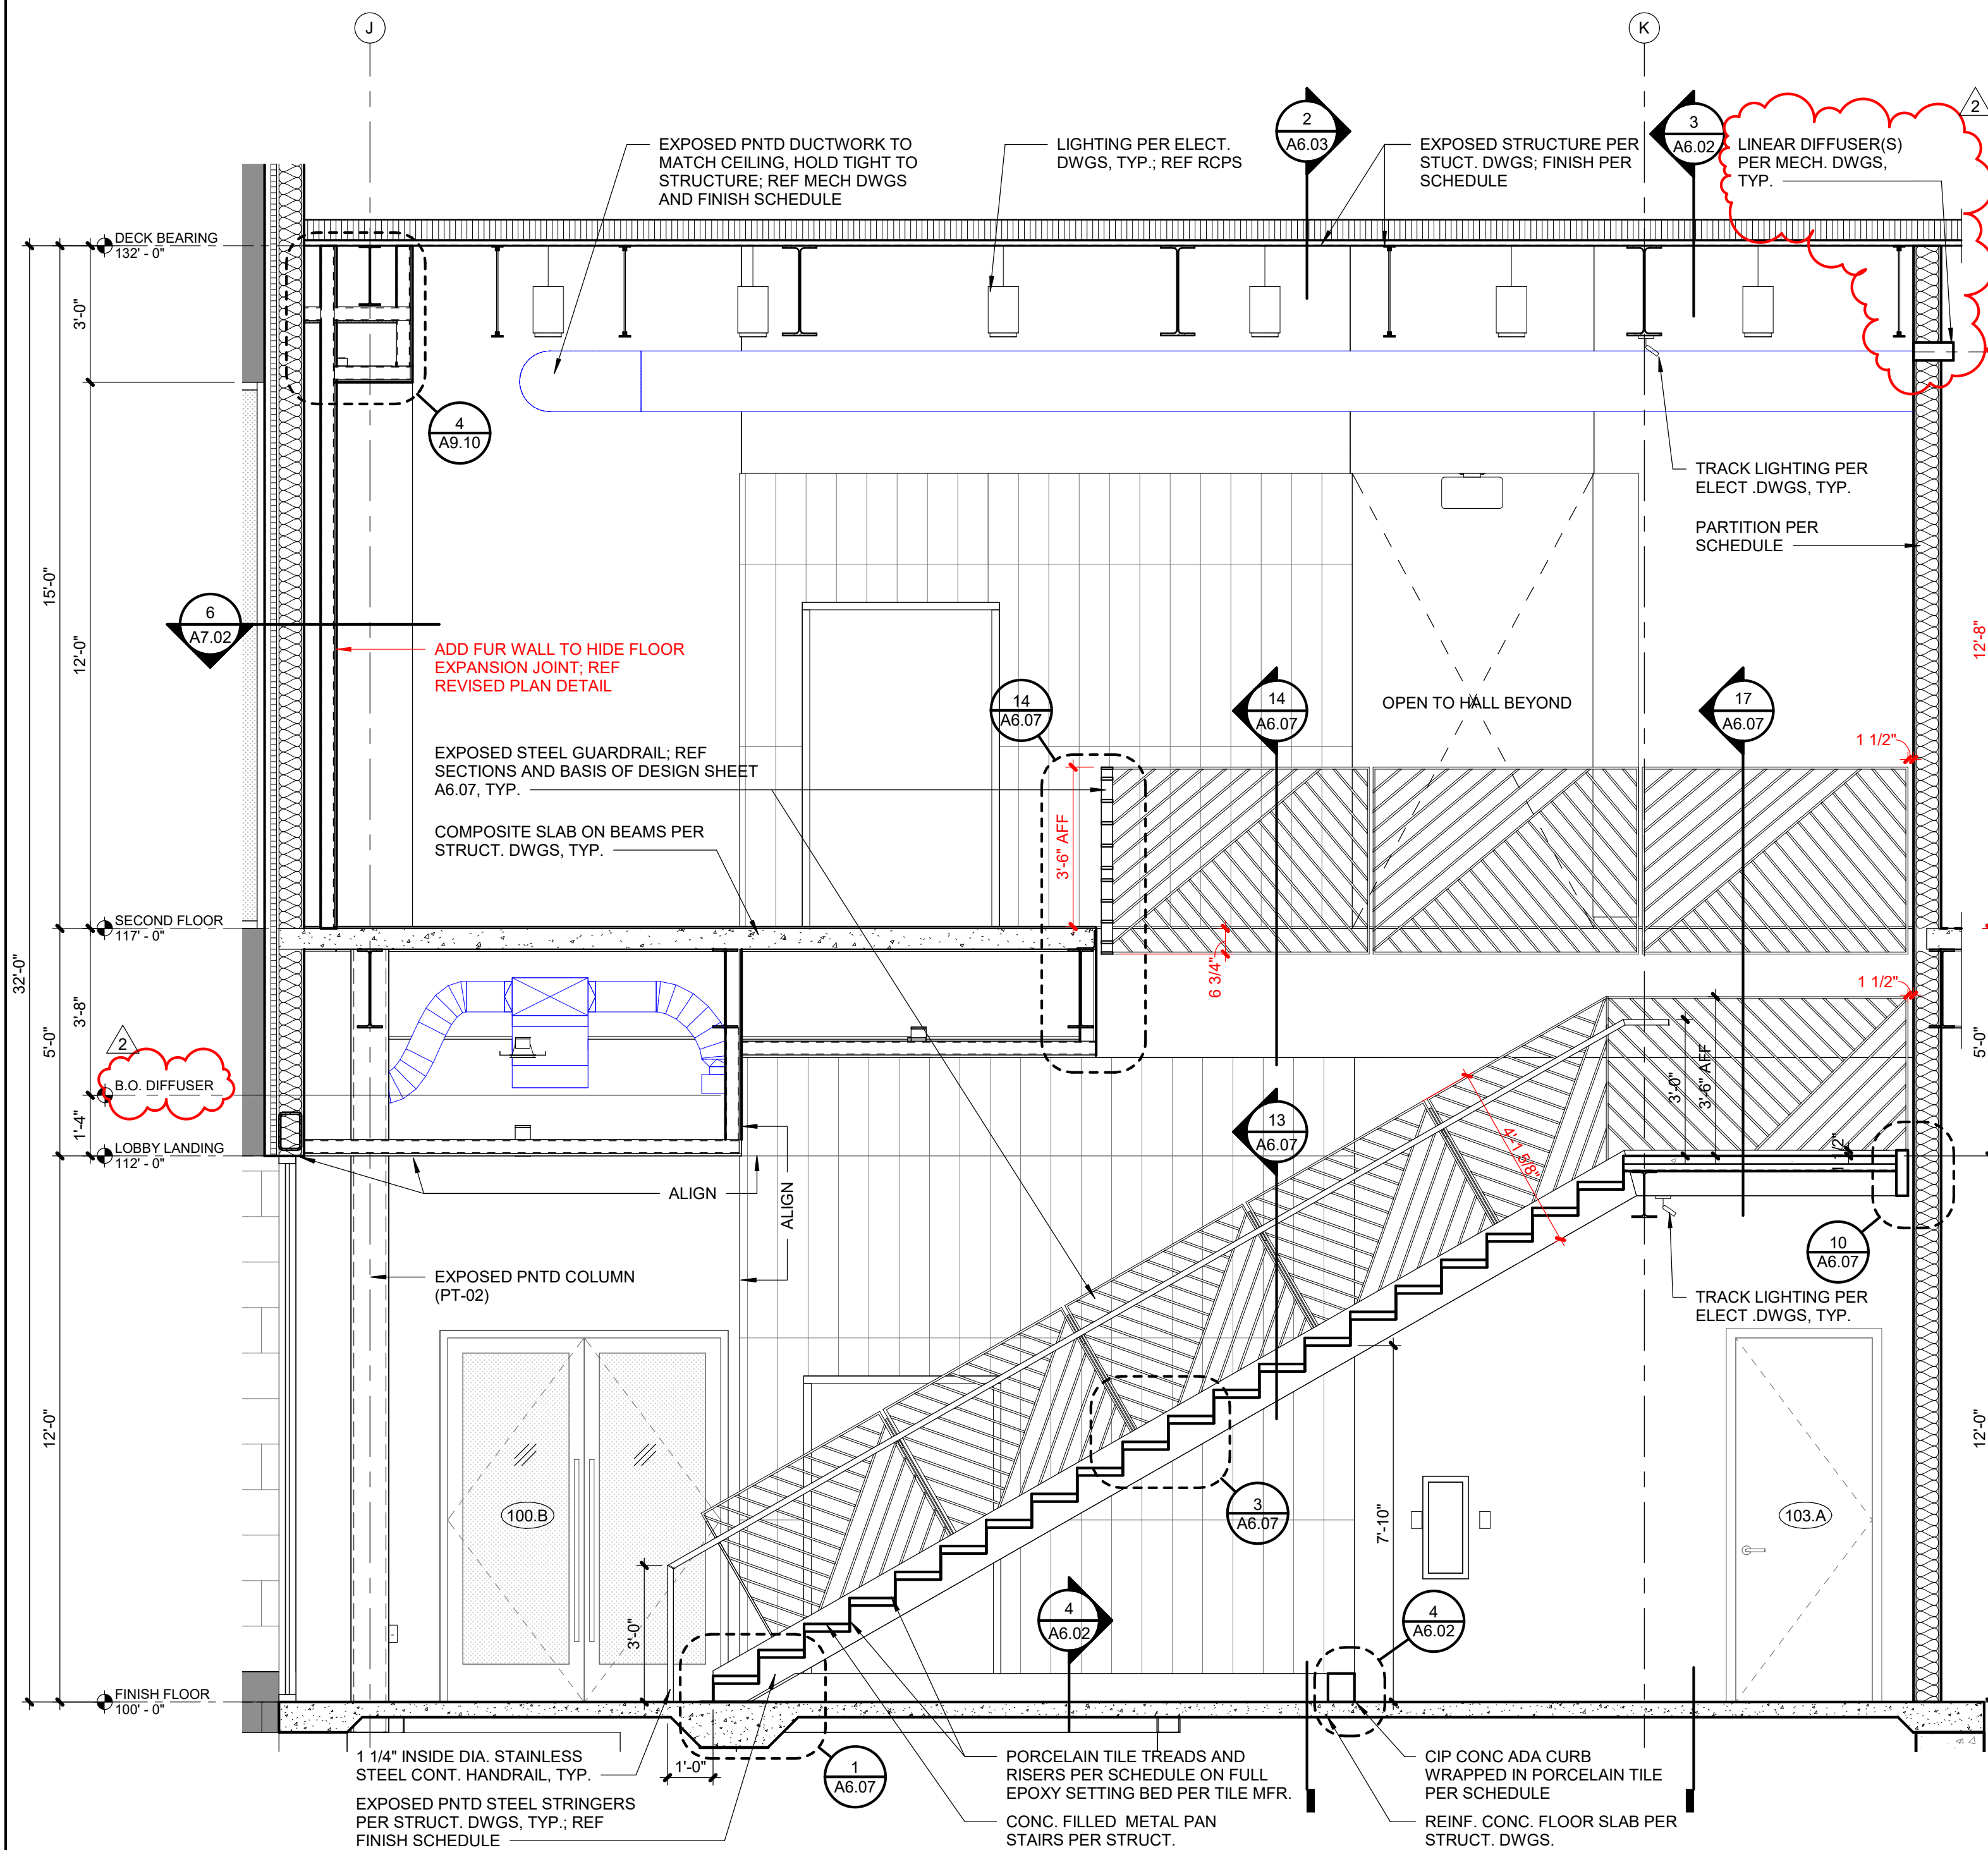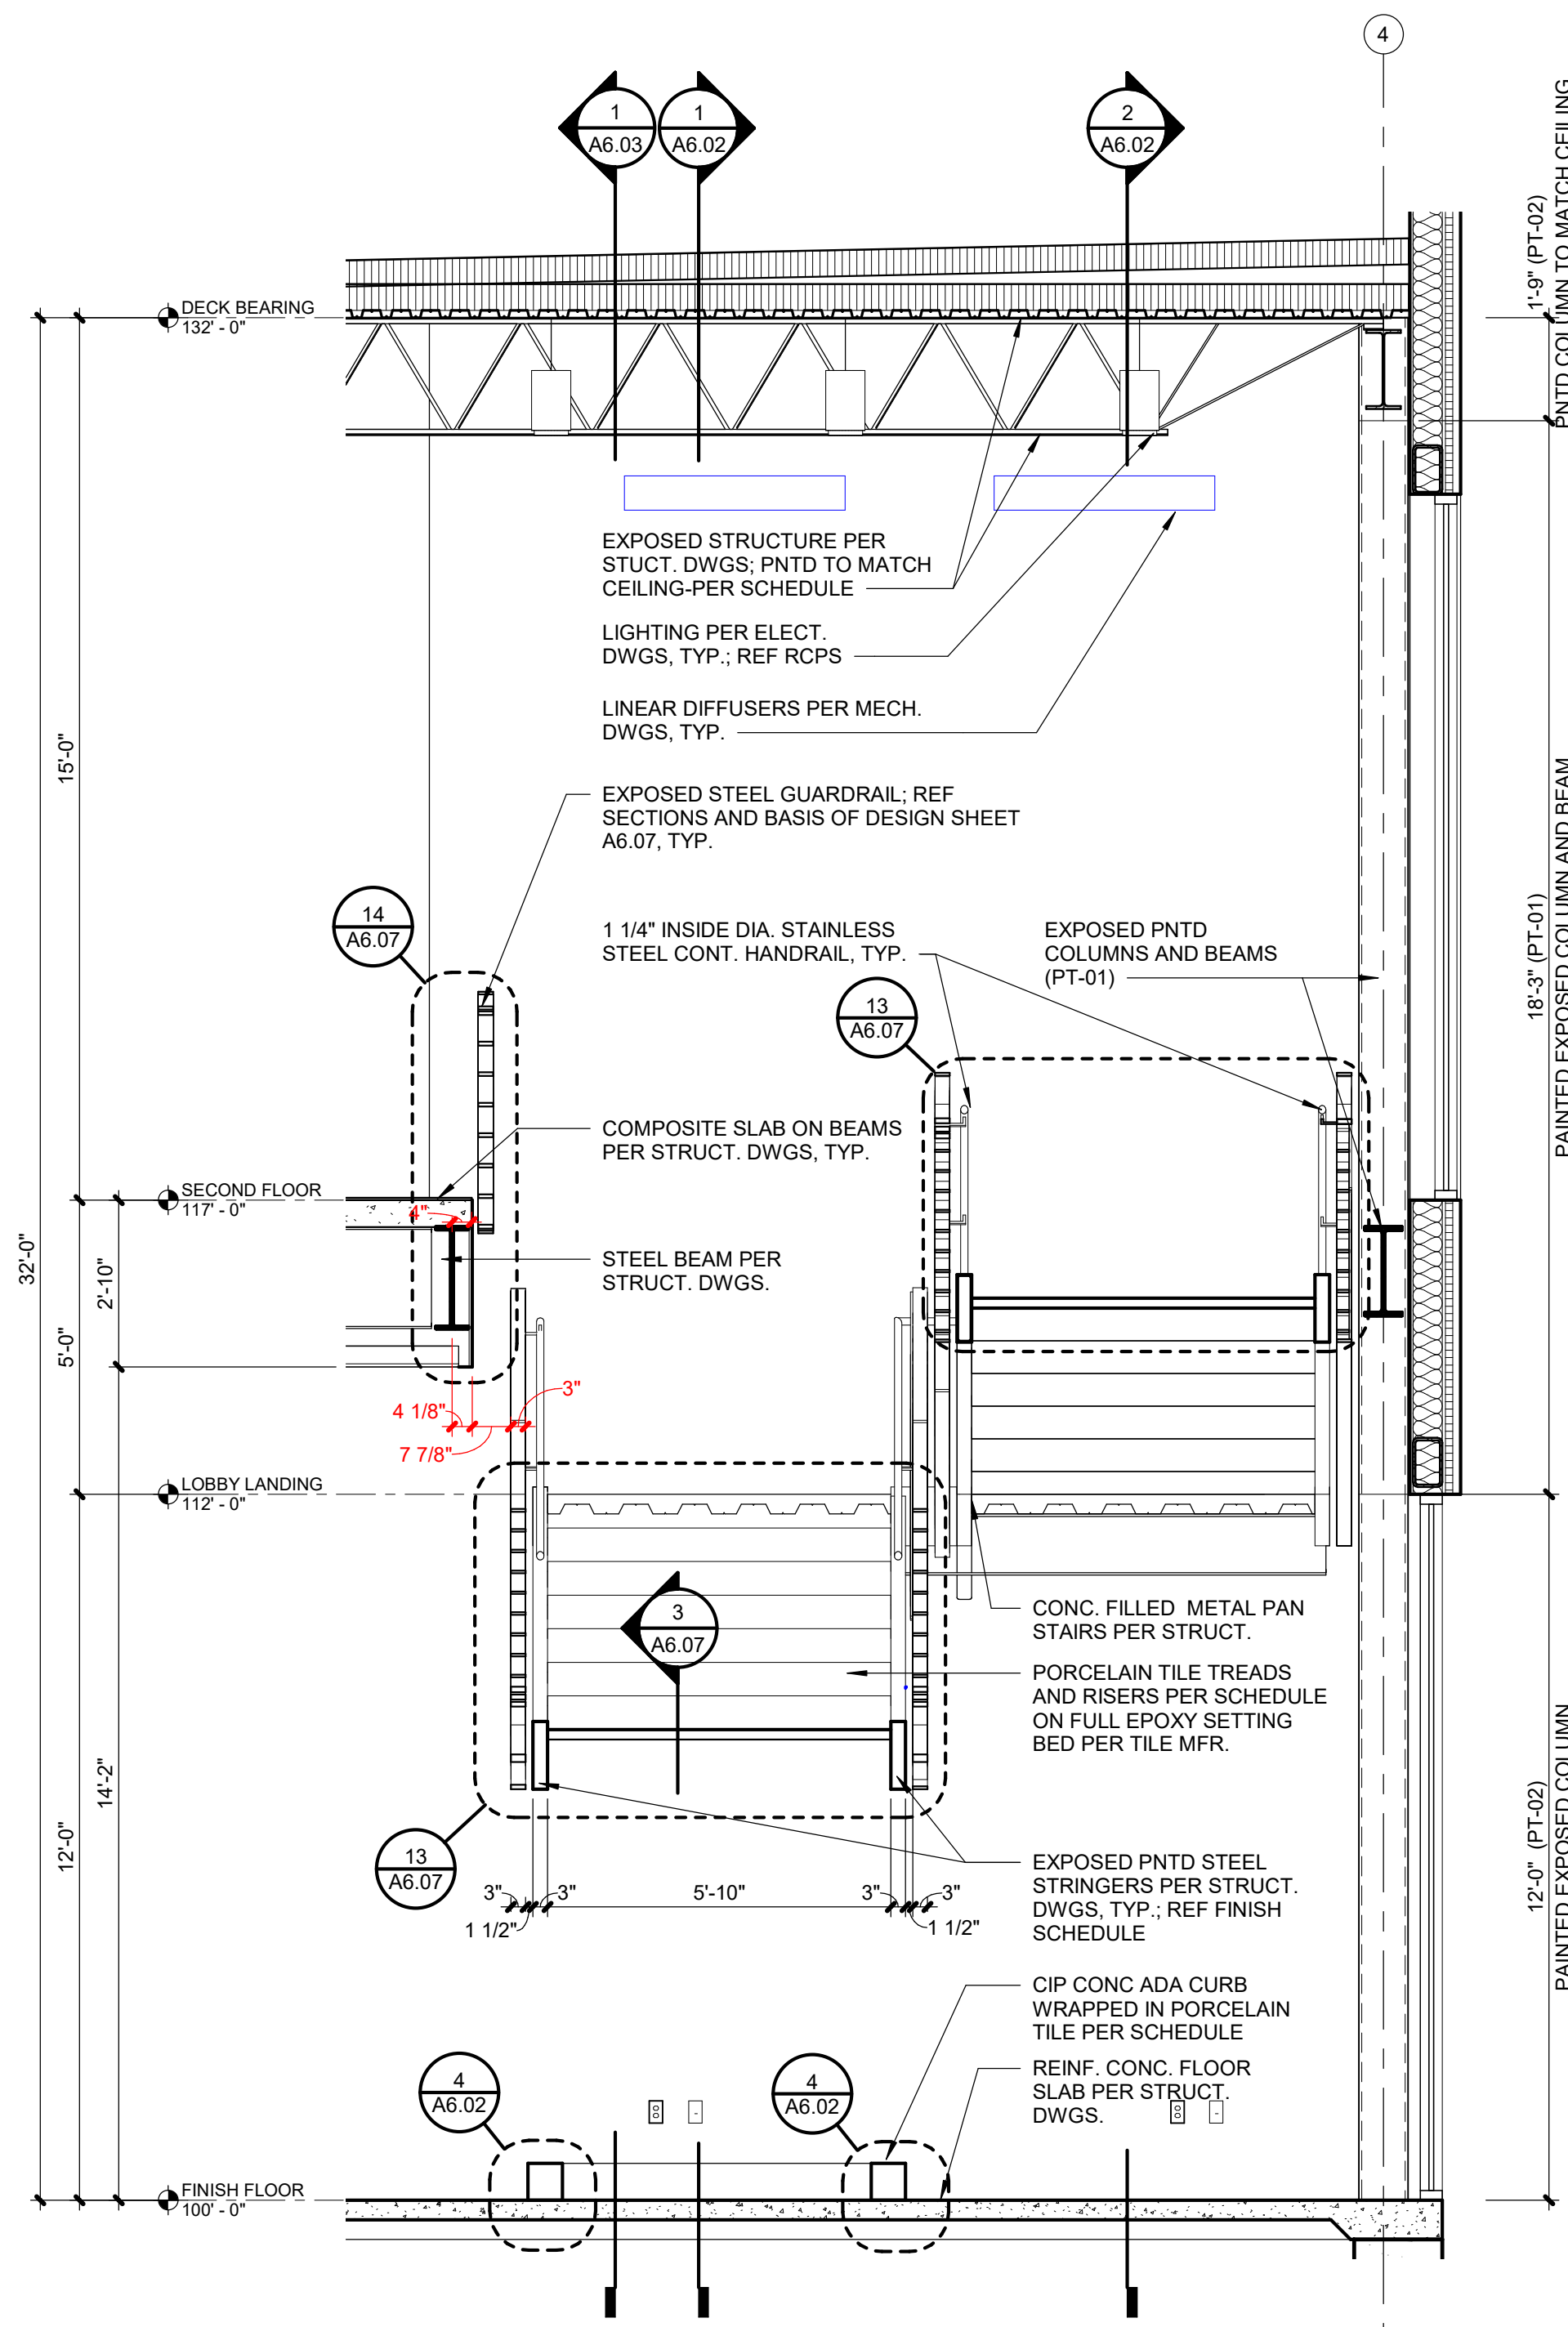



REVISIONS		
No.	Date	Description

REGISTRATION



05.06.22

PROJECT TEAM

ARCHITECT	FINKLE+WILLIAMS ARCHITECTURE
CIVIL	GBA
LANDSCAPE	LAND 3
FOUNDATIONS	BSE STRUCTURAL ENGINEERS
STRUCTURAL	BSE STRUCTRAL ENGINEERS
PLUMBING	HENDERSON ENGINEERS
MECHANICAL	HENDERSON ENGINEERS
ELECTRICAL	HENDERSON ENGINEERS
FIRE PROTECTION	HENDERSON ENGINEERS
CONTRACTOR	FOGEL-ANDERSON



FINKLE + WILLIAMS  
ARCHITECTURE


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LENEXA, KANSAS 66219  
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SHEET TITLE

VERTICAL  
CIRCULATION


SHEET NUMBER

A6.05

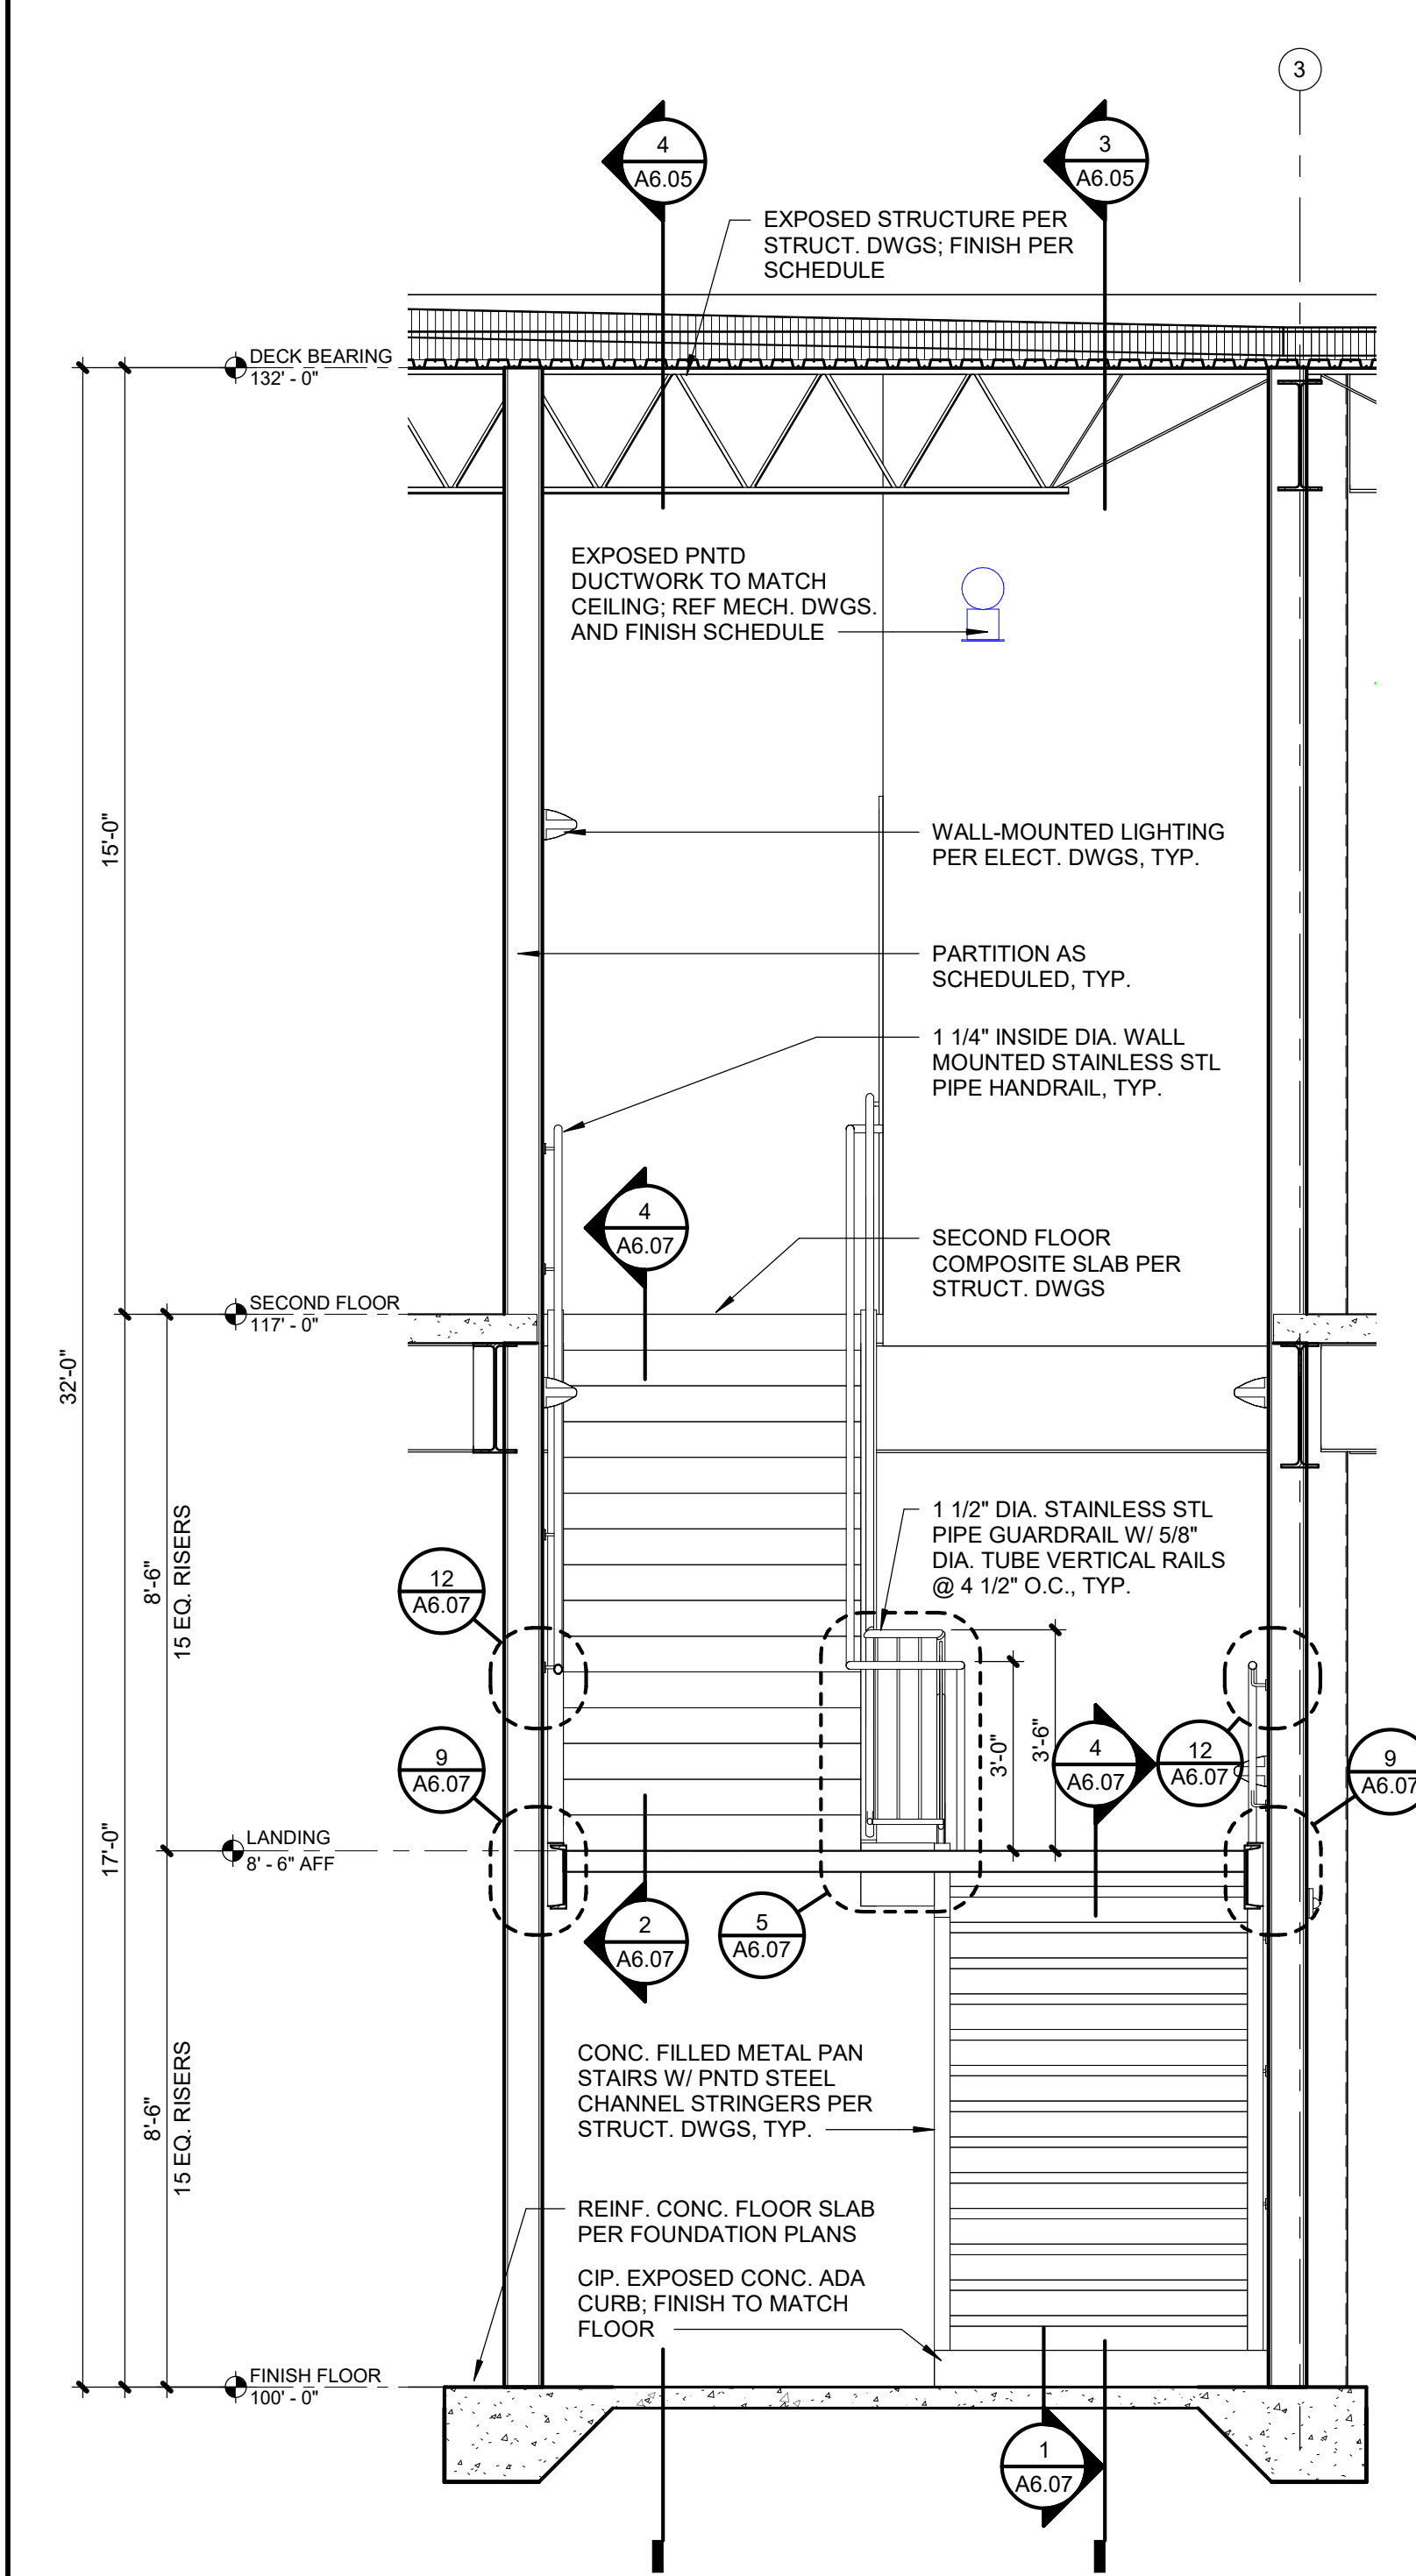


5 STAIR SECTION

A6.05 SCALE: 3/8" = 1'-0"

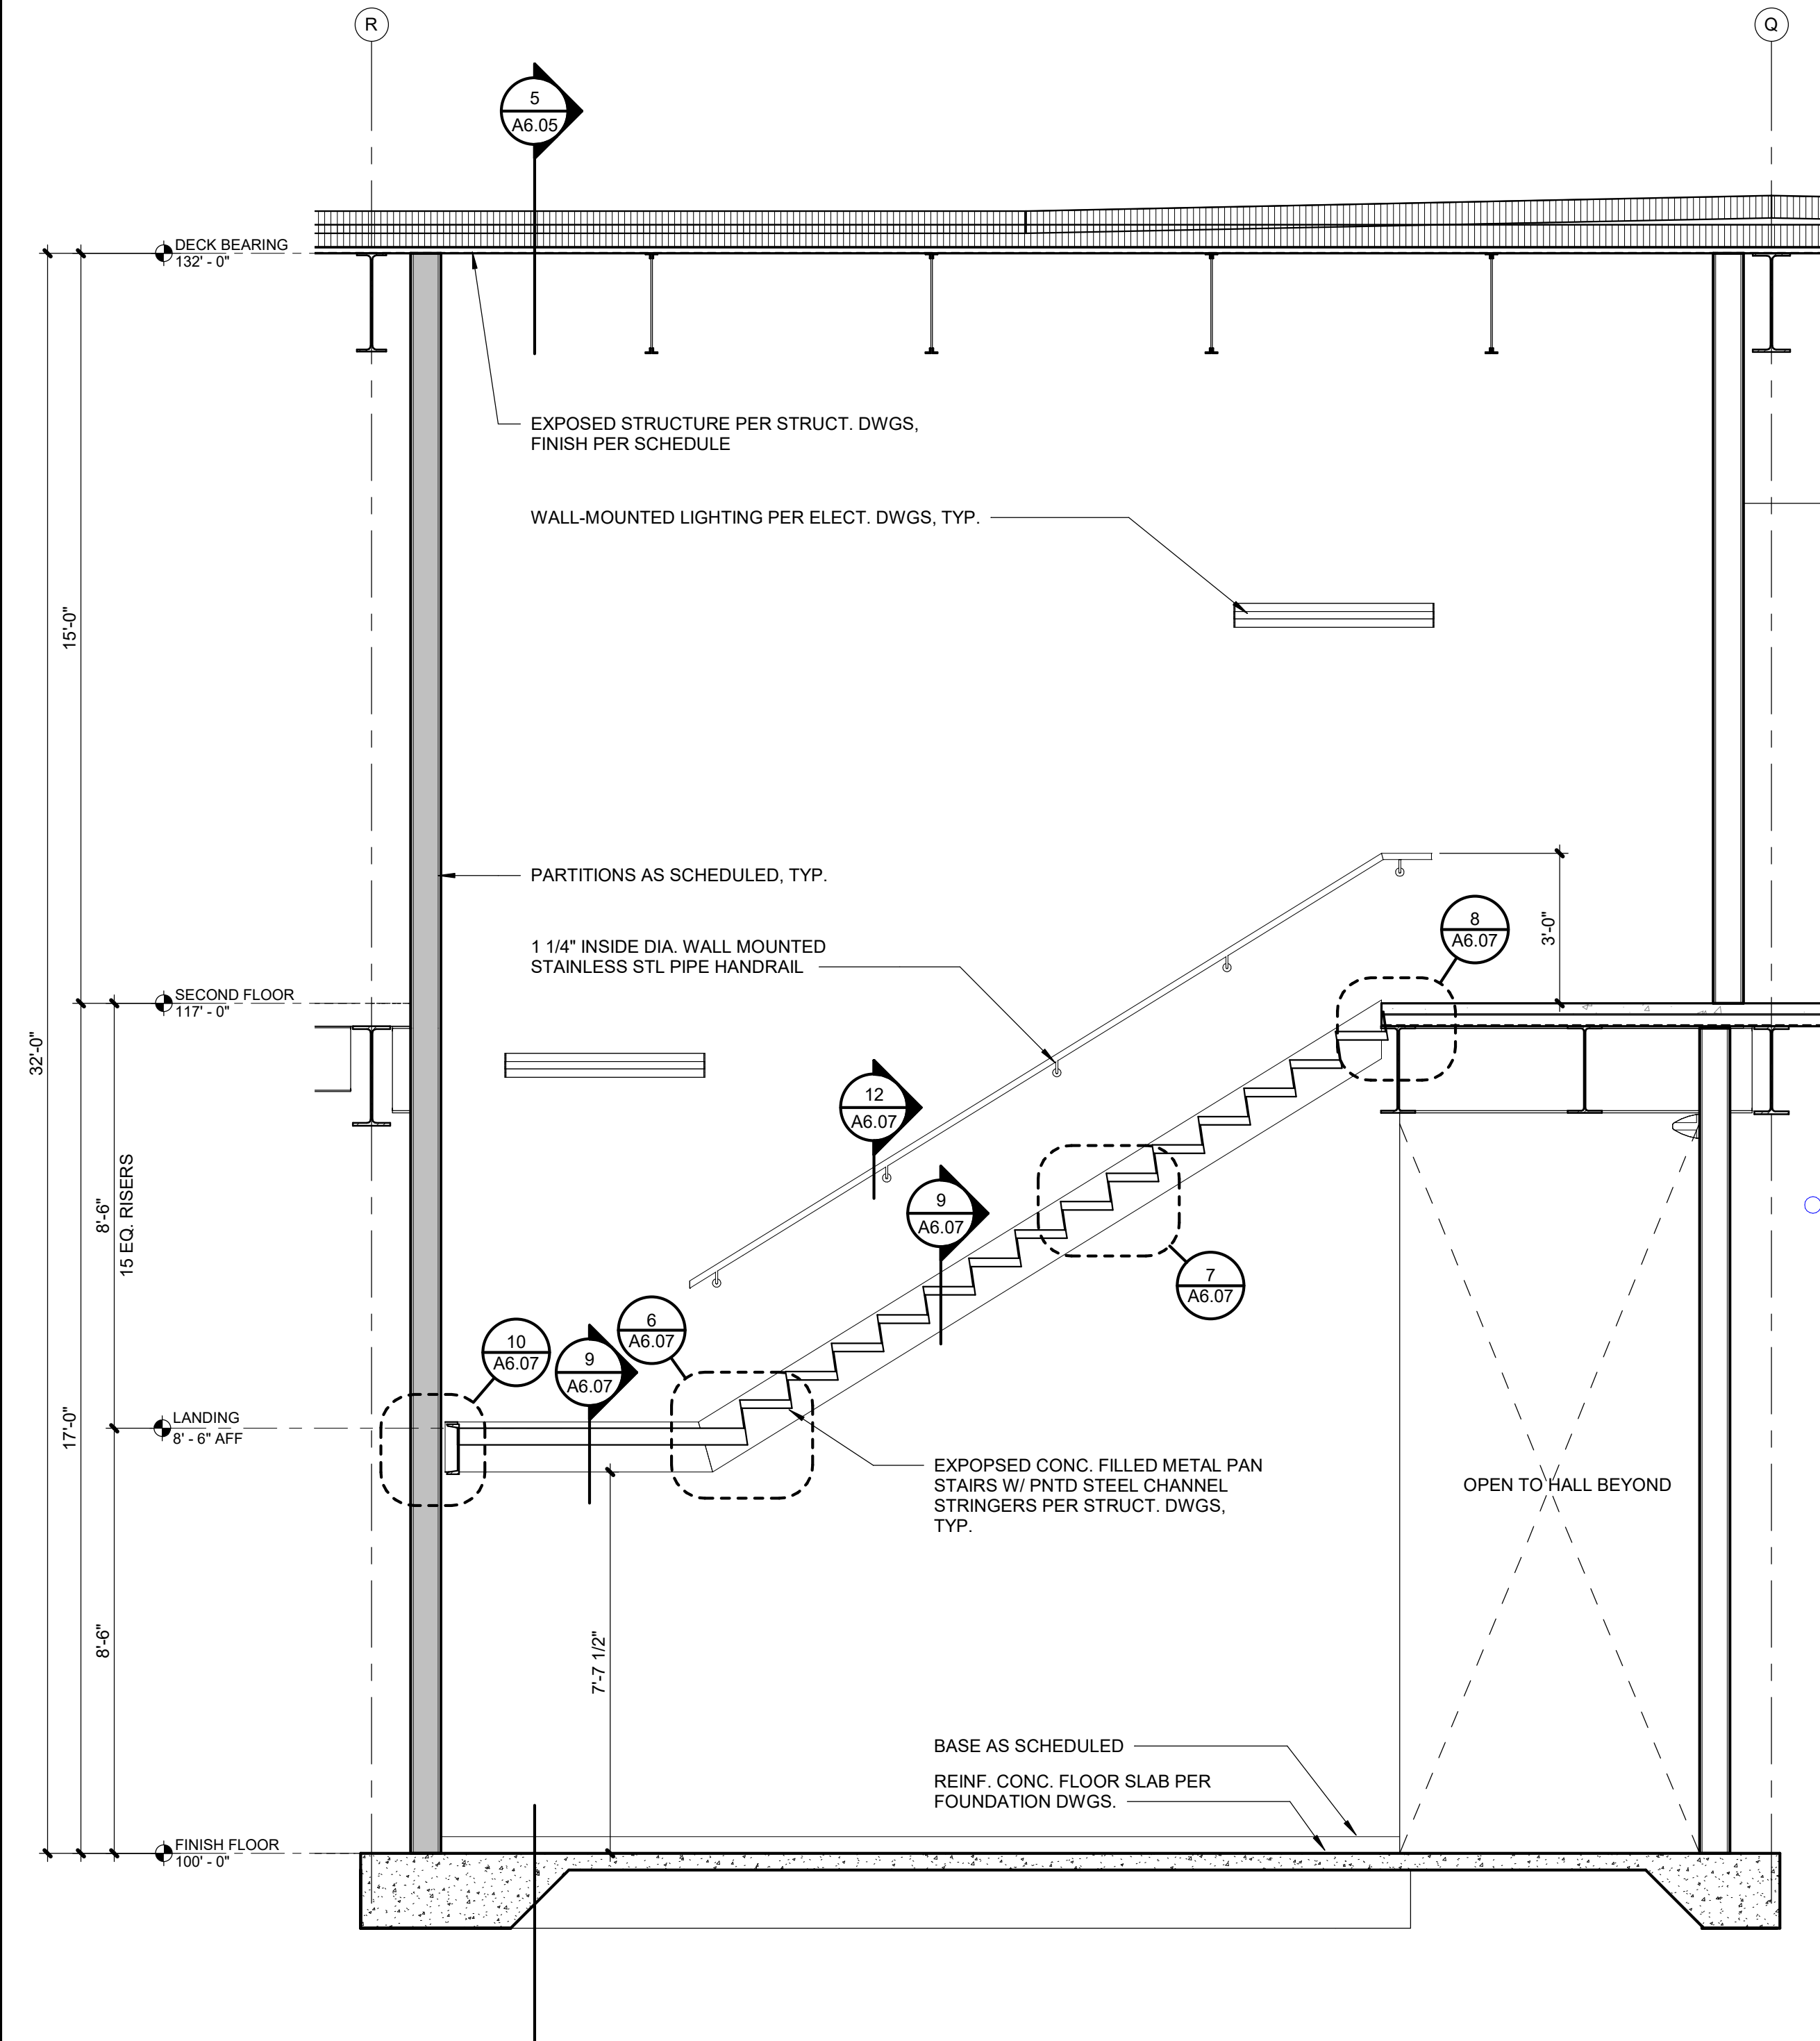


4 STAIR SECTION

A6.05 SCALE: 3/8" = 1'-0"

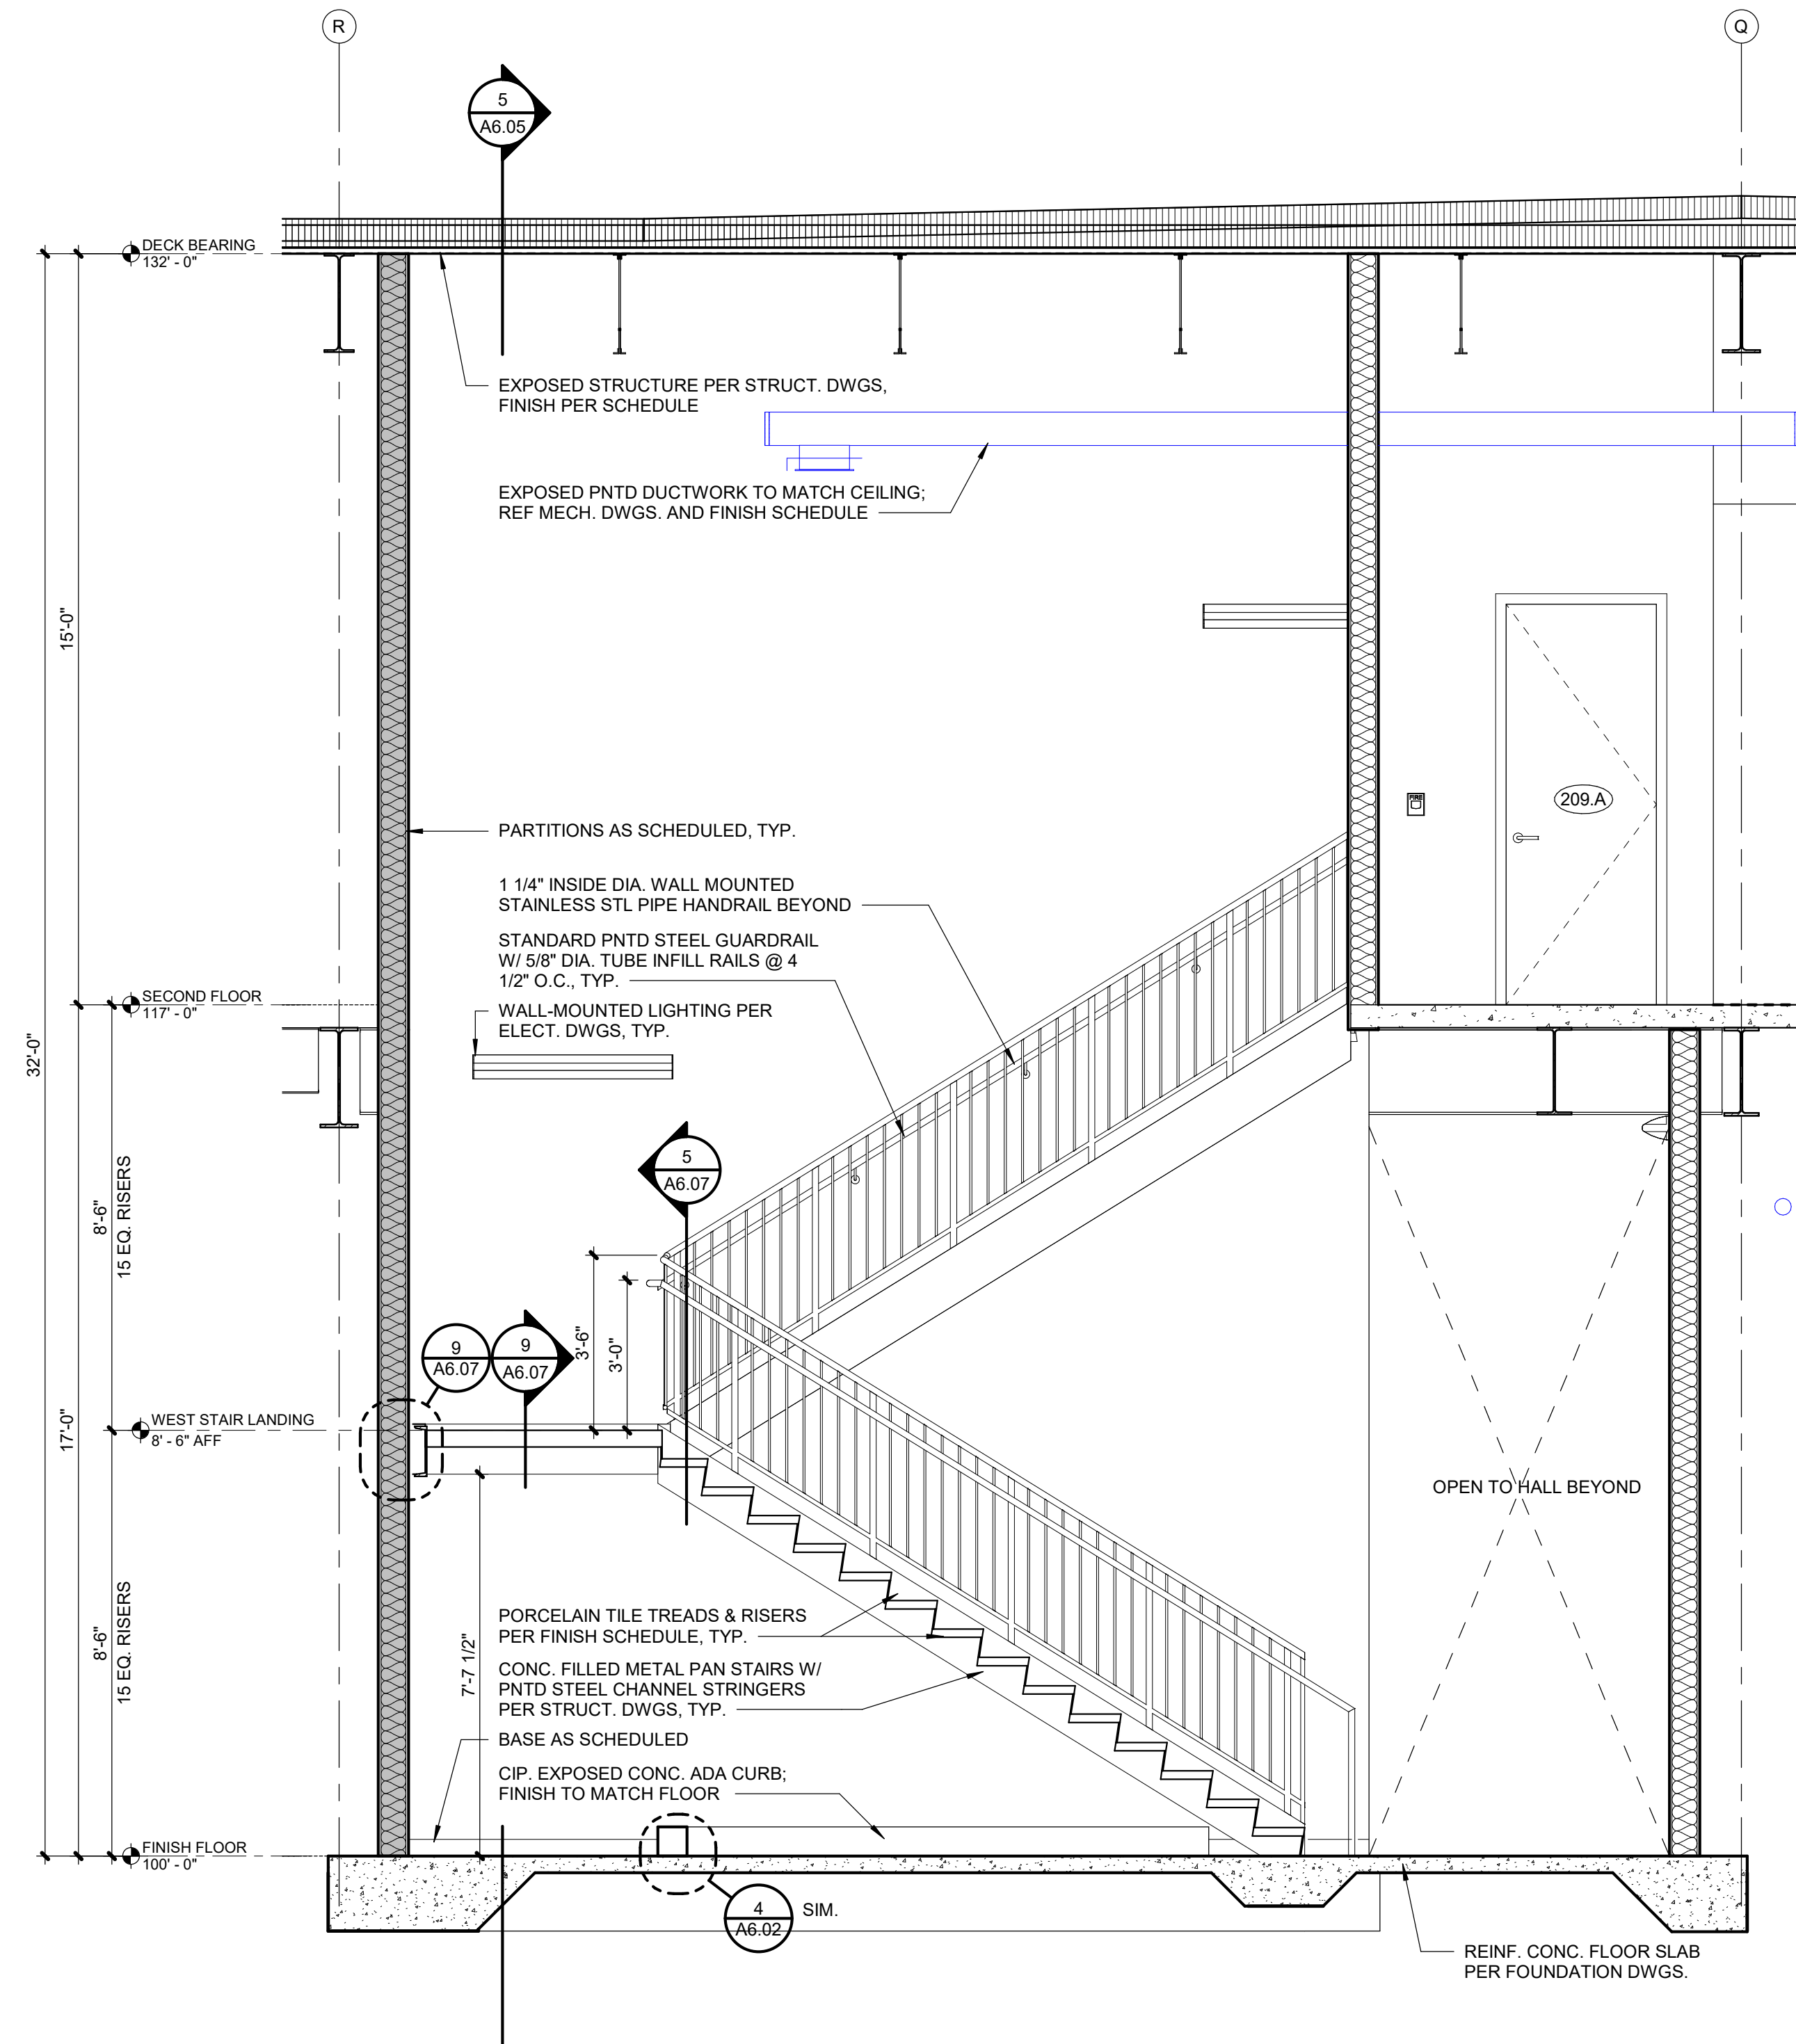


3 STAIR SECTION

A6.05 SCALE: 3/8" = 1'-0"

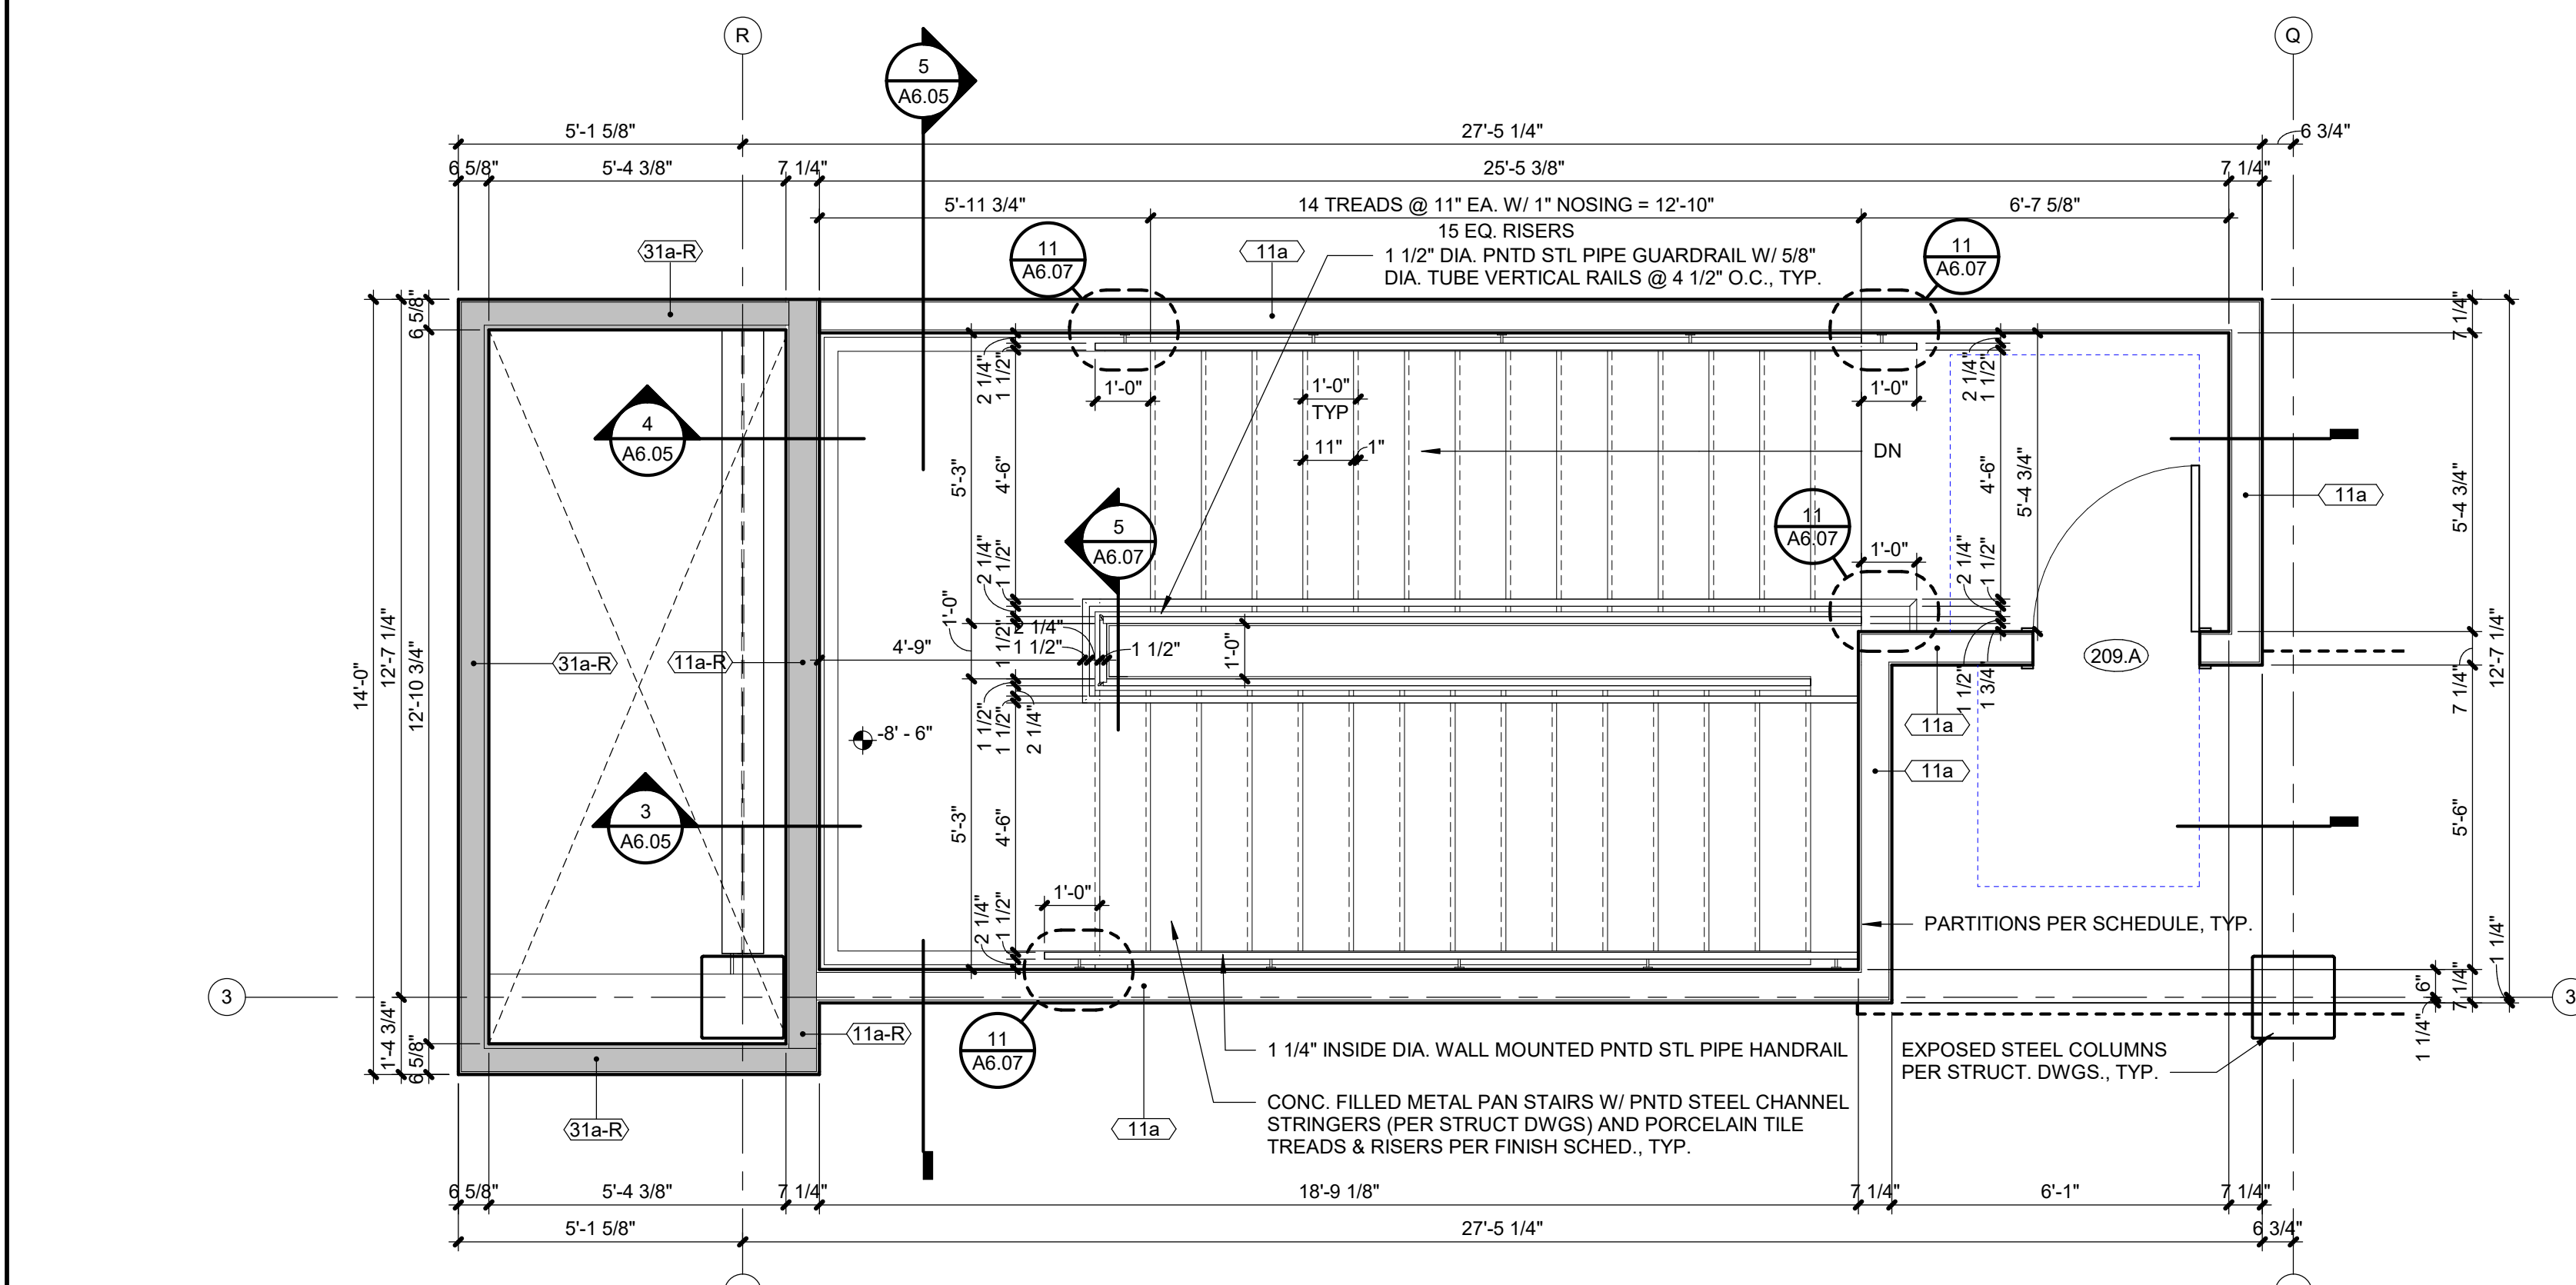

2 WEST STAIR 2ND FLOOR PLAN

A6.05 SCALE: 3/8" = 1'-0"

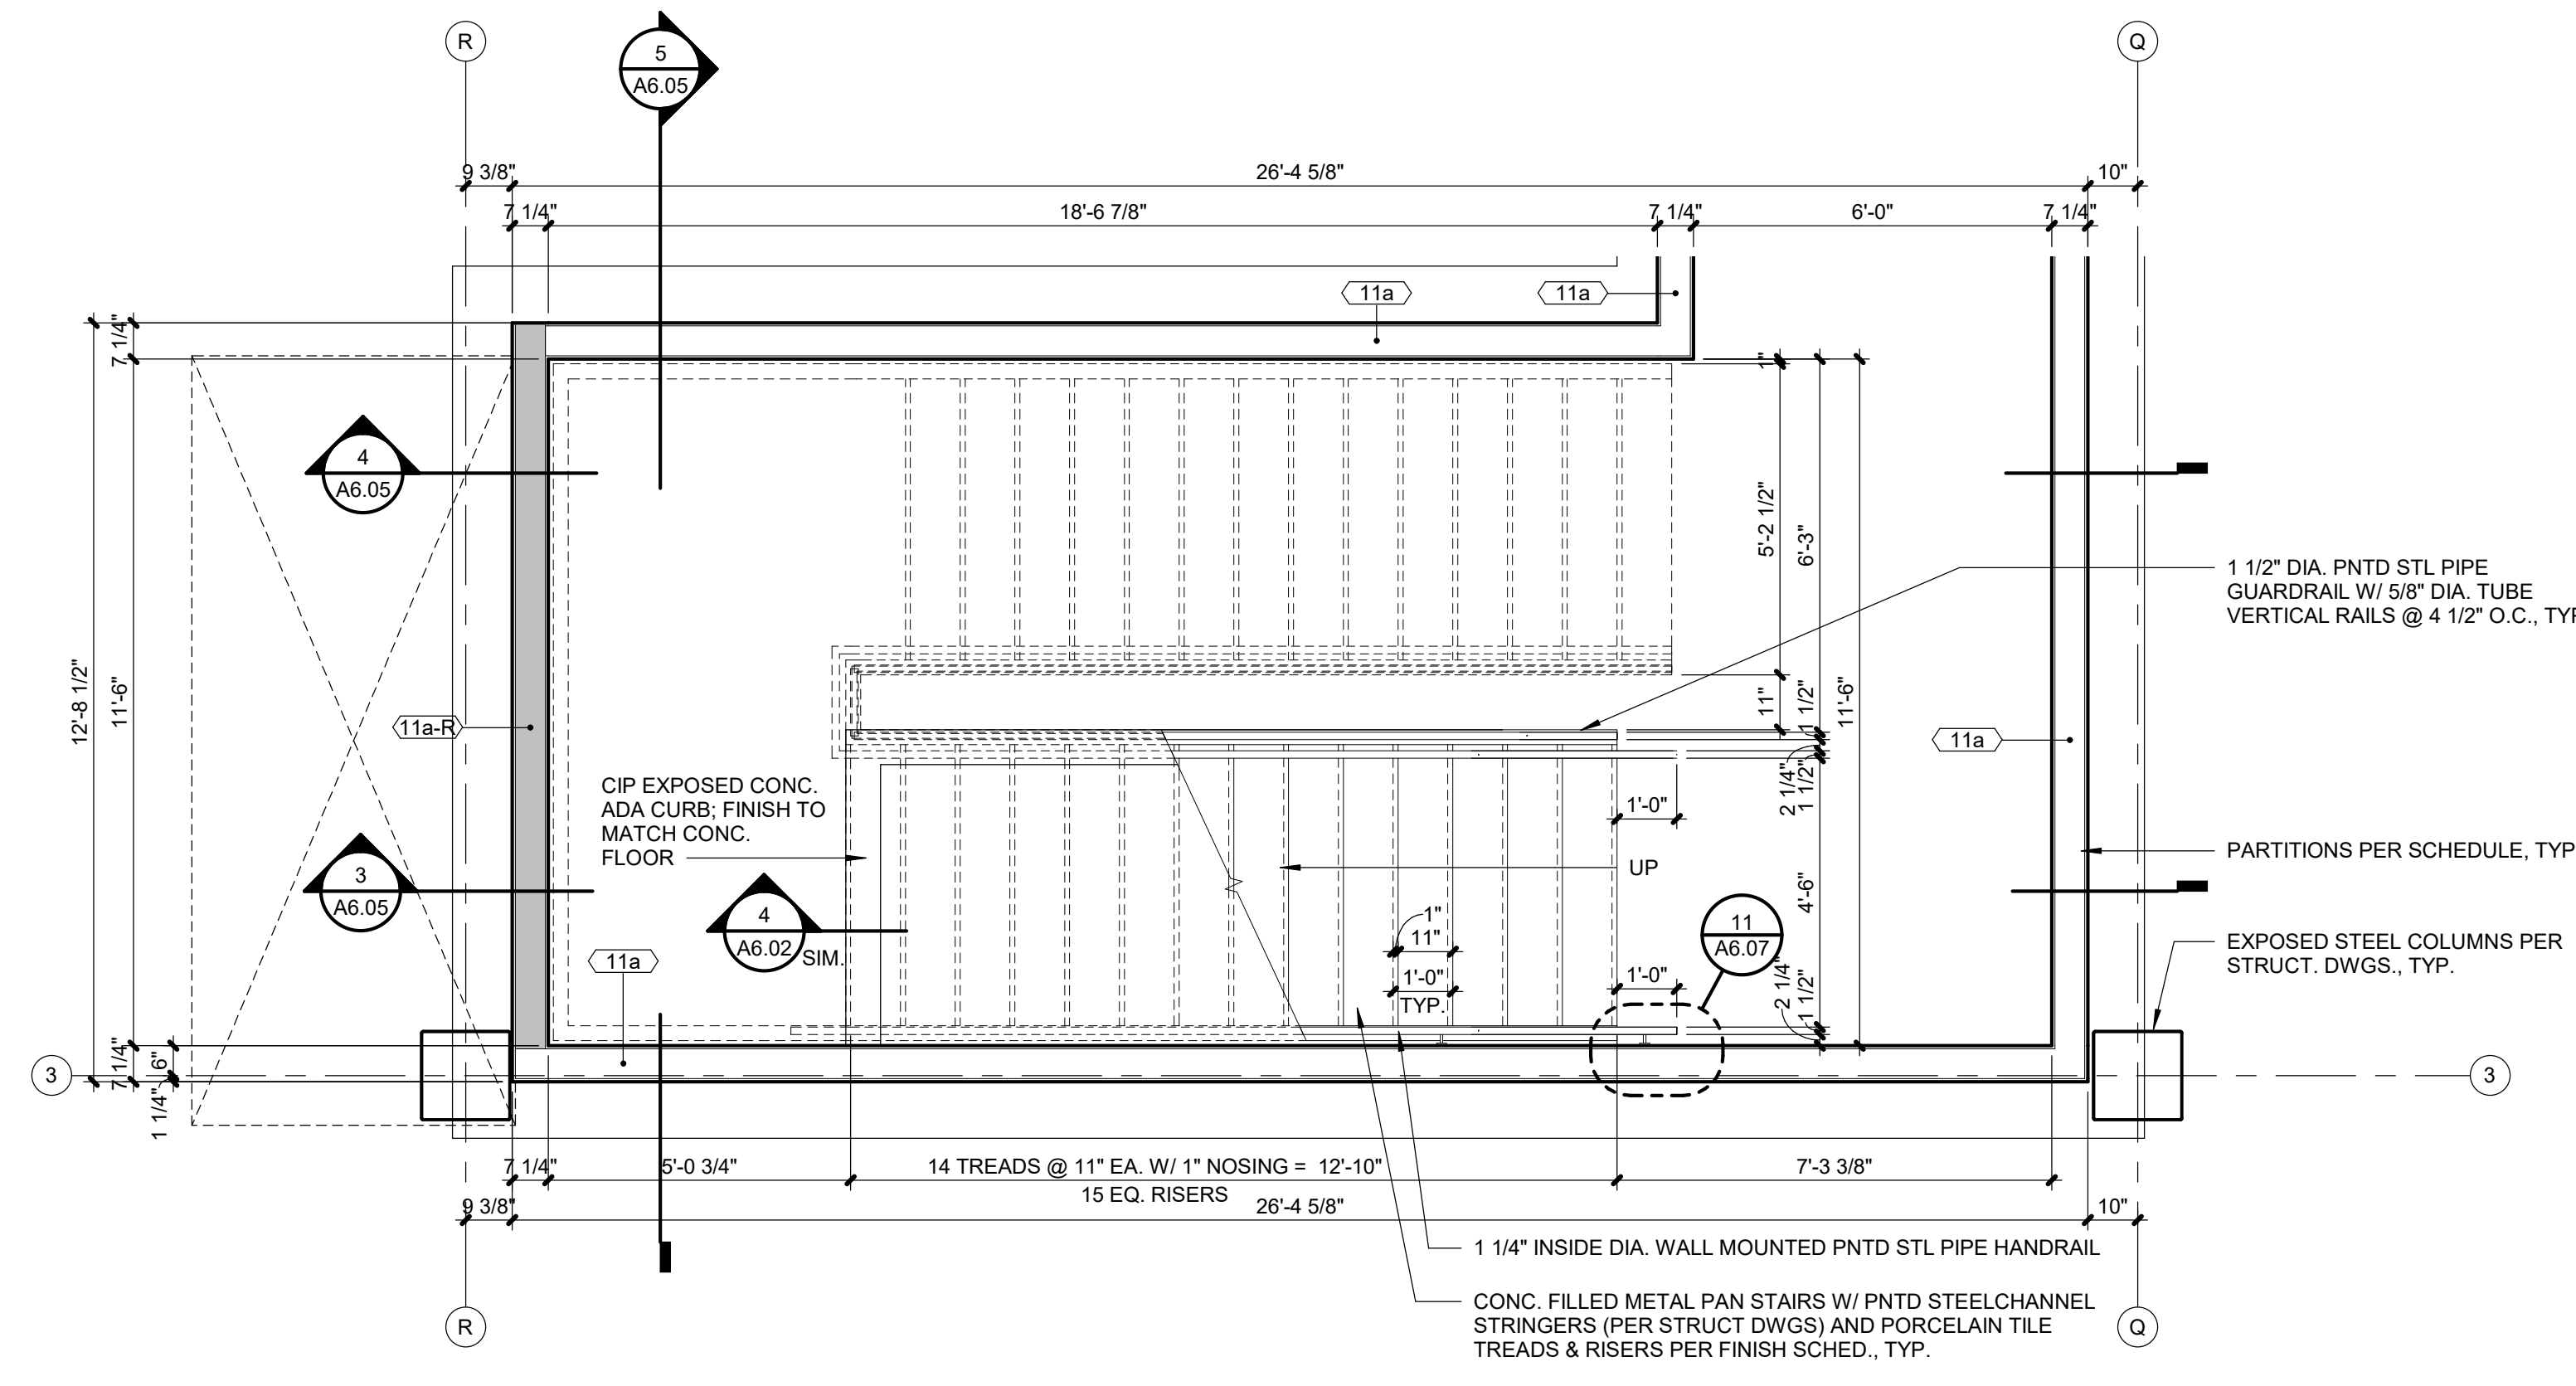


1 WEST STAIR FIRST FLOOR PLAN


A6.05 SCALE: 3/8" = 1'-0"

1	EAST STAIR 1ST FLOOR PLAN
A6.06	SCALE : 3/8" = 1'-0"



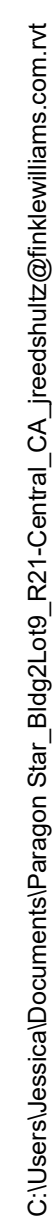

ARCHITECT	FINKLE+WILLIAMS ARCHITECTURE
CIVIL	GBA
LANDSCAPE	LAND 3
FOUNDATIONS	BSE STRUCTURAL ENGINEERS
STRUCTURAL	BSE STRUCTURAL ENGINEERS
PLUMBING	HENDERSON ENGINEERS
MECHANICAL	HENDERSON ENGINEERS
ELECTRICAL	HENDERSON ENGINEERS
FIRE PROTECTION	HENDERSON ENGINEERS
CONTRACTOR	FOGEL-ANDERSON

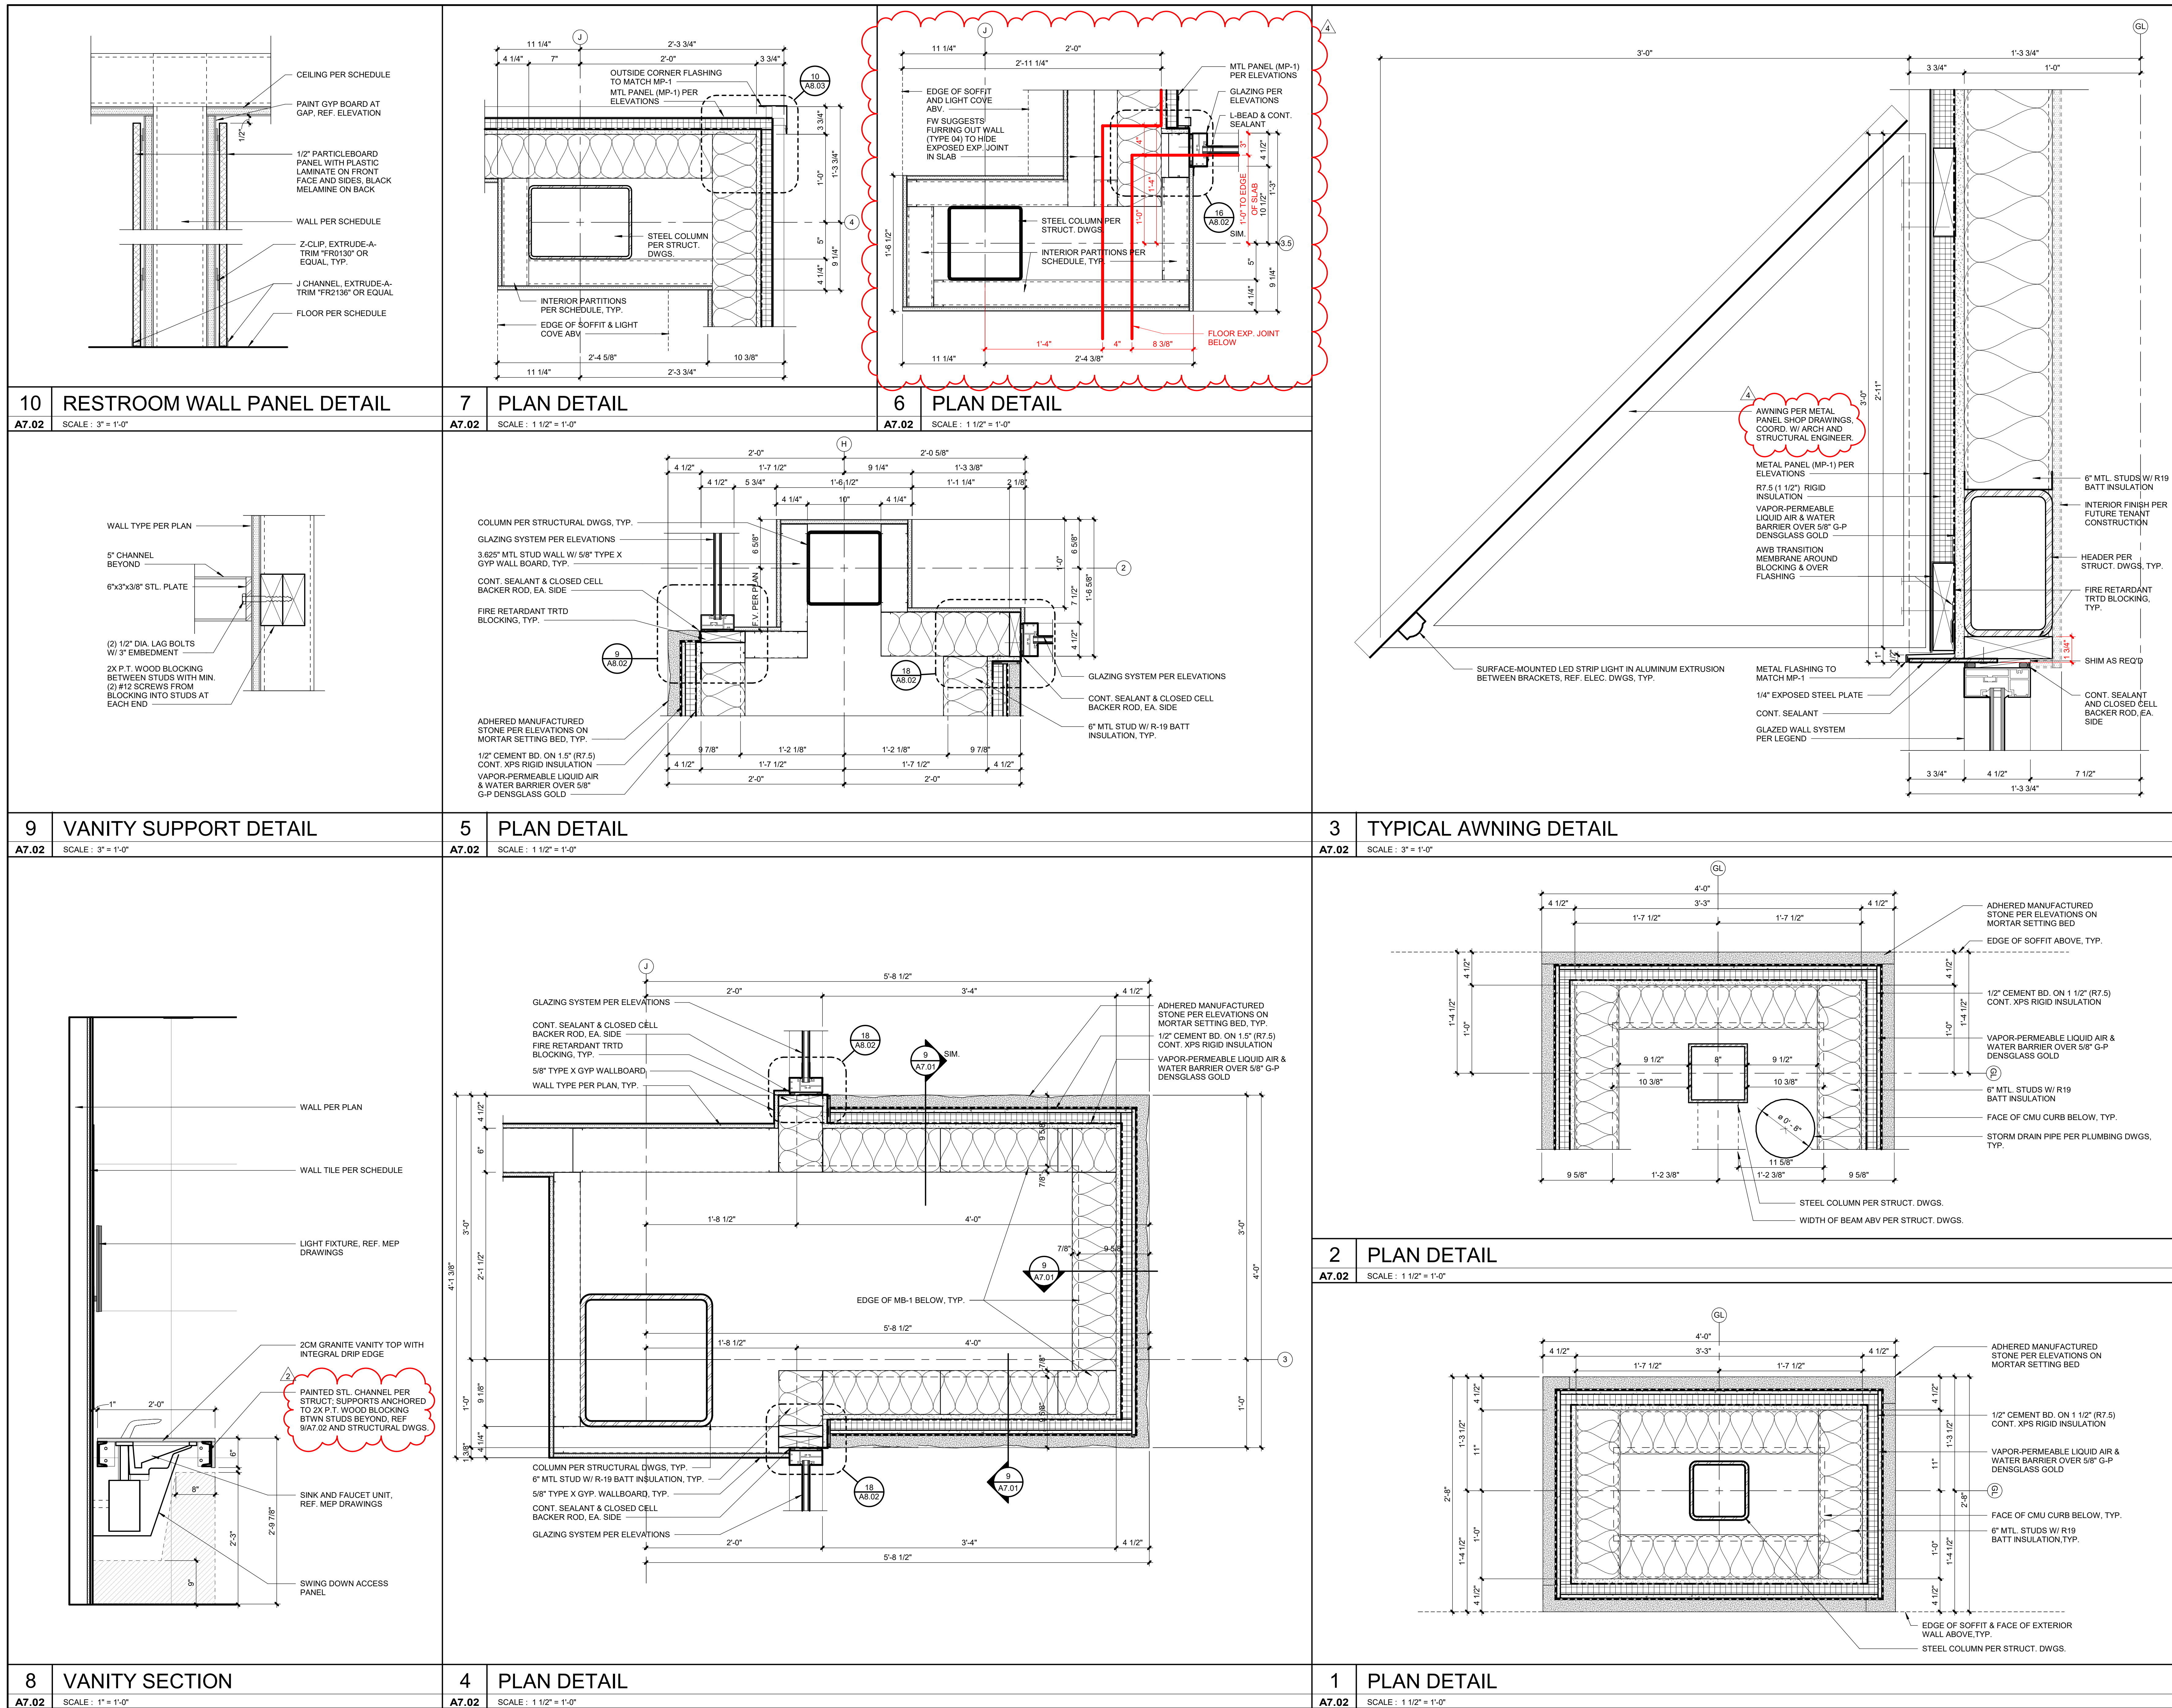


## SEE SPECIFICATIONS FOR DETAILED HARDWARE INFORMATION.

1. ALL HARDWARE SHALL COMPLY WITH APPLICABLE REQUIREMENTS OF THE AMERICANS WITH DISABILITIES ACT (ADA).
2. ALL DOOR HARDWARE SHALL BE FINISH US614 IRON BLACK OR EQUIVALENT.
3. ALL LATCHSETS AND LOCKSETS SHALL BE EQUIPPED WITH LEVER TYPE OPERATING TRIM W/ THE "CLUTCH" FEATURE.
4. ALL CLOSERS SHALL BE LOCATED ON ROOMS SIDES OF DOORS.
5. CONTRACTOR'S HARDWARE CONSULTANT SHALL BE RESPONSIBLE FOR DETERMINING APPROPRIATE HARDWARE FUNCTION AND OPTIONS.
6. CONTRACTOR SHALL COORDINATE FINAL KEYING WITH OWNER.

- HINGES
- LATCHSET
- CLOSER
- WALL STOP
- SMOKE GASKET

- BOTTOM SWEEP
- ASTRAGAL (MEETING STI


ALL HOLLOW METAL DOORS TO BE FACTORY PRIMED. PAINT TO BE SPRAYED

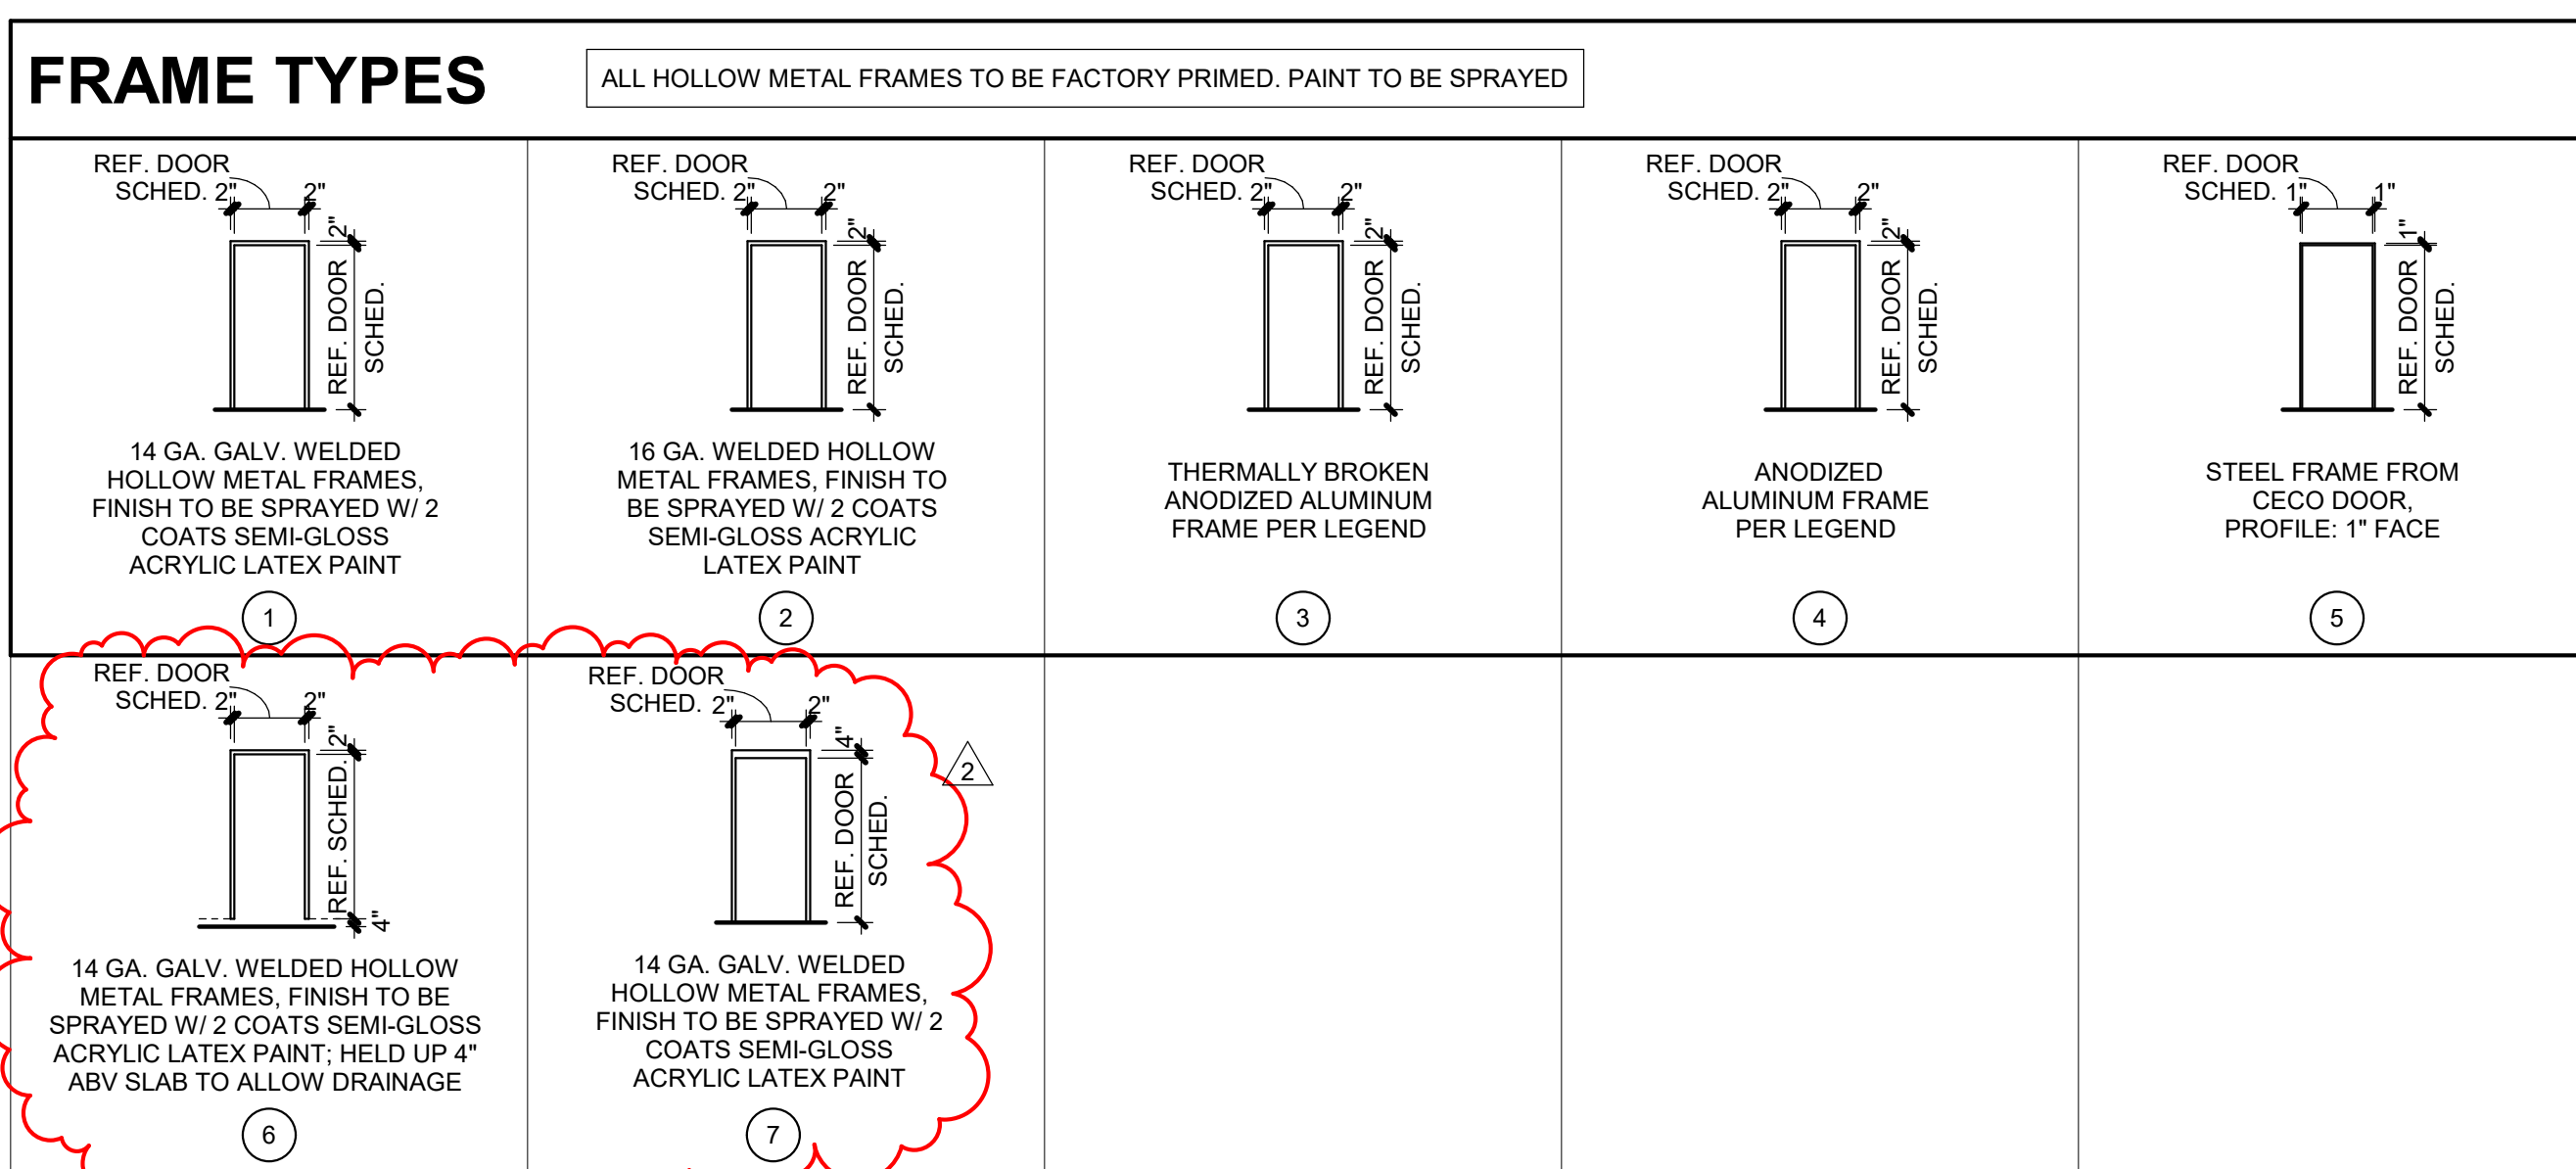

ALL HOLLOW METAL FRAMES TO BE FACTORY PRIMED. PAINT TO BE SPRAYED

- BOTTOM SWEEP
- ASTRAGAL (MEETING STILE)

REF DETAILS ON SHEETS A3.05, A7.01-A7.02, A8.02-A8.04 FOR FLASHING DETAILS

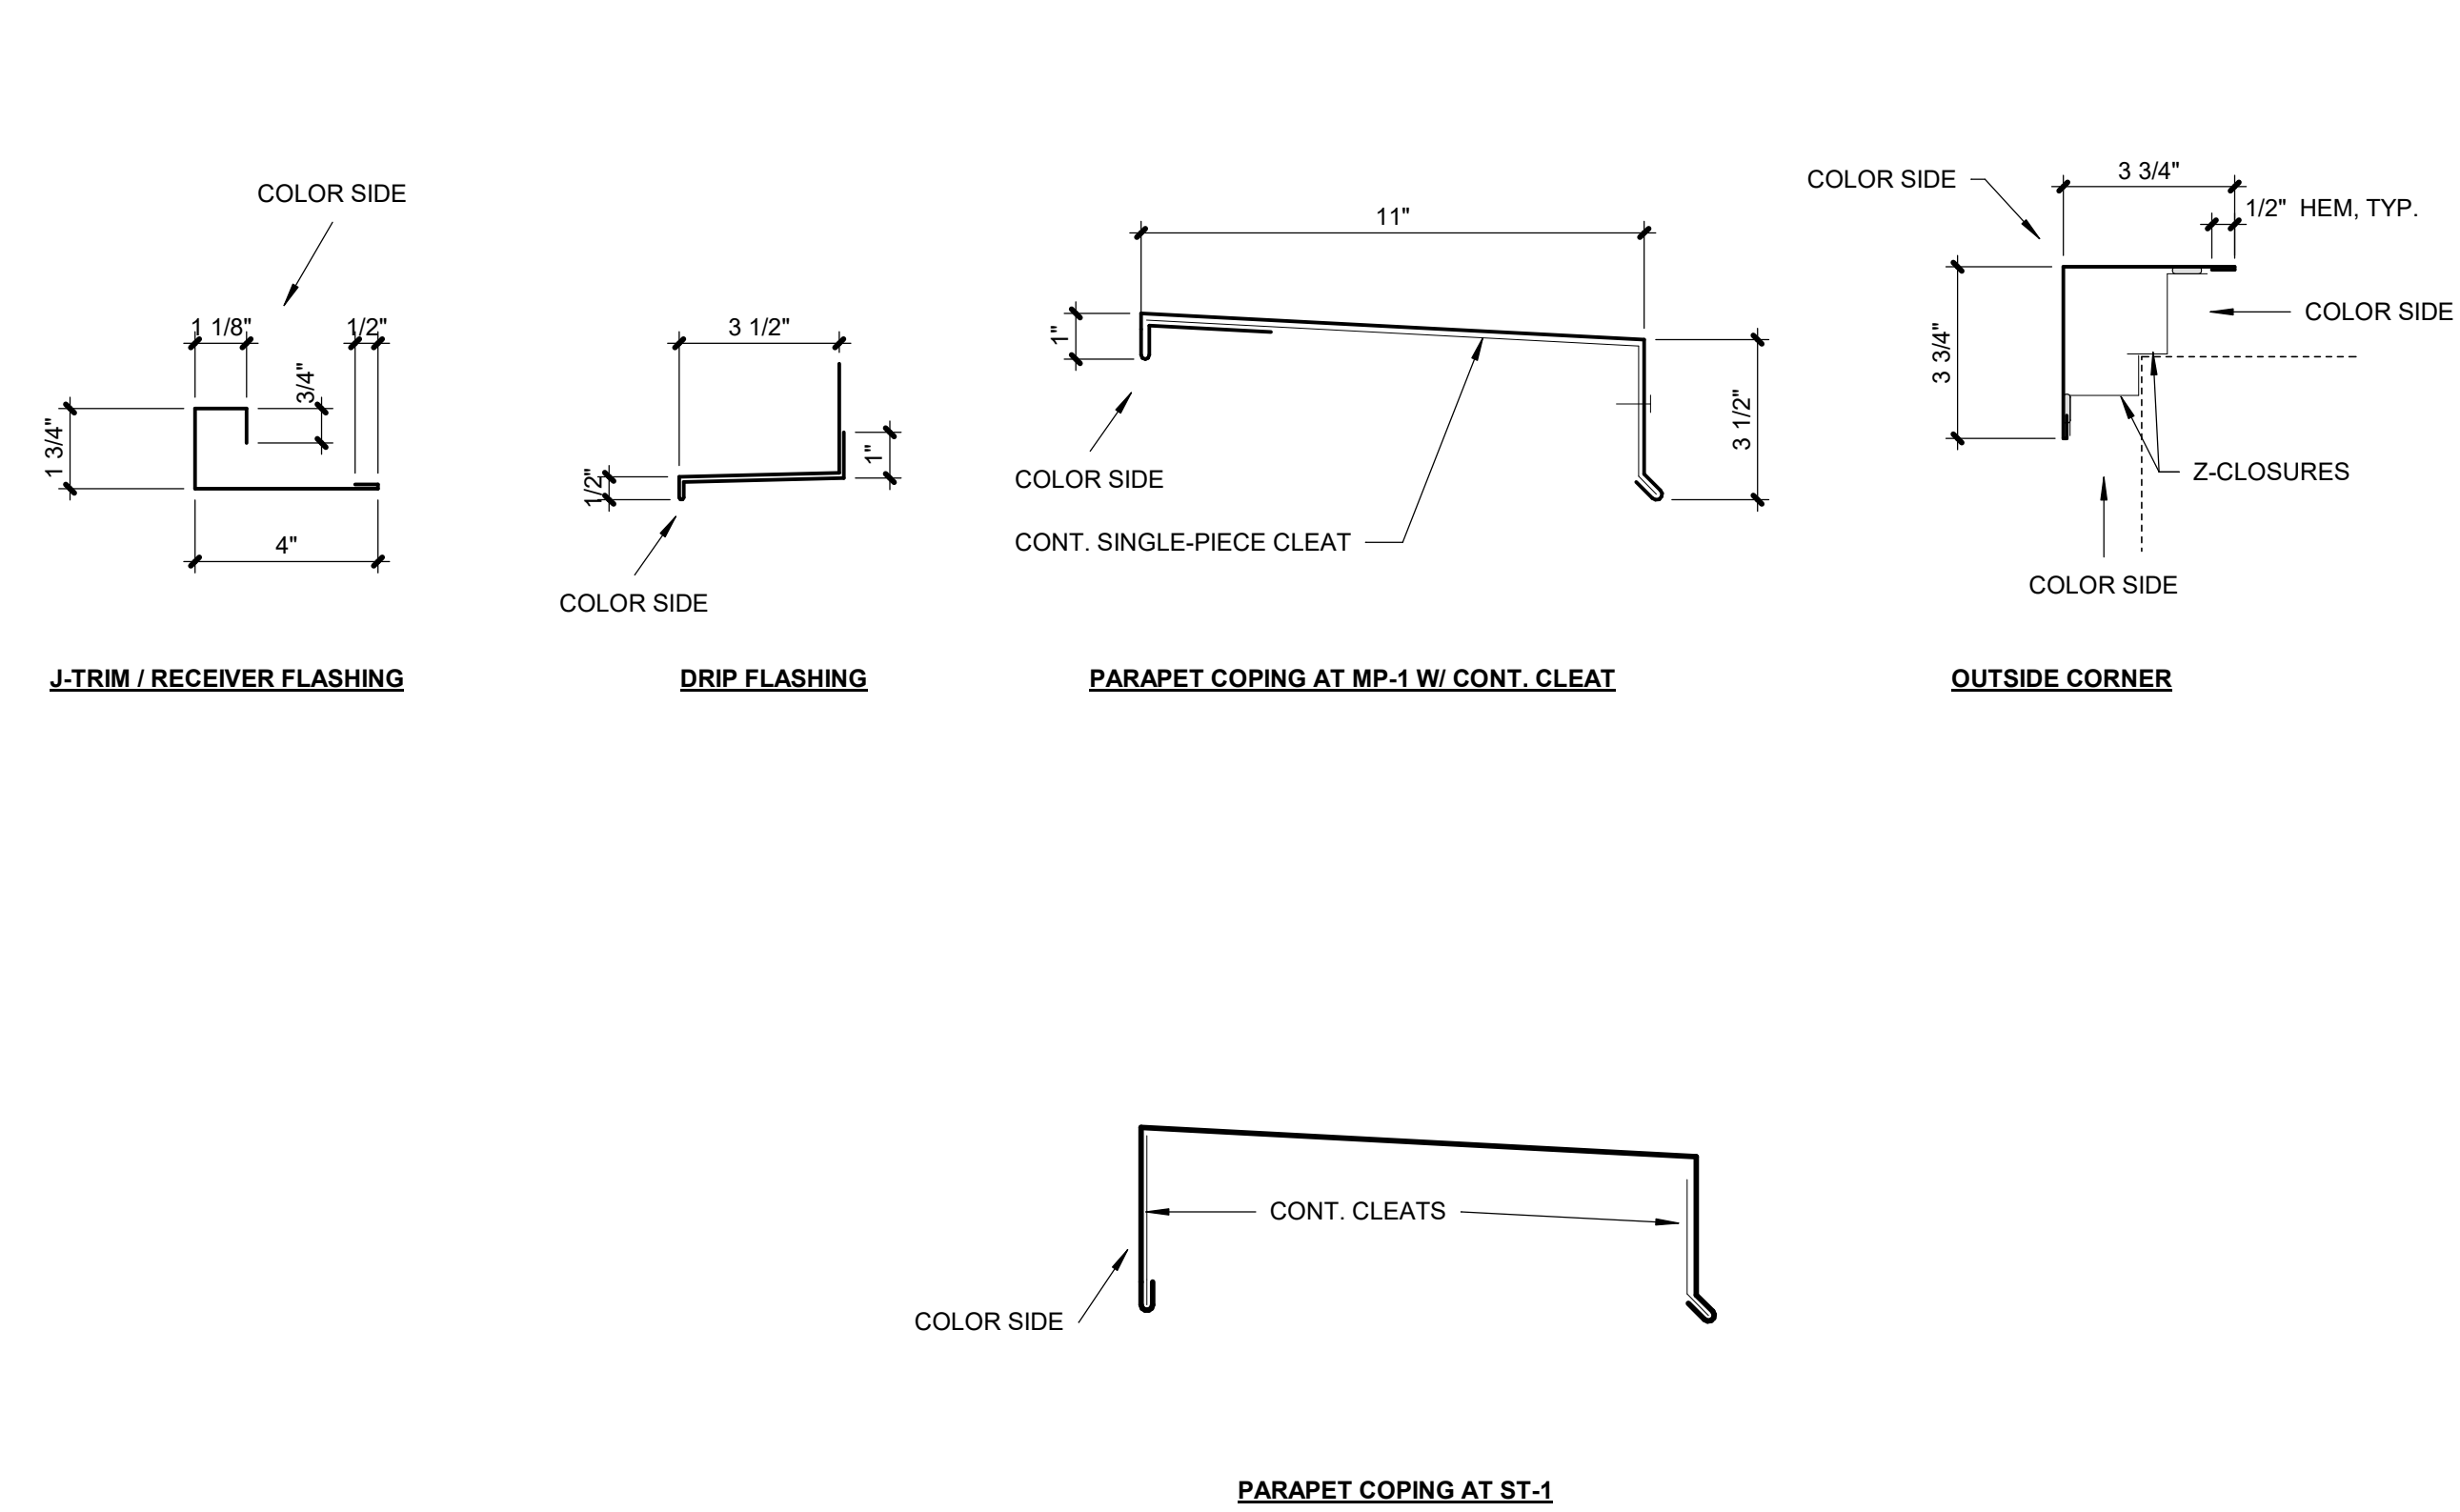

	DOOR				FRAME		RATING	DETAILS			HARDWARE	REMARKS	
	SIZE	TYPE	MAT.	TYPE	MAT.	JAMB		HEAD	SILL				
100A	8'-10"	8'-0"	1 3/4"	A3	AL	-	AL	-	11 & 18/A8.02	6/A7.01	3/A7.01	AL.5	
100B	6'-0"	8'-0"	1 3/4"	A4	AL	4	AL	-	1/A8.03	2/A8.03	-	AL.3	
100C	6'-0"	8'-0"	1 3/4"	A4	AL	4	AL	-	1/A8.03	2/A8.03	-	AL.3	
102A	3'-8"	8'-0"	MFR	MFR	MFR	MFR	MFR	-	6/A6.04	7/A6.04	MFR	MFR	ELEV
103A	3'-0"	8'-0"	1 3/4"	H3	HM	2	HM	-	3/A8.03	4/A8.03	-	LK.2	
103B	3'-0"	8'-0"	1 3/4"	H3	HM	2	HM	45 MIN.	3/8.03 SIM	4/8.03 SIM	-	LK.3	(5)
104A	3'-9"	8'-0"	1 3/4"	A3	AL	-	AL	-	18/A8.02	6/A7.01	3/A7.01	AL.1	
105A	3'-0"	8'-0"	1 3/4"	A1	AL	3	AL	-	7/A8.02	8/A8.02	3/A7.01	AL.1	
106A	3'-0"	8'-0"	1 3/4"	H3	HM	2	HM	-	3/A8.03	4/A8.03	-	LK.9	
107A	4'-0"	8'-0"	1 3/4"	H1	HM	1	HM	-	3/A8.02	4/A8.02	17/A8.02	EL.2	(4)
108A	3'-0"	8'-0"	1 3/4"	A1	AL	-	AL	-	9/A8.02	6/A7.01	3/A7.01	AL.1	
108B	3'-0"	8'-0"	1 3/4"	A1	AL	3	AL	-	9 & 18/A8.02	6/A7.01	3/A7.01	AL.1	
109A	3'-0"	8'-0"	1 3/4"	A1	AL	3	AL	-	7/A8.02	8/A8.02	3/A7.01	AL.1	
110A	3'-0"	8'-0"	1 3/4"	H3	HM	2	HM	-	3/A8.03	4/A8.03	-	LK.9	
111A	3'-0"	8'-0"	1 3/4"	A1	AL	3	AL	-	7/A8.02	8/A8.02	3/A7.01	AL.2	
112A	4'-0"	8'-0"	1 3/4"	H1	HM	1	HM	-	3/A8.02	4/A8.02	17/A8.02	EL.2	(4)
113A	4'-0"	8'-0"	1 3/4"	H1	HM	6	HM	-	7/A0.07	10/A0.07	-	EL.1	
114A	3'-0"	7'-0"	1 3/4"	H1	HM	7	HM	-	12/A8.03	13/A8.03	17/A8.02	EL.1	
114B	16'-0"	9'-4"	MFR.	O1	MFR	-	-	-	13/A0.06	8/A0.06	10/A0.06	-	
114C	16'-0"	9'-4"	MFR.	O1	MFR	-	-	-	13/A0.06	8/A0.06	10/A0.06	-	
201A	3'-6"	8'-0"	MFR	MFR	MFR	MFR	MFR	-	6/A6.04	7/A6.04	MFR	MFR	ELEV
203A	3'-0"	8'-0"	1 3/4"	W1	WD	2	HM	-	3/A8.03	4/A8.03	-	LK.9	(4)
205A	3'-0"	8'-0"	1 3/4"	W1	WD	2	HM	-	3/A8.03	4/A8.03	-	LK.1	
206A	3'-0"	8'-0"	1 3/4"	W1	WD	2	HM	-	3/A8.03	4/A8.03	-	PP.1	(2)
206B	2'-8"	8'-0"	1 3/4"	L1	HPDL	5	STL	--	7/A8.03	9/A8.03	-	LK.11	(3)
206C	3'-0"	8'-0"	1 3/4"	L1	HPDL	5	STL	--	11/A8.03	9/A8.03	-	LK.11	(3)
207A	3'-0"	8'-0"	1 3/4"	W1	WD	2	HM	-	3/A8.03	4/A8.03	-	PP.1	(2)
207B	2'-8"	8'-0"	1 3/4"	L1	HPDL	5	STL	--	7/A8.03	9/A8.03	-	LK.11	(3)
207C	2'-8"	8'-0"	1 3/4"	L1	HPDL	5	STL	--	7/A8.03	9/A8.03	-	LK.11	(3)
207D	2'-8"	8'-0"	1 3/4"	L1	HPDL	5	STL	--	7/A8.03	9/A8.03	-	LK.11	(3)
207.E	3'-0"	8'-0"	1 3/4"	L1	HPDL	5	STL	--	11/A8.03	9/A8.03	-	LK.11	(3)
209A	3'-0"	8'-0"	1 3/4"	W1	WD	2	HM	-	3/A8.03	4/A8.03	-	LA.2	
211A	3'-0"	8'-0"	1 3/4"	W1	WD	2	HM	-	3/A8.03	4/A8.03	-	LA.2	

- (1) ACCESS CONTROL DOORS WITH PANIC HARDWARE: PROVIDE APPROVED ENTRANCE AND EGRESS ACCESS CONTROL SYSTEM, LISTED IN ACCORDANCE WITH UL 294 AND INSTALLED IN COMPLIANCE WITH CRITERIA 1 THROUGH 7 IN SECTION 1010.1.9.9 OF IBC 2018
- (2) PROVIDE 16" X 34" KICK PLATE
- (3) UNDERCUT DOOR 1"
- (4) PROVIDE PANIC EGRESS HARDWARE AS REQ'D PER 2017 NEC ARTICLE 110.26 (C).
- (5) CONFIRM RATED DOOR REQ'TS W/ ELEVATOR MFR.

FOR ALL DOORS NOT LOCATED ON PLAN

6" 3'-0" 1'-0" IF DOOR HAS A CLOSER AND LATCH


32" CLEAR MIN.

PUSH SIDE

PULL SIDE


1'-6"

GL	-	GLASS
HM	-	HOLLOW METAL
WD	-	WOOD
STL	-	STEEL
AL	-	ALUMINUM
MFR	-	PER MANUFACTURER
POLY	-	POLYETHYLENE
P	-	POLYCARBONATE
HPDL	-	HIGH PRESSURE DECORATIVE LAMINATE

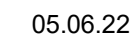

## SHEET NUMBER

# A8.01

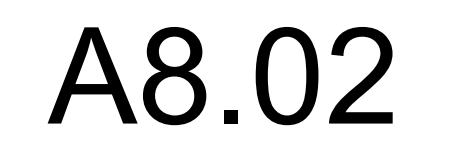

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ALL TRANSITIONS ARE TO BE ADA COMPLIANT, 1/2" MAXIMUM CHANGE IN ELEVATION



**FLOOR FINISHES** REFERENCE FLOOR PLAN FOR LOCATION OF FLOOR FINISH TRANSITIONS & PATTERN.

- **FTL-1:** MFR: ENGINEERED STONE, COLLECTION: STONE PROJECT, COLOR: WHITE CONTRAFOLDA NATURAL, SIZE: 24"x47" 98660R; SEE FINISH PLANS FOR INSTALLATION PATTERN; GROUT: MAPEL, ULTRACOLOR PLUS, COLOR 02 PEWTER
- **FTL-2:** MFR: ENGINEERED STONE, COLLECTION: STONE PROJECT, COLOR: WHITE CONTRAFOLDA NATURAL, SIZE: 8"x47" 82660R. SEE FINISH PLANS FOR INSTALLATION PATTERN; GROUT: MAPEL, ULTRACOLOR PLUS, COLOR 02 PEWTER
- **FTL-3:** MFR: ENGINEERED STONE, COLLECTION: STONE PROJECT, COLOR: WHITE CONTRAFOLDA NATURAL, SIZE: 12"x24" BULLNOSE GRADINO STAIR TREAD 70660R; GROUT: MAPEL, ULTRACOLOR PLUS, COLOR 02 PEWTER
- **FTL-4:** MFR: ENGINEERED STONE, COLLECTION: STONE PROJECT, COLOR: BLACK CONTRAFOLDA NATURAL, SIZE: 12"x24" 63660R; SEE FINISH PLANS FOR INSTALLATION PATTERN; GROUT: MAPEL, ULTRACOLOR PLUS, COLOR 10 BLACK

- **CON-1: CONCRETE FLOOR W/ ASHFORD FORMULA SEALER WITH METZGER/MCGUIRE RE 88 SEMI-RIGID POLYUREA OR EQUAL FLOOR JOINT FILLER.**

REFERENCE ROOM FINISH DESIGNATIONS ON FLOOR PLAN & INTERIOR ELEVATIONS FOR BASE FINISH LOCATIONS & TRANSITIONS.

- **RB-01:** MFR: ROPPE, SIZE: 4" COVE, COLOR: 123 CHARCOAL, ROLL GOODS ONLY

- **TB-01:** MFR: ERGON ENGINEERED STONE, COLLECTION: STONE PROJECT, COLOR: WHITE  
CONTROFALDA NAT. RETT., SIZE: 3"x24" 88660R

ALL GYPSUM BOARD WALLS PERPENDICULAR TO EXTERIOR WALL WITH WINDOWS TO RECEIVE PAINT ARE TO HAVE A LEVEL 5 DRYWALL FINISH.

- **PT-01:** SHERWIN WILLIAMS, WHITE HERON, SW7627, EGGSHELL LATEX COATING
- **PT-02:** SHERWIN WILLIAMS, IRON ORE, SW7069, EGGSHELL LATEX COATING
- **PT-03:** SHERWIN WILLIAMS, WORLDLY GRAY, SW7043, SEMI-GLOSS LATEX COATING
- **PT-04:** SHERWIN WILLIAMS, GRIFFIN, SW7026, SEMI-GLOSS LATEX COATING

- **EPT-01:** SHERWIN WILLIAMS, WHITE HERON, SW7627, SEMI-GLOSS EPOXY COATING

- **FRP-01:** PANOLAM FRP, COLOR GRAY, PROVIDE COLOR MATCHED SEAM TREATMENTS AND MOLDINGS

**WTL: PORCELAIN TILE W 1/8" MAX GROUT JOINTS, INSTALL PER TCNA AND MANUFACTURER'S GUIDELINES**

- **WTL-01:** MFR: STONE PEAK, COLOR: WHITE PLANE HONED USH3030087, SIZE: 30"x30", STRAIGHT STACK PATTERN; GROUT: MAPEI ULTRACOLOR PLUS, COLOR 01 ALABASTER

• **WTL-02:** MFR: ERGON ENGINEERED STONE, COLLECTION: STONE PROJECT, COLOR: BLACK CONTROFALDA NATURAL  
SIZE: 8"x47" 82669R; SEE ELEVATIONS FOR INSTALLATION PATTERN; GROUT: MAPEI, ULTRACOLOR PLUS, COLOR 10 BLACK

- **WTL-03:** MFR: ERGON ENGINEERED STONE, COLLECTION: STONE PROJECT, COLOR: BLACK CONTROFALDA NATURAL, SIZE: 12"x24" 63669R; SEE ELEVATIONS FOR INSTALLATION PATTERN; GROUT: MAPEI, ULTRACOLOR PLUS, COLOR 10 BLACK
- **WTL-04:** MFR: ERGON ENGINEERED STONE, COLLECTION: STONE PROJECT, COLOR: WHITE CONTROFALDA NATURAL, SIZE: 8"x47" 82660R; SEE ELEVATIONS FOR INSTALLATION PATTERN; GROUT: MAPEI, ULTRACOLOR PLUS, COLOR 02 PEWTER

LAM: PLASTIC LAMINATE

LAM: PLASTIC LAMINATE

- **LAM-01:** MFR: WILSONART, COLOR: WALNUT HEIGHTS 7965K-12 (SOFT GRAIN FINISH WITH AEON SCRATCH RESISTANCE)

**ST:** NATURAL STONE

- **ST-01:** 2CM BLUE PEARL QUARTZ, SEAL WITH PENETRATING SEALER

**S REFERENCE REFLECTED CEILING PLAN(S) FOR CEILING FINISH LOCATIONS & TRANSITIONS**

**GB:** GYPSUM WALLBOARD W/ FLAT FINISH ACRYLIC LATEX PAINT - 2 FINISH COATS OVER PRIMER

- **GB-01:** SHERWIN WILLIAMS SW 7007 "CEILING BRIGHT WHITE"

**EXP:** EXPOSED CEILING WITH PAINTED DECK, STRUCTURE AND DUCTS

- **EXP-01:** SHERWIN WILLIAMS, WATERBORNE ACRYLIC DRYFALL, COLOR SW 6258 TRICORN BLACK

1. ROOM FINISH SCHEDULE IS FOR GENERAL COORDINATION OF FINISHES. REFERENCE ROOM FINISH PLANS, INTERIOR ELEVATIONS AND REFLECTED CEILING PLANS FOR COORDINATION OF ALL FINAL FINISHES.
2. WHERE MULTIPLE FINISHES ARE INDICATED ON ANY SURFACE REFER TO THE DRAWINGS FOR EXTENT OF EACH FINISH.
3. STOP WALL / CEILING PAINT COLORS AND FINISH MATERIAL CHANGES AT INSIDE CORNERS, UNLESS NOTED OTHERWISE.
4. ALCOVES AND CLOSETS WITHOUT A ROOM IDENTIFICATION NUMBER SHALL HAVE THE SAME FINISHES AS THE ADJOINING SPACE.
5. ALL FLOOR FINISHES TRANSITIONING AT DOORWAYS SHALL BE CENTERED ON THE CLOSED DOOR, UNLESS NOTED OTHERWISE.
6. WHERE NO BASE IS INDICATED CONTINUE WALL FINISH TO FLOOR.
7. CONTINUE WALL AND FLOOR FINISH AS SCHEDULED BEHIND OR UNDER OPEN MILLWORK / CASEWORK WHEN WALL OR FLOOR IS EXPOSED TO VIEW, UNLESS NOTED OTHERWISE.
8. SOFFITS TO BE PAINTED TO MATCH GB-1 UNLESS NOTED OTHERWISE.
9. ALL EXPOSED DUCTWORK, ELECTRICAL CONDUIT, PLUMBING SUPPLY, WASTE OR VENTING AND ALL OTHER PIPING SHALL BE PAINTED TO MATCH ADJACENT WALL OR CEILING FINISH, UNLESS NOTED OTHERWISE.
10. ALL MECHANICAL GRILLES, ACCESS PANELS, RECESSED SPEAKERS (IF APPROVED BY MANUFACTURER), AND OTHER MECHANICAL PANELS SHALL BE PAINTED TO MATCH ADJACENT SURFACES UNLESS FACTORY FINISH OR OTHER COLOR IS SPECIFIED. CONCEALED SPRINKLER HEADS TO BE PROVIDED WITH FACTORY-APPLIED FINISH TO MATCH ADJACENT FINISH, UNLESS NOTED OTHERWISE.
11. TILE INDICATED ON WALLS IS TO BE FULL HEIGHT, UNLESS NOTED OTHERWISE.
12. ALIGN FLOOR AND WALL TILE JOINTS, UNLESS NOTED OTHERWISE.
13. PAINT ALL HOLLOW METAL DOORS AND FRAMES W/ 2 COATS OF SEMI-GLOSS, ACRYLIC LATEX PAINT TO MATCH ADJACENT WALL, U.N.O.
14. DOOR FRAME FINISH TRANSITIONS SHALL BE AT THE INSIDE CORNER OF THE STOP ON THE DOOR SIDE.
15. DUAL FINISH DOORS SHALL HAVE MATCHING FRONT FACE AND STRIKE EDGE AND MATCHING BACK FACE AND HINGE EDGE.
16. REFER TO FLOOR TRANSITION DETAILS WHERE DISSIMILAR FLOOR MATERIALS MEET.
17. ALL GYPSUM BOARD WALLS, SOFFITS AND CEILINGS PERPENDICULAR TO EXTERIOR WALL WITH WINDOWS TO RECEIVE PAINT ARE TO HAVE A LEVEL 5 DRYWALL FINISH.
18. WINDOW COVERINGS ARE NOT IN CORE AND SHELL SCOPE. FUTURE WINDOW COVERINGS ARE BY TENANT AND MUST FOLLOW DESIGN GUIDELINES.

ROOM		FLOOR	BASE	WALLS				MILLWORK		REMARKS
NO.	NAME			N	E	S	W	CEILING	TOP	
100	VESTIBULE	FTL-01 / FTL-02	TB-01	PT-01	PT-01	PT-01	PT-01	GB-01	-	-
101	LOBBY	FTL-01 / FTL-02	TB-01	PT-01	PT-01	PT-01 / WTL-02	PT-01	GB-01	-	1, 6, 7, 11, 12, 13
102	ELEV	FTL-02	-	-	-	-	-	-	-	3
103	ELECT./IT	CON-01	RB-01	PT-01	PT-01	-	PT-01	-	-	-
104	FUTURE TENANT	-	-	-	-	-	-	-	-	2
105	WEST VESTIBULE	CON-01	RB-01	PT-01	PT-01	PT-01	PT-01	GB-01	-	-
106	WEST STAIR	CON-01	RB-01	PT-01	PT-01	PT-01	PT-01	EXP-01	-	9
107	ELECTRICAL	CON-01	RB-01	PT-01	PT-01	PT-01	PT-01	-	-	-
108	FUTURE TENANT	-	-	-	-	-	-	-	-	2
109	EAST VESTIBULE	CON-01	RB-01	PT-01	PT-01	PT-01	PT-01	GB-01	-	-
110	EAST STAIR	CON-01	RB-01	PT-01	PT-01	PT-01	PT-01	EXP-01	-	9
111	FIRE RISER ROOM	CON-01	RB-01	EPT-01	EPT-01	EPT-01	EPT-01	-	-	-
112	ELECTRICAL	CON-01	RB-01	PT-01	PT-01	PT-01	PT-01	-	-	-
113	METER ENCLOSURE	-	-	-	-	-	-	-	-	(14)
200	LOBBY	FTL-01 / FTL-02	TB-01	PT-01	PT-01	PT-01 / PT-02 / WTL-02	PT-01	EXP-01	-	1, 6, 7, 11, 12
201	ELEV	FTL-02	-	-	-	-	-	-	-	3
202	HALL	FTL-01 / FTL-02	TB-01	-	PT-02 / WTL-02	PT-01	PT-01 / WTL-04	GB-01	-	1, 12
203	ELECTRICAL/ TELECOM	CON-01	RB-01	PT-01	PT-01	PT-01	PT-01	-	-	-
205	JANITOR	CON-01	RB-01	FRP-01 / EPT-01	FRP-01 / EPT-01	FRP-01 / EPT-01	FRP-01 / EPT-01	GB-01	-	4
206	MENS RR	FTL-04	-	WTL-01	WTL-01	WTL-01	WTL-01	ST-01	-	1, 5, 10
207	WOMENS RR	FTL-04	-	WTL-01 / WTL-03	WTL-01	WTL-01	WTL-01	ST-01	-	1, 5, 10
208	FUTURE OFFICE TENANT WEST	-	-	-	-	-	-	-	-	2, 8
209	WEST STAIR	CON-01	RB-01	PT-01	PT-01	PT-01	PT-01	EXP-01	-	2, 8
210	FUTURE OFFICE TENANT EAST	-	-	-	-	-	-	-	-	2, 8
211	EAST STAIR	CON-01	RB-01	PT-01	PT-01	PT-01	PT-01	GB-01	-	9

- (1) REF. INTERIOR ELEVATIONS AND FINISH PLANS FOR ADDITIONAL INFORMATION ON FINISH LOCATIONS.
- (2) INTERIOR FINISHES BY FUTURE TENANT.
- (3) REF. ELEVATOR TRIM PACKAGE BASIS OF DESIGN ON SHEET A6.04
- (4) PROVIDE FRP TO 8'-0" ON ALL WALLS.
- (5) LAMINATE (LAM-1) PANELS ON FRONT WALL OF TOILET "ROOMS". REFERENCE FINISH PLANS AND ELEVATIONS.
- (6) PAINT EXPOSED STEEL STAIR STRINGER PT-03
- (7) STAIR LANDINGS TO BE FTL-1. STAIR TREADS TO BE FTL-3. STAIR RISERS TO BE FTL-2.
- (8) ACOUSTICAL CEILING SOFFIT IN SECOND LEVEL "FUTURE TENANT" SPACES PER RCP.
- (9) PAINT EXPOSED STEEL AND HANDRAILS PT-02
- (10) UNFINISHED EXPOSED WALL TILE EDGES TO RECEIVE ANODIZED ALUMINUM TRIM EQUAL TO SCHLUTER - JOLLY, FINISH SATIN NICKEL
- (11) UNFINISHED EXPOSED WALL TILE EDGES TO RECEIVE ANODIZED ALUMINUM TRIM EQUAL TO SCHLUTER - JOLLY, FINISH BRUSHED GRAPHIT
- (12) REF. FINISH PLANS FOR FLOOR PATTERN
- (13) CONCRETE CURB UNDER STAIR TO BE TILED USING FTL-02. FLOOR INSIDE CURB TO BE FTL-01/FTL-02 PATTERN. REFERENCE FINISH PLAN.
- (14) REF. SHEET A0.07 FOR METER ENCLOSURE FINISHES.

ARCHITECT FINKLE+WILLIAMS  
ARCHITECTURE

CIVIL                      GBA

LANDSCAPE LAND 3

FOUNDATIONS      BSE STRUCTURAL

STRUCTURAL      BSE STRUCTURAL  
ENGINEERS

PLUMBING HENDERSON  
ENGINEERS

MECHANICAL HENDERSON  
ENGINEERSELECTRICAL HENDERSON  
ENGINEERS

FIRE PROTECTION HENDERSON  
ENGINEERS

CONTRACTOR      FOGEL-ANDERSON



8787 RENNER BLVD., SUITE 100  
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SHEET TITLE


## FINISH SCHEDULE AND DETAILS

SHEET NUMBER



## A8.10



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<b>A9.01</b>	SCALE : 1/8" = 1'-0"
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1. SUSPENDED ACOUSTICAL TILE NOTE: NO CEILING EDGE TILE IS TO BE UNDER 6" WIDE. USE MATCHING STYLE 2'x4' CEILING TILE CUT TO THE PERIMETER SIZE AS NEEDED.
2. NO BUILDING ELEMENTS SHALL BE CONNECTED TO OR SUSPENDED FROM DUCTWORK. ALL MATERIALS SHALL BE INDEPENDENTLY SUPPORTED FROM STRUCTURE.
3. FIRE SPRINKLER NOTE: PROVIDE VICTAULIC FLEXIBLE HOSE ASSEMBLIES FOR ALL SUSPENDED ACOUSTICAL TILE CEILINGS. CENTER WHITE SPRINKLERS AND HEADS IN THE 2'x2' CEILING TILE.

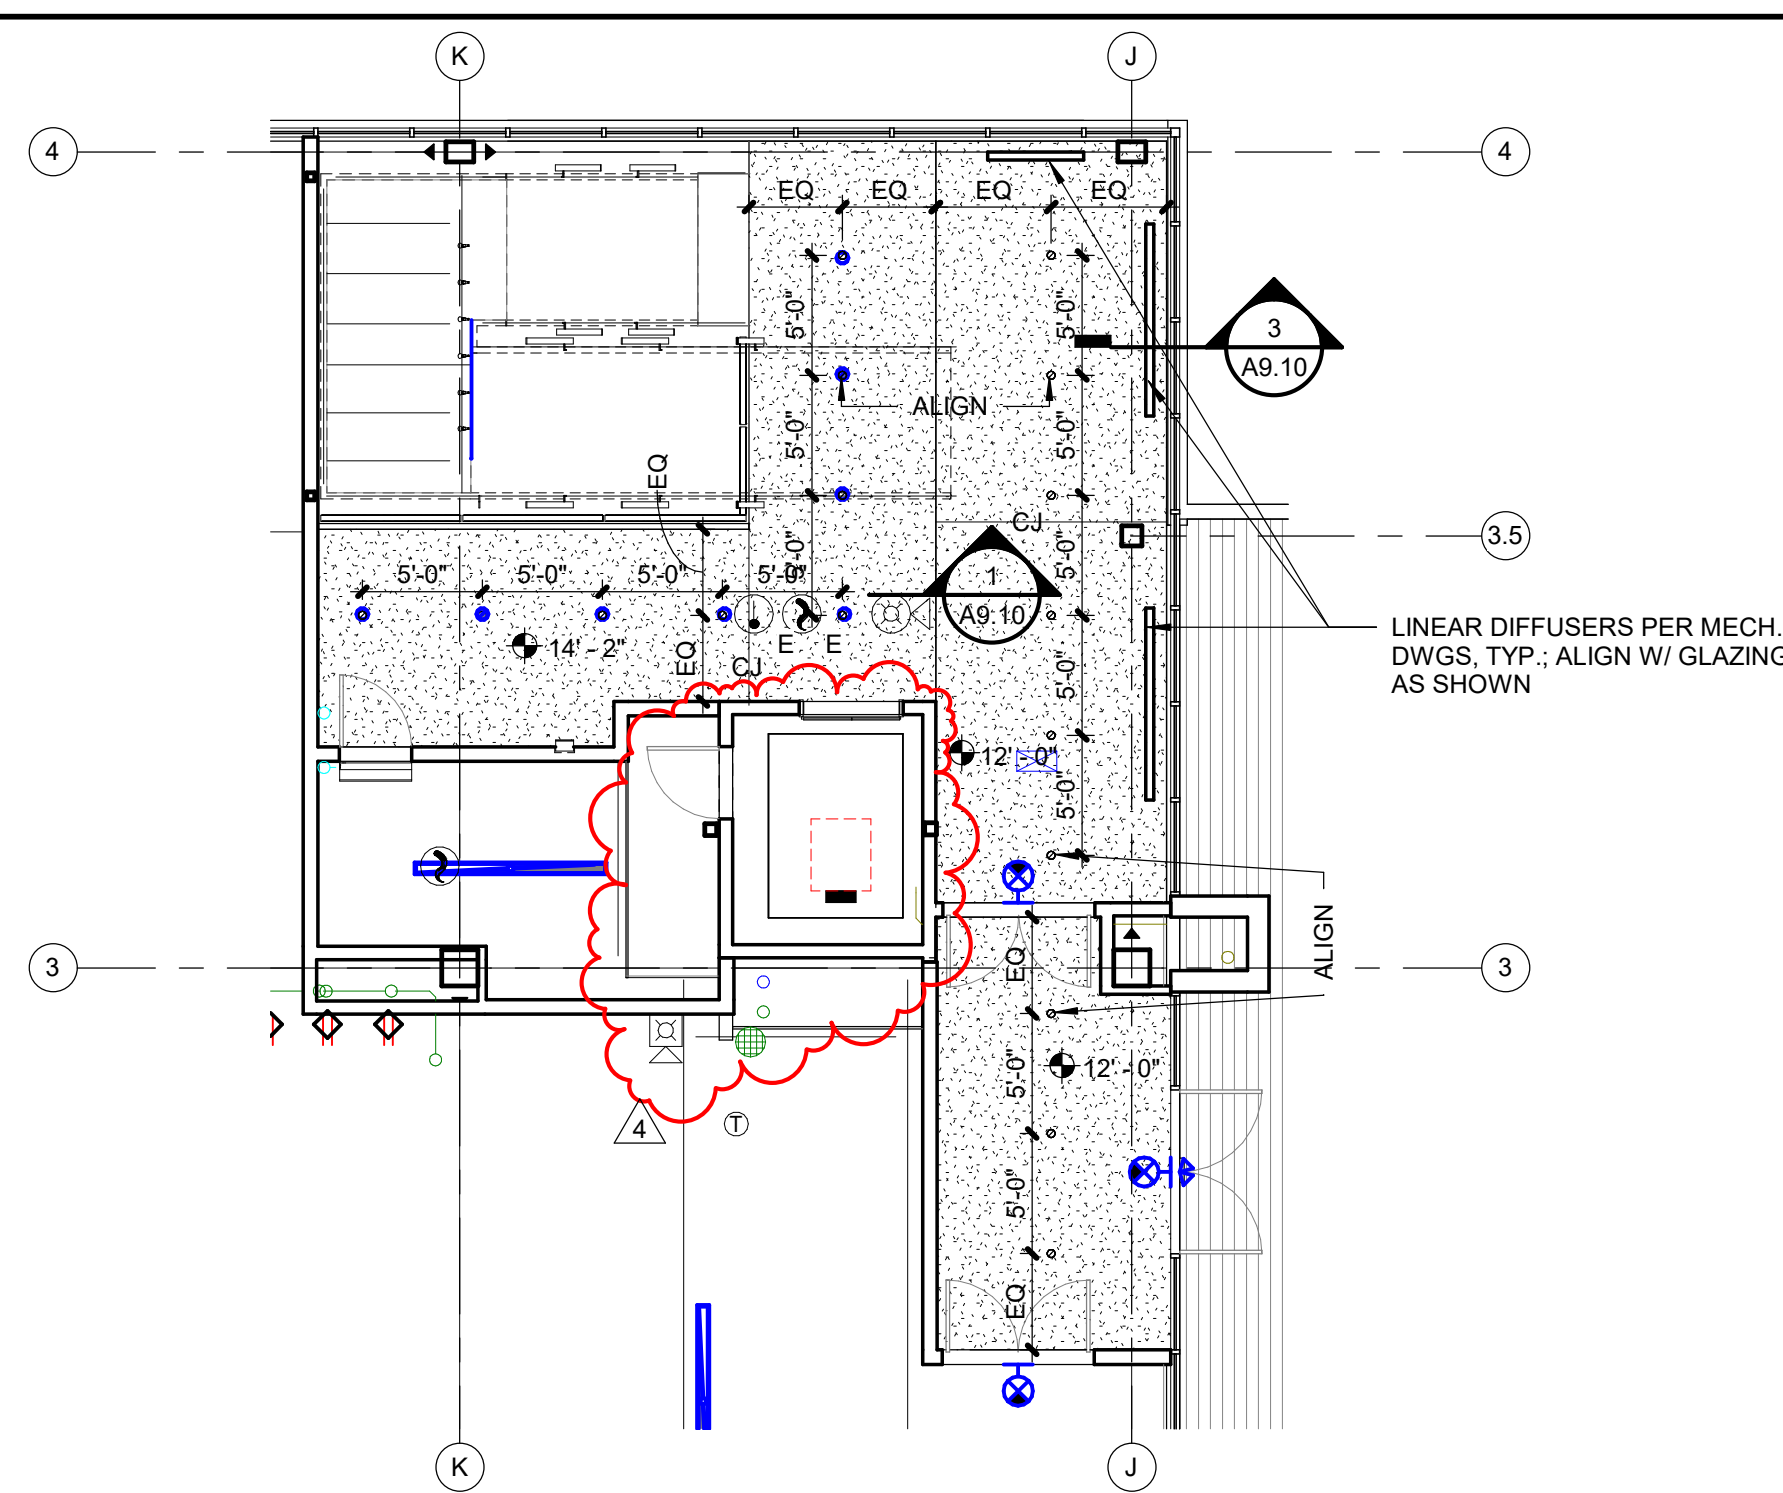	FLAT FINISH ACRYLIC LATEX PAINT ON GYPSUM WALLBOARD, 2 FINISH COATS OVER PRIMER.
	2x2' SUSPENDED ACOUSTICAL CEILING. REFERENCE FINISH SCHEDULE FOR TYPE.
	2x4' SUSPENDED ACOUSTICAL CEILING. REFERENCE FINISH SCHEDULE FOR TYPE.
	2x4' DIRECT INDIRECT LIGHT TROFFER PER ELECTRICAL DRAWINGS
	2x2' DIRECT INDIRECT LIGHT TROFFER PER ELECTRICAL DRAWINGS
	LINEAR DIRECT LED PER ELECTRICAL DRAWINGS
	4' STRIP FIXTURE WITH STEEL HOUSING PER ELECTRICAL DRAWINGS
	LED CAN LIGHT FIXTURE PER ELECTRICAL DRAWINGS
	LINEAR PENDANT LIGHT FIXTURE PER ELECTRICAL DRAWINGS
	PENDANT LIGHT FIXTURE PER ELECTRICAL DRAWINGS
	SUPPLY AIR DIFFUSER PER MECHANICAL DRAWINGS
	RETURN AIR DIFFUSER PER MECHANICAL DRAWINGS
	LINEAR SLOT DIFFUSER PER MECHANICAL
	24"x24" DRYWALL INLAY ACCESS PANEL WITH MUD IN FLANGE AND FULLY DETACHABLE HATCH, PAINTED TO MATCH CEILING



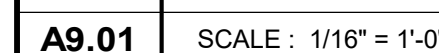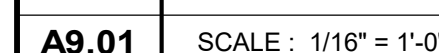





[illegible]

## PROJECT TEAM

ARCHITECT	FINKLE+WILLIAMS ARCHITECTURE
CIVIL	GBA
LANDSCAPE	LAND 3
FOUNDATIONS	BSE STRUCTURAL ENGINEERS
STRUCTURAL	BSE STRUCTURAL ENGINEERS
PLUMBING	HENDERSON ENGINEERS
MECHANICAL	HENDERSON ENGINEERS
ELECTRICAL	HENDERSON ENGINEERS
FIRE PROTECTION	HENDERSON ENGINEERS
CONTRACTOR	FOGEL-ANDERSON



## PROJECT SPECIFICATIONS

A11.12