






PROJECT TEAM

LAKEVIEW SELF STORAGE - LEE'S SUMMIT, MO


PROJECT NAME:	LAKEVIEW SELF STORAGE	BASE ALLOWABLE BUILDING AREA: 52,500 S.F. PER STORY (FULLY-SPRINKLED, MULTISTORY)
PROJECT LOCATION: -	4101 NE PORT DRIVE LEE'S SUMMIT, MISSOURI	ACTUAL FLOOR AREAS: ————————————————————————————————————
PROJECT OWNERSHIP:		ST FLOOR - GROUP S-1, B = 34,375 S.F. (OK) 2ND FLOOR - GROUP S-1 = 33,284 S.F. (OK) 3RD FLOOR - GROUP S-1 = 34,426 S.F. (OK)
		OCCUPANT LOAD FACTORS: ————————————————————————————————————
ARCHITECT:	HERNLY ASSOCIATES, INC. IIOO RHODE ISLAND ST. LAWRENCE, KANSAS 66044 P. 785-749-5806 F. 785-749-1515	OCCUPANT LOADS: ————————————————————————————————————
GENERAL CONTRACTOR:	STRICKLAND CONSTRUCTION T20 S. ROGERS ROAD, SUITE B OLATHE, KANSAS 66062 P. 913-764-7000 F. 913-768-8425	RETAIL/OFFICE: FIRST FLOOR = 1200/150 = 8 = 211 TOTAL
BUILDING INSPECTION DEPT:	DEVELOPMENT SERVICES 220 SE GREEN LEE'S SUMMIT, MO 64063 816-969-1200	EGRESS REQUIREMENTS: ————————————————————————————————————
CODES/REGULATIONS UTILIZED:	2018 International Building Code 2018 International Mechanical Code 2017 National Electrical Code 2018 Uniform Plumbing Code 2018 International Fire Code 2012 International Energy Conservation Code ICC/ANSI AII7.I - 2009 Accessibility and Usability Code	EGRESS WIDTH REQ: IST - 75 O.L. x O.15" = 11.25" EGRESS WIDTH PROVIDED: 176" (OK) 2ND - 67 O.L. x O.15" = 10.1" EGRESS WIDTH PROVIDED: 140" (OK) 3RD - 69 O.L. x O.20" = 13.8 EGRESS WIDTH PROVIDED: 72" (OK)
CONSTRUCTION:	— METAL STUDS, STEEL DECK/ CONCRETE TOPPING, METAL PANEL, MASONRY VENEER	MAX. ALLOWABLE TRAVEL DISTANCE: - = 250 FEET
CONSTRUCTION TYPE:	TYPE II-B - FULLY SPRINKLED THREE FLOOR SELF STORAGE FACILITY W/ OFFICE	ACTUAL MAX. TRAVEL DISTANCE: FIRST FLOOR SECOND FLOOR THIRD FLOOR REV: 2023/01/03
OCCUPANCY GROUPS:	SELF STORAGE - GROUP S-I OFFICE/RETAIL - GROUP B	MIN. PLUMBING FIXTURE REQ'S (WHOLE BLDG): TOTAL OCC (S-I & B): 2II: 106 MEN, 106 WOMEN FIXTURES REQUIRED FOR STORAGE & OFFICE OCC: = I FIX:50 MEN OCC. = 3 FIXTURE
OCCUPANCY SEPARATIONS:	NONE REQUIRED	= 1 FIX:50 HEN OCC. = 3 FIXTURES = 1 FIX:50 WOMEN OCC. = 3 FIXTURES = 1 SERVICE SINK
FIRE RESISTANCE RATINGS:	STRUCTURAL FRAME = 0 BEARING WALLS = 0 PARTITIONS = 0 FLOOR CONSTRUCTION = 0 ROOF CONSTRUCTION = 0 CORRIDORS = 0 SHAFT CONSTRUCTION = 1-HOUR	FIXTURES PROVIDED: = 3 WC AND LAV FIXTURES FOR MEN (OK) = 3 WC AND LAV FIXTURES FOR WOMEN (OK) = 1 SERVICE SINK (OK)
DESIGN LOADS:	ROOF LIVE LOAD: 20 PSF ROOF DEAD LOAD: 7 PSF WIND SPEED: 115 MPH REV: 2023/02/10	SPECIAL INSPECTIONS REQUIRED: VERIFICATION OF SOILS PLACEMENT OF REINFORCING STEEL TESTING OF REINFORCED CONCRETE BOLTS INSTALLED IN CONCRETE
FIRE SAFETY:		STRUCTURAL MASONRY STEEL FRAME INSPECTION
AUTOMATIC FIRE SPRINKLER THROUGHOUT FIRE ALARM SYSTEM & SMOKE DETECTION FIRE EXTINGUISHERS		This project has been designed by this office for compliance with applicable laws, codes and ordinances including the ADA Title III guidelines. Since the requirements of these regulations are subject to various and possibly contradictory interpretations, reasonable professional efforts have been used
EMERGENCY/EXIT LIGHTING —	PER ELEC. DRAWINGS	to interpret applicable requirements. No warranty or guarantee is given that the project complies with all interpretations as they apply to the project.
SAFETY GLAZING ————————————————————————————————————	—— PROVIDE SAFETY GLAZING IN DOORS AND FIXED PANELS ADJACENT TO DOORS COMPLYING WITH 2003 IBC CHAPTER 24	

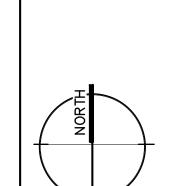

LOCATION MAP

ARCHITECTUR	RAL SET REV: 2023/01/03
COVER	CODE INFORMATION, LOCATION PLAN
A1.1	CODE PLANS (1-3)
A1.2	FIRE RATED DETAILS, CODE DETAILS
A2.1	FIRST FLOOR PLAN
A2.2	SECOND FLOOR PLAN
A2.3	THIRD FLOOR PLAN
A2.4	PLAN DETAILS
A2.5	PLAN DETAILS
A2.6	INTERIOR ELEVATIONS
A2.7	PLAN DETAILS
A3.1	ELEVATIONS
A3.2	ELEVATIONS
A4.1	WALL SECTIONS
A4.2	WALL SECTIONS
A4.3	WALL SECTIONS
A4.4	WALL SECTIONS
A4.5	WALL SECTIONS
A4.6	WALL SECTIONS
A4.7	WALL SECTIONS
A4.8	WALL SECTIONS
A4.9	WALL SECTIONS
A4.10	WALL SECTIONS
A4.11	WALL SECTIONS
A4.12	WALL SECTION DETAILS
A4.13	WALL SECTION DETAILS
A5.1	ROOF PLAN & ROOF DETAILS
A6.1	FINISH & DOOR SCHEDULES
A6.2	WINDOW SCHEDULE
F1.1	FOUNDATION PLAN
F1.2	FOUNDATION DETAILS
- 4 0	

..FOUNDATION DETAILS

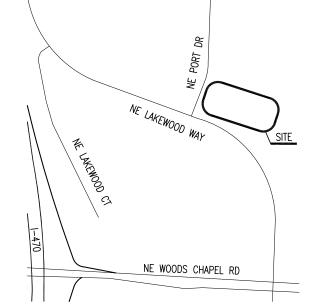



3-STORY, 75 FEET (FULLY SPRINKLED)


3-STORY, 38'-2" (OK)

ALLOWABLE BUILDING HEIGHT:

CODE INFORMATION


ACTUAL BUILDING HEIGHT:

SHEET INDEX

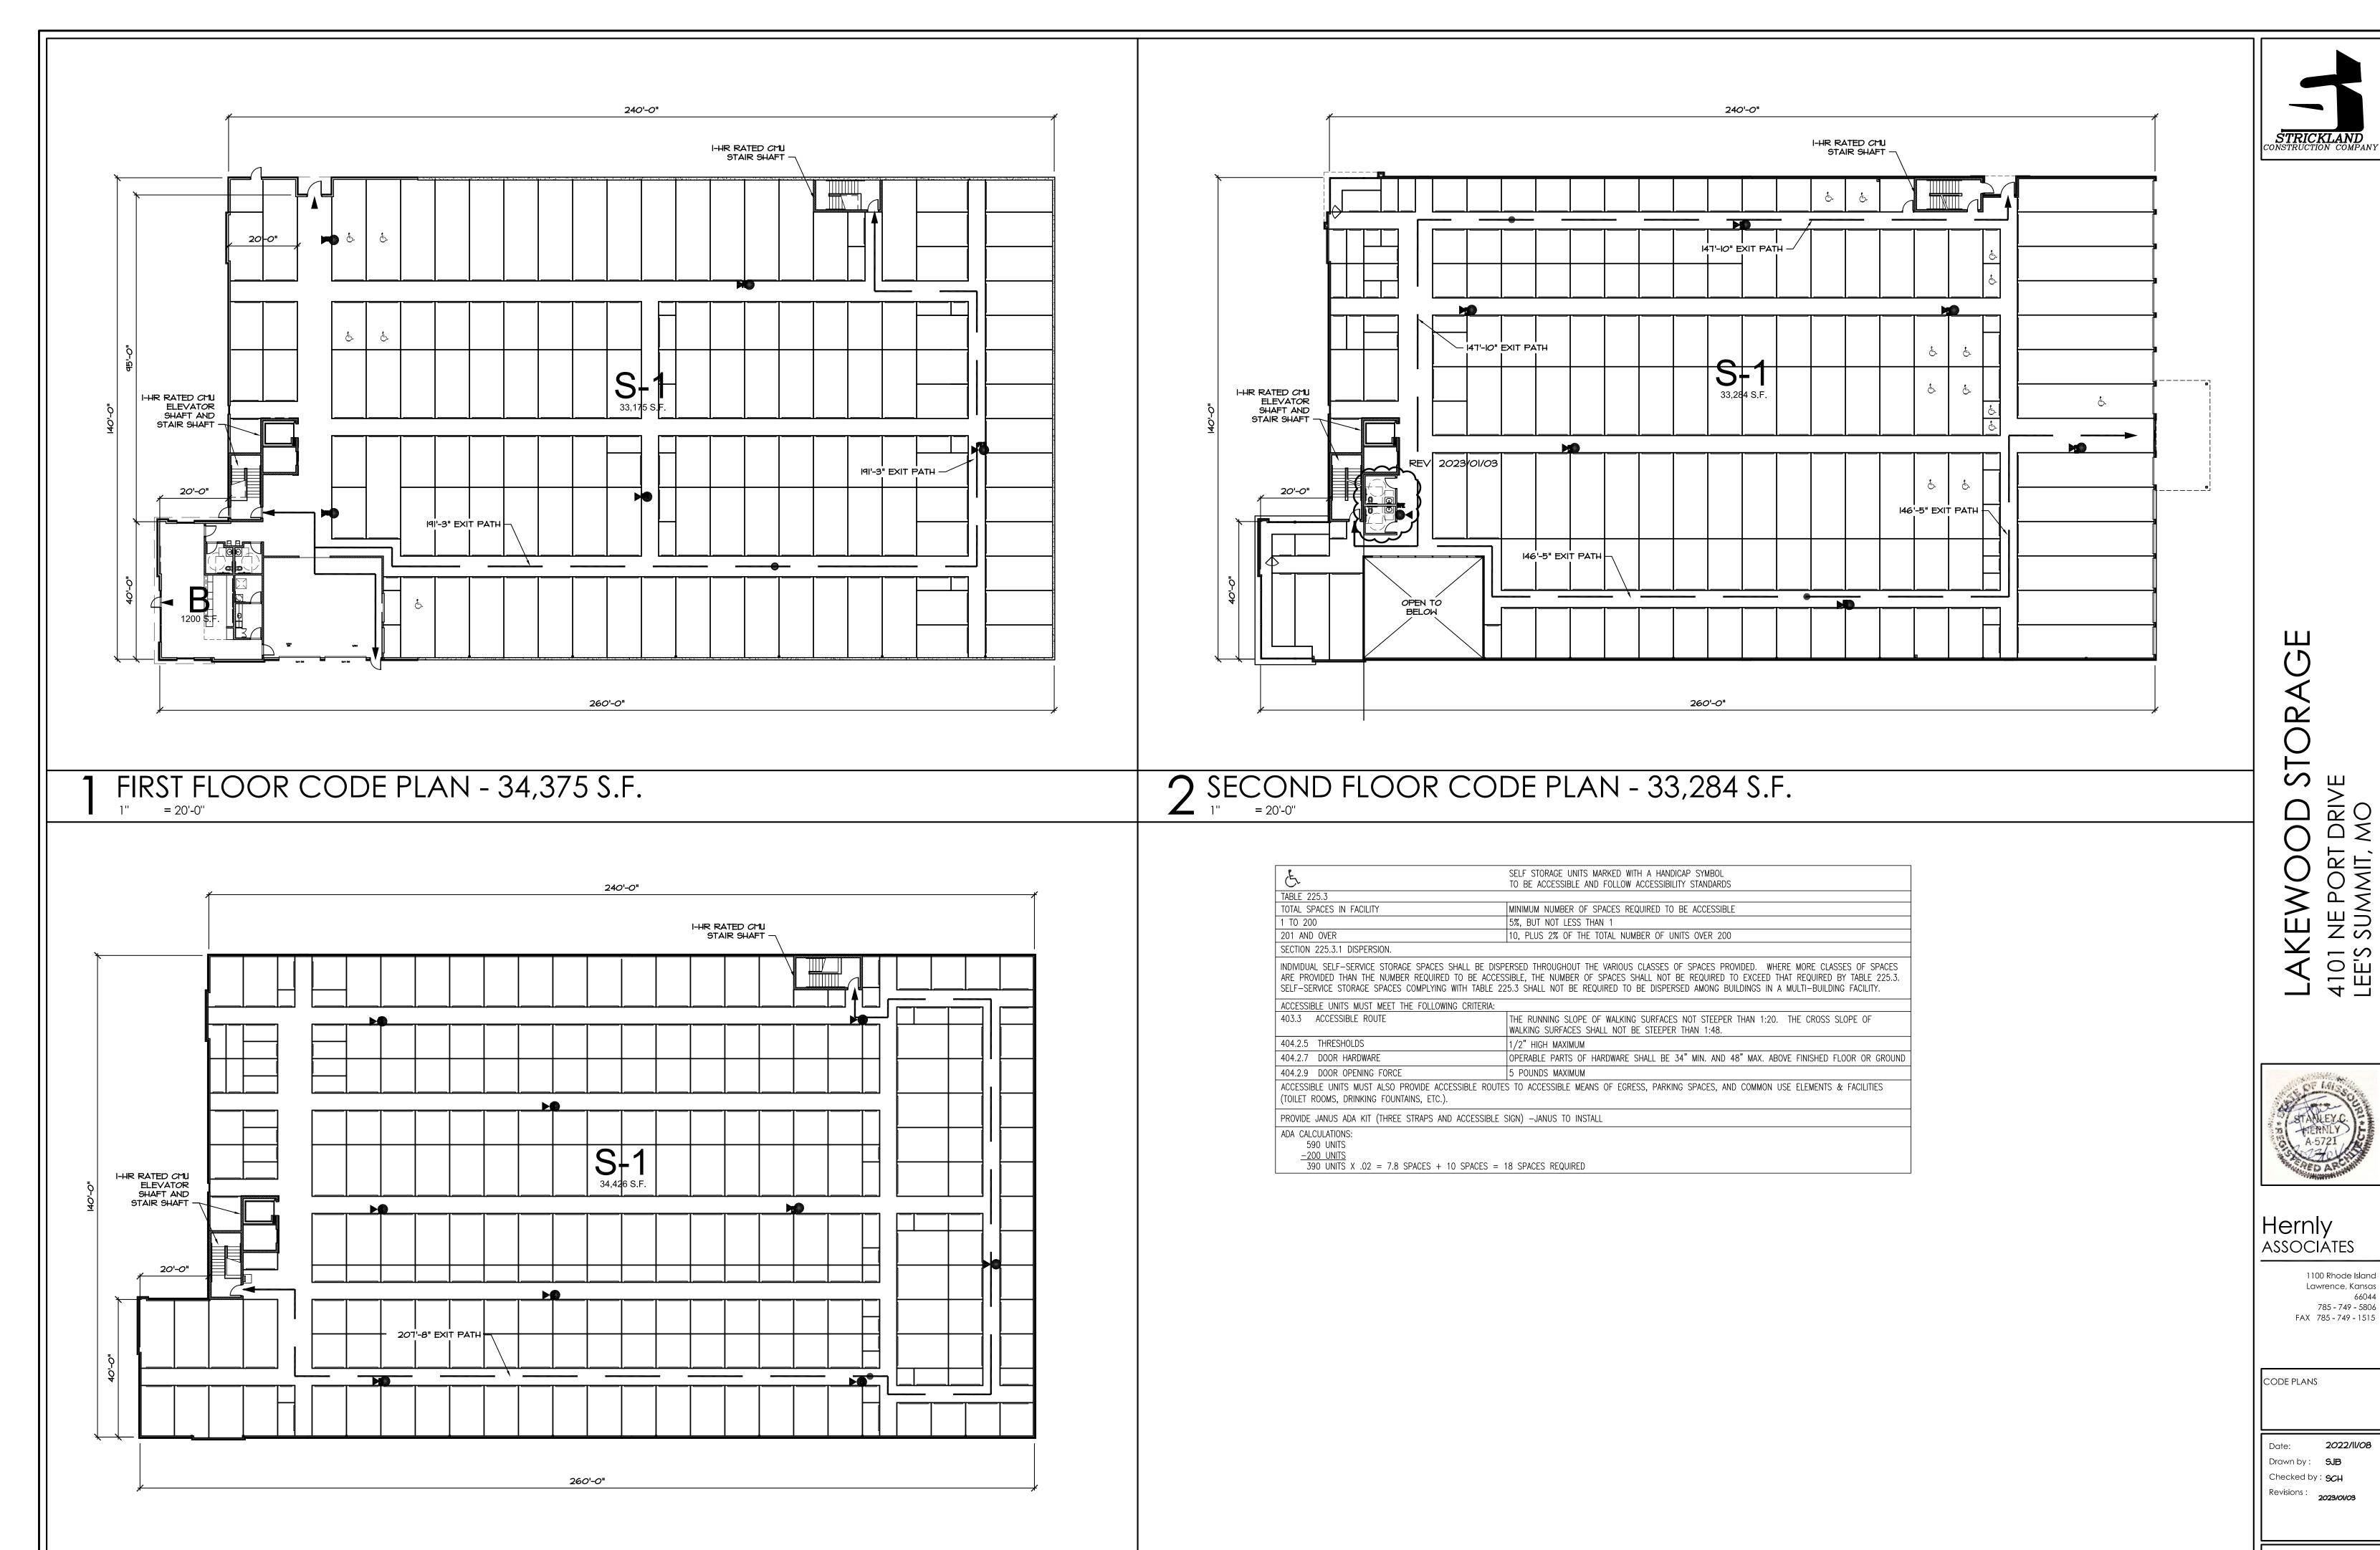

THIRD FLOOR CODE PLAN - 34,426 S.F.

A1.

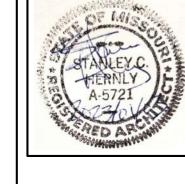




1100 Rhode Island Lawrence, Kansas 785 - 749 - 5806 FAX 785 - 749 - 1515

CODE DETAILS FIRE DETAILS

2022/11/08 Drawn by: SJB Checked by: **SCH** Revisions:

2023/01/03

CONCRETE MASONRY UNITS, MORTAR - UL DESIGN NO. U904 BEARING WALL RATING: 3 HR. - NONBEARING WALL RATING: 3 HR.

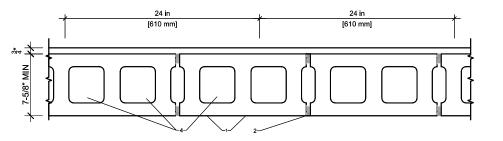


* Indicates such products shall bear the UL Certification Mark for jurisdictions employing the UL Certification.


- 1. Concrete Blocks* Various designs. Classification C-3 (3 hr.)
- 2. Mortar Blocks laid in full bed of mortar, nom. § in. thick, of not less than 2-1/4 and not more the 3-1/2 parts of clean sharp sand to 1 part Portland cement (proportioned by volume) and not
- 3. Portland Cement Stucco or Gypsum Plaster Add $\frac{1}{2}$ hr to Classification if used. Attached to concrete

more than 50 percent hydrated lime (by cement volume). Vertical joints staggered.


4. Loose Masonry Fill - If all core spaces are filled with loose dry expanded slag, expanded clay or shale (Rotary Kiln Process), water repellant vermiculite masonry fill insulation, or silicone treated perlite loose fill insulation add 1 hr to Classification.


STAIR/ELEV SHAFT WALL (1-HR REQUIRED)

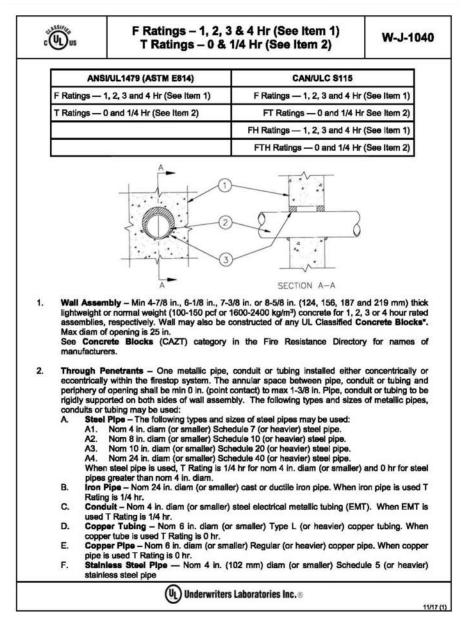

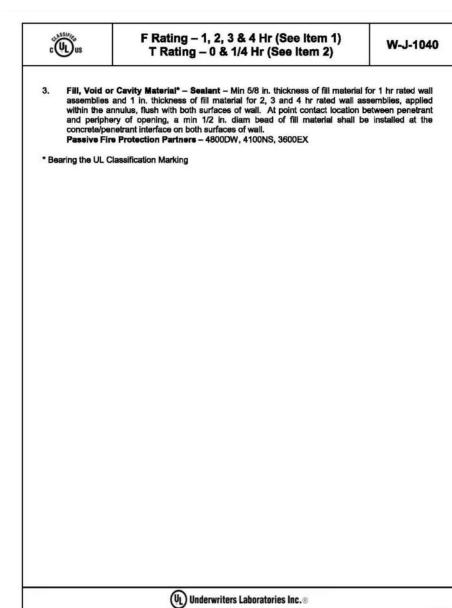

CMU PENETRATION

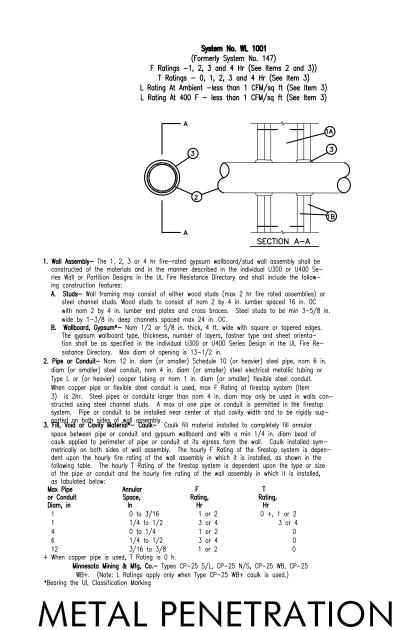

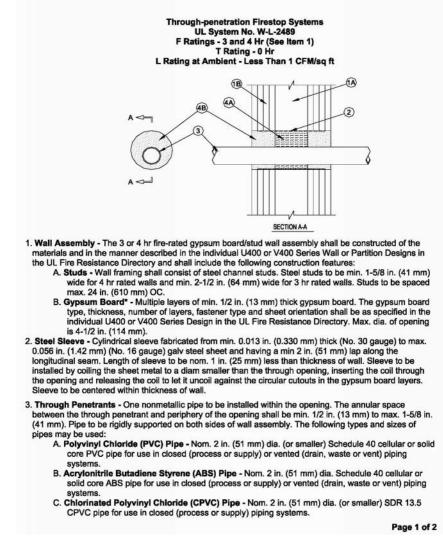

ADA STANDARD DETAILS

HINGE APPROACH PULL SIDE

36" MIN. IF 60" 42" MIN. IF 54"

2010 - ADA STANDARDS FOR ACCESSIBLE DESIGN

60" MIN. DIA.

WHEELCHAIR

TURNING RADIUS

TO HAVE 9" TOE

CLEARANCE AFF.

& LATCH

RECEPTACLE

FRONT APPROACH, PULL SIDE

NAPKIN DISPOSAL

WALKING PARALLEL TO A WALL

LATCHICLOSER

FRONT APPROACH, PUSH SIDE

HINGE APPROACH PUSH SIDE

NAPKIN DISPENSER

CLEAR WIDTH ANY

- CLEAR FLOOR SPACE AT FIXTURES CAN

-30" X 48" WHEELCHAIR CLEAR FLOOR SPACE

- DOOR SWING CAN SWING

INTO REQUIRED TURN

SPACE BUT NOT CLEAR

FLOOR SPACE FOR FIXTURES.

-FLUSH VALVE SHALL

BE INSTALLED ON WIDE SIDE OF T/R OR STALL

OVERLAP. FIXTURES CAN NOT OVERLAP INTO

CLEAR FLOOR SPACE OF ANOTHER FIXTURE.

MAX.

- FAUCETS SHALL BE OPERABLE W/ 1 HAND

AND SHALL NOT BE REQUIRE TIGHT GRASPING,

PINCHING, OR TWISTING OF THE WRIST. THE

FORCE REQUIRED TO ACTIVATE OPERABLE

- PROVIDE PIPE INSULATION

PARTS SHALL BE 5 POUNDS MAX.

TO HOT WATER & DRAIN LINES

- FLUSH VALVE SHALL

BE INSTALLED ON WIDE

SIDE OF T/R OR STALL

DOORS IN SERIES AND GATES IN SERIES

SOAP DISPENSER

HEIGHT: REACH DEPTH: 48" MAX. 20" MAX. 44" MAX. 20"-25" MAX.

HAND DRYER

LATCH APPROACH PULL SIDE

LANDING

*NOTE: SIGNS SHALL COMPLY WITH 2010

ADA STANDARDS FOR ACCESSIBLE DESIGN

MANAGER__

SURFACE OF RAMP

EDGE PROTECTION & HANDRAIL EXTENSIONS

BE 7" MIN. & 9" MAX. IN FRONT

OF THE WATER CLOSET. MEASURE

KNEE CLEAR

CLEAR FLOOR SPACE AT LAVATORIES

39"-41"

TO THE CENTERLINE OF THE DISPENSER

— MAINTAIN 1

CLEARANCE AT

GRAB BARS

THE OUTLET OF THE DISPENSER SHALL BE 15"

OF A TYPE THAT CONTROLS DELIVERY OR THAT

DOES NOT ALLOW CONTINUOUS PAPER FLOW.

60" MIN.

T-SHAPED TURNING SPACE

(TO SPOUT)

ON TACTILE

LATCH APPROACH PUSH SIDE

- CONTINUOUS HANDRAILS PROVIDED

' EDGE PROTECTION TO EXTEND TO END OF REQUIRED LANDING

ON BOTH SIDES OF RAMPS AT

SURFACES > 6" GROUND

LEVEL

LANDING


CHARACTERS

MIN. & 48" MAX. AFF. & SHALL NOT BE LOCATED BEHIND GRAB BARS. DISPENSERS SHALL NOT BE

PVC PENETRATION

FIRE RATED CONSTRUCTION DETAILS



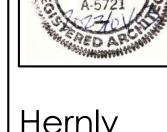

ASSOCIÁTES 1100 Rhode Island Lawrence, Kansas 785 - 749 - 5806

FAX 785 - 749 - 1515

1ST STORY PLAN

2022/11/08 Drawn by: SJB Checked by: **SCH**

Revisions : 2023/01/03

25'-0" 115'-Q" METAL STUD\$ OVER CONC. STEM WALL 20'-0" |TO F.F. | 50'+0" 8" CONCRETE STEM WALL TO 4" BELOW|F.F. 10X30 10X30 10X30 と **(** 0 0 10X14 10X14 10X14 CLEAR 10X20 10X20 0 **((** 0 **D** 10X24 10X24 10X24 10X24 10X24 10X24 10X24 10X24 10X24 1/A4.2 (OPEN TO ABOVE) A 142'-0" METAL STUDS OVER 8" CONC. STEM WALL 43'-0" 8" CONC. WALL TO 4" BELOW F.F. 1/A2.5 12|-0" 5'-0" 5'-0" 5'-0" 12'-0" 185'-0"_| 260'-0"

6	7	
PLAN	NORTH	

FLOOR PLAN I	EGEND	GEN
	METAL PARTITION SYSTEM (CORRIDOR SIDE OF PARTITION EXCEPT WHERE NOTED OTHERWISE) HALLWAYS TO BE JANUS CORRUGATED METAL PARTITIONS TYPREFER DETAIL 5/A6.1	1. IN PF 2. GI
	INSULATED METAL WALL PANEL -REF. ELEVATIONS SHEET FOR EXTENTS OF EXTERIOR FINISHES.	3. R
	GYP. BD. ON METAL STUD FRAMING -REFER PARTITION TYPES, SHEET A6.1	BY
	1-HOUR FIRE-RATED WALL @ STAIRS, ELEVATOR, AND FIRE RISER ROOM	4. GI RE CO
44.44.	8" CONCRETE STEM WALL	5. GI
	INSULATED METAL PARTITION SYSTEM REFER TO DETAIL SHEET 4/A6.1	6. AL
		FL OI
		7. N

ENERAL NOTES (TYPICAL ALL SHEETS)

INTERIOR AND EXTERIOR STORAGE UNIT SIGNAGE TO BE APPROVED BY OWNER. SIGNAGE TO BE

PROVIDED AND INSTALLED BY GENERAL CONTRACTOR.

GENERAL CONTRACTOR TO COORDINATE ALL FOUNDATION PENETRATIONS WITH STRUCTURAL ENGINEER. ROOF PANELS TO BE 60 MIL TPO ROOF TO MEET LOCAL WIND LOAD REQUIREMENTS ENGINEERED

BY METAL BUILDING MANUFACTURER. GENERAL CONTRACTOR/TPO ROOFING SUBCONTRACTOR TO SIZE/SPACE INTERNAL ROOF DRAINS AS

REQUIRED TO MEET LOCAL REQUIREMENTS. SECONDARY ROOF DRAINS TO BE PROVIDED. GENERAL CONTRACTOR TO COORDINATE CONNECTION TO UNDERGROUND STORM DRAIN.

GENERAL CONTRACTOR IS TO SUBMIT ALL SAMPLES OF PRODUCTS, ETC. TO OWNER FOR APPROVAL/ SELECTION OF ALL COLORS, FINISHES, ETC. PRIOR TO PURCHASE AND INSTALLATION

ALL EXTERIOR WALL DIMENSIONS ARE TO FOUNDATION (INCL. LUG) UNLESS NOTED OTHERWISE. 3RD FLOOR EXTERIOR WALL DIMENSIONS ARE TO FINISH MATERIAL. ALL INTERIOR DIMENSIONS ARE TO OUTER FACE OF MATERIAL USED UNLESS NOTED OTHERWISE.

NOT USED.

8. PROVIDE & INSTALL FIRE EXTINGUISHERS (FE) WALL CABINETS. RECESS CABINETS @ 48" A.F.F. RECESSED, FLUSH WITH WALL AT ALL INTERIOR APPLICATIONS. MOUNT TO PIERS, 48" A.F.F. IN HEAVY DUTY OUTDOORS FIRE EXTINGUISHER CABINET AT ALL EXTERIOR APPLICATIONS. LOCATE ONE CLASS 2-A FIRE EXTINGUISHER SO THAT MAX. TRAVEL DISTANCE IS 75 L.F. W/ A MINIMUM OF 1 FOR EVERY 11,250 S.F. PER TABLE 906.3(1) OF THE 2015 INTERNATIONAL FIRE CODE OR AS DIRECTED BY LOCAL AUTHORITIES HAVING JURISDICTION. (KEYED ON FLOOR PLANS)

FURR OUT WALL AT FE LOCATIONS W/ 6" METAL STUDS AND METAL WALL PANEL EACH SIDE.

9. FLOOR FINISH CONCRETE TO BE POLISHED CONCRETE IN CORRIDORS ONLY. (EXCLUDING STORAGE UNITS)

10. BUILDING MUST COMPLY W/ LOCAL AMERICAN W/ DISABILITIES ACT -REF. SHEET A2.6

11. FURR OUT WALL IN ELECTRICAL ROOMS TO RECESS ELECTRICAL PANEL.

12. ALL INTERIOR CMU TO BE PAINTED SW PRO CLASSIC B31 SERIES PAINT EXCLUDING INSIDE OF INDIVIDUAL STORAGE UNITS. ALL CMU INSIDE INDIVIDUAL STORAGE UNITS NOT TO BE PAINTED OR SEALED.

13. FIRE RISER ROOM TO HAVE 1—HR FIRE—RATED WALLS AND CEILING. REFER UL FIRE—RATED - ASSEMBLES, SHEET A1.3

14. GENERAL CONTRACTOR TO COORDINATE STANDPIPE/FIRE SPRINKLER DESIGN WITH ROOM SIZE AND

是	SELF STORAGE UNITS MARKED WITH A HANDICAP SYMBOL
5	TO BE ACCESSIBLE AND FOLLOW ACCESSIBILITY STANDARDS
TABLE 225.3	
TOTAL SPACES IN FACILITY	MINIMUM NUMBER OF SPACES REQUIRED TO BE ACCESSIBLE
1 TO 200	5%, BUT NOT LESS THAN 1
201 AND OVER	10, PLUS 2% OF THE TOTAL NUMBER OF UNITS OVER 200
SECTION 225.3.1 DISPERSION.	
INDIVIDUAL SELF-SERVICE STORAGE SPACES SHALL	L BE DISPERSED THROUGHOUT THE VARIOUS CLASSES OF SPACES PROVIDED. WHERE MORE CLASSES OF SPACES
ARE PROVIDED THAN THE NUMBER REQUIRED TO	BE ACCESSIBLE, THE NUMBER OF SPACES SHALL NOT BE REQUIRED TO EXCEED THAT REQUIRED BY TABLE 225.3.

SELF-SERVICE STORAGE SPACES COMPLYING WITH TABLE 225.3 SHALL NOT BE REQUIRED TO BE DISPERSED AMONG BUILDINGS IN A MULTI-BUILDING FACILITY. ACCESSIBLE UNITS MUST MEET THE FOLLOWING CRITERIA:

THE RUNNING SLOPE OF WALKING SURFACES NOT STEEPER THAN 1:20. THE CROSS SLOPE OF

WALKING SURFACES SHALL NOT BE STEEPER THAN 1:48. 404.2.5 THRESHOLDS /2" HIGH MAXIMUM 404.2.7 DOOR HARDWARE OPERABLE PARTS OF HARDWARE SHALL BE 34" MIN. AND 48" MAX. ABOVE FINISHED FLOOR OR GROUND 404.2.9 DOOR OPENING FORCE 5 POUNDS MAXIMUM

ACCESSIBLE UNITS MUST ALSO PROVIDE ACCESSIBLE ROUTES TO ACCESSIBLE MEANS OF EGRESS, PARKING SPACES, AND COMMON USE ELEMENTS & FACILITIES (TOILET ROOMS, DRINKING FOUNTAINS, ETC.).

PROVIDE JANUS ADA KIT (THREE STRAPS AND ACCESSIBLE SIGN) -JANUS TO INSTALL ADA CALCULATIONS: 590 UNITS

403.3 ACCESSIBLE ROUTE

 $\frac{-200 \text{ UNITS}}{390 \text{ UNITS}}$ X .02 = 7.8 SPACES + 10 SPACES = 18 SPACES REQUIRED

FIRST STORY PLAN

3/32" = 1'-0"






ASSOCIATES

1100 Rhode Island Lawrence, Kansas 785 - 749 - 5806 FAX 785 - 749 - 1515

2ND STORY PLAN

2022/11/08

Drawn by: SJB Checked by : **SCH** Revisions: 2023/01/03

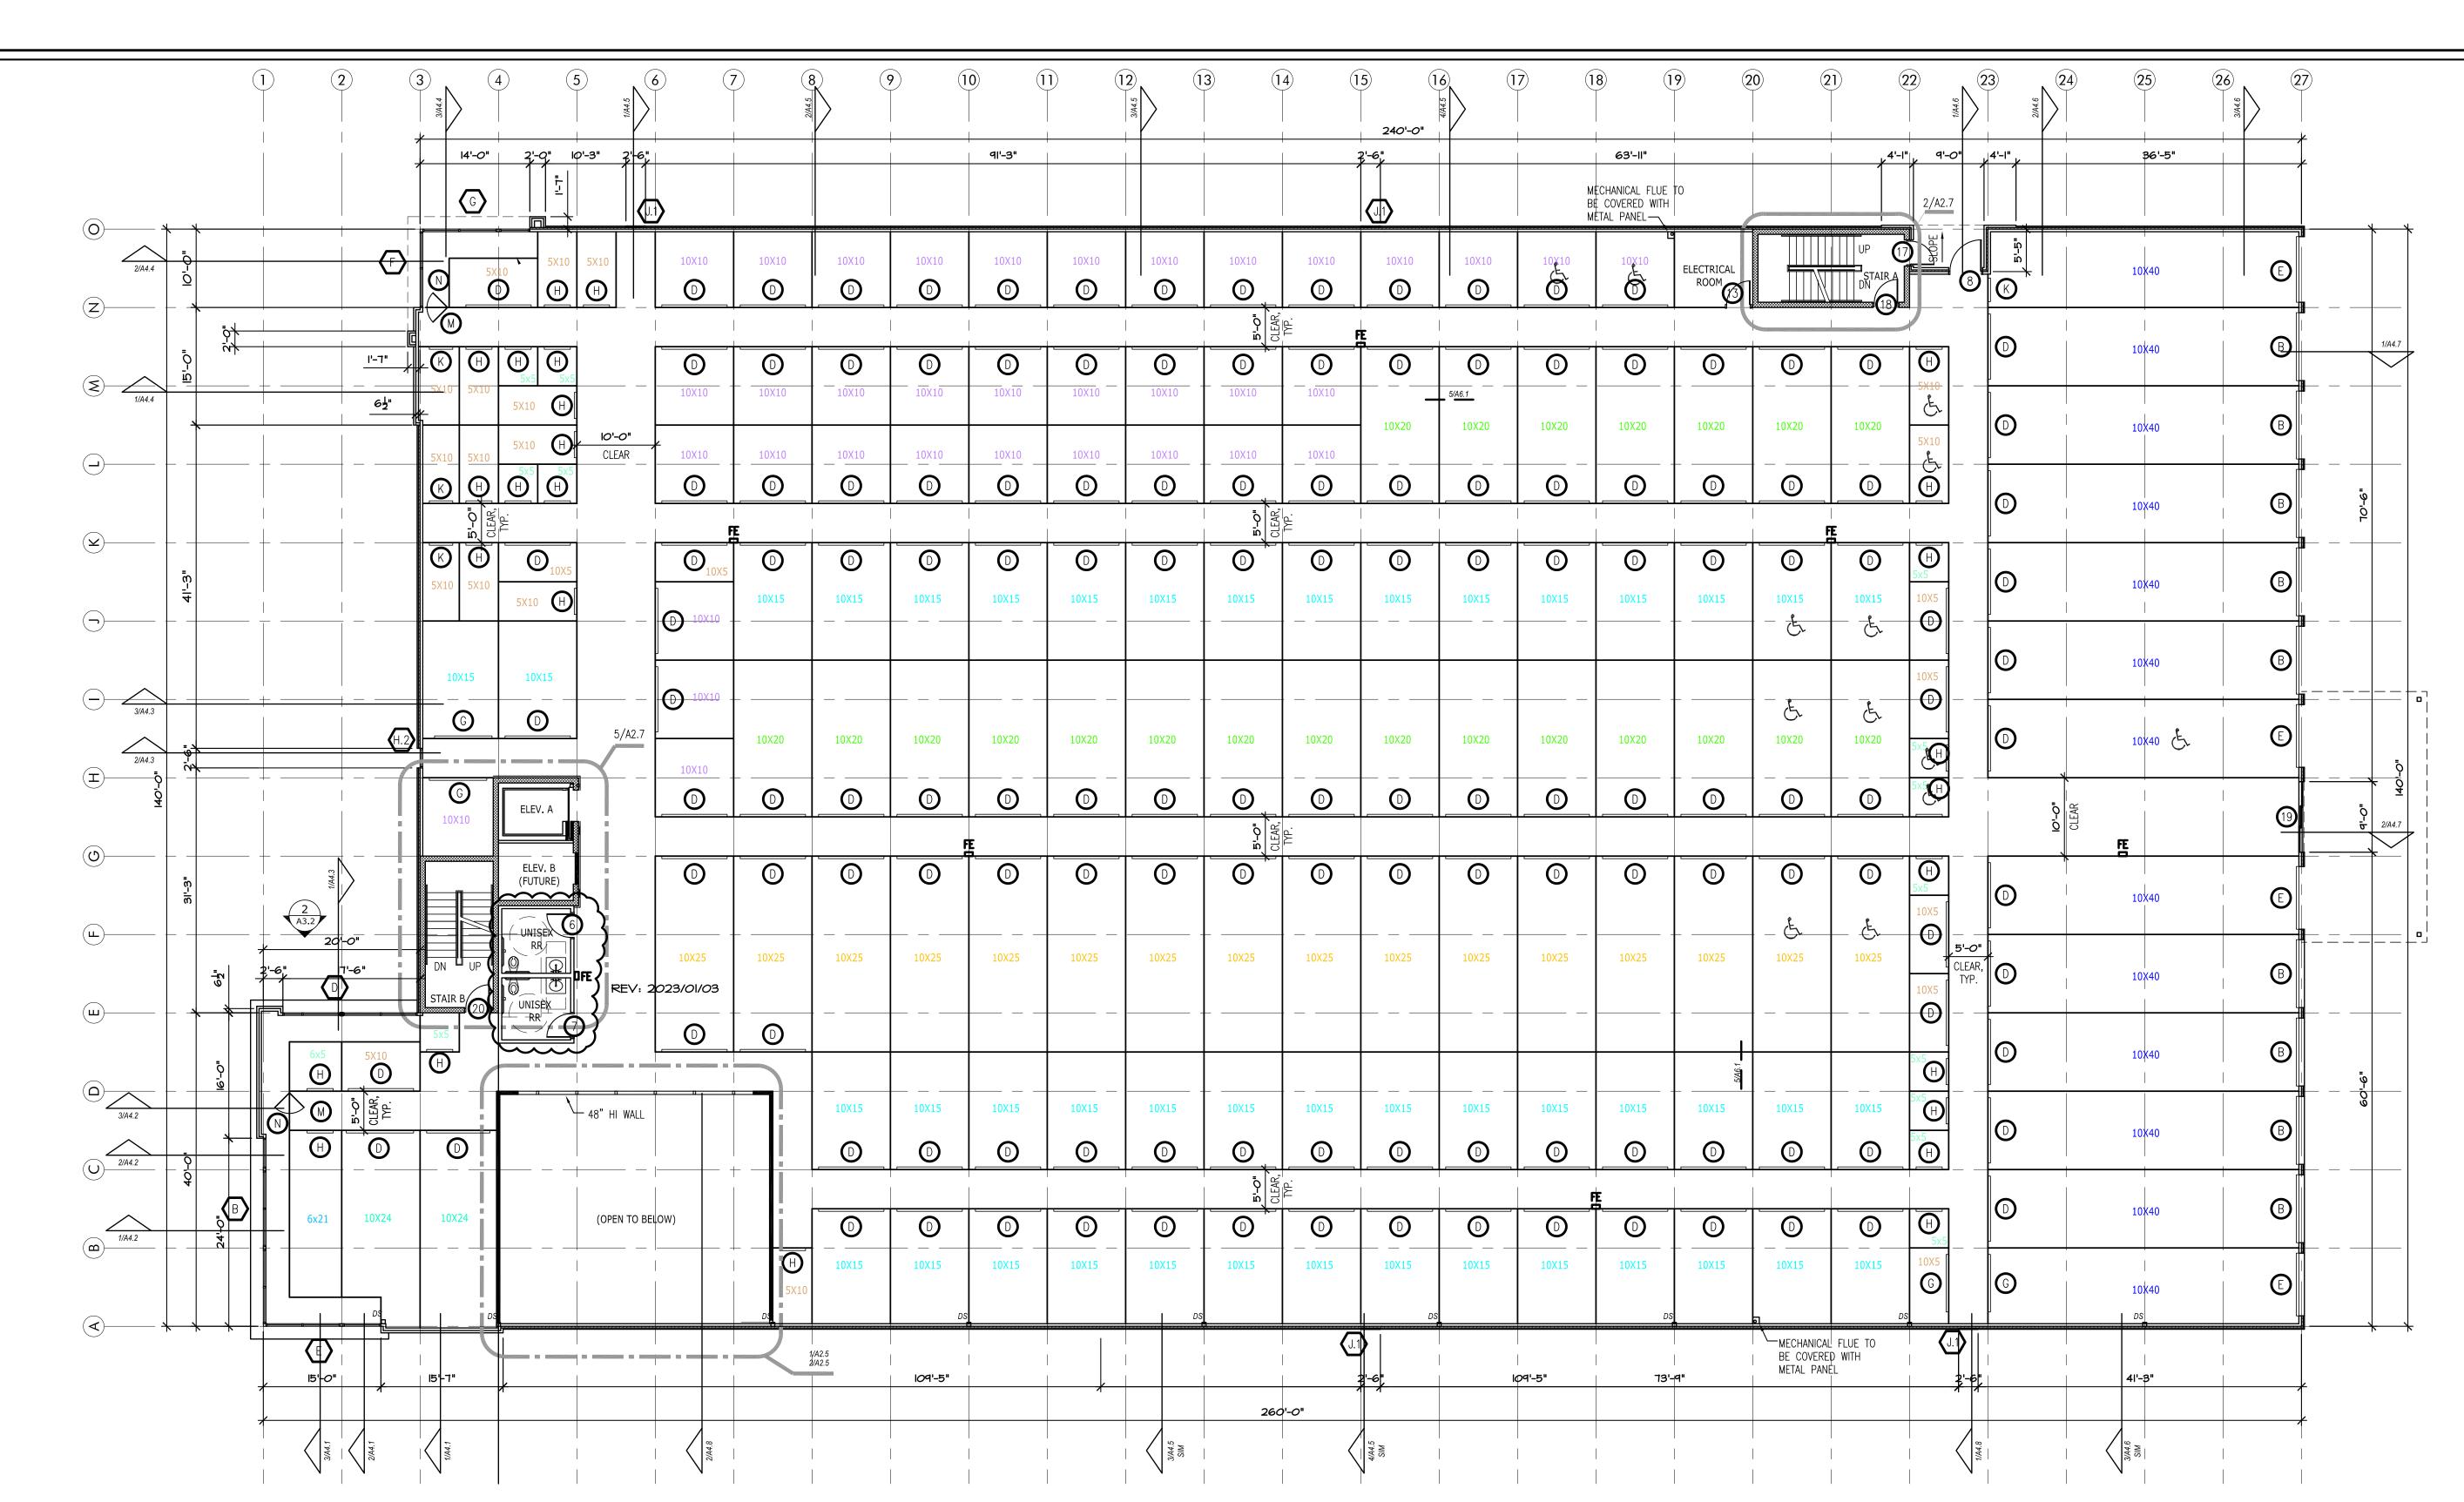



3/32'' = 1'-0''

	METAL PARTITION SYSTEM (CORRIDOR SIDE OF PARTITION EXCEPT WHERE NOTED OTHERWISE) HALLWAYS TO BE JANUS CORRUGATED METAL PARTITIONS TYPREFER DETAIL 5/A6.1
	INSULATED METAL WALL PANEL -REF. ELEVATIONS SHEET FOR EXTENTS OF EXTERIOR FINISHES.
	GYP. BD. ON METAL STUD FRAMING -REFER PARTITION TYPES, SHEET A6.1
	1-HOUR FIRE-RATED WALL @ STAIRS, ELEVATOR, AND FIRE RISER ROOM
44.44.44.	8" CONCRETE STEM WALL
	INSULATED METAL PARTITION SYSTEM REFER TO DETAIL SHEET 4/A6.1

FLOOR PLAN LEGEND

SECOND STORY PLAN

GENERAL NOTES (TYPICAL ALL SHEETS) 1. INTERIOR AND EXTERIOR STORAGE UNIT SIGNAGE TO BE APPROVED BY OWNER. SIGNAGE TO BE

PROVIDED AND INSTALLED BY GENERAL CONTRACTOR.

2. GENERAL CONTRACTOR TO COORDINATE ALL FOUNDATION PENETRATIONS WITH STRUCTURAL ENGINEER.

3. ROOF PANELS TO BE 60 MIL TPO ROOF TO MEET LOCAL WIND LOAD REQUIREMENTS ENGINEERED BY METAL BUILDING MANUFACTURER.

4. GENERAL CONTRACTOR/TPO ROOFING SUBCONTRACTOR TO SIZE/SPACE INTERNAL ROOF DRAINS AS REQUIRED TO MEET LOCAL REQUIREMENTS. SECONDARY ROOF DRAINS TO BE PROVIDED. GENERAL CONTRACTOR TO COORDINATE CONNECTION TO UNDERGROUND STORM DRAIN.

5. GENERAL CONTRACTOR IS TO SUBMIT ALL SAMPLES OF PRODUCTS, ETC. TO OWNER FOR APPROVAL/ SELECTION OF ALL COLORS, FINISHES, ETC. PRIOR TO PURCHASE AND INSTALLATION

6. ALL EXTERIOR WALL DIMENSIONS ARE TO FOUNDATION (INCL. LUG) UNLESS NOTED OTHERWISE. 3RD FLOOR EXTERIOR WALL DIMENSIONS ARE TO FINISH MATERIAL. ALL INTERIOR DIMENSIONS ARE TO OUTER FACE OF MATERIAL USED UNLESS NOTED OTHERWISE.

7. NOT USED.

- 8. PROVIDE RECESS 48" A.F. W/AN FIRE C
- 9. FLOOR FINISH CONCRETE TO BE POLISHED CONCRETE IN CORRIDORS ONLY.
- 10. BUILDING MUST COMPLY W/ LOCAL AMERICAN W/ DISABILITIES ACT -REF. SHEET A2.6
- 11. FURR OUT WALL IN ELECTRICAL ROOMS TO RECESS ELECTRICAL PANEL.

DE & INSTALL FIRE EXTINGUISHERS (FE) WALL CABINETS. RECESS CABINETS @ 48" A.F.F.
SSED, FLUSH WITH WALL AT ALL INTERIOR APPLICATIONS. MOUNT TO PIERS,
A.F.F. IN HEAVY DUTY OUTDOORS FIRE EXTINGUISHER CABINET AT ALL EXTERIOR APPLICATIONS.
TE ONE CLASS 2-A FIRE EXTINGUISHER SO THAT MAX. TRAVEL DISTANCE IS 75 L.F.
MINIMUM OF 1 FOR EVERY 11,250 S.F. PER TABLE 906.3(1) OF THE 2015 INTERNATIONAL
CODE OR AS DIRECTED BY LOCAL AUTHORITIES HAVING JURISDICTION. (KEYED ON FLOOR PLANS)
OUT WALL AT FE LOCATIONS W/ 6" METAL STUDS AND METAL WALL PANEL EACH SIDE.

(EXCLUDING STORAGE UNITS)

14. GENERAL CONTRACTOR TO COORDINATE STANDPIPE/FIRE SPRINKLER DESIGN WITH ROOM SIZE AND

CONFIGURATION.

12. ALL INTERIOR CMU TO BE PAINTED SW PRO CLASSIC B31 SERIES PAINT EXCLUDING INSIDE OF INDIVIDUAL STORAGE UNITS. ALL CMU INSIDE INDIVIDUAL STORAGE UNITS NOT TO BE PAINTED OR SEALED. 13. FIRE RISER ROOM TO HAVE 1—HR FIRE—RATED WALLS AND CEILING. REFER UL FIRE—RATED — ASSEMBLES, SHEET A1.3

ADA CALCULATIONS: 590 UNITS <u>-200 UNITS</u> 390 UNITS X .02 = 7.8 SPACES + 10 SPACES = 18 SPACES REQUIRED

TOTAL SPACES IN FACILITY

SECTION 225.3.1 DISPERSION.

403.3 ACCESSIBLE ROUTE

404.2.5 THRESHOLDS

404.2.7 DOOR HARDWARE

404.2.9 DOOR OPENING FORCE

(TOILET ROOMS, DRINKING FOUNTAINS, ETC.).

ACCESSIBLE UNITS MUST MEET THE FOLLOWING CRITERIA:

PROVIDE JANUS ADA KIT (THREE STRAPS AND ACCESSIBLE SIGN) -JANUS TO INSTALL

1 TO 200

201 AND OVER

SELF STORAGE UNITS MARKED WITH A HANDICAP SYMBOL

TO BE ACCESSIBLE AND FOLLOW ACCESSIBILITY STANDARDS

MINIMUM NUMBER OF SPACES REQUIRED TO BE ACCESSIBLE

10, PLUS 2% OF THE TOTAL NUMBER OF UNITS OVER 200

WALKING SURFACES SHALL NOT BE STEEPER THAN 1:48.

THE RUNNING SLOPE OF WALKING SURFACES NOT STEEPER THAN 1:20. THE CROSS SLOPE OF

OPERABLE PARTS OF HARDWARE SHALL BE 34" MIN. AND 48" MAX. ABOVE FINISHED FLOOR OR GROUND

INDIVIDUAL SELF-SERVICE STORAGE SPACES SHALL BE DISPERSED THROUGHOUT THE VARIOUS CLASSES OF SPACES PROVIDED. WHERE MORE CLASSES OF SPACES

ARE PROVIDED THAN THE NUMBER REQUIRED TO BE ACCESSIBLE, THE NUMBER OF SPACES SHALL NOT BE REQUIRED TO EXCEED THAT REQUIRED BY TABLE 225.3 SELF-SERVICE STORAGE SPACES COMPLYING WITH TABLE 225.3 SHALL NOT BE REQUIRED TO BE DISPERSED AMONG BUILDINGS IN A MULTI-BUILDING FACILITY.

ACCESSIBLE UNITS MUST ALSO PROVIDE ACCESSIBLE ROUTES TO ACCESSIBLE MEANS OF EGRESS, PARKING SPACES, AND COMMON USE ELEMENTS & FACILITIES

5%, BUT NOT LESS THAN 1

5 POUNDS MAXIMUM








1100 Rhode Island Lawrence, Kansas 785 - 749 - 5806 FAX 785 - 749 - 1515

3RD STORY PLAN

2022/11/08

Drawn by: SJB Checked by: **SCH** Revisions : 2023/01/03

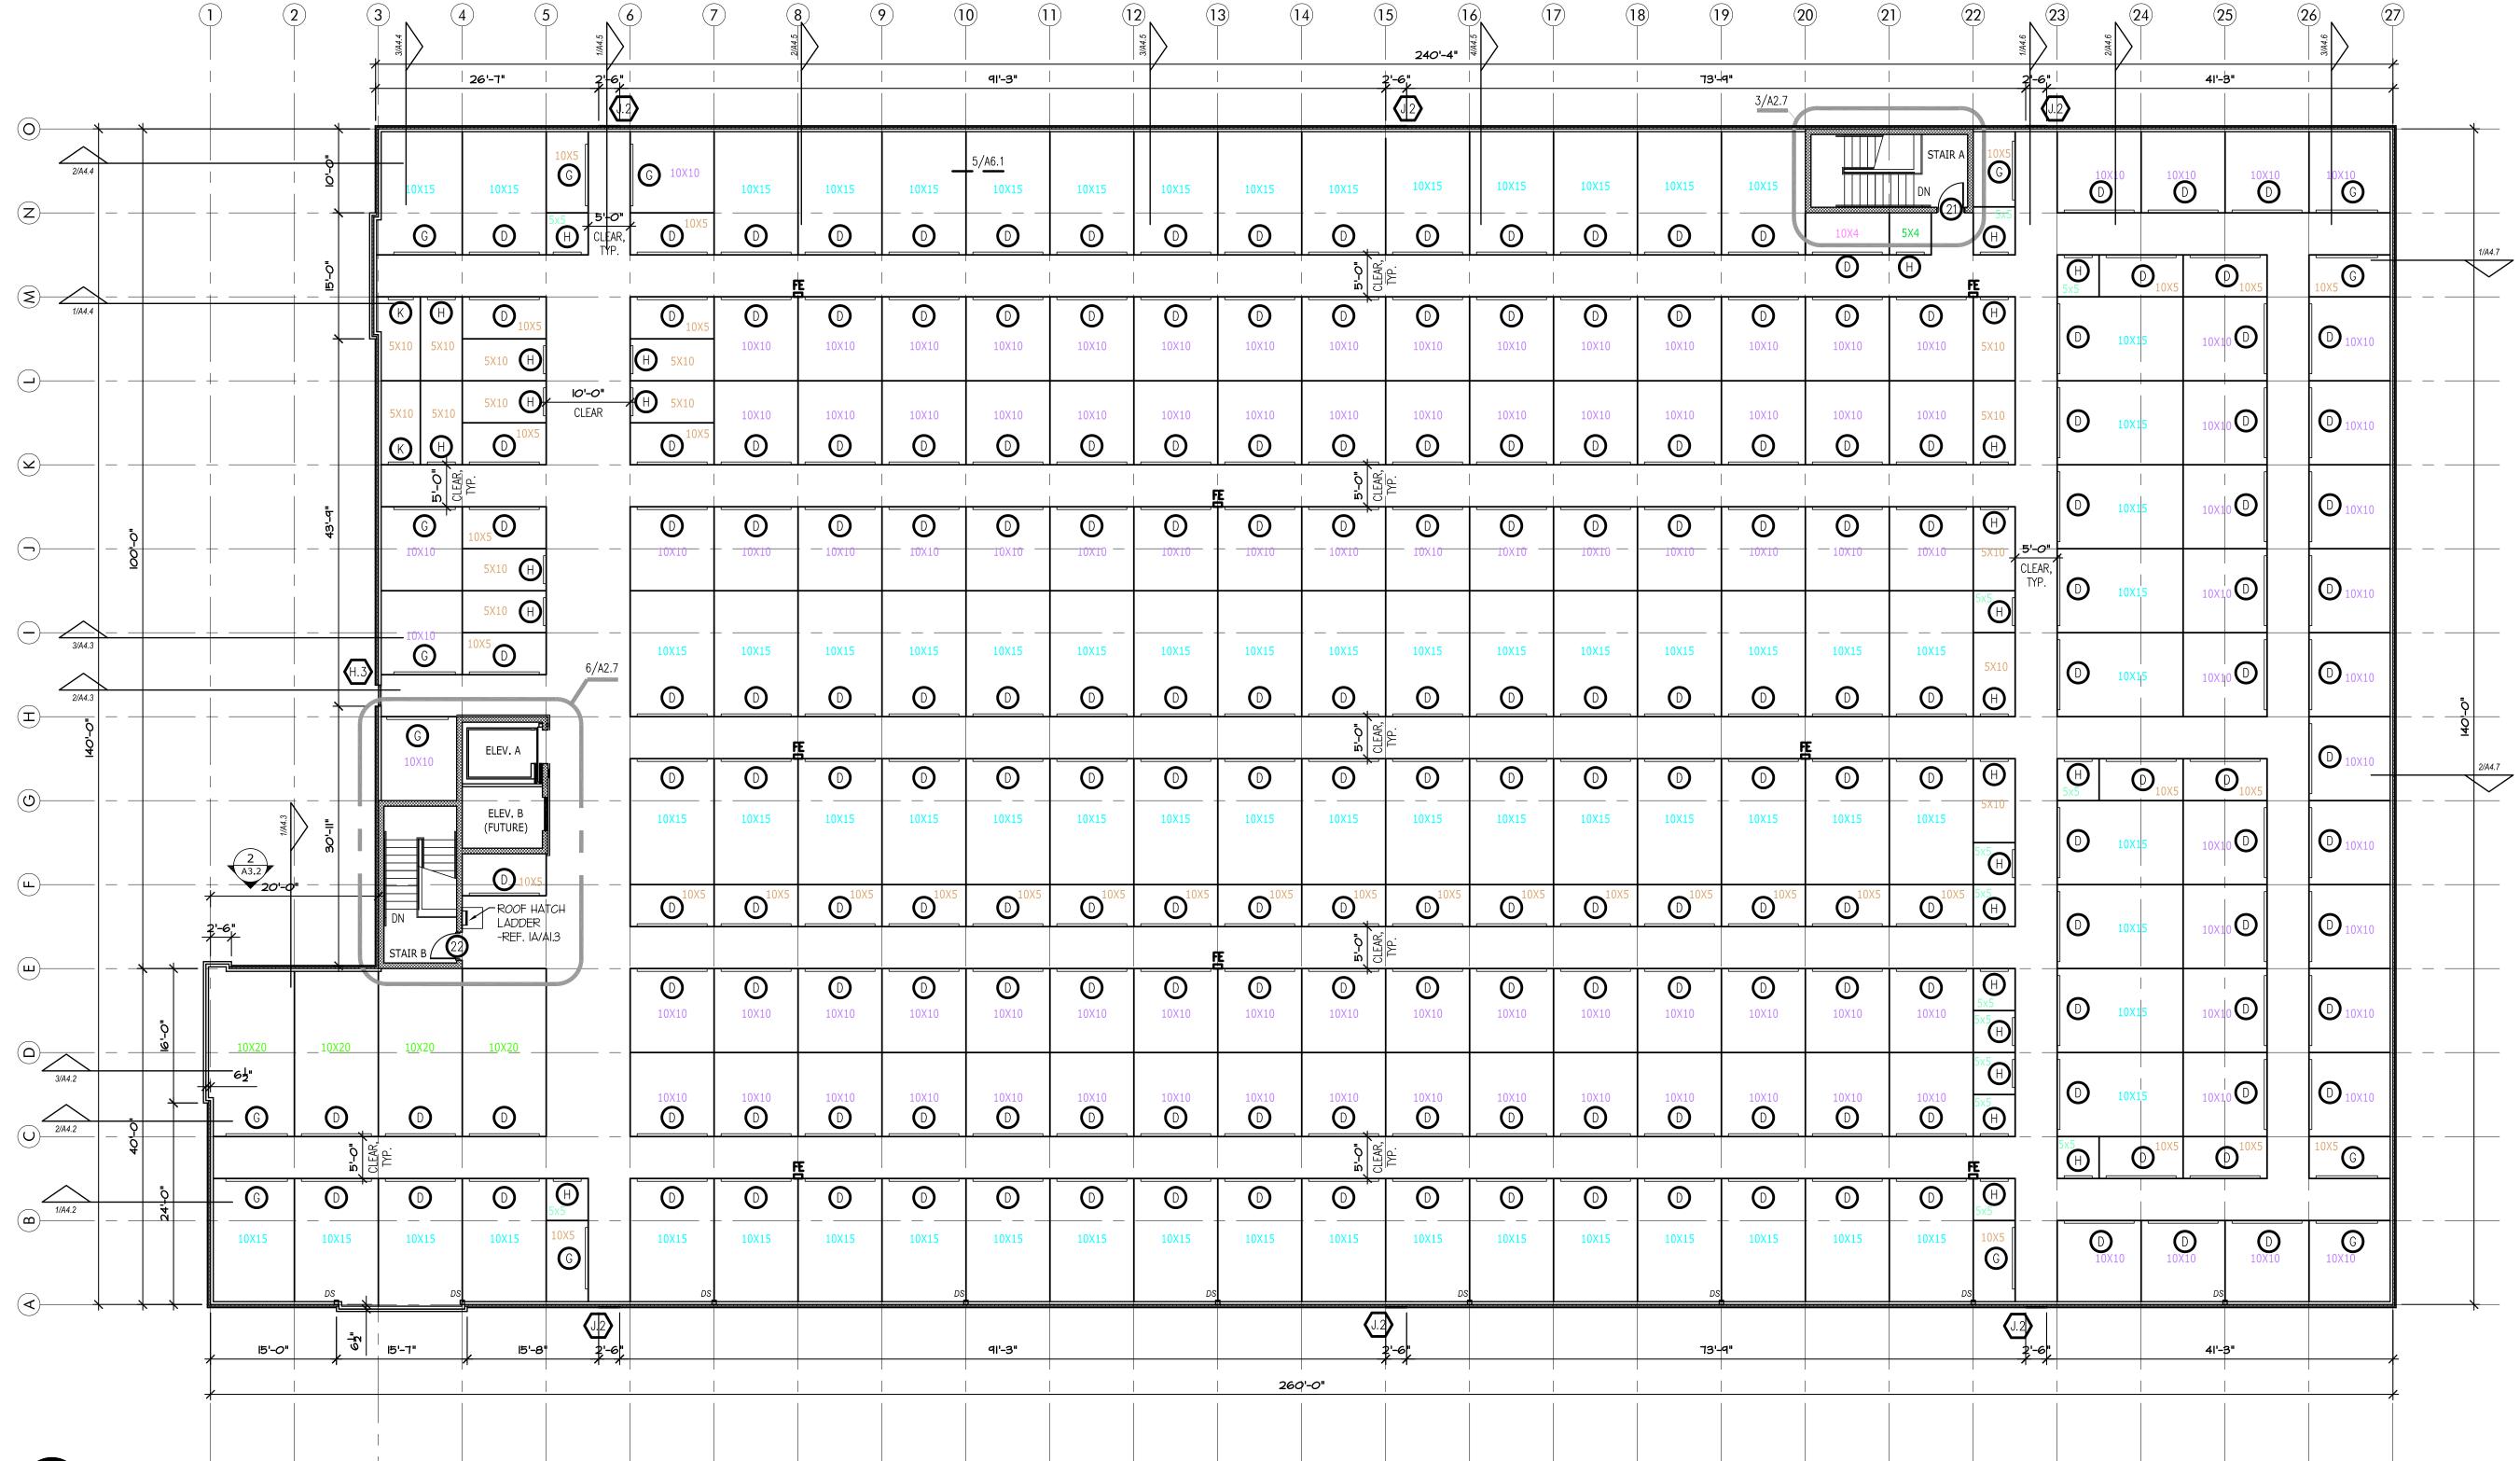



3/32" = 1'-0"

FLOOR PLAN L	EGEND	GENERAL NOTES (TYPICAL ALL SHEETS)
	METAL PARTITION SYSTEM (CORRIDOR SIDE OF PARTITION EXCEPT WHERE NOTED OTHERWISE) HALLWAYS TO BE JANUS CORRUGATED METAL PARTITIONS TYPREFER DETAIL 5/A6.1	INTERIOR AND EXTERIOR STORAGE UNIT SIGNAGE TO BE APPROVED BY OWNER. SIGNAGE TO BE PROVIDED AND INSTALLED BY GENERAL CONTRACTOR. GENERAL CONTRACTOR TO COORDINATE ALL FOUNDATION PENETRATIONS WITH STRUCTURAL ENGINEER.
	INSULATED METAL WALL PANEL -REF. ELEVATIONS SHEET FOR EXTENTS OF EXTERIOR FINISHES.	3. ROOF PANELS TO BE 60 MIL TPO ROOF TO MEET LOCAL WIND LOAD REQUIREMENTS ENGINEERED
	GYP. BD. ON METAL STUD FRAMING -REFER PARTITION TYPES, SHEET A6.1	BY METAL BUILDING MANUFACTURER. 4. GENERAL CONTRACTOR/TPO ROOFING SUBCONTRACTOR TO SIZE/SPACE INTERNAL ROOF DRAINS AS
	1-HOUR FIRE-RATED WALL @ STAIRS, ELEVATOR, AND FIRE RISER ROOM	REQUIRED TO MEET LOCAL REQUIREMENTS. SECONDARY ROOF DRAINS TO BE PROVIDED. GENERAL CONTRACTOR TO COORDINATE CONNECTION TO UNDERGROUND STORM DRAIN.
4 4 4 4 4 4 4 4 4 4 4 4 4 4 4 4 4 4 4 4	8" CONCRETE STEM WALL	5. GENERAL CONTRACTOR IS TO SUBMIT ALL SAMPLES OF PRODUCTS, ETC. TO OWNER FOR APPROVAL/ SELECTION OF ALL COLORS, FINISHES, ETC. PRIOR TO PURCHASE AND INSTALLATION
	, INSULATED METAL PARTITION SYSTEM REFER TO DETAIL SHEET 4/A6.1	6. ALL EXTERIOR WALL DIMENSIONS ARE TO FOUNDATION (INCL. LUG) UNLESS NOTED OTHERWISE. 3RD FLOOR EXTERIOR WALL DIMENSIONS ARE TO FINISH MATERIAL. ALL INTERIOR DIMENSIONS ARE TO OUTER FACE OF MATERIAL USED UNLESS NOTED OTHERWISE. 7. NOT USED.

GENERAL NOTES (TYPICAL ALL SHEETS)

- 1. INTERIOR AND EXTERIOR STORAGE UNIT SIGNAGE TO BE APPROVED BY OWNER. SIGNAGE TO BE PROVIDED AND INSTALLED BY GENERAL CONTRACTOR.
- 2. GENERAL CONTRACTOR TO COORDINATE ALL FOUNDATION PENETRATIONS WITH STRUCTURAL ENGINEER.
- 3. ROOF PANELS TO BE 60 MIL TPO ROOF TO MEET LOCAL WIND LOAD REQUIREMENTS ENGINEERED BY METAL BUILDING MANUFACTURER.
- REQUIRED TO MEET LOCAL REQUIREMENTS. SECONDARY ROOF DRAINS TO BE PROVIDED. GENERAL CONTRACTOR TO COORDINATE CONNECTION TO UNDERGROUND STORM DRAIN. 5. GENERAL CONTRACTOR IS TO SUBMIT ALL SAMPLES OF PRODUCTS, ETC. TO OWNER FOR APPROVAL/
- SELECTION OF ALL COLORS, FINISHES, ETC. PRIOR TO PURCHASE AND INSTALLATION
- 6. ALL EXTERIOR WALL DIMENSIONS ARE TO FOUNDATION (INCL. LUG) UNLESS NOTED OTHERWISE. 3RD FLOOR EXTERIOR WALL DIMENSIONS ARE TO FINISH MATERIAL. ALL INTERIOR DIMENSIONS ARE TO OUTER FACE OF MATERIAL USED UNLESS NOTED OTHERWISE.
- 7. NOT USED.

- 8. PROVIDE & IN RECESSED, I 48" A.F.F. IN LOCATE ONE
- W/ A MINIMUN FIRE CODE O FURR OUT WALL AT FE LOCATIONS W/ 6" METAL STUDS AND METAL WALL PANEL EACH SIDE.
- 9. FLOOR FINISH CONCRETE TO BE POLISHED CONCRETE IN CORRIDORS ONLY.
- 11. FURR OUT WALL IN ELECTRICAL ROOMS TO RECESS ELECTRICAL PANEL.
- 13. FIRE RISER ROOM TO HAVE 1—HR FIRE—RATED WALLS AND CEILING. REFER UL FIRE—RATED — ASSEMBLES, SHEET A1.3
- 14. GENERAL CONTRACTOR TO COORDINATE STANDPIPE/FIRE SPRINKLER DESIGN WITH ROOM SIZE AND

	IABLE ZZO.J
INSTALL FIRE EXTINGUISHERS (FE) WALL CABINETS. RECESS CABINETS @ 48" A.F.F.	TOTAL SPACES IN FACILITY
FLUSH WITH WALL AT ALL INTERIOR APPLICATIONS. MOUNT TO PIERS,	1 TO 200
IN HEAVY DUTY OUTDOORS FIRE EXTINGUISHER CABINET AT ALL EXTERIOR APPLICATIONS.	201 AND OVER
E CLASS 2-A FIRE EXTINGUISHER SO THAT MAX. TRAVEL DISTANCE IS 75 L.F.	
NUM OF 1 FOR EVERY 11,250 S.F. PER TABLE 906.3(1) OF THE 2015 INTERNATIONAL	SECTION 225.3.1 DISPERSION.
OR AS DIRECTED BY LOCAL AUTHORITIES HAVING JURISDICTION. (KEYED ON FLOOR PLANS)	INDIVIDUAL SELE—SERVICE STORAGE S

(EXCLUDING STORAGE UNITS)

10. BUILDING MUST COMPLY W/ LOCAL AMERICAN W/ DISABILITIES ACT -REF. SHEET A2.6

12. ALL INTERIOR CMU TO BE PAINTED SW PRO CLASSIC B31 SERIES PAINT EXCLUDING INSIDE OF INDIVIDUAL STORAGE UNITS. ALL CMU INSIDE INDIVIDUAL STORAGE UNITS NOT TO BE PAINTED OR SEALED.

SELF STORAGE UNITS MARKED WITH A HANDICAP SYMBOL TO BE ACCESSIBLE AND FOLLOW ACCESSIBILITY STANDARDS MINIMUM NUMBER OF SPACES REQUIRED TO BE ACCESSIBLE 5%, BUT NOT LESS THAN 1 10, PLUS 2% OF THE TOTAL NUMBER OF UNITS OVER 200 INDIVIDUAL SELF-SERVICE STORAGE SPACES SHALL BE DISPERSED THROUGHOUT THE VARIOUS CLASSES OF SPACES PROVIDED. WHERE MORE CLASSES OF SPACES ARE PROVIDED THAN THE NUMBER REQUIRED TO BE ACCESSIBLE, THE NUMBER OF SPACES SHALL NOT BE REQUIRED TO EXCEED THAT REQUIRED BY TABLE 225.3.

SELF-SERVICE STORAGE SPACES COMPLYING WITH TABLE 225.3 SHALL NOT BE REQUIRED TO BE DISPERSED AMONG BUILDINGS IN A MULTI-BUILDING FACILITY. ACCESSIBLE UNITS MUST MEET THE FOLLOWING CRITERIA:

403.3 ACCESSIBLE ROUTE THE RUNNING SLOPE OF WALKING SURFACES NOT STEEPER THAN 1:20. THE CROSS SLOPE OF WALKING SURFACES SHALL NOT BE STEEPER THAN 1:48. 404.2.5 THRESHOLDS 1/2" HIGH MAXIMUM 404.2.7 DOOR HARDWARE OPERABLE PARTS OF HARDWARE SHALL BE 34" MIN. AND 48" MAX. ABOVE FINISHED FLOOR OR GROUND 404.2.9 DOOR OPENING FORCE 5 POUNDS MAXIMUM

ACCESSIBLE UNITS MUST ALSO PROVIDE ACCESSIBLE ROUTES TO ACCESSIBLE MEANS OF EGRESS, PARKING SPACES, AND COMMON USE ELEMENTS & FACILITIES (TOILET ROOMS, DRINKING FOUNTAINS, ETC.).


PROVIDE JANUS ADA KIT (THREE STRAPS AND ACCESSIBLE SIGN) -JANUS TO INSTALL


ADA CALCULATIONS: 590 UNITS

 $\frac{-200 \text{ UNITS}}{390 \text{ UNITS}}$ X .02 = 7.8 SPACES + 10 SPACES = 18 SPACES REQUIRED

THIRD STORY PLAN



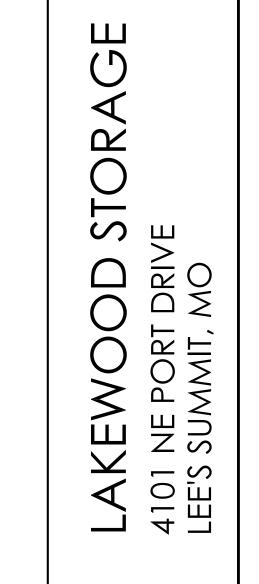

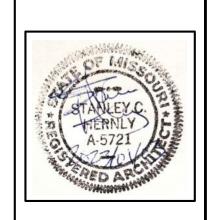



1100 Rhode Island Lawrence, Kansas 66044 785 - 749 - 5806 FAX 785 - 749 - 1515

PLAN DETAILS


Date: 2022/II/08

Drawn by: SJB

Checked by: SCH

Revisions: 2023/01/03

A2.4

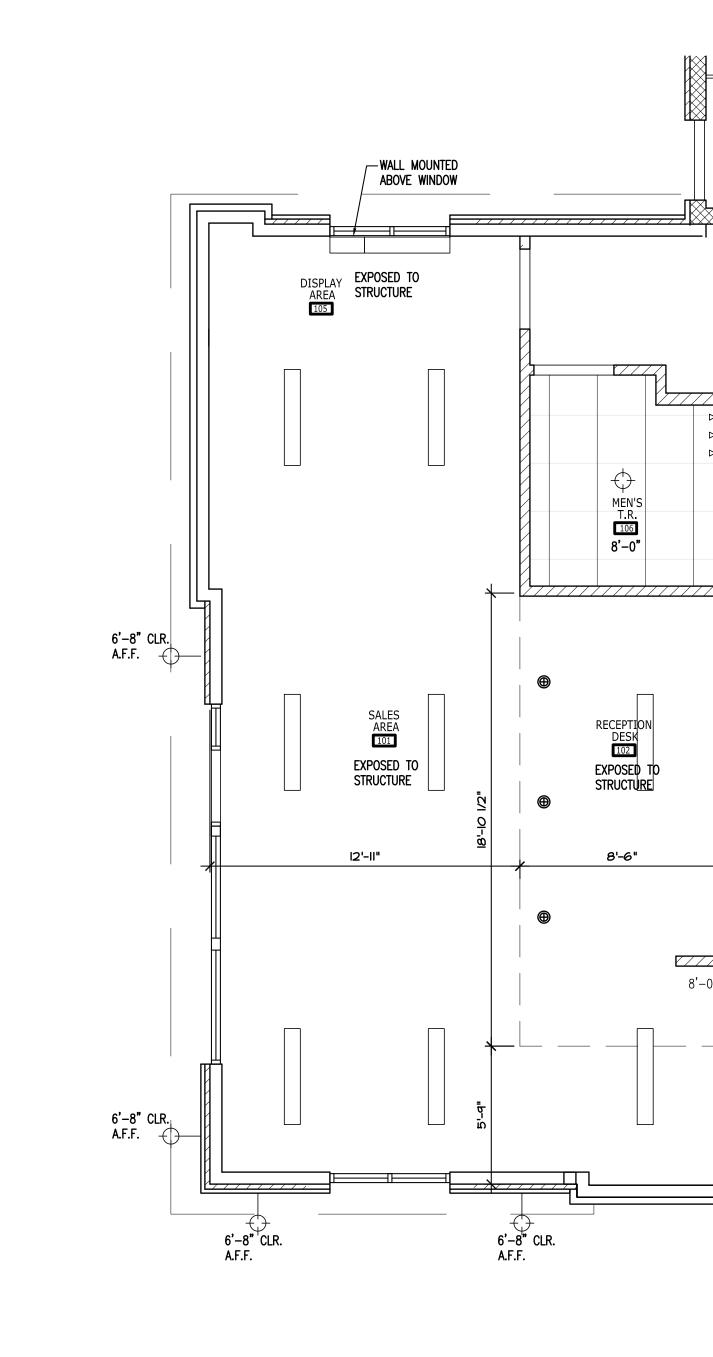

DRINKING FOUNTAIN 108 EXPOSED TO STRUCTURE

> WOMEN'S T.R. 107 8'-0"

> > AHU ROOM


EXPOSED TO STRUCTURE

MDF/BREAK ROOM 103 8'-0"

EXPOSED TO STRUCTURE



	SUSPENDED PAINTED GYP. BD. CEILING	\(\rightarrow \)	EXTERIOR WALL SCONCE —WALL MOUNTED
	2' X 2' OPEN GRID CEILING	<u> </u>	VANITY LIGHT
	4' LED LIGHT	(b)	PENDANT LIGHT
	2' X 4' LED LIGHT -RECESSED	0	LARGE PENDANT LIGHT
ϕ	RECESSED LIGHT		MEP DIFFUSER
2. COORDINATE LIGH	FIXTURE SPECIFICATIONS. HT FIXTURES AND MECHANICAL SUPPLY/RETURE OF FLOOR DECK, EXPOSED STRUCTURE AND	N PRIOR TO INSTALLATION DUCTS IN OFFICE WHERE	E VISIBLE.

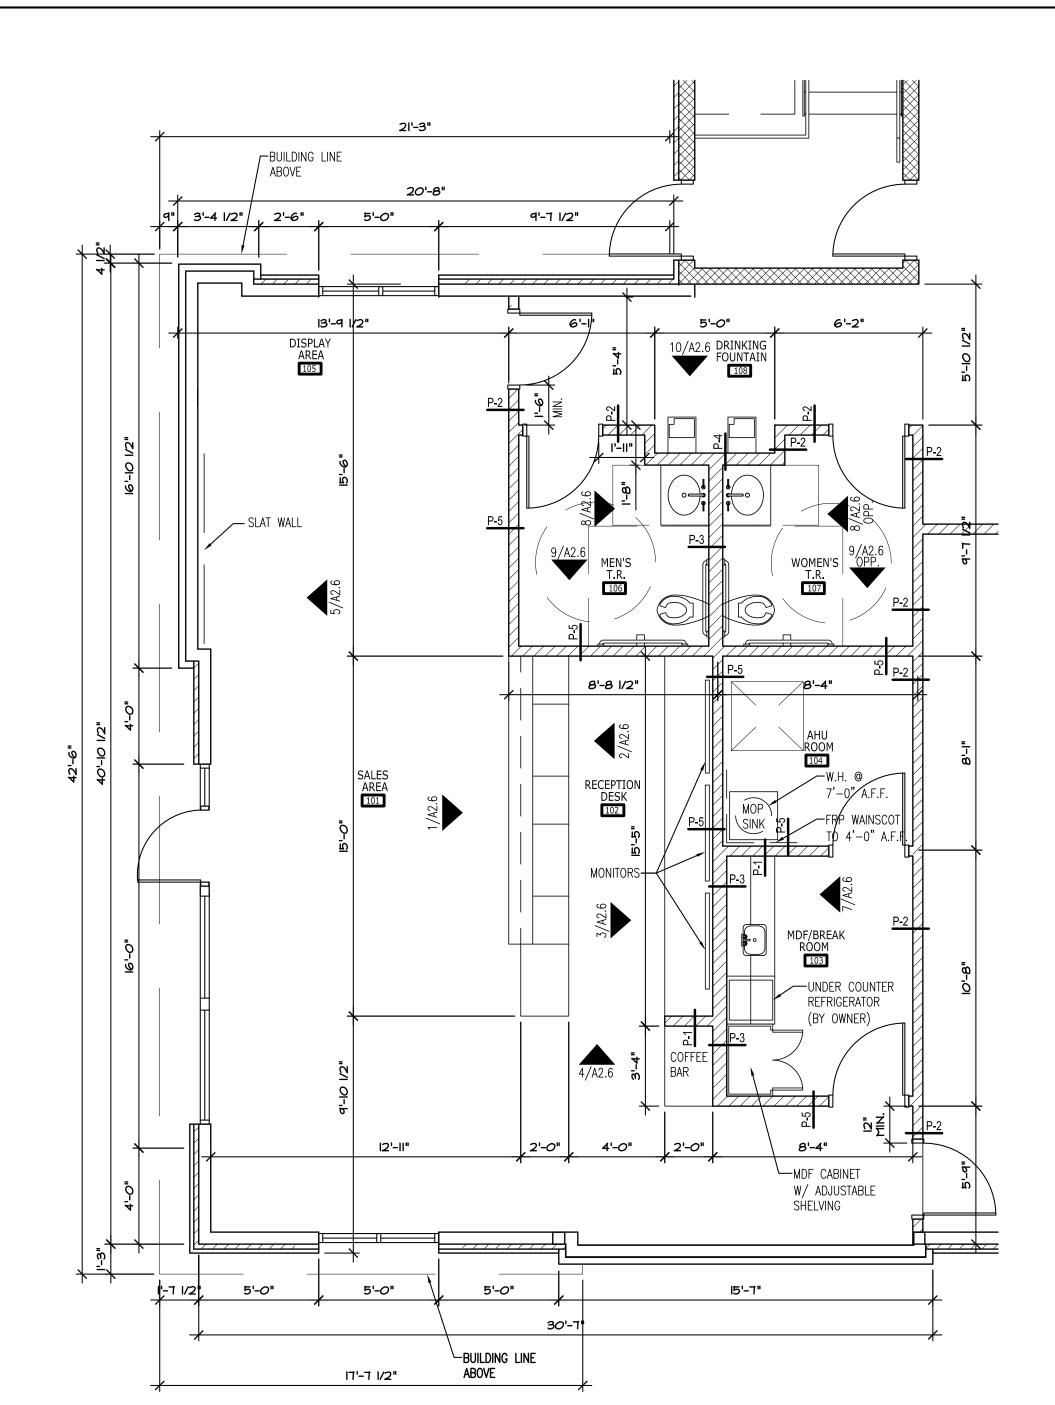



ENLARGED	FLOOR PLAN LEGEND
	METAL PARTITION SYSTEM (CORRIDOR SIDE OF PARTITION EXCEPT WHERE NOTED OTHERWISE) HALLWAYS TO BE JANUS CORRUGATED METAL PARTITIONS TYP. —REFER CORRUGATED HALLWAY SYSTEM A6.1
///////////////////////////////////////	METAL STUD WALL FRAMING
	INTERIOR METAL STUD WALL FRAMING -REFER PARTITION TYPES SHEET A6.1
	4" STRIPES PAINTED ON PAVING @ 2'-0" O.C. COLOR: SAFETY YELLOW
GENERAL N	IOTES
1. REFERENCE SHE	ET A6.1 FOR PARTITION TYPES (P-#)
2. BUILDING MUST	COMPLY W/ LOCAL AMERICAN W/ DISABILITIES ACT -REF. SHEET A2.6

OFFICE FLOOR PLAN









1100 Rhode Island Lawrence, Kansas 66044 785 - 749 - 5806 FAX 785 - 749 - 1515

PLAN DETAILS


Date: 2022/II/08

Drawn by: SJB


Checked by: SCH

Revisions: 2023/01/03

A2.5

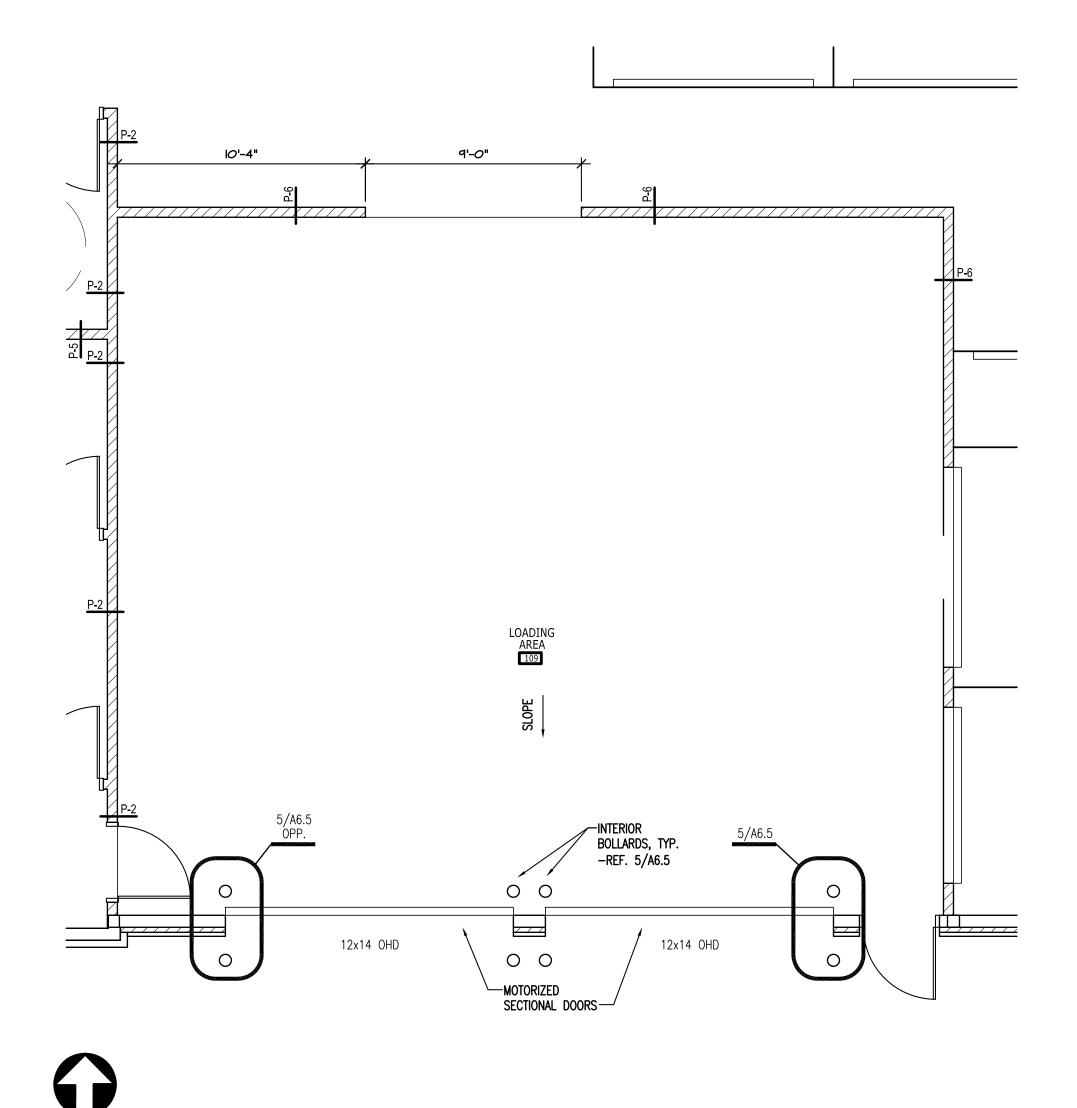

	METAL PARTITION SYSTEM (CORRIDOR SIDE OF PARTITION EXCEPT WHERE NOTED OTHERWISE) HALLWAYS TO BE JANUS CORRUGATED METAL PARTITIONS TYPREFER CORRUGATED HALLWAY SYSTEM A6.1
/////////	METAL STUD WALL FRAMING
	INTERIOR METAL STUD WALL FRAMING -REFER PARTITION TYPES SHEET A6.1
	4" STRIPES PAINTED ON PAVING @ 2'-0" O.C. COLOR: SAFETY YELLOW
GENERAL N	OTES

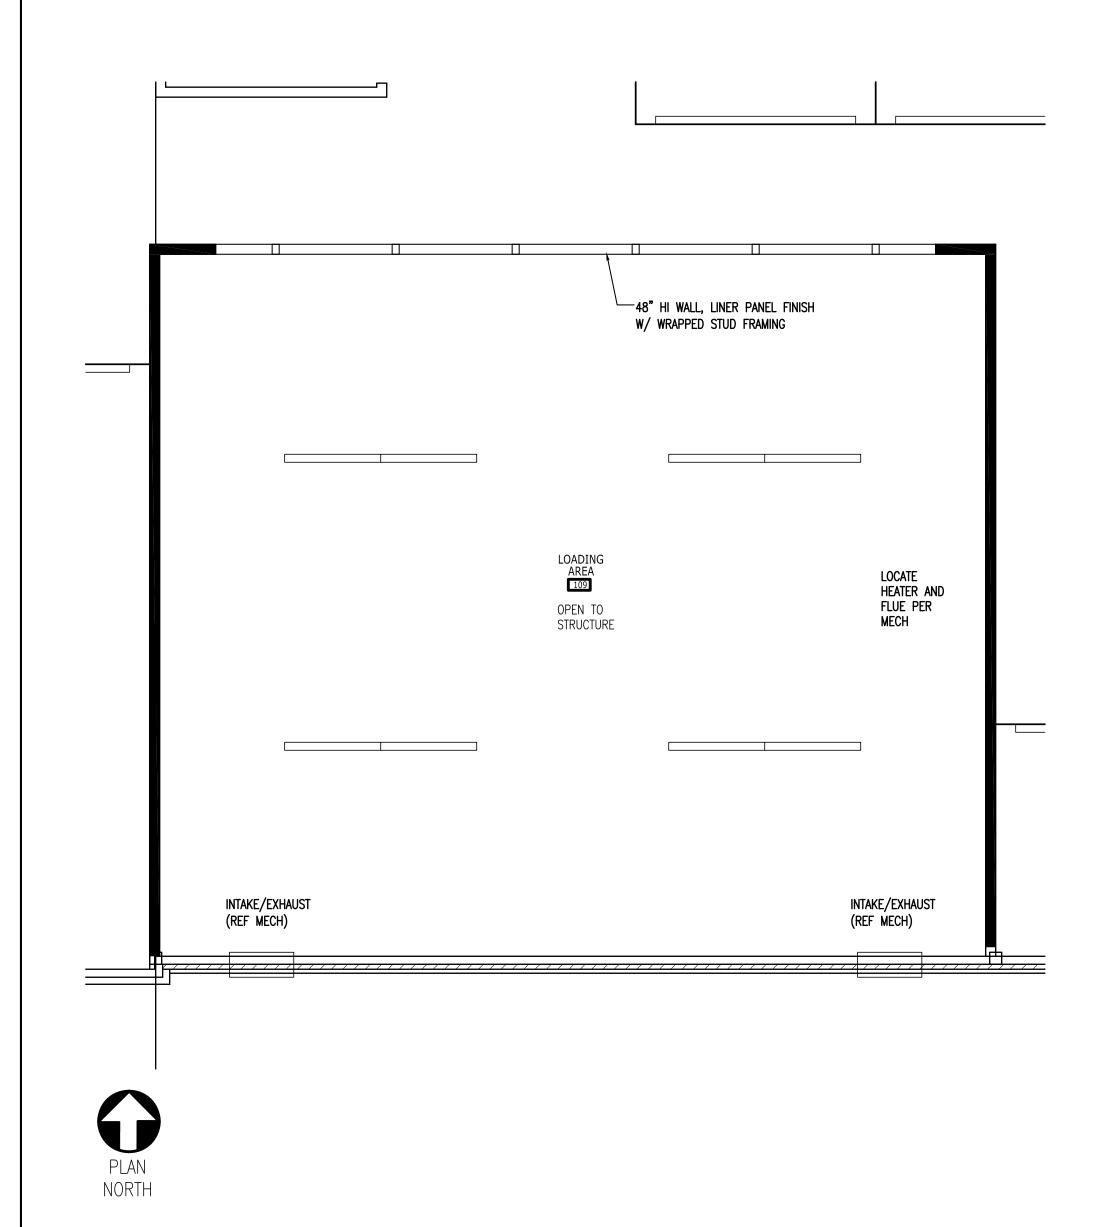

REFLECTE	O CEILING PLAN LEGEND		
	SUSPENDED PAINTED GYP. BD. CEILING	ϕ	EXTERIOR WALL SCONCE —WALL MOUNTED
	2' X 2' OPEN GRID CEILING		VANITY LIGHT
	4' LED LIGHT	₩	PENDANT LIGHT
	2' X 4' LED LIGHT -RECESSED	0	LARGE PENDANT LIGHT
\Diamond	RECESSED LIGHT		MEP DIFFUSER
2. COORDINATE LIGH	FIXTURE SPECIFICATIONS. IT FIXTURES AND MECHANICAL SUPPLY/RETURE OF FLOOR DECK, EXPOSED STRUCTURE AND DLOR ON A7.1)	N PRIOR TO INSTALLATION. DUCTS IN OFFICE WHERE	VISIBLE.

LOADING AREA FLOOR PLAN

2 LOADING AREA REFLECTED CEILING PLAN

UNDERSIDE C DECK ABOVE	OF .
5'-0'	
J'-3"	EPOXY PAINTED
BRACE EWC WITH	DRYWALL ELECTRIC WATER
FLOOR MOUNTED STEEL TUBES AND CARRIER (ANCHOR WITH FULL HEIGHT BLOCKING)	COOLERS REFER TO PLUMBING DWGS. FOR MOUNTING HEIGHTS.

4'-4"

PT-1¬

__SOLID SURFACE

Cabinet to Remain open @

TOP (AIR FLOW)----

PLAM-1 CABINET VENEER———

LOUVERED VENT ON CABINET DOORS

COUNTERTOP-

CABINETS -

3'-0"

PLAM-1 Cabinets—

PT-1

PT-2

¹ G" RUBBER

PLAM-3 COUNTERTOP & BACKSPLASH-\(\)

MDF/BREAK ROOM ELEVATION

SCALE: 1/4" = 1'-0"

2'-0" 3'-0"

/—ADJUSTABLE

SHELVES

└─PLAM-1 CABINETS

-WATER Heater

RECEPTION DESK ELEVATION

-BLOCKING IN

ANCHORAGE

| 2'-0" | 3'-0" | 3'-0" | 2'-0" | 2'-6"

SCALE: 1/4" = 1'-0"

MONITOR WALL ELEVATION

WALL FOR T.V.

SCALE: 1/4" = 1'-0"

MONITORS

(BY OWNER)—

NOTE: ALL CABINETRY

TO BE PLAM FINISH

SELECTED BY OWNER

DRINKING FOUNTAIN ELEVATION

SCALE: 1/4" = 1'-0"

	LET ACCESSORIES	T
MARK	ITEM	HEI
TA-1	TOILET TISSUE DISPENSER	19"
TA-2	HAND DRYERS	48"
TA-3	42" HORIZONTAL GRAB BAR	34"
TA-4	MIRROR	4(
TA-5	36" HORIZONTAL GRAB BAR	34"
TA-6	LAVATORY PIPING INSULATION	N,
TA-7	FEMININE NAPKIN DISPOSAL	48"
TA-8	SOAP DISPENSER	44"
TA-9	18" VERTICAL GRAB BAR	40"

1. FOR CONTROLS OR REACH, HEIGHT IS MAX.

2. FOR MIRRORS, HEIGHT IS TO BOTTOM OF REFLECTIVE EDGE. 3. FOR GRAB BARS, HEIGHT IS TO CENTER OF HORIZONTAL BAR. 4. ALL DESIGN MUST COMPLY W/ LOCAL AMERICAN'S W/DISABILITIES ACT

- REF. SHEET A2.6 5. BLOCKING FOR ACCESSORIES BY GENERAL CONTRACTOR 6. SOAP DISPENSER TO BE INSTALLED OVER COUNTERTOP

INTERIOR ELEVATIONS

1/4" = 1'-0"


. С DRIV NE PORT SUMMIT, KEW 4101 LEE'S


Hernly ASSOCIATES

1100 Rhode Island Lawrence, Kansas 785 - 749 - 5806 FAX 785 - 749 - 1515

INTERIOR ELEVATIONS

2022/11/08 Drawn by: SJB Checked by: **SCH** Revisions : **2023/01/03**

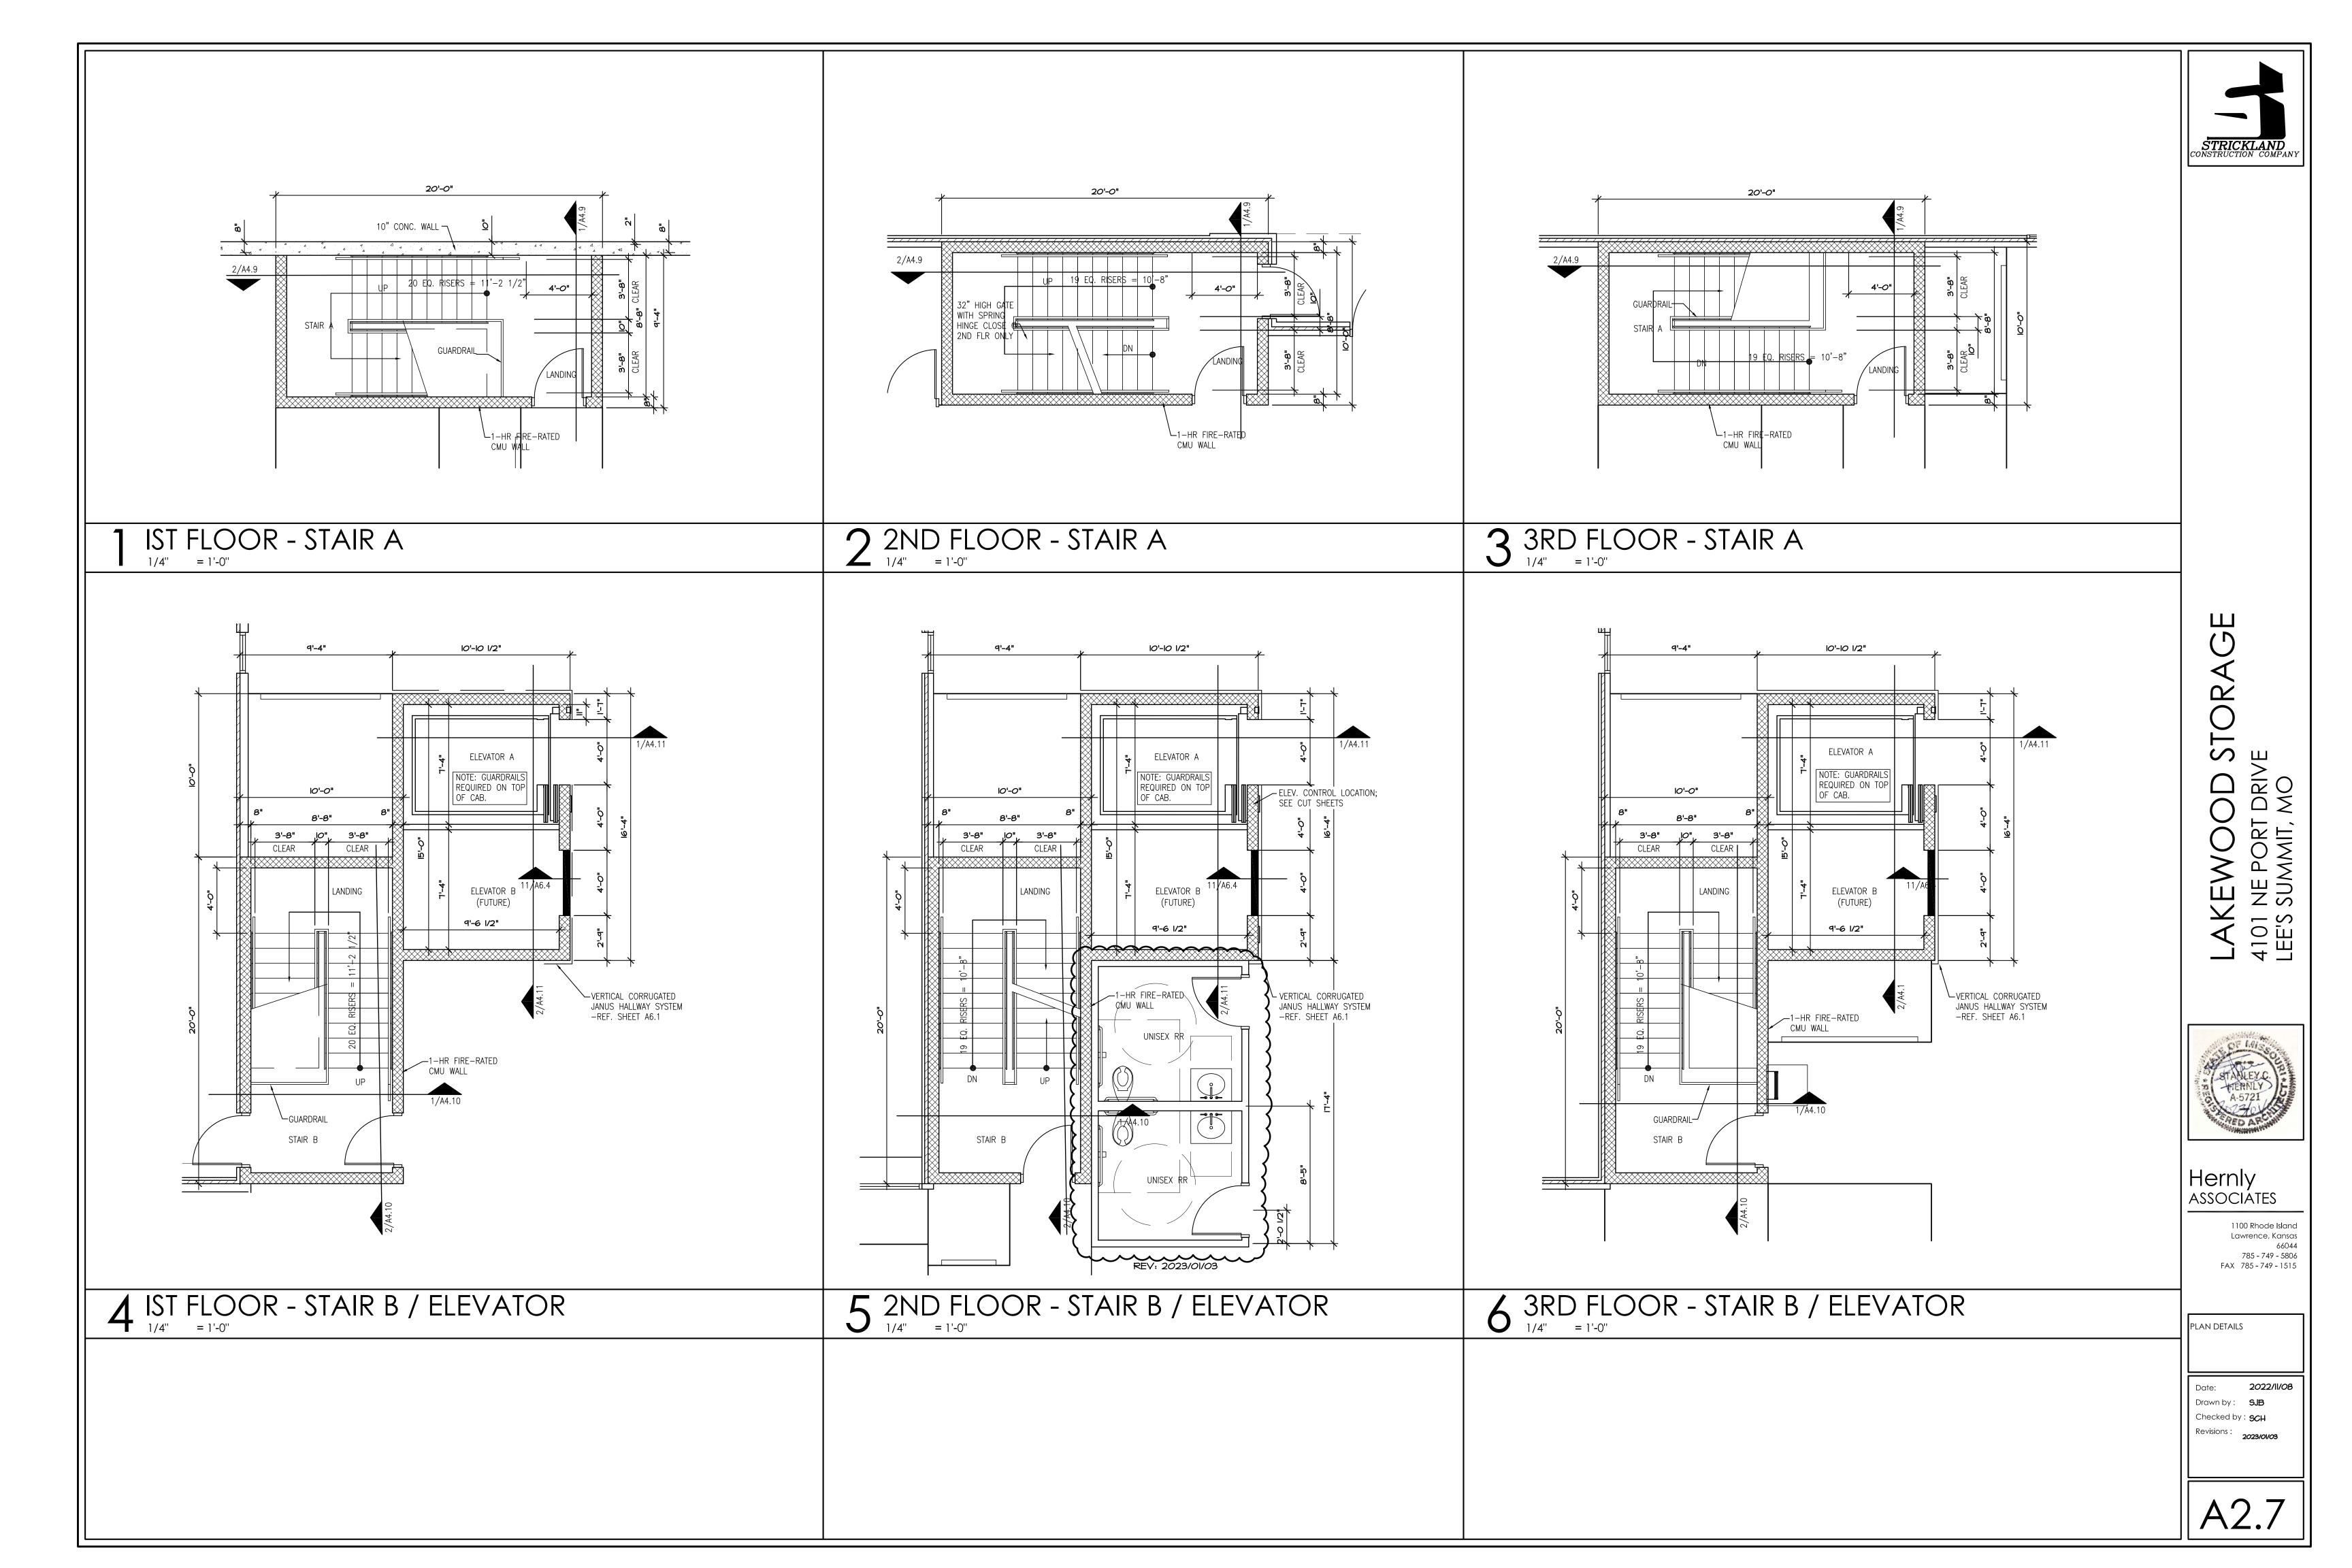

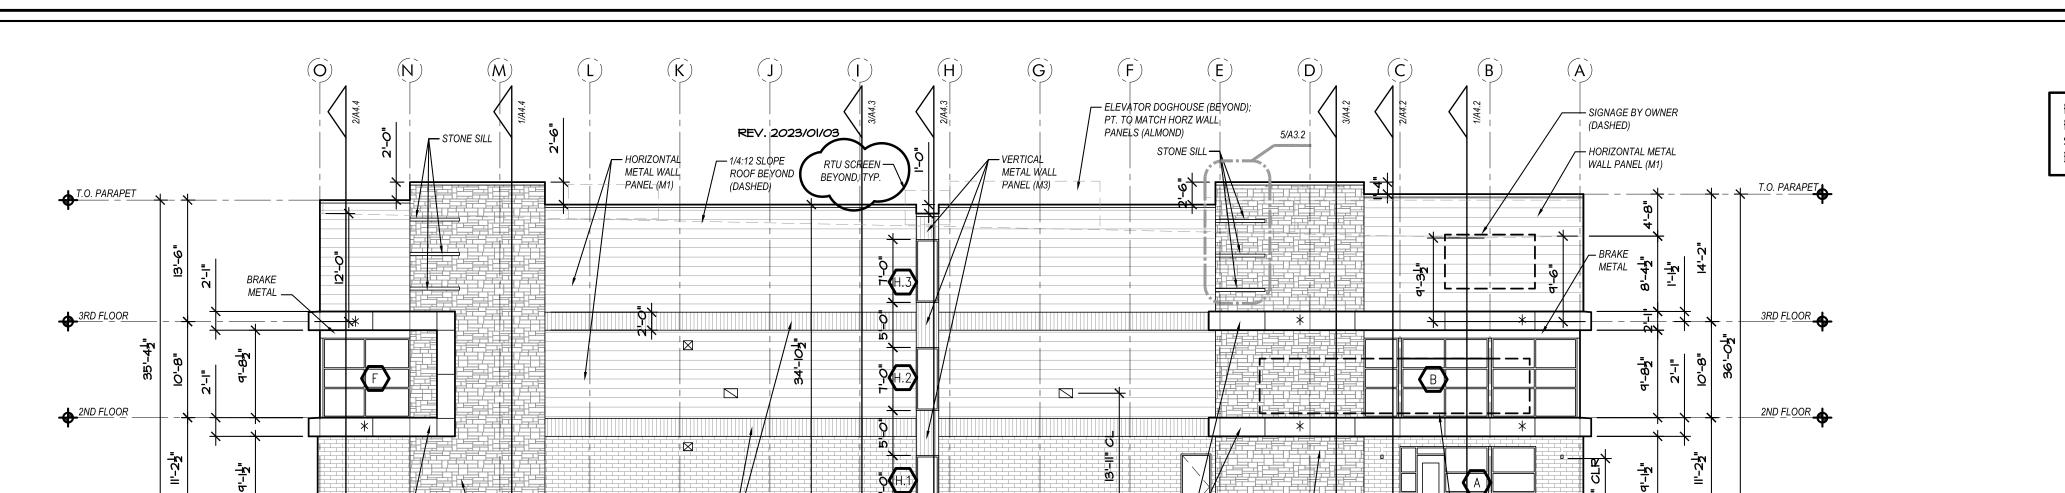

ACM —

CULTURED STONE VENEER

OFFICE ENTRY —

PANEL

∟ | |BRICK

RAINSCREEN

WALL PANEL

VERTICAL METAL

BAND (M2)

REV. 2023/01/03 ROOFTOP UNIT SCREENS SHOWN ON BUILDING ELEVATIONS



WEST ELEVATION 3/32" = 1'-0"

1ST FLOOR

ACM J

└─ CULTURED

STONE VENEER

ROOF BEYOND (DASHED) _ REV. 2023/01/03 ROOF BEYOND (DASHED) HORIZONTAL METAL /— HORIZONTAL METAL WALL VERTICAL METAL BAND — VERTICAL METAL WALL OVERFLOW
SCUPPER WALL PANEL (M1)_ T.O. PARAPET 3RD FLOOR 2ND FLOOR 2ND FLOOR 2'-6" STEM WALL PAINT TO MATCH ADJACENT WALL PANEL -REF. 3/A3.2 1ST FLOOR ULTURED SECTIONAL UNDERGROUND __BRICK — -CULTURED
STONE
VENEER SPREAD FOOTING BELOW GRADE PANEL STORM SEWER — RAINSCREEN OVERHEAD DOOR WALL PANEL W/ VISION GLASS, -REF. CIVIL CEDAR RED

— SIGNAGE BY OWNER


RAINSCREEN

WALL PANEL

(DASHED BEHIND

GLAZING)

2 SOUTH ELEVATION
3/32" = 1'-0"

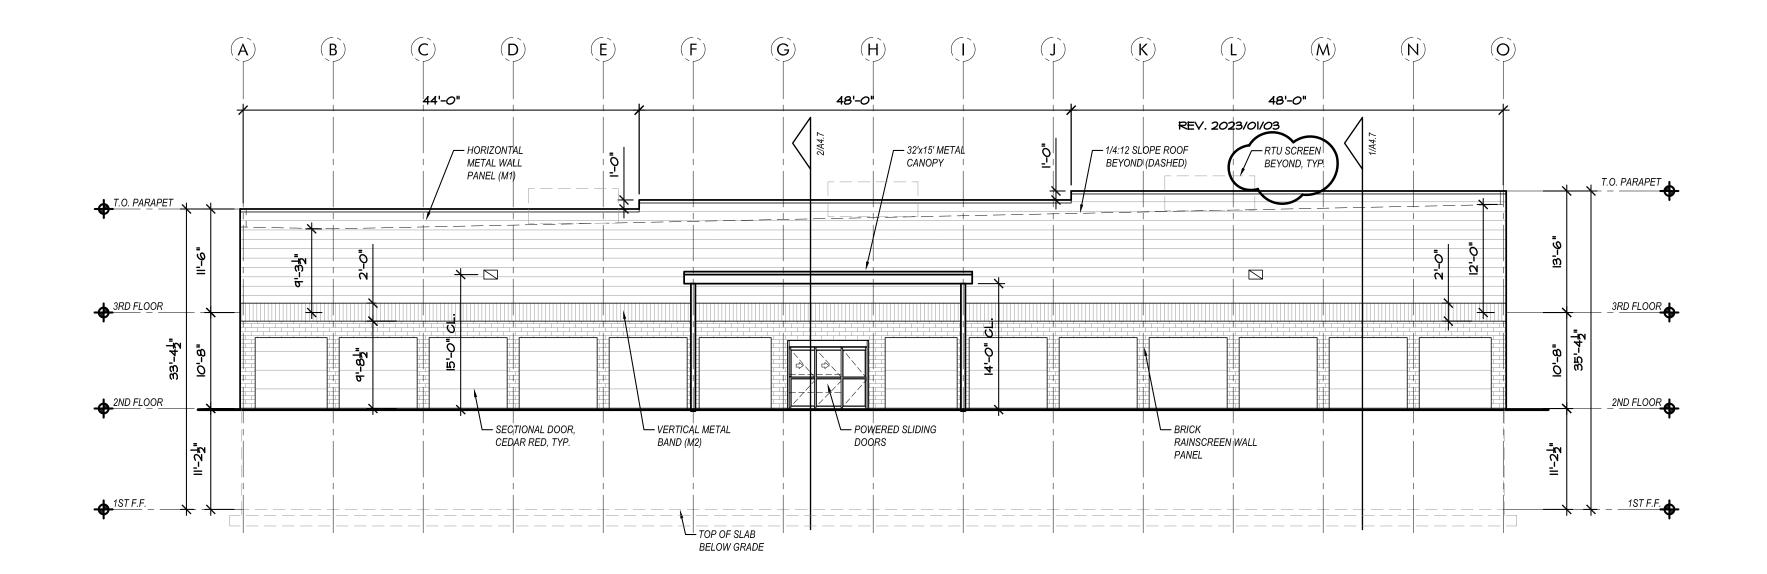

//// SPANDREL	GLASS	
//// SI ANDINEL	OLASS	

ELEVATION	LEGEND	NOTES
	HORIZONTAL METAL WALL PANEL (M1)	MBCI SIGNATURE 300, 'ALMOND'
	VERTICAL METAL BAND (M2)	MBCI SIGNATURE 200 PBD, 'SOLAR WHITE'
*	ACM - ALUMINUM COMPOSITE MATERIAL PANEL	
	BRICK RAINSCREEN WALL PANEL (NICHIHA)	SIM. TO ACME BRICK, MENAWA
	CULTURED STONE VENEER	SIM. TO COBRASTONE, ANTIQUE LEUDERS, 4", 5",
	EXTERIOR ROLL UP DOORS	SIM. TO JANUS, CEDAR RED
	EXTERIOR LIGHT FIXTURE -REF. MEP	
	OVERFLOW SCUPPER -REF. 12/A6.3	
	OUTSIDE AIR LOCATIONS -REF. MEP	
ELEVATION	NOTES	
	COPING, TRIM, AND FLASHING TO MATCH COLOR ACENT MATERIAL.	
	MATERIAL TO BE TPO ROOF SYSTEM SLOPED	

- AT 1/4" FT WITH INTERNAL ROOF DRAINS TO CONNECT TO UNDERGROUND SEWER
- OVERFLOW SCUPPERS TO BE 2" ABOVE LOWEST POINT OF ROOF.
- PAINT MAN DOOR TO MATCH ADJACENT MATERIAL UNLESS NOTED OTHERWISE.
- GENERAL CONTRACTOR/SIGNAGE COMPANY TO PROVIDE
- ANCHORAGE, BLOCKING, & WATERPROOFING FOR
- MAX PARAPET HEIGHT TO BE 2'-6" WITHOUT STRUCTURAL SUPPORT.

OF 1415
48 102 184
STANLEY
2 A-5721 23/04/89
2 270 ARMAN

S III

NE PORT SUMMIT,

4101 LEE'S

Hernly ASSOCIÁTES


> 1100 Rhode Island Lawrence, Kansas 66044 785 - 749 - 5806 FAX 785 - 749 - 1515


ELEVATIONS


2022/11/08 Date: Drawn by: SJB Checked by: **SCH**


Revisions : **2023/01/03**


3 EAST ELEVATION
3/32" = 1'-0"

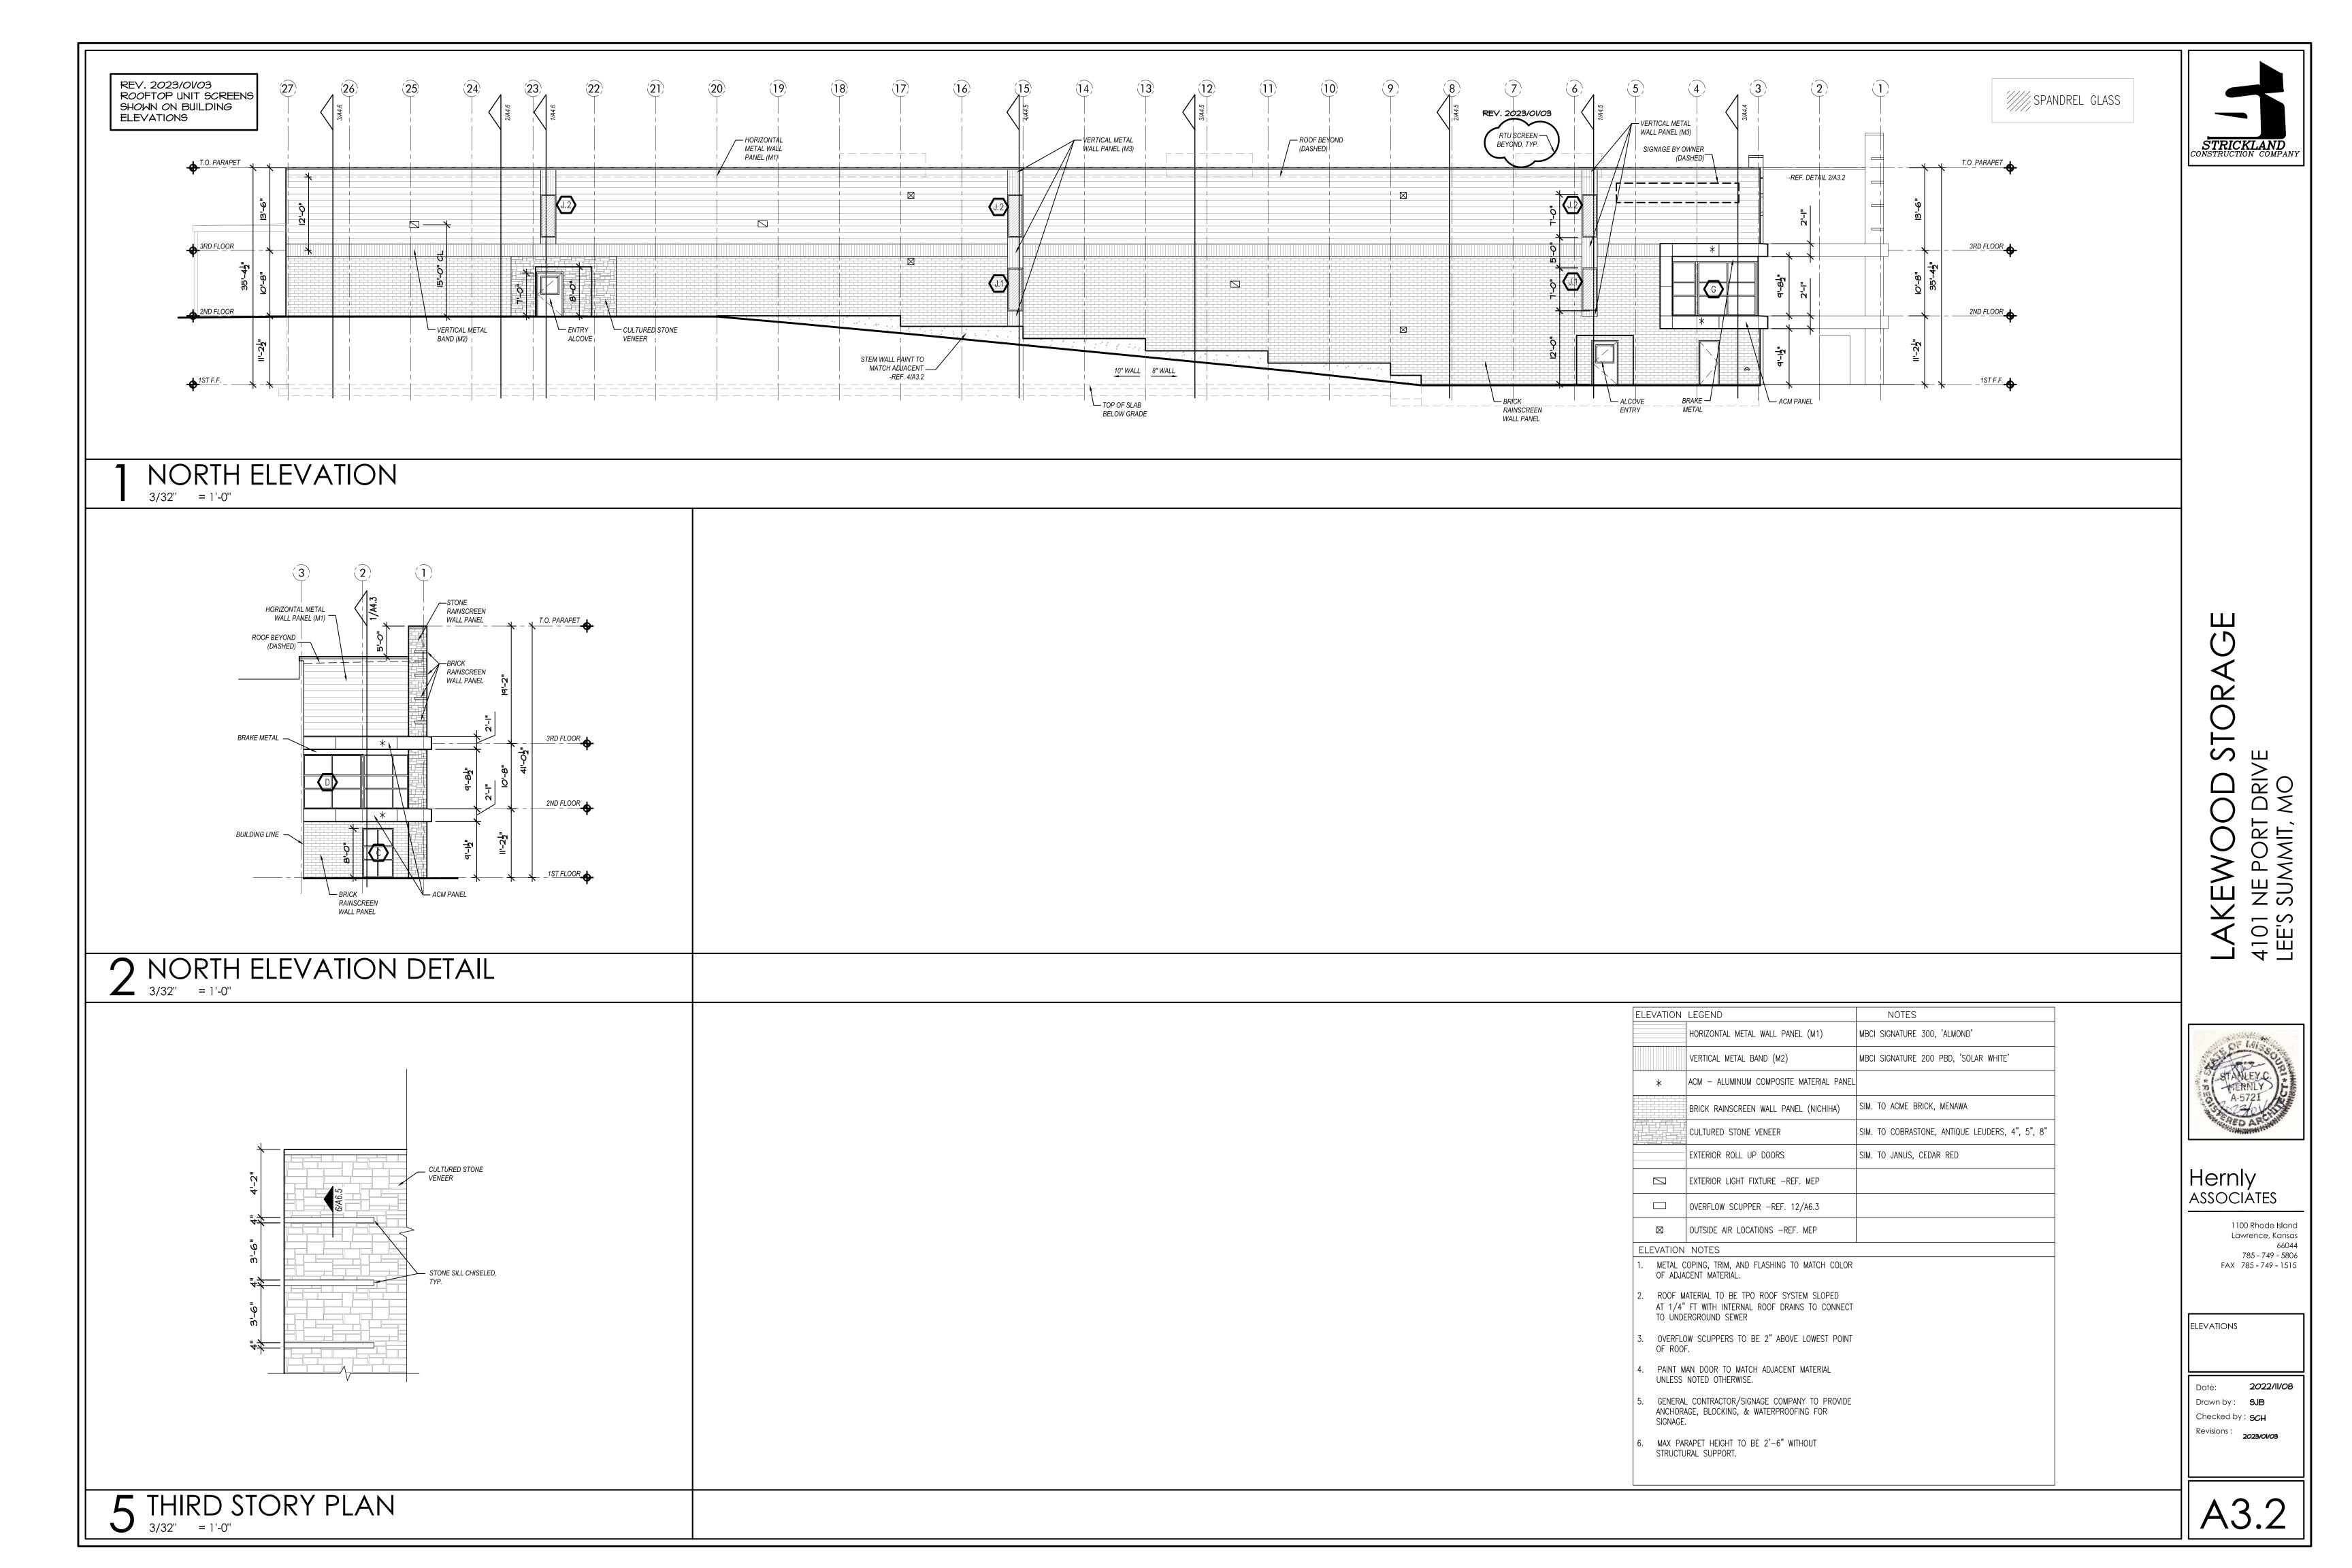


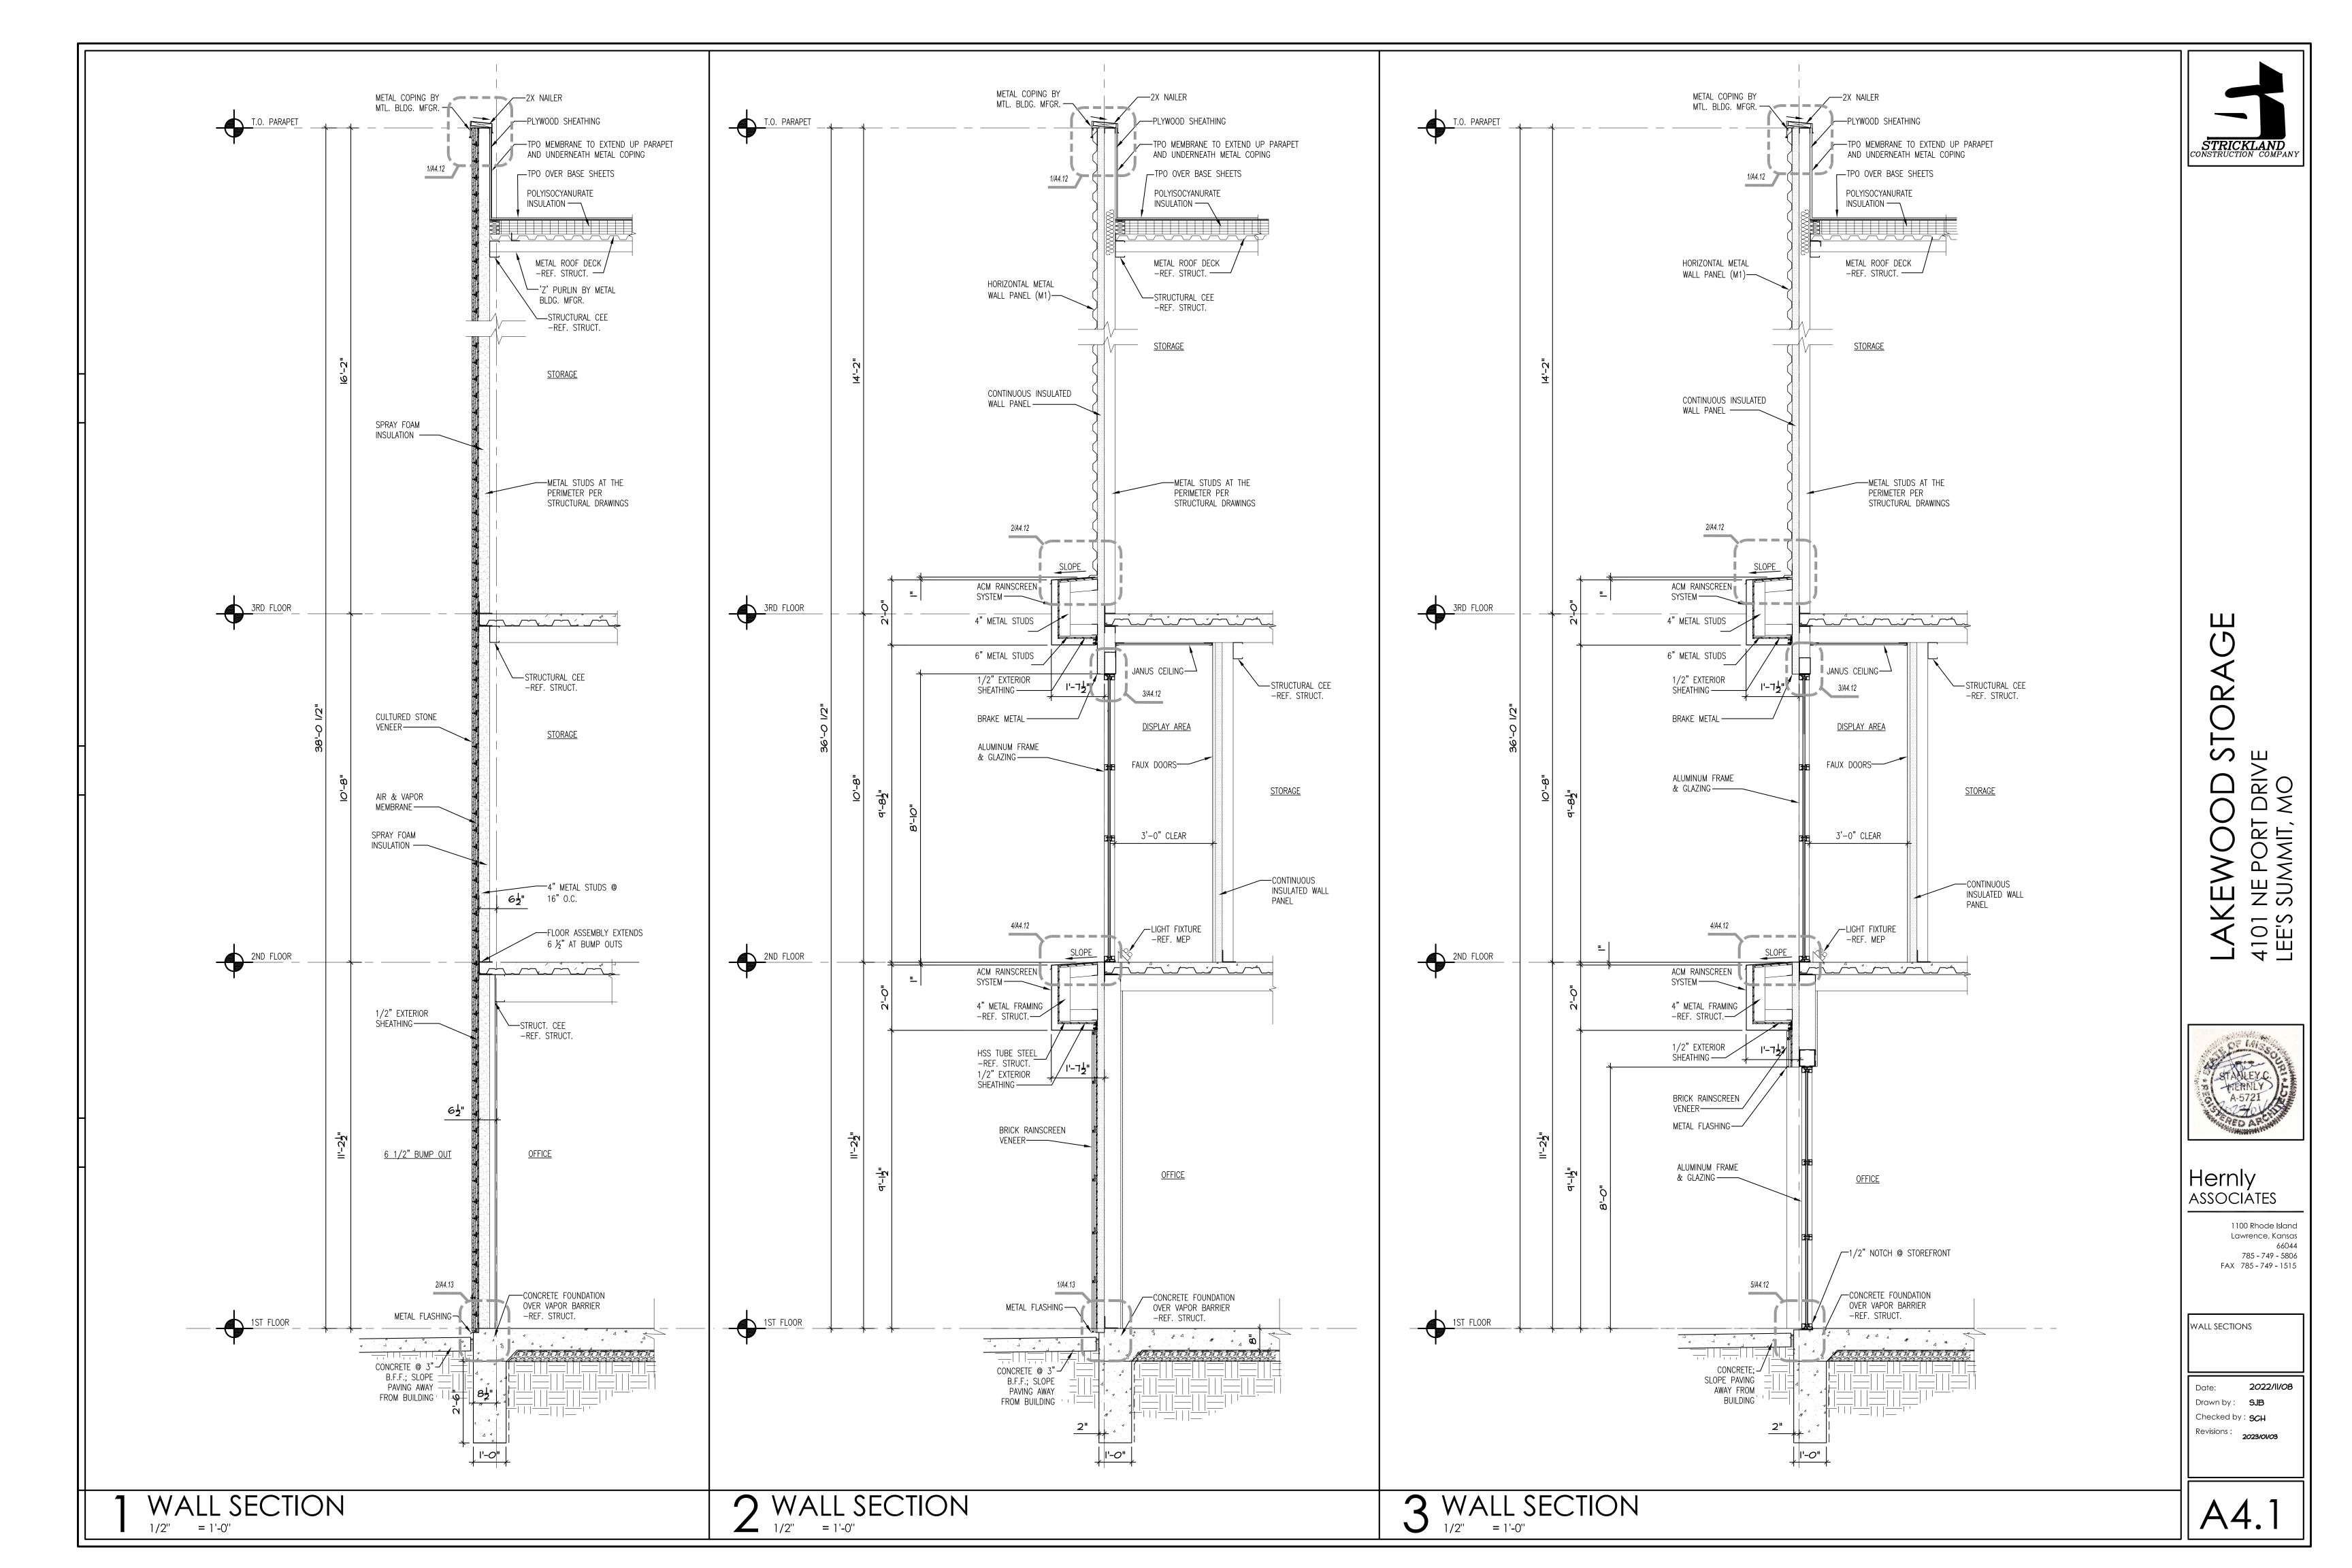


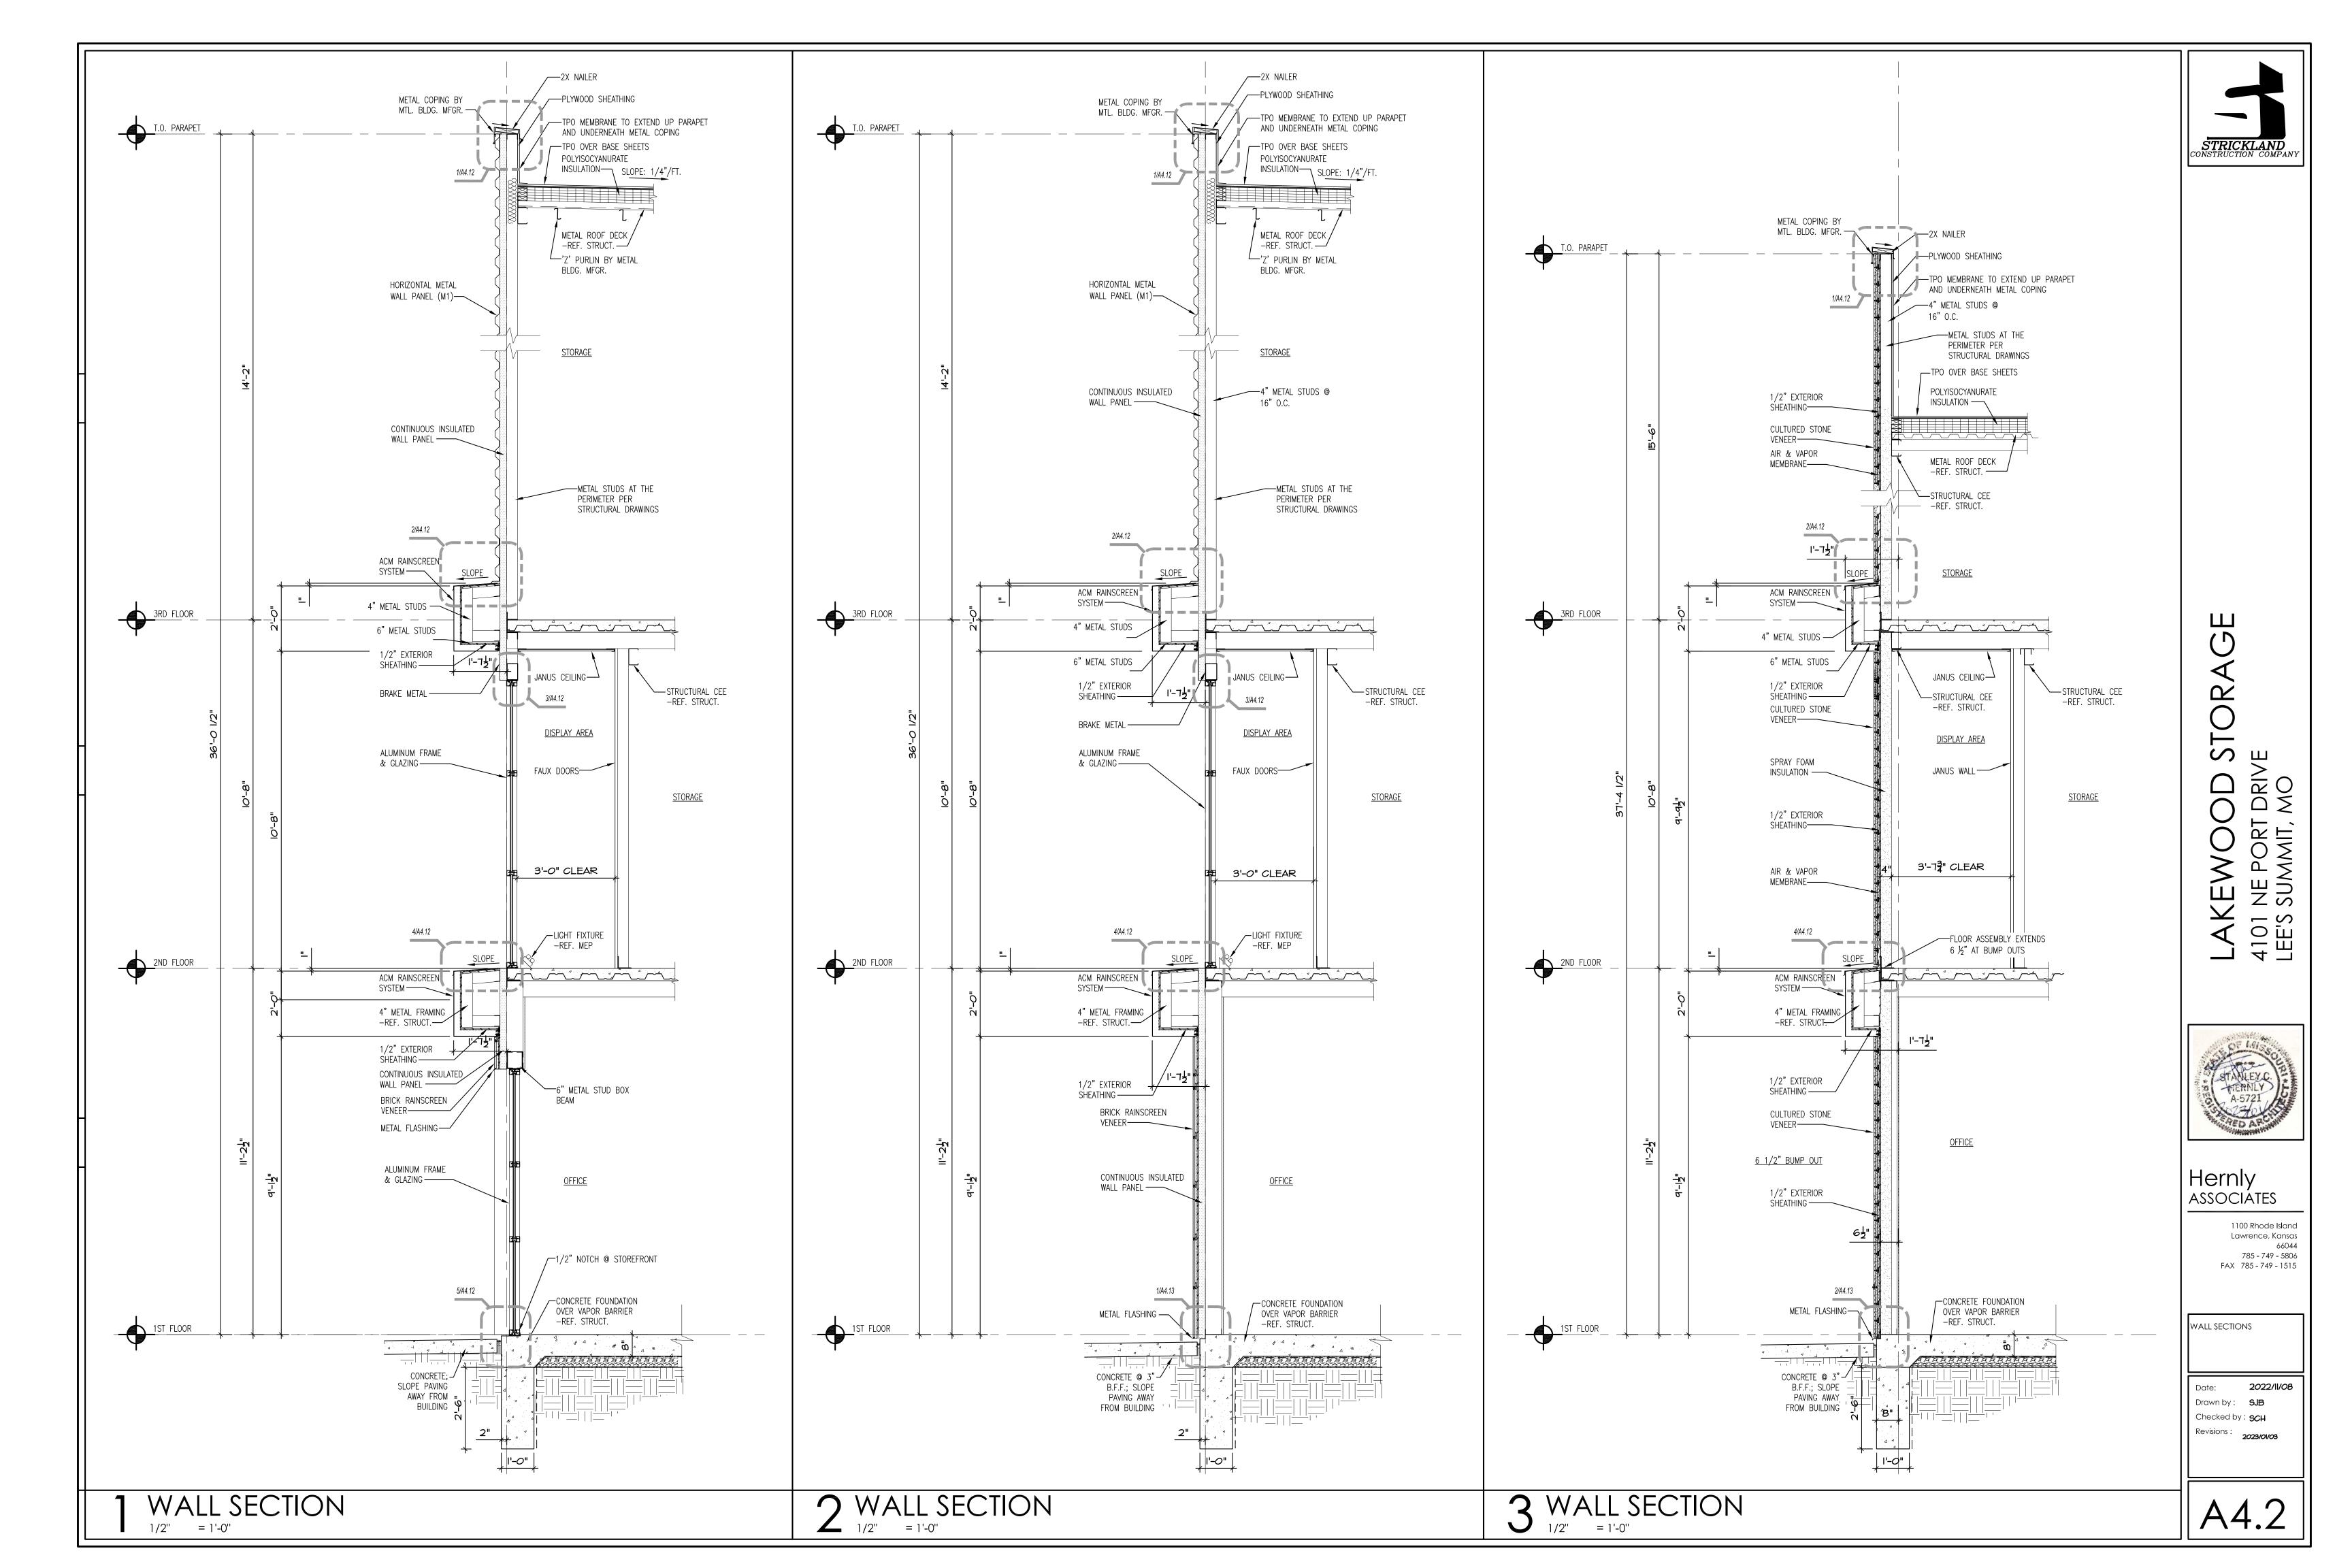


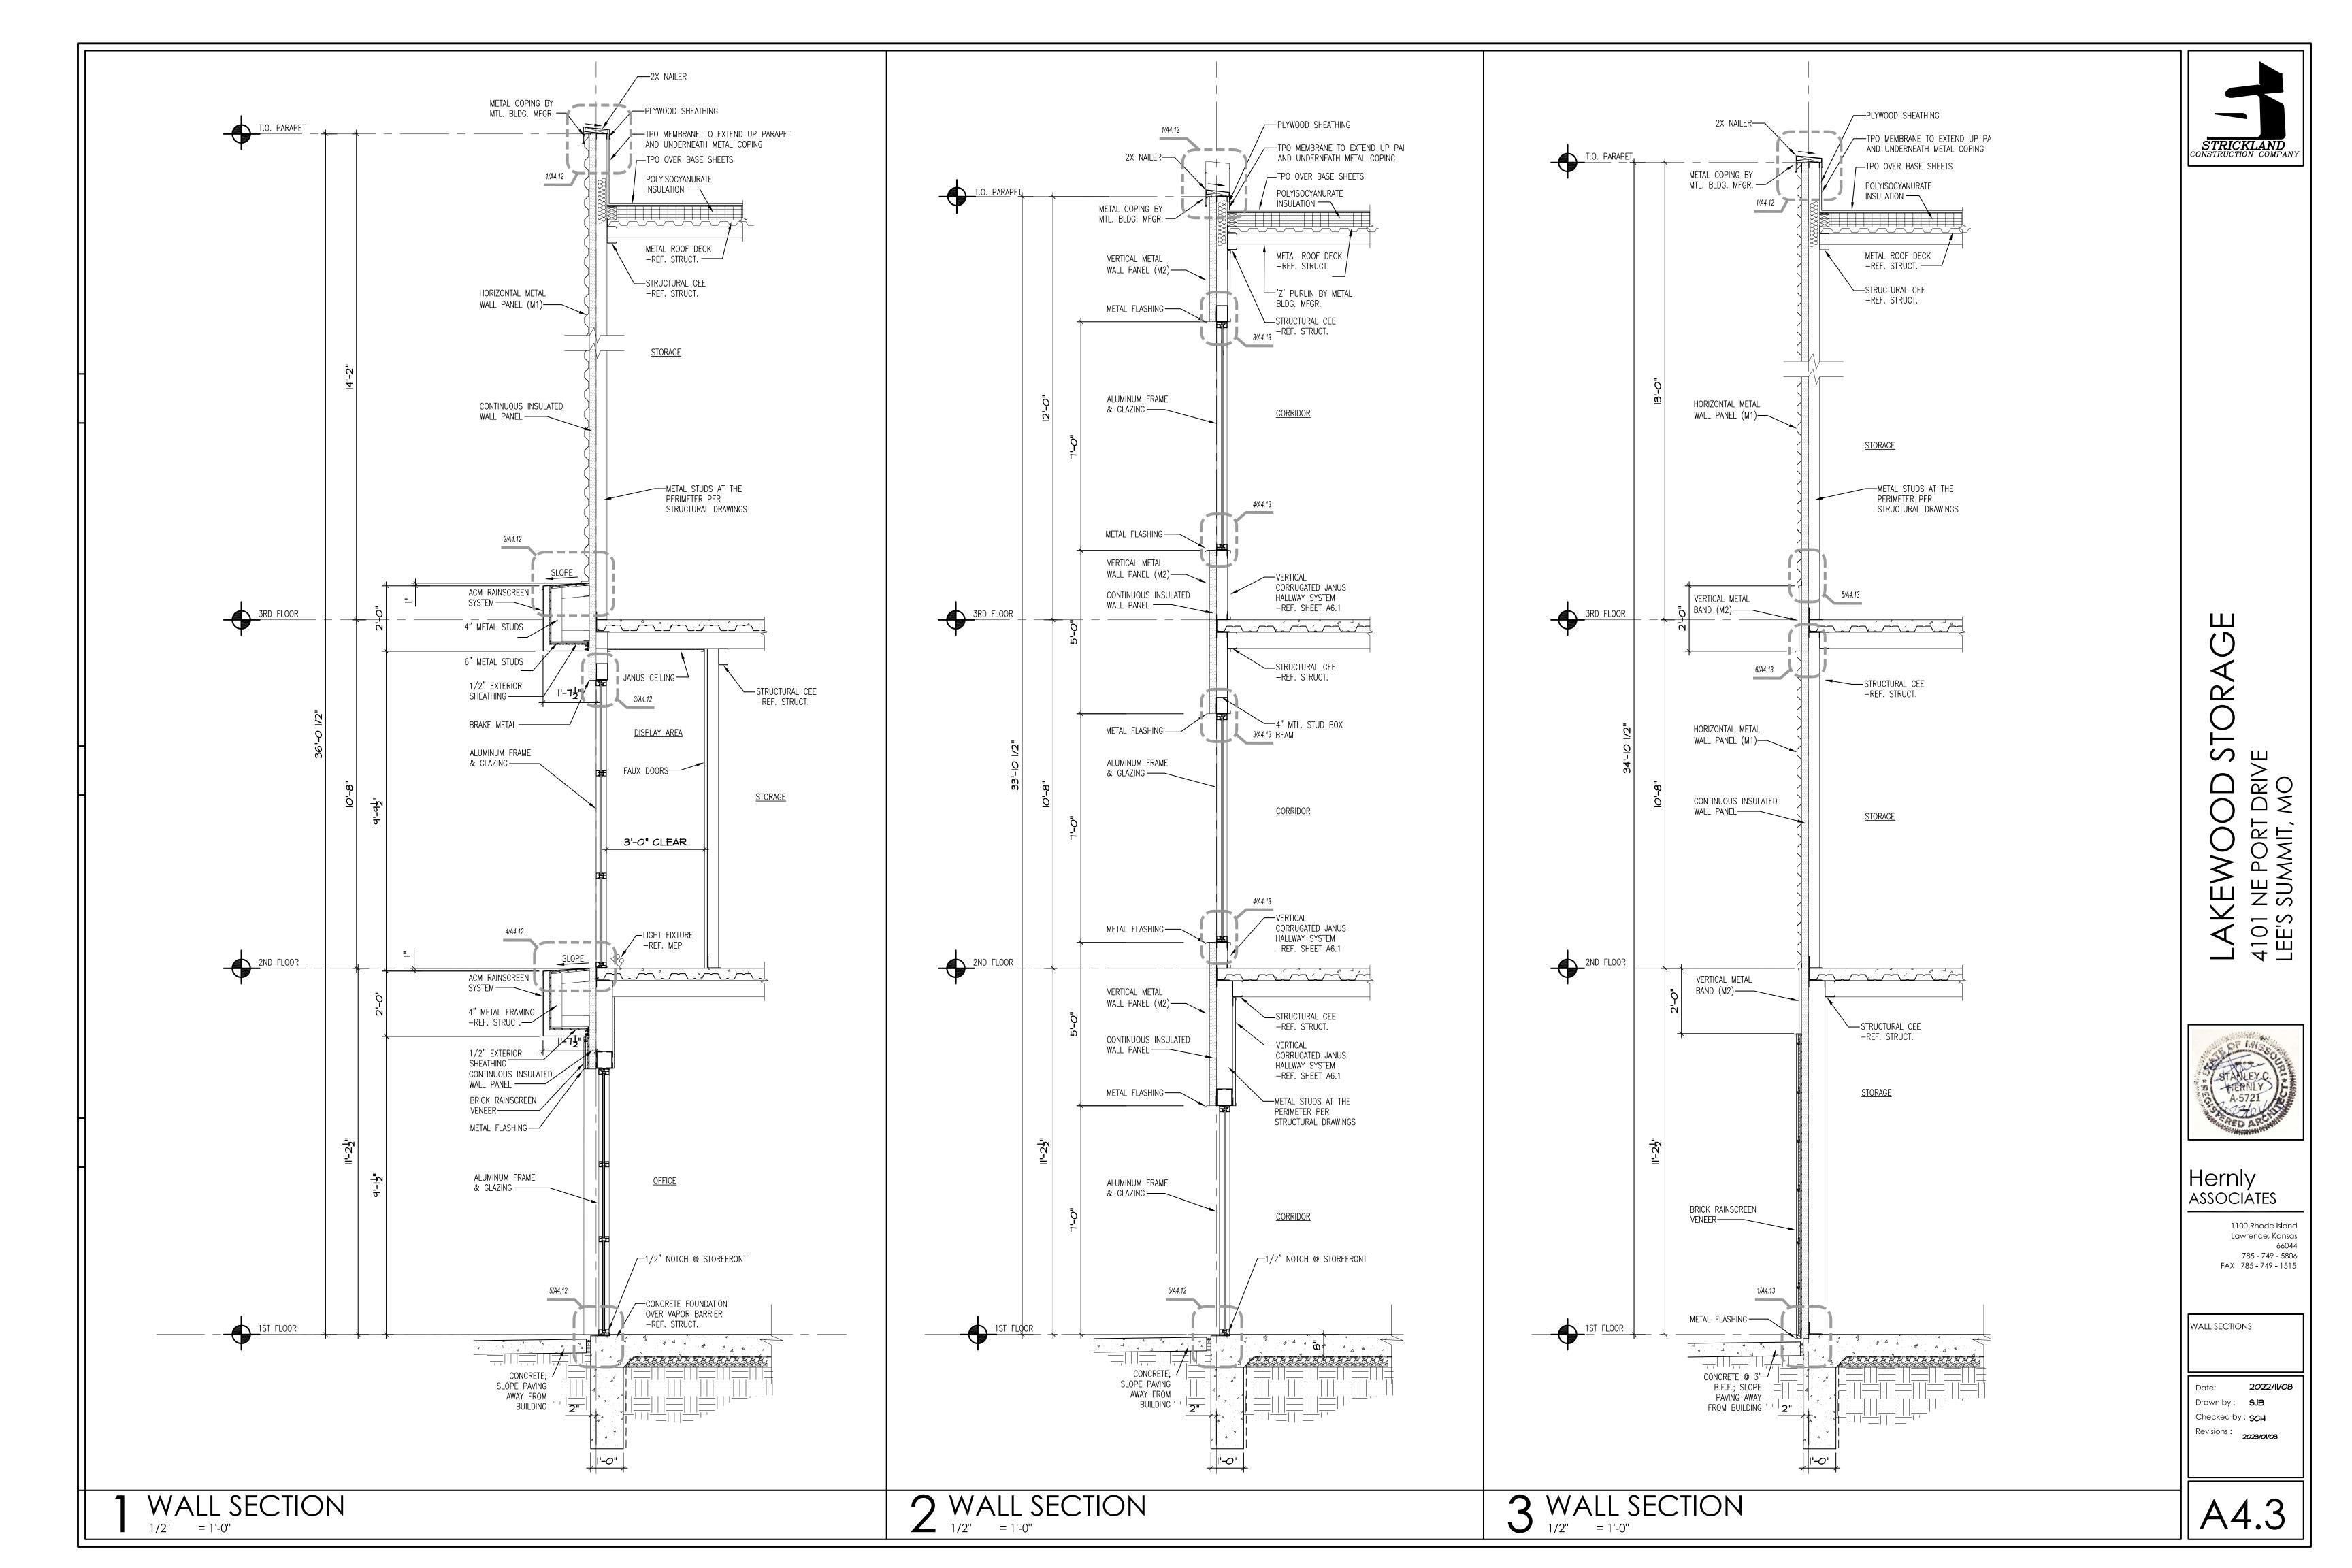


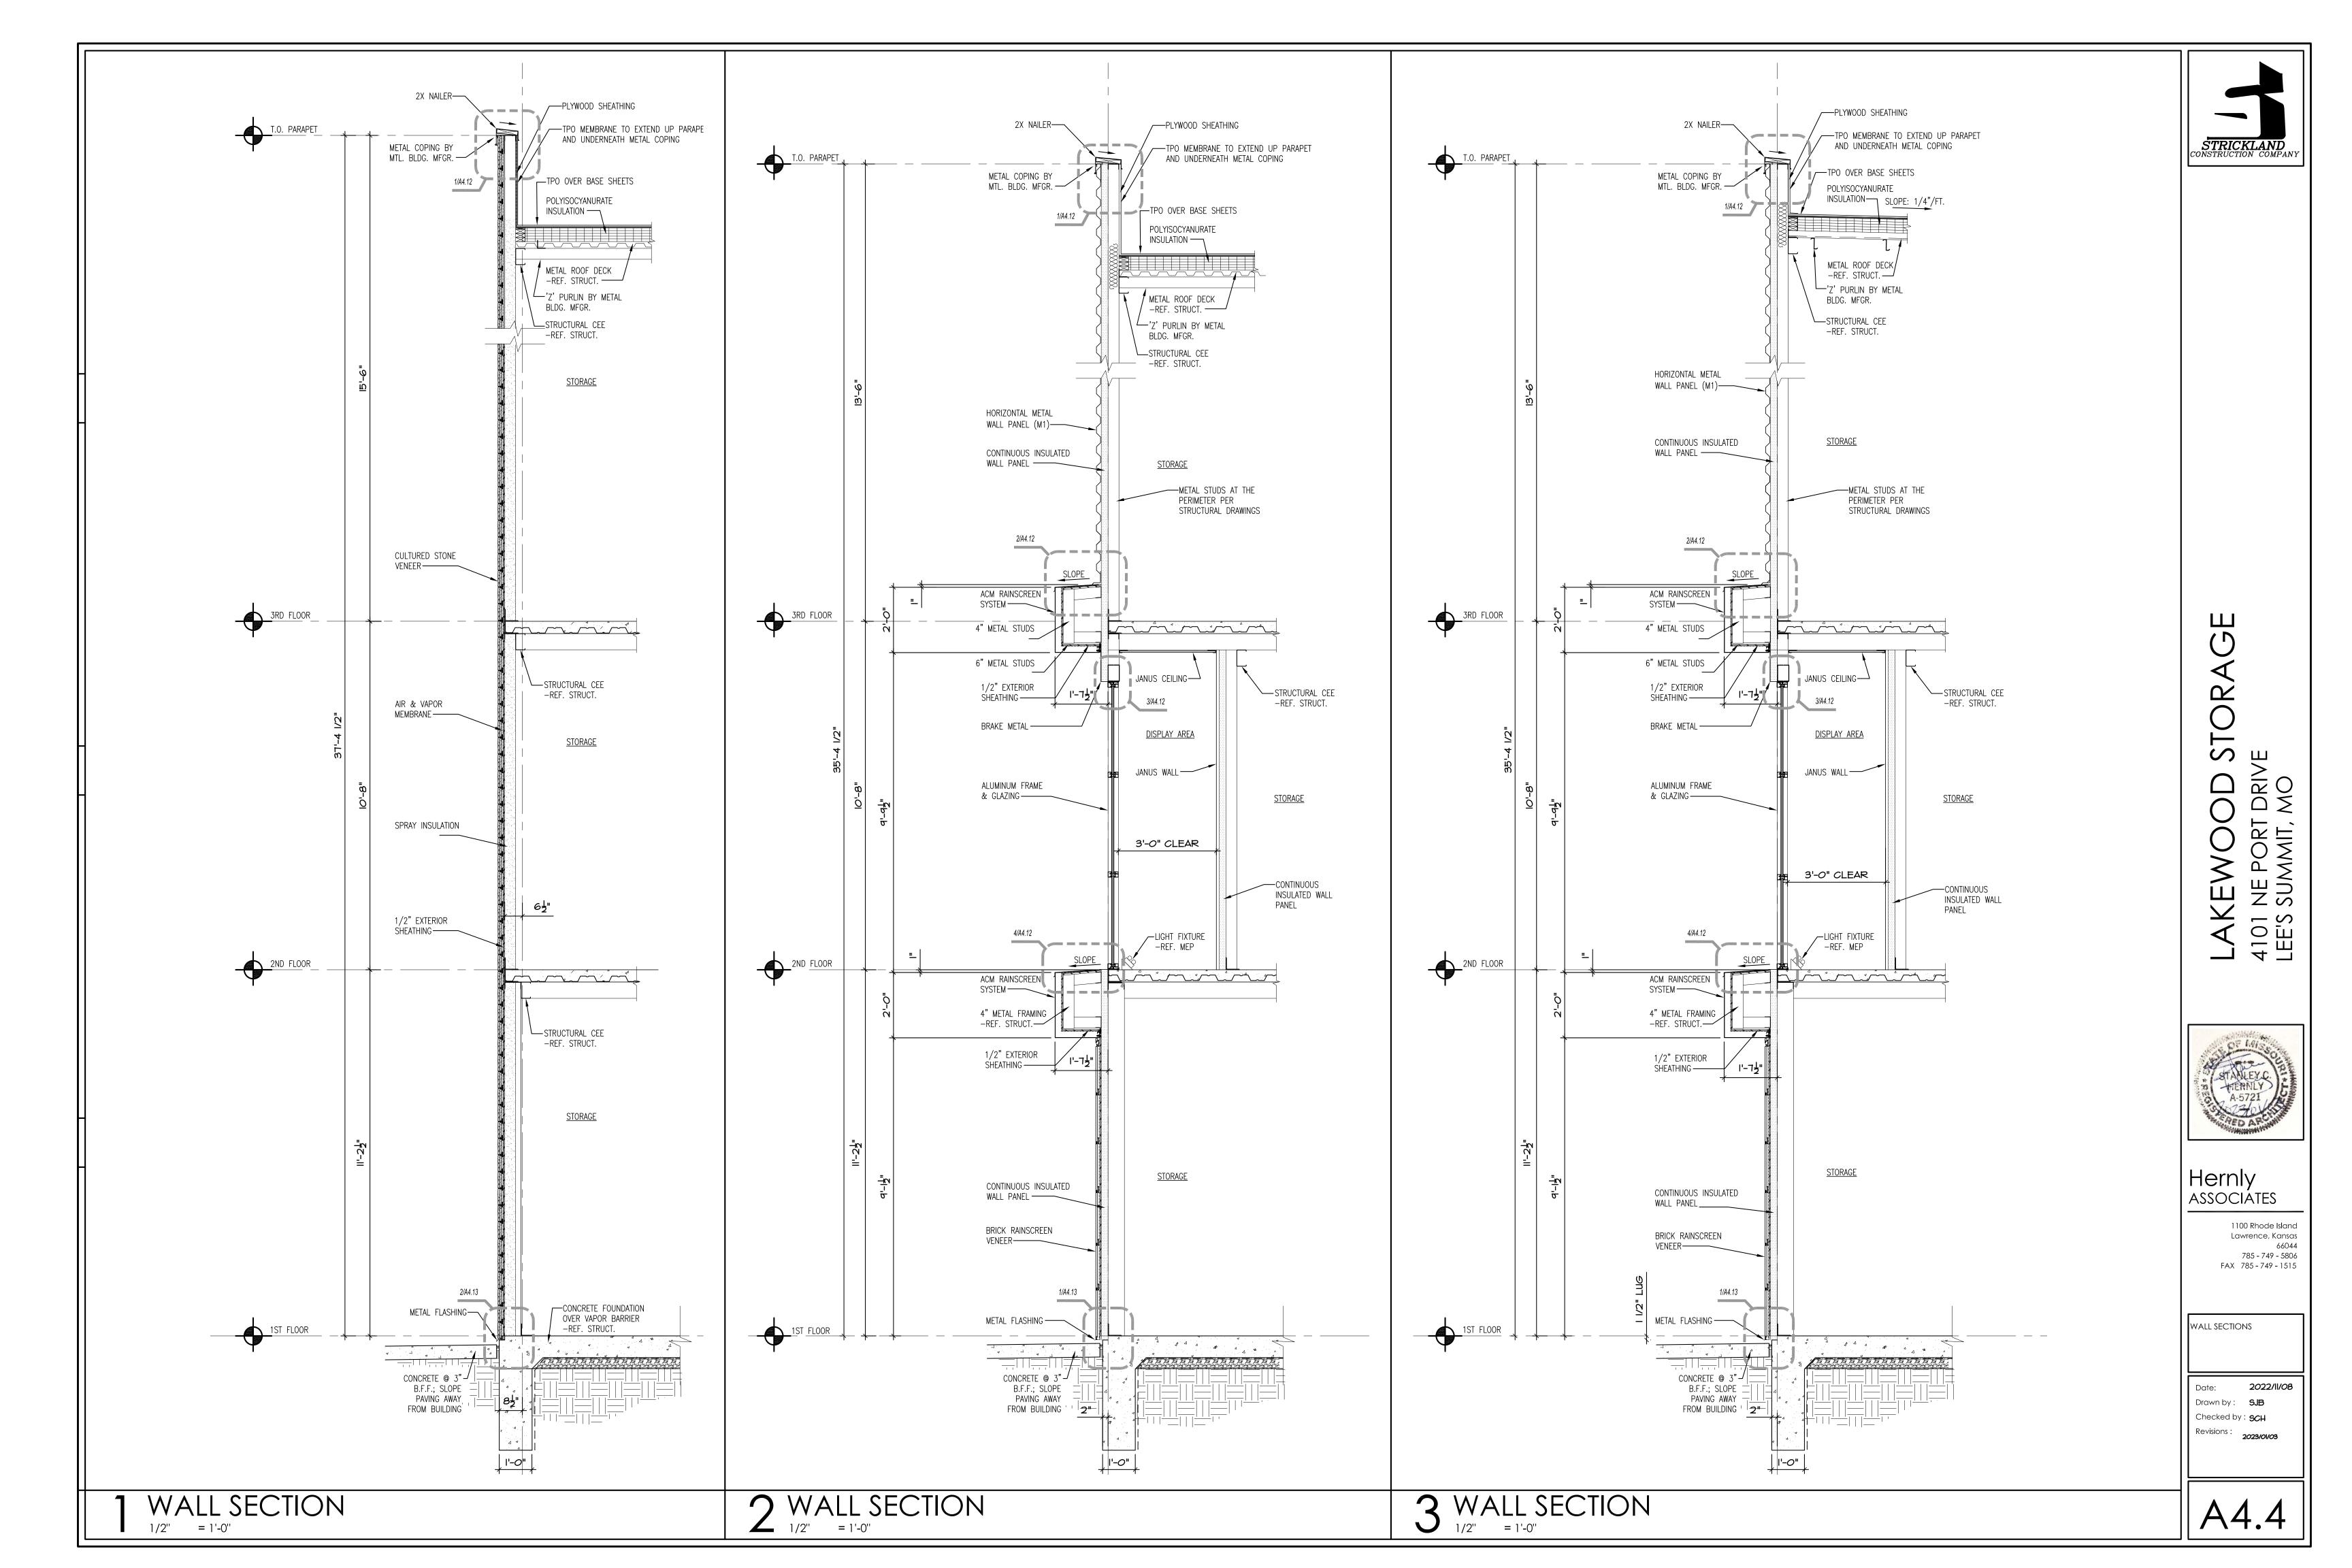

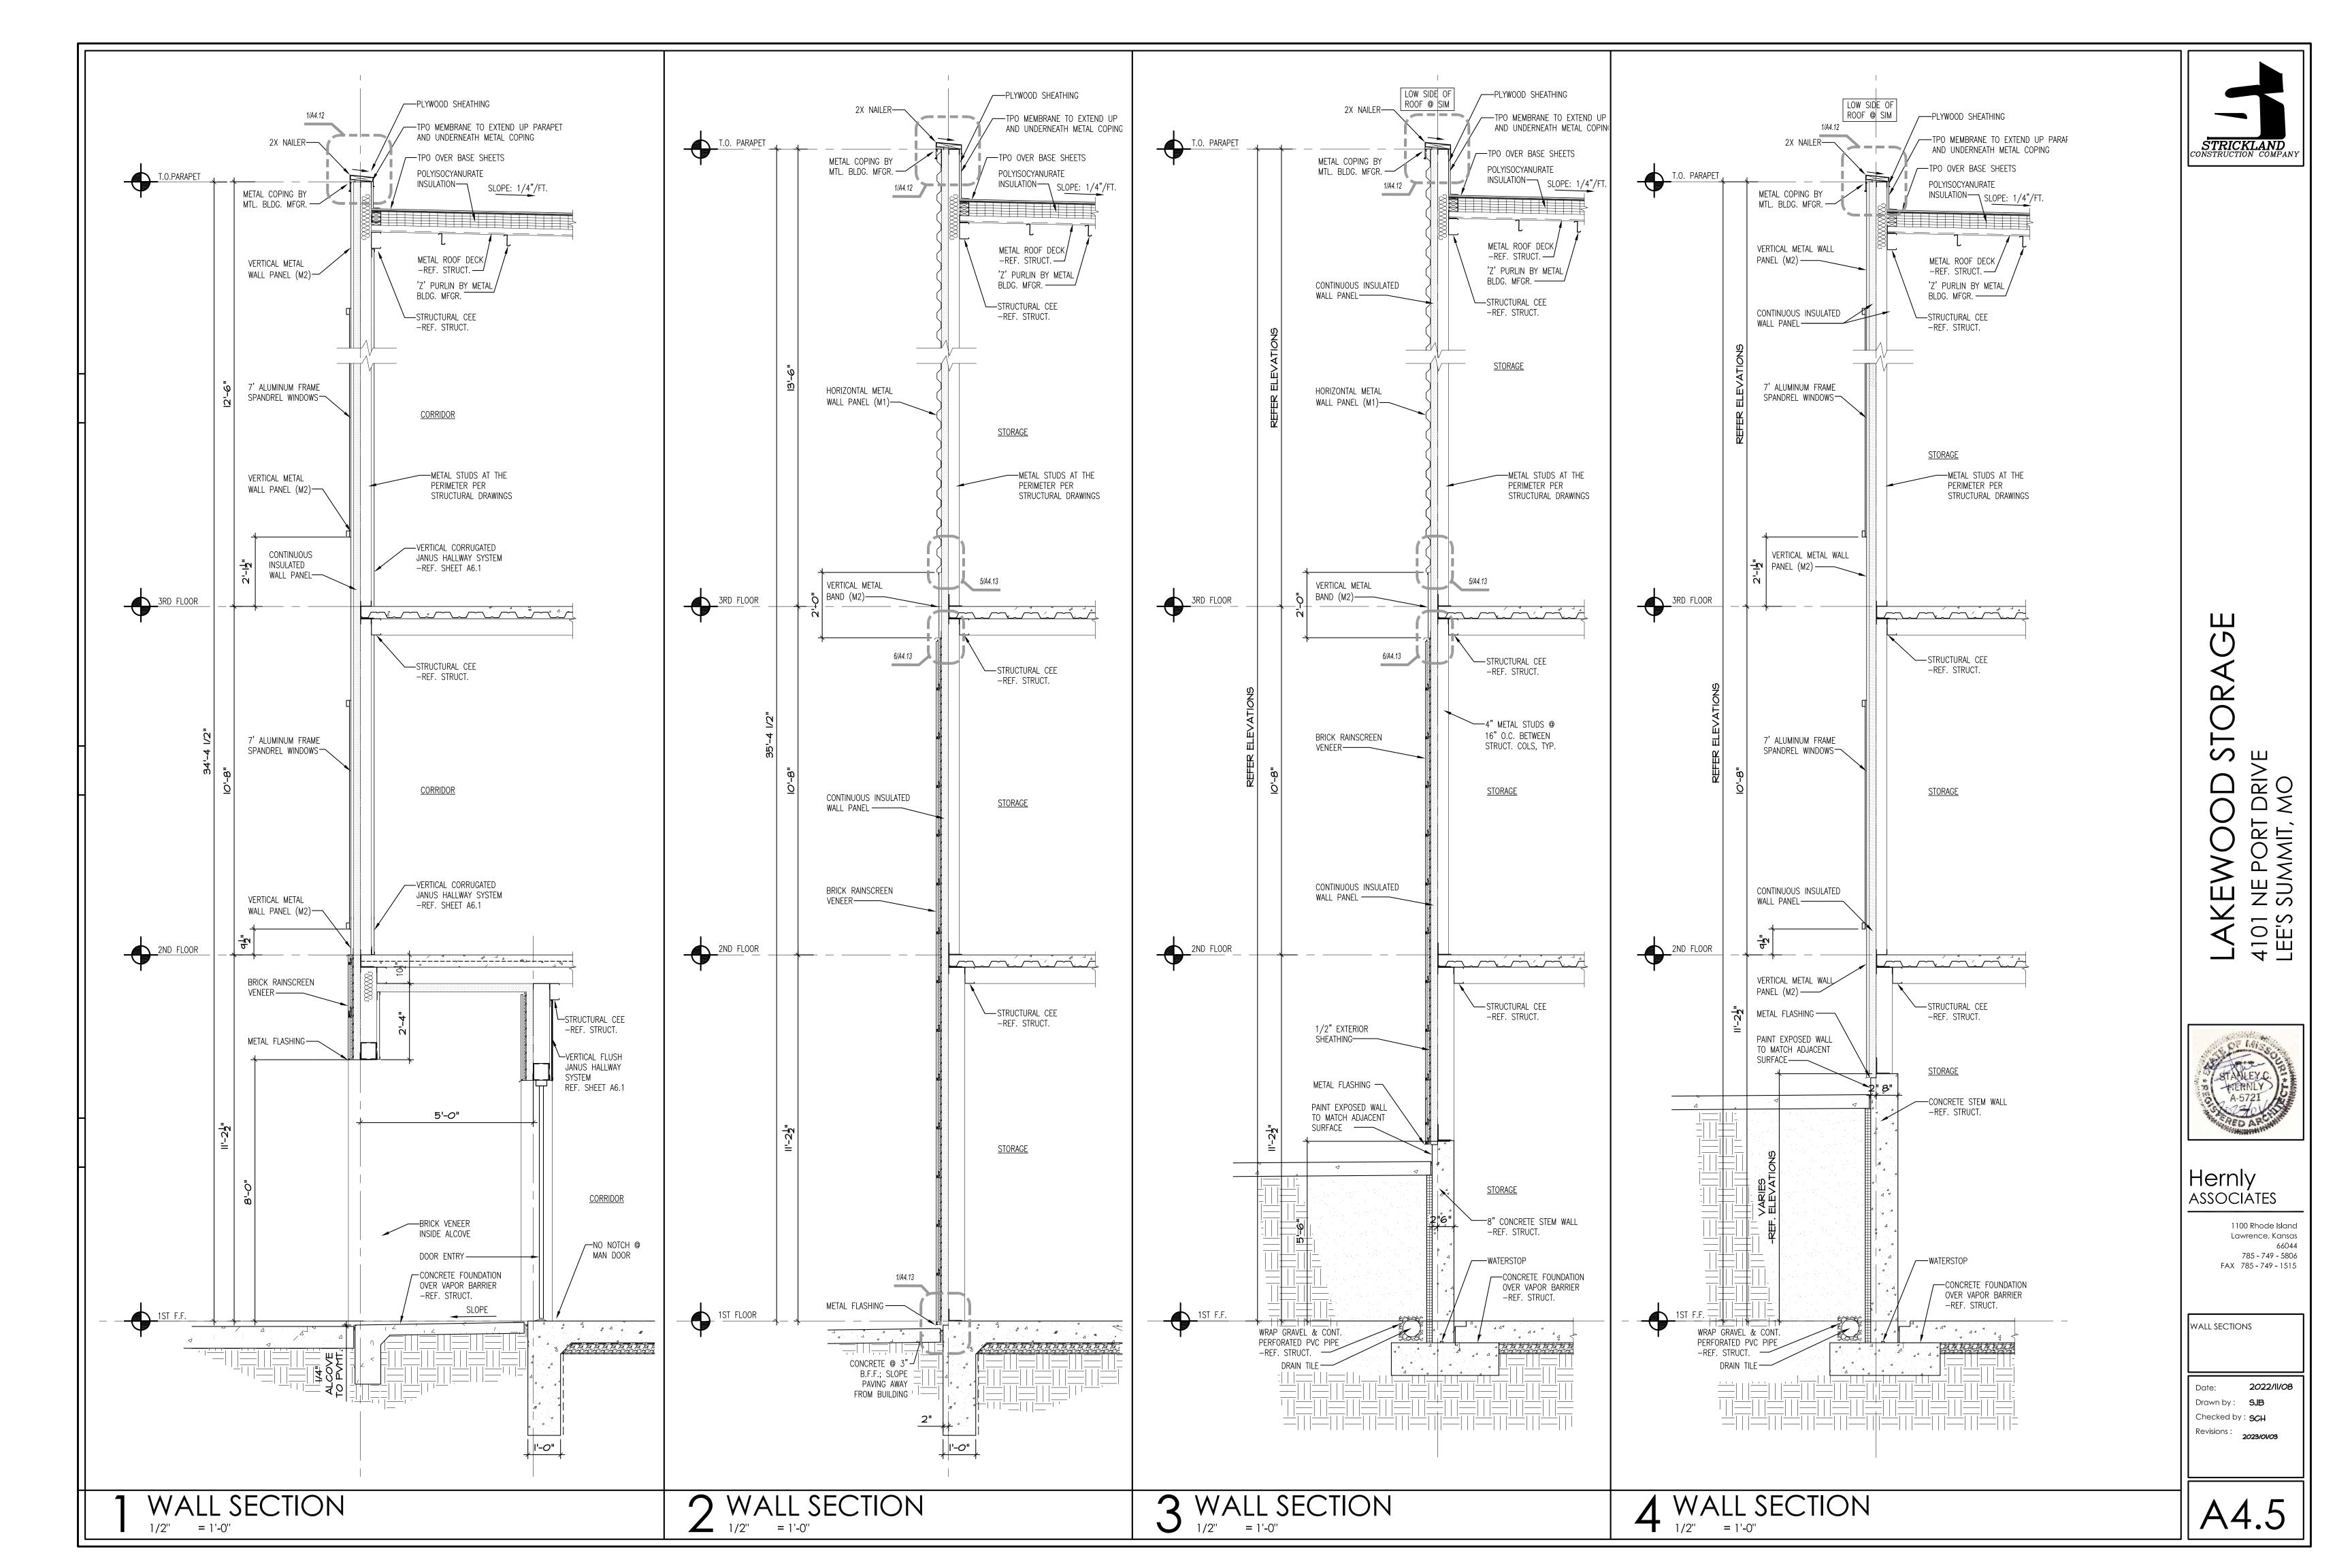


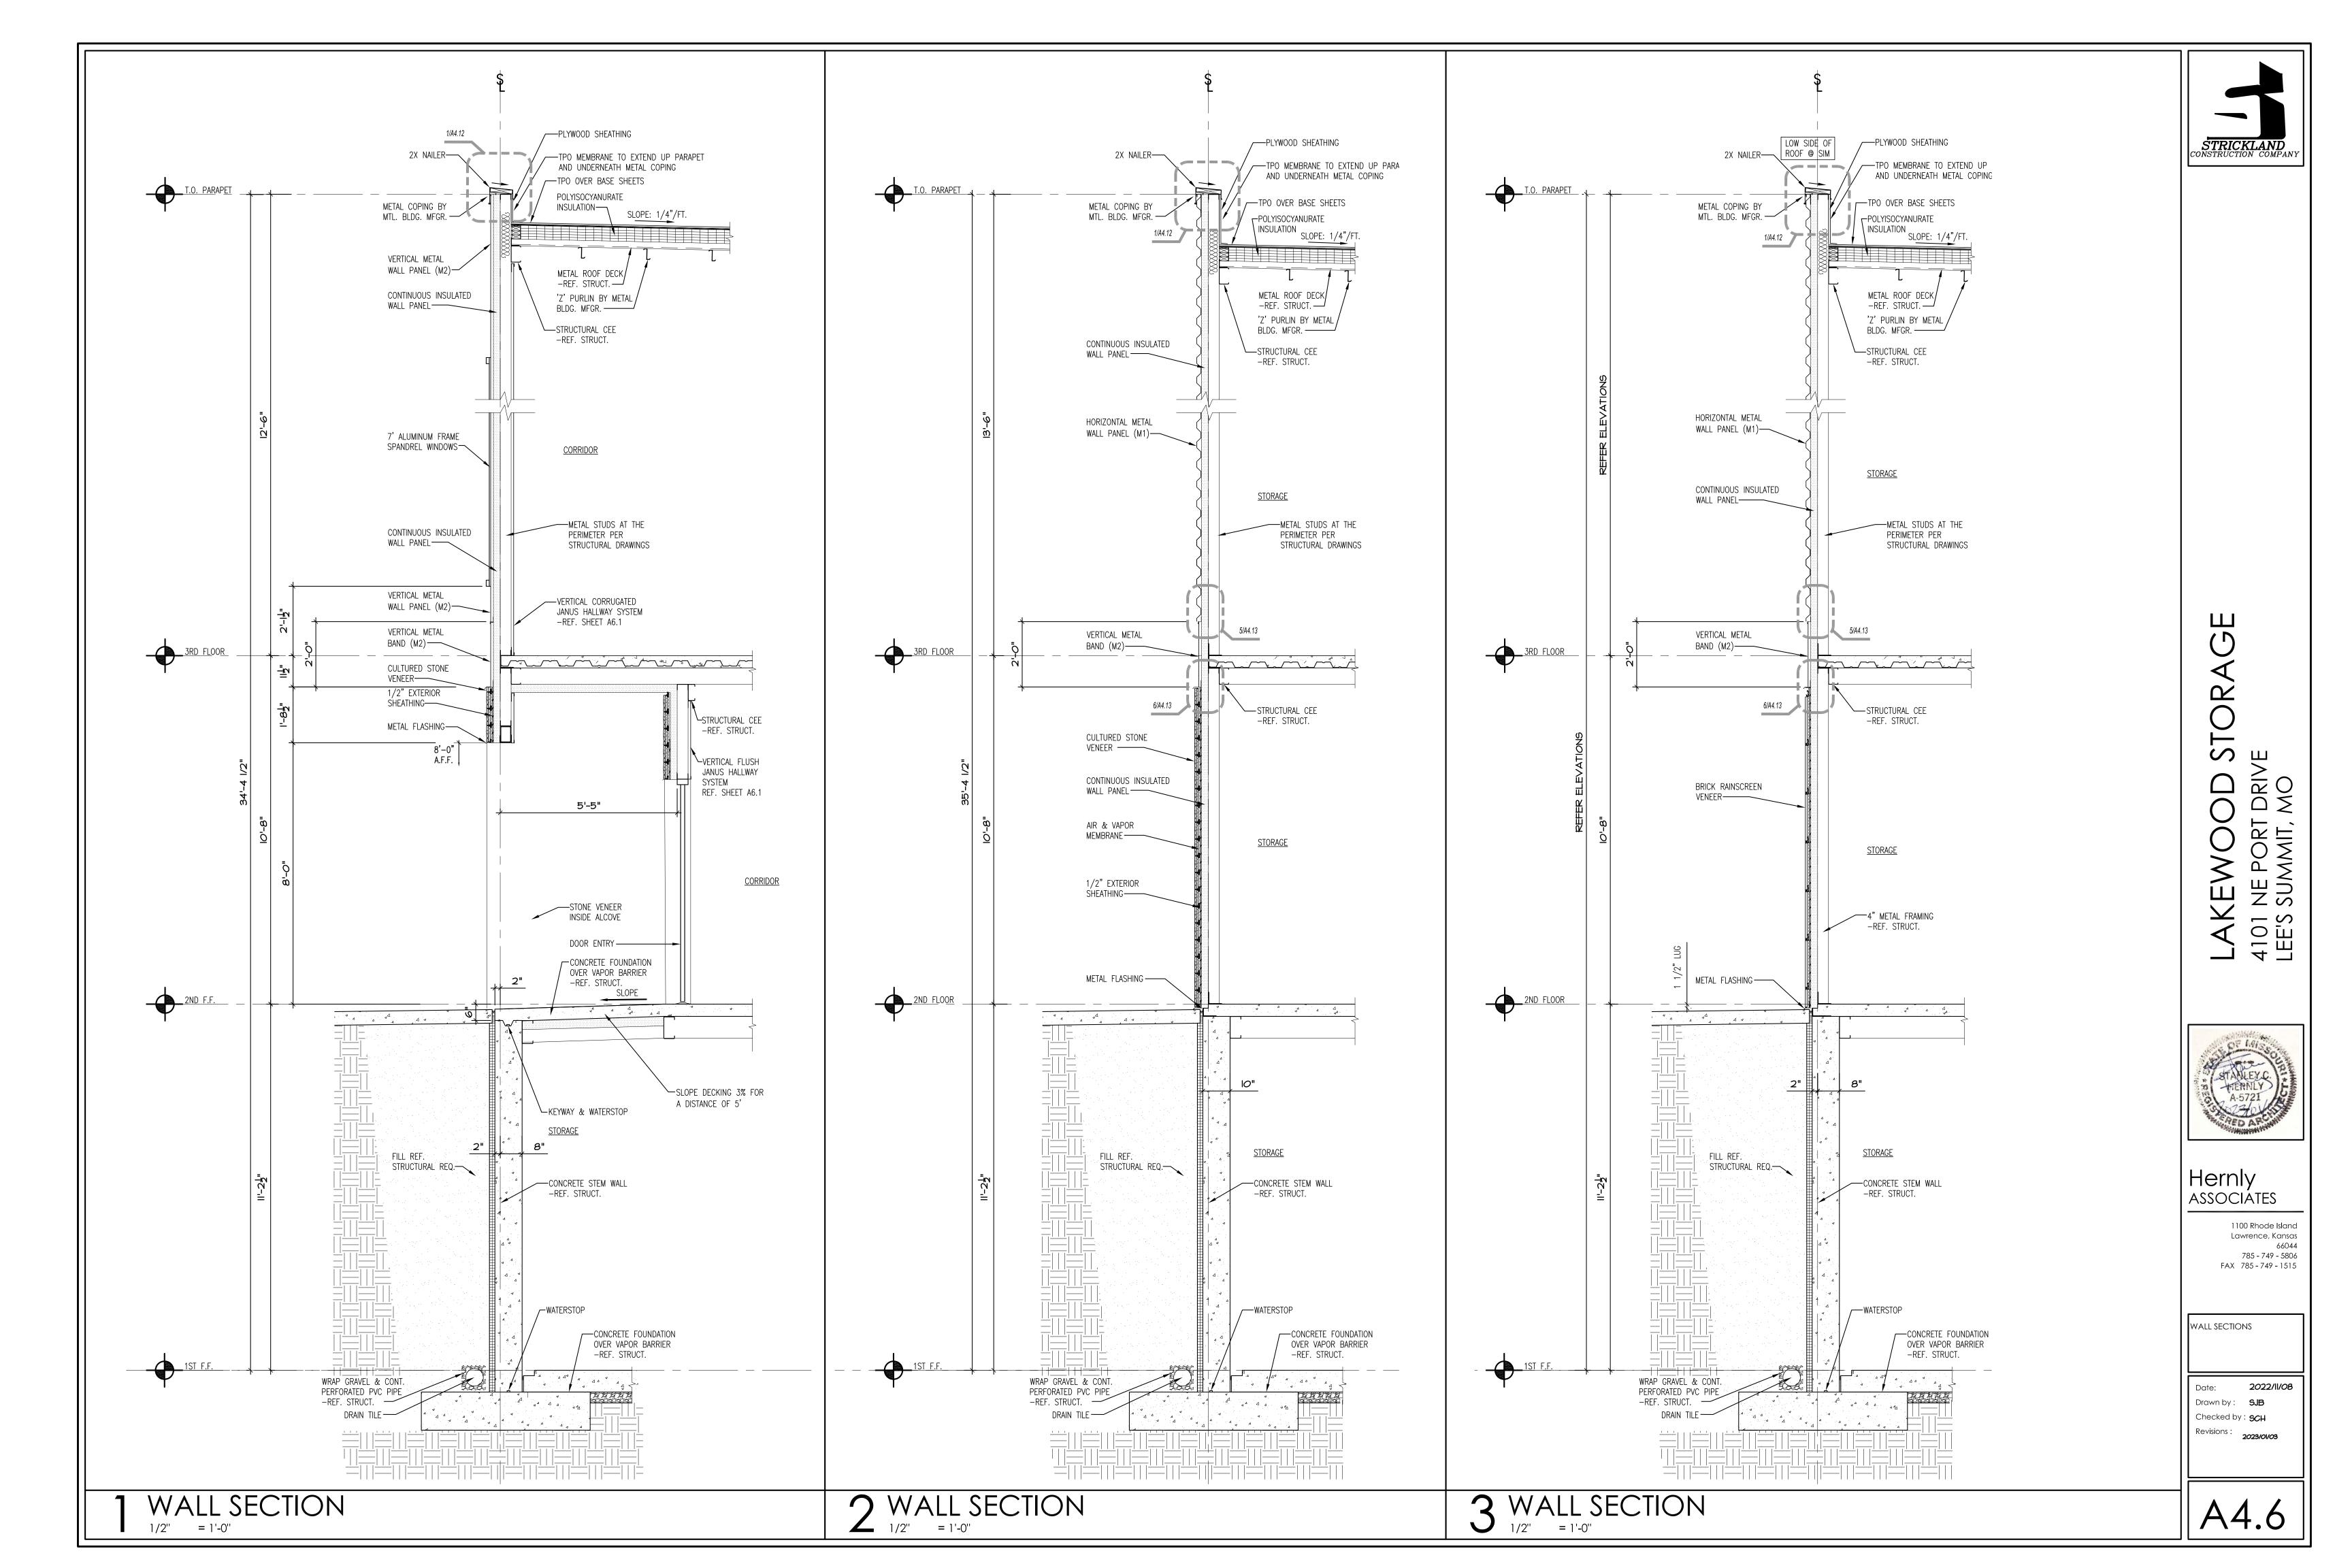

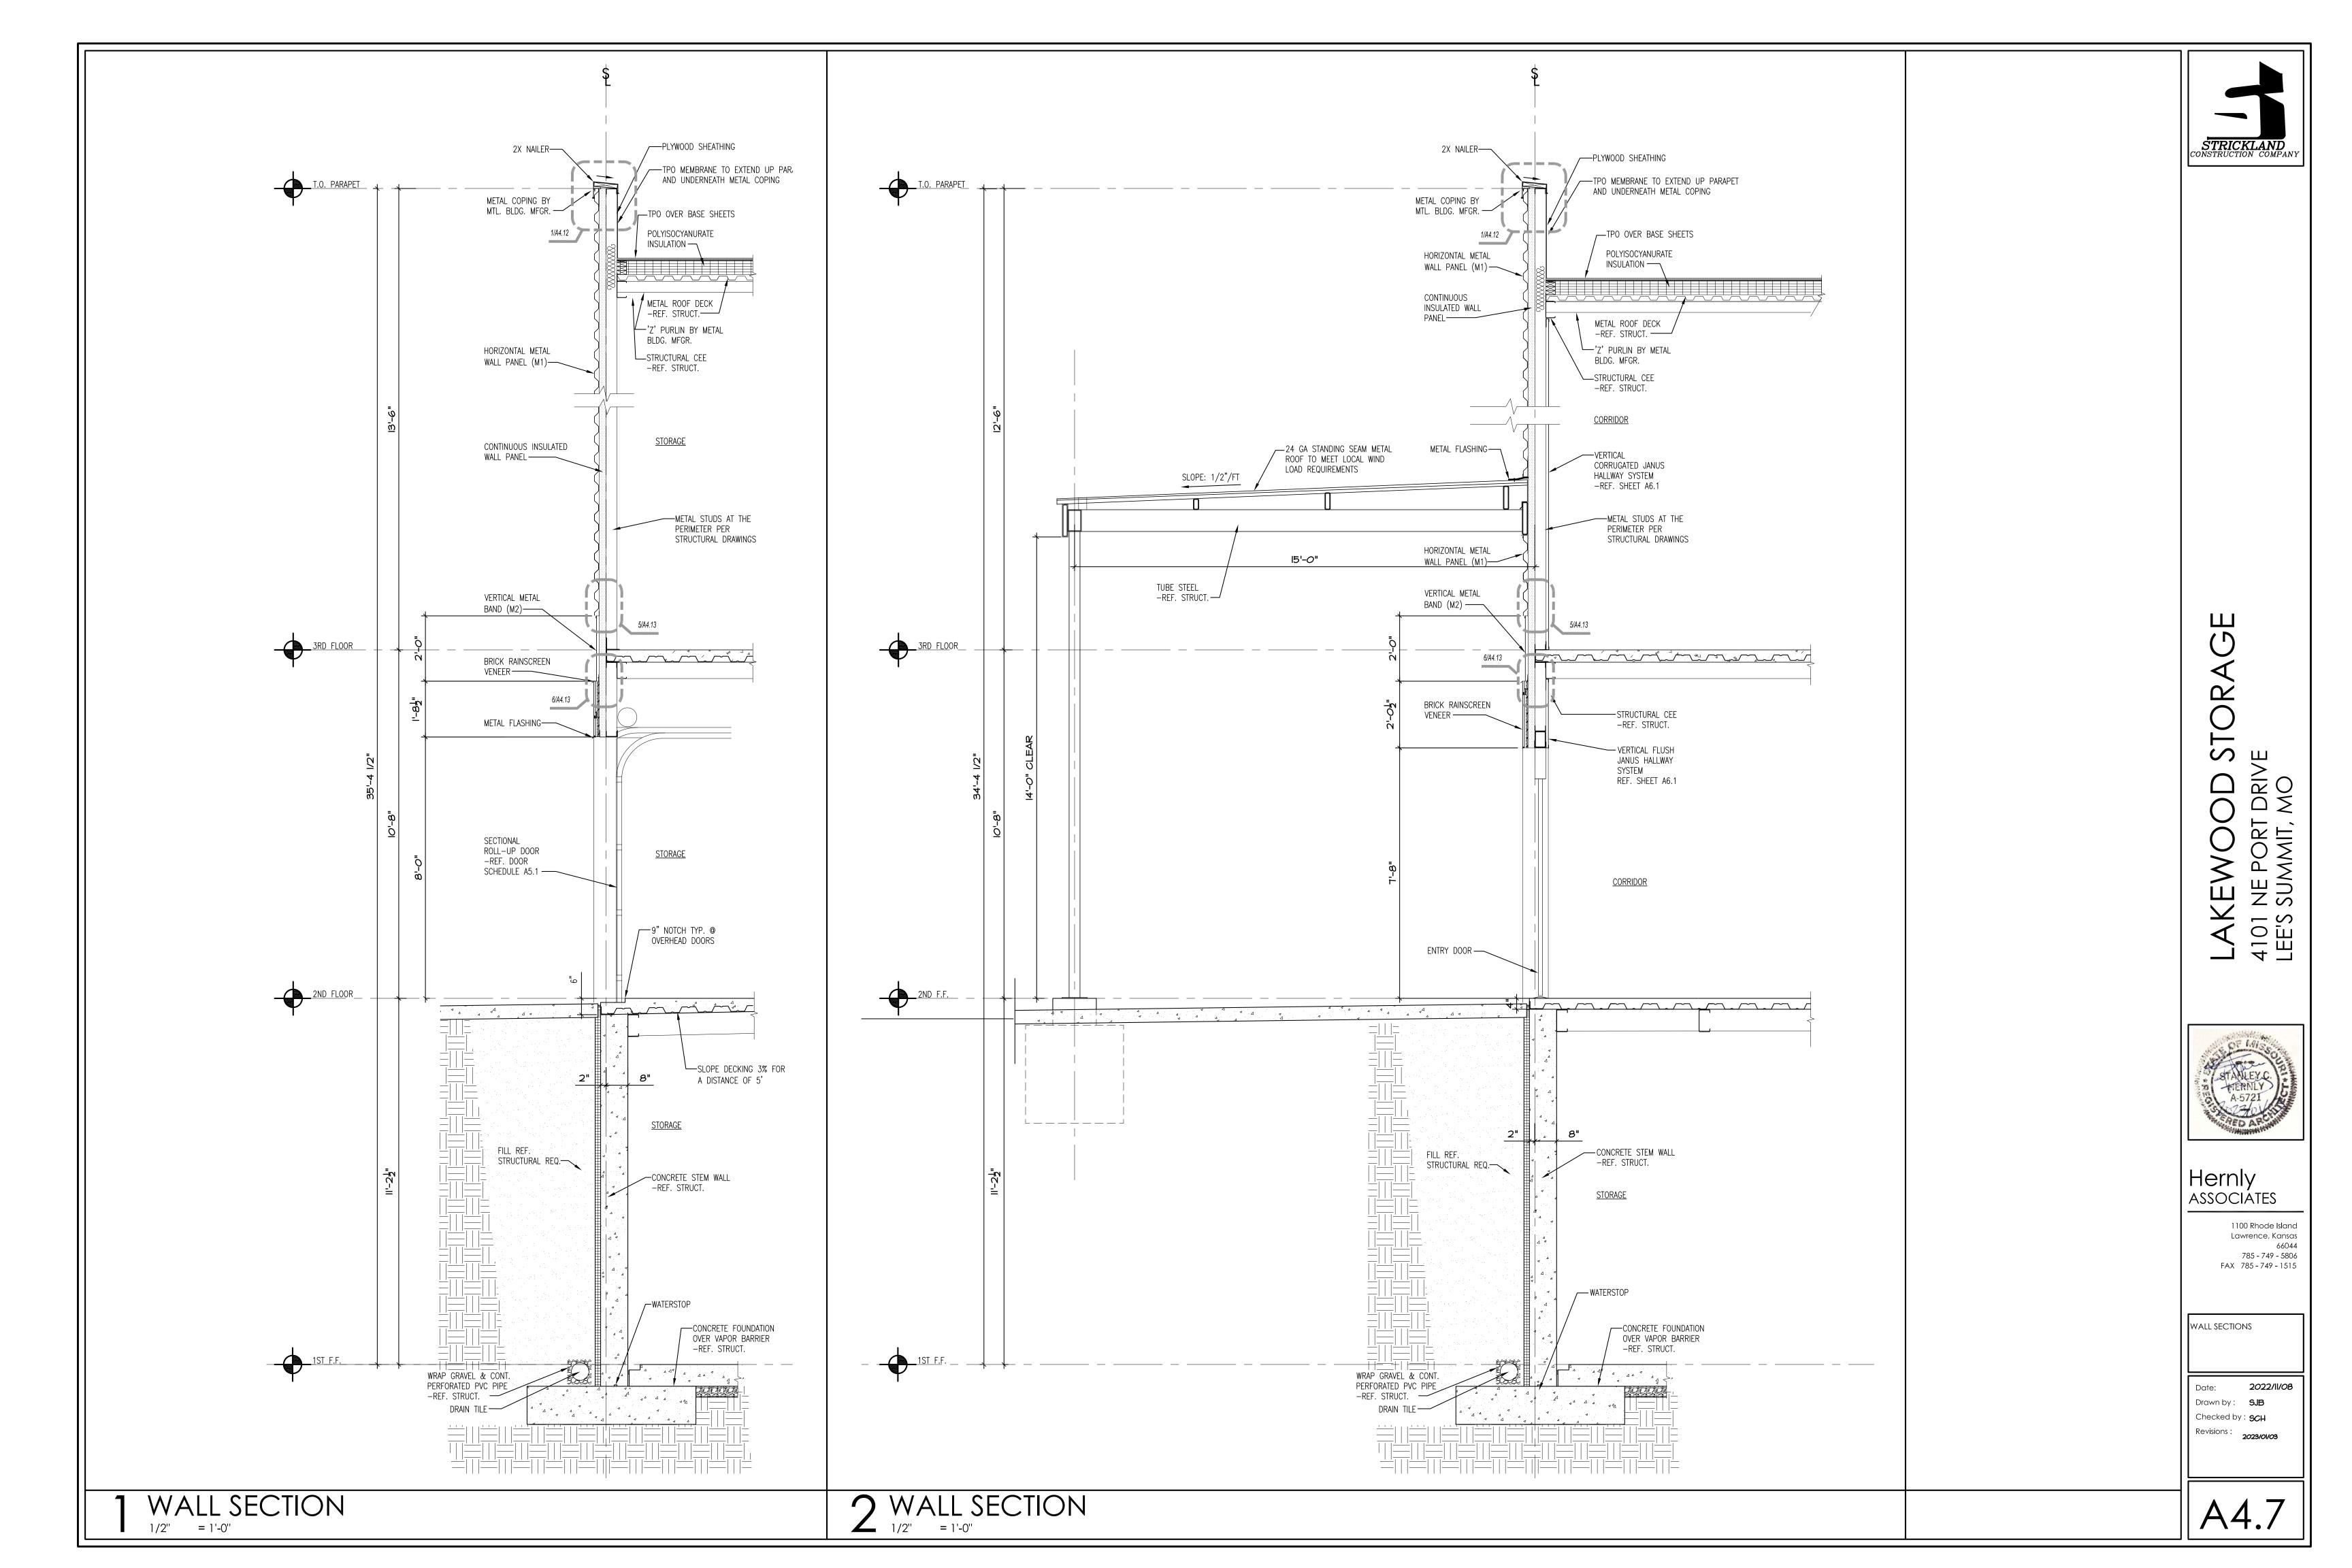

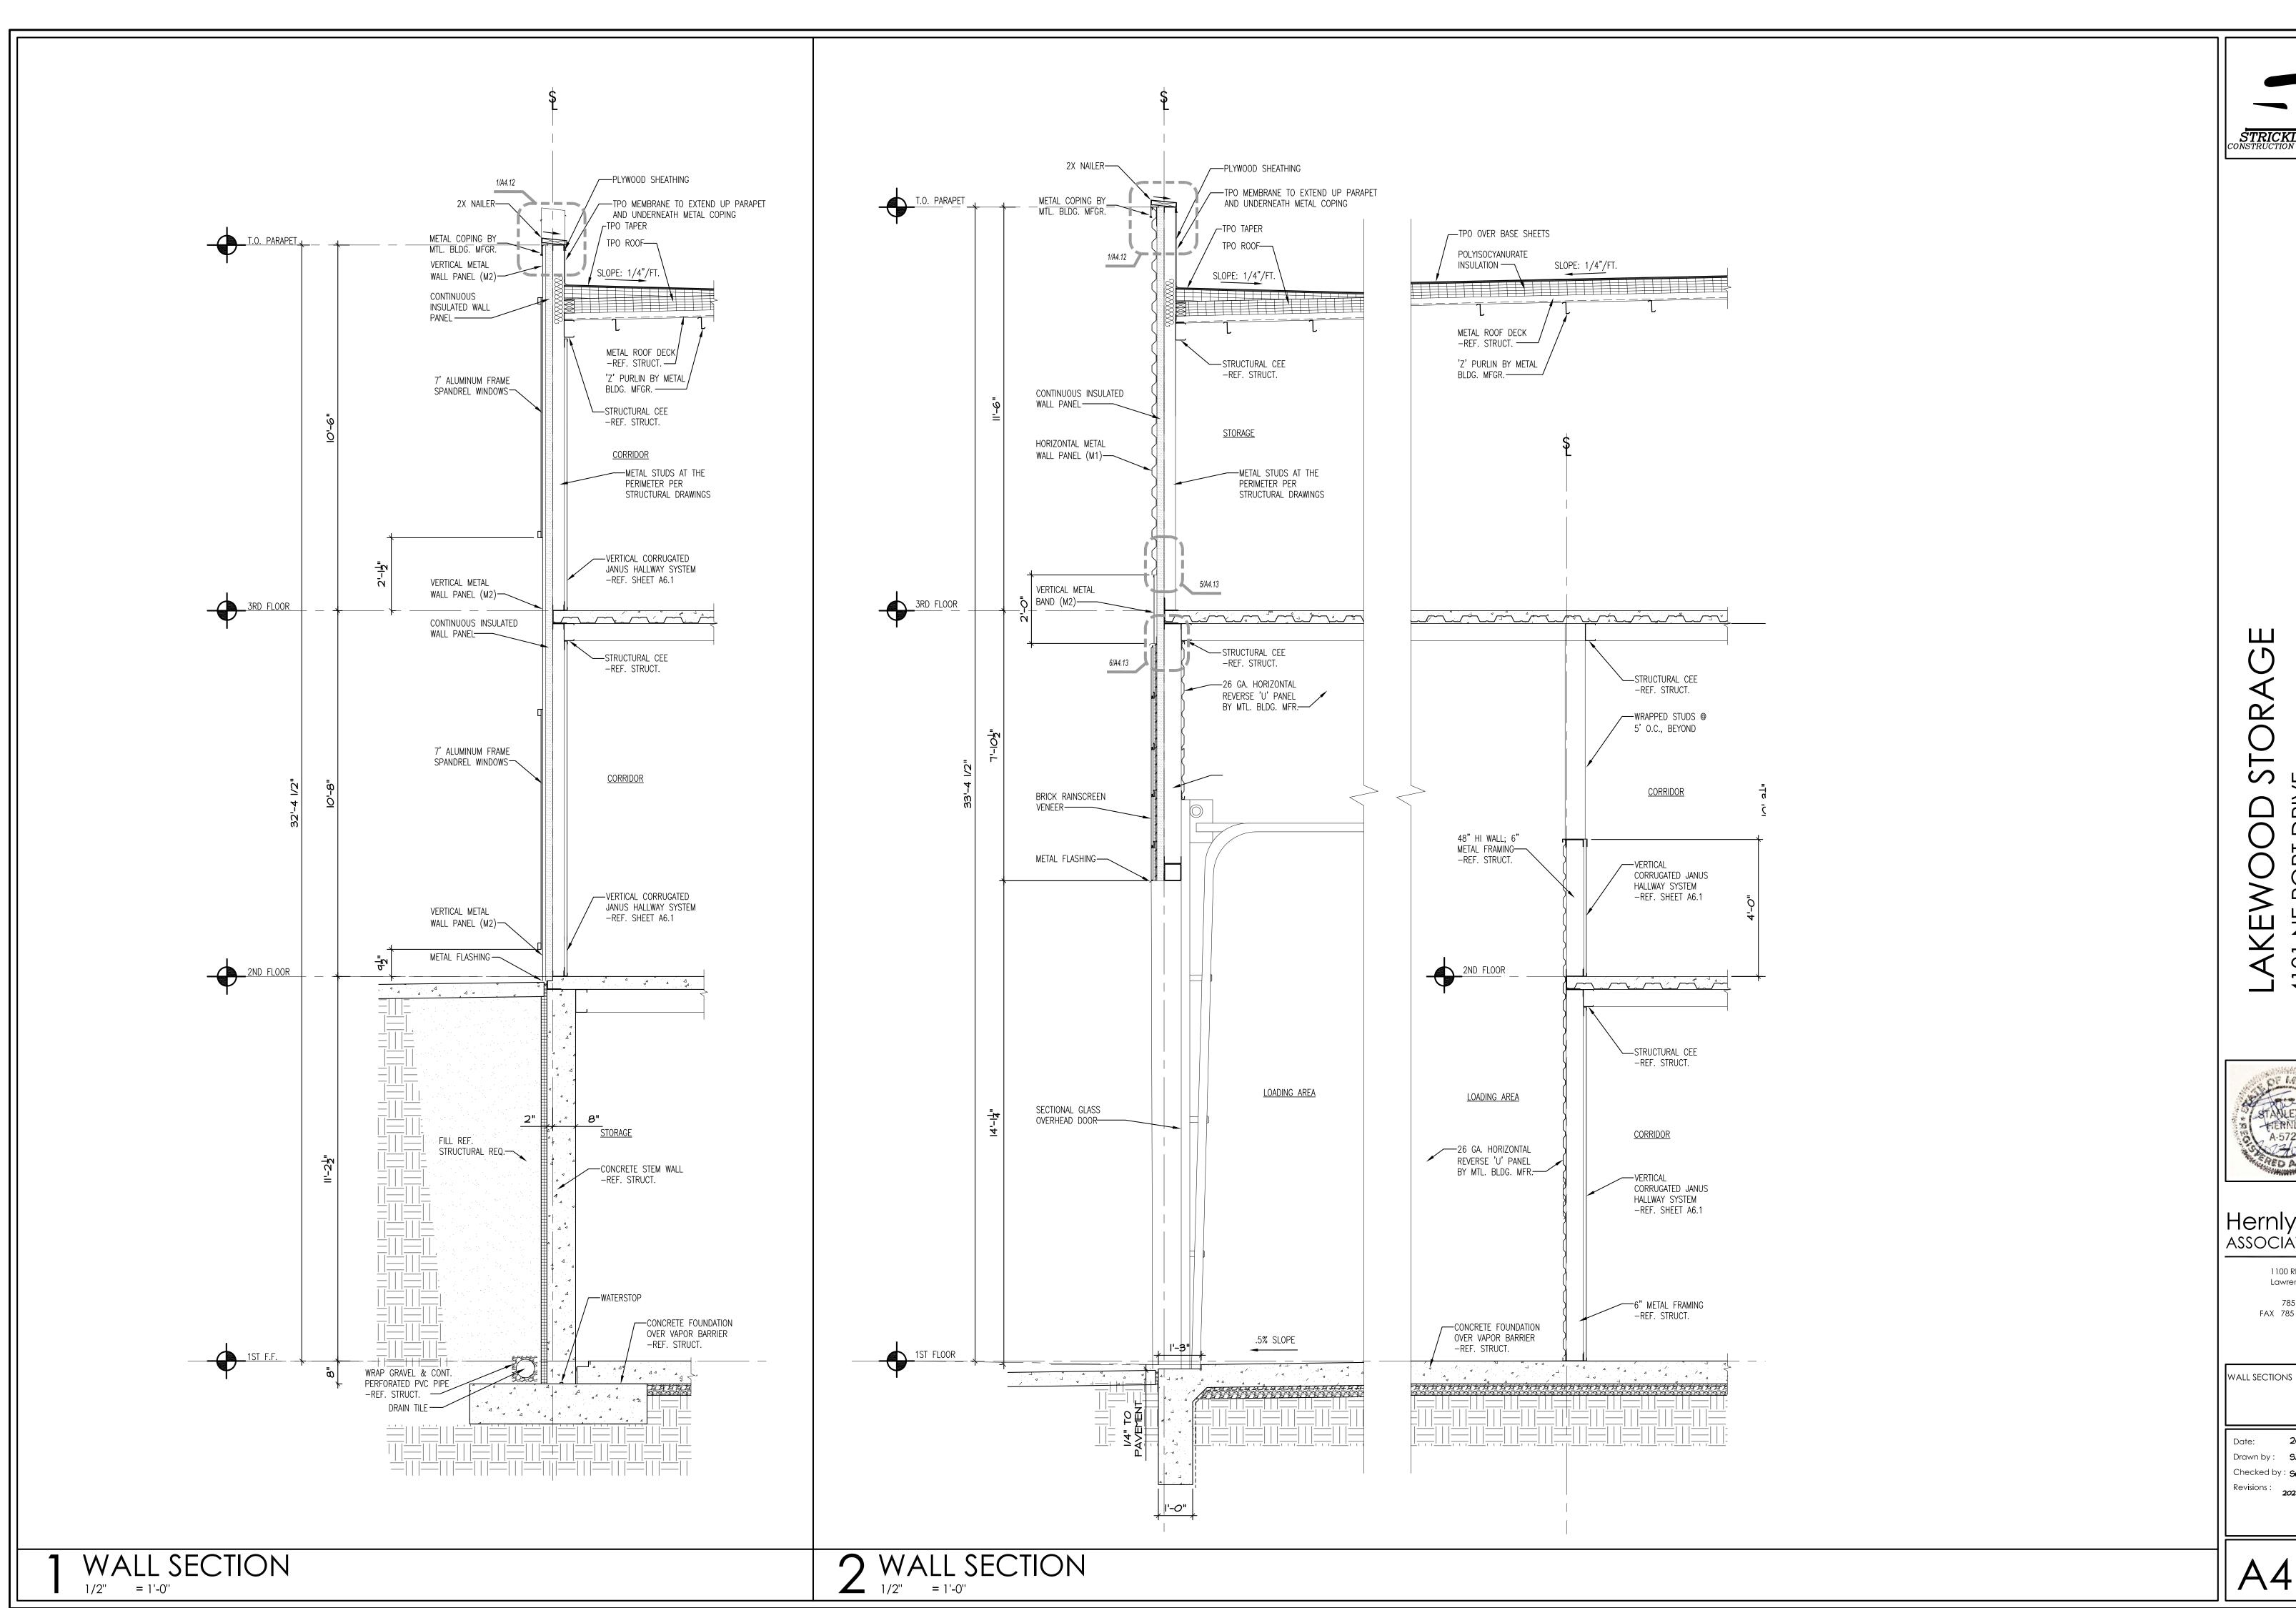


S m NE PORT SUMMIT, 4101 LEE'S

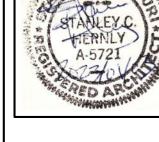



Hernly ASSOCIATES


1100 Rhode Island Lawrence, Kansas 785 - 749 - 5806 FAX 785 - 749 - 1515


2022/11/08 Drawn by: SJB Checked by: **SCH** Revisions : 2023/01/03

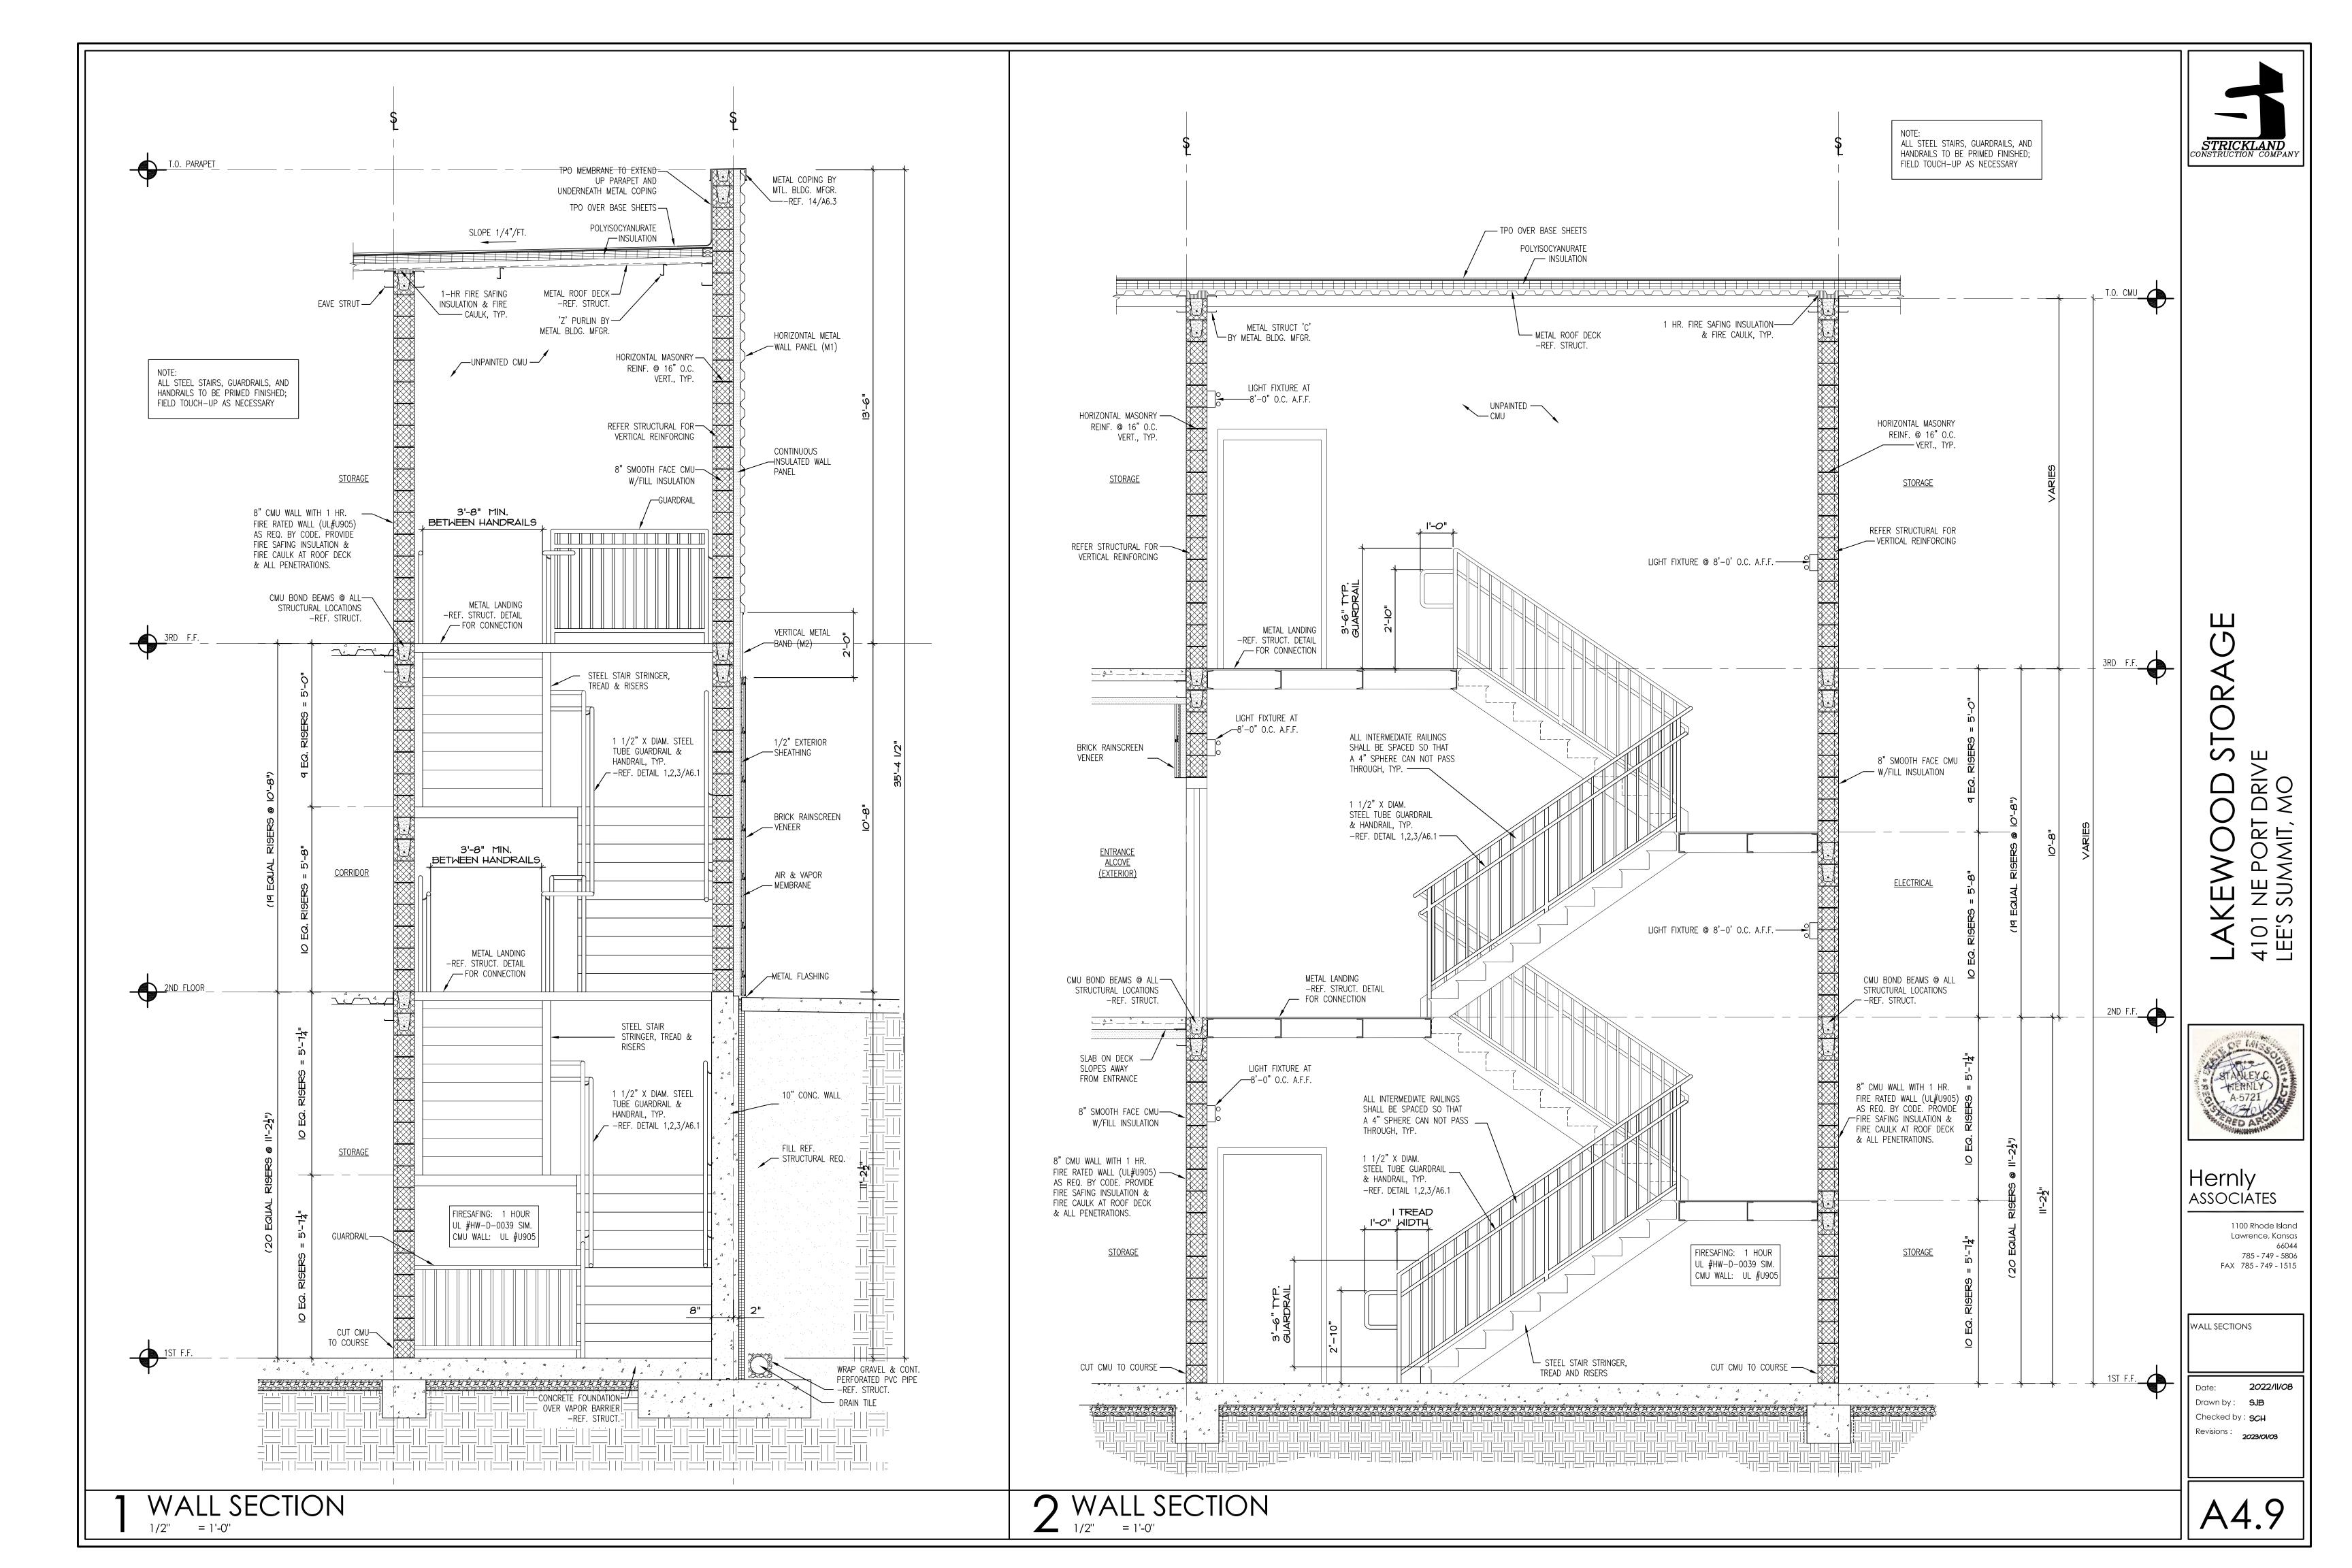


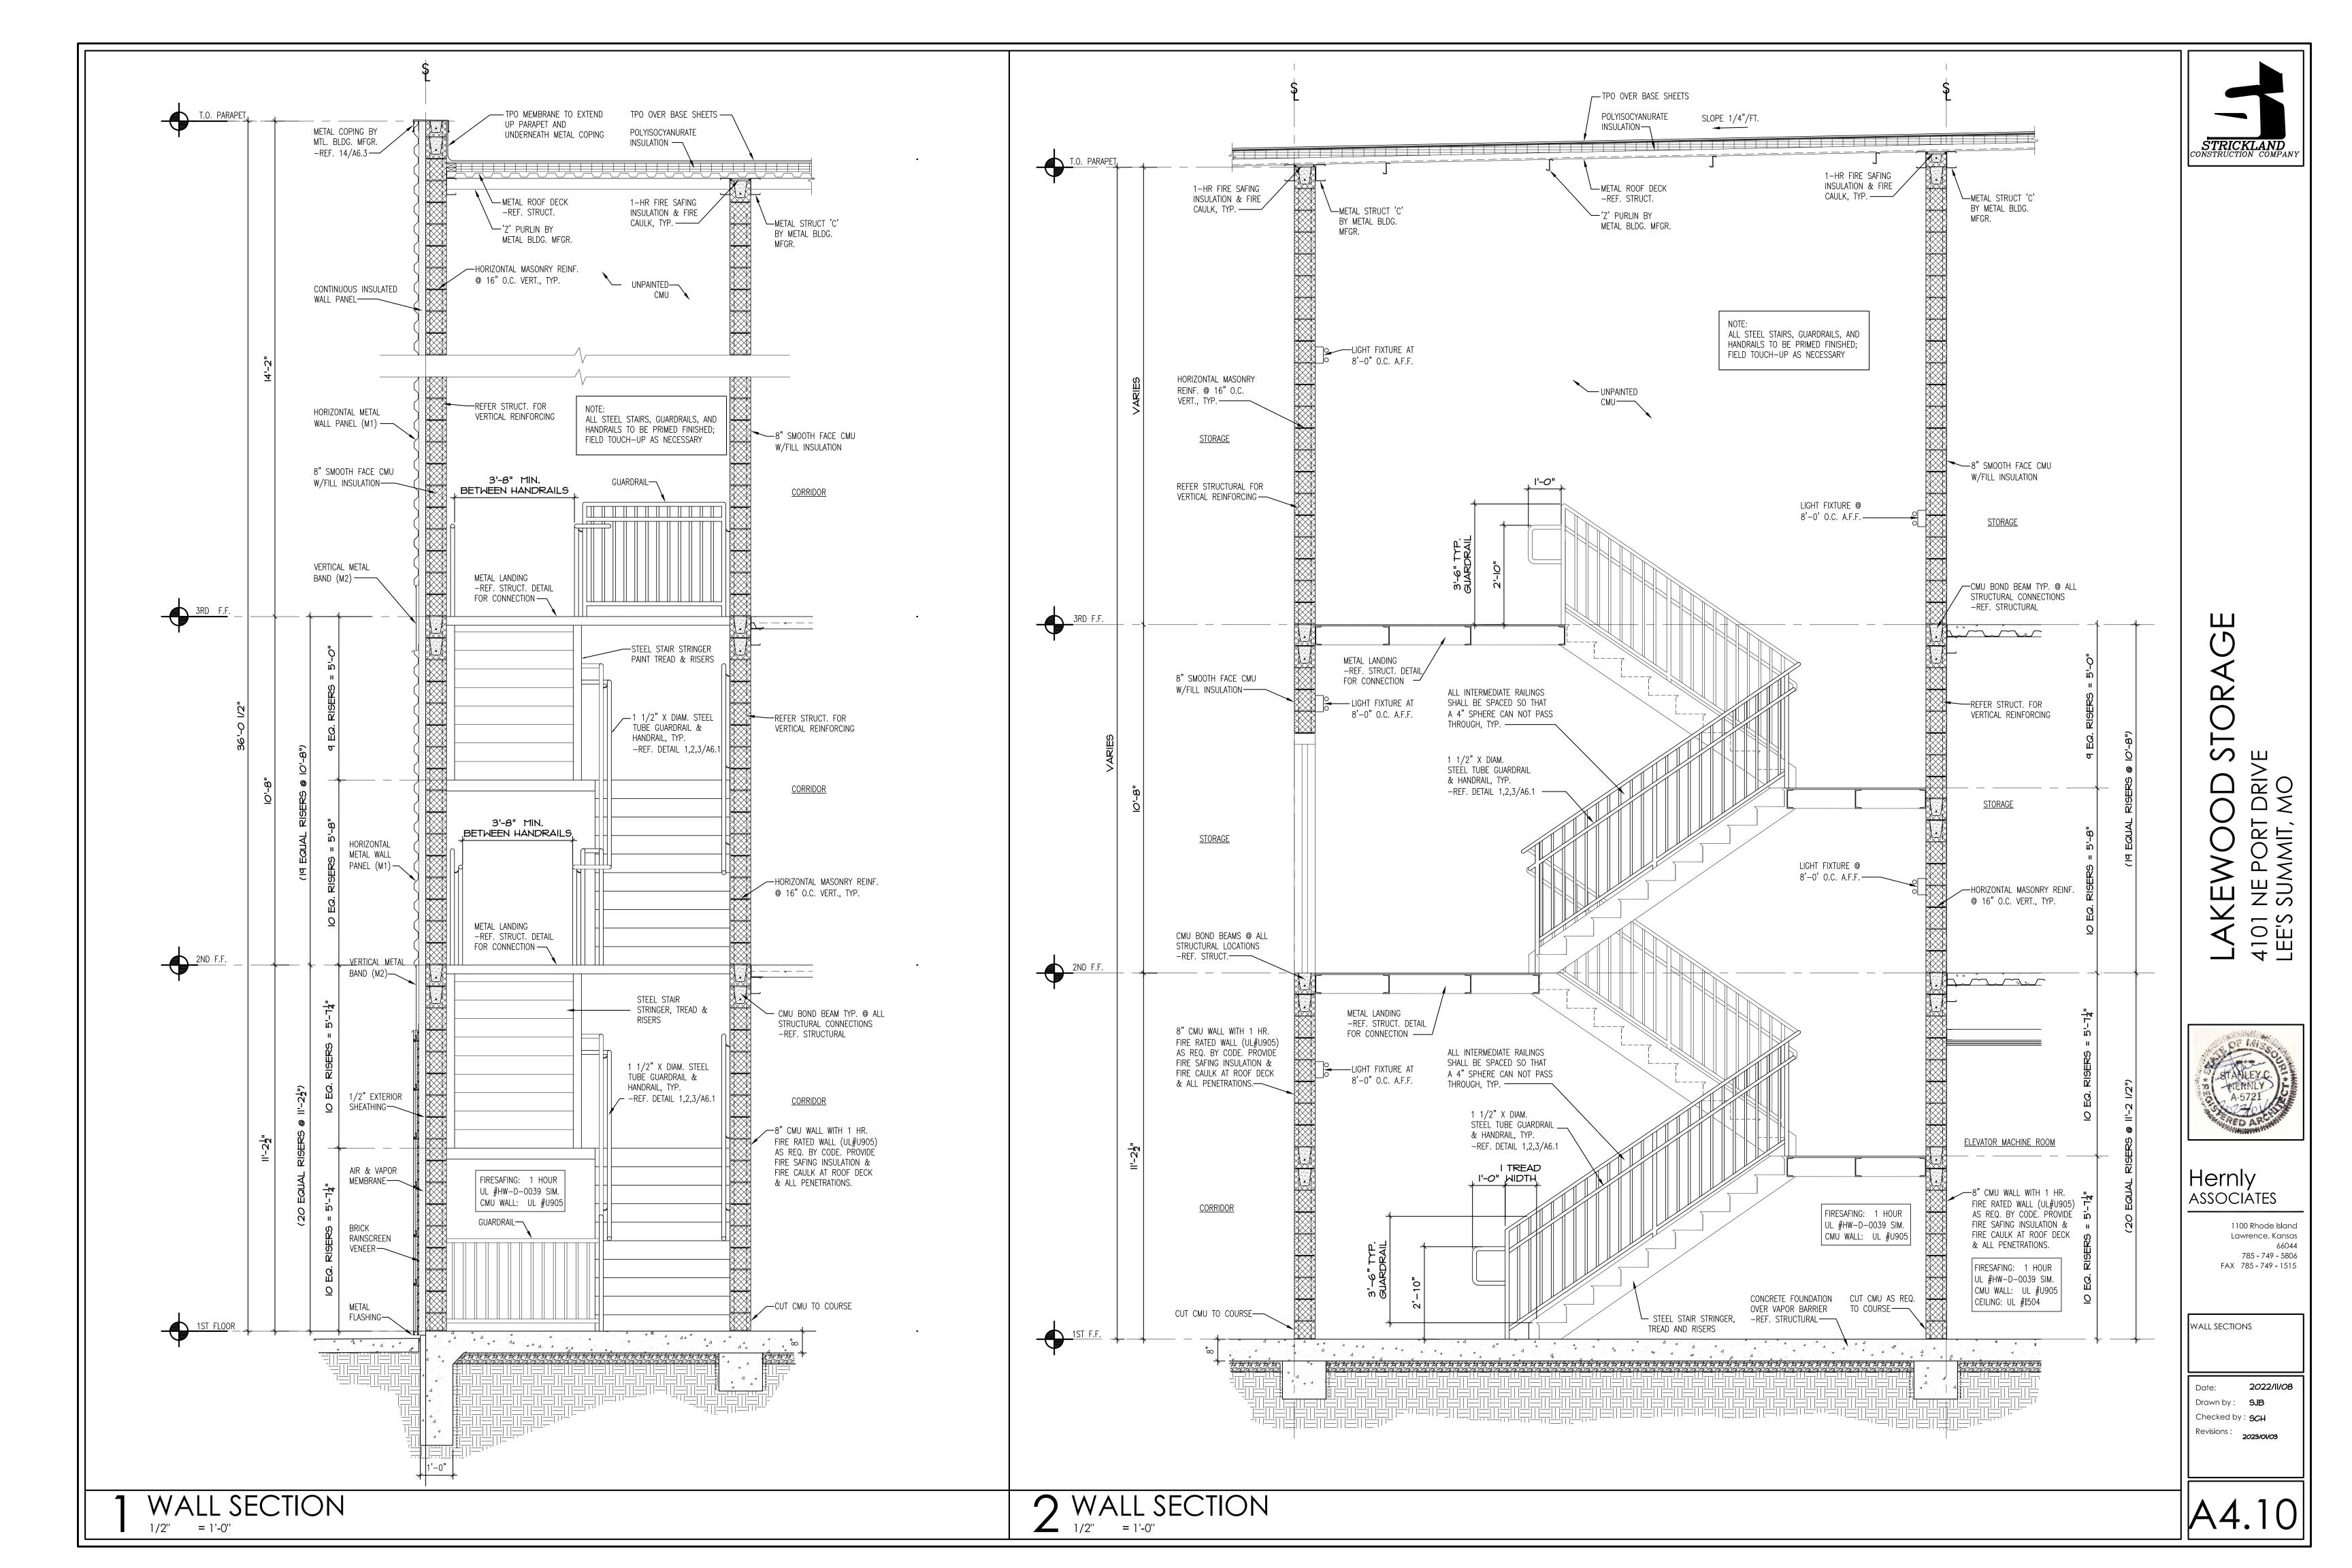

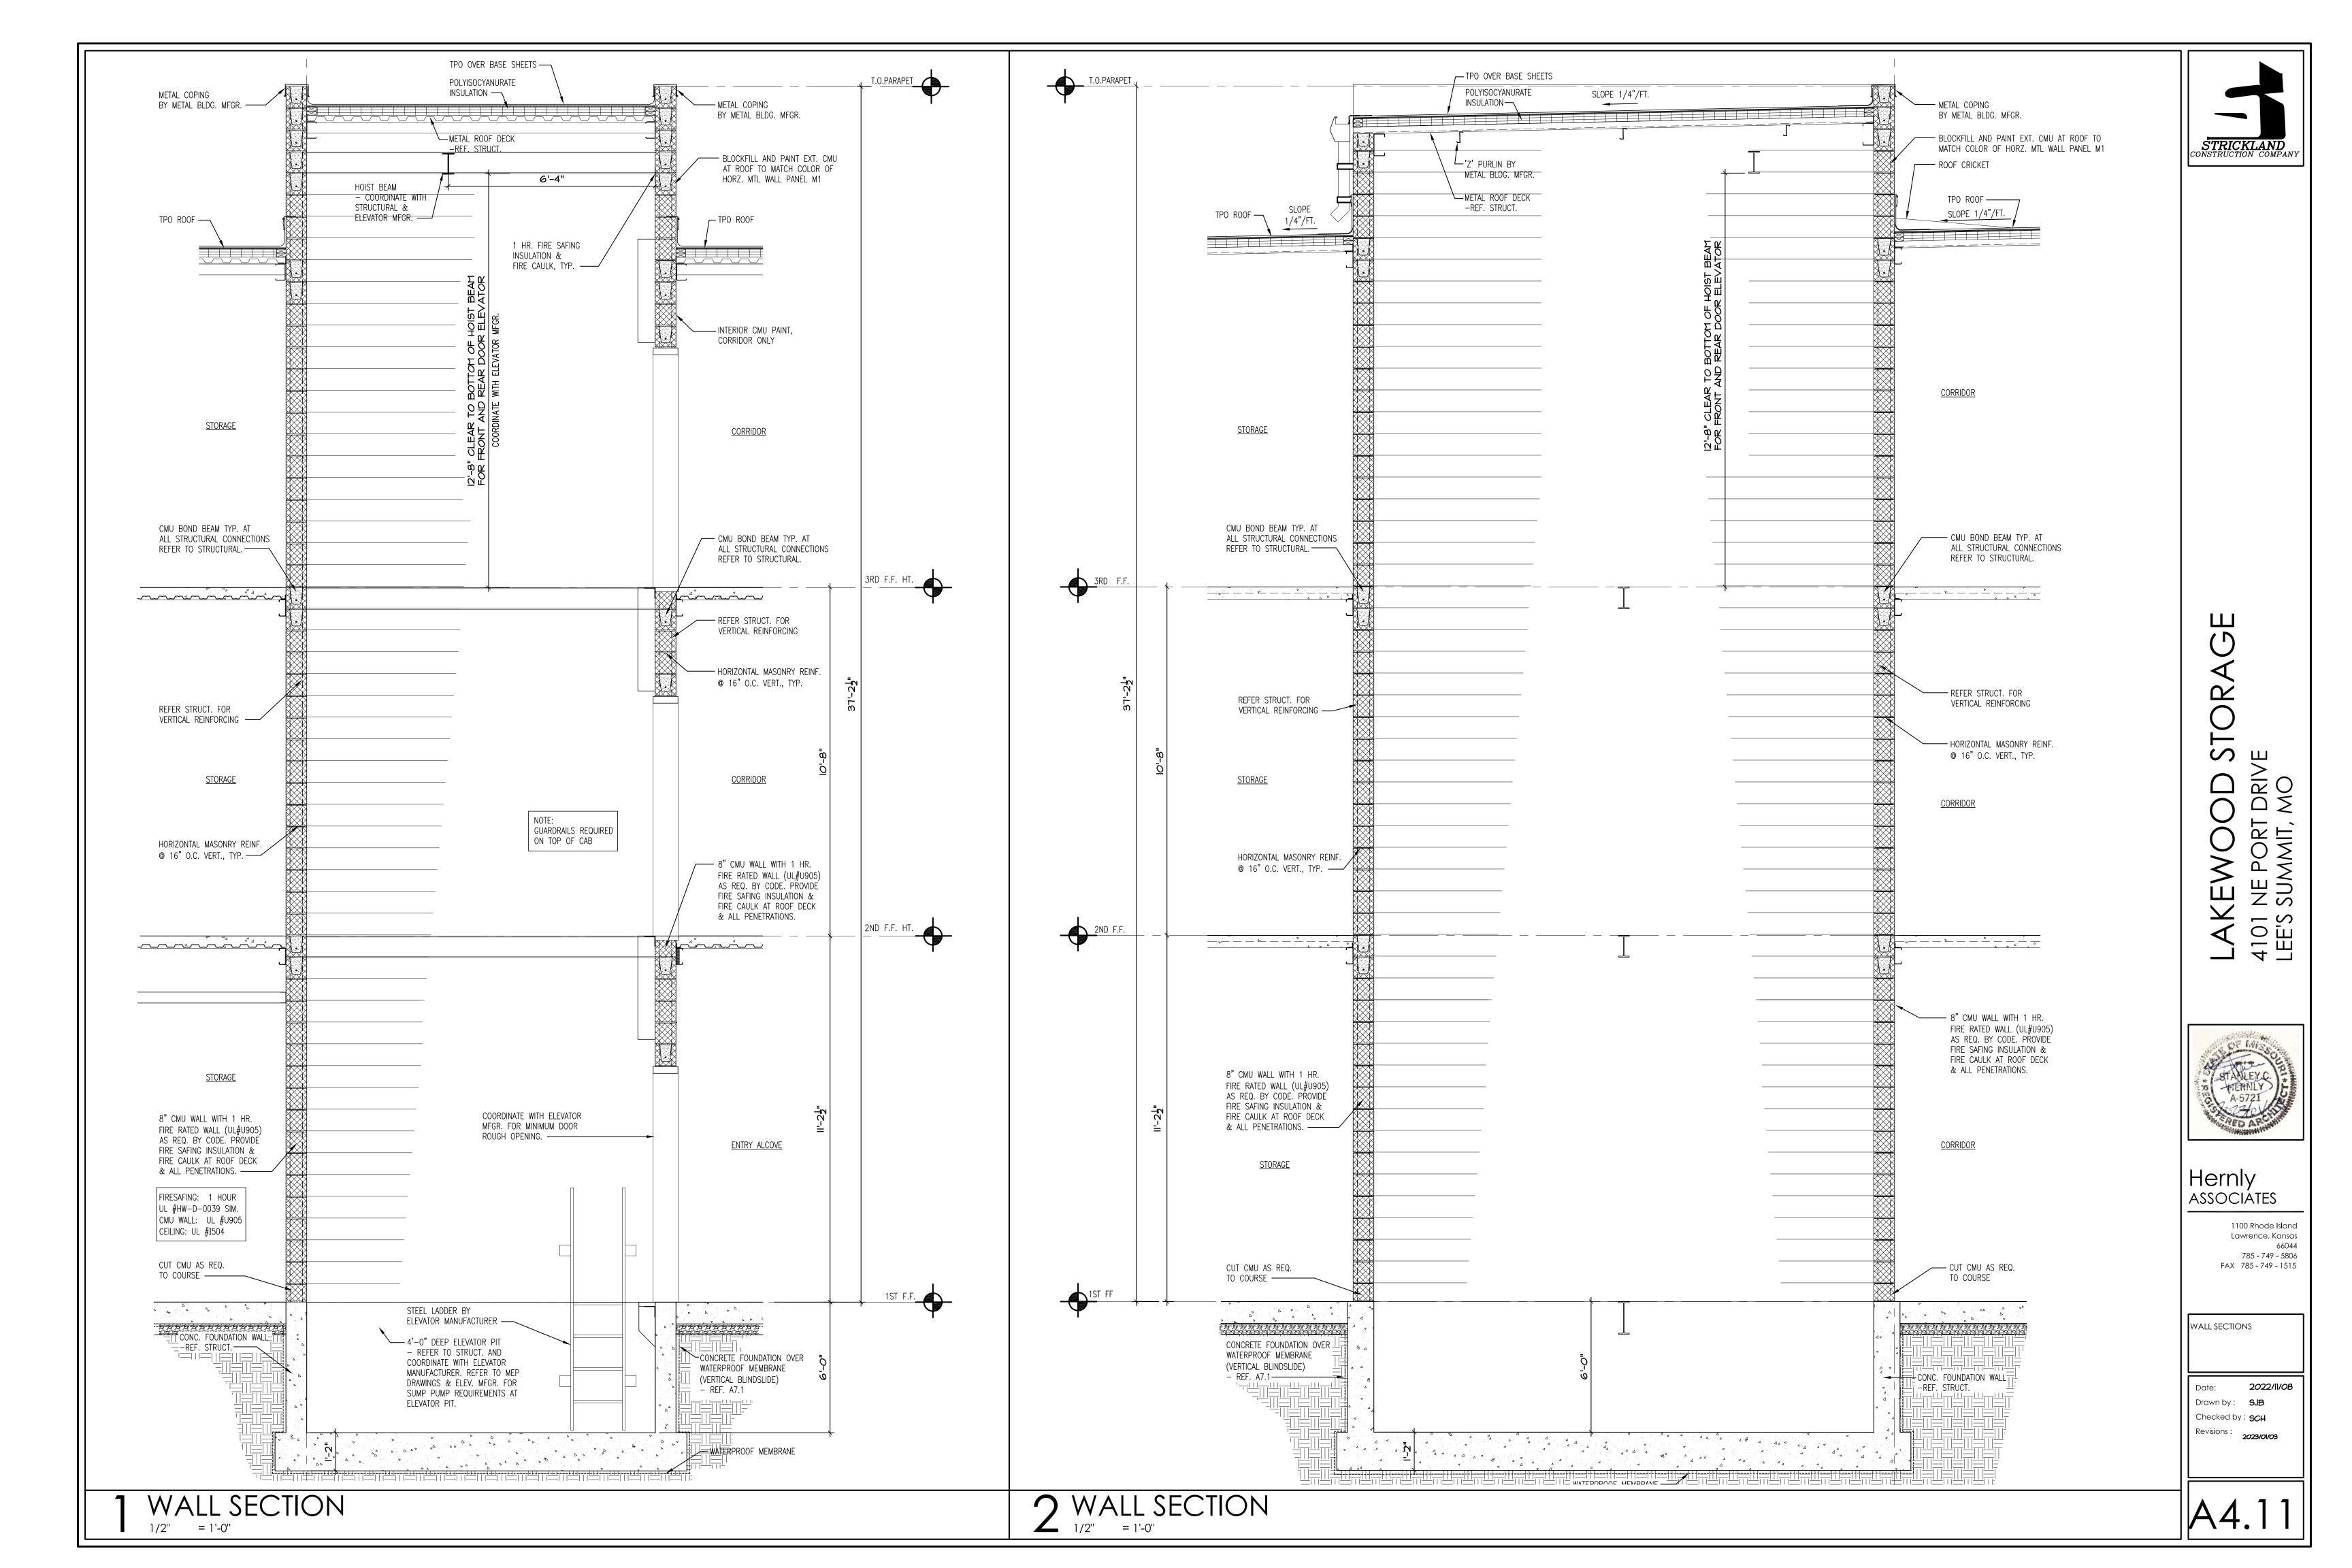

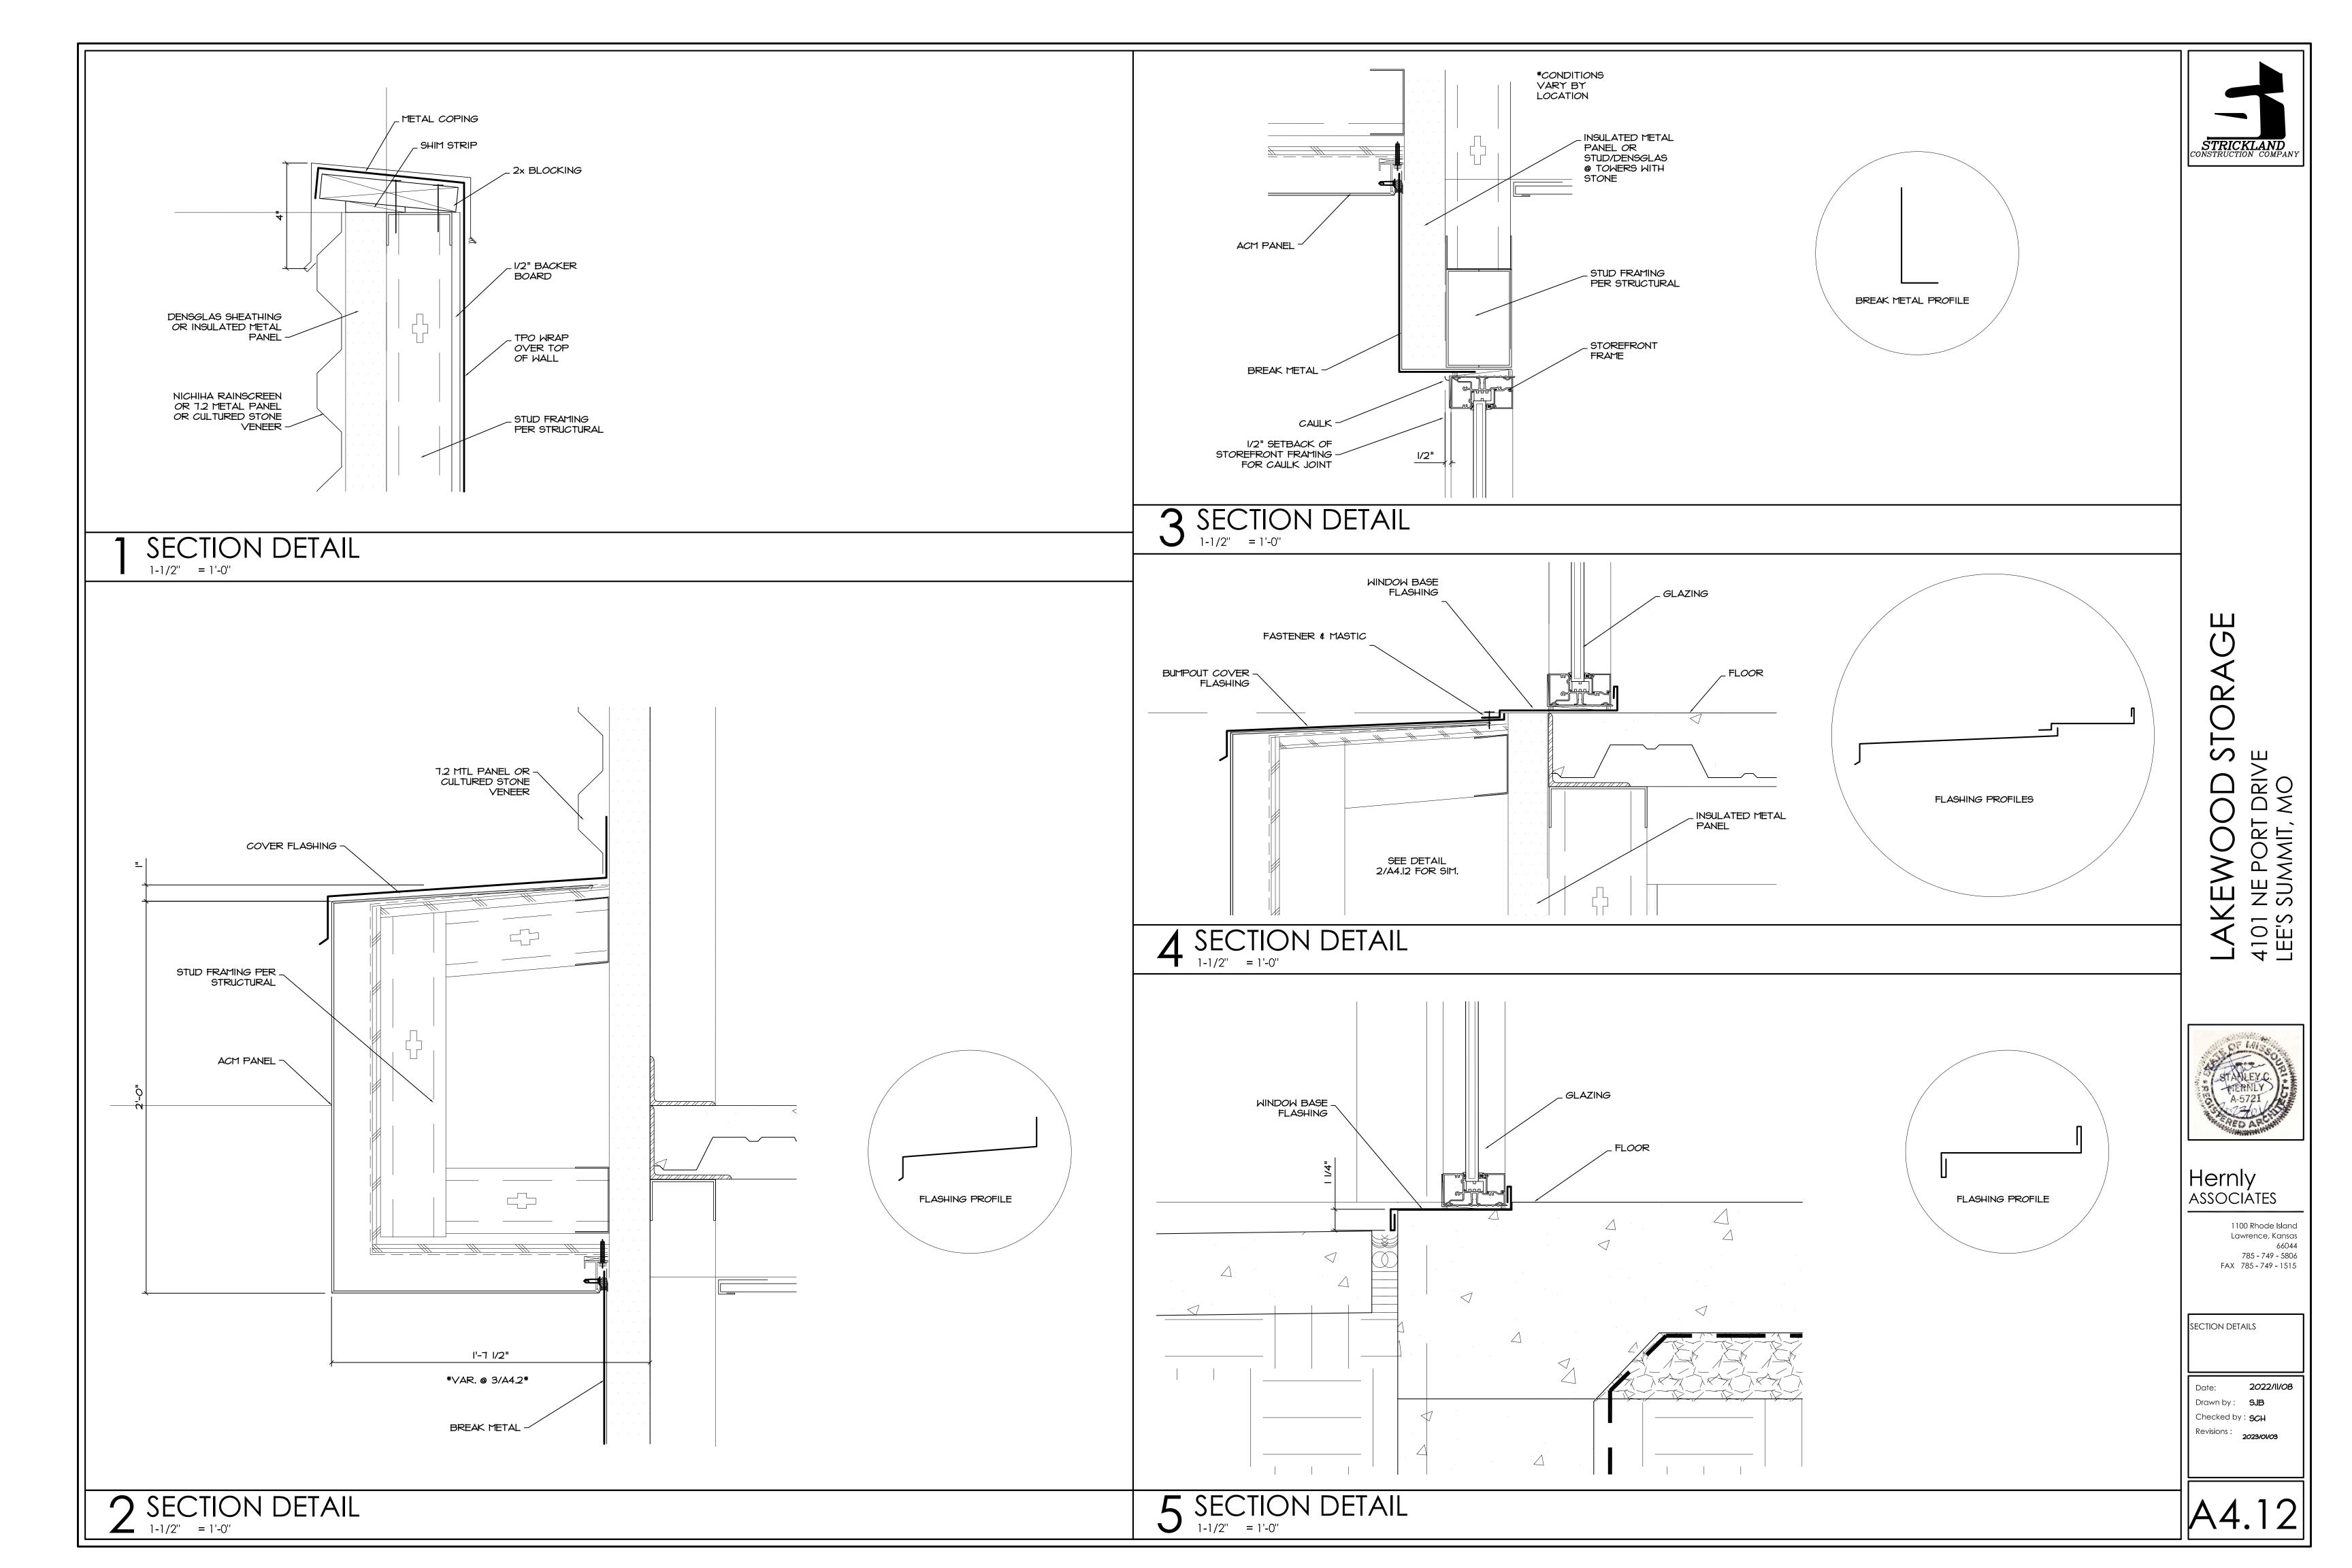

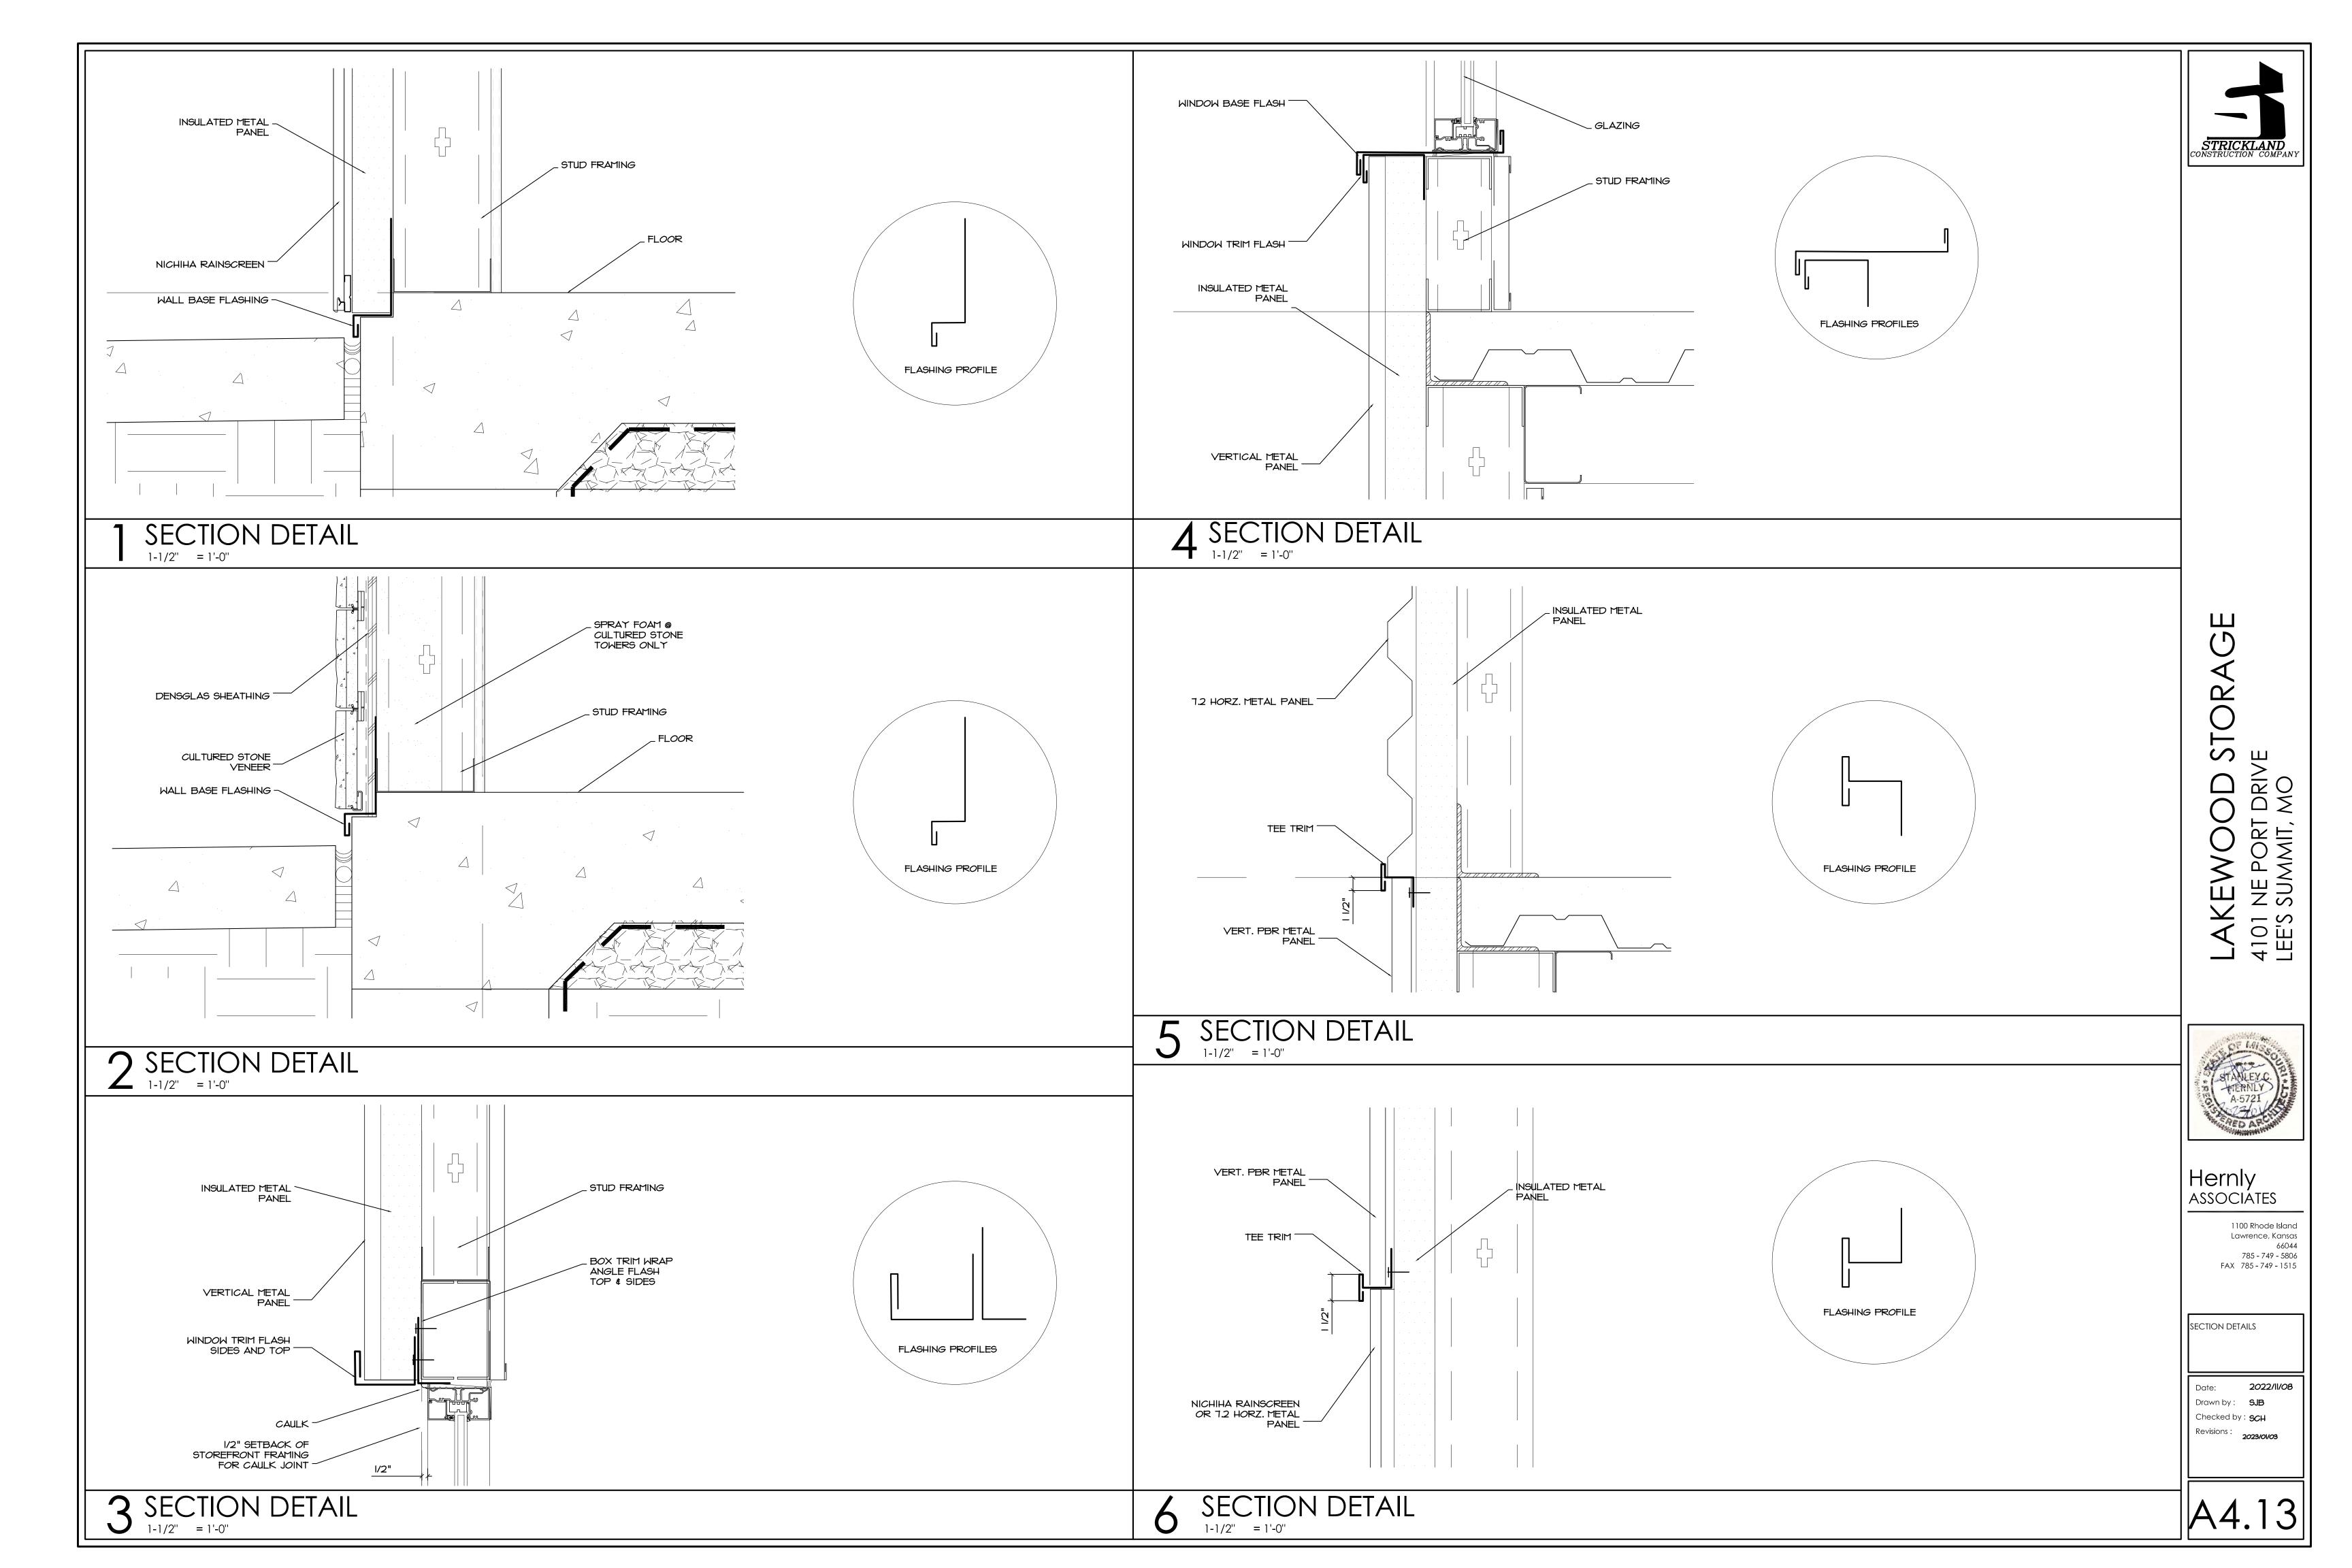

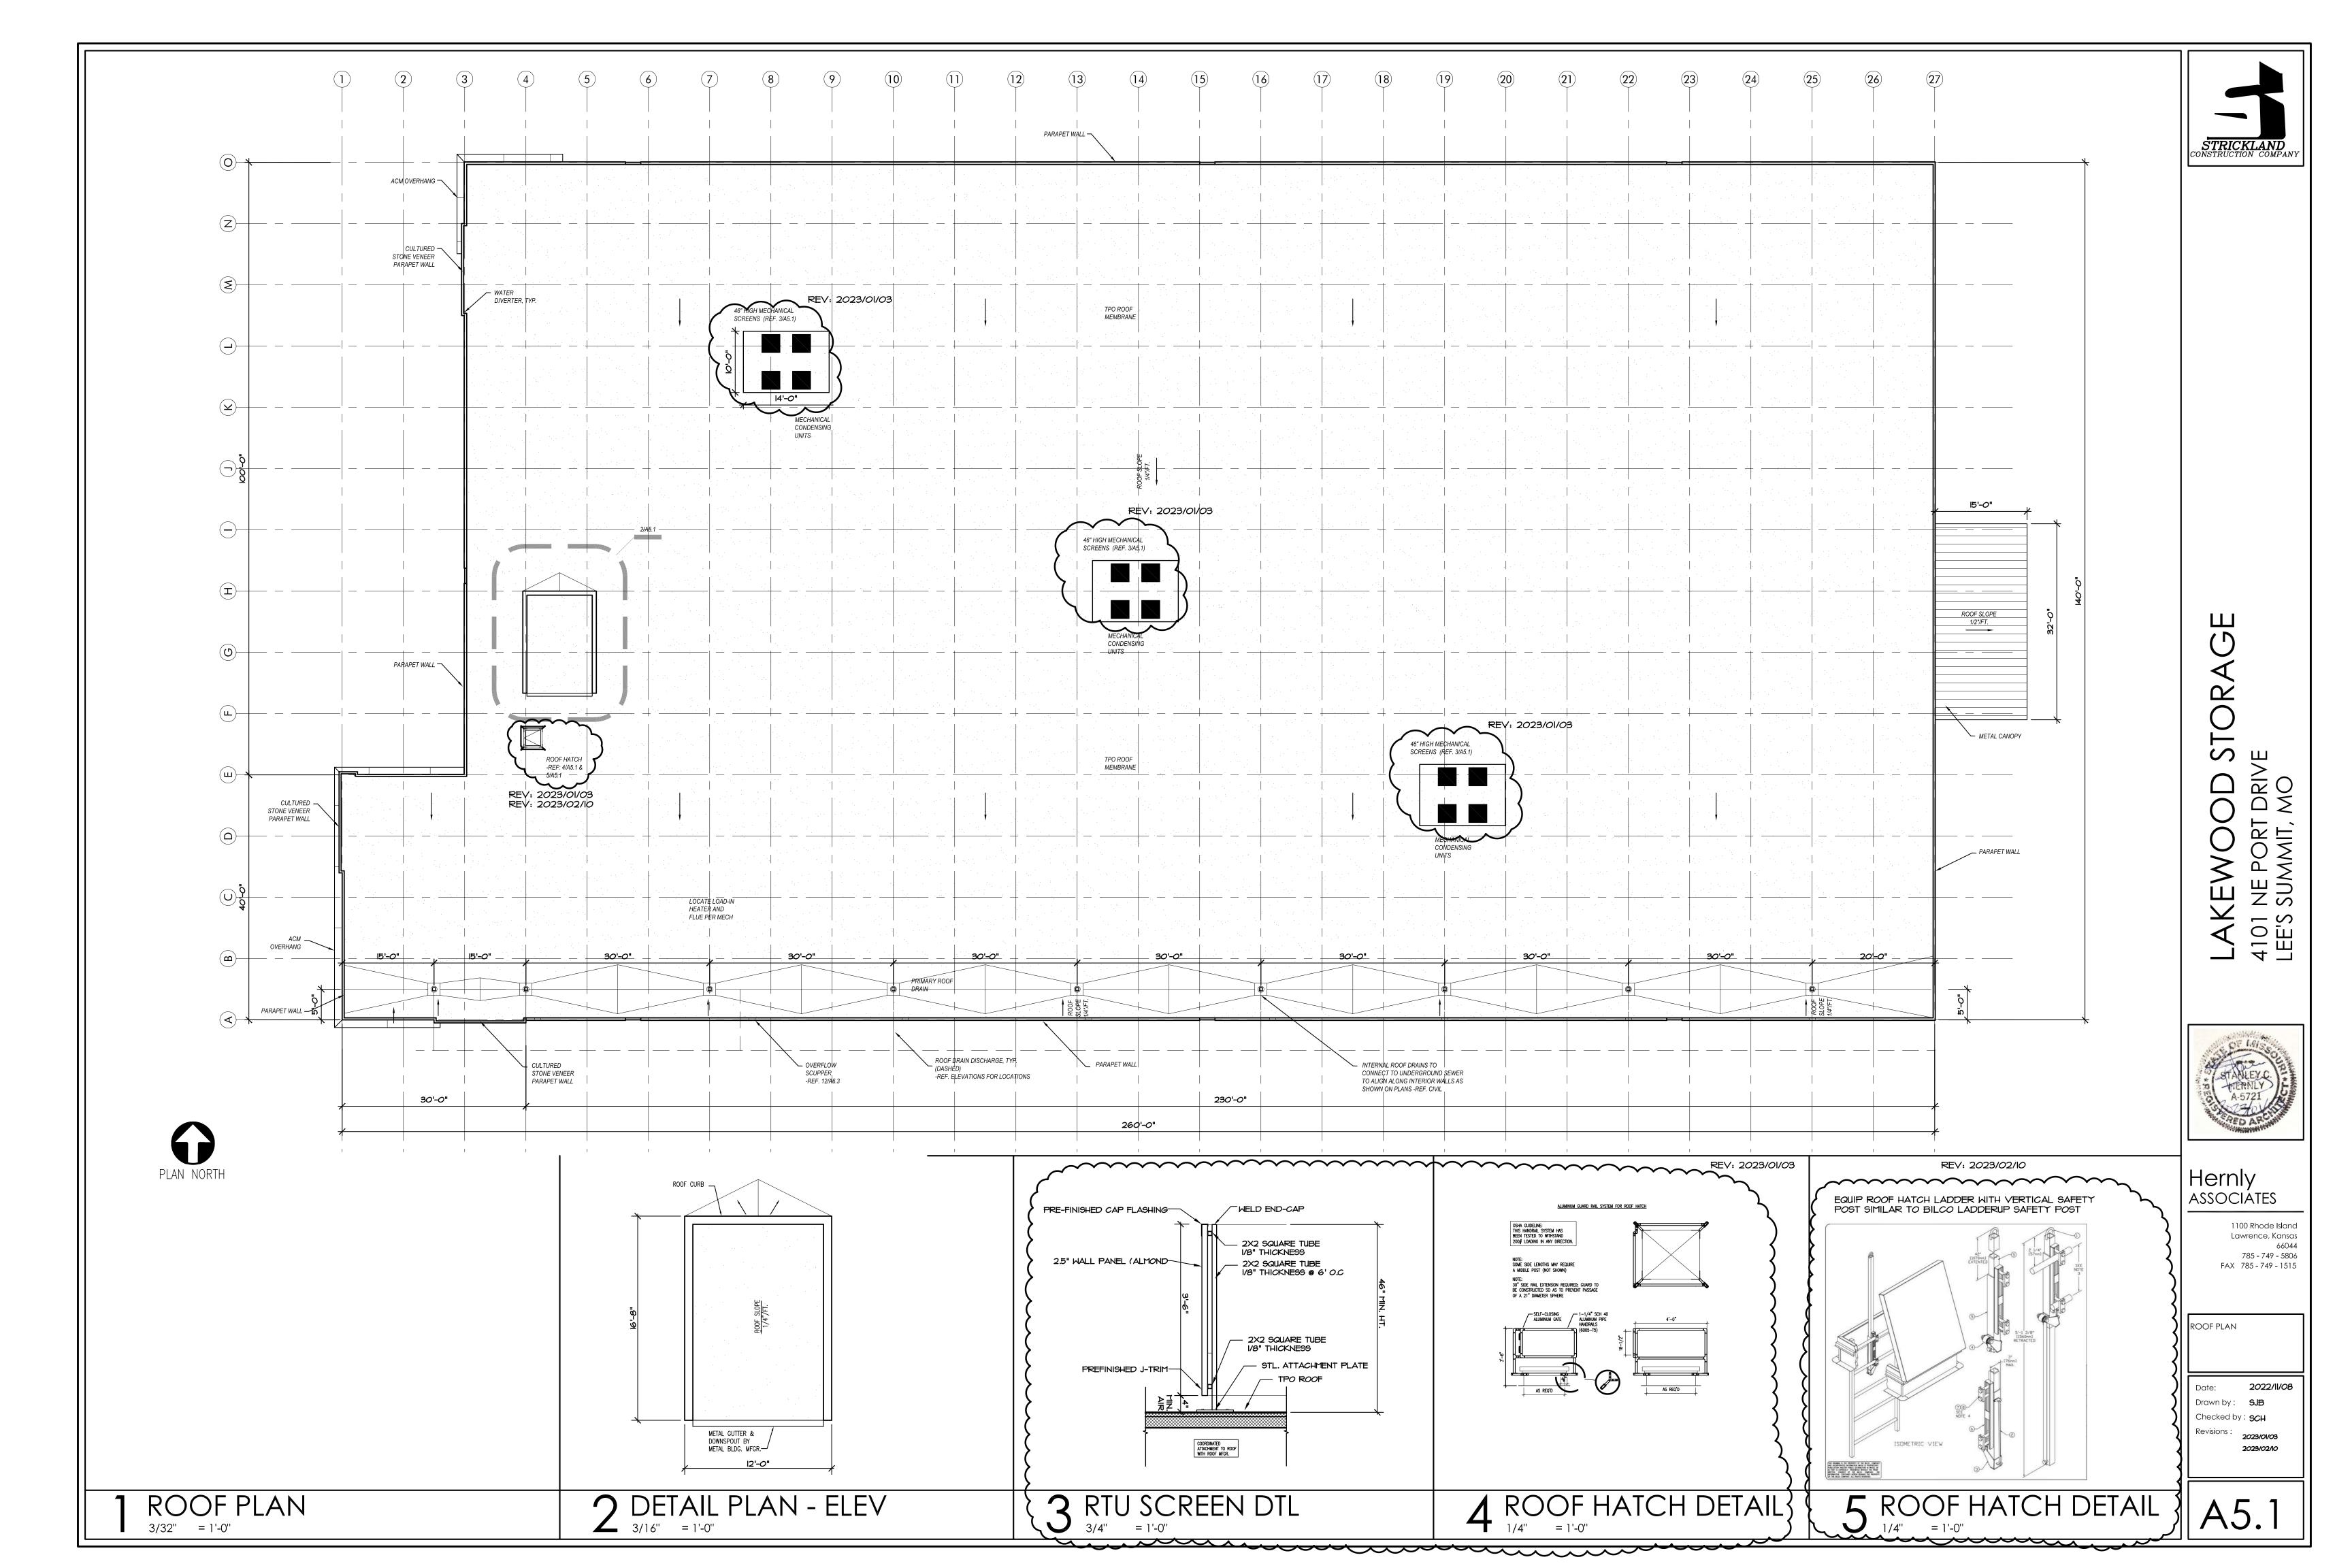

17,28

17,28

17

17,28

17

9,17

17


17,29

STFT 1,2,3,5,8,9,11,15,16,17,18,23

FRAME TYPE REMARKS





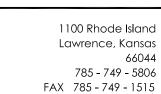


SCHEDULES


2022/11/08 Date: Drawn by: SJB


Checked by: **SCH** Revisions : 2023/01/03

DOOR TYPES FRAME TYPES II'-O" \\ \-______ 1/4" THICK CLEAR LOW E I" CLEAR DOUBLE PANE (I" TOTAL) INSUL. GLAZING INSUL. GLAZING (TEMPERED) (TEMPERED) 9'-0" AS SCHED. AS SCHED. AS SCHED. AS SCHED. AS SCHED. CLEAR OPENING AS SCHED. AS SCHED. 2" TYP. - — — H.M. FRAME, PAINT 3'-4" INTERIOR STORAGE ROLL-UP DOOR JANUS DOOR PTD. NOT USED 12'-0" EXTERIOR SECTIONAL ROLL-UP DOOR 8'-8" EXTERIOR SECTIONAL ROLL-UP DOOR H.M. DOOR, PTD. NOT USED EXTERIOR MAN GATE AUTOMATIC TELESCOPING SLIDING DOOR (OVERHEAD DOOR INSULATED MOTORIZED) (OVERHEAD DOOR INSULATED MANUAL) HOLLOW METAL CLEAR ANODIZED -REF. SITE W/ HALF GLASS ALUMINUM FRAME STANLEY DURA-GLIDE 5300 SERIES POWER AUTOMATIC (MATCH STOREFRONT) 1-HR FIRE RATED DR. 8'-4" INTERIOR STORAGE ROLL-UP DOOR 3'-0" FIXED "DUMMY" DOOR JANUS DOOR PTD. OPERATED TELESCOPE SLIDING DOORS; MEDIUM STILE 8'-0" EXTERIOR SECTIONAL ROLL-UP DOOR UL #1784 FRAMES WITH HORIZ. MUNTINS CLEAR ANODIZED FINISH (OVERHEAD DOOR INSULATED MANUAL) WITH 1" INSULATED LOW —E SAFETY GLASS, U-FACTOR-0.47, SHGC-0.70, & VT 0.79; OPERATION BY 3'-0" INTERIOR STORAGE ROLL-UP DOOR NOT USED MOTION DETECTOR EACH SIDE. INCLUDES EMERGENCY BREAKOUT SLIDING DOOR FUNCTION FOR BUILDING CODE EXIT COMPLIANCE FOR EMERGENCY EGRESS. PROVIDE COMPLETE HARDWARE PACKAGE. 7'-4" INTERIOR STORAGE ROLL-UP DOOR NOT USED

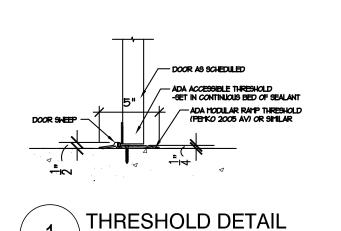


/ SCALE: 1 1/2" = 1'-0"

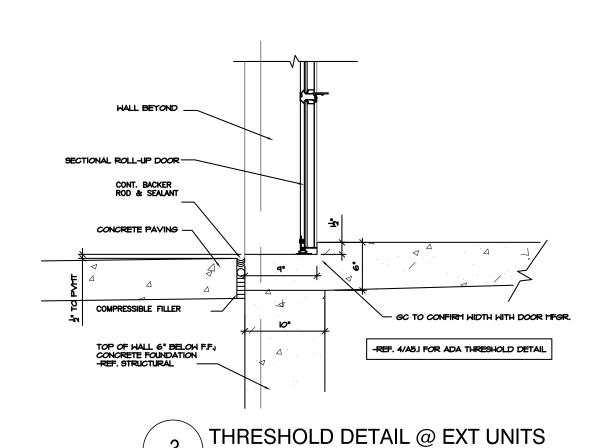

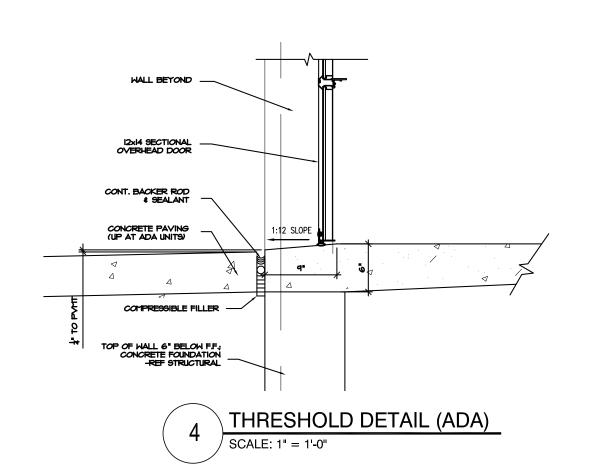

SCALE: 1" = 1'-0"

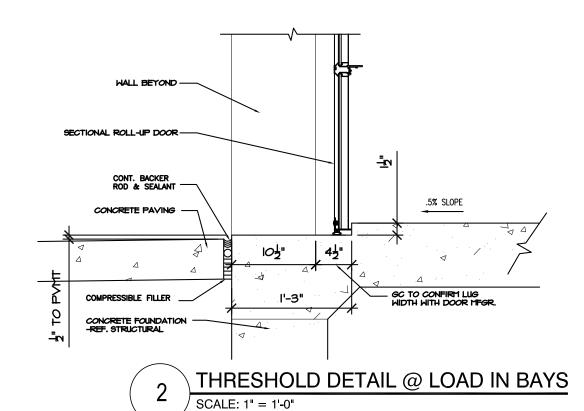

	NIIC	SH SCHEDULE									
H	-:										
	ļ		FLOOR		WALLS				CEILING		KEYED
	FIRST FLOOR		MATERIAL	BASE	NORTH	SOUTH	EAST	WEST	HEIGHT	TYPE	NOTES
	101	SALES AREA	SC	RUBBER	PT-1	PT-1	-	PT-1	-	ES	-
	102	RECEPTION DESK	SC	RUBBER	PT-1	PT-1	PT-1/PT-2	-	-	ES	-
	103	MDF / BREAK ROOM	SC	RUBBER	PT-1	PT-1	PT-1	PT-1	8'-0"	LAY-IN	
빙	104	AHU ROOM	SC	-	PT-1	PT-1	PT-1	PT-1	1	ES	
H	105	DISPLAY AREA	SC	RUBBER	PT-1	PT-1	PT-1	PT-1	1	ES	2
ō	106	MENS T.R.	PFT	-	PT-3	PT-3	PT-3	PT-3	8'-0"	LAY-IN	1
	107	WOMENS T.R.	PFT	-	PT-3	PT-3	PT-3	PT-3	8'-0"	LAY-IN	1
	108	DRINKING FOUNTAIN	SC	-	JANUS	JANUS	JANUS	JANUS	-	ES	-
	109	LOADING AREA	SC	-	JANUS	JANUS	JANUS	JANUS	-	ES	-
KEYED NOTES: LEGEND:											

(EPOXY PAINT TYP. @ ALL RESTROOMS) 2. DUMMY DOORS PER FLOOR PLANS.

GENERAL NOTES: A. GENERAL CONTRACTOR TO SUBMIT ALL FINISH SELECTIONS TO OWNER AND ARCHITECT FOR APPROVAL PRIOR

TO ORDERING B. REF. SHEET A7.1 FOR SPECIFICATIONS. C. GENERAL CONTRACTOR TO PROVIDE ALLOWANCE FOR CERAMIC TILE IN ROOMS 101-105 AS AN ALTERN

1. SMOOTH, HARD, NON-ABSORBANT FINISH REQ'D UP TO 48" ES EXPOSED STRUCTURE GRID 2X2 CEILING GRID ONLY GYP **JANUS** LAY-IN PT-1 PT-2 PT-3 RUBBER

5/8" TYPE 'X' GYPSUM BOARD JANUS WALL SYSTEM 2x2 LAY-IN ACOUSTICAL CEILING INTERIOR OFFICE PAINT INTERIOR OFFICE PAINT - ACCENT EPOXY PAINT RUBBER WALL BASE PAINTED WOOD BASE WD SEALED CONCRETE

RNATE
I" INSULATED ALIM. STOREFRONT QUALITY STOREFRONT A POINT HEEL BEAD SEALANT F.F. OUT TO SEALANT TO SEALANT F.F. OUT TO SEALANT
STOREFRONT DETAIL

DOOR NOTES

- : DOOR HARDWARE TO BE APPROVED BY OWNER BASED ON SUBCONTRACTOR SUBMITTAL.
- 2: CONTRACTOR TO COORDINATE DOOR HARDWARE AND FRAMES WITH SECURITY EQUIPMENT AND MAGNETIC HOLD OPEN DEVICES.
- 3: PROVIDE MIN. INTERIOR & EXTERIOR ACCESSIBLE HARDWARE, THRESHOLDS, SIGNAGE, ETC. TO COMPLY W/ ADA ACCESSIBILITY STANDARDS. REFERENCE FLOOR PLANS FOR LOCATIONS.
- 4: NOT USED
- 5: NOT USED
- 6: STORAGE ROLL-UP DOORS-PROVIDE ALUM. HANDLES W/ SLIDE BAR LATCH TO FRAME, CONTINUOUS ALUM. BOTTOM PULL BAR, WEATHER SEALS (EXTERIOR) AND REMOVABLE CYLINDER LOCK W/ EMERGENCY OVERRIDE LATCH OPERATOR TO OPERATOR.
- 7: GLAZING IN ALL EXTERIOR DOORS TO BE INSULATED LOW-E GLAZING W/ 1/4" DOUBLE PANES W/ 1/2" AIR SPACE (1" TOTAL) (TEMPERED).
- 8. THRESHOLDS $1\frac{1}{2}$ " LUGS NOT REQUIRED AT ALCOVE ENTRIES.
- 9. READILY VISIBLE DURABLE SIGN POSTED ON THE EGRESS SIDE ON OR ADJACENT TO THE DOOR STATING: "THIS DOOR TO REMAIN UNLOCKED WHEN BUILDING IS OCCUPIED" -REF. SHEET A2.6 FOR INSTALLATION INSTRUCTIONS.
- 10. FIRE RATED DOORS TO BE SELF CLOSING OR AUTOMATIC CLOSING.
- 11. READILY VISIBLE DURABLE SIGN POSTED ON EGRESS SIDE ADJACENT TO DOOR STATING: "EXIT" IN TACTILE LETTERS & BRAILLE -REF SHEET A2.6 FOR INSTALLATION INSTRUCTIONS.
- 12. READILY VISIBLE DURABLE SIGN POSTED ON ENTRY SIDE OF DOOR STATING "ROOM NAME" IN TACTILE LETTERS AND BRAILLE - REF. SHEET A2.6 FOR INSTALLATION INSTRUCTIONS.
- 13. ROLL UP DOORS TO MEET LOCAL WIND LOAD REQUIREMENTS.
- 14. CONSTRUCTION CORES TO REMAIN REKEYING/MASTER KEYING BY OWNER
- 15. 3'-0" CLEAR MAN GATE ORNAMENTAL IRON APPLIED METAL SECURITY MESH AT GATE AND ADJACENT FENCE PANEL EXTEND FULL LENGTH OF EITHER SIDE OF LOCKSET. LEVER HARDWARE PER ADA REQUIREMENTS.
- 16. SLIDING DOOR OPENING TO BE ON SAME SIDE AS MAN DOOR ADJACENT.
- 17. DOORS TO COMPLY WITH ENERGY CODES SHOWN ON SHEET A7.1.
- 18. DOORS TO COMPLY WITH LOCAL WIND LOAD CAPACITY.

91110E EN1111	$\overline{}$			_	9111	.,_,_,,,,,,,,,,,,,,,,,,,,,,,,,,,,,,,,,,
MDF ROOM	2	3'-0"	7'-0"	3	1	11,15,20
AHU ROOM	3	3'-0"	7'-0"	3	1	7,10,11,20
OFFICE / LOADING	4	3'-0"	7'-0"	1	1	11,15,20
OFFICE / STORAGE	5	3'-0"	7'-0"	3	1	11,15,20
TOILET ROOM	6	3'-0"	7'-0"	3	1	11,14,20,24
TOILET ROOM	7	3'-0"	7'-0"	3	1	11,14,20,24
ALCOVE ENTRY	8	4'-0"	7'-0"	1	1	1,2,3,4,10,11,12,13,16,19,
LOADING EXIT	9	3'-0"	7'-0"	1	1	1,2,3,8,10,11,12,16,19,24
STAIR B - 1ST FLR	10	3'-0"	7'-0"	4	1	1,2,6,10,11,19,24
STAIR B - EXIT	11	3'-0"	7'-0"	4	1	1,2,3,8,10,11,12,16,19,24
ELEV. ACCESS	(12N)	3'-0"	7'-0"	3	1	2,3,8,10,11,12,16,20
ELEV. ACCESS	128	3'-0"	7'-0"	3	1	2,3,8,10,11,12,16,20
ELECTRICAL ROOM	13	3'-0"	7'-0"	3	1	2,3,8,10,11,12,16,20
FIRE RISER ROOM	14)	6'-0" PR	7'-0"	3	1	2,3,8,10,11,12,16,20
ALCOVE ENTRY	15)	4'-0"	7'-0"	1	1	1,2,3,4,10,11,12,13,16,19,
STAIR A - 1ST FLR	16	3'-0"	7'-0"	4	2	1,2,6,10,11,19,24
STAIR A - EXIT	(17)	3'-0"	7'-0"	3	2	1,2,3,8,10,11,12,16,19,24

5R

STORAGE DOOR SCHEDULE

11'-0" 14'-0" EXT. SECT.

8'-8" 8'-0" EXT. SECT.

MARK WIDTH HEIGHT DOOR TYPE FRAME TYPE REMARKS

NOT USED

NOT USED

NOT USED

7'-0" INT. ROLL-UF

8'-0" EXT. SECT.

7'-0" INT. ROLL-UF

7'-0" INT. ROLL-UF

7'-0" DUMMY DOOR

7'-0" INT. ROLL-UF

(M) 3'-0" 7'-0" JANUS SWING

N 3'-0" 7'-0" JANUS SWING

MARK WIDTH HEIGHT DOOR TYPE

DOOR SCHEDULE

1 3'-0" 7'-0"

LOCATION

STAIR A

SLIDING DOOR

STAIR B - 2ND FLR

STAIR A - 3RD FLR

STAIR B - 3RD FLR

MAN GATE

OFFICE ENTRY

REMARKS::
1: PANIC HARDWARE

3'-0"

3'-0"

(23) | 3'-0" | 6'-0"

(19) | 9'-0" |

- 2: DOOR CLOSER 3: WEATHER STRIPPING / THRESHOLD
- -REF. DETAIL 1/A5.1 4: MAGNETIC HOLD OPEN

7'-0"

7'-8"

7'-0"

3'-0" 7'-0"

3'-0" 7'-0"

- DOORS W/ 15 MINUTE TIMER 5: DEADBOLT
- 6: FIRE RATED 1-HR (REF. NOTE 10) 7: VENTED AT AHU LOCATIONS 8: DRIP FLASHING
- 9: FIXED "DUMMY DOORS 10: STORAGE LOCKSET
- 15: OFFICE LOCKSET
- 12: INSULATED 13: KEY PAD 14: TR LOCKSET
- 11: DOOR STOP
- 18: DOOR SIGNAGE @ ENTRY (REF. NOTE 9)

16: DOOR SWEEP

19: DOOR SIGNAGE @ EXITS (REF. NOTE 11) 20: DOOR SIGNAGE @ IDENTIFYING ROOMS (REF. NOTE 12) 21: STANLEY ACCESS CONTROL

1,2,3,8,10,11,12,16,19,24

3,13,19,21,22,27

1,2,6,10,11,19,24

1,2,6,10,11,19,24

1,2,6,10,11,19,24


1,2,24,25

17: COLOR: REF. SHEET A7.1

- (PANIC BAR & ELECTRIC LOCK) 22: STANLEY TIMER 23: MAIL-SLOT 24: KICKPLATE ON PUSH SIDE 25: MAN GATE KEYSET
- 26: NOT USED 27: RIGHT HAND OPENING 28: INSULATED SECTIONAL ROLL-UP 29: CLASP ON LATCH PUSH SIDE

30: LEFT HAND OPENING

- 1. VERIFY ALL ROUGH OPENING DIMENSIONS IN RELATION
 TO STRUCTURAL DRAWINGS. FRAME SIZES TO BE
 ADJUSTED AS NECESSARY FOR PROPER SHIM, FLASHING,
 AND THERMAL EXPANSION.
- 2. SAFETY (TEMPERED) GLAZING IS REQUIRED IN AN INDIVIDUAL FIXED OR OPERABLE PANEL ADJACENT TO A DOOR WHERE THE NEAREST EXPOSED EDGE OF THE GLAZING IS WITHIN A 24-INCH ARC OF EITHER VERTICAL EDGE OF THE DOOR IN A CLOSED POSITION AND WHERE THE BOTTOM EXPOSED EDGE OF THE GLAZING IS LESS THAN 60 INCHES ABOVE THE WALKING SURFACE (IBC 2406.3.6).
- 3. STOREFRONT INSULATED LOW-E GLAZING TO BE 1/4" DOUBLE PANES WITH 1/2" AIR SPACE(1" TOTAL)(TEMPERED).
- 4. EXTERIOR INSULATED LOW-E GLAZING TO BE 1/4" DOUBLE PANES WITH 1/2" AIR SPACE (1" TOTAL) (TEMPERED).
- 5. FLASH AND WEATHERSTRIP ALL EXTERIOR WINDOWS TO PROVIDE WATER RESISTANT ASSEMBLY.
- 6. WINDOW DIMENSION @ FIRST FINISHED FLOOR IS FROM LUG TO SILL.
- 7. WINDOW AND DOOR DIMENSIONS ARE ROUGH OPENINGS. DOORS, FRAMES, WINDOWS, ETC. ARE TO BE SIZED TO ALLOW SHIMS AND TOLERANCES TO MEET INDUSTRY STANDARDS AND THERMAL EXPOSION (DEFINE IN SHOP DRAWINGS).
- 8. STOREFRONTS TO BE ANODIZED ALUMINUM.

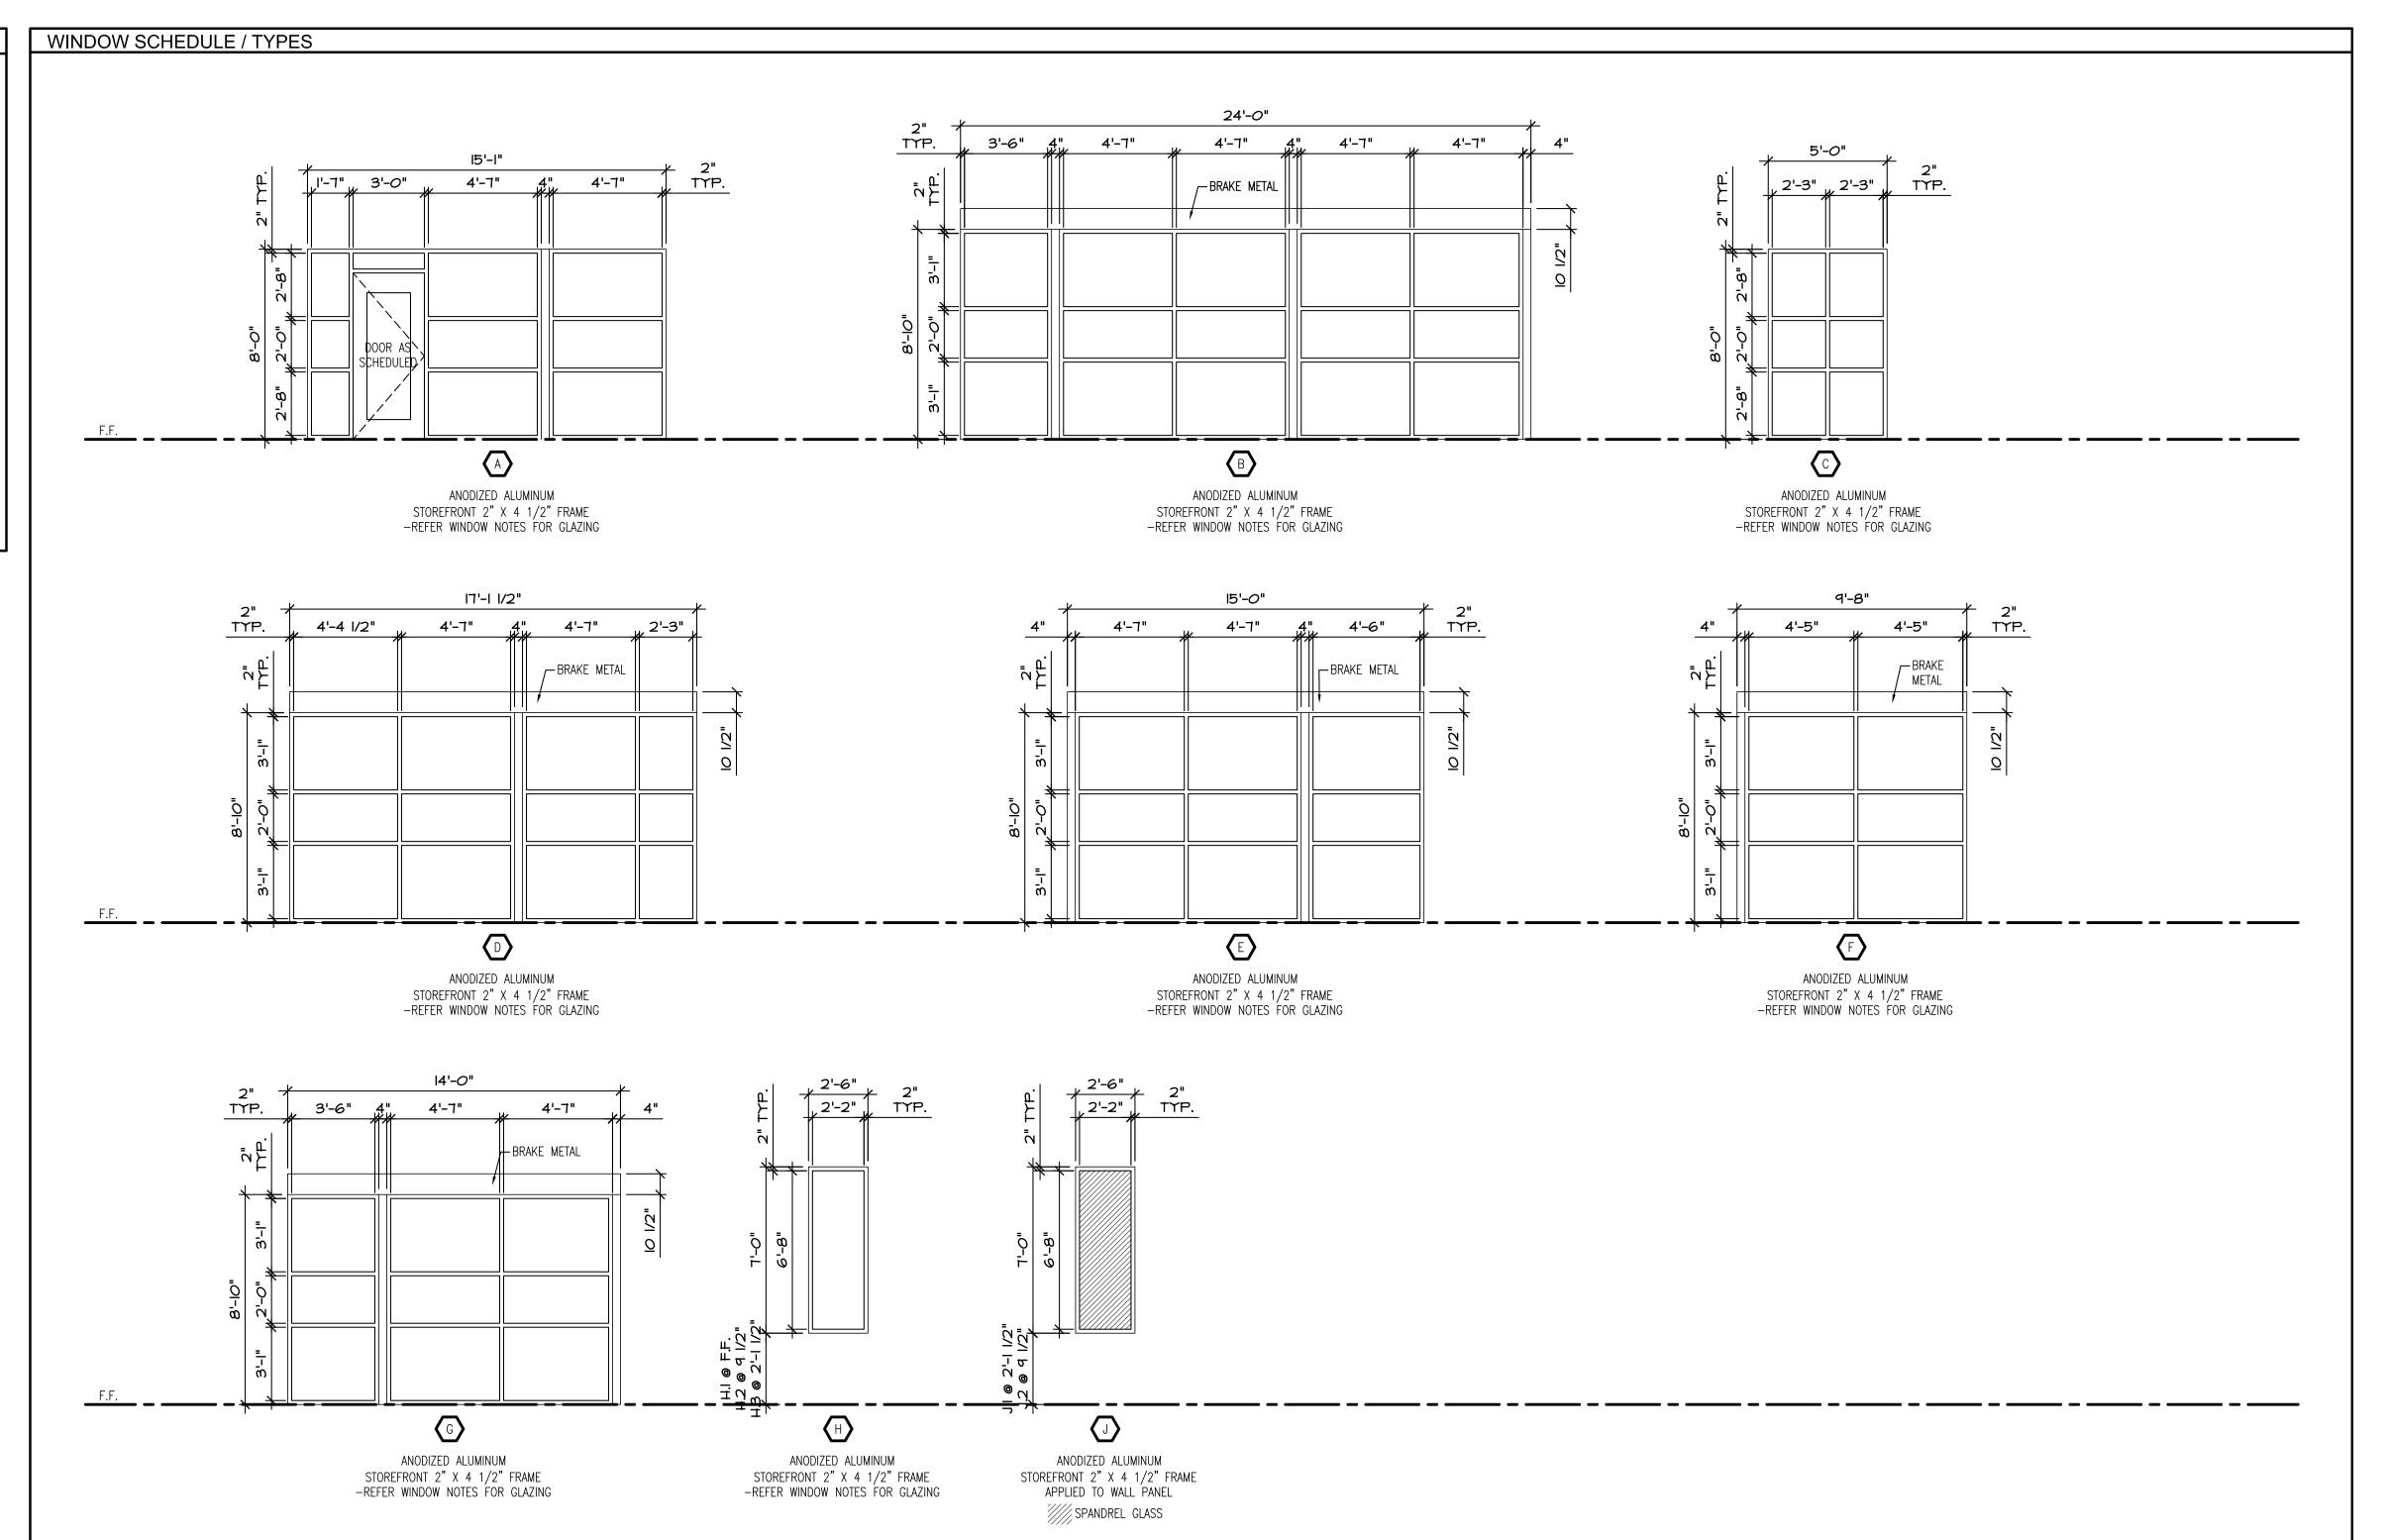



LAKEWOOD STORAGE
4101 NE PORT DRIVE
LEE'S SUMMIT, MO




Hernly ASSOCIATES

> 1100 Rhode Island Lawrence, Kansas 66044 785 - 749 - 5806 FAX 785 - 749 - 1515

SCHEDULES

Date: 2022/II/08
Drawn by: SJB
Checked by: SCH
Revisions:

A6.2

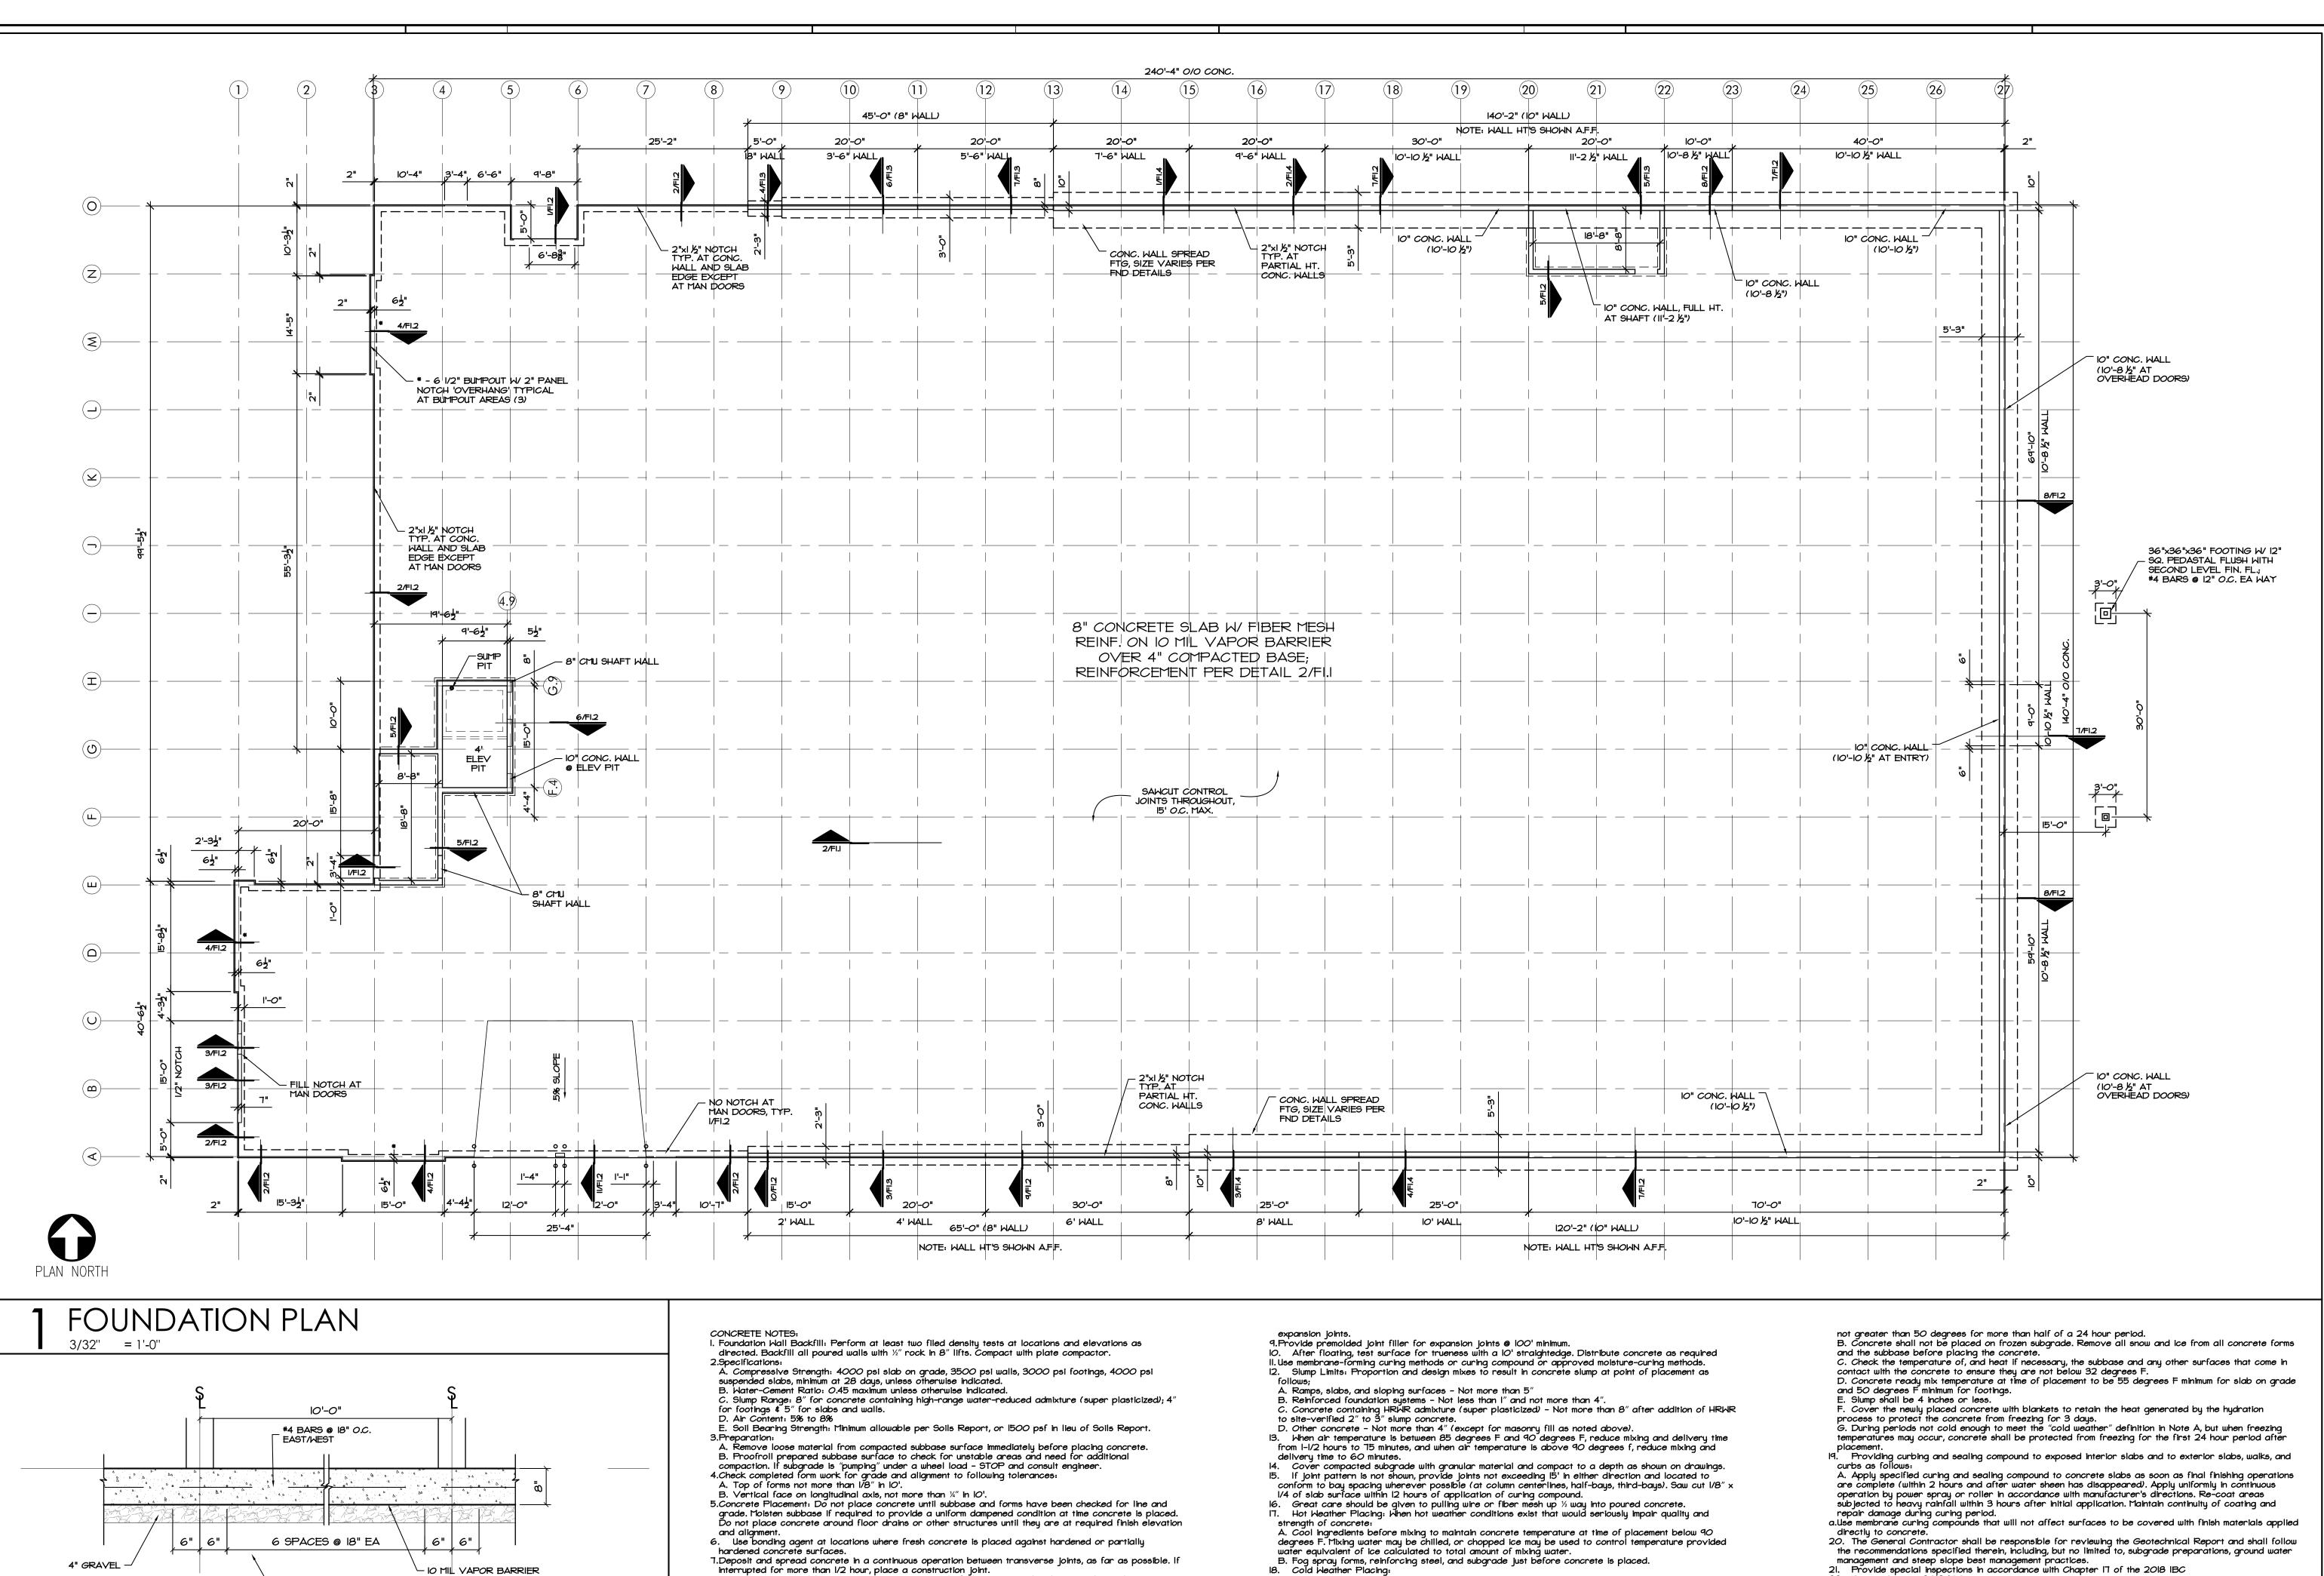

A. Cold weather concrete procedures are to be followed when the average daily outside temperature

(average over 24 hour period) is below 40 degree for three consecutive days, and the temperature is

22. Design Criteria 2018 IBC

23. Design values for allowable soil pressure are 2,000 psf at continuous footings and 2,500 psf at

– 10 MIL VAPOR BARRIER

- #4 BARS SPACING NORTH/SOUTH

? SLAB REINFORECEMENT DETAIL

interrupted for more than 1/2 hour, place a construction joint.

FOUNDATION NOTES

8.Construction joints: Place construction joints at end of placements and at location where placement operations are stopped for a period of more than 1/2 hour, except where such placements terminate at

NE PORT SUMMIT, 110 EE'

Hernly **ASSOCIATES**

> 1100 Rhode Island Lawrence, Kansas 785 - 749 - 5806 FAX 785 - 749 - 1515

OUNDATION PLAN CONC NOTES

2022/11/08 Drawn by: Checked by: **SCH**

2023/01/03

