5 8" SMART TRIM 6 SMART SHEET SIDING W/ VERTICAL GROOVES OVER BUILDING WRAP. 7 STAINED CEDAR CORBEL 8 4" SMART TRIM 9 MANUF. STONE VENEER AND SILL OVER BUILDING WRAP OVER APA-RATED EXTERIOR SHEATHING. 10 AWNING ROOF 11 MANUF. BOARD & BATTEN SIDING OVER BUILDING WRAP OVER APA-RATED EXTERIOR SHEATHING. 12 24" x 24" COLUMN BASE

- 2 COMPOSITE SHINGLES, TAMKO, HERITAGE 30 YR. WARRANTY, WEATHERED WOOD OR APPROVED EQUAL.

3 PRE-MANF SMART SHINGLES OVER BUILDING WRAP OVER APA-RATED EXTERIOR SHEATHING.

4 STANDING SEAM METAL ROOF

- 1 12" x 12" CEDAR POST
- GENERAL ELEVATION NOTES
- DECK 332 sq/ft PAVEMENT AREAS 1427 sq/ft

3340 sq/ft

1901 sq/ft

1439 sq/ft

842 sq/ft

0 sq/ft

SQUARE FOOTAGE SUMMARY

TOTAL FINISHED


GARAGE


TOTAL FINISHED MAIN


TOTAL UNFINISHED MAIN


TOTAL FINISHED LOWER

TOTAL UNFINISHED LOWER 410 sq/ft

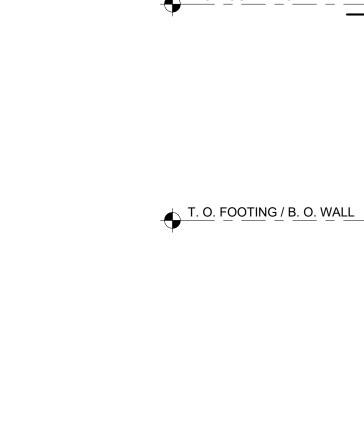


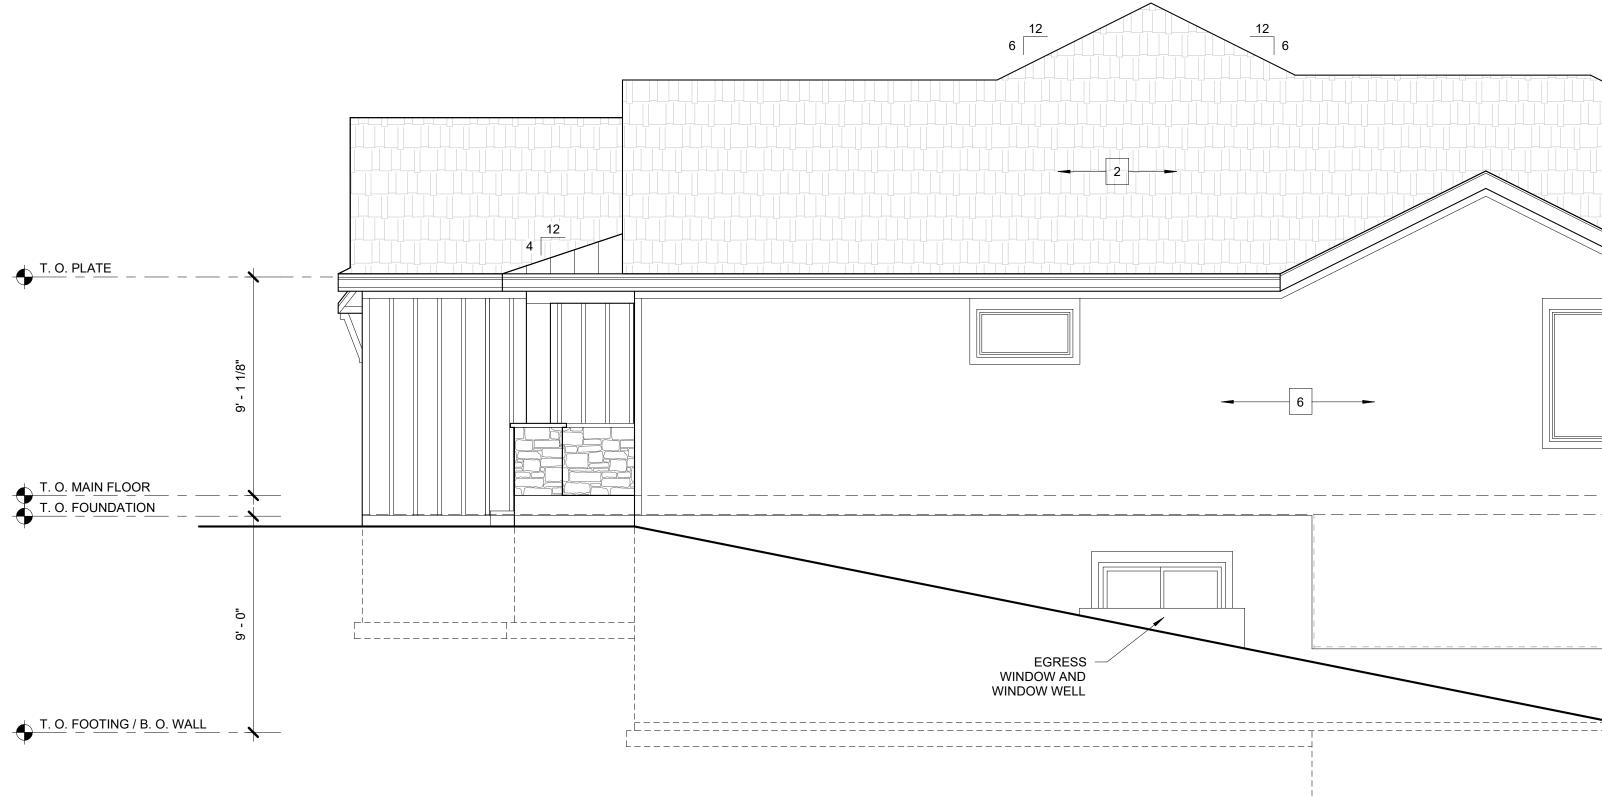


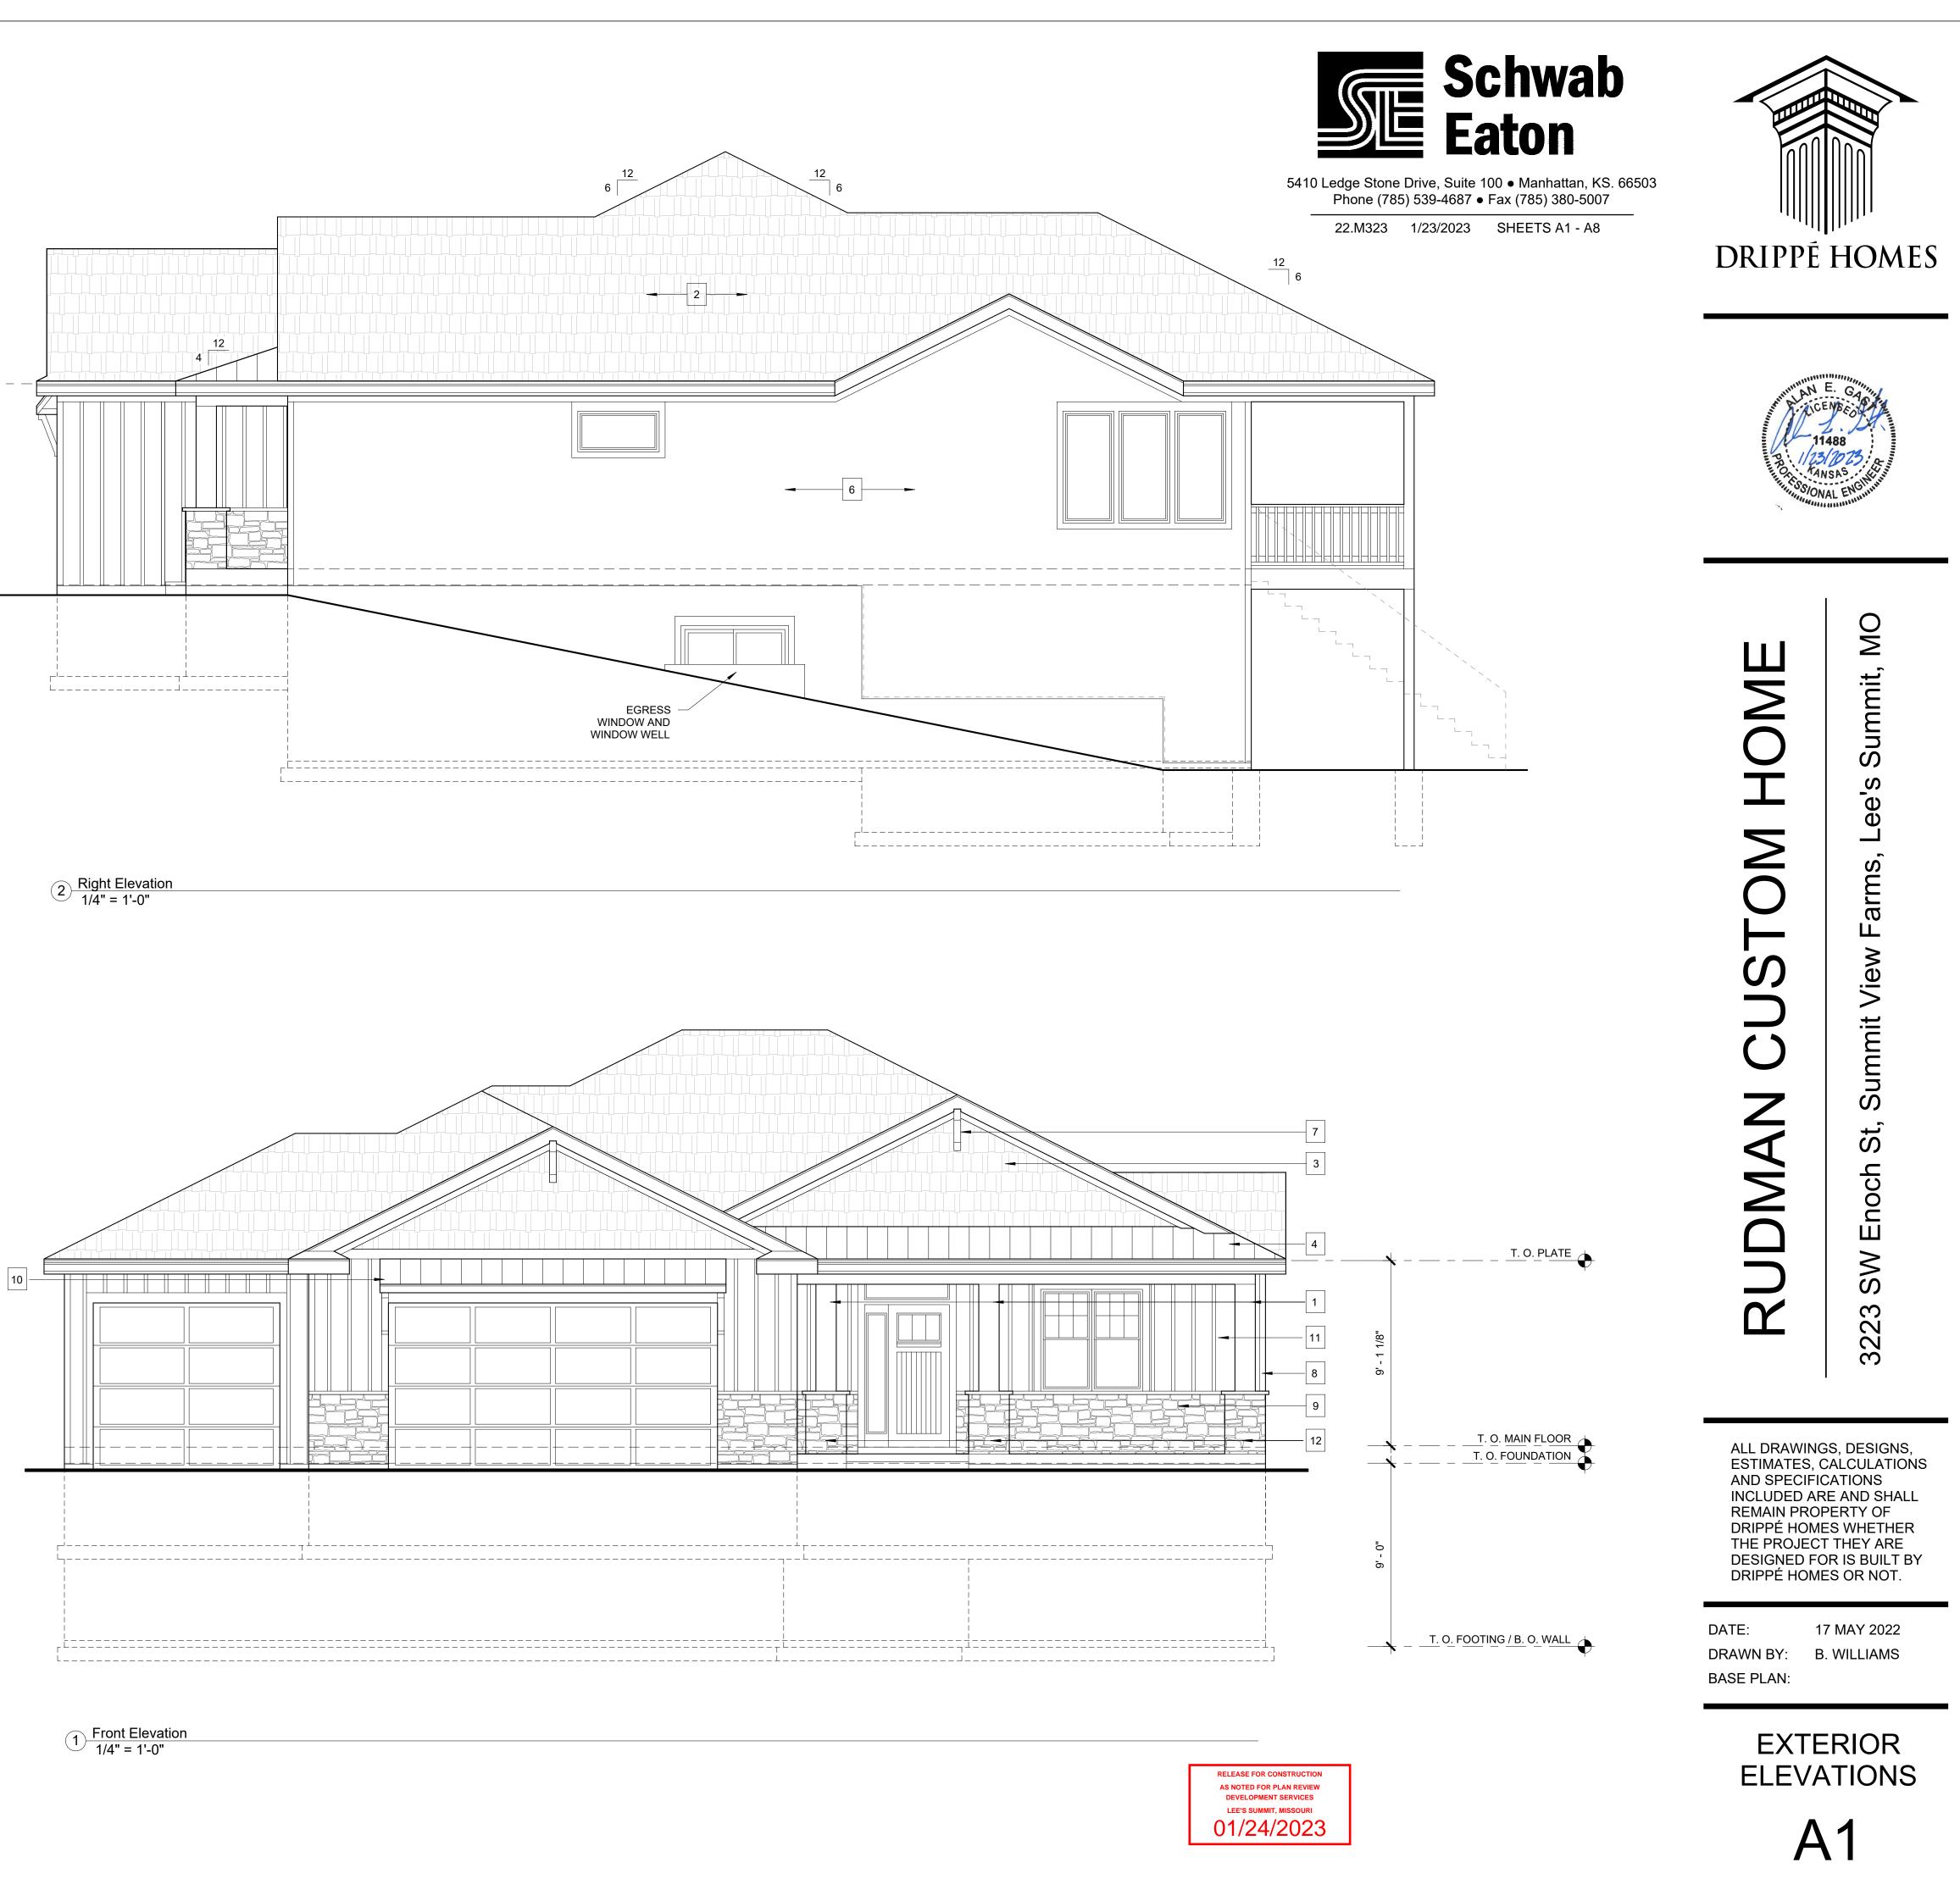


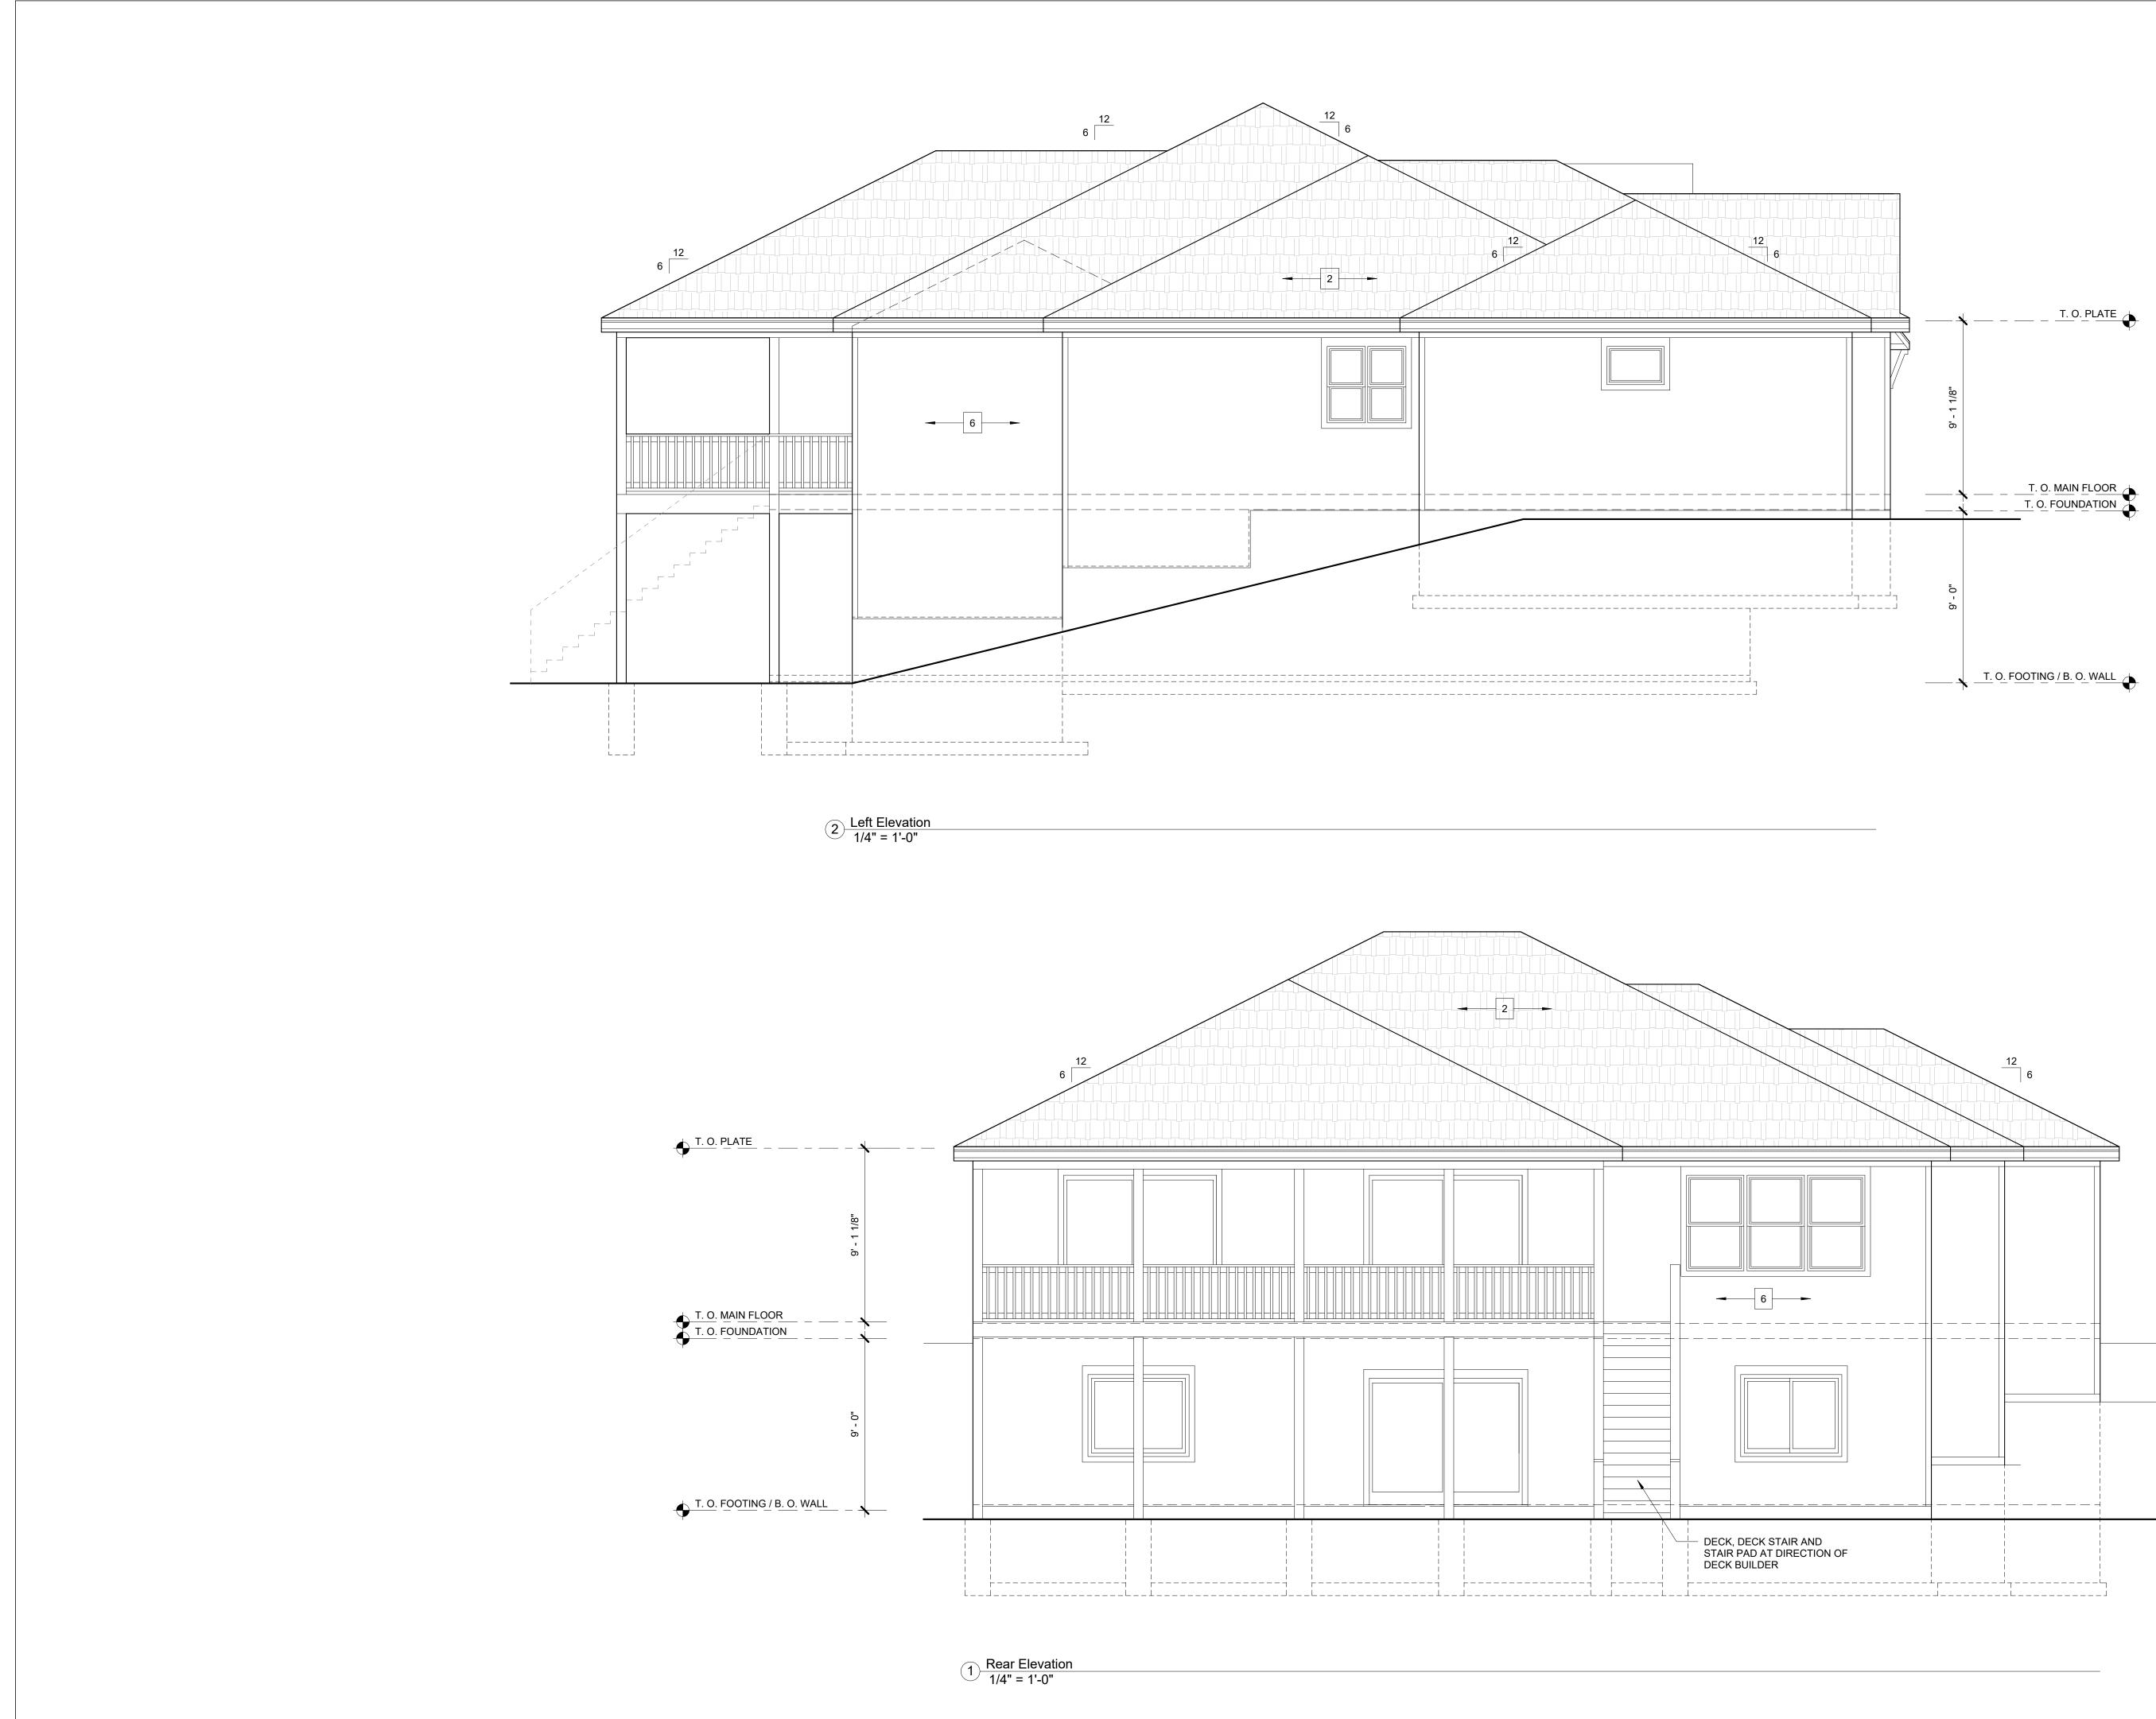




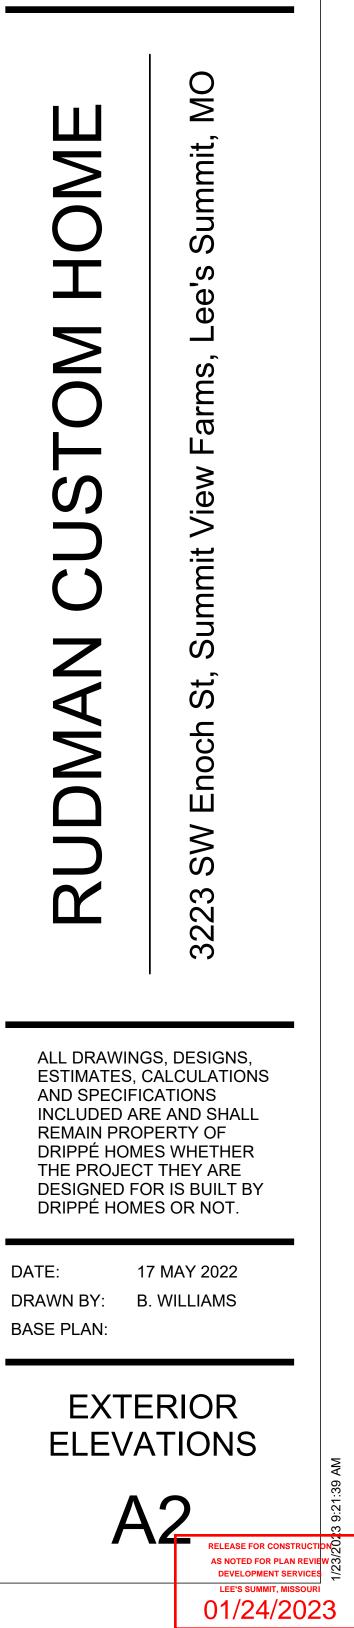

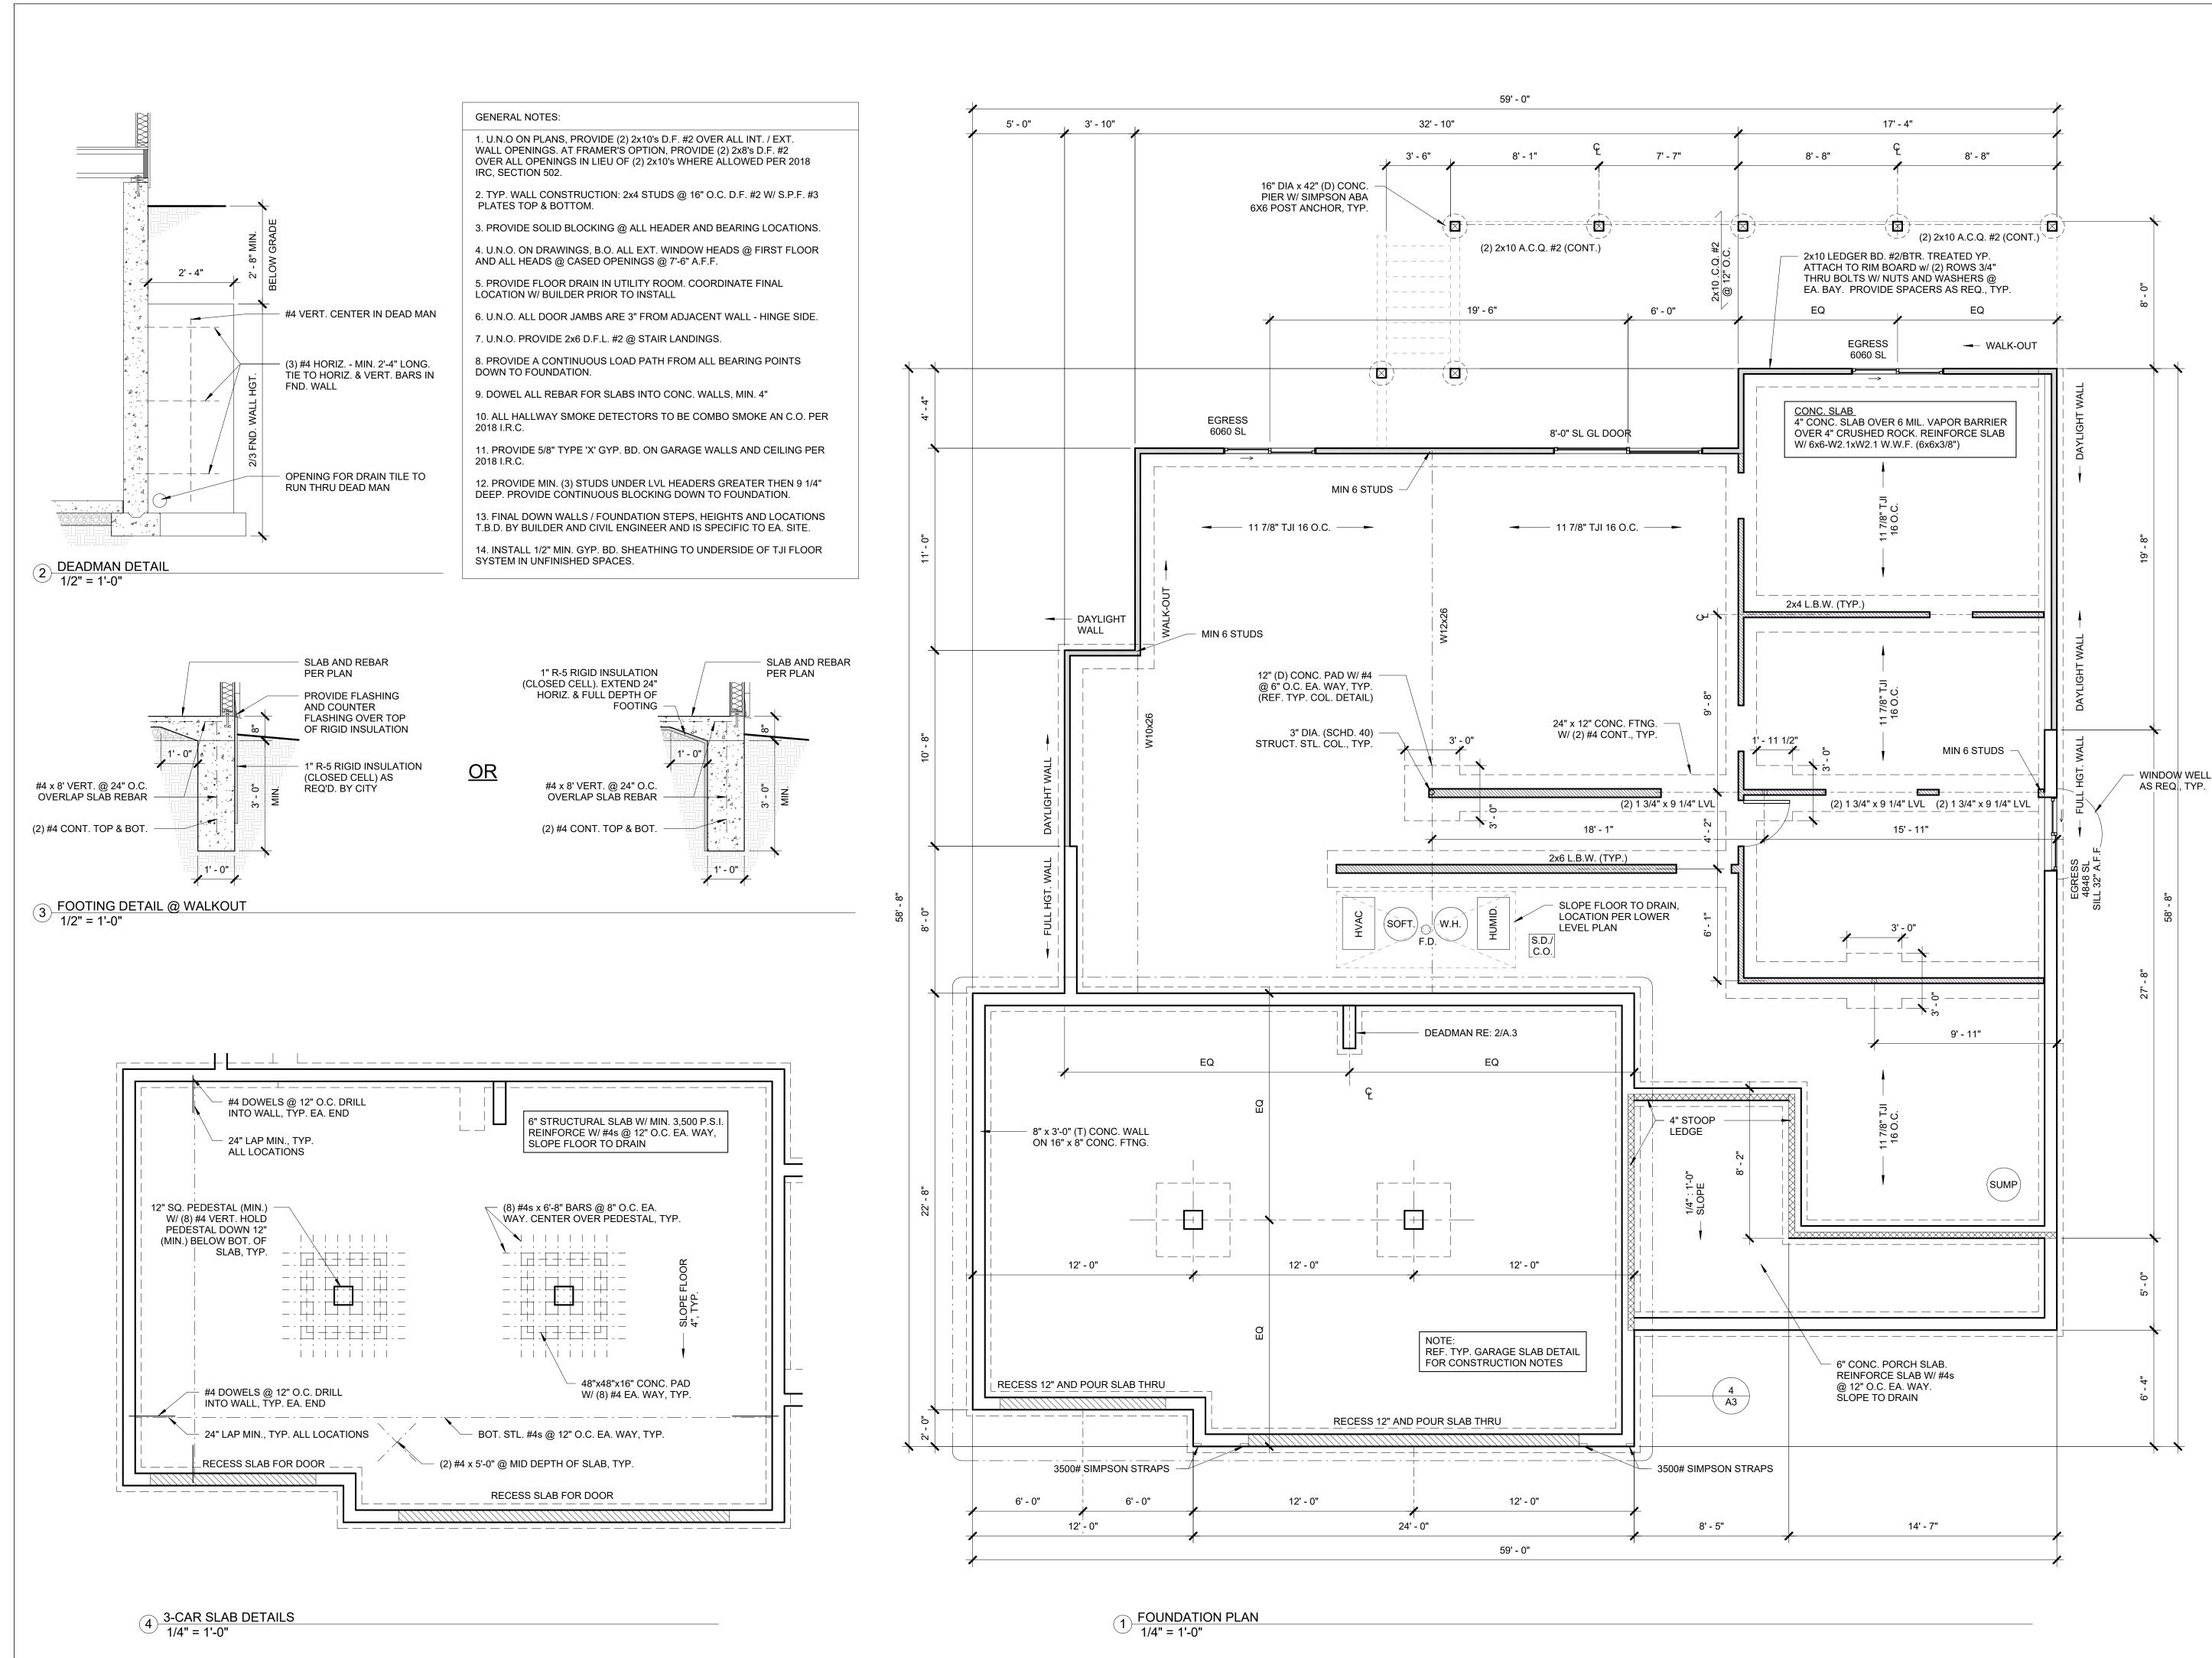

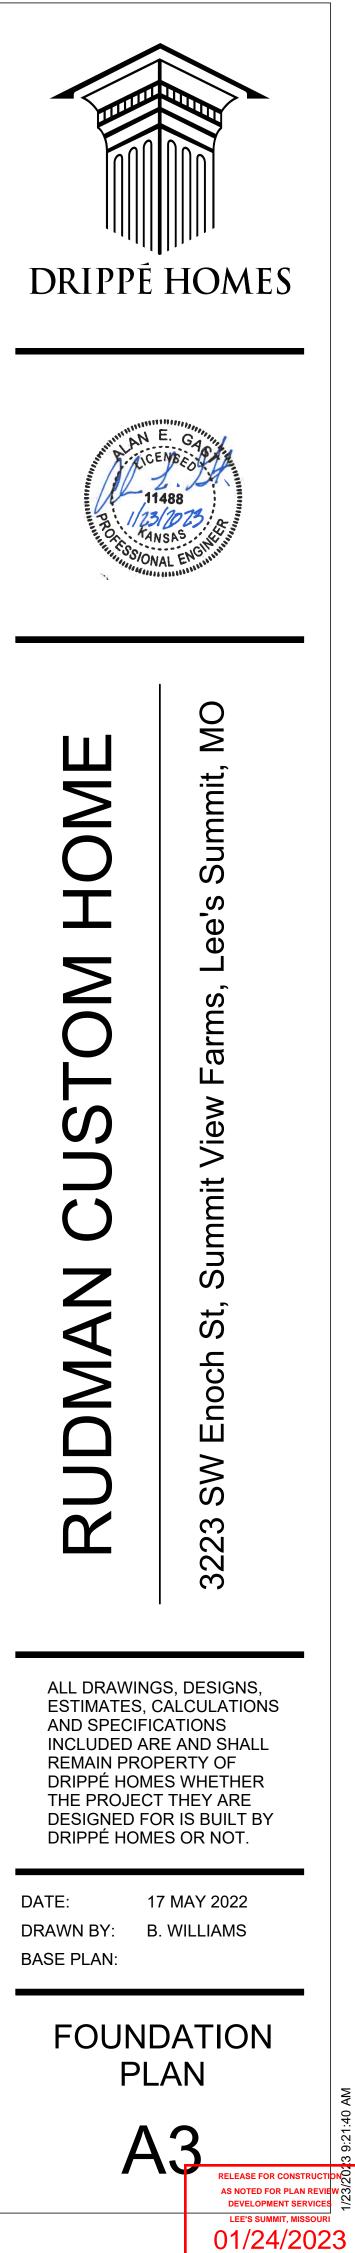

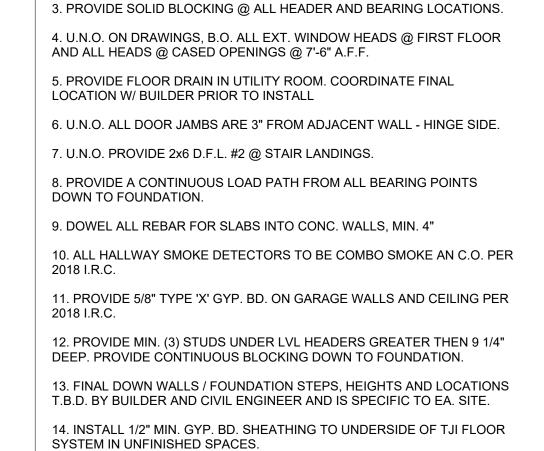


1. U.N.O ON PLANS, PROVIDE (2) 2x10's D.F. #2 OVER ALL INT. / EXT. WALL OPENINGS. AT FRAMER'S OPTION, PROVIDE (2) 2x8's D.F. #2 OVER ALL OPENINGS IN LIEU OF (2) 2x10's WHERE ALLOWED PER 2018

2. TYP. WALL CONSTRUCTION: 2x4 STUDS @ 16" O.C. D.F. #2 W/ S.P.F. #3 PLATES TOP & BOTTOM.



GENERAL NOTES:


IRC, SECTION 502.

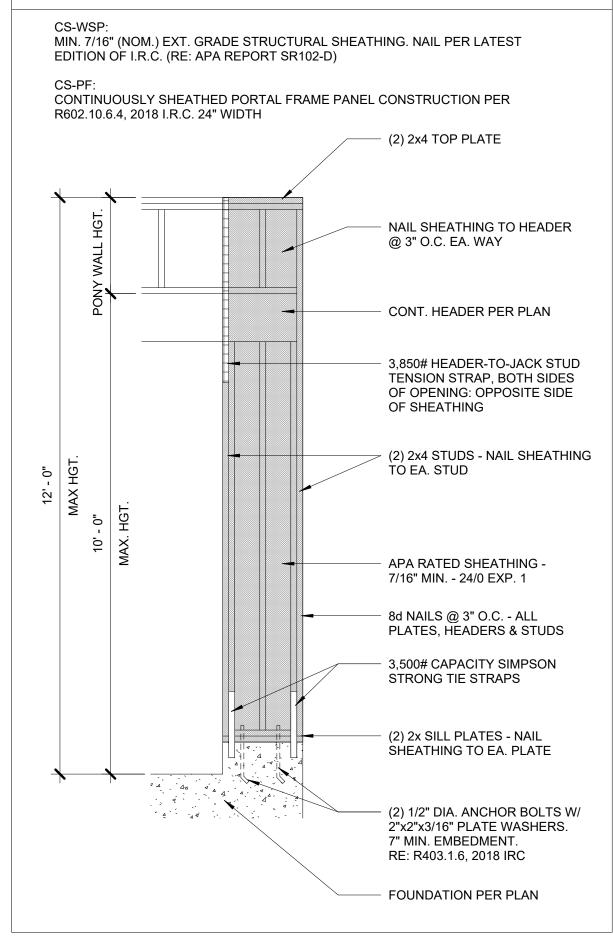


SQUARE FOOTAGE SUMMARY TOTAL FINISHED TOTAL FINISHED MAIN TOTAL UNFINISHED MAIN TOTAL FINISHED LOWER GARAGE DECK

PAVEMENT AREAS

2 BRACED WALL PANEL SCHED 1/2" = 1'-0"

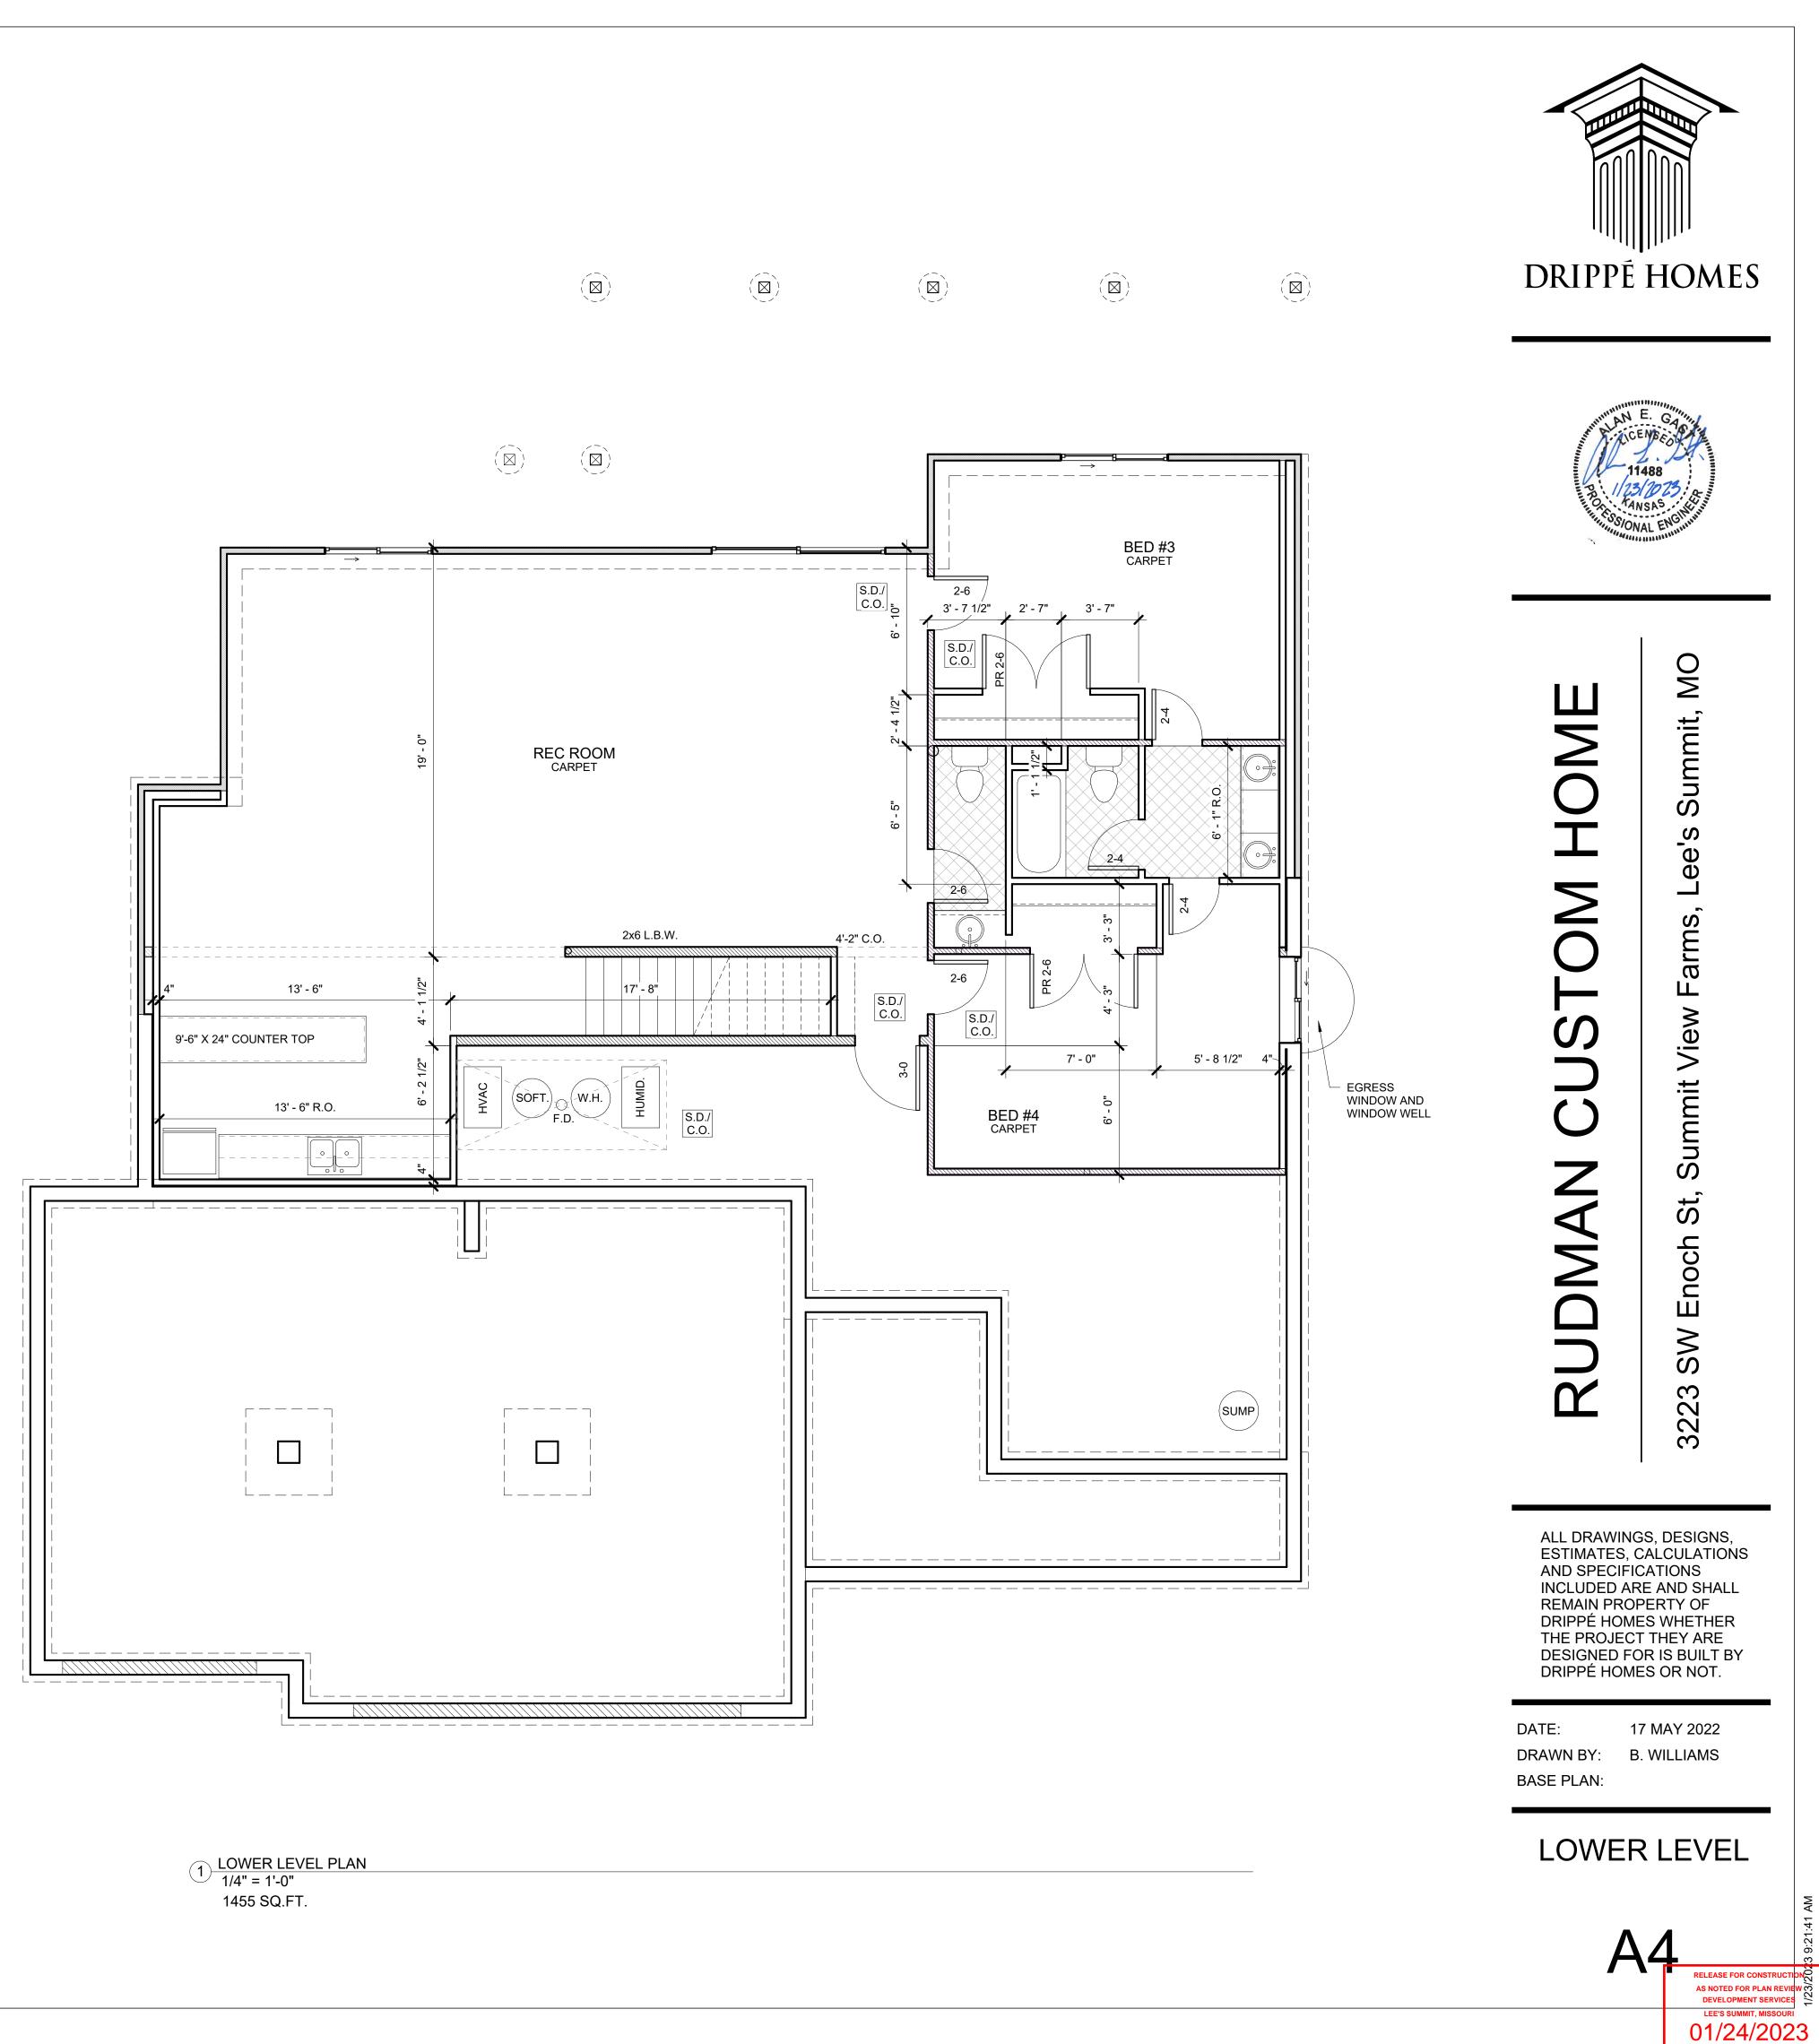

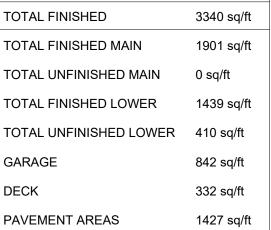

GENERAL NOTES:

1. U.N.O ON PLANS, PROVIDE (2) 2x10's D.F. #2 OVER ALL INT. / EXT. WALL OPENINGS. AT FRAMER'S OPTION, PROVIDE (2) 2x8's D.F. #2 OVER ALL OPENINGS IN LIEU OF (2) 2x10's WHERE ALLOWED PER 2018 IRC, SECTION 502.

2. TYP. WALL CONSTRUCTION: 2x4 STUDS @ 16" O.C. D.F. #2 W/ S.P.F. #3 PLATES TOP & BOTTOM.

3. PROVIDE SOLID BLOCKING @ ALL HEADER AND BEARING LOCATIONS.

4. U.N.O. ON DRAWINGS, B.O. ALL EXT. WINDOW HEADS @ FIRST FLOOR AND ALL HEADS @ CASED OPENINGS @ 7'-6" A.F.F.

5. PROVIDE FLOOR DRAIN IN UTILITY ROOM. COORDINATE FINAL LOCATION W/ BUILDER PRIOR TO INSTALL

6. U.N.O. ALL DOOR JAMBS ARE 3" FROM ADJACENT WALL - HINGE SIDE.

7. U.N.O. PROVIDE 2x6 D.F.L. #2 @ STAIR LANDINGS.

8. PROVIDE A CONTINUOUS LOAD PATH FROM ALL BEARING POINTS DOWN TO FOUNDATION.

9. DOWEL ALL REBAR FOR SLABS INTO CONC. WALLS, MIN. 4"

10. ALL HALLWAY SMOKE DETECTORS TO BE COMBO SMOKE AN C.O. PER 2018 I.R.C.

11. PROVIDE 5/8" TYPE 'X' GYP. BD. ON GARAGE WALLS AND CEILING PER 2018 I.R.C.

12. PROVIDE MIN. (3) STUDS UNDER LVL HEADERS GREATER THEN 9 1/4" DEEP. PROVIDE CONTINUOUS BLOCKING DOWN TO FOUNDATION.

13. FINAL DOWN WALLS / FOUNDATION STEPS, HEIGHTS AND LOCATIONS T.B.D. BY BUILDER AND CIVIL ENGINEER AND IS SPECIFIC TO EA. SITE. 14. INSTALL 1/2" MIN. GYP. BD. SHEATHING TO UNDERSIDE OF TJI FLOOR

SYSTEM IN UNFINISHED SPACES.

BRACED WALL PANEL SCHED.


<u>BV-WSP</u>

7/16" EXT. GRADE STRUCTURAL SHEATHING. NAIL PER TABLE R602.10.4 OF THE 2018 I.R.C.

<u>G.B.-1</u> 1/2" GYP. BD. SHEATHING - FULL LENGTH OF WALL. PROVIDE FASTENERS @ 7" O.C. EDGES & 7" O.C. FIELD. PER TABLE R702.3.5 OF THE 2018 I.R.C. PROVIDE FULL BLOCKING BEHIND ALL JOINTS.


<u>HPS:</u> 7/16" HARDBOARD PANEL SIDING (MIN. 4'-0" LENGTH) INSTALLED PER TABLE R703.4 OF THE 2018 I.R.C.

<u>CS-PF:</u> CONTINUOUSLY SHEATHED PORTAL FRAME PANEL CONSTRUCTION PER R602.10.6.4 OF THE 2018 I.R.C - 24" WIDTH

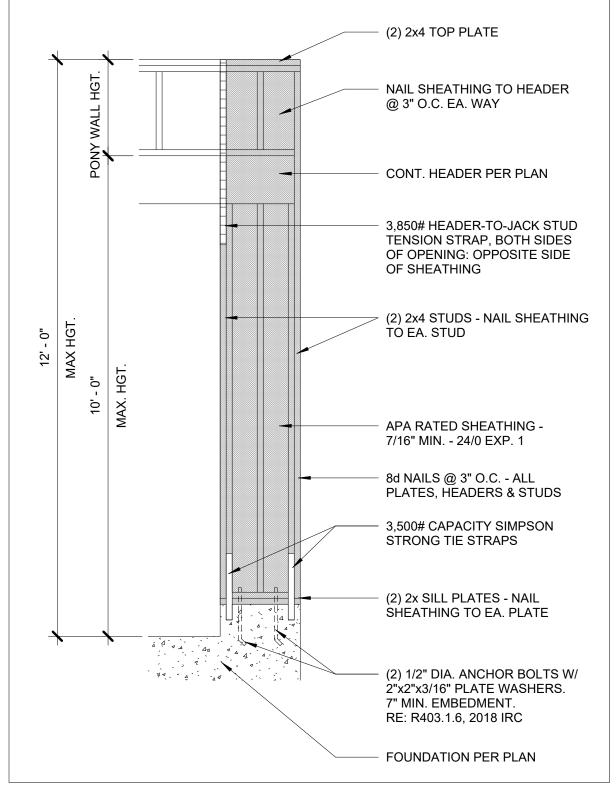


SQUARE FOOTAGE SUMMARY	,
TOTAL FINISHED	3340 sq/ft
TOTAL FINISHED MAIN	1901 sq/ft
TOTAL UNFINISHED MAIN	0 sq/ft
TOTAL FINISHED LOWER	1439 sq/ft
TOTAL UNFINISHED LOWER	410 sq/ft
GARAGE	842 sq/ft
DECK	332 sq/ft
PAVEMENT AREAS	1427 sq/ft

2 BRACED WALL PANEL SCHED MAIN 1/2" = 1'-0"

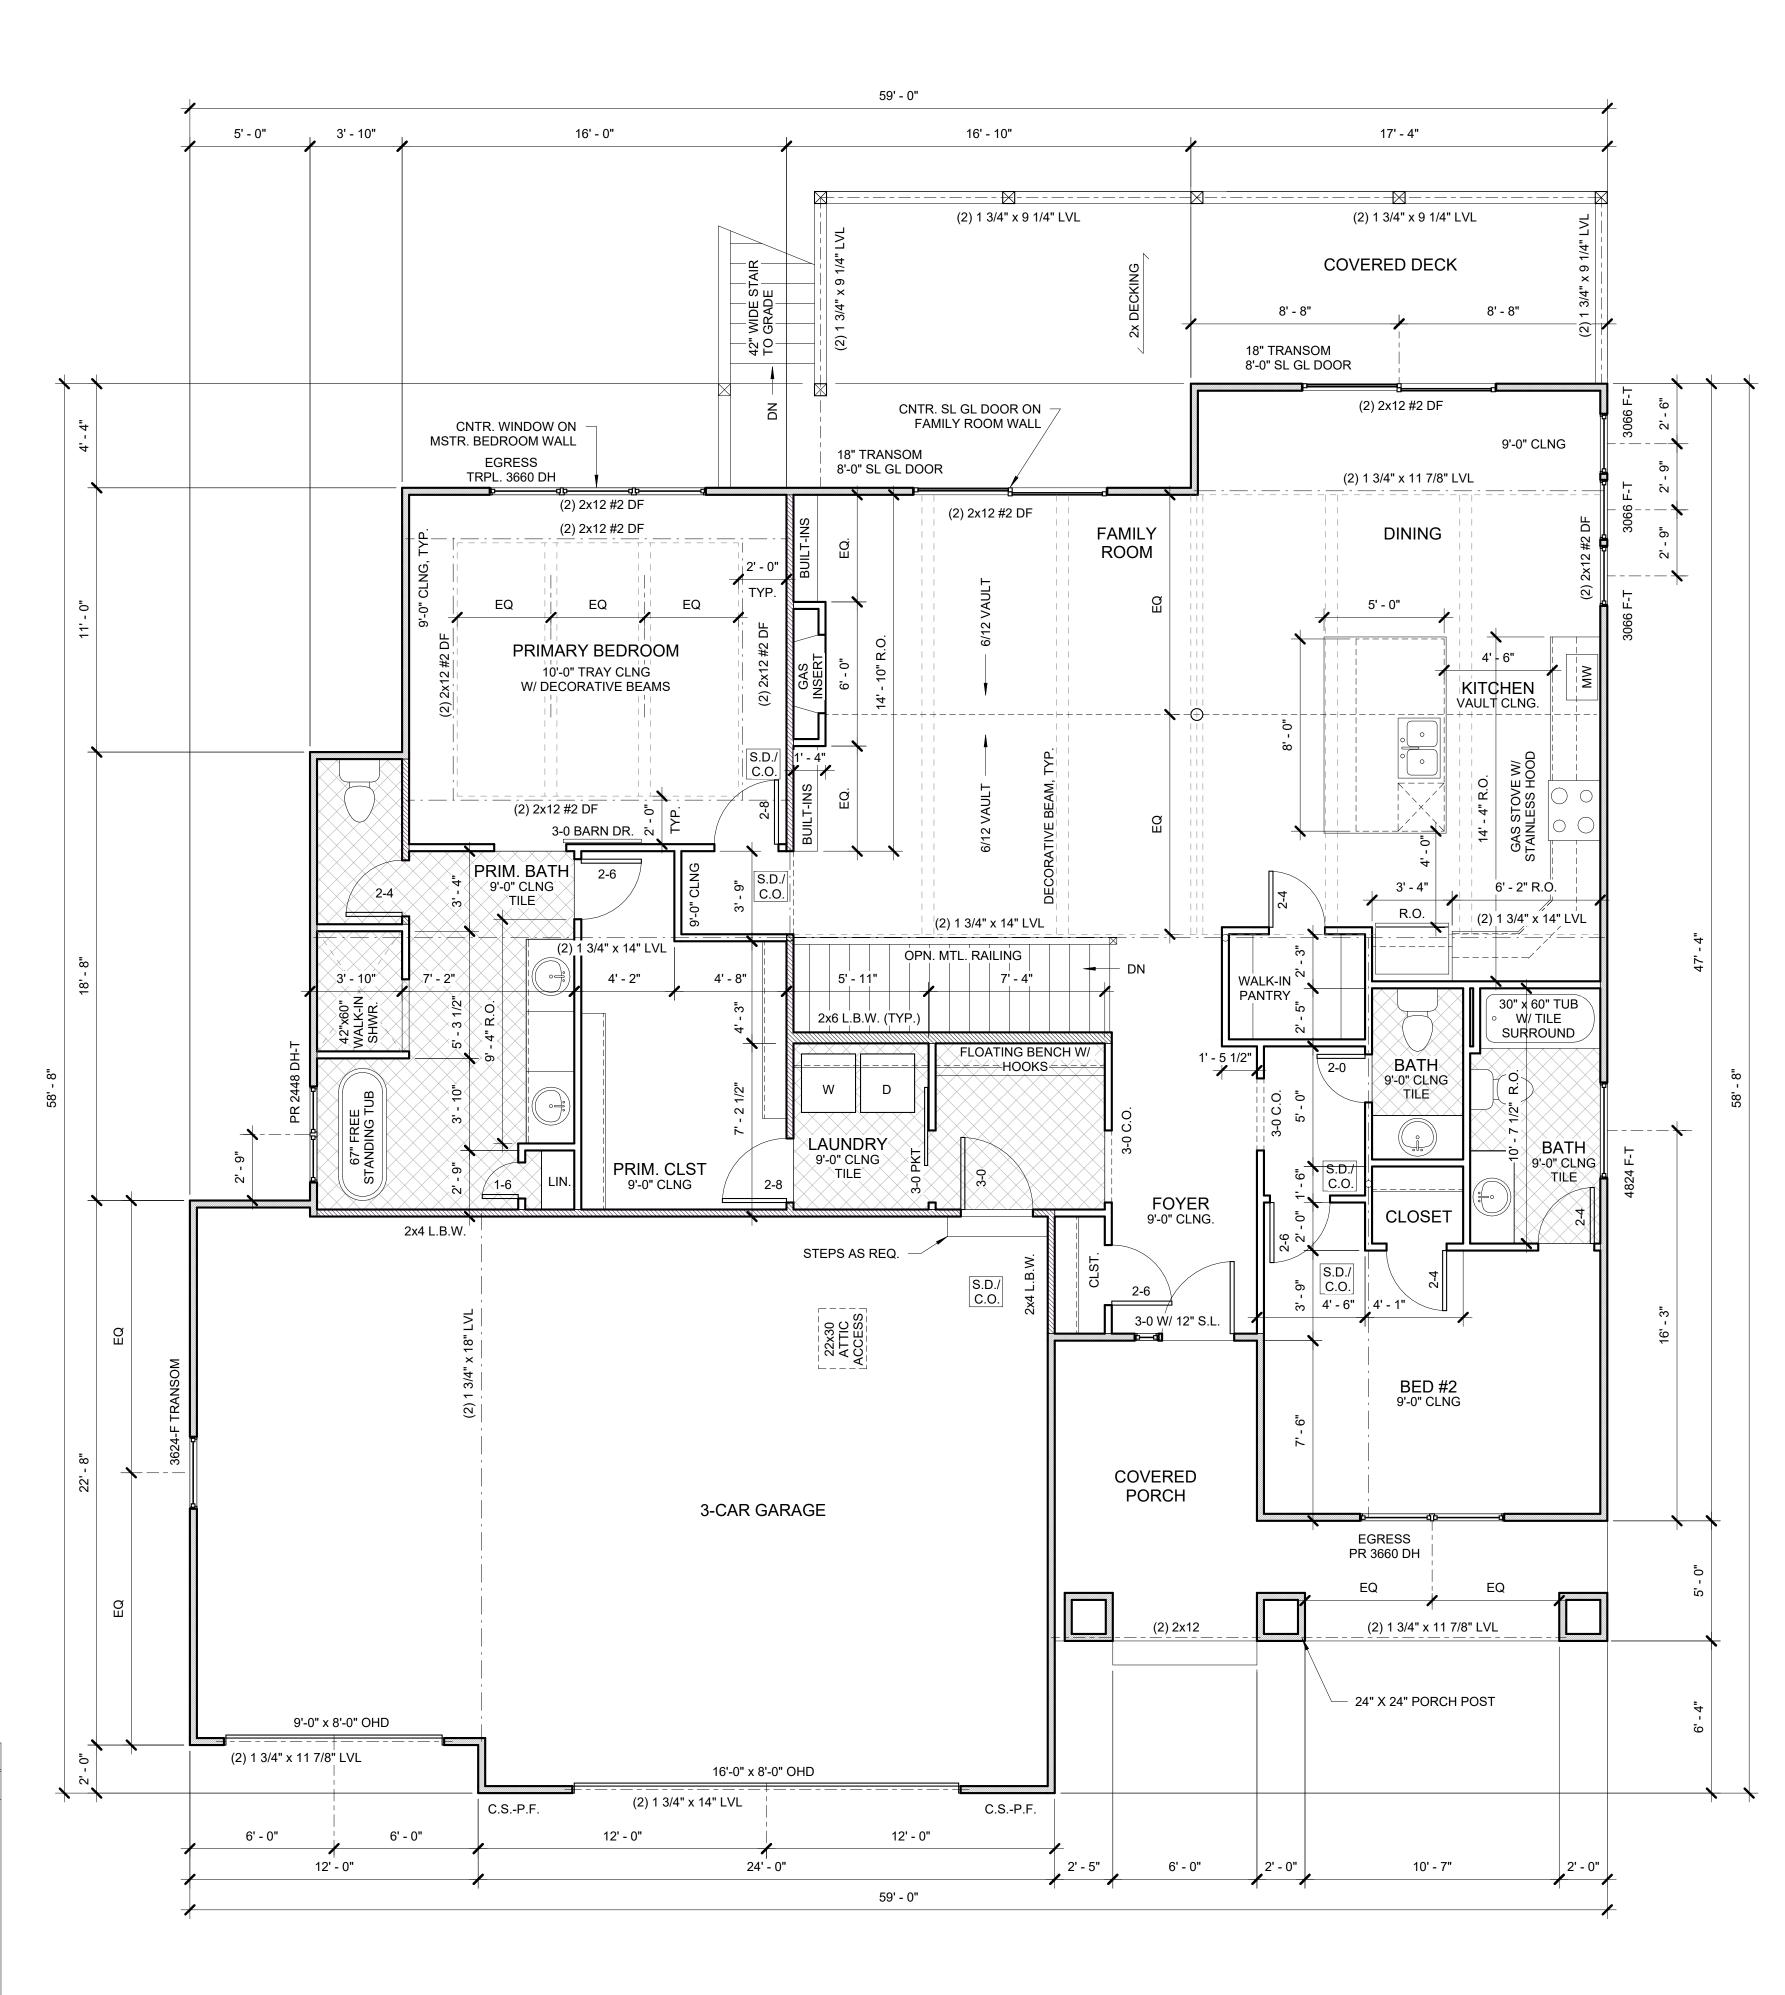



 $1 \frac{\text{MAIN FLOOR PLAN}}{1/4" = 41.0"}$ / 1/4" = 1'-0"


340 sq/ft 901 sq/ft sq/ft 439 sq/ft 0 sq/ft 42 sq/ft 32 sq/ft

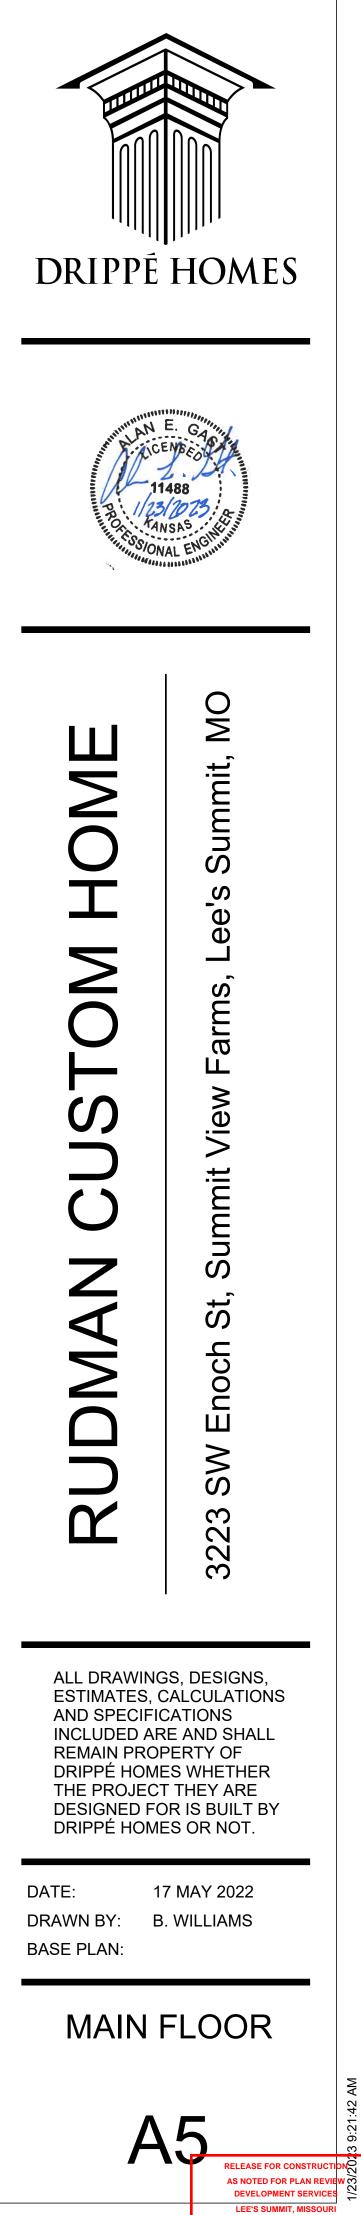


01/24/2023

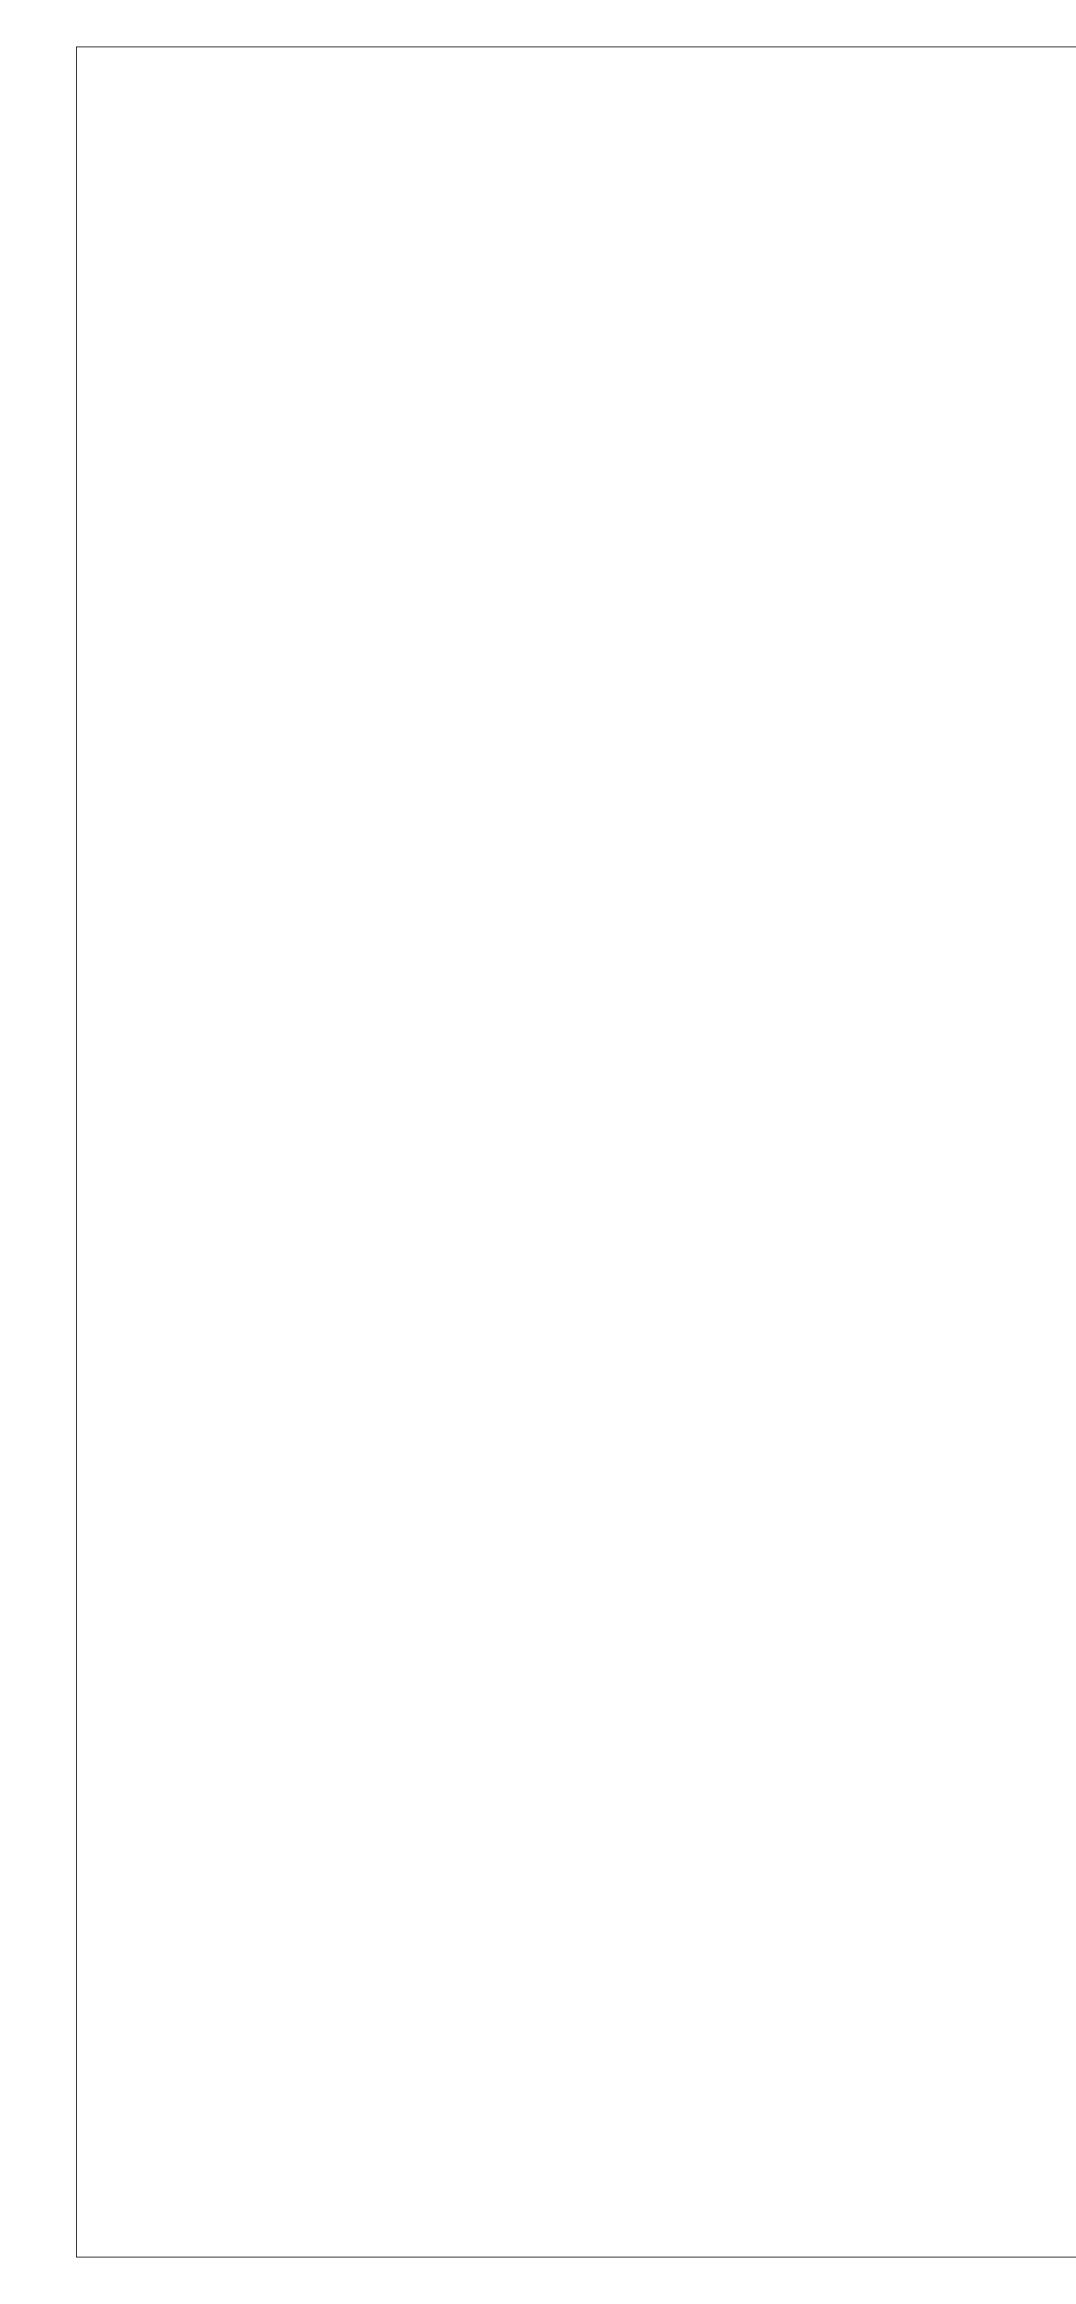

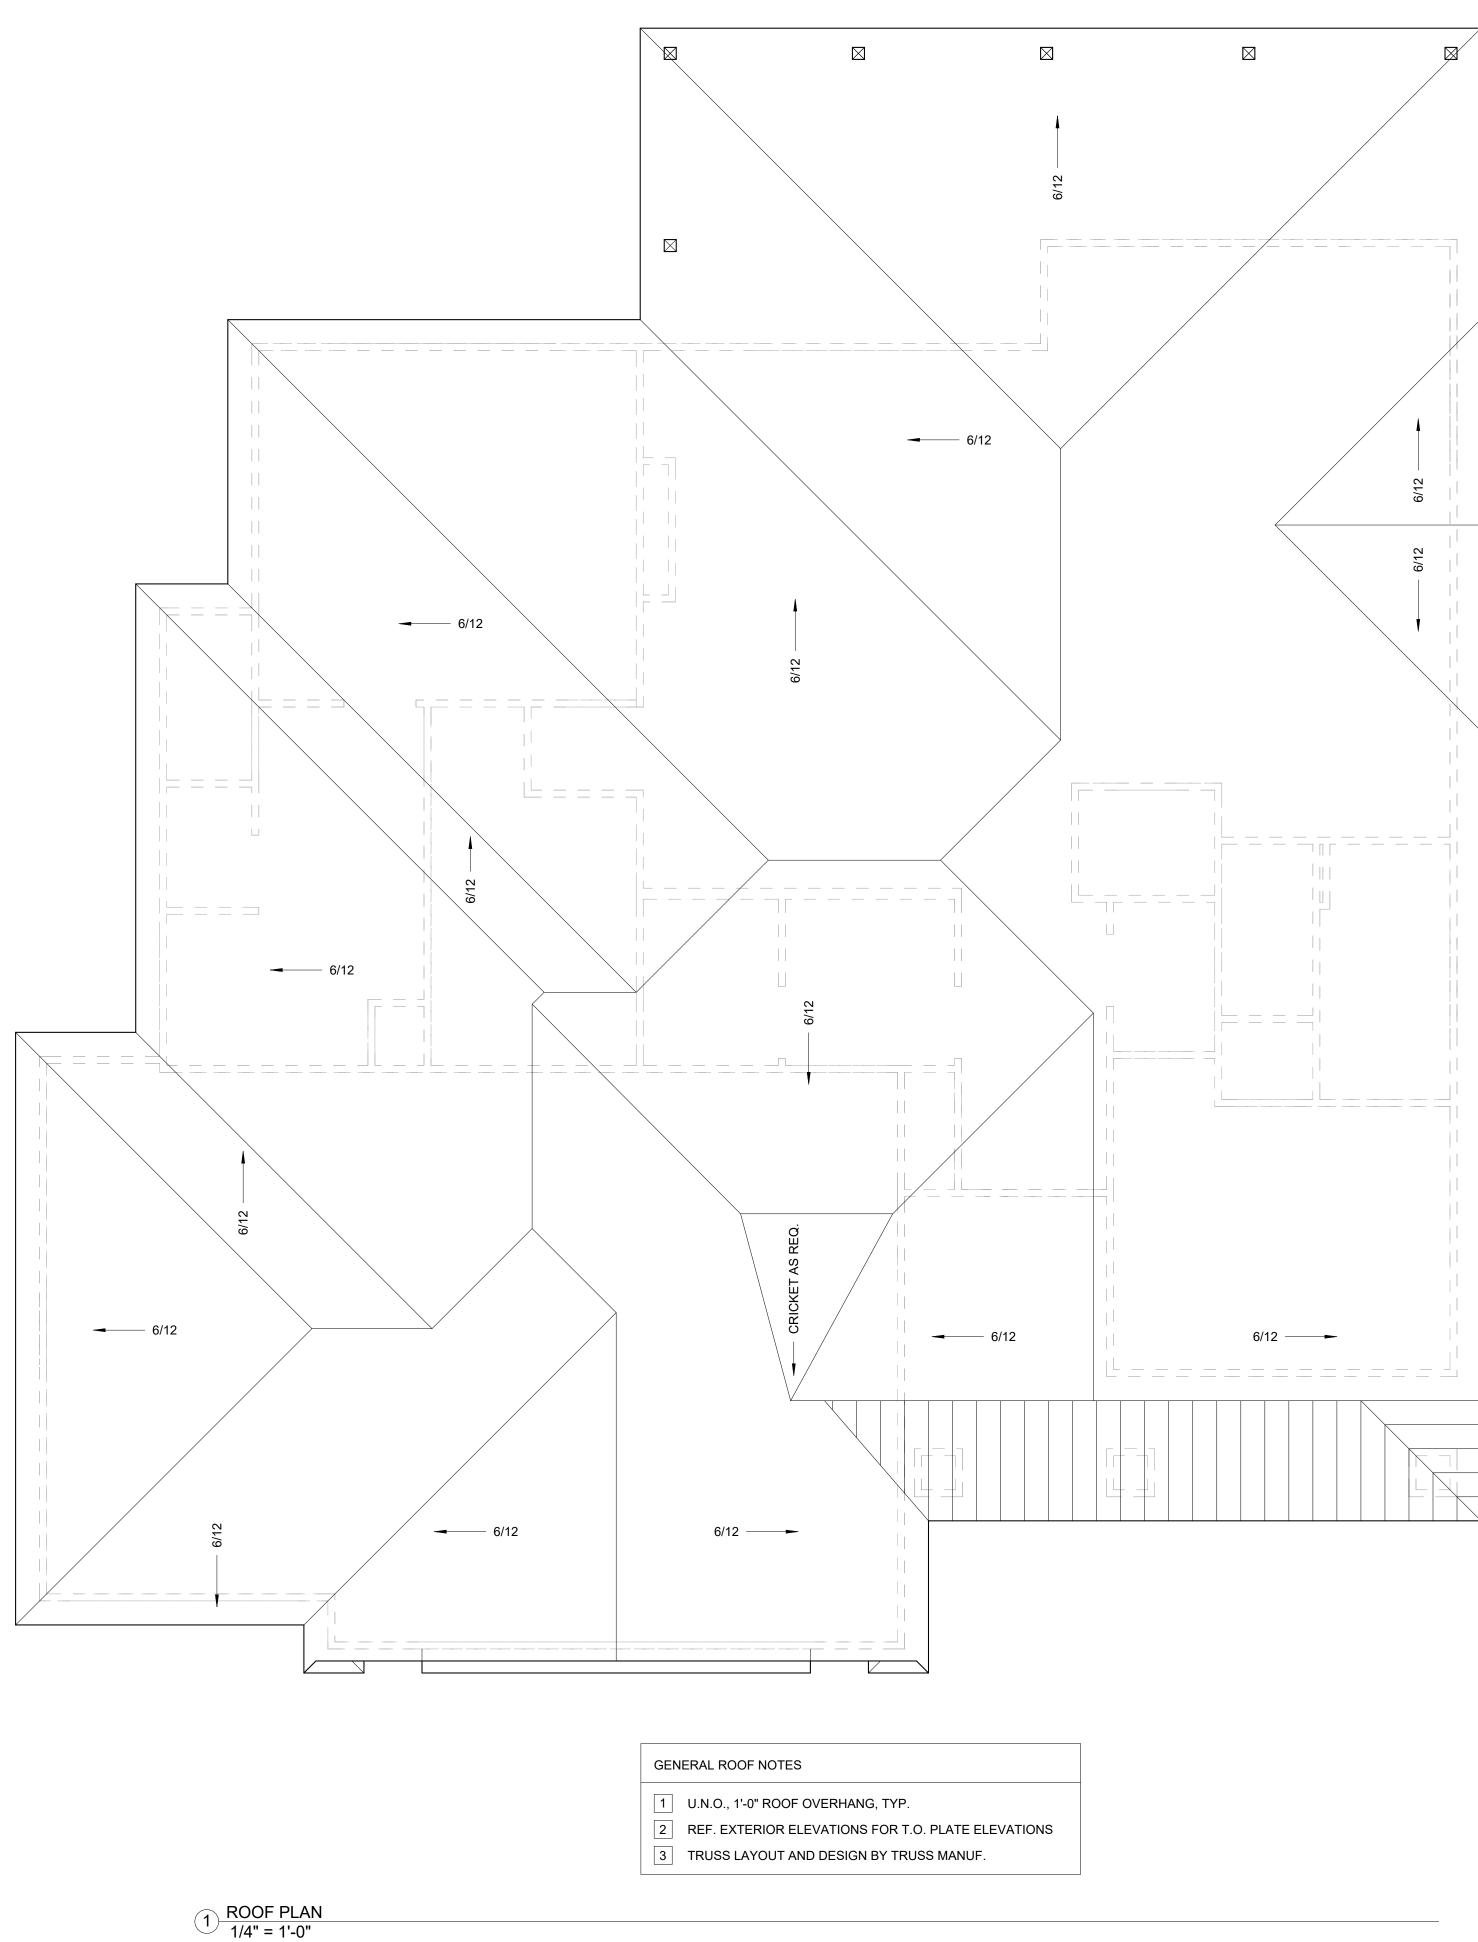

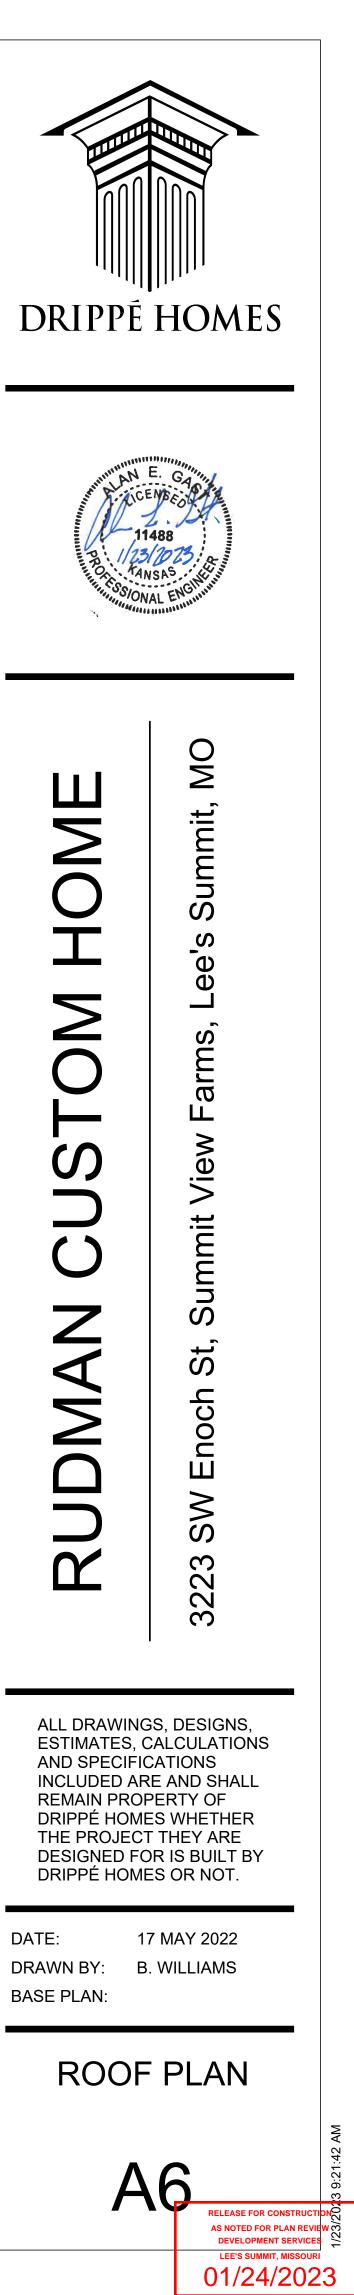

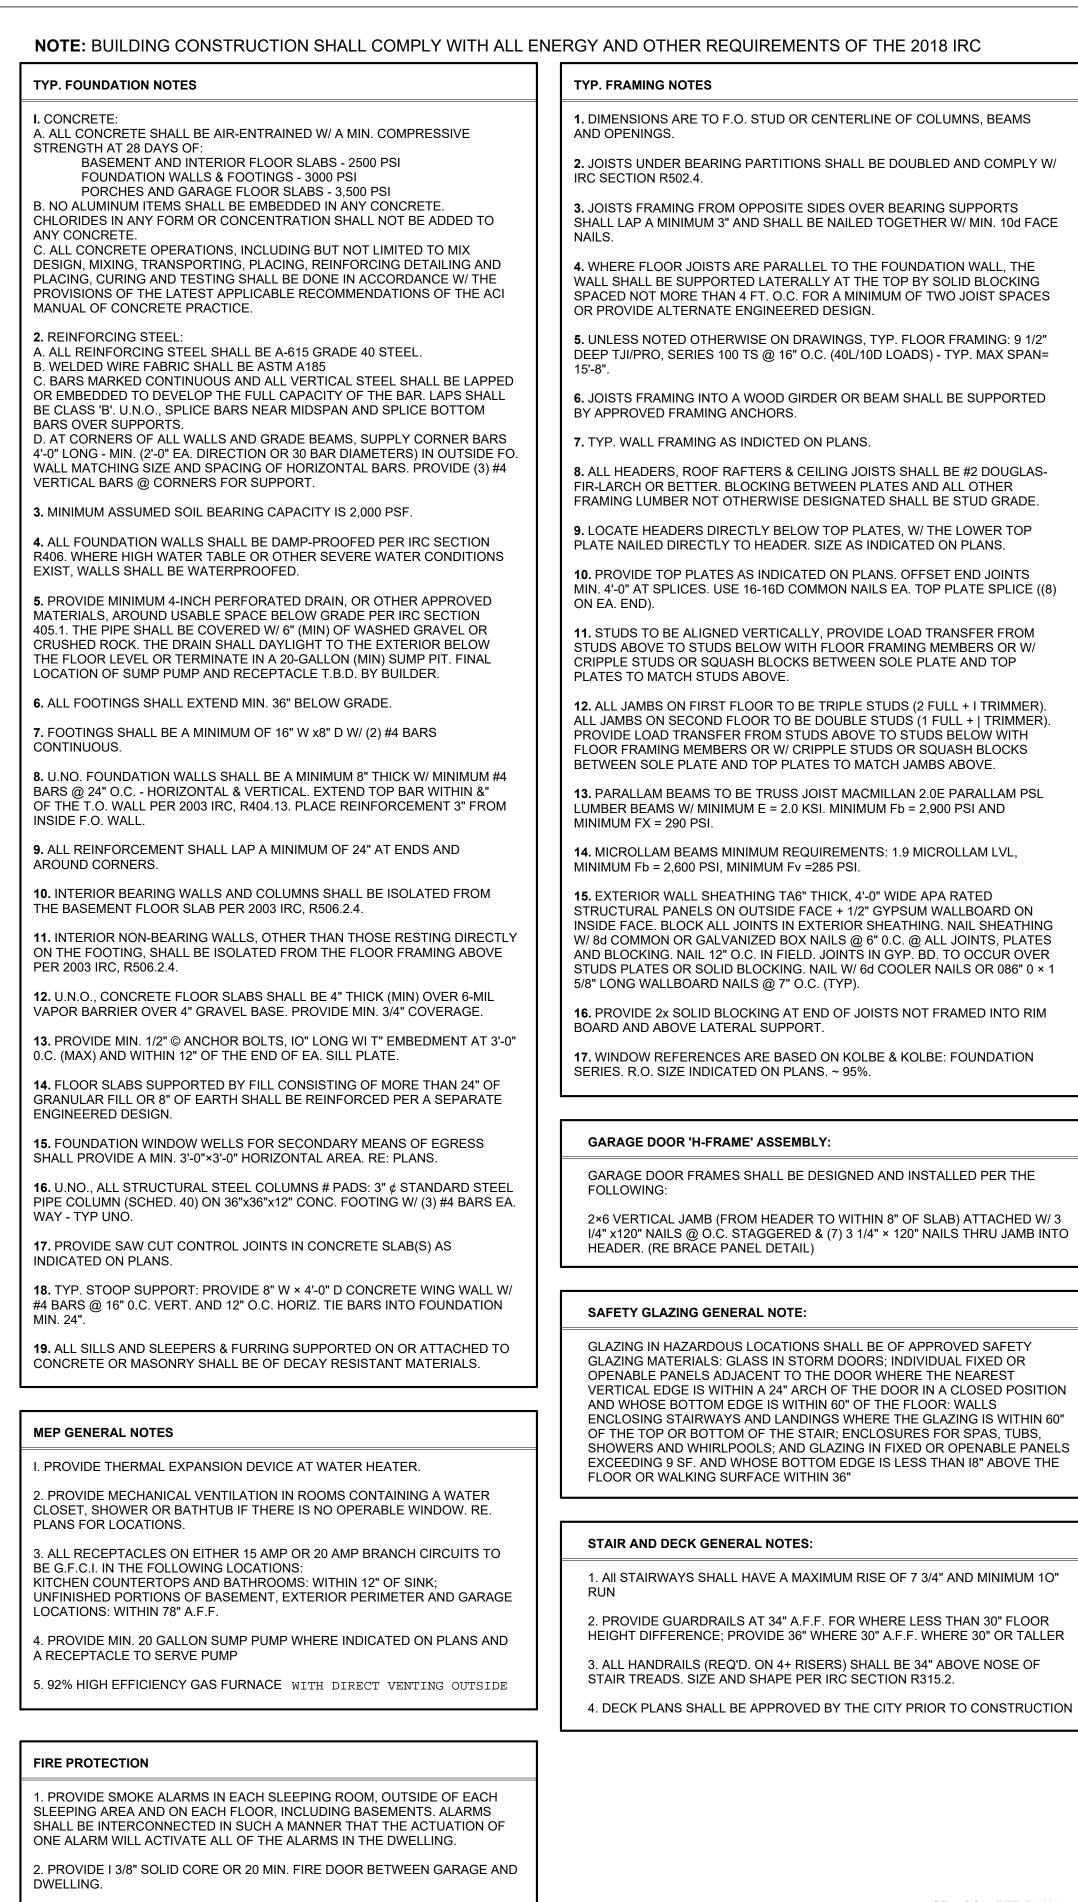

3. SEPARATE GARAGE FROM DWELLING AND ATTIC AREAS BY MINIMUM 1/2" TYPE 'X' GYP. BD. APPLIED TO GARAGE SIDE. WHERE A FLOOR / CEILING SPACE IS PROVIDED ABOVE THE GARAGE, COLUMNS AND BEAMS SHALL ALSO BE PROTECTED.

4. PROVIDE 1/2" FIRE-RATED GYP BD. IN THE FOLLOWING LOCATIONS: IN USABLE, ENCLOSED SPACES UNDER STAIRS: BETWEEN LIVING AREAS AND GARAGE.

5. NON-COMBUSTIBLE FIREPLACE HEARTHS SHALL BE A MIN. OF 20" DEEP

EMERGENCY EGRESS AND RESCUE

1. ALL DESIGNATED EGRESS WINDOWS SHALL HAVE A MIN. OPENABLE AREA OF 5.1 S.F., 24" MIN. (OPENABLE) CLEAR HEIGHT, 2/" MIN. CLEAR (OPENABLE) WIDTH. 44" MAX. SILL HEIGHT OFF FLOOR

- STL. COL. PER PLAN - DELAY POUR

(2) LAYERS 15# FELT MIN.

REINFORCEMENT PER PLAN

PER PLAN

3 <u>TYP. COLUMN DETAIL</u> 3/4" = 1'-0"

INSULATION VALUES PER TABLE N1102.1(1) - WINDOW AREA NOT LIMITED		
LOCATION	MIN. R-VALUE	
CEILING	R-38	
CATHEDRAL CEILING	R-30	
FLOORS OVER HEATED SPACE	R-19	
FLOORS OVER OUTSIDE AIR	R-30	
EXTERIOR WALL	R-13 (4"); R-19 (6")	
CRAWL SPACE WALL	R-19	
BASEMENT WALL	R-10 - INSULATE CONC. WALLS ADJACENT TO FIN. SPACE	
GLAZING	U ≤ 0.40; SHGF ≤ 0.40	

MIN. DEAD LOAD

10

10

10

10

10

10

10

10

20

MIN. LIVE LOAD

60

40

20

40

30

20

20

LOAD CONDITION TABLE

EXTERIOR BALCONIES

CEILING JSTS./ATTICS W/O

CEILING JSTS./ATTICS W/O

STORAGE - SCUTTLE ACCESS

STORAGE - SCUTTLE ACCESS

DOOR / PULL DOWN LADDER

ROOMS - NON-SLEEPING

ROOF - HEAVY COVERING

CONCRETE/TILE/SLATE

ROOMS - SLEEPING

ONLY - ROOF SLOPE OVER 3/12

ROOF - LIGHT ROOF COVERING


CEILING JSTS./ATTICS W/ STORAGE -

ONLY - ROOF SLOPE 3/12 OR LESS

AREA


DECKS

ACCESS

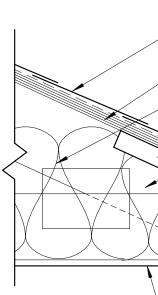


5/8" GYP. BD. ON 2X CLNG. JST. PER PLAN


2 TYP. EAVE DETAIL - TRUSS 1 1/2" = 1'-0"

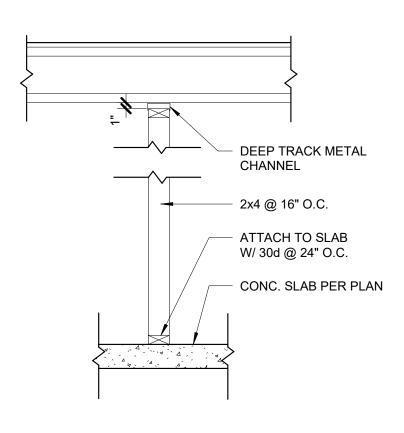

 $\bigcirc \frac{\text{TYP. NON-BEARING DETAIL}}{3/4" = 1'-0"}$

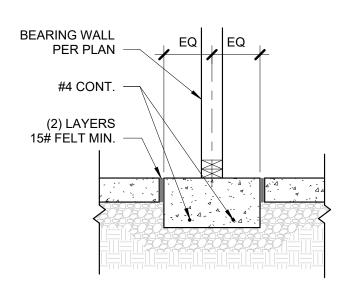

(4) TYP. BEARING DETAIL 3/4" = 1'-0"

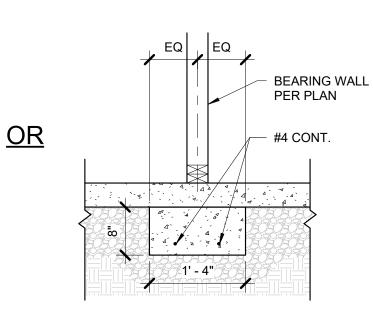

3/4" T&G EXT. GRADE PLYWD. OVER

1/2" DIA. x 10" ANCHOR BOLTS


5/8" GYP. BD. OVER 2x4 FRAMING @ 16" O.C. WITH R-13 FULL BATT INSULATION. MAINTAIN 1" AIR GAP BTWN. EXT. FACE OF FRAMING AND INT. FACE OF FDN. WALL, TYP.

1/2" COMPRESSIBLE FILLER

4" CONC. SLAB W/ 6x6 WIRE AND REBAR PER PLAN OVER 6 MIL. VAPOR BARRIER OVER 4" CRUSHED ROCK

CONT. @ INTERIOR FOOTING

1 TYP. WALL SECTION 3/4" = 1'-0"

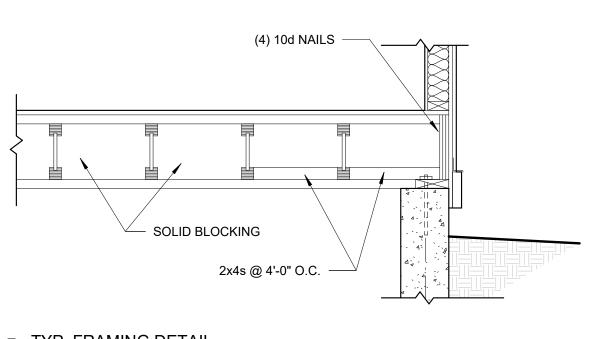

TYP. FRAMING DETAIL 3/4" = 1'-0"



7/16" OSB (MIN. 24' APA SPAN RATIN6 FOR ROOFS) W/ H-CLIPS ATTACHED TO TRUSSES W/ 10d NAILS @ 6" O.C.


R-49 BLOWN INSULATION

AIR BAFFLE

ENGINEERED TRUSSES @ 24" O.C. DESIGNED BY MFR.


SIMPSON H25 CLIPS AT EACH END OF TRUSS AND @ INTERMEDIATE SUPPORTS PER TRUSS MFR.

2x6 BLOCKING B/W ROOF TRUSSES WHERE REQ. AT BWPs

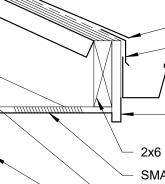

1/2" SHINGLE OVERHANG, TYP. 2" x 3" PRE-FIN. ALUM. EDGE FLASHING PRE-FIN. ALUM. GUTTER W/ ANCHOR STRAPS @ 4'-0" O.C. MOUNT MIN. 1/2" BELOW SLOPE OR ROOF **8" SMART TRIM FASCIA BOARD**

2x6 SUBFASCIA SMART TRIM SOFFIT PANEL W/ 16" x 8" UNDER EAVE LOUVER 2x WD. BLOCKING SMART TRIM PER ELEVATION 1/2" BACKER ROD & SEALANT

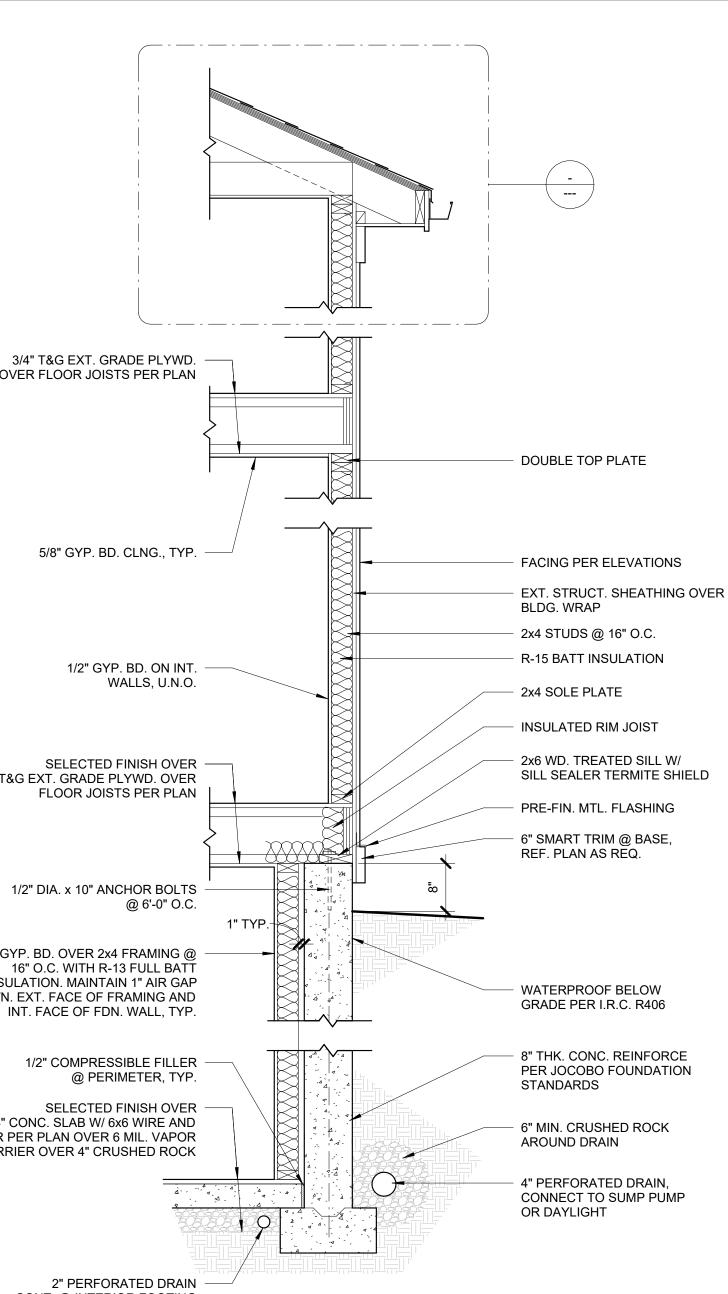

DRIPPE HOMES



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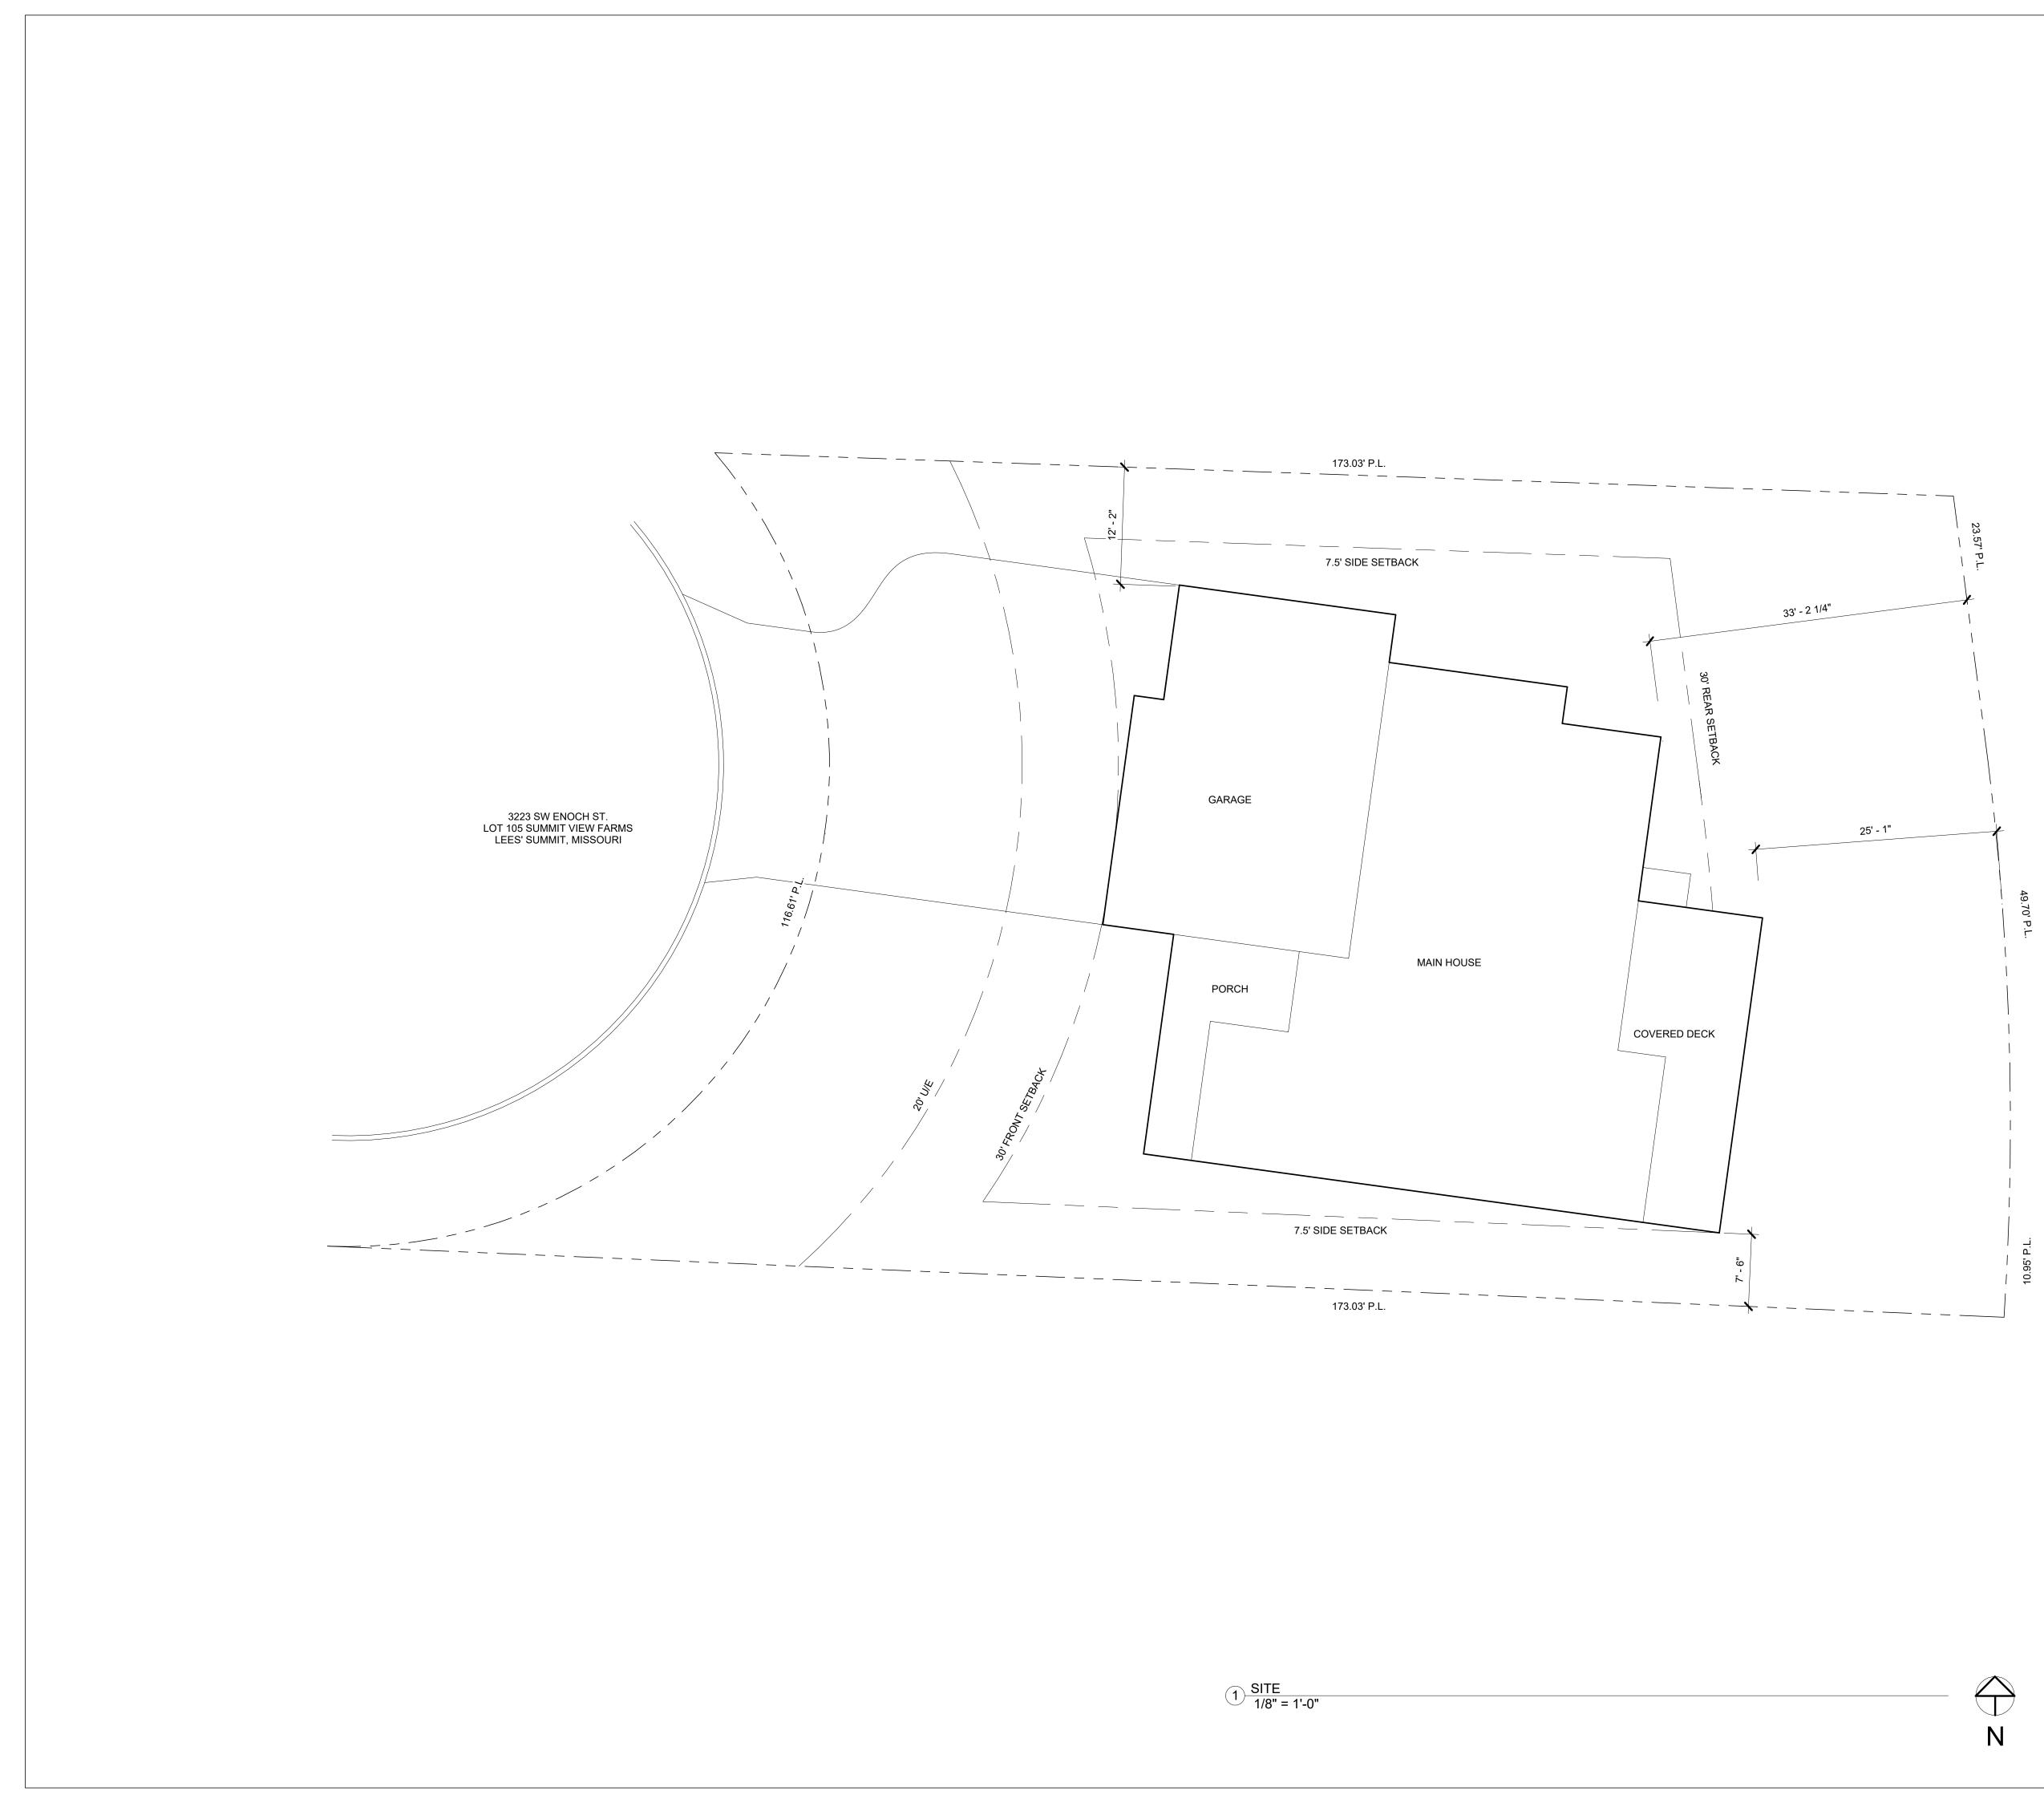
ALL DRAWINGS, DESIGNS, ESTIMATES, CALCULATIONS AND SPECIFICATIONS INCLUDED ARE AND SHALL REMAIN PROPERTY OF DRIPPÉ HOMES WHETHER THE PROJECT THEY ARE DESIGNED FOR IS BUILT BY DRIPPÉ HOMES OR NOT.

DATE: DRAWN BY: B. WILLIAMS BASE PLAN:

17 MAY 2022


AS NOTED FOR PLAN REVIEW DEVELOPMENT SERVICES LEE'S SUMMIT, MISSOURI 01/24/2023









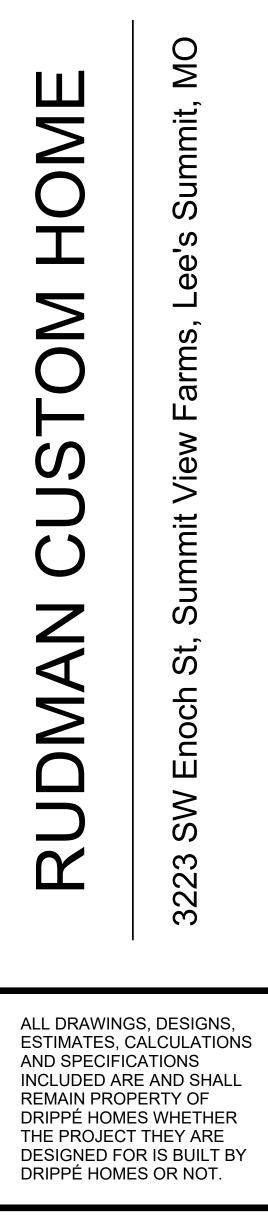

DATE:	17
DRAWN BY:	В.
BASE PLAN:	

7 MAY 2022 B. WILLIAMS



