
JAZZERCISE LSMO

618 SW 3RD STREET, SUITE E LEE'S SUMMIT, MO 64063


PERMIT DOCUMENTS


01/13/2023

COLLINS WEBB #: 23010

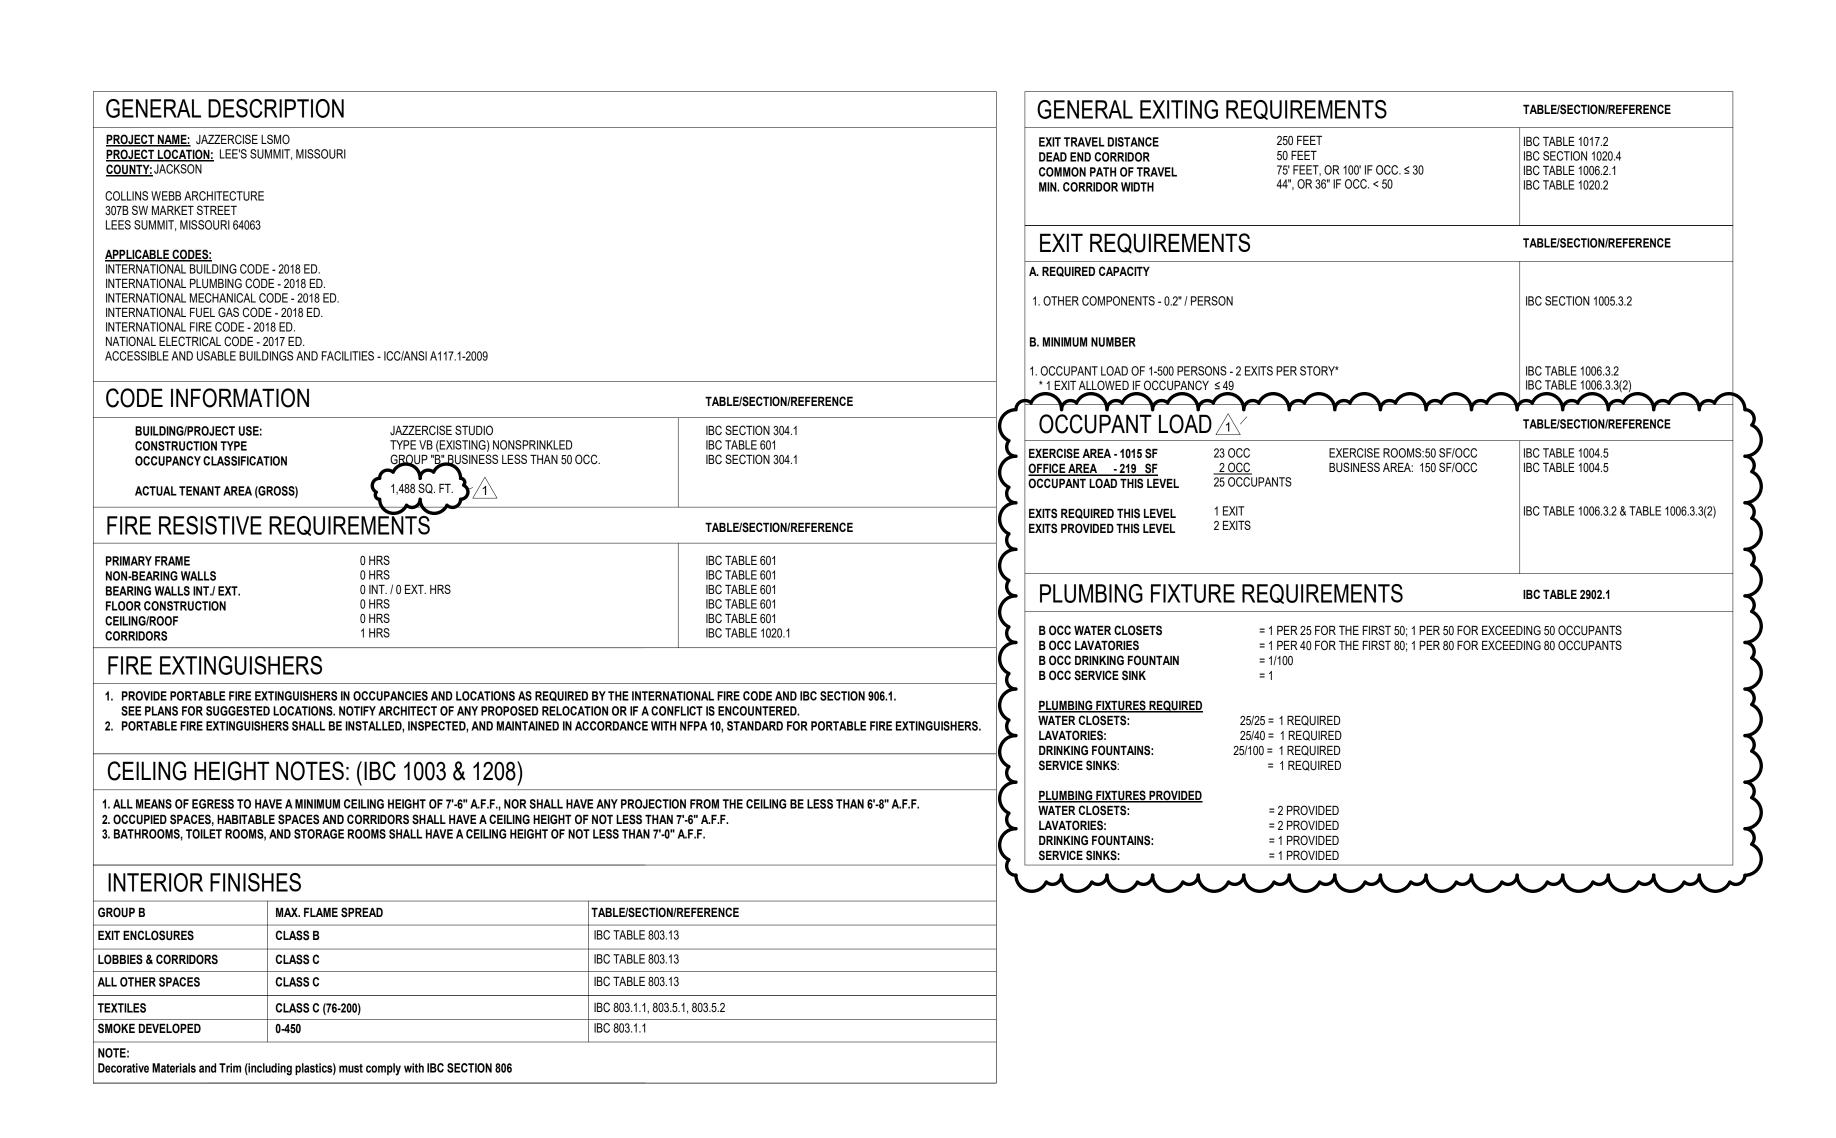

GENER	AL
SHEET NUMBER	SHEET NAME
CS	COVER SHEET
G001	GENERAL INFORMATION
G002	ACCESSIBILITY GUIDELINES
ARCHI	ΓECTURAL
SHEET NO.	SHEET NAME
A101	1ST FLOOR PLAN, FINISHES & SCHEDULES
MEP	
SHEET NUMBER	SHEET NAME
M101	MECHANICAL PLANS, SPECS & SCHEDULES
P101	PLUMBING PLANS, SPECS & SCHEDULES
E001	ELECTRICAL PLANS
E101	ELECTRICAL PLANS

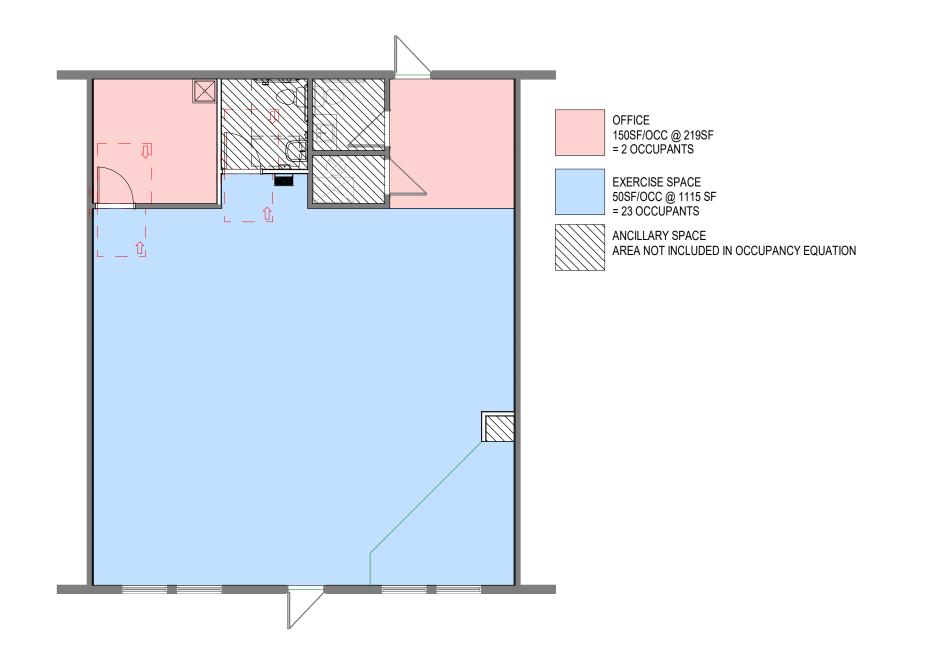

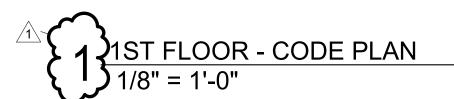



LSJZ, LLC DBA LEE'S SUMMIT JAZZERCISE 2909 SW MUIR DRIVE LEE'S SUMMIT, MO 64081 P: 816.679.4954

ARCHITECT


COLLINS | WEBB ARCHITECTURE 307B SW MARKET STREET LEE'S SUMMIT, MISSOURI 64063 P: 816.249.2270 www.collinsandwebb.com

CONTRACTOR

CAMM CONSTRUCTION, INC 344 NE CAPITAL DRIVE LEE'S SUMMIT, MO 64086 P: 816.918.5548 www.cammconstructioninc.com

MEP ENGINEER

JSC ENGINEERS 1925 CENTRAL ST. KANSAS CITY, MO 64108 P: 816.272.5289 www.jscengineers.com

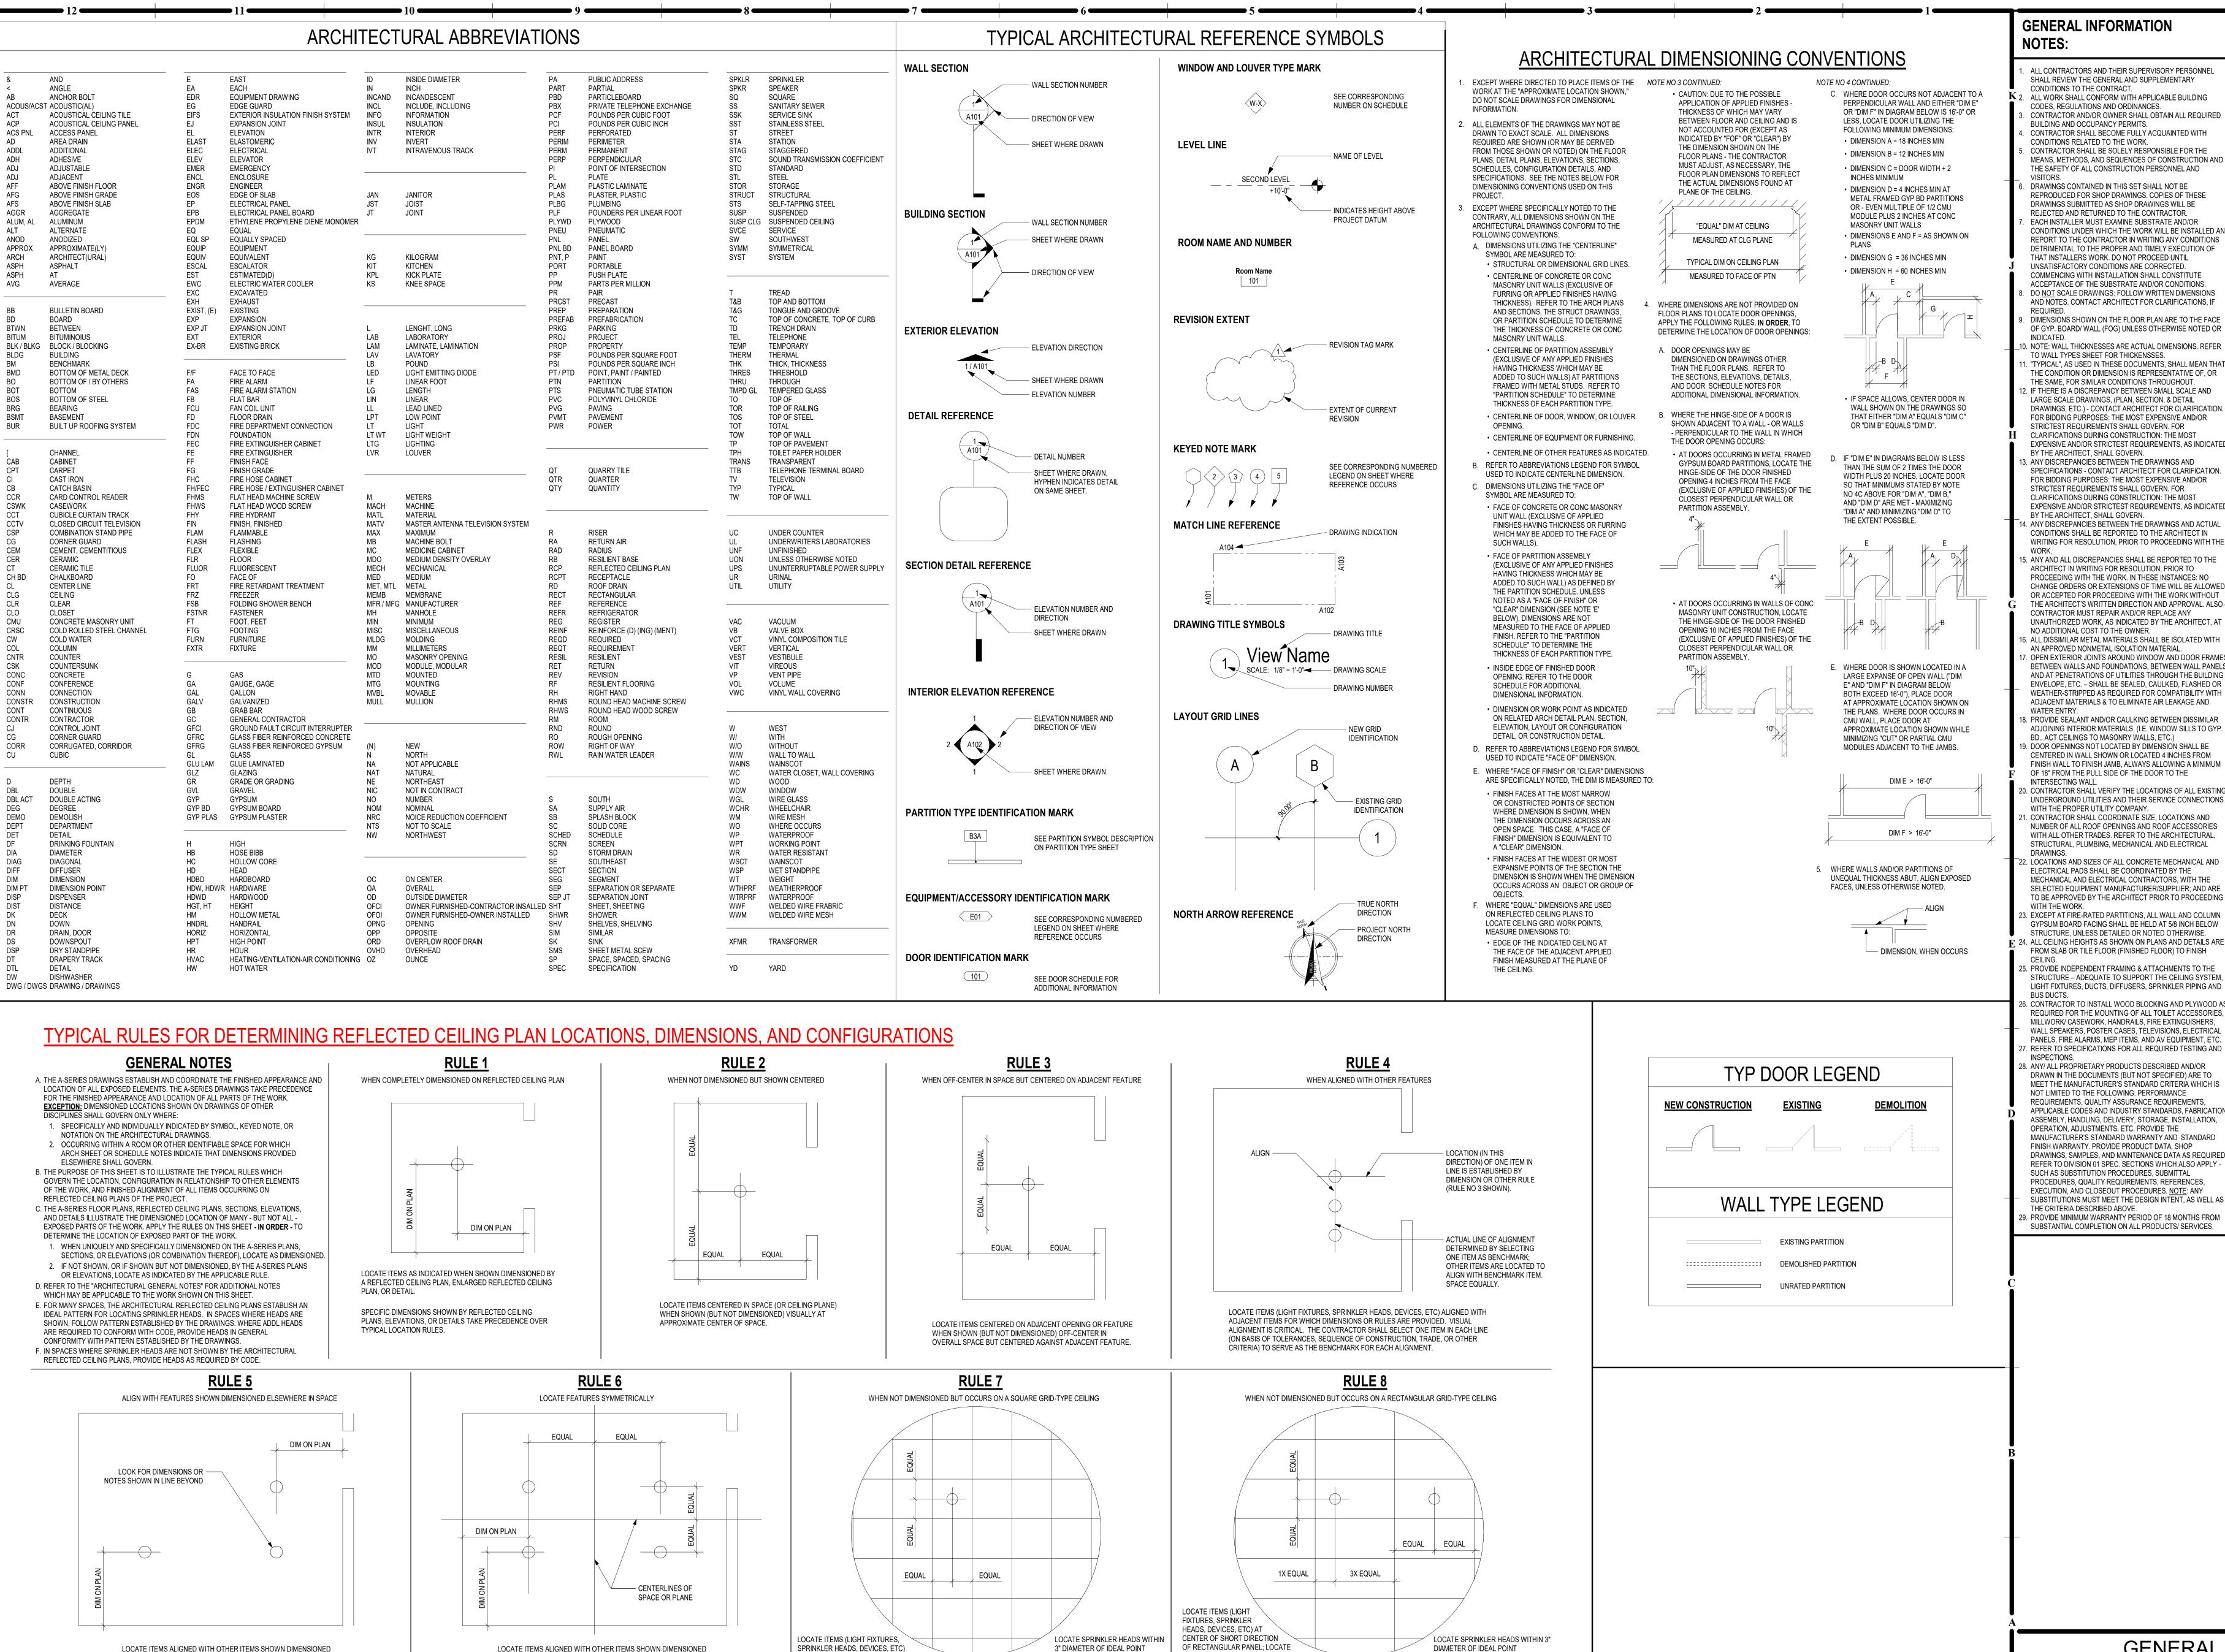

DIMENSIONED (OR SHOWN BY RULE) AT 1/4, 1/2, OR 3/4 POINT OF LONG

ON REFLECTED CEILING PLAN.

DIRECTION OF RECTANGULAR PANEL

DIMENSIONED (OR SHOWN BY RULE)

ON REFLECTED CEILING PLAN.

AT CENTER OF PANEL ON SQUARE

GRID-TYPE CEILINGS

ELSEWHERE IN SPACE (OR CEILING PLANE).

ALL CONTRACTORS AND THEIR SUPERVISORY PERSONNEL SHALL REVIEW THE GENERAL AND SUPPLEMENTARY ALL WORK SHALL CONFORM WITH APPLICABLE BUILDING CODES, REGULATIONS AND ORDINANCES. CONTRACTOR AND/OR OWNER SHALL OBTAIN ALL REQUIRED CONTRACTOR SHALL BECOME FULLY ACQUAINTED WITH CONTRACTOR SHALL BE SOLELY RESPONSIBLE FOR THE


SELECTED EQUIPMENT MANUFACTURER/SUPPLIER; AND ARE TO BE APPROVED BY THE ARCHITECT PRIOR TO PROCEEDING 3. EXCEPT AT FIRE-RATED PARTITIONS, ALL WALL AND COLUMN GYPSUM BOARD FACING SHALL BE HELD AT 5/8 INCH BELOW STRUCTURE, UNLESS DETAILED OR NOTED OTHERWISE. 24. ALL CEILING HEIGHTS AS SHOWN ON PLANS AND DETAILS ARE FROM SLAB OR TILE FLOOR (FINISHED FLOOR) TO FINISH 5. PROVIDE INDEPENDENT FRAMING & ATTACHMENTS TO THE STRUCTURE - ADEQUATE TO SUPPORT THE CEILING SYSTEM, LIGHT FIXTURES, DUCTS, DIFFUSERS, SPRINKLER PIPING AND

REQUIRED FOR THE MOUNTING OF ALL TOILET ACCESSORIES, MILLWORK/ CASEWORK, HANDRAILS, FIRE EXTINGUISHERS, WALL SPEAKERS, POSTER CASES, TELEVISIONS, ELECTRICAL PANELS, FIRE ALARMS, MEP ITEMS, AND AV EQUIPMENT, ETC REFER TO SPECIFICATIONS FOR ALL REQUIRED TESTING AND 28. ANY/ ALL PROPRIETARY PRODUCTS DESCRIBED AND/OR DRAWN IN THE DOCUMENTS (BUT NOT SPECIFIED) ARE TO MEET THE MANUFACTURER'S STANDARD CRITERIA WHICH IS NOT LIMITED TO THE FOLLOWING: PERFORMANCE REQUIREMENTS, QUALITY ASSURANCE REQUIREMENTS,

APPLICABLE CODES AND INDUSTRY STANDARDS, FABRICATION, ASSEMBLY, HANDLING, DELIVERY, STORAGE, INSTALLATION, OPERATION, ADJUSTMENTS, ETC. PROVIDE THE MANUFACTURER'S STANDARD WARRANTY AND STANDARD FINISH WARRANTY. PROVIDE PRODUCT DATA, SHOP DRAWINGS, SAMPLES, AND MAINTENANCE DATA AS REQUIRED REFER TO DIVISION 01 SPEC. SECTIONS WHICH ALSO APPLY -SUCH AS SUBSTITUTION PROCEDURES, SUBMITTAL PROCEDURES, QUALITY REQUIREMENTS, REFERENCES, EXECUTION. AND CLOSEOUT PROCEDURES. NOTE: ANY SUBSTITUTIONS MUST MEET THE DESIGN INTENT, AS WELL AS

 ω


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COLLINS WEBB #:

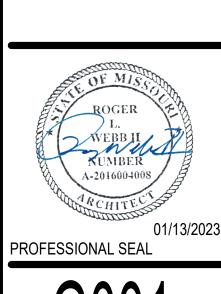GENERAL INFORMATION

ELSEWHERE IN SPACE (OR CEILING PLANE).



GENERAL NOTES: ACCESSIBILITY GUIDELINES

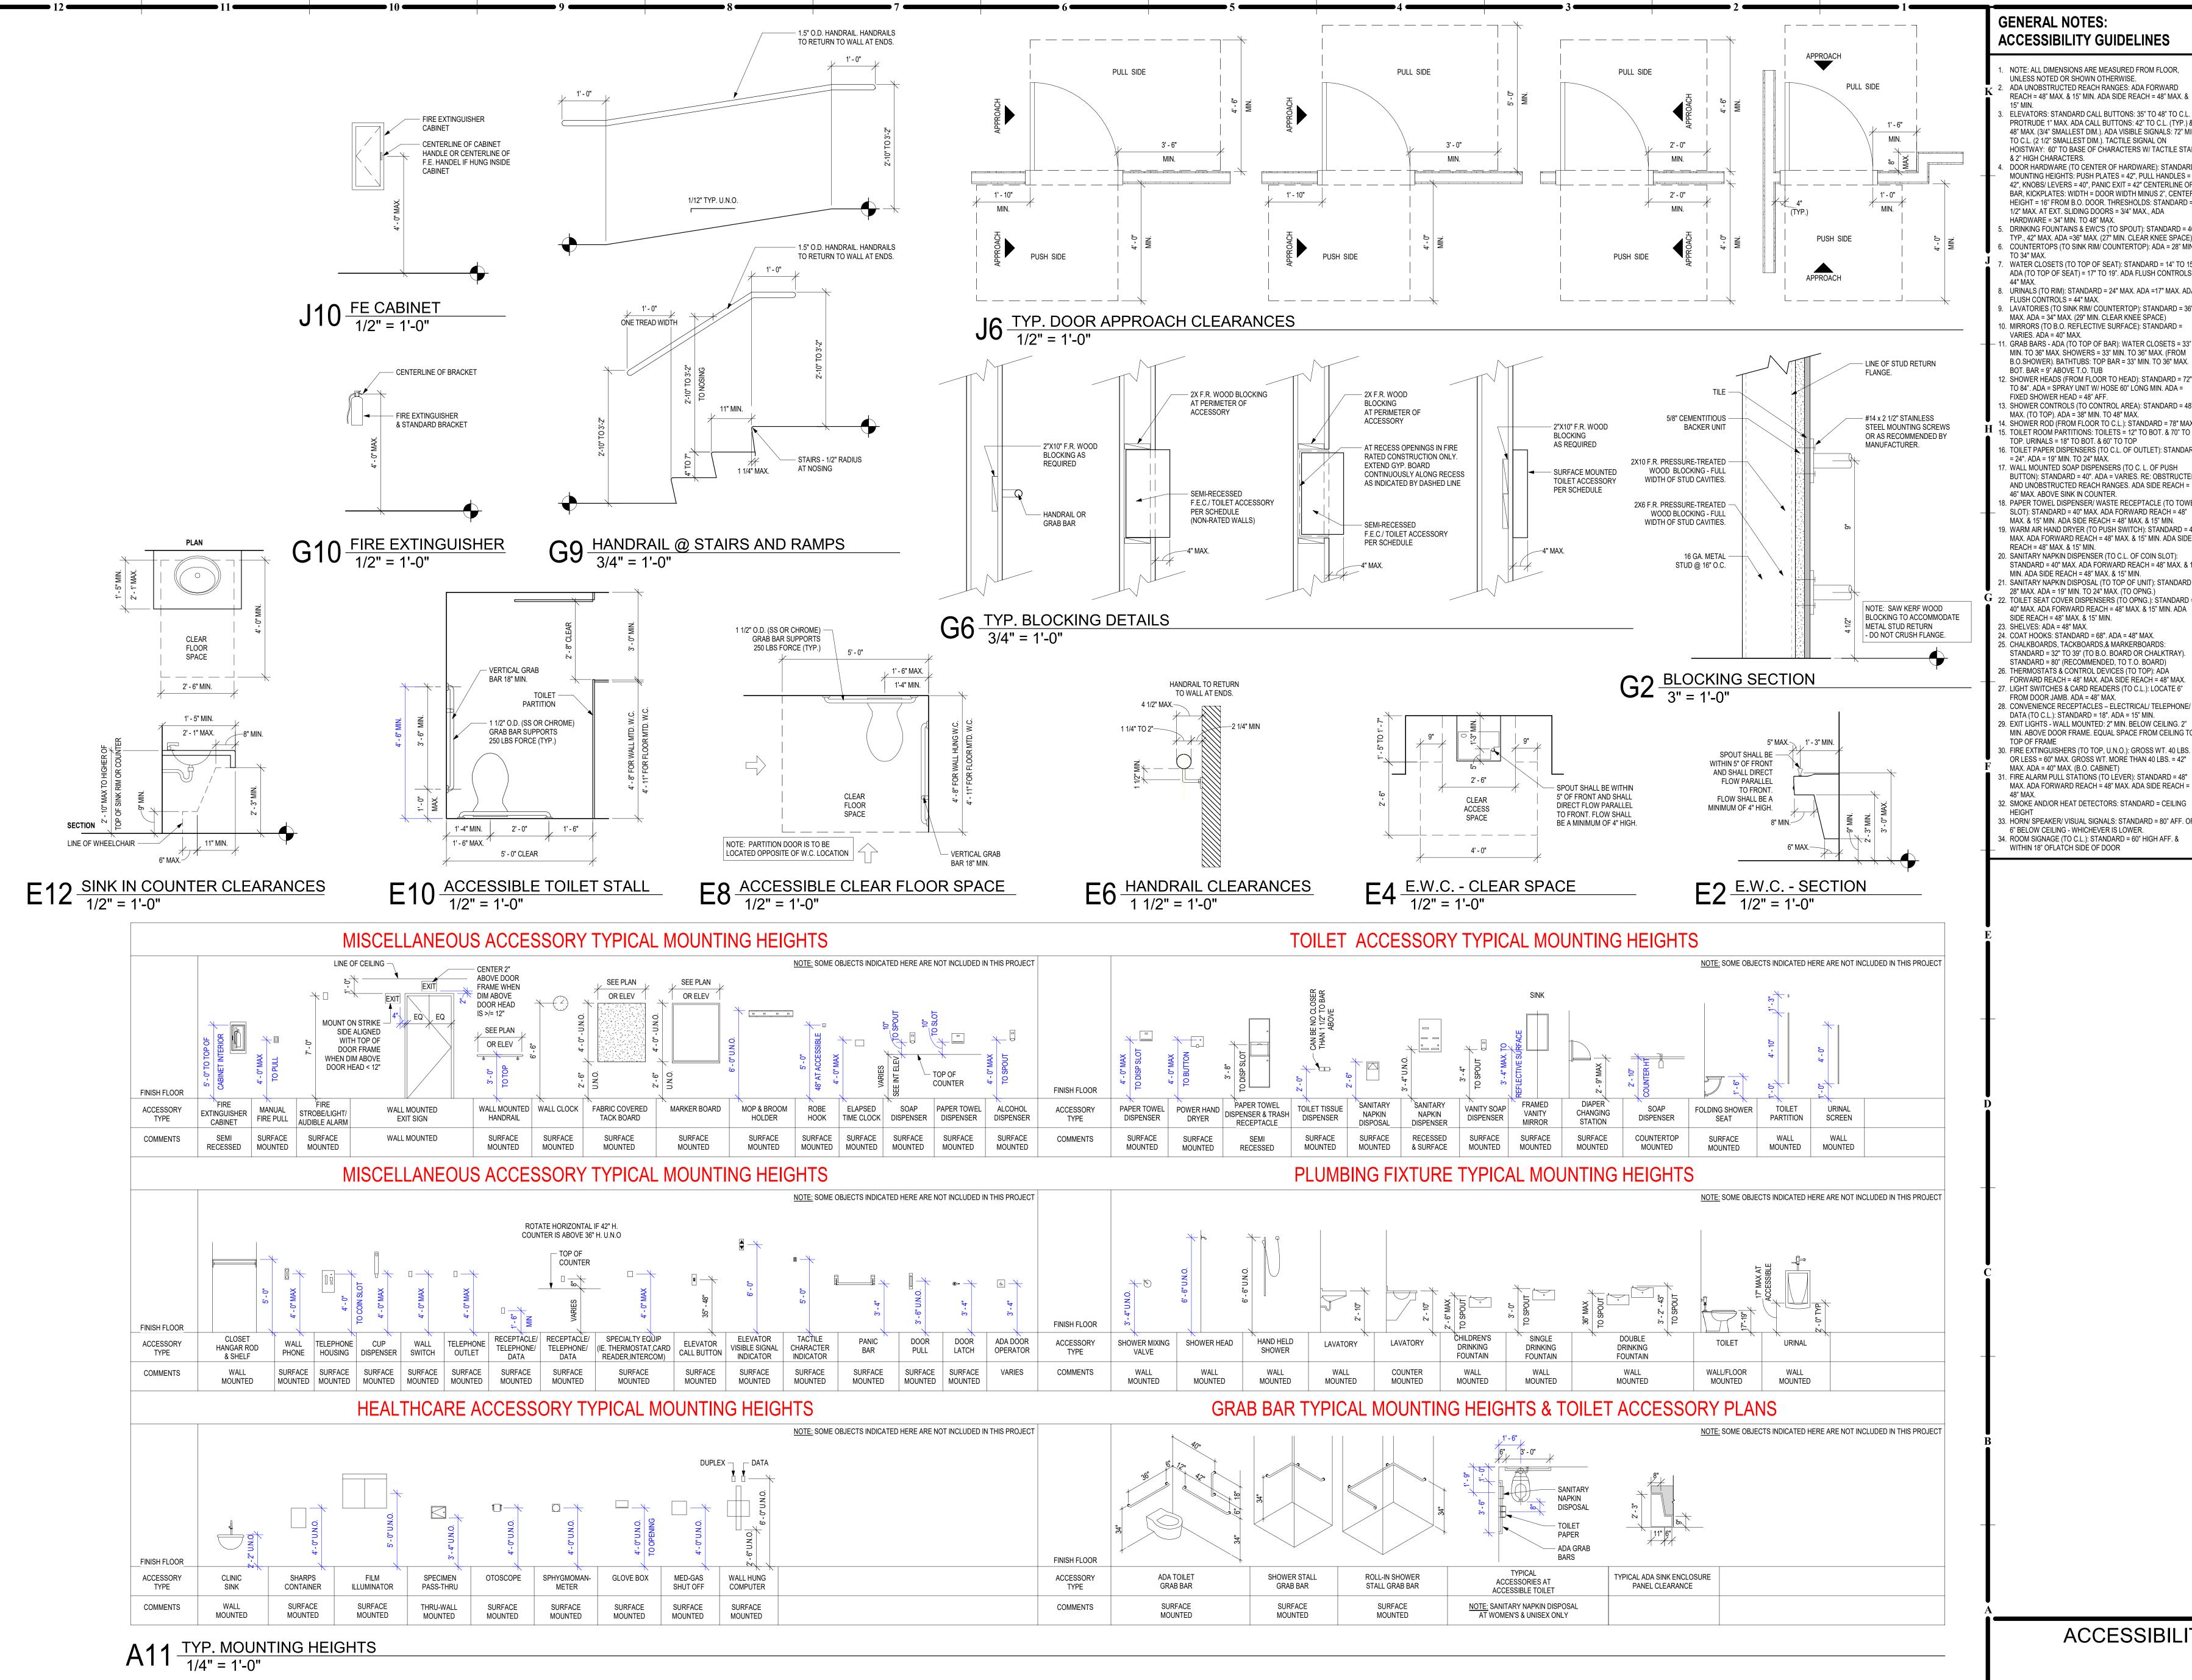. NOTE: ALL DIMENSIONS ARE MEASURED FROM FLOOR, UNLESS NOTED OR SHOWN OTHERWISE.

ADA UNOBSTRUCTED REACH RANGES: ADA FORWARD REACH = 48" MAX. & 15" MIN. ADA SIDE REACH = 48" MAX. &

. ELEVATORS: STANDARD CALL BUTTONS: 35" TO 48" TO C.L. 8 PROTRUDE 1" MAX. ADA CALL BUTTONS: 42" TO C.L. (TYP.) & 48" MAX. (3/4" SMALLEST DIM.). ADA VISIBLE SIGNALS: 72" MIN. TO C.L. (2 1/2" SMALLEST DIM.). TACTILE SIGNAL ON HOISTWAY: 60" TO BASE OF CHARACTERS W/ TACTILE STAR & 2" HIGH CHARACTERS. . DOOR HARDWARE (TO CENTER OF HARDWARE): STANDARD MOUNTING HEIGHTS: PUSH PLATES = 42", PULL HANDLES = 42", KNOBS/ LEVERS = 40", PANIC EXIT = 42" CENTERLINE OF BAR, KICKPLATES: WIDTH = DOOR WIDTH MINUS 2", CENTER, HEIGHT = 16" FROM B.O. DOOR. THRESHOLDS: STANDARD = 1/2" MAX. AT EXT. SLIDING DOORS = 3/4" MAX., ADA

HARDWARE = 34" MIN. TO 48" MAX. DRINKING FOUNTAINS & EWC'S (TO SPOUT): STANDARD = 40" TYP., 42" MAX. ADA =36" MAX. (27" MIN. CLEAR KNEE SPACE) . COUNTERTOPS (TO SINK RIM/ COUNTERTOP): ADA = 28" MIN.

WATER CLOSETS (TO TOP OF SEAT): STANDARD = 14" TO 15" ADA (TO TOP OF SEAT) = 17" TO 19". ADA FLUSH CONTROLS = URINALS (TO RIM): STANDARD = 24" MAX. ADA =17" MAX. ADA FLUSH CONTROLS = 44" MAX. . LAVATORIES (TO SINK RIM/ COUNTERTOP): STANDARD = 36"

MAX. ADA = 34" MAX. (29" MIN. CLEAR KNEÉ SPACE) 0. MIRRORS (TO B.O. REFLECTIVE SURFACE): STANDARD = VARIES. ADA = 40" MAX. . GRAB BARS - ADA (TO TOP OF BAR): WATER CLOSETS = 33" MIN. TO 36" MAX. SHOWERS = 33" MIN. TO 36" MAX. (FROM B.O.SHOWER). BATHTUBS: TOP BAR = 33" MIN. TO 36" MAX. BOT. BAR = 9" ABOVE T.O. TUB

12. SHOWER HEADS (FROM FLOOR TO HEAD): STANDARD = 72" TO 84". ADA = SPRAY UNIT W/ HOSE 60" LONG MIN. ADA = FIXED SHOWER HEAD = 48" AFF.

13. SHOWER CONTROLS (TO CONTROL AREA): STANDARD = 48" MAX. (TO TOP). ADA = 38" MIN. TO 48" MAX. 14. SHOWER ROD (FROM FLOOR TO C.L.): STANDARD = 78" MAX.

15. TOILET ROOM PARTITIONS: TOILETS = 12" TO BOT. & 70" TO TOP. URINALS = 18" TO BOT. & 60" TO TOP TOILET PAPER DISPENSERS (TO C.L. OF OUTLET): STANDARD = 24". ADA = 19" MIN. TO 24" MAX. 17. WALL MOUNTED SOAP DISPENSERS (TO C. L. OF PUSH BUTTON): STANDARD = 40". ADA = VARIES. RE: OBSTRUCTED

18. PAPER TOWEL DISPENSER/ WASTE RECEPTACLE (TO TOWE) SLOT): STANDARD = 40" MAX. ADA FORWARD REACH = 48" MAX. & 15" MIN. ADA SIDE REACH = 48" MAX. & 15" MIN. 19. WARM AIR HAND DRYER (TO PUSH SWITCH): STANDARD = 44"

MAX. ADA FORWARD REACH = 48" MAX. & 15" MIN. ADA SIDE REACH = 48" MAX. & 15" MIN. 20. SANITARY NAPKIN DISPENSER (TO C.L. OF COIN SLOT): STANDARD = 40" MAX. ADA FORWARD REACH = 48" MAX. & 15" MIN. ADA SIDE REACH = 48" MAX. & 15" MIN.

1. SANITARY NAPKIN DISPOSAL (TO TOP OF UNIT): STANDARD = 28" MAX. ADA = 19" MIN. TO 24" MAX. (TO OPNG.) 22. TOILET SEAT COVER DISPENSERS (TO OPNG.): STANDARD = 40" MAX. ADA FORWARD REACH = 48" MAX. & 15" MIN. ADA SIDE REACH = 48" MAX. & 15" MIN.

25. CHALKBOARDS, TACKBOARDS, & MARKERBOARDS: STANDARD = 32" TO 39" (TO B.O. BOARD OR CHALKTRAY). STANDARD = 80" (RECOMMENDED, TO T.O. BOARD) 26. THERMOSTATS & CONTROL DEVICES (TO TOP): ADA FORWARD REACH = 48" MAX. ADA SIDE REACH = 48" MAX. 27. LIGHT SWITCHES & CARD READERS (TO C.L.): LOCATE 6" FROM DOOR JAMB. ADA = 48" MAX.

9. EXIT LÌGHTS - WALL MOUNTED: 2" MIN. BELOW CEILING. 2' MIN. ABOVE DOOR FRAME. EQUAL SPACE FROM CEILING TO

OR LESS = 60" MAX. GROSS WT. MORÉ THAN 40 LBS. = 42" MAX. ADA = 40" MAX. (B.O. CABINET)

MAX. ADA FORWARD REACH = 48" MAX. ADA SIDE REACH =

33. HORN/ SPEAKER/ VISUAL SIGNALS: STANDARD = 80" AFF. OR 6" BELOW CEILING - WHICHEVER IS LOWER.
34. ROOM SIGNAGE (TO C.L.): STANDARD = 60" HIGH AFF. & WITHIN 18" OFLATCH SIDE OF DOOR


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REVISION DATES:



ACCESSIBILITY GUIDELINES



MECHANICAL SPECIFICATIONS

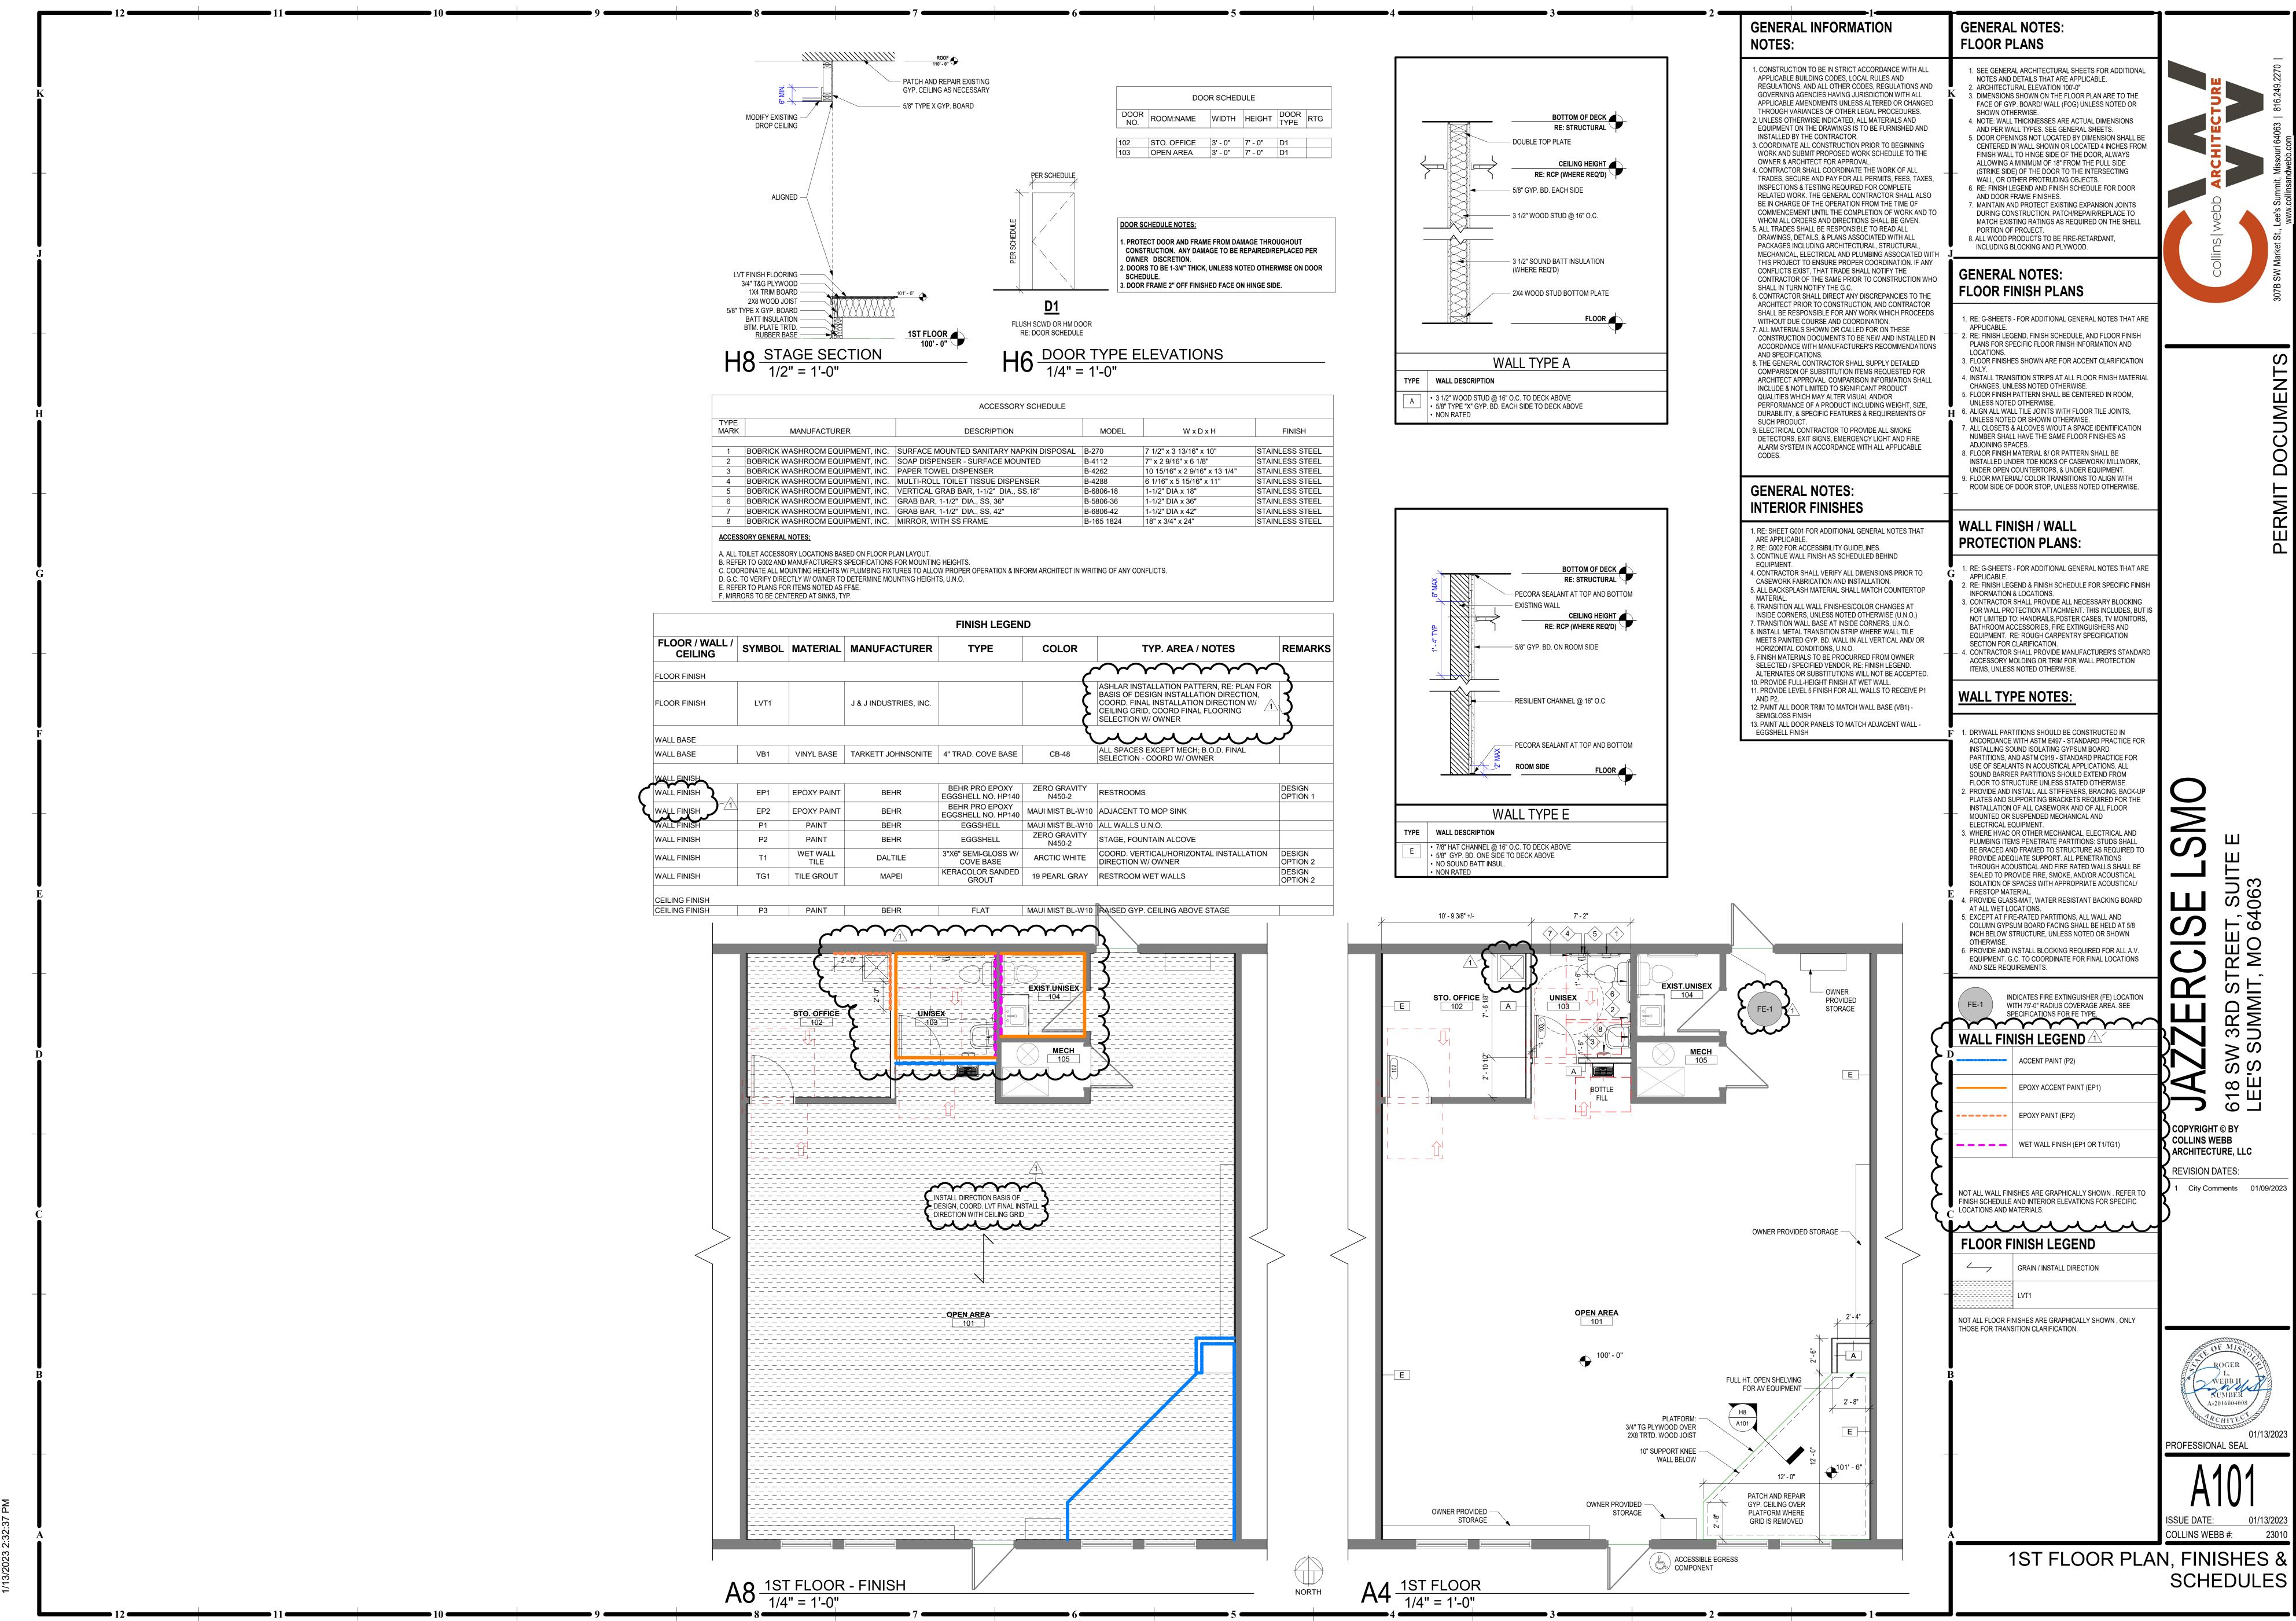- A. PROVIDE ALL LABOR. MATERIALS. AND EQUIPMENT NECESSARY FOR THE COMPLETE INSTALLATION OF THE MECHANICAL SYSTEMS OUTLINED.
- B. OBTAIN ALL PERMITS, FEES, LICENSES, INSPECTIONS, AND CERTIFICATIONS OF COMPLIANCE OR APPROVAL AS REQUIRED BY AUTHORITIES.
- C. ALL WORK SHALL BE PERFORMED IN ACCORDANCE WITH ALL APPLICABLE LAWS, CODES AND REGULATIONS OF THE GOVERNMENTAL BODIES HAVING JURISDICTION OVER THE SITE. D. ALL TESTING REQUIRED BY AUTHORITIES SHALL BE CONSIDERED PART OF THIS WORK.
- E. DURING CONSTRUCTION, ALL FIXTURES, EQUIPMENT, PIPE, DUCT, ETC. SHALL BE COVERED, PLUGGED, OR CAPPED AS REQUIRED TO KEEP CLEAN AND UNDAMAGED. ALL DAMAGED ITEMS SHALL BE RESTORED TO ORIGINAL CONDITION OR REPLACED. ALL PROTECTIVE COVERING SHALL BE REMOVED BEFORE FINAL ACCEPTANCE.
- F. PROVIDE ALL NECESSARY CUTTING AND PATCHING OF WALLS, FLOORS, CEILINGS, AND ROOFS AS NECESSARY. PATCH AROUND ALL OPENINGS SHALL MATCH ADJACENT AREA. COORDINATE ALL ROOFING WORK WITH OWNER OR RESPONSIBLE PARTY, SO THAT THE EXISTING ROOFING WARRANTY WILL BE MAINTAINED.
- G. CONTRACTOR SHALL GUARANTEE ALL WORK AND MATERIALS AGAINST DEFECT FOR A PERIOD OF ONE YEAR FROM FINAL ACCEPTANCE.
- H. INSPECTION OF THE SITE: THIS CONTRACTOR SHALL THOROUGHLY ACQUAINT HIMSELF WITH THE MEP DRAWINGS, SPECIFICATIONS, DETAIL, AND THE SITE. THIS CONTRACTOR SHALL NOTIFY THE ARCHITECT OF ANY SPECIAL OR UNUSUAL PROBLEMS, CONFLICTS, OR OBSTRUCTIONS THAT AFFECT HIS BID.
- I. FOR THE PURPOSE OF CLEARNESS AND LEGIBILITY, THE MECHANICAL AND PLUMBING DRAWINGS ARE ESSENTIALLY DIAGRAMMATIC AND DO NOT SHOW ALL OFFSETS AND FITTINGS REQUIRED FOR INSTALLATION. DO NOT SCALE DRAWINGS. THE SIZE AND LOCATION OF EQUIPMENT IS SHOWN TO SCALE WHEREVER POSSIBLE. THE CONTRACTOR SHALL VERIFY ALL CONDITIONS AND DATA AS INDICATED ON THE DRAWINGS AND IN THE SPECIFICATION SECTIONS WHERE MECHANICAL WORK INTERFACES WITH
- OTHER TRADES. J. IN THE EVENT OF A CONFLICT OR INCONSISTENCY BETWEEN ITEMS INDICATED ON THE PLANS OR WITH CODE REQUIREMENTS, THE NOTE OR CODE WHICH PRESCRIBES AND ESTABLISHES THE MORE COMPLETE JOB OR HIGHER STANDARD SHALL PREVAIL
- K. INSTALL MATERIALS AND SYSTEMS IN ACCORDANCE WITH MANUFACTURER'S INSTRUCTIONS AND APPROVED SUBMITTALS. INSTALL MATERIALS IN PROPER RELATION WITH ADJACENT CONSTRUCTION AND WITH UNIFORM APPEARANCE FOR EXPOSED WORK, COORDINATE WITH WORK OF OTHER SECTIONS, COMPLY WITH APPLICABLE REGULATIONS AND CODE REQUIREMENTS. PROVIDE PROPER CLEARANCES FOR

A. PROVIDE THERMAL OVERLOAD PROTECTION FOR EACH MOTOR PROVIDED BY THIS WORK.

- A. ALL DUCTWORK UNLESS OTHERWISE INDICATED SHALL BE FABRICATED FROM GALVANIZED SHEET STEEL COMPLYING WITH ASTM A 527, LOCKFORMING QUALITY, WITH G60 ZINC COATING IN ACCORDANCE WITH ASTM A 525, AND MILL PHOSPHATIZED FOR EXPOSED LOCATIONS.
- B. DUCTWORK METAL GAUGES, REINFORCING, ETC SHALL BE CONSTRUCTED IN ACCORDANCE WITH SMACNA "HVAC DUCT CONSTRUCTION STANDARDS," LATEST EDITION FOR A 2" WATER GAUGE STATIC PRESSURE. C. ALL FITTINGS SHALL BE CONSTRUCTED IN ACCORDANCE WITH SMACNA "HVAC DUCT CONSTRUCTION STANDARDS," LATEST EDITION.

-. FLEXIBLE DUCT:

A. ATCO #086 (R-6), OR EQUAL.

B. FACTORY APPLIED INSULATION AND VAPOR BARRIER, 1-1/2" THICK.


5. REMODELING WORK:

- A. THIS PROJECT INVOLVES CONSTRUCTION INSIDE AN EXISTING STRUCTURE. CONTRACTORS, BY SUBMITTING A BID ARE DEEMED TO BE COMPLETELY FAMILIAR WITH THE EXISTING CONDITIONS OF THE BUILDING AS IT INFLUENCES THE WORK DESCRIBED. NO CLAIMS FOR EXTRA COMPENSATION WILL BE CONSIDERED FOR EXISTING CONDITIONS VISIBLE OR REASONABLY INFERABLE FROM A CAREFUL EXAMINATION OF THE EXISTING BUILDING CONDITIONS.
- B. CONTRACTOR SHALL INSPECT THE EXISTING FIELD CONDITIONS AT THE SITE AND THE CONTRACT DOCUMENTS PRIOR TO THE START OF ANY WORK TO DETERMINE WHAT EFFECT THE EXISTING CONDITIONS WILL HAVE ON THE WORK POTENTIAL. CONTRACTOR SHALL REPORT DISCREPANCIES TO THE ARCHITECT AND INCLUDE IN THE BID ALL COSTS REQUIRED TO MAKE THE WORK MEET EXISTING CONDITIONS.
- C. PROTECT ADJACENT MATERIALS INDICATED TO REMAIN. INSTALL AND MAINTAIN DUST AND NOISE BARRIERS TO KEEP DIRT, DUST, AND NOISE FROM BEING TRANSMITTED TO ADJACENT AREAS. REMOVE PROTECTION AND BARRIERS AFTER REMODELING OPERATIONS ARE COMPLETE.

MECHANICAL SYMBOLS

HVAC EQUIPMENT & DUCTWORK

THIS IS A MASTER LEGEND AND NOT ALL SYMBOLS, ETC, ARE NECESSARILY USED ON THE DRAWINGS.

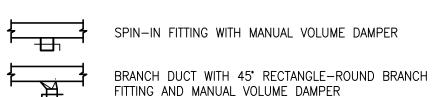


(FD) FIRE DAMPER (FSD) FIRE SMOKE DAMPER

HS HUMIDITY SENSOR (SD) SMOKE DAMPER SP STATIC PRESSURE SENSOR (MD) MOTORIZED DAMPER TS TEMPERATURE SENSOR

(BD) BACKDRAFT DAMPER (VD) VOLUME DAMPER

(H) HUMIDISTAT (T) THERMOSTAT

CO2 CARBON DIOXIDE SENSOR

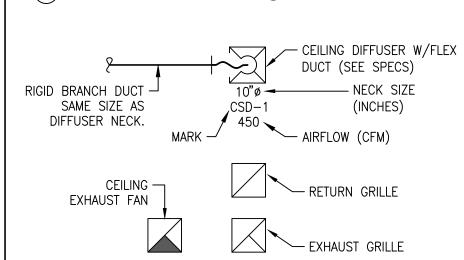


ABBREVIATIONS

AFF	ABOVE FINISHED FLOOR	МС	MECHANICAL CONTRACTOR
BAS	BUIDLING AUTOMATION SYSTEM	MIN	MINIMUM
BD	BACKDRAFT	NC	NOISE CRITERIA
CFM	CUBIC FEET PER MINUTE	OA	OUTSIDE AIR
DDC	DIRECT DIGITAL CONTROL	RA	RETURN AIR
DX	DIRECT EXPANSION	SA	SUPPLY AIR
EA	EXHAUST AIR	SD	SMOKE DUCT DETECTOR
FFA	FROM FLOOR ABOVE	TFA	TO FLOOR ABOVE
FFB	FROM FLOOR BELOW	TFB	TO FLOOR BELOW
GPM	GALLONS PER MINUTE	TYP	TYPICAL
IN WC	INCHES OF WATER COLUMN	UNO	UNLESS NOTED OTHERWISE
MAX	MAXIMUM	W/	WITH
MBH	1000 BTU PER HOUR	l w′∕∩	WITHOUT

STANDARD MOUNTING HEIGHTS


(AFF, UNLESS NOTES OTHERWISE)
THERMOSTATS (USER ADJUSTABLE) (TOP OF DEVICE) CONTROLS (TOP OF DEVICE)
CONTROLS (TOP OF DEVICE)

ANNOTATION

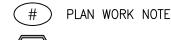

MECHANICAL EQUIPMENT DESIGNATION (CONTRACTOR FURNISHED AND INSTALLED UNLESS NOTED OTHERWISE)

CONNECTION POINT OF NEW WORK TO EXISTING

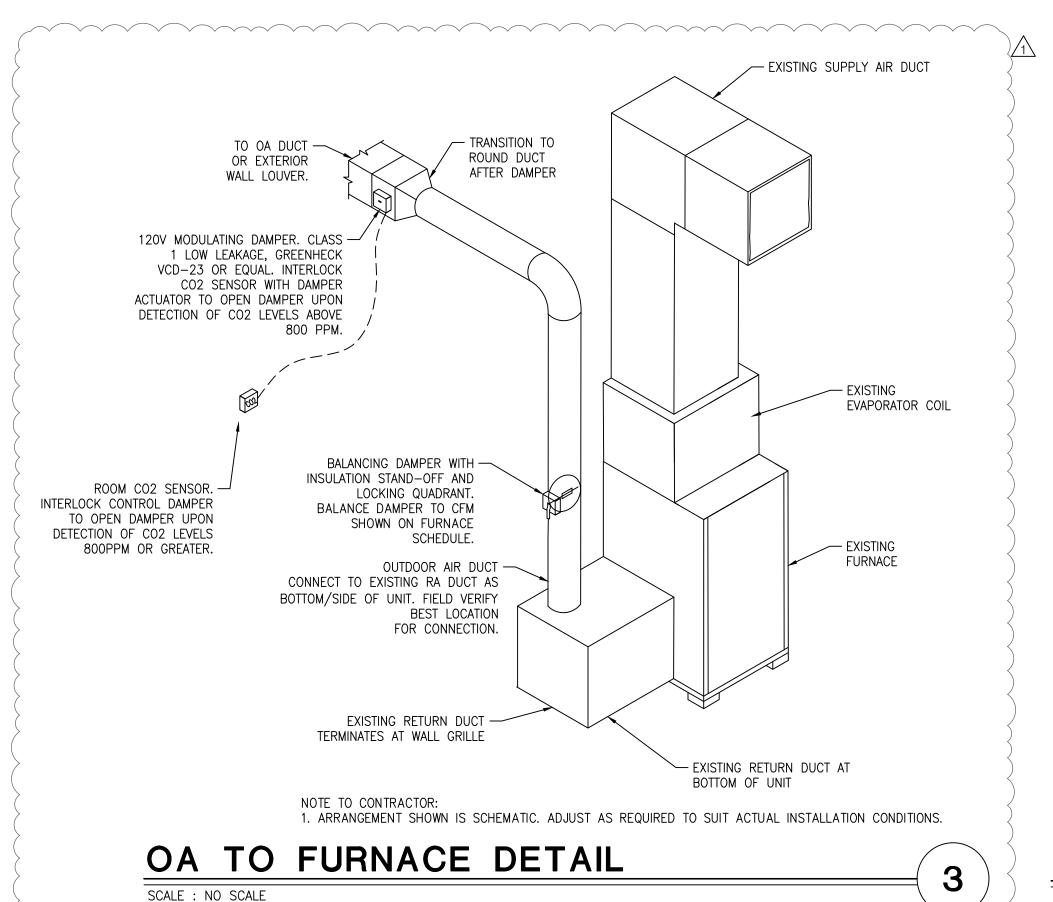

EXHAUST FAN SCHEDULE ELECTRICAL MARK AREA SERVED MANUFACTURER MODEL MOUNTING / TYPE | CFM | ESP (IN) | DRIVE | POWER | VOLTS | PHASE | WEIGHT NOTES

PANASONIC | FV-0511VQ1 | CEILING / CABIENT | 110 | 0.1 | DIRECT | 10.6w |

- PROVIDE INTERNAL CABINET BACKDRAFT DAMPER, CEILING GRILLE, ALL THREAD RODS AND VIBRATION ISOLATORS.
- INTERLOCK FAN OPERATION WITH LIGHT SWITCH
- PROVIDE WITH SPEED CONTROL.

NEW RESTROOM 103

EF-1

NOTES:


		OU	TDOOR A	IR CALCULATIO	NS	
UNIT	AREA (SQ-FT)	OCCUPANCY CLASSIFICATION	SPECIFIED OCCUPANCY	OUTDOOR AIRFLOW RATE PER PERSON (Rp), CFM/PERSON	AREA OUTDOOR AIRFLOW RATE IN BREATHING ZONE (Ra), CFM/SQ-FT	REQUIRED AIR FLO
EXISTING UNIT	108	OFFICE	2	5	0.06	16.5
	1235	EXERCISE	23	20	0.06	534.1
					TOTAL	550.6

120 1

A,B,C

#KEYED PLAN NOTES

- 1. EXISTING HVAC SYSTEM TO REMAIN. RELOCATE DIFFUSERS AS REQUIRED TO ACCOMMODATE MODIFICATIONS TO EXISTING CEILING GRID.
- 2. PROVIDE NEW 12x10 RETURN AIR TRANSFER GRILLE ON EACH SIDE OF WALL WITH OPENING THROUGH WALL. TITUS MODEL 3L OR EQUAL
- 3. EXISTING RESTROOM TO REMAIN. VERIFY RESTROOM HAS EXISTING OPERATIONAL EXHAUST FAN TERMINATING TO THE EXTERIOR OF BUILDING.
- 4. PROVIDE CEILING EXHAUST FAN WITH 4"Ø DUCT TO ROOF CAP. CAP SHALL HAVE BIRDSCREEN. LOCATE DISCHARGE A MINIMUM OF 10'-0" FROM ANY OUTSIDE AIR INTAKE.
- EXISTING SUPPLY FOR ROOM TO REMAIN. RELOCATE AS REQUIRED TO BE WITHIN OFFICE.
- 6. NOTE FOR PLANCHECK PURPOSES. EXISTING AIR RETURN GRILLE LOW ON WALL. GRILLE TO REMAIN. RETURN AIR SYSTEM IS NOT PLENUM
- 7. ROUTE FRESH AIR DUCT DOWN TO SIDE OF RETURN DUCT. AT CONNECTION TO RETURN DUCT PROVIDE MANUAL DAMPER BALANCED TO 575 CFM. PROVIDE CO2 SENSOR IN ROOM INTERLOCKED WITH 120V MOTORIZED DAMPER AT WALL LOUVER TO OPEN UPON DETECTION OF CO2. SEE DETAIL 3 ON THIS SHEET.
- 8. PROVIDE 18"X18" DRAINABLE LOUVER WITH BIRDSCREEN, RUSKIN ELF6375DX OR EQUAL. COORDINATE THICKNESS WITH WALL AND COLOR WITH ARCHITECT. PRIOR TO FRESH AIR DUCT CONNECTION PROVIDE CLASS-1 LOW LEAKAGE MOTORIZED DAMPER, GREENHECK VCD-33, WITH 115V ACTUATOR. LOCATE LOUVER A MINIMUM OF 10'-0" FROM ANY EXHAUST DISCHARGE.
- 9. PROVIDE WALL MOUNT CO2 SENSOR, HONEYWELL C7232 OR EQUAL. INTERLOCK WITH ACTUATOR AT WALL LOUVER TO OPEN UPON DETECTION OF CO2 LEVELS 800PPM OR GREATER.

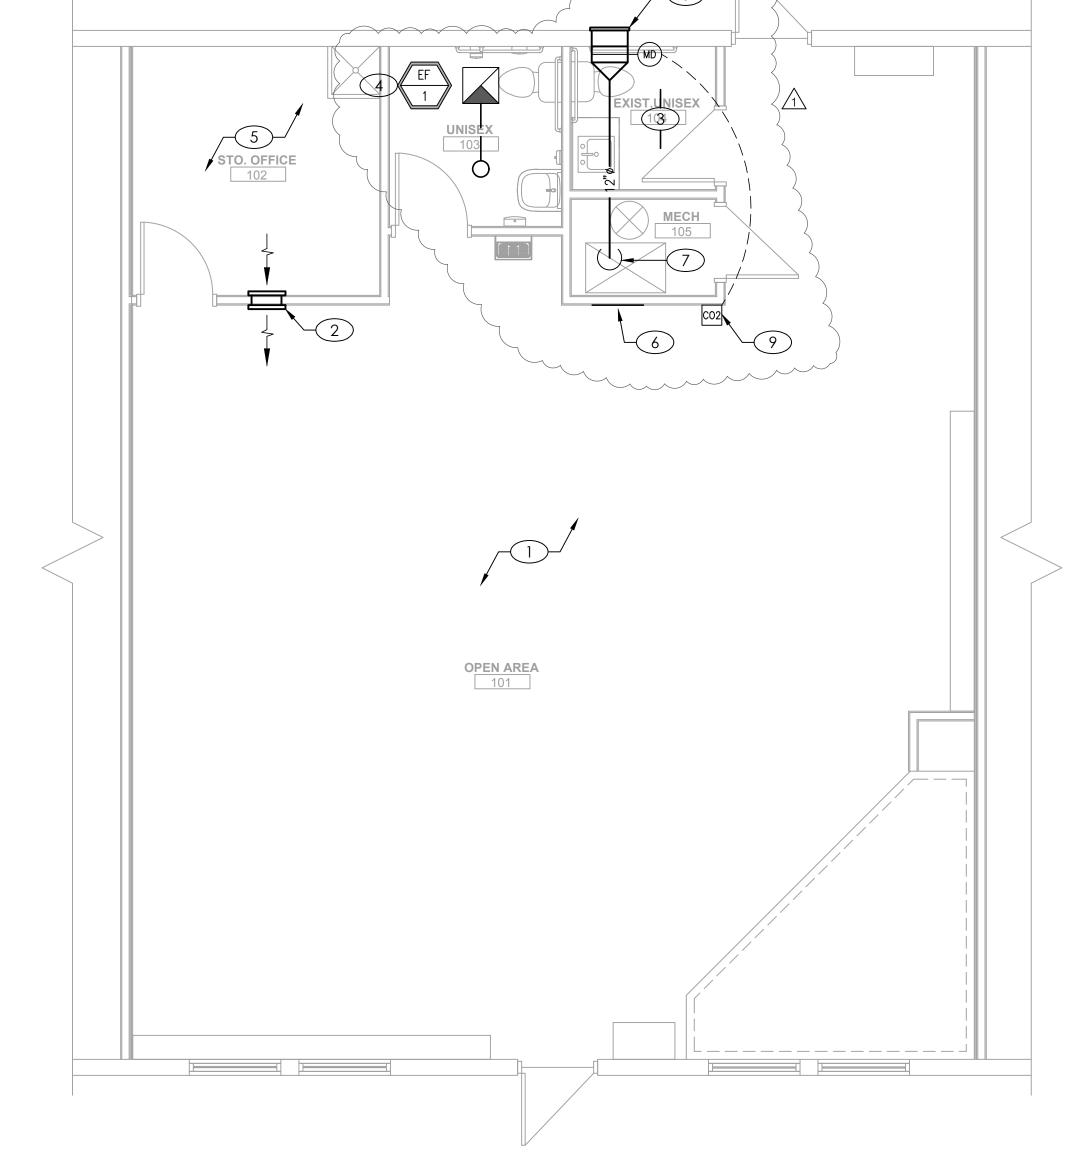

CEILING MOUNTED EXHAUST FAN SCALE: NO SCALE

- ALL-THREAD ROD

BACKDRAFT

FLEX CONNECTOR

— CEILING

DAMPER

EXHAUST GRILLE

PROVIDED WITH

EXHAUST FAN

- EXHAUST DUCT

RE: MECHANICAL

TO STRUCTURE

ELECTRICAL -

WIRING BY

ELECTRICAL

CONTRACTOR

FAN HOUSING -

ADJUSTABLE

MOUNTING BRACKETS


ISOLATOR BUSHING —

WITH FLANGED NUT

MECHANICAL PLAN

SCALE : 1/4" = 1'-0"


MEP ENGINEER

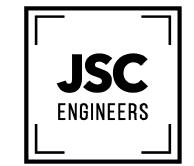

MO COA NO. 2012006786 / KS COA NO. E-2818 1925 CENTRAL STREET, SUITE 201 KANSAS CITY, MO 64108 phone: (816) 272-5289 email: jsmothers@jscengineers.com

REVISION DATES:

↑ 01.13.23 PLANCHECK

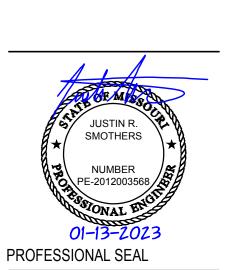

I<u>SSUE DATE:</u> 01.13.23 JSC PROJECT #: 22-339

MECHANICAL PLANS. SPECS & SCHEDULES

PLUMBING SPECIFICATIONS

- A. PROVIDE ALL LABOR, MATERIALS, AND EQUIPMENT NECESSARY FOR THE COMPLETE INSTALLATION OF
- THE PLUMBING SYSTEMS OUTLINED.
- B. OBTAIN ALL PERMITS, FEES, LICENSES, INSPECTIONS, AND CERTIFICATIONS OF COMPLIANCE OR APPROVAL AS REQUIRED BY AUTHORITIES.
- C. ALL TESTING REQUIRED BY AUTHORITIES SHALL BE CONSIDERED PART OF THIS WORK. D. PROVIDE ALL NECESSARY CUTTING AND PATCHING OF WALLS, FLOORS, CEILINGS, AND ROOFS AS NECESSARY. PATCH AROUND ALL OPENINGS SHALL MATCH ADJACENT AREA. COORDINATE ALL ROOFING WORK WITH OWNER OR RESPONSIBLE PARTY, SO THAT THE EXISTING ROOFING WARRANTY WILL BE
- E. CONTRACTOR SHALL GUARANTEE ALL WORK AND MATERIALS AGAINST DEFECT FOR A PERIOD OF ONE YEAR FROM FINAL ACCEPTANCE.
- F. INSPECTION OF THE SITE: THIS CONTRACTOR SHALL THOROUGHLY ACQUAINT HIMSELF WITH THE MEP DRAWINGS, SPECIFICATIONS, DETAIL, AND THE SITE. THIS CONTRACTOR SHALL NOTIFY THE ARCHITECT OF
- ANY SPECIAL OR UNUSUAL PROBLEMS, CONFLICTS, OR OBSTRUCTIONS THAT AFFECT HIS BID. G. FOR THE PURPOSE OF CLEARNESS AND LEGIBILITY, THE PLUMBING DRAWINGS ARE ESSENTIALLY DIAGRAMMATIC AND DO NOT SHOW ALL OFFSETS AND FITTINGS REQUIRED FOR INSTALLATION. DO NOT SCALE DRAWINGS. THE SIZE AND LOCATION OF EQUIPMENT IS SHOWN TO SCALE WHEREVER POSSIBLE. THE CONTRACTOR SHALL VERIFY ALL CONDITIONS AND DATA AS INDICATED ON THE DRAWINGS AND IN THE SPECIFICATION SECTIONS WHERE MECHANICAL WORK INTERFACES WITH OTHER TRADES.
- A. PROVIDE AN APPROVED WATER HAMMER ARRESTOR FOR EACH PLUMBING FIXTURE SUPPLY AS
- REQUIRED BY FIXTURE MANUFACTURER. B. ALL EXPOSED PIPE IN FINISHED AREAS SHALL BE CHROME PLATED BRASS PIPE, NO FERROUS PIPE.
- C. PROVIDE ACCESS PANELS FOR ALL CONCEALED VALVES AND TRAPS. D. ALL SEWER PIPING LOCATED INSIDE THE BUILDING SHALL BE INSTALLED WITH THE FOLLOWING SLOPES.
- 1. INSTALL 2-1/2" AND SMALLER PIPE AT 1/4" PER FOOT FALL. 2. INSTALL 3" AND LARGER PIPE AT 1/8" PER FOOT FALL.

3. PIPING

- A. DOMESTIC COLD AND HOT WATER (ABOVEGROUND). TYPE L HARD DRAWN COPPER TUBING, ASTM B-88 WITH WROUGHT BRONZE SOLDERED FITTINGS.
- BALL VALVE: CRANE #932 OR EQUAL. PEX. HIGH DENSITY CROSS-LINKED POLYETHYLENE TUBING IS PERMITTED FOR USE. TUBING SHALL BE MANUFACTURED TO THE REQUIREMENTS OF ASTM F876 AND MEET THE STANDARD GRADE HYDROSTATIC PRESSURE RATING FROM THE PLASTIC PIPE INSTITUTE IN ACCORDANCE WITH TR-4/03. PEX MECHANICAL, CRIMP/INSERT FITTINGS SHALL BE INSTALLED IN ACCORDANCE WITH MANUFACTURER'S INSTRUCTIONS. PIPE SIZE SHOW ON THE DRAWINGS ARE NOMINAL COPPER PIPE SIZES. INCREASE PEX PIPING SIZE AS REQUIRED TO EQUAL OR EXCEED COPPER PIPE SIZE INSIDE DIAMETER.
- B. SANITARY SEWER AND VENTS (UNDERGROUND, INTERIOR TO BUILDING). WASTE, DRAIN AND VENT PIPE AND FITTINGS, THROUGHOUT THE BUILDING BELOW THE BASE SLAB TO THE LOCATIONS NOTED OUTSIDE OF THE BUILDING SHALL BE ASTM D2665 POLYVINYL
- CHLORIDE (PVC) DWV PIPE, SCHEDULE 40, SOLVENT JOINT. 2. SEWER LINES SHALL BE LOCATED IN GENERAL AS SHOWN ON THE DRAWINGS. THE EXACT LOCATIONS SHALL BE DETERMINED BY THE CONTRACTOR IN SUCH A MANNER AS TO MAINTAIN PROPER CLEARANCES AND SUFFICIENT SLOPE TO ENSURE DRAINAGE.
- C. ALL PIPE HANGERS AND SUPPORTS SHALL BE STANDARD PRODUCTS OF GRINNELL, FEE AND MASON, OR ANVIL. HANGER SPACING SHALL BE IN ACCORDANCE WITH MSS-SP-69. D. PROVIDE CHROME PLATED ESCUTCHEONS ON ALL PIPE ENTERING FINISHED AREAS.

- A. ALL INSULATIONS AND ACCESSORIES SHALL HAVE A FIRE HAZARD CLASSIFICATION WITH A FLAME SPREAD RATING OF NOT OVER 25, A FUEL CONTRIBUTION RATING OF NOT OVER 50, AND A SMOKE DEVELOPMENT RATING OF NOT OVER 50, IN ACCORDANCE WITH NFPA. B. PIPE INSULATION (ABOVE GRADE):
- 1. THE PIPE INSULATION USED SHALL HAVE A THERMAL CONDUCTIVITY OF 0.27 BTU PER IN/HR*SQ-FT*°F OR LESS.
- FLEXIBLE CLOSED CELL ELASTOMERIC THERMAL INSULATION, UNSLIT OR PRESLIT WITH PRESSURE SENSITIVE ADHESIVE SYSTEM FOR CLOSURE AND VAPOR SEALING, EQUAL TO ARMSTRONG AP ARMAFLEX OR ARMAFLEX 2000. INSULATION SCHEDULE:
- a. DOMESTIC COLD WATER: b. DOMESTIC HOT WATER:

- 5. TESTING, BALANCING AND CLEANING: A. ALL PIPING SHALL BE TESTED FOR LEAKS BEFORE BEING CONCEALED IN WALL CONSTRUCTION OR
- B. SEWER AND VENT PIPING SHALL BE HYDROSTATICALLY TESTED WITH NO LESS THAN 10 FEET OF HEAD FOR A PERIOD OF NOT LESS THAN 15 MINUTES, PER THE LOCAL PLUMBING CODE, WITH NO LEAKS. C. DOMESTIC WATER PIPING SHALL BE HYDROSTATICALLY TESTED AT A PRESSURE OF NOT LESS THAN 1-1/2 TIMES THE OPERATING PRESSURE, BUT NOT LESS THAN 60 PSI, FOR A PERIOD OF NOT LESS THAN 2 HOURS, WITH NO LEAKS.

6. REMODELING WORK:

- A. THIS PROJECT INVOLVES CONSTRUCTION INSIDE AN EXISTING STRUCTURE. CONTRACTORS, BY SUBMITTING A BID ARE DEEMED TO BE COMPLETELY FAMILIAR WITH THE EXISTING CONDITIONS OF THE BUILDING AS IT INFLUENCES THE WORK DESCRIBED. NO CLAIMS FOR EXTRA COMPENSATION WILL BE CONSIDERED FOR EXISTING CONDITIONS VISIBLE OR REASONABLY INFERABLE FROM A CAREFUL EXAMINATION OF THE EXISTING BUILDING CONDITIONS.
- B. CONTRACTOR SHALL INSPECT THE EXISTING FIELD CONDITIONS AT THE SITE AND THE CONTRACT DOCUMENTS PRIOR TO THE START OF ANY WORK TO DETERMINE WHAT EFFECT THE EXISTING CONDITIONS WILL HAVE ON THE WORK POTENTIAL. CONTRACTOR SHALL REPORT DISCREPANCIES TO THE ARCHITECT AND INCLUDE IN THE BID ALL COSTS REQUIRED TO MAKE THE WORK MEET EXISTING
- C. REMOVE ALL PIPING TO BE DEMOLISHED BACK TO PIPE MAIN OR EDGE OF PROJECT AREA AND CAP
- D. PIPING EMBEDDED IN FLOORS, WALLS, AND CEILINGS MAY REMAIN IF SUCH MATERIALS DO NOT INTERFERE WITH NEW INSTALLATIONS. PIPING TO REMAIN SHALL BE APPROVED BY THE ARCHITECT. REMOVE MATERIALS ABOVE ACCESSIBLE CEILINGS. DRAIN AND CAP PIPING ALLOWED TO REMAIN ABOVE CEILING OR BELOW FLOOR, CONCEALED FROM VIEW, EXCEPT AS OTHERWISE NOTED. PATCH FLOOR TO
- E. PIPE SHALL BE CONCEALED WITH NEW OR EXISTING CONSTRUCTION WHENEVER POSSIBLE, UNLESS INDICATED OTHERWISE.
- F. DEMOLITION: DISCONNECT, DEMOLISH, AND REMOVE ABANDONED MECHANICAL AND PLUMBING MATERIALS AND EQUIPMENT INDICATED TO BE REMOVED AND NOT INDICATED TO BE SALVAGED OR REMAIN. ALL WORK SHOWN DASHED IS TO BE DEMOLISHED. WORK SHOWN LIGHT IS EXISTING TO REMAIN. REFER TO ARCHITECTURAL PLANS FOR FURTHER EXTENT OF DEMOLITION REQUIRED.

PLUMBING SYMBOLS

DESCRIPTION
SANITARY SEWER (ABOVE GRADE)
SANITARY SEWER (BELOW GRADE)
GREASE WASTE (BELOW GRADE)
CONDENSATE DRAIN
VENT PIPING
COLD WATER PIPING
HOT WATER PIPING
RECIRCULATING HOT WATER
COMPRESSED AIR
PIPE ELBOW DOWN
PIPE ELBOW UP
GATE VALVE
FLOOR CLEANOUT (FCO)
CLEANOUT AT GRADE (GCO)

ANNOTATION

#	PLAN WO	ORK NOTE
RTU		CAL EQUIP


IANICAL EQUIPMENT DESIGNATION (CONTRACTOR FURNISHED AND INSTALLED UNLESS NOTED OTHERWISE)

WALL CLEANOUT (WCO)

1/2"CW &-

WATER PLAN

SCALE : 1/4" = 1'-0"

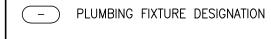

CONNECTION POINT OF NEW WORK TO EXISTING

PLUMBING FIXTURE SCHEDULE

	BOTTLE FILLING STATION: ELKAY EZ8WS, ADA COMPLIANT, NON-FILTERED,
BF	ANTIMICROBIAL, STAINLESS STEEL, TOUCHLESS SENSOR ACTIVATION, 8 GPH, 115V,
	5 FLA.
	WALL MOUNT LAVATORY: AMERICAN STANDARD 0355.012, THREE FAUCET HOLE, 4"
	CENTERS, 20.5"X18.25" D-SHAPED BOWL, VITREOUS CHINA, MOUNT AT ADA
LAV	HEIGHT, WITH DUAL HANDLE FAUCET (DELTA 2523LF-SSMPU). PROVIDE FLEXIBLE SS
	RISERS WITH CHROME PLATED STOP VALVES, P-TRAP WITH CLEANOUT AND
	ESCUTCHEONS. INSULATE WITH "HANDI-LAV-GUARD" MODEL 102, OR EQUAL.
	FLOOR-MOUNTED ADA WATER CLOSET: KOHLER K-3519-TR-0, HANDICAP
	ACCESSIBLE, VITREOUS CHINA, 1.0 GPF, ELONGATED BOWL, FLOOR MOUNTED W/
WC	17.125" BOWL HEIGHT, WHITE, VITREOUS CHINA TANK AND COVER CONTAINING
	FLUSH VALVE, WHITE OPEN-FRONT SEAT, CHROME STOPS, C.P. FLEXIBLE RISER

BASIS OF DESIGN: CONFIRM ALL SELECTIONS WITH OWNER AND ARCHITECT PRIOR TO PURCHASE.

	FLOSH VALVE, WITH COPEN-PRONT SEAT, CHRONIE STOPS, C.F. FLEXIBLE RISER	
	TUBE, BOLT CAPS AND ESCUTCHEON.	
	MOP SINK: FIAT MSB2424. 24"x24"x6" MOP BASIN WITH 3" DRAIN. WALL MOUNT	
√IS	FAUCET (FIAT 830AA), TWO HANDLES, PAIL HOOK, VACUUM BREAKER AND 3/4" N	IΡ
	THREAD.	

FIXTURE BRANCH CONNECTION SCHEDULE										
FIXTURE	COLD WATER	HOT WATER	WASTE	VENT						
BOTTLE FILLING STATION	1/2"	-	1-1/2"	1-1/2"						
LAVATORY	1/2"	1/2"	1-1/2"	1-1/2"						
MOP SINK	1/2"	1/2"	3"	2"						
WATER CLOSET (FLUSH TANK)	1/2"	-	4"	2"						
NOTE:	PIPE SIZES SHOW	PIPE SIZES SHOWN ARE MINIMUM. MINIMUM SANITARY SIZE								
	UNDERGROUND	S 2".								

#KEYED PLAN NOTES

- 1. CONNECT NEW 1/2"CW AND 1/2"HW PIPING TO DOMESTIC WATER PIPING SERVING EXISTING RESTROOM. FIELD VERIFY EXACT LOCATION PRIOR TO START OF WORK.
- 2. NO WORK IN EXISTING RESTROOM. FIXTURES SHOWN FOR REFERENCE ONLY.
- 3. CONNECT NEW SANITARY SEWER LINE TO SANITARY SEWER SERVING EXISTING RESTROOM. FIELD VERIFY EXACT LOCATION, SIZE, FLOW DIRECTION AND ADEQUATE INVERT DEPTH PRIOR TO START OF WORK. CAMERA EXISTING SEWER PIPING AS REQUIRED IN ORDER TO LOCATE CONNECTION POINT.
- 4. CONNECT NEW 2"V TO EXISTING 2" OR GREATER VENT OVERHEAD SERVING EXISTING RESTROOM. FIELD VERIFY LOCATION PRIOR TO START OF WORK.
- 5. 1/2"CW DOWN IN WALL TO WATER CLOSET.
- 6. 1/2"HW AND 1/2"CW DOWN IN WALL TO LAVATORY. PROVIDE THERMOSTATIC MIXING VALVE EQUAL TO LEONARD MODEL 170. SET HOT WATER SUPPLY WATER TEMPERATURE TO
- 7. 1/2"CW DOWN IN WALL TO BOTTLE FILLING STATION.

ENGINEERS

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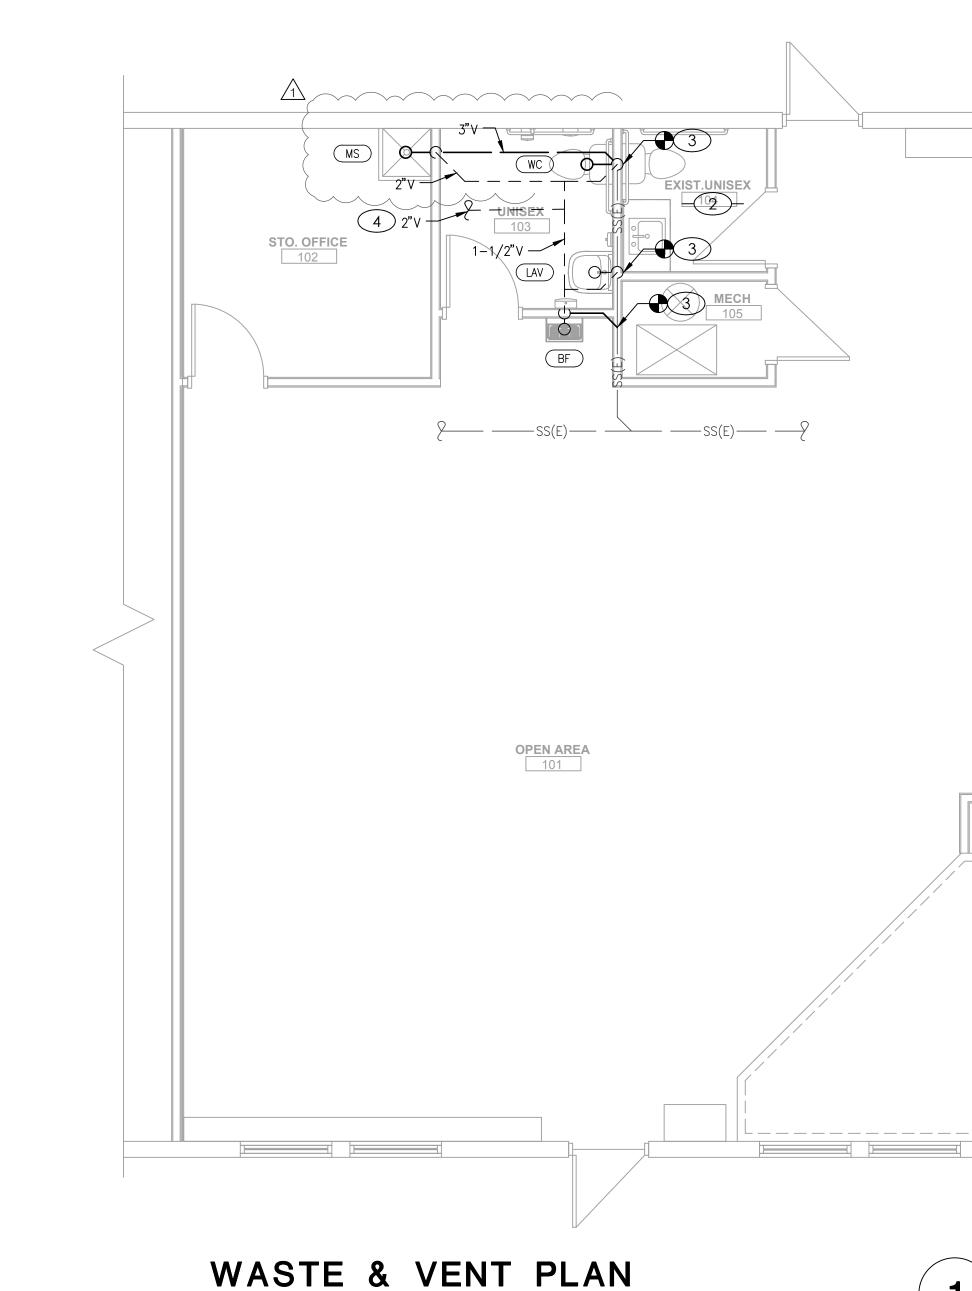
MEP ENGINEER


REVISION DATES: 1 01.13.23 PLANCHECK

PROFESSIONAL SEAL

I<u>SSUE DATE:</u> 01.13.23 JSC PROJECT #:

PLUMBING PLANS. SPECS & SCHEDULES



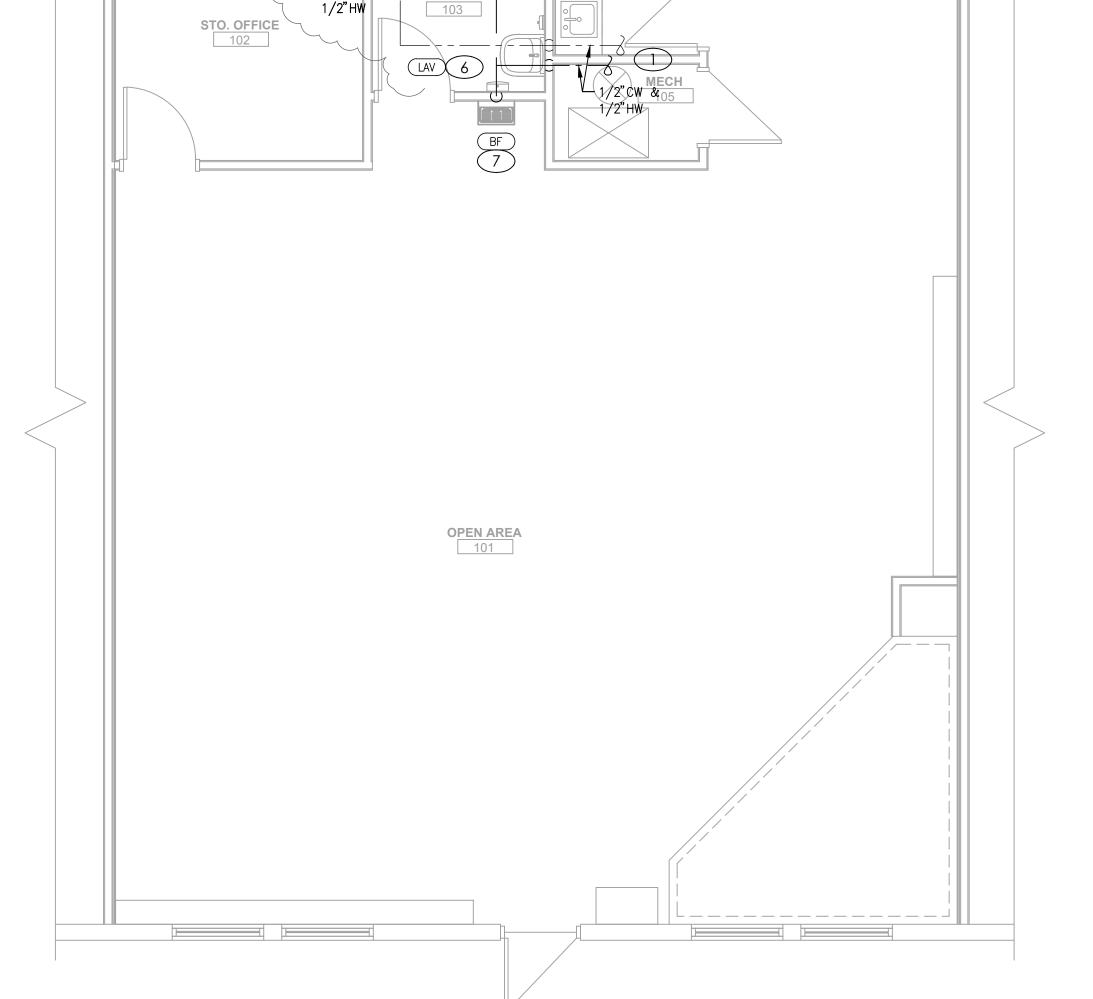

SCALE : 1/4" = 1'-0"

ELECTRICAL SPECIFICATIONS

PART I - GENERAL

- FURNISH AND INSTALL A COMPLETELY WIRED AND OPERATIONAL ELECTRICAL SYSTEM AS SHOWN ON THE DRAWINGS AND SPECIFIED HEREIN, INCLUDING BUT NOT LIMITED TO, THESE MAJOR ITEMS. A. LIGHTING FIXTURES AS INDICATED AND SPECIFIED ON THE PLANS. B. ELECTRICAL PANELS, SERVICE, CONDUIT, WIRING, ETC., FOR ALL OUTLETS AND EQUIPMENT
- OBTAIN AND REVIEW ALL OTHER DRAWINGS INCLUDING REFLECTED CEILING PLAN, INTERIOR AND EXTERIOR ELEVATIONS, FURNITURE PLANS AND ALL MILL WORK DRAWINGS. COORDINATE INSTALLATION OF ALL ELECTRICAL DEVICES AND EQUIPMENT PRIOR TO ROUGH-IN.
- OBTAIN SUBMITTAL AND SHOP DRAWINGS FROM OTHER TRADES AND EQUIPMENT TO COORDINATE INSTALLATION ACCORDINGLY.

C. TELEPHONE, TELEVISION, AND FIRE ALARM. OUTLETS AND CONDUIT AS INDICATED.

- INSTALLATION SHALL COMPLY WITH ALL CURRENT APPLICABLE CODES AND GOVERNING AGENCIES HAVING JURISDICTION.
- FIRE ALARM SYSTEM, IF REQUIRED PER IBC, SHALL BE DESIGN-BUILD BY OWNER'S/GC'S FIRE ALARM CONTRACTOR, DESIGN SHALL BE IN ACCORDANCE WITH NFPA 72. FIRE ALARM CONTRACTOR SHALL SUBMIT STAMPED DRAWINGS TO AHJ FOR REVIEW AND APPROVAL. FIRE ALARM CONTRACTOR IS RESPONSIBLE FOR TESTING AND VERIFYING THAT THE AUDIBILITY OF THE FIRE ALARM SYSTEM MEETS A MINIMUM OF 15 DBA ABOVE AMBIENT NOISE LEVELS. ADD HORNS WHERE REQUIRED TO MAINTAIN MINIMUM
- PROVIDE FIRE STOP ON ALL PIPING THAT PENETRATES RATED WALLS. METHOD OF FIRE STOP SHALL MEET WALL RATING. REFER TO ARCHITECTURAL DRAWINGS FOR LOCATION OF FIRE RATED WALLS. THIS CONTRACTOR SHALL PROVIDE FIRE RATED ENCLOSURES AROUND ALL ROUGH-IN BOXES, PANELS, ETC. THAT ARE LOCATED IN FIRE RATED WALLS AND SHALL FIRE CAULK ALL OPENINGS IN RATED ASSEMBLIES.

C. CODES, REGULATIONS, AND STANDARDS

- THE INSTALLATION SHALL COMPLY WITH APPLICABLE LOCAL AND STATE CODES AND ORDINANCES, WITH THE REGULATIONS OF THE LATEST EDITION OF THE NATIONAL ELECTRIC CODE AND WITH THE REQUIREMENTS OF THE POWER, TELEPHONE, AND CATV COMPANIES FURNISHING SERVICES TO THIS INSTALLATION.
- THE LATEST EDITIONS OF THE FOLLOWING INDUSTRY STANDARDS, SPECIFICATIONS, AND CODES ARE A. THE NATIONAL ELECTRICAL MANUFACTURER'S ASSOCIATION STANDARDS.
- B. THE NATIONAL ELECTRICAL CODE, INCLUDING LOCAL AMENDMENTS. C. UNDERWRITER LABORATORIES INCORPORATED STANDARDS.
- D. AMERICAN NATIONAL STANDARDS INSTITUTE. E. INTERNATIONAL BUILDING CODE.

D. INSPECTION OF SITE

- PRIOR TO SUBMITTING A BID FOR ELECTRICAL WORK, THE CONTRACTOR SHALL VISIT THE SITE OF THE PROPOSED CONSTRUCTION AND SHALL THOROUGHLY ACQUAINT HIMSELF WITH EXISTING UTILITIES, AND WORKING CONDITIONS TO BE ENCOUNTERED, ETC. ALLOWANCE WILL NOT BE MADE FOR NONCOMPLIANCE WITH THIS CONDITION AFTER BIDDING.
- ELECTRICAL INSTALLATION SHALL MEET THE EXISTING CONDITIONS.

H. DRAWINGS

THE DRAWINGS INDICATE THE GENERAL ARRANGEMENT AND LOCATIONS OF THE ELECTRICAL WORK DATA PRESENTED ON THESE DRAWINGS ARE AS ACCURATE AS PLANNING CAN DETERMINE, BUT FIELD VERIFICATION OF ALL DIMENSIONS, LOCATIONS, LEVELS, ETC., TO SUIT FIELD CONDITIONS IS REQUIRED. REVIEW ALL ARCHITECTURAL, STRUCTURAL, AND MECHANICAL DRAWINGS AND ADJUST ALL WORK TO MEET THE REQUIREMENTS OF CONDITIONS SHOWN. THE ARCHITECTURAL DRAWINGS SHALL TAKE PRECEDENCE OVER ALL OTHER DRAWINGS. DISCREPANCIES BETWEEN DIFFERENT PLANS, OR BETWEEN DRAWINGS AND SPECIFICATIONS, OR REGULATIONS AND CODES GOVERNING THE INSTALLATION SHALL BE BROUGHT TO THE ATTENTION OF THE ENGINEER IN WRITING BEFORE THE DATE OF BID OPENING. IF DISCREPANCIES ARE NOT REPORTED, THE CONTRACTOR SHALL BID THE GREATER QUANTITY OR BETTER QUALITY, AND APPROPRIATE ADJUSTMENTS WILL BE MADE AFTER CONTRACT AWARD. CONTRACTOR SHALL BE RESPONSIBLE TO FIELD MEASURE AND CONFIRM MOUNTING HEIGHTS AND LOCATION OF ELECTRICAL EQUIPMENT WITH RESPECT TO COUNTERS, RADIATION, ETC. DO NOT SCALE DISTANCES OFF THE ELECTRICAL DRAWINGS, USE ACTUAL BUILDING DIMENSIONS.

COOPERATION WITH OTHER CONTRACTORS

- COOPERATE WITH THE OTHER TRADES SO THAT THE INSTALLATION OF THE ELECTRICAL OUTLETS AND EQUIPMENT WILL BE PROPERLY COORDINATED. CONDUIT, LIGHTING FIXTURES, AND OTHER EQUIPMENT LOCATIONS SHALL BE VERIFIED WITH OTHER TRADES TO AVOID CONFLICT WITH THE PIPING, DUCTWORK,
- STEEL, BEAMS, OR OTHER OBSTRUCTIONS CAREFULLY VERIFY THE LOCATIONS OF THE OUTLET BOXES AND DETERMINE THAT THEY HAVE NOT BEEN DISTURBED DURING THE INSTALLATION OF MATERIALS OF OTHER TRADES.
- COORDINATE THE LOCATION OF THE TRENCHES AND CONDUITS FOR ELECTRICAL AND TELEPHONE UTILITY SERVICES WITH THE GENERAL CONTRACTOR.
- COORDINATE HVAC AND PLUMBING EQUIPMENT CONNECTION REQUIREMENTS WITH HVAC AND PLUMBING

PART II - PRODUCTS AND EXECUTION

A. MATERIALS

1. ALL MATERIALS SHALL BE NEW AND OF QUALITY AS SPECIFIED ON THE PLANS OR SPECIFICATIONS AND MUST CARRY THE UNDERWRITER'S LABORATORIES APPROVAL COVERING THE PURPOSE FOR WHICH THEY ARE USED, IN ADDITION TO MEETING ALL REQUIREMENTS OF THE CURRENT APPLICABLE CODES AND REGULATIONS.

C. SYSTEM GROUNDING

- 1. GROUNDING SHALL COMPLY WITH REQUIREMENTS OF ARTICLE 250. ALL EXPOSED NONCURRENT CARRYING METALLIC PARTS OF ELECTRICAL EQUIPMENT, METALLIC RACEWAY SYSTEMS, METALLIC CABLE ARMOR, GROUNDING CONDUCTOR OF NONMETALLIC SHEATHED CABLES, GROUNDING CONDUCTOR IN NONMETALLIC RACEWAYS, AND GROUNDED CONDUCTORS OF THE WIRING SYSTEM SHALL BE GROUNDED.
- CONDUCTOR SIZES SHOWN ON THE DRAWINGS ARE BASED ON COPPER WIRE. UNLESS OTHERWISE SPECIFIED, ALL WIRE SHALL BE TYPE XHHW OR SE FOR FEEDERS OR BRANCH CIRCUITS LARGER THAN 4 AWG, TYPE THHN/THWN INSULATION FOR FEEDERS AND BRANCH CIRCUITS 4 AWG AND SMALLER. ALL BRANCH CIRCUIT WIRING SHALL BE COPPER.
- THE WIRES SHALL BE MARKED WITH COLOR TO SIMPLIFY CIRCUIT IDENTIFICATION. UNLESS OTHERWISE REQUIRED BY LOCAL ORDINANCES GROUND WIRES SHALL BE GREEN, NEUTRAL WIRES SHALL BE 120V-WHITE, AND LIVE WIRES 208Y/120V AND 120/240 SHALL BE BLACK (PHASE A), RED (PHASE B), AND BLUE (PHASE C). CIRCUIT SHALL BE LABELED IN EACH J-BOX.
- ALL CONDUCTORS SHALL BE RATED 600 VOLT. PROVIDE SOLID CONDUCTOR FOR 12 AWG AND SMALLER.
- 5. NO WIRE SHALL BE INSTALLED IN THE CONDUIT SYSTEM UNTIL THE CONDUIT SYSTEM IS COMPLETE. USE MINERALAC NO. 100 OR EQUIVALENT AS A LUBRICANT TO FACILITATE THE INSTALLATION OF THE
- CONDUCTORS IN THE CONDUIT SYSTEM. 6. MC CABLE WITH COPPER CONDUCTORS AND GROUND WIRE MAY BE USED WHERE PERMITTED.

- ALL WIRING SHALL BE INSTALLED IN LISTED METALLIC CONDUIT EXCEPT AS PERMITTED IN OTHER SECTIONS. RGS, WITH A 20 MIL PVC COATING WILL BE USED WHEN IN CONTACT WITH EARTH. IMC MAY BE USED IN INDOOR LOCATIONS NOT IN CONTACT WITH THE EARTH. EMT MAY BE USED IN INDOOR LOCATIONS NOT IN CONTACT WITH EARTH, NOT IN CONCRETE SLABS OR WALLS AND NOT SUBJECT TO DAMAGE. PVC MAY BE USED IN OR BELOW CONCRETE AND DIRECT BURIED IN EARTH. FLEXIBLE STEEL CONDUIT SHALL BE USED FOR INDOOR FINAL CONNECTIONS TO EQUIPMENT IN LENGTHS NOT TO EXCEED 72". LIQUID-TIGHT FLEXIBLE STEEL CONDUIT SHALL BE FOR OUTDOOR FINAL CONNECTIONS TO EQUIPMENT NOT TO EXCEED
- WHERE CONDUIT ENTERS OUTLET BOXES, FIXTURES OR CABINETS, FIRMLY FASTEN WITH STEEL SET SCREW, COMPRESSION CONNECTORS, OR DOUBLE LOCKNUTS FOR GRC. ALL CONNECTIONS SHALL HAVE BUSHINGS OR INSULATED THROAT CONNECTORS. FIRMLY FASTEN CONDUIT TO THE BUILDING CONSTRUCTION. RUN EXPOSED CONDUIT PARALLEL TO THE BUILDING LINES, SUPPORTED BY APPROPRIATE HANGERS (UNISTRUT, T & B OR APPLETON, OR EQUAL).

FITTINGS AND CONDUIT BODIES SHALL BE STEEL. DIECAST FITTINGS ARE NOT ACCEPTABLE.

- CONDUIT SIZES SHALL BE AS REQUIRED BY CODE AND AS INDICATED OR SPECIFIED. WIRING, CONDUITS, AND OUTLETS SHALL BE CONCEALED WITH THE BUILDING STRUCTURE, EXCEPT THAT CERTAIN MOTOR AND LIGHTING FEEDER CONDUITS MAY BE RUN EXPOSED IN CERTAIN AREAS AS INDICATED
- ON THE DRAWINGS. CONDUIT PENETRATION THROUGH ROOF SHALL HAVE ROOF FLASHING WITH CAULK TYPE COUNTER FLASHING
- SLEEVE. INSTALLATION SHALL BE WATERTIGHT. 7. CONDUITS SHALL BE ROUTED PARALLEL AND PERPENDICULAR TO THE STRUCTURE.

OUTLET, PULL, AND JUNCTION BOXES

- EACH SWITCH, LIGHT. RECEPTACLE OR OTHER OUTLET, INSTALLED IN RESIDENTIAL UNITS. SHALL BE PROVIDED WITH A CODE SIZED, PLASTIC OUTLET BOX. JUNCTION AND PULL BOXES SHALL BE CODE
- SIZED, PLASTIC OR METAL OUTLET BOX. ALL OTHER OUTLET BOXES SHALL BE STEEL BOXES INSTALLED IN POURED CEMENT FLOORS SHALL BE FLUSH TYPE CAST IRON OR STEEL WITH WATERTIGHT GASKETED COVERS. WHERE BOXES ARE INSTALLED IN FLOORS WITH TILE OR CARPET FLOOR COVERING, COVERS SHALL BE OF THE RECESSED TYPE TO ACCOMMODATE THE FLOOR COVERING.
- 3. BOXES INSTALLED FOR THE ALARM, COMPUTER, AND SECURITY SYSTEM SHALL BE PROVIDED WITH APPROPRIATE COVER PLATES.
- BOXES FOR TELEPHONE, COMPUTER, T.V., FIRE ALARM, SECURITY, AND SIMILAR SYSTEMS SHALL BE MINIMUM 2-1/8" DEEP.

G WIRING DEVICES

- WALL SWITCHES SHALL BE SPECIFICATION GRADE AC SILENT TYPE SWITCHES, 20A 120/277 VOLT. RECEPTACLES SHALL BE SPECIFICATION GRADE, DUPLEX TYPE. NEMA5-20R, 20 AMPERE, 120VOLT GROUNDED TYPE. SPECIAL APPLICATION RECEPTACLES SHALL BE INDICATED ON PLANS. MOUNT WITH THE GROUND DOWN.
- DEVICE PLATES SHALL BE EQUAL TO SIERRA SMOOTH-LINE PLASTIC WALL PLATES. COLOR SHALL BE WHITE, UNLESS OTHERWISE NOTED.
- RECEPTACLES IN OUTDOOR AND WET LOCATIONS SHALL BE INSTALLED WITH A HINGED OUTLET COVER/ENCLOSURE CLEARLY MARKED AND U.L. LISTED SUITABLE FOR WET LOCATIONS WHILE IN USE, EQUAL TO TAYMAC SPECIFICATION GRADE.

- CIRCUIT BREAKER TYPE AS INDICATED ON DRAWINGS. UNLESS INDICATED OTHERWISE, ALL PANELS SHALI HAVE PANEL HAVE PANEL BOARD TYPE CONSTRUCTION WITH BOLT-ON CIRCUIT BREAKERS FOR 30 PANELS MANUFACTURERS SHALL BE GENERAL ELECTRIC. SQUARE D. SEIMENS. CUTLER-HAMMER WITH VOLTAGE.
- SIZES, AND RATINGS AS INDICATED ON DRAWINGS. THE CIRCUIT BREAKERS SHALL BE OPERABLE IN ANY POSITION AND BE REMOVABLE FROM THE FRONT O THE PANEL BOARD WITHOUT DISTURBING THE ADJACENT UNITS. BRANCH BREAKERS SHALL BE OF SUCH DESIGN THAT COMBINATION OF SINGLE-POLE, DOUBLE-POLE, AND THREE-POLE BREAKERS CAN BE ASSEMBLED ON THE SAME PANEL. EACH BRANCH CIRCUIT SHALL BE CLEARLY NUMBERED. BRANCH AND MAN TERMINALS SHALL BE SOLDERLESS TYPE. HANDLE TIES TO FORM MULTI-POLE BREAKERS NOT ACCEPTABLE.

- PROVIDE ALL LIGHTING FIXTURES, WIRED AND CONNECTED. THE DRAWINGS INDICATE THE FIXTURES FOR EACH LOCATION. PROVIDE LAMPS FOR ALL FIXTURES. THE LAMPS SHALL BE BY THE SAME MANUFACTURER. VERIFY CEILING CONSTRUCTION BEFORE ORDERING RECESSED UNITS. PROVIDE PLASTER FRAMES AND HANGERS AS REQUIRED. CEILING CONSTRUCTION, ARCHITECTURAL ACCESSORIES, VOLTAGE, AND BALLASTS TO MEET THE EXISTING CEILING CONDITION.
- FURNISH AND INSTALL TIME SWITCHES, PHOTOCELLS, CONTRACTORS AND FULL LIGHTING CONTROL SYSTEMS AS REQUIRED FOR LIGHTING CONTROLS INDICATED ON THE DRAWINGS.
- TIME SWITCHES SHALL BE EQUAL TO PARAGON, GENERAL ELECTRIC, TORK, OR INTERMATIC AND SHALL HAVE SIZE AND NUMBER OF POLES AS REQUIRED.
 - 3. PHOTOCELLS SHALL BE EQUAL TO TORK OR INTERMATIC WITH VOLTAGE AS INDICATED.

GUARANTEE ALL MATERIAL FURNISHED AND ALL WORKMANSHIP PERFORMED FOR A PERIOD OF ONE YEAR FROM DATE OF FINAL ACCEPTANCE OF WORK. ANY DEFECTS DEVELOPING WITHIN THIS PERIOD, TRACEABLE TO MATERIAL FURNISHED AS A PART OF THIS SECTION OR WORKMANSHIP PERFORMED HEREUNDER, SHALL BE MADE GOOD AT NO EXPENSE TO THE OWNER.

ELECTRIC SERVICE SINGLE LINE DIAGRAM IS EXISTING TO REMAIN. NO MODIFICATIONS ARE BEING MADE TO THE SEQUENCE OFELECTRICAL SERVICE DISTRIBUTION EQUIPMENT IN THIS SCOPE.

BUS MAIN VOLT	ADCENTER: PA(EXIS AMPS: 100A SIZE/TYPE: MLO S/PHASE: 120/240V, 1PH, 3W TION: 1	STING)			AIC F SERV MOU	ROM: RATING VES: JA NTING ATION:	B: AZZ B: Sl	ER(URF	000 FUL CISE FACE	UTILI LY RA				LINE-SIDE LUGS: MECHAN EQUIPMENT GROUND	
СКТ	DESCRIPTION		VOLTAN	PS/PHASE	WIRE	BKR	Р	Р	BKR	WIRE	VOLTA MI	PS/PHASE		DESCRIPTION	CK
NO.			Α	В	NO.	AMP			AMP	NO.	Α	В			NO
1	UNUSABLE SPACE						1	1					UNUSAE	LE SPACE	2
3	UNUSABLE SPACE						1	1					UNUSAE	LE SPACE	4
5	COMPUTER RECEPT		500		EX	20	1	1	20/20	ΕX	√5 0 0√	\\\\\\\\\\\\\\\\\\\\\\\\\\\\\\\\\\\\\\	AIR COA	IPRE\$SQR V	√ 6 .
7	LTG - GENERAL			800	12	20	1	1	20	12		500		ZED DAMPER	8
9	PLUGS		500		EX	20	1	7	20	12	180		RCPT-C	THECK-IN V	10
11	PLUGS			500	EX	20	1	1	20	12		180		STAGE AV EQUIPMENT	12
. •	LIGHTS		500		EX	20	1	1	20	EX	500			MERGENCY	14
	PLUGS			500	EX	20	1	2	40	EX		3,000	AIR CON	IDITIONER	16
	UNLABELED		500		EX	20	1				3,000				18
19				500	EX	20	1	1	15	EX		500	UNLABE		20
	GENERAL PLUGS		500		EX	20	1	1	20	12	800		RCPT - F		22
23	FURNACE			500	EX	15/15	1	1	20	12		200	(GF)RCF	T - BOTTLE FILLER	24
	SUBTOTAL		2,500	2,800							4,980	4,380		SUBTOTAL	
	TOTAL PHASE A - VA 7,480	LOAD		CONN. V	/A	DF		LO	AD			ONN. VA	DF		
	AMPS 62	COOLIN	G			1.00	1	RE	FRIG				1.00		
	TOTAL PHASE B - VA 7,180	HEATIN	G			0		SIGN/DISP		Р			1.25		
	AMPS 60	LIGHTIN	IG	800		1.25		KIT	CHEN	l			1.00		
TOTAL PNLBD - VA 14,660 RECEPTA		TACLES	1,360	1.0/.		1	EXISTING		}		12,500	1.00			
	AMPS 61	MOTOR	S			1.00		LR	G MOT	OR			1.25	TOTAL DEMAND	
		SUPP H	EAT			1.00			IOW W				1.25	14,860 VA	
MISC EQUIP				1.00 LTG TRACK				1.00 62 A		Α					

	ELECTRICAL LIGHTING SCHEDULE (or equal, verify all selections and finishes with owner and architect prior to ordering).										
FIXTURE	FIXTURE MANUFACTURER					MOUNTING	LAMP TYPE	REMARKS	VOLT		
TYPE	NAME	SERIES	AMPS	MOUNTING		IKLIAN IKKO					
A	VISCOR	LRTA2X4-LED835049LUNV-B02	35	RECESSED	INCLUDED LED	2'X4' DIMMABLE LED TROFFER- 3500K - 4900LM	MVOLT				
TR	ELCO LIGHTING	ET62630DW EP008W	13/FIXT	TRACK	INCLUDED LED	LED SINGLE CIRCUIT TRACK & FIXTURE - CONFIRM SPECIFICATION, FIXTURE QUANTITY, AND FINISH WITH OWNER	120				
ØH	EMERGI-LITE	LUX-RAY SERIES	5	SURFACE	INCLUDED LED	OUTDOOR EMERGENCY REMOTE EGRESS LIGHTING UNIT - BLACK	MVOLT				
	EMERGI-LITE	PREMIER SERIES	5	SURFACE	INCLUDED LED	EMERGENCY EXIT EGRESS COMBO LIGHTING UNIT WITH RED FACE EXIT SIGN AND 90 MIN. BATTERY PACK	MVOLT				
	EMERGI-LITE	THERMOPLASTIC COMPACT BATTERY SERIES	5	SURFACE	INCLUDED LED	EMERGENCY LIGHTING UNIT WITH 90 MIN. BATTERY PACK	MVOLT				

(GF) = GFCI-TYPE BREAKER

SYMBOLS LEGEND

NOTE: THIS IS A MASTER LEGEND AND NOT ALL SYMBOLS, ETC, ARE NECESSARILY USED ON THE DRAWINGS.

LIGHTING FIXTURES - SYMBOL/LETTER INDICATES LIGHT FIXTURE AS INDICATED ON FIXTURE SCHEDULE

LED FIXTURE (SEE LIGHTING FIXTURE SCHEDULE)



FIXTURE WITH EMERGENCY BATTERY DRIVER UNIT TRACK LIGHT

- DOWNLIGHT FIXTURE WITH EMERGENCY BATTERY DRIVER UNIT
- WALL MOUNTED FIXTURE WITH EMERGENCY BATTERY DRIVER UNIT
- PENDANT MOUNTED FIXTURE WITH EMERGENCY BATTERY DRIVER UNIT
- \circ DOWNLIGHT FIXTURE
- Ю WALL MOUNTED FIXTURE
- α PENDANT MOUNTED FIXTURE
- SINGLE FACE EXIT SIGN UNIVERSAL MOUNTED
- SINGLE FACE EXIT SIGN W/ DIRECTIONAL ARROWS -
- DOUBLE FACE EXIT SIGN W/ DIRECTIONAL ARROWS -
- DUAL HEADED EMERGENCY UNIT
- COMBO DUAL HEADED EMERGENCY AND EXIT SIGN UNIT

LIGHTING CONTROLS

- SINGLE POLE SWITCH @ +48" UNLESS NOTED
- Sabc SWITCH BANK @ +48" UNLESS NOTED. LOWER CASE
- LETTER INDICATES FIXTURE CONTROLLED.
- S₃ 3-WAY SWITCH @ +48" UNLESS NOTED
- S4 4-WAY SWITCH @ +48" UNLESS NOTED
- DIMMER SWITCH SIZE AS REQUIRED @ +48" UNLESS NOTED
- MANUAL MOTOR STARTER
- WALL SWITCH WITH OCCUPANCY SENSOR. DIGITAL LOW VOLTAGE WALL SWITCH. SWITCH @ +48" UNLESS NOTED.
- TWO BUTTON DIGITAL LOW VOLTAGE WALL SWITCH. PROVIDES ON/OFF/0-10V DIMMING. SWITCH
- LIGHTING CONTROLS CEILING MOUNT OCCUPANCY SENSOR LIGHTING CONTROLS POWER PACK
- LIGHTING CONTACTOR
- TC TIMECLOCK

POWER DISTRIBUTION

120/240V, 1 PHASE, 3 WIRE PANELBOARD, UNO

Т TRANSFORMER

POWER DEVICES

- SPECIAL HEAVY DUTY RECEPTACLE SIZE AS NOTED.
- @ +18" UNLESS NOTED 1/2 SWITCHED RECEPTACLE @ +18" UNLESS NOTED
- FIRE RATED POKE THRU WITH TYPE INDICATED
- FLUSH FLOOR BOX WITH TYPE INDICATED
- → SINGLE RECEPTACLE @ +18" UNLESS NOTED
- DUPLEX RECEPTACLE @ +18" UNLESS NOTED
- DOUBLE DUPLEX RECEPTACLE @ +18" UNLESS NOTED
- DUPLEX RECEPTACLE INSTALLED ABOVE COUNTERTOP
- GFCI-RATED DUPLEX RECEPTACLE
- ARC FAULT RATED DUPLEX RECEPTACLE
- TAMPER RESISTANT RATED DUPLEX RECEPTACLE
- DUPLEX RECEPTACLE WITH WEATHERPROOF COVERPLATE WP @ 18" UNLESS NOTED
- JUNCTION BOX ☐☐☐ DISCONNECT SWITCH — SIZE AND TYPE NOTED
- COMBINATION FUSED STARTER DISCONNECT SWITCH FUSE SIZE AS INDICATED, STARTER SIZE '1'

AUXILIARY SYSTEMS

- MECHANICAL EQUIP. CONNECTION, SEE SCHED. ON MECH. PLAN
- TELEPHONE OUTLET@ +18" UNLESS NOTED
- DATA OUTLET @ +18" UNLESS NOTED COMBINATION TELEPHONE/DATA OUTLET @ +18" UNLESS NOTED
- TELEVISION OUTLET @ +60" UNLESS NOTED
- **(** SMOKE DETECTOR HEAT DETECTOR
- DUCT SMOKE DETECTOR
- REMOTE TEST STATION WITH INDICATING LIGHT. MOUNT AT 48" AFF UNO. AUXILIARY SYSTEM TERMINAL CABINET

<u>GENERAL</u>

———— CONDUIT RUN CONCEALED IN WALL OR ABOVE CEILING

————— CONDUIT RUN BELOW FLOOR OR GRADE

THOMERUN TO PANELBOARD, INFORMATION AT ARROWS ARE CIRCUIT NUMBERS AND PANELBOARD FOR TERMINATION. REFER TO ASSOCIATED NOTE FOR BRANCH CIRCUIT CONDUCTOR SIZES.

5 INDICATES 1/2" CONDUIT CONCEALED IN CEILING OR WALL WITH (3) CONDUCTORS. (1) PHASE,

(1) NEUTRAL AND (1) GROUND WIRE. ALL ARE #12 AWG UNLESS NOTED OTHERWISE.

(E) OR ETR: DENOTES EXISTING ITEM/EQUIPMENT TO REMAIN

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1 01.13.23 PLANCHECK



ISSUE DATE: 01.13.23 JSC PROJECT #:


ELECTRICAL PLANS


GENERAL NOTES

- A. REFER TO LIGHTING FIXTURE SCHEDULE FOR LIGHT FIXTURE TYPES AND REQUIREMENTS.
- B. CONNECT ALL EXIT SIGNS AND EMERGENCY LIGHTING UNITS TO THE INDICATED CIRCUIT WITH A SEPARATE AND UN-SWITCHED CONDUCTOR BYPASSING ALL CONTROLS AND CONTACTORS. REFER TO MANUFACTURER'S WRITTEN INSTRUCTIONS FOR PROPER INSTALLATION AND TESTING.
- C. CONTRACTOR SHALL BE RESPONSIBLE FOR ENSURING THAT COORDINATION AND CONFLICT ISSUES BE RESOLVED PRIOR TO INSTALLATION OF LIGHT FIXTURES.
- D. ROUTE ALL EXPOSED, RIGID CONDUIT TIGHT TO STRUCTURE, PARALLEL TO BUILDING LINES AND IN UNISTRUT CABLE/PIPE TRAY WHERE POSSIBLE. COORDINATE CONDUIT ROUTING AND INSTALLATION WITH OTHER TRADES PRIOR TO ROUGH—IN. SUPPORT CONDUIT FROM STRUCTURE NOT ROOF DECK. MAINTAIN 2" MIN SPACING FROM BOTTOM OF ROOF DECK TO PREVENT ROOFING SCREWS FROM PENETRATING CONDUITS.
- E. THROUGH WIRING OF RECESSED LIGHT FIXTURES, IN SUSPENDED CEILINGS, IS NOT PERMITTED. CONNECT EACH LIGHT FIXTURE BY A WHIP TO A JUNCTION BOX. PROVIDE CABLE WHIPS OF SUFFICIENT LENGTH TO ALLOW FOR RELOCATING EACH LIGHT FIXTURE WITHIN A 5-FOOT RADIUS OF ITS INSTALLED LOCATION, BUT NOT EXCEEDING 6 FEET IN UNSUPPORTED LENGTH.

KEYED PLAN NOTES


- THREE-GANG SWITCH. (1) FOR TRACK LIGHITNG, (1) FOR OPEN AREA FANS & (1) FOR STAGE FAN. COORDINATE DIMMING SWITCH STYLE WITH ASSOCIATED TRACK FIXTURE. COORDINATE EXACT GANGED SWITCH LOCATION WITH OWNER PRIOR TO CONSTRUCTION.
- 2. MAKE CONNECTION TO EMERGENCY/EXIT LIGHT VIA UNSWITCHED HOT CONDUCTOR.
- RECEPTACLE FOR OWNER-SUPPLIED FAN. COORDINATE EXACT LOCATION AND MOUNTING HEIGHT WITH OWNER PRIOR TO CONSTRUCTION.
- 4. RECEPTACLE FOR OWNER-SUPPLIED SPEAKER. COORDINATE EXACT LOCATION AND MOUNTING HEIGHT WITH OWNER PRIOR TO CONSTRUCTION.
- 5. RECEPTACLE FOR OWNER-SUPPLIED AUDIO-VISUAL EQUIPMENT. COORDINATE EXACT LOCATION AND MOUNTING HEIGHT WITH OWNER PRIOR TO CONSTRUCTION.
- 6. RELOCATE EXISTING RECEPTACLE TO 18" ABOVE PLATFORM LEVEL.
- EXISTING POWER/DATA DEVICES IN THIS ROOM ARE TO REMAIN UNLESS NOTED OTHERWISE ON DEVICE.
- 8. CONNECT NEW RECEPTACLE TO CIRCUIT SERVING GENERAL CONVENIENCE RECEPTACLE CIRCUIT IN ROOM.
- 9. MAKE CONNECTION TO DIVISION 22/23 EQUIPMENT ACCORDING TO MANUFACTURER'S LITERATURE AND NEC REQUIREMENTS.
- WIRE SO THAT ON/OFF OPERATION OF EXHAUST FAN COORDINATES WITH LIGHTING IN ROOM.

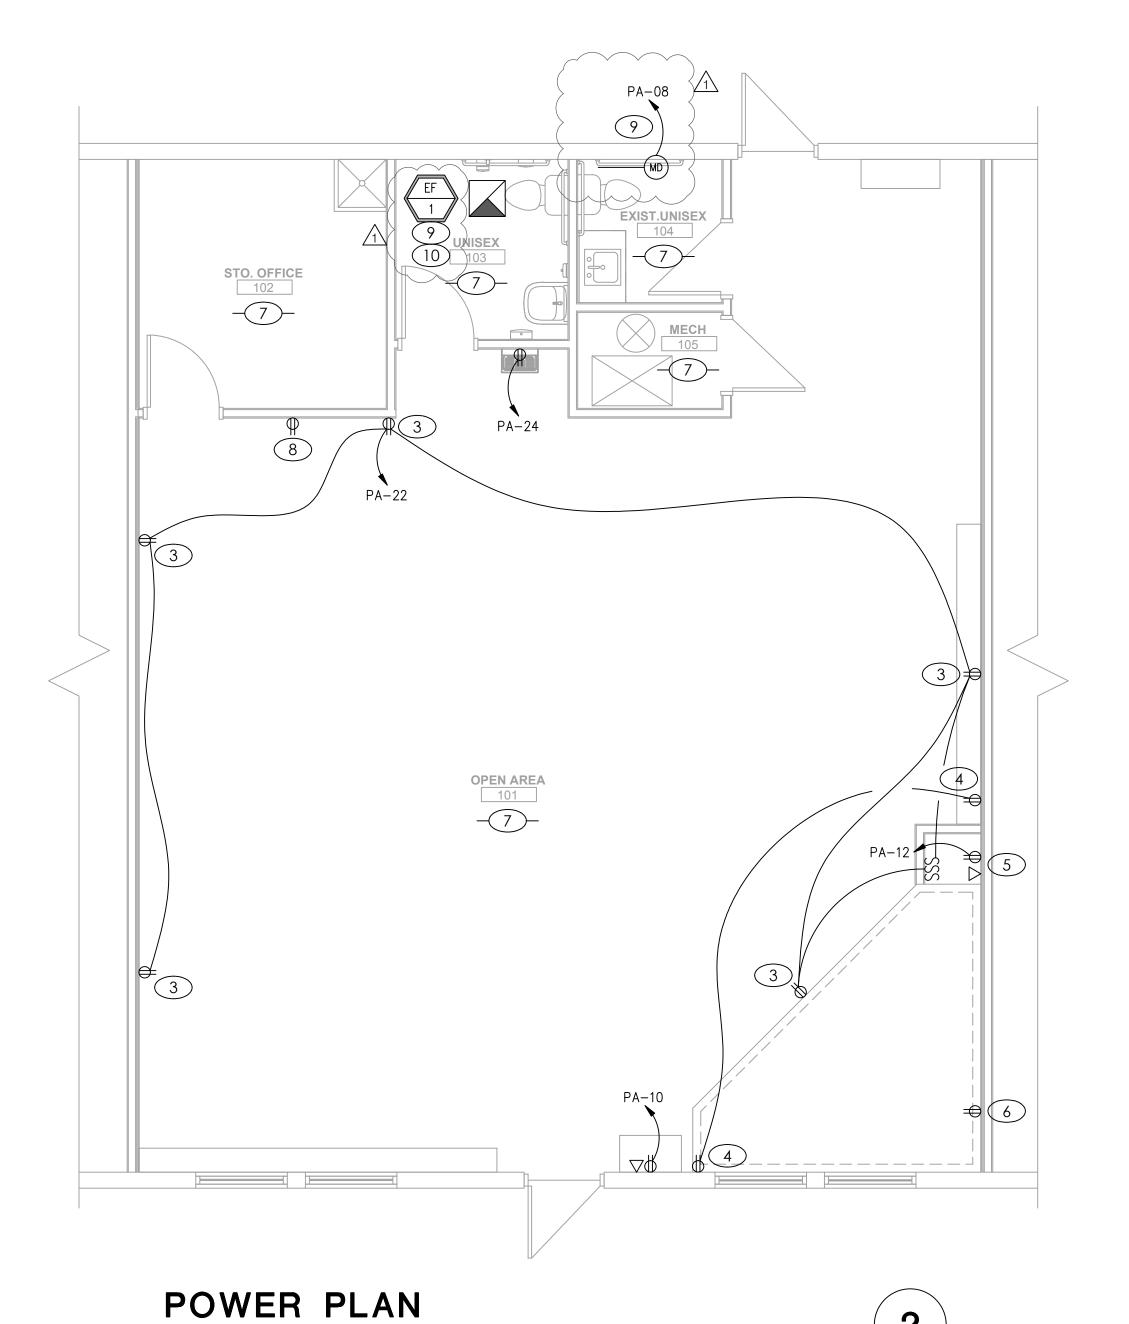

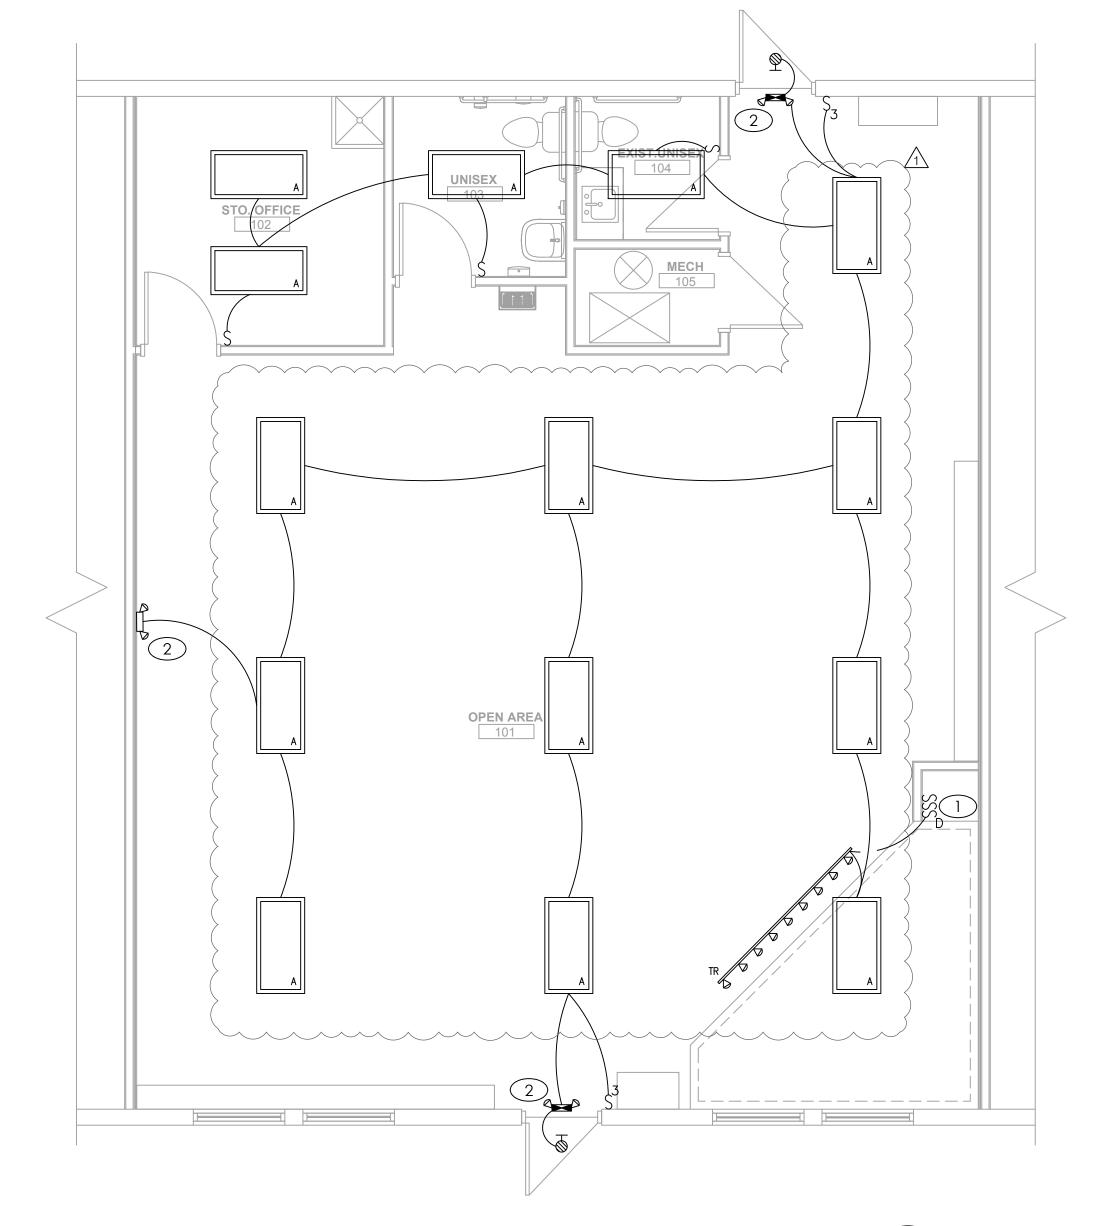

LIGHTING PLAN

SCALE : 1/4" = 1'-0"

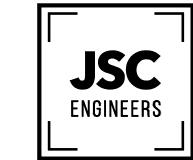

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ELECTRICAL PLANS