

AERIAL SITE PLAN | NTS

SIGN SCHEDULE

A INTERNALLY ILLUMINATED CHANNEL LETTERSET | ONE (1) REQ

GENERAL NOTES

- INSTALLER SHALL VERIFY WALL CONDITIONS IN THE FIELD
- TYPE, SIZE & QUANTITY OF FASTENERS TO BE DETERMINED
- ALL BOLT HOLES TO BE DRILLED OR PUNCHED
- ISOLATE ALL ALUMINUM FROM STEEL.

<p>NEW & REMODEL CONSTRUCTION</p> <p>ADEQUATE BEHIND THE WALL BACKING AND ACCESS IS REQUIRED FOR THE INSTALLATION OF NEW SIGNAGE. CUSTOMER TO FORWARD APPROVED SIGNAGE DRAWINGS TO THE ON SITE CONTACT TO INSURE THAT THE REQUIRED PROVISIONS ARE MADE DURING CONSTRUCTION, PRIOR TO THE SIGN INSTALLATION.</p>	<p>INSTALLER REQUIREMENTS</p> <p>ALL INSTALLATION (MOUNTING) HARDWARE AND SECONDARY WIRING COMPONENTS, CONDUIT & CONNECTORS, ETC ARE TO BE PROVIDED BY THE INSTALLATION CONTRACTOR</p> <p>ALL WALL PENETRATIONS TO BE SEALED WITH SILICONE TO HELP PREVENT MOISTURE PENETRATION @ EXTERIOR LOCATIONS.</p> <p>ANY DEVIATION FROM FEDERAL HEALTH REQUIREMENTS MAY RESULT IN DAMAGE TO OR IMPROPER OPERATION OF SIGNAGE, CAUSING DELAYS AND ADDITIONAL COSTS.</p>	<p>CUSTOMER TO PROVIDE DEDICATED BRANCH CIRCUITS FOR SIGNS ONLY PER NEC CODE 600.5</p> <p>ALL BRANCH CIRCUITS FOR SIGNS MUST BE TOTALLY DEDICATED TO SIGNS (INCLUDING DEDICATED GROUND & NEUTRAL, PER CIRCUIT) AND SHALL NOT BE SHARED WITH OTHER LOADS (SUCH AS LIGHTING, A/C and OTHER EQUIPMENT). PROPERLY SIZED GROUND WIRE THAT CAN BE TRACED BACK TO THE BREAKER PANEL IS REQUIRED.</p> <p>NUMBER AND SIZE OF CIRCUITS FOR EACH SIGN MUST MEET FEDERAL HEALTH SIGN REQUIREMENTS.</p>
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<p>ALL ELECTRICAL SIGNS SHALL CONFORM TO THE REQUIREMENTS OF ARTICLE 600 OF THE N.E.C. AND U.L. 48 ALONG WITH OTHER APPLICABLE STATE & LOCAL CODE REQUIREMENTS. THIS INCLUDES PROPER GROUNDING AND BONDING OF THE SIGN</p>	<p>120V - 20 AMP (PRIMARY ELECTRICAL SERVICE) CIRCUITS AND FINAL CONNECTION TO EACH SIGN, TO WITHIN 6 FT TO BE BY THE CUSTOMER'S CERTIFIED ELECTRICIAN. NUMBER AND SIZE OF CIRCUITS FOR EACH SIGN TO MEET FEDERAL HEALTH SIGN COMPANY REQUIREMENTS</p>
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WARRANTY NOTICE

CERTAIN ELECTRICAL COMPONENTS OF SIGNS WILL FAIL PREMATURELY IF NOT SHUT OFF FOR A PERIOD OF TIME, ONCE EACH DAY. FOR BEST PERFORMANCE WE RECOMMEND THAT SIGNS BE CONNECTED TO AN AUTOMATIC CONTROLLING DEVICE SUCH AS AN EMERGENCY MANAGEMENT SYSTEM, TIME CLOCK OR PHOTO CELL TO CONTROL THE DAILY SHUT-OFF PERIOD. FAILURE TO FOLLOW THESE RECOMMENDATIONS CAN CAUSE DAMAGE TO ELECTRICAL COMPONENTS OF THE SIGN AND VOID THE WARRANTY. SOME DIMMING DEVICES WILL ADVERSELY AFFECT THE ELECTRICAL COMPONENTS OF THE SIGN IF IT IS ATTACHED TO, CAUSING FAILURE. ANY DIMMING OF THE SIGN WITHOUT CONSULTATION WITH FEDERAL HEALTH SIGN CO. WILL VOID THE WARRANTY.



VISUAL COMMUNICATIONS
www.FederalHeath.com

2300 North Highway 121 Euless, Texas 76039

(817) 685-9077 (800) 527-9495 Fax (817) 685-9103

Manufacturing Facilities:
Delaware, OH - Euless, TX - Jacksonville, TX
Oceanside, CA - Racine, WI - Rochester Hills, MI

Office Locations:
Atlanta, GA - Brandon, FL - Indianapolis, IN
Tunica, MS - Daytona Beach, FL - Delaware, OH - Euless, TX
Grafton, WI - Houston, TX - Idaho Falls, ID - Jacksonville, TX
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Oceanside, CA - Racine, WI - Rochester Hills, MI - San Antonio, TX
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Building Quality Signage Since 1901

Revisions:
R1 11.15.22 CHC Remove opt 1, add site map/legend. Remove verify notes

Colors Depicted In This Rendering May Not Match Actual Finished Materials. Refer To Product Samples For Exact Color Match.

Client Approval/Date: *Jane L. Woodward*

Landlord Approval/Date: *Jane L. Woodward*

Account Rep: JACK KIRKLAND

Project Manager: LAILA SAYLORS

Drawn By: Virgo S. Aragonces/chc

Underwriters Laboratories Inc. ELECTRICAL TO USE U.L. LISTED COMPONENTS AND SHALL MEET ALL N.E.C. STANDARDS
ALL ELECTRICAL SIGNS ARE TO COMPLY WITH U.L. 48 AND ARTICLE 600 OF THE N.E.C. STANDARDS, INCLUDING THE PROPER GROUNDING AND BONDING OF ALL SIGNS.

Project / Location:



STORE #
1121 NE RICE ROAD
LEES SUMMIT, MO 64086

Job Number: 23-79465-10

Date: November 03, 2022

Sheet Number: 1 of 3

Design Number: 23-79465-10 R1

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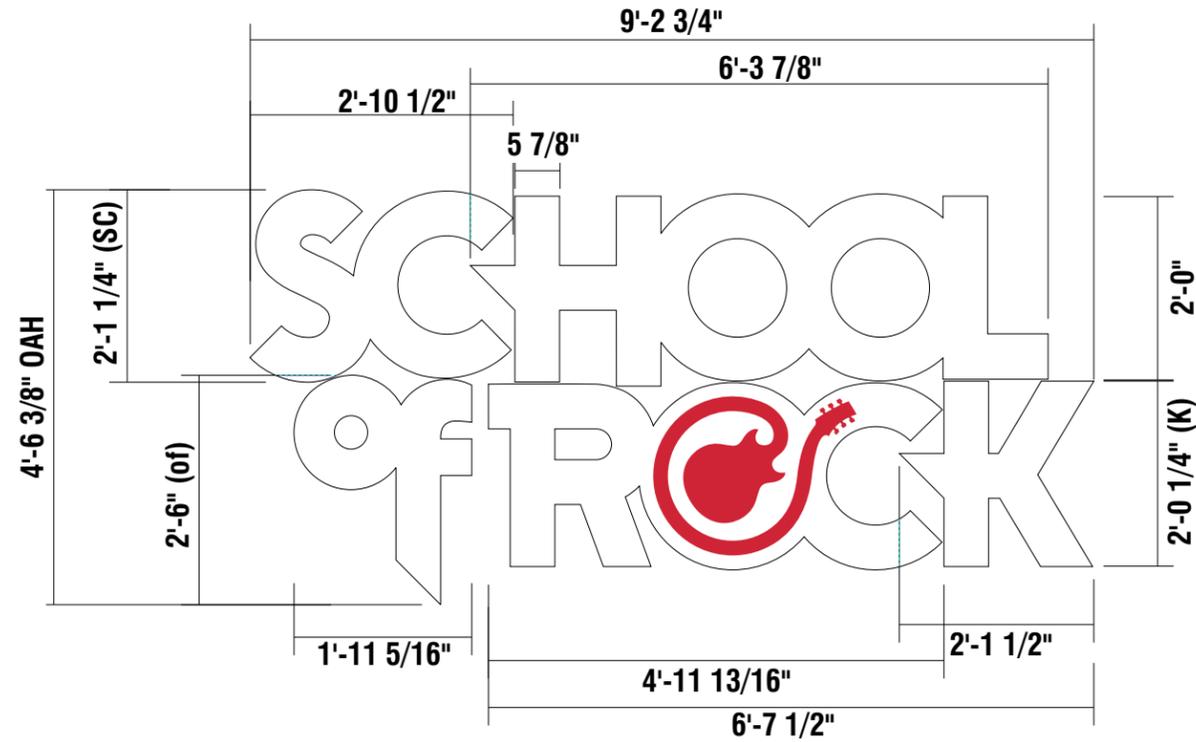
EXISTING CONDITION FRONT ELEVATION
SCALE: 1/8" = 1'-0"



Wall Area - West Elevation:
26' 6" x 42' = 1,113 sq ft

A PROPOSED FRONT ELEVATION - NEW LOOK
SCALE: 1/8" = 1'-0"

4' 7" x 9' 3" = 42.4 sq ft



A **SOR - 24 - W-STACK INTERNALLY ILLUM. CHANNEL LETTERS | ONE (1) SET REQ'D.**
 SCALE: 1/2"=1' 41.82 SQ.FT.

SCOPE OF WORK: MANUFACTURE & INSTALL ONE (1) INTERNALLY ILLUMINATED CHANNEL LETTER SET FLUSH MOUNTED TO BUILDING FASCIA.

LETTERS: FABRICATED 4" DEEP BLACK ALUMINUM RETURNS WITH .187 WHITE ACRYLIC FACES w/ FIRST SURFACE RED VINYL GRAPHICS AND 1" TRIMCAP BLACK.

ILLUMINATION: WHITE LEDs AND REMOTE POWER SUPPLIES.




***MANUFACTURING NOTE:** Plant to ship lap any face seams so light leaks and seams are not as visible*

***INSTALLATION NOTE:** Layout is an assembly of five (5) letter shaped cans.* Assembly should be installed with minimum space (.25") between cans to still allow trim cap/face install and service.

LOW VOLTAGE L.E.D. LIGHTING SYSTEM

U.L. LISTED CLASS 2 - CONFORMS TO U.L. 48 & NEC 600 CODE

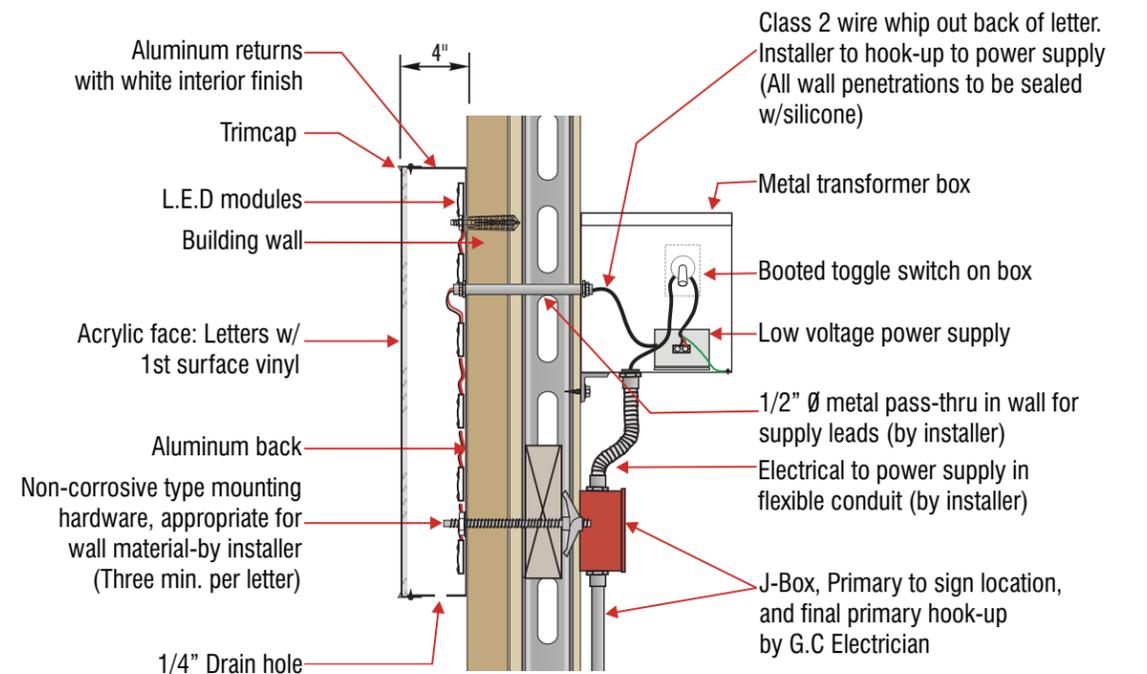

SECTION DETAIL - LED ILLUMINATED FLUSH MOUNTED LETTERS

N.T.S

ELECTRICAL REQUIREMENTS	
Total: T.B.D. Amps	REFER TO PAGE 1 FOR ADDITIONAL ELECTRICAL AND INSTALLATION INFORMATION & REQUIREMENTS
# of 120V, 20A Circuits Req'd T.B.D.	
ALL BRANCH CIRCUITS SHALL BE DEDICATED TO SIGNS (INCLUDING GROUND AND NEUTRAL) AND SHALL NOT BE SHARED WITH OTHER LOADS.	

INSTALLATION OF THIS SIGN SHALL CONFORM TO ARTICLE 600 OF THE NEC, UL 48 AND OR OTHER APPLICABLE LOCAL CODES, INCLUDING THE PROPER GROUNDING AND BONDING OF THE SIGN.

THE LOCATION OF THE DISCONNECT SWITCH, AFTER INSTALLATION SHALL COMPLY WITH ARTICLE 600.6(A) OF THE NEC.



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Client Approval/Date: *Janet L. Woodward*

Landlord Approval/Date: _____

Account Rep: JACK KIRKLAND

Project Manager: LAILA SAYLORS

Drawn By: Virgo S. Aragonese/chc

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