PRESS BOX FINISHES INTERIOR FINISH COLORS COLOR COTTON WALL LAMINATE ALUMINUM PEWTER VINYTERSE COVE GRAY ARMSTRONG EXCELON TILE COUNTERTOP EXTERIOR FINISH COLORS COLOR GRAY WHITE WINDOW FINISH COLORS VINYL SIDING COLOR SOPPLATE VINYL FRAMES WHITE

PRESS BOX C	PTIONS	
FILMING PLATFORM	YES	NO
HVAC	YES	NO
MAIN ELECTRICAL SERVICE	240V	208V
DATA/SOUND PACKAGE	YES	NO

DRAWING REVIEW	
OWNER / APPROVAL AGENT:	
PLEASE REVIEW THESE PLANS AND DETAILS FOR CONFORMANCE TO YOUR ORDER WITH DANT CLAYTON CORPORATION. MARK	
YOUR COMMENTS ON THE DRAWINGS, AND CHECK THE APPLICABLE APPROVAL BOX.	
APPROVED	
APPROVED AS NOTED	
REVISE AND RESUBMIT	
BY DATE	
TITLE	

PART NO.	SHEET	DESCRIPTION
	CP	COVER SHEET
	PB-1	FRAMING PLANS
	PB-2	SECTIONS AND DETAILS
	PB-3	ELECTRICAL PLAN
	PB-4	ELEVATIONS
	PB-5	LIFTING DIAGRAM

DRAWING INDEX





GAME READY PRESS BOX

MISSOURI

Project Number

Professional Seal

*BUILDING WILL NOT BE LOCATED IN A FLOOD PLAIN

APPROVAL DRAWINGS for LEES SUMMIT PARAGON STAR (GRPB) KANSAS CITY, MO PROJECT #48523

OCCUPIED SPACE = 240

DESIGN SPECIFICATIONS

F	ASTENING SCH	HEDULE
DING ELEMENT	FASTENER	NUMBER AND LOCATION
SOLE PLATE	15GA X 2 1/2" LONG	(4) DIRECT
CAP PLATE	GALVANIZED STAPLE 15GA X 2 1/2" LONG	(4) DIRECT
STUDS	GALVANIZED STAPLE #8X3" SCREW	12" O.C. DIRECT
ATE TO JOIST OR G	16d COMMON	16" O.C. (6" O.C. AT SHEAR WALLS)
CAP PLATE	15GA X 2 1/2" LONG	(2) 12" O.C. DIRECT
OISTS	16d COMMON	MIN. (3) DIRECT
EDGE RAIL	16d COMMON	MIN. (3) DIRECT
JOISTS TO PLATE	16d COMMON	MIN. (3) DIRECT
PROOF AND WALL HING (1/2" OR LESS) PROOF AND WALL HING (5/8" OR GREATER) PSUBFLOORING 3/4") BOARD ROOF AND WALL HING (1/2" OR LESS) BOARD ROOF AND WALL HING (5/8" OR GREATER) WALL (END) TO RAFTERS	15GA X 2 1/2" LONG GALVANIZED STAPLE 16GA X 1 1/2" LONG GALVANIZED STAPLE 16GA X 2" LONG GALVANIZED STAPLE 6d RING SHANK 16GA X 1 1/2" LONG GALVANIZED STAPLE 16GA X 2" LONG GALVANIZED STAPLE 16GA X 2" LONG GALVANIZED STAPLE 16d NAILS (1) #8X4 SCREW	
	CAP PLATE OISTS EDGE RAIL JOISTS TO PLATE BEAMS TO TRIMMERS D ROOF AND WALL HING (1/2" OR LESS) D ROOF AND WALL HING (5/8" OR GREATER) D SUBFLOORING 3/4") E BOARD ROOF AND WALL HING (1/2" OR LESS) E BOARD ROOF AND WALL HING (5/8" OR GREATER) WALL (END) TO RAFTERS TO TOP PLATES	GALVANIZED STAPLE 16d COMMON EDGE RAIL JOISTS TO PLATE BEAMS TO TRIMMERS D ROOF AND WALL HING (1/2" OR LESS) D ROOF AND WALL HING (5/8" OR GREATER) E BOARD ROOF AND WALL HING (1/2" OR LESS) E BOARD ROOF AND WALL HING (5/8" OR GREATER)

GENERAL STRUCTURAL INFORMATION 1. INTERIOR PARTITIONS TO BE CONSTRUCTED TO WITHSTAND A5 PSF

- ON HORIZONTAL FORCE. 2. INTERIOR WALL BOARD SHALL BE §" NOMINAL THICKNESS OR CONFORM TO SEC. 803. TESTED W/ MATERIALS SUSPENDED FROM NON-COMBUSTABLE BACKING.
 - 3. ALL LUMBER TO BE GRADED AND MARKED.
- 4. COMPRESSION PLATE REQUIRED TO ENSURE WOOD TO WOOD CONTACT AT BEARING WALL TO ROOF JOINT CONNECTIONS.
- 15. DADOS AND NOTCHING NOT TO OCCUR IN THE CENTER $\frac{1}{3}$ OF LENGTH OF WALL STUD.
- 6. EXTERIOR BRACING PROVIDED BY 1/2" CDX AND GLUED W/ APPROVED PVA GLUE AT ALL STUD TO END WALL CONNECTIONS.
- 7. APPROVED DATA PLATE AND STATE LABEL TO BE LOCATED ON MAIN ENTRANCE PANEL.
- 8. ON SITE STRUCTURE TO MEET THE FOLLOWING: -UPLIFT RATING FROM RIM JOIST TO SUPPORT AND RESIST 880 LBS @6'-0" O.C.
- -RATING OF HORIZONTAL CONNECTION TO BE A MINIMUM OF 1356 LBS @ 6'-0" O.C. -BEARING SUPPORT OF THE UNDERSTRUCTURE TO HAVE MIN.
- CAPACITY OF 8000 LBS @ 6'-0" O.C. 9. ATTIC VENTILATION SHALL NOT BE LESS THAN 1 / 150 OF THE
- HORIZONTAL AREA TO BE VENTILATED.
- 10. THE BUILDING EXTERIOR AND ALL FACILITIES WITHIN THE BUILDING SHALL BE IDENTIFIED WITH THE INTERNATIONAL SYMBOL V
- FREE PROVISIONS. BUILDING APPROACH SHALL HAVE A MINIMUM WIDTH OF 5' AND A GRADIENT OF NOT MORE THAN 1' IN 20'

11. BUILDER/DEALER SHALL BE RESPONSIBLE FOR ON SITE BARRIER

- 12. ALL LOCKS TO BE UNLOCKABLE FROM THE INTERIOR WITHOUT THE 10. SERVICE CONDUCTORS LOCATED WITHIN THE PERIMETER OF THE USE OF A KEY OR SPECIAL KNOWLEDGE.
- 13. CORROSION RESISTANT FLASHING AT TOP AND SIDES OF DOORS, WINDOWS AND AT ROOF PENETRATIONS.
- 14. ALL WINDOWS ARE OPERABLE AND PROVIDE AT LEAST 4% OF THE FLOOR AREA AS OPENABLE AND NATURAL VENTILATION
- \mid 15. ALL GLAZING WITHIN A 24" ARC OF VERTICAL DOOR EDGES IN THE \mid CLOSED POSITION TO BE SAFETY GLAZED AND MARKED SO.
- 16. INTERIOR FINISH SHALL BE CLASS A OR BETTER. 17. RESTROOM AND HANDICAPPED RESTROOM FACILITIES ARE TO BE PROVIDED IN AN ADJACENT BUILDING LOCATED ON THE SAME PROPERTY HAVING ADEQUATE FACILITIES TO HANDLE THE ADDITIONAL OCCUPANT LOAD CREATED BY THE ADDITION OF THIS BUILDING TO THE SITE. THE LOCAL OFFICIAL HAVING
- JURISDICTION SHALL VERIFY THE EXISTENCE OF THESE FACILITIES. 18. DISTANCE TO RESTROOM AND HANDICAPPED RESTROOM FACILITIES IS NOT TO EXCEED 500'
- 19. THE MINIMUM SEPARATION OF THE UNIT FROM ANY PROPERTY LINE OR ASSUMED PROPERTY LINE IS 15'.
- 12. THIS BUILDING DOES NOT CONTAIN PLUMBING FACILITIES. PLUMBING FACILITIES SHALL BE PROVIDED ON—SITE SUBJECT TO THE LOCAL AUTHORITY HAVING JURISDICTION.

GENERAL ELECTRICAL INFORMATION

- 1. ALL WIRING TO BE ENCASED IN THIN WALL EMT CONDUIT MIN. 12THHN COPPER WIRE OR MC CABLE.
- 2. ALL RECEPTACLES TO BE GROUNDING TYPE.
- 3. MAIN PANEL TO BE MARKED SUITABLE FOR USE AS SERVICE EQUIPMENT, AND TO BE EQUIPPED WITH BREAKER/FUSE TYPE OVER CURRENT PROTECTION.
- 4. PROPER THERMAL OVERLOAD PROTECTION TO BE PROVIDED FOR ALL MOTORS.
- . DISCONNECTING MEANS WITHIN SITE REQUIRED FOR ALL MOTORS.
- . WEATHERPROOF PROTECTION REQUIRED FOR ALL OUTDOOR LIGHTS, RECEPTACLES AND DISCONNECTS.
- . PROPER WORKING CLEARANCES TO BE PROVIDED AND MAINTAINED AROUND ALL ELECTRICAL EQUIPMENT.
- 8. ALL FLUORESCENT FIXTURES REQUIRE THERMAL PROTECTION AND PROPER CLEARANCES FROM INSULATION, ALSO APPLICABLE FOR INCANDESCENT FIXTURES.
- 9. EXIT LIGHTS (IF ELECTRIC) MUST BE FED FROM AN APPROVED EMERGENCY SERVICE CONNECTED AHEAD OF, BUT NOT WITHIN MAIN SERVICE DISCONNECTING MEANS ENCLOSURE, AND INSTALLED AS PER SERVICE REQUIREMENTS, OR BE BATTERY BACK UP TYPE UNITS.
- BUILDING SHALL BE INSTALLED PER NEC.
- 11. ELECTRICAL WIRING TO BE INSTALLED PER NEC.
- 12. ALL DATA/ TELECOMMUNICATION CONDUCTORS TO BE INSTALLED AND TERMINATED ON-SITE BY OTHERS.
- 13. ALL WIRING TO BE COPPER 0 TO 2,000 VOLTS, COMPLYING W/ ARTICLE 310, NEC AND NO SMALLER THAN #12, AWG, INSULATED CONDUCTORS SHALL NOT EXCEED THE CAPACITY RATINGS AS SCHEDULED IN TABLES 310. NEC AND PROVIDED AND COMPLYING CIRCUIT PROTECTION.

DISCLAIMERS

IT IS THE SOLE RESPONSIBILITY OF THE CUSTOMER TO VERIFY THAT THE APPROVAL DRAWINGS SATISFY LOCAL, STATE AND FEDERAL REGULATIONS. IT IS RECOMMENDED THAT THE DRAWINGS BE REVIEWED AND APPROVED BY LOCAL AUTHORITIES WITH JURISDICTIONAL AUTHORITY. REVISIONS AFTER REVIEW MAY RESULT IN CHANGE ORDERS FOR ADDITIONAL TIME AND/OR MONEY. THE APPROVAL DRAWINGS ARE <u>NOT</u> TO BE USED AS CONSTRUCTION DRAWINGS.

de la	ATE OF MISSOUR
REGIS	JEFFREY R. WALTON, JR. NUMBER
THE STATE OF THE S	E-29504
gist	8/24/2022

No.	Description	Date
1	DRAWINGS UPDATED PER STATE REVIEW	6/22/22
2		
3		
4		
5		
6		
7		
8		
9		
10		


Submittal Type	
Submitted Typo	
Sheet Title	
COVERSHEET	

Sheet number

Key Plan

DANT# 0275822

© 2019 DANT CLAYTON

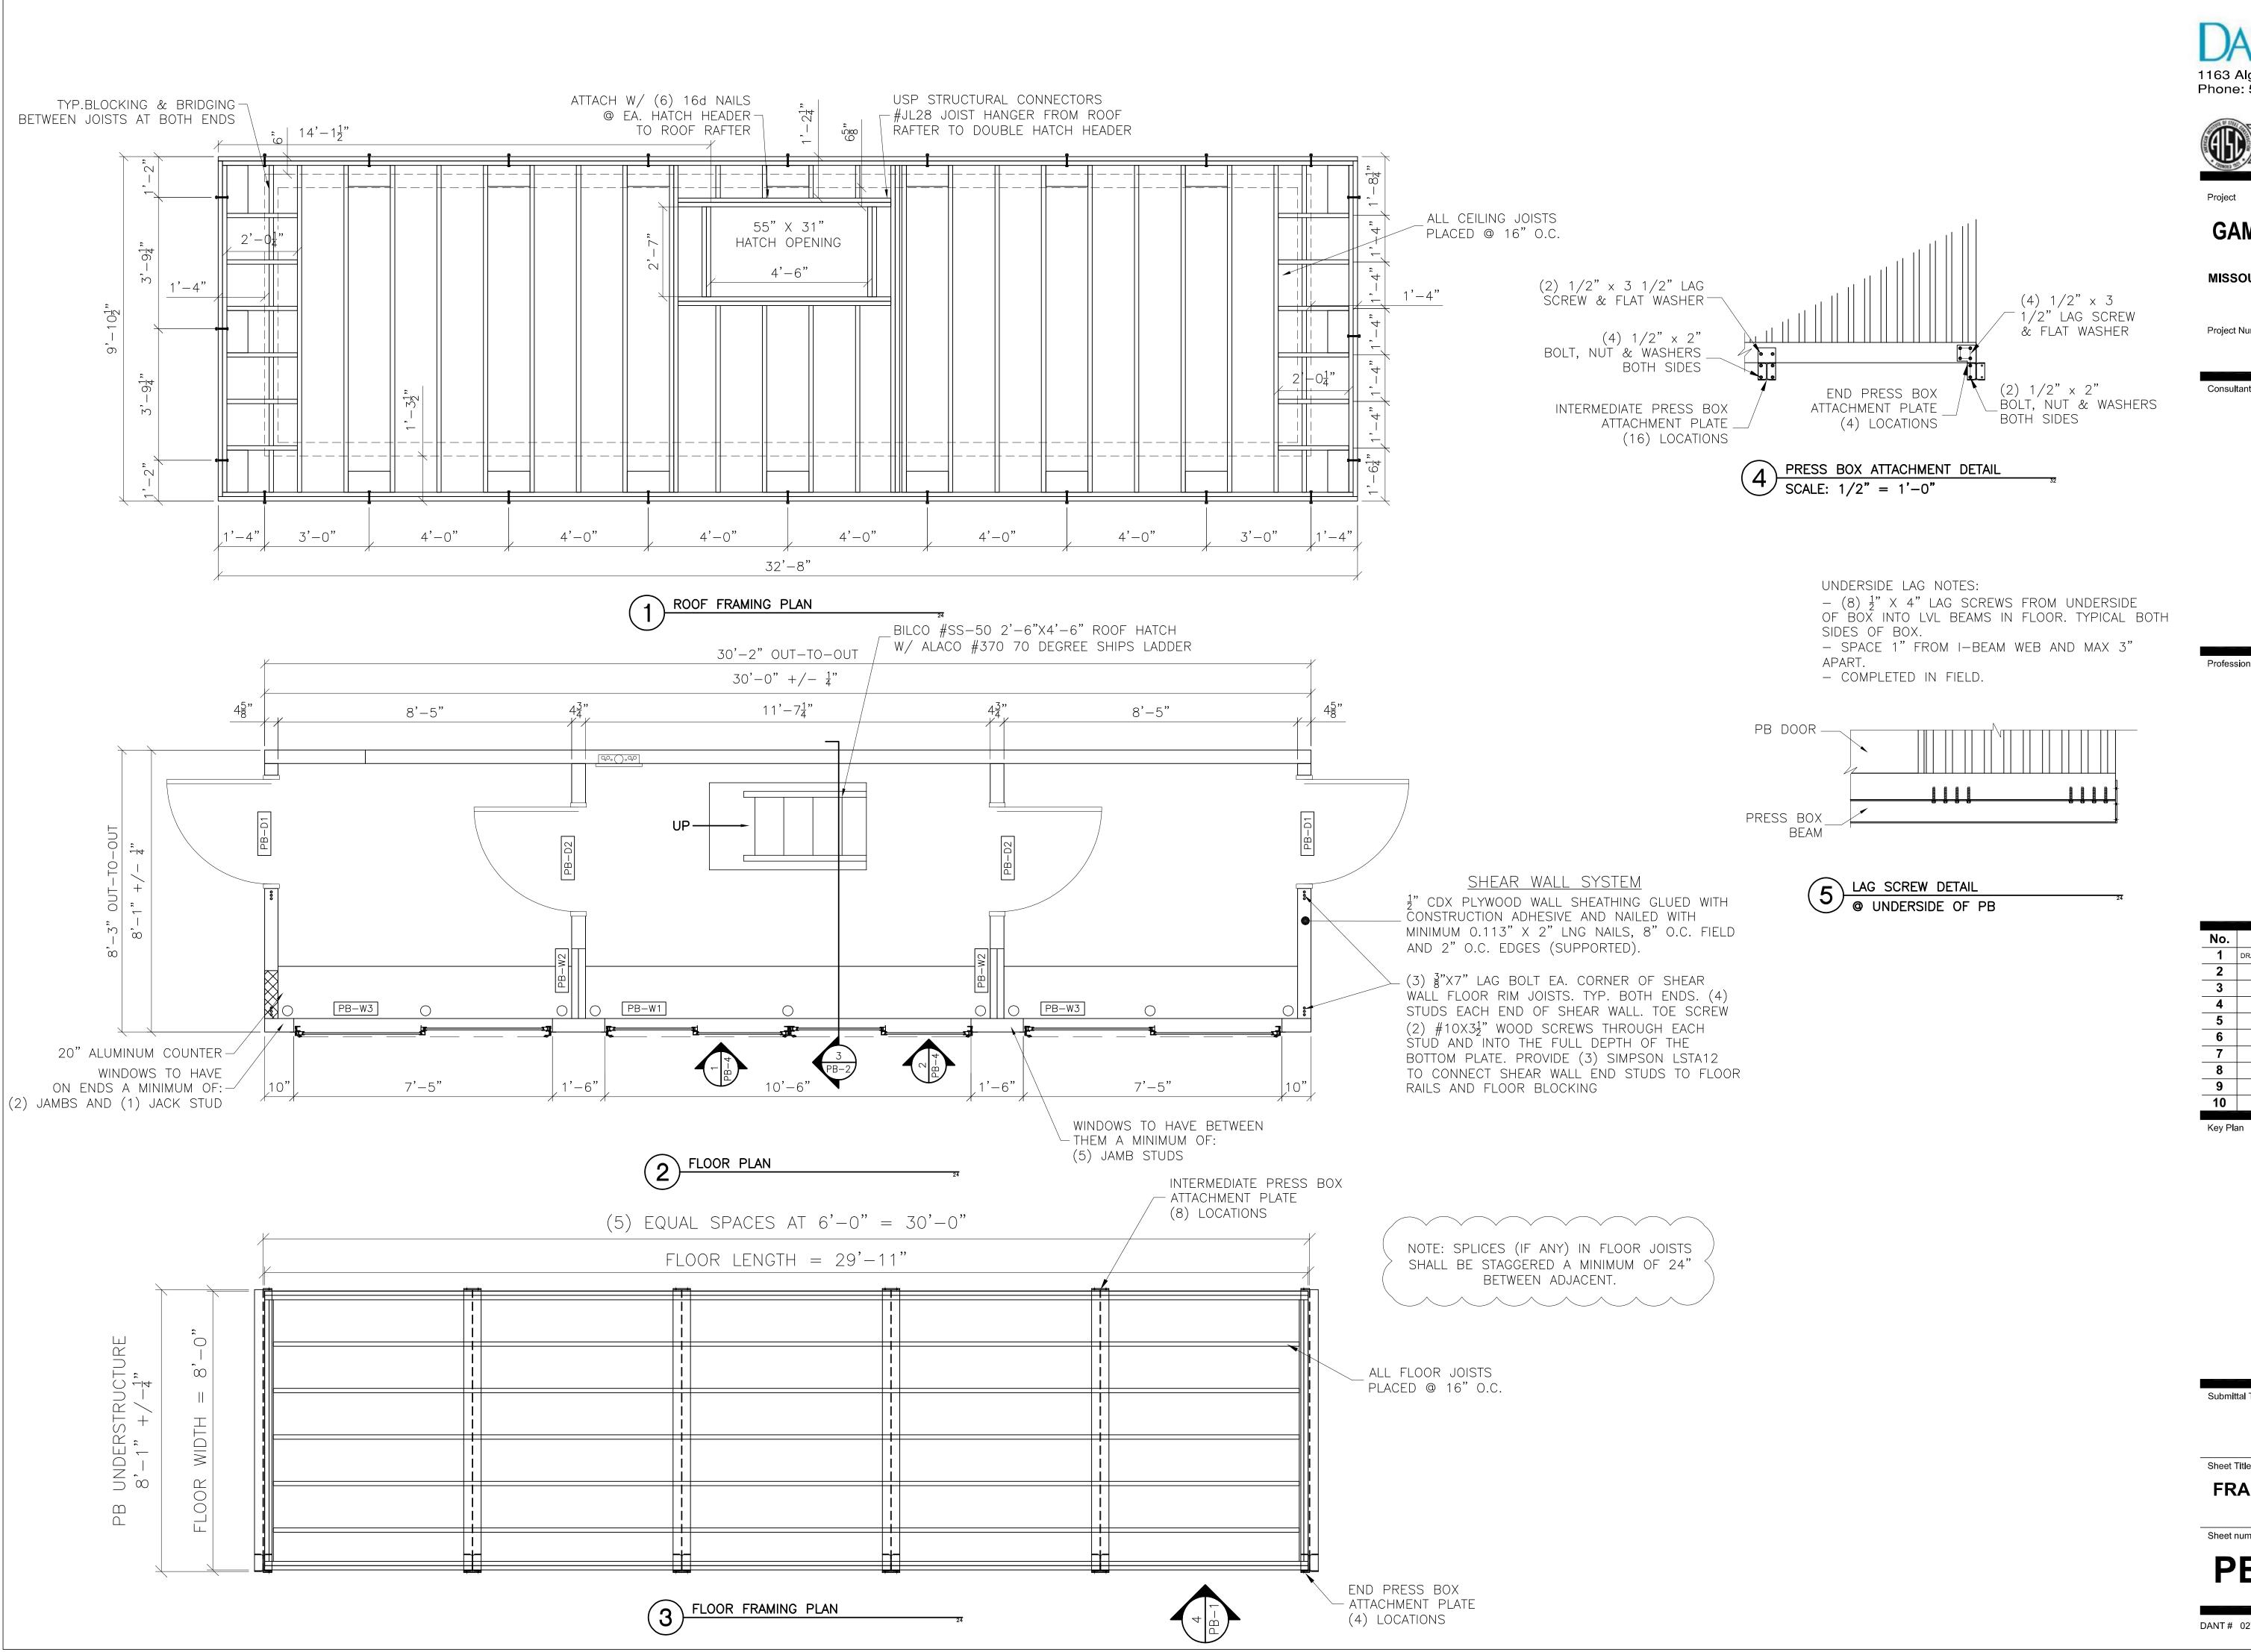

ELEVATE YOUR VIEW. 1163 Algonquin Pkwy, Louisville, KY 40208 Phone: 502-634-3626



GAME READY PRESS BOX

MISSOURI

Project Number

Consultants

Professional Seal



No.	Description	Date
1	DRAWINGS UPDATED PER STATE REVIEW	8/23/22
2		
3		
4		
5		
6		
7		
8		
9		
10		

Submittal Type

Sheet Title

FRAMING PLANS

Sheet number

PB-1

DANT # 0275822 © 2019 DANT CLAYTON





roject


GAME READY PRESS BOX


MISSOURI

Project Number

Consulta

Professional Seal

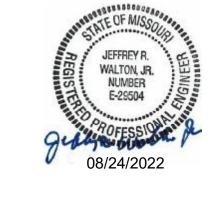

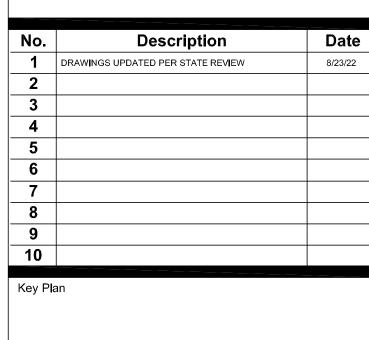

Submittal Type


Sheet Title

SECTIONS AND DETAILS

Sheet number

PB-2

DANT # 0275822 © 2019 DANT CLAYTON

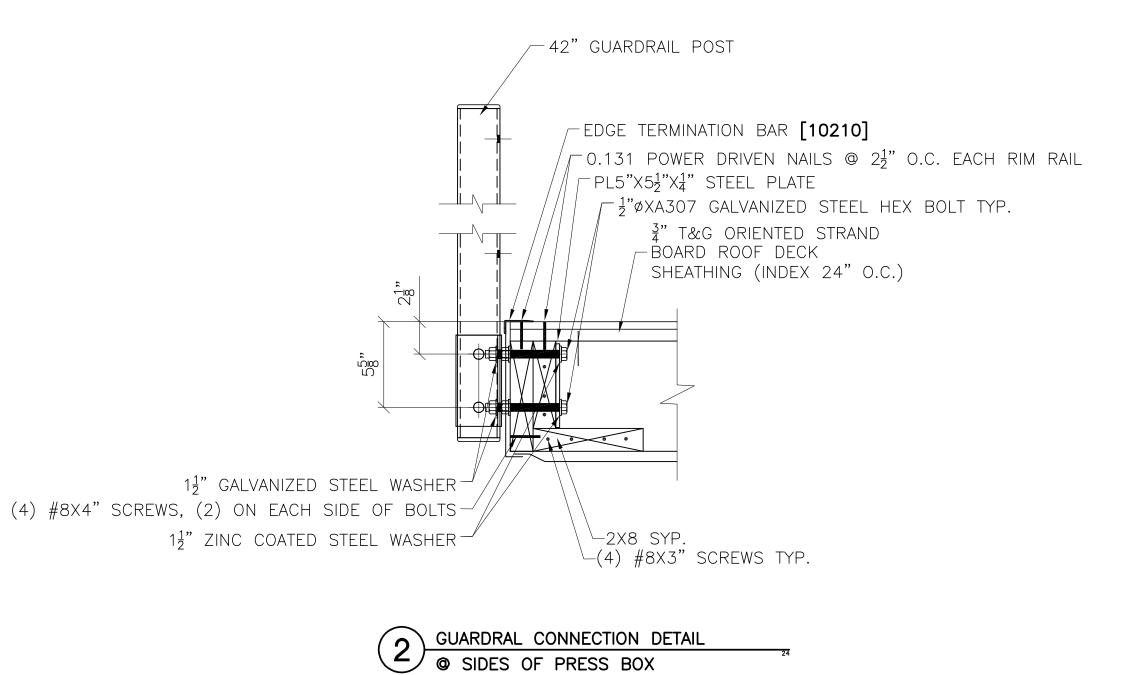



_EDGE TERMINATION BAR [10210] Γ 0.131 POWER DRIVEN NAILS @ $2\frac{1}{2}$ " O.C. EACH RIM RAIL Γ PL5"X5 $\frac{1}{2}$ "X $\frac{1}{4}$ " STEEL PLATE 7 mar januari FASTEN SHEATHING OVER BLOCK WITH (5) 0.131 POWER DRIVEN NAILS 3" T&G ORIENTED STRAND -BOARD ROOF DECK SHEATHING (INDEX 24" O.C.) -BLOCK (1) BAY AFTER WALL 11 GALVANIZED STEEL WASHER (4) #8X4" SCREWS, (2) ON EACH SIDE OF BOLTS -2X8 SYP. └(4) #8X3" SCREWS TYP. $1\frac{1}{2}$ " galvanized steel washer - $-(8)\#8X4\frac{1}{2}$ " SCREWS FROM DOUBLE TOP PLATE TO ROOF JOIST

GUARDRAL CONNECTION DETAIL

© FRONT OF PRESS BOX

ROOFING SYSTEM DECKING .060 POLYESTER REINFORCED SKID AND SPIKE RESISTANT PVC MEMBRANE FULLY ADHERED 3" T&G ORIENTED STRAND BOARD ROOF DECK SHEATHING (INDEX 24" O.C.) APPROVED UPLIFT CLIP 2X8 TRANSVERSE ROOF JOIST SYSTEM, #2 SYP, 16" O.C. 585 LB UPLIFT RATING R-19 FIBERGLASS BATT INSULATION W/ VAPOR BARRIER §" TYPE-X FIRE RATED GYPSUM CEILING BOARD, CLASS A RATED USP STRUCTURAL CONNECTORS -TAPED AND BEDDED WITH SPRAY TEXTURED FINISH **9** #RT7, 18 GA. REF. #2.5/H5 MASTIC FASCIA AND PERFORATED SOFFIT OR EQUAL (CONTINUOUS AROUND PERIMETER) RAILING TO BE INSTALLED ON-SITE BY DANT CLAYTON 1'-0" -(2) $\frac{1}{2}$ " GALVANIZED STEEL BOLTS 5" PERFORATED SOFFIT $1'-3\frac{1}{2}"$ ROOF IS NOT OCCUPIED (ATTIC CROSS VENTILATION) BY THE PUBLIC IT IS FOR OFFICIAL USE ONLY 1'-1" PERFORATED SOFFIT-WALL SYSTEM (2) $1\frac{3}{4}$ " X9 $\frac{1}{4}$ " LVL HEADER — SHIPS LADDER IS FOR ACCESS §" VINYL FACED GYPSUM INTERIOR WALL PANELS TO NON-OCCUPIED SPACE CLASS A RATED 2X4 WALL CONSTRUCTION, #2 SPF OR BETTER, 16" O.C. R-13 FIBERGLASS BATT INSULATION W/ VAPOR BARRIER " CDX PLYWOOD EXTERIOR WALL SHEATHING 20" ALUMINUM COUNTER — (INDEX 32/16)(3) SILL PLATES BUILDING WRAP WEATHER BARRIER 0.50 MASTIC 8" VERTICAL BOARD & BATTEN PREMIUM STEEL SUPPORT VINYL EXTERIOR SIDING BRACKET 32" O.C. BOTTOM STARTER TRIM WIREMOLD 5400 SERIES MULTI-CHANNEL SURFACE RACEWAY ON 48" X 🔎 X MAXXXXX MAXXXXX MAXXXXX MAXXXXX MAXXXXX MAXXXXX MAXXXXX SIDING TO START AT FLOORING SYSTEM FINISHED FLOOR ELEVATION 4" THERMOPLASTIC RUBBER BASE MOLDING BY ROPPE PRESS BOX UNDERSTRUCTURE $8'-1" +/- \frac{1}{4}"$ 1" ARMSTRONG VINYL COMPOSITION TILE FLOORING—CLASS A RATED SPACED AT 6'-0" O.C. ALONG LENGTH 3" STURDIFLOOR, UNDERLAYMENT GRADE, T&G FIR PLYWOOD FLOOR -W/ ANCHORING BRACKETS AT ENDS. DECKING (INDEX 24" O.C.) PRE-WORK, NOT A PART OF PRESS MEETS APA VOLUNTARY PRODUCT STANDARD PS1-09 BOX CONSTRUCTION. STRUCTURAL PLYWOOD /R-19 FIBERGLASS BATT INSULATION W/ VAPOR BARRIER (3) SECTION THRU PRESS BOX 2X6 LONGITUDINAL FLOOR CONSTRUCTION, #2 SYP. ,16" O.C. (SPLICED 16'-0" O.C. AND STAGGERED) $\frac{1}{2}$ " PLYWOOD UNDERBELLY (INDEX 32/16) W/ CONTINUOUS VENT 96" O.C. (MIN. 2) (PAINTED INUSTRIAL GRADE ASPHALT BASED BLACK)

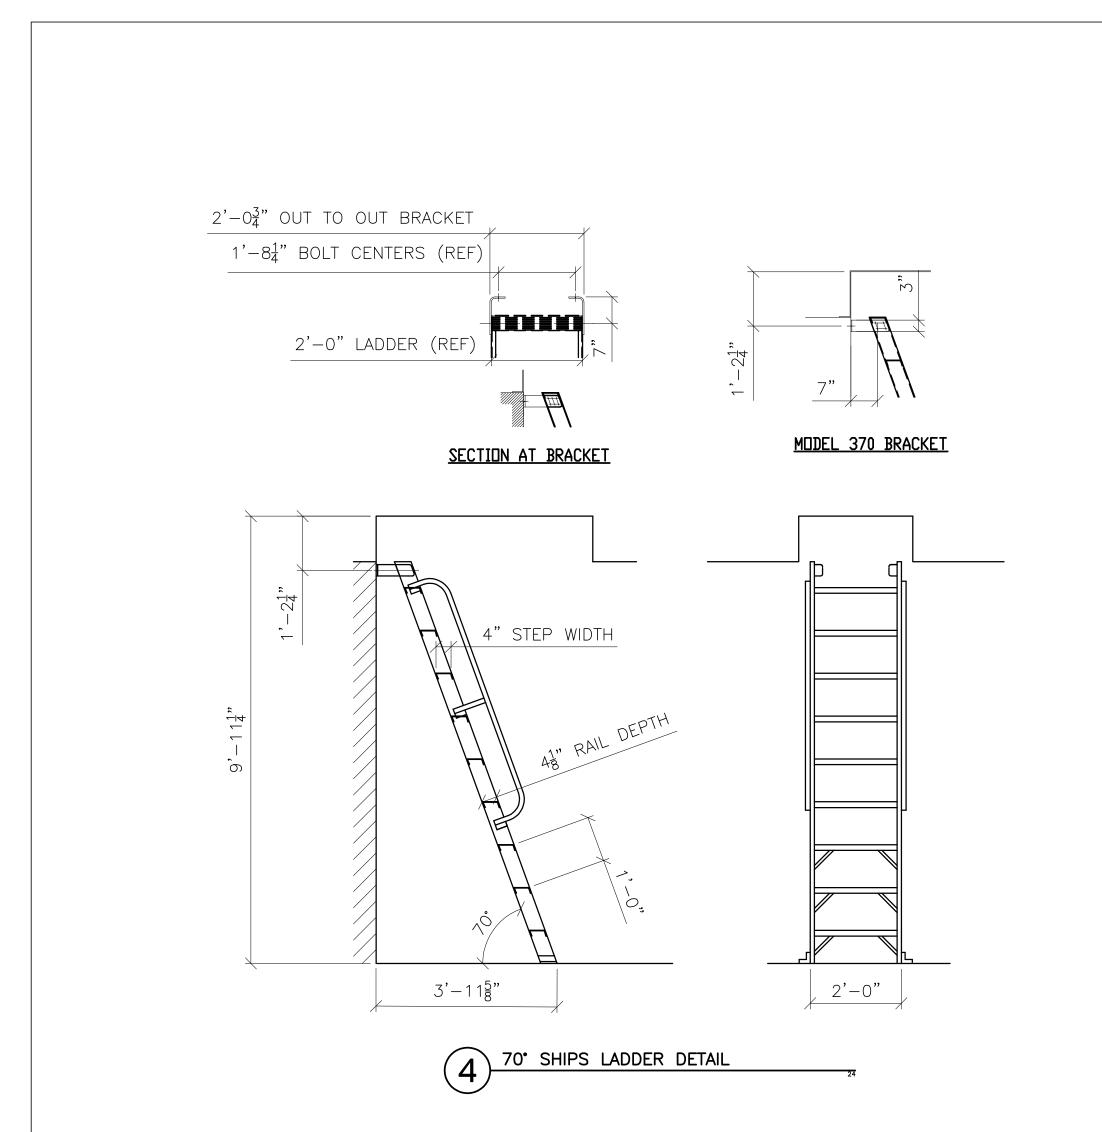

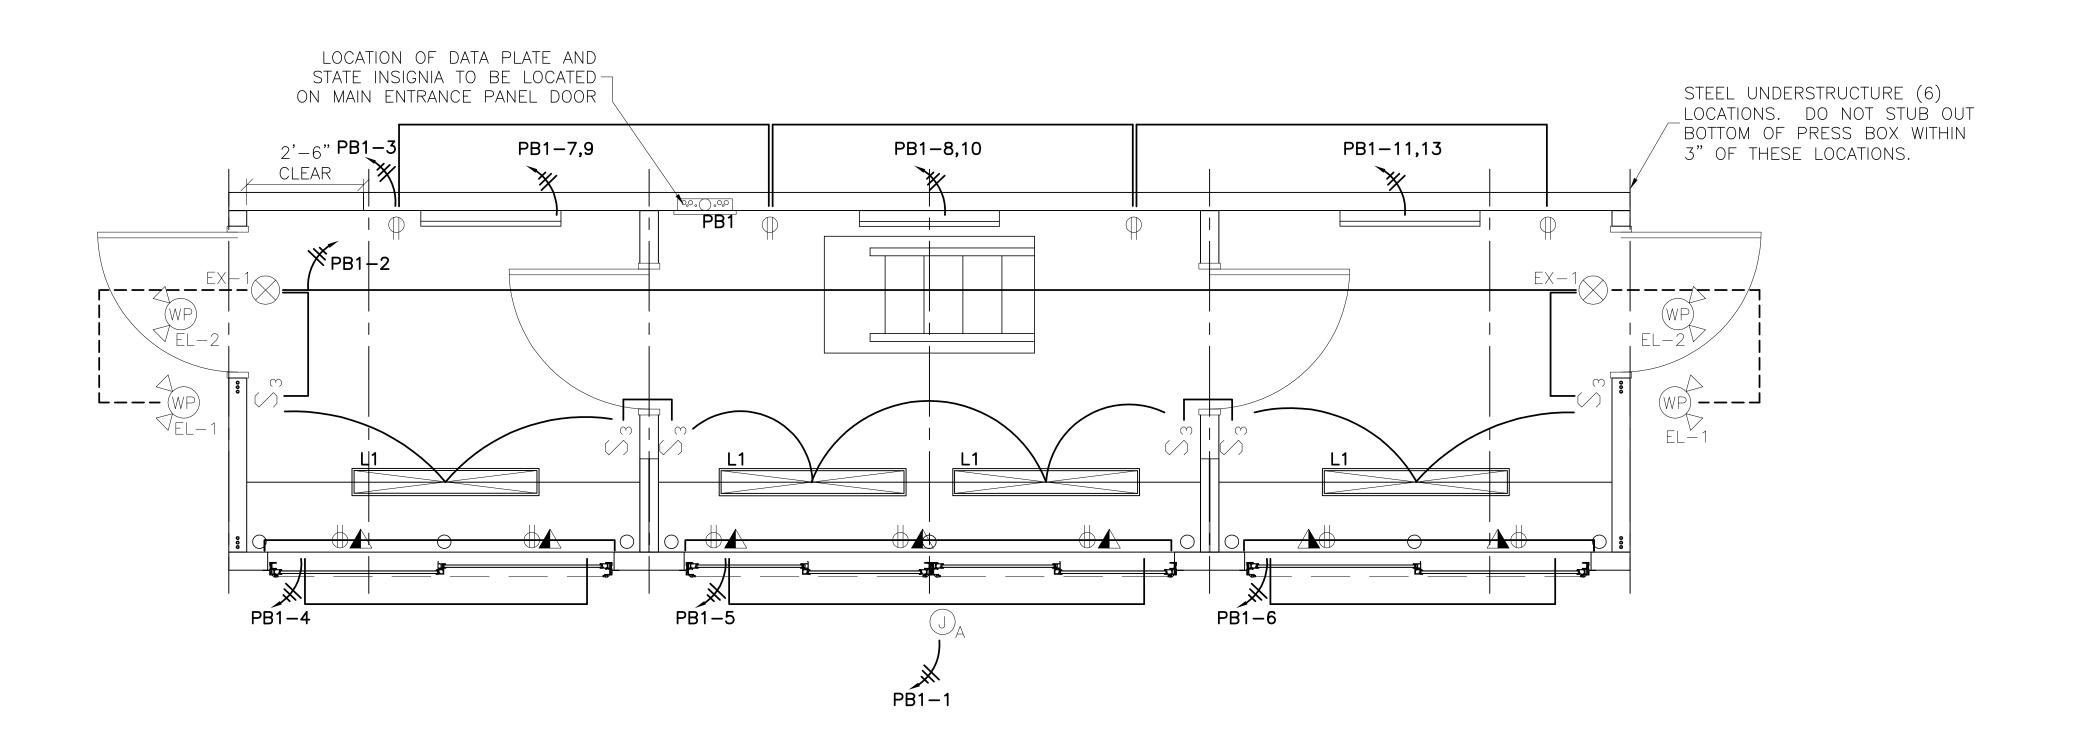

DANT CLAYTON

1163 Algonquin Pkwy, Louisville, KY 40208
Phone: 502-634-3626



Projec

GAME READY PRESS BOX

MISSOURI

Project Number

Consultants

Professional Seal



Description

DRAWINGS UPDATED PER STATE REVIEW

Date


8/23/22

NOTES:

- 1) THE UTILITY METER BASE & FEEDER SYSTEM TO BE PROVIDED BY OTHERS ON SITE, UNDER THE AUTHORITY OF THE LOCAL JURISDICTIONS.
- 2) CONNECTION OF ELECTRICAL SERVICE TO BE PERFORMED BY A LICENSED ELECTRICIAN. (BY OTHERS)
- 3) ALL NUMBERS ON ELECTRICAL CIRCUITS DESIGNATE FEED SIDE OF CIRCUIT.
- 4) ALL BRANCH CIRCUIT WIRING TO BE ENCASED IN THIN WALL EMT CONDUIT—MIN 12 THHN WIRE OR MC CABLE

PANEL PB1

	SCRIPTION: 120/240V SINGLE PH	•		ΠΖ Ι(JU AMP	WAIN	DISC	JININI	ECIII	NG BREAKER	
F E E	DER SIZE: #1 COPPER W/ #6	GRNL)								
FED	FROM:							_			
CKT		BKR	PL	WIRE	WATTS	WATTS	WIRE	PL	BKR	DESCRIPTION	CKT
1	ROOFTOP RECEPTACLE (GFCI)	20	1	12	1920	1088	12	1	20	PRESS BOX LIGHTING	2
3	PRESS BOX GENERAL RECEPT.	20	1	12	720	540	12	1	20	PRESS BOX WIRE-MOLD	4
5	PRESS BOX WIRE-MOLD	20	1	12	540	540	12	1	20	PRESS BOX WIRE-MOLD	6
7	 -BASEBOARD HEATER	20	2	12	750	750	12	2	20	 BASEBOARD HEATER	8
9	BASEBUARD HEATER	20			/30	730	12		20	DASEBOAND FILATEN	10
11	 -BASEBOARD HEATER	20	2	12	750						12
13	BASEBOAND HEATEN	20		12	750						14
15											16
17											18
19											20
21	SPARE	20	1					1	20	SPARE	22
23	SPARE	20	1					1	20	SPARE	24
		•	•		4680	2918	WATT	S			

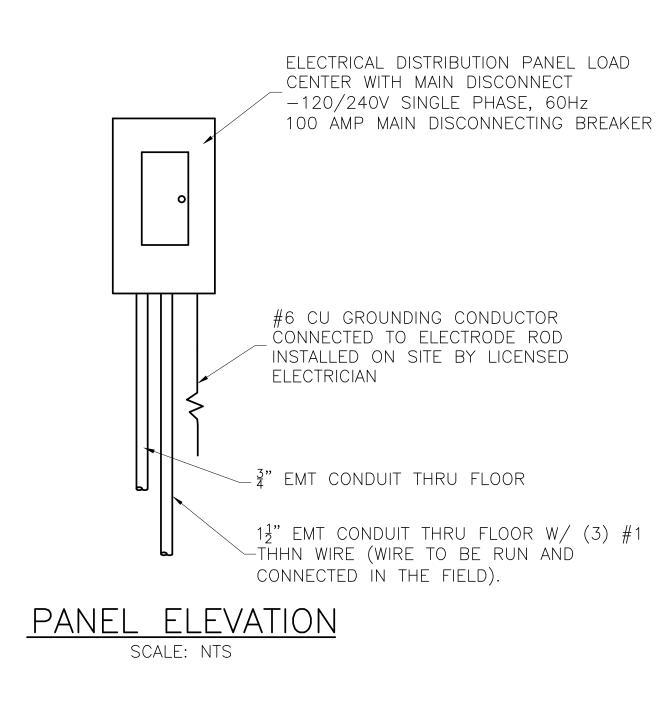

ELECTRICAL PLAN

SCALE: 1/2"=1'-0"

SYMBOL	DESCRIPTION	
L1	(2) 4' LINEAR LED LIGHT WITH PARABOLIC DIFFUSERS (17 WATT)	No. 1 DRAWINGS I 2 3
PB1	ELECTRICAL DISTRIBUTION LOAD CENTER W/ MAIN DISCONNECT-120/240V. SINGLE PHASE, 100 AMP CAPACITY, SQ. 'D' #Q0124M100 W/ (1) 1 1/2" CONDUIT THRU FLOOR100 AMP CAPACITY W/ (1) 3/4" CONDUIT THRU FLOOR	4 5 6 7 8
S_3	PASS & SEYMOUR #TM873 SPEC. GRADE, GROUNDING TYPE, 3-WAY SWITCH	9 10
EX-1	MORRIS SQUARE HEAD LED COMBO EXIT/EMERGENCY LIGHT. PRODUCT #73442	Key Plan
Φ	PASS & SEYMOUR CR20 SPEC. GRADE, GROUNDING TYPE, RECEPT GFI WHERE NOTED UP 18" UNLESS NOTED OTHERWISE	
	WIREMOLD #5400 SERIES ELECTRIC PLUG STRIPS W/ RECEPTS AND COMMUNICATION JACK COVERS 48" O.C. AND 1" CONDUIT THRU FLOOR AT END-UP 14"	
WP) EL-2	180-DEGREE WHITE OUTDOOR LED MOTION SECURITY LIGHT W/ DUSK TO DAWN SENSOR #DFI-5982-WH WALL MOUNTED ABOVE THE CENTER OF THE DOOR.	
WP) EL-1	LITHONIA #ELA-W-NX-N0806 REMOTE EMERGENCY LIGHT HEAD	Submittal Type
JA	ROOF ELECTRICAL ACCESS— 2X4 WATERPROOF FASCIA MOUNTED JUNCTION BOX WITH 3/4" EMT CONDUIT TO ENTRANCE PANEL FOR (FUTURE USE) (WEATHER-RESISANT RECEPTACLES IN WEATHERPROOF ENCLOSURES TO BE INSTALLED ON GUARD RAILS BY EC)	Sheet Title ELECTE
	BERKO #BKOC2543W 3'-0" ELECTRIC BASEBOARD HEATER WITH THERMOSTAT	Sheet number PB-

2		
3		
4		
5		
6		
7		
8		
9		
10		
Key Pla	an	
,		
Submi	ttal Type	
Sheet	Title	
	ECTRICAL PLAN	
CL	LOTRICAL PLAIN	

DANT # 0275822

© 2019 DANT CLAYTON





GAME READY PRESS BOX

MISSOURI

Project Number

Consultants

Professional Seal




LOCATION OF DATA PLATE AND STATE INSIGNIA TO BE LOCATED STEEL UNDERSTRUCTURE (6)
LOCATIONS. DO NOT STUB OUT
BOTTOM OF PRESS BOX WITHIN
3" OF THESE LOCATIONS. ON MAIN ENTRANCE PANEL DOOR PB1-8,10 PB1 PB1-2 6" EX-1PB1-5 PB1-11

> ELECTRICAL PLAN SCALE: 1/2"=1'-0"


- 1) THE UTILITY METER BASE & FEEDER SYSTEM TO BE PROVIDED BY OTHERS ON SITE, UNDER THE AUTHORITY OF THE LOCAL JURISDICTIONS.
- 2) CONNECTION OF ELECTRICAL SERVICE TO BE PERFORMED BY A LICENSED ELECTRICIAN. (BY OTHERS)
- 3) ALL NUMBERS ON ELECTRICAL CIRCUITS DESIGNATE FEED SIDE OF CIRCUIT.
- 4) ALL BRANCH CIRCUIT WIRING TO BE ENCASED IN THIN WALL EMT CONDUIT-MIN 12 THHN WIRE OR MC


PANEL PB1


	CRIPTION: 120/240V SINGLE PH DER SIZE: #1 COPPER W/ #6				7 (1411	1717 (111					
		GINID									
FED	FROM:						ı	ı			
CKT		BKR	PL	WIRE	WATTS	WATTS	WIRE	PL	BKR	DESCRIPTION	CKT
1	ROOFTOP RECEPTACLE (GFCI)	20	1	12	1920	1088	12	1	20	PRESS BOX LIGHTING	2
3	PRESS BOX GENERAL RECEPT.	20	1	12	720	540	12	1	20	PRESS BOX WIRE-MOLD	4
5	PRESS BOX WIRE-MOLD	20	1	12	540	7500	10	2	20	70NELINE 11/40 11NIT	6
7	70151115 111/40 111117	00	(1.0	7500	3500	12	2	20	ZONELINE HVAC UNIT	8
9	ZONELINE HVAC UNIT	20	2	12	3500						10
11	PRESS BOX WIRE-MOLD	20	1	12	540						12
13											14
15											16
17											18
19											20
21	SPARE	20	1					1	20	SPARE	22
23	SPARE	20	1					1	20	SPARE	24
					7220	5128	WATT	S	<u> </u>		l

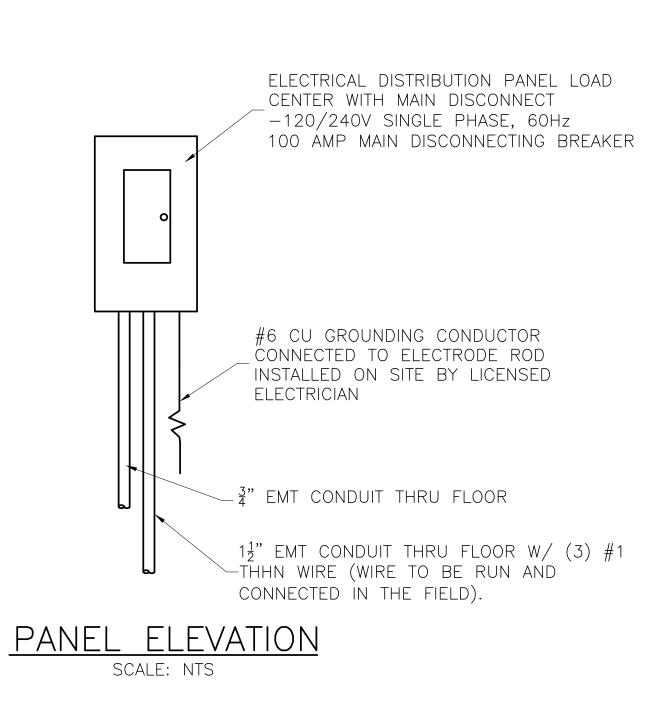

		No.	Description
SYMBOL	DESCRIPTION		DRAWINGS UPDATED PER STATE REVIEW
OTIVIDOL			
L1		4	
	(2) 4' LINEAR LED LIGHT WITH PARABOLIC DIFFUSERS (17 WATT)	5	
		6	
	FLECTRICAL DISTRIBUTION LOAD CENTER W/ MAIN DISCONNECT 120/240V		
[00 () 00]	ELECTRICAL DISTRIBUTION LOAD CENTER W/ MAIN DISCONNECT-120/240V. SINGLE PHASE, 100 AMP CAPACITY, SQ. 'D' #Q0124M100	9	
PB1	W/ (1) 1 1/2" CONDUIT THRU FLOOR——100 AMP CAPACITY	10	
	W/ (1) 3/4" CONDUIT THRU FLOOR	Key P	lan
23	PASS & SEYMOUR #TM873 SPEC. GRADE, GROUNDING TYPE, 3-WAY SWITCH		
EX-1	MORRIS SQUARE HEAD LED COMBO EXIT/EMERGENCY LIGHT. PRODUCT #73442		
Φ	PASS & SEYMOUR CR20 SPEC. GRADE, GROUNDING TYPE, RECEPT GFI WHERE NOTED UP 18" UNLESS NOTED OTHERWISE	_	
	WIREMOLD #5400 SERIES ELECTRIC PLUG STRIPS W/ RECEPTS AND COMMUNICATION JACK COVERS 48" O.C. AND 1" CONDUIT THRU FLOOR AT END-UP 14"		
WP) EL-2	180-DEGREE WHITE OUTDOOR LED MOTION SECURITY LIGHT W/ DUSK TO DAWN SENSOR #DFI-5982-WH WALL MOUNTED ABOVE THE CENTER OF THE DOOR.	Subm	ittal Type
(WP)	LITHONIA #ELA-W-NX-N0806 REMOTE EMERGENCY LIGHT HEAD	 Sheet	Title
EL-1	LITTONIA # LLA W INA INOUGO INLIVIOTE LIVILINGEINOT LIGITI TILAD	EL	ECTRICAL PLAN
	ROOF ELECTRICAL ACCESS— 2X4 WATERPROOF FASCIA MOUNTED JUNCTION BOX		
	WITH 3/4" EMT CONDUIT TO ENTRANCE PANEL FOR (FUTURE USE)	Sheet	number
(J) _A	(WEATHER—RESISANT RECEPTACLES IN WEATHERPROOF ENCLOSURES TO BE INSTALLED ON GUARD RAILS BY EC)		B-3
	ZONELINE #AZ61H09D 3.5 KW ELECTRIC WALL MOUNT	_ r	D-3
	HEAT PUMP UNIT-UP 6"		
	9,400 BTU COOL	DANT#	0275822 © 2019 DANT
	8,300 BTU HEAT		

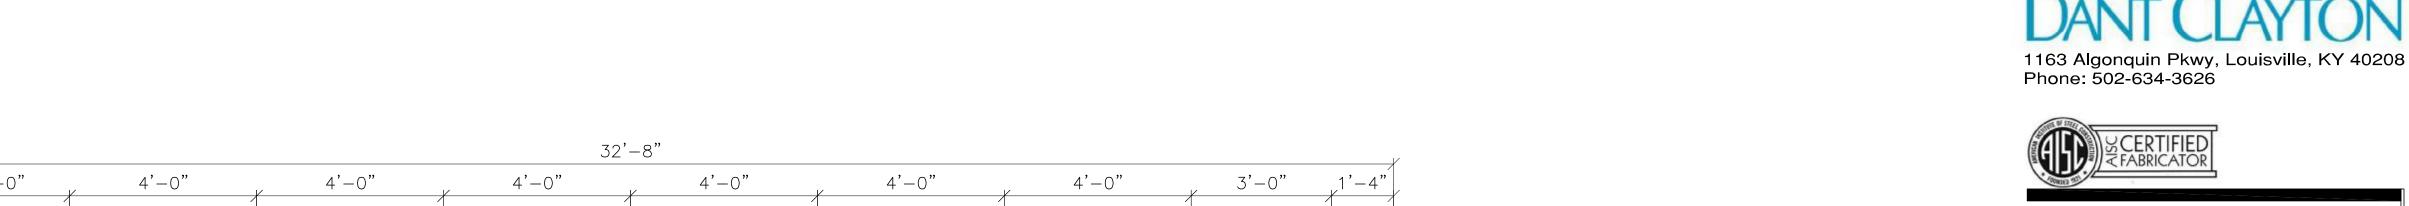

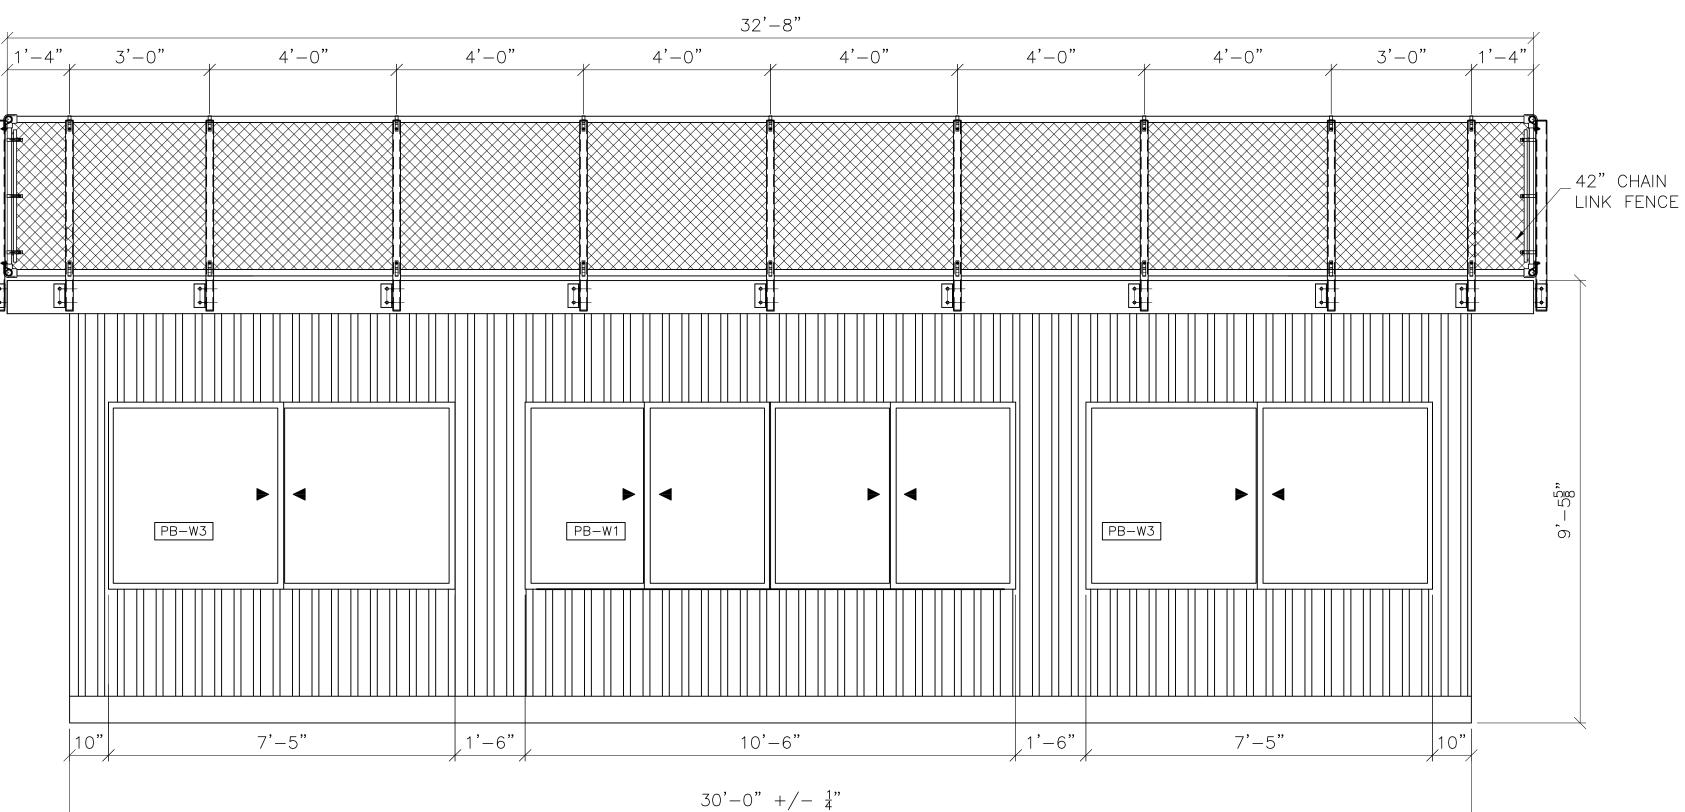

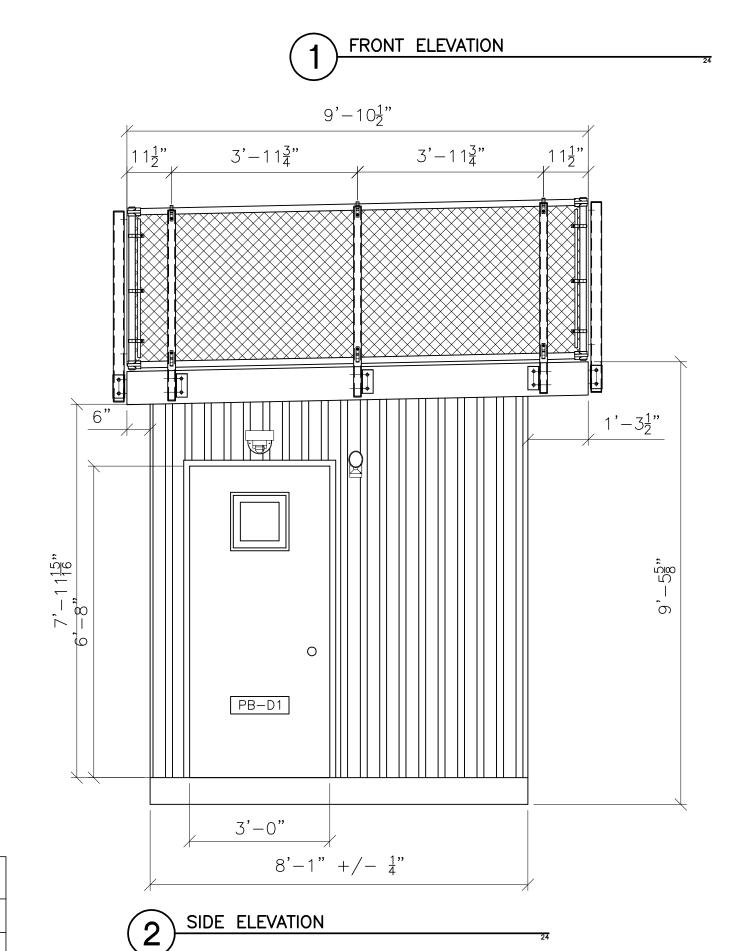

DOOR SCHEDULE							
DOOR					FRAME		
KEY	WIDTH	HEIGHT	THICKNESS	TYPE	MATERIAL	MATERIAL	FIRE RATING
PB-D1	3'-0"	6'-8"	$0'-1\frac{3}{4}"$	3	STEEL	WOOD	
PB-D2	3'-0"	6'-8"	$0'-1\frac{1}{2}"$	1	WOOD	WOOD	

PB-D1 - INSULATED VINYL-FACED STEEL CLAD W/ WOOD JAMBS; 16" INSULATED/TEMPERED LITE, ALUMINUM THRESHOLD, VINYL WEATHER STOPS, STAINLESS STEEL HINGES AND HEAVY-DUTY RETENTION CHAINS. DOORS EQUIPPED WITH COMMERCIAL LEVER-HANDLED KEYED LOCKSETS.

PB-D2 - SOLID-CORE STAINED BIRCH PRE-HUNG INTERIOR DOOR W/ MATCHING WOOD JAMB AND CASING 12" PAIR MORTISED BUTT HINGES, AND LEVER HANDLED LOCKSET.

(ALL DOORS EQUIPPED W/ LEVER HANDLE LOCKSETS)
*NOTE — DOORS INSTALLED PER MANUFACTURERS INSTALLATION DETAILS

WINDOW SCHEDULE							
KEY	WIDTH	HEIGHT	TYPE	FRAME	U-FACTOR	SHGC	
' ' '	10'-6"	4'-0"	DOUBLE SLIDER	VINYL	.29	.29	
PB-W2	2'-03"	3'-6"	GLASS ONLY	N/A	N/A	N/A	
PB-W3	7'-5"	4'-0"	DOUBLE SLIDER	VINYL	.29	.29	

PB-W1 - SOFT-LITE "BARRINGTON DSL7 HS", DOUBLE HORIZONTAL SLIDER WINDOWS W/ EXTRUDED

VINYL FRAMES, AAMA STRUCTURAL RATING, W/ 3" INSULATED LOW-E, ARGON FILLED TEMPERED

GLASS W/ REMOVABLE INSECT SCREENS.

PB-W2 - TEMPERED SAFETY GLASS WINDOW. INSERTED INTO PARTITION WALLS AT SAME HEIGHT AS HEADER.

*NOTE - GLAZING DESIGN PRESSURE = 22 PSF MINIMUM
WINDOWS INSTALLED PER MANUFACTURERS INSTALLATION DETAILS

GAME READY PRESS BOX				
MISSOURI				
Project Number				
Consultants				

ELEVATE YOUR VIEW.

Professional Seal

Key Plan




No.	Description	Date
1	DRAWINGS UPDATED PER STATE REVIEW	8/23/22
2		
3		
4		
5		
6		
7		
8		
9		
10		

ı	
	Submittal Type
_	
_	
	Sheet Title
	ELEVATIONS

Sheet number

PB-4

DANT # 0274906 © 2019 DANT CLAYTON

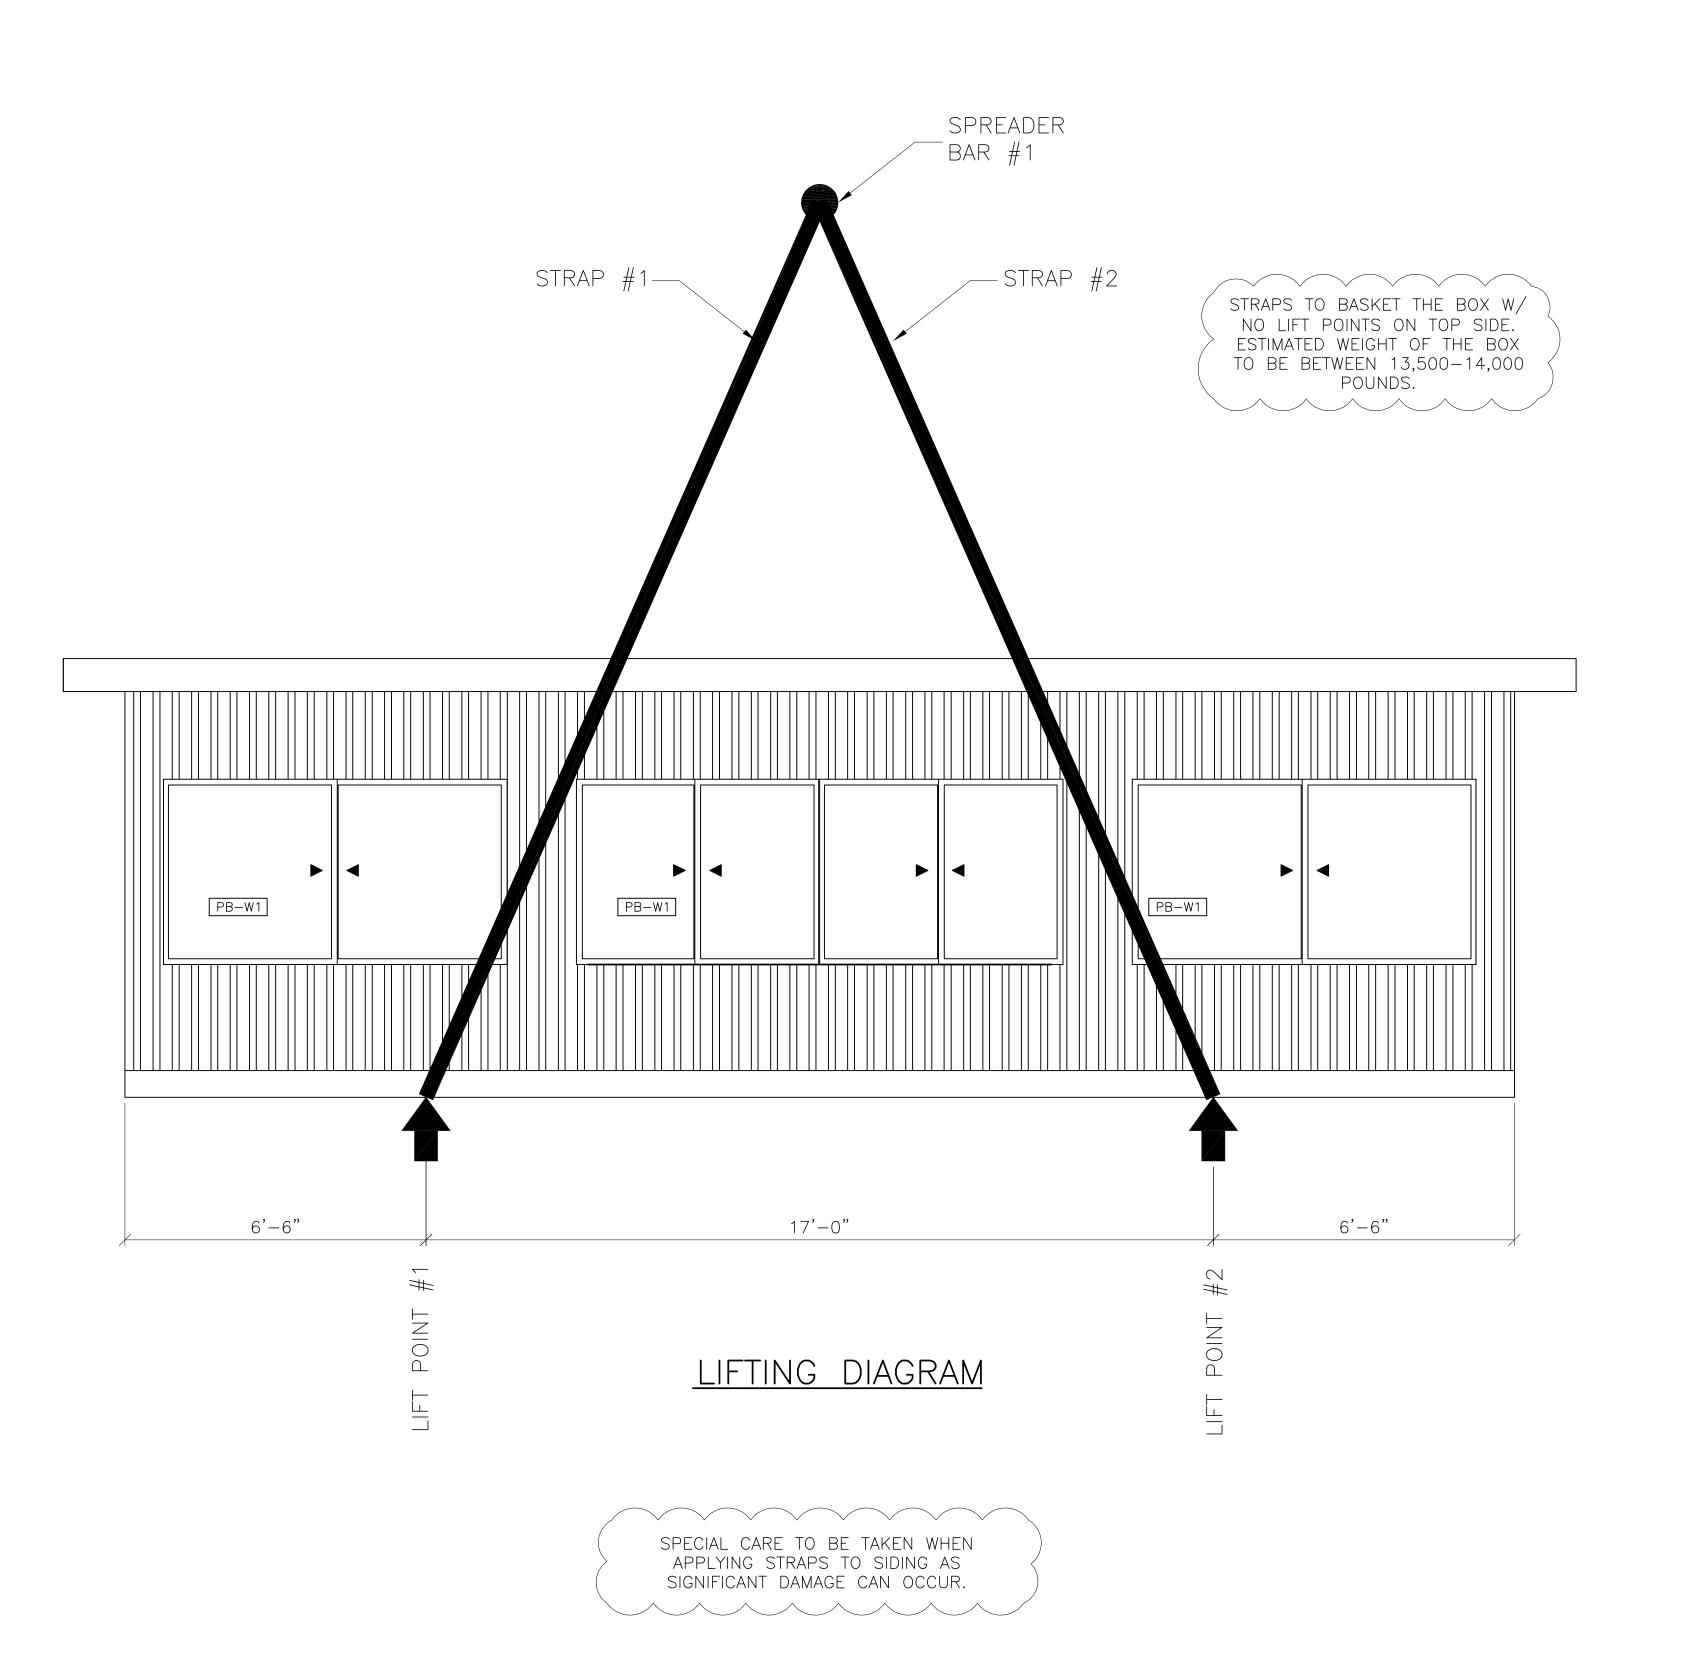





Project

GAME READY PRESS BOX

MISSOURI

Project Number

Consultants

Professional Seal



No.	Description	Date
1	DRAWINGS UPDATED PER STATE REVIEW	8/23/22
2		
3		
4		
5		
6		
7		
8		
9		
10		

Key

Submittal Type

Sheet Title

LIFTING DIAGRAM

Sheet number

PB-5

DANT# 0275822

© 2019 DANT CLAYTON