MARKET STREET CENTER PUBLIC SANITARY SEWER IMPROVEMENTS

IN THE CITY OF LEE'S SUMMIT, JACKSON COUNTY, MO

GENERAL NOTES:

UTILITY COMPANIES:

3025 SOUTHEAST CLOVER DRIVE

LUCAS WALLS (LUCAS.WALLS@SUG.COM)

PHILLIP INGRAM (PHILLIP.INGRAM@KCPL.COM)

RON DEJARNETTE (RON.DEJARNETTE@KCPL.COM)

STORM SEWER (PUBLIC WORKS DEPARTMENT)

MR. CLAYTON ANSPAUGH (CA4089@ATT.COM)

SANITARY SEWER & WATER (WATER UTILITIES DEPT.) (816)-969-1900

MISSOURI GAS ENERGY

LEE'S SUMMIT, MO 64082

1300 HAMBLEN ROAD LEE'S SUMMIT, MO 64081

220 SE GREEN STREET LEE'S SUMMIT, MO 64063

1200 SE HAMBLEM ROAD,

LEE'S SUMMIT, MO 64081

AT&T (913) 383-4929

OVERLAND PARK, KANSAS 66207

9444 NALL AVENUE

EVERGY

THE DESIGN AND CONSTRUCTION OF THE PUBLIC SANITARY SEWER FACILITIES SHALL BE GOVERNED BY THE CITY OF LEE'S SUMMIT, MISSOURI DESIGN CRITERIA AND TECHNICAL SPECIFICATIONS, LATEST EDITIONS.

(816) 969-2218

(816) 347-4339

(816) 347-4316

(816) 969-1800

(913) 383-4849-FAX

SANITARY SEWER PROPOSED SANITARY EXISTING SANITARY SEWER MARKET STREET CENTER nmitcrest Dr TRACT A SW State Route 150 SW State Route 150

INDEX

COVER SHEET


SANITARY SEWER PLAN & PROFILE **EROSION CONTROL & RESTORATION**

SANITARY SEWER DETAILS

SS-5 PAVEMENT DETAILS

Accepted Record Drawings

These plans have been reviewed for accuracy and are accepted for basic conformance to the approved construction drawings.

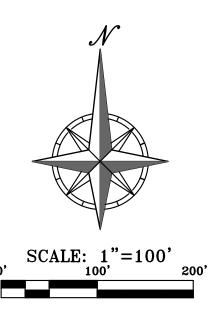

"AS-BUILT"

DATED: 9-30-22 BY: SNH

PREPARED & SUBMITTED BY: PHELPS ENGINEERING, INC. 1270 N. WINCHESTER

OLATHE, KANSAS 66061



JUDD D. CLAUSSEN, MISSOURI P.E.#29850

DATE

151ST STREET NW1/4 159TH STREET VICINITY MAP

SEC. 11-14-23

Know what's **below**. Call before you dig.

VISUAL INDICATIONS OF UTILITIES ARE AS SHOWN. UNDERGROUND LOCATIONS SHOWN, AS FURNISHED BY THEIR LESSORS, ARE APPROXIMATE AND SHOULD BE VERIFIED IN THE FIELD AT THE TIME OF CONSTRUCTION. FOR ACTUAL FIELD LOCATIONS OF UNDERGROUND UTILITIES CALL 811.

Proposed Sanitary Sewer
Existing Sanitary Sewer


LEGEND OF SYMBOLS

SHEET



PROFILE \RY SANITA

SHEET

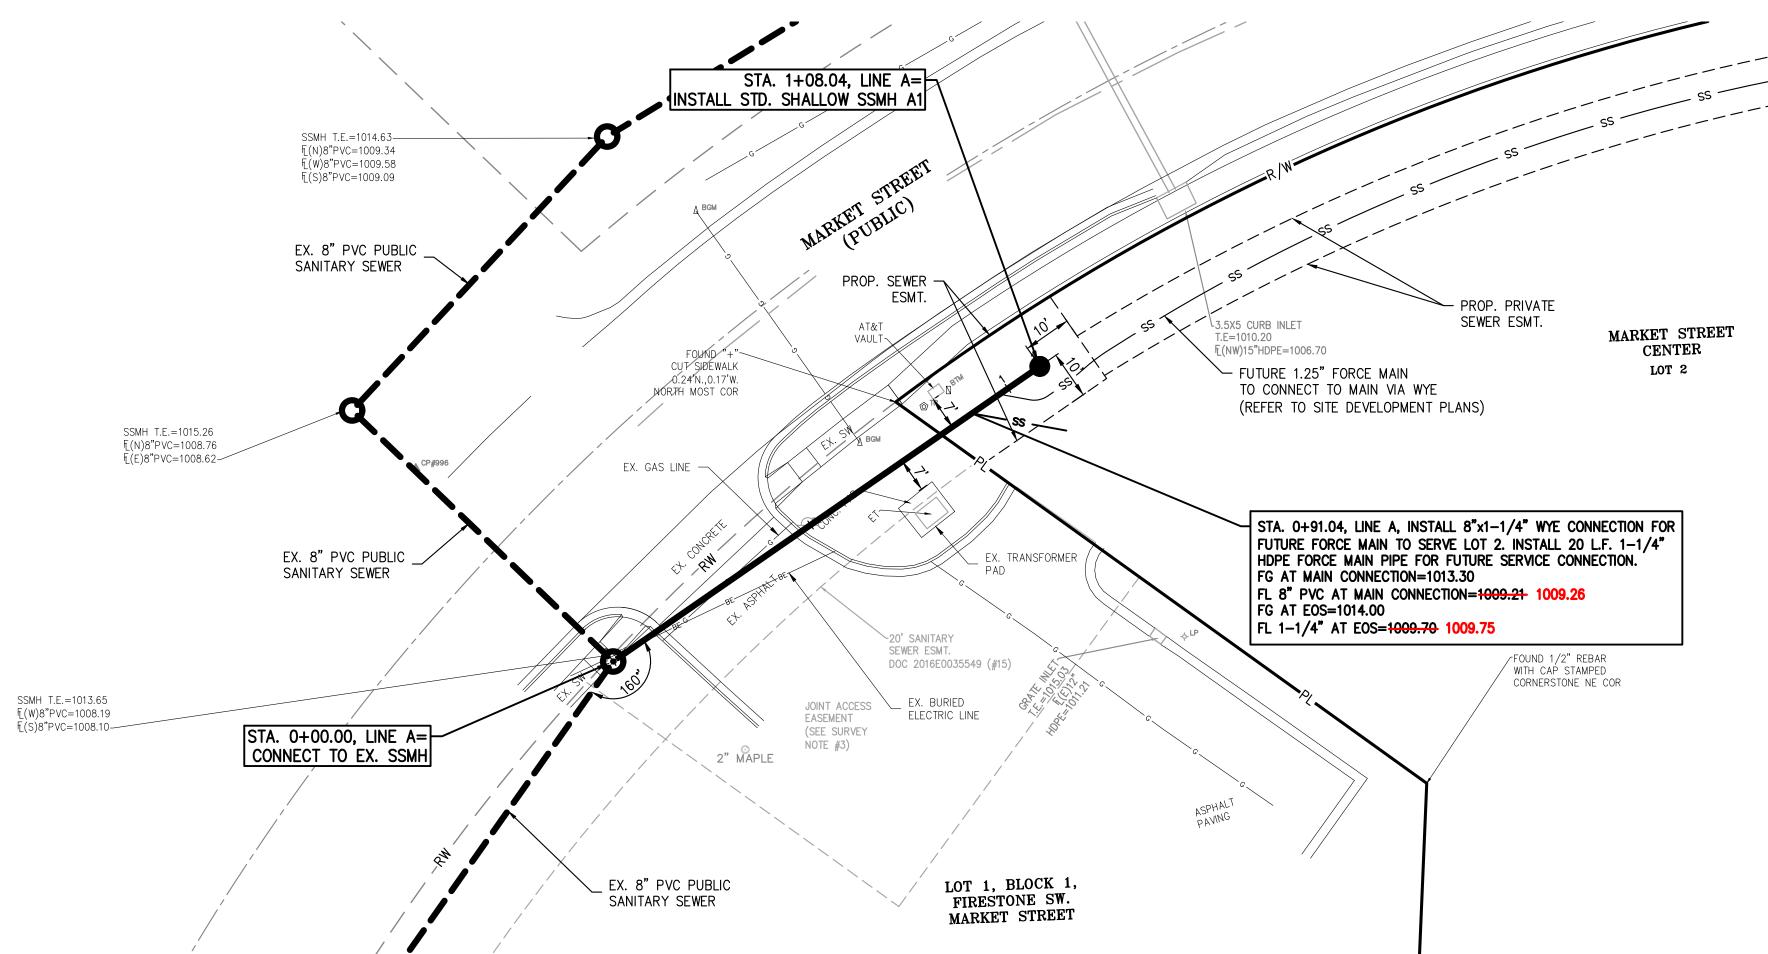



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"AS-BUILT"

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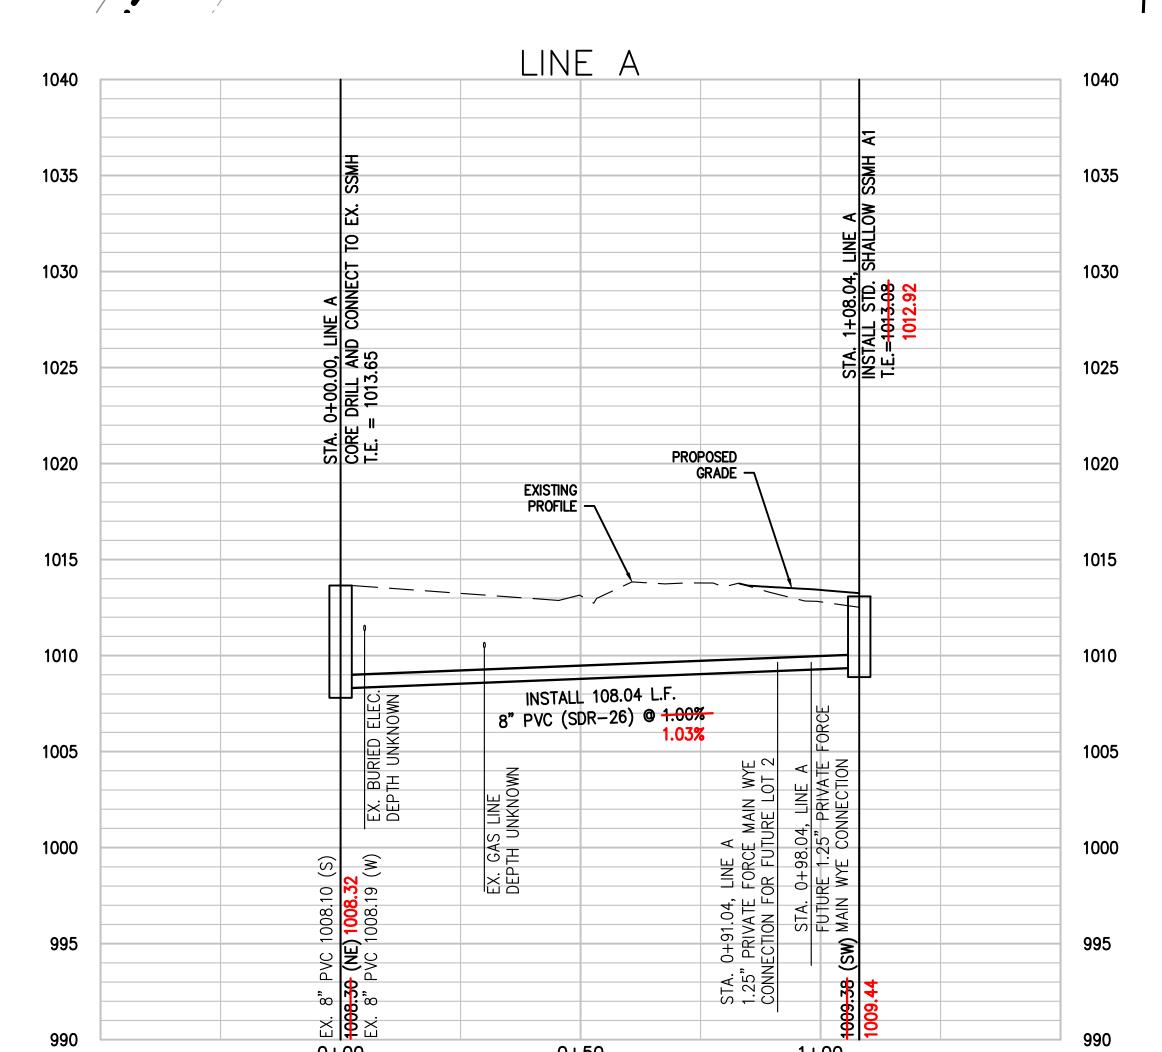
SCALE: 1"=20' HORIZ.

1"= 5' VERT.

MANHOLE CONNECTION NOTE:

1. THE EXISTING MANHOLE WALL SHALL BE CORE DRILLED.


2. A FLEXIBLE PIPE—TO—MANHOLE CONNECTOR SHALL BE INSTALLED AS SHOWN IN THE STANDARD DRAWINGS.



0+50

1+00

0+00

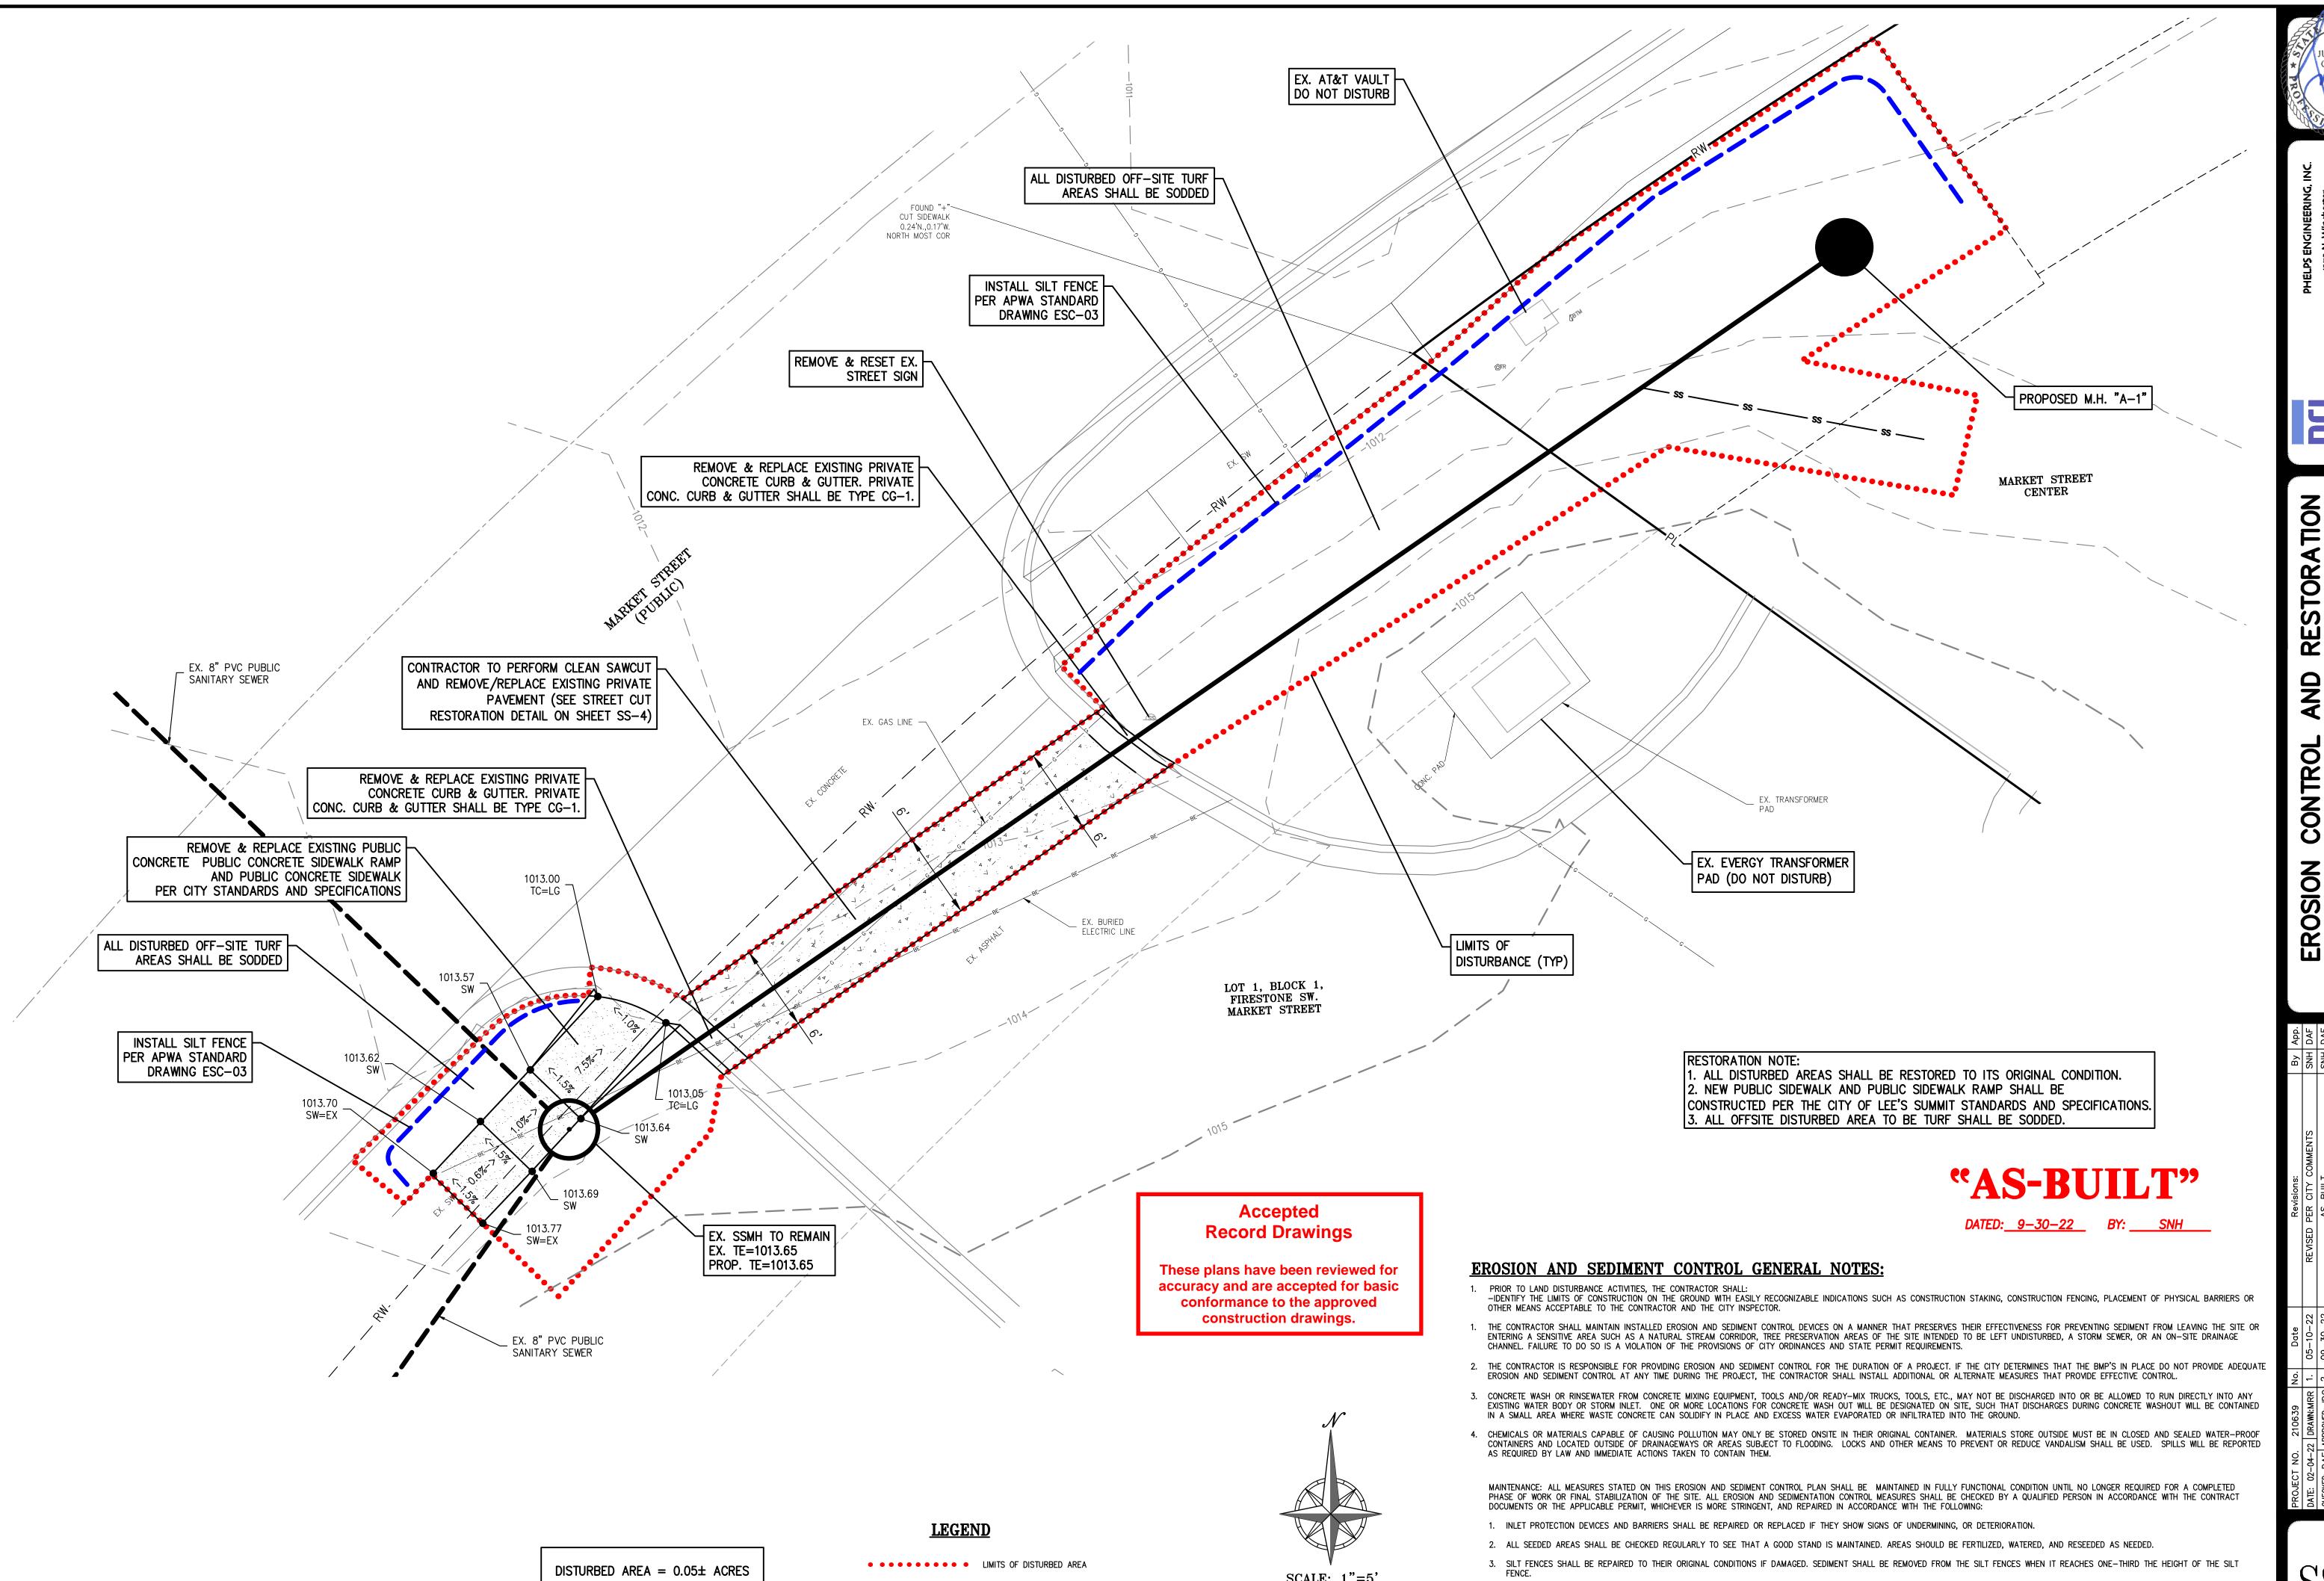

PROPOSED SILT FENCE

RESTORA


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4. THE CONSTRUCTION ENTRANCES SHALL BE MAINTAINED IN A CONDITION WHICH WILL PREVENT TRACKING OR FLOW OF MUD ONTO PUBLIC RIGHTS-OF-WAY. THIS MAY REQUIRE PERIODIC TOP


5. THE TEMPORARY PARKING AND STORAGE AREA SHALL BE KEPT IN GOOD CONDITION (SUITABLE FOR PARKING AND STORAGE). THIS MAY REQUIRE PERIODIC TOP DRESSING OF THE TEMPORARY

DRESSING OF THE CONSTRUCTION ENTRANCES AS CONDITIONS DEMAND.



- . ALL SEWER STUBS SHALL BE CONSTRUCTED TO PROPERTY LINE OR 10' MINIMUM FROM THE MAIN, WHICHEVER IS GREATER. WHERE SIDEWALKS ARE PRESENT, CONTRACTOR SHALL EXTEND SERVICE LINE UNDER EXISTING SIDEWALK TO TWO FEET BEYOND.
- 2. IMPERVIOUS TRENCH CHECKS SHALL BE PLACED ON BUILDING SEWER STUBS (AT LEAST 5' AWAY FROM THE SANITARY SEWER MAIN). 3. TRENCH CHECKS ON THE BUILDING SEWER STUBS SHALL EXTEND 6" BELOW THE BOTTOM OF THE PIPE. LENGTH SHALL BE A MINIMUM OF 12". THE HEIGHT OF THE TRENCH CHECK SHALL EXTEND 12" ABOVE THE TOP OF THE PIPE. THE WIDTH OF THE TRENCH CHECK SHALL BE THE WIDTH OF THE TRENCH.
- 4. SEE SPECIFICATION SECTION 2100 FOR SEWER MAIN BEDDING AND BACKFILL. 5. #12 GAUGE GREEN INSULATED COPPER TRACER WIRE SHALL BE INSTALLED. TRACER WIRE TERMINAL BOXES SHALL BE INSTALLED DIRECTLY ABOVE THE SEWER SERVICE OR AS DETERMINED BY THE ENGINEER. 6. FOR SERVICES, TRACER WIRE SHALL RUN FROM THE WYE AND TERMINATE IN A FLUSH MOUNTED TRACER BOX WITH A GREEN CAST IRON LOCKABLE TOP. WIRE SHALL BE TAPED OR TIED TO THE PIPE AT 5' INTERVALS.
- 7. TRACER WIRE BOX SHALL BE INSTALLED WITHIN 1.0' OF PROPERTY LINE. 8. THE TRACER WIRE SHALL REMAIN CONTINUOUS TO THE GREATEST EXTENT POSSIBLE. SPLICES IN THE TRACER WIRE SHOULD BE MADE WITH SPLIT BOLT CONNECTORS. WIRE NUTS SHALL NOT BE USED. A WATER-PROOF CONNECTION IS

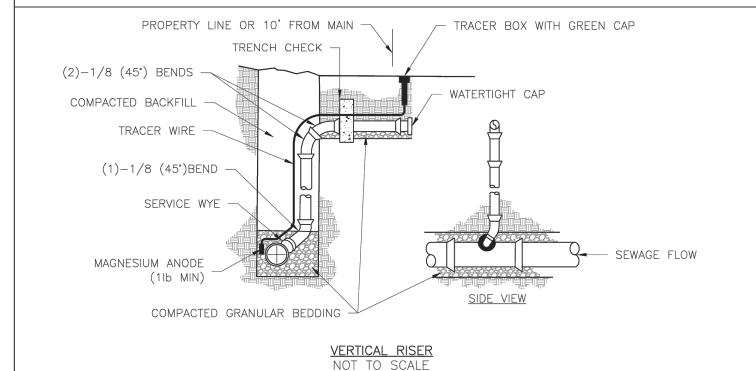NECESSARY TO PREVENT CORROSION.	
LEE'S SUMMIT Date: 12/20 Drawn By:	2015
LEE 3 3UIVIIVIII Drawn By:	MJF
M I S S O U R I	y: DL
PUBLIC WORKS ENGINEERING DIVISION 220 SE GREEN STREET LEE'S SUMMIT, MO 64063	
SANITARY SEWER STUB DETAIL SA	SAN-1

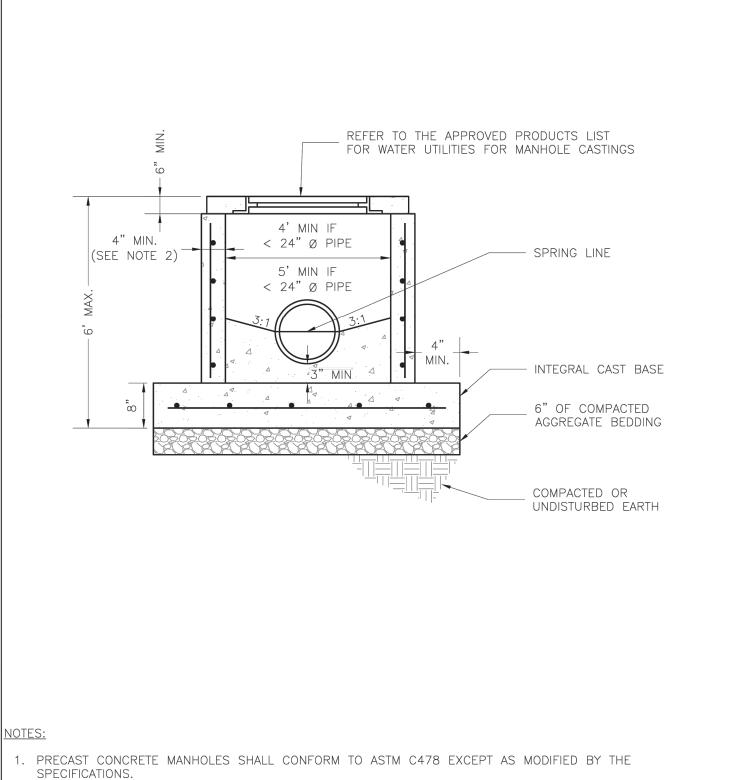

STANDARD SHALLOW SANITARY PRECAST MANHOLE

MISSOURI PUBLIC WORKS ENGINEERING DIVISION 220 SE GREEN STREET LEE'S SUMMIT, MO 64063	Checked By: DL	MISSOURI PUBLIC WORKS ENGINEERING DIVISION 220 SE GREEN STREET LEE'S SUMMIT. MO 64063	Checked By: DL	
LEE'S SUMMIT	Date: 12/2015 Drawn By: MJF	LEE'S SUMMIT	Date: 02/2013 Drawn By: MJF	
5. REFER TO THE APPROVED PRODUCTS LIST FOR WATER UTILITIES FOR MANHOLE GASE 6. PROVIDE STEPS AS SHOWN ON THE APPROVED PRODUCTS LIST FOR MANHOLE DEPT	HS GREATER THAN 4'.			
3. WATERPROOFING SHALL BE REQUIRED ON THE OUTSIDE OF MANHOLES. THE WATERPROOFING SHALL CONSIST OF A TOTAL DRY FILM THICKNESS OF NOT LESS THEN 14 MILS OF BITUMINOUS COATING. 4. THE FILL CONCRETE FLOW CHANNEL FOR SIDE BRANCHES SHALL BE PLACED TO PROVIDE A SMOOTH TRANSITION INTO THE FLOW LINE.		EXISTING MANHOLE		
SPECIFICATIONS. 2. A WALL THICKNESS NOT LESS THAN ONE—TWELFTH (1/12) OF THE INSIDE DIAMETER IS GREATER SHALL BE USED.	R OR 4", WHICHEVER	TOP OF MH BASE		
NOTES: 1. PRECAST CONCRETE MANHOLES SHALL CONFORM TO ASTM C478 EXCEPT AS MODIFIED BY THE				
		FLOWLINE CONCRETE INVERT		
		& GASKET PIPE-TO-MANHOLE CON BOOT SYSTEM		

FLOWLINE OF

TOP OF MH BASE -

OPENING FOR PIPE

NEW MANHOLE

MANHOLE WALL CONNECTION

CONCRETE INVERT

Accepted **Record Drawings**

SAN-3


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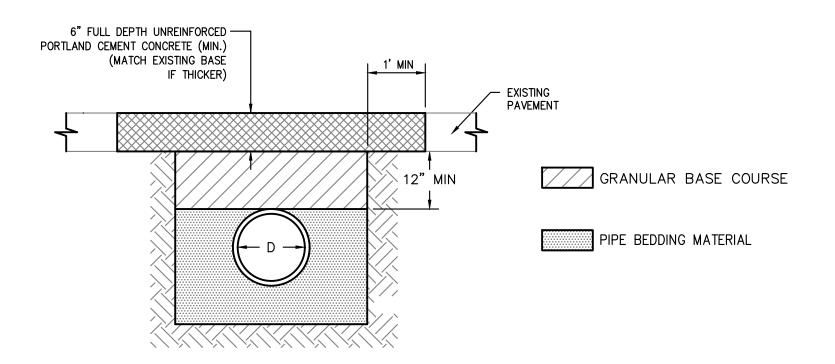


REFER TO THE APPROVED PRODUCTS LIST FOR WATER UTILITIES FOR FLEXIBLE


PIPE-TO-MANHOLE CONNECTORS/GASKETS CAST INTO THE PRECAST WALL STRUCTURE.

REFER TO THE APPROVED PRODUCTS LIST



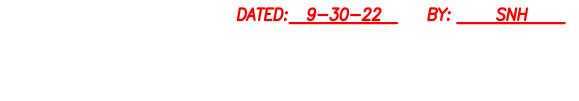




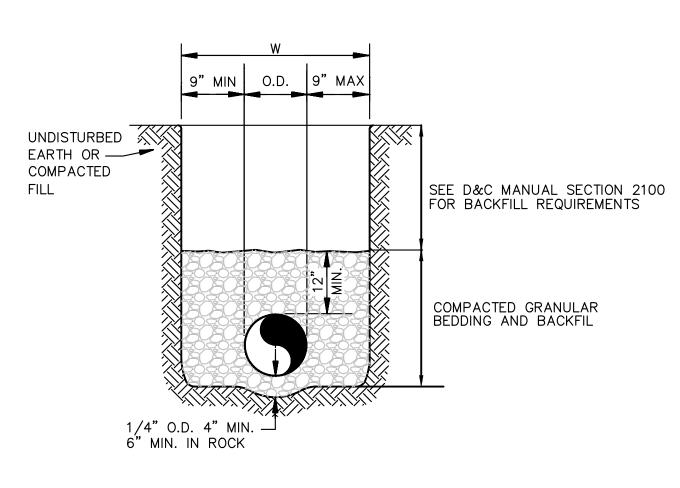

SANITARY SEWER - PVC (SDR-26) SCALE: NOT TO SCALE

PIPE INSTALLATION DETAIL

SHEET

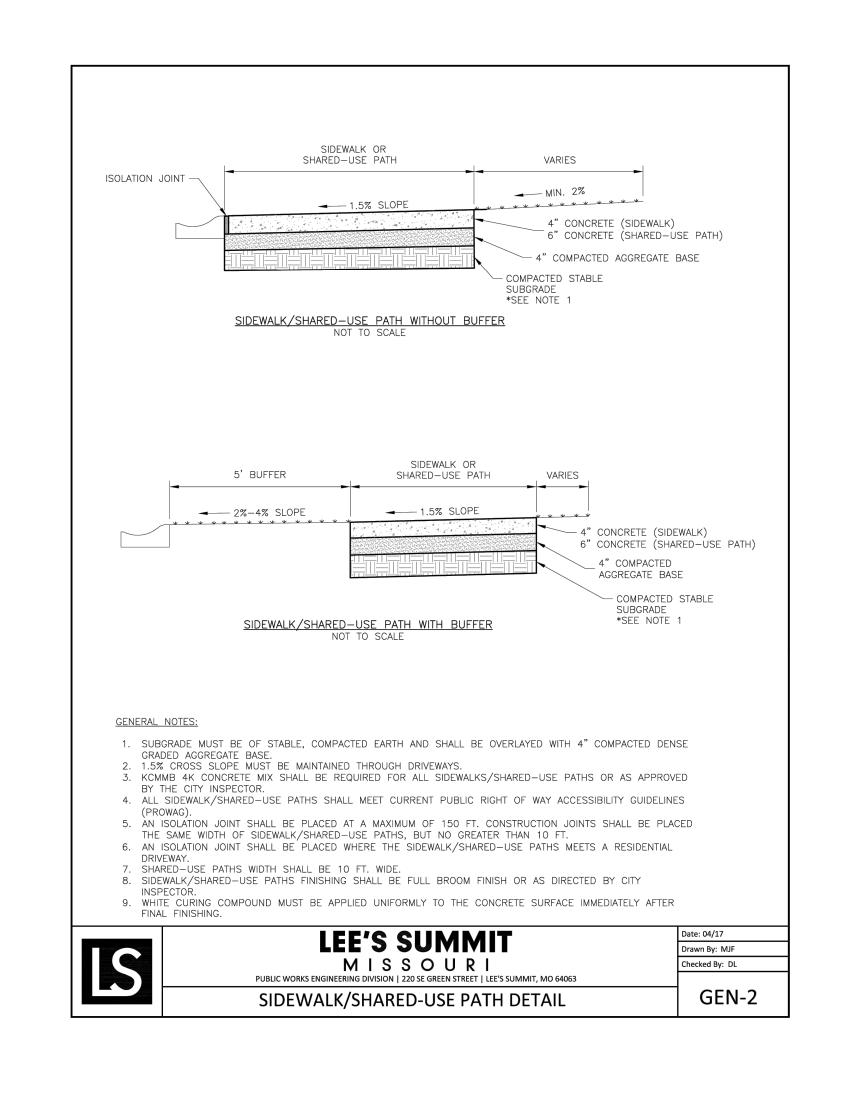





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"AS-BUILT"

DATED: 9-30-22 BY: SNH



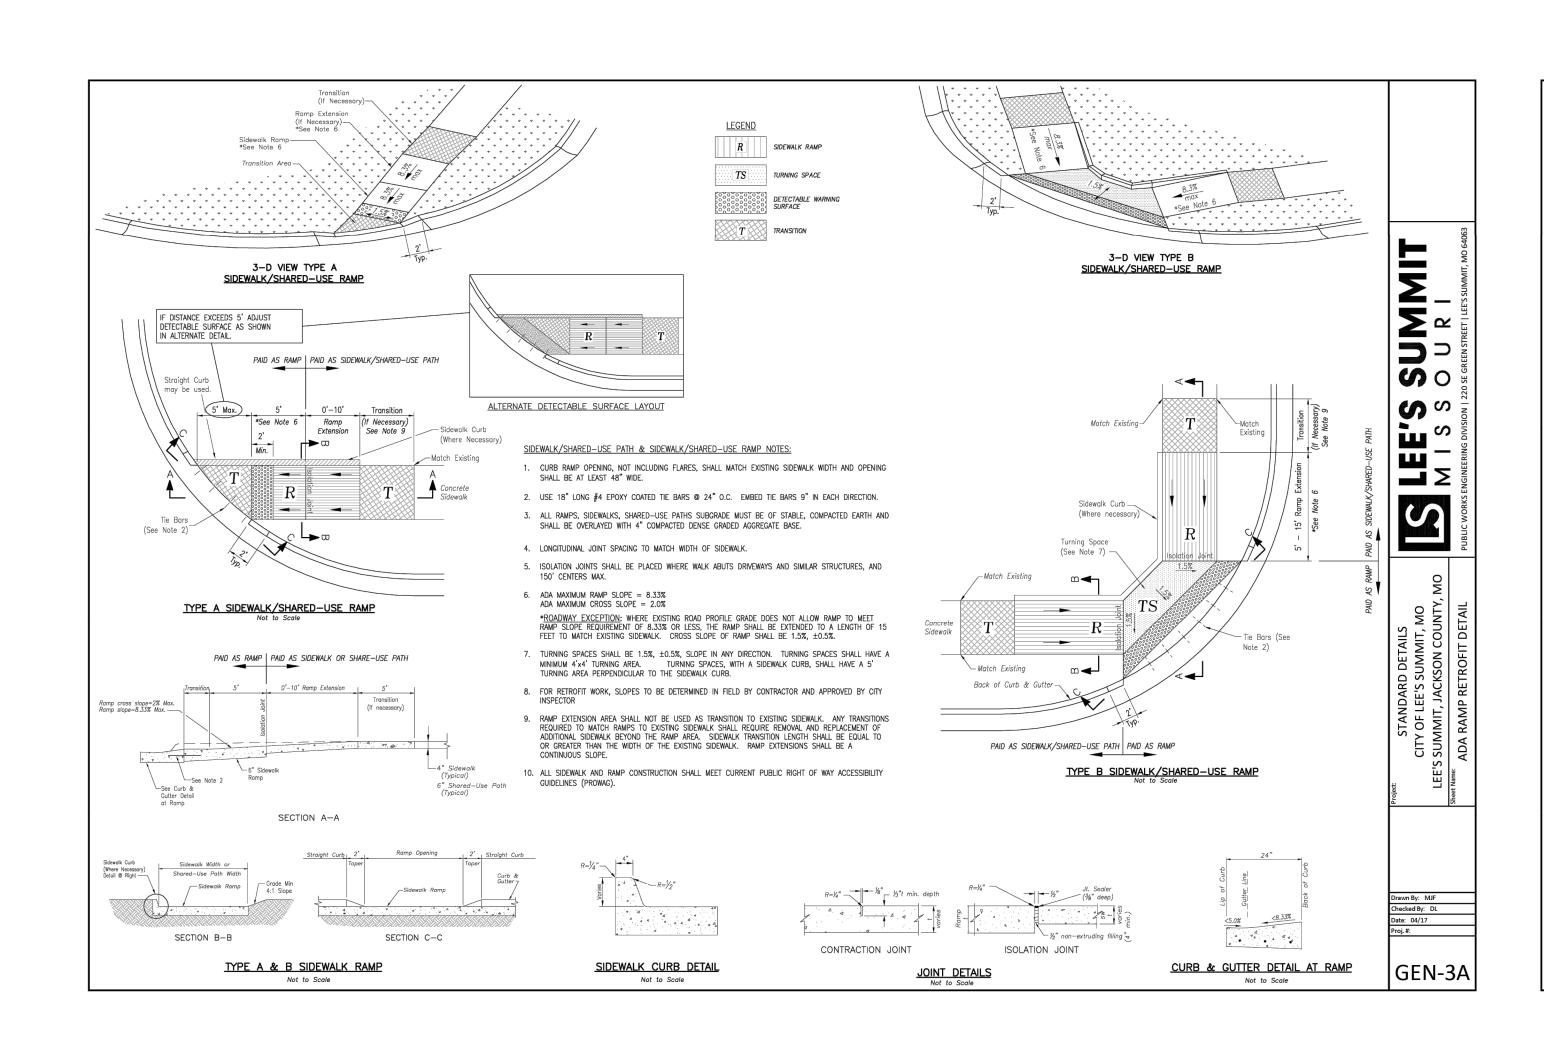

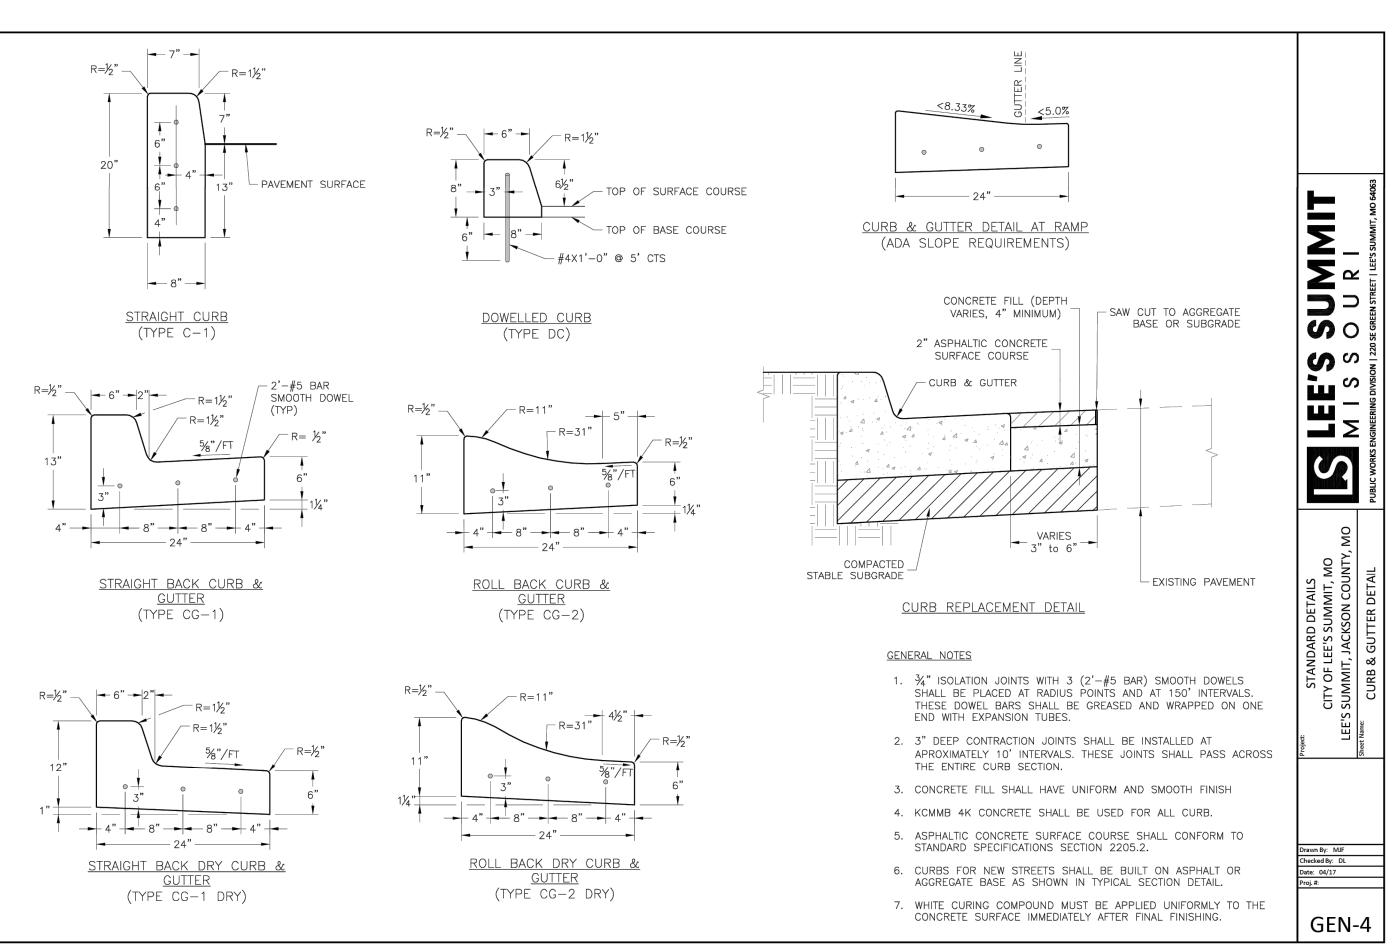

1270 N. Winchester
1270 N. Winchester
Olathe, Kansas 66061
(913) 393-1155
Fax (913) 393-1166

PLANNING ENGINEERING IMPLEMENTATION

PLANNIN

AVEMENI DEIAILS 1arket street center 1 and Sw market street

Date Revisions: By App.

05–10–22 REVISED PER CITY COMMENTS SNH DAF

09–30–22 AS–BUILT SNH DAF

SHEET

SS-5