# GROUND ROOTS COFFEE


FINAL DEVELOPMENT PLAN

3680 NE AKIN DRIVE SUITE 144 LEE'S SUMMIT, MO

ate: 5-11-22

### **INNOVATIVE DESIGN & RENOVATION**

8011 PASEO SUITE 201 KANSAS CITY, MO. 64131 (816) 531-2221 Arkitec35@aol.com

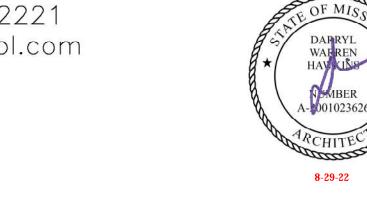

ARCHITECTURAL
ENGINEERING
CONSORTIUM, INC

MECHANICAL • ELECTRICAL • PLUMBING
STRUCTURAL • FIRE PROTECTION

 KANSAS OFFICE
 MISSOURI OFFICE


 \$11032 S Green Rd.
 752 Bagneli Dam Blvo

 Olathe, KS 66061
 £ake Ozark, MO 6504


 913-829-3803
 573-385-2100


WWW.AECONSORT.COM


### ABBREVIATIONS

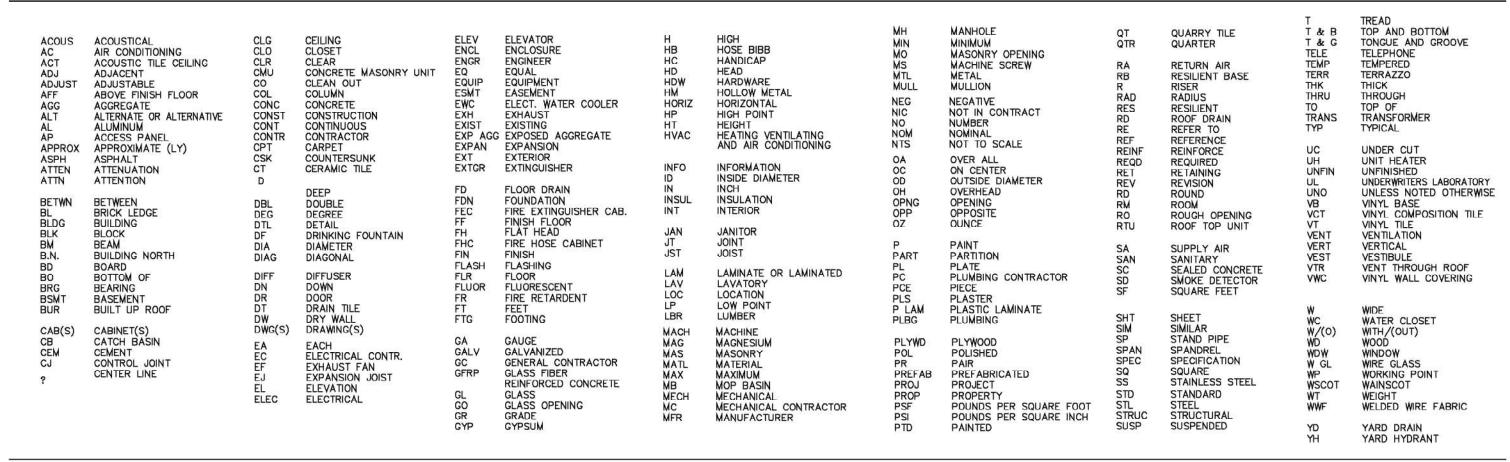

### SYMBOLS LEGEND

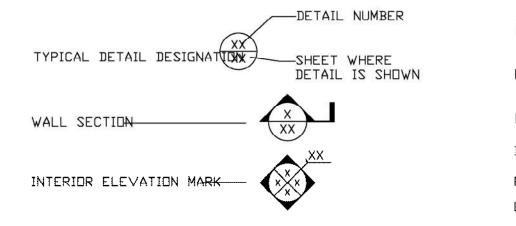

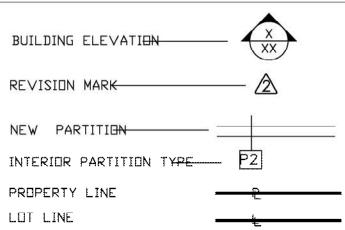

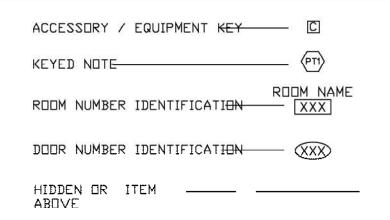


### **CODE REVIEW**

```
1. Building codes used:
       2018 International Building Code
        2018 International Mechanical Code
        2018 International Plumbing Code
        2018 International Fuel and Gas Code
        2018 International Fire Code
      2017 National Electrical Code
      2018 International Existing Building Code
      2012 International Energy Conservation Code
    2. Occupancy type: (B) Retail shop (New building)
   3. Construction type VB (NO SPRINKLERS)
    4. Area of building for occupancy M
      Retail Sales 388 \text{ SF}/60(\text{gross}) =
       Kitchen
                   415 SF/200(gross)=
    TOTAL
                                                8 Occupants
   5. Sprinklers are NOT required.
    6. Building height 18'-0" actual 40'-0" allowed.
     7. Number of stories 1 actual, 2 allowed above grade plane.
    8. Structural fire ratings for type VB construction per table 601:
                                    0 hour
      Primary structural frame
                         Exterior 0 hour Noncombustible 0 hour
                          Interior
                         Interior 0 hour
                                                               0 hour
      Nonbearing walls
      Floor construction
                                                               0 hour
      Roof construction
                                                               0 hour
    9. Number of exits required = 1 Number provided =2
The subject property lies within a flood zone designated Zone (X),
     areas located outside the 100-year floodplain, per FEMA Map, Community Panel
     No. 29095C0430G Effective Date 1/20/2017.
~~~~PNGINEERS ESTIMATE OF PROBABLE CONSTRUCTIONS COST TO BE
```

### OIL AND GAS


ACCORDING TO THE WELL INSTALLATION SECTION DRILLING INFORMATION MAP OF THE MISSOURI DEPARTMENT OF NATURAL RESOURCES THERE ARE NO OIL AND GAS WELLS IN THE VICINITY OF THIS PROPERTY

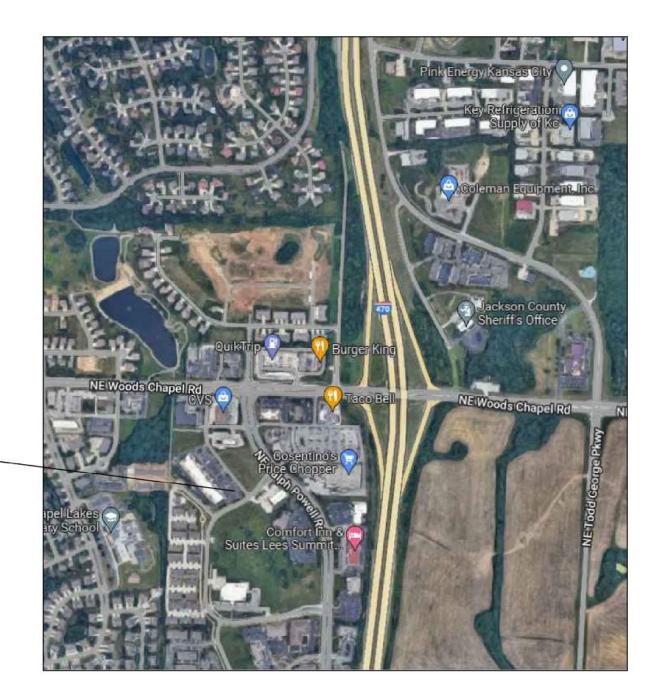




### **VICINITY MAP**

SITE LOCATION .

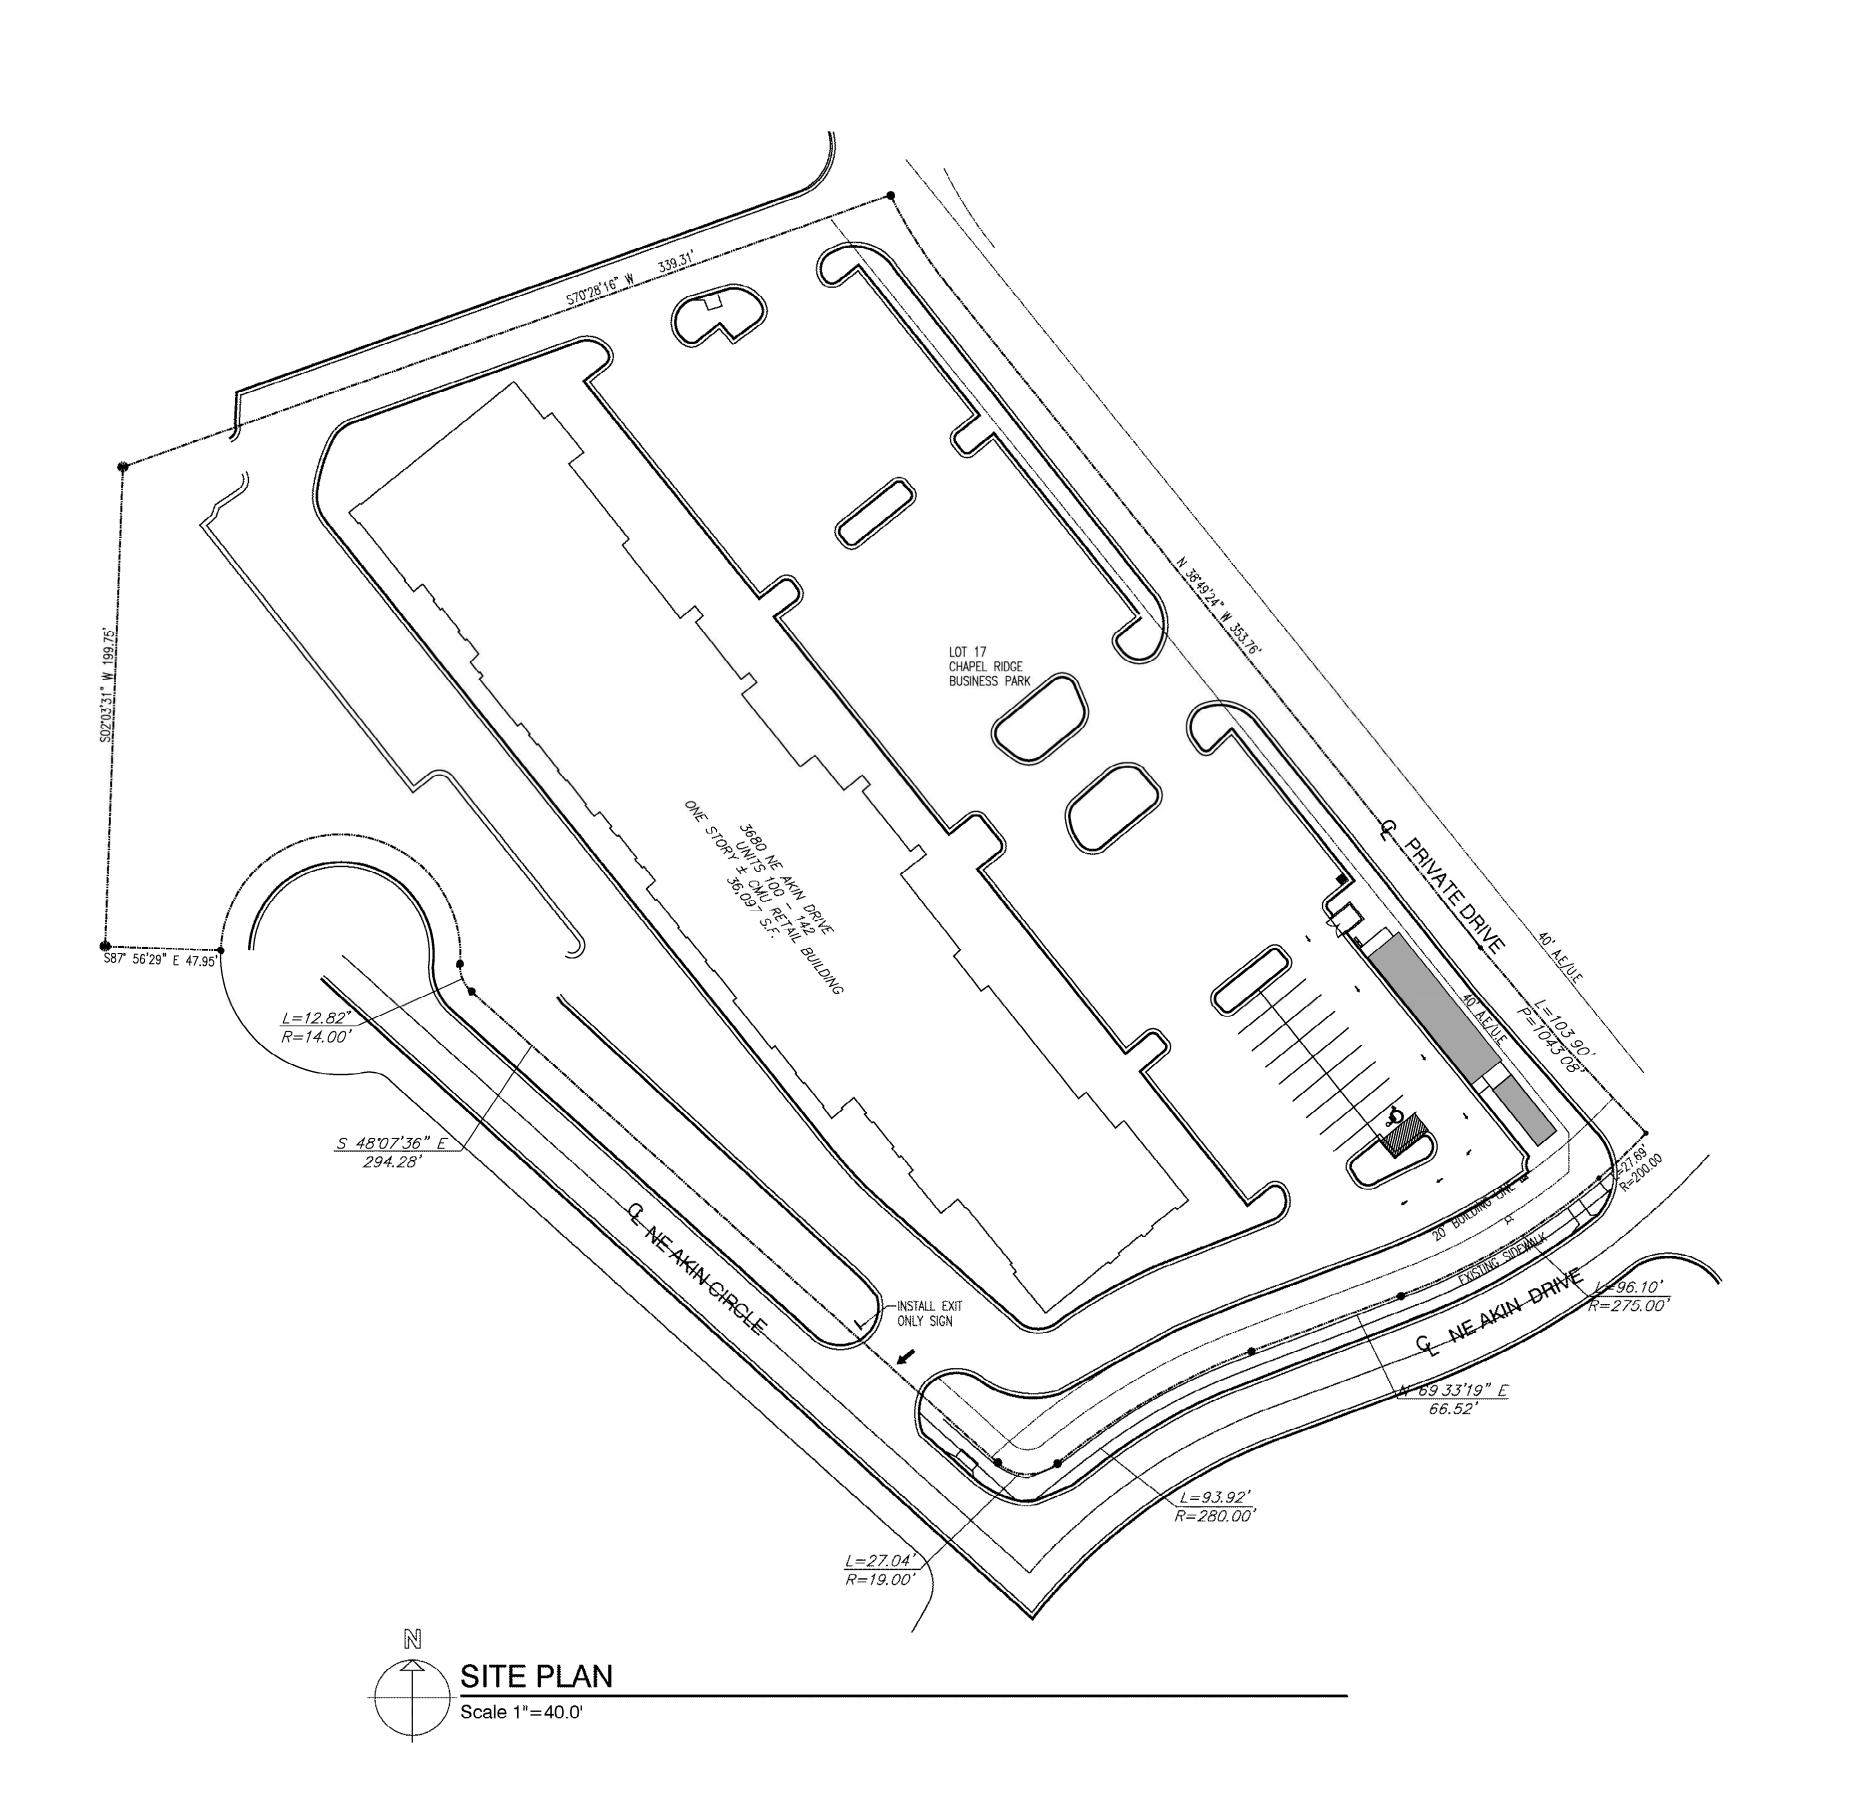

### SITE LEGEND

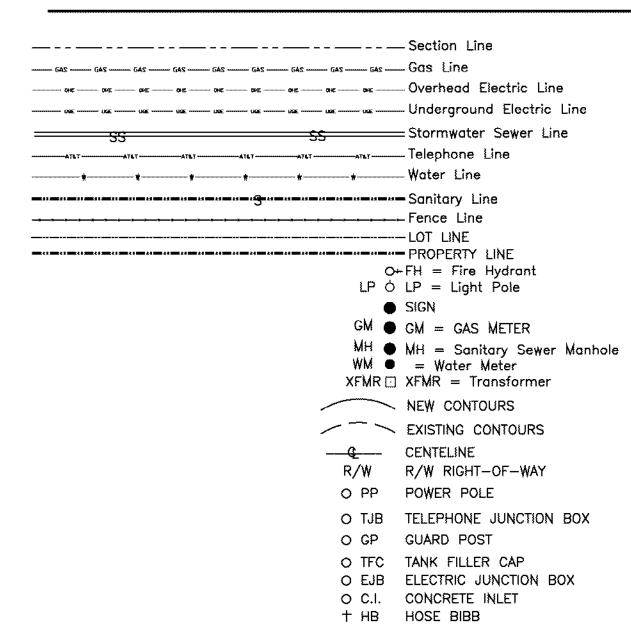

### LEGAL DESCRIPTION

LOT 17, CHAPEL RIDGE BUSINESS PARK, LOTS 10 THRU 18 TRACTS H THRU K, A SUBDIVISION IN LEE'S SUMMIT, JACKSON COUNTY, MISSOURI, ACCORDING TO THE RECORDED PLAT THEREOF.

### SITE DATA TABLE


EXISTING LOT AREA PROPOSED BUILDING AREA 182,138 SQ.FT. 1,096 SQ.FT. 1.9% NO CHANGE 170 155 FAR % (LOT 17)
IMPERVIOUS AREA
EXISTING PARKING SPACES
PROPOSED PARKING SPACES

### DEVELOPER

VAAP CHAPEL RIDGE, LLC ATTN DR. VEERAL BHOOT P.O. BOX 24193 OVERLAND PARK, KS

RENOVATION

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# Œ GROUND ROOTS

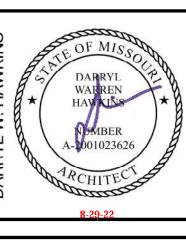
3680 NE AKIN DRIVE SUITE LEE'S SUMMIT, MO

date 5-11-22 drawn by R.E.S. checked by revised


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velopment Services Departm Lee's Summit, Missouri 09/15/2022



NNOVATIVE DESIGN & RENOVATION 011 PASEO SUITE 201 ANSAS CITY, MO. 64131

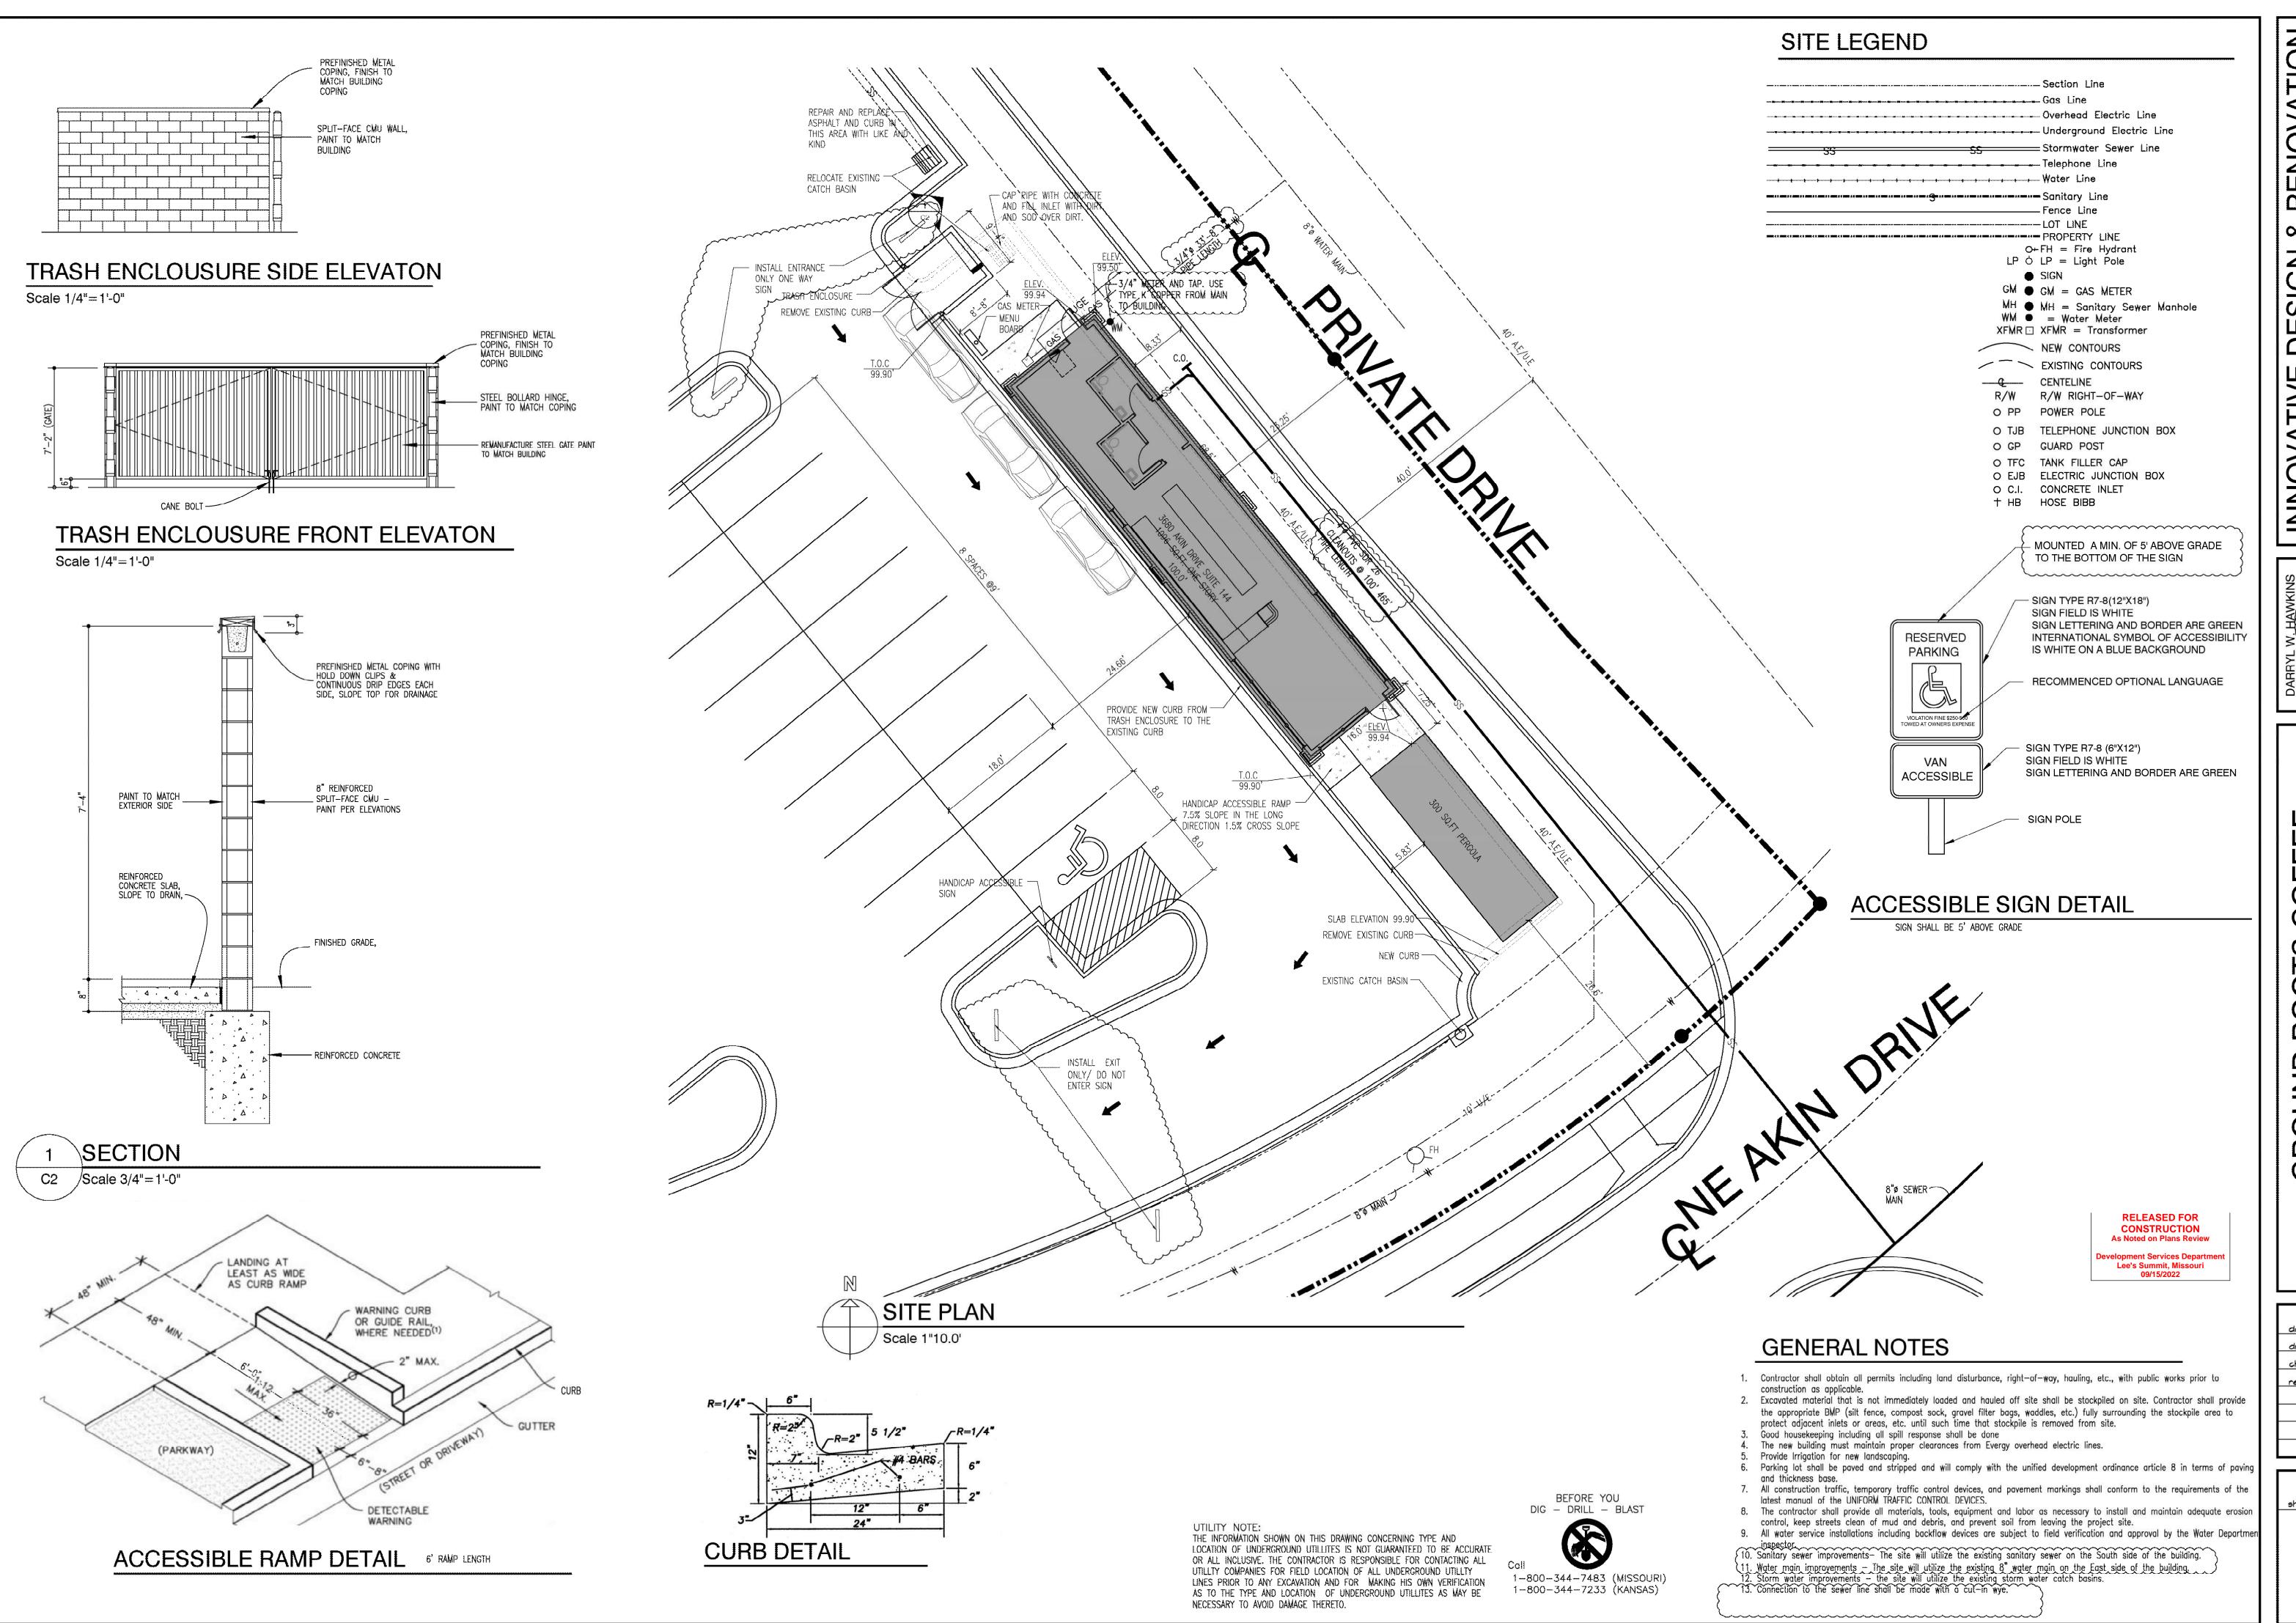

GROUND ROOTS COFFEE

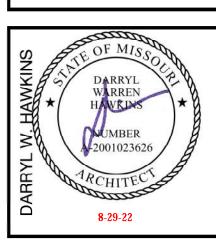date 5-11-22
drawn by R.E.S.
checked by 8-29-22
revised

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### SILT FENCE EROSION CONTROL

1. Fabric fences may be constructed with supporting fences, such as snow fences or wire mesh fences. The supporting fences shall be strong enough to withstand the load from pond water and trapped sediment. The support posts shall be spaced at 10 feet intervals or less, and shall be placed or driven at least 2 feet into the ground. Posts shall be 4-inch diameter wooden posts or standard steel posts.

When fabric fence is installed without a supporting fence, the posts shall be spaced at 4 feet or less. Posts shall be placed or driven at least 2 feet into the ground. Posts shall be 2-inch square wood posts or standard steel posts.

- 2. A trench for anchoring the fabric shall be dug along the upslope side of the posts. The trench shall be at least 8 inches wide and 12 inches deep. The fabric shall be laid in the trench, which then shall be back filled and compacted to prevent water and sediment from passing underneath the fabric fence.
- 3. The filter fabric shall be furnished in a continuous roll cut to the length of the sill fence to avoid splices. When splices are necessary, the fabric shall be spliced at a support post with a minimum of 6-inch overlap, folded over, and securely fastened.
- 4. The synthetic filter fabric shall be a pervious sheet of polypropylene, nylon, polyester, or ethylene yarn uniform in texture and appearance and free from defects, flaws, or tears that would affect its physical properties. When installing fabric for silt fences, follow manufacturer's recommendations.

### **EROSION CONTROL:**

All erosion control practices are to be in accordance with **EROSION** and **SEDIMENT CONTROL** SPECIFICATION, of the MDNR, Erosion control practices are to be in place prior to construction. Where it is impractical to install erosion control practices prior to construction, the contractor shall install erosion control practices as soon as practical, during or following construction.

SODDING, may be used in any area requiring permanent seeding.

### PERMANENT SEEDING/MULCHING

Permanent vegetation is to be seeded within 30 working days of the completion of construction and


At the contractors option sod may be established in any area where permanent vegetation is required.


SILT FENCE or STRAW BALE BARRIERS: Silt fence is to be installed in accordance with MDNR Standards


### SEDIMENT FENCE.

Straw bale barriers are to be installed in accordance MDNR Standards.

Maintain sediment traps, silt fence straw bales after each significant rainfall, remove sediment and restore to original dimensions when sediment has accumulated to half the design depth. Place removed sediment in disposal or fill areas.

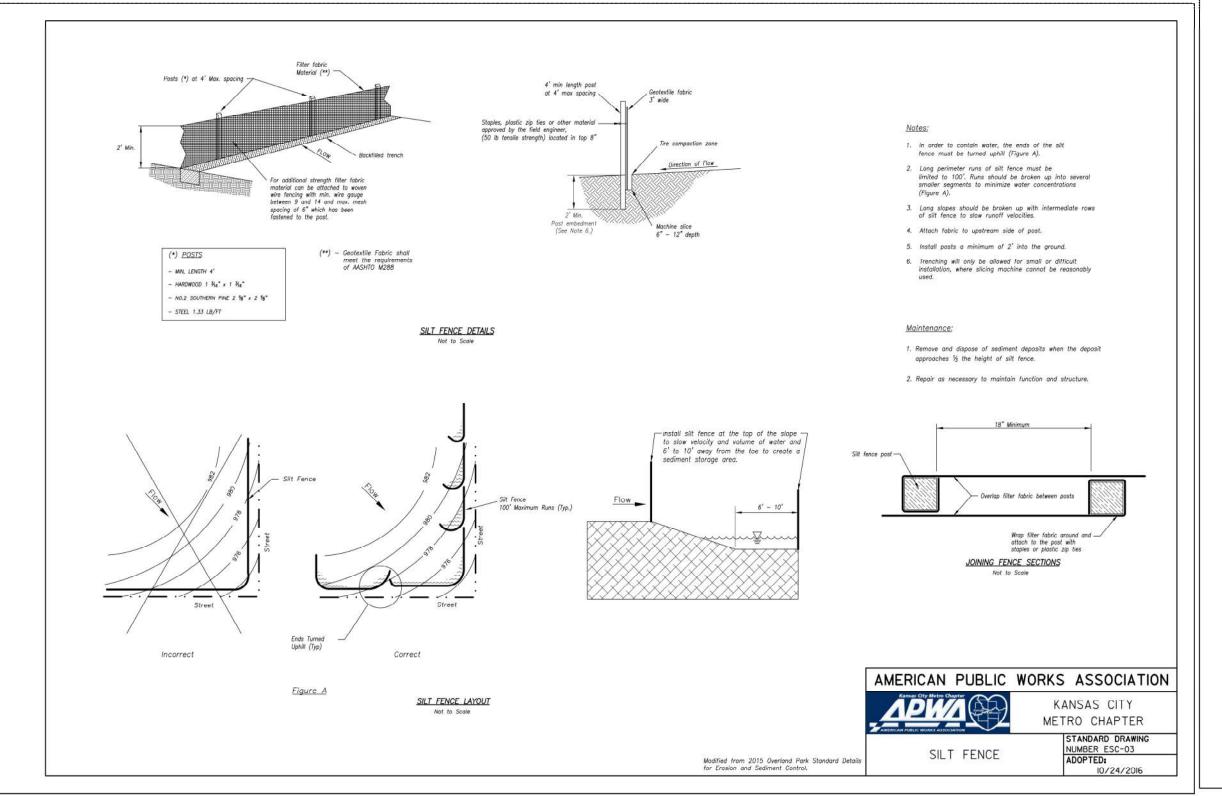

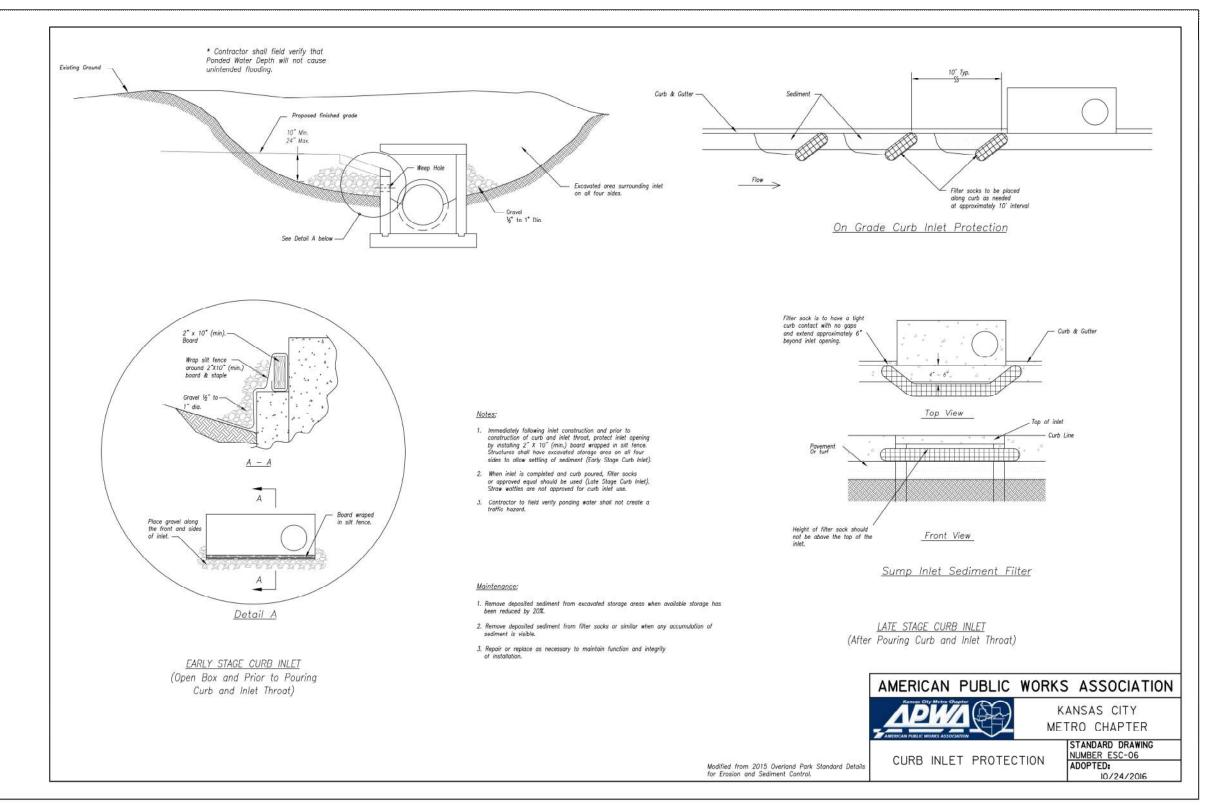


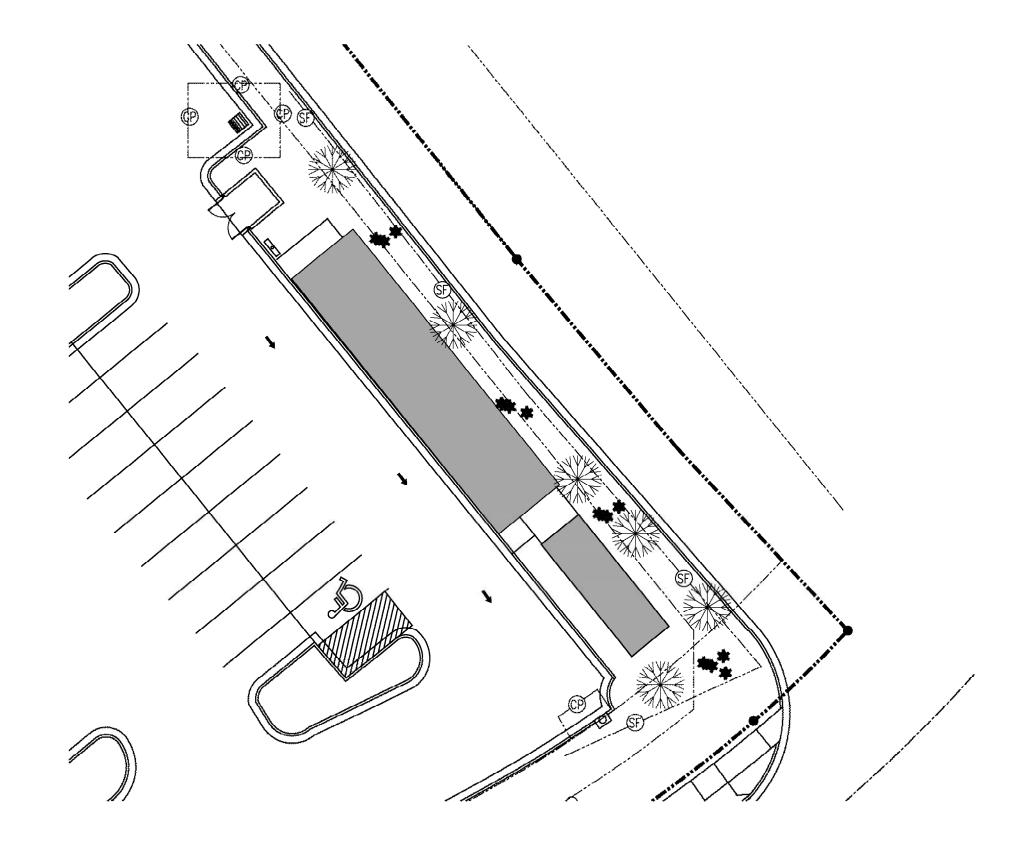





GRATE INLET PROTECTION TO BE IN PLACE PRIOR TO CONSTRUCTION SILT FENCE SHALL BE INSTALLED IN ACCORDANCE WITH MISSOURI DEPARTMENT OF NATURAL RESOURCES

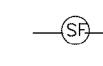

—(SF)— SILT FENCING TO BE IN PLACE PRIOR TO CONSTRUCTION SILT FENCE SHALL BE INSTALLED IN ACCORDANCE WITH THE CITY OF LEE'S SUMMIT, MO

### GENERAL NOTES

- 1. The contractor shall provide all materials, tools, equipment and labor as necessary to install and maintain adequate erosion control, keep streets clean of mud and debris, and prevent soil from leaving the project site. The contractor's erosion control measures shall conform to the city of Lee's Summit, Mo. The contractor shall be responsible for providing additional erosion control measure or modifications if the plan fails to substantially control erosion or offsite sedimentation.
- 2. The contractor shall inspect erosion control devices every 7 days and within 24 hours of a storm of 0.5" or more. The contractor shall repair damage, clean out sediment, and additional erosion control devices as needed, as soon as practicable,


RENOVATION **∞** DESIGN INNOVATIVE (ANS) (816) 7kit

Ш COFF SU ROOTS SUITE GROUND

date 5-11-22 drawn by R.E.S. checked by revised

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Lee's Summit, Missouri 09/15/2022

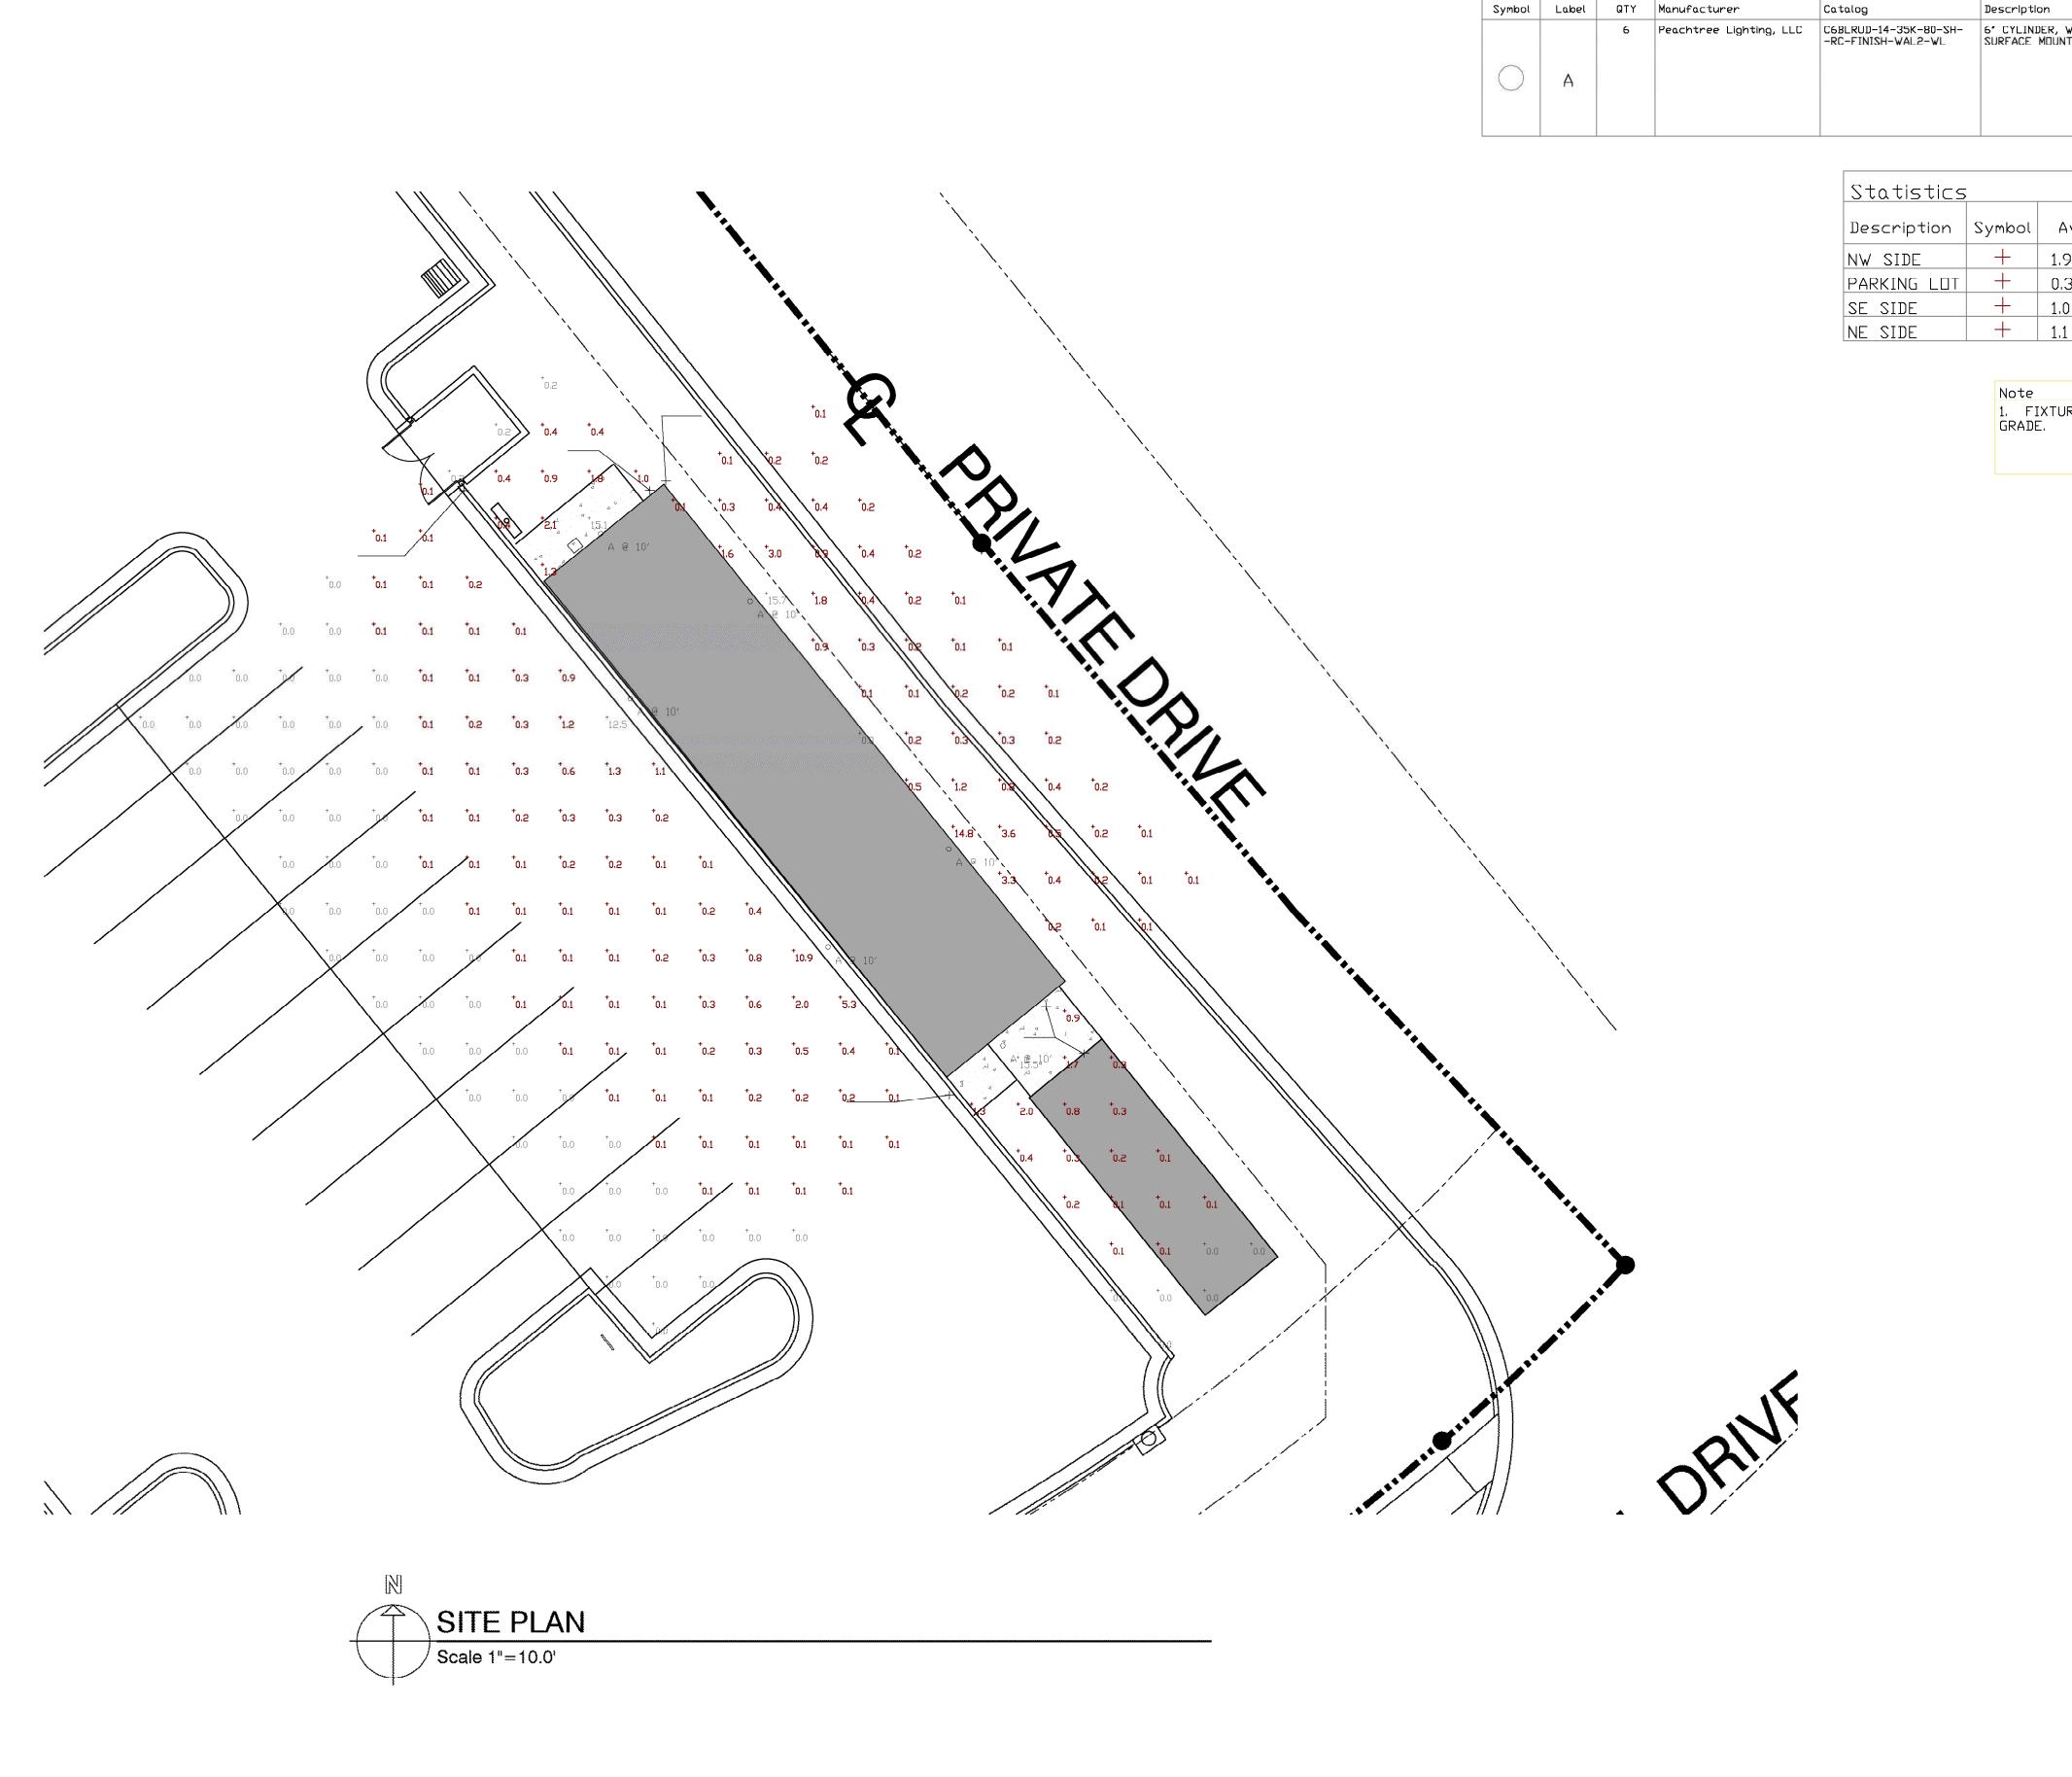

Schedule

Symbol Label QTY Manufacturer Catalog Description Number Lamp Dutput LLF Power Polar Plot

6 Peachtree Lighting, LLC C6BLRUD-14-35K-80-SH--RC-FINISH-WAL2-WL SURFACE MOUNT

1 2911 0.9 17

 Statistics

 Description
 Symbol
 Avg
 Max
 Min
 Max/Min
 Avg/Min

 NW SIDE
 +
 1.9 fc
 15.1 fc
 0.2 fc
 75.5:1
 9.5:1

 PARKING LOT
 +
 0.3 fc
 12.5 fc
 0.0 fc
 N/A
 N/A

 SE SIDE
 +
 1.0 fc
 15.5 fc
 0.0 fc
 N/A
 N/A

 NE SIDE
 +
 1.1 fc
 15.7 fc
 0.0 fc
 N/A
 N/A

Note

1. FIXTURES MOUNTED AT 10' ABOVE GRADE.

GROUND ROOTS COFFEE

RENOVATION

INNOVATIVE DESIGN & F 8011 PASEO SUITE 201 KANSAS CITY, MO. 64131 (816) 531-2221 Arkitec35@aol.com

> 3680 NE AKIN DRIVE SUITE LEE'S SUMMIT, MO

date 5-11-22
drawn by R.E.S.
checked by
revised


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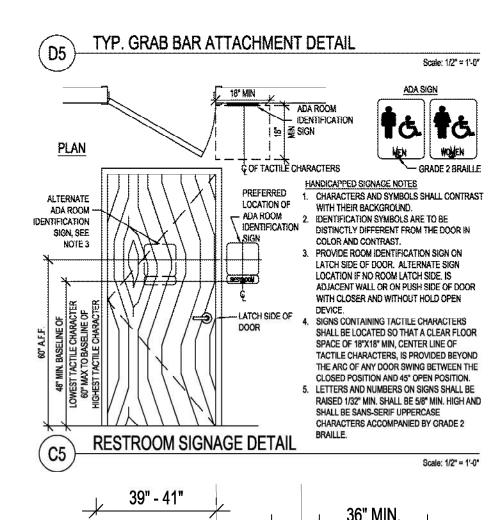
1. ALL LANDSCAPING IS EXISTING, REPLACE WITH LIKE AND KIND AS NEEDED.





GROUND ROOTS COFFEE

3680 NE AKIN DRIVE SUITE LEE'S SUMMIT, MO


date 5-11-22 drawn by R.E.S. checked by revised

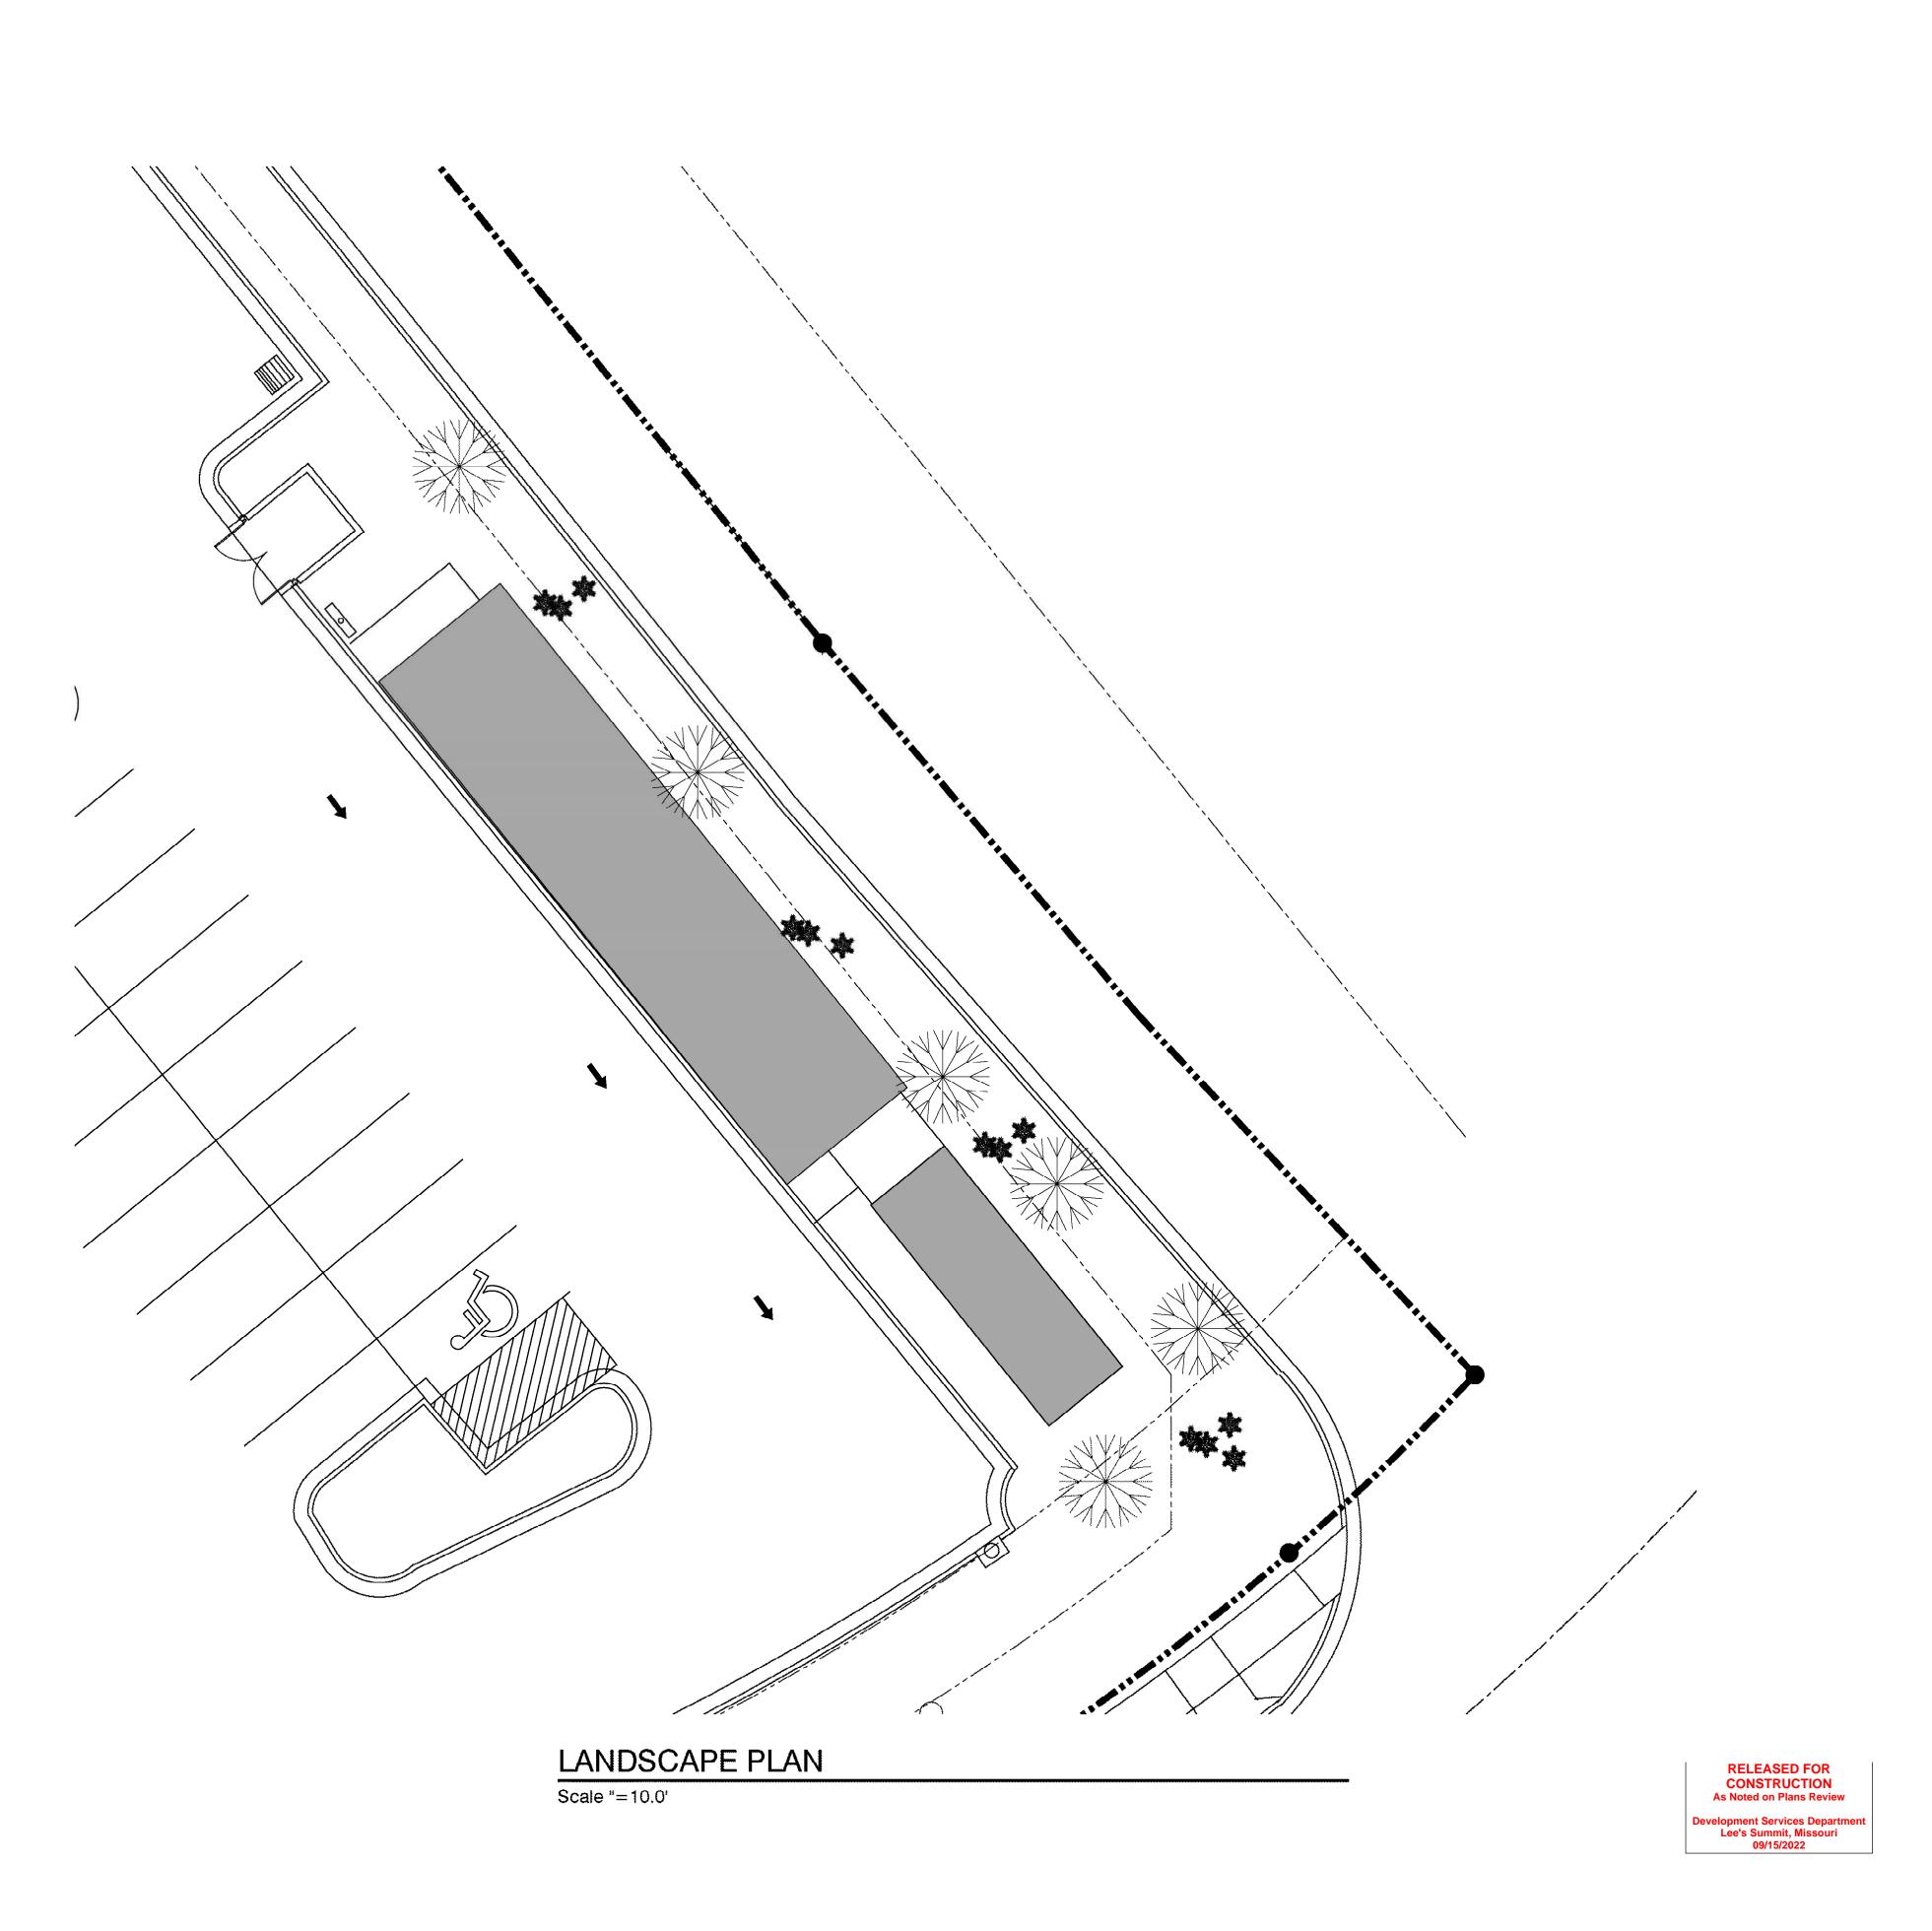

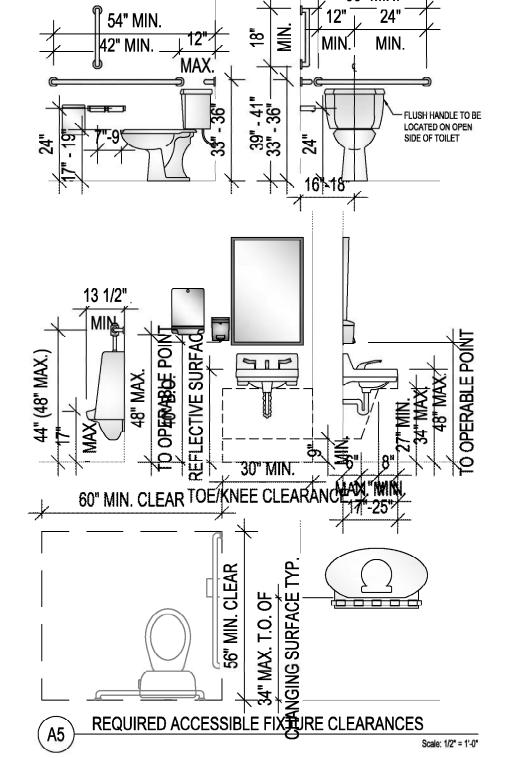

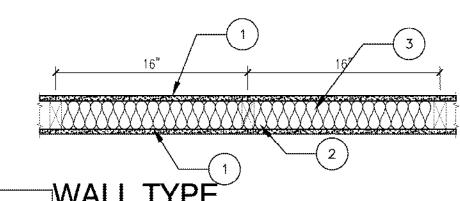

5/8 IN. THICK GYPSUM BOARD APPLIED VERTICALLY. GYPSUM BOARD: 2. WOOD STUDS: 2X4 WOOD STUDS @16" O.C. INSULATION: MIN. 3-1/2 IN. THICK FIBERGLASS. INSULATION

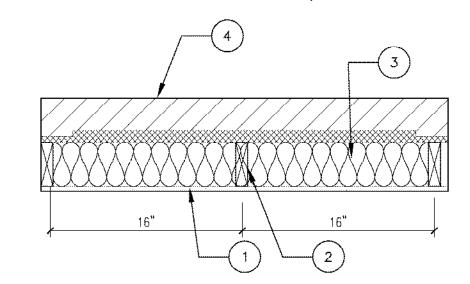

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- GYPSUM BOARD: WOOD STUDS: INSULATION: 4. BRICK WAINSCOT
  - 5/8 IN. THICK GYPSUM BOARD APPLIED VERTICALLY. 2X6 WOOD STUDS @16" O.C. MIN. 3-1/2 IN. THICK FIBERGLASS, INSULATION

ROOM FINISH SCHEDULE									
	DOOM NIAME	FLOOR	WALLS				CEILING		NOTES
ROOM NUMBER ROOM NAME	FLOOR	N	S	Е	W	MATL	HEIGHT	NOTES	
101	PREP	SEALED CONC.	FRP	FRP	FRP	FRP	2X4	8'-0"	<b>—</b> —
102	SALES	SEALED CONC.	GYP.BD	GYP.BD	GYP.BD	GYP.BD	EXPOSED	12'-0"	
103	BATH	TILE	TILE 4' A.F.F.	TILE 4' A.F.F.	TILE 4' A.F.F.	TILE 4' A.F.F.	2X4	8'-6"	
104	BATH	TILE	TILE 4' A.F.F.	TILE 4' A.F.F.	TILE 4' A.F.F.	TILE 4' A.F.F.	2X4	8'-0"	
105	HALL	SEALED CONC.	GYP.BD	GYP.BD	GYP.BD	GYP.BD	2X4	8'-0"	

LEGEND		
NEW STUD WALLS		PARTITION TYPE
NEW STUD WALLS	(-)	DOOR NUMBER
	$\langle - \rangle$	WINDOW TAG

D	DOOR AND FRAME SCHEDULE								
	·	DOOR	}		FRAME	HARI	WARE		
MARK		SIZE		MATL		INCOMM		NOTES	
WARK	WD	HGT	THK	WAIL	MATL	SE	T NO		
01	3'-0"	6'-8"	1 3/4"	GLASS	MTL				
02	3'-0"	6'-8"	1 3/4°	WD	₩D		ANT, RAM		
03	3'-0"	6'-8"	1 3/4"	WD	WD		EAL SAL		
04	3'-0"	7'-0"	1 3/4"	GLASS	MTL.				
05	3'-0"	6'-8"	ΝÁ	WD	₩Ď				

	EQUIP	MENT LIST
EQ#	QTY	DESCRIPTION
1	1	MOP SINK
2	1	FREEZER
3	1	REFRIGERATOR
4	1	HAND SINK
5	1	DISHWASHER
6	1	3 COMPARTMENT SINK
7	3	SHELVING
8	2	P.O.S.
9	1	UNDERCOUNTER TRASH CONTAINE
10	i	EGG MAKER
11	1	MICROWAVE
12	1	REFRIGERATED PREP TABLE
13	1	DROP IN HAND SINK
14	1	ICE BIN
15	1	OVEN/TOASTER
16	1	UNDERCOUNTER ICE MAKER
17	2	BLENDERS
18	1	KOMBUCHA ON TAP
19	1	BEVERAGE COOLER
20	1	PASTRY DISPLAY
21	1	COLD BREW ON TAP
22	1	ESPRESSO MACHINE
23	1	UNDERCOUNTER REFRIGERATOR
24	2	ICE TEA MAKER
25	1	TAMPER
26	2	GRINDERS
27	-	SYRUPS
28	2	CUPS
29	-	PRODUCT DISPLAY
30	1	TWIN AIRPOT COFFEE BREWER
31	1	GH2 GRINDER
32	1	FLOOR SAFE
33	1	DISPLAY CASE
34	1	FLUSH MOUNT RINSER

### **GENERAL NOTES**

- 1. All refrigeration units are capable of maintaining refrigerated foods at or below 41° Fahrenheit at all times. Reach—in refrigerators, prep refrigerators, refrigerated display cases, and freezers must be specifically constructed for commercial use.
- 2. This is a non-smoking establishment.
- 3. All cooking and food service equipment must be commercial grade and shall meet NSF Standards.
- 4. Adequate and suitable space has been provided for the storage of food. Approximately twenty—five percent (25%) of the food preparation area, and at least 32 lineal feet of approved shelving for each 100 square feet of storage area are considered adequate (excluding refrigeration). Shelving is easily cleanable and durable. The lowest shelf of any shelving unit shall be at least six inches above the
- 5. The floor surfaces, in all areas in which food is prepared, packaged, or stored, where any utensil is washed, where refuse or garbage is stored and where janitorial facilities are located, and in all toilet and hand washing areas, shall be smooth and of such durable construction and non-absorbent material as to be easily cleaned. Floor surfaces are covered at the juncture of the floor and wall, with a three—eighths inch (3/8") minimum radius coving.
- 6. Walls and ceilings of food preparation and utensil washing areas shall be light colored and constructed with materials that provide a durable, smooth, non-absorbent, washable surface. Conduits of all types shall be installed within walls as practicable. When otherwise installed, they are mounted or enclosed so as to facilitate cleaning.
- 7. The delivery door leading to the outside is the overhead door #14
- 8. The main entrance door leading to the outside shall have a self-closing device.Provide a sign on the main exit door that says "THIS DOOR MUST REMAIN UNLOCKED DURING BUSINESS HOURS" instead of panic hardware.
- 9. All floors, walls and ceilings in the kitchen, restrooms, food prep areas and storage areas will be smooth washable and nonabsorbent.
- 10. Install batt insulation in all interior walls for sound transmission.
- 11. Building address shall be posted in a conspicuous place during construction.
- 12. Fire extinguishers shall be installed in accordance with the International Fire Code and NFPA 10. Extinguishers shall be mounted 5 feet for 40 lbs or 3.5 feet for greater the 40 Ibs above finished floor. Provide blocking in wall for mounting. A class "K" fire extinguisher shall be supplied in the kitchen.
- 13. Tactile "Exit" signs shall be placed at each Exit door. ADA required wall signage shall be placed on the latch side of single doors 9-inches center-line from the door edge. Tactile signs shall be installed 48—inches minimum and 60—inches maximum AFF to the baseline of the highest
- 14. Verify existing dimensions before construction.
- 15. Type I Hood system must have a current inspection tag and shall be cleaned upon final inspection.
- 16. Additional emergency lighting/exit signs may be required if upon final fire inspection it is determined there is not adequate lighting to show a clear path of egress.
- 17. Supply Knox box at front door facing the street. Install box 5' to the top of the box.
- 18. Install towel and soap dispenser at all hand sinks
- 19. Use suspended ceiling with a flame spread rating of

### Door Hardware:

- All doors required for egress (exit doors) shall be installed with
- approved hardware as listed below: a. Exit doors shall be operable from the inside without the use of a key or any special knowledge of effort. For exception on the main exterior exits. See note 8 sheet A1
- b. Manually operated edge— or surface—mounted flush bolts and surface bolts are prohibited.
- c. Handles, pulls, latches, locks and other operating devices on accessible doors shall be easy to grasp with one hand and does not require tight grasping, tight pinching, or twisting of the wrist to operate. Lever-operated mechanisms, push-type mechanisms and U-shaped mechanisms are acceptable designs.

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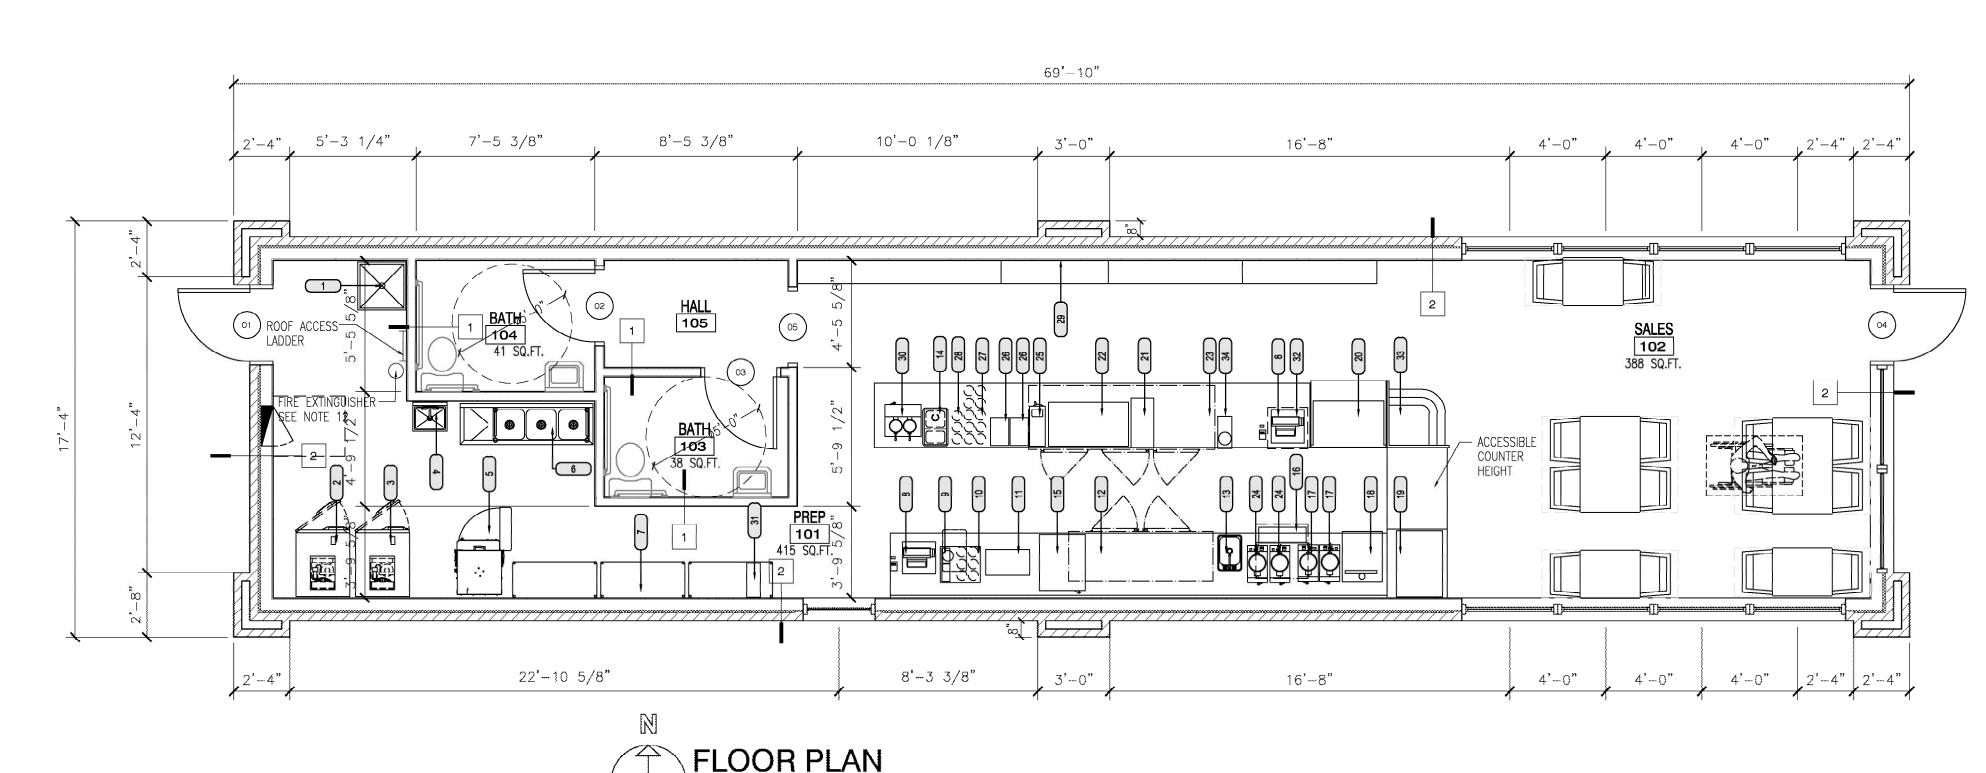
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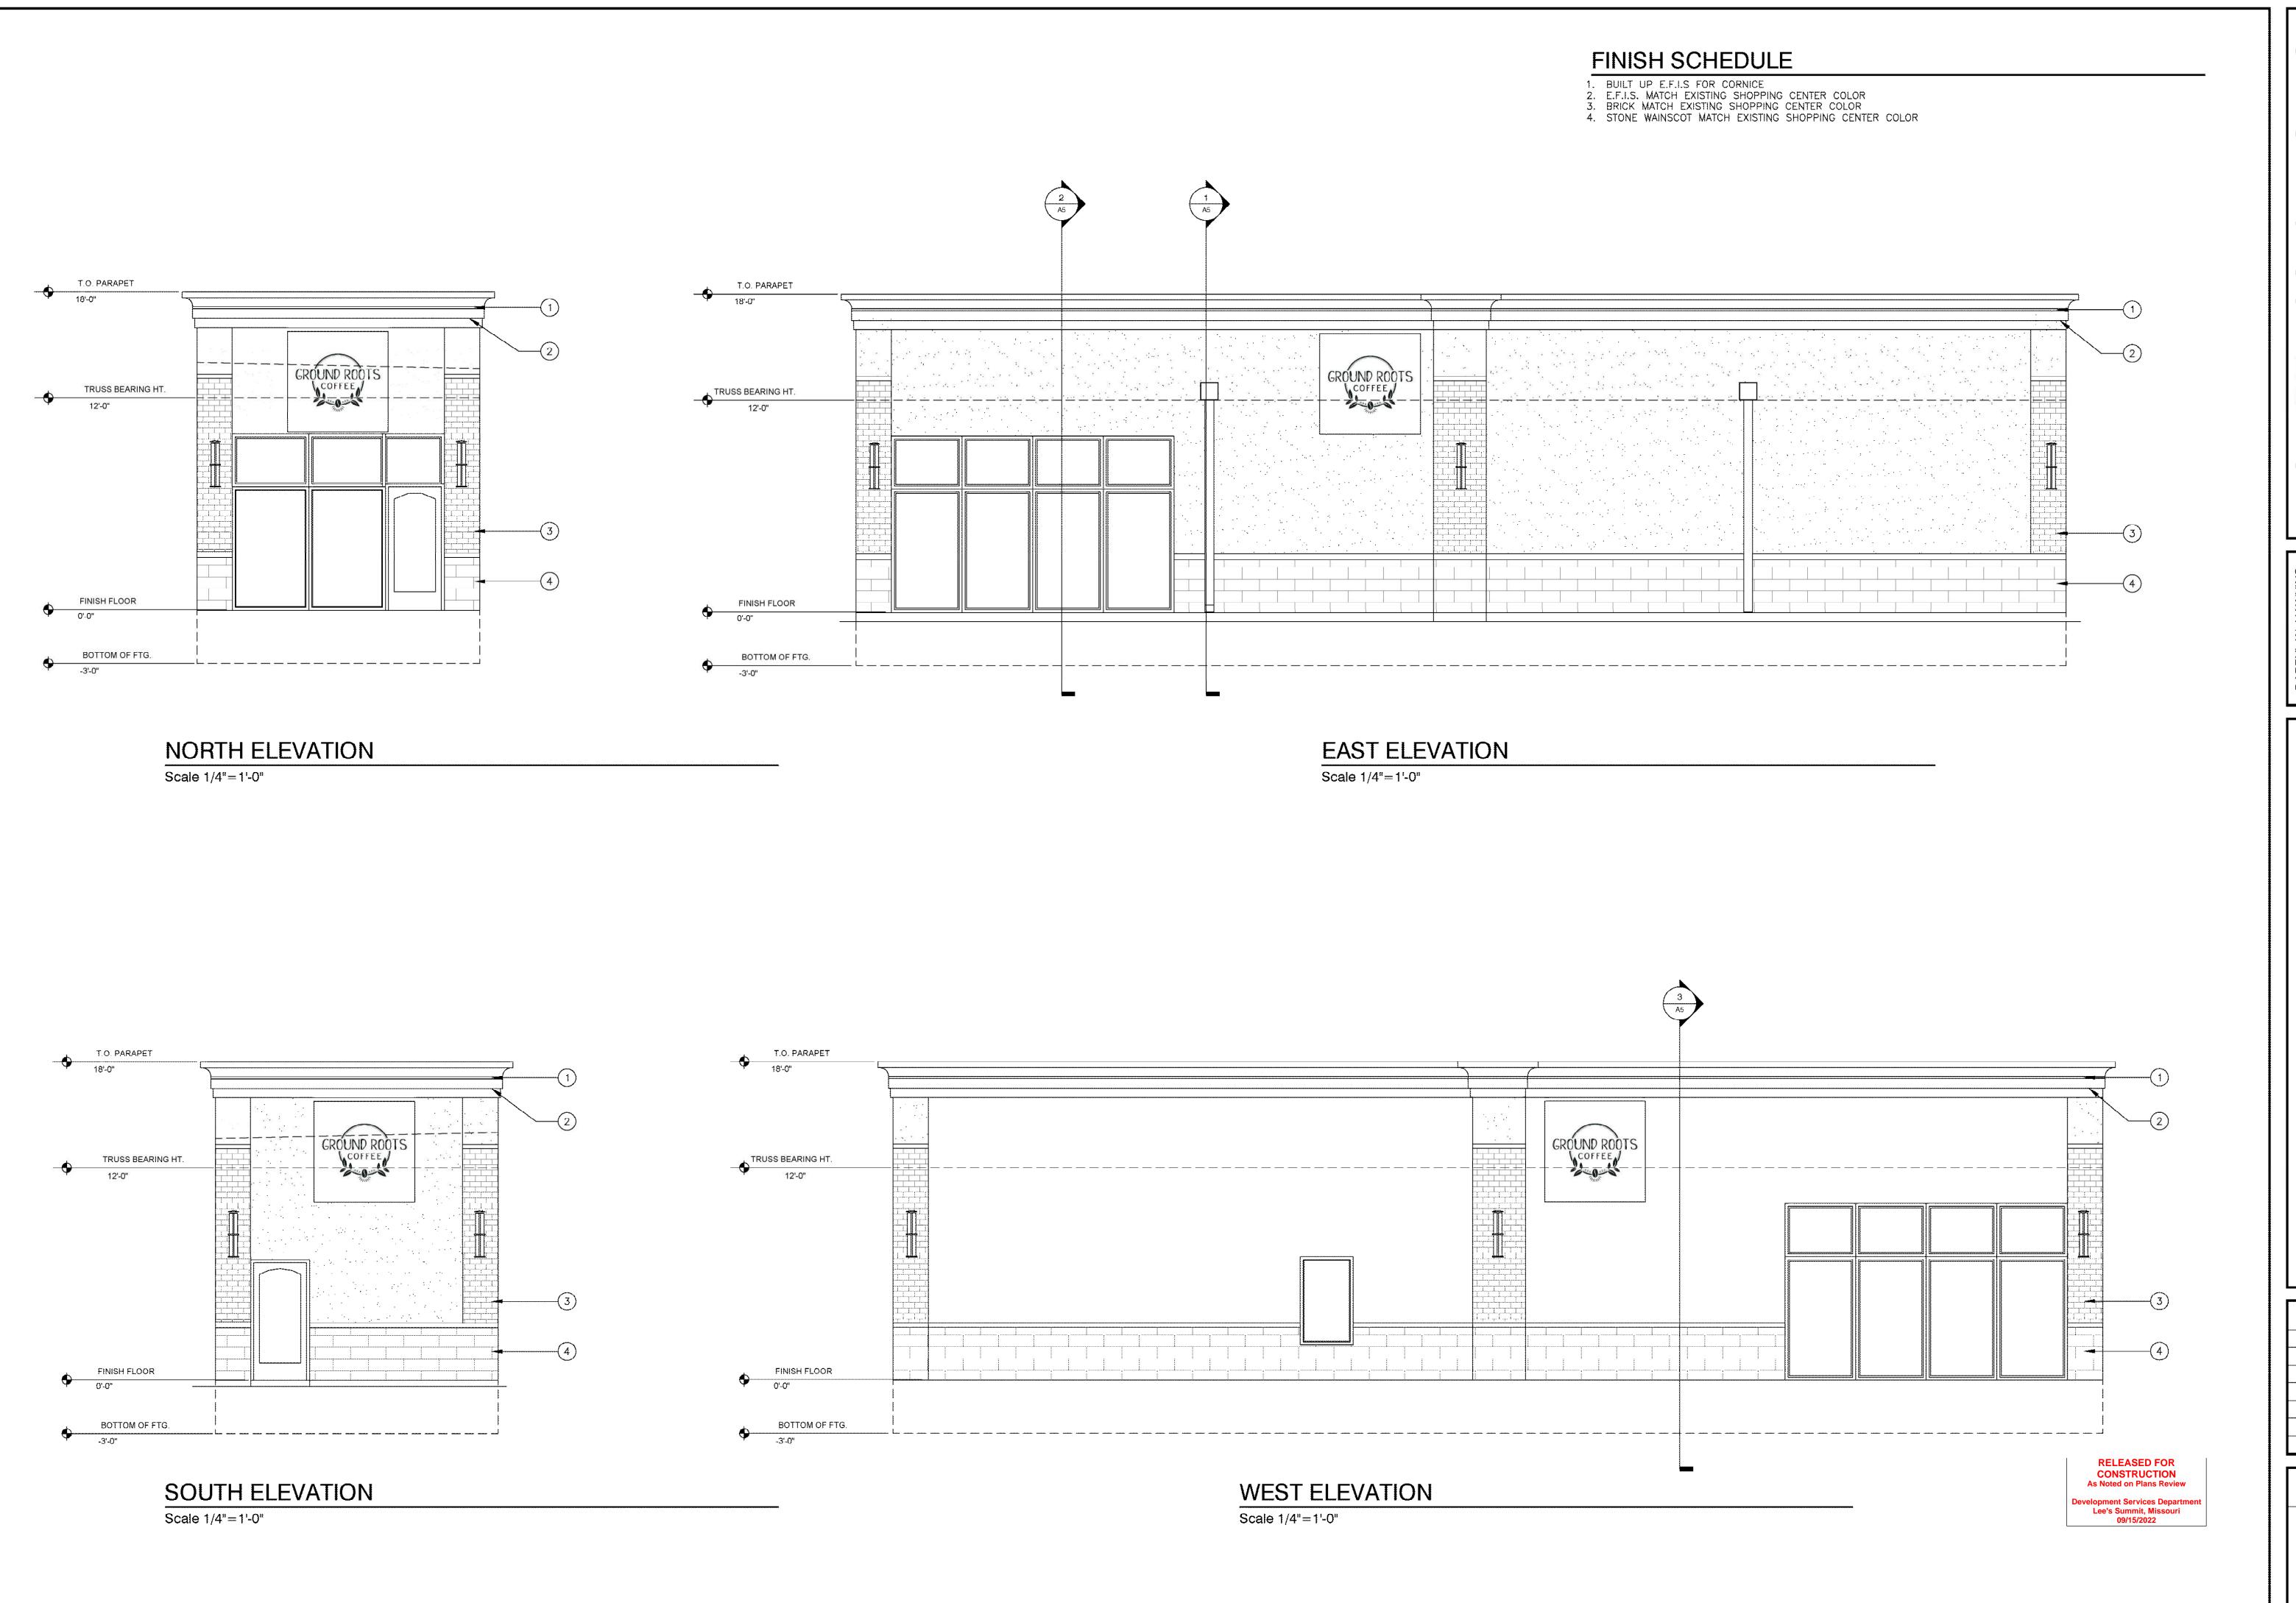
NE AKIN DRIVE S LEE'S SUMMIT, I 3680

date 5-11-22 drawn by R.E.S. checked by revised

sheet no.



/ Scale 1/4"=1'-0"



E DESIGN & RENOVATION


INNOVATIVE DESIGN 8

8011 PASEO SUITE 201

KANSAS CITY, MO. 64131

(816) 531-2221

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GROUND ROOTS COFFEE

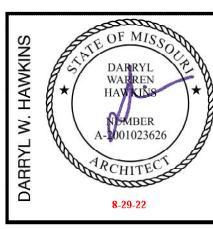
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revised

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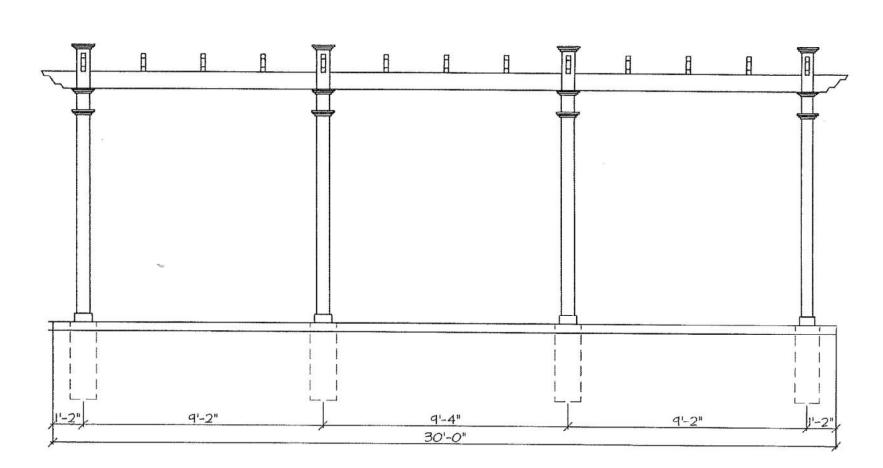
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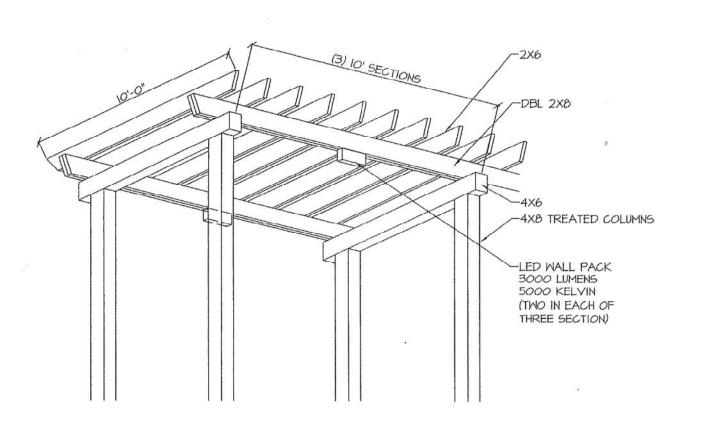
## PURGOLA SIDE ELEVATION

Scale 1/4"=1'-0"



PURGOLA FRONT ELEVATION

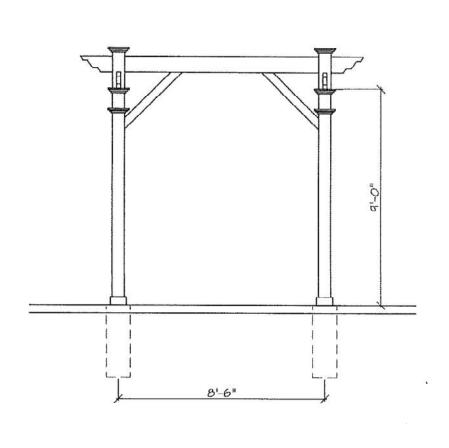Scale 1/4"=1'-0"



**PURGOLA DETAIL** Scale 1/4"=1'-0"