2. INSTALL ALL PIPING TIGHT TO STRUCTURE.

3. SEE K-SHEET ELEVATIONS FOR KITCHEN EQUIPMENT WATER PIPING ROUGH-IN LOCATIONS.

4. AT 4" CONDUIT DROPS IN DRIVE-THRU, PROVIDE 1/8TH BEND FITTING WITH SHORT PIPE STUB AT BASE OF DROP. CUT STUB AND FITTING FLUSH WITH FINISHED WALL.

5. CONTRACTOR TO FIELD VERIFY ALL EXISTING CONDITIONS, INCLUDING LOCATION, FALL, DIRECTION OF FLOW AND CONNECTING INVERTS, PRIOR TO COMMENCING WORK. NOTIFY CHICK-FIL-A CONSTRUCTION REPRESENTATIVE IF EXISTING MAJOR DISCREPANCIES IN ROUTING OF SERVICE LINES ARE DISCOVERED IN FIELD.

6. IT IS THE RESPONSIBILITY OF THE CONTRACTOR TO VISIT THE SITE DURING BID PHASE, WITH EXISTING DRAWINGS PROVIDED BY THE OWNER IN ORDER TO DETERMINE THE TRUE AS-BUILT CONDITIONS OF THE POTABLE WATER, SANITARY, WASTE, VENT, AND OTHER PIPING SYSTEMS.

GENERAL CONTRACTOR SHALL BE RESPONSIBLE FOR REMOVING, STORING, AND RELOCATING EXISTING PLUMBING EQUIPMENT. PLUMBING CONTRACTOR TO COORDINATE DISCONNECTING OF EXISTING EQUIPMENT WITH GENERAL CONTRACTOR PRIOR TO COMMENCING WORK.


8. CONTRACTOR IS RESPONSIBLE FOR REPAIRING AND LEVELING OF FLOOR DEPRESSIONS IN AREAS WHERE EXISTING FLOOR DRAINS, CLEANOUTS AND/OR OTHER FLOOR ITEMS ARE BEING DEMOLISHED. ABANDONED. OR RELOCATED.

() KEY NOTES


- PROVIDE TRAP SEAL PROTECTOR P-26A.
- CONNECT TO EXISTING.
- 1/2" FW TO P-24 & P-34 AT TWO TEA BREWERS AND TWO COFFEE MAKERS. REFER
- PROVIDE NEW 3/4" HW AND 1/2" HWR BACK TO WATER HEATER. REFER TO DETAIL
- 3/4" FW DROP TO TWO-HANDLE FAUCET, P-30. MOUNT FAUCET ON WALL. SEE K-SHEETS FOR EXACT LOCATION. PIPE 1/2" FW TO EACH FAUCET INLET WITH 6" SPREAD. PROVIDE BALL VALVE ABOVE CEILING. SEE RISER DIAGRAM 2/P-102.
- REMOVE ASSOCIATED PIPING, FLOOR DRAIN, AND/OR CLEAN OUT WITH DASHED LINES AND CAP AT MAIN.
- EXISTING TO REMAIN.
- REMOVE VENT PIPING IN WALL AND CAP AT MAIN.

NOTES ABOUT (0,0) BENCHMARK ORIGIN


- THE (X=0, Y=0) BENCHMARK ORIGIN IS LOCATED AT THE INSIDE FACE OF FRAMING FOR THE EXTERIOR WALL AT THE CORNER WHERE SHOWN ON THE ADJACENT PLAN.
- IT IS EXTREMELY IMPORTANT FOR THE PLUMBING INSTALLER TO BECOME COMPLETELY FAMILIAR WITH THE FACE-OF-FRAMING POSITION AND ITS RELATION TO THE FLOOR SLAB CONSTRUCTION PRIOR TO BEGINNING THE UNDERSLAB PLUMBING ROUGH-IN...
- PLUMBING CONTRACTOR SHALL REVIEW STRUCTURAL DETAIL "TYPICAL SECTION @ EXTERIOR WALL" FOR PRECISE LOCATION OF FACE-OF-FRAMING WITH RESPECT TO THE SLAB INSTALLATION PRIOR TO LOCATING SLAB ROUGH-INS.

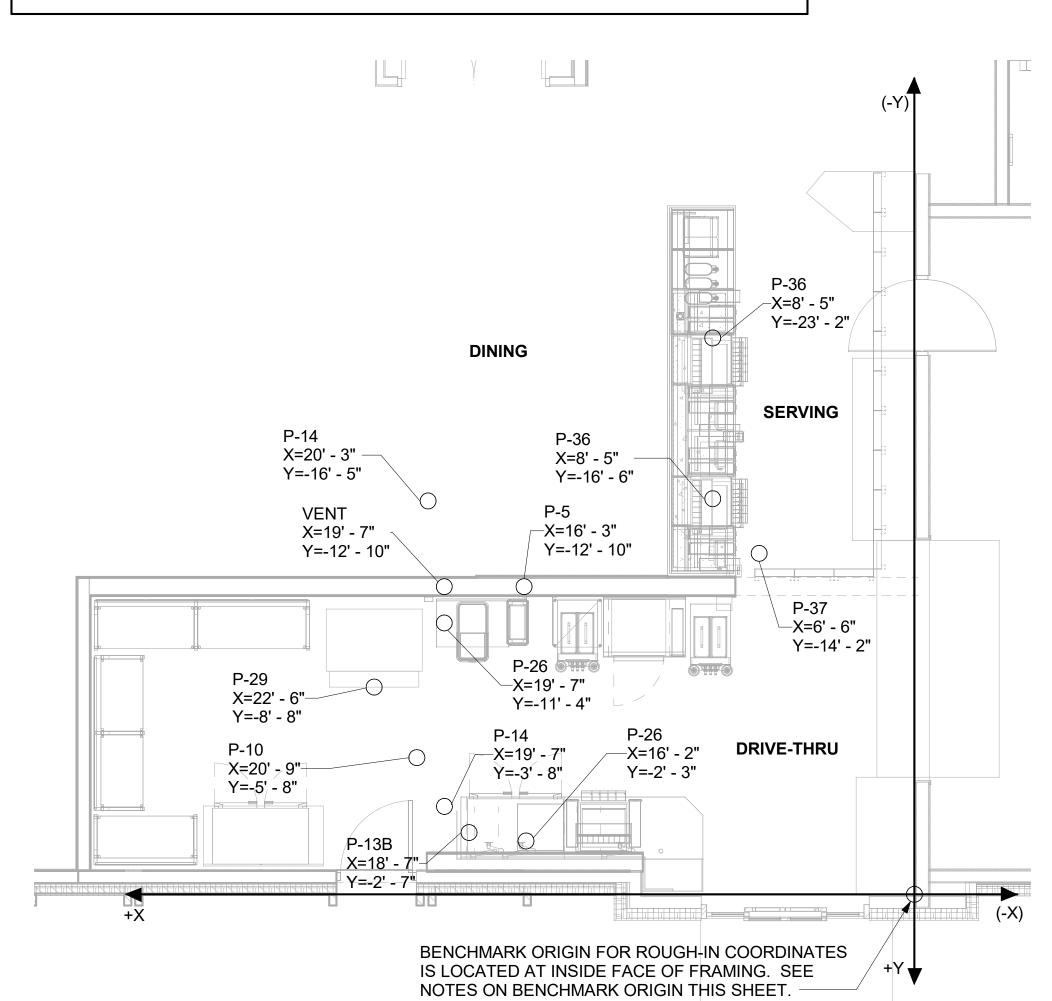


SLAB ROUGH-IN PLAN

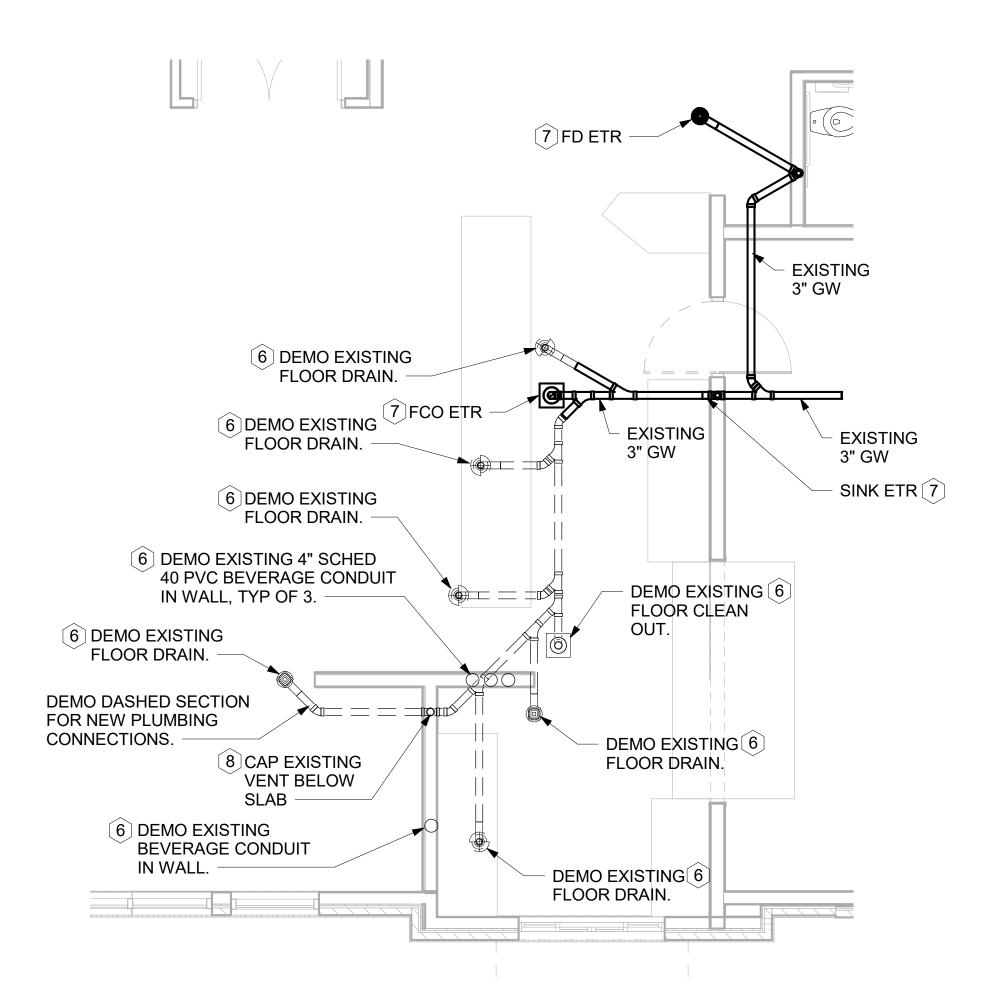

PLUMBING DEMOLITION PLAN

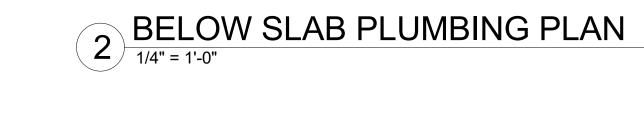

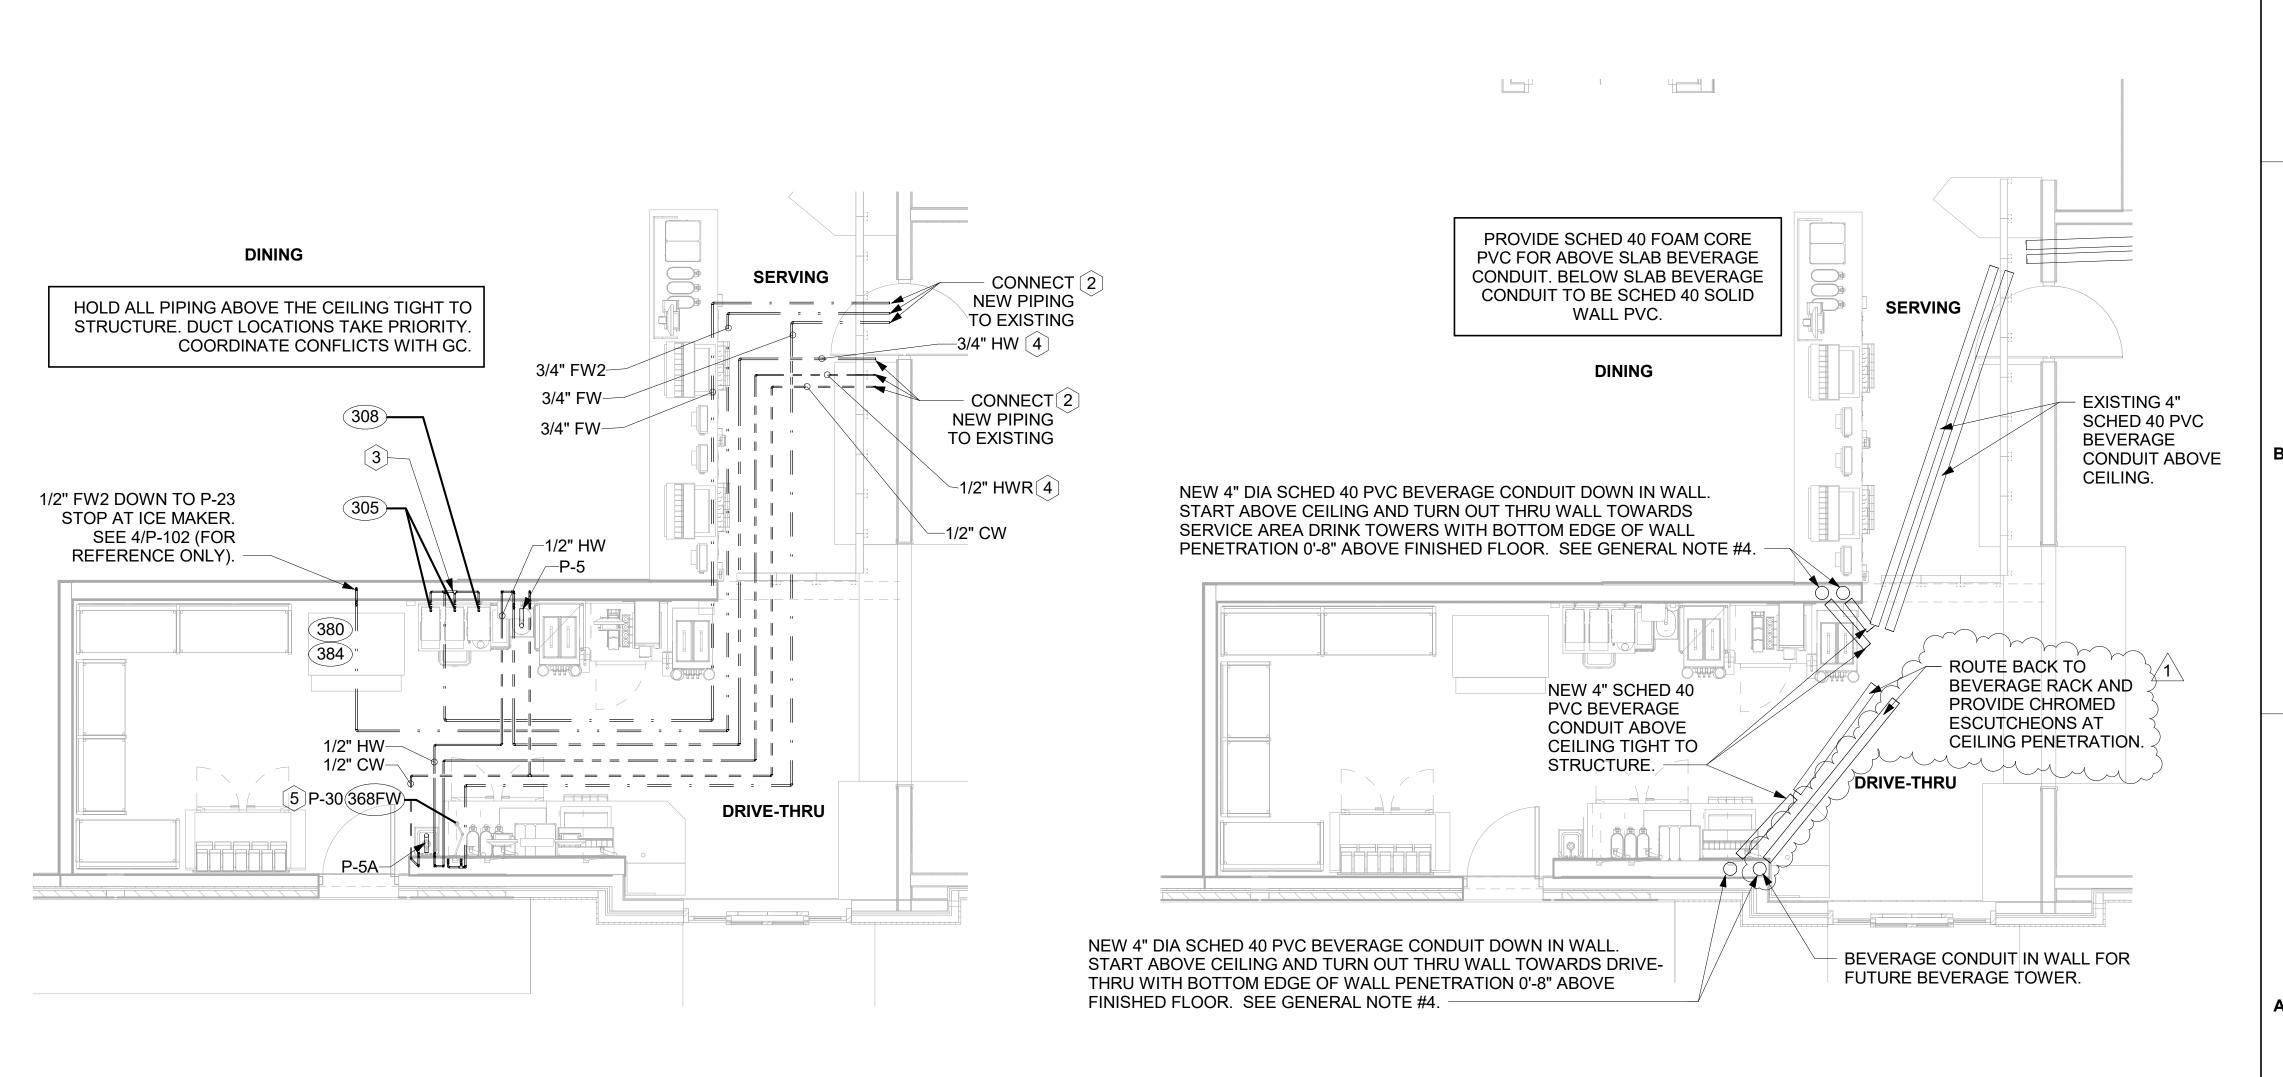

WATER PIPING PLAN PLUMBING

1/4" = 1'-0"

5 BEVERAGE CONDUIT PIPING PLAN

1/4" = 1'-0"

CONSTRUCTION
As Noted on Plans Review

Chick-fil-A

FD ETR

NEW FOOTING

DRIVE-THRU

ROUTE 3" DRAIN LINE

FROM BEVERAGE

TOWER IN FURRED

OUT WALL TO P-26.

EXISTING FOOTING

- EXISTING

3" GW

SINK ETR

P-36-

COORDINATE UNDERSLAB PLUMBING WITH

EXISTING FOOTING. GC TO AVOID ANY MODIFICATIONS TO GRADE BEAMS. SEE

STRUCTURAL PLANS FOR SPECIAL INSTRUCTIONS.

FCO ETR

DINING

3" FCO,

P-14—

3" GW-

3" FCO,



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2022,09-02\https://december.201202665725-05'00' ASSOCIATES, LTD E-2005011725-F

FSR#02859 RELEASE:

OTP NO. DATE 1 08/31/22 Owner Changes

PRINTED FOR

CONSULTANT PROJECT # 27-22-50043 OTP 07/08/2022 Information contained on this drawing and in all digital files produced for above named project may not be reproduced in any manner without express written or verbal consent from PLUMBING FLOOR PLANS

SHEET NUMBER

P-101

A3 ENLARGED SERVING AREA POWER PLAN 1/2" = 1'-0"

POWER PLAN KEYNOTES

- RECONNECT TO EXISTING CIRCUIT PREVIOUSLY FEEDING RELOCATED EQUIPMENT
- CONNECT TO EXISTING CIRCUIT VERIFY EXISTING CIRCUIT HAS SPARE CAPACITY.
- E.C. TO RELOCATE EXISTING DEVICE AND EXTEND EXISTING CIRCUIT AS NEEDED FOR RELOCATION OF EXISTING DIGITAL MENU BOARDS. REPLACE EXISTING DEVICE WITH GFI EQUIVALENT AS NEEDED PER LOCAL CODE.
- PROVIDE DUPLEX RECEPTACLE (SEE ELEVATIONS FOR MTG HT) IN AN ARLINGTON #DVFR2W DOUBLE-GANG RECESSED BOX FOR THE FLY SYSTEM ITEMS. DO NOT CUT THE CORDSET FURNISHED WITH THE UNIT, BUT COIL THE CORD ON THE BACK OF THE UNIT AND TUCK INTO THE BACKBOX.

SECURITY KEYNOTES

- PROVIDE SINGLE GANG JUNCTION BOX AND STAINLESS STEEL COVER PLATE WITH 7/8" HOLE IN CENTER. EXTEND 1" CONDUIT UP IN WALL TO ABOVE ACCESSIBLE
- EXTEND 3/4" RIGID CONDUIT FROM TOP OF STRIKE-SIDE DOOR FRAME CHANNEL TO ABOVE ACCESSIBLE CEILING.
- PROVIDE SINGLE GANG JUNCTION BOX WITHOUT COVERPLATE. EXTEND 1/2" CONDUIT UP IN WALL TO ABOVE ACCESSIBLE CEILING.
- EXTEND 1/2" CONDUIT FROM WINDOW'S FRAME MULLION (RIGHT SIDE) TO ABOVE ACCESSIBLE CEILING.

POS DATA KEYNOTES

- PROVIDE SINGLE-GANG JUNCTION BOX WITH A 1" CONDUIT EXTENDING UP INTO THE CEILING SPACE FOR POS MONITOR(S). COVER PLATE PROVIDED BY OWNER'S POS SYSTEM VENDOR.
- PROVIDE A 'RETROFIT' SINGLE GANG RING (CARLON #SC100RR) FOR OWNER'S DEVICE PLATE WITH A 1" EMPTY CONDUIT AT THE OPENING STUBBED UP INTO THE CEILING SPACE FOR OWNER'S DATA CABLES.
- PROVIDE SINGLE-GANG JUNCTION BOX WITH A 1" CONDUIT EXTENDING UP INTO THE CEILING SPACE FOR POS TERMINAL. POS SYSTEM SUPPLIER WILL PROVIDE COVER PLATE ON BOX.
- PROVIDE SINGLE-GANG EXTRA DEEP JUNCTION BOX MOUNTED ON THE MOUNTING PLATE WITHIN THE FRONT SERVING COUNTER CASEWORK. MOUNT BOX ADJACENT TO THE RECEPTACLE FOR EQUIPMENT 180. DO NOT MOUNT BOX BETWEEN EQUIPMENT 180 AND EQUIPMENT 182 RECEPTACLES.

ENLARGED POWER PLAN KEYNOTES

- JUNCTION BOX ABOVE CEILING FOR AD-1 AT THE DRIVE-THRU WINDOW.
- EXISTING SECURITY CAMERA, AND HME UNIT TO BE RELOCATED. VERIFY EXISTING CONDITIONS AND COORDINATE WITH THE OWERS SECURITY SYSTEM VENDOR TO RELOCATE THESE ITEMS AND POWER.

POS POWER KEYNOTES

- PROVIDE ORANGE ISOLATED GROUND (IG) DUPLEX RECEPTACLE.
- PROVIDE GROUND FAULT PROTECTION FOR THESE DEVICES VIA A GROUND FAULT CIRCUIT BREAKER IF LOCAL CODE DEFINES THIS A FOOD PREPARATION AREA.
- USE TYPE MC CABLE FOR THE ISOLATED GROUND CIRCUIT: #12 HOT, NEUTRAL, GREEN GROUND, STRIPED ISOLATED GROUND. EACH 15 AMP HOMERUN SHALL BE DEDICATED TO A CIRCUIT BREAKER VIA DEDICATED CONDUCTORS WITHIN A CABLE ASSEMBLY. ALL MC CABLES SHALL BE RUN OVERHEAD ABOVE THE CEILING AND RACKED TOGETHER ON J-HOOKS. NO SPLICES IN ANY HOMERUN CABLES FROM FIRST RECEPTACLE TO BREAKER.
- THE RECEPTACLE BACKBOX AND SYSTEM CABLE JUNCTION BOX FOR ITEMS 180 AND 182 SHALL BE TURNED HORIZONTAL. REFER TO THE KITCHEN EQUIPMENT ROUGH-IN ELEVATIONS FOR ADDITIONAL INFORMATION.


POWER PLAN GENERAL NOTES

- ALL SECURITY, POS, MUSIC, COMMUNICATIONS, AND POWER ROUGH-IN SHALL BE INSTALLED DURING THE FRAMING/ROUGH-IN PHASE OF CONSTRUCTION.
- REFER TO KITCHEN EQUIPMENT SHEETS FOR EQUIPMENT ELECTRICAL ROUGH-IN ELEVATIONS ABOVE FINISHED FLOOR.
- ALL EMPTY CONDUITS SHALL BE PROVIDED WITH PULL STRING.
- PROVIDE INSULATED BUSHING AT TERMINATION POINTS OF ALL
- CONDUITS FOR LOW VOLTAGE WIRING.
- THE ELECTRICAL INSTALLER SHALL COORDINATE THE ROUTING OF ALL CONDUIT IN THE BUILDING WITH OTHER TRADES (SPECIFICALLY THE DUCTWORK INSTALLATION) TO AVOID CONFLICTS OF SPACE REQUIREMENTS IN WALLS AND CEILING SPACES.





CONSTRUCTION As Noted on Plans Review

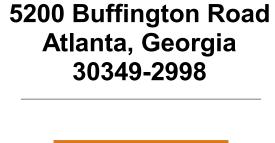


Chick-fil-A



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PE-2017005852 HARRISON FRENCH & ASSOCIATES, LTD E-2005011725-F

FSR#02859 BUILDING TYPE / SIZE:

REVISION SCHEDULE NO. DATE DESCRIPTION 1 09/02/2022 OWNER CHANGES

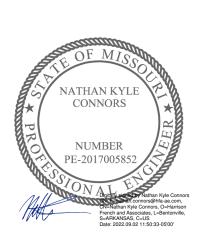CONSULTANT PROJECT # 27-22-50003 OTP 05/03/2022 Information contained on this drawing and in all digital files produced for above named project may not be reproduced in any manner without express written or verbal consent from

ENLARGED POWER PLAN

SHEET NUMBER E-302

THE INFORMATION USED TO DEVELOP THE EXISTING CONDITIONS AS SHOWN ON THESE PLANS IS FROM PREVIOUS BUILDING DRAWINGS. WHAT WAS SHOWN ON PLAN AND WHAT IS ACTUALLY INSTALLED MAY VARY. FIELD VERIFY ALL EXISTING CONDITIONS.

NEW PANELBOARD

PHASES: 3

VOLTS: 120/208 Wye

A.I.C. SERIES RATING: 65K/10K

MAINS TYPE: MLO

Branch Panel: A

LOCATION: BOH

SUPPLY FROM: MDP

		LOCATION: BOH SUPPLY FROM: MDP MOUNTING: FLUSH ENCLOSURE: NEMA 1				PH	/OLTS: HASES: WIRES:		8 Wye			A.I.	C. SERIES RATING: 65K/10K MAINS TYPE: MLO MAINS RATING: 250 A	(
Γ	NT	1 KITCHEN LTG	TRIP 20 A	POLE 1		A 1.620		B)	POLE		LOAD DESCRIPT BUILDING SIGNAGE	rion (CKT 2	NT
		3 KITCHEN LTG	20 A	1	1.124	1.020	1.553	1.620			1		BUILDING SIGNAGE		4	
		5 RESTROOM LTG & EF-3	20 A	1			1.000	1.020	0.748	0.000	-		SPARE		6	
		7 DINING AREA LTG	20 A	1	1.221	0.000					1	20 A	SPARE		8	
		9 PLAY AREA LTG	20 A	1			0.542	0.000			1	20 A	SPARE		10	
		11 DINING AREA LTG	20 A	1					0.801	0.624	1		SECURITY/FLAGPOLE LTG		12	
		13 SERVING AREA LTG	20 A	1	0.232	0.000					1		SPARE		14	
		15 SPARE	20 A	1			0.000	0.000	4 740	0.700	1		SPARE		16	
		17 MENUBOARDS 19 DIRECTIONAL SIGNS	20 A 20 A	1	1 080	0.416			1.740	0.786	1		AWNING LTG BLDG LTG		18	
		21 PARKING LOT LTG	20 A	1	1.000	0.410	0.930	0.416			1		BLDG LTG		22	
		23 PARKING LOT LTG	20 A	1			0.500	0.410	0.930	0.000			SPARE		24	
		25 PARKING LOT LTG	20 A	1	0.930	0.000					1		SPARE		26	
		27 PARKING LOT LTG	20 A	1			0.930	0.000			1	20 A	SPARE		28	
		29 PARKING LOT LTG	20 A	1					0.930	0.000	1	20 A	SPARE		30	
		31 PARKING LOT LTG	20 A	1	0.930	0.000					1	20 A	SPARE		32	
		33 MENUBOARD COVE LTG	20 A	1			0.160	0.000			1		SPARE		34	
		35 FRZR/COOLER LTG	20 A	1					1.000	0.000			SPARE		36	
		37 MAIN ID SIGN	20 A	1	1.620	0.780	4.000	4.000			1		DRIVE - THRU CANOPY		38	
		39 MAIN ID SIGN 41 MAIN ID SIGN	20 A 20 A	1			1.620	1.620	1 620	1.620	1		BUILDING SIGNAGE BUILDING SIGNAGE		40 42	
		oad Classification		Total Load: 9.9			5 kVA 9.39 kVA 3.7 A 78.2 A			10.80 kVA 90.7 A		207	DOILDING CICIVACE		72	
	Load C			Connected Load			Demand Factor			Estimated Damand			Panel To	otals		
	LIGHTI		30140 VA			125.00%			Estimated Demand 37675 VA				ranei it	Diais		
		assification		VA			0.00%	-		0 VA			Total Conn. Load: 3	0.1 kVA		
													Total Est. Demand: 3			
\dashv													Total Conn.: 8 Total Est. Demand: 1			
													Total Est. Demand:	U4.6 A		
	1	Branch Panel: E LOCATION: BOH SUPPLY FROM: MDP MOUNTING: FLUSH ENCLOSURE: NEMA 1		VOLTS: 120/208 Wye PHASES: 3 WIRES: 4 A.I.C. SERIES RATING: 65K/10K MAINS TYPE: MLO MAINS RATING: 400 A												
_	NT	CKT LOAD DESCRIPTION	TRIP			A	I	В	(C	POLE		LOAD DESCRIPT	rion (СКТ	NT
\dashv		1 ROOF TOP UNIT AC-1	150 A	3	15.120	4.080	45 100	4.000			3		ROOFTOP UNIT AC-2		2	
		3 5					15.120	4.080	15 120	4.080					6	<u></u>
		7 ROOFTOP UNIT AC-3	80 A	3	7 920	4.080			13.120	7.000	3	50 A	ROOFTOP UNIT AC-4		8	
_		9			7.520	1.000	7.920	4.080							10	
		11							7.920	4.080					12	
		13 ELECTRIC DUCT HEATER	90 A	3	8.330	4.068					3	45 A	HEATED AIR DOOR (AD-1)		14	N
		15					8.330	4.068							16	
		17							8.330	4.068					18	
		19 WALL HEATER	20 A	2	0.375	0.960					1	20 A	UNHEATED AIR DOOR		20	
		21					0.375	0.000					SPACE		22	
		23 SPACE			0.000	0.000			0.000	0.000			SPACE		24	
		25 SPACE			0.000	0.000	0.000	0.000					SPACE		26	
-		27 SPACE 29 SPACE					0.000	0.000	0.000	0.000			SPACE SPACE		30	
		29 OFACL	Total	Load: Amps:		13 kVA 4.9 A		7 kVA 5.9 A	43.60	0.000 0 kVA 5.3 A			SFACE		30	
						_										
	Load C HEAT	lassification	Connec	Demand Factor 100.00%				Estimated Demand 12204 VA			Panel Totals					
		HEAT HVAC COOL		04 VA 300 VA			100.00%			120300			Total Conn. Load: 1 Total Est. Demand: 1	32.5 kVA		
					_								Total Conn.: 3 Total Est. Demand: 3			

EXISTING PANELBOARD

VOLTS: 120/208 Wye

A.I.C. SERIES RATING: 65K/10K

Branch Panel: C

LOCATION: BOH

EXISTING PANELBOARD

VOLTS: 120/120 Single PHASES: 1

A.I.C. SERIES RATING: 10K **MAINS TYPE:** MLO WIRES: 3 MAINS RATING: 100 A MCB RATING: PROVIDE A JUMPER FOR PHASE A & B

NT CKT B POLE TRIP LOAD DESCRIPTION CKT NT LOAD DESCRIPTION TRIP POLE 15 A 1 0.151 0.121 IG,H 1 COUNTER POS STATION (180/182) 1 15 A COUNTER POS STATION (180/182) 2 IG.H IG,H 3 COUNTER POS STATION (180/182/183) 0.227 | 0.360 | 1 | 15 A | NETWORK CABINET 15 A IG,H 5 COUNTER POS STATION (180/182) 15 A OFFICE RECEPTACLE 15 A | 1 | 0.106 | 0.180 0.090 0.150 1 15 A 4 MONITORS 7 DRIVE THRU POS STATION 9 DUAL DT MONITORS 15 A 1 0.110 0.000 1 15 A SPARE 11 SPARE 0.000 | 0.000 | 1 | 20 A | BACKFED MAIN BREAKER Total Load: 0.67 kVA 0.83 kVA

Total Amps: 11.1 A 12.4 A **Load Classification** Demand Factor Estimated Demand Panel Totals Connected Load MISCELLANEOUS 1494 VA 100.00% 1494 VA Total Conn. Load: 1.5 kVA **Total Est. Demand:** 1.5 kVA Total Conn.: 12.4 A Total Est. Demand: 12.4 A

Distribution Panel: MDP

Branch Panel: POS

LOCATION: OFFICE

MOUNTING: FLUSH

ENCLOSURE: NEMA 1

SUPPLY FROM: A

LOCATION: OUTSIDE **SUPPLY FROM: UTILITY** MOUNTING: SURFACE **ENCLOSURE**: NEMA 3R

VOLTS: 120/208 Wye PHASES: 3 WIRES: 4

EXISTING PANELBOARD

A.I.C. SERIES RATING: 65K MCB RATING:

MAINS TYPE: MLO MAINS RATING: 1200 A

NT CKT LOAD DESCRIPTION TRIP POLE POLE TRIP LOAD DESCRIPTION CKT NT N 1 PANEL A 3 250 A PANEL C 4 ---- 3 --25.02 9.39 | 25.65 | 10.80 | -- | -- | ---- | 5 |--6 ---7 PANEL B 3 400 A PANEL D 250 A 3 31.86 63.71 10 --33.13 | 63.71 | -- 9 ---- 11 --31.90 | 63.71 13 PANEL F 400 A 3 44.93 -- 15 --43.97 43.60 19 TVSS 30 A 3 0.00 -- 21 --0.00 -- 23 --Total Load: 176.2 kVA 175.2 kVA 175.7 kVA

LOAD SUMMARY

Total Amps: 1469.0 A 1460.2 A 1464.4 A

TOTAL CONNECTED KVA | IF TOTAL LOAD IS 0_200 | IF TOTAL LOAD IS 201_325 | IF TOTAL LOAD IS 326-800 | IF TOTAL LOAD IS OVER 800 | DIVERSIFIED AMPS AT 208 VOLT

CALCULATONS PER NEC 220.88

CONSTRUCTION As Noted on Plans Review

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CONNORS

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E-2005011725-F

BUILDING TYPE / SIZE:

REVISION SCHEDULE

NO. DATE DESCRIPTION 1 09/02/2022 OWNER CHANGES

CONSULTANT PROJECT # 27-22-50003 OTP 05/03/2022

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SHEET NUMBER E-501

PANELBOARD NOTES

- CONTROLLED BY RELAY IN CONTROL PANEL CFA-T500 AND STORE-OPEN EXHAUST FAN SWITCH. PANELBOARD SUPPLIER TO PROVIDE NOTATION ON CIRCUIT THAT THE CFA-T500 ALSO HAS AN INTEGRAL BREAKER ON THE FAN CIRCUITS FOR THE DISCONNECTION OF POWER AT THE CONTROLLER PER THE NEC. SEE CFA-T500 CONTROL PANEL CONNECTION DIAGRAM ON E-001.
- CONTROLLED BY EXTERIOR SIGN RELAY IN CONTROL PANEL CFA-T500.
- CONTROLLED BY EXTERIOR LIGHTING RELAY IN CONTROL PANEL CFA-T500. CONTROLLED BY EXTERIOR LIGHTING RELAY - DUSK TO DAWN ZONE.
- CONTROLLED BY PARKING LOT LIGHTING CONTROL SWITCH.
- GFCI TYPE BREAKER TO BE 30MA TYPE BREAKER.
- GROUND FAULT.
- THE CONTRACTOR SHALL PROVIDE GROUND FAULT PROTECTION FOR ALL 120 VOLT, 15 AND 20 AMP, RECEPTACLES IN THE KITCHEN/FOOD PREPARATION AREA. THE GROUND FAULT PROTECTION SHALL BE PROVIDED AT THE RECEPTACLE AS A GROUND FAULT TYPE RECEPTACLE UNLESS NOTED OTHERWISE. (NOTE THAT THE RECEPTACLES FOR THE OEP BOXES, THE KITCHEN/SERVING AREA, SERVING EQUIPMENT, AND THE CIRCUIT FOR THE FLY SYSTEM SHALL BE PROTECTED BY GROUND FAULT TYPE CIRCUIT BREAKERS RATHER THAN GROUND FAULT TYPE RECEPTACLES SINCE ISOLATED GROUNDING TYPE RECEPTACLES. AND CLOCK TYPE RECEPTACLES ARE NOT AVAILABLE AS GROUND FAULT TYPE.) GFCI BREAKERS REQUIRE A DEDICATED NEUTRAL (NOT SHARED) TO OPERATE PROPERLY.
 - GFCI TYPE BREAKER TO BE 5MA TYPE BREAKER.
- ISOLATED GROUND.
- CONTROLLED BY INTERIOR LIGHTING RELAYS IN CONTROL PANEL T-500. LIGHTS SHALL TURN ON WHEN STORE IS OCCUPIED.
- LOCK-ON.
- LOCK-OFF FOR MAINTENANCE.
- (M) HIGH MAG LOAD.
- (N) NEW CIRCUIT BREAKER PROVIDED BY CONTRACTOR.
- THRU (1) SB6100-020-0 GFCI PROTECTION DEVICE IN SB6000 PANEL ENCLOSURE OR (1)
- SB6100-021-0 GFCI PROTECTION DEVICE.
- ST) SHUNT TRIP. INTERLOCK W/ ANSUL SYSTEM VIA T-500 PANEL.
 - SURGE PROTECTION FOR INDIVIDUAL CIRCUIT. REF SHEET E-502 NOTES FOR TYPE.
 - ALL BREAKERS ARE EXISTING TO REMAIN EXCEPT WHERE NOTED OTHERWISE.

THE INFORMATION USED TO DEVELOP THE EXISTING CONDITIONS AS SHOWN ON THESE PLANS IS FROM PREVIOUS BUILDING DRAWINGS. WHAT WAS SHOWN ON PLAN AND WHAT IS ACTUALLY INSTALLED MAY VARY.

2

FIELD VERIFY ALL EXISTING CONDITIONS.