

ROOF PLAN
1/8" = 1'-0"
SIDE TO SIDE 9/12
FRONT TO BACK 8/12
RAFTERS 2 X 6 DF NO 2 @ 16" OC
HIPS AND RIDGES 2 X 8 DF NO 2




TURN STONE CORNERS (5)

FRONT EL.
STUCCO AND STONE




REAR EL.
1/8" = 1'-0"

TYPICAL WALL HEIGHTS 10'-1"

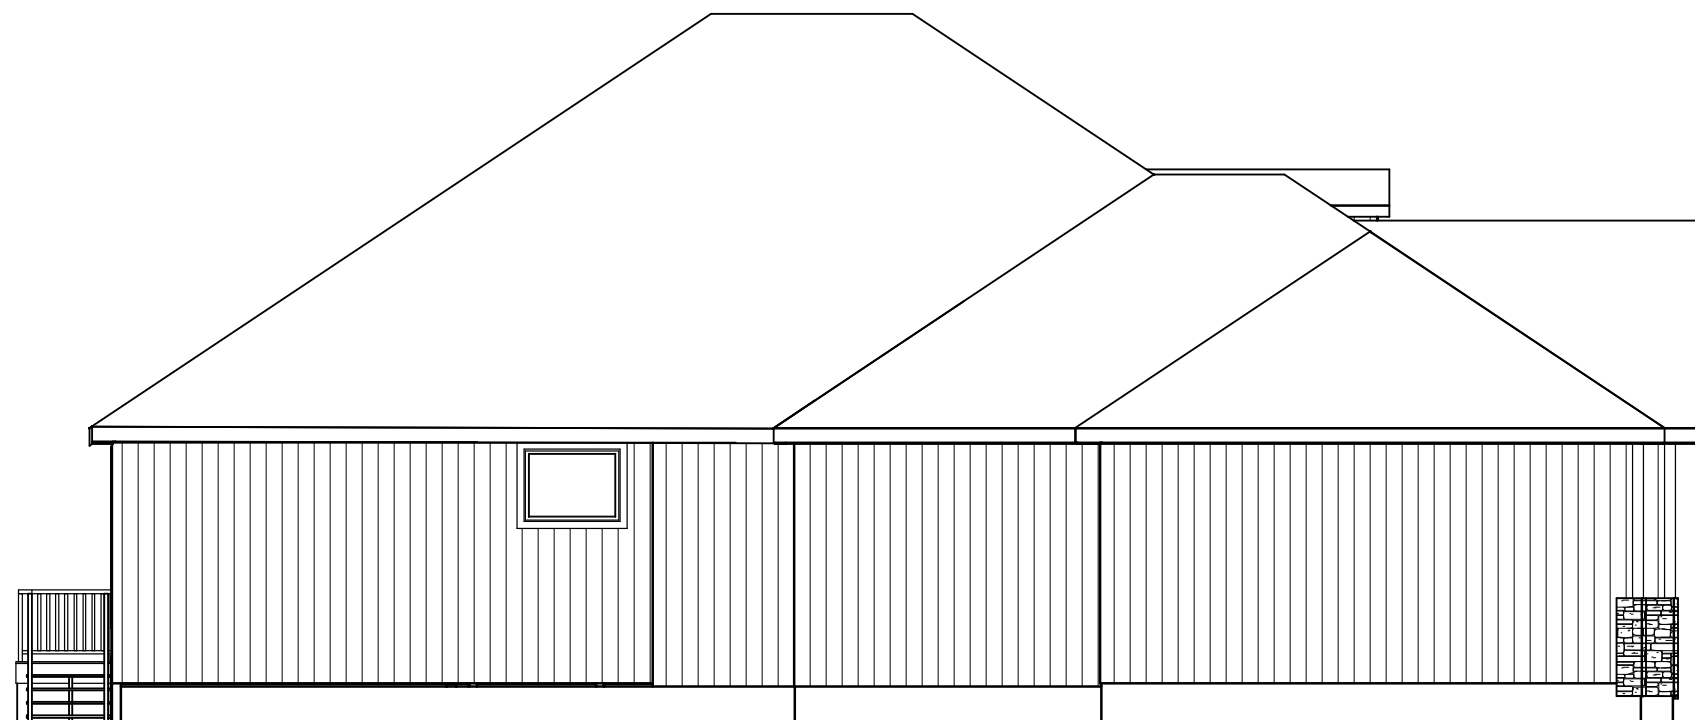

LEFT EL.
1/8" = 1'-0"

3 SIDES LP PANEL SIDING

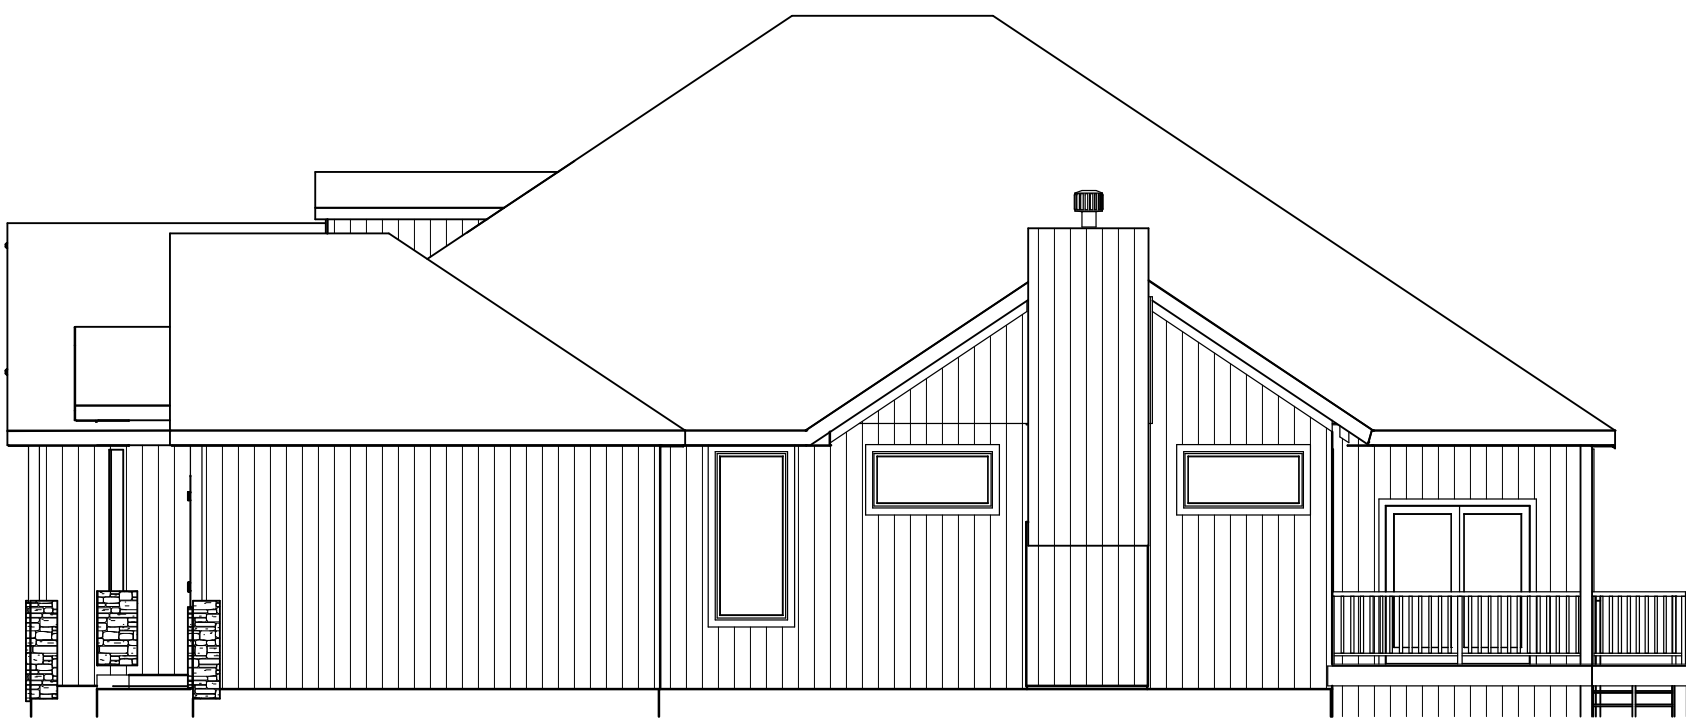

RIGHT EL.
1/8" = 1'-0"

RELEASE FOR
CONSTRUCTION
AS NOTED ON PLANS REVIEW
Development Services
LEE'S SUMMIT, MISSOURI



BUILD IN ACCORDANCE WITH
2018 INTERNATIONAL
RESIDENTIAL CODE AND
LOCAL CODES.


TRUMARK HOMES
KYLE VIII
LOT 170 RESERVE AT WOODSIDE RIDGE
2113 NW O'BRIEN RD
LEE SUMMIT MO

SCALE
1/4" = 1'-0"

DATE
6-14-22

PLAN NO.
3833

SHEET NO.
1 OF 5

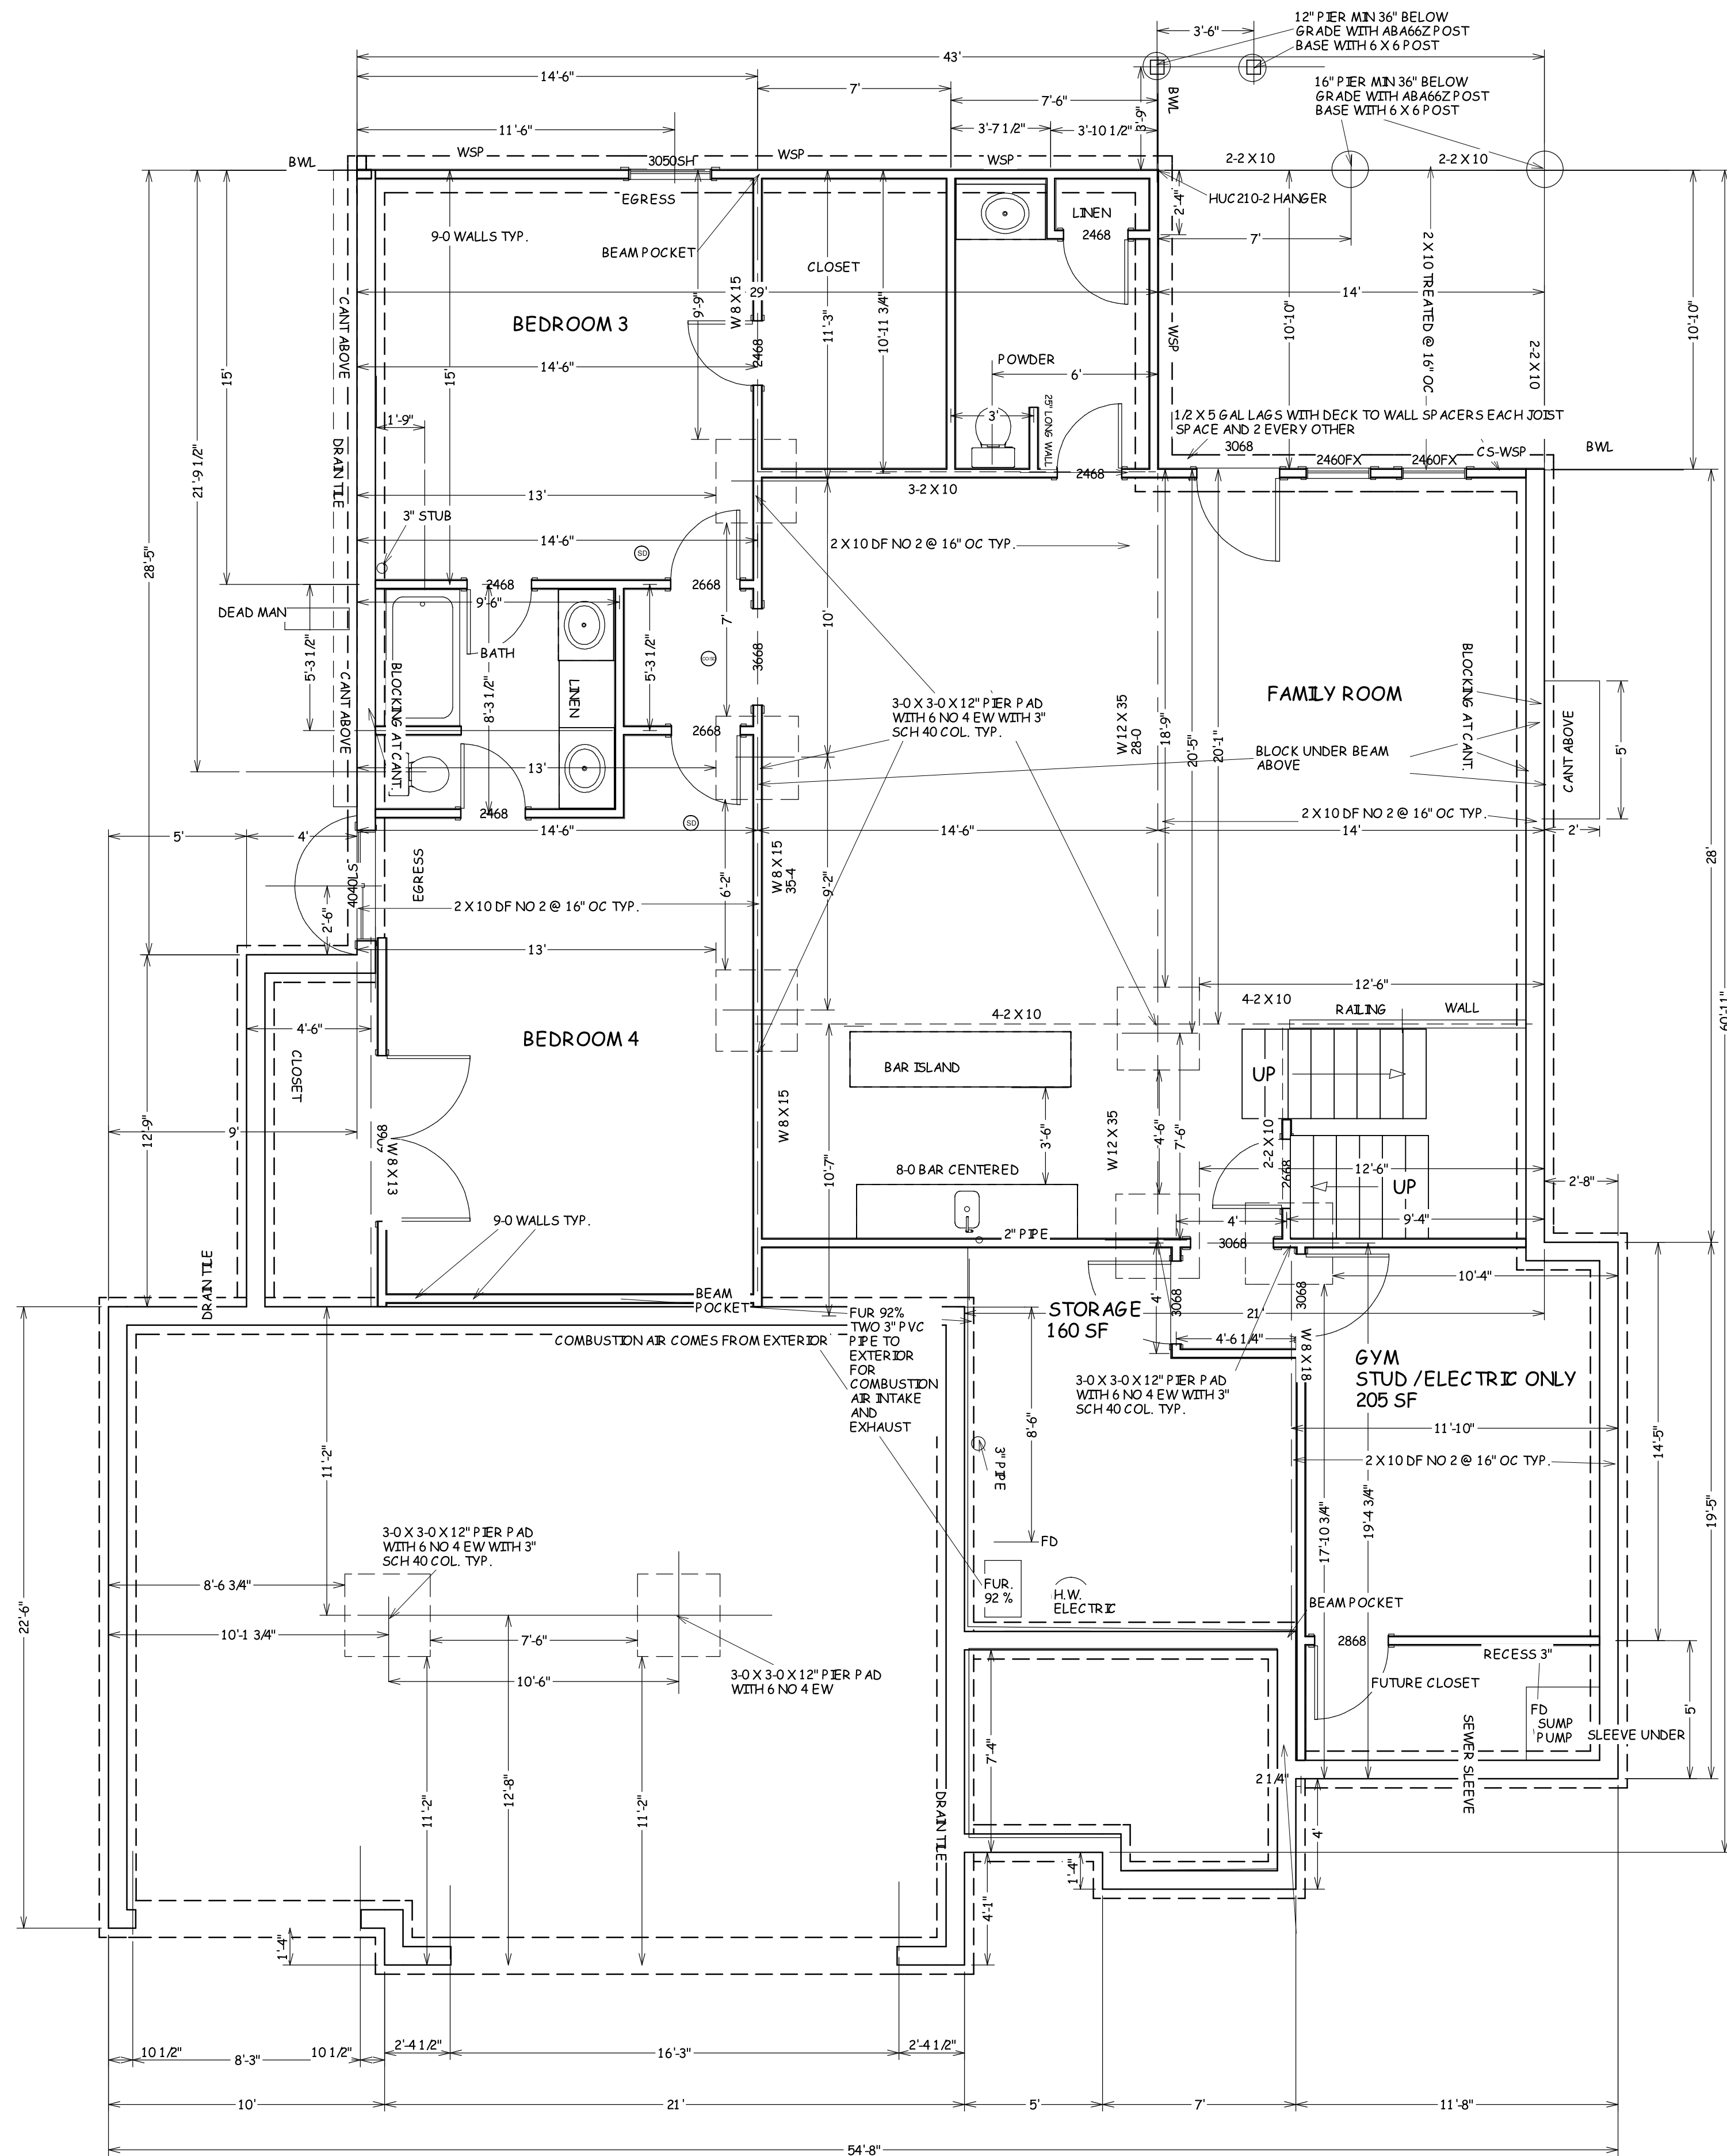

FOUNDATION PLAN
1414 SF FINISHED



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TRUMARK HOMES
KYLE VIII
LOT 170 RESERVE AT WOODSIDE RIDGE
2113 NW O'BRIEN RD
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SCALE
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DATE
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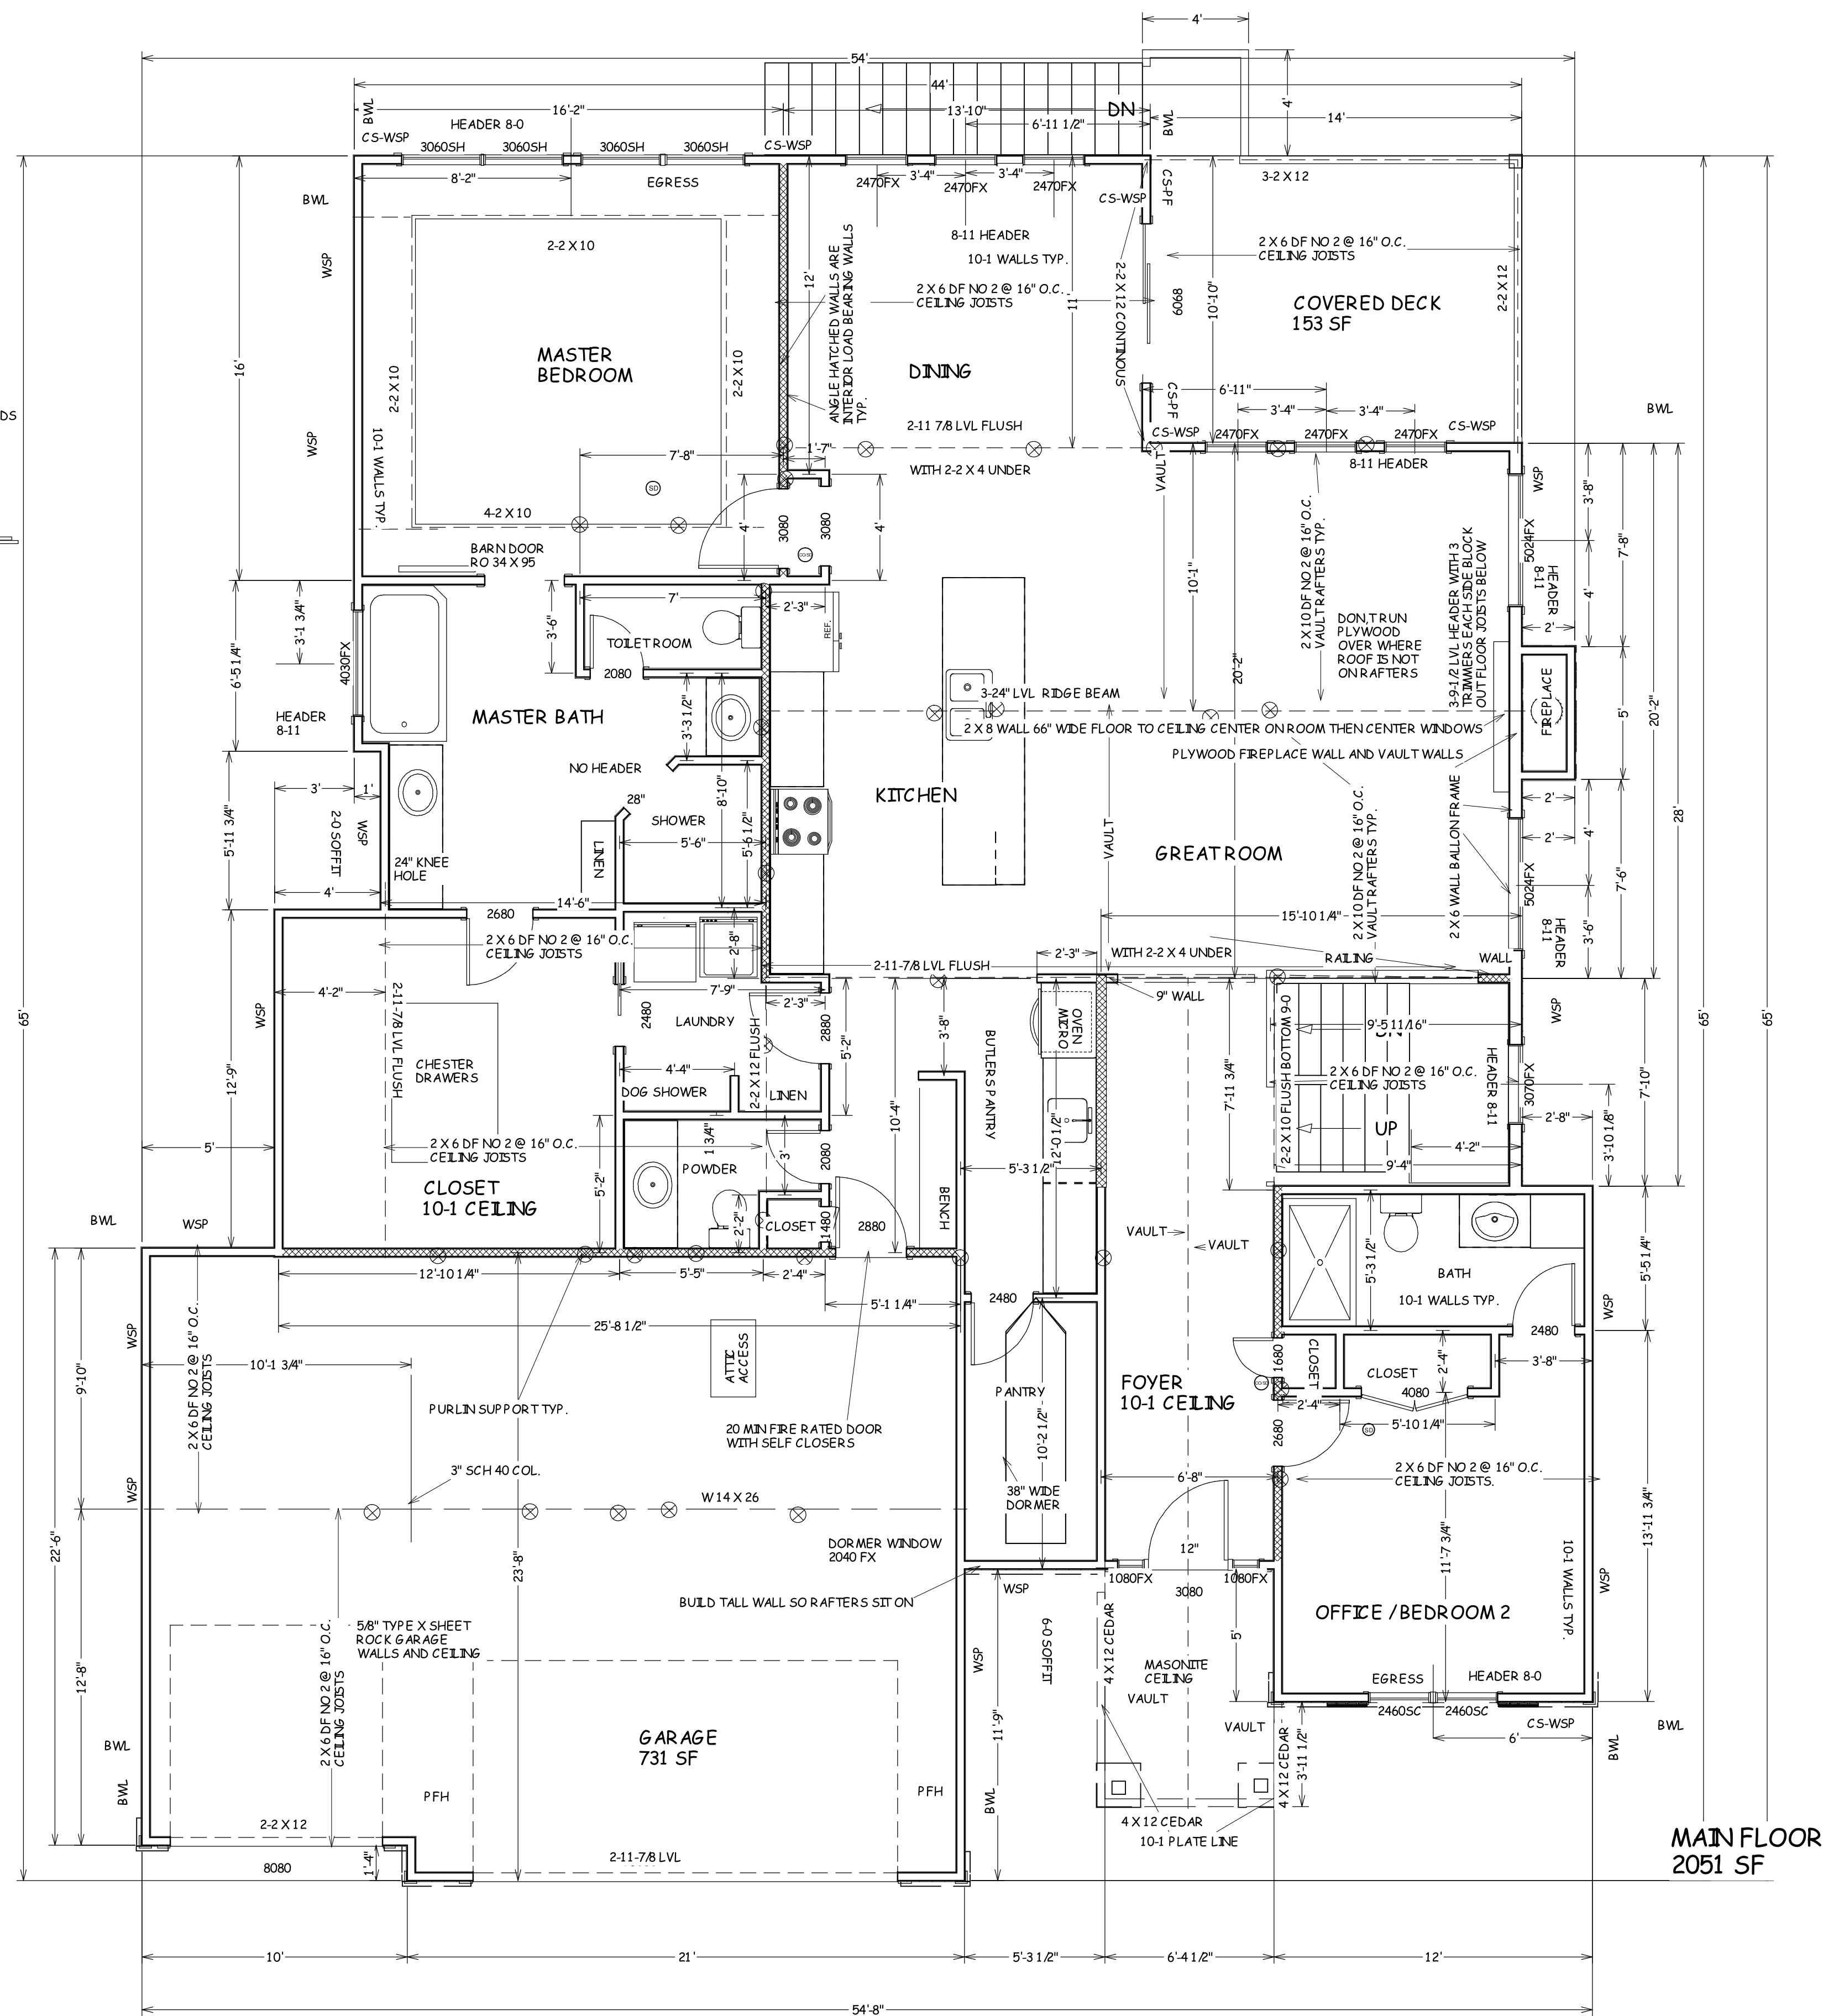
PLAN NO.
3833


SHEET NO.
2 OF 5

TRUMARK HOMES
KYLE VIII
LOT 170 RESERVE AT WOODSIDE RIDGE
2113 NW O'BRIEN RD
LEE SUMMIT MO

SHEET NO.
3 OF 5

STATE OF MISSOURI
REGISTERED PROFESSIONAL ENGINEER
DAVID PAUL AMOSWORTH
NUMBER R-10000
6-16-72



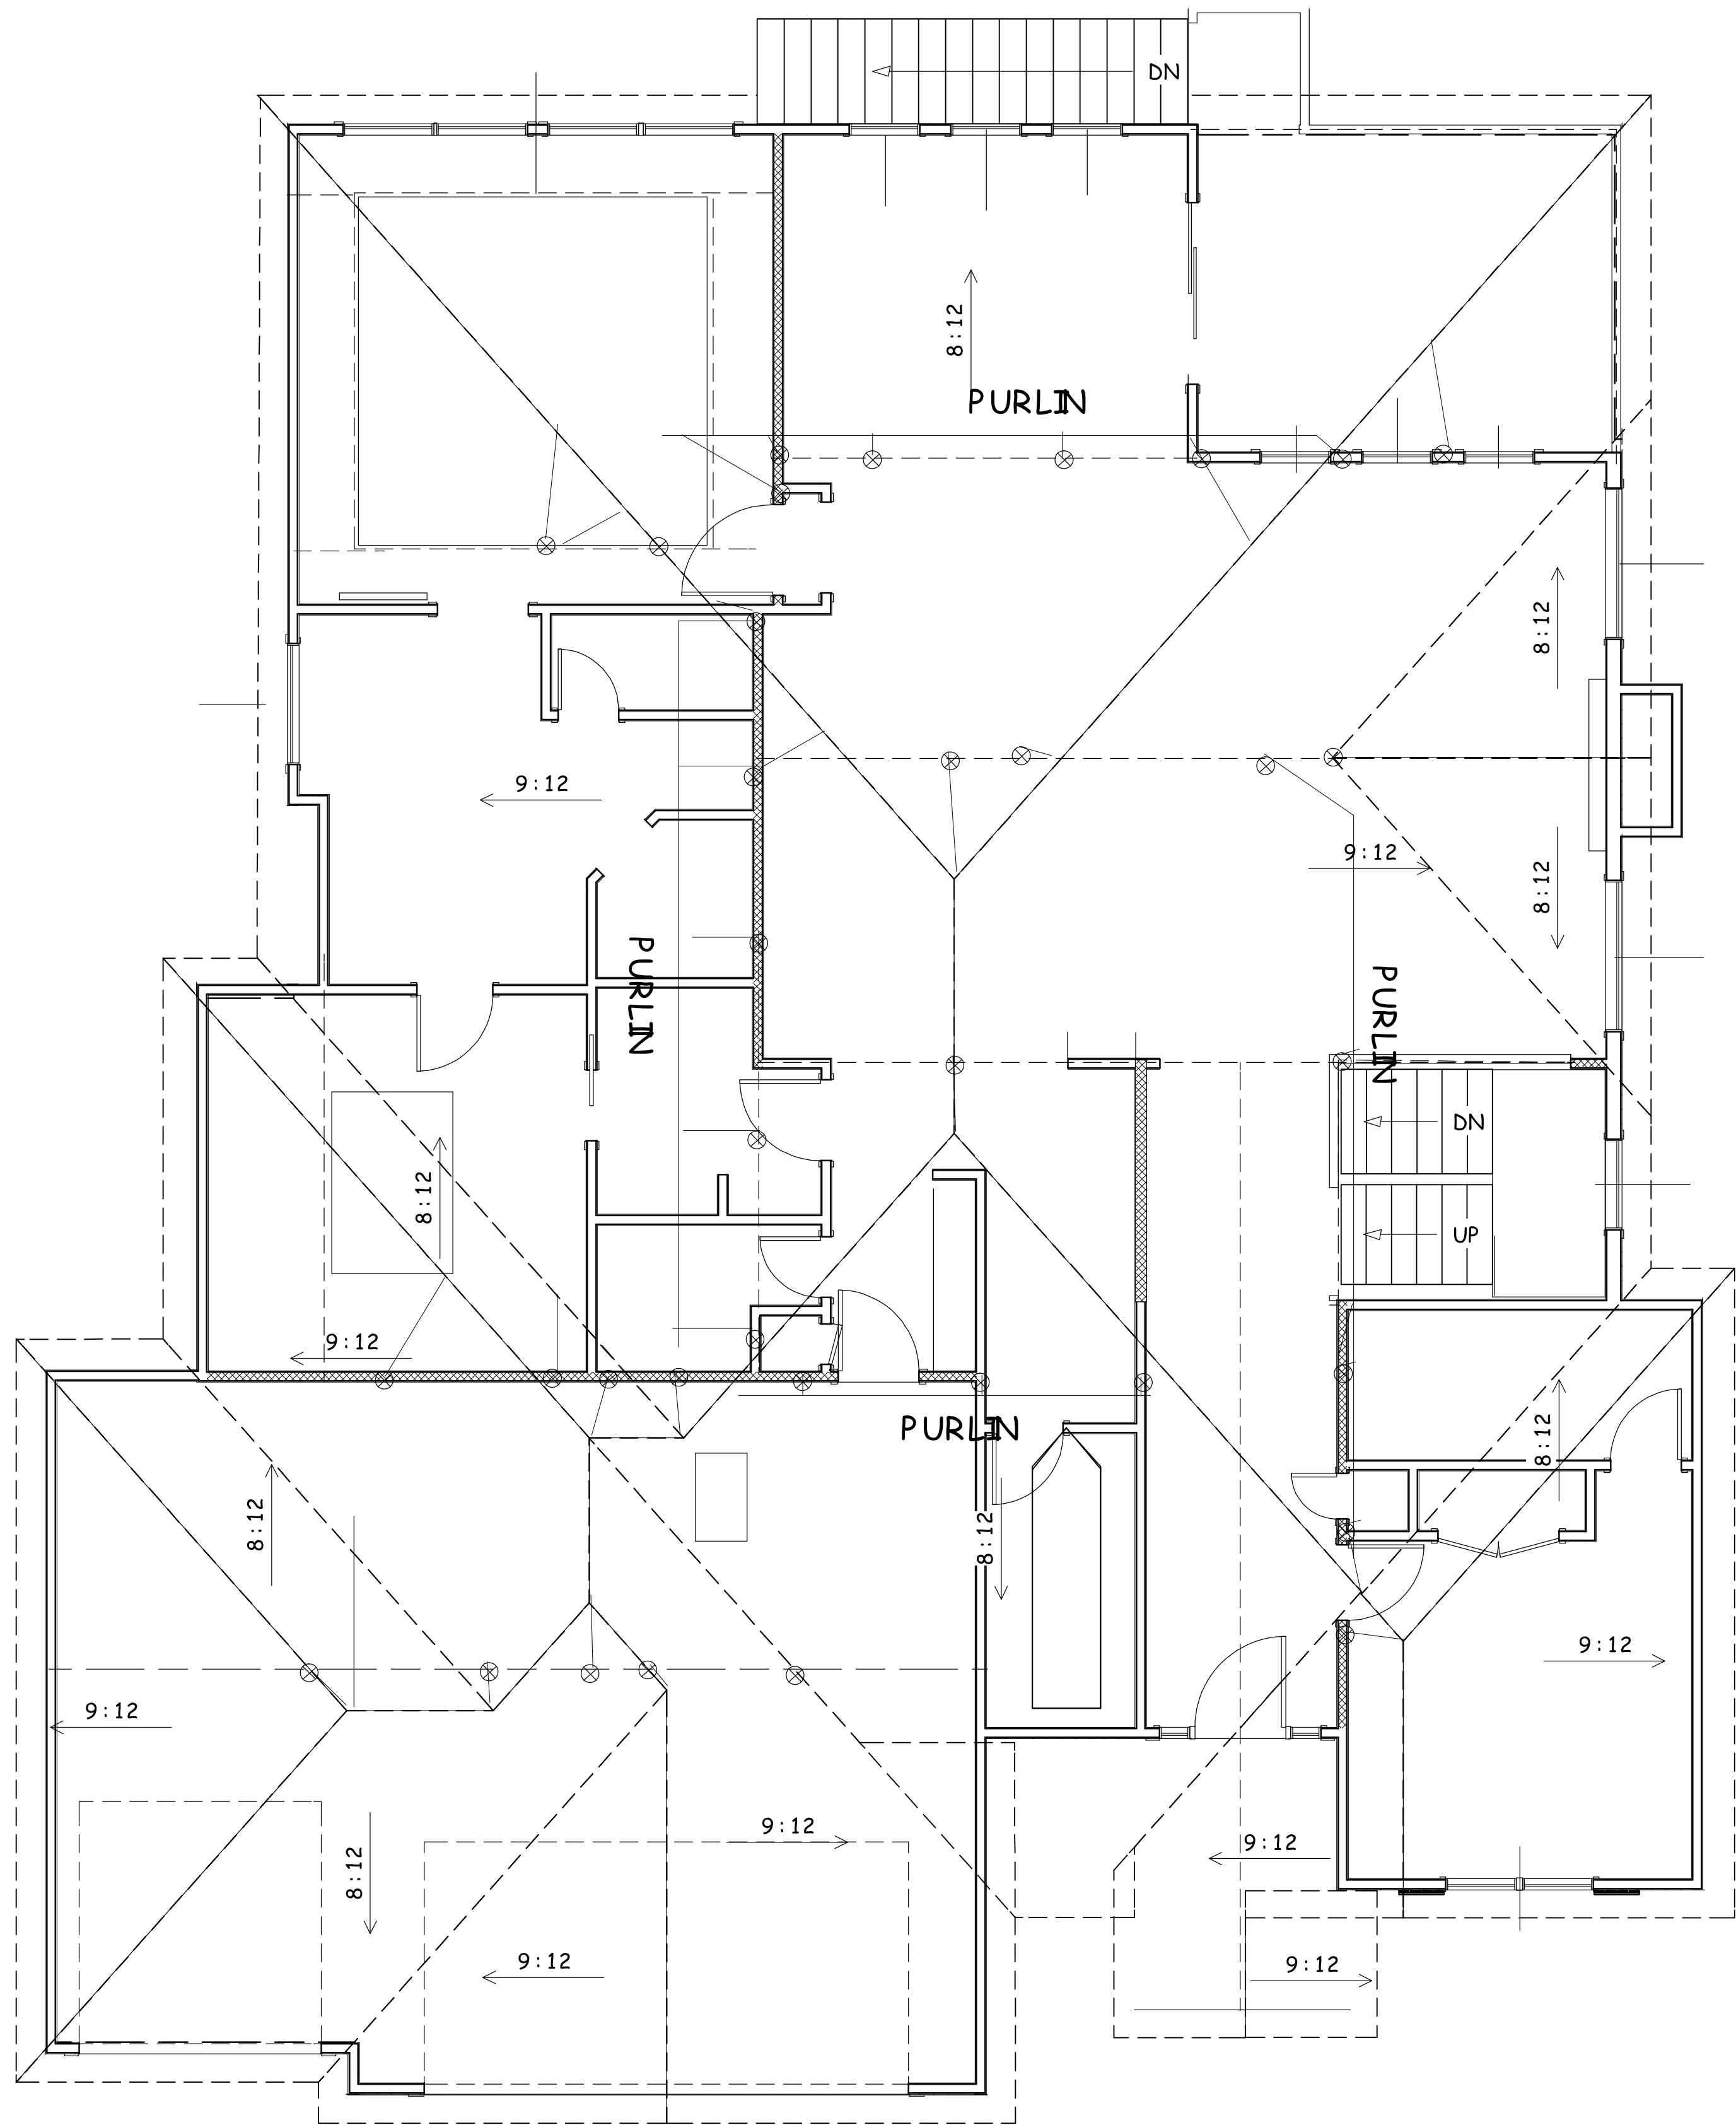

PURLIN PLAN

ENERGY CONSERVATION CODE
THE FOLLOWING VALUES ARE NEEDED.

R-15 IN WALLS

R-49 IN ATTICS

R-38 IN VAULTS
R-30 REDUCTION FOR VAULTS IS ONLY FOR 500 SF
PF AREA

R-19 IN FLOORS OVER UNCONDITIONED SPACES



R-10 IN CRAWL SPACE WALLS

BASEMENT WALLS R-13 CAVITY OR R-10 CONTINUOUS

SLABS SHALL BE R-10 FOR A DEPTH OF 2 FOOT

A WINDOW U FACTOR OF .35 OR BETTER

DUCTWORK NEEDS TO HAVE AN R-8 VALVE

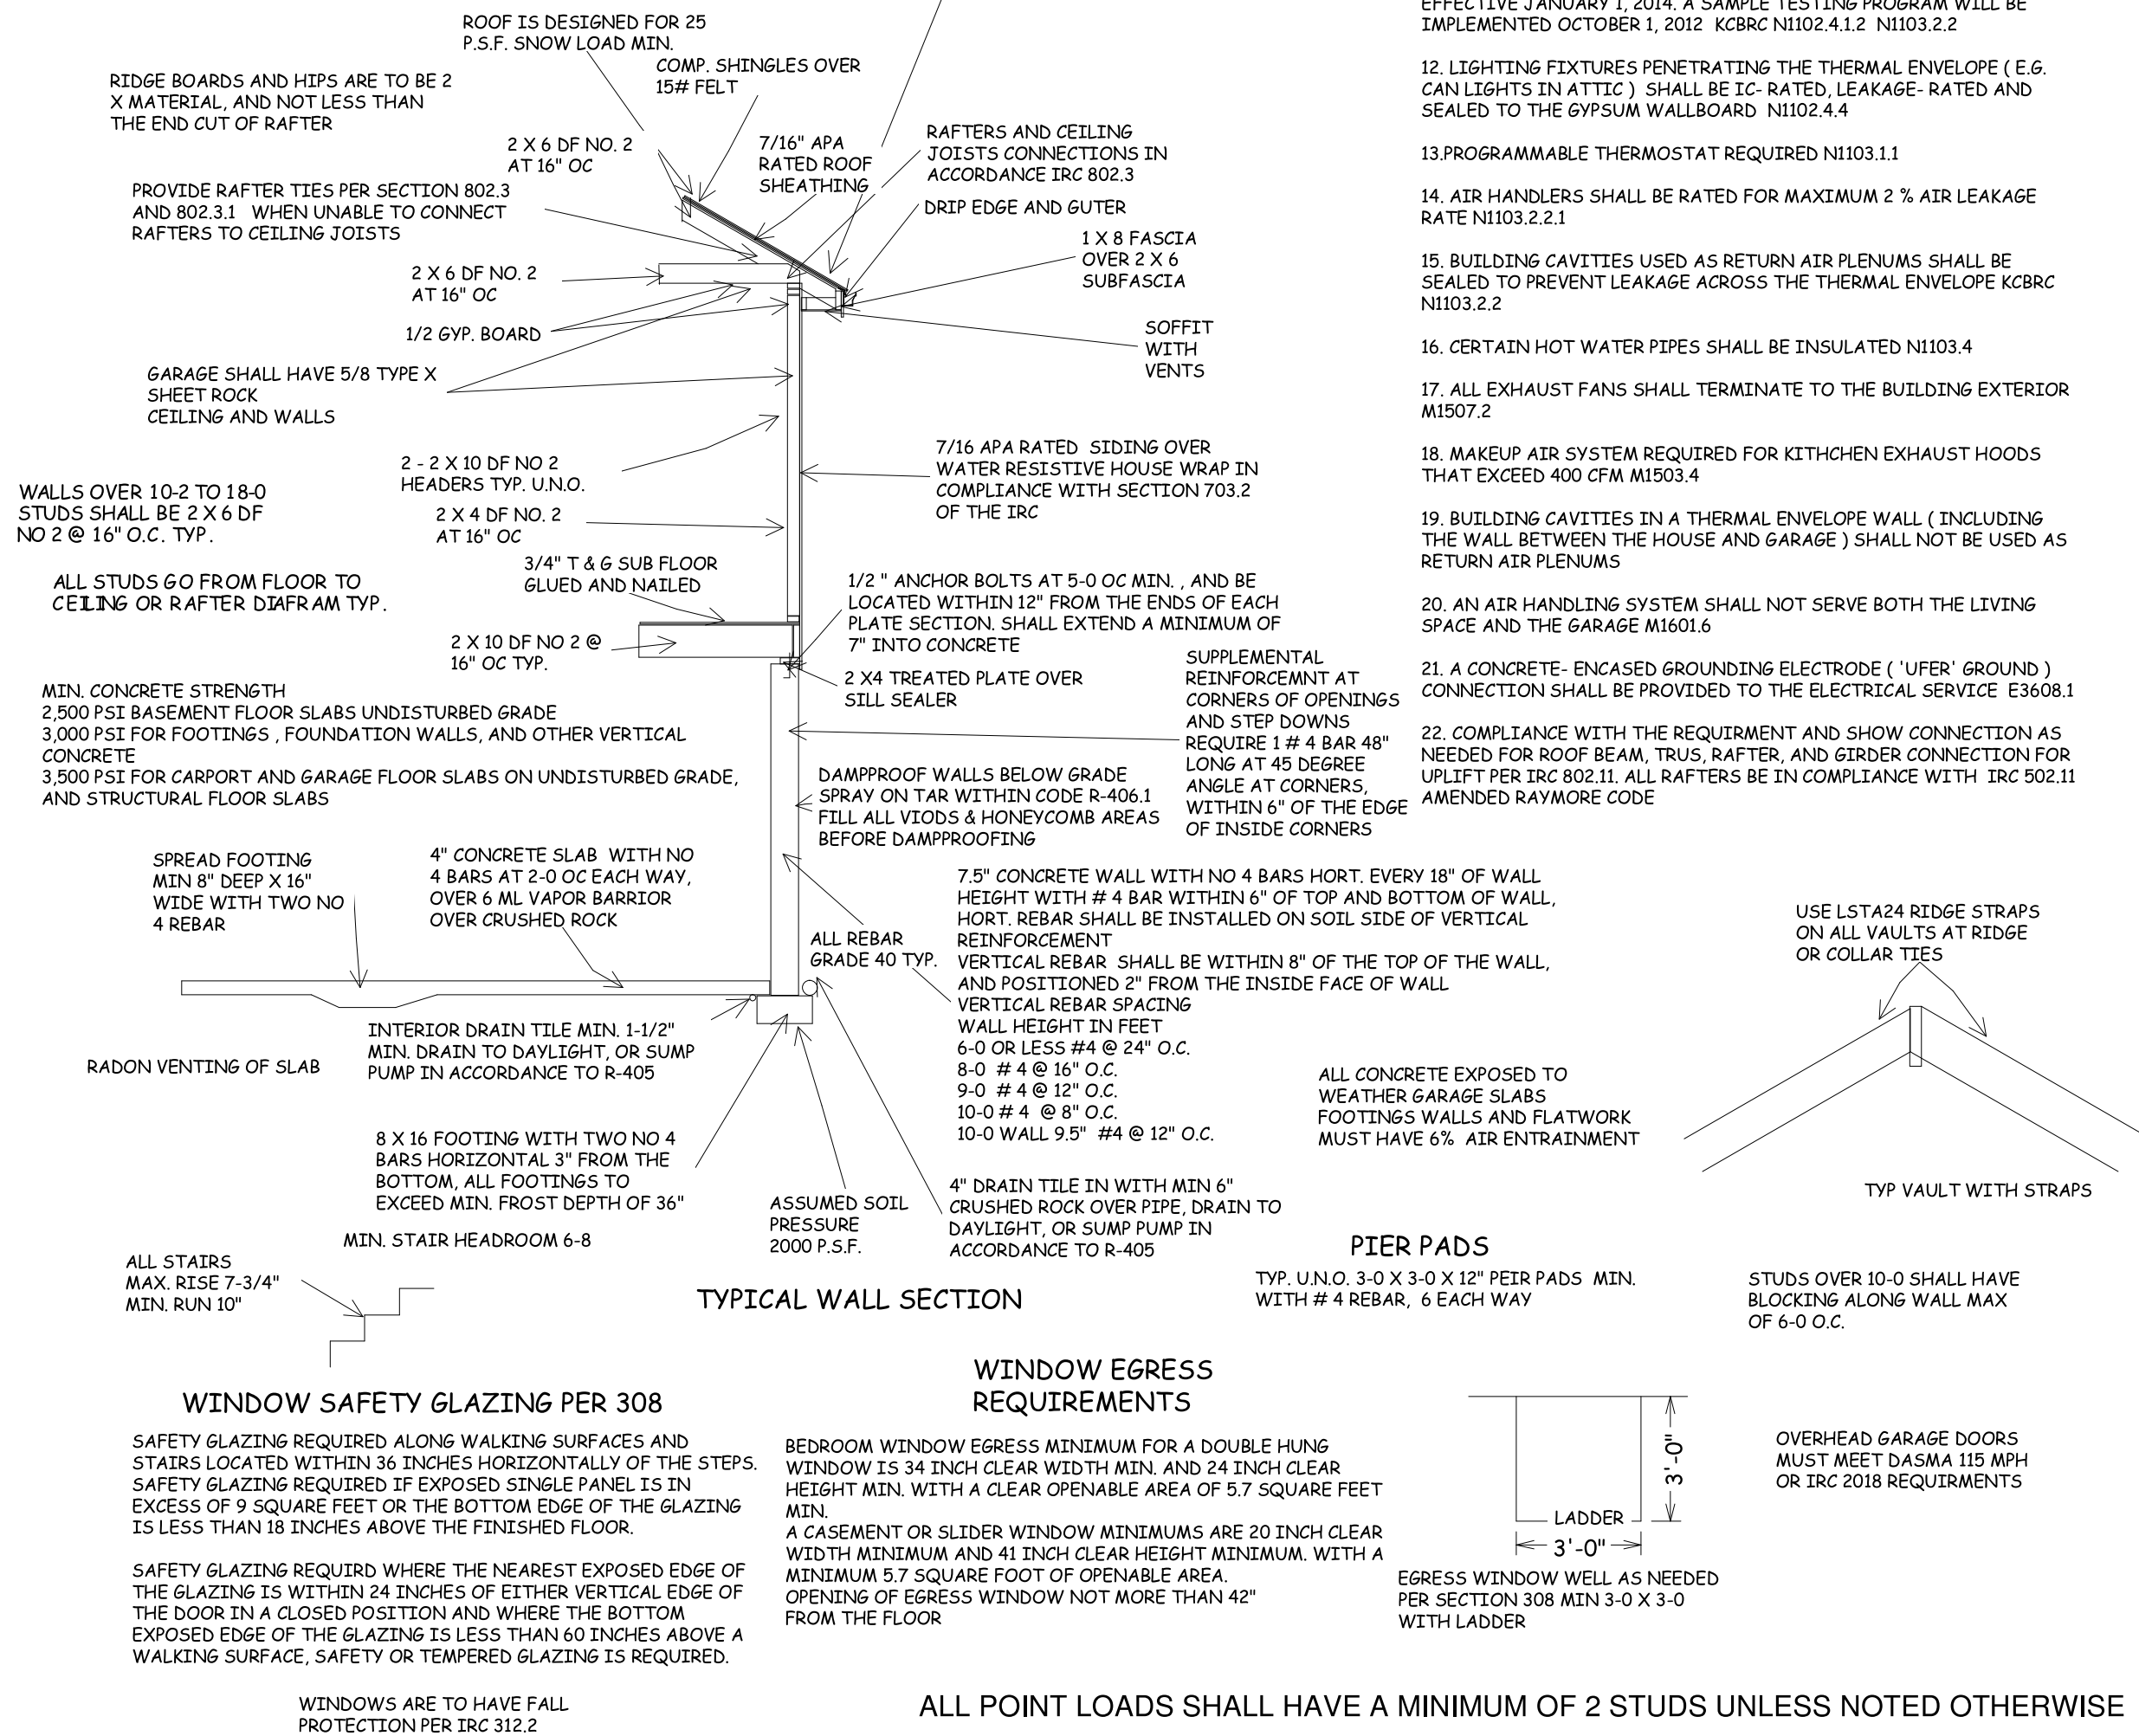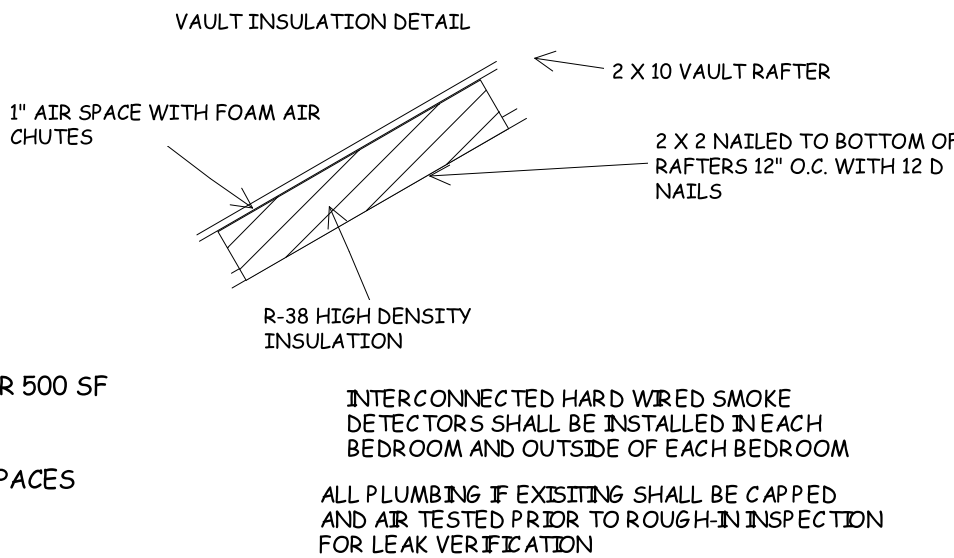

ALL POINT LOADS SHALL HAVE A MINIMUM OF 2 STUDS UNLESS NOTED OTHERWISE



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SHEET NO.
4 OF 5

