
RELEASE FOR CONSTRUCTION AS NOTED ON PLANS REVIEW DEVELOPMENT SERVICES LEE'S SUMMIT, MISSOURI 06/09/2022 11:37:06

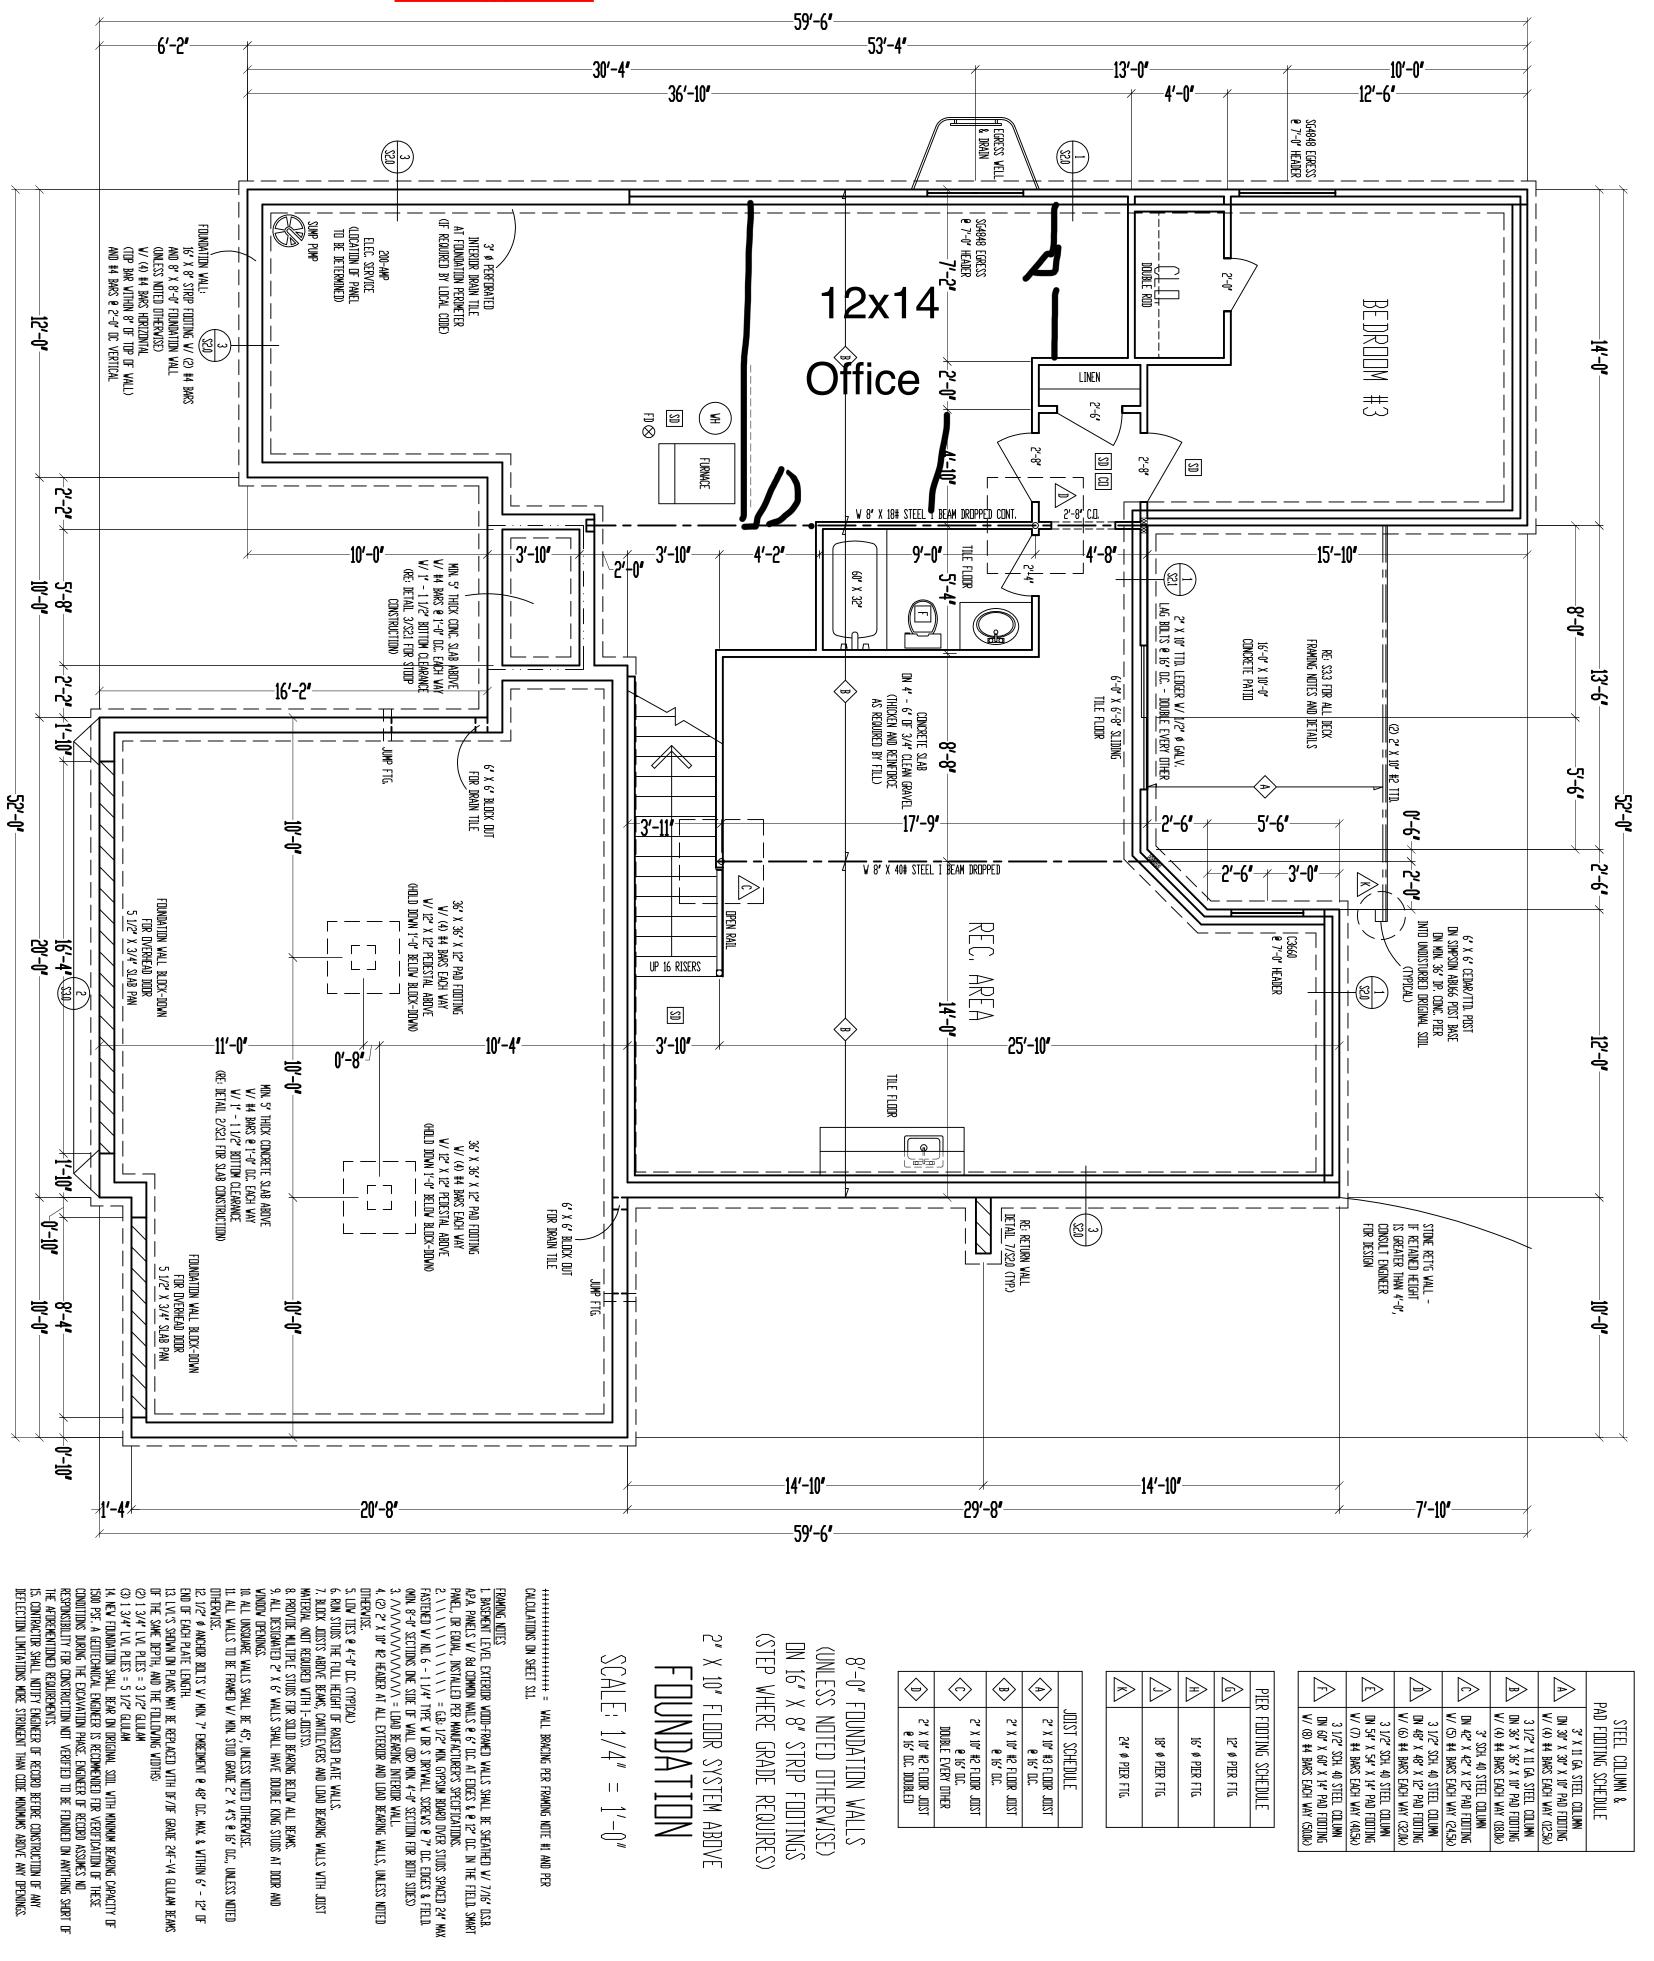

12. 1/2' Ø ANCHDR BOLTS W/ MIN 7' EMBEDMENT @ 48' D.C. MAX. & WITHIN 6' - 12' DF END DF EACH PLATE LENGTH.

13. LVL'S SHOWN ON PLANS MAY BE REPLACED WITH DF/DF GRADE 24F-V4 GLULAM BEAMS OF THE SAME DEPTH, AND THE FOLLOWING WIDTHS:

(2) 1 3/4' LVL PLIES = 3 1/2' GLULAM

(3) 1 3/4' LVL PLIES = 5 1/2' GLULAM

(3) 1 3/4' LVL PLIES = 5 1/2' GLULAM

(3) 1 3/4' LVL PLIES = 5 1/2' GLULAM

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(3) 1 3/4' LVL PLIES = 5 1/2' GLULAM

14. NEV FOUNDATION SHALL BEAR ON DRIGINAL SOIL WITH MINIMUM BEARING CAPACITY OF SON PSF. A GEDITECHNICAL ENGINEER IS RECOMMENDED FOR VERIFICATION OF THESE CONDITIONS DURING THE EXCAVATION PHASE. ENGINEER OF RECIRD ASSUMES NO RESPONSIBILITY FOR CONSTRUCTION NOT VERIFIED TO BE FOUNDED ON ANYTHING SHORT OF THE AFDREMENTIONED REQUIREMENTS.

15. CONTRACTOR SHALL NOTIFY ENGINEER OF RECORD BEFORE CONSTRUCTION OF ANY DEFLINGS.

Sheet No.:

Sheet Title: FOUNDATION Date: Rev. 1: Rev. 2: Rev. 3: PLAN 7 - 16 - AD 2021 5. LOW TIES @ 4'-0' D.C. (TYPICAL)
6. RUN STUDS THE FULL HEIGHT OF RAISED PLATE VALLS.
7. BLOCK JOISTS ABOVE BEAMS, CANTILEVERS AND LOAD BEARING VALLS WITH JOIST MATERIAL (NOT REQUIRED WITH I-JOISTS).
8. PROVIDE MULTIPLE STUDS FOR SOLID BEARING BELOW ALL BEAMS.
9. ALL DESIGNATED 2' X 6' WALLS SHALL HAVE DOUBLE KING STUDS AT DOOR AND

VINDOV OPENINGS. II. ALL VALLS TO BE FRAMED V/ MIN. STUD GRADE 2' X 4'S @ 16' O.C., UNLESS NOTED

Lee's Summit, Missouri Parkway Villas

Street Address:

Site Description:

Lot 42, The

Greens at Chapel

Ridge HERITAGE

SCALE: 1/4" = 1'-0"

2" X 10" FLOOR SYSTEM ABOVE FOUNDATION

(STEP WHERE GRADE REQUIRES)

ON 16" X 8" STRIP FOOTINGS

(UNLESS NOTED OTHERWISE)

8'-0" FOUNDATION WALLS

Project Title: **The RESIDENTIAL DESIGN LLC** 

M/T: (816)547-4437

 $\Diamond$  $\Leftrightarrow$  $\langle \Rightarrow \rangle$ 2" X 10" #2 FLOOR JOIST @ 16" O.C. DOUBLED 2' X 10' #2 FLOOR JOIST @ 16' D.C. Double Every other JOIST SCHEDULE 2" X 10" #2 FLOOR JOIST @ 16" O.C. 2" X 10" #3 FLOOR JOIST @ 16" O.C.

E: Plans@ViewpointDesign.net

 $\geqslant$  $\geqslant$ PIER FOOTING SCHEDULE 16" Ø PIER FTG. 24' Ø PIER FTG. 12" Ø PIER FTG. 18" Ø PIER FTG.

but have

STEEL COLUMN & PAD FOOTING SCHEDULE  3' X 11 GA, STEEL COLUMN ON 30' X 30' X 10' PAD FOOTING W/ (4) #4 BARS EACH WAY (125K) 3 1/2' X 11 GA, STEEL COLUMN ON 36' X 36' X 10' PAD FOOTING W/ (4) #4 BARS EACH WAY (120K) 3 1/2' SCH, 40 STEEL COLUMN ON 48' X 48' X 12' PAD FOOTING W/ (6) #4 BARS EACH WAY (24.5K) 3 1/2' SCH, 40 STEEL COLUMN ON 54' X 54' X 14' PAD FOOTING W/ (7) #4 BARS EACH WAY (40.5K) 3 1/2' SCH, 40 STEEL COLUMN ON 54' X 54' X 14' PAD FOOTING W/ (8) #4 BARS EACH WAY (40.5K) 3 1/2' SCH, 40 STEEL COLUMN ON 60' X 60' X 14' PAD FOOTING W/ (8) #4 BARS EACH WAY (50.0K)
STEEL COLUMN & AD FODTING SCHEDULE  3' X 11 GA STEEL COLUMN ON 30' X 30' X 10' PAD FODTING V/ (4) #4 BARS EACH WAY (12.5k) 3 1/2' X 11 GA STEEL COLUMN ON 36' X 36' X 10' PAD FODTING V/ (4) #4 BARS EACH WAY (18.0k) 3 1/2' X 14' A STEEL COLUMN ON 42' X 42' X 12' PAD FODTING V/ (5) #4 BARS EACH WAY (24.5k) 3 1/2' SCH 40 STEEL COLUMN ON 54' X 54' X 14' PAD FODTING V/ (7) #4 BARS EACH WAY (40.5k) 3 1/2' SCH 40 STEEL COLUMN ON 54' X 54' X 14' PAD FODTING V/ (7) #4 BARS EACH WAY (40.5k) 3 1/2' SCH 40 STEEL COLUMN ON 54' X 54' X 14' PAD FODTING V/ (7) #4 BARS EACH WAY (50.0k) 3 1/2' SCH 40 STEEL COLUMN ON 60' X 60' X 14' PAD FODTING V/ (8) #4 BARS EACH WAY (50.0k)

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