

Lee's Summit, Missouri

PROJECT NO.: 20-078

ISSUE DATE: 5.12.2022 REVISION 1

GENERAL NOTES


- 1. AIA DOCUMENT A-201, GENERAL CONDITIONS OF THE CONTRACT FOR CONSTRUCTION, CURRENT EDITION, AND SPECIAL CONDITIONS AS NOTED IN THE PROJECT MANUAL, SHALL GOVERN THE WORK.
- GENERAL CONTRACTOR AND SUBCONTRACTORS SHALL VERIFY EXISTING FIELD CONDITIONS PRIOR TO THE START OF CONSTRUCTION AND SHALL REPORT ANY DISCREPANCIES TO THE ARCHITECT IMMEDIATELY.
- 3. GENERAL CONTRACTOR SHALL CROSS-REFERENCE THE VARIOUS DISCIPLINES' PLANS HEREIN AND REVIEWED SHOP DRAWINGS PRIOR TO STARTING
- 4. ONLY CONTRACT DOCUMENTS APPROVED FOR CONSTRUCTION AND REVIEWED SHOP DRAWINGS SHALL BE USED FOR CONSTRUCTION. GENERAL
- CONTRACTOR SHALL BE RESPONSIBLE FOR DISTRIBUTION OF SAID DOCUMENTS AND UPDATES TO THE FIELD FOR CONSTRUCTION.


 5. IT SHALL BE THE RESPONSIBILITY OF THE GENERAL CONTRACTOR TO COORDINATE THE SUBCONTRACTOR WORK WITH THESE PROJECT
- DOCUMENTS.
- DIMENSIONS TO THE EXTERIOR OF THE BUILDING ARE TO THE EXTERIOR OF FOUNDATION/MASONRY UNLESS NOTED OTHERWISE.
 DO NOT SCALE DRAWINGS.
- THE WORD 'ALIGN' AS USED IN THESE DOCUMENTS SHALL SUPERSEDE DIMENSIONAL INFORMATION.
- 9. NO PRODUCTS CONTAINING ASBESTOS SHALL BE INSTALLED IN OR USED DURING THE CONSTRUCTION OF THIS PROJECT. IT SHALL BE THE RESPONSIBILITY OF THE GENERAL CONTRACTOR TO CERTIFY TO THE OWNER THAT THIS REQUIREMENT HAS BEEN COMPLIED WITH
- 10. ALL HVAC EQUIPMENT AND DUCTWORK SHALL COMPLY WITH THE CURRENT APPLICABLE MECHANICAL CODE AND INSTALLED PER SMAC RECOMMENDATIONS.
- 11. CODE COMPLIANCE THE WORK SHALL BE GOVERNED BY ALL CURRENT APPLICABLE LOCAL, CITY, STATE AND NATIONAL CODES AND LAWS. THESE AUTHORITIES INCLUDE, BUT ARE NOT LIMITED TO THE INTERNATIONAL BUILDING CODE, NATIONAL ELECTRIC CODE, NATIONAL FIRE PROTECTION ASSOCIATION OR ANY OTHER AUTHORITY OR BODY HAVING JURISDICTION OVER WORK. THE SITE, PARKING LOT, AND BUILDING SHALL COMPLY WITH ADA (AMERICANS WITH DISABILITIES ACT) REGULATIONS. NOTICY ARCHITECT OF ANY REQUIRED CHANGES TO COMPLY WITH ADA
- . REFERENCE CIVIL DRAWINGS FOR SITE WORK, INCLUDING THE BUILDING LOCATION ON THE SITE.

ABBREVIATIONS

ABBREVIATIONS						
ABV	ABOVE	LIDWD	HARRWOOD	SCHED	SCHEDULE	
	ABOVE ABOVE FINISH FLOOR	HDWD HDPB	HARDWOOD HIGH DENSITY	SECT	SECTION	
AFF ACT		пирв	PARTICLE BOARD	SECT	SHEET	
	ACOUSTICAL				SIMILAR	
ALUM	ALUMINUM	HT	HEIGHT	SIM		
&	AND	HR	HOUR	SC	SOLID CORE	
@	AT	INICLII	INSULATION	SPEC	SPECIFICATION	
DLIZ	DI OCK	INSUL	INSULATION	SQ	SQUARE	
BLK	BLOCK	IT.	IOINIT	SF	SQUARE FOOT	
BD	BOARD	JT	JOINT	SS	STAINLESS STEEL	
ВО	BOTTOM OF			STD	STANDARD	
CLG	CEILING	LAV	LAVATORY	STL	STEEL	
C	CENTER LINE	140	MACCAIDY OBENING	STRUCT	STRUCTURAL	
€ ct	CERAMIC TILE	MO	MASONRY OPENING	SUSP	SUSPENDED	
CLR	CLEAR	MSRY	MASONRY	T-1	TELEBLIONE	
CONC	CONCRETE	MDF	MEDIUM DENSITY	TEL	TELEPHONE	
		MEGH	FIBERBOARD	THK	THICK	
CMU CONT	CONC. MASONRY UNIT	MECH	MECHANICAL	TO	TOP OF	
CONTR	CONTINOUS	MTL	METAL	T&G	TONGUE & GROOVE	
	CONTRACTOR			TYP	TYPICAL	
CFCI	CONTRACTOR FURNISHED CONTRACTOR INSTALLED	NIC	NOT IN CONTRACT	UNF	UNFINISHED	
		NTS	NOT TO SCALE	UNO	UNLESS NOTED OTHERWISE	
CJ	CONTROL JOINT			0110	ONLEGO NOTED OTHERWISE	
CG	CORNER GUARD	OFCI	OWNER FURNISHED	VEDT	VEDTICAL	
DTL	DETAIL		CONTRACTOR INSTALLED	VERT VEST	VERTICAL VESTIBULE	
DIA	DIAMETER	OFOI	OWNER FURNISHED	VEST	VESTIBULE	
DR	DOOR	00	OWNER INSTALLED			
DS	DOWNSPOUT	OC	ON CENTER	WP	WATERPROOF	
DWG	DRAWING	OPNG	OPENING	WT	WEIGHT	
DWG	DIVAWING	DTD		W/	WITH	
EOS	EDGE OF SLAB	PTD	PAINTED	W/O	WITH OUT	
ELEC	ELECTRICAL	PLAM	PLASTIC LAMINATE	WD	WOOD	
ELEV	ELEVATION	PLYWD	PLYWOOD			
EQ	EQUAL	PT	PRESSURE TREATED			
EQUIP	EQUIPMENT	D.4.D.	DARWIG			
EXIST	EXISTING	RAD	RADIUS			
EJ	EXPANSION JOINT	RE:	REFERENCE			
F.T.	FFFT	REINF	REINFORCING			
FT	FEET	RCP	REFLECTED CEILING PLAN			
FG	FINISH GRADE	REQ'D	REQUIRED			
FF	FINISH FLOOR	RD	ROOF DRAIN			
FR FL	FIRE RETARDANT FLOOR	RM	ROOM			
I L	ILOUN	RO	ROUGH OPENING			
GC	GENERAL CONTR.					
OVD	OVPOLIM					



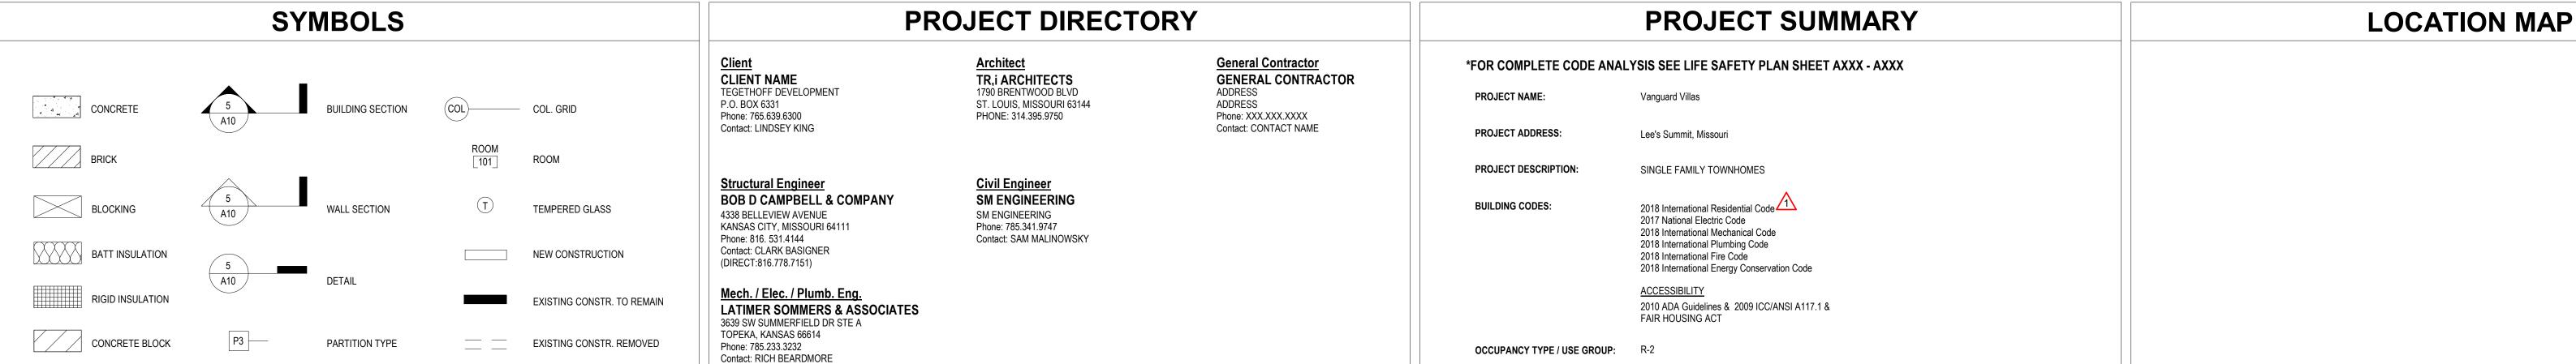

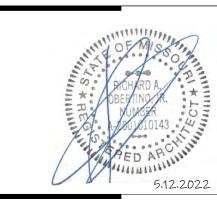

CIVIL ENGINEER
SENERAL CONTRACTOR
MECHANICAL ENGINEER

BOB D CAMPBELL & COMPANY SM ENGINEERING GENERAL CONTRACTOR

Tegethobb DEVELOPMENT

guard Villas

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DATE:
9.2.2021

REVISIONS #

100% BID/PERMIT
PACKAGE
1 PERMIT COMMENTS
9.24.2021
2 ADDENDUM 1
11.12.2021
3 REVISION 1
5.12.2022

DWG BY MKSS
TR,i PROJECT NO. 20-078
SHEET NO.

A000 COVER SHEET

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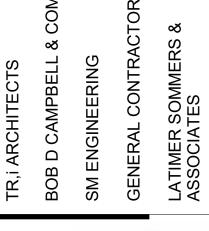
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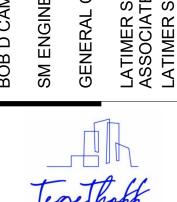
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ELECTRICAL

TYPICAL UNIT PLAN - ELECTRICAL

ELECTRICAL DETAILS AND SCHEDULES








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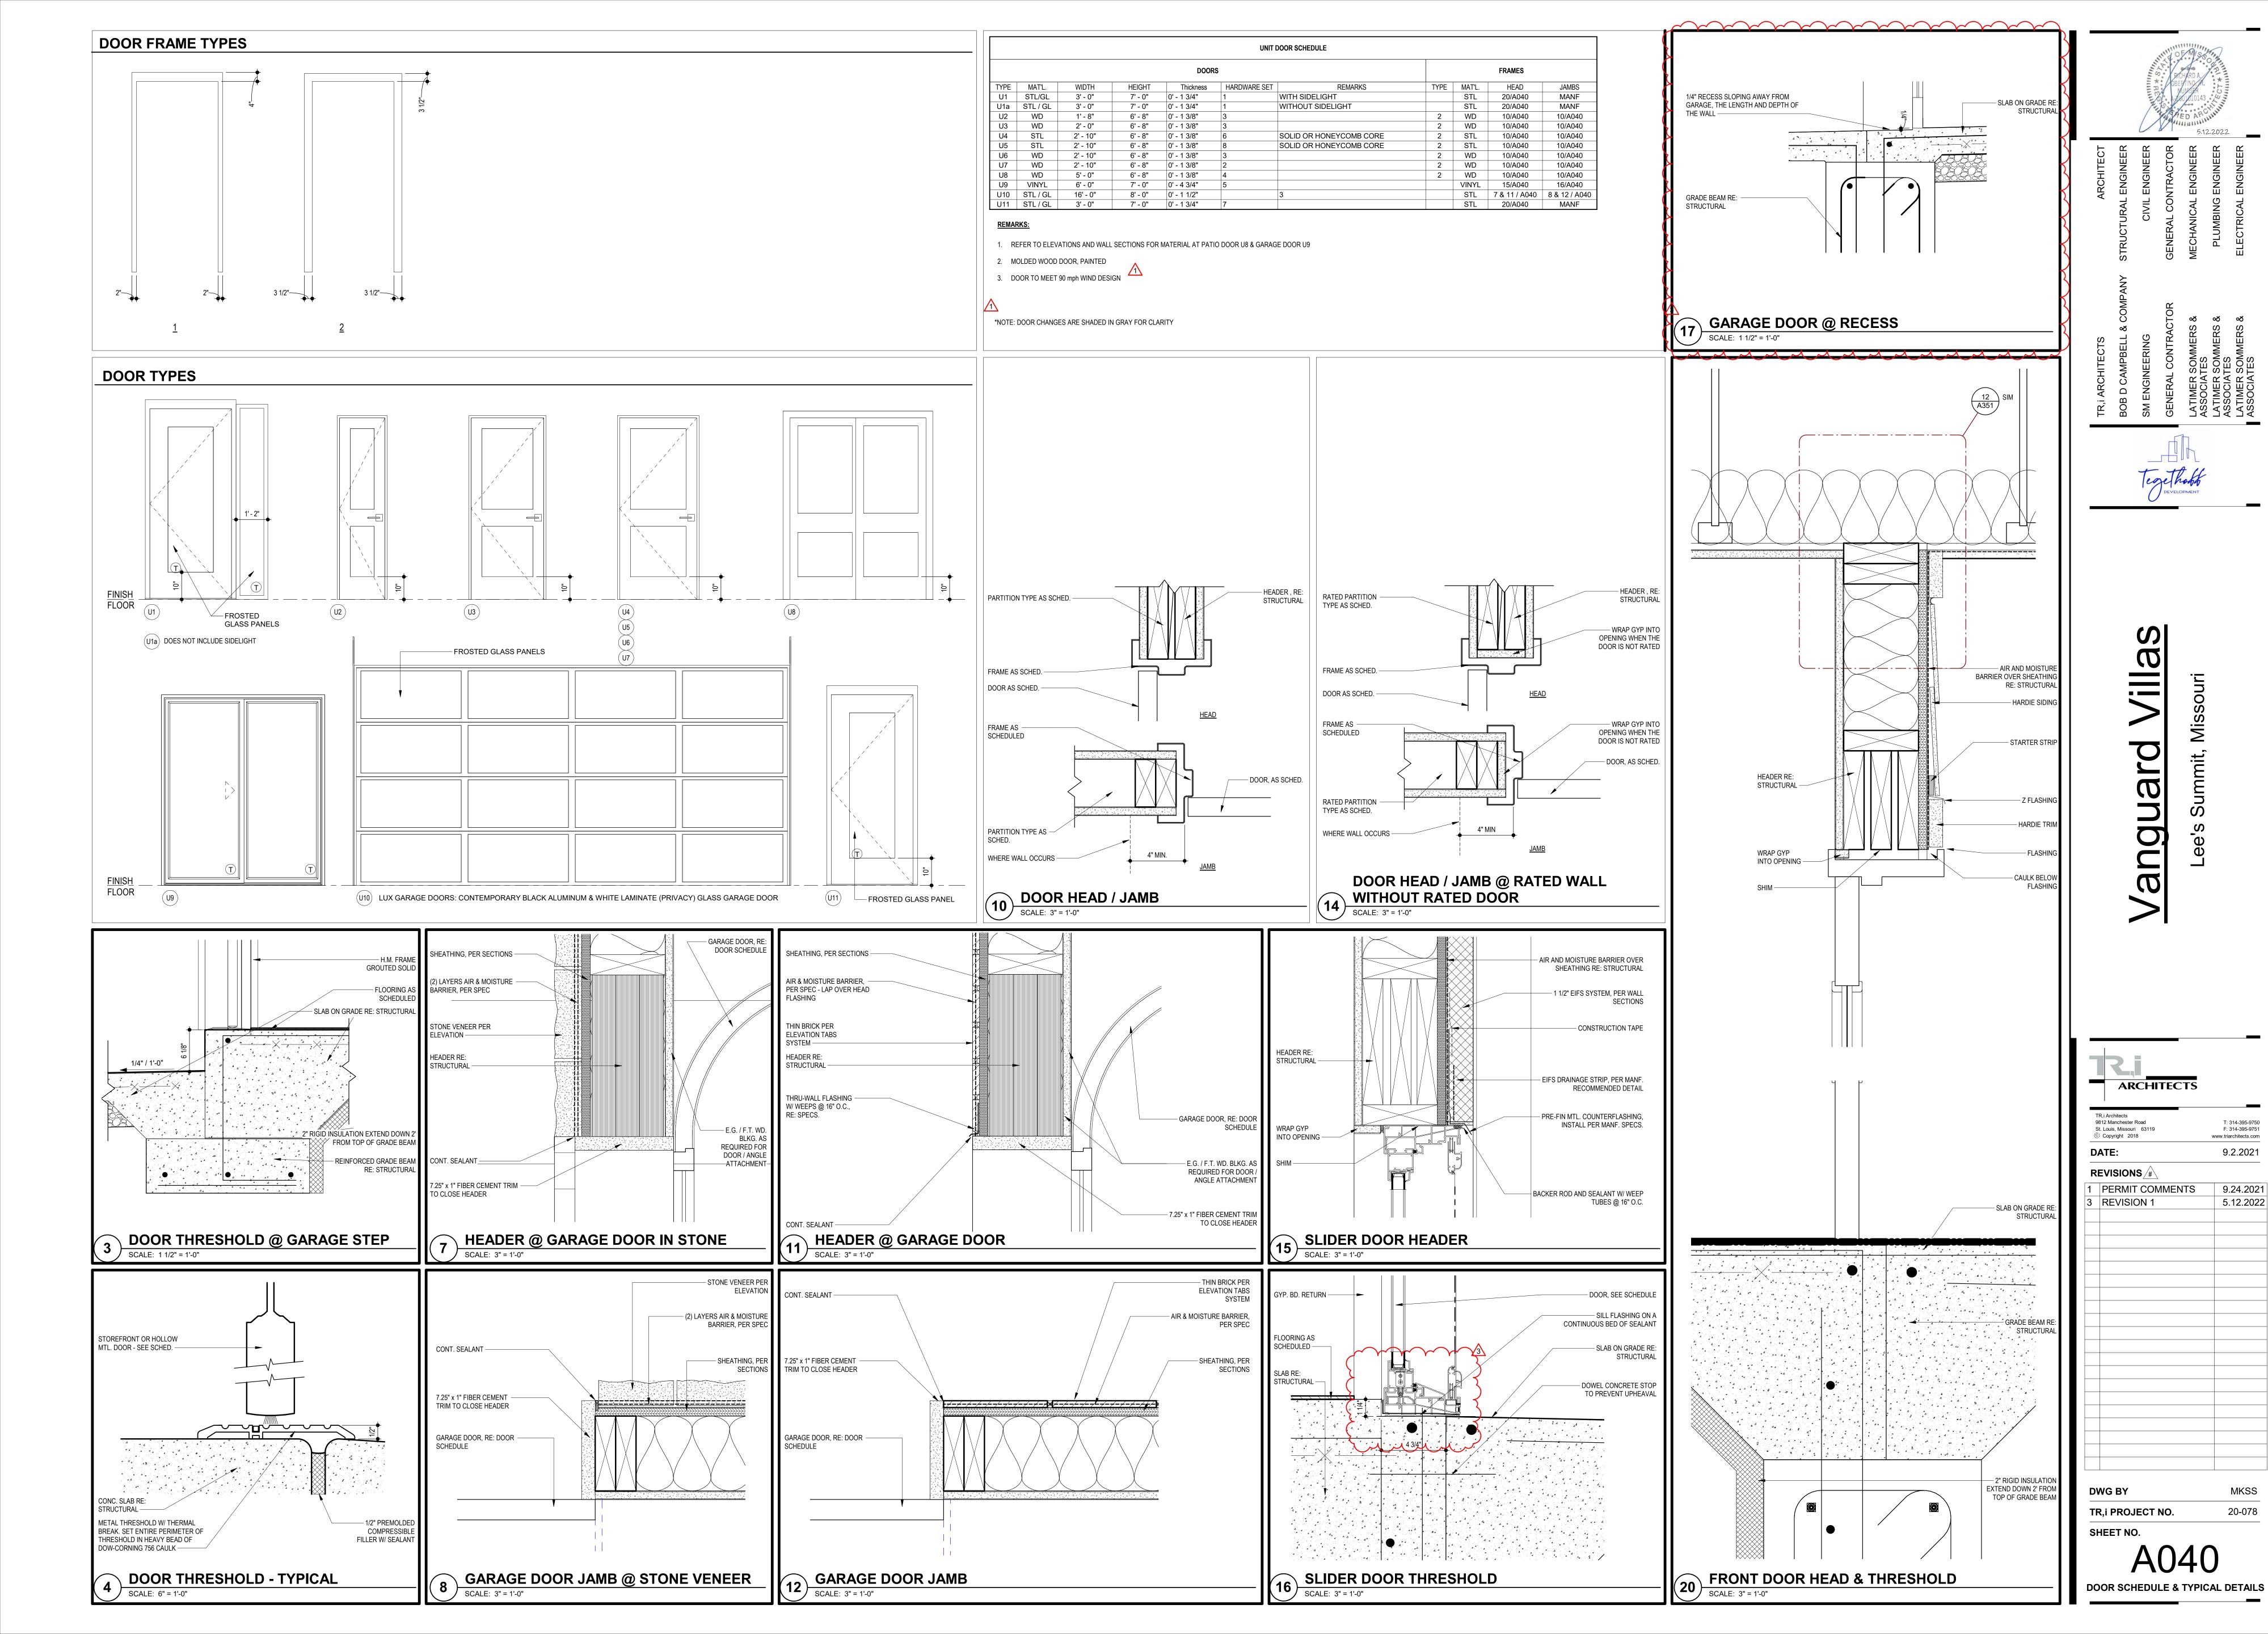
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GENERAL NOTES

- A. DIMENSIONS ARE TO FACE OF STUD OR FACE OF MASONRY.
- B. FOR DOOR SCHEDULE SEE SHEET A040 XXX C. FOR WINDOW SCHEDULE SEE SHEET A050 \langle X \rangle
- D. FOR PARTITION TYPES SEE SHEET A030 X
- E. FOR UNIT INTERIOR PARTITION TYPES AND LOCATIONS REFER TO UNIT SHEETS (A400 THROUGH A401). F. GENERAL CONTRACTOR WILL FURNISH & INSTALL 5 LB MULTIPURPOSE DRY CHEMICAL 2A:10B:C RATED FIRE

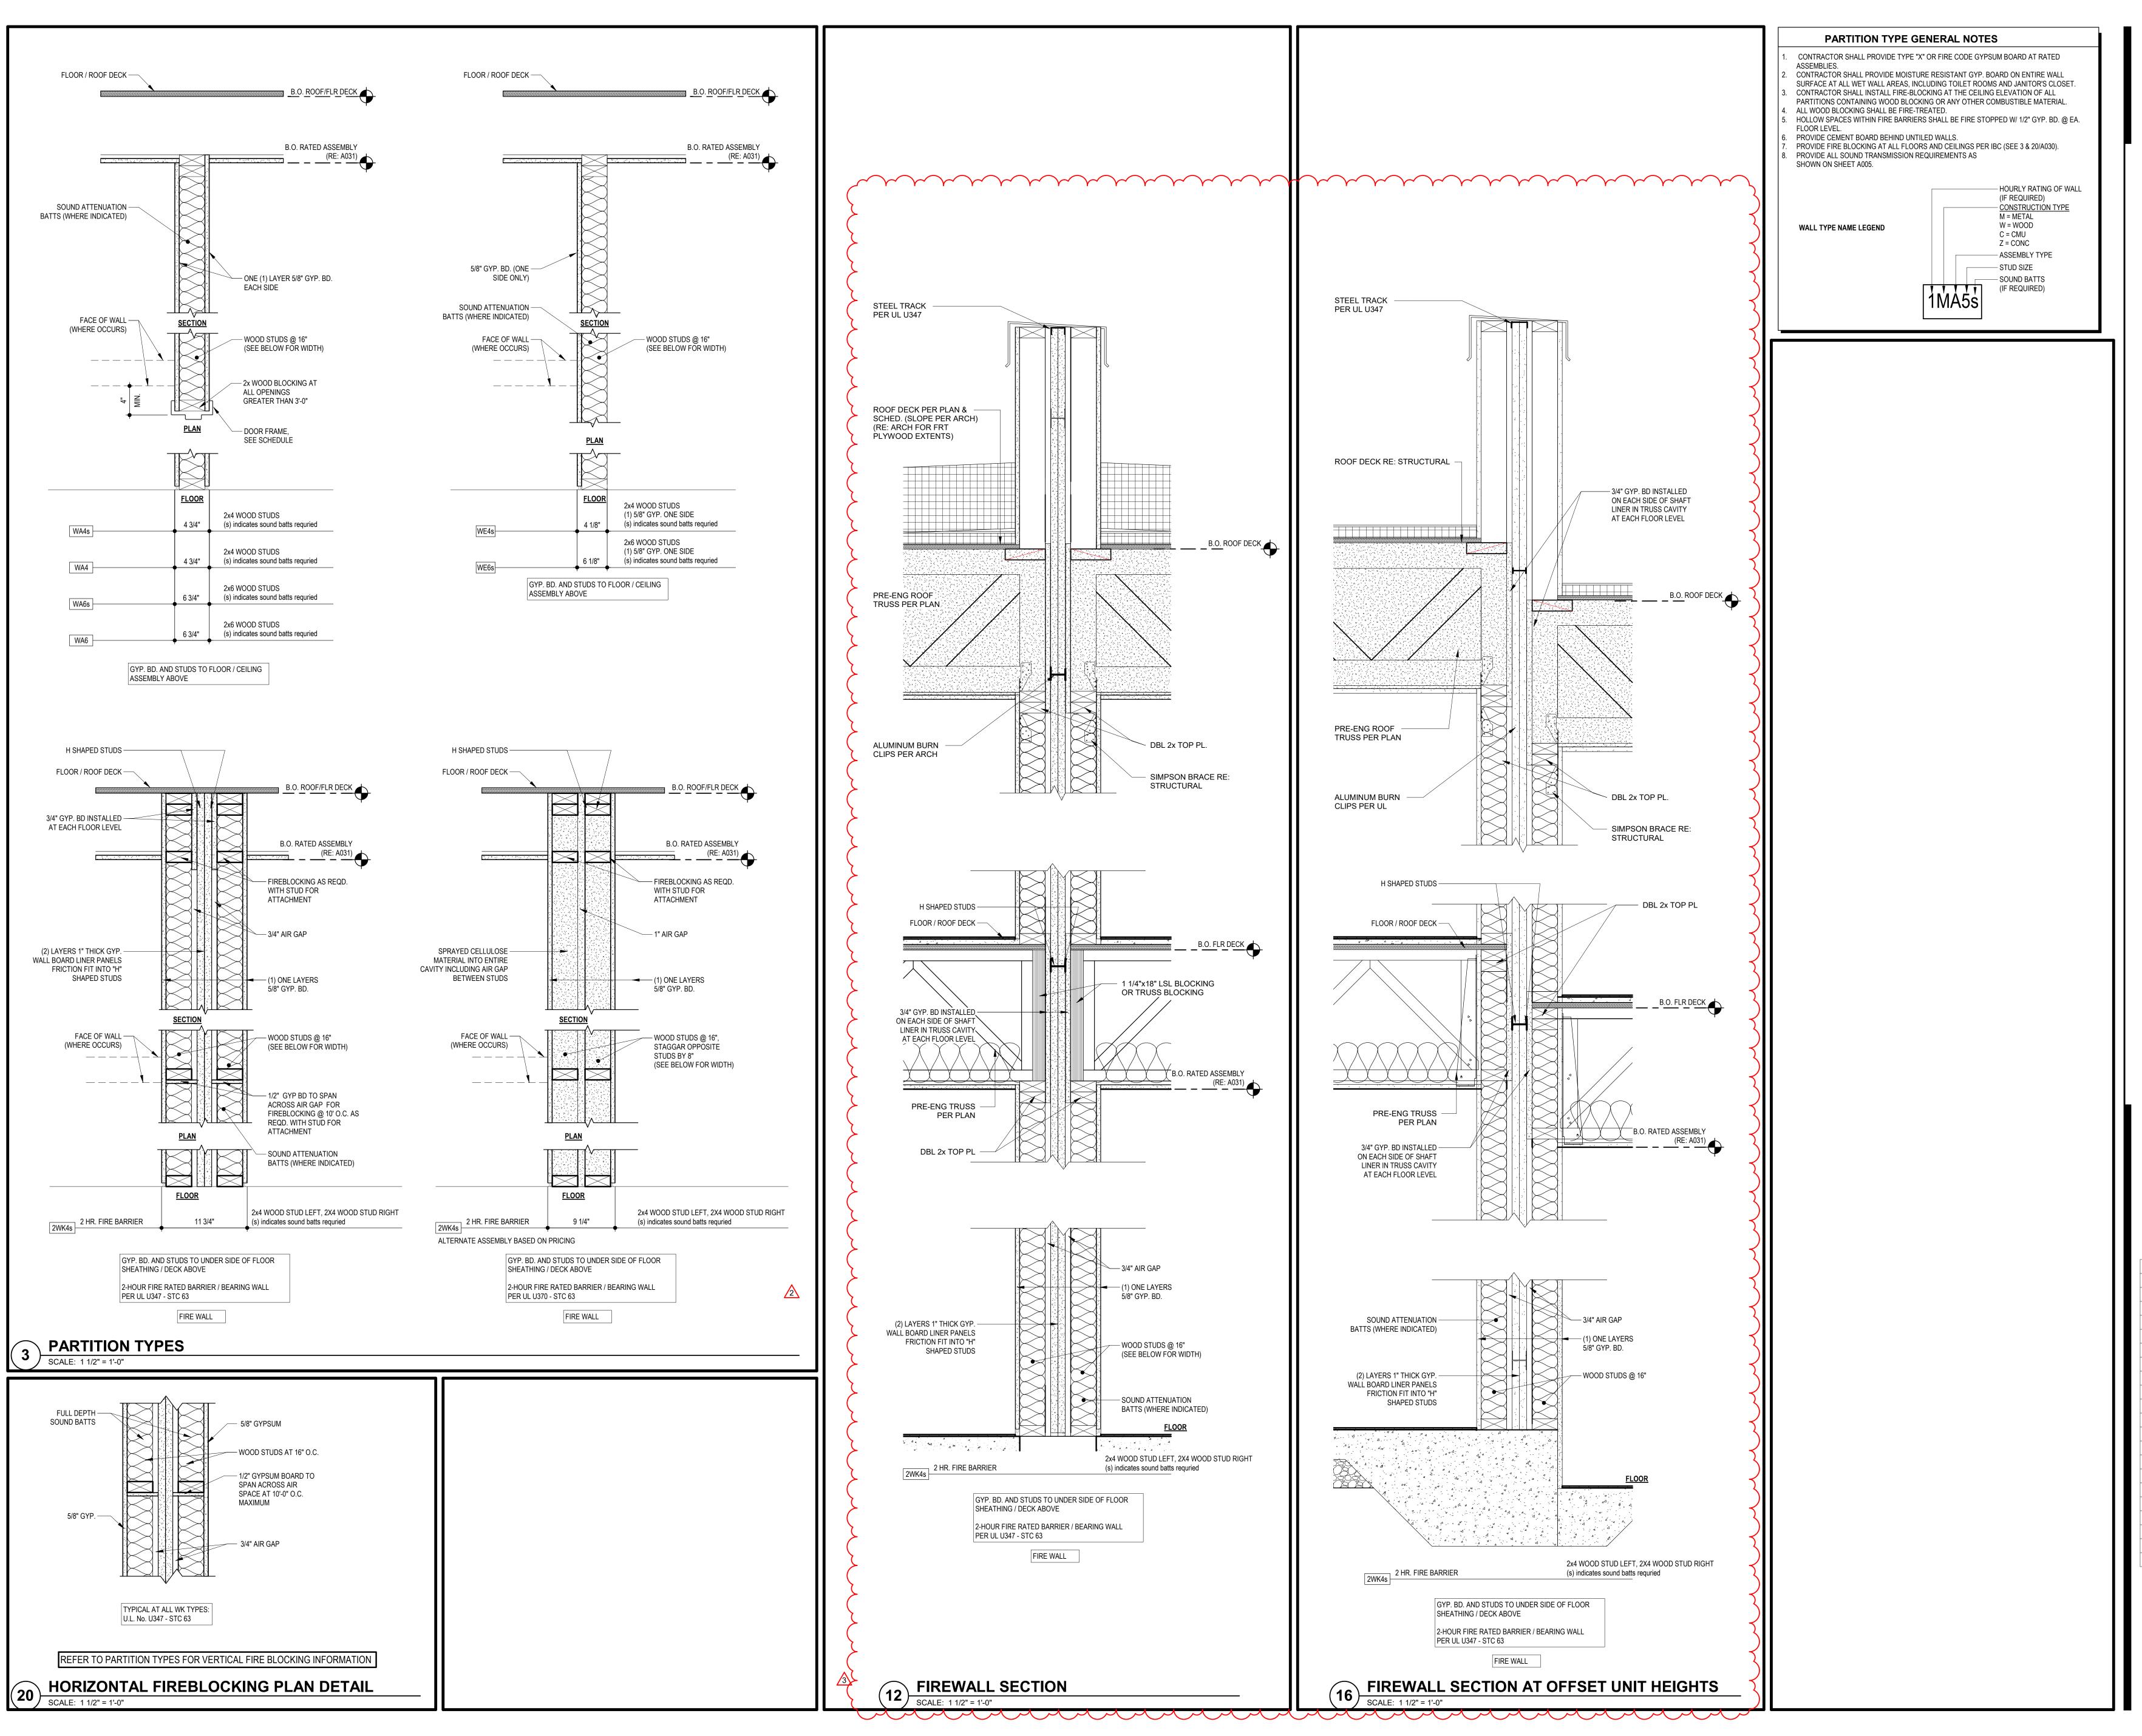EXTINGUISHERS w/ MOUNTING BRACKETS & ACCESSORIES @ 4'-0" A.F.F. AS REQUIRED BY GOVERNMENTAL

AUTHORITIES. MAXIMUM TRAVEL DISTANCE OF 75'-0" FOR PLACEMENT IN PUBLIC SPACES AND CORRIDORS. A

G. CONTROL JOINTS SHOULD BE SPACED IN GYPSUM WALL BOARD TO LIMIT EXPANSES TO 30-'0" MAXIMUM. CONTROL JOINTS ARE RECOMMENDED AT DOOR JAMBS EXTENDING FROM DOOR HEAD TO CEILING. CEILING GYPSUM BOARD CONTROL JOINTS SHOULD LIMIT THE CEILING AREA TO 2,500 SF MAX. AND 50'-0" IN EITHER DIRECTION. CONTROL JOINT SHOULD BE INSTALLED WHERE THERE IS A CHANGE IN DIRECTION IN CEILING FRAMING/FURRING OR SPACE CONTROL JOINTS AT THE CEILING AND WALL PER THE MANUFACTURER'S RECOMMENDED INSTALLATION GUIDELINES. CEILING AND WALL CONTROL JOINTS ARE TO ALIGN AT ALL INTERSECTIONS WHERE APPLICABLE TO FORM A CONTINUOUS CONTROL JOINT. ENSURE THAT CONTROL JOINTS ARE LOCATED AT STRUCTURAL CONSTRUCTION JOINTS AND AT THE TOP AND BOTTOM OF ALL INTERIOR RAMPS.

- MATERIAL DIMENSION STRING

49' - 6 5/8"

20' - 0 3/4" ,

H. COORDINATE LOCATION OF BEARING WALLS INSIDE DWELLING UNITS WITH UNIT PLANS.

MINIMUM RATED 1A:10B:C FIRE EXTINGUISHER TO BE PROVIDED IN EACH UNIT.

I. REFER TO LIFE SAFETY PLANS FOR ADDITIONAL INFORMATION ON FIRE RATED PARTITION LOCATIONS.

- J. FINISH FLOOR ELEVATION AT GROUP 1 IS 100'-0" AND ALL OTHER GROUPS ARE LABELED IN RELATION TO THAT LEVEL RE: CIVIL DRAWINGS FOR ALL GRADE INFORMATION.
- K. 5" CONCRETE FLOOR SLAB WITH 6"x6" W1.4xW1.4 W.W.F. ON 10 MIL POLY FILM VAPOR BARRIER ON 4" GRANULAR FILL. RE: STRUCTURAL DWGS.
- L. NO PENETRATIONS WITHIN 4' OF FIRE WALLS. VERIFY IN FIELD.
- M. IT IS THE GENERAL CONTRACTOR'S RESPONSIBILITY TO COORDINATE, LOCATE AND CONFIRM ALL FLOOR SINK, UNDERGROUND / OVERHEAD PLUMBING AND ELECTRICAL STUB-UPS, SPOT GRADING AT PERIMETER FOUNDATIONS
- N. THE ARCHITECT ASSUMES THE GENERAL CONTRACTOR HAS INCLUDED IN HIS BID THE HIGHEST QUALITY AND GREATEST QUANTITY FOR THE PURPOSE OF RESOLVING ANY CONFLICTS IN THE CONSTRUCTION DOCUMENTS WHICH ARE IMPLIED OR UNDEFINED.
- O. * ASSUMED FIRST FLOOR FINISH FLOOR ELEVATION = 100.00'* VERIFY ACTUAL FINISH FLOOR ELEVATION WITH CIVIL
- P. GENERAL CONTRACTOR TO CAULK AND SEAL EXPANSION JOINTS AT ALL EXTERIOR/INTERIOR CONCRETE SEE MASONRY SPECIFICATIONS.
- Q. GENERAL CONTRACTOR SHALL VERIFY GOVERNMENTAL REQUIREMENTS PRIOR TO BID AND INCLUDE IN BID ALL COSTS ASSOCIATED WITH FIRE ALARM SYSTEM INCLUDING AUDIO/VISUAL DEVICES AND PULL STATIONS WHERE
- R. FIRE RETARDANT TREATED WOOD PERMITTED TO BE USED IN LOCATIONS SPECIFIED IN TABLE 602, NOTE D AND SECTION 603.2 AND 2310.0. VERIFY SECTIONS IN 2018 IBC.
- S. ALL OPENING DIMENSIONS ARE TO CENTERLINE OF OPENING.

ROOF GENERAL NOTES

- VERIFY LOCATIONS OF ALL ROOF PENETRATIONS WITH STRUCTURAL, M.E.P. AND ARCHITECTURAL DRAWINGS.
- 3. EXHAUST FANS AND VENTS TO BE LOCATED A MINIMUM OF 10'-0" FROM RTU's.
- ALL ROOF EQUIPMENT TO BE MOUNTED ON CURBS. MECHANICAL SUBCONTRACTOR TO COORDINATE INSTALLATION AND ACCEPTANCE OF PREFABRICATED CURBS AND PENETRATIONS WITH ROOF MEMBRANE MANUFACTURER. GENERAL CONTRACTOR TO PROVIDE ALL REQUIRED BLOCKING, NAILING, ETC. AS REQUIRED FOR A WATERTIGHT BUILDING.
- IT IS THE GENERAL CONTRACTOR'S RESPONSIBILITY TO COORDINATE THE INSTALLATION OF ALL FLASHING, BLOCKING, NAILERS, INSULATION STOPS, CRICKETS, ETC. NECESSARY FOR A COMPLETE, WARRANTED AND WATERTIGHT INSTALLATION.
- ALL ROOF SLOPES ARE TO HAVE A MINIMUM OF 1/4" FALL WHERE CRICKETS AND VALLEYS OCCUR. CRICKETS ARE TO BE PROVIDED WITH SUFFICIENT DEPTH AND SLOPE TO ACCOMMODATE A MINIMUM 1/4" PER FOOT FALL AT

ROOF KEYED NOTES (#)

STEP PARAPET DOWN 1'-6" FOR ROOF ACCESS —

- . PROVIDE TAPERED CRICKETS AT ALL ROOF TOP UNITS, SLOPE 1/2" PER FOOT MINIMUM. INSTALL FLASHING AND COUNTER FLASHING PER ROOFING MANUFACTURER'S WRITTEN RECOMMENDATIONS.
- 2. TAPERED CRICKETS AS REQUIRED. SLOPE 1/2" PER FOOT MINIMUM.
- 3. FULLY ADHERED T.P.O. ROOF MEMBRANE.
- 4. CHANGE IN ROOF SLOPE AND/OR ELEVATION. 5. THRU-WALL ROOF SCUPPER WITH OVERFLOW.
- 6. PROVIDE WALKWAY PADS FROM ROOF ACCESS TO ALL ROOFTOP EQUIPMENT.
- 7. NOT USED 2
- 8. GUTTER TO DOWNSPOUT TO MAIN ROOF


DOWNSPOUT CALC

3 1/4" / 1'-0"

1,059 /120 = 8.825 SQUARE INCHES OF DOWNSPOUT AREA

<u>AREA OF 1 VILLA:</u> 1,059 S.F. / 1 DOWNSPOUTS = 1,058 S.F./D.S. (SMACNA) TABLE 1-2 - 100 YEAR S.F./S.I. = 120

USE (1) 4" SQ. DOWNSPOUTS PER VILLA

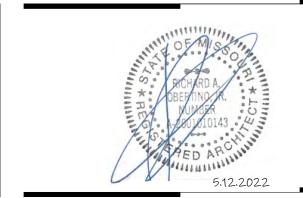


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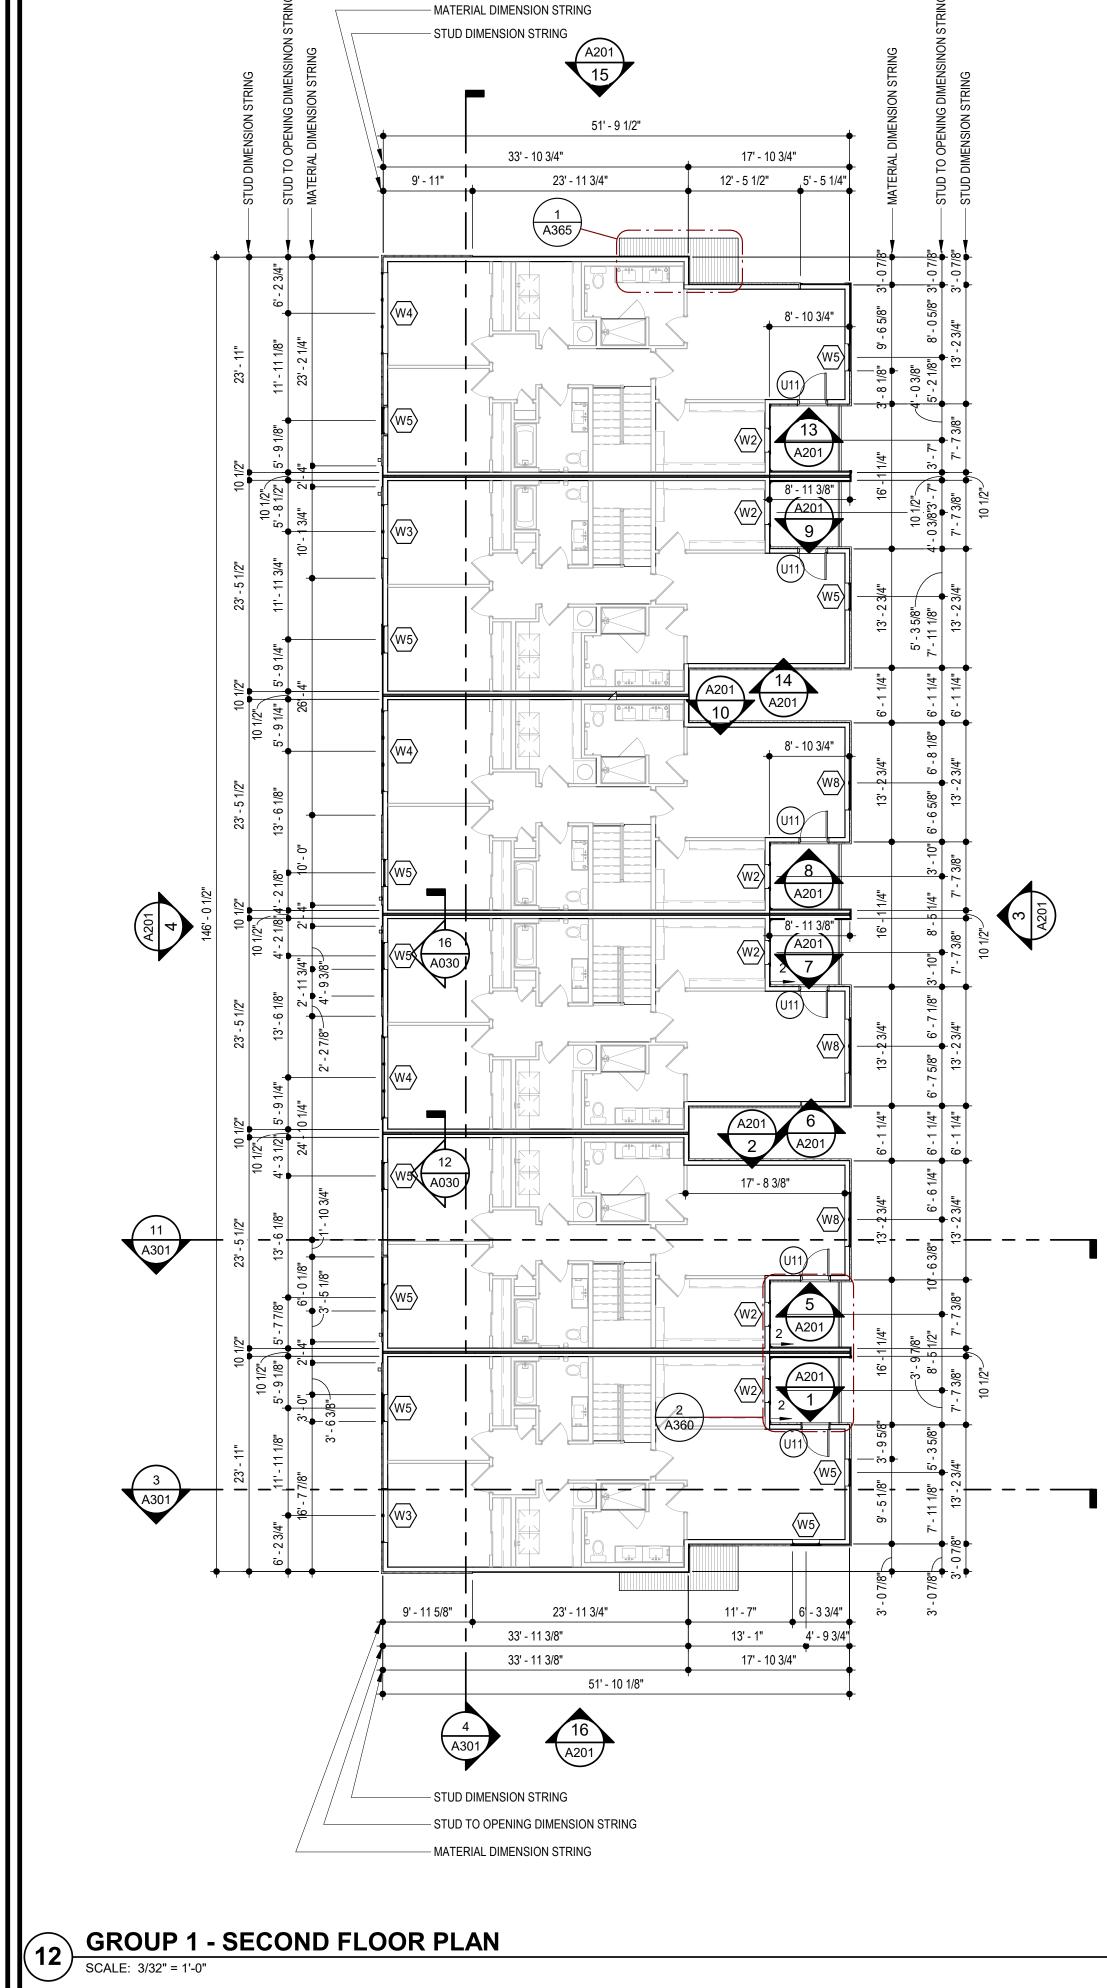
5.12.2022


3 REVISION 1

TR,i PROJECT NO.

SHEET NO.



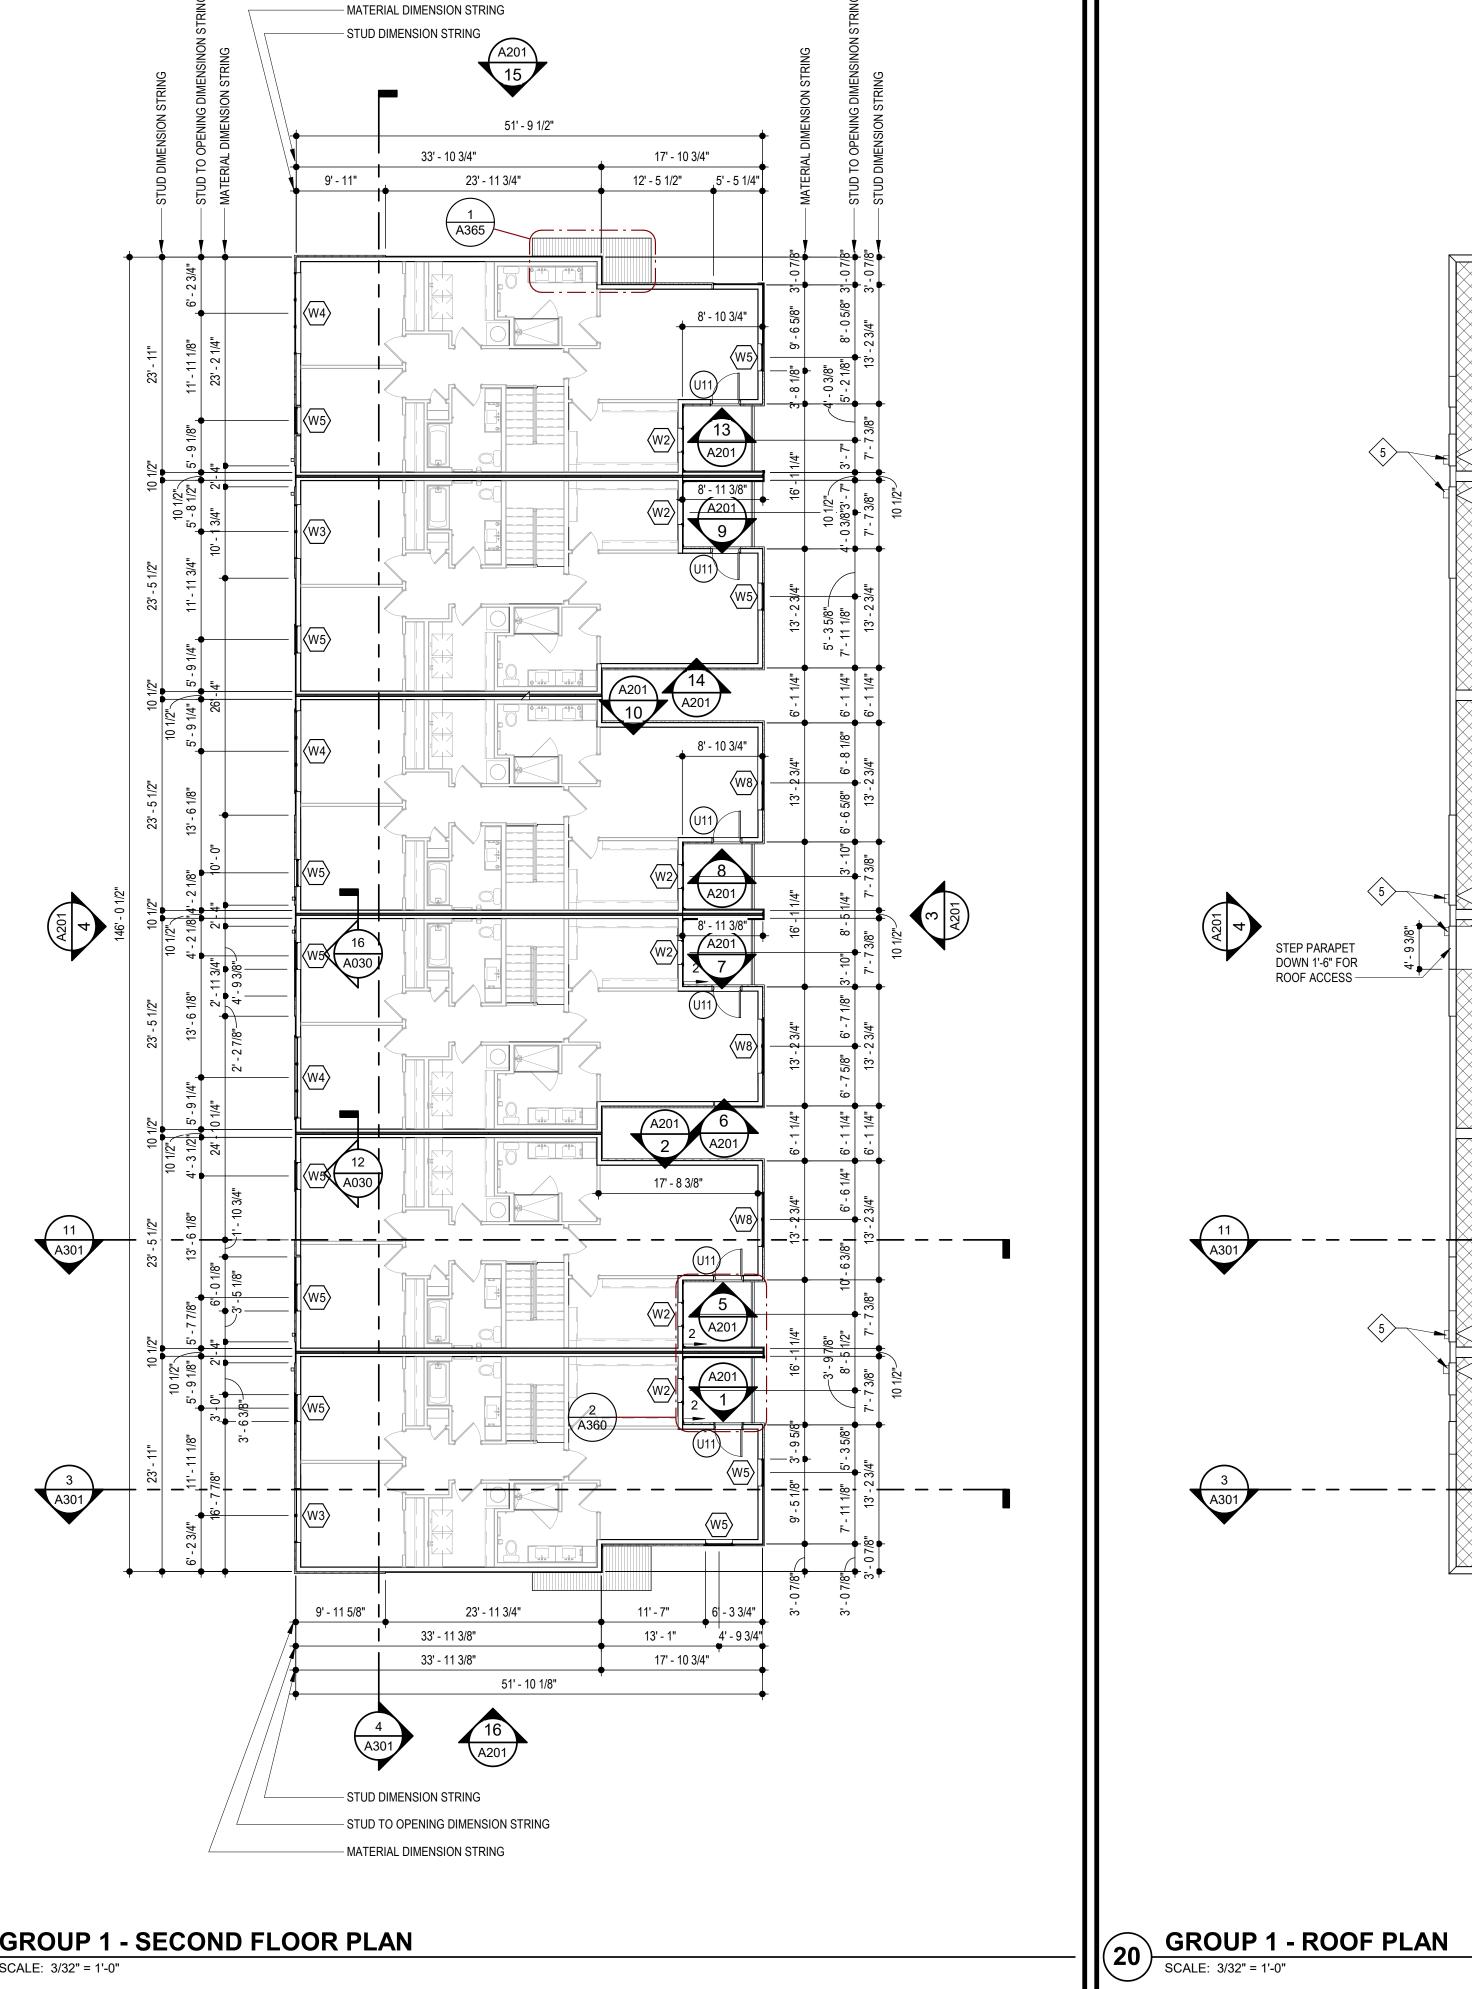


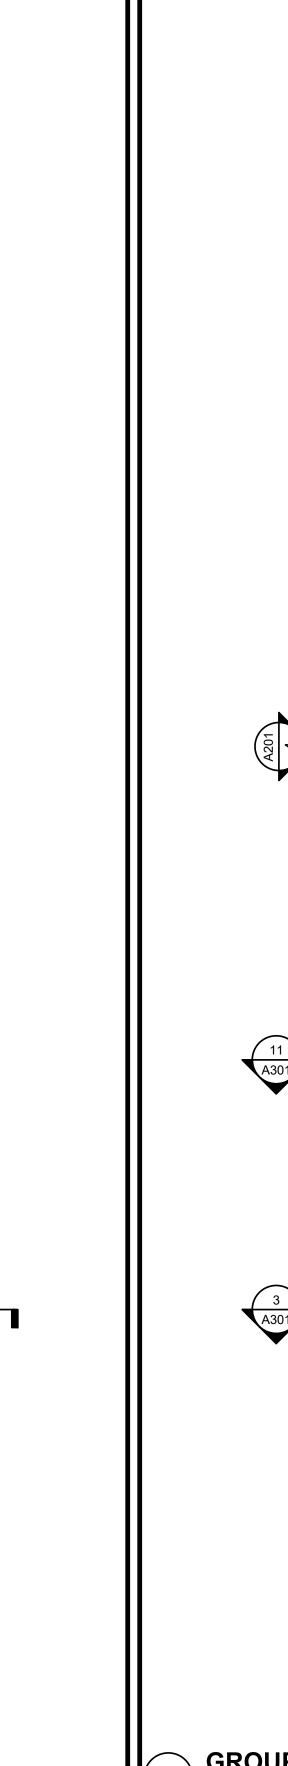

- STUD DIMENSION STRING - MATERIAL DIMENSION STRING


49' - 6 5/8"


GROUP 1 - FIRST FLOOR PLAN SCALE: 3/32" = 1'-0"

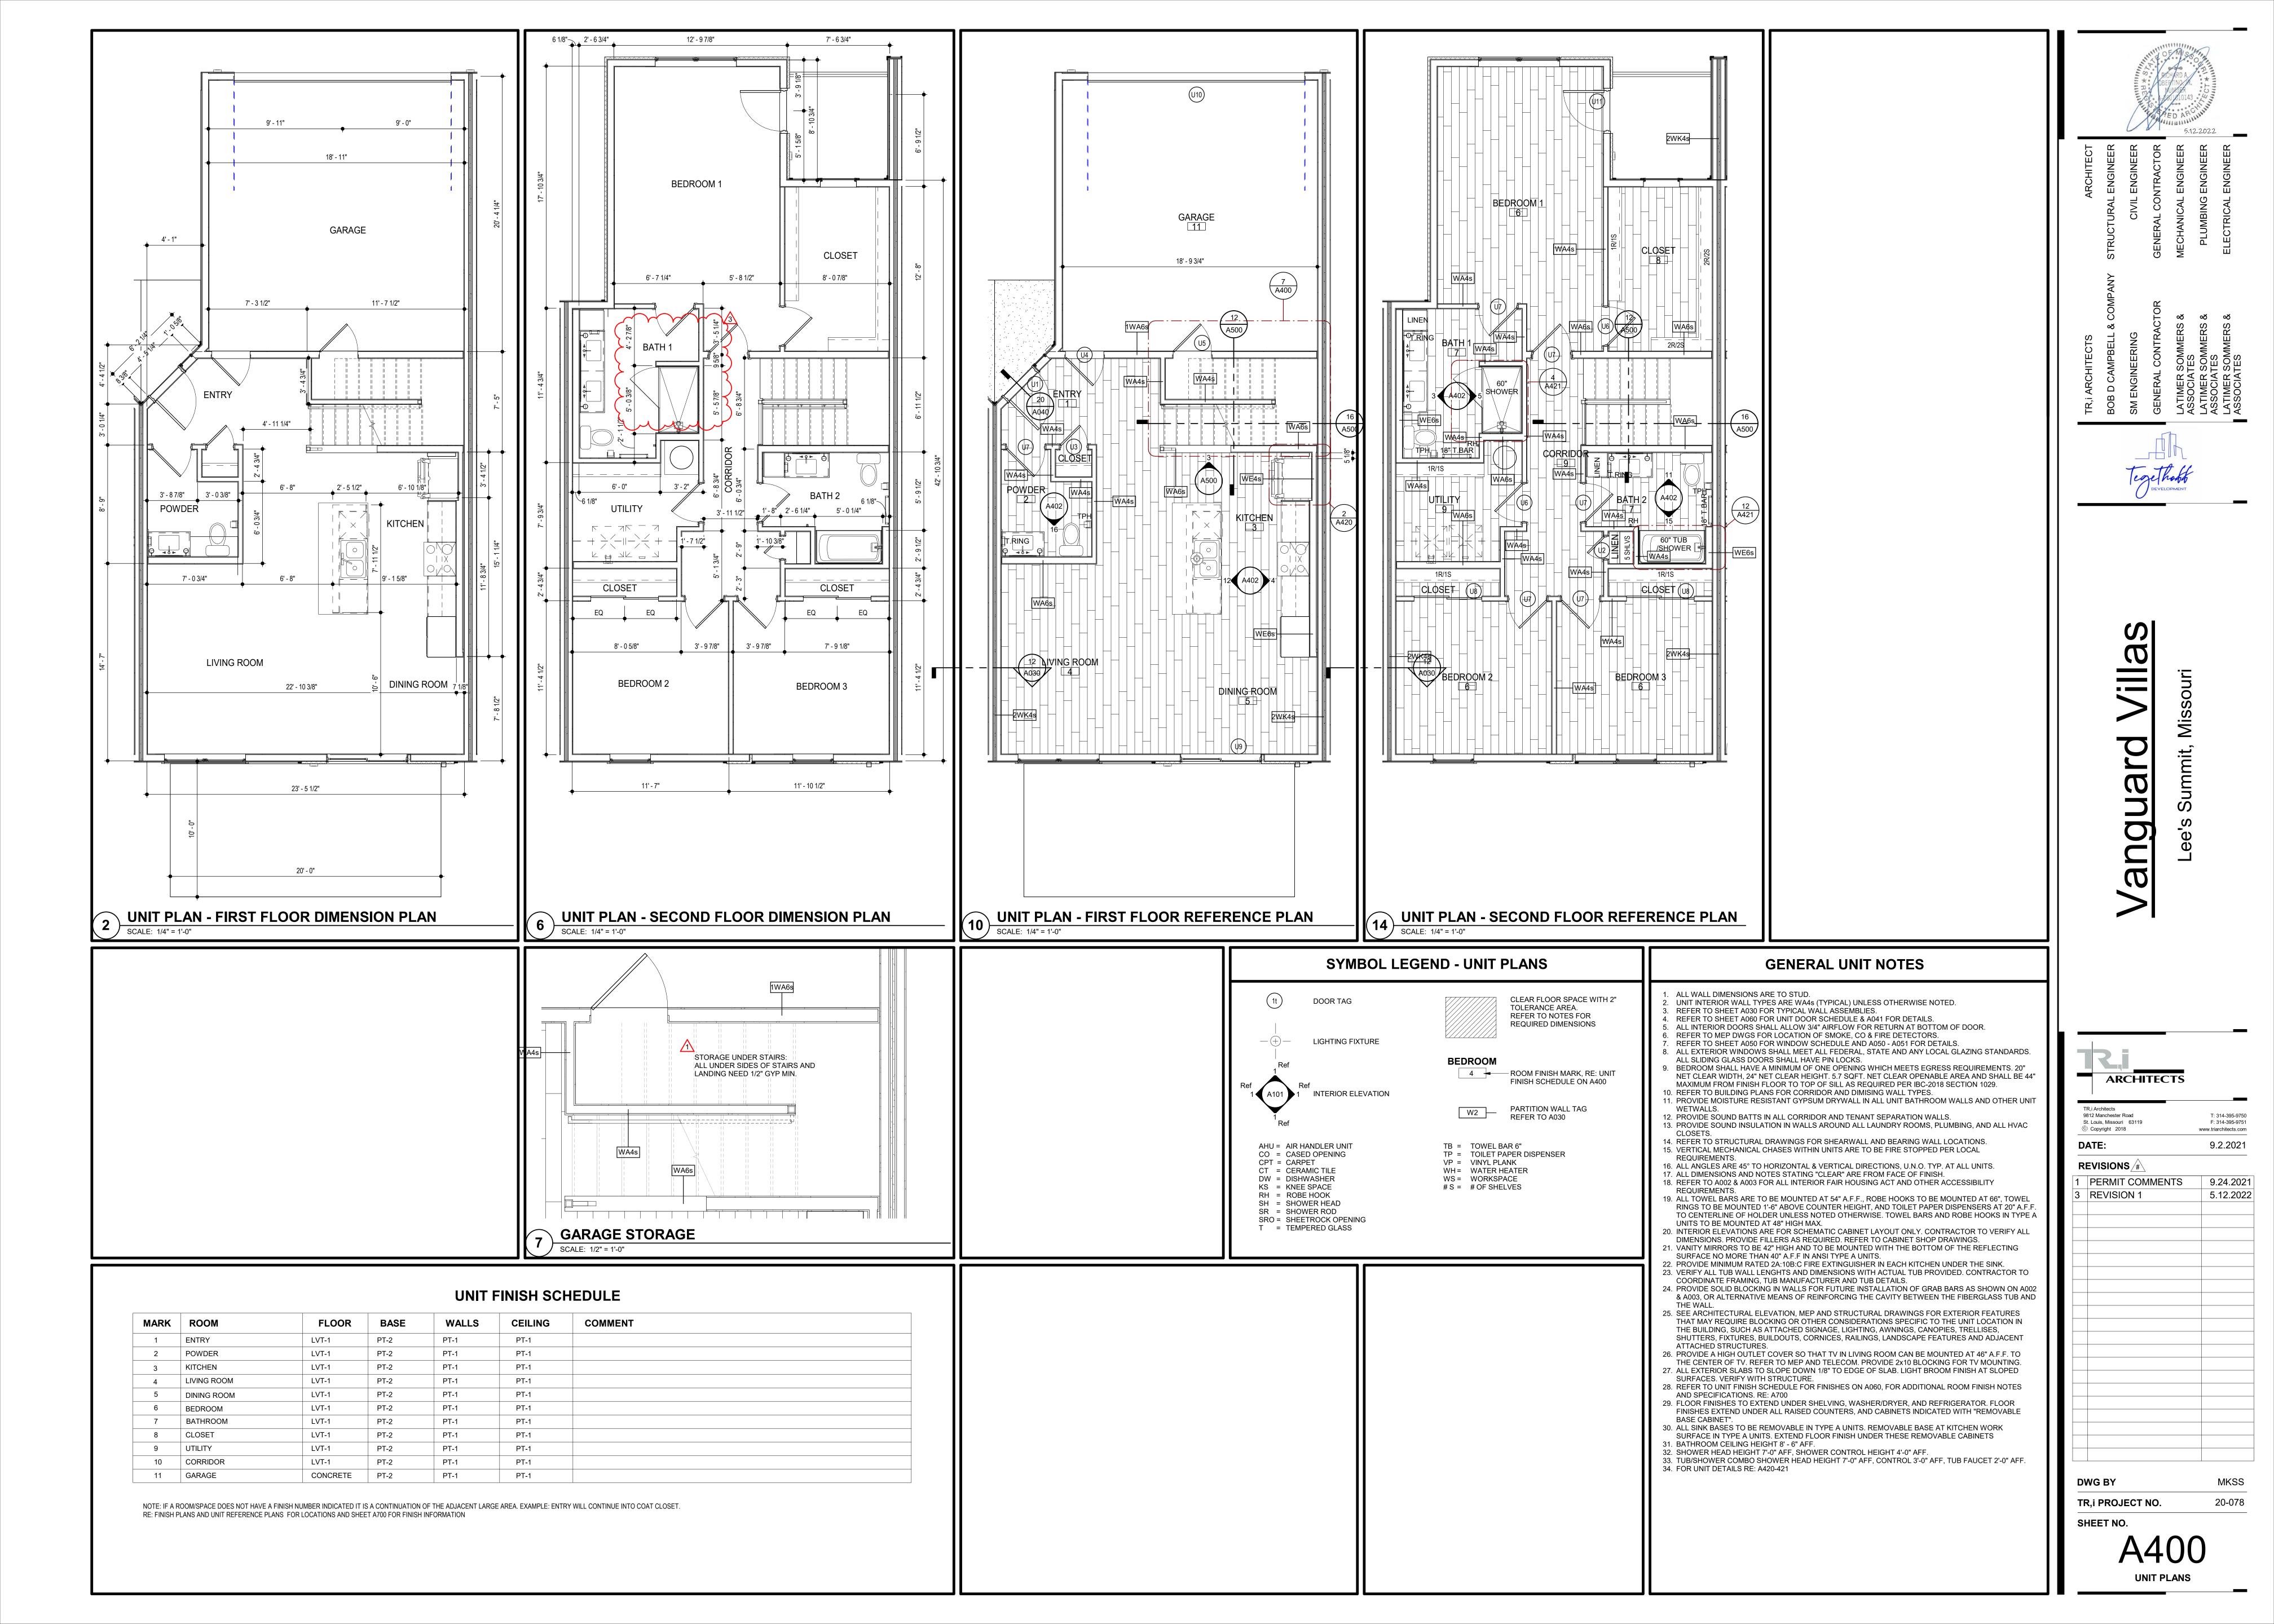

LIGHTING FIXTURE SCHEDULE

LABEL	MANUFACTURER	DESCRIPTION/MODEL	FINISH
Α	NORA LIGHTING	NELOCAC-8R30W ELO SURFACE MOUNT	WHITE TRIM
В	FANIMATION	FPD8534BL KUTE 52" LK8534 KUTE LIGHT KIT	BLACK
С	MATTEO	S03910MB	MATTE BLACK
D	ACCESS	20399LEDMG-BL	TEXTURED BLACK
E	ET-2	E20366-92BK HALF MOON	BLACK
F	NORA LIGHTING	NELOCAC-11R30W ELO SURFACE MOUNT	WHITE TRIM

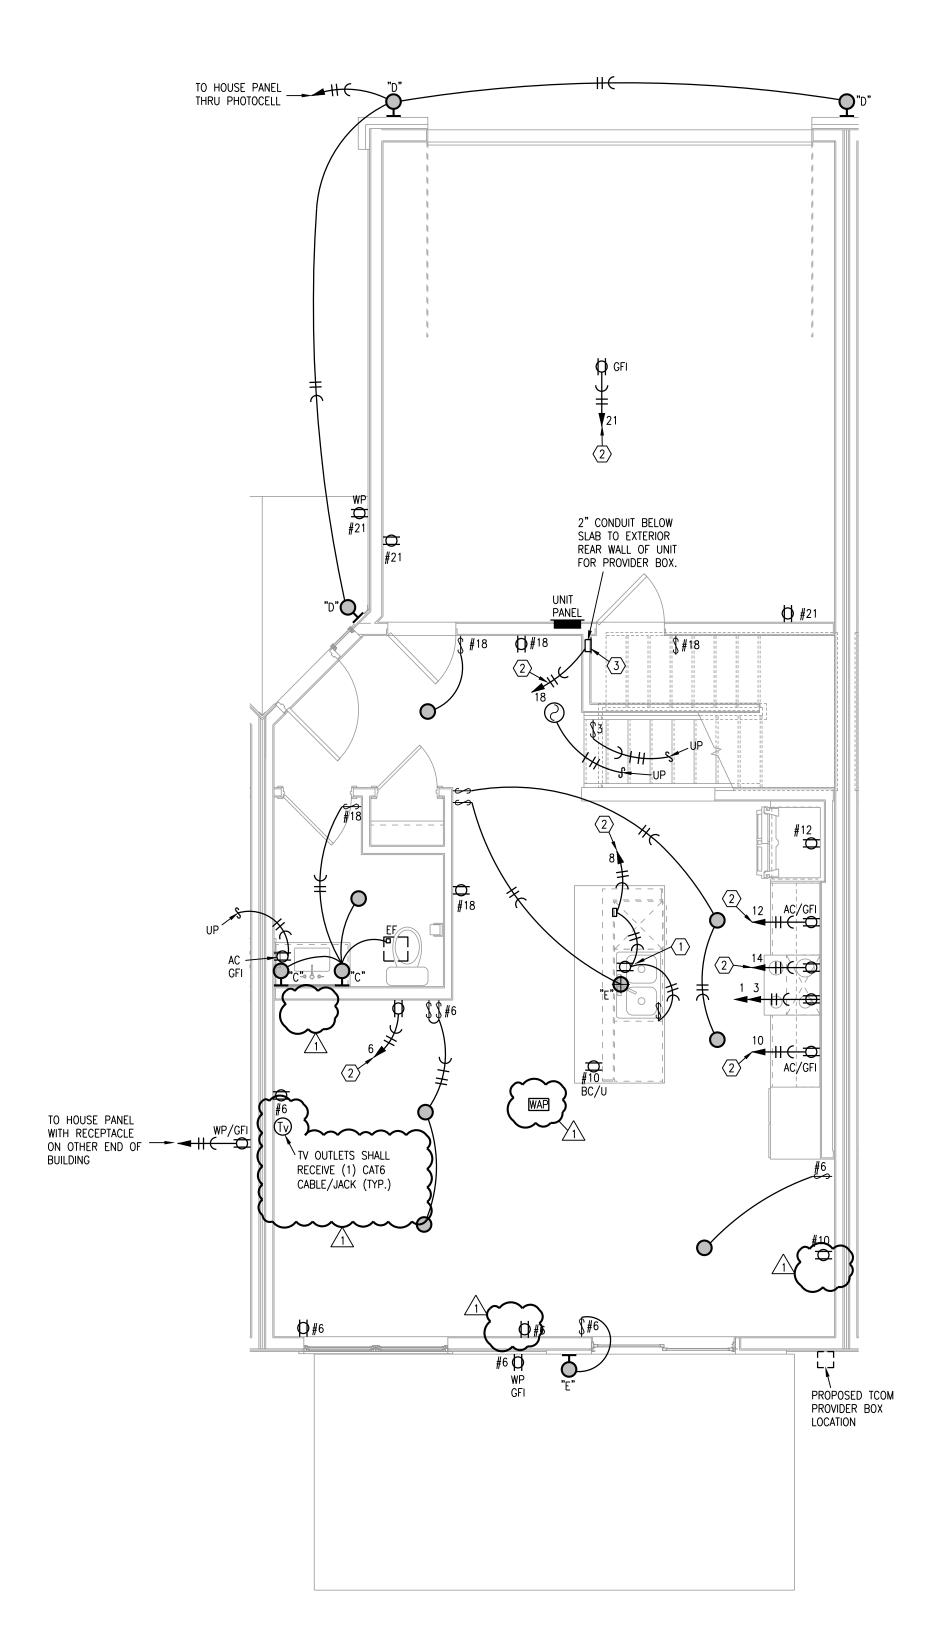

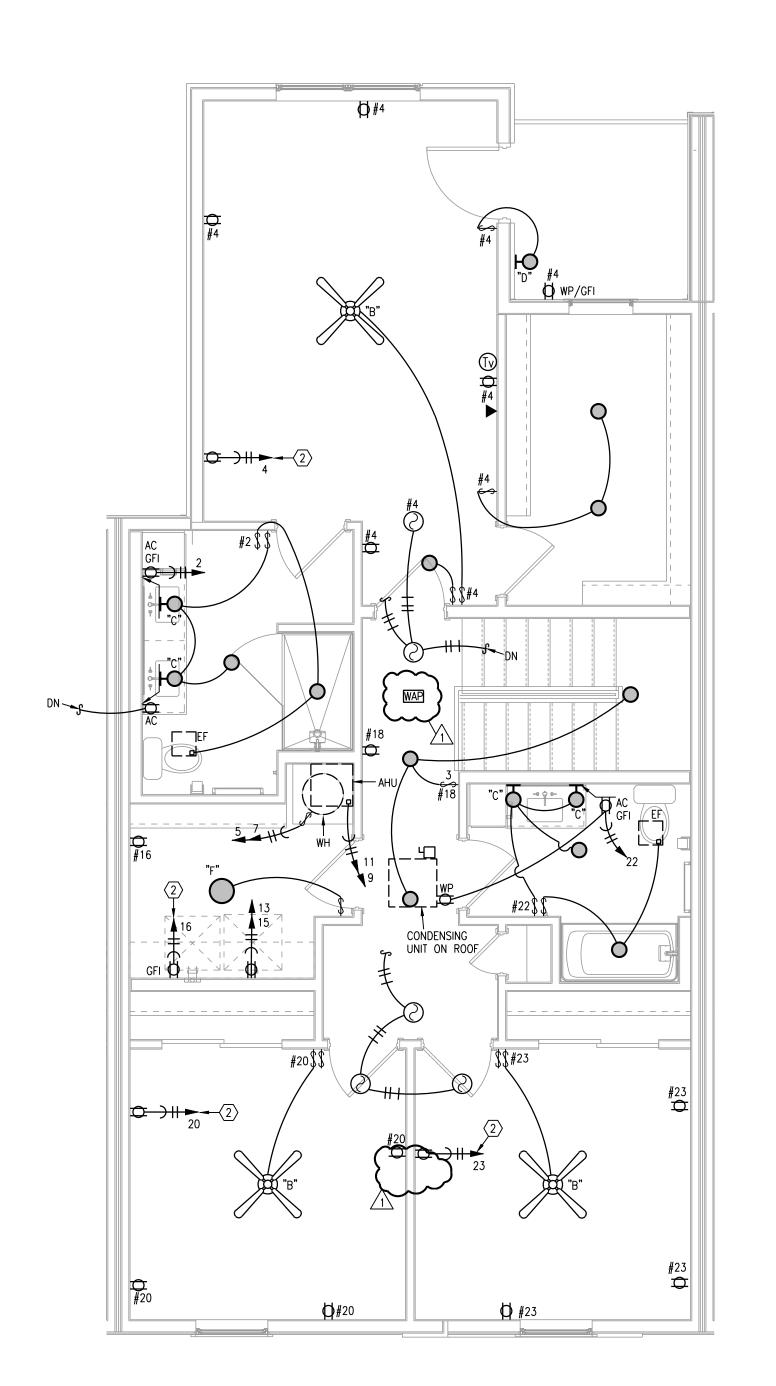

TYPICAL UNIT PLAN - FIRST FLOOR

1/4"=1'-0"

ELECTRICAL

TYPICAL UNIT PLAN - SECOND FLOOR

1/4"=1'-0"

ELECTRICAL

 CEILING FAN SWITCHES PROVIDED WITH FAN. CONTROL LIGHT AND FAN SEPARATELY. INTENDED FOR SINGLE GANG BOX.

2. CENTER ISLAND PENDANT LIGHTS OVER BASE BACK WALL AND CENTERED EQUALLY LEFT TO RIGHT OVER SINK. THESE ARE SEPARATELY SWITCHED.

GENERALLY CENTER LIGHT ON WINDOWS, DOOR, HALLWAYS, SINKS, OVER TUBS, ETC. VERIFY ALL LOCATIONS IN EACH UNIT DIMENSIONALLY WITH ARCHITECT, INTERIOR DESIGNER AND OWNER. MOUNT SWITCHES CLOSE TO DOORS OR WALL CORNERS.

I. THERMOSTATS HAVE LOW VOLTAGE WIRE BACK TO AHU. CONDENSING UNITS HAVE LOW VOLTAGE WIRE BACK TO AHU.

= 120V. SMOKE/CO ALARM WITH BATTERY
BACK-UP AND AUXILIARY CONTACT SO ALL SOUND
TOGETHER.

ALL ARC-FAULT CIRCUIT BREAKERS SHALL BE COMPATIBLE WITH CEILING FANS, LED FIXTURES AND OTHER ELECTRONIC DEVICES.

8. FIXTURES ARE TYPE "A" UNLESS NOTED OTHERWISE.

TO ACCEPT BEDROOM HORN/STROBES IN FUTURE INCLUDING WIRING AND PANEL CAPACITY.

FIRE ALARM HORN/STROBE CIRCUITS SHALL BE SIZED

10. ALL RANGES SERVED BY (3) #8 AND (1) # 10 AND 50A. RECEPTACLE.

11. ALL WATER HEATERS SERVED BY (3) #10.

12. ALL WASHERS AND REFRIGERATORS HAVE RECEPTACLES AT 48". MW RECEPTACLES AT 66" (VERIFY).

13. SEE HVAC SCHEDULE AND SHOP DRAWINGS FOR AHU AND OUTDOOR UNIT CIRCUITS.

 ALL DRYERS SERVED BY (4) #10 AND 30A. RECEPTACLE.

15. BELOW COUNTER RECEPTACLES AND PLATES SHALL MATCH THE BASE CABINETS WHERE THEY ARE MOUNTED (BROWN, WHITE, ETC.) VERIFY WITH ARCHITECT.

LEGE

SWITCHED GFI RECEPTACLE FOR GARBAGE DISPOSER CONTINUE CIRCUIT TO DISHWASHER.

2 PROVIDE ARC-FAULT CIRCUIT BREAKER IN PANEL.

TELE/TV DEMARK FLUSH BOX. PROVIDE WITH DUPLEX OUTLET. PROVIDE 1" CONDUIT FROM BOX TO ABOVE CEILING AND OUT TO CEILING IN THE HALLWAY. SEE DETAILS.

Juard Villas s Summit, Missouri

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REVISIONS #

1 PERMIT COMMENTS 9.24.2021
3 REVISION 1 5.12.2022

3 REVISION 1

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E101

TYPICAL UNIT PLAN - ELECTRICAL

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LSA PROJECT NO. 2104028