

COMPOSITION ROOF W/ 7/16' SHEATHING UNDER (TYPICAL)

EGRESS

UNDISTURBED

UNDISTURBED

4'-0'

FRONT ELEVATION

SCALE: 1/4" = 1'-0"

ROOF VENTS AND 5

SOFFIT VENTS

PED 10011

PER LOCAL CODE

6' X 5/4' SMART TRIM (TYP. @ FRONT ELEV.)

SMART PANEL WOOD GRAIN SIDING

(SIDES AND REAR ELEVATIONS ONLY)

RIGHT ELEVATION

SCALE: 1/8" = 1'-0"

EGRESS

4' X 4/4' SMART TRIM (UNLESS NOTED OTHERWISE)

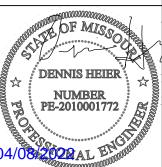
UNDISTURBED \_\_\_

VENEER STONE W/ 7/16' SHEATHING UNDER (FRONT ELEVATION ONLY)

## Drawing Title: WWS048 Spec

Site Description: Lot 48, Whispering Woods 2nd Plat


Street Address: 1604 SW 27th St., Lee's General Contractor: Walker Custom Homes, LLC



Date: 10 - 11 - AD 2021 Rev. 1: 3 - 28 - AD 2022 Rev. 2: Rev. 3:

Sheet Title: **ELEVATIONS** 

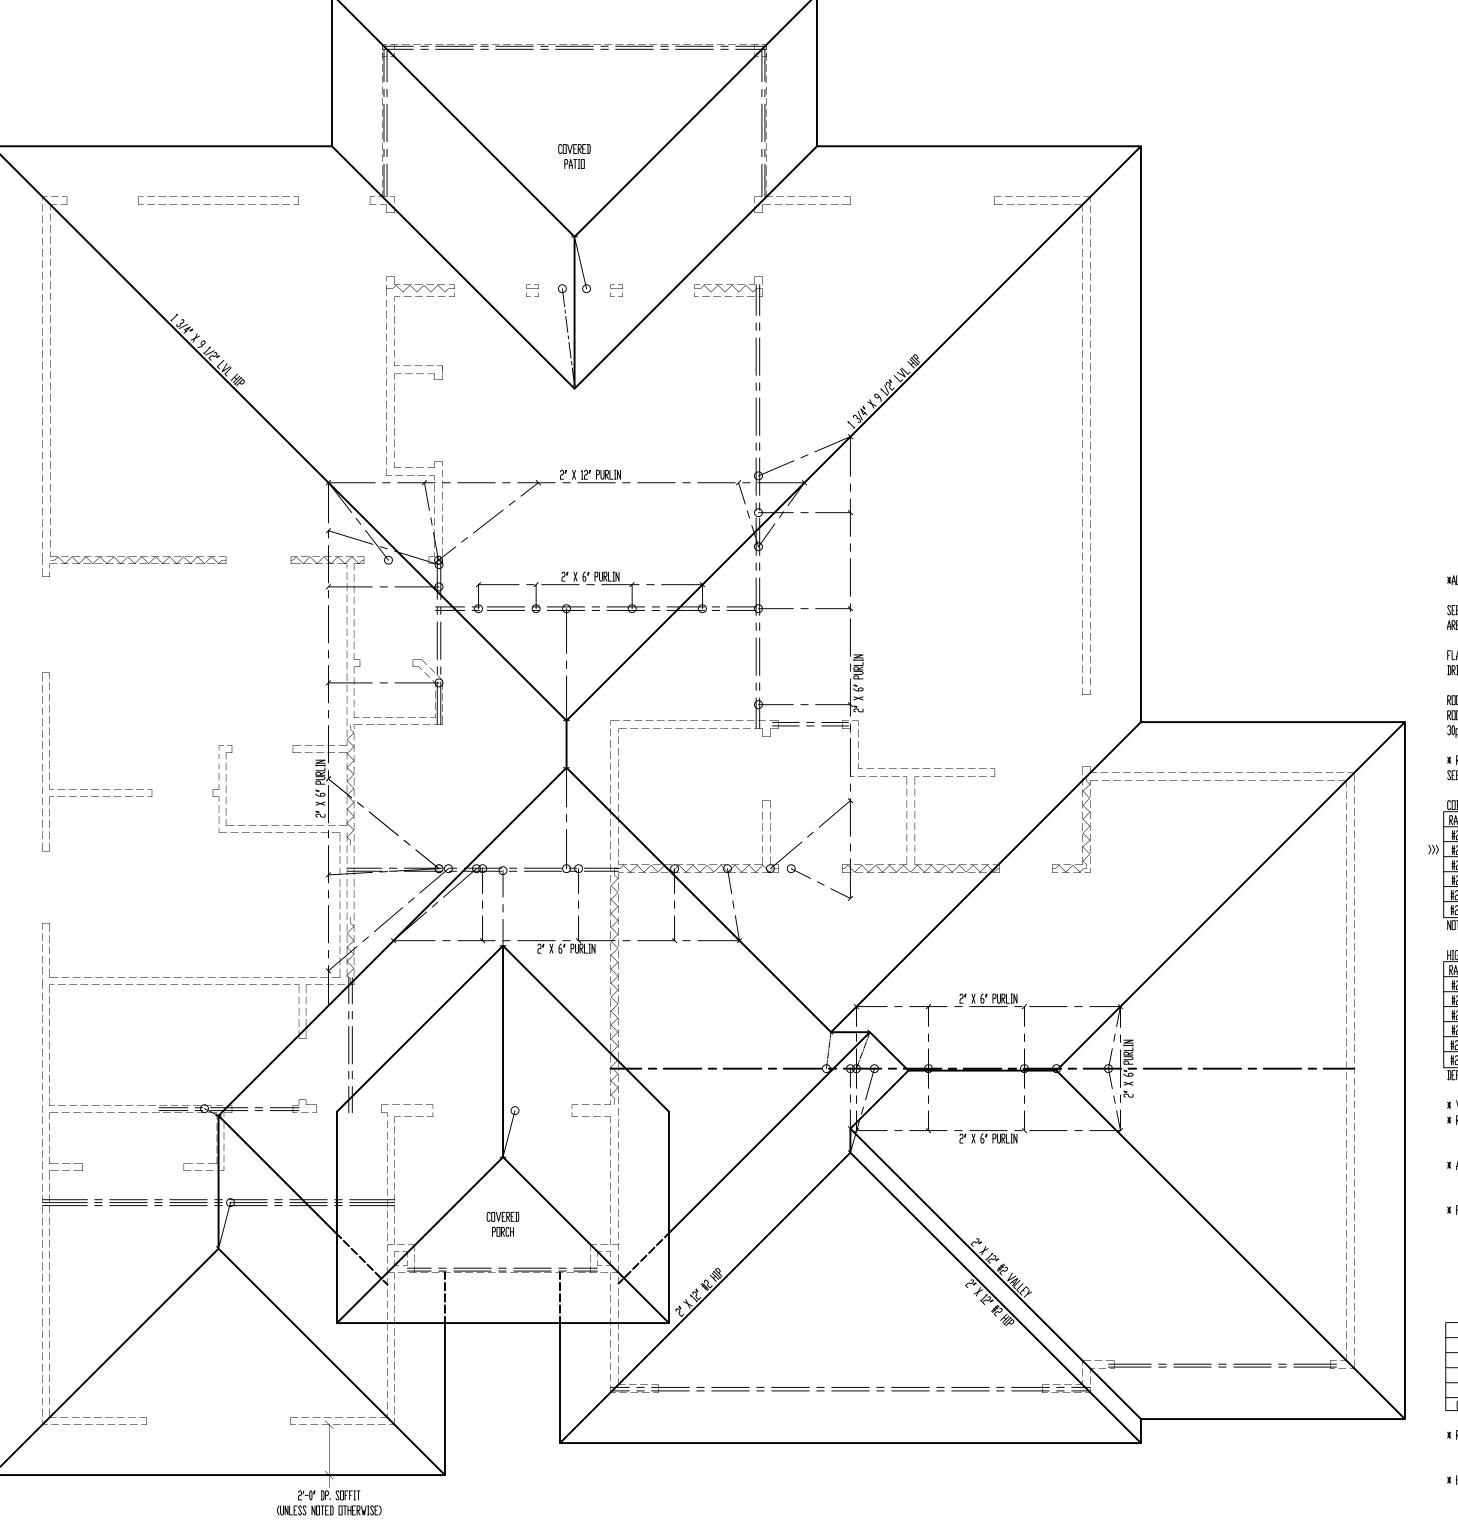Sheet No.:



## ROOF

SCALE: 1/4'' = 1'-0''

\*ALL RAFTERS SHALL BE 2' X 6' #2 @ 16' D.C., UNLESS NOTED OTHERWISE.

SEE DETAIL 7/S3.2 FOR ALTERNATE RAFTER BEARING DETAIL WHEN RAFTERS ARE REQUIRED TO BEAR HIGHER THAN THE WALL DOUBLE TOP PLATE.

FLASHING NOTE: DRIP EDGE, VALLEYS AND FLASHINGS TO BE METAL CLAD.

ROOF DESIGNED FOR LIGHT ROOF COVERING 30psf TOTAL LOAD [10psf DL, 20psf LL (SL)]

\* RAFTERS (HEM-FIR, DOUG-FIR, OR EQUAL): SEE SPAN CHARTS BELOW

	CODE MINI	CODE MINIMUM		
	RAFTERS	SPACING	MAX HORIZONTAL CLEARSPAN	
	#2-2x6	@24″ □.C.	11'-7 <b>'</b>	
$\rangle \rangle \rangle$	#2-2x6	<b>€</b> 16 <b>′</b> □.C.	14'-2 <b>'</b>	<b> </b> ((
	#2-2x8	@24 <b>″</b> □.C.	14'-8 <b>'</b>	
	#2-2x8	<b>0</b> 16 <b>′</b> □.C.	17'-11 <b>'</b>	
	#2-2x10	@24″ □.C.	17'-10 <b>'</b>	
	#2-2x10	€16 <b>′</b> □.C.	21'-11 <b>'</b>	

NOTE: CODE MINIMUM ALLOWS FOR A RAFTER DEFLECTION OF L/180 TOTAL LOAD

HIGHER PE	RFORMANCE (RI	ECOMMENDED)
RAFTERS	SPACING	MAX HORIZONTAL CLEARSPAN
#2-2x6	@24″ □.C.	8'-6 <b>"</b>
#2-2x6	<b>0</b> 16 <b>′</b> □.C.	9'-9 <b>'</b>
#2-2x8	@24" D.C.	11'-3 <b>'</b>
#2-2x8	<b>0</b> 16 <b>′</b> □.C.	12'-9 <b>'</b>
#2-2x10	@24 <b>″</b> □.C.	14′-3 <b>′</b>
#2-2x10	€16 <b>'</b> □.C.	16'-3 <b>'</b>
DEFLECTIO	N = L/360 LIV	VE LOAD, L/240 TOTAL LOAD

\* VAULTS TO BE 2x10 DEPTH
\* RIDGE BOARDS ARE: (UNLESS OTHERWISE NOTED) - #2- 2X8 UP TO 10/12 PITCH

- #2- 2X10 NVFR 10/12 PITCH

\* ALL HIPS & VALLEYS ARE: (UNLESS OTHERWISE NOTED) - #2- 2X8 UP TO 10/12 PITCH - #2- 2X10 OVER 10/12 PITCH

\* PURLINS ARE 2X6 MIN.

- PURLIN STRUTS ARE AT 4'-0' D.C. - PURLIN STRUTS SHALL BE INSTALLED AT NOT LESS THAN A 45 Degree angle with the Horizontal

- ALL PURLINS STRUTS SHALL HAVE A MAXIMUM UNBRACED LENGTH OF 8'-0' - PURLINS STRUTS SHALL BE CONSTRUCTED IN A 'T' CONFIGURATION AND PER THE FOLLOWING CHART:

PURLIN STRUT	MAX PURLIN STRUT LENGTH
(2) 2x4	8'-0 <b>'</b>
(1) 2x4 & (1) 2x6	12'-0 <b>'</b>
(1) 2x6 & (1) 2x8	20'-0 <b>'</b>
(2) 2x6 & (1) 2x8	30'-0 <b>'</b>
CONSULT ARCH./ENGR. >	30'-0 <b>'</b>

\* RIDGE BRACES ARE SAME AS PURLIN BRACES-SPACING, SIZE, CONFIGURATION, & INSTALLATION (SEE PURLIN BRACE NOTES ABOVE) \* HIP & VALLEY BRACES ARE SAME AS PURLIN SIZE, CONFIGURATION, & INSTALLATION (SEE PURLIN BRACE NOTES ABOVE)

\* VERTICAL BRACE IF DOT IS UNDER HIP OR VALLEY \* SLASH IS TOP END OF BRACE ( / ), DOT IS BOTTOM OF BRACE ( o ). \* ODENOTES BEARING WALL \*---- DENOTES ROOF BRACE \*---- DENOTES PURLIN

\*—— DENOTES BEARING STRUCTURE

Drawing Title: WWS048 Spec

Site Description: Lot 48, Whispering Woods 2nd Plat

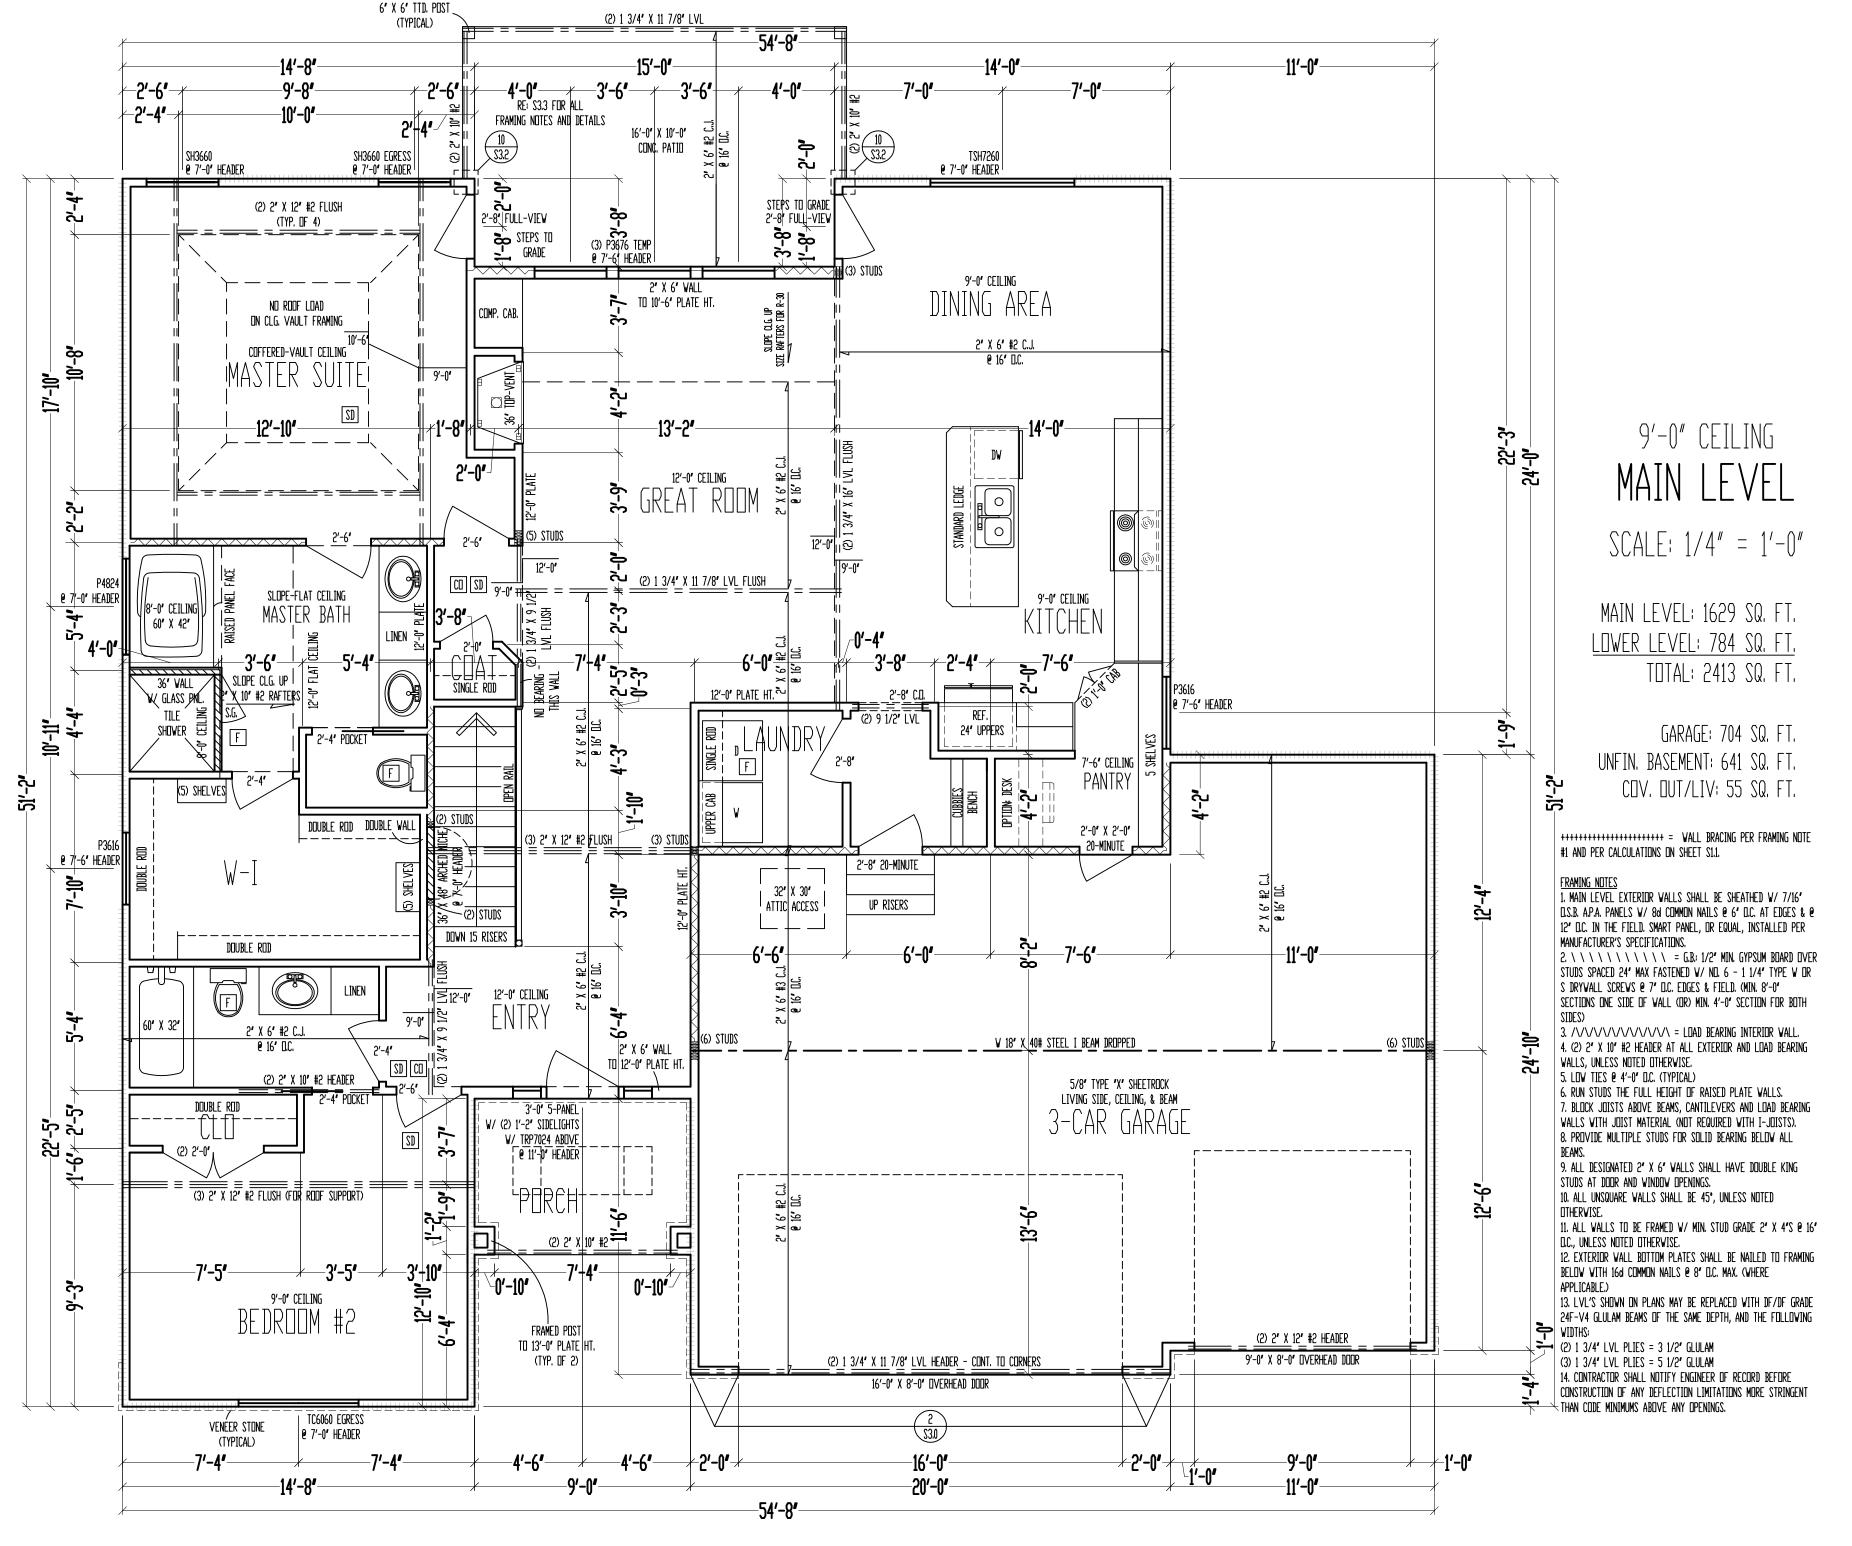
Street Address: 1604 SW 27th St., Lee's General Contractor: Walker Custom Homes, LLC



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Sheet Title: **ROOF PLAN** 

Sheet No.:



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Site Description:

Lot 48,

Whispering

Woods 2nd Plat

Street Address:

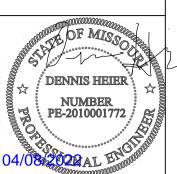
1604 SW 27th St., Lee's

Summit, Missouri

General Contractor:

Walker Custom

Homes, LLC



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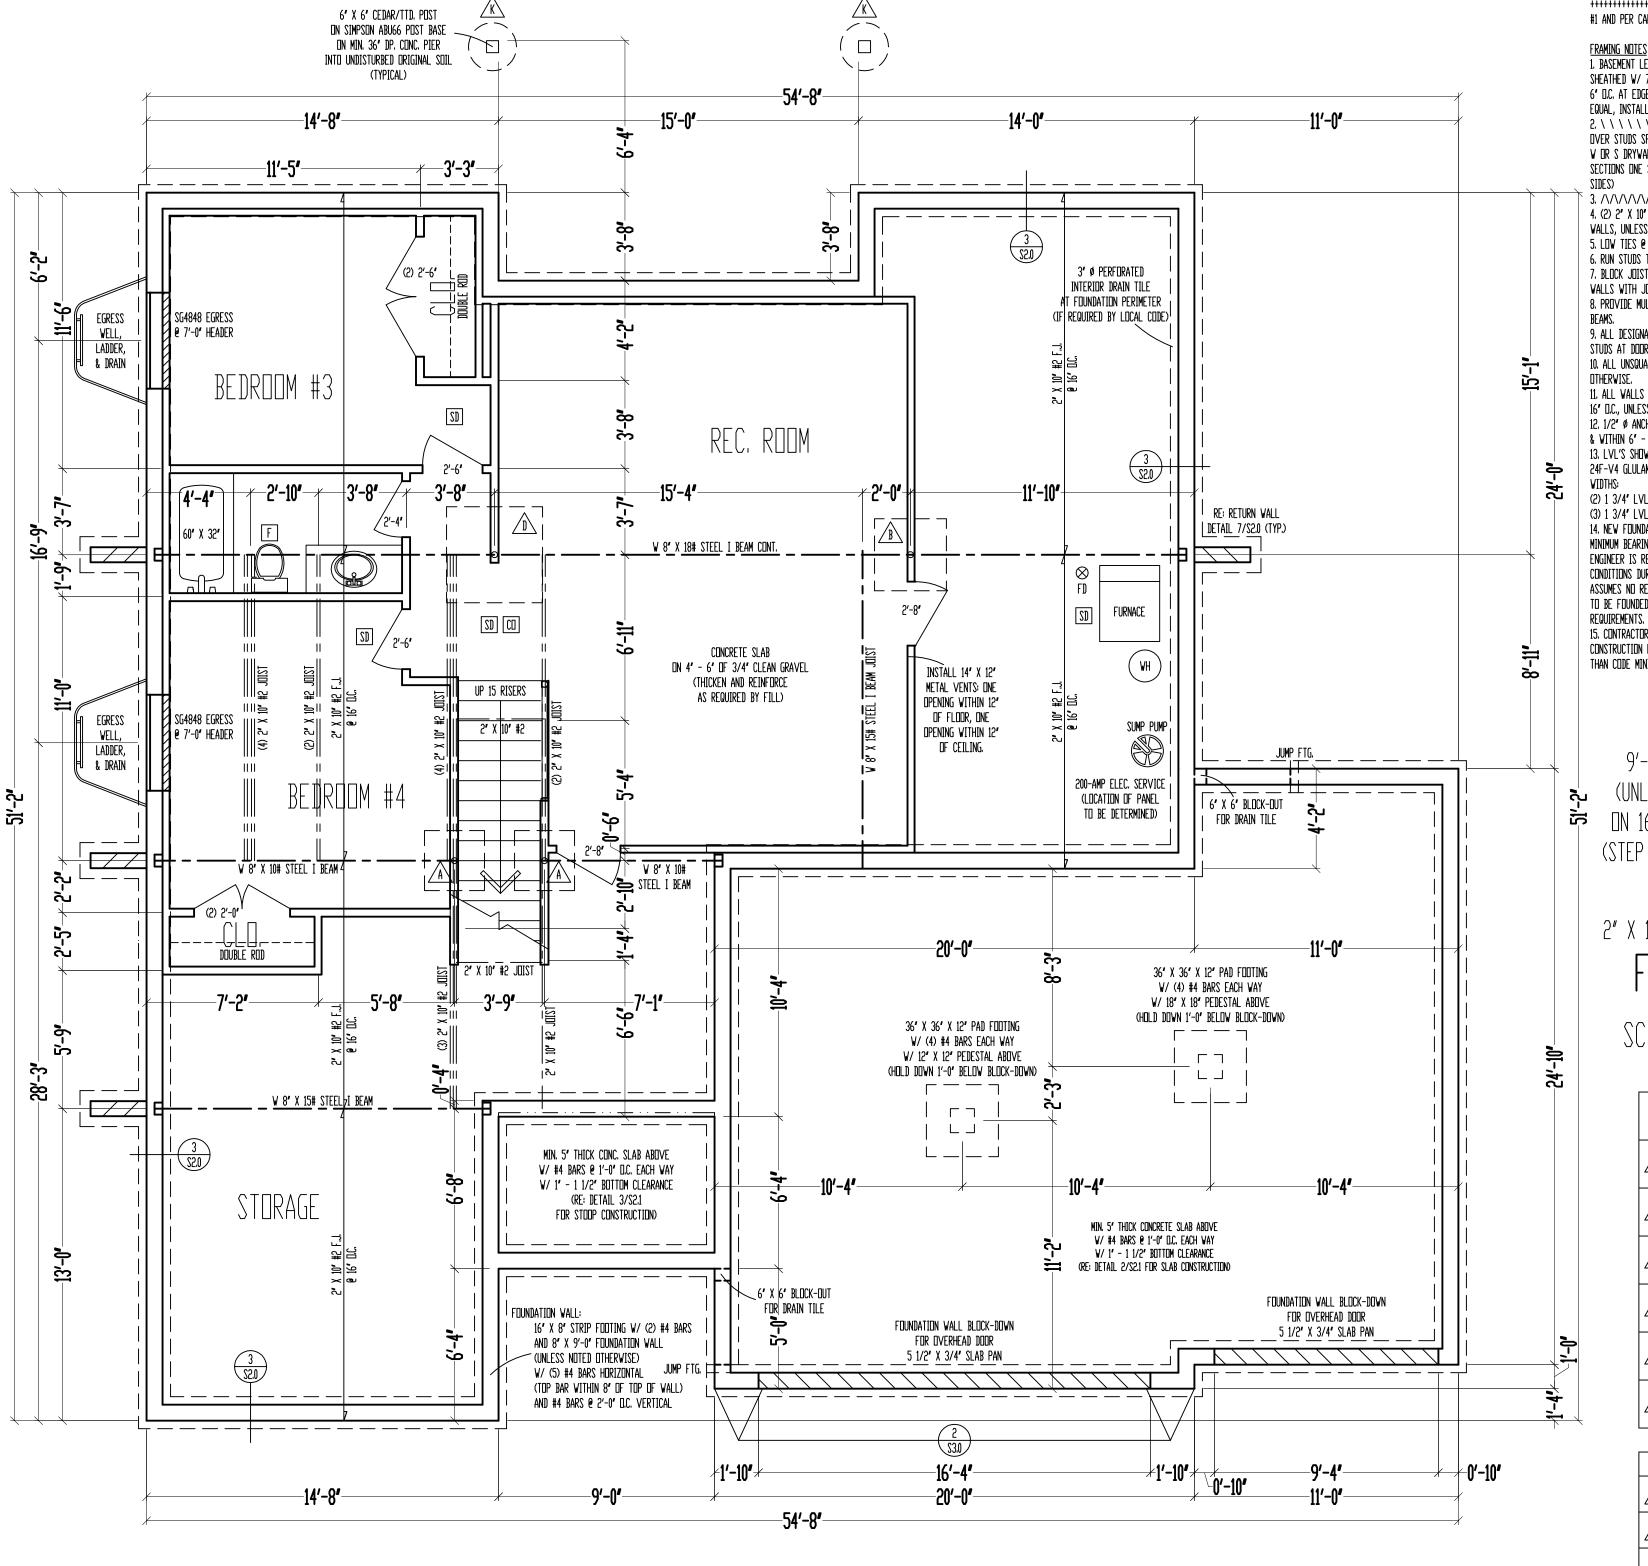
Sheet Title:

MAIN LEVEL PLAN

Sheet No.:

A - 3

of 4



FRAMING NOTES

1. BASEMENT LEVEL EXTERIOR WOOD-FRAMED WALLS SHALL BE SHEATHED W/ 7/16' D.S.B. A.P.A. PANELS W/ 8d CDMMON NAILS @ 6' D.C. AT EDGES & @ 12' D.C. IN THE FIELD. SMART PANEL, DR EQUAL, INSTALLED PER MANUFACTURER'S SPECIFICATIONS. 2. \ \ \ \ \ \ \ \ \ = G.B.; 1/2' MIN. GYPSUM BOARD OVER STUDS SPACED 24" MAX FASTENED W/ ND. 6 - 1 1/4" TYPE W DR S DRYWALL SCREWS @ 7" D.C. EDGES & FIELD. (MIN. 8'-0" SECTIONS ONE SIDE OF WALL (OR) MIN. 4'-0' SECTION FOR BOTH

3. /\/\/\/\/\\ = LOAD BEARING INTERIOR WALL. 4. (2) 2" X 10" #2 HEADER AT ALL EXTERIOR AND LOAD BEARING WALLS, UNLESS NOTED OTHERWISE.

5. LOW TIES @ 4'-0" D.C. (TYPICAL) 6. RUN STUDS THE FULL HEIGHT OF RAISED PLATE WALLS. 7. BLOCK JOISTS ABOVE BEAMS, CANTILEVERS AND LOAD BEARING WALLS WITH JOIST MATERIAL (NOT REQUIRED WITH I-JOISTS). 8. PROVIDE MULTIPLE STUDS FOR SOLID BEARING BELOW ALL

9. ALL DESIGNATED 2' X 6' WALLS SHALL HAVE DOUBLE KING STUDS AT DOOR AND WINDOW OPENINGS. 10. ALL UNSQUARE WALLS SHALL BE 45°, UNLESS NOTED

11. ALL WALLS TO BE FRAMED W/ MIN. STUD GRADE 2' X 4'S @ 16' D.C., UNLESS NOTED OTHERWISE.

12. 1/2' Ø ANCHOR BOLTS W/ MIN. 7' EMBEDMENT @ 48' D.C. MAX. & WITHIN 6' - 12' OF END OF EACH PLATE LENGTH. 13. LVL'S SHOWN ON PLANS MAY BE REPLACED WITH DF/DF GRADE 24F-V4 GLULAM BEAMS OF THE SAME DEPTH, AND THE FOLLOWING

(2) 1 3/4" LVL PLIES = 3 1/2" GLULAM (3) 1 3/4" LVL PLIES = 5 1/2" GLULAM 14. NEW FOUNDATION SHALL BEAR ON ORIGINAL SOIL WITH MINIMUM BEARING CAPACITY OF 1500 PSF. A GEOTECHNICAL ENGINEER IS RECOMMENDED FOR VERIFICATION OF THESE CONDITIONS DURING THE EXCAVATION PHASE, ENGINEER OF RECORD ASSUMES NO RESPONSIBILITY FOR CONSTRUCTION NOT VERIFIED TO BE FOUNDED ON ANYTHING SHORT OF THE AFOREMENTIONED

15. CONTRACTOR SHALL NOTIFY ENGINEER OF RECORD BEFORE CONSTRUCTION OF ANY DEFLECTION LIMITATIONS MORE STRINGENT THAN CODE MINIMUMS ABOVE ANY OPENINGS.

9'-0" FOUNDATION WALLS ON 16" X 8" STRIP FOOTINGS (STEP WHERE GRADE REQUIRES)

2" X 10" FLOOR SYSTEM ABOVE

## FOUNDATION

SCALE: 1/4" = 1'-0"

	STEEL COLUMN &			
	PAD FOOTING SCHEDULE			
	Â	3' X 11 GA. STEEL COLUMN ON 30' X 30' X 10' PAD FOOTING W/ (4) #4 BARS EACH WAY (12.5k)		
	B	3 1/2" X 11 GA. STEEL COLUMN ON 36" X 36" X 10" PAD FOOTING W/ (4) #4 BARS EACH WAY (18.0k)		
	<u>\( \)</u>	3' SCH. 40 STEEL COLUMN ON 42' X 42' X 12' PAD FOOTING W/ (5) #4 BARS EACH WAY (24.5k)		
		3 1/2' SCH. 40 STEEL COLUMN ON 48' X 48' X 12' PAD FOOTING W/ (6) #4 BARS EACH WAY (32.0k)		
	<u>E</u>	3 1/2" SCH. 40 STEEL COLUMN DN 54" X 54" X 14" PAD FOOTING W/ (7) #4 BARS EACH WAY (40.5k)		
	F	3 1/2" SCH. 40 STEEL COLUMN ON 60" X 60" X 14" PAD FOOTING W/ (8) #4 BARS EACH WAY (50.0k)		

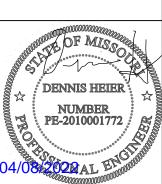
PIER FOOTING SCHEDULE					
<u>C</u>	12' Ø PIER FTG.				
Ĥ\	16" Ø PIER FTG.				
<u>/</u>	18" Ø PIER FTG.				
Ŕ	24' Ø PIER FTG.				

#1 AND PER CALCULATIONS ON SHEET S1.1.

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**FOUNDATION PLAN** 

Sheet No.: