ALL CONSTRUCTION SHALL CONFORM TO 2018 INTERNATIONAL RESIDENTIAL CODE OR ATTACHED ENGINEER SPECIFICATIONS WHERE APPLICABLE.

ALL UNMARKED HEADERS SHALL BE A MINIMUM #2 DOUGLAS FIR LARCH (2) 2 X 10 ON LOAD BEARING WALLS.

DETAILS AND NOTES:

BASEMENT EGRESS WINDOWS ARE TO COMPLY WITH IRC

WINDOW FALL PROTECTION REQUIREMENTS TO COMPLY WITH SECTION R612.2. STAIRS SHALL COMPLY WITH IRC R311.7. THE MAXIMUM RISER HEIGHT OF STAIRWAYS SHALL NOT EXCEED 7-3/4"

AND THE TREADS SHALL PROVIDE A MINIMUM TREAD DEPTH

OF 10" (IRC 2018 R311.7.5.1). SELF CLOSING DEVICES ARE REQUIRED FOR GARAGE TO DWELLING SEPARATION DOORS.

STEEL COLUMNS WILL BE A MINIMUM OF SCHEDULE 40. ENERGY REQUIREMENTS SHALL CONFORM TO THE IRC

CHAPTER 11. SECURITY SHALL CONFORM TO IRC R326/KCBRC. AN ACCESSIBLE CONNECTION POINT WILL BE PROVIDED TO A 20 FOOT CONCRETE ENCASED ELECTRODE (FOOTING REBAR) FOR THE ELECTRICAL SERVICE GROUNDING

ELECTRODE CONDUCTOR (UFER GROUND). CARBON MONOXIDE DETECTORS WILL BE PROVIDED IN ACCORDANCE WITH IRC SECTION R315. THE BUILDING THERMAL ENVELOPE IS REQUIRED TO BE SEALED(2018 IRC SECTION N1102.4.1 AND TABLE N1102.4.1.1). DUCTS, AIR HANDLERS, FILTER BOXES AND BUILDING CAVITIES USED AS DUCTS SHALL BE SEALED (2018 IRC SECTION N1103.2.2)

FLOOR PLANS:

LEDGERS(FLOOR AND CEILING) SHALL BE IN ACCORDANCE WITH IRC 507. ALL CANTILIEVERS SHALL HAVE AT LEAST A 3:1 BACK SPAN. A MINIMUM OF DOUBLE JOIST UNDER EACH BEARING WALL IS REQUIRED.

ALL WALLS UNDER 12' SHALL BE DOUGLAS FIR LARCH #2 2X4 STUDS AT 16" O.C. FULL HEIGHT CONTINUOUS (UNLESS OTHERWISE NOTED).

ALL WALLS 12' AND OVER SHALL BE DOUGLAS FIR #2 (M-12) <u>UMBER 2x6 STUDS AT 16" O.C. FULL HEIGHT CONTINUOUS</u> (UNLESS OTHERWISE NOTED).

EXTERIOR WALL SHEATHING SHALL BE AS FOLLOWS:

3" THICK OSB FOR METHODS: WSP, CS-WSP AND PFH $\frac{7}{16}$ " THICK OSB FOR METHOD CS-PF.

SPECIFIED THICKNESS OF OSB SHALL BE INSTALLED UNDERNEATH LP LAP SIDING AND/OR ENGINEERED BRACED WALL PANELS.

LP PANEL SIDING - 7/16" GROOVED SHALL BE EQUIVALENT TO 3" THICK OSB. OSB MAY BE OMITTED UNDERNEATH 7/16" GROOVED PANEL SIDING IN AREAS REQUIRING 3" THICK OSB.

INSTALL FASTENERS AND NAILING PATTERN PER 2018 IRC SECTION R602.10.

MIN. STUD PACK OF (4) 2 x 4 OR (4) 2 x 6 DOUGLAS FIR LARCH #2 (DEPENDING ON WALL THICKNESS) BELOW EACH BEARING POINT OF EACH GIRDER TRUSS, UNLESS
OTHERWISE NOTED. STUD PACKS SHALL BE CARRIED DOWN
TO FOUNDATION OR LOAD SUPPORTING MEMBER.

PROVIDE 2X SOLID BLOCKING SUPPORT BELOW ALL POINT LOADS CONTINUOUS TO BEARING STRUCTURE AND/OR FOUNDATION BELOW.

BRACING METHODS

EXTERIOR BRACING CS-PF PER IRC R602.10

EXTERIOR BRACING CS-WSP PER IRC R602.10

PANELS PER IRC R602.10.5.2)

55" - 8' TALL WALL HEIGHT


62" - 9' TALL WALL HEIGHT 69" - 10' TALL WALL HEIGHT

INTERIOR BRACING LIB PER IRC R602.10

MINIMUM LIB LENGTH PER 2018 IRC TABLE R602.10.5:

LVL'S SHALL BE: BOISE CASCADE VERSA-LAM 3100 FB GLU-LAMS SHALL BE: DF 24F-V4 - WESTERN PROVIDE FULL BEARING FOR OPTION SELECTED

IRC TABLE N1102.1.2 (R402.1.2) INSULATION AND FENESTRATION REQUIREMENTS BY COMPONENT (PARTIAL) BASEMENT SLAB R-VALUE CRAWL SPACE CEILING WOOD FRAME WALL WALL CLIMATE | FENESTRATION | SKYLIGHT | FLOOR U-FACTOR U-FACTOR FENESTRATION R-VALUE R-VALUE R-VALUE | WALL R-VALUE | & DEPTH SHGC b, e R-VALUÉI R-VALUE 8/13 10/13 10, 2 FT 10/13 .32 .40 20 OR 13+5 MARINE

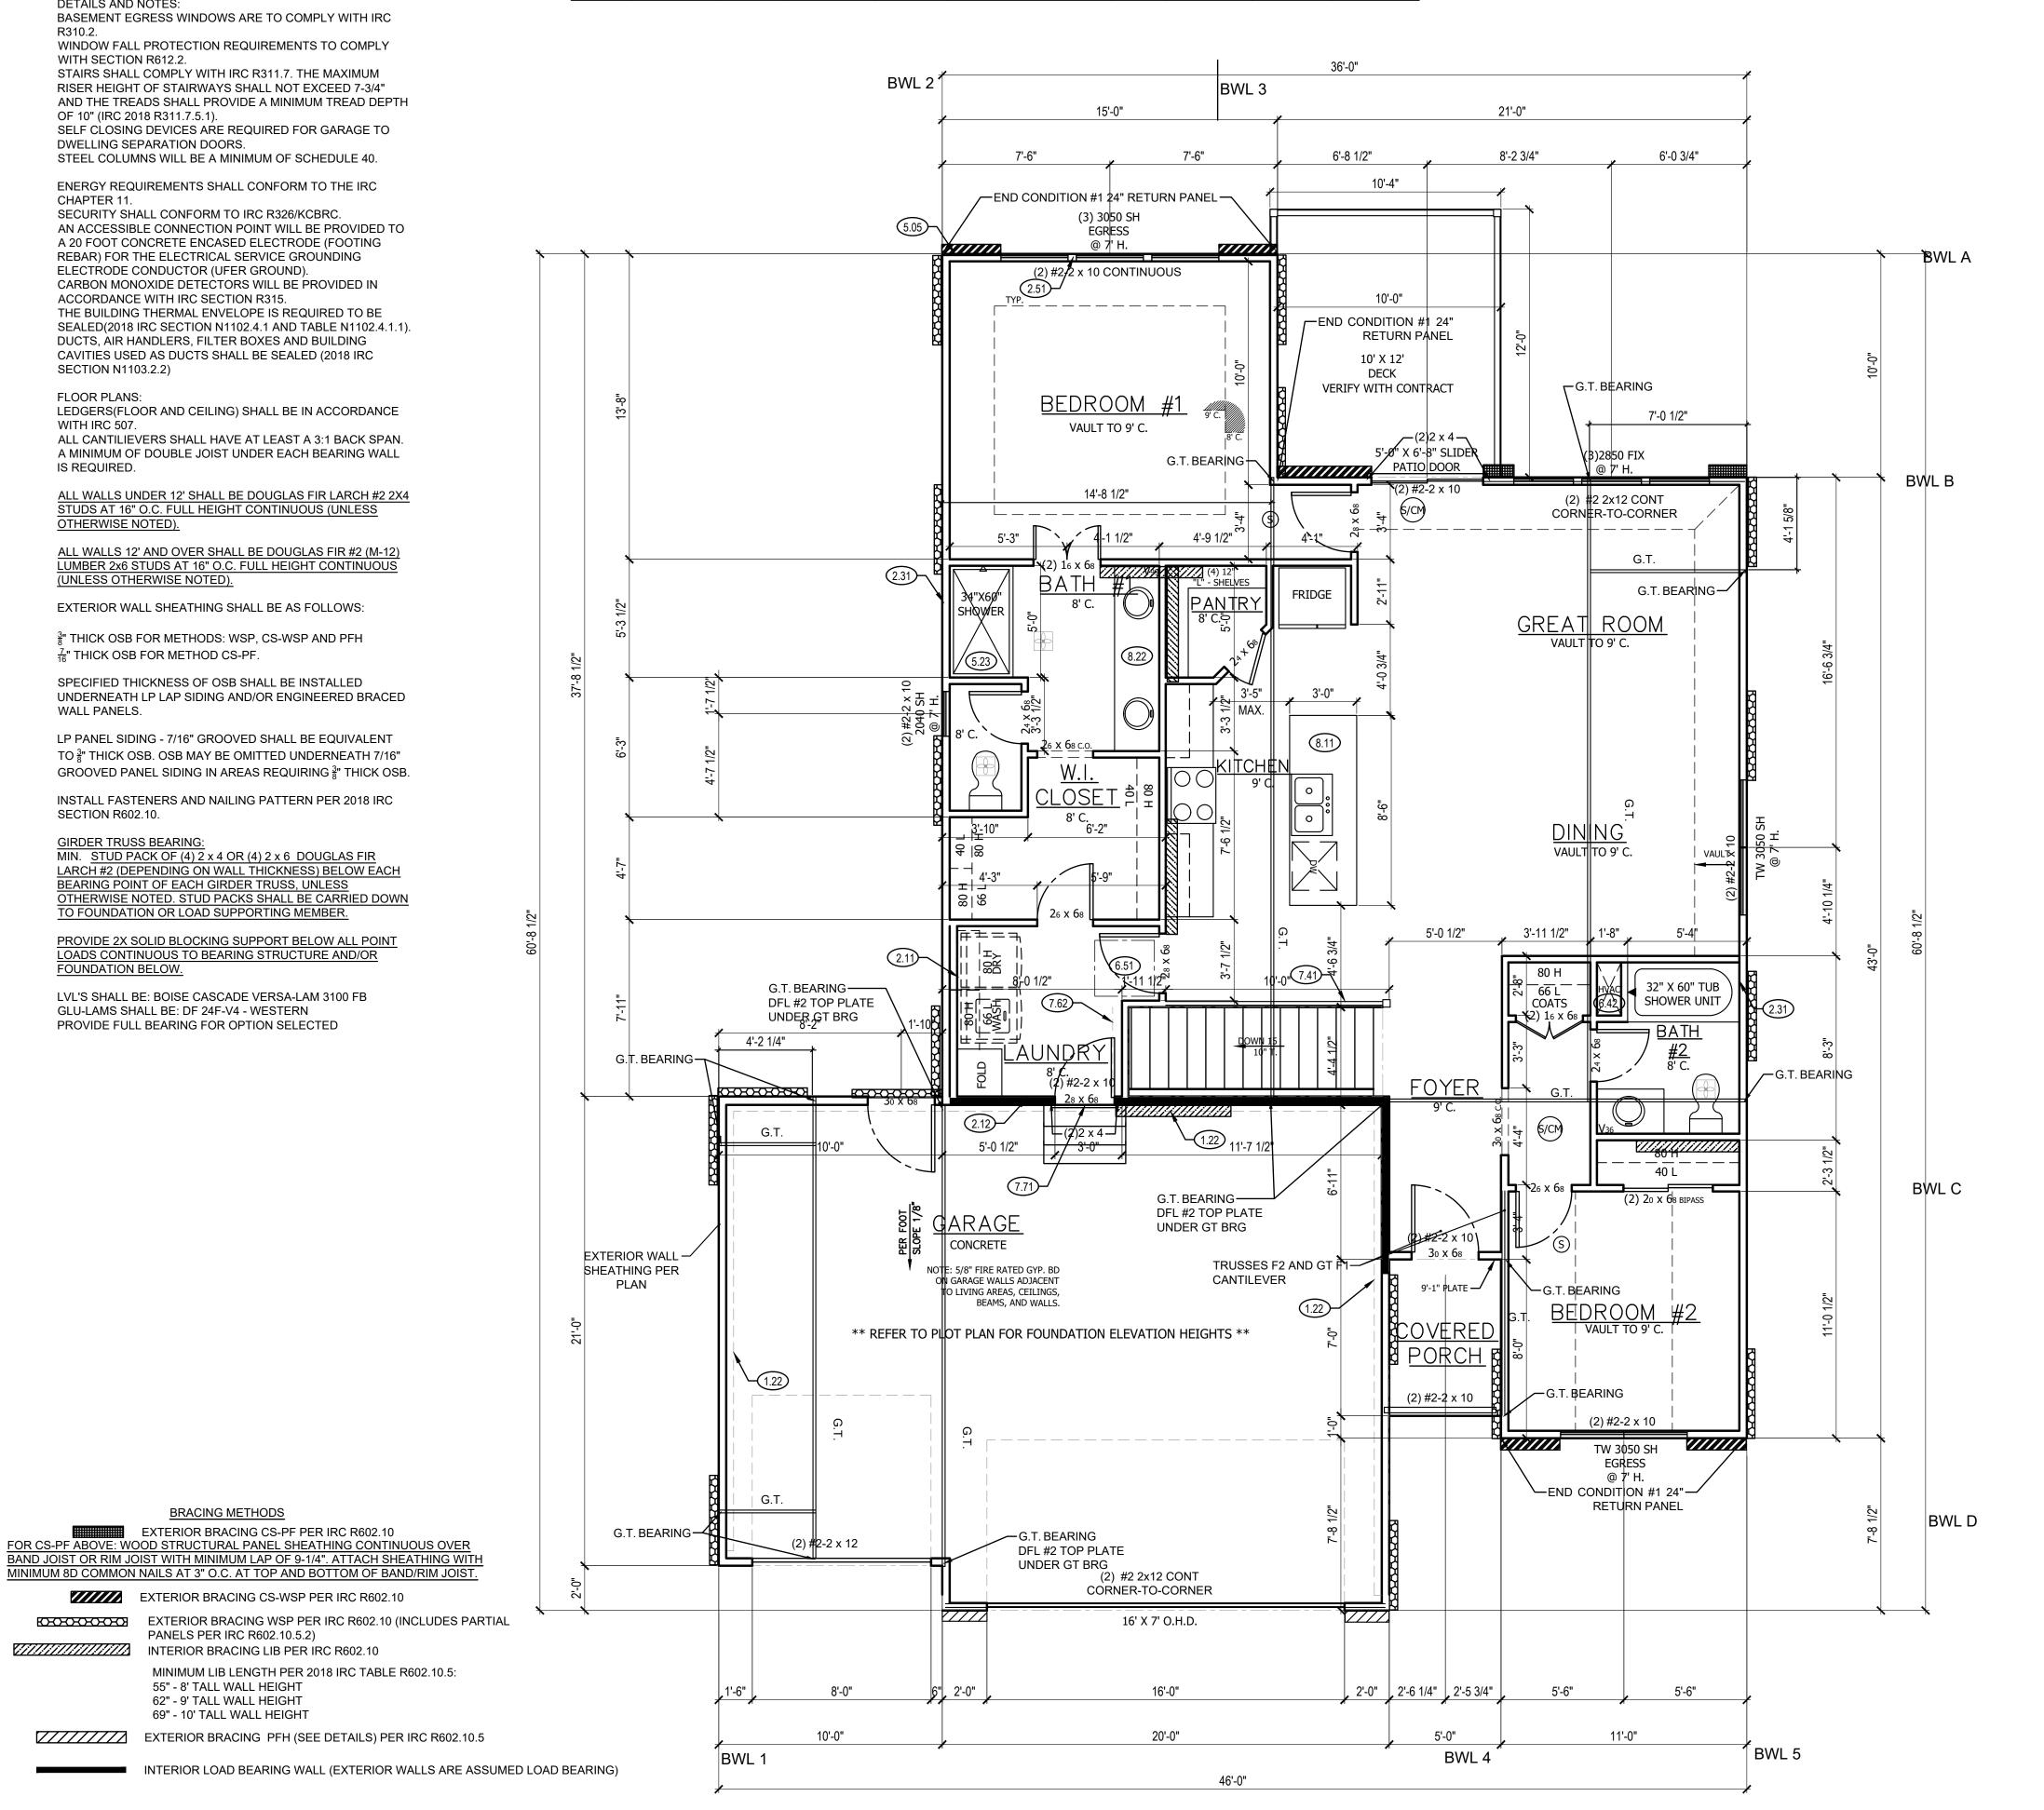

MAIN FLOOR PLAN NOTES

- 1.22 EXPOSED TOP OF FOUNDATION WALL.
- 2.11 DOUBLE 2X4 STUD WALL
- 2.12 2X6 STUD WALL
- 2.31 SIX SIDED TUB ASSEMBLY INCLUDING THERMOPLY ON EXTERIOR WALL TO 2" ABOVE TOP OF TUB DECK OR TUB/SHOWER UNIT
- 2.51 3 STUDS BETWEEN WINDOW UNITS
- 4.51 SINGLE BOX VAULT
- 5.05 HOSE BIBB
- 5.23 34X60 SHOWER. SEE PRICE SUMMARY.
- 6.42 HVAC FLOOR OPENING. HEADER OFF FLOOR JOISTS AS REQUIRED. BUMP TRUSSES AS NECESSARY FOR HVAC ACCESS.
- 6.51 1'-10"X3'-0" MINIMUM ATTIC ACCESS WITH 3/4" BACKER BOARD AND 2 LATCHES. BUMP TRUSSES FOR ATTIC ACCESS.
- 7.41 OPEN HANDRAILS
- 7.62 DASHED LINE REPRESENTS STAIRS BELOW
- 7.71 20 MINUTE FIRE RATED SOLID CORE WITH
- SELF-CLOSING HINGES 7.88 CHANGE IN FLOORING MATERIAL
- 8.11 24" CABINET + 12" OVERHANG FLAT ISLAND. VERIFY LOCATION WITH PERSONAL BUILDER.
- 8.22 CONTINUOUS FLAT VANITY
- 8.52 FOLDING TABLE

GENERAL NOTES

PROTECTION.

OTHERWISE.

PER VENDOR.

REQUIREMENTS.

INSULATION SURROUND.

WINDOWS TO COMPLY WITH IRC R312.2 FOR FALL

ALL INTERIOR NON-LOAD BEARING, NON-BRACED, NON-CABINET WALLS ARE ALLOWED AT 24" O.C.

TRUSSES UNLESS NOTED OTHERWISE.

ALL EXTERIOR WALLS, INTERIOR BEARING WALLS, AND

INTERIOR BRACED WALLS ARE AT 16" O.C. UNLESS NOTED

ROOF AND CEILING FRAMING ARE PRE-ENGINEERED WOOD

DIMENSIONAL LUMBER IS LABELED PER INDUSTRY STANDARD

HVAC DUCTWORK RUNNING THROUGH THE ATTIC SPACE

PROVIDE BLOCKING AT ALL CEILING JUMPS FOR INSULATION.

SMOKE AND CARBON MONOXIDE DETECTORS SHOW ON PLANS ARE TO BE CONSIDERED RECOMMENDATIONS ONLY. FINAL

2X6 EXTERIOR WALL OVER 12' SHALL BE DOUGLAS FIR #2.

PLACEMENT IS TO BE DETERMINED BY MUNICIPAL

HUNG, 3066 FIX = 3'-0" X 6'-6" FIXED.

WINDOW SIZES ARE WRITTEN IN FEET AND INCHES PER INDUSTRY STANDARDS. EX: 3050 SH = 3'-0" X 5'-0" SINGLE

SHALL BE HUNG FROM ABOVE TO ALLOW COMPLETE

TERMINOLOGY. ACTUAL LUMBER SIZING IS EXPECTED TO VARY

CPG DBA


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> DRAWN BY: C.HOOPER

ISSUE DATE:

12.01.21

SHEET NUMBER:

RELEASE FOR

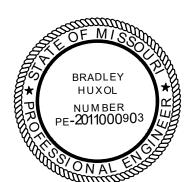CONSTRUCTION

Development Services LEE'S SUMMIT, MISSOURI

AS NOTED ON PLANS REVIEW

SCALE: 1/4" = 1'-0"